







AFF	ABOVE FINISHED FLOOR
ACT	ACOUSTICAL CEILING TILE
AL/ALUM	ALUMINUM
BLDG	BUILDING
САВ	CABINET
CPT	CARPET
CSWK	CASEWORK
CLG	CEILING
CL	CENTERLINE
СМ	CONSTRUCTION MANAGEMENT
COOR	COORDINATE
DEMO	DEMOLITION
DBL	DOUBLE
EW	EACH WAY
ELEV	ELEVATION
EQ	EQUAL
XTG	EXISTING
FRP	FIBERGLASS REINFORCED PLASTIC
FEC	FIRE EXTINGUISHER CABINET
FD	FLOOR DRAIN
FLUOR	FLUORESCENT
	FURNISHED BY OWNER, INSTALLED BY
FOIC FOIO	CONTRACTOR FURNISHED BY OWNER, INSTALLED BY OWNER
GA	GAUGE
GC	GAUGE GENERAL CONTRACTOR
GL	GLASS
GUGU	GLASS GYPSUM WALL BOARD
HDWD	
HVAC	HEATING, VENTILATION, AND AIR CONDITIONING
HGT	HEIGHT
HM	HOLLOW METAL
MEP	MECHANICAL, ELECTRICAL, PLUMBING
MTL	METAL
NIC	NOT IN CONTRACT
	NOT TO SCALE
NTS	
	OVERHANG
PT	PAINT PLASTIC LAMINATE
REQ	REQUIRED
SS	STAINLESS STEEL
TYP	TYPICAL
UON	UNLESS OTHERWISE NOTED
VIF	VERIFY IN FIELD
WDB	WOOD BASE
WD	WOOD/WOOD VENEER

ARCHITECT: DESTREE DESIGN ARCHITECTS, INC.

222 WEST WASHINGTON AVE. SUITE 310 MADISON, WI 53703 PH: 608.268.1499 FAX: 608.268.1498 WWW.DESTREEARCHITECTS.COM PROJECT ARCHITECT: MELISSA DESTREE AIA MELISSA@DESTREEARCHITECTS.COM DESIGNER/PROJECT MANAGER: JASON EKSTROM-DESIGNER/ASSOC AIA JASON@DESTREEARCHITECTS.COM

STRUCTURAL ENGINEER: ECHELON STRUCTURES

THOMAS R. BOEHNEN JR, P.E., S.E. CELL: 608-206-0521 ESCHELONSTRUCTURES@CHARTER.NET

<u>SYMB</u>	OL LEGEND:	
ROOM IDEN	ROOM NAME ROOM NUMBER	X
	WALL PARTITION TYPE CALLOUT	LEVEL ELEV. +000'-0"
X AXXX X	SHEET NUMBER	X
X	ELEVATION NUMBER	
	BUILDING OR WALL SECTION CALLOUT	





MECHANICAL ENGINEER: HEIN ENGINEERING GROUP 17 APPLEGATE CT. SUITE #200

MADISON WI PH: 608.288.9260 CONTACT: MIKE HEIN HEIN@CHORUS.NET

OWNER: CITY OF MADISON PARKS DIVISION (CIVIL & LANDSCAPE)

CITY COUNTY BUILDING SUITE:104 210 MARTIN LUTHER KING JR BLVD MADISON WI 53703 CONTACT: MIKE STURM MSTURM@CITYOFMADISON.COM 608.267.4921 CONTACT: JEANINE ZWART JZWART@CITYOFMADISON.COM 608.266.4711

DESIGN LOADS

DESIGN CODE DATA

IBC 2009 (WI Commercial Building Code, Chapter 62) ASCE 7-05: MINIMUM DESIGN LOADS FOR BUILDING AND OTHER STRUCTURES

ACI 318-08: BUILDING CODE REQUIREMENTS FOR STRUCTURAL CONCRETE AND COMMENTARY ACI 530-08/ASCE 5-08/TMS 402-08: BUILDING CODE REQUIREMENTS AND SPECIFICATION FOR MASONRY STRUCTURES

AF & PA NDS-01: NATIONAL DESIGN SPECIFICATION FOR WOOD CONSTRUCTION WITH 2005 SUPPLEMENT AISC 335-89S1: SPECIFICATION FOR STRUCTURAL STEEL BUILDINGS

AISC 341-02: SEISMIC PROVISIONS FOR STRUCTURAL STEEL BUILDINGS

BUILDING OCCUPANCY CATEGORY II (PER ASCE 7-05 TABLE 1-1)


4. ROOF LIVE LOADS (ASCE 7-05) 20 PSF (REDUCIBLE)

DEFLECTION LIMITS ROOF

OF MEMBERS	
LIVE LOAD	L/240
SNOW LOAD	L/240
WIND LOAD	L/240
DEAD LOAD + LIVE LOAD	L/180
EXTERIOR WALLS WITH SIDING WIND) LOAD

L/180 EXTERIOR WALLS WITH MASONRY VENEER WIND L/600 LOAD

5. SNOW LOAD (ASCE 7-05) GROUND SNOW LOAD (Pg) 30 PSF EXPOSURE FACTOR (Ce) 1.0 THERMAL FACTOR (Ct) 1.1

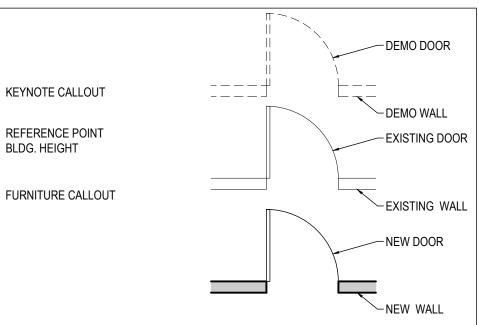

PAINT COLOR SELECTIONS:

P-1 P-2 _____

P-3 _____ P-4 _____

*****ALL COLORS TO BE APPROVED BY ARCHITECT

PENN PARK SHELTER RENOVATION & CONCESSION/RESTROOM BLDG 2101 FISHER STREET

MADISON, WI 53713

SQUARE FOOTAGES

BUILDING FOOTPRINT = 435SF CONCRETE APRON AREA = 2239SF ROOF AREA = 1387SF

GENERAL NOTES:

- FIELD VERIFY ALL DIMENSIONS, CONSULT ARCHITECT W/ INCONSISTENCIES.
- CONTRACTOR TO COMPLY WITH ALL APPLICABLE BUILDING CODES.
- ALL SHOP DRAWING TO BE APPROVED BY ARCHITECT

CODE SUMMARY:

PROJECT DESCRIPTION: PARK SHELTER W/ TOILET ROOMS CONSTRUCTION TYPE: 5B HEIGHT: ONE STORY

SNOW LOAD IMPORTANCE FACTOR (Is) FLAT ROOF SNOW LOAD (Pf) 30.2 PSF


7. WIND LOADS (ASCE 7-05" BASIC WIND SPEED (3-SEC GUST) DIRECTIONALITY (Kd) WIND IMPORTANCE FACTOR (Iw) WIND EXPOSURE CATEGORY TOPOGRAPHIC FACTOR (Kzt) ENCLOSURE CLASSIFICATION INTERNAL PRESSURE COEFFICIENT (GCpi) BASE VELOCITY PRESSURE (Qh) 18.2 PSF


90 MPH 0.85 1.00 D 1.0 ENCLOSED


1.0


+/- 0.18


Sheet List Table					
Sheet Number	Sheet Title				
T000	Title Sheet				
C000	Site Plan				
Concession/Restroom Plans					
S100	Foundation & Framing Plans				
S101	Concrete Slab Plan				
A100	Floorplan & Window Elevations				
A101	Clearstory, Reflected Ceiling & Roof Plan				
A300	Exterior Elevations				
A301	Exterior Elevations				
A500	Building Sections				
A501	Building Sections				
Shelter Plan	18				
AD100-B	Demo Plan				
AD300-B	Demo Elevations				
A100-B	Floorplan				
A300-B	Exterior Elevations				
A301-B	Exterior Elevations				
A500-B	Exterior Details & Plan Enlargements				

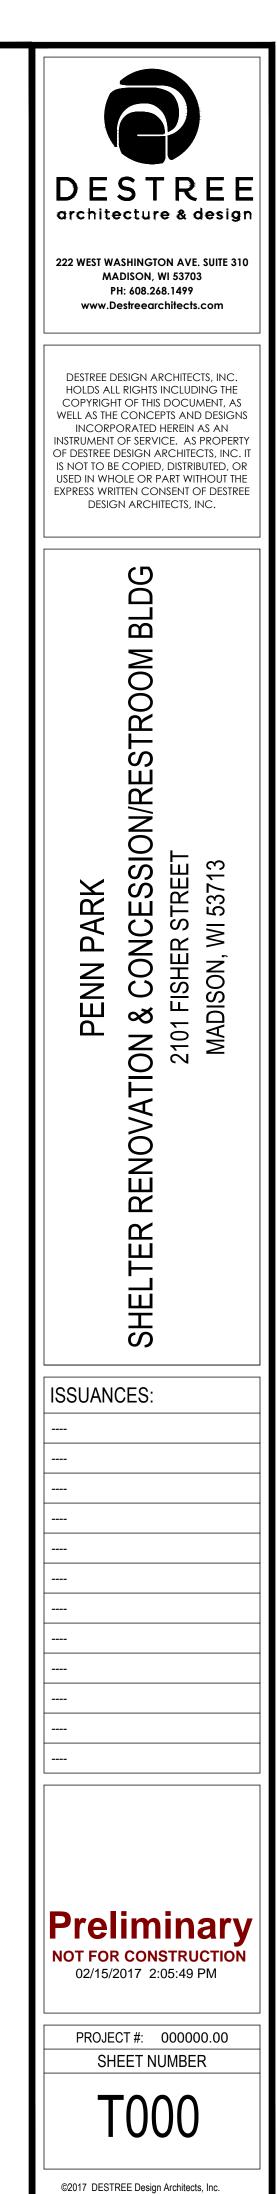

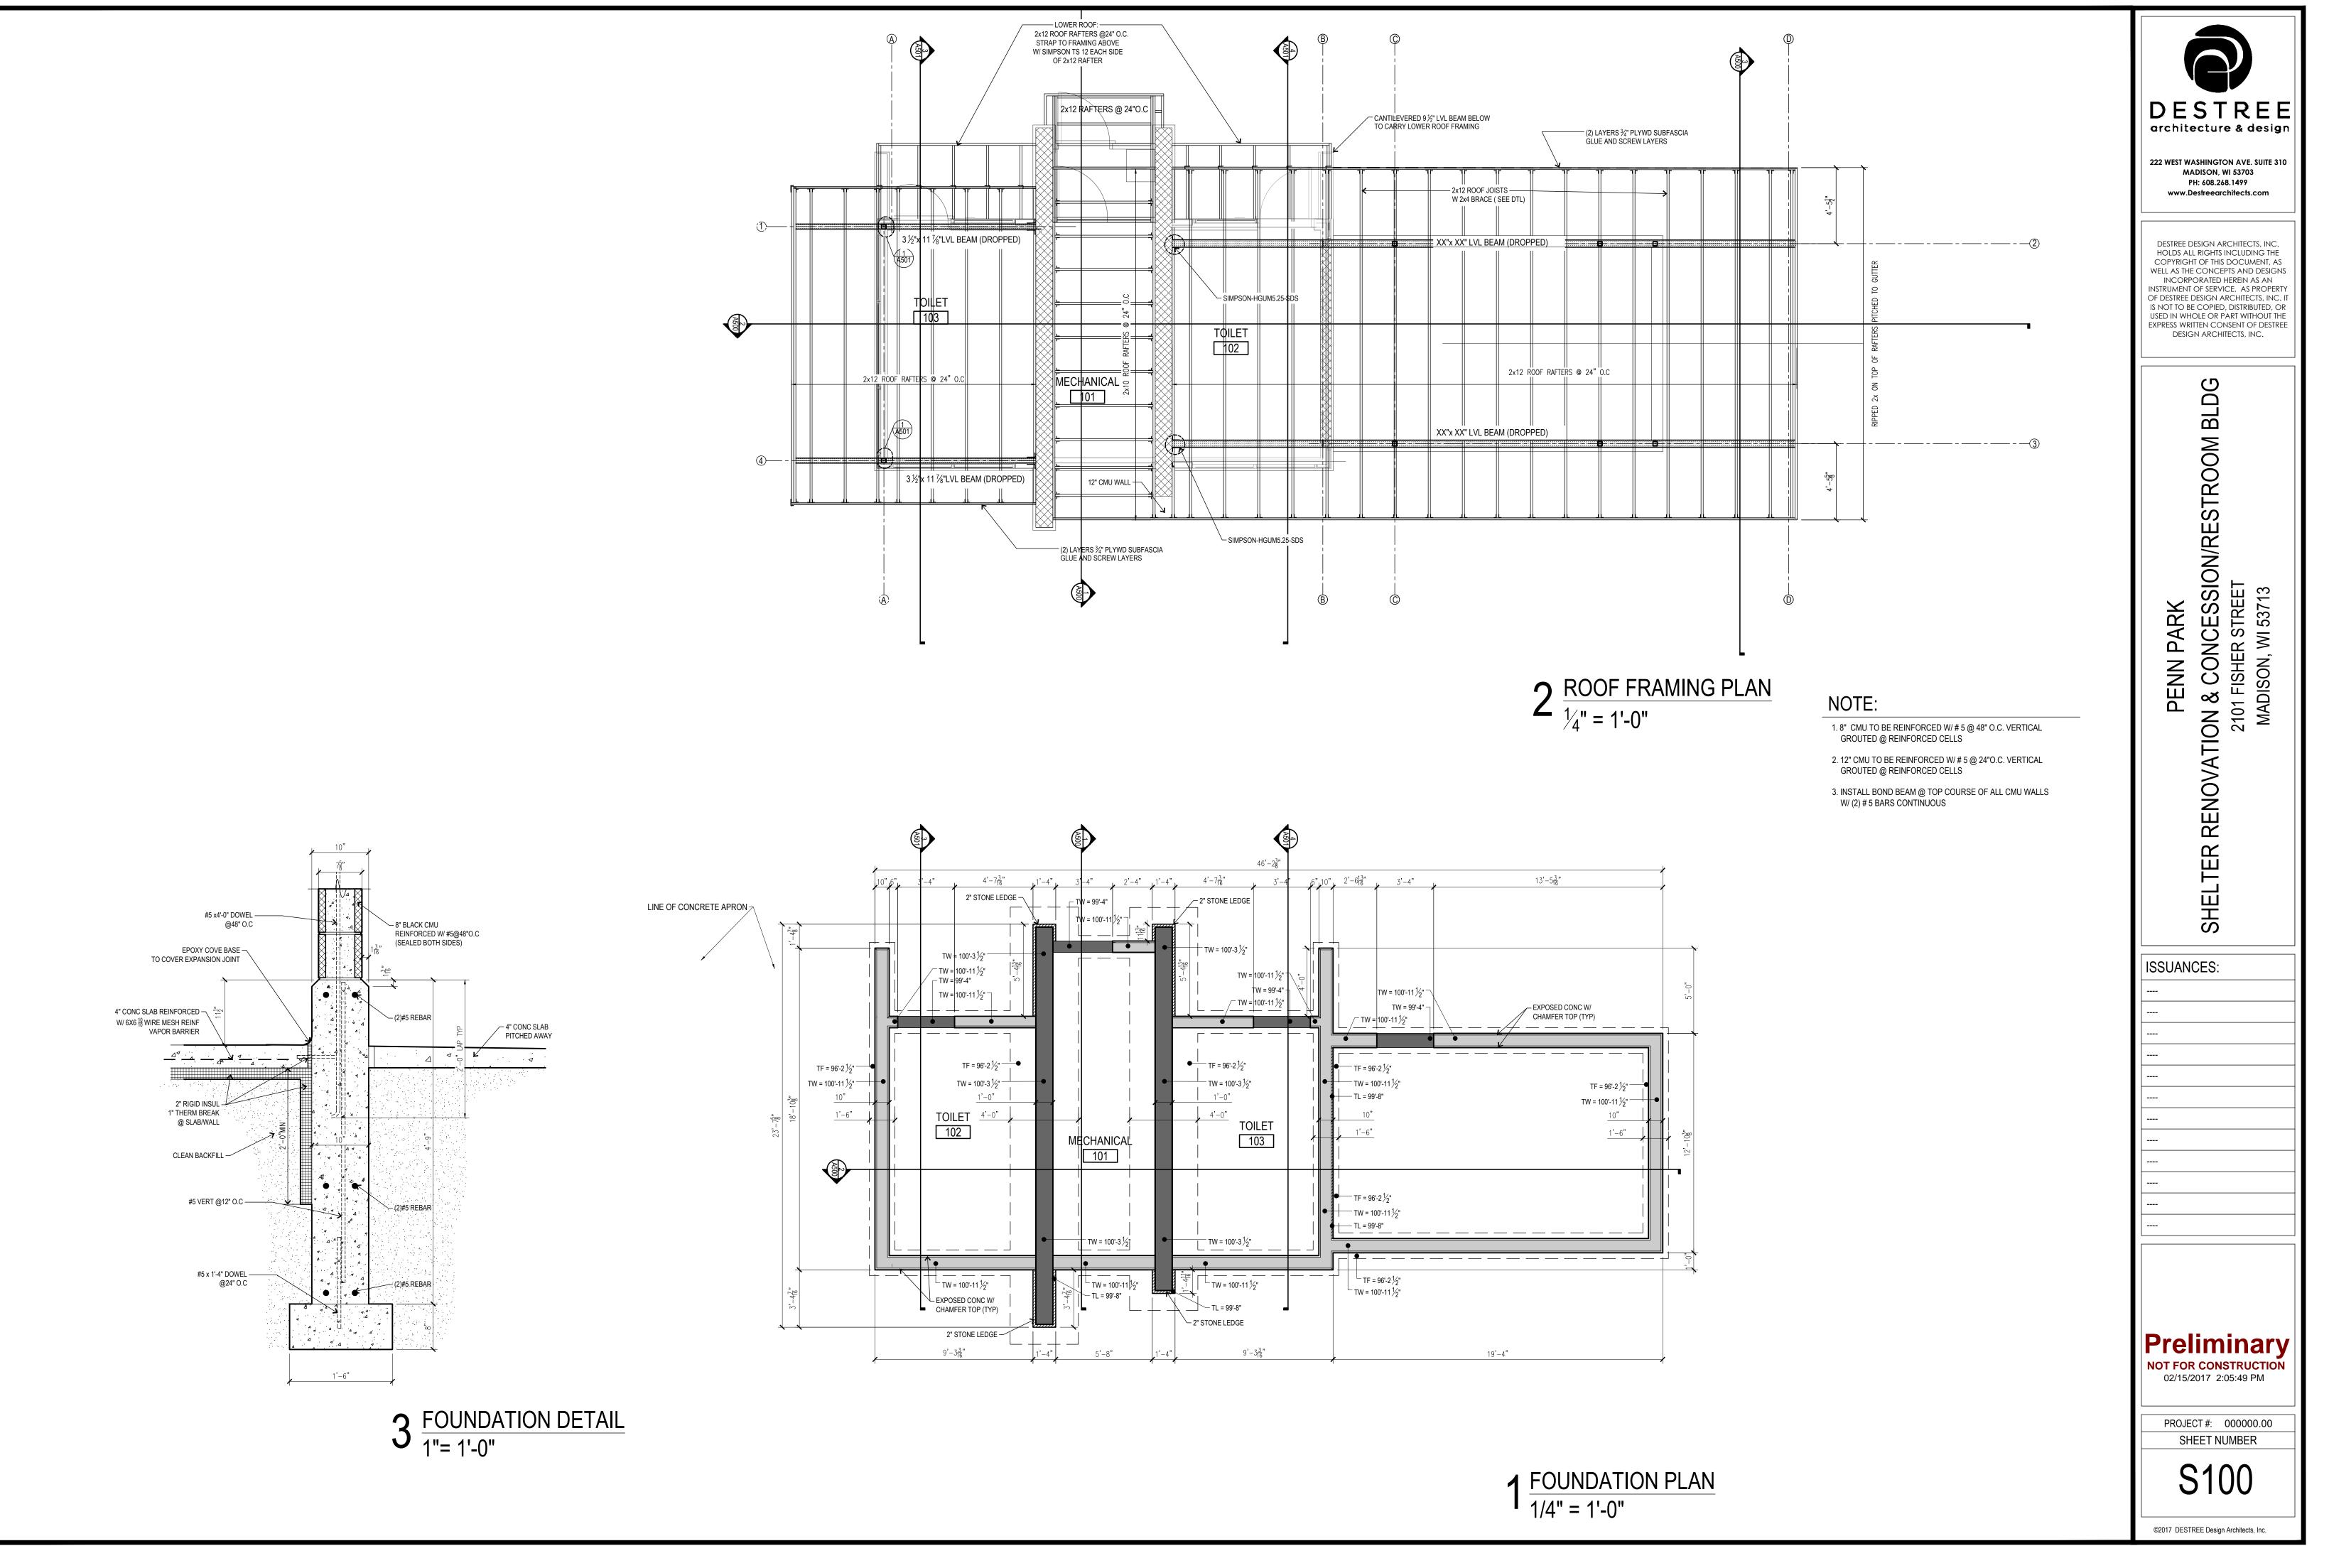

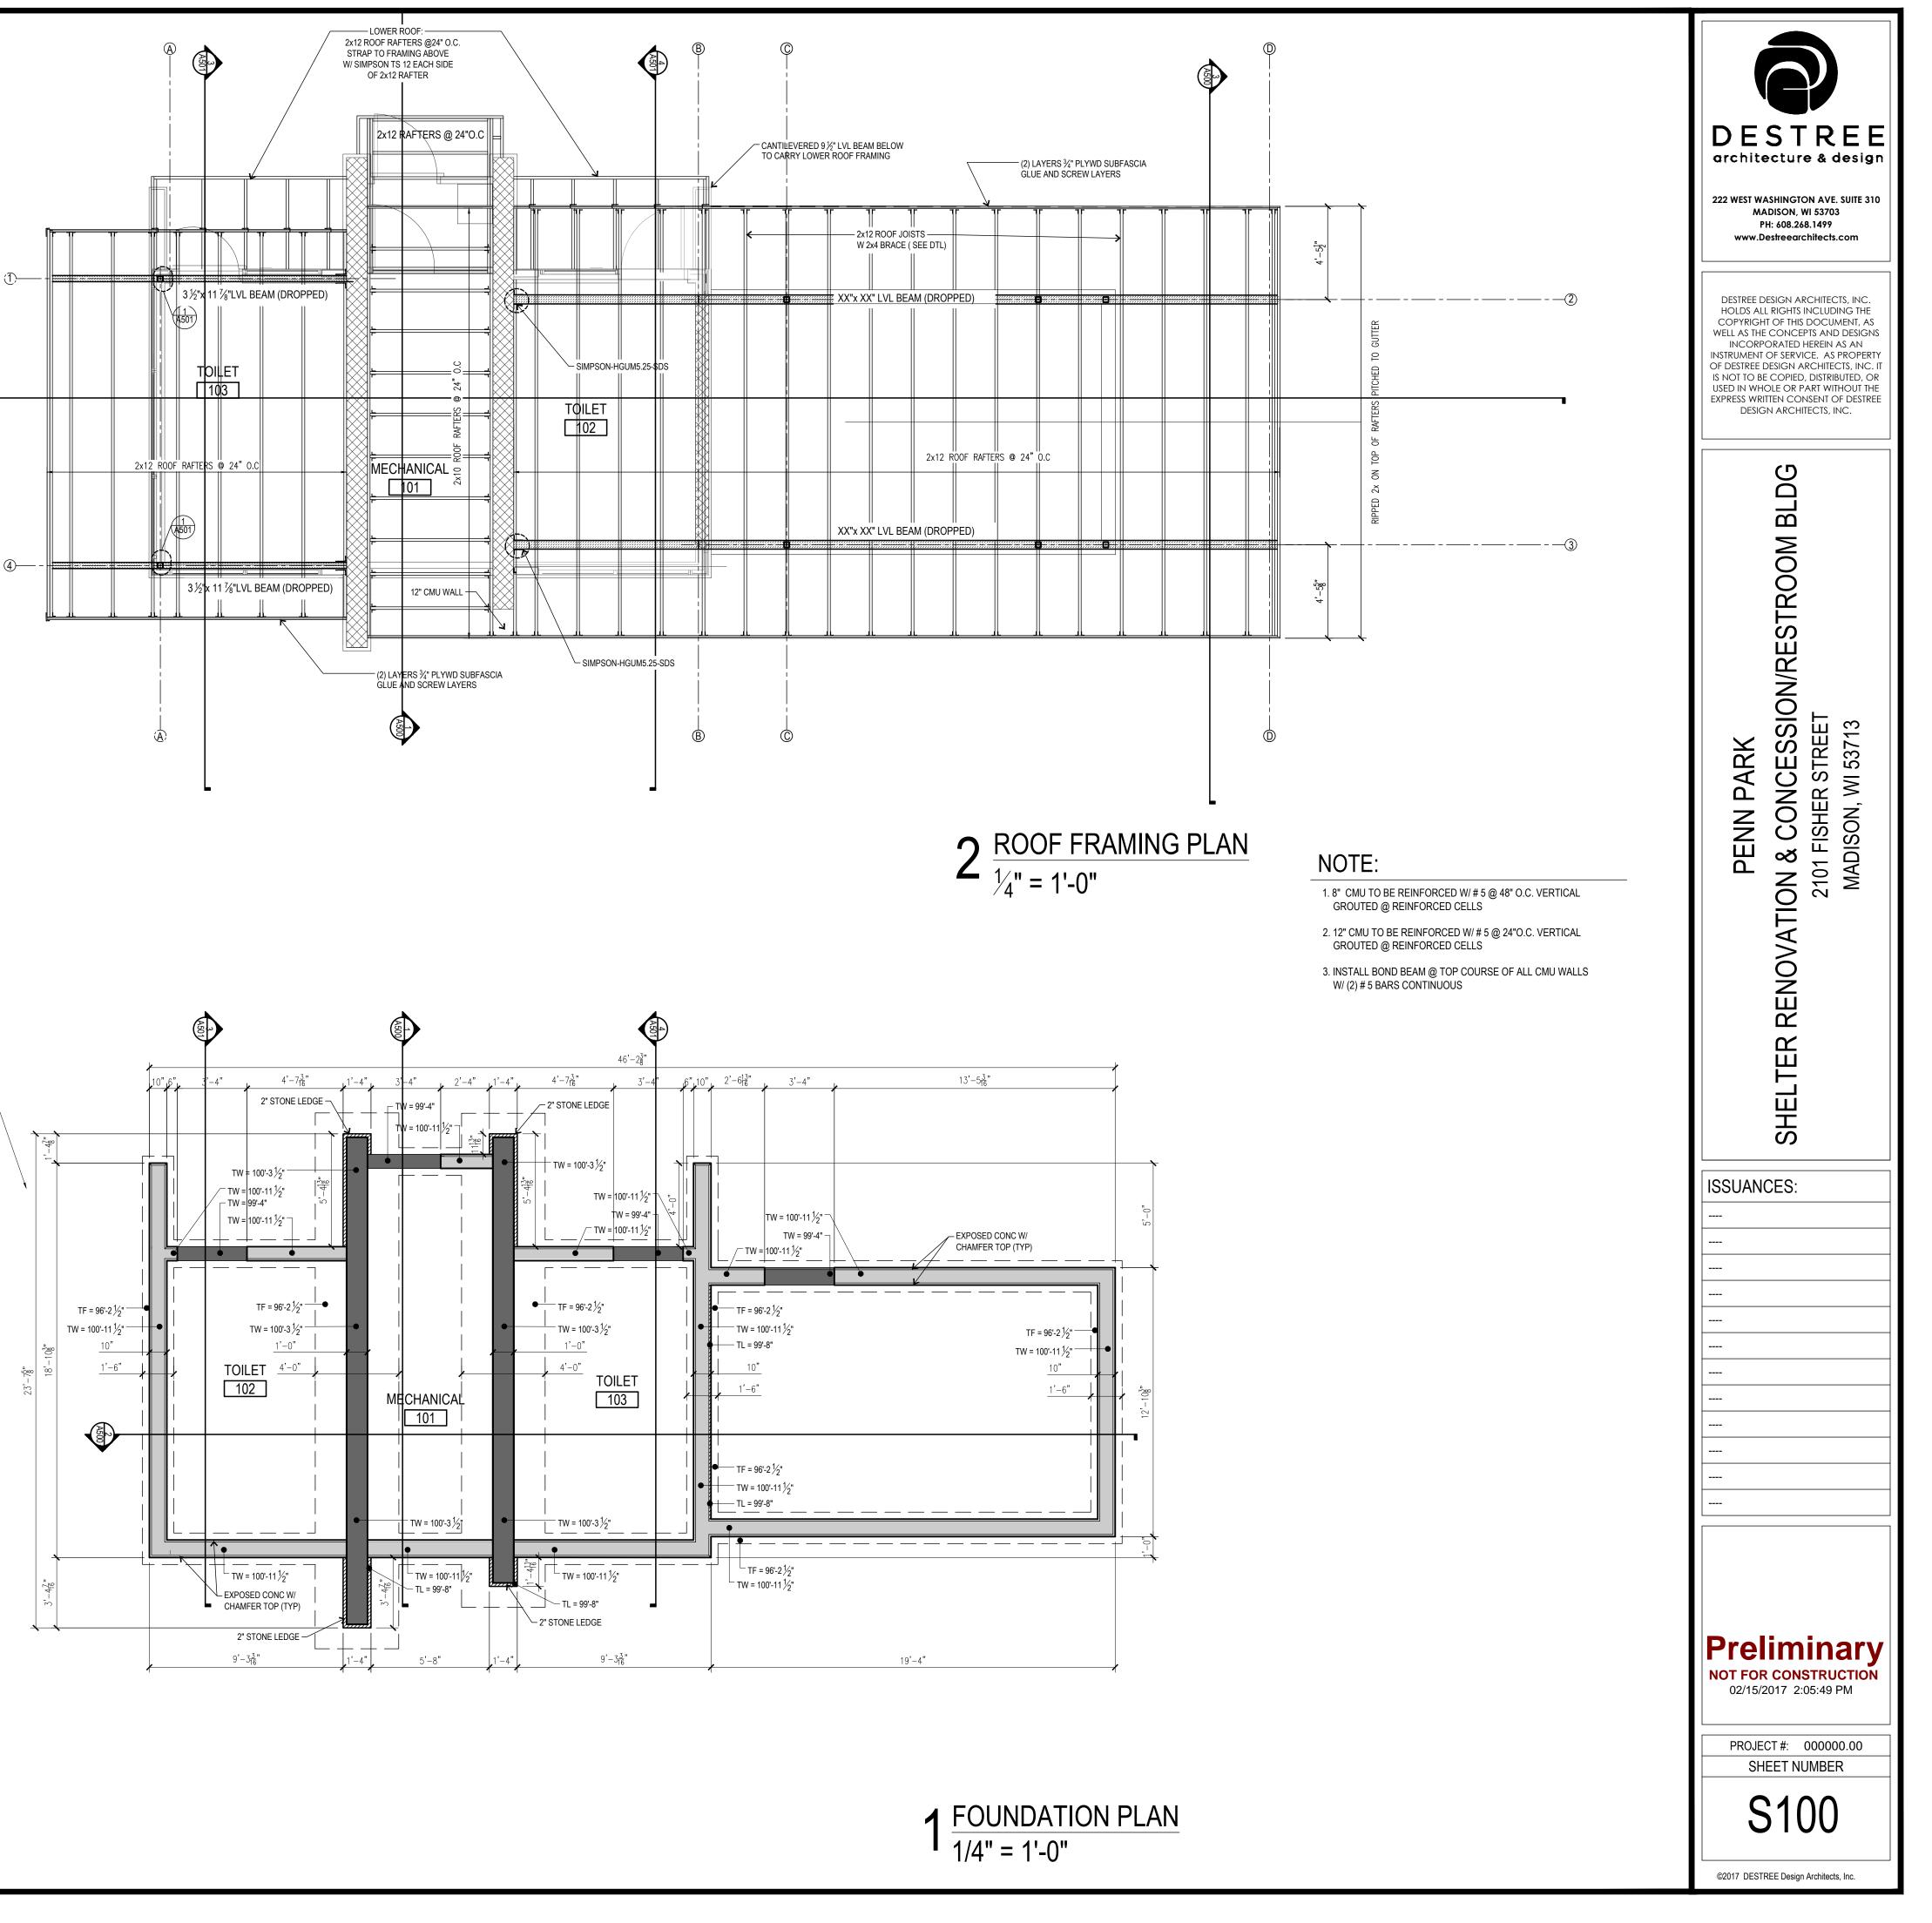

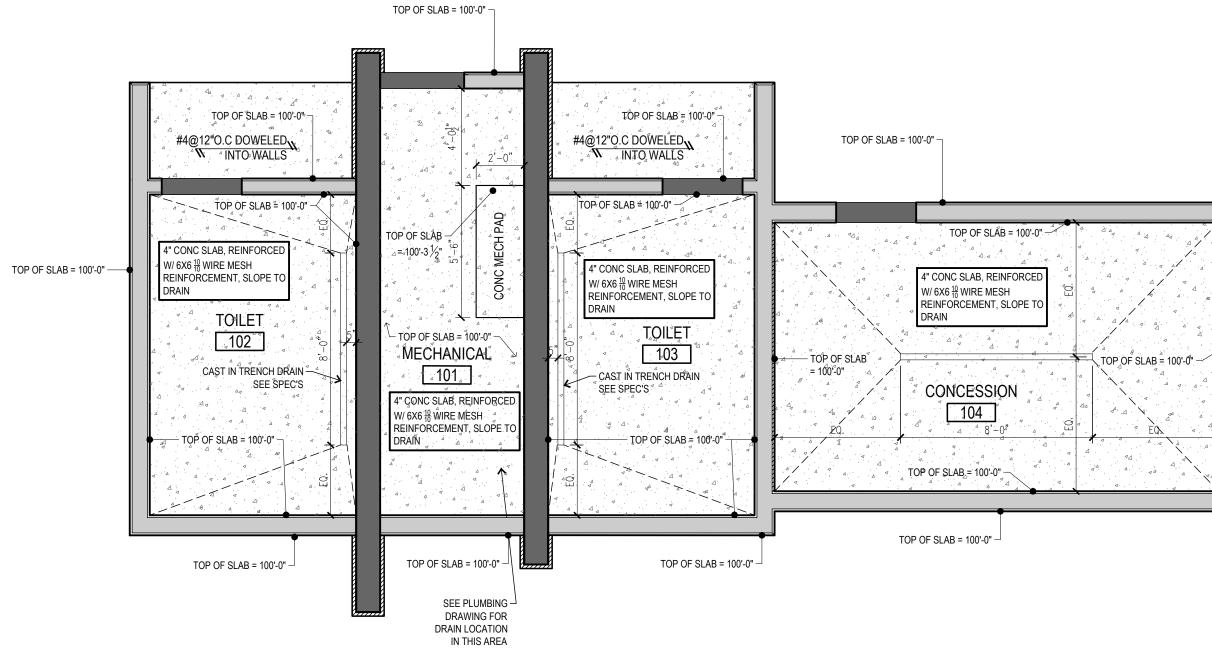

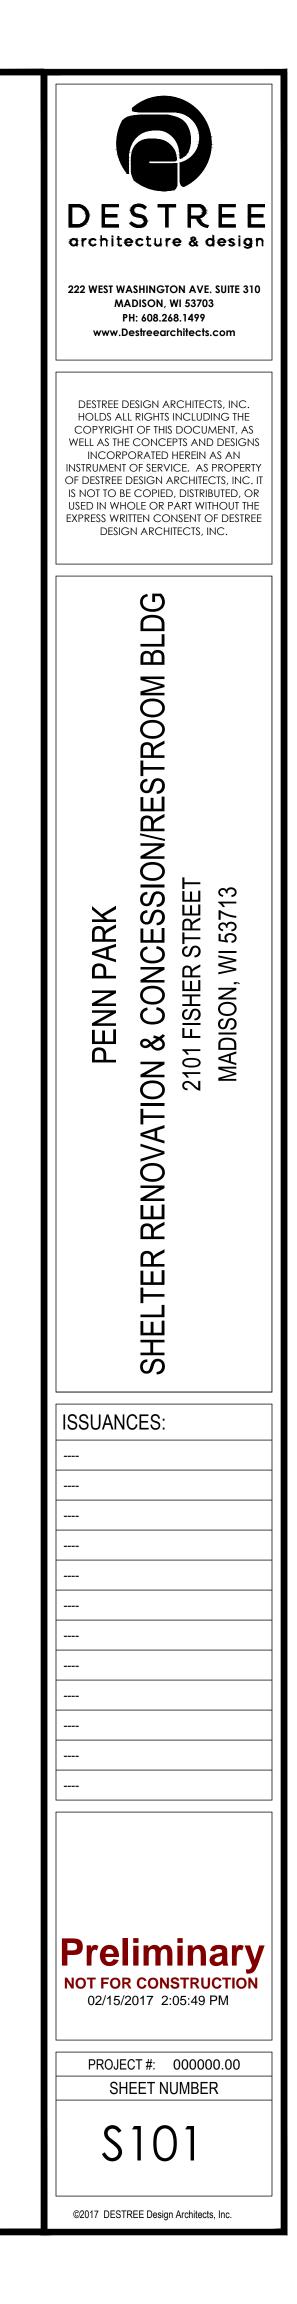


4" CONC SLAB W/ 6X6 $\frac{10}{10}$ WIRE MESH REINFORCEMENT THICKENED EDGE @ PERIMETER PICTURE FRAME / BROOM FINISH


 $\frac{1}{1/4"} = 1'-0"$






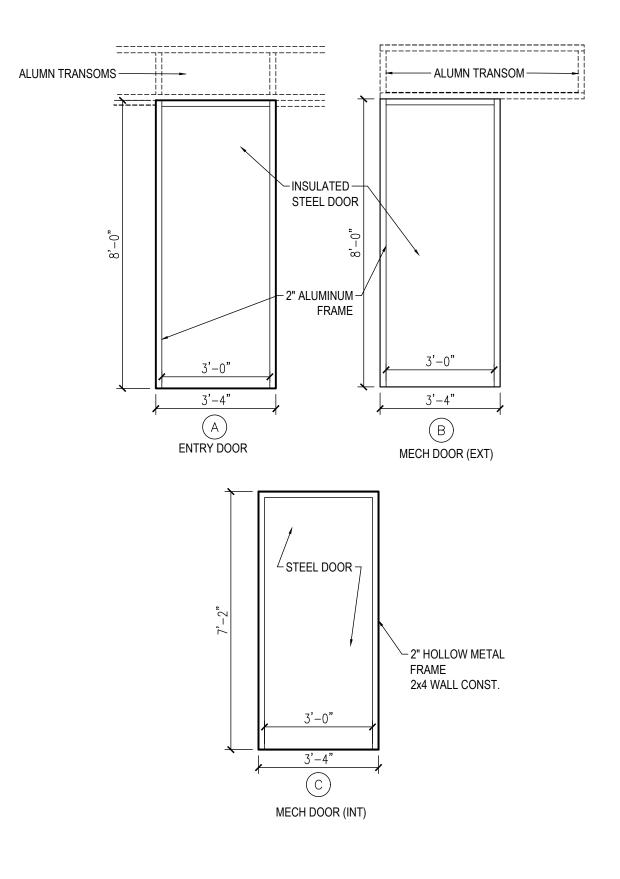




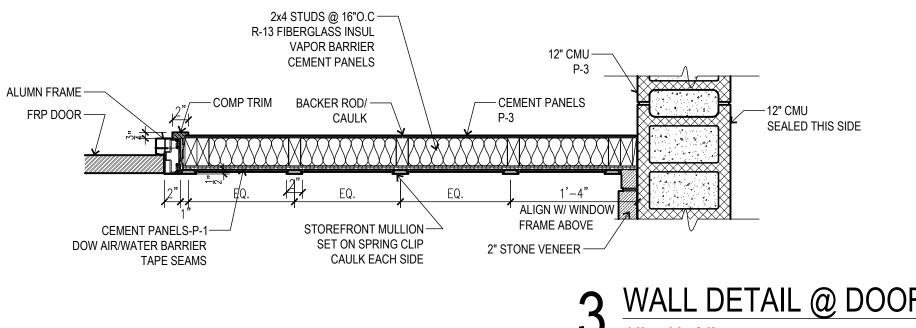


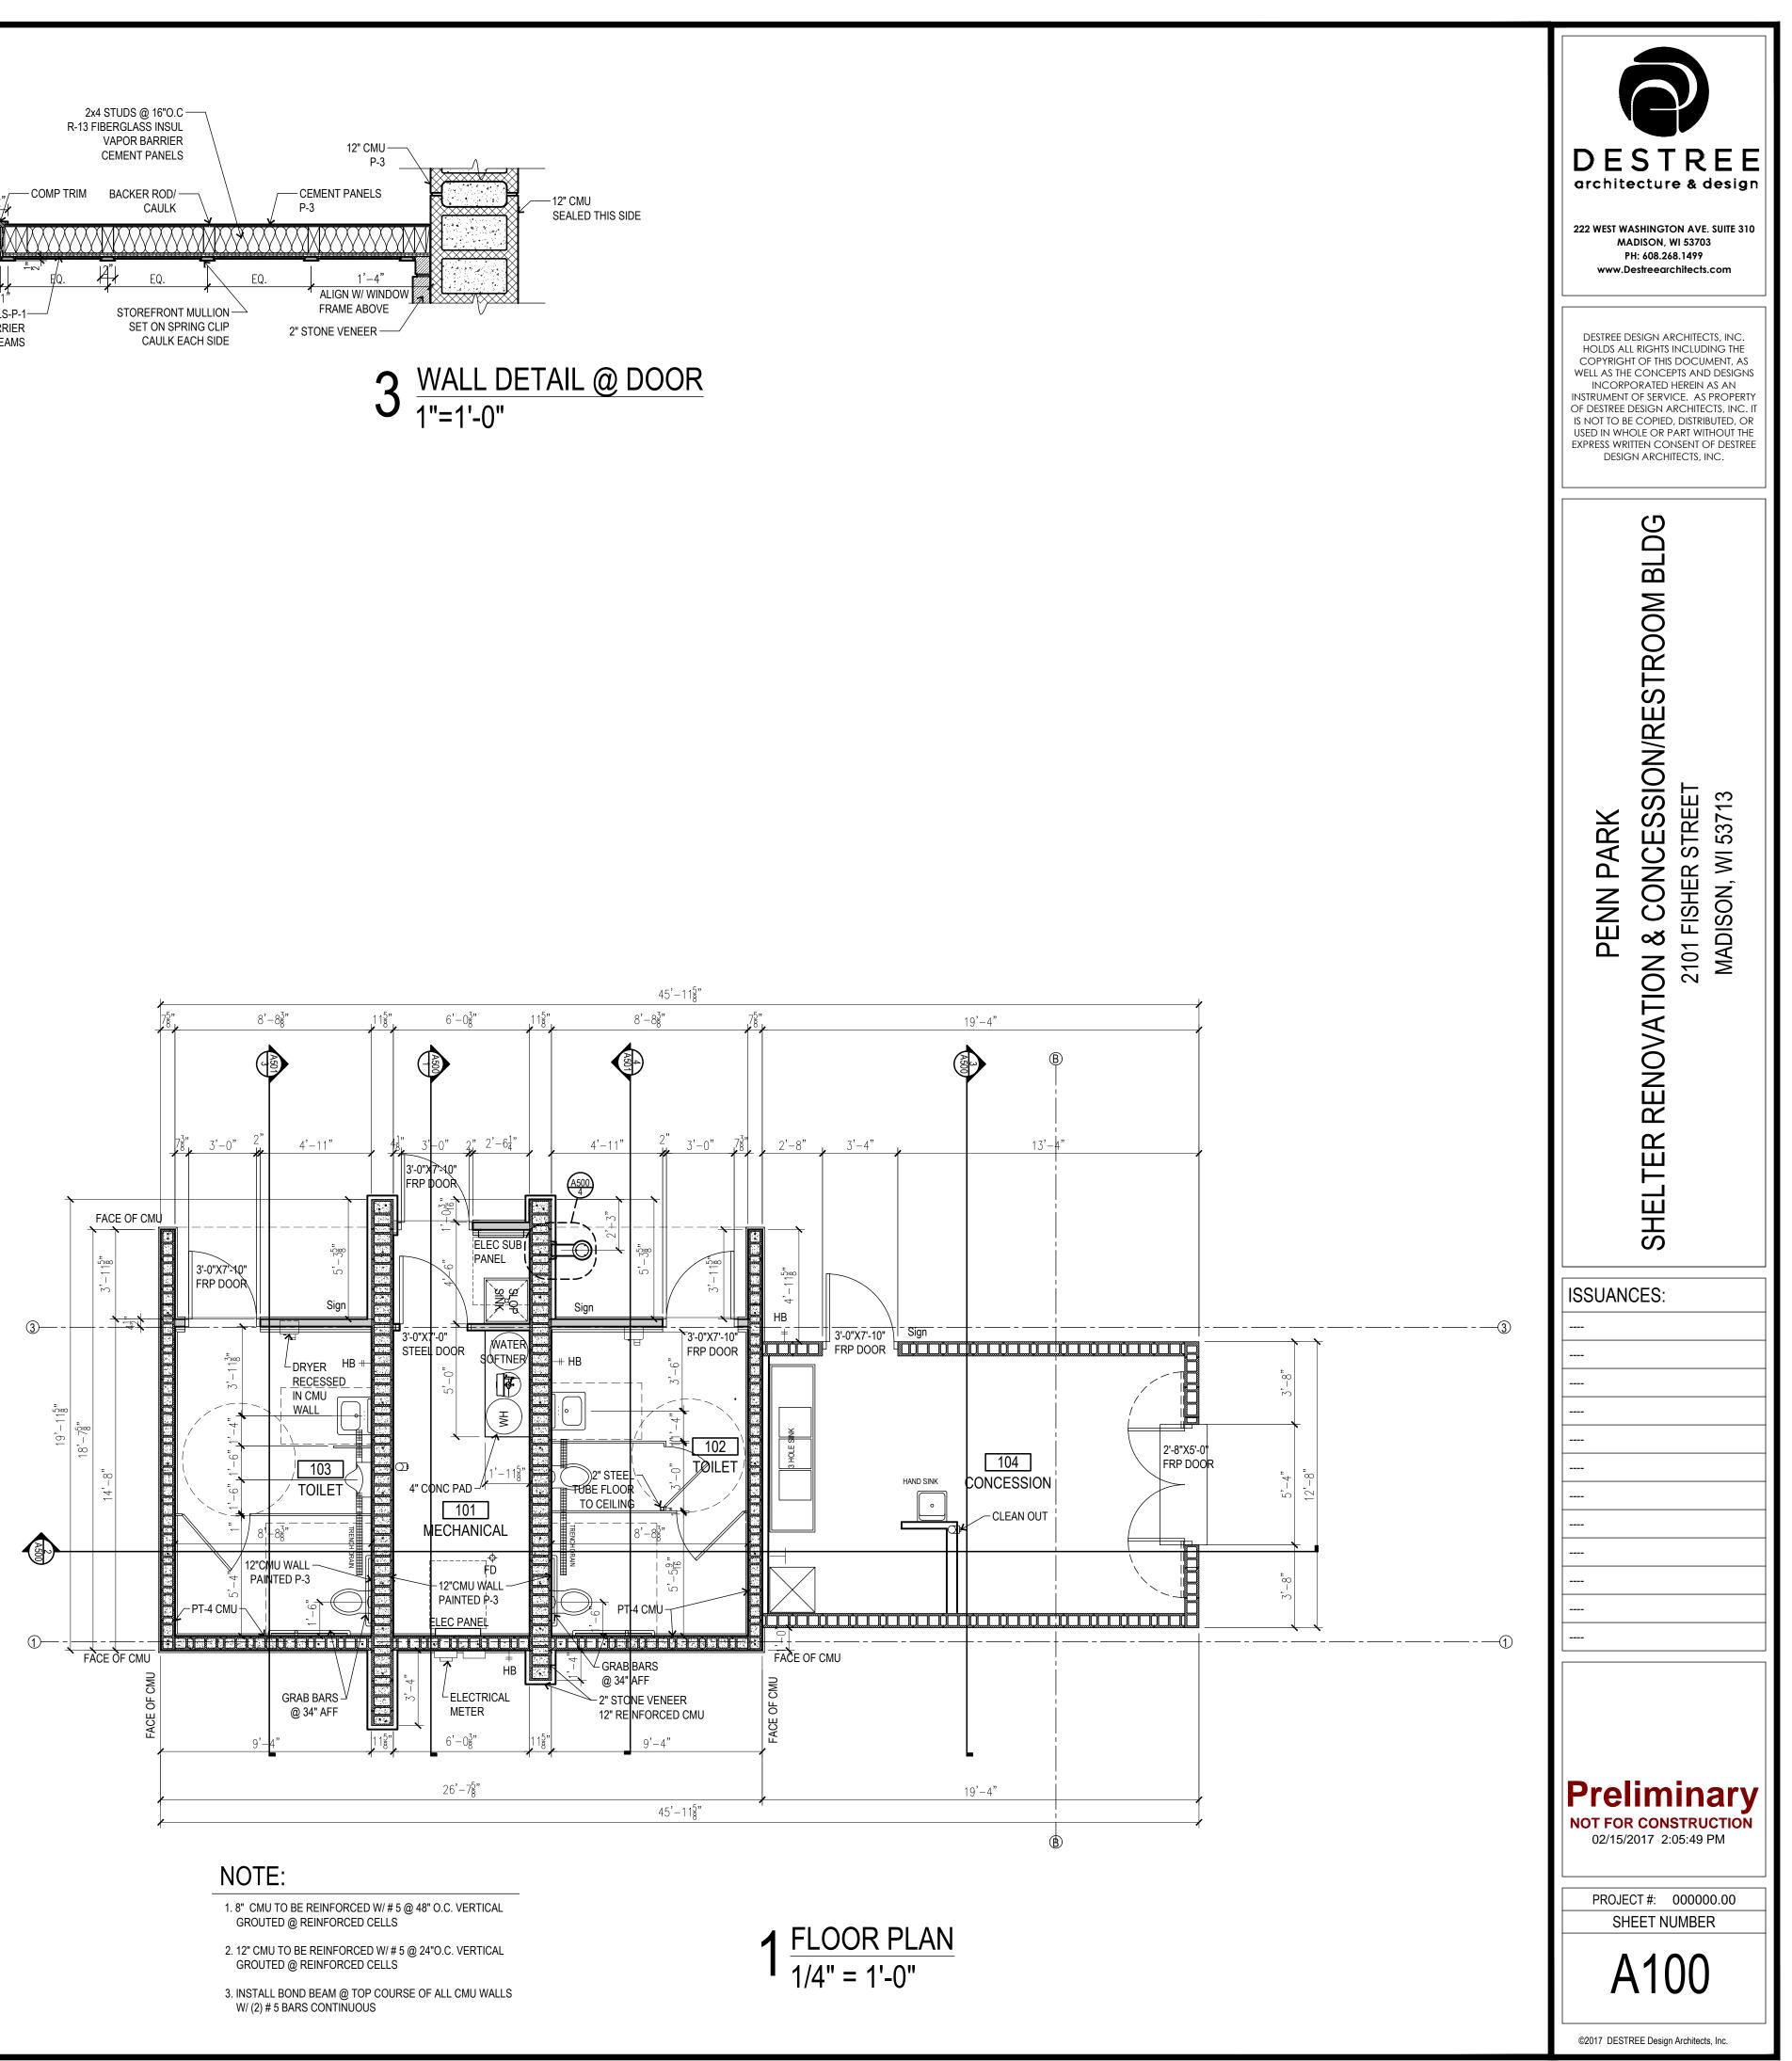




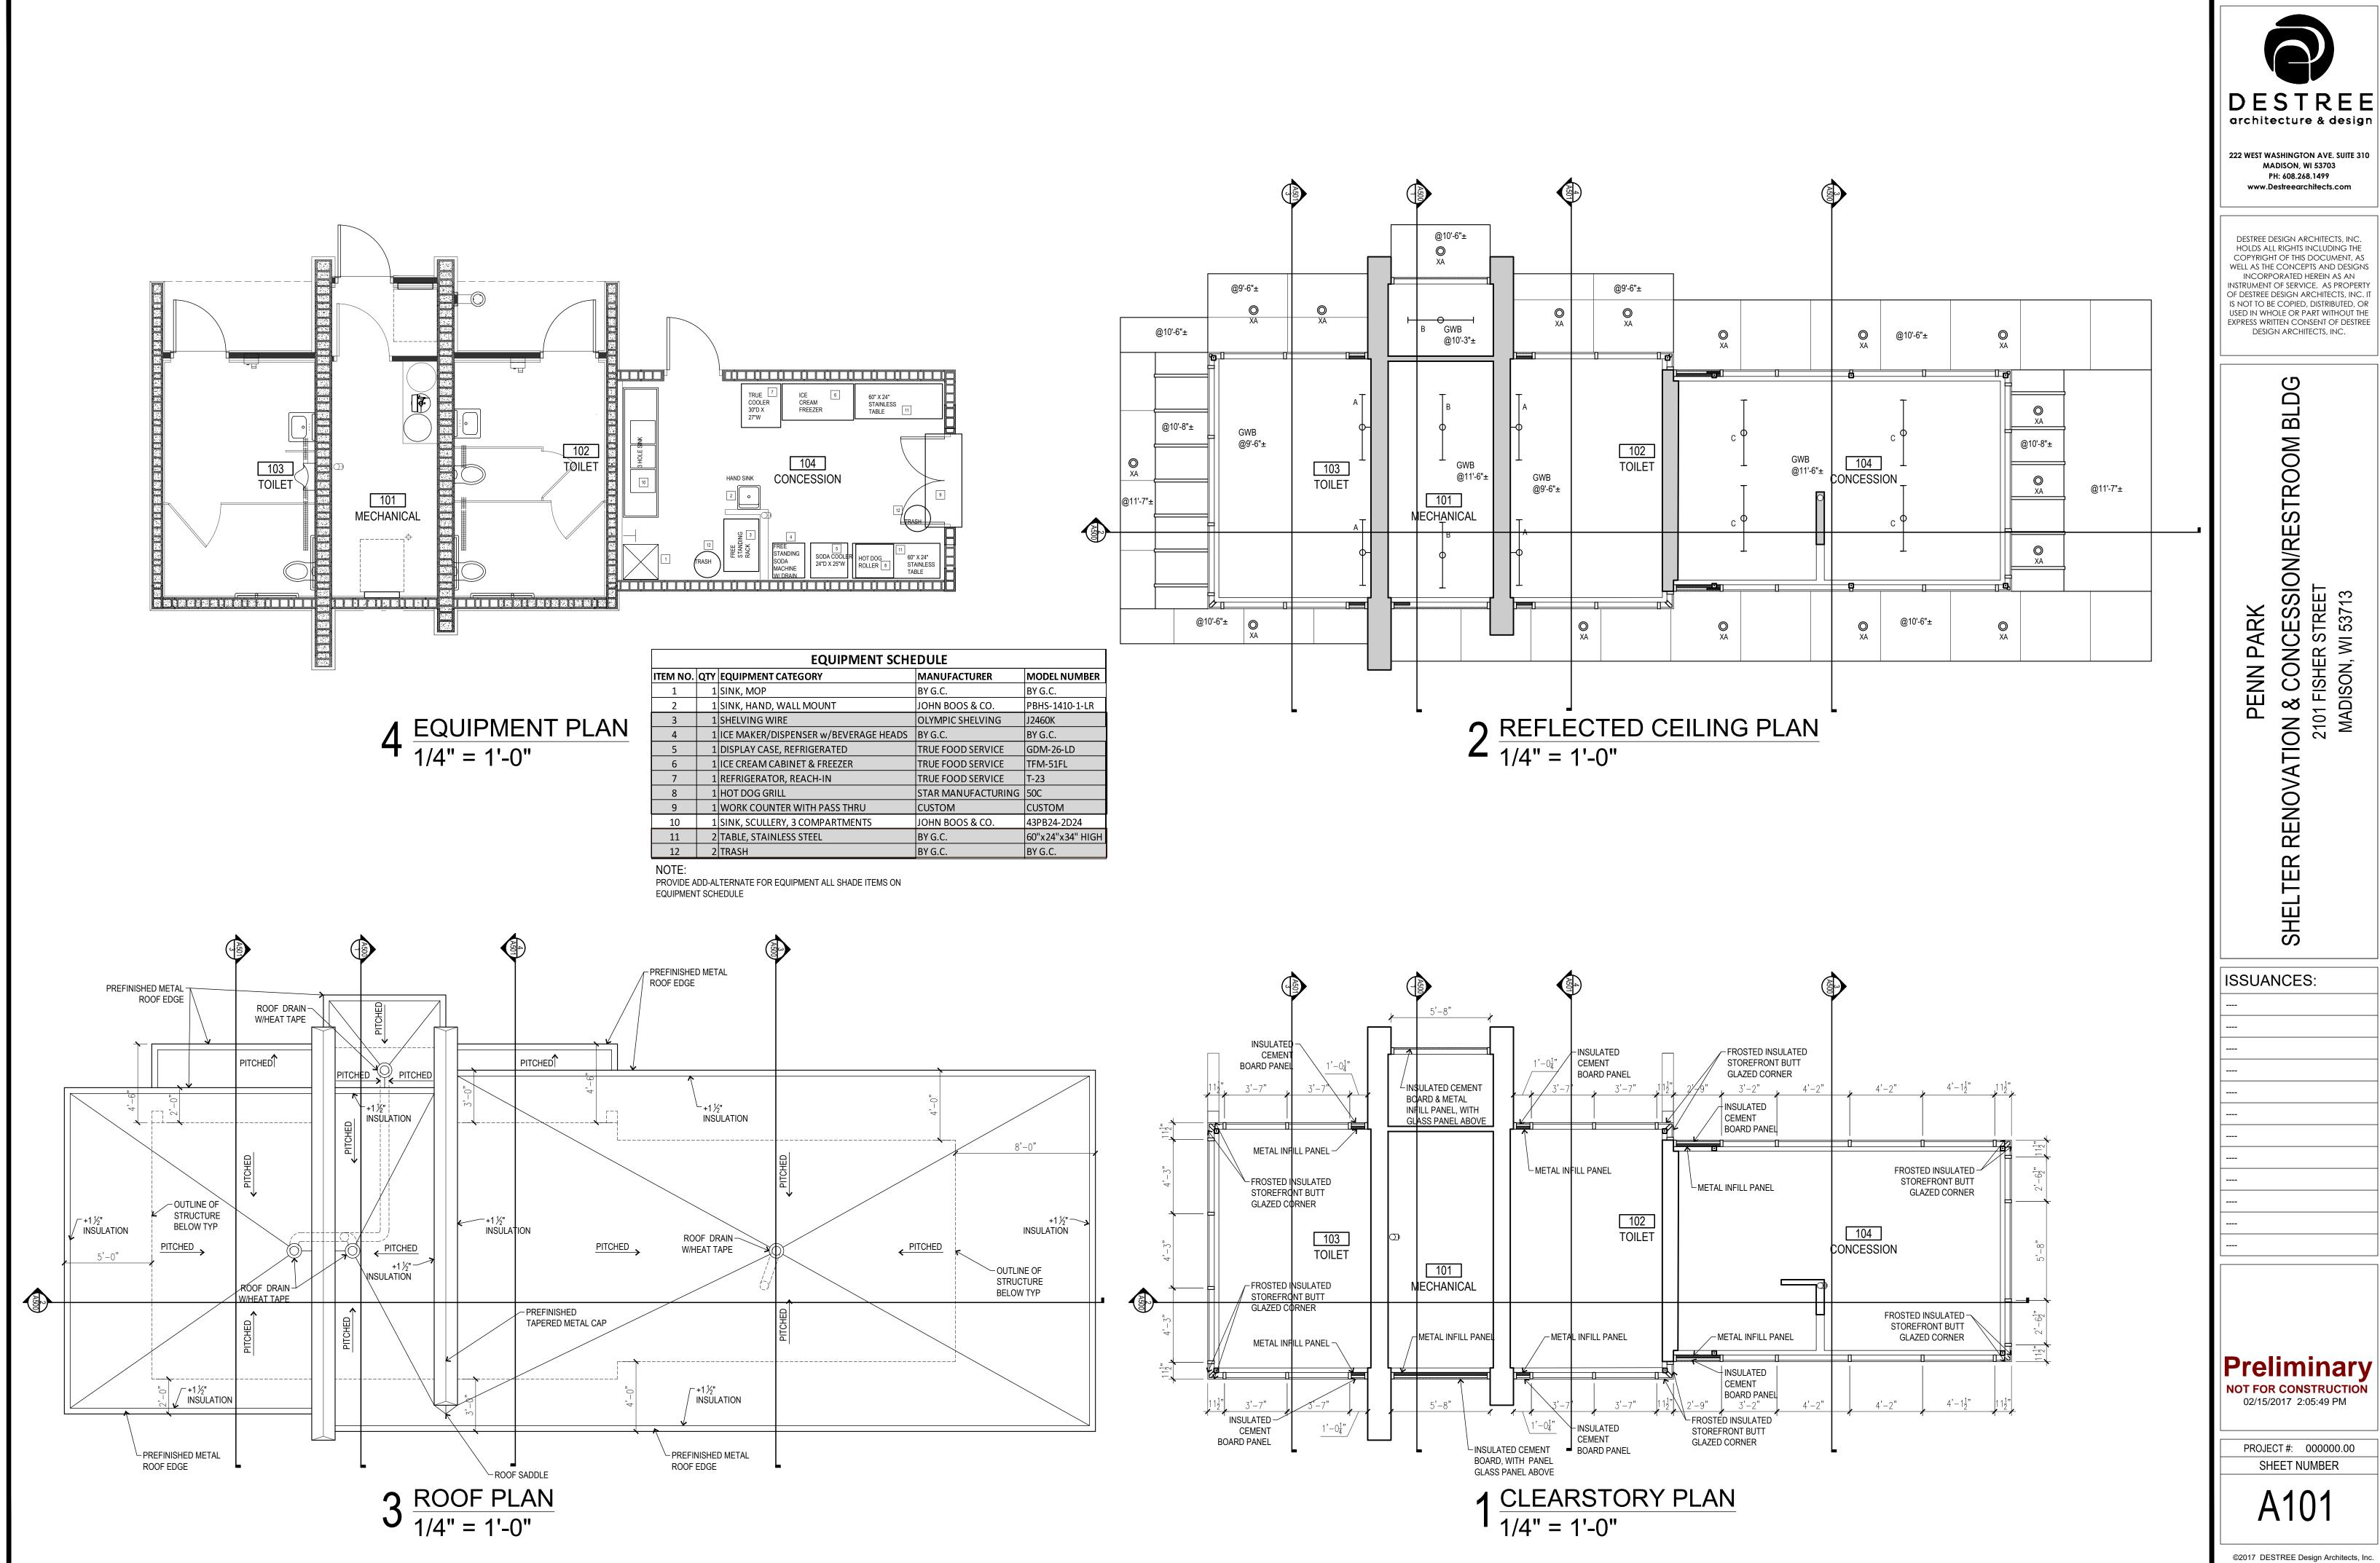



EQUIPMENT SCHEDULE					
MANUFACTURER	MODEL NUMBER				
BY G.C.	BY G.C.				
JOHN BOOS & CO.	PBHS-1410-1-LR				
OLYMPIC SHELVING	J2460K				
BY G.C.	BY G.C.				
TRUE FOOD SERVICE	GDM-26-LD				
TRUE FOOD SERVICE	TFM-51FL				
TRUE FOOD SERVICE	T-23				
STAR MANUFACTURING	50C				
CUSTOM	CUSTOM				
JOHN BOOS & CO.	43PB24-2D24				
BY G.C.	60"x24"x34" HIGH				
BY G.C.	BY G.C.				
	MANUFACTURER BY G.C. JOHN BOOS & CO. OLYMPIC SHELVING BY G.C. TRUE FOOD SERVICE TRUE FOOD SERVICE TRUE FOOD SERVICE STAR MANUFACTURING CUSTOM JOHN BOOS & CO. BY G.C.				

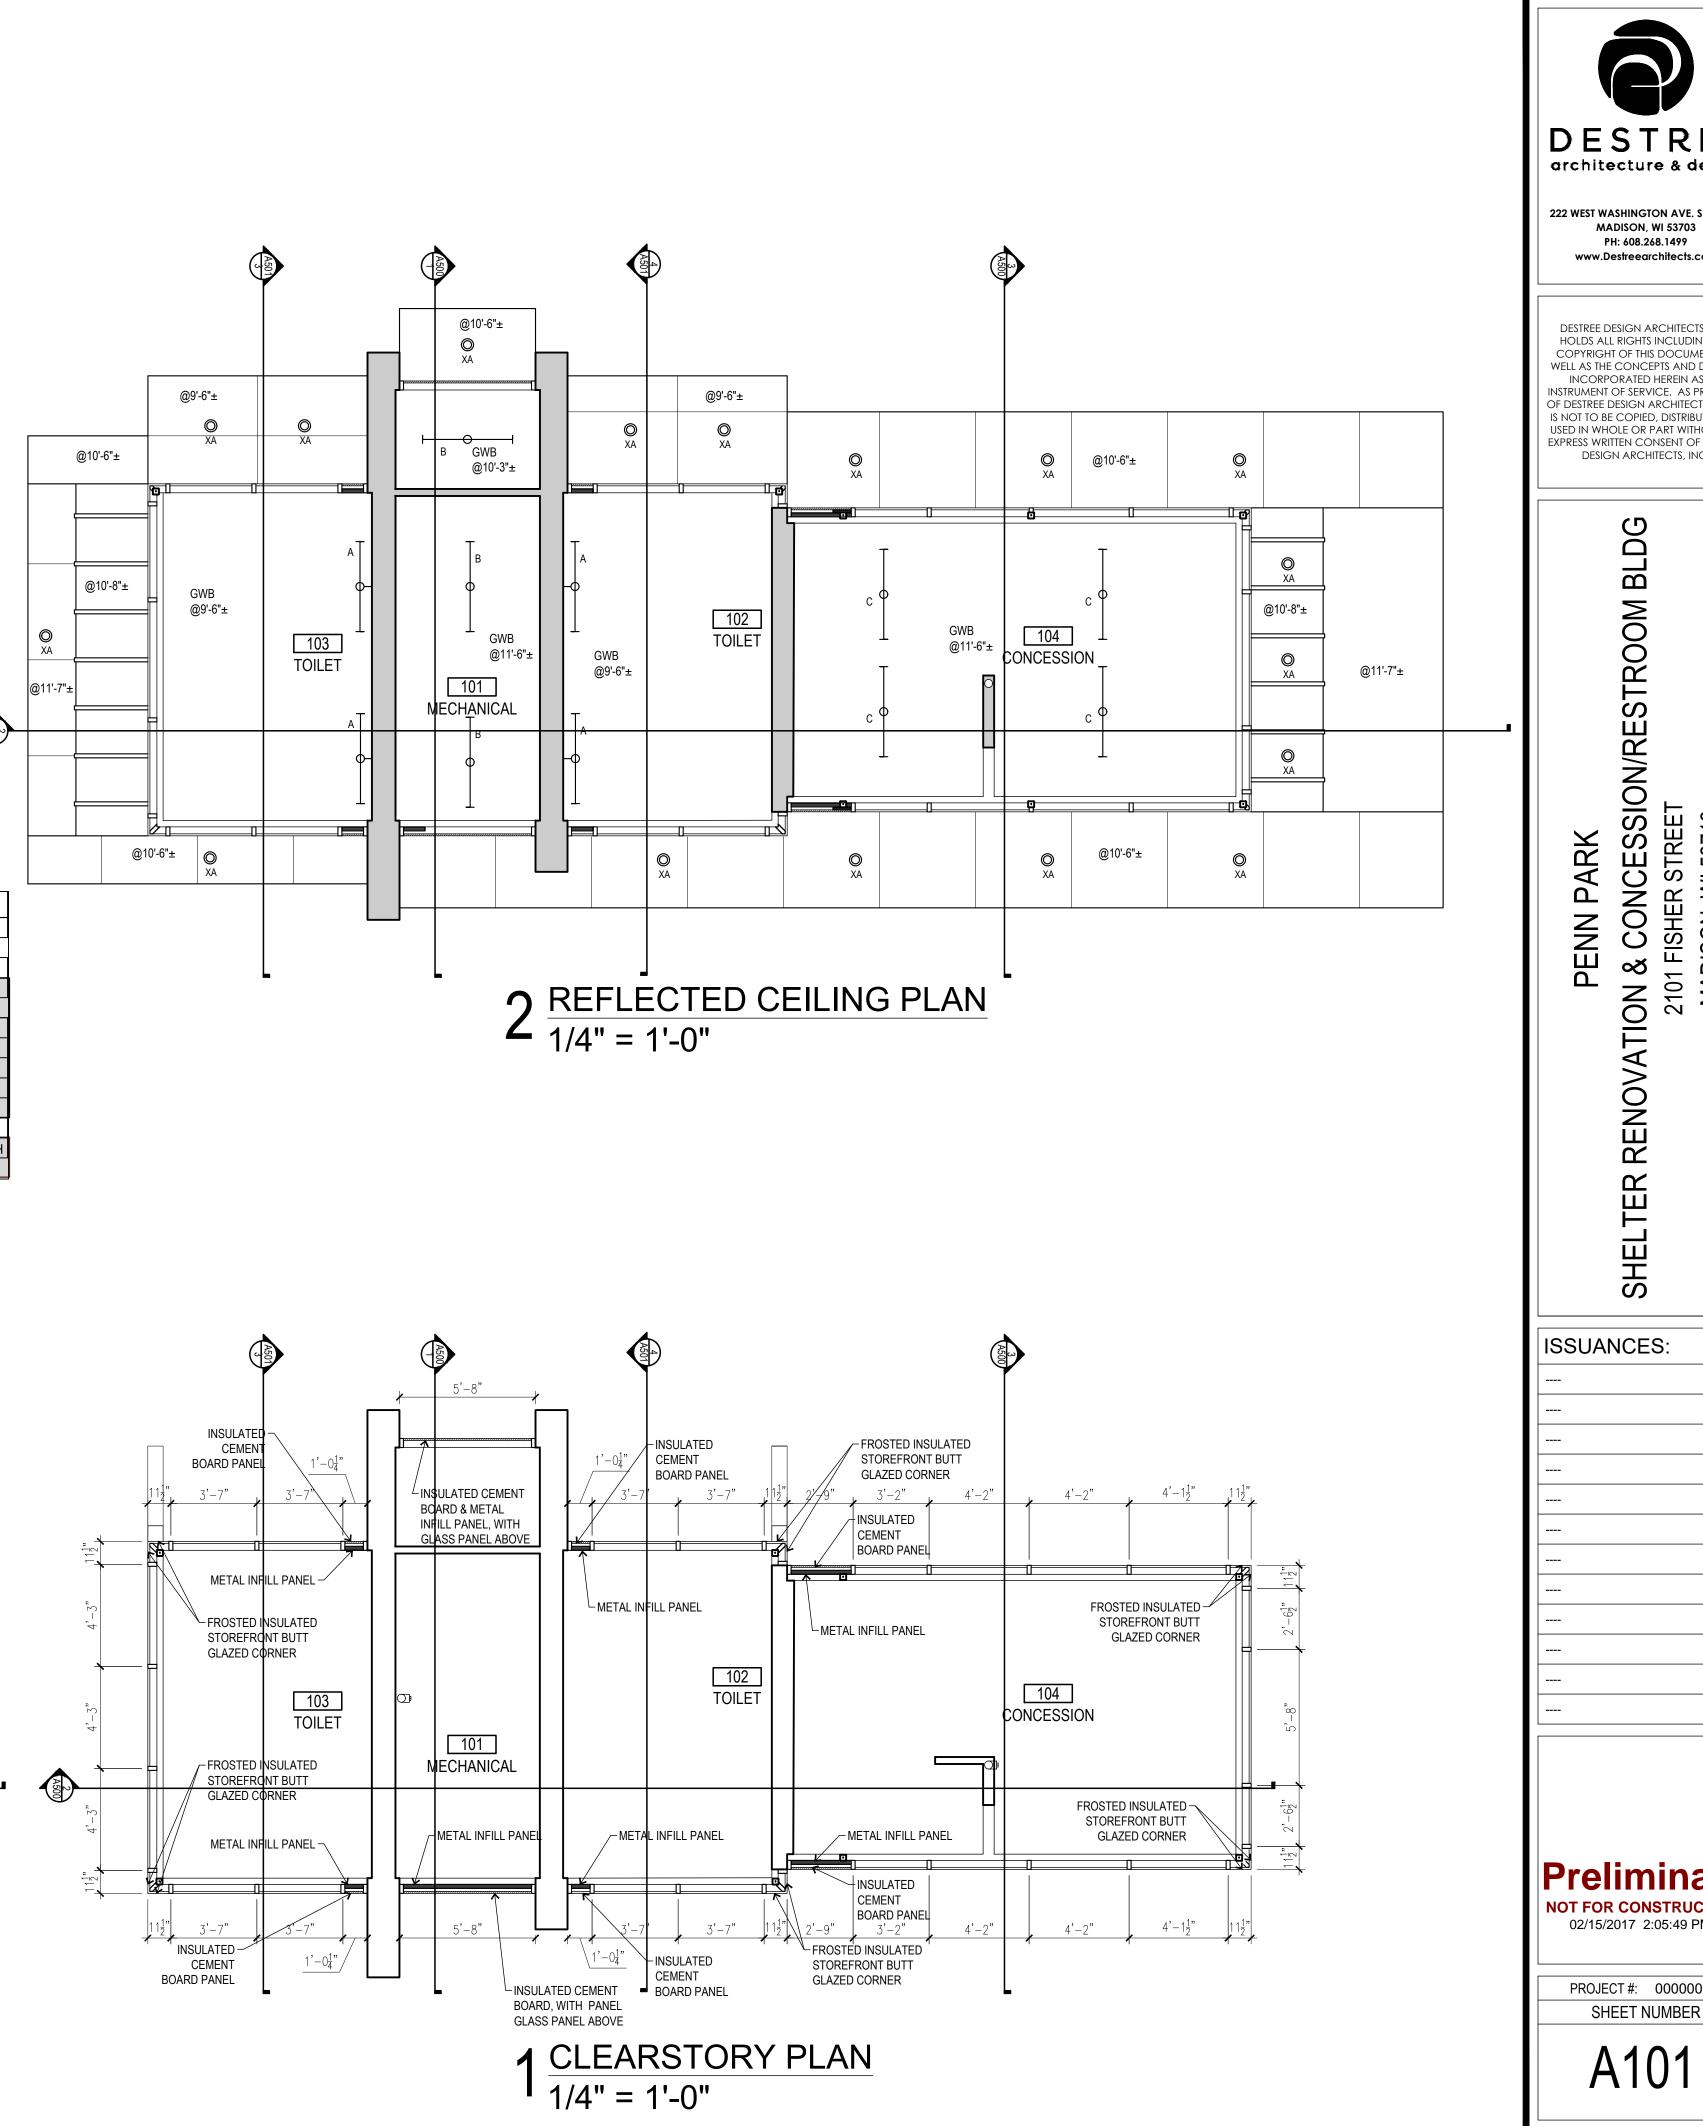

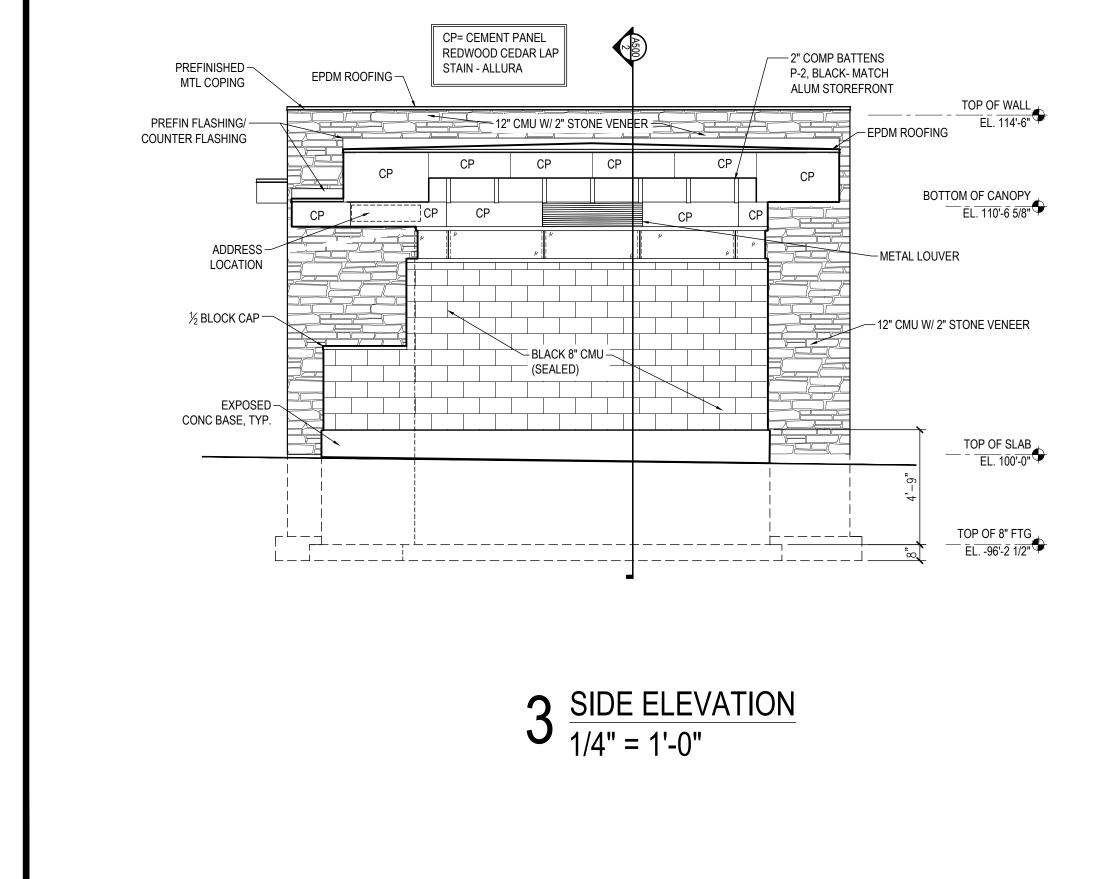



4 $\frac{\text{CONCESSION ELEVATION}}{1/4" = 1'-0"}$

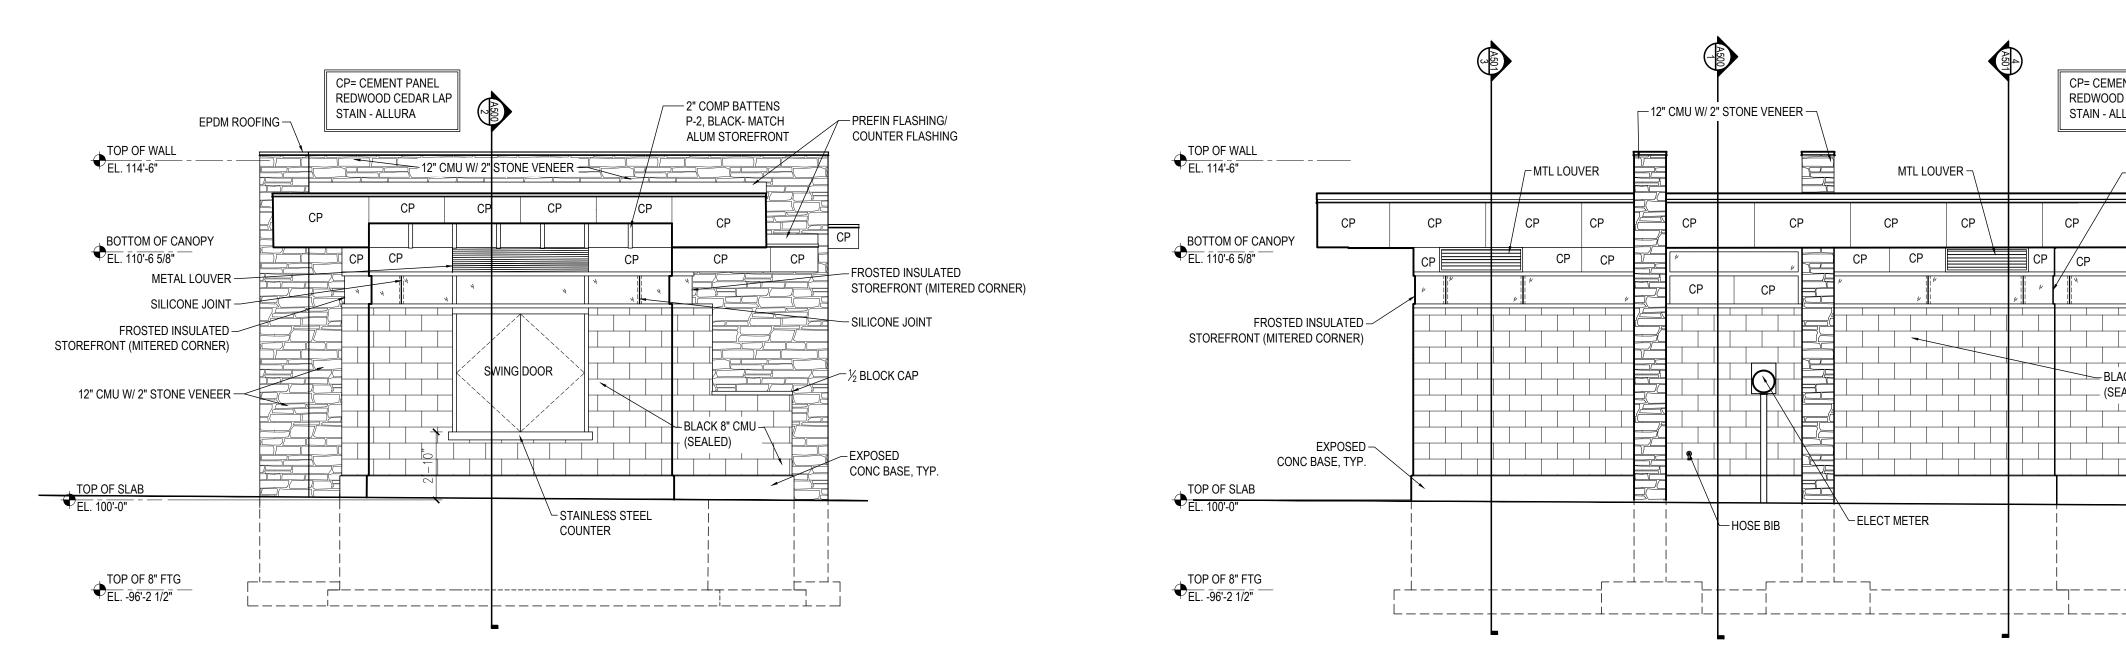


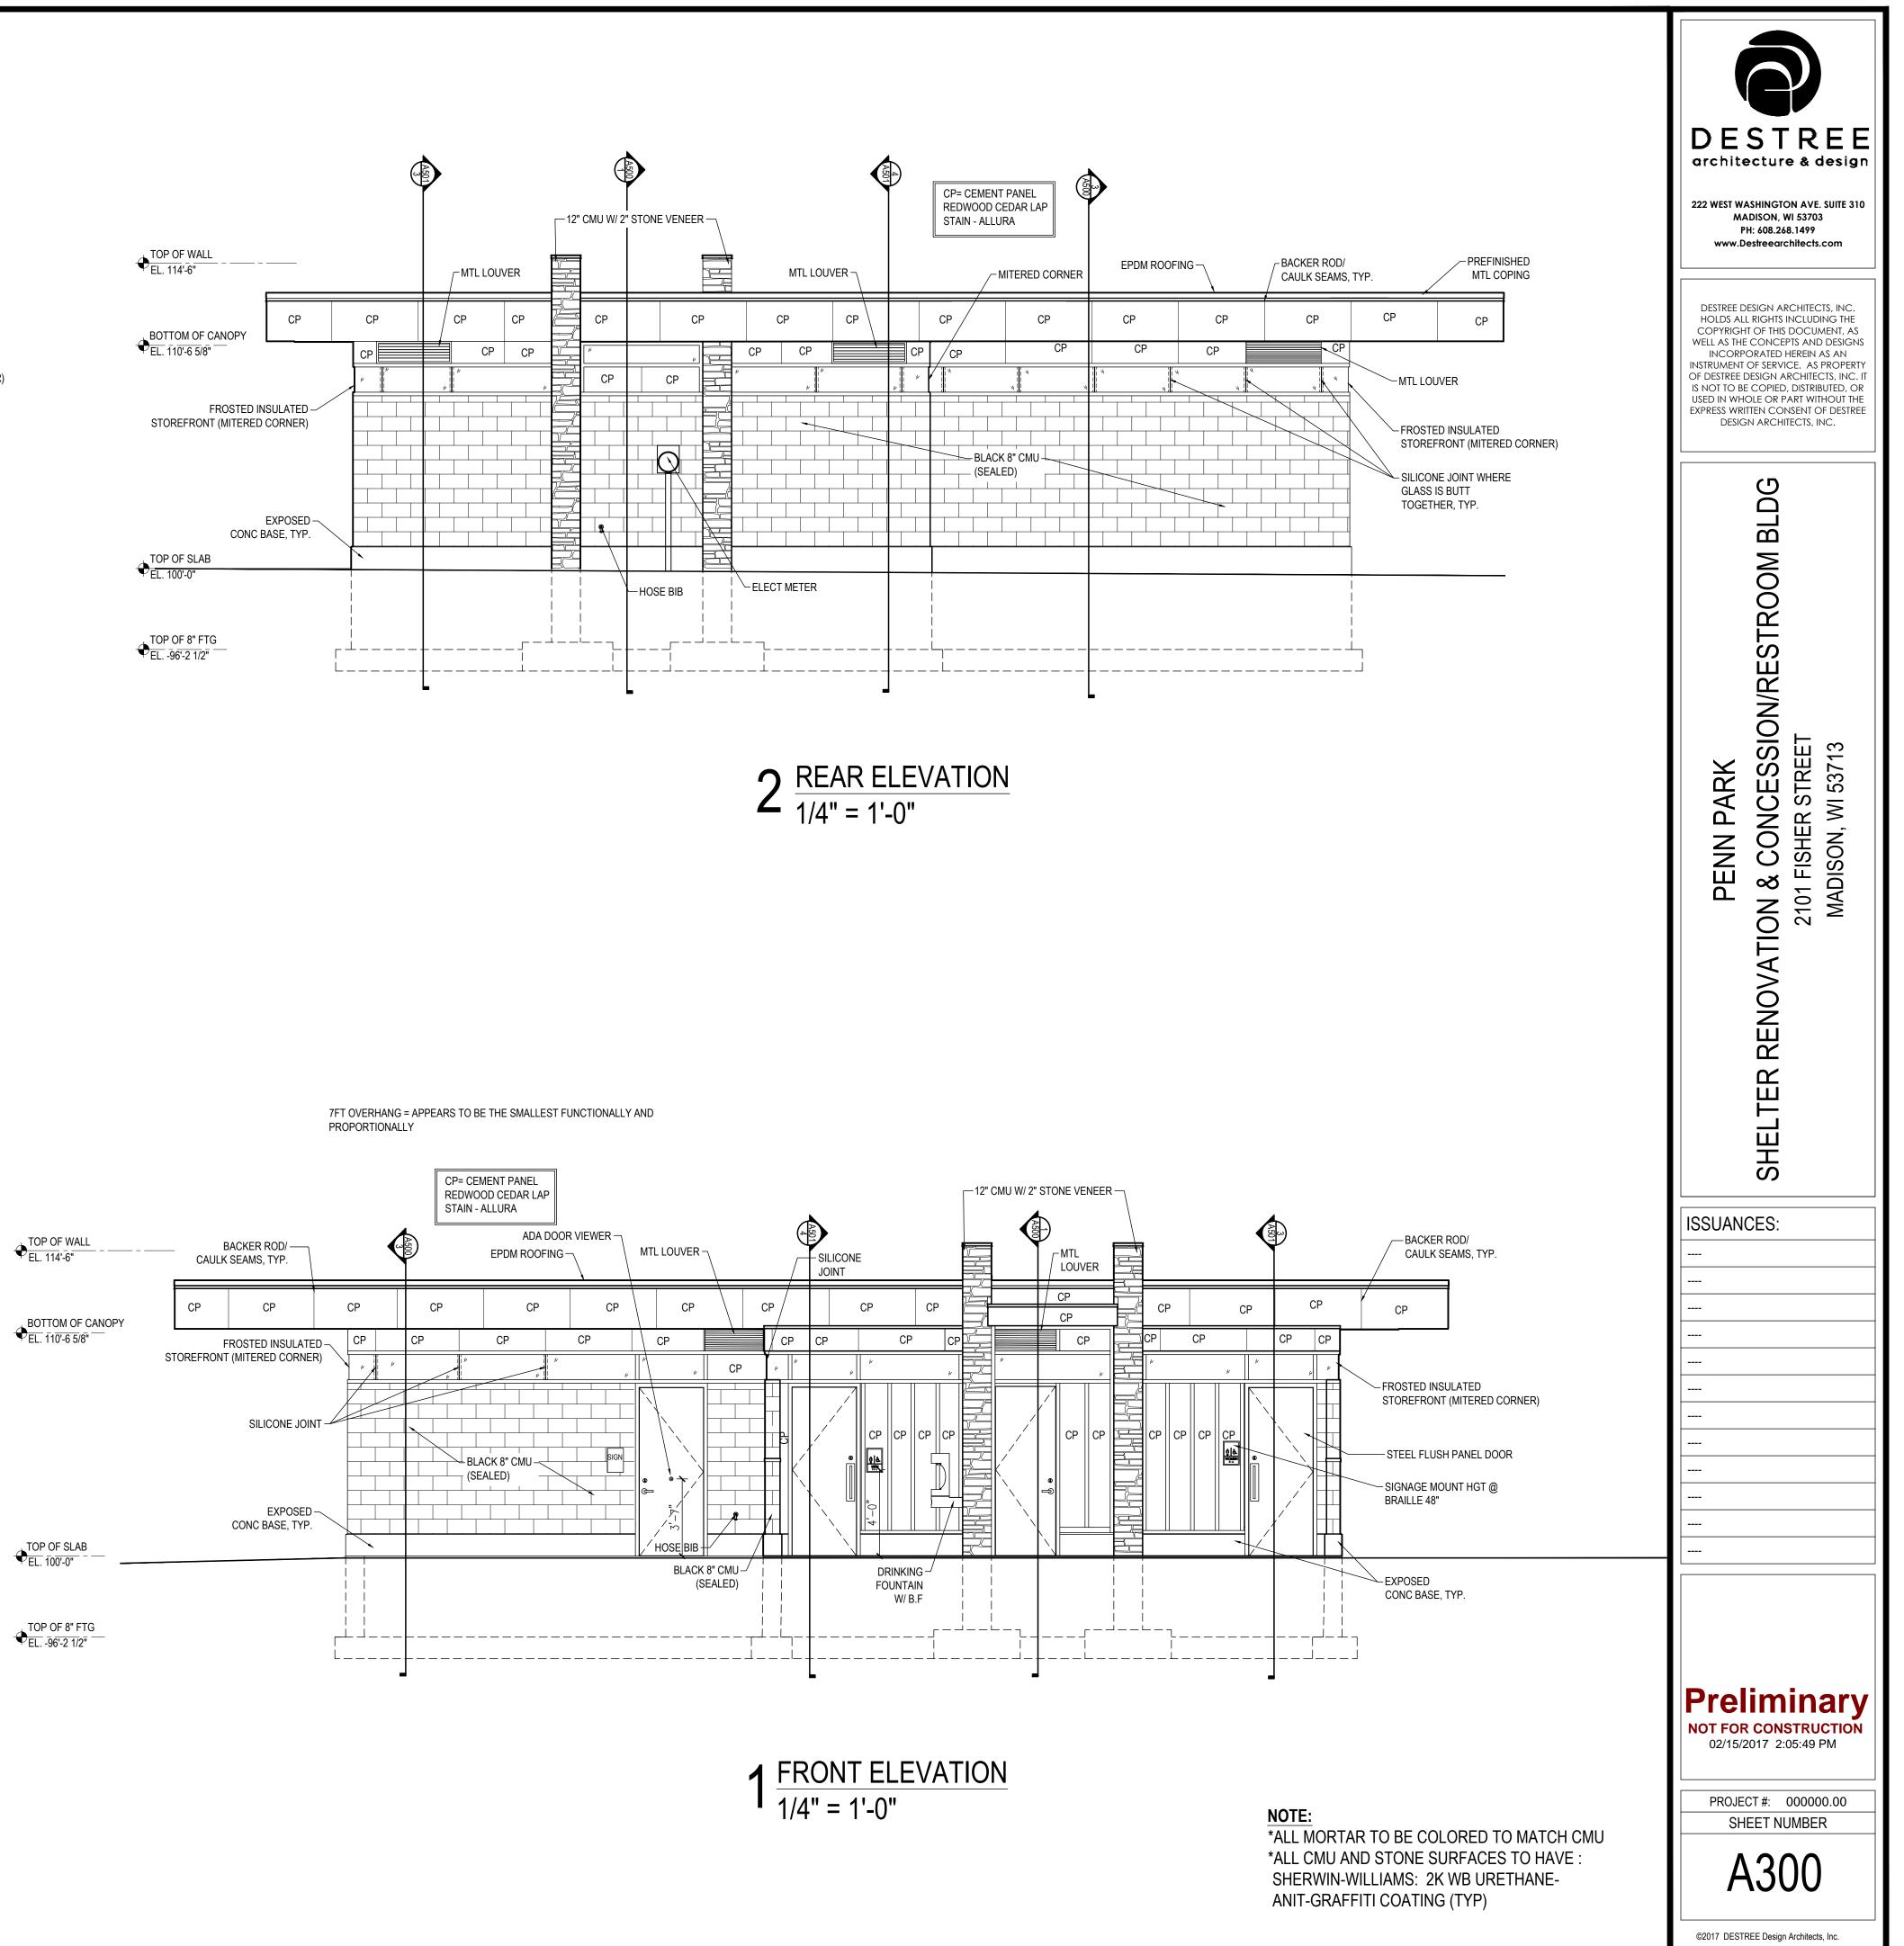





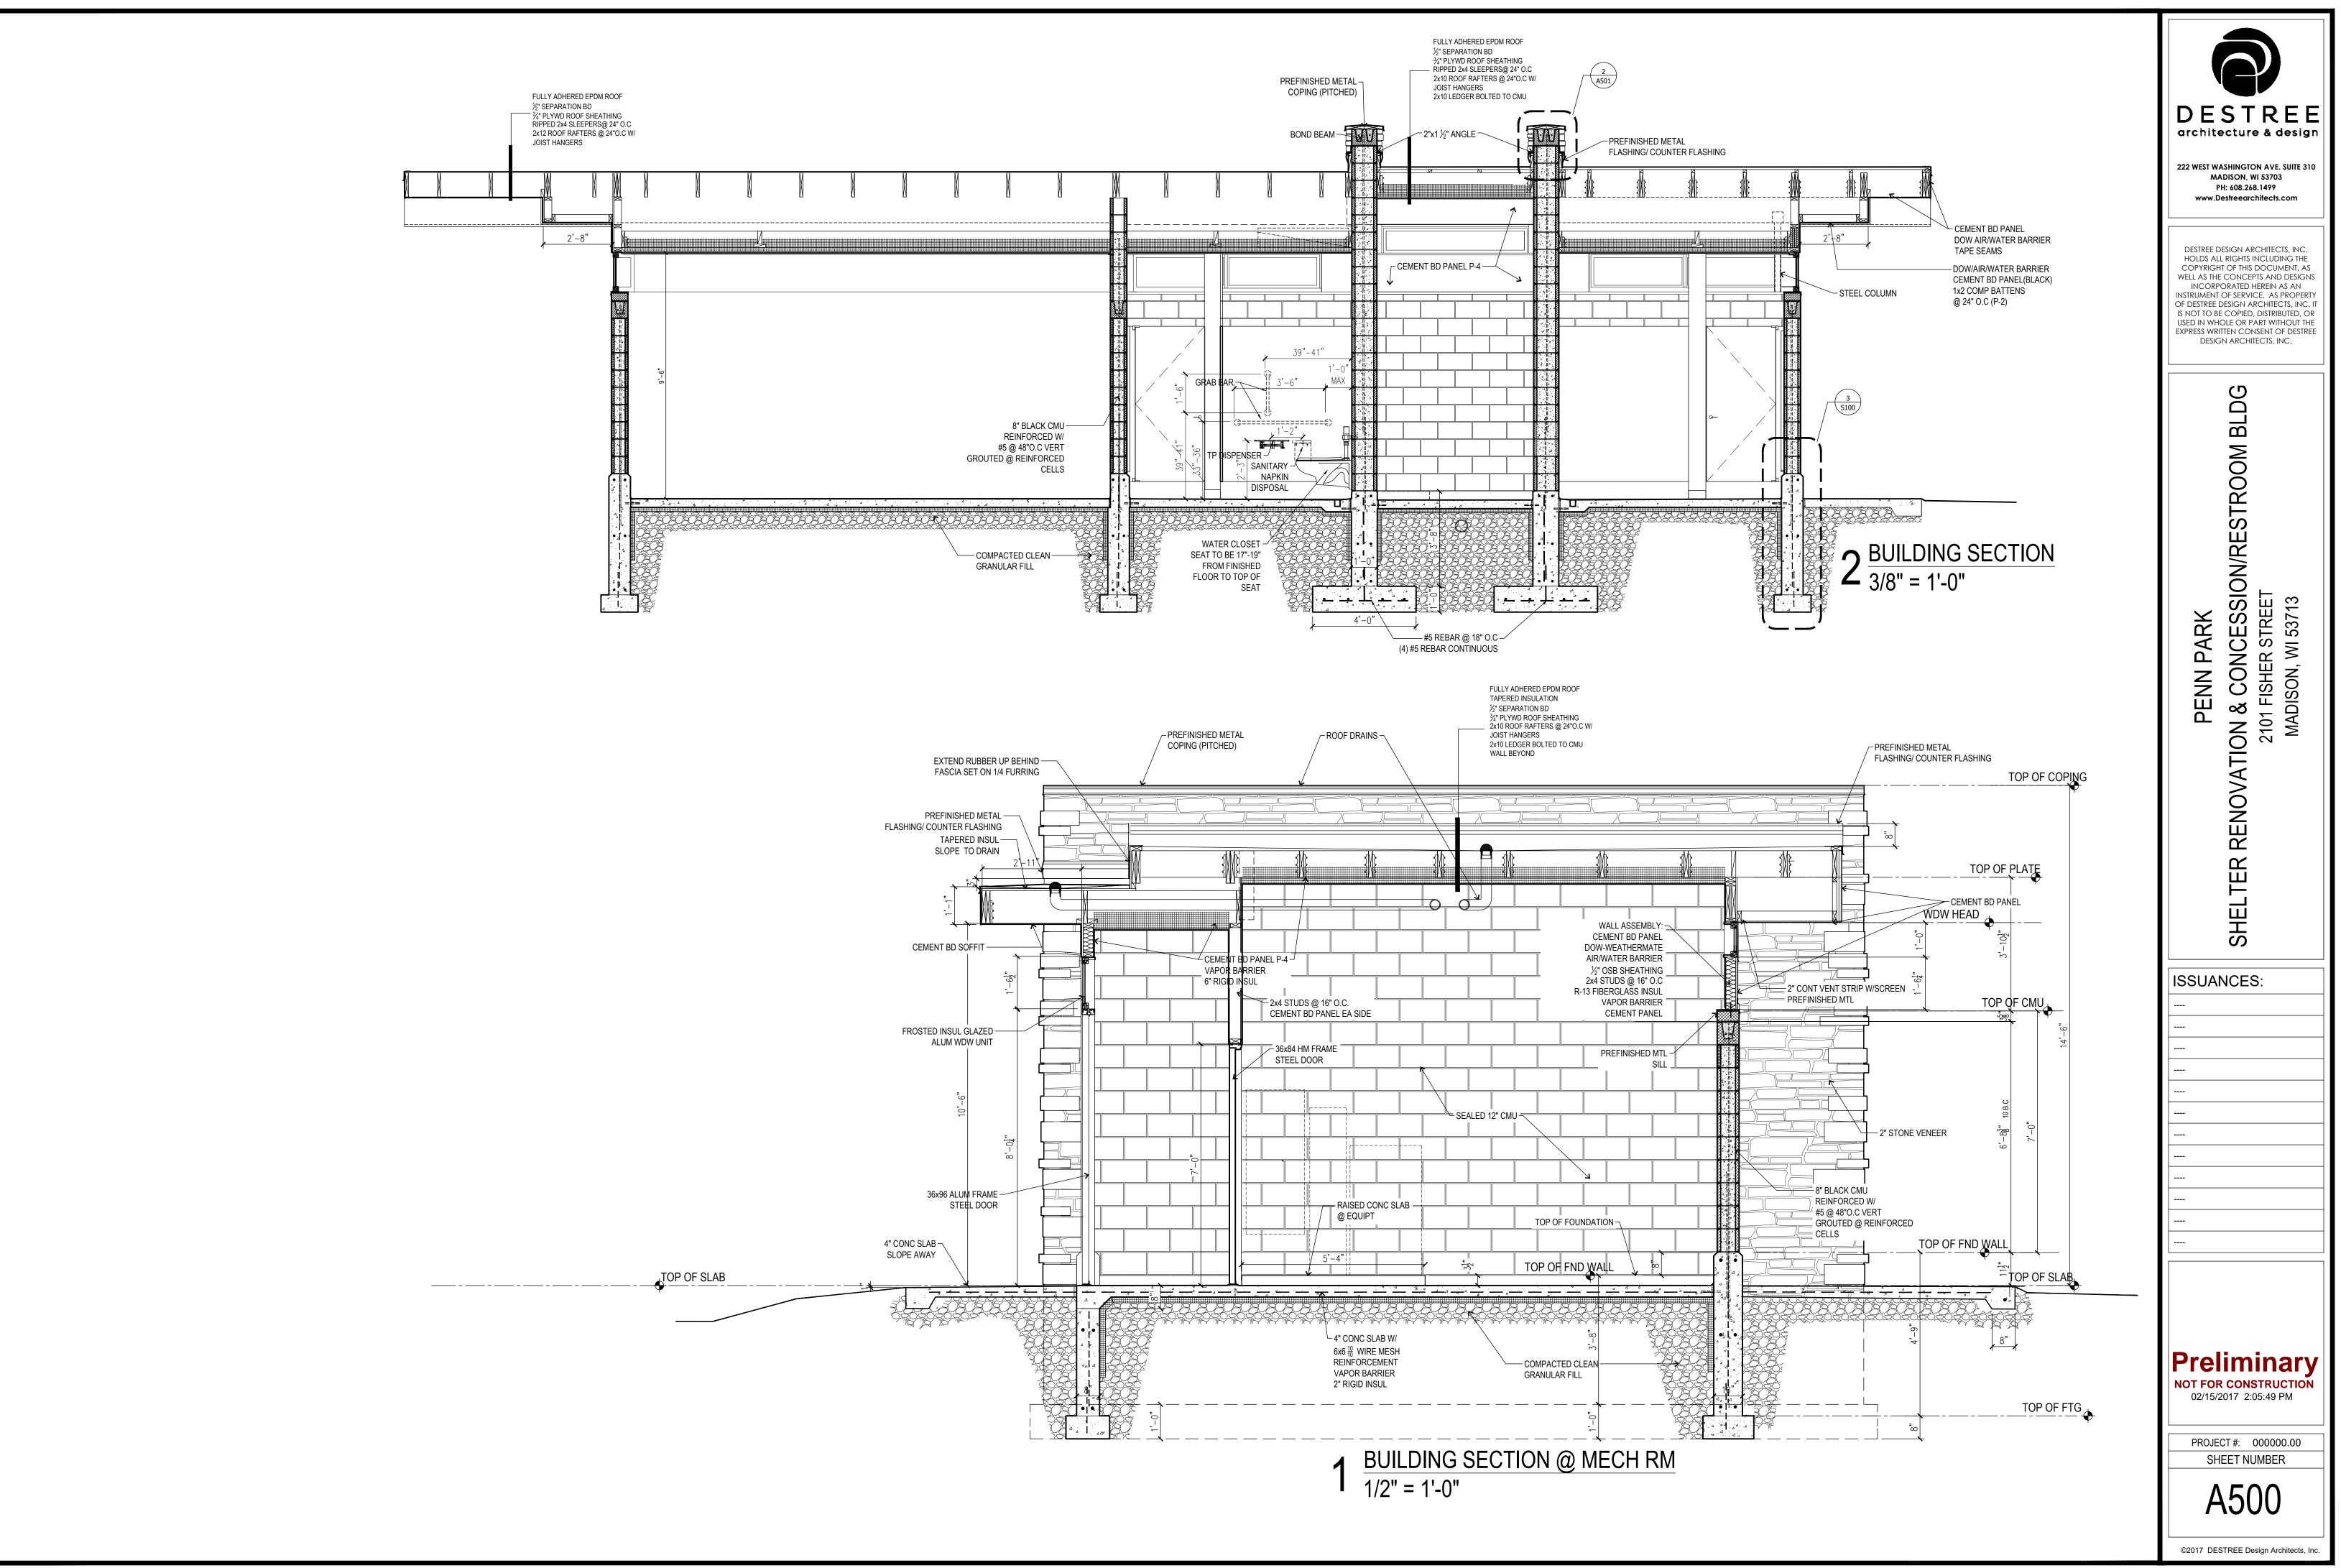


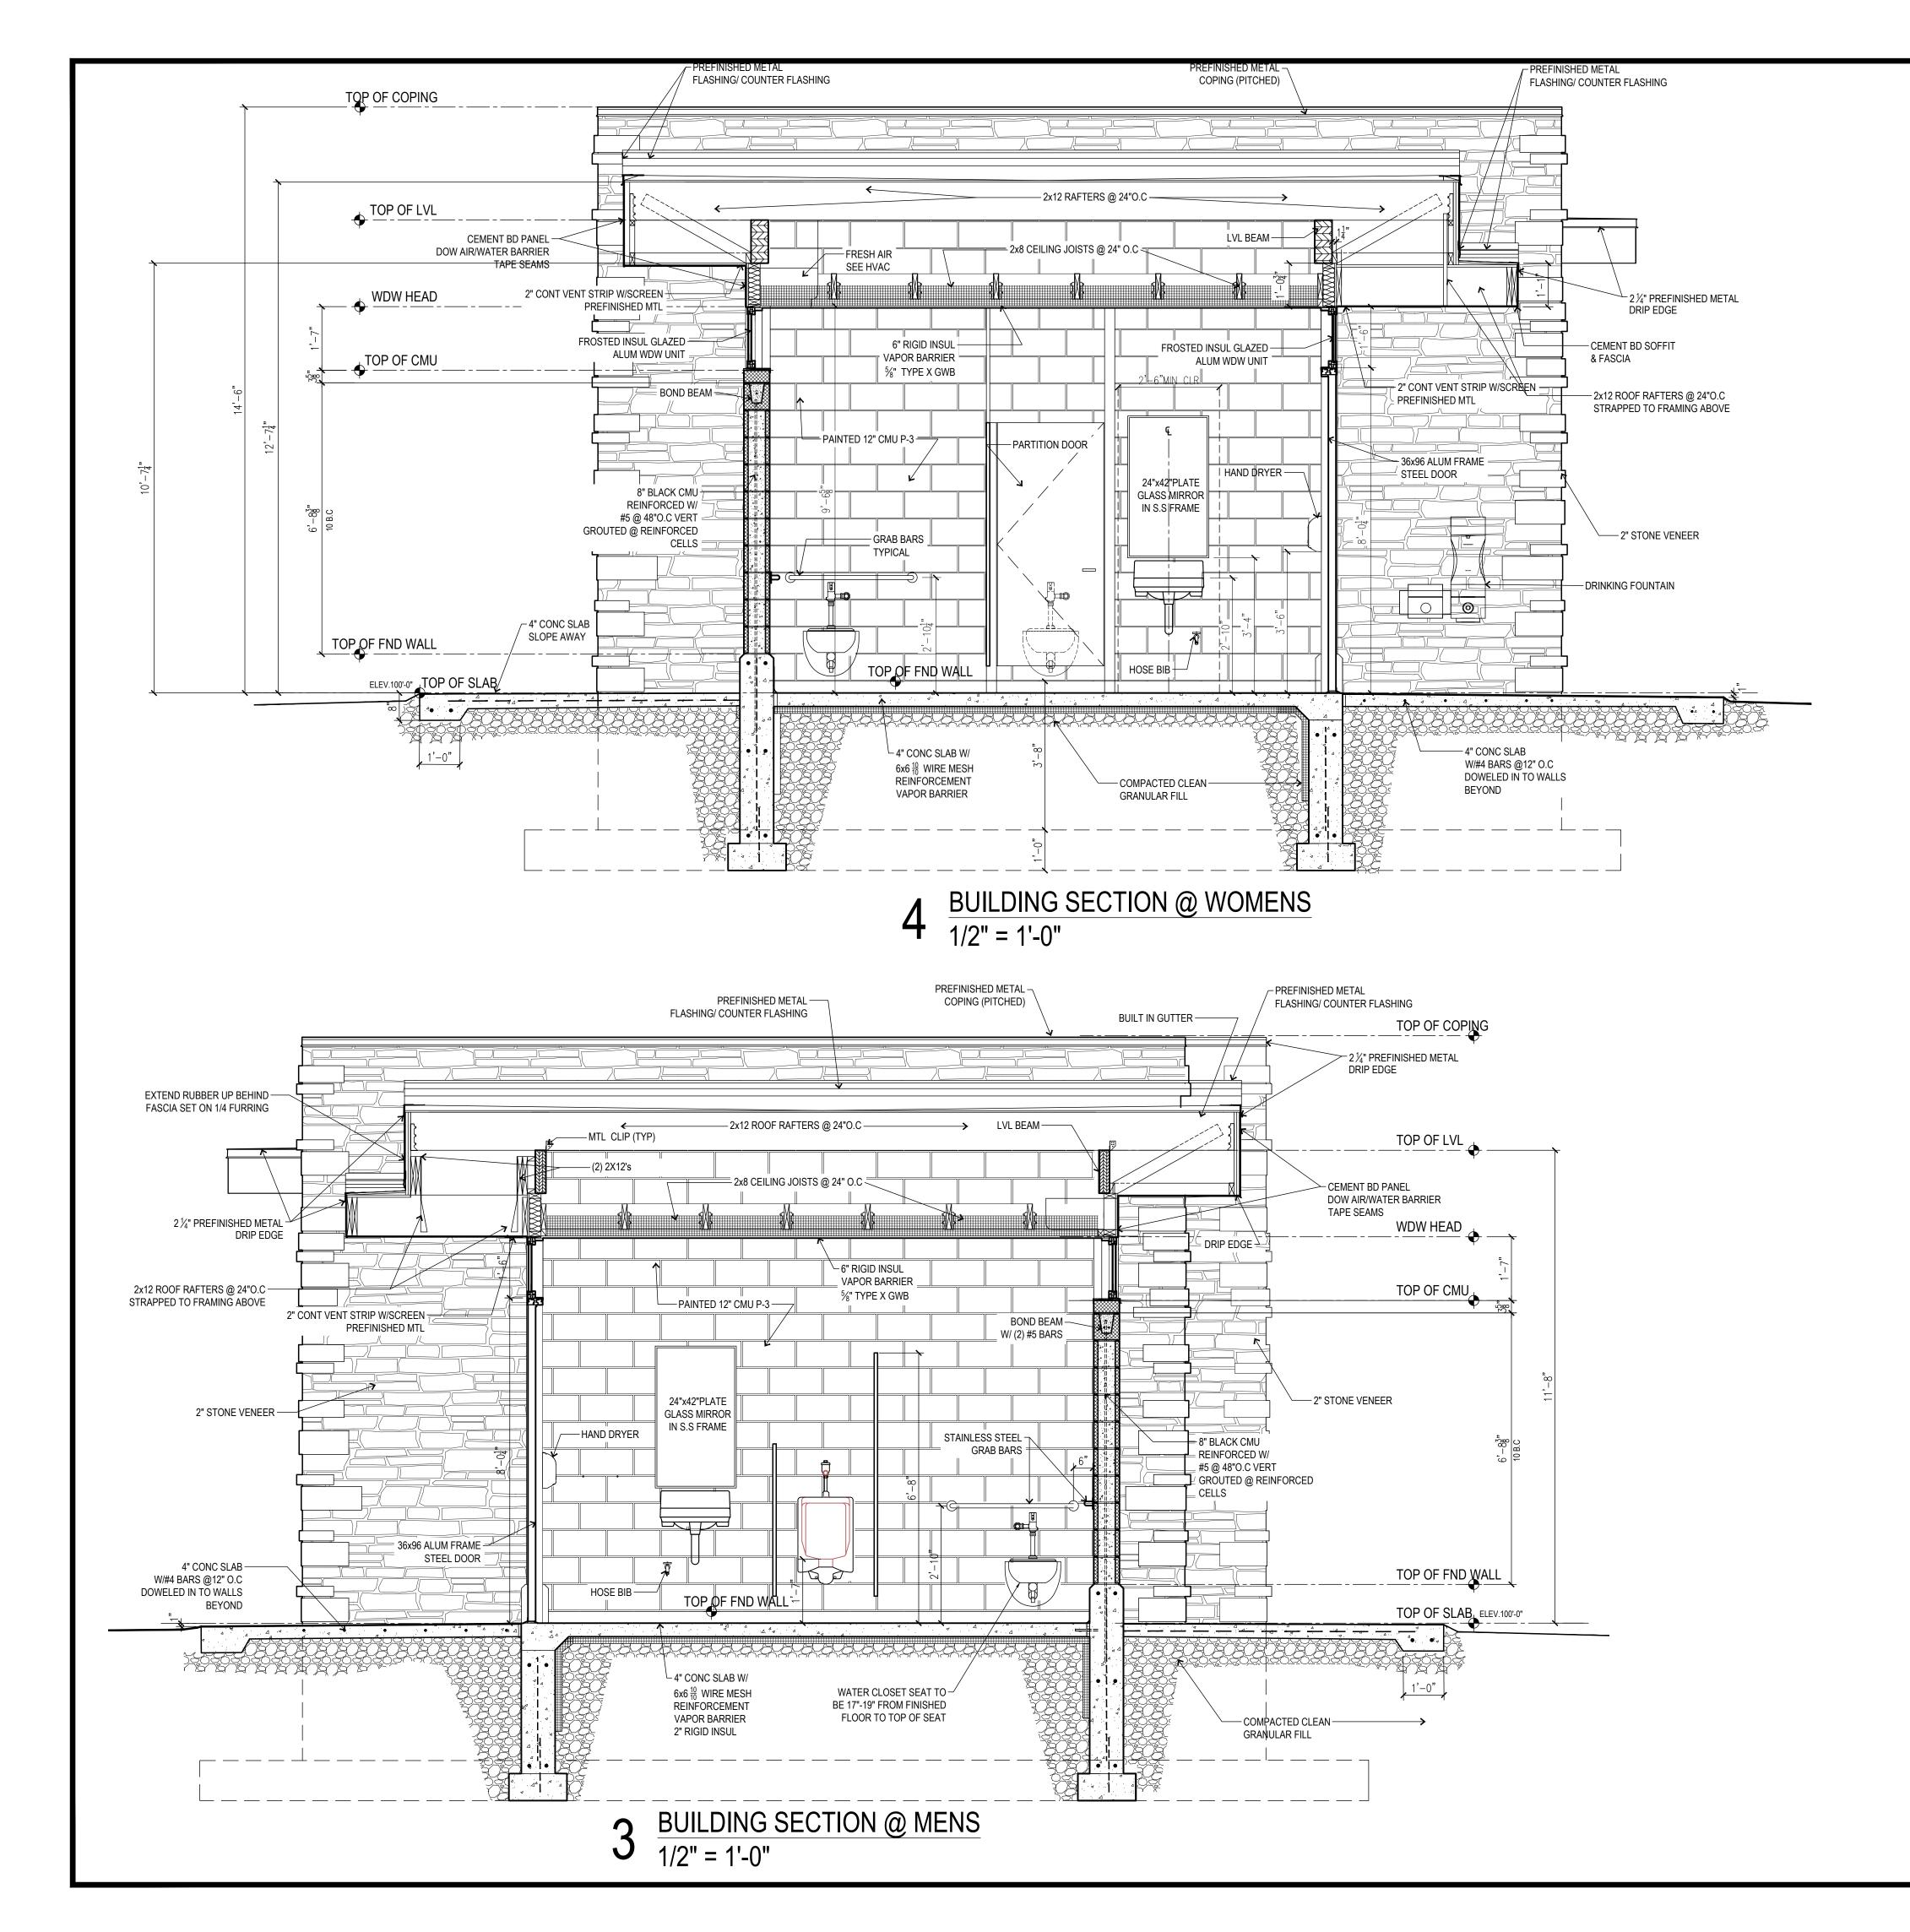


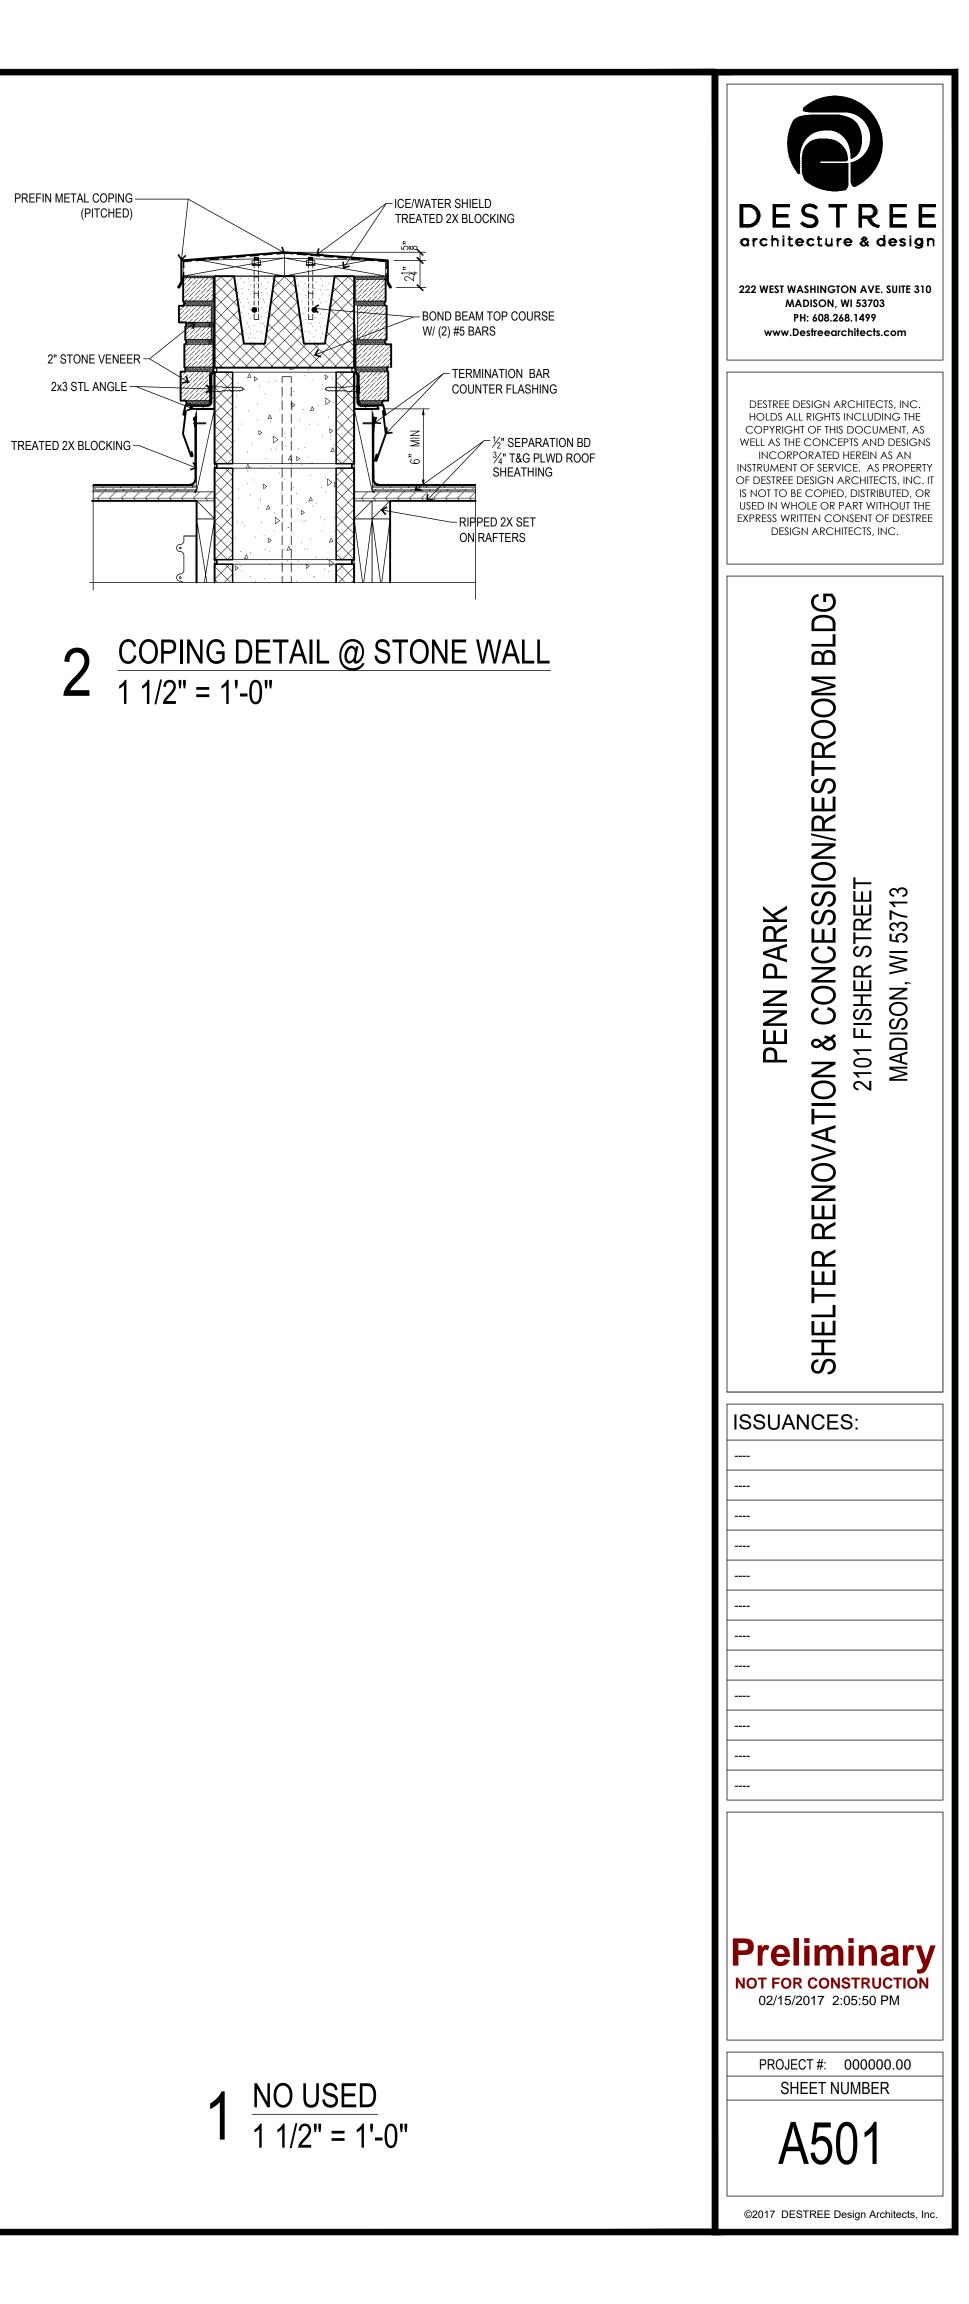

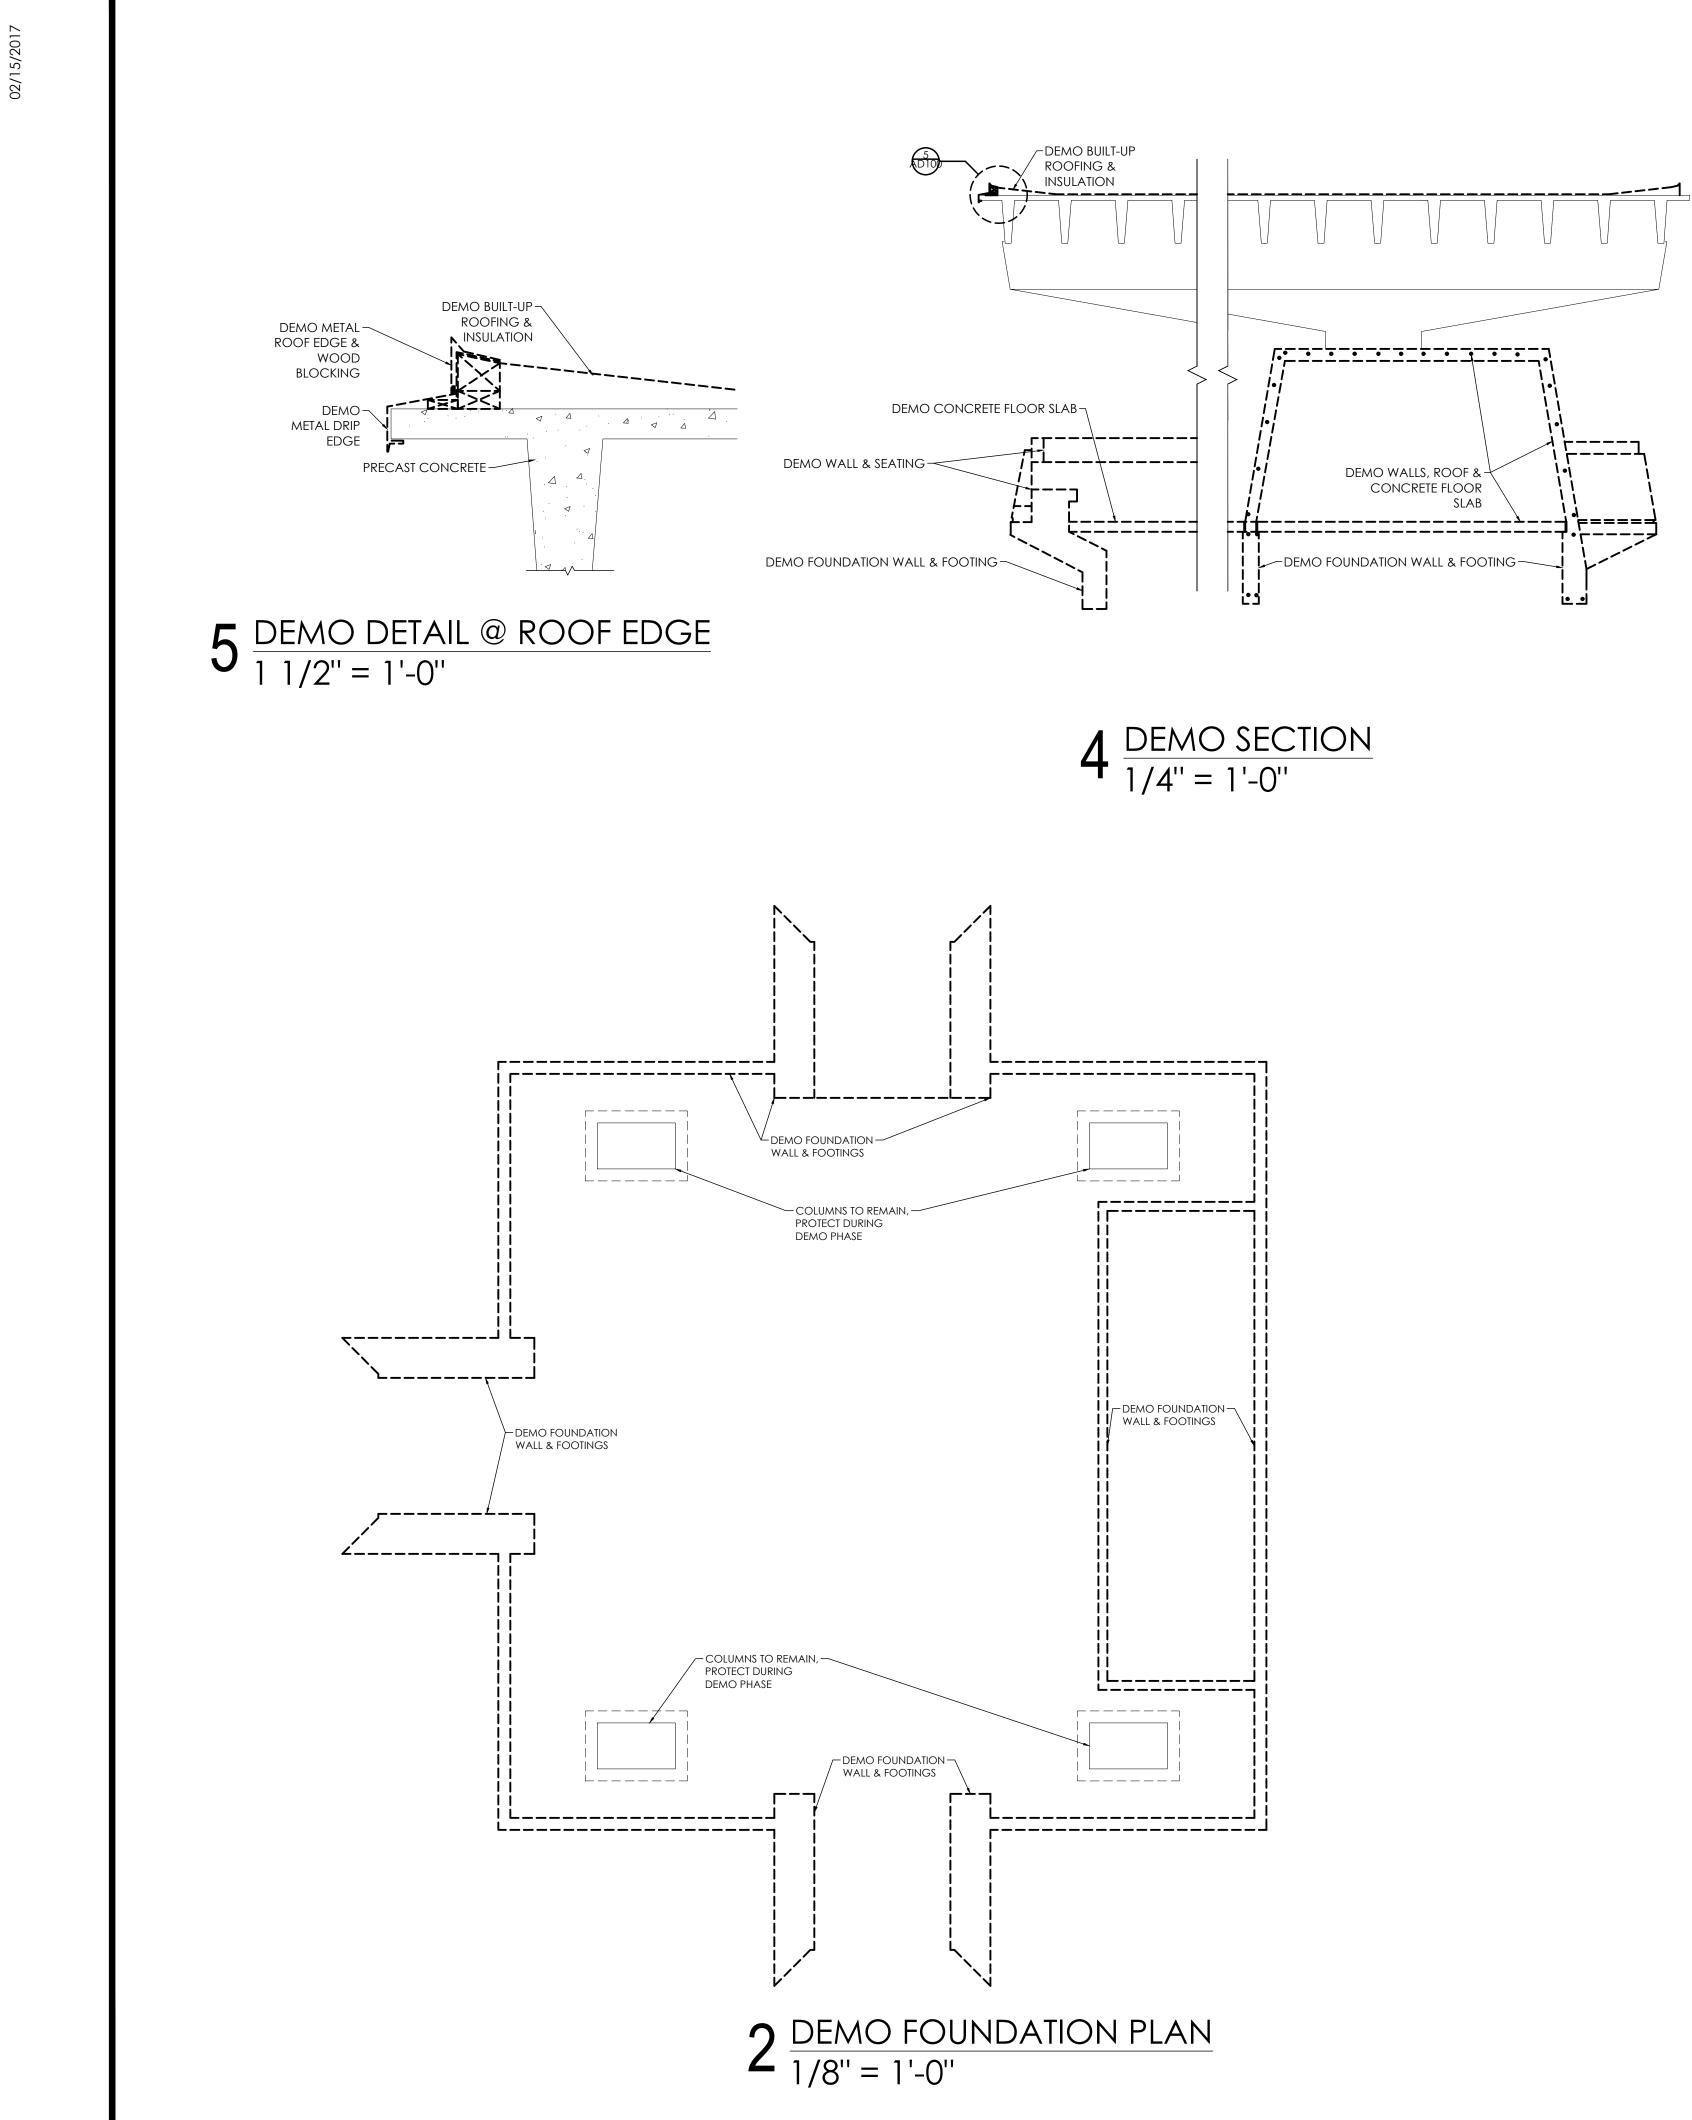

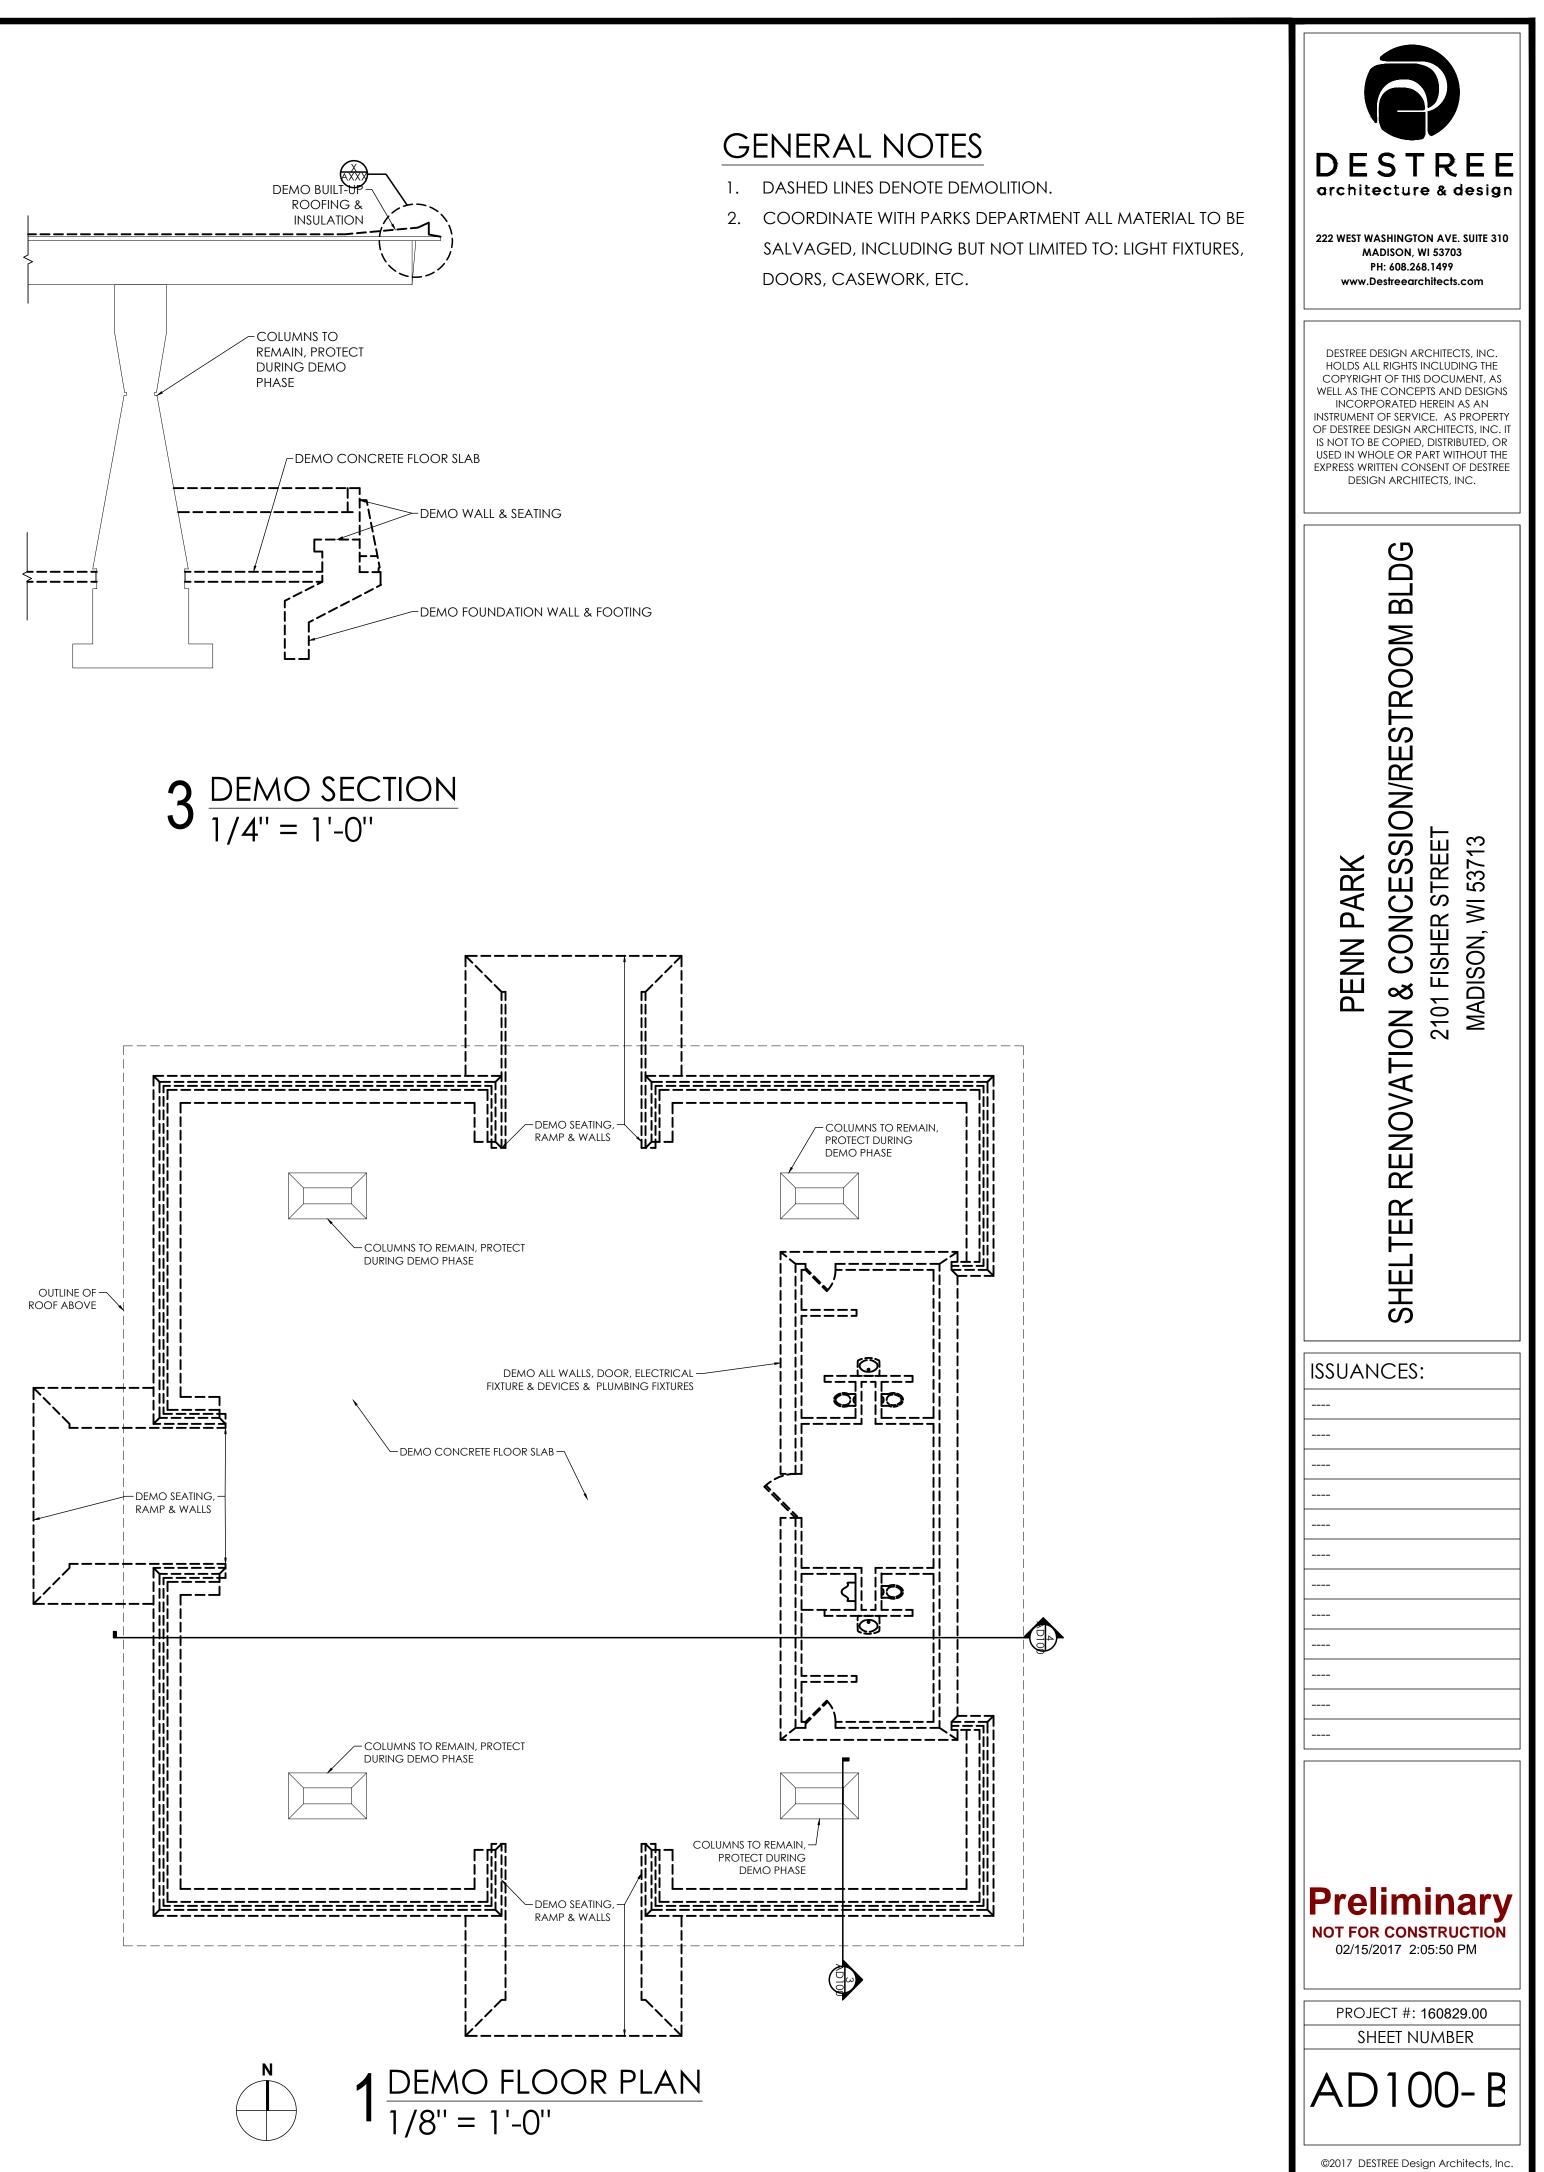

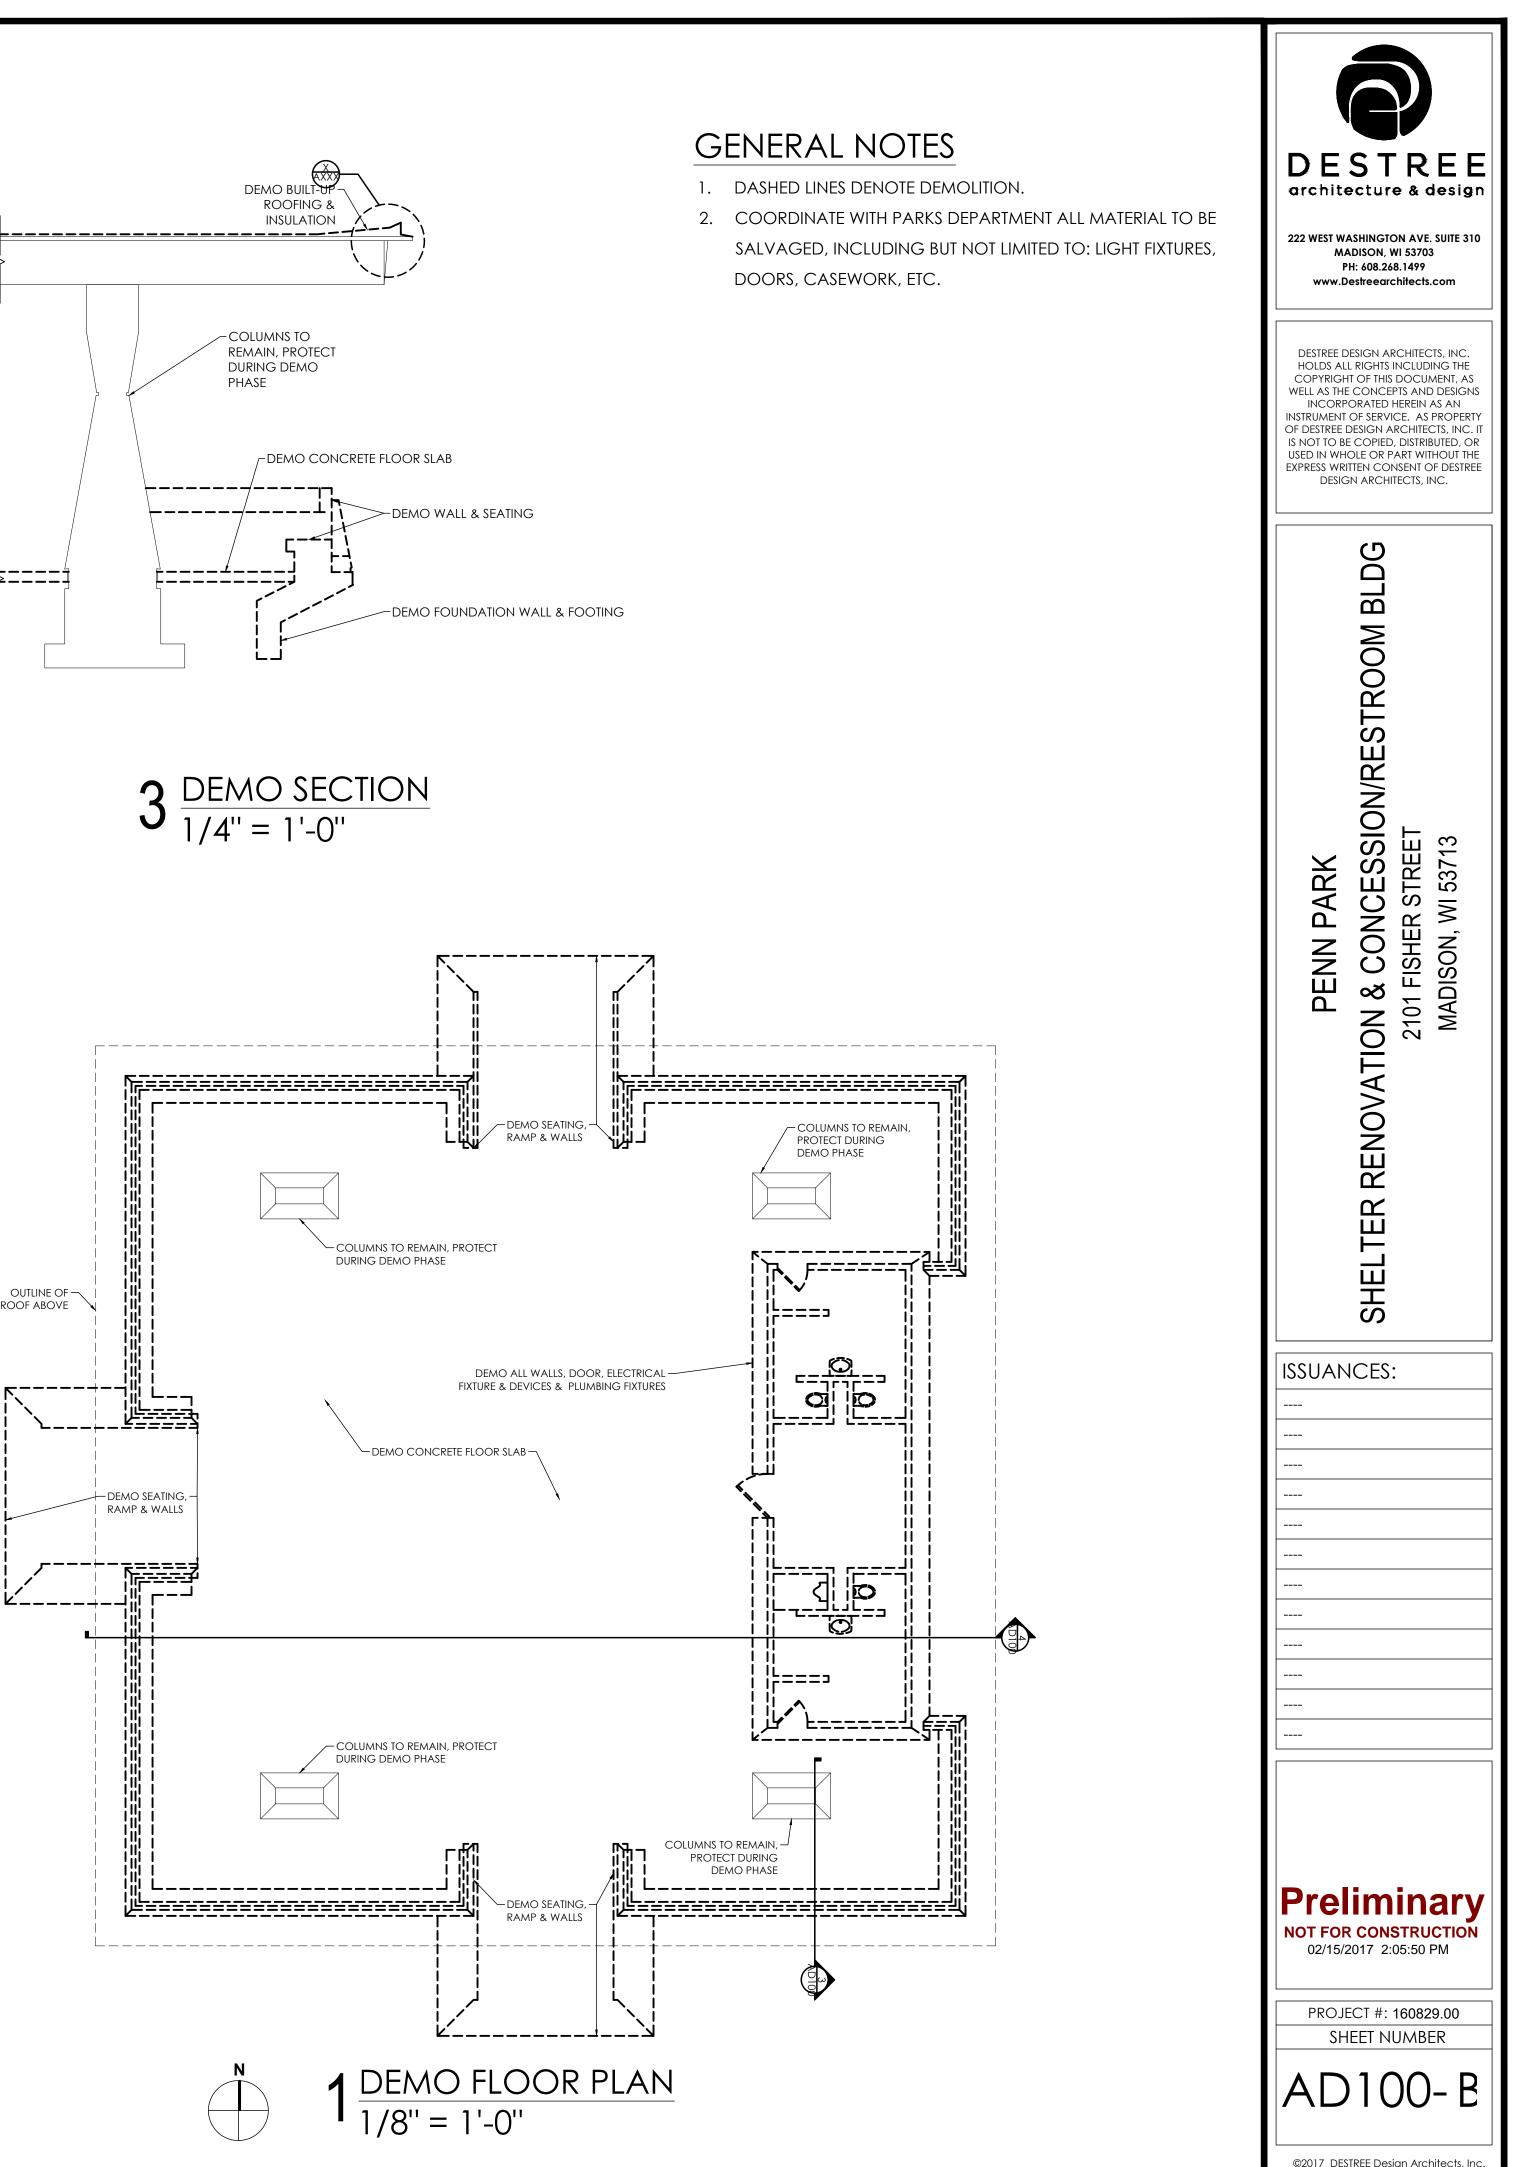

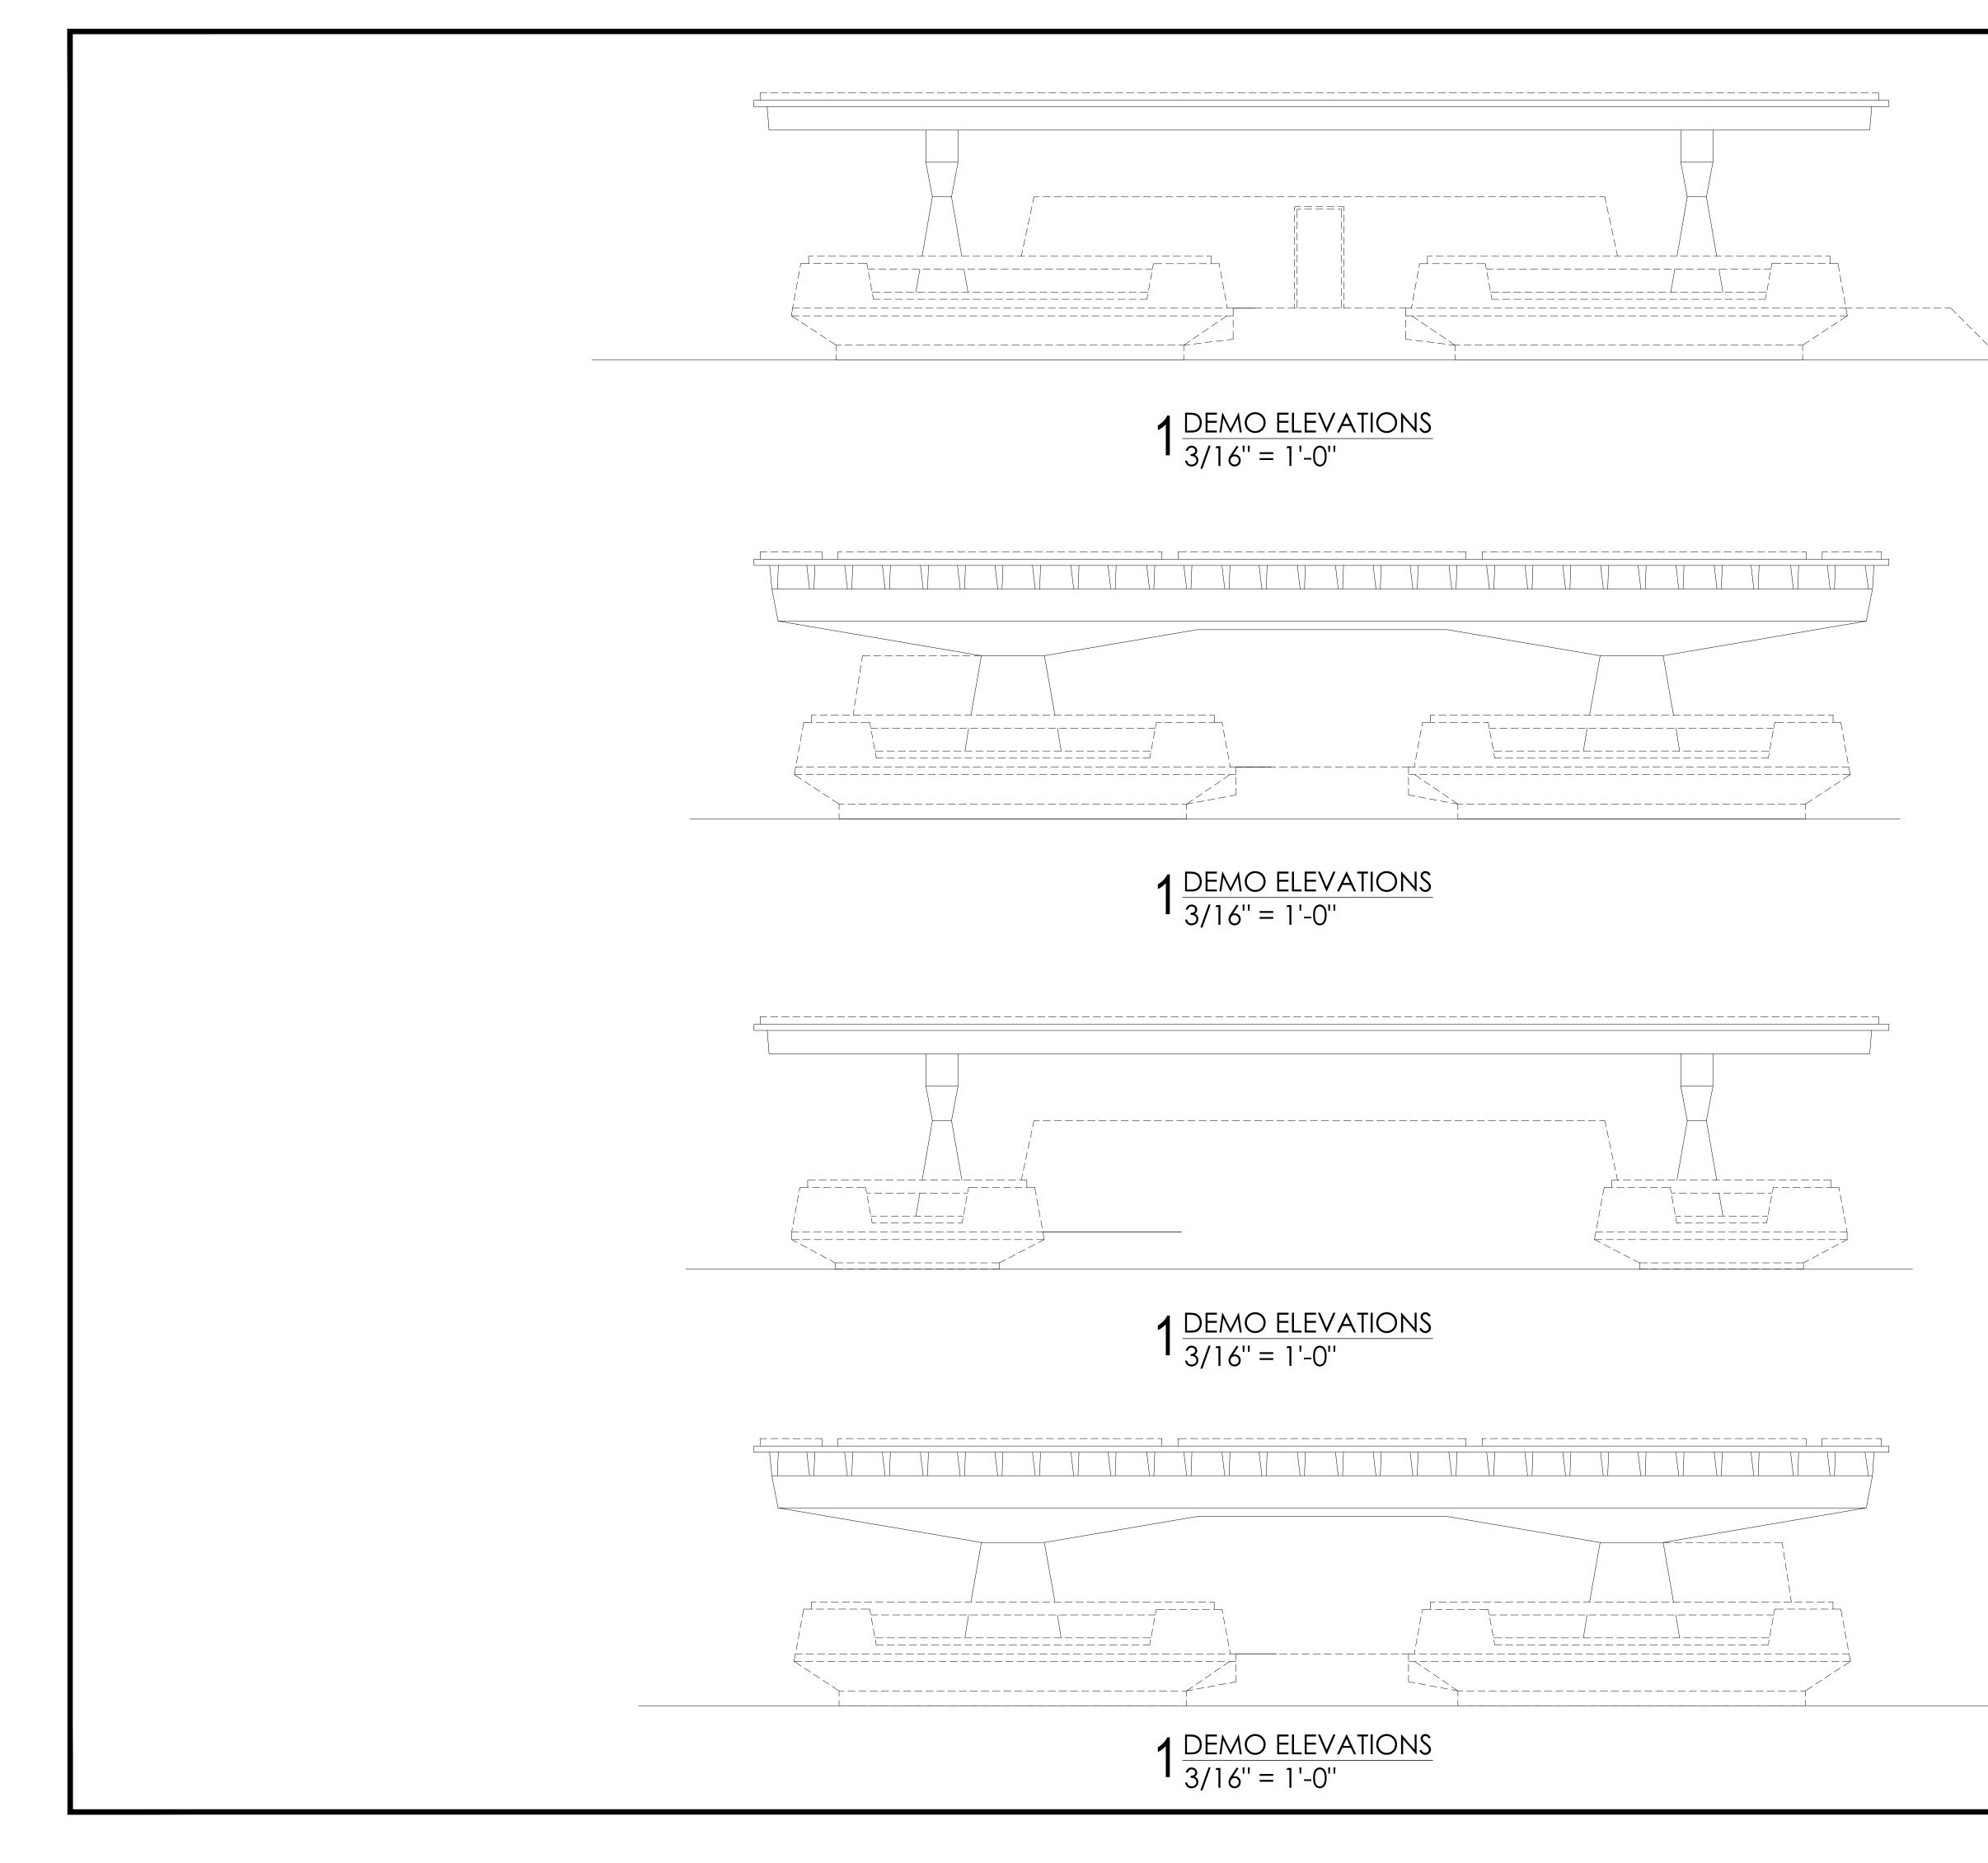


GENERAL NOTES


1. XXXX

KEYNOTES

- 1 XXXX
- 2 XXXX

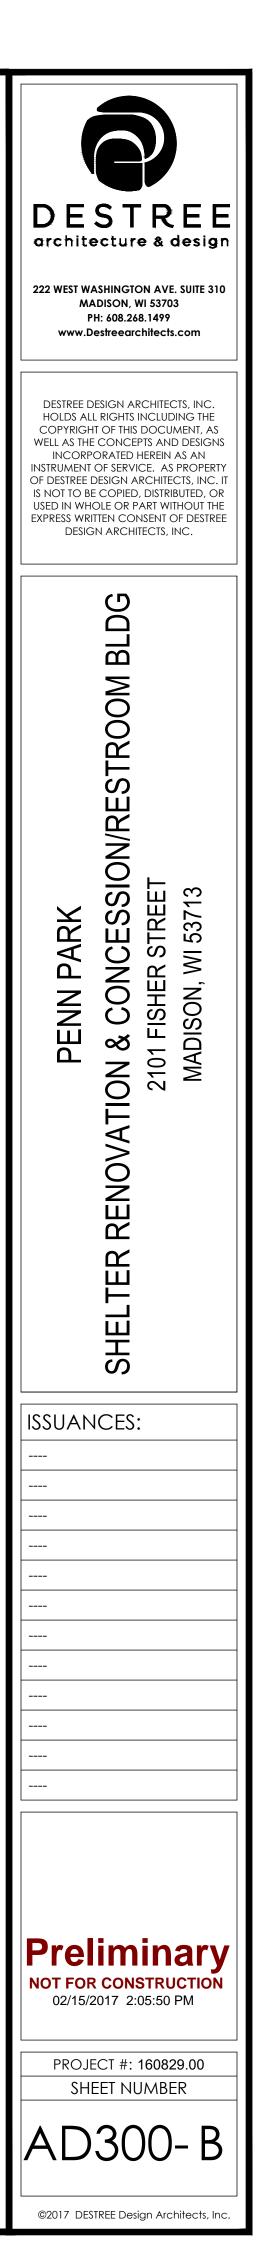


PLOT DATE: 02/15/201

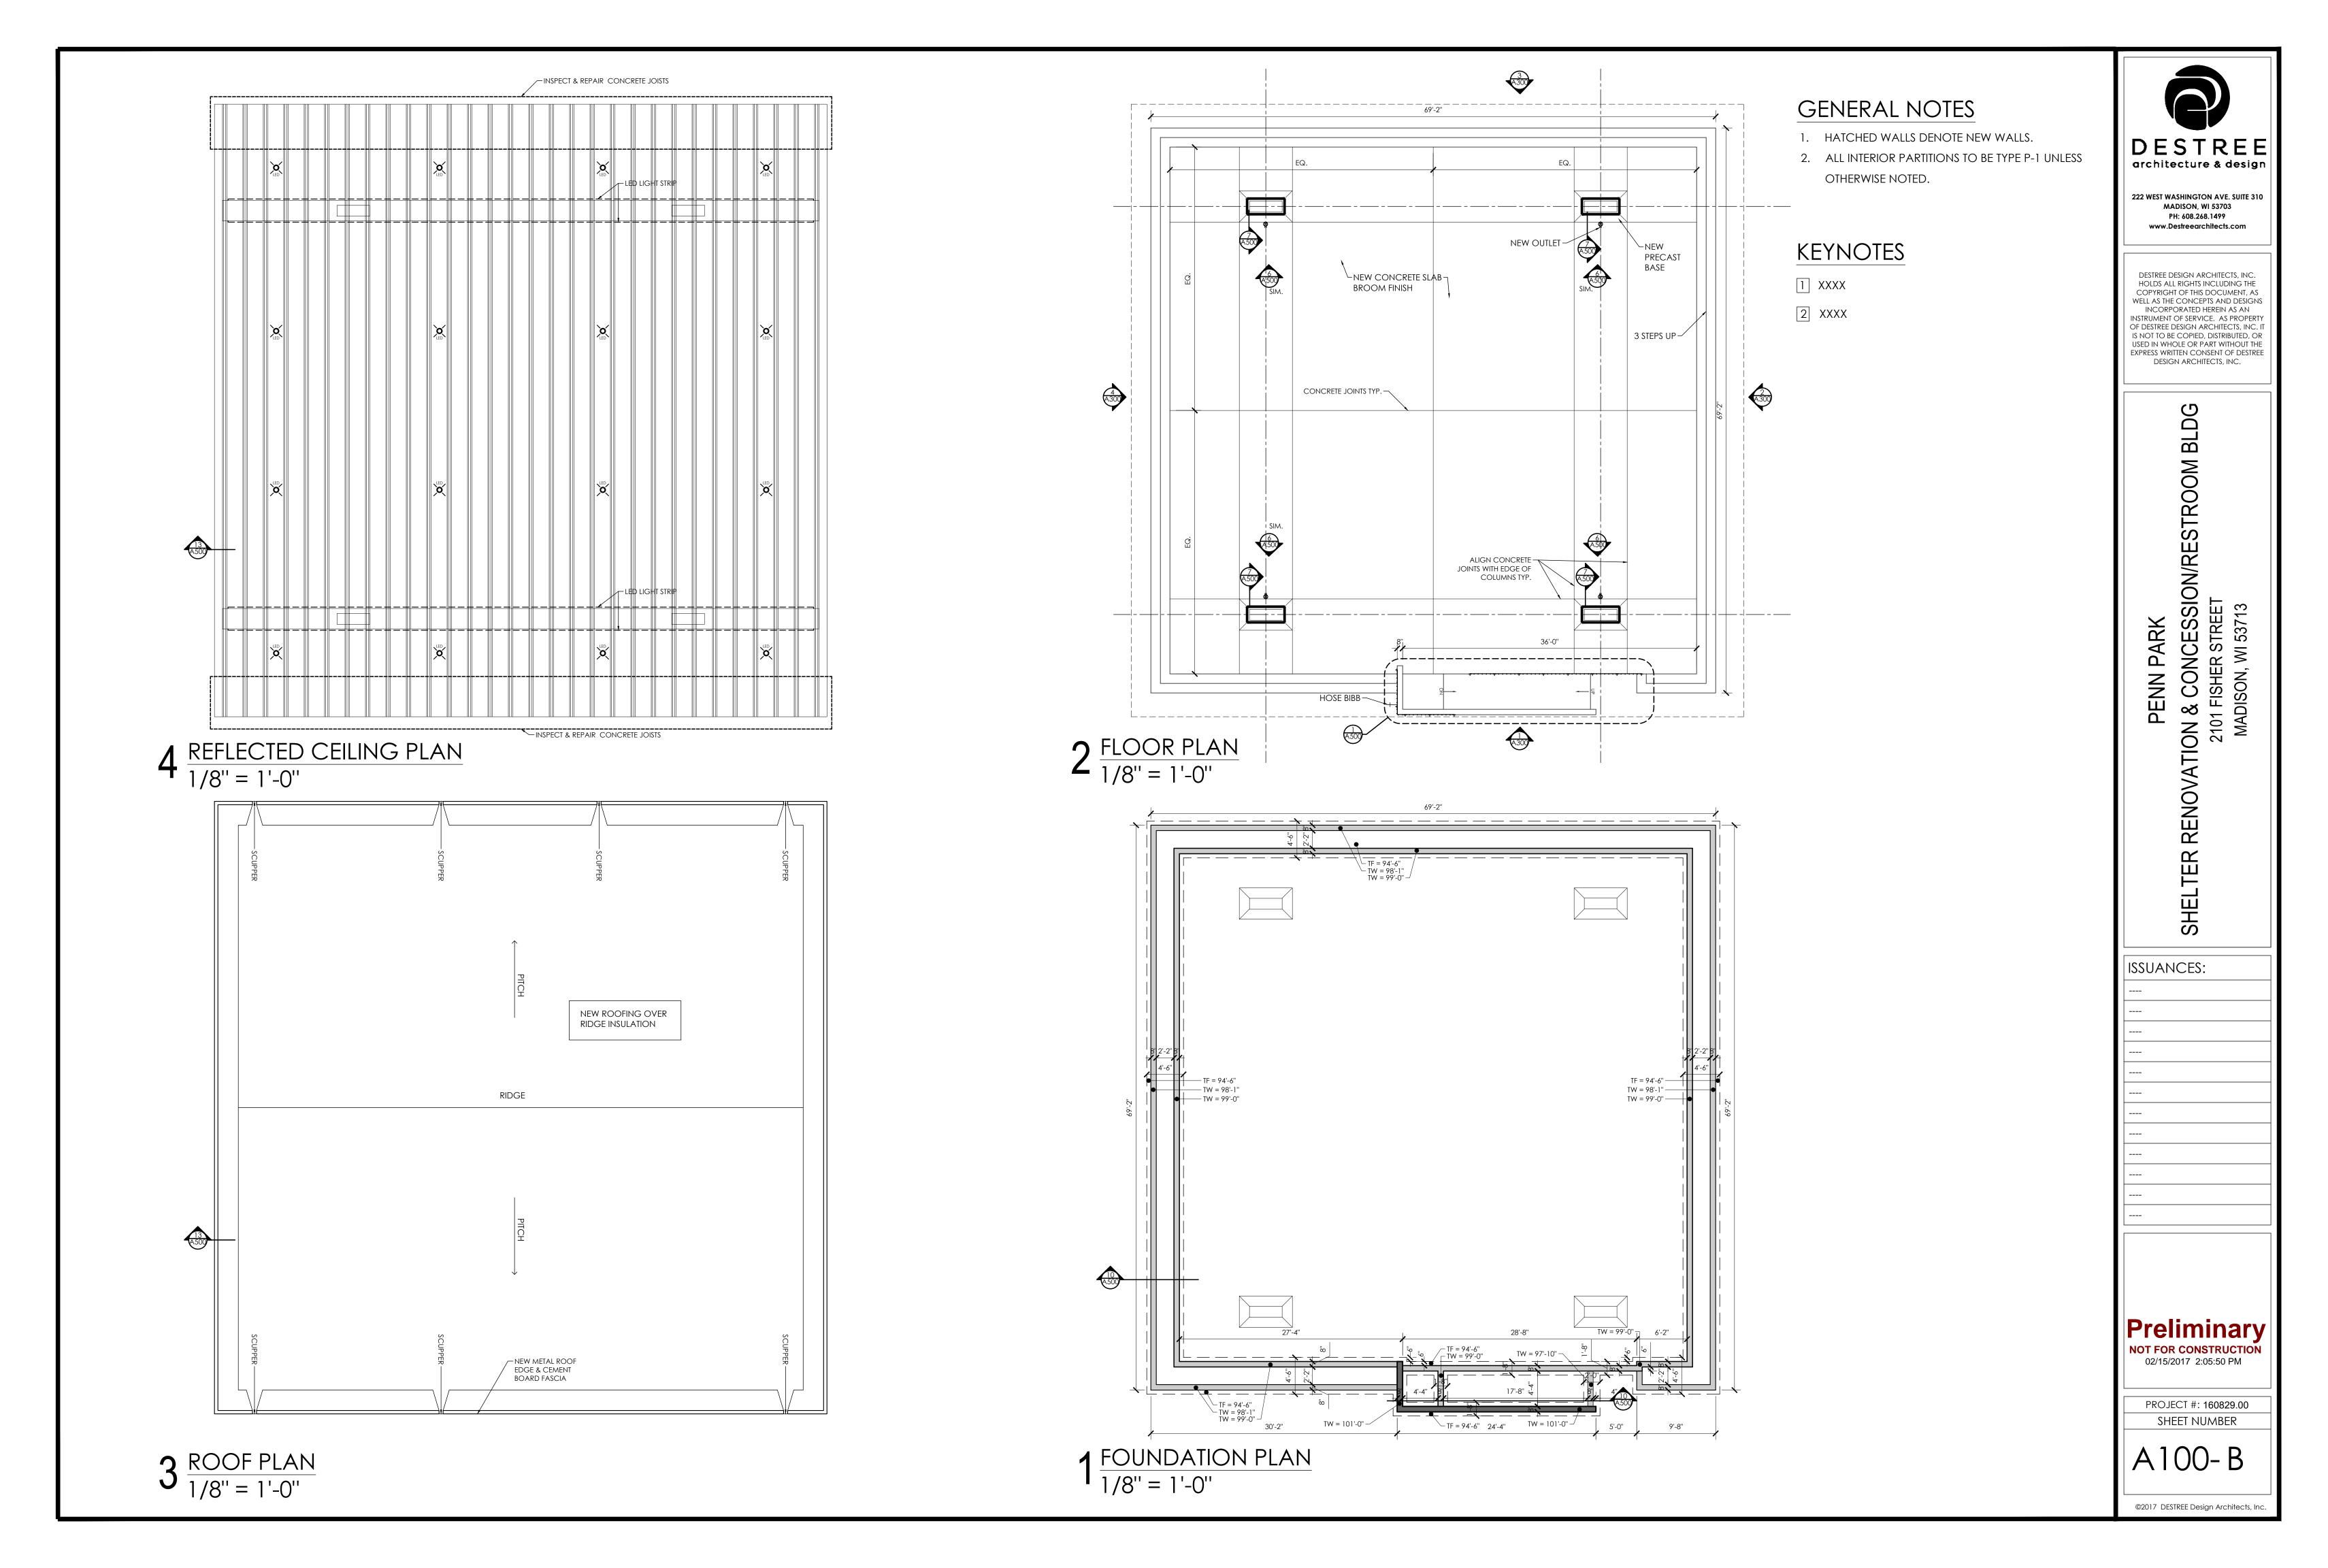



- NEW RAILING BLACK POWDER COATED PLATE STEEL NEW CONCRETE-A500 - NEW FULLY ADHERED EPDM ROOF, NEW GRAVEL STOP & FASCIA, COLOR BLACK

-INSPECT & REPAIR XTG CONCRETE JOISTS AS REQUIRED

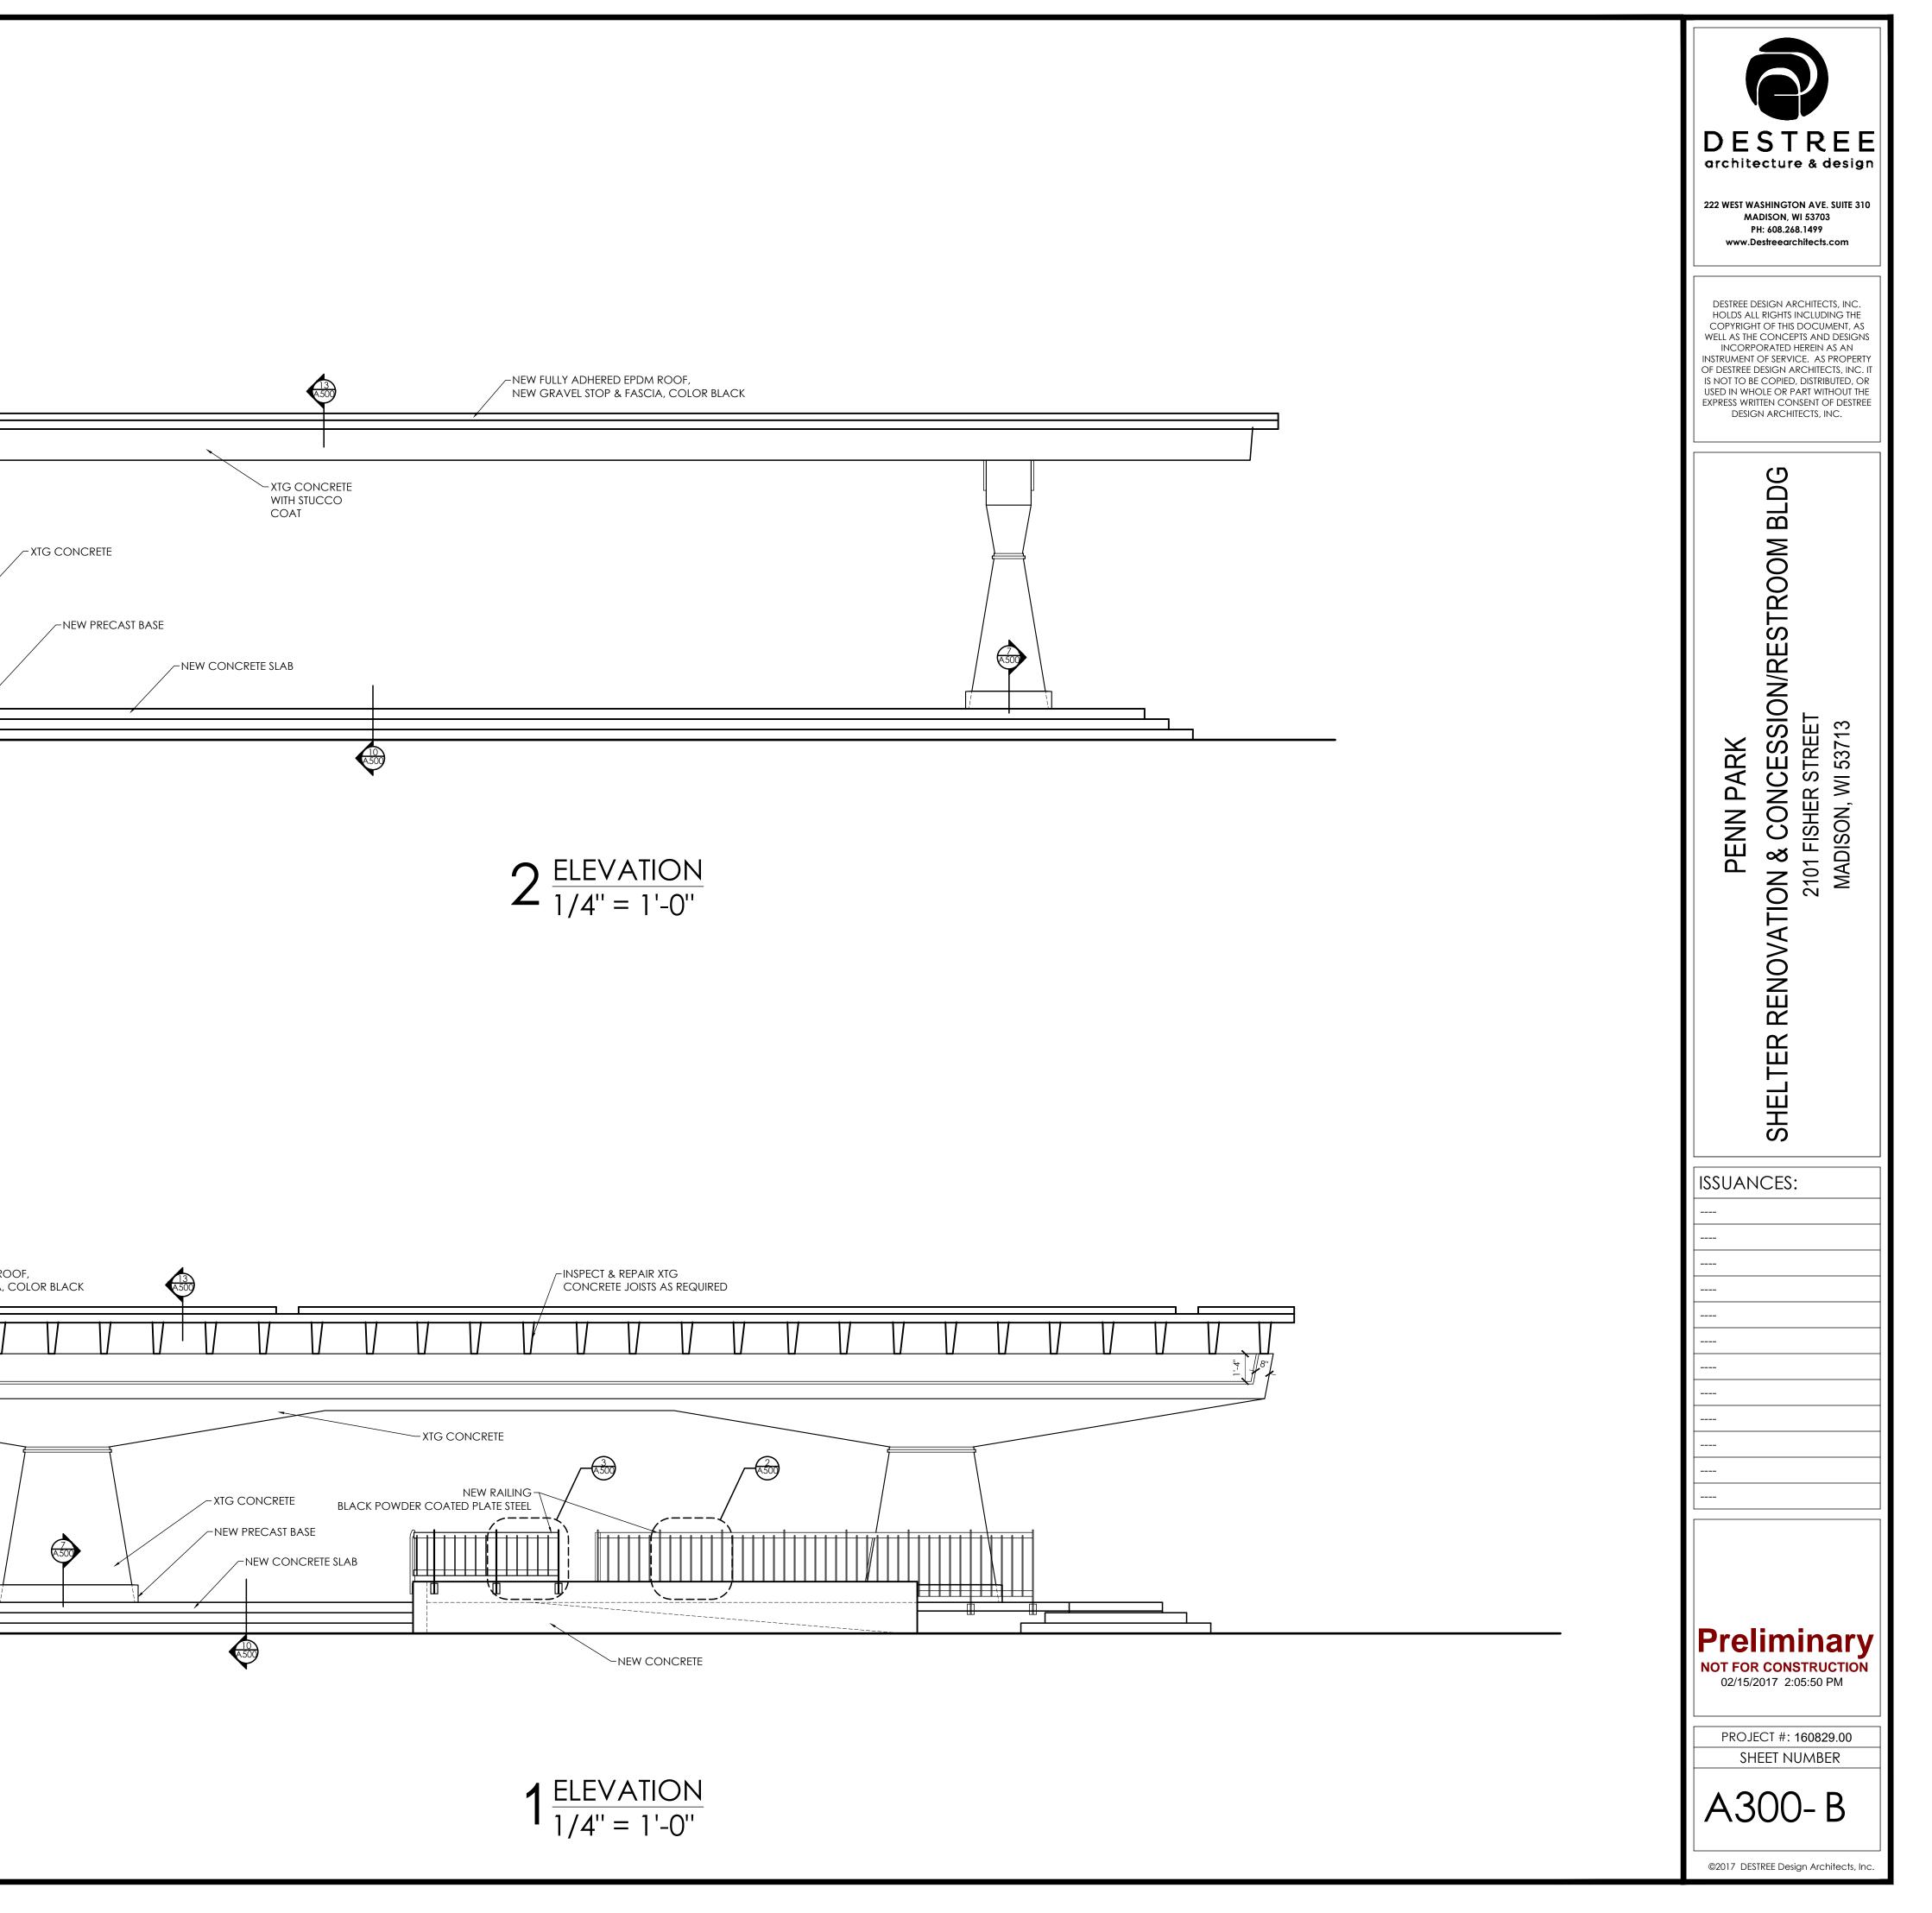



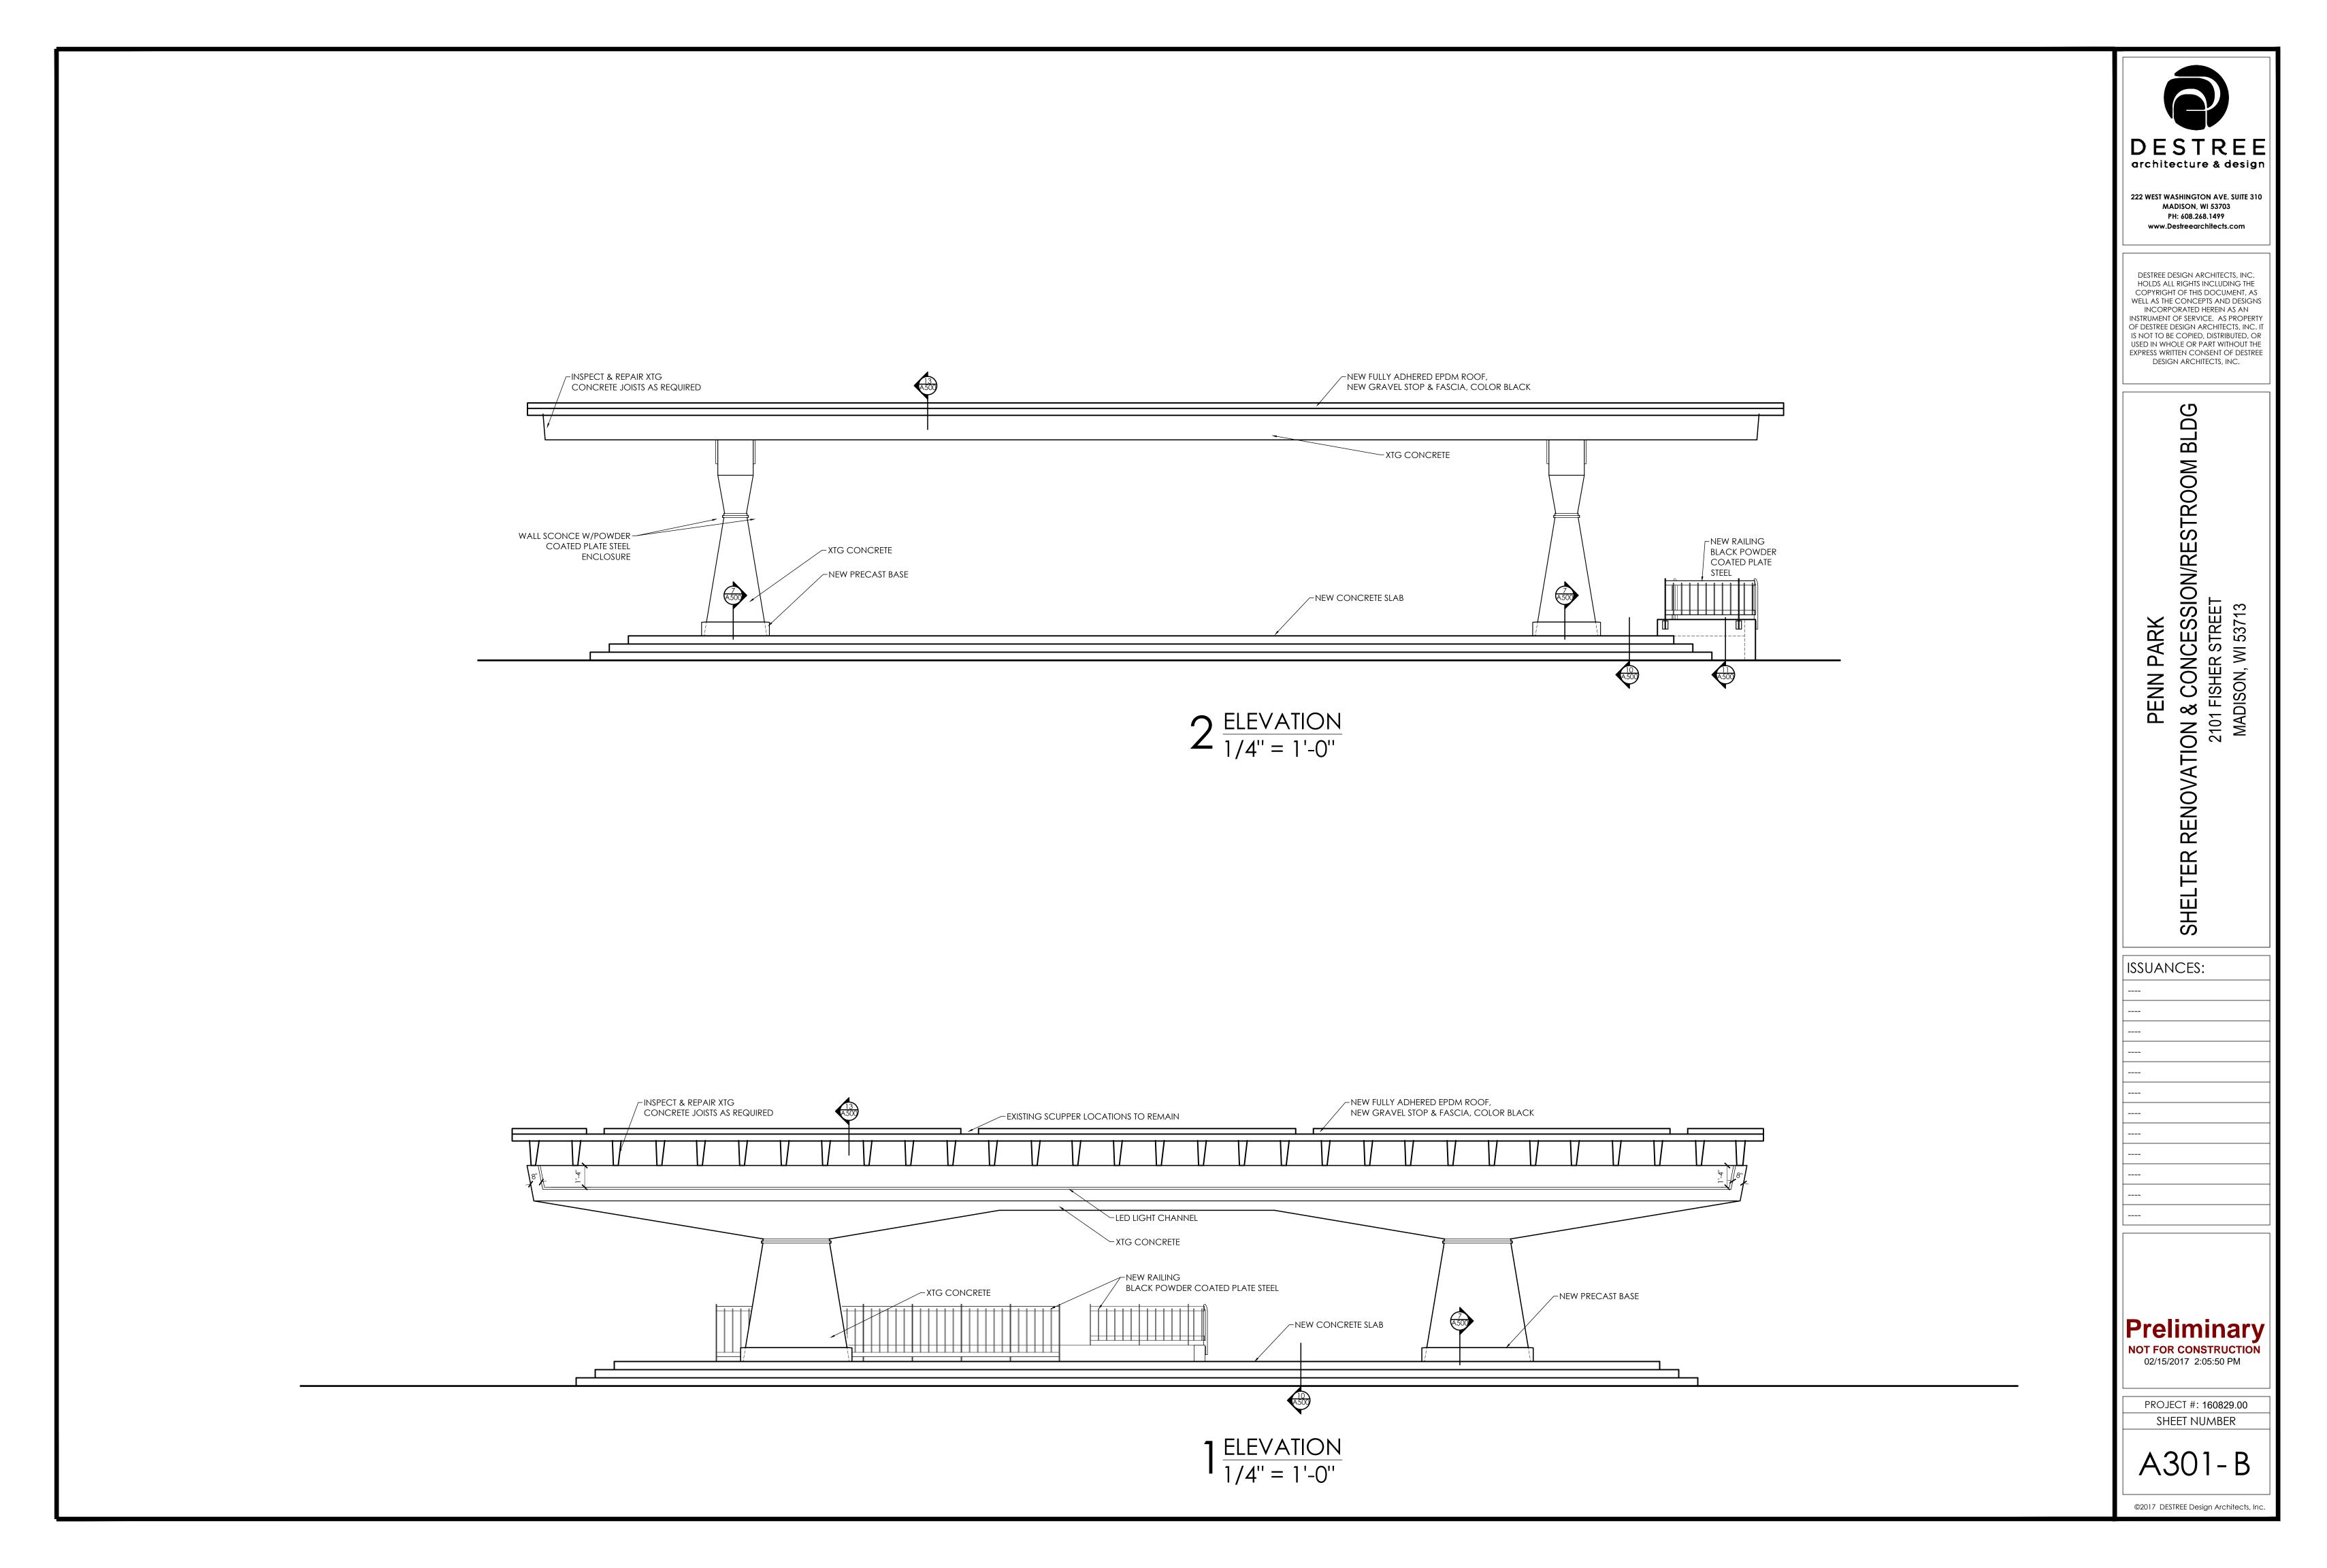

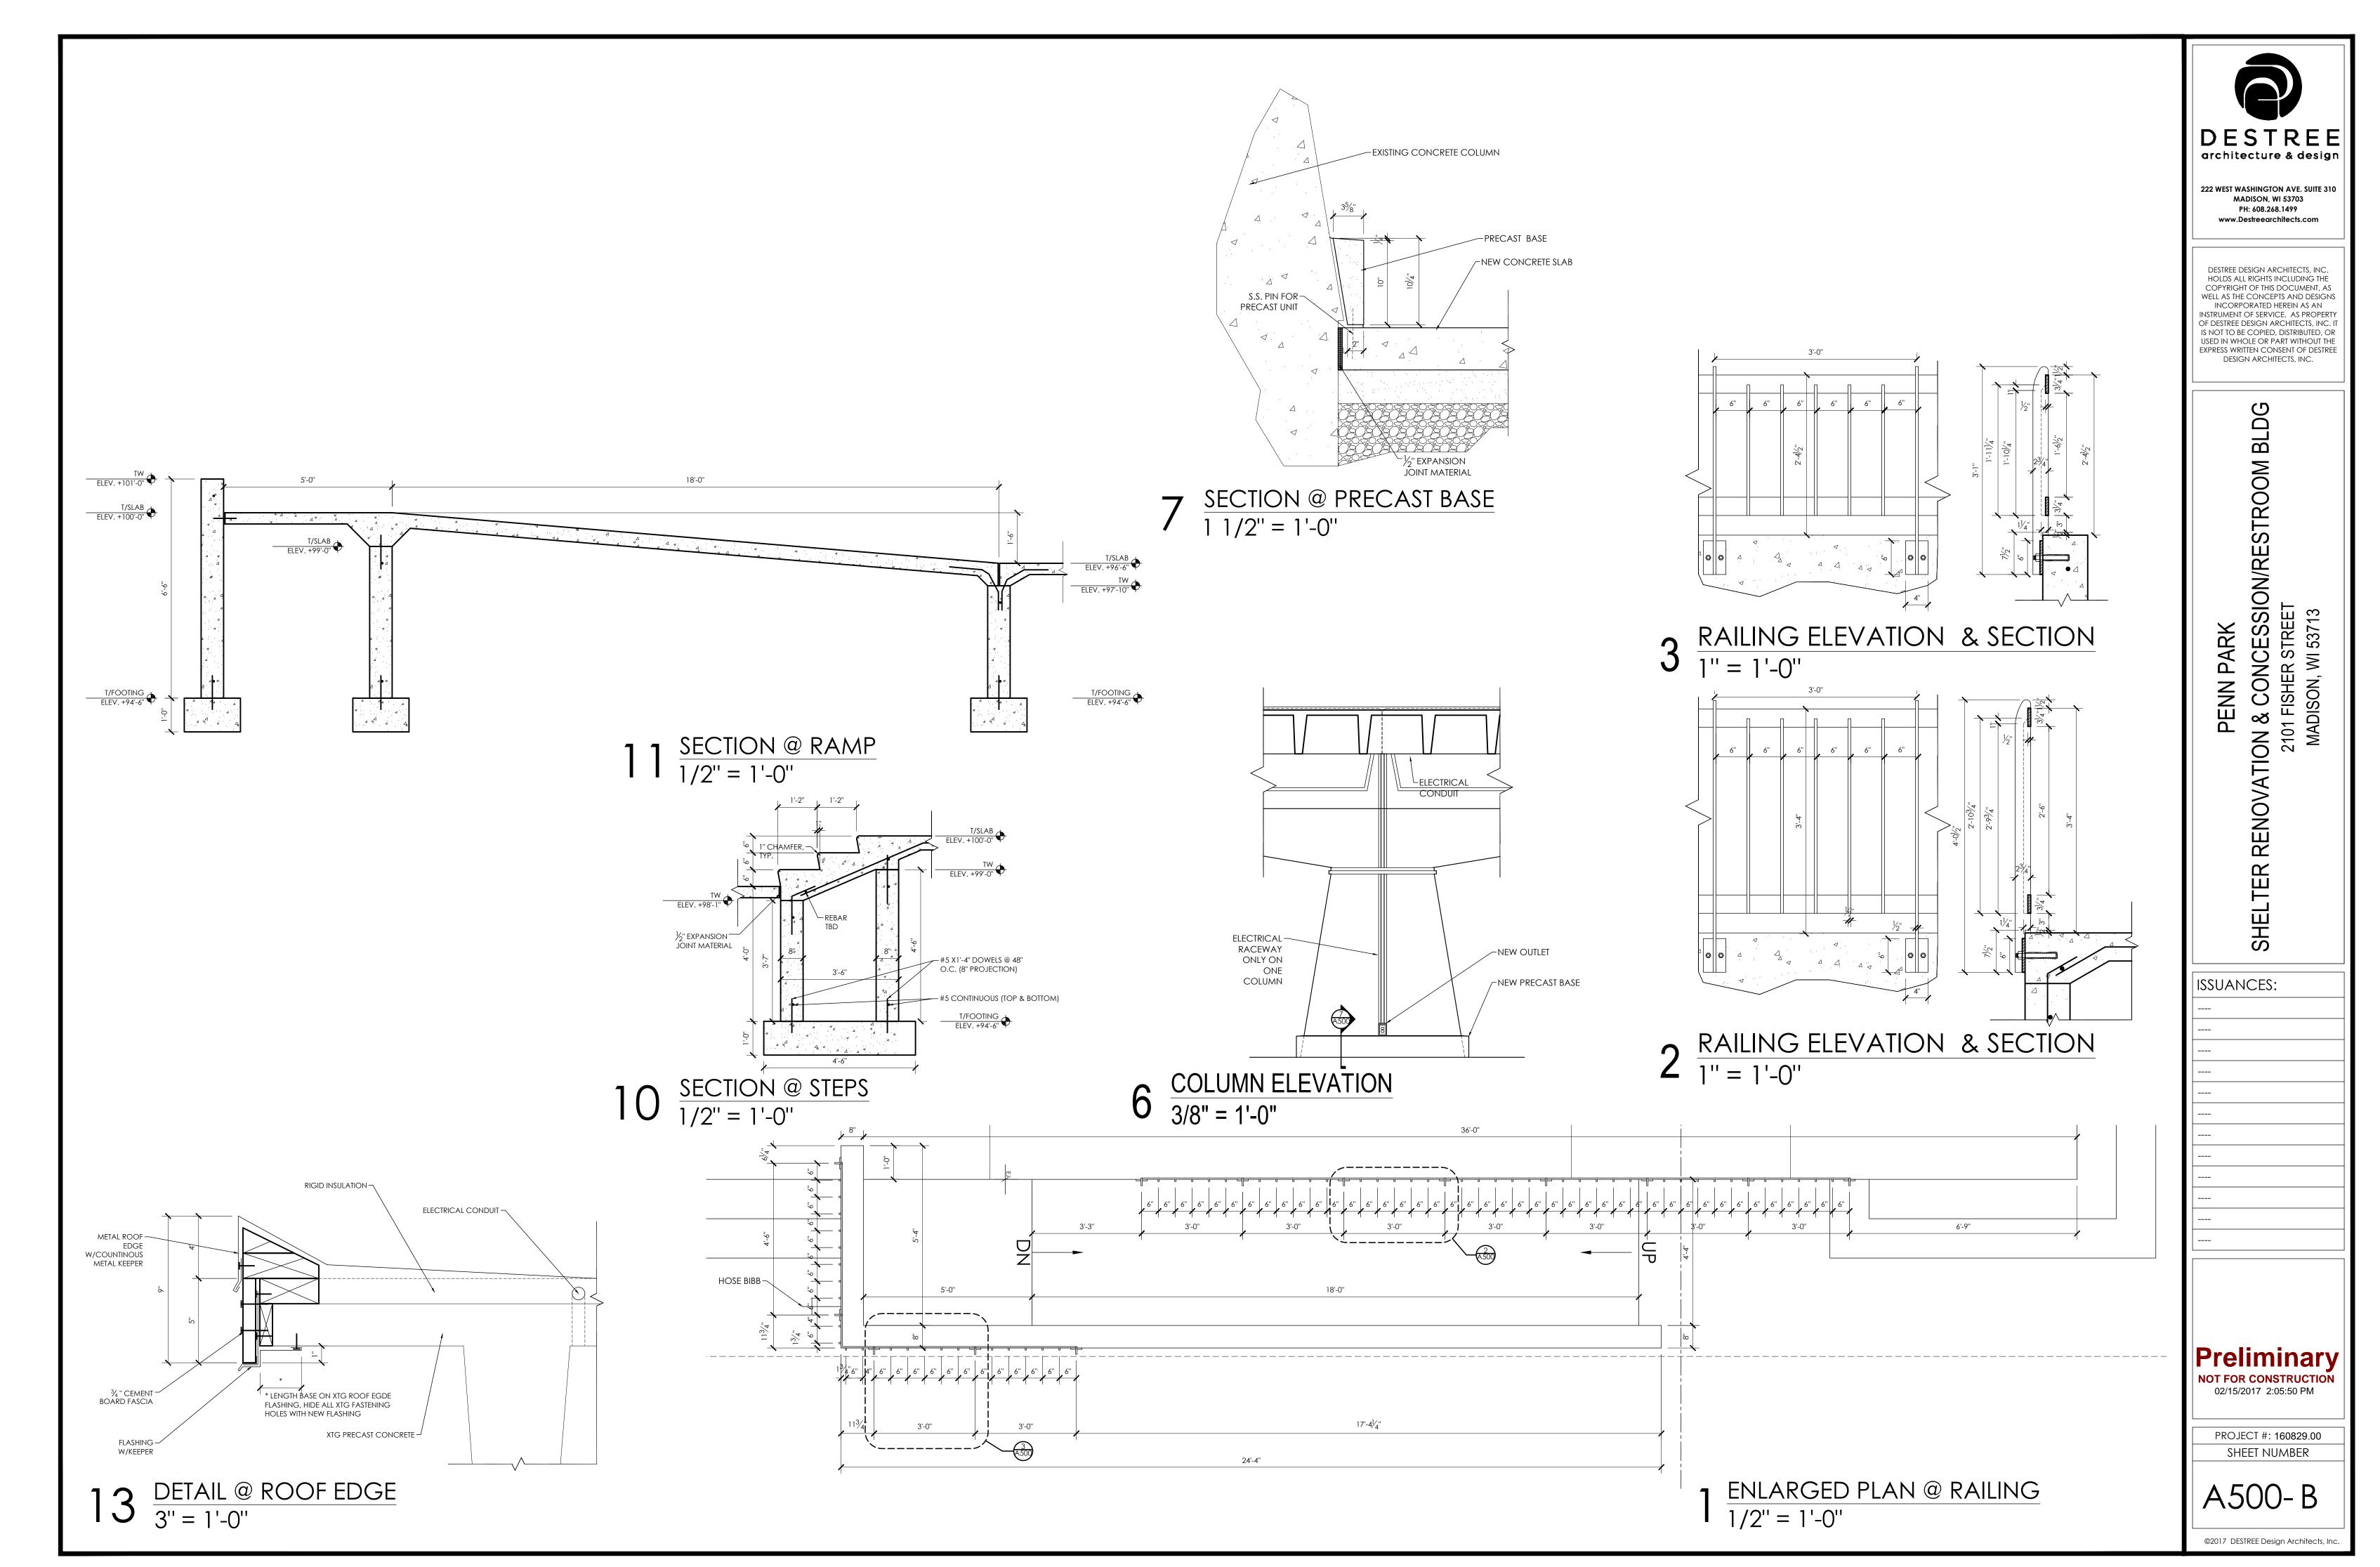

PLOT DATE: 02/15/2017