

URBAN DESIGN COMMISSION APPLICATION CITY OF MADISON

This form may also be completed online at: http://www.cityofmadison.com/planning/documents/UDCapplication.pdf

215 Martin Luther King Jr. Blvd; Room LL-100 PO Box 2985; Madison, Wisconsin 53701-2985 Phone: 608.266.4635 | Facsimile: 608.267.8739

Please complete all sections of the application, including the desired meeting date and the type of action requested.

Date Submitted: January 18, 2017		☐ Informational Presentation
UDC Meeting Date: March 8. 2017		☐ Initial Approval
Combined Schedule Plan Commission Date (if applicable): Marc	h 20, 2017	
Project Address: 1704 Autumn Lake Parkway Project Title (if any): Lot 564 - Village at Autumn L	ake	
2. This is an application for (Check all that apply to this UDC application):	
		evelopment
A. Project Type: Project in an Urban Design District* (public hearing-\$300 fee) Project in the Downtown Core District (DC) or Urban N Suburban Employment Center (SEC) or Campus Instituted Planned Development (PD) General Development Plan (GDP) Specific Implementation Plan (SIP) Planned Multi-Use Site or Planned Residential Comple	Aixed-Use District (UI tional District (CI) or	
B. Signage: Comprehensive Design Review* (public hearing-\$300 fee) Signage Exception(s) in an Urban Design District (public left) C. Other: Please specify:		Variance* (public hearing-\$300 fee)
3. Applicant, Agent & Property Owner Information:		
Applicant Name: Randy Bruce	Company: Knothe &	Bruce Architects, LLC
Street Address: 7601 University Ave., Suite 201	City/State: Middleto	
Telephone:(608) 836-3690 Fax:()	Email: rbruce@knc	
Project Contact Person: Same as applicant		
		7:
Street Address:	City/State:	Zip:
1		
Project Owner (if not applicant): Grosse, Hanzel & Simon and	0	
Street Address: 6650 University Ave.	City/State: Middleto	
Telephone:(608):575-9023 Fax:()	Email: <u>CICKN</u>	anzel@yahoo.com
4. Applicant Declarations: A. Prior to submitting this application, the applicant is required to discuss the application was discussed with DAT Meeting on (name of staff person)		ban Design Commission staff. This
B. The applicant attests that all required materials are included in this submit the application deadline, the application will not be placed on an Urban Desig	tal and understands that it	
Name of Applicant Randy Bruce	Relationship to Property	Architect
Authorized Signature Authorized Signature	Date //8//	7

January 18, 2017

Ms. Heather Stouder
Department of Planning & Development
City of Madison
146 S. Hamilton Street
PO Box 2985
Madison, Wisconsin 53701

Re: Letter of Intent 1704 Autumn Lake Parkway The Village at Autumn Lake – Lot 564 KBA Project # 1644

Ms. Heather Stouder:

The following is submitted together with the plans and application for the staff and Plan Commission's consideration of approval.

Organizational structure:

Owner: Grosse, Hanzel & Simon Architect: Knothe & Bruce Architects, LLC

6650 University Ave.

7601 University Avenue, Ste 201 Middleton, WI 53562

608-575-9023 608-836-3690

Contact: Dick Hanzel

dickhanzel@yahoo.com

Contact: Randy Bruce

rbruce@knothebruce.com

Engineer: D'Onofrio & Kottke Landscape Olson Toon Landscaping, Inc.

 7530 Westward Way
 Design:
 3570 Pioneer Road

 Madison, WI 53717
 Verona, WI 53593

 (608) 833-7530
 (608) 827-9401

 (608) 833-1089 fax
 Contact: Rich Carlson

Contact: Dan Day rich@olsontoon.com
dday@donofrio.cc

Introduction:

The proposed site is Lot 564 of Village of Autumn Lake subdivision, located at the northeast corner of Lien Road and City View Drive in Madison, Wisconsin. This site will be developed along with Lot 520 by development team listed above. The site is zoned CC-T and a conditional-use approval is required to allow the proposed multifamily building complex.

Project Description:

Lot 564 contains 73 apartments and 3,134 S.F. of flex space in two to three-story apartment buildings with underground parking. A one-story clubhouse building and a swimming pool are provided for community social and recreation facilities to serve Lots 564 and 520. The exterior architecture is well articulated, using a combination of stone and horizontal siding to create a moderately dense residential village at the entrance to the Autumn Lake subdivision.

The site is bounded on all four sides by public streets and vehicular access to the site is achieved from two of them: Summer Shine Drive and Willow Rock Road. Underground parking at each building is provided and includes a total of 82 resident parking stalls. An additional 43 parking spaces are located

knothe bruce

Letter of Intent –Conditional Use The Village at Autumn Lake – Lot 564 1704 Autumn Lake Parkway, Madison, WI January 18, 2017 Page 2 of 3

on grade and on-street parking is available to supplement on-site parking. Bicycle parking is dispersed throughout the site with covered bike parking conveniently located in each basement garage.

Building 2 includes the flex-space that faces Autumn Lake Parkway. The flex-space is designed to ultimately accommodate neighborhood-serving office and retail uses. In the near term, this space will be filled with 3 apartments. The exterior architecture provides a commercial facade and with a downsizing of the window openings, can be utilized for the residential use.

Site Development Data:

De	nc	i+i	^ .
<u> </u>	112	ıu	<u>es.</u>

Lot Area 131,856 S.F. / 3.1 Acres

Dwelling Units 73 to 76 DU
Flex-Space 3,134 SF (3 DU's)
Lot Area / D.U. 1,734 to 1,806 SF/unit
Density 24.1 to 25.1 units/acre

Building Height 2 - 3 stories

Lot Coverage 62,865 S.F. = 48% (75% Max.) Usable Open Space 68,991 S.F. (908 SF/DU)

Dwelling Unit Mix:

Efficiency 6

 One Bedroom
 34 to 35

 Two Bedroom
 33 to 35

 Total Dwelling Units
 73 to 76

Vehicle Parking:

Surface43 stallsUnderground80 stallsTotal123 stalls

Ratio I.6 to I.7 stalls/unit

Bicycle Parking:

Surface I4 stalls
Surface Guest 8 stalls
Underground Garage – Wall Hung
Underground Garage STD. 2'x6' 53 stalls
Total 90 stalls

Letter of Intent –Conditional Use The Village at Autumn Lake – Lot 564 1704 Autumn Lake Parkway, Madison, WI January 18, 2017 Page 3 of 3

Project Schedule:

This site (Lot 564) will be constructed and managed as a single development along with the buildings on Lot 520. It is anticipated that the construction on this site will start in summer 2017 with Building I and that the 7 buildings on the two sites will be completed over a 4-year build-out.

Thank you for your time reviewing our proposal.

Sincerely,

Randy Bruce, AIA

December 15, 2016

Alder Samba Baldeh
Alderperson – District # 17
City-County Building
Common Council Office
210 Martin Luther King Jr. Blvd.
Madison, WI 53709-0001



Re: 5501 Spring Tide Way & 1704 Autumn Lane Parkway

Dear Samba,

I understand that you met with Dan Brinkman last week to discuss a proposed development located at 5501 Spring Tide Way & 1704 Autumn Lane Parkway. As a follow up to that discussion, I would like to take this opportunity to formally notify you that we are planning to submit an application for conditional use approval on January 18, 2017.

The proposed development is an apartment community on Lots 520 & 564 of The Village of Autumn Lake Replat. There are a total of approximately 250 apartments, 2,000 square feet of commercial-residential flex-space and common amenities to support the apartment community.

We look forward to working with you to design a successful development for this property. If you have any questions, please contact me at 608-836-3690 or rbruce@knothebruce.com.

Sincerely,

J. Randy Bruce, AIA

Managing Member

From: Baldeh, Samba < district17@cityofmadison.com>

Sent: Thursday, December 15, 2016 11:17 AM

To: Randy Bruce

Cc: Dan Brinkman; Dan Day; Denise Salimes; Greg Held

Subject: Re: Autumn Lake Apartments

Morning Bruce -

Thank you for the letter, I appreciate the updates on this. Please keep me posted and let me know if anything.

Like I said to Dan I am looking forward to working with all of you on this project and hopefully others. Also mentioned to him about affordable units. I totally understand if the project could not accommodation a few in this phase but I just believe that having one or two affordable units will diversity the economic make up of the complex and also serves as give back to a community.

While this totally skip my mind and I did not bring this up to Dan, I generally like to engage neighbors very early on so their input can be factored in designs but this area is not that inhabited yet except to the South East of the proposed project site. I would therefore, like to have an informational session with the neighbors to the south east some time after your January 18th application is finalized.

Please let me know if you have any questions or concerns.

Thank you.

Alder Samba Baldeh MCC - District 17

Email: <u>district17@cityofmadison.com</u> www.cityofmadison.com/council/district17

From: Randy Bruce < RBruce@knothebruce.com > Sent: Thursday, December 15, 2016 10:03 AM

To: Baldeh, Samba

Cc: Dan Brinkman; Dan Day; Denise Salimes; Greg Held

Subject: Autumn Lake Apartments

Samba,

Please see attached letter.

J. Randolph Bruce, AIA I Managing Member I Knothe & Bruce Architects, LLC I Ph: 608.836.3690, ext. 101 7601 University Avenue, Middleton, WI 53562 I rbruce@knothebruce.com

Cree Edge™ Series

LED Area/Flood Luminaire

Product Description

The Cree Edge™ Series has a slim, low profile design. Its rugged cast aluminum housing minimizes wind load requirements and features an integral, weathertight LED driver compartment and high performance aluminum heat sinks. Various mounting choices: Adjustable Arm, Direct Arm, Direct Arm Long, or Side Arm (details on page 2). Includes a leaf/debris guard.

Applications: Parking lots, walkways, campuses, car dealerships, office complexes, and internal roadways

Performance Summary

Patented NanoOptic® Product Technology

Made in the U.S.A. of U.S. and imported parts

CRI: Minimum 70 CRI

CCT: 4000K (+/- 300K), 5700K (+/- 500K) standard

Limited Warranty[†]: 10 years on luminaire/10 years on Colorfast DeltaGuard® finish


†See http://lighting.cree.com/warranty for warranty terms

Accessories

Field-Installed			
Bird Spikes	Backlight Control Shields		
XA-BRDSPK	XA-20BLS-4		
Hand-Held Remote	- Four-pack		
XA-SENSREM	- Unpainted stainless steel		
- For successful implementation of the programmable multi-level	·		
antian a minimum of any hand hald remote is required			

DA Mount



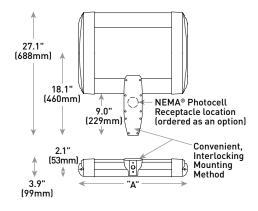

LED Count (x10)	Dim. "A"	Weight
02	12.1" (306mm)	21 lbs. (10kg)
04	12.1" (306mm)	24 lbs. (11kg)
06	14.1" (357mm)	27 lbs. (12kg)
08	16.1" (408mm)	28 lbs. (13kg)
10	18.1" (459mm)	32 lbs. (15kg)
12	20.1" (510mm)	34 lbs. (15kg)
14	22.1" (560mm)	37 lbs. (17kg)
16	24.1" (611mm)	41 lbs. (19kg)

AA/DL/SA Mount - see page 22 for weight & dimensions

Ordering Information

Example: ARE-EDG-2M-AA-12-E-UL-SV-350

						E				
Product	Optic			Mounting*	LED Count (x10)	Series	Voltage	Color Options	Drive Current	Options
ARE- EDG	ZM Type II Medium ZMB Type II Medium WBLS ZMP Type II Medium W/BAS ZMP Type II Medium M/Partial BLS 3M Type III Medium 25 25° Flood	3MB Type III Medium w/BLS 3MP Type III Medium w/Partial BLS 4M Type IV Medium 4MB Type IV Medium w/BLS 70 70* Flood	Type IV Medium W/Partial BLS 5M Type V Medium 5S Type V Short	AA Adjustable Arm DA Direct Arm DL Direct Long Arm SA Side Arm - Available with 20-60 LEDs	02 04 06 08 10 12 14	E	UL Universal 120-277V UH Universal 347-480V	BK Black BZ Bronze SV Silver WH White	350 350mA 525 525mA 700 700mA - Available with 20- 60 LEDs	DIM 0-10V Dimming - Control by others - Refer to Dimming spec. sheet for details - Can't exceed specified drive current F Fuse - Refer to ML spec sheet for availability with ML options - Available with UL voltage only - When code dictates fusing, use time delay fuse HL Hi/Low [Dual Circuit Input] - Refer to HL spec sheet for details - Sensor not included ML Multi-Level - Refer to ML spec sheet for details - Sensor not included ML Multi-Level - Refer to ML spec sheet for details - Sensor mot included ML Multi-Level - Refer to ML spec sheet for details - Con't exceed specified drive current - Refer to ML spec sheet for details - Sensor not included ML Multi-Level - Refer to ML spec sheet for details - Con't exceed specified drive current - Refer to ML spec sheet for details - Sensor not included - Refer to ML spec sheet for details - Con't exceed specified drive current - Refer to ML spec sheet for details - Refer to ML spec sheet for applications with maximum details - Refer to ML spec sheet for availability with ML options
	40 40° Flood	SN Sign								- Intended for downlight applications at 0° tilt - Color temperature per luminaire - Refer to ML spec sheet for availability with ML options - Available with UL voltage only

^{*} Reference EPA and pole configuration suitability data beginning on page 19 NOTE: Price adder may apply depending on configuration






Rev. Date: V3 08/03/2016




All published luminaire photometric testing performed to IESNA LM-79-08 standards by a NVLAP accredited laboratory. To obtain an IES file specific to your project consult: http://lighting.cree.com/products/outdoor/area/cree-edge-series-1

3ME

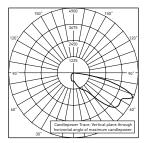

CSA Test Report #: 6448 ARE-EDG-3MB-**-06-E-UL-700 Initial Delivered Lumens: 7,740

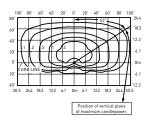

ARE-EDG-3MB-**-12-E-UL-525-40K Mounting Height: 25' (7.6m) A.F.G. Initial Delivered Lumens: 12,420 Initial FC at grade


Type III Medium Distribution w/BLS					
	4000K		5700K		
LED Count (x10)	Initial Delivered Lumens*	BUG Ratings** Per TM-15-11	Initial Delivered Lumens*	BUG Ratings** Per TM-15-11	
350mA					
02	1,499	B1 U0 G1	1,557	B1 U0 G1	
04	2,999	B1 U0 G1	3,114	B1 U0 G1	
06	4,446	B1 U0 G1	4,617	B1 U0 G1	
08	5,929	B1 U0 G2	6,157	B1 U0 G2	
10	7,393	B1 U0 G2	7,677	B1 U0 G2	
12	8,872	B1 U0 G2	9,213	B1 U0 G2	
14	10,285	B1 U0 G2	10,680	B1 U0 G2	
16	11,754	B1 U0 G3	12,206	B1 U0 G3	
525mA					
02	2,099	B1 U0 G1	2,180	B1 U0 G1	
04	4,198	B1 U0 G1	4,359	B1 U0 G1	
06	6,225	B1 U0 G2	6,464	B1 U0 G2	
08	8,300	B1 U0 G2	8,619	B1 U0 G2	
10	10,350	B1 U0 G2	10,748	B1 U0 G2	
12	12,420	B1 U0 G3	12,898	B1 U0 G3	
14	14,398	B1 U0 G3	14,952	B2 U0 G3	
16	16,455	B2 U0 G3	17,088	B2 U0 G3	
700mA					
02	2,564	B1 U0 G1	2,662	B1 U0 G1	
04	5,127	B1 U0 G2	5,325	B1 U0 G2	
06	7,603	B1 U0 G2	7,896	B1 U0 G2	

^{*} Initial delivered lumens at 25°C (77°F). Actual production yield may vary between -10 and +10% of initial delivered lumens


lumens
** For more information on the IES BUG (Backlight-Uplight-Glare) Rating visit: www.ies.org/PDF/Erratas/TM-1511BugRatingsAddendum.pdf. Valid with no tilt

All published luminaire photometric testing performed to IESNA LM-79-08 standards by a NVLAP accredited laboratory. To obtain an IES file specific to your project consult: http://lighting.cree.com/products/outdoor/area/cree-edge-series-1

4M

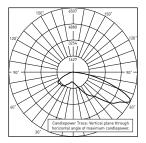

CSA Test Report #: 6438 ARE-EDG-4M-**-06-E-UL-700-40K Initial Delivered Lumens: 11,367

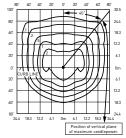


ARE-EDG-4M-**-12-E-UL-525-40K Mounting Height: 25' [7.6m] A.F.G. Initial Delivered Lumens: 17,710 Initial FC at grade

Type IV Medium Distribution								
	4000K		5700K					
LED Count (x10)	Initial Delivered Lumens*	BUG Ratings** Per TM-15-11	Initial Delivered Lumens*	BUG Ratings** Per TM-15-11				
350mA								
02	2,138	B1 U0 G1	2,220	B1 U0 G1				
04	4,276	B1 U0 G1	4,440	B1 U0 G1				
06	6,340	B2 U0 G2	6,584	B2 U0 G2				
08	8,454	B2 U0 G2	8,779	B2 U0 G2				
10	10,542	B2 U0 G2	10,947	B2 U0 G2				
12	12,650	B3 U0 G3	13,137	B3 U0 G3				
14	14,665	B3 U0 G3	15,229	B3 U0 G3				
16	16,760	B3 U0 G3	17,405	B3 U0 G3				
525mA								
02	2,993	B1 U0 G1	3,108	B1 U0 G1				
04	5,986	B2 U0 G1	6,216	B2 U0 G2				
06	8,876	B2 U0 G2	9,218	B2 U0 G2				
08	11,835	B2 U0 G2	12,290	B3 U0 G3				
10	14,759	B3 U0 G3	15,326	B3 U0 G3				
12	17,710	B3 U0 G3	18,391	B3 U0 G3				
14	20,531	B3 U0 G3	21,321	B3 U0 G3				
16	23,464	B3 U0 G3	24,367	B4 U0 G3				
700mA								
02	3,656	B1 U0 G1	3,796	B1 U0 G1				
04	7,311	B2 U0 G2	7,593	B2 U0 G2				
06	10,842	B2 U0 G2	11,259	B2 U0 G2				


^{*} Initial delivered lumens at 25°C (77°F). Actual production yield may vary between -10 and +10% of initial delivered

lumens
** For more information on the IES BUG (Backlight-Uplight-Glare) Rating visit: www.ies.org/PDF/Erratas/TM-1511BugRatingsAddendum.pdf. Valid with no tilt

All published luminaire photometric testing performed to IESNA LM-79-08 standards by a NVLAP accredited laboratory. To obtain an IES file specific to your project consult: http://lighting.cree.com/products/outdoor/area/cree-edge-series-1

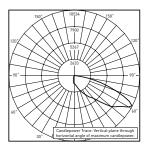

CSA Test Report #: 6449 ARE-EDG-4MB-**-12-E-UL-525-40K Initial Delivered Lumens: 13,155

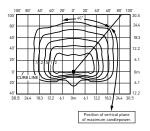

ARE-EDG-4MB-**-12-E-UL-525-40K Mounting Height: 25' [7.6m] A.F.G. Initial Delivered Lumens: 13,340 Initial FC at grade


Type IV Medium Distribution w/BLS							
	4000K		5700K				
LED Count (x10)	Initial Delivered Lumens*	BUG Ratings** Per TM-15-11	Initial Delivered Lumens*	BUG Ratings** Per TM-15-11			
350mA							
02	1,610	B0 U0 G1	1,672	B0 U0 G1			
04	3,221	B1 U0 G1	3,345	B1 U0 G1			
06	4,776	B1 U0 G1	4,959	B1 U0 G1			
08	6,368	B1 U0 G2	6,613	B1 U0 G2			
10	7,941	B1 U0 G2	8,246	B1 U0 G2			
12	9,529	B1 U0 G2	9,895	B1 U0 G2			
14	11,046	B1 U0 G2	11,471	B1 U0 G2			
16	12,624	B1 U0 G2	13,110	B1 U0 G2			
525mA							
02	2,254	B0 U0 G1	2,341	B0 U0 G1			
04	4,509	B1 U0 G1	4,682	B1 U0 G1			
06	6,686	B1 U0 G2	6,943	B1 U0 G2			
08	8,915	B1 U0 G2	9,258	B1 U0 G2			
10	11,117	B1 U0 G2	11,544	B1 U0 G2			
12	13,340	B1 U0 G2	13,853	B2 U0 G2			
14	15,465	B2 U0 G2	16,060	B2 U0 G3			
16	17,674	B2 U0 G3	18,354	B2 U0 G3			
700mA							
02	2,754	B0 U0 G1	2,860	B0 U0 G1			
04	5,507	B1 U0 G1	5,719	B1 U0 G2			
06	8,167	B1 U0 G2	8,481	B1 U0 G2			

^{*} Initial delivered lumens at 25° C (77° F). Actual production yield may vary between -10 and +10% of initial delivered

lumens


** For more information on the IES BUG (Backlight-Uplight-Glare) Rating visit: www.ies.org/PDF/Erratas/TM-1511BugRatingsAddendum.pdf. Valid with no tilt

AA Mount

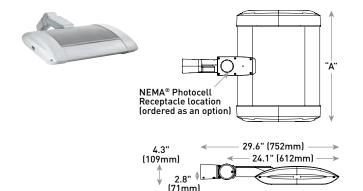


LED Count (x10)	Dim. "A"	Weight
02	12.1" (306mm)	21 lbs. (10kg)
04	12.1" (306mm)	24 lbs. (11kg)
06	14.1" (357mm)	27 lbs. (12kg)
08	16.1" (408mm)	28 lbs. (13kg)
10	18.1" (459mm)	32 lbs. (15kg)
12	20.1" (510mm)	34 lbs. (15kg)
14	22.1" (560mm)	37 lbs. (17kg)
16	24.1" (611mm)	41 lbs. (19kg)

DL Mount

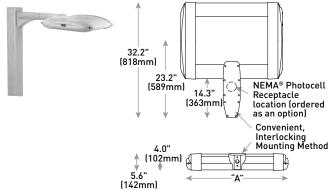

LED Count (x10)	Dim. "A"	Weight
02	12.1" (306mm)	23 lbs. (10kg)
04	12.1" (306mm)	26 lbs. (12kg)
06	14.1" (357mm)	29 lbs. (13kg)
08	16.1" (408mm)	30 lbs. (14kg)
10	18.1" (459mm)	34 lbs. (15kg)
12	20.1" (510mm)	36 lbs. (16kg)
14	22.1" (560mm)	42 lbs. (19kg)
16	24.1" (611mm)	44 lbs. (20kg)

SA Mount

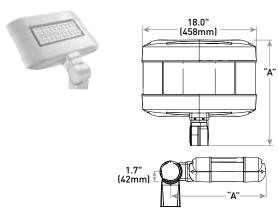

LED Count (x10)	Dim. "A"	Weight
02	16.0" (406mm)	25 lbs. (11kg)
04	18.0" (457mm)	26 lbs. (12kg)
06	20.0" (508mm)	28 lbs. (13kg)

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Cree Edge™ Series

LED High Output Area/Flood Luminaire featuring Cree TrueWhite® Technology

Product Description

The Cree Edge™ High Output Area/Flood luminaire is designed to deliver high lumen packages with precise optical control. The unit features a slim, low profile design that minimizes wind load and a rugged die cast aluminum adjustable arm that mounts to a horizontal or vertical 2" [51mm] IP, 2.375-2.50" (60-64mm) 0.D. steel tenon. Tenon length must be a minimum of 3.75" (95mm). The direct mount bracket accessory allows for further mounting flexibility. Available with Cree TrueWhite® Technology, the Cree Edge™ High Output helps to beautifully render true colors and deliver value beyond energy savings.

Applications: Auto dealerships, parking lots, campuses, facade lighting, high-mast and general site lighting applications

Performance Summary

Utilizes Cree TrueWhite® Technology on 5000K Luminaires

Patented NanoOptic® Product Technology

Made in the U.S.A. of U.S. and imported parts

CRI: Minimum 70 CRI (4000K & 5700K); 90 CRI (5000K)

CCT: 4000K (+/- 300K), 5000K (+/- 300K), 5700K (+/- 500K) standard

Limited Warranty[†]: 10 years on luminaire/10 years on Colorfast DeltaGuard[®] finish

Accessories


Field-Installed		
Bird Spikes XA-BRDSPKXAK12	Backlight Control Shields XA-30BLS-4	
- 120 LED XA-BRDSPKXAK24	- Four-pack for 120 LED - Unpainted stainless steel	
- 240 LED	XA-30BLS-8 - Eight-pack for 240 LED - Unpainted stainless steel	



HV Mount (shown in horizontal position)




120 LED

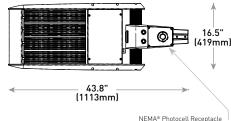

NEMA® Photocell Receptacle location (ordered as an option)

240 LED

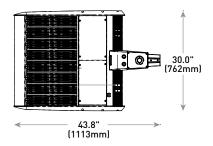

LED Count (x10)	Weight
12	45.3 lbs. (20.5kg)
24	80.5 lbs. (36.5kg)

HV Mount (shown in Vertical position)Direct Mount Bracket- see page 13 for weight & dimensions

Ordering Information

Example: ARE-EH0-2M-HV-12-E-UL-SV-700

				н٧		E						
Product	Optic			Mounting	LED Count (x10)	Series	Voltage	Color Options	Drive Current	Options		
ARE- EHO	2M Type II Medium 2MB Type II Medium w/BLS 3M Type III Medium	3MB Type III Medium w/BLS 4M Type IV Medium 4MB Type IV Medium w/BLS	5M Type V Medium 5S Type V Short AF Automotive Frontline- Optic™	HV Horizontal/ Vertical Tenon - For EHO-UNV direct mount bracket, refer to Tenons & Brackets on page 12	12 24	E	UL Universal 120-277V UH Universal 347-480V	BK Black BZ Bronze SV Silver WH White	700 700mA 1000 1000mA	DIM 0-10V Dimming - Control by others - Refer to Dimming spec sheet for details - Can't exceed specified drive current F Fuse - When code dictates fusing, use time delay fuse - Refer to ML spec sheet for availability with ML options - Not available with UH voltage		
FLD- EHO	15° Flood 25° 25° Flood	40 40° Flood 70 70° Flood	SN Sign N6 NEMA® 6							ML Multi-Level - Refer to ML spec sheet for details - Intended for downlight applications at 0° tilt - Not available with UH voltage or 240 LEDs with 1000mA drive current - Winimum 70 CRI - Color temperature per luminaire 50K 500K Color Temperature - Minimum 90 CRI - Utilizes Cree TrueWhite® Technology - Color temperature		

NOTE: Price adder may apply depending on configuration












Rev. Date: V7 05/20/2016




^{*}See http://lighting.cree.com/warranty for warranty terms

All published luminaire photometric testing performed to IESNA LM-79-08 standards by a NVLAP accredited laboratory. To obtain an IES file specific to your project consult: www.cree.com/Lighting/Tools-and-Support/Exterior-IES-Configuration-Tool

4M

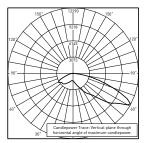

ITL Test Report #: 77685 ARE-EHO-4M-**-12--E-UL-700-50K Initial Delivered Lumens: 19,507

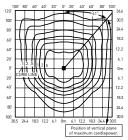


ARE-EHO-4M-**-24--E-UL-1000-40K Mounting Height: 25' (7.6m) A.F.G. Initial Delivered Lumens: 61,352 Initial FC at grade


Type IV Medium Distribution									
	4000K		5000K		5700K				
LED Count (x10)	Initial Delivered Lumens* BUG Ratings** Per TM-15-11		Initial Delivered Lumens* BUG Ratings** Per TM-15-11		Initial Delivered Lumens*	BUG Ratings** Per TM-15-11			
700mA	700mA								
12	22,829	B3 U1 G3	18,088	B3 U1 G3	23,707	B3 U1 G3			
24	45,687	B5 U1 G4	36,199	B4 U1 G4	47,445	B5 U1 G4			
1000mA									
12	30,656	B4 U1 G4	24,289	B3 U1 G3	31,835	B4 U1 G4			
24	61,352	B5 U1 G5	48,609	B5 U1 G5	63,711	B5 U1 G5			

^{*} Initial delivered lumens at 25°C (77°F). Actual production yield may vary between -10 and +10% of initial delivered lumens

4MB

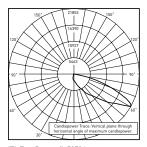

ITL Test Report #: 78734 ARE-EHO-4MB-**-12-E-UL-1000-40K Initial Delivered Lumens: 25,113

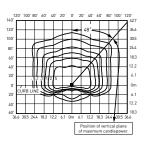

ARE-EH0-4MB-**-24-E-UL-1000-40K Mounting Height: 25' (7.6m) A.F.G. Initial Delivered Lumens: 46,213 Initial FC at grade

Type IV Medium w/BLS Distribution								
	4000K		5000K		5700K			
LED Count (x10)	Initial Delivered Lumens*	BUG Ratings** Per TM-15-11	Initial Delivered Lumens* BUG Ratings** Per TM-15-11		Initial Delivered Lumens*	BUG Ratings** Per TM-15-11		
700mA								
12	17,196	B2 U1 G3	13,625	B1 U1 G2	17,857	B2 U1 G3		
24	34,414	B2 U1 G4	27,266	B2 U1 G4	35,738	B3 U1 G4		
1000mA	1000mA							
12	23,092	B2 U1 G3	18,296	B2 U1 G3	23,980	B2 U1 G4		
24	46,213	B3 U1 G5	36,615	B3 U1 G4	47,990	B3 U1 G5		

^{*} Initial delivered lumens at 25°C (77°F). Actual production yield may vary between -10 and +10% of initial delivered

^{**} For more information on the IES BUG (Backlight-Uplight-Glare) Rating visit: www.ies.org/PDF/Erratas/TM-15-11BugRatingsAddendum.pdf. Valid with no tilt

tumens

** For more information on the IES BUG (Backlight-Uplight-Glare) Rating visit:


www.ies.org/PDF/Erratas/TM-15-11BugRatingsAddendum.pdf. Valid with no tilt

HV Mount (shown in vertical position) 120 LED 16.5" [419mm] 240 LED 33.6" [853mm] 30.0" [762mm]

Direct Mount Bracket (accessory sold separately)

120 LED

33.6" (853mm)

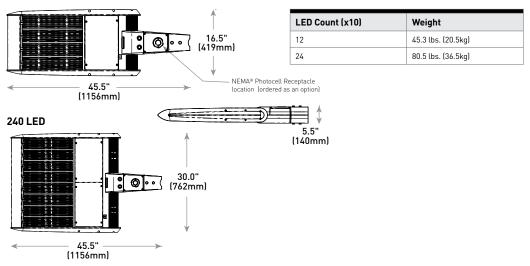

Weight

45.3 lbs. (20.5kg)

80.5 lbs. (36.5kg)

Cree Edge™ Series

LED Security Wall Pack Luminaire

Product Description

The Cree Edge™ wall mount luminaire has a slim, low profile design. The luminaire end caps are made from rugged die cast aluminum with integral, weathertight LED driver compartments and high performance aluminum heat sinks specifically designed for LED applications. Housing is rugged aluminum. Includes a lightweight mounting box for installation over standard and mud ring single gang J-Boxes. Secures to wall with four 3/16" (5mm) screws (by others). Conduit entry from top, bottom, sides and rear. Allows mounting for uplight or downlight. Designed and approved for easy through-wiring. Includes leaf/debris guard.

Applications: General area and security lighting



Patented NanoOptic® Product Technology

Made in the U.S.A. of U.S. and imported parts

CRI: Minimum 70 CRI

CCT: 4000K (+/- 300K), 5700K (+/- 500K) standard


Limited Warranty[†]: 10 years on luminaire/10 years on Colorfast DeltaGuard® finish

†See http://lighting.cree.com/warranty for warranty terms

Accessories

Field-Installed	
Bird Spikes	Hand-Held Remote
XA-BRDSPK	XA-SENSREM
	 For successful implementation of the programmable multi-level option, a minimum of one hand-held remote is required



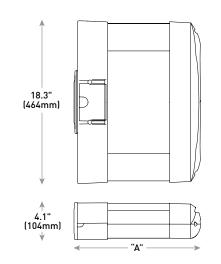

LED Count (x10)	Dim. "A"	Weight
02	9.9" (251mm)	20 lbs. (9.1kg)
04	11.9" (303mm)	22 lbs. (10.0kg)
06	13.9" (353mm)	25 lbs. (11.3kg)
08	15.9" (404mm)	27 lbs. (12.2kg)
10	17.9" (455mm)	31 lbs. (14.1kg)
12	19.9" (505mm)	32 lbs. (14.5kg)

Ordering Information

Example: SEC-EDG-2M-WM-06-E-UL-SV-700

SEC-EDG		WM		E				
Product	Optic	Mounting	LED Count (x10)	Series	Voltage	Color Options	Drive Current	Options
SEC-EDG	2M Type II Medium 2MB Type II Medium w/BLS 2S Type II Short 2SB Type II Short w/BLS 3M Type III Medium 3MB Type III Medium w/BLS 4M Type IV Medium 4MB Type IV Medium w/BLS	WM Wall Mount	02 04 06 08 10 12	Е	UL Universal 120-277V UH Universal 347-480V 34 347V	BK Black BZ Bronze SV Silver WH White	350 350mA 525 525mA -Available with 20-80 LEDs 700 700mA -Available with 20-60 LEDs	DIM 0-10V Dimming - Control by others - Refer to Dimming spec sheet for details - Can't exceed specified drive current F Fuse - Refer to ML spec sheet for availability with ML options - Available with UL voltage only - When code dictates fusing, use time delay fuse ML Multi-Level - Refer to ML spec sheet for details - Intended for downlight applications of 0° tilt P Photocell - Refer to ML spec sheet for availability with ML options - Must specify UL or 34 voltage PML Programmable Multi-Level - Refer to PML spec sheet for details - Intended for downlight applications of 0° tilt 40K 4000K Color Temperature - Minimum 70 CRI - Color temperature per luminaire









Rev. Date: V2 07/28/2016




All published luminaire photometric testing performed to IESNA LM-79-08 standards by a NVLAP accredited laboratory. To obtain an IES file specific to your project consult: http://lighting.cree.com/products/outdoor/wall-mount/cree-edge-series-5

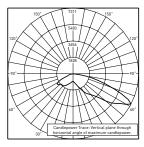

ITL Test Report #: 78793 SEC-EDG-4M-**-06-E-UL-700-40K Initial Delivered Lumens: 11,607

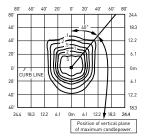


SEC-EDG-4M-**-08-E-UL-525-40K Mounting Height: 10' (3.0m) A.F.G. Initial Delivered Lumens: 11,835 Initial FC at grade

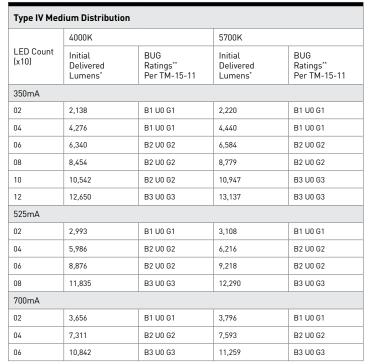

4MB

CSA Test Report #: 6449 ARE-EDG-4MB-**-12-E-UL-525-40K Initial Delivered Lumens: 13,155

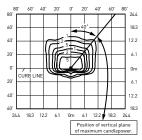

SEC-EDG-4MB-**-08-E-UL-525-40K Mounting Height: 10' (3.0m) A.F.G. Initial Delivered Lumens: 8,915 Initial FC at grade

Type IV Medium Distribution w/BLS							
	4000K		5700K				
LED Count (x10)	Initial Delivered Lumens*	BUG Ratings** Per TM-15-11	Initial Delivered Lumens*	BUG Ratings** Per TM-15-11			
350mA							
02	1,610	B0 U0 G1	1,672	B0 U0 G1			
04	3,221	B1 U0 G1	3,345	B1 U0 G1			
06	4,776	B1 U0 G1	4,959	B1 U0 G1			
08	6,368	B1 U0 G2	6,613	B1 U0 G2			
10	7,941	B1 U0 G2	8,246	B1 U0 G2			
12	9,529	B1 U0 G2	9,895	B1 U0 G2			
525mA							
02	2,254	B0 U0 G1	2,341	B0 U0 G1			
04	4,509	B1 U0 G1	4,682	B1 U0 G1			
06	6,686	B1 U0 G2	6,943	B1 U0 G2			
08	8,915	B1 U0 G2	9,258	B1 U0 G2			
700mA							
02	2,754	B0 U0 G1	2,860	B0 U0 G1			
04	5,507	B1 U0 G1	5,719	B1 U0 G2			
06	8,167	B1 U0 G2	8,481	B1 U0 G2			


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Initial delivered lumens at 25°C (77°F)
 For more information on the IES BUG (Backlight-Uplight-Glare) Rating visit: www.ies.org/PDF/Erratas/TM-15-11BugRatingsAddendum.pdf

^{*} Initial delivered lumens at 25°C (77°F)

** For more information on the IES BUG (Backlight-Uplight-Glare) Rating visit: www.ies.org/PDF/Erratas/TM-15-11BugRatingsAddendum.pdf




C-1.0PROJECT NO. 164
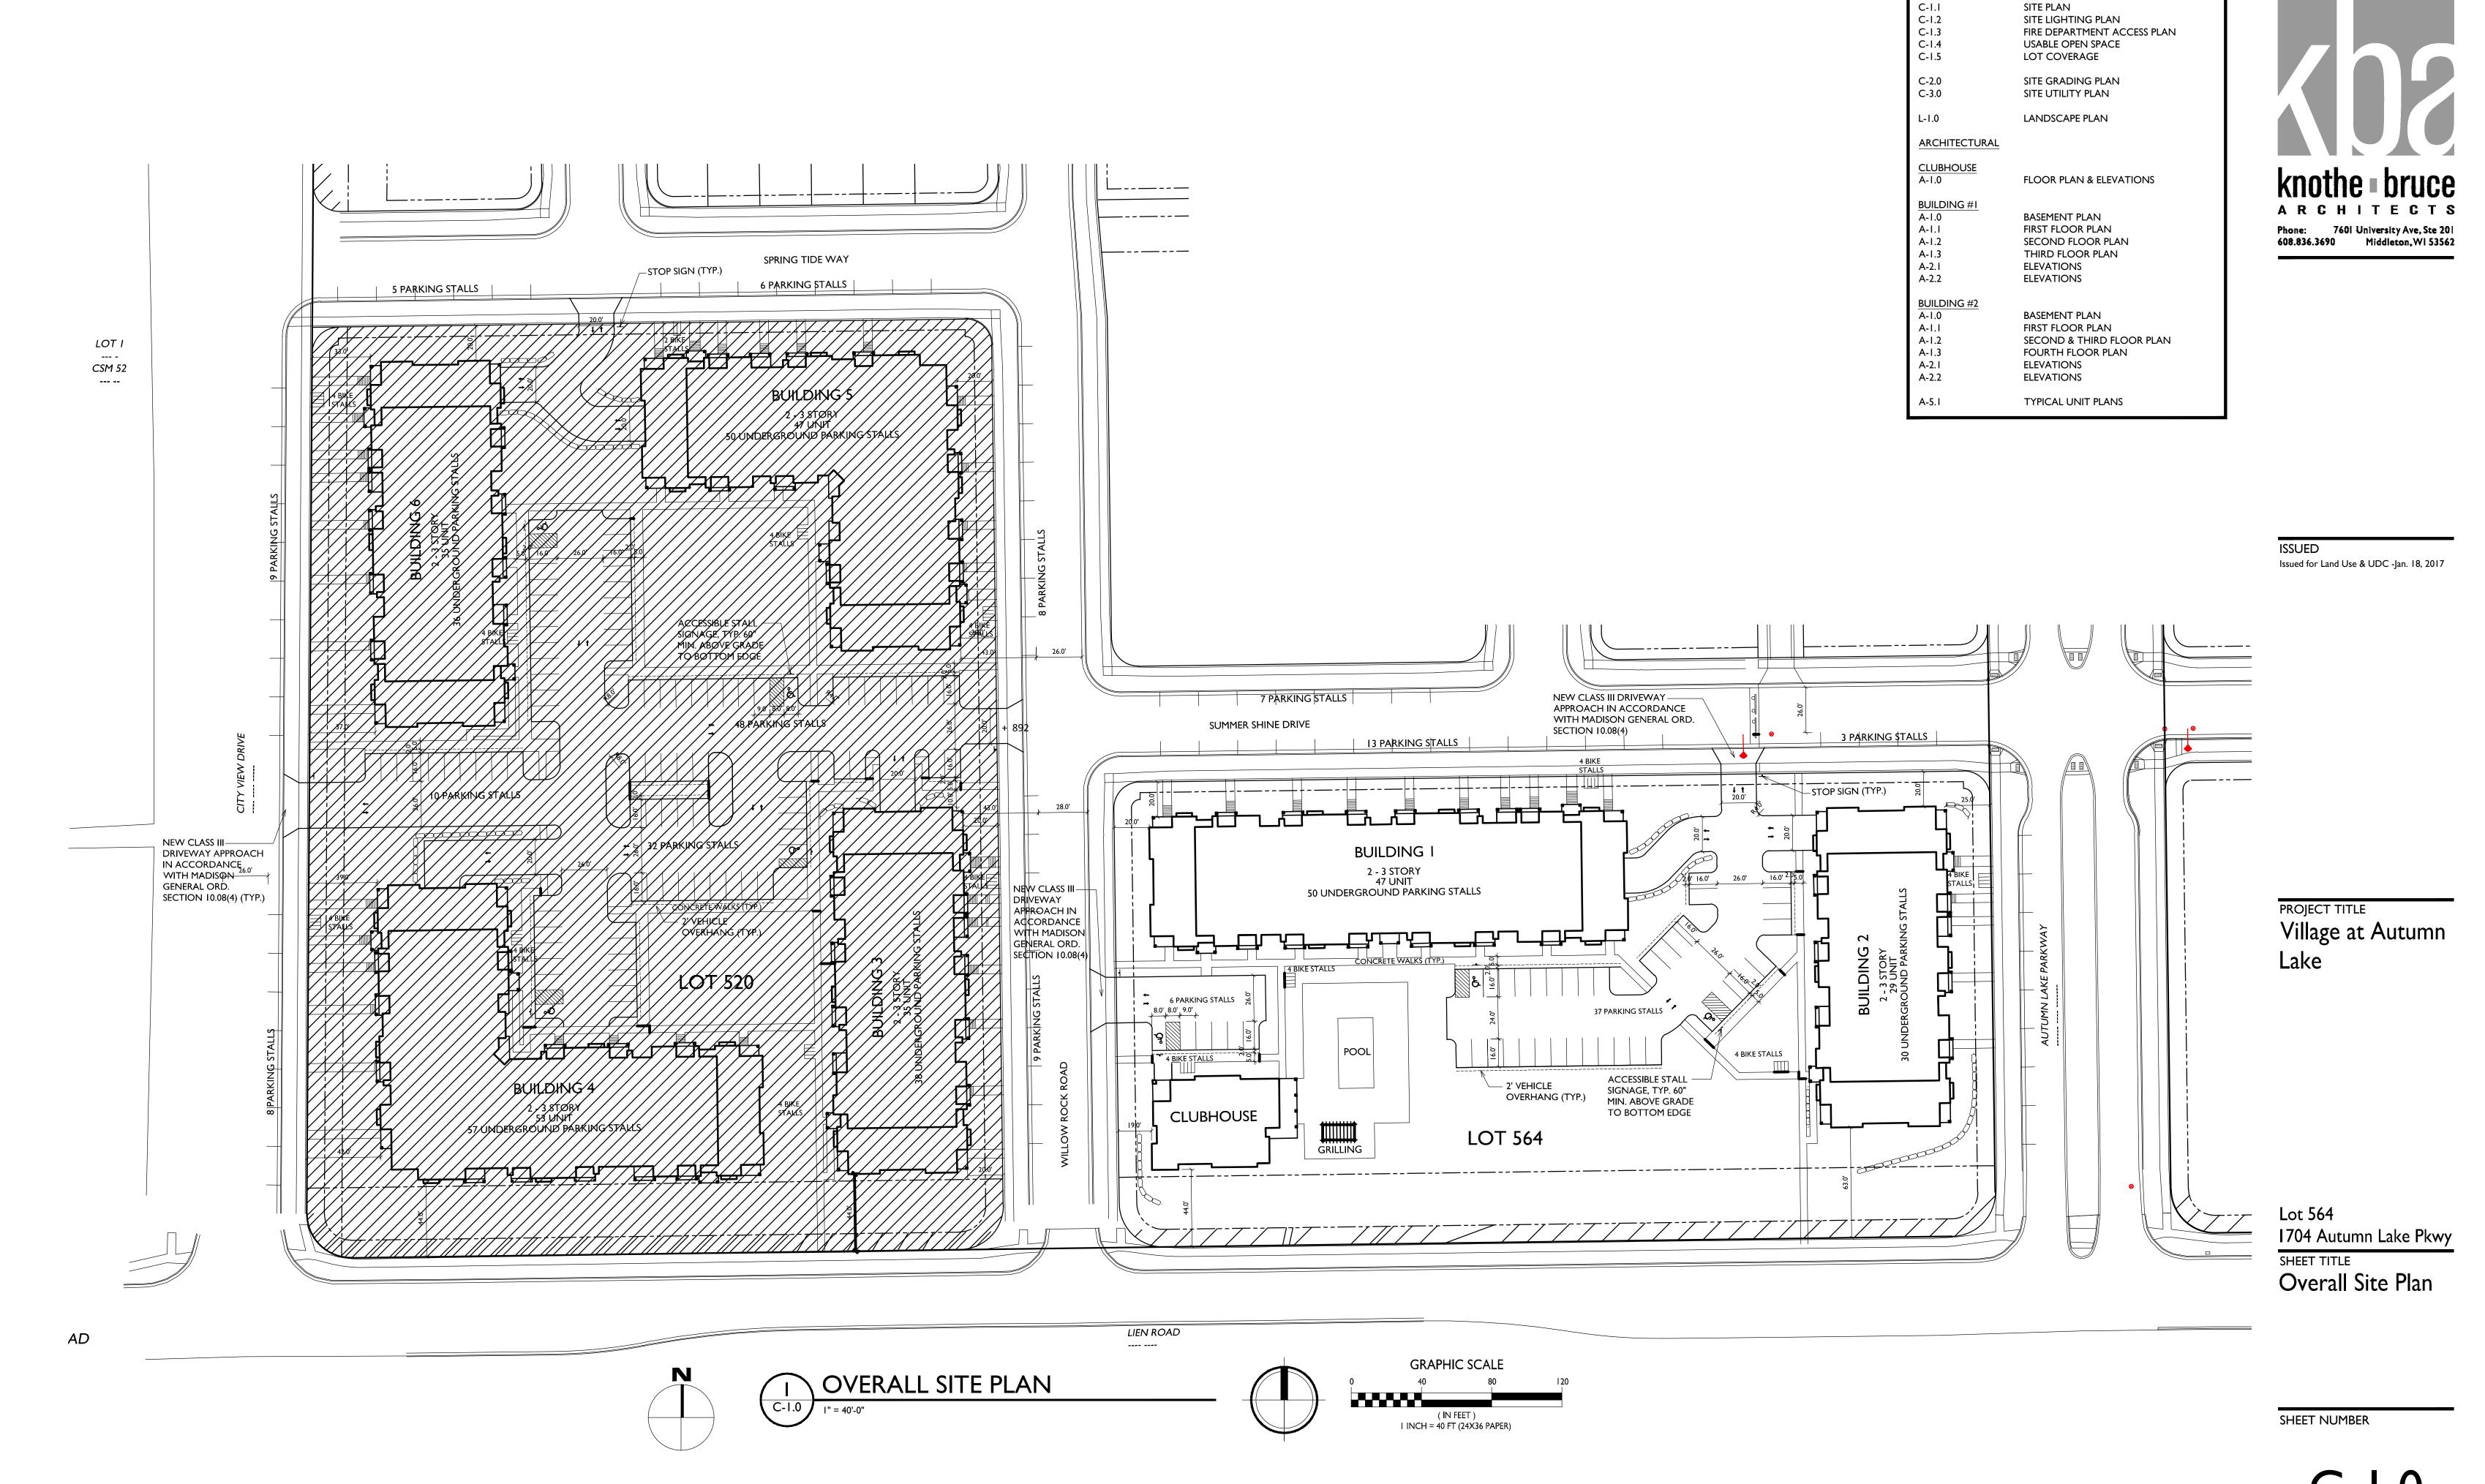
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SHEET INDEX

OVERALL SITE PLAN

SITE C-1.0

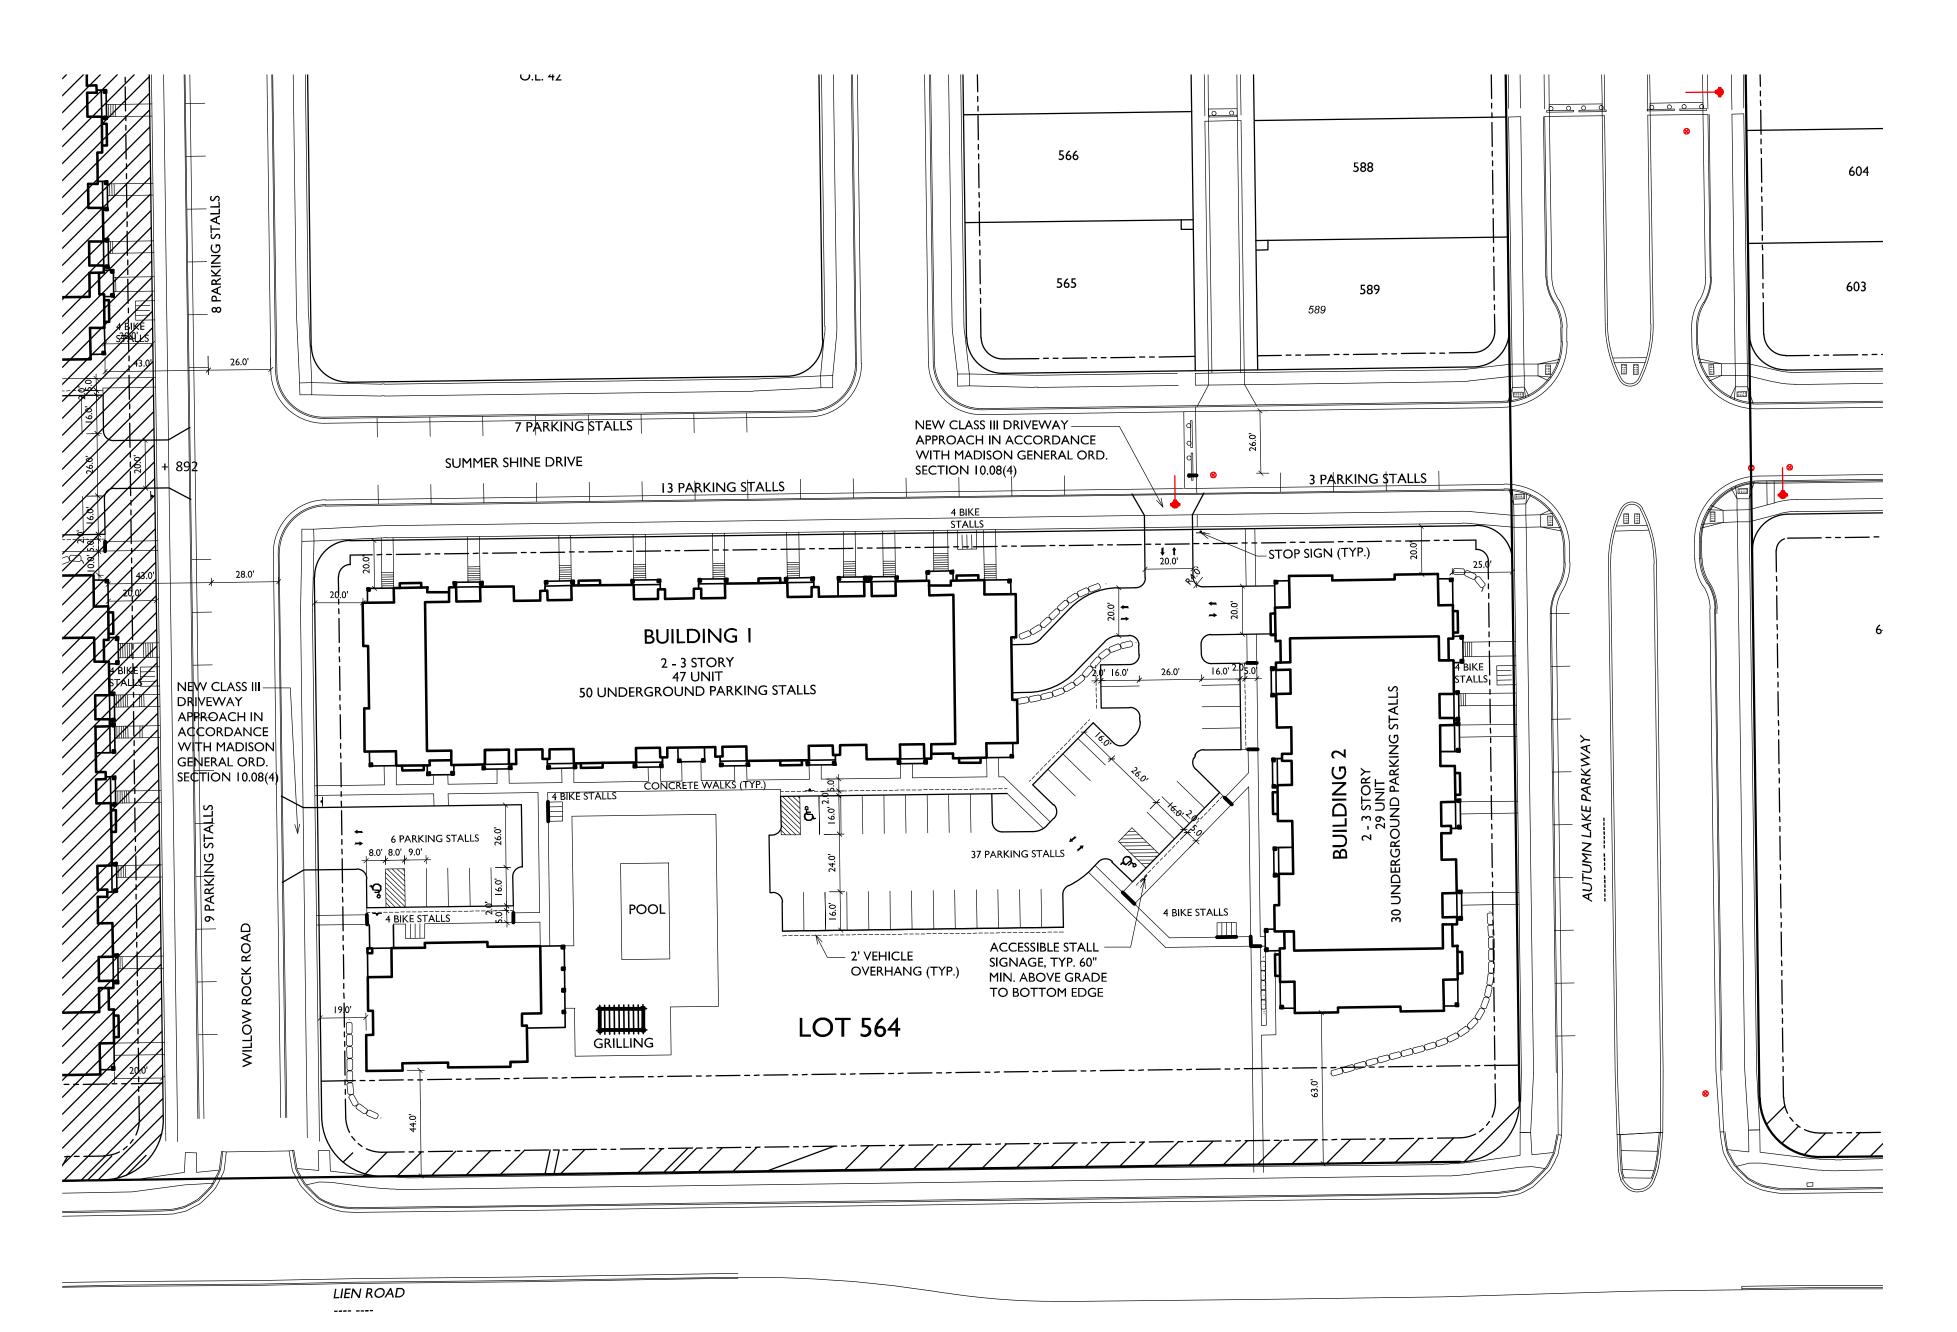

(IN FEET) I INCH = 40 FT (24X36 PAPER)

LOT 546 SITE DEVELOPMENT DATA DENSITIES LOT AREA 131,856365 S.F./3.1 ACRES DWELLING UNITS 76 DU LOT AREA/ D.U. 1,735 S.F. /DU DENSITY 24.5 UNITS/ACRE 2-3 STORIES **BUILDING HEIGHT** LOT COVERAGE 62,865 S.F. = 48% (75% MAX) USABLE OPEN SPACE 68,991 S.F. USABLE OPEN SPACE / D.U. 908 S.F./ D.U. DWELLING UNIT MIX: EFFICIENCY 34 - 35 ONE BEDROOM 33 - 35 73 - 76 UNITS TWO BEDROOM TOTAL UNITS **VEHICLE PARKING STALLS:** UNDERGROUND 80 123 VEHICLE STALLS RATIO I.6 STALLS/UNIT BICYCLE PARKING STALLS SURFACE SURFACE GUEST UNDERGROUND GARAGE-WALL HUNG 12

UNDERGROUND GARAGE STD. 2'X6'
TOTAL

56
90 BICYCLE STALLS

GENERAL NOTES:

DAMAGED BY THE CONSTRUCTION OR ANY SIDEWALK AND CURB AND GUTTER WHICH THE CITY ENGINEER DETERMINES NEEDS TO BE REPLACED BECAUSE IT IS NOT AT A DESIRABLE GRADE REGARDLESS OF WHETHER THE CONDITION EXISTED PRIOR TO BEGINNING CONSTRUCTION.

THE APPLICANT SHALL REPLACE ALL SIDEWALK AND CURB AND GUTTER WHICH ABUTS THE PROPERTY WHICH IS

ALL WORK IN THE PUBLIC RIGHT-OF-WAY SHALL BE PERFORMED BY A CITY LICENSED CONTRACTOR.
 ALL DAMAGE TO THE PAVEMENT, ADJACENT TO THIS

DEVELOPMENT SHALL BE RESTORED IN ACCORDANCE WITH THE CITY OF MADISON'S PAVEMENT PATCHING CRITERIA.

4. APPROVAL OF PLANS FOR THIS PROJECT DOES NOT INCLUDE ANY APPROVAL TO PRUNE, REMOVE, OR PLANT TREES IN THE PUBLIC RIGHT-OF-WAY. PERMISSION FOR SUCH ACTIVITIES

MUST BE OBTAINED FROM THE CITY FORESTER, 266-4816.

5. EASEMENT LINES SHOWN ON THIS SHEET ARE FOR GENERAL REFERENCE ONLY - SEE CSM AND CIVIL SHEETS FOR ADDITIONAL AND MORE COMPLETE EASEMENT INFORMATION

knothe bruce
ARCHITEGTS
Phone: 7601 University Ave, Ste 201
608.836.3690 Middleton, WI 53562

ISSUED
Issued for Land Use & UDC -Jan. 18, 2017

Village at Autumn
Lake

Lot 564
1704 Autumn Lake Pkwy
SHEET TITLE
Site Plan

SHEET NUMBER




PROJECT NO.

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LOT #564 - ST	LOT #564 - STATISTICS						
Description	Symbol	Avg	Max	Min	Max/Min	Avg/Min	
Lot #564 - East	+	I.0 fc	1.7 fc	0.4 fc	4.3:I	2.5:1	
Lot #564 - Central	+	I.5 fc	2.5 fc	0.6 fc	4.2:1	2.5:1	
Lot #564 - West	+	I.I fc	2.3 fc	0.3 fc	7.7:1	3.7:I	
Lot #520 - Pool Deck	+	6.1 fc	9.0 fc	3.7 fc	2.4:1	1.6:1	

YMBOL	_ LABE	L QTY	CATALOG	DESCRIPTION	LAMP	FILE		MOUNTING
	A	2	ARE-EDG-3MB-**- 06-E-UL-350-40K (350mA)	LED TYPE III MEDIUM OPTIC W/ FULL BACKLIGHT 700MA 4000K LEDWAY STREETLIGHT	60 WHITE LED, VERTICAL BASEUP	ARE-EDG- 3MB06-E- UL-350-40K- CONFIGURED. IES	Α	20'-0" POLE ON FLUSH CONC. BASE
	B B-I	3	ARE-EDG-4MB-**- 06-E-UL-350-40K (350mA)	CREE EDGE AREA, TYPE IV MEDIUM W- FULL BLS, 120 LEDS, 525MA, 4000K	I 20 WHITE LED, VERTICAL BASE-UP	ARE-EDG- 4MB06-E- UL-350-40K- CONFIGURED. IES	B B-I	20'-0" POLE ON FLUSH CONC. BASE 18'-0" POLE ON 2'-0" TALL CONC. BASE
	С	(NOT I	USED ON LOT #564)					
	D	3	ARE-EHO-4MB-**- I 2-E-UL-700-40K (700mA)	CREE EDGE HIGH OUTPUT, TYPE IV MEDIUM W- FULL BLS, 120 LEDS, 1000mA, 4000K	I 20 WHITE LED, VERTICAL BASE-UP	ARE-EHO- 4MB12-E- UL-700-40K- CONFIGURED. IES	D	20'-0" POLE ON FLUSH CONC. BASE
	E	2	SEC-EDG-4MB-**- 02-E-UL-350-40K (350mA)	CREE EDGE AREA, TYPE IV MEDIUM W- FULL BLS, 120 LEDS, 525mA, 4000K	I 20 WHITE LED, VERTICAL BASE-UP	SEC-EDG- 4MB02-E- UL-350-40K- CONFIGURED. IES		8'-0" ABOVE GRADE ON SIDE OF BUILDING
				EXAMPLE LIGH	HT FIXTURE DIS	TRIBUTION		
					ISOLUX CONTOL	JR = 0.25 FC		
) }-	ISOLUX CONTOL			
				. •		JK = 1.0 FC_		
						JR = 0.5 FC		




PROJECT TITLE

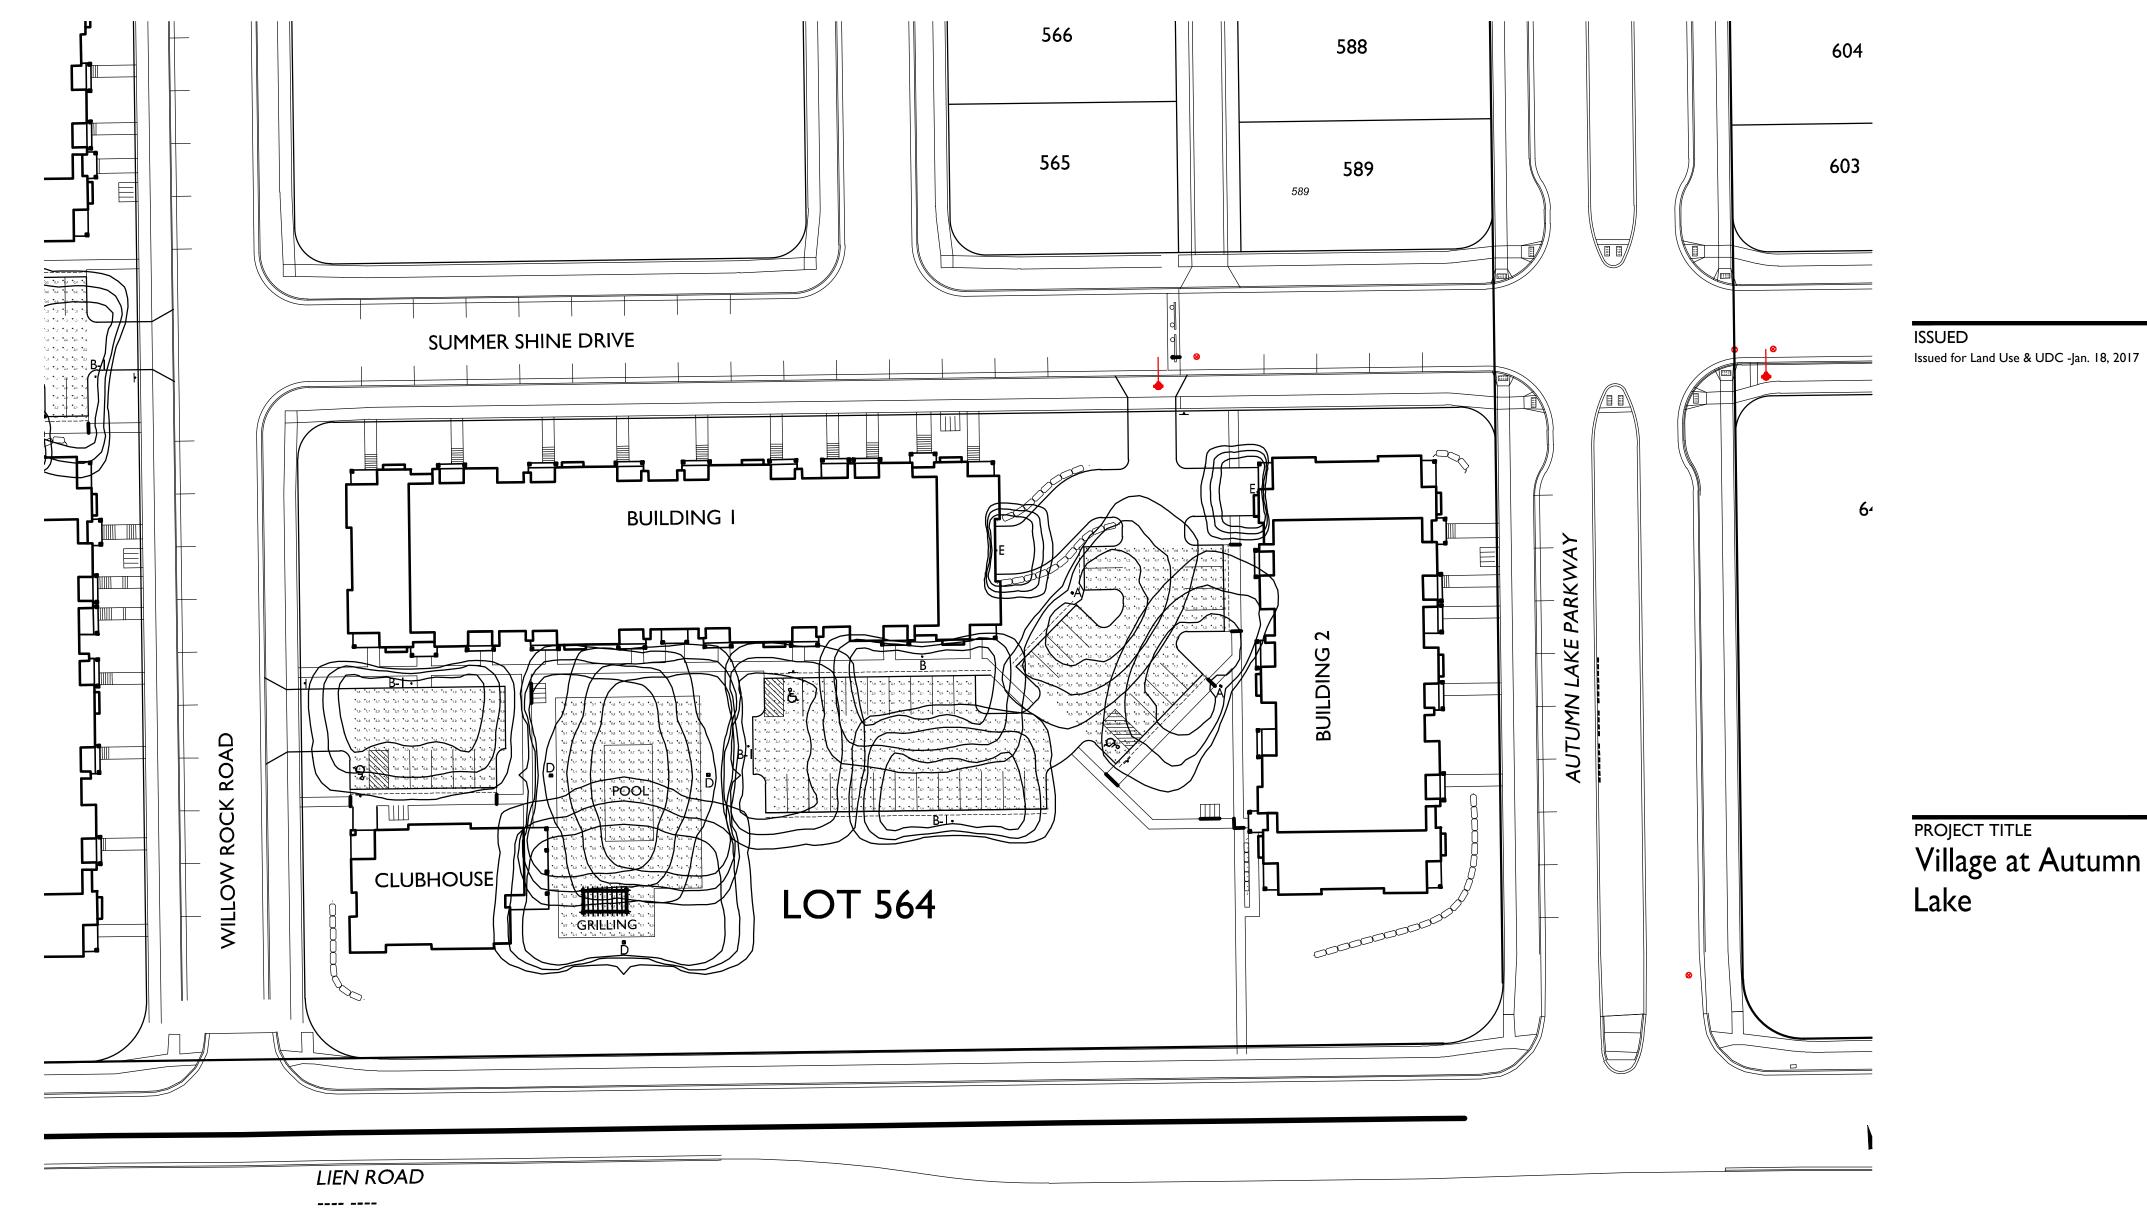Village at Autumn Lake

SITE LIGHTING PLAN

| " = 40'-0"



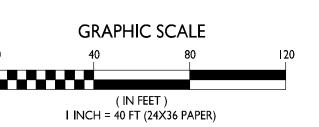


Lot 564 1704 Autumn Lake Pkwy SHEET TITLE
Site Lighting Plan


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C-1.2


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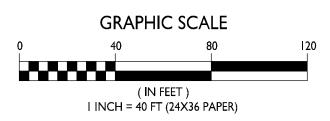
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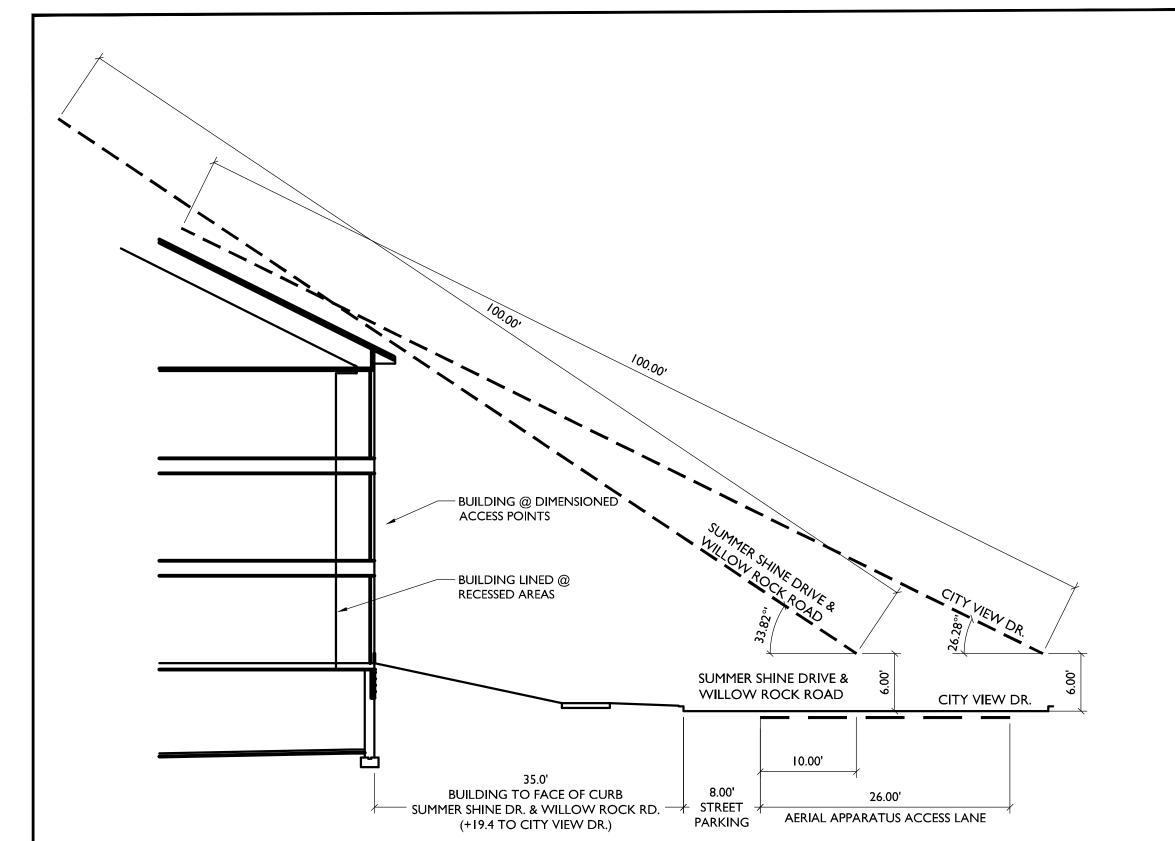






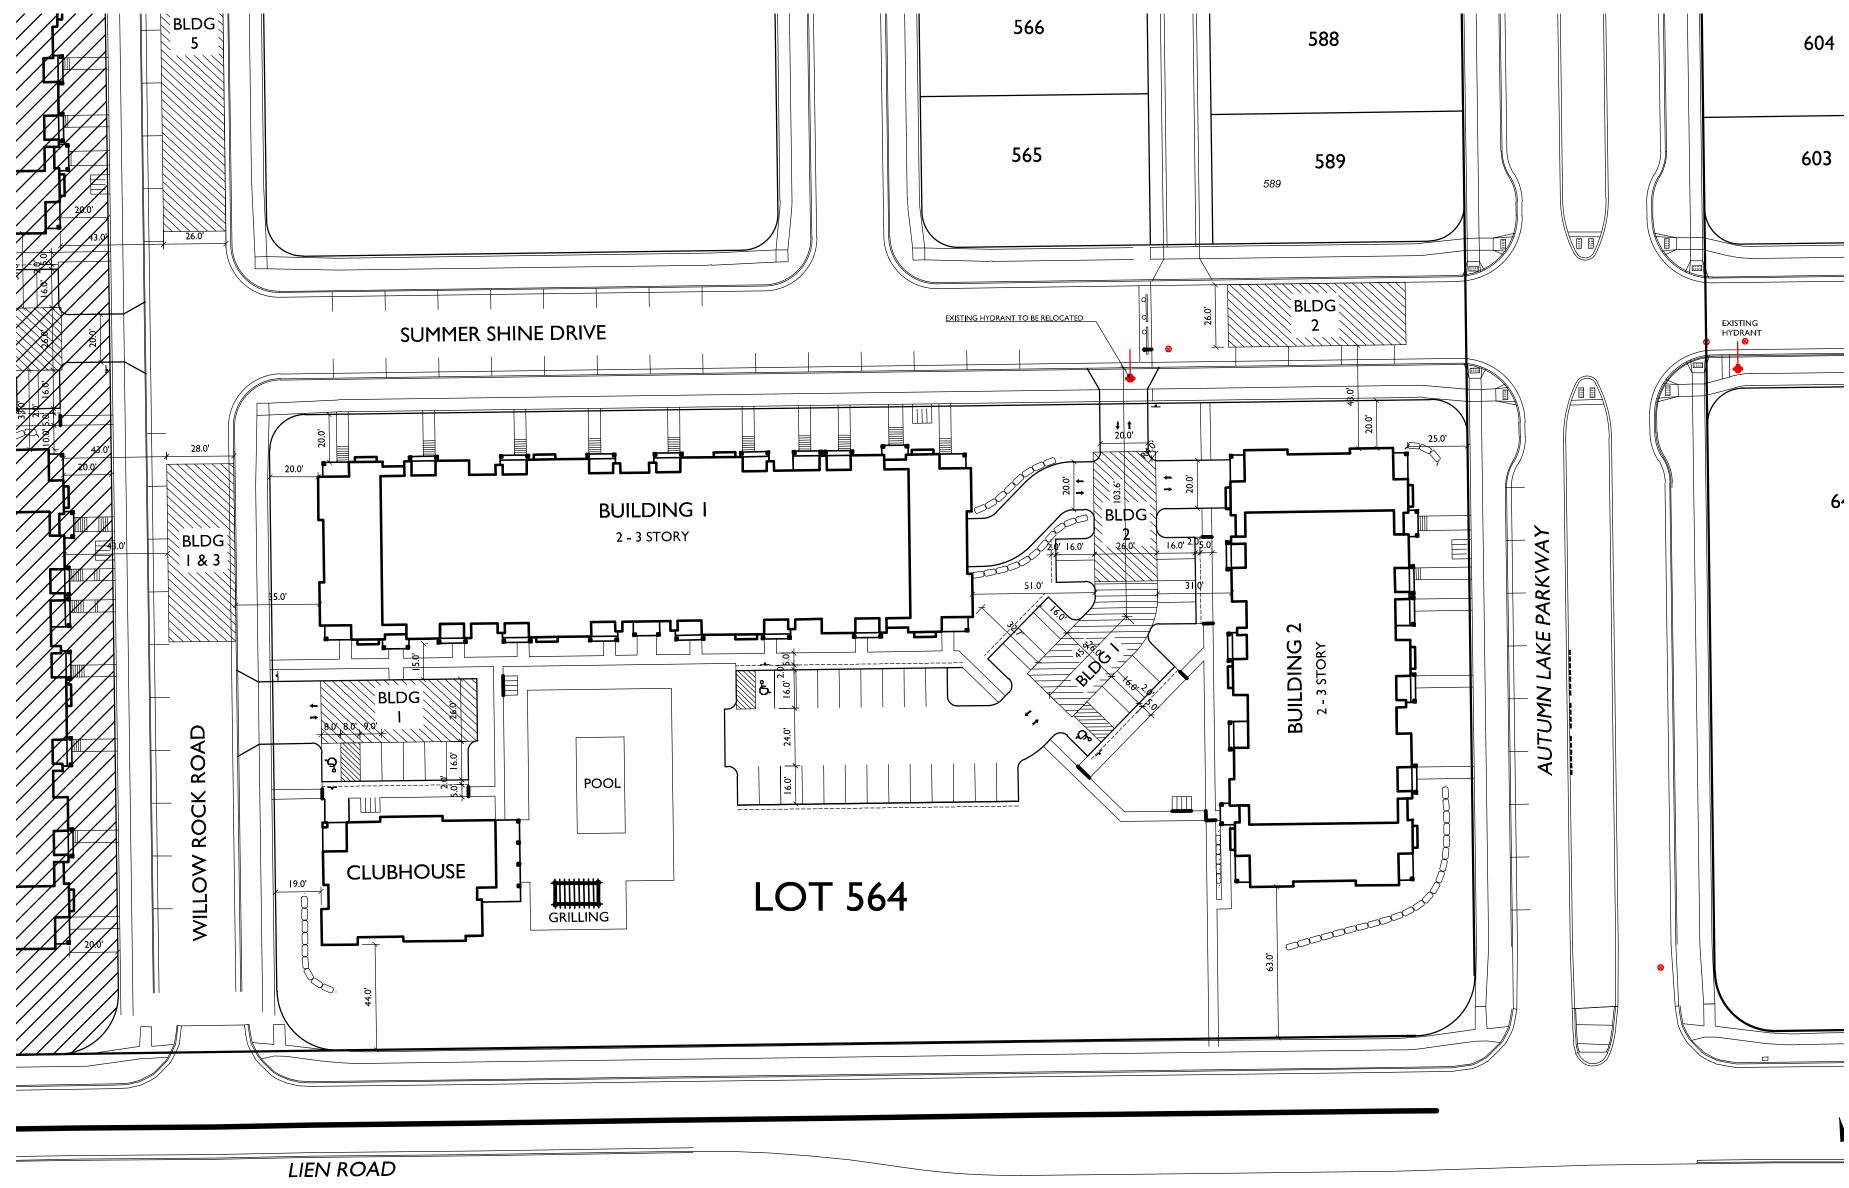

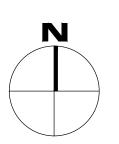

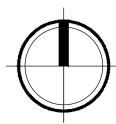

knothe bruce
ARCHITECTS

Phone: 7601 University Ave, Ste 201
608.836.3690 Middleton, WI 53562

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Issued for Land Use & UDC -Jan. 18, 2017

AERIAL ACCESS FROM STREETS

O 10 20 30

I" = 10'-0"

(IN FEET)
INCH = 10 FT (24X36 PAPER)

Village at Autumn
Lake

Lot 564 1704 Autumn Lake Pkwy SHEET TITLE


Fire Department
Access Plan

SHEET NUMBER


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PROJECT NO. 6

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PROJECT TITLE


Village at Autumn Lake

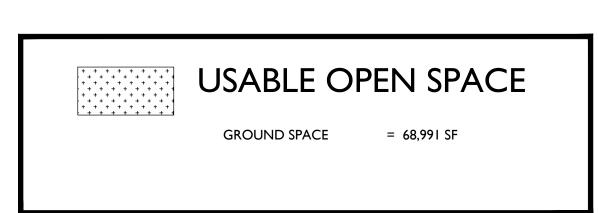Lot 564 1704 Autumn Lake Pkwy SHEET TITLE Usable Open Space

SHEET NUMBER

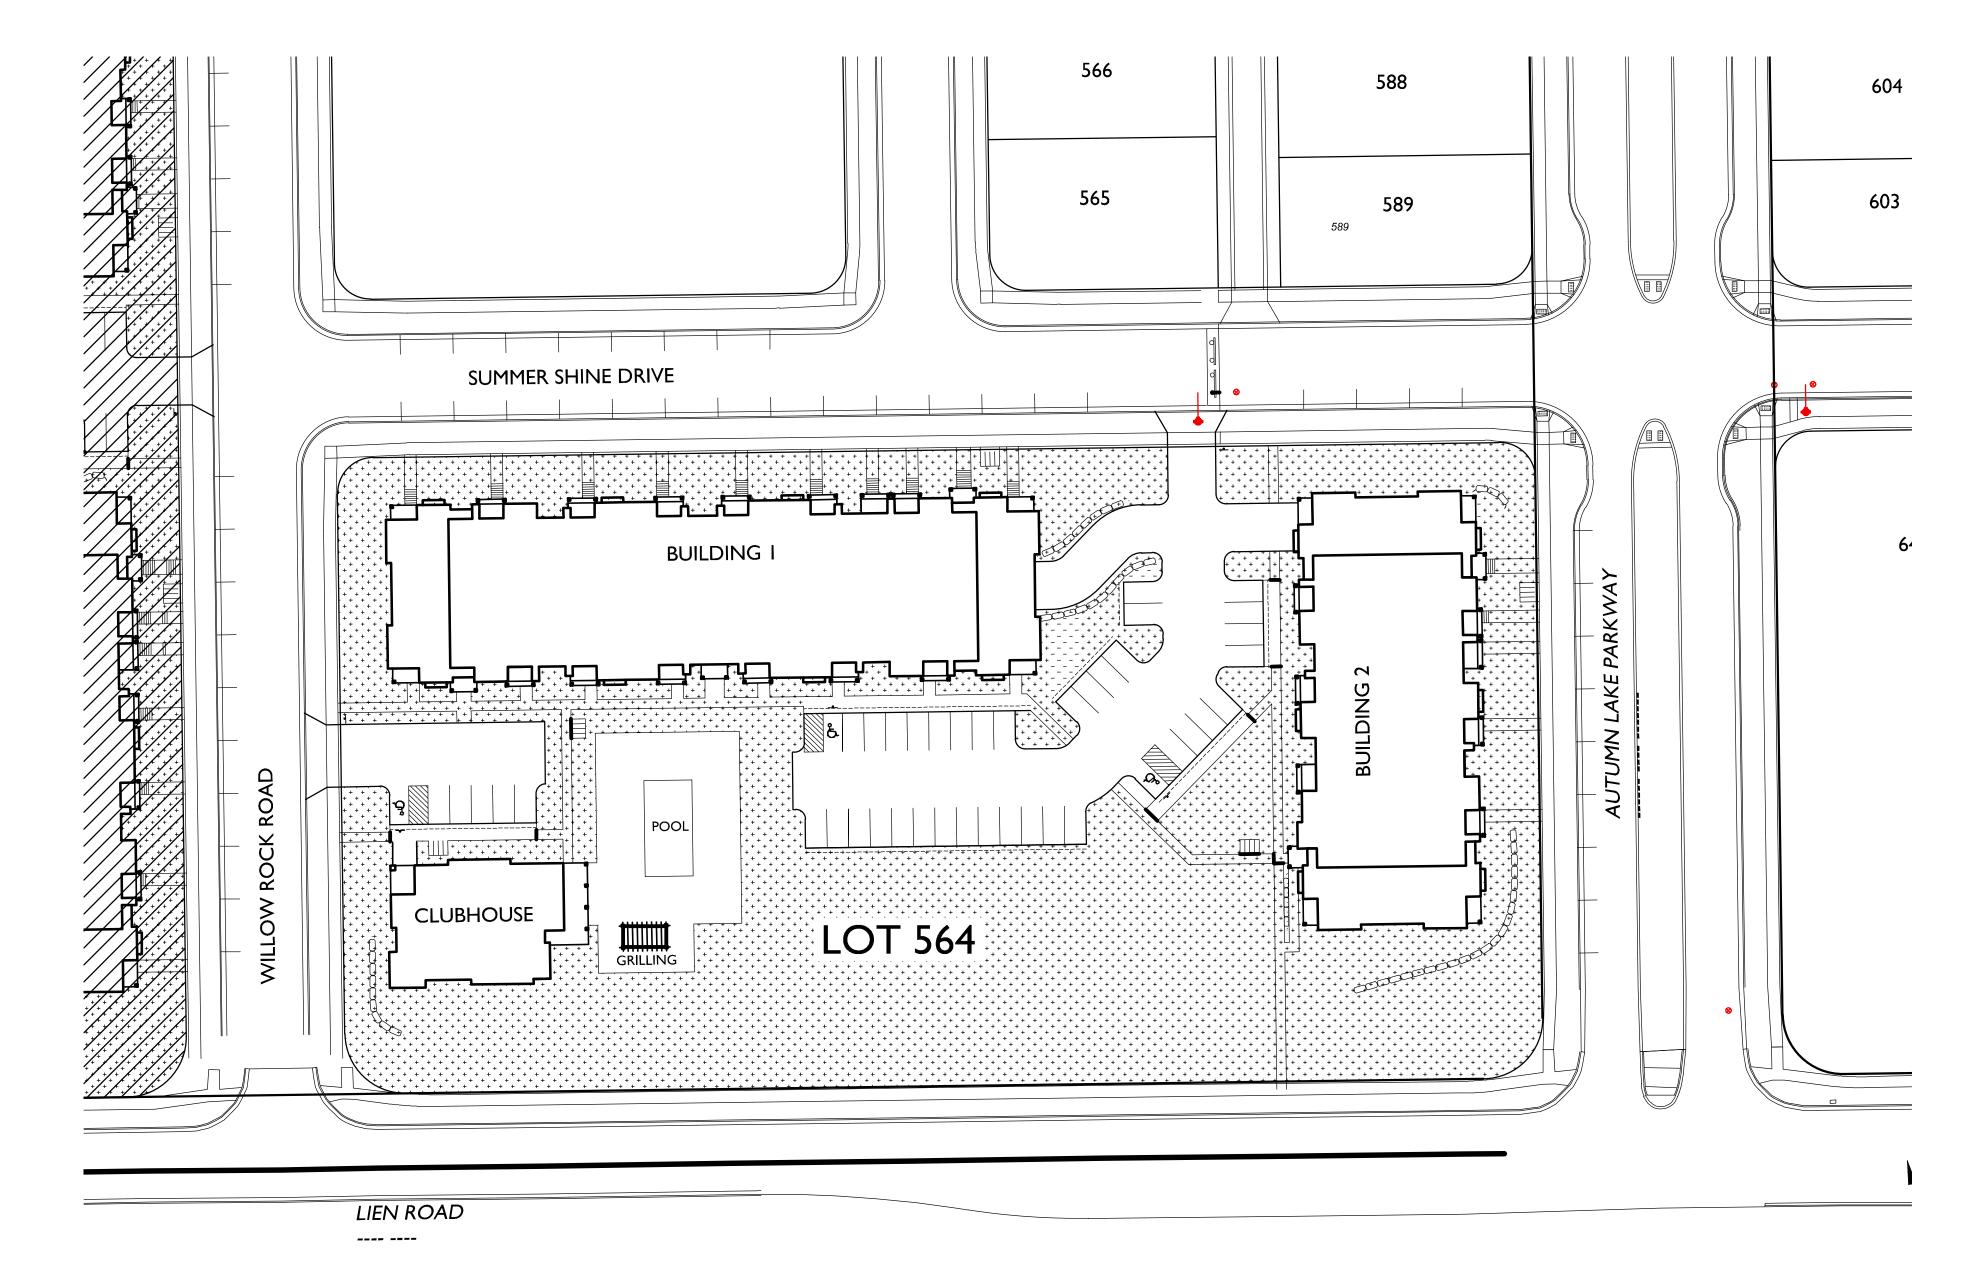
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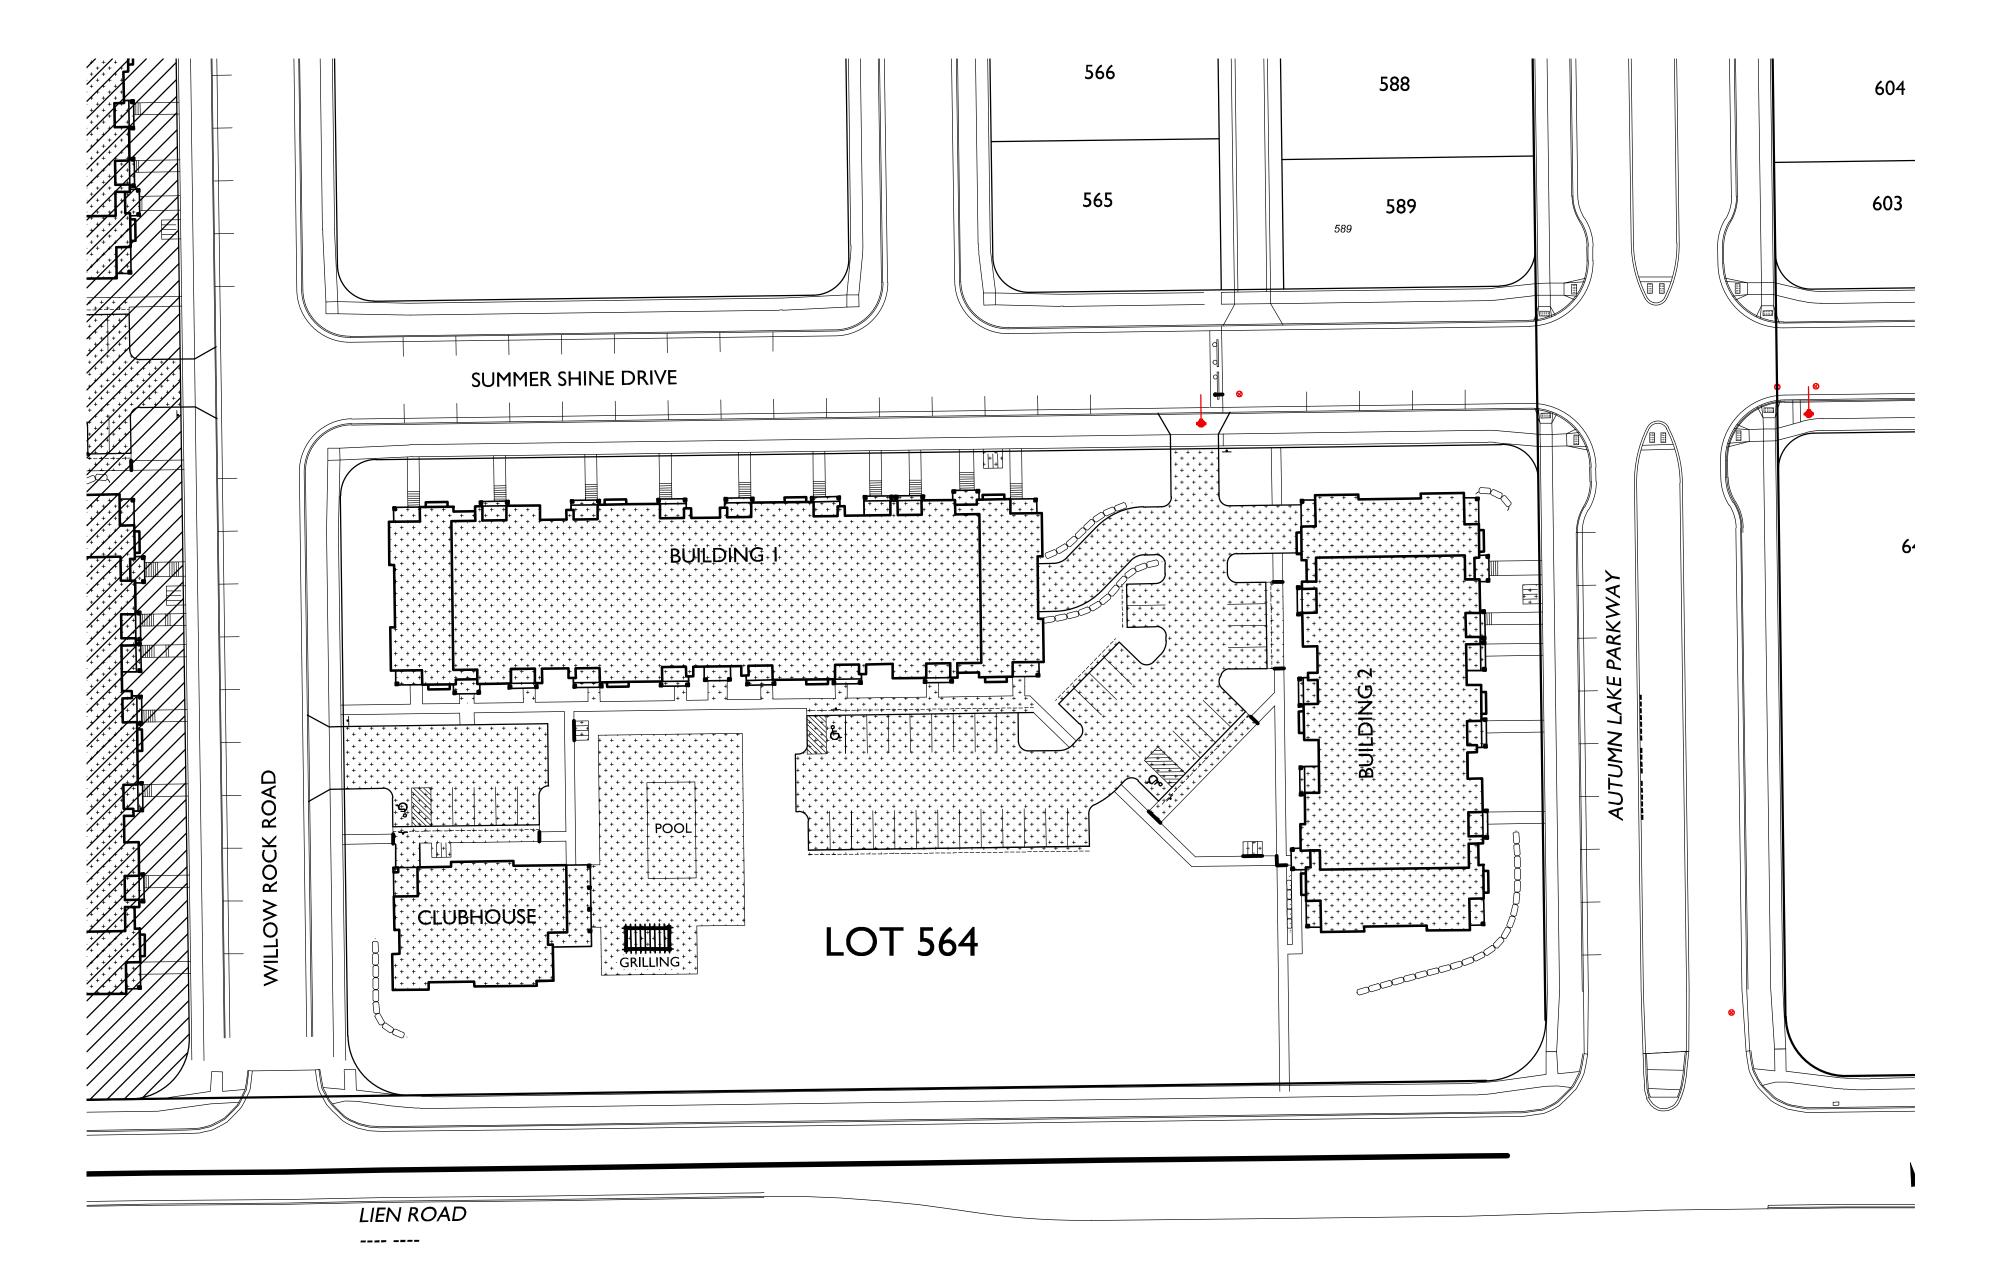




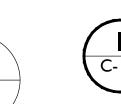





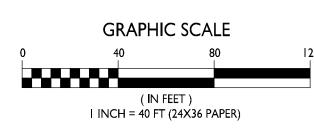

Issued for Land Use & UDC -Jan. 18, 2017

PROJECT TITLE

Village at Autumn Lake

Lot 564 1704 Autumn Lake Pkwy

SHEET TITLE

Lot Coverage

SHEET NUMBER


C-1.5


PROJECT NO.

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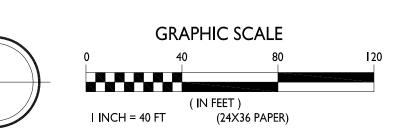
SEQUENCE/ ANTICIPATED TIME SCHEDULE

1. INSTALL EROSION CONTROL

STABILIZED.

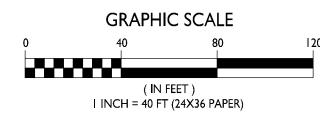- 2. ROUGH SITE GRADING, BEGIN BUILDING CONSTRUCTION
- 3. FINE GRADING, CONCRETE CURB AND GUTTER, ASPHALT, CONCRETE, UTILITIES, RETAINING WALL, AND BUILDING CONSTRUCTION.
- 4. RESPREAD TOPSOIL AND FINAL RESTORATION
- 5. REMOVE EROSION CONTROL WHEN SITE HAS BECOME

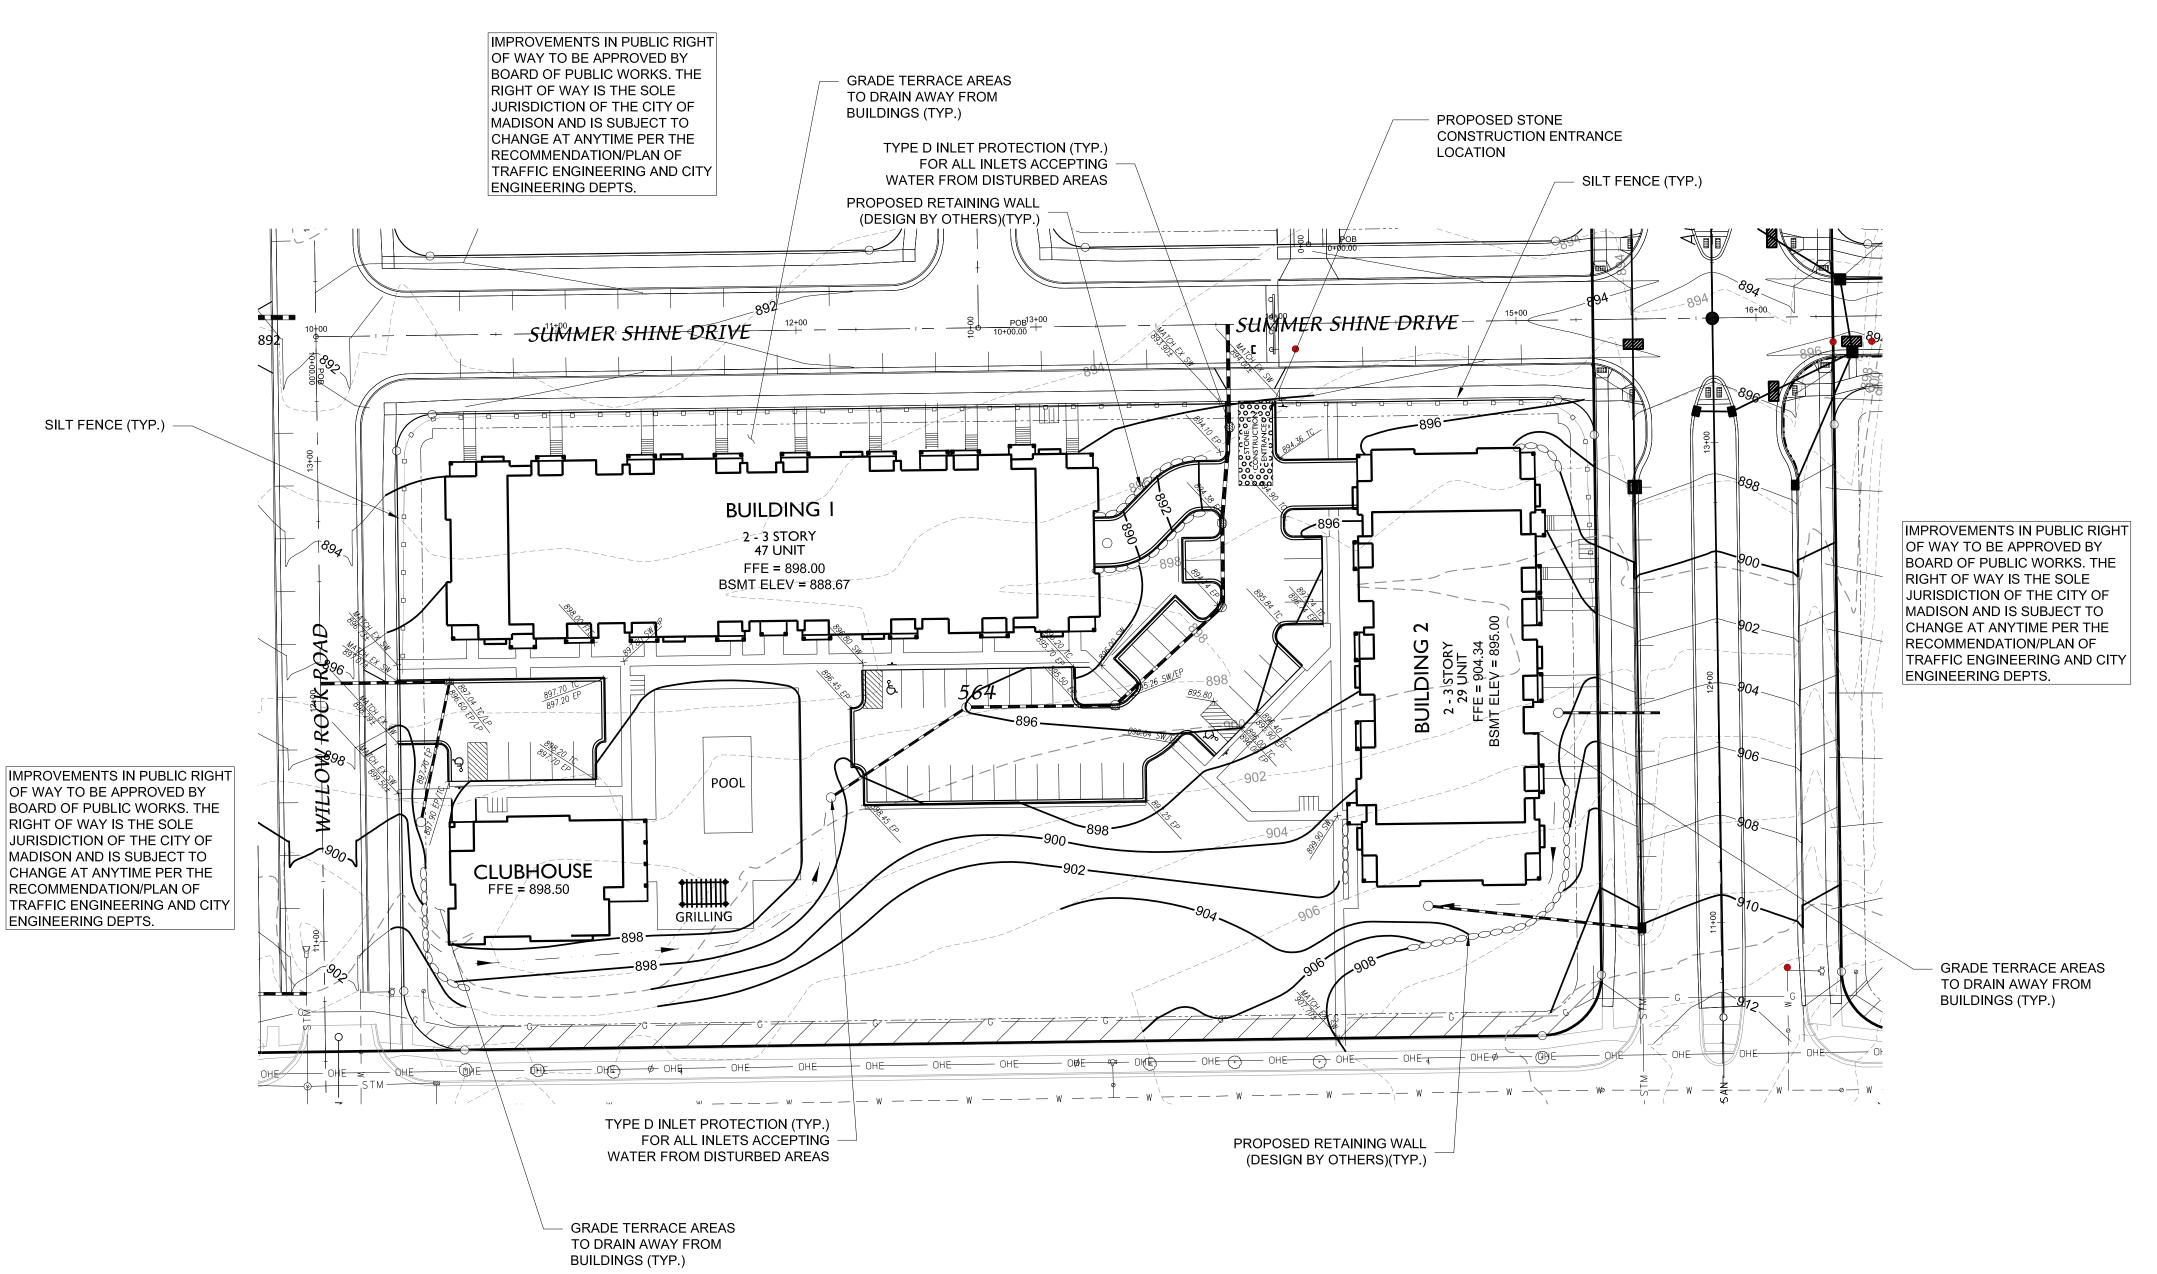GRADING PLAN







PROPOSED CONTOUR

× 895.50

EXISTING CONTOUR

SPOT ELEVATION **EP - EDGE OF PAVEMENT**

> FFE - FINISHED FLOOR ELEVATION TC - TOP OF CURB TW - TOP OF WALL (GROUND ELEVATION)

BW - BOTTOM OF WALL (GROUND ELEVATION) HP - HIGHPOINT

LIMITS OF DISTURBANCE

SILT FENCE/SILT SOCK

RETAINING WALL (DESIGN BY OTHERS)

FLOW ARROW

GENERAL NOTES

- 1. ALL WORK SHALL BE PER THE CITY OF MADISON STANDARDSPECIFICATIONS
- 2. CONTRACTOR IS RESPONSIBLE TO OBTAIN ANY AND ALL PERMITS REQUIRED.
- 3. BUILDING CORNERS ARE APPROXIMATE AND FOR GENERAL BUILDING FOOTPRINT ONLY
- 4. IF ANY ERRORS, DISCREPANCIES, OR DIMENSIONS WITH PLAN BECOME APPARENT. IT SHALL BE BROUGHT TO THE ATTENTION OF THE ENGINEER PRIOR TO CONSTRUCTION
- 5. CONTRACTOR SHALL ENSURE THAT ALL STORMWATER DRAINS AWAY FROM BUILDING FOUNDATIONS DURING FINAL RESTORATION
- 6. ALL DIMENSIONS TO FACE OF CURB UNLESS OTHERWISE NOTED
- 7. ALL WORK IN THE PUBLIC RIGHT-OF-WAY SHALL BE PERFORMED BY A CITY LICENSED CONTRACTOR
- 8. CONTRACTOR SHALL REPLACE ALL SIDEWALK AND CURB & GUTTER WHICH ABUTS THE PROPERTY AND IS DAMAGED BY CONSTRUCTION.
- 10. ALL DAMAGE TO THE PAVEMENT OF ADJACENT PUBLIC STREETS SHALL BE RESOTRED IN ACCORDANCE WITH THE CITY OF MADISON'S PAVEMENT PATCHING CRITERIA

GRADING AND EROSION CONTROL NOTES:

- 1. ALL EROSION CONTROL MEASURES SHALL BE CONSTRUCTED AND MAINTAINED BY THE CONTRACTOR IN ACCORDANCE WITH THE WISCONSIN DNR TECHNICAL STANDARDS. IT IS THE CONTRACTOR'S RESPONSIBILITY TO OBTAIN A COPY OF THESE STANDARDS.
- 2. INSTALL EROSION CONTROL MEASURES PRIOR TO ANY SITE WORK INCLUDING GRADING OR DISTURBANCE OF EXISTING SURFACE MATERIALS AS SHOWN ON PLAN. MODIFICATIONS TO SEDIMENT CONTROL DESIGN MAY BE CONDUCTED TO MEET UNFORESEEN FIELD CONDITIONS IF MODIFICATIONS CONFORM TO WDNR TECHNICAL STANDARDS.
- EROSION CONTROL MEASURES INDICATED ON THE PLANS SHALL BE CONSIDERED MINIMUMS. IF DETERMINED NECESSARY DURING CONSTRUCTION ADDITIONAL MEASURES SHALL BE INSTALLED TO PREVENT SEDIMENT FROM LEAVING THE SITE.
- 4. INSPECTIONS AND MAINTENANCE OF ALL EROSION CONTROL MEASURES SHALL BE ROUTINE (ONCE PER WEEK MINIMUM) TO ENSURE PROPER FUNCTION OF EROSION CONTROLS AT ALL TIMES. EROSION CONTROL MEASURES ARE TO BE IN WORKING ORDER AT THE END OF EACH WORK DAY.
- 5. INSPECT EROSION CONTROL MEASURES AFTER EACH 1/2" OR GREATER RAINFALL. REPAIR ANY DAMAGE OBSERVED DURING THE INSPECTION.
- 6. NO SITE GRADING OUTSIDE OF THE LIMITS OF DISTURBANCE
- 7. EROSION CONTROL MEASURES SHALL BE REMOVED ONLY AFTER SITE CONSTRUCTION IS COMPLETE WITH ALL SOIL SURFACES HAVING AN ESTABLISHED VEGETATIVE COVER
- 8. INSTALL TYPE D INLET PROTECTION IN ALL STORM SEWER INLETS AND CATCH BASINS THAT MAY RECEIVE RUNOFF FROM DISTURBED AREAS
- 9. CUT AND FILL SLOPES SHALL BE NO GREATER THAN 4:1
- 10. SLOPES EXCEEDING 4:1 SHALL BE STABILIZED WITH CLASS I, TYPE B EROSION MATTING AND ALL DRAINAGE SWALES SHALL BE STABILIZED WITH CLASS II, TYPE B EROSION MATTING.
- 11. ALL INCIDENTAL MUD TRACKING OFF-SITE ONTO ADJACENT PUBLIC THOROUGHFARES SHALL BE CLEANED UP AND REMOVED BY THE END OF EACH WORKING DAY USING PROPER DISPOSAL METHODS.
- 12. ANY DISTURBED AREA THAT REMAINS INACTIVE FOR GREATER THAN 7 DAYS SHALL BE STABILIZED WITH TEMPORARY STABILIZATION METHODS SUCH AS TEMPORARY SEEDING, SOIL TREATMENT, EROSION MATTING, OR MULCH
- 13.PREVENT EXCESSIVE DUST FROM LEAVING THE CONSTRUCTION SITE IN ACCORDANCE WITH LOCAL AND STATE REGULATIONS.
- 14.INSTALL EROSION CONTROLS ON THE DOWNSTREAM SIDE OF STOCKPILES.
- 15.AT A MINIMUM ALL DISTURBED AREAS SHALL RECEIVE A MINIMUM OF 4" OF TOPSOIL FERTILIZER, SEED AND MULCH. SEED MIXTURE SHALL BE WISCONSIN DOT SEED MIX #40 OR EQUIVALENT APPLIED AT A RATE OF 5 POUNDS PER 1000 SQFT ON ALL DISTURBED AREAS. ANNUAL RYEGRASS AT A RATE OF 1 POUNDS PER 1000 SQFT SHALL BE ADDED TO THE MIXTURE.
 FERTILIZER SHALL BE PLACED PER A SOIL TEST. SEE LANDSCAPE PLAN FOR A MORE DETAILED PLANTING PLAN AND LANDSCAPE DETAILS.
- 16.DEWATERING, IF APPLICABLE, SHALL BE CONDUCTED PER WDNR STORM WATER MANAGEMENT TECHNICAL STANDARD 1061.



D'ONOFRIO KOTTKE AND ASSOCIATES, INC. 7530 Westward Way, Madison, WI 53717

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YOUR NATURAL RESOURCE FOR LAND DEVELOPMENT

ISSUED

Issued for Land Use & UDC - Jan. 18, 2017

PROJECT TITLE Village at Autumn

Lake

Lot 564 1704 Autumn Lake Pkwy

SHEET TITLE Grading Plan

SHEET NUMBER

PROJECT NO.


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TO OBTAIN LOCATIONS OF

PARTICIPANT UNDERGROUND FACILITIES BEFORE YOU DIG IN WISCONSIN

PRELIMINARY - NOT FOR CONSTRUCTION



GENERAL NOTES

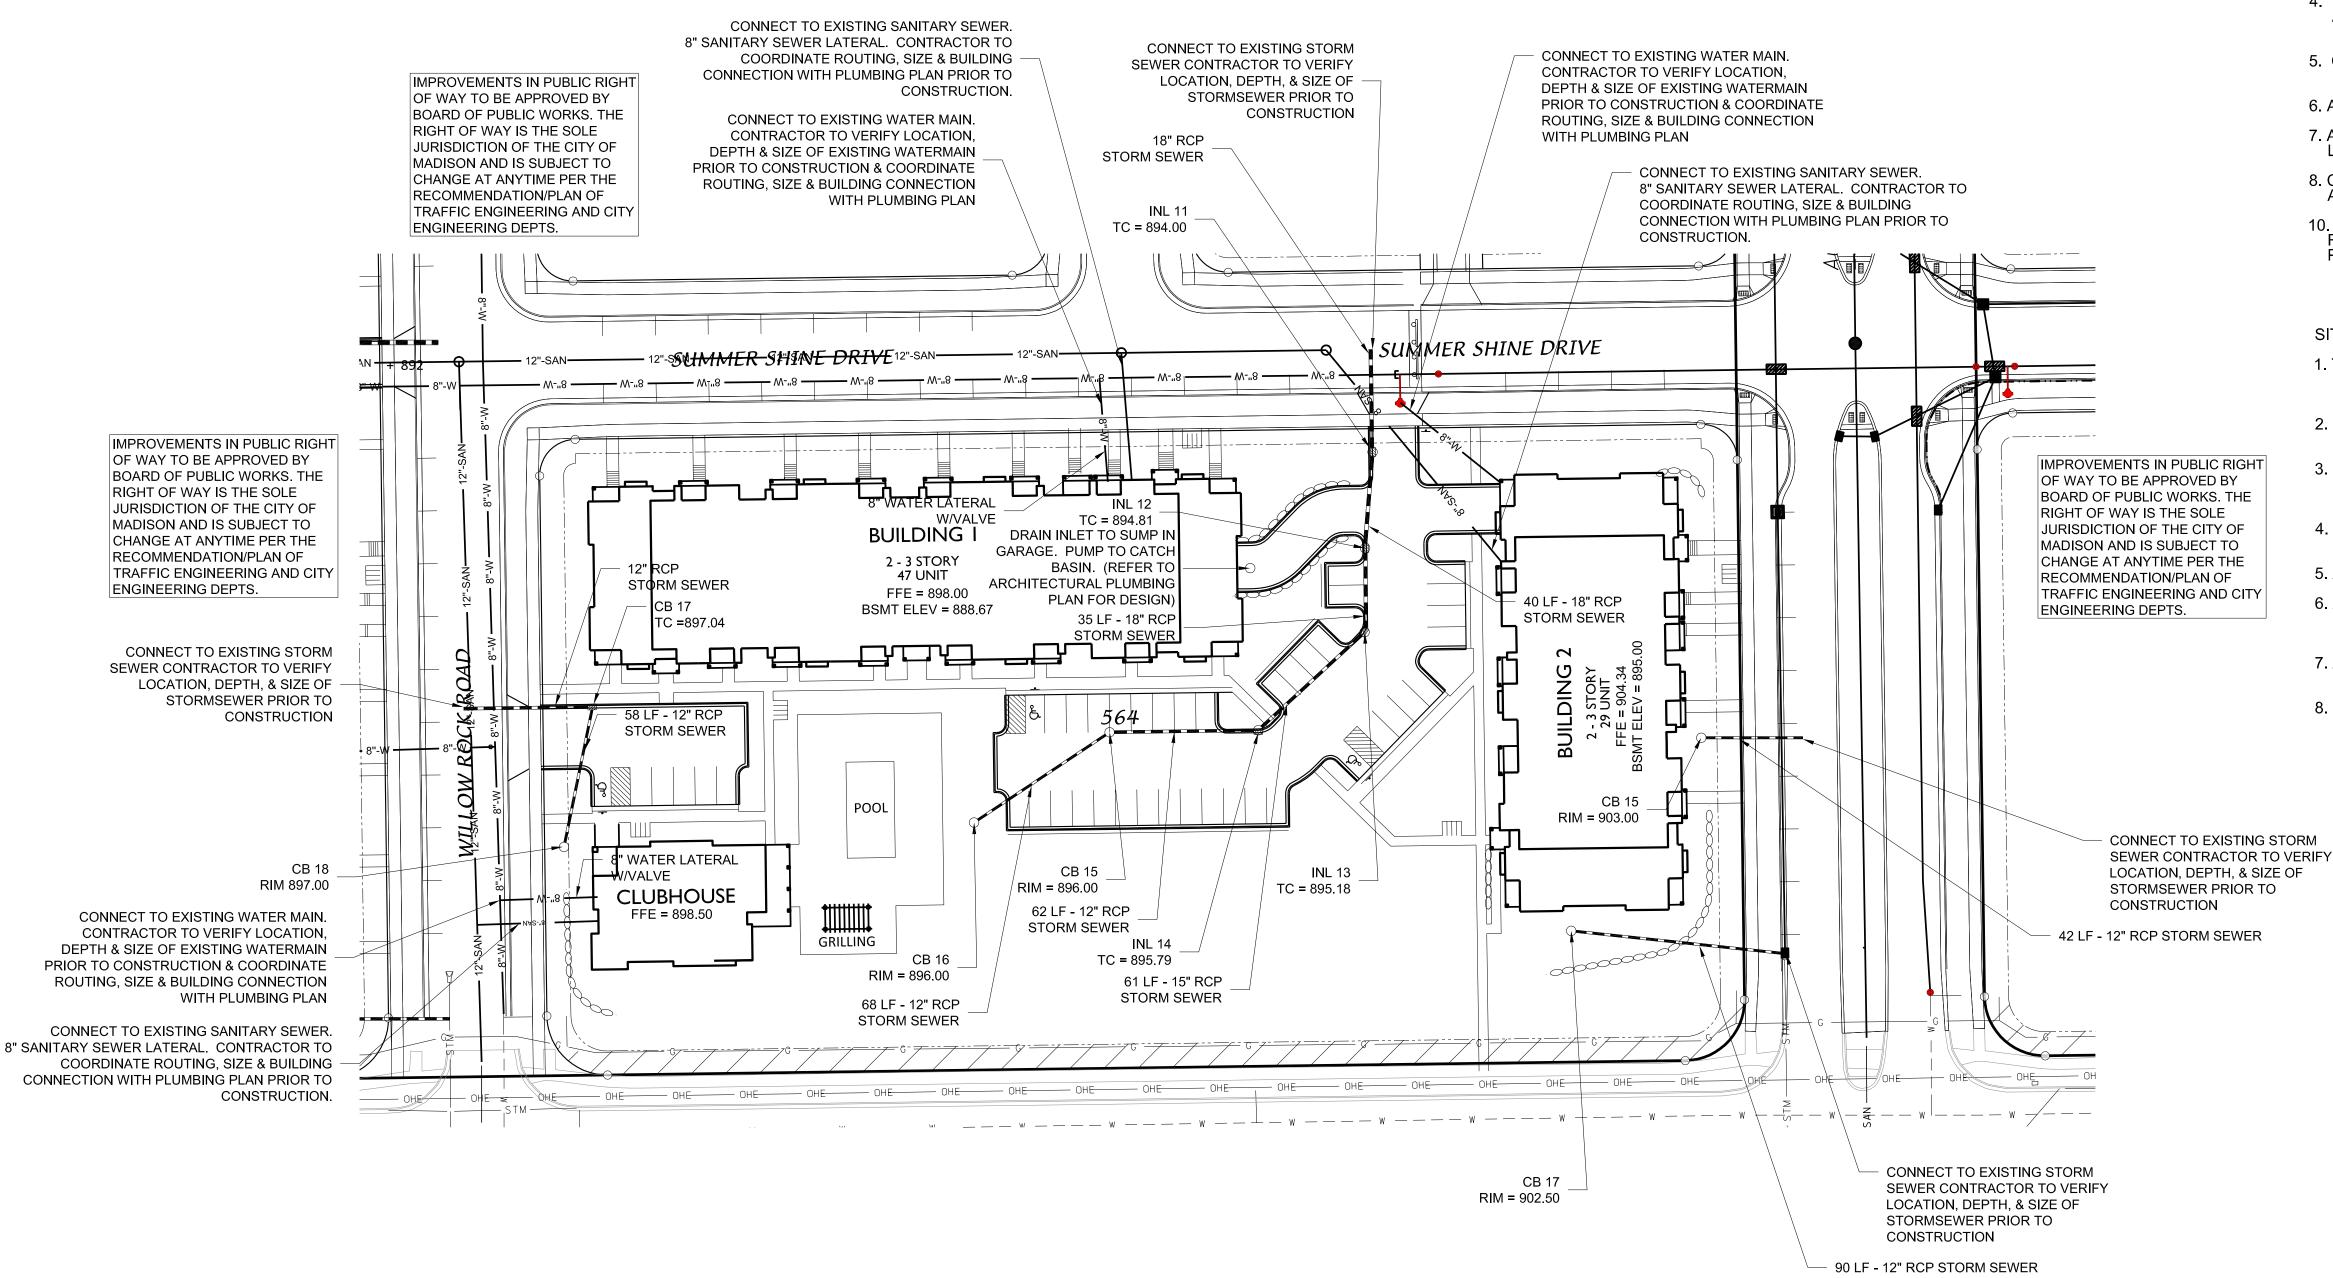- 1. ALL WORK SHALL BE PER THE CITY OF MADISON STANDARDSPECIFICATIONS
- 2. CONTRACTOR IS RESPONSIBLE TO OBTAIN ANY AND ALL PERMITS REQUIRED.
- 3. BUILDING CORNERS ARE APPROXIMATE AND FOR GENERAL BUILDING FOOTPRINT ONLY
- 4. IF ANY ERRORS, DISCREPANCIES, OR DIMENSIONS WITH PLAN BECOME APPARENT. IT SHALL BE BROUGHT TO THE ATTENTION OF THE ENGINEER PRIOR TO CONSTRUCTION
- 5. CONTRACTOR SHALL ENSURE THAT ALL STORMWATER DRAINS AWAY FROM BUILDING FOUNDATIONS DURING FINAL RESTORATION
- 6. ALL DIMENSIONS TO FACE OF CURB UNLESS OTHERWISE NOTED
- 7. ALL WORK IN THE PUBLIC RIGHT-OF-WAY SHALL BE PERFORMED BY A CITY LICENSED CONTRACTOR
- 8. CONTRACTOR SHALL REPLACE ALL SIDEWALK AND CURB & GUTTER WHICH ABUTS THE PROPERTY AND IS DAMAGED BY CONSTRUCTION.
- 10. ALL DAMAGE TO THE PAVEMENT OF ADJACENT PUBLIC STREETS SHALL BE RESOTRED IN ACCORDANCE WITH THE CITY OF MADISON'S PAVEMENT PATCHING CRITERIA

SITE UTILITY NOTES

- 1. THE LOCATION OF EXISTING UTILITIES SHOWN ON THE PLANS ARE APPROXIMATE. PROTECTION OF EXISTING UTILITIES IS THE CONTRACTOR'S RESPONSIBILITY.
- CONTRACTOR TO VERIFY LOCATION DEPTH & SIZE OF EXISTING WATER, STORM AND SEWER PRIOR TO CONSTRUCTION.
- 3. CONTRACTOR TO VERIFY AND COORDINATE SANITARY, STORM AND WATER BUILDING SERVICE CONNECTION LOCATION, SIZES, & DEPTHS WITH ARCHITECTURAL PLUMBING PLAN PRIOR TO CONSTRUCTION.
- 4. CONTRACTOR TO COORDINATE ELECTRIC, GAS, PHONE & CABLE INSTALLATION WITH THE RESPECTIVE UTILITY COMPANIES.
- 5. ALL WATER SERVICES AND HYDRANTS SHALL BE INSTALLED WITH A VALVE.
- 6. ALL STORM CATCHBASINS TO BE 48" DIAMETER WITH NEENAH R-2501 INLET FRAME, GRATE WITH TYPE G LID UNLESS NOTED AS SOLID LID ON PLAN
- 7. ALL STORM CURB INLETS TO BE 2'X3' INLET BOXES WITH NEENAH R-3067 COMBINATION INLET FRAME, GRATE, CURB BOX WITH TYPE C LID
- 8. PLACE 8' X 4' X 2" WATERMAIN INSULATION AT ALL STORM SEWER CROSSINGS

knothe bruce
ARCHITECTS
Phone: 7601 University Ave, Ste 201
608.836.3690 Middleton, WI 53562

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ISSUED

Issued for Land Use & UDC - Jan. 18, 2017

Village at Autumn
Lake

Lot 564 1704 Autumn Lake Pkwy

SHEET TITLE
Utility Plan

SHEET NUMBER


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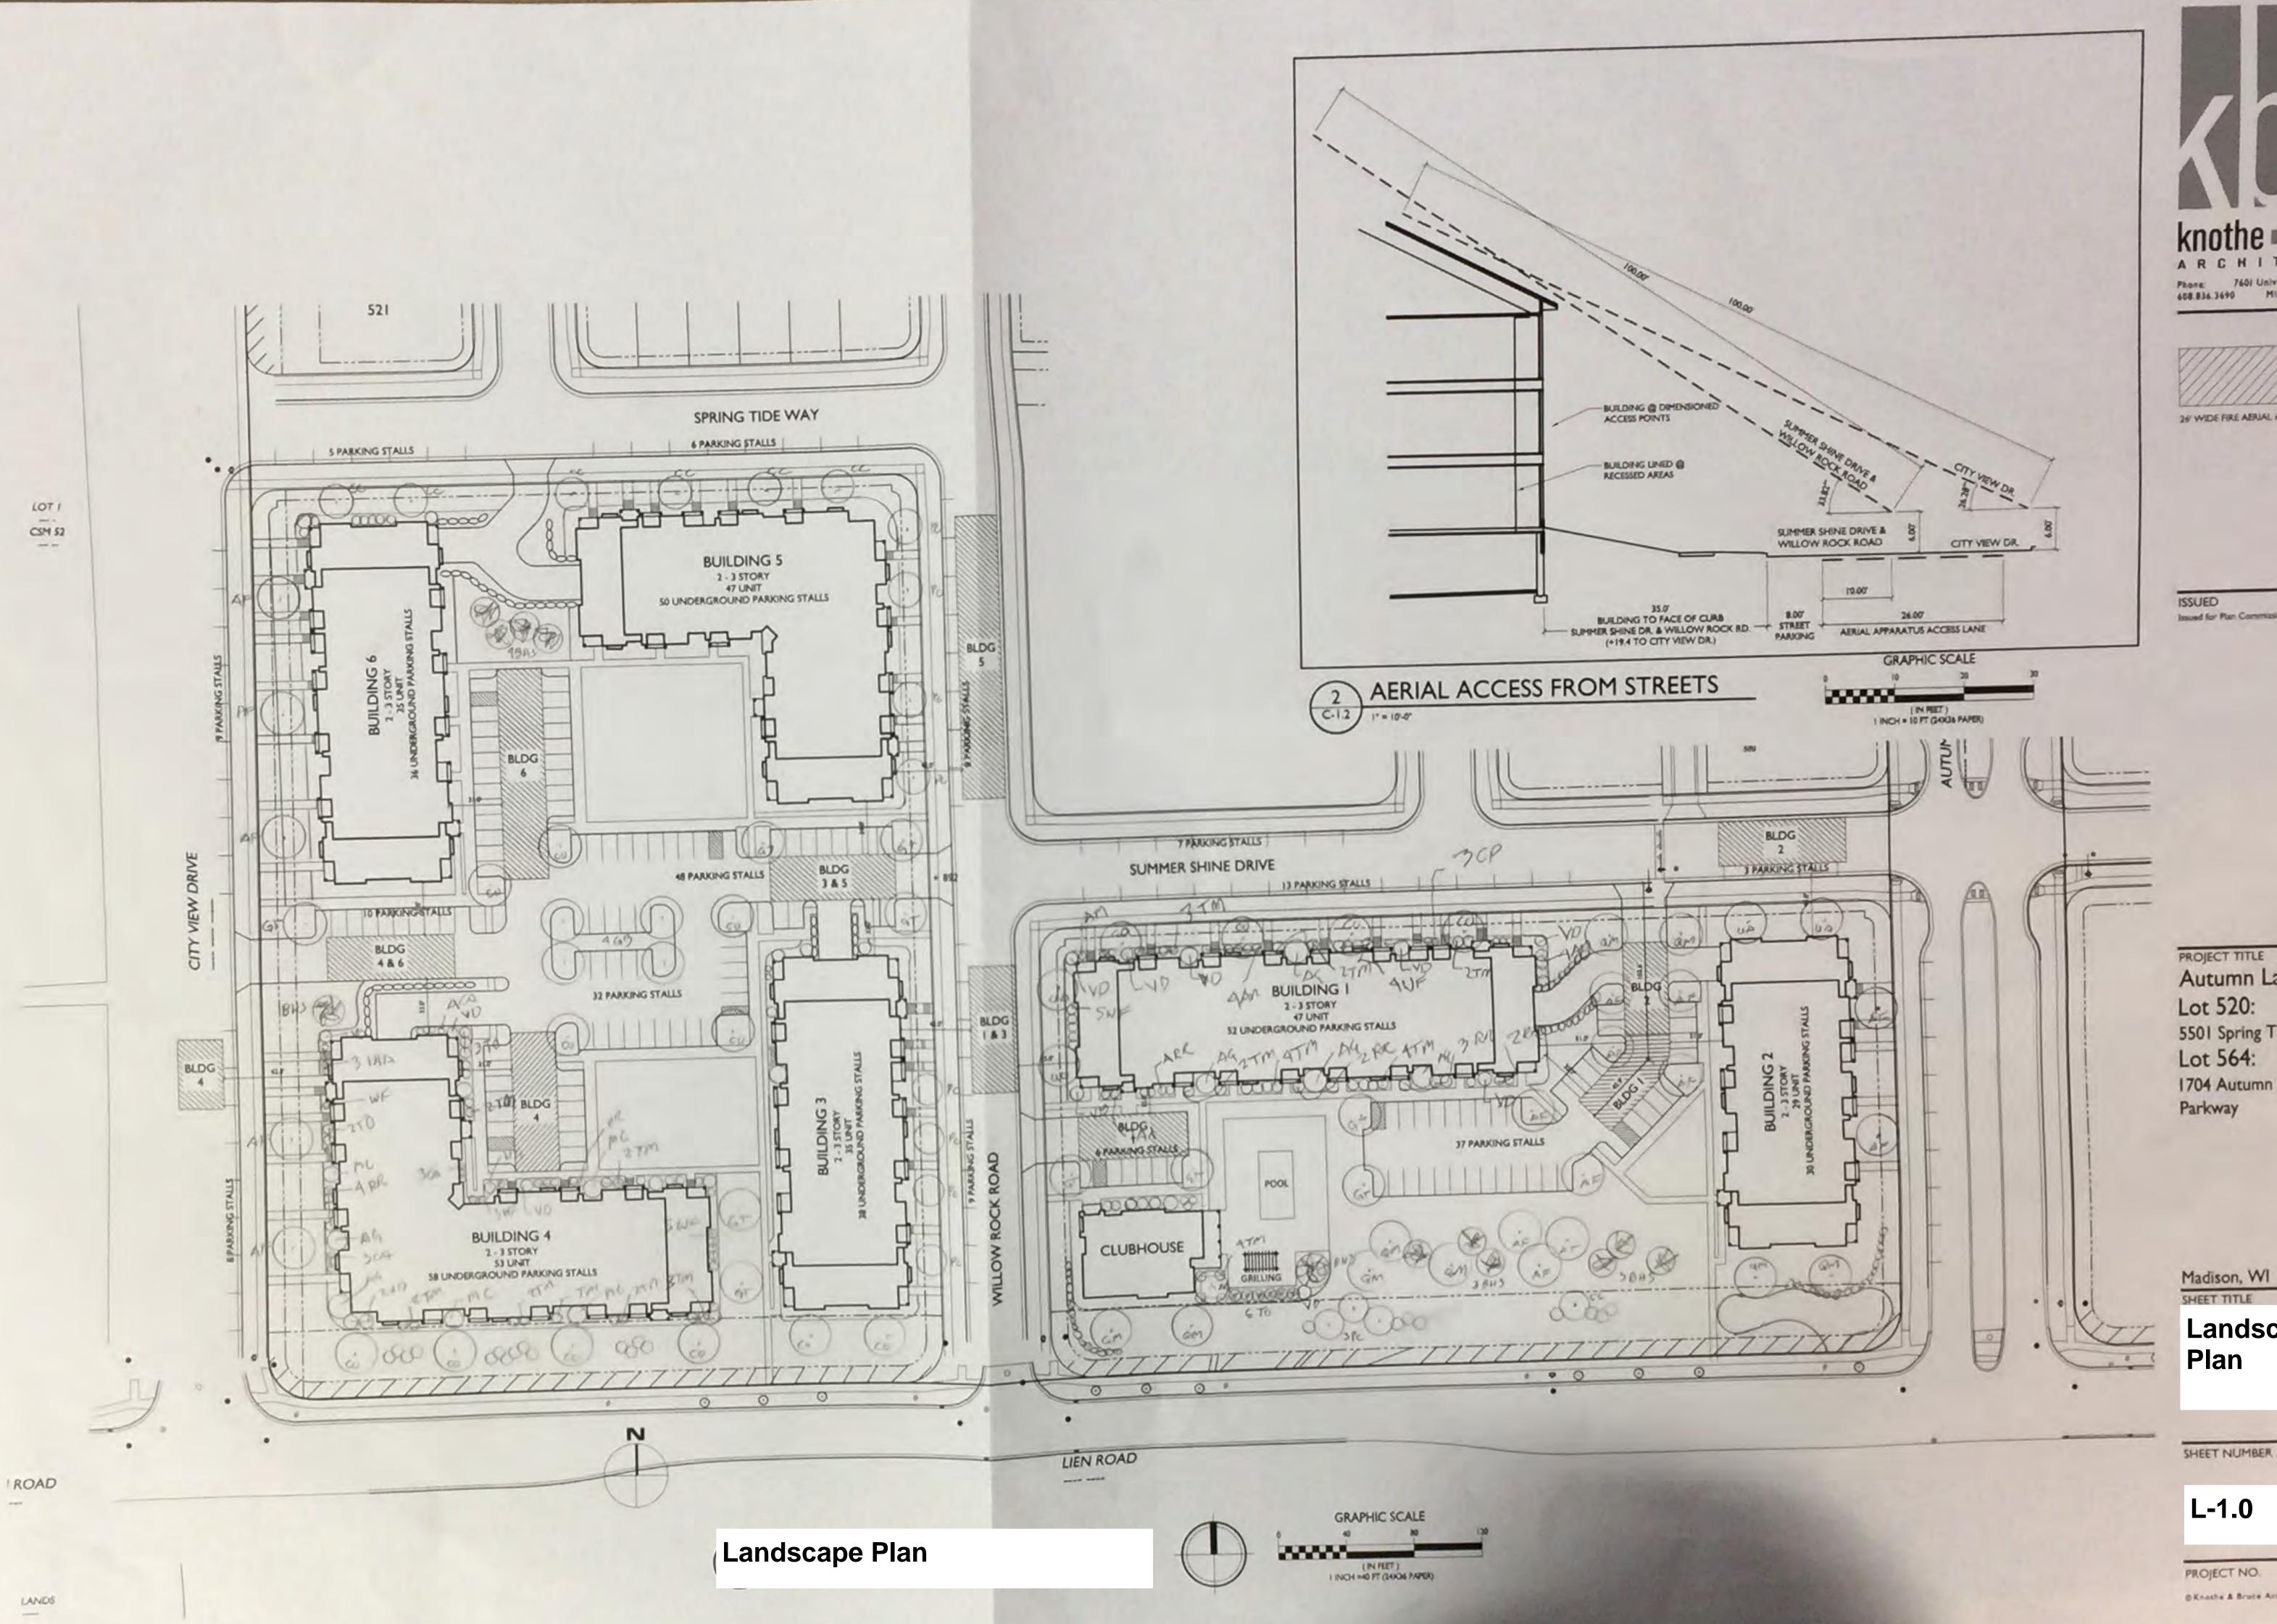
PROJECT NO.

PRELIMINARY - NOT FOR CONSTRUCTION


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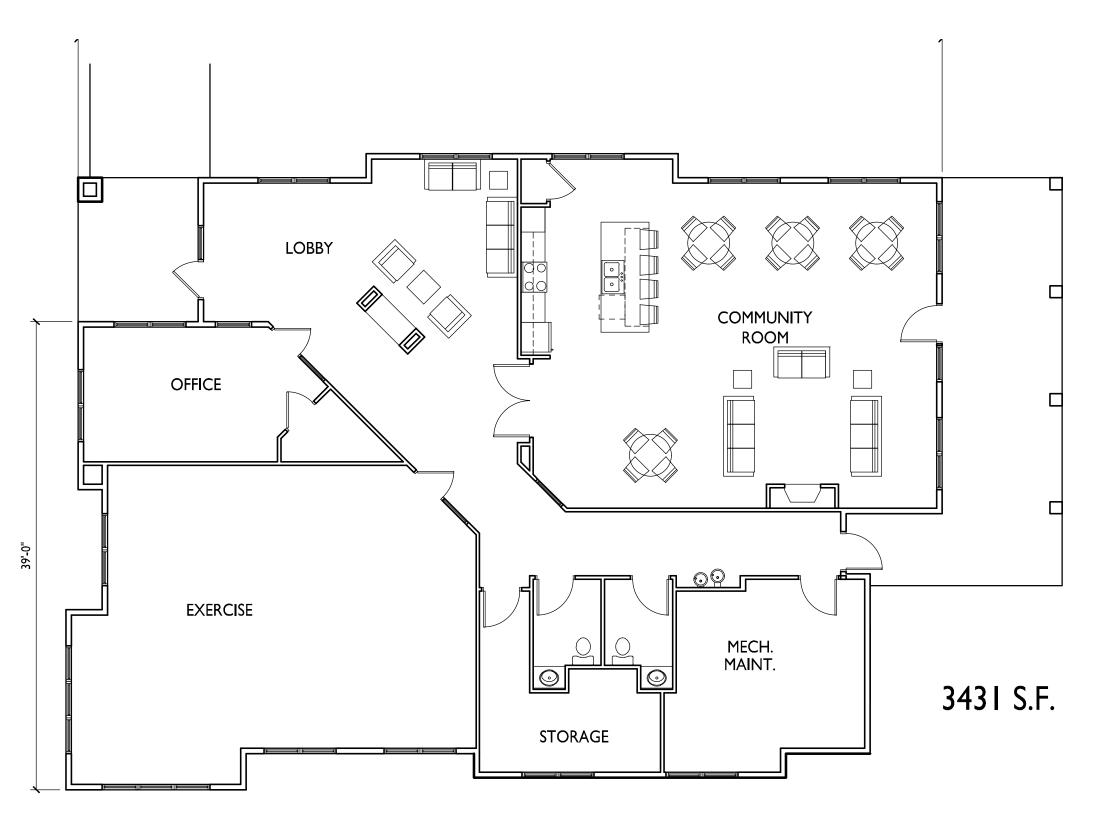
PROJECT TITLE Autumn Lake Lot 520: 5501 Spring Tide Way Lot 564: 1704 Autumn Lake Parkway

Landscape

L-1.0

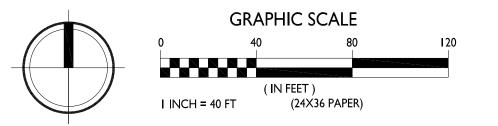PROJECT NO.

1644 SKnothe & Bruce Architects, LLC

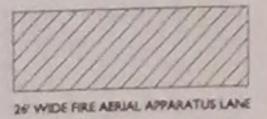



SOUTH ELEVATION

| SOUTH ELEVATION | SOUTH ELEVATION | SOUTH ELEVA



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Issued for Land Use & UDC - January 18, 2017

PROJECT TITLE
Village at Autumn
Lake


Lot 564
1704 Autumn Lake Pkwy
SHEET TITLE
Clubhouse
Plans & Elevations


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A-1.0

PROJECT NO. 164
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PROJECT TITLE Village at Autumn Lake

Lot 564 1704 Autumn Lake Pkwy SHEET TITLE

Basement Floor Plan Building I

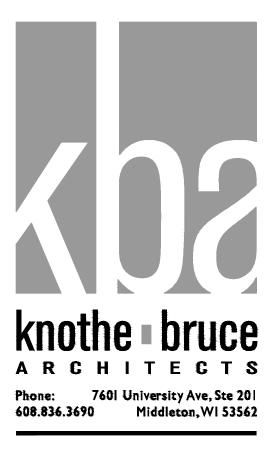SHEET NUMBER

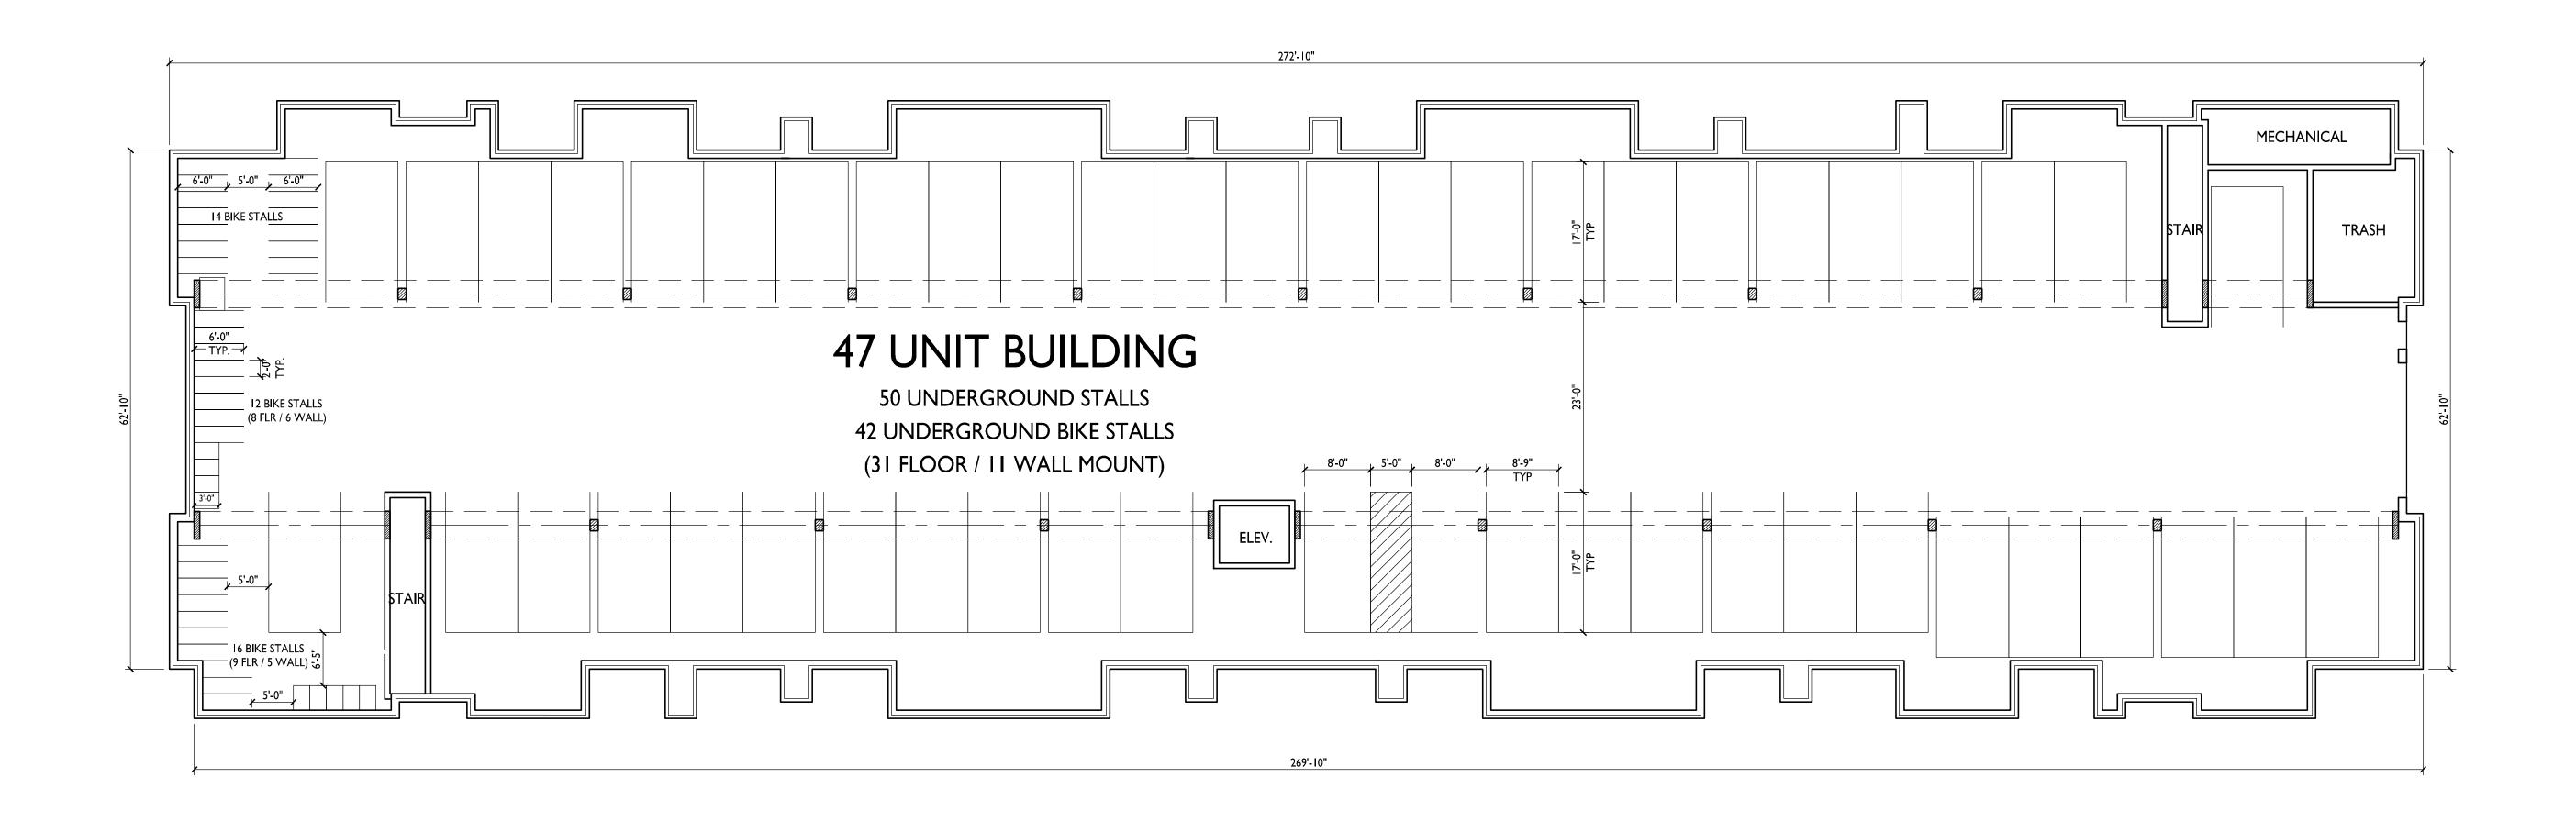
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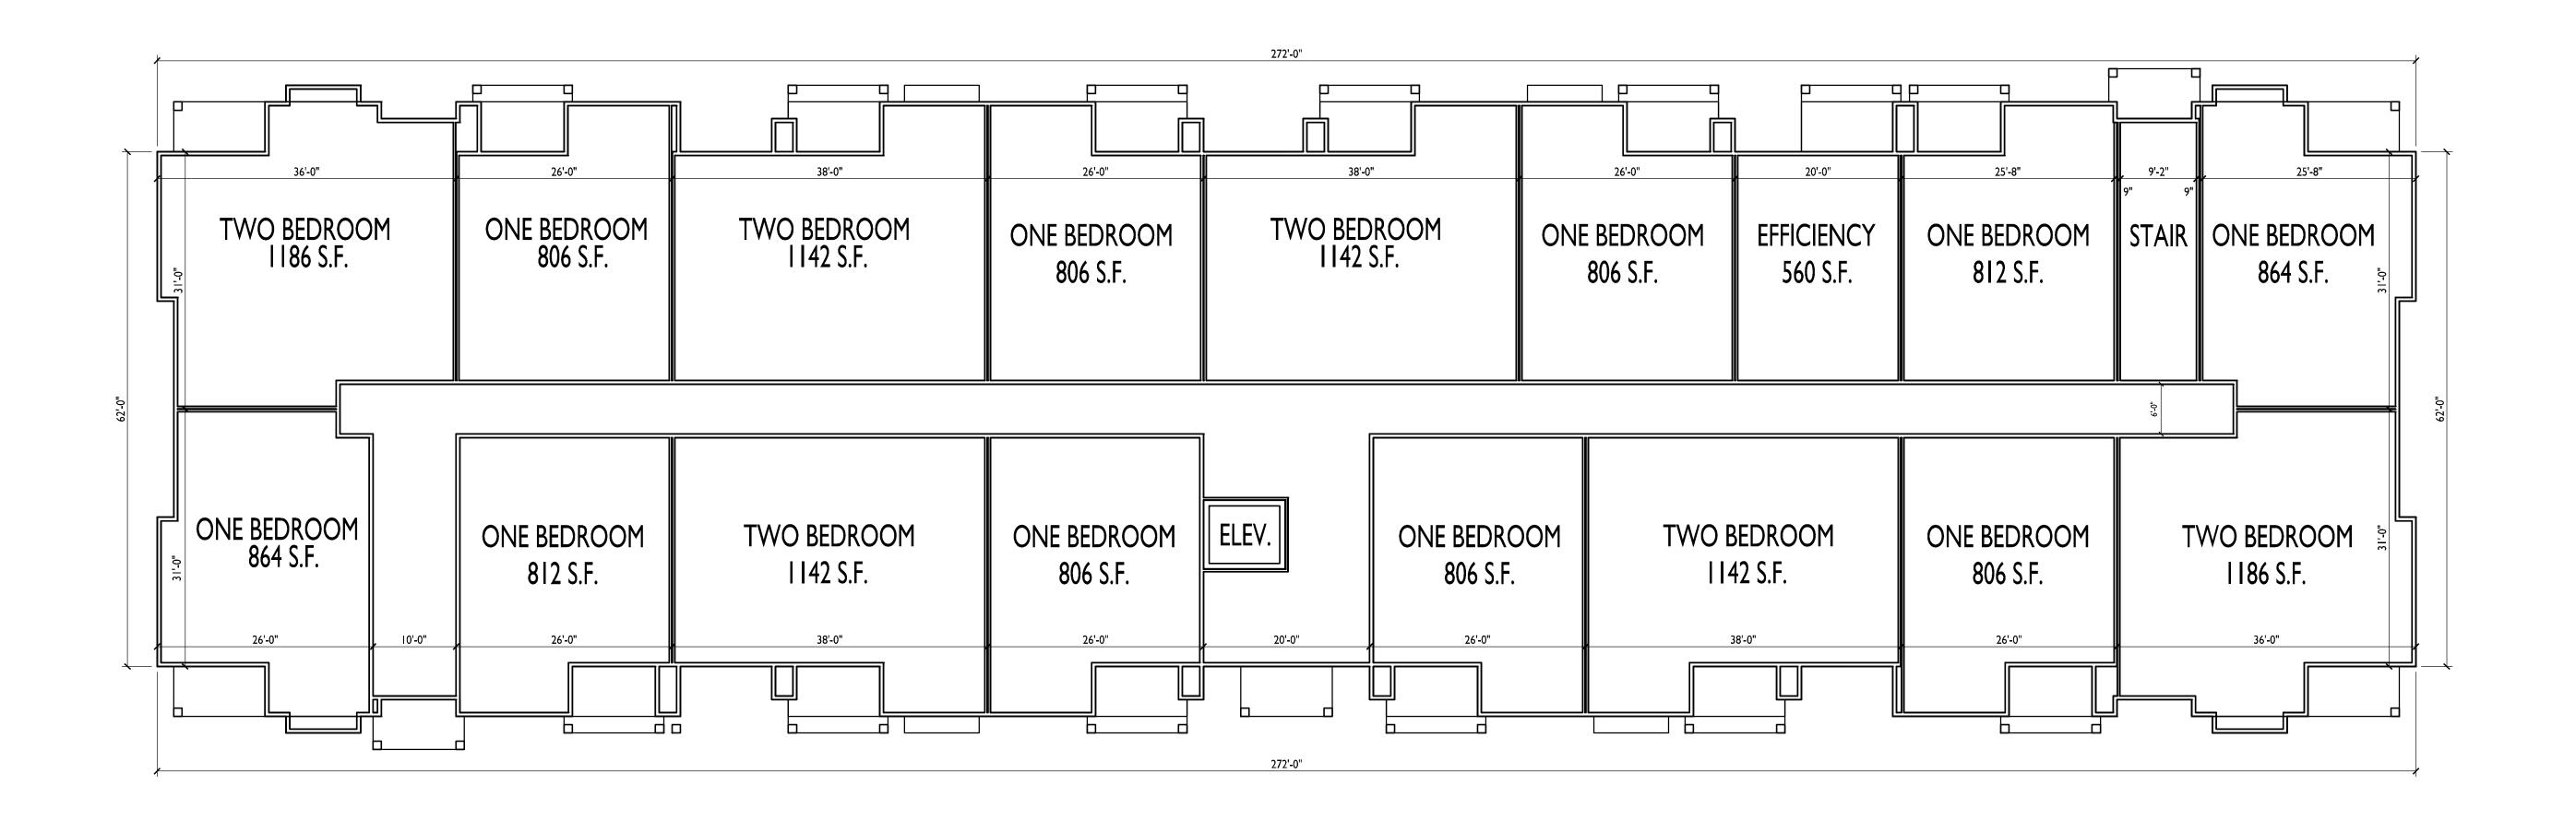
PROJECT NO.

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Village at Autumn
Lake

Lot 564
1704 Autumn Lake Pkwy
SHEET TITLE
First Floor Plan
Building I


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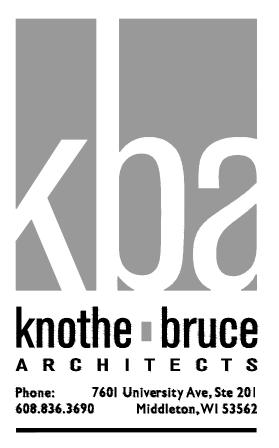
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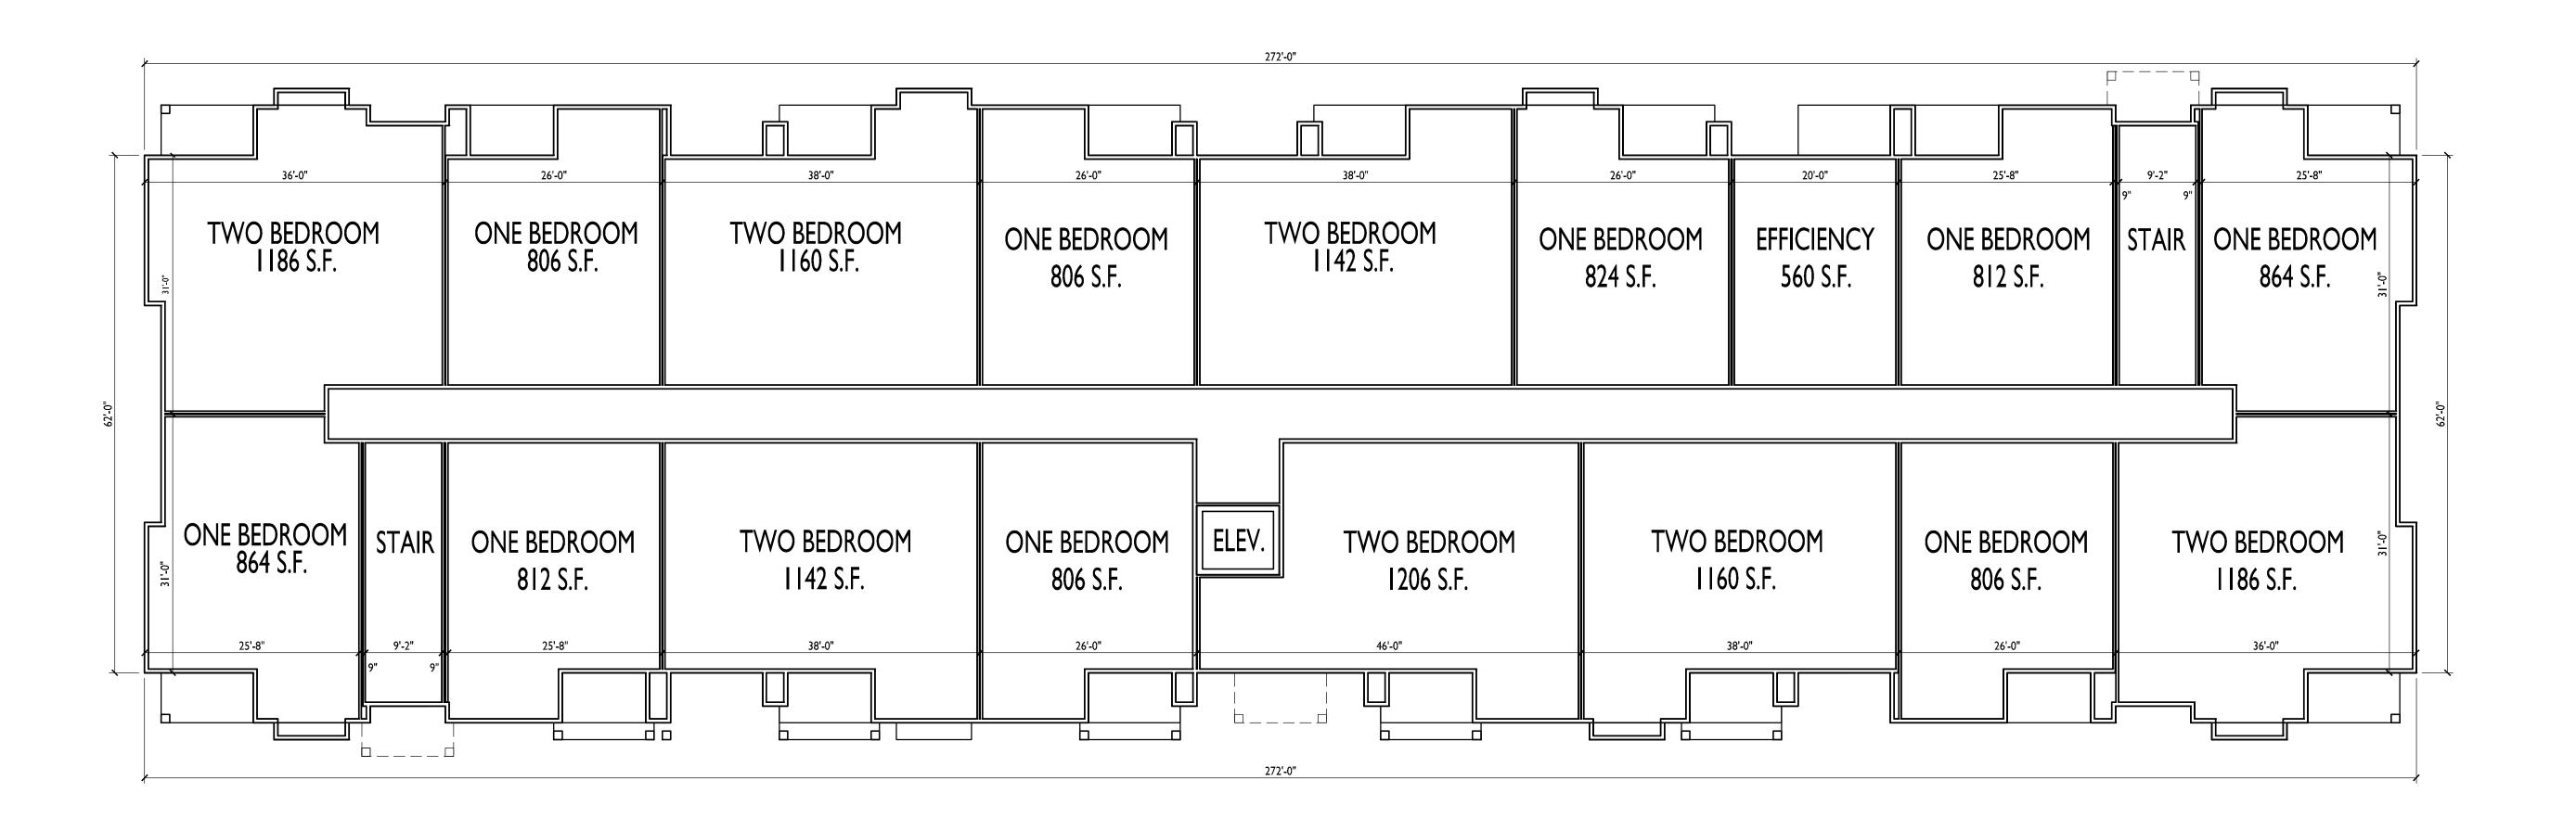
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PROJECT TITLE Village at Autumn Lake

Lot 564 1704 Autumn Lake Pkwy SHEET TITLE Second Floor Plan Building I

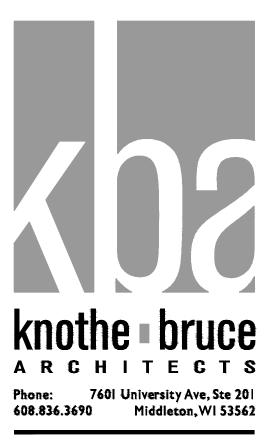SHEET NUMBER

A-1.2


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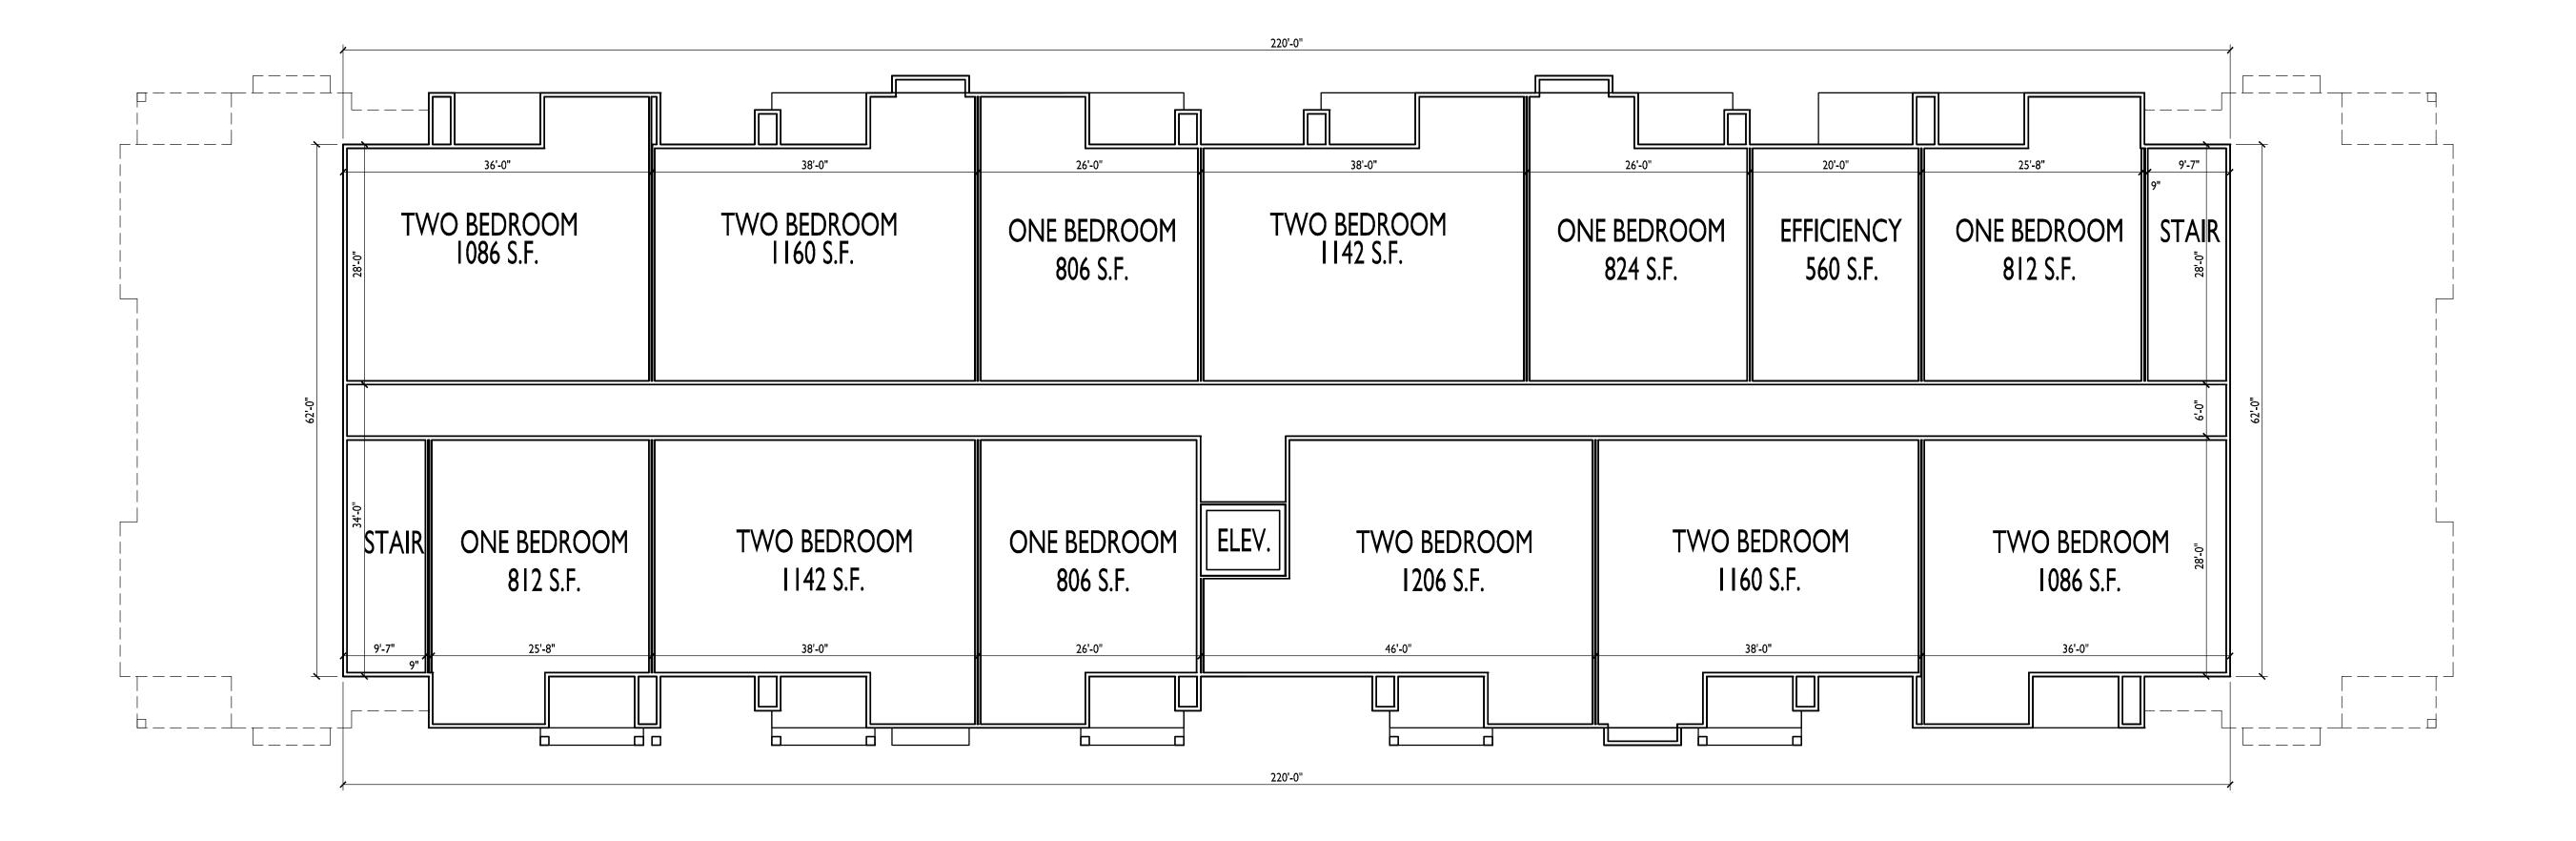
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SECOND FLOOR PLAN

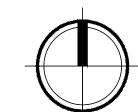1/8" = 1'-0"





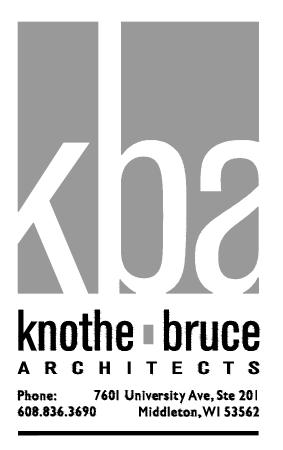

PROJECT TITLE Village at Autumn Lake

Lot 564 1704 Autumn Lake Pkwy SHEET TITLE
Third Floor Plan Building I

SHEET NUMBER

A-1.3

PROJECT NO. 1644

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SOUTH ELEVATION

PROJECT TITLE Village at Autumn Lake

> Lot 564 1704 Autumn Lake Pkwy SHEET TITLE Exterior Elevations Building I


SHEET NUMBER

A-2.1

PROJECT NO. © Knothe & Bruce Architects, LLC



NORTH ELEVATION
(ALONG SUMMER SHINE DR.)

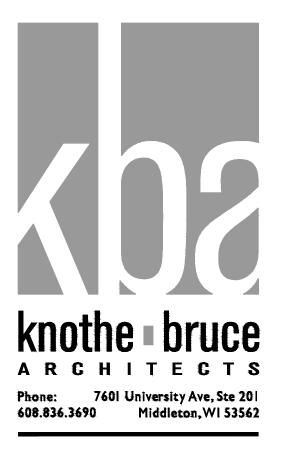



EAST ELEVATION

A-2.2

I/8"=1'-0"



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PROJECT TITLE
Village at Autumn Lake

WEST ELEVATION
(ALONG WILLOW ROCK RD.)


1/8"=1'-0"

Lot 564 1704 Autumn Lake Pkwy SHEET TITLE Exterior Elevations Building I

SHEET NUMBER

A-2.2

PROJECT NO. © Knothe & Bruce Architects, LLC

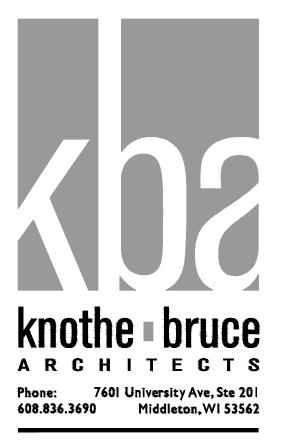


Village at Autumn
Lake

Lot 564
1704 Autumn Lake Pkwy
SHEET TITLE
Basement Floor Plan
Building 2

SHEET NUMBER


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PROJECT NO. 64



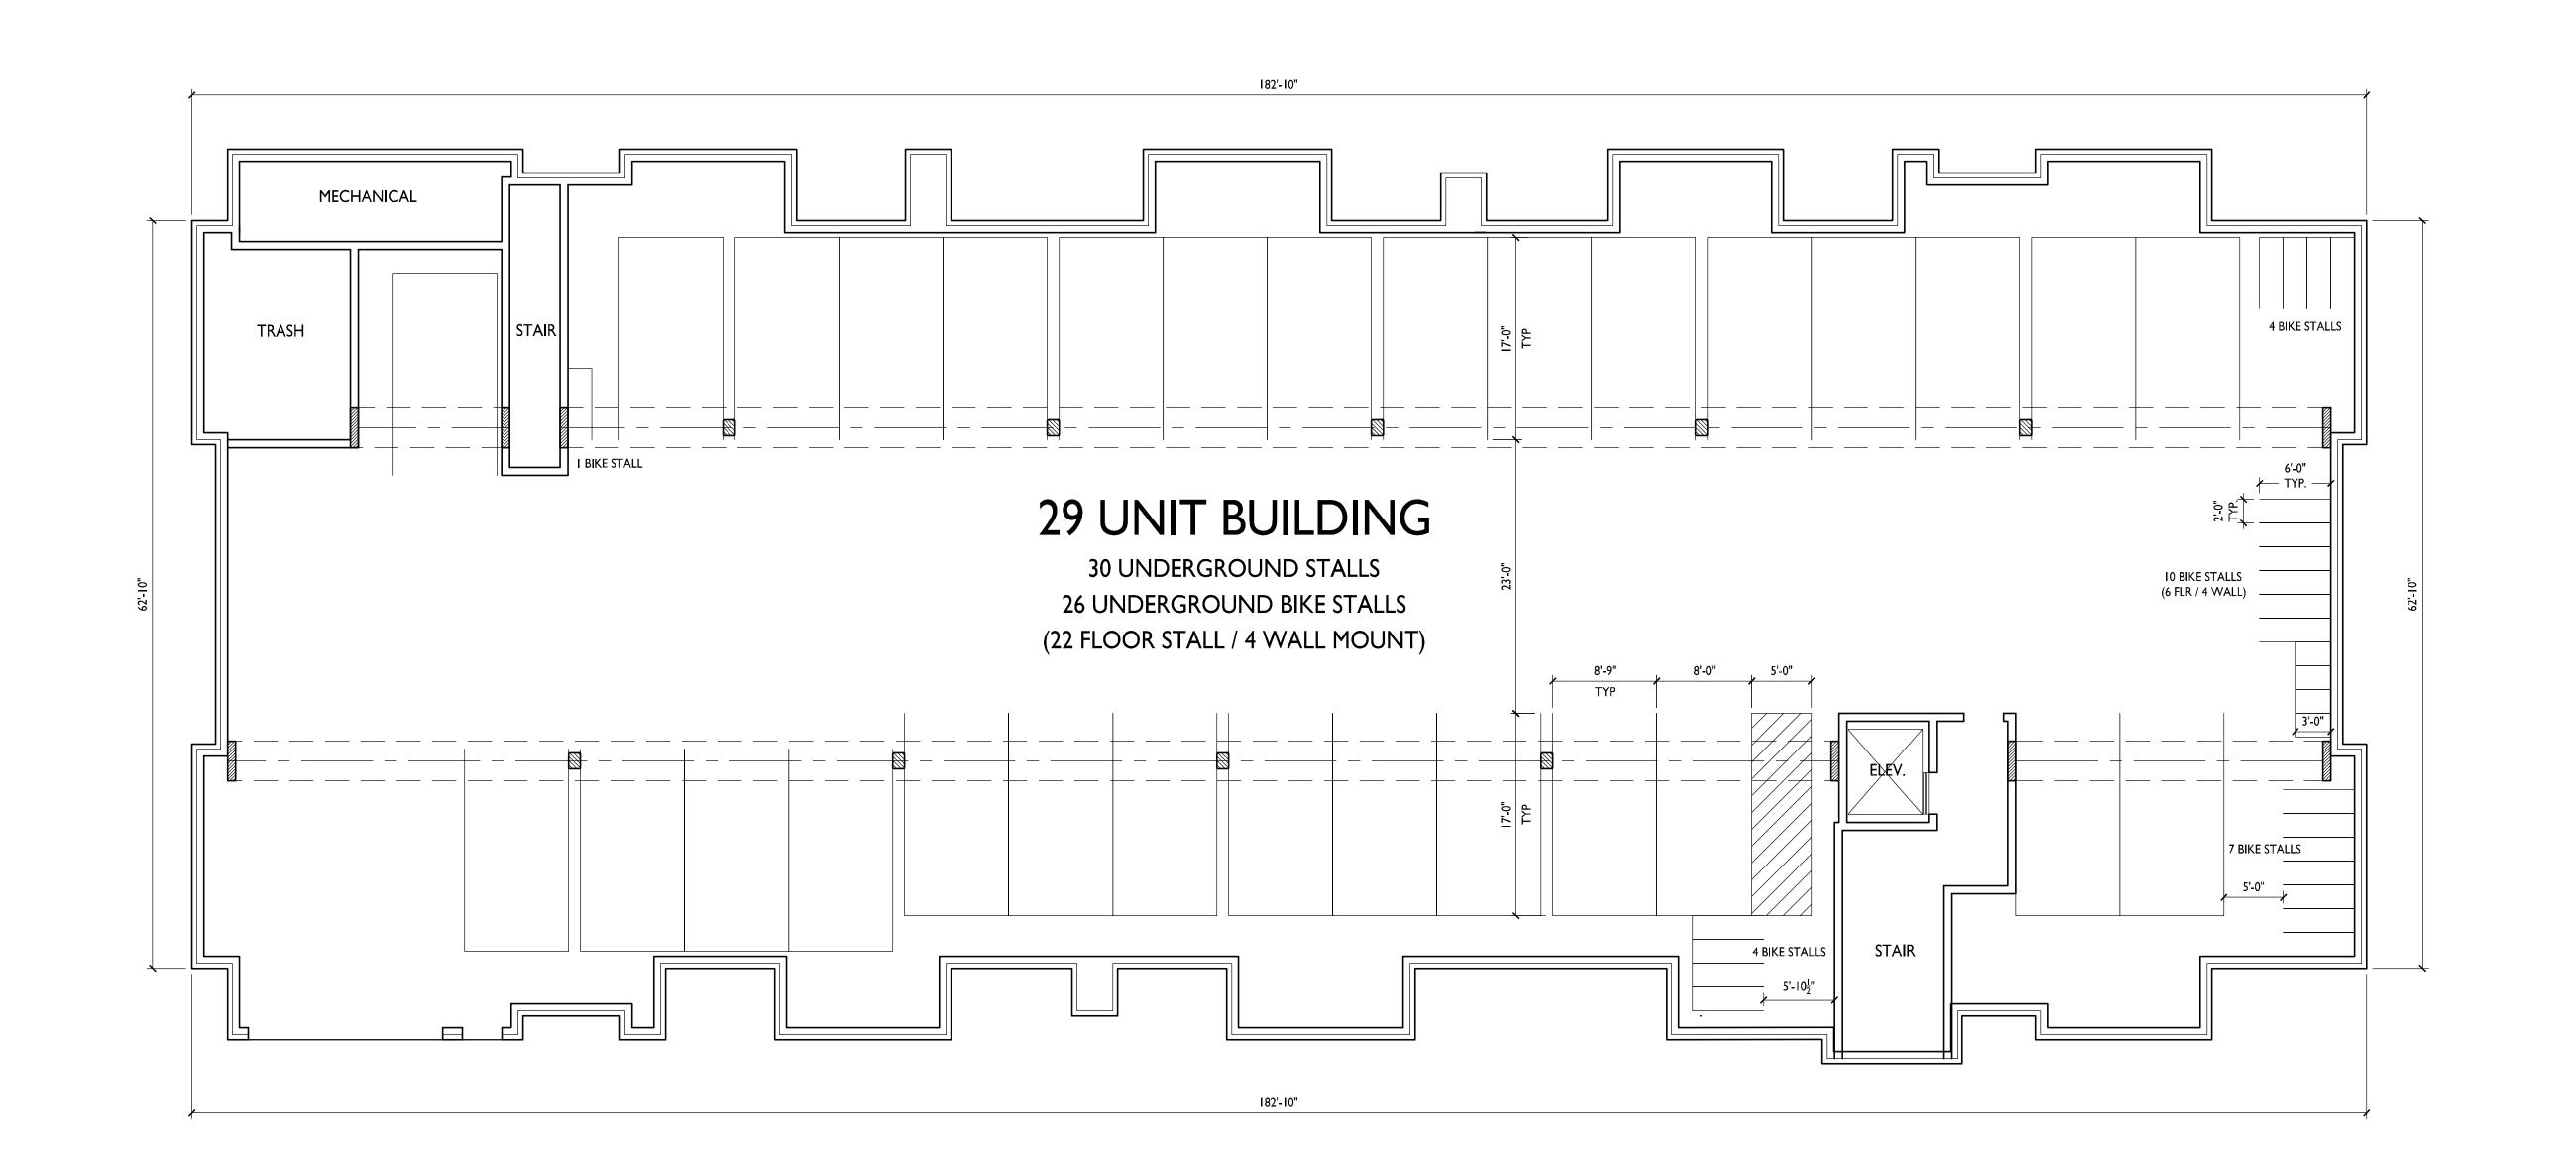



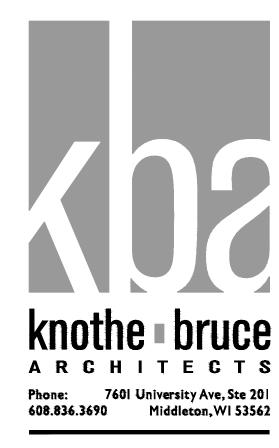


PROJECT TITLE
Village at Autumn
Lake

Lot 564
1704 Autumn Lake Pkwy
SHEET TITLE
First Floor Plan
Building 2


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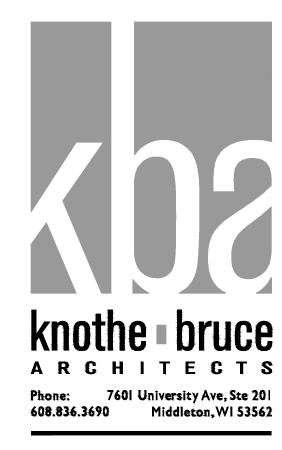


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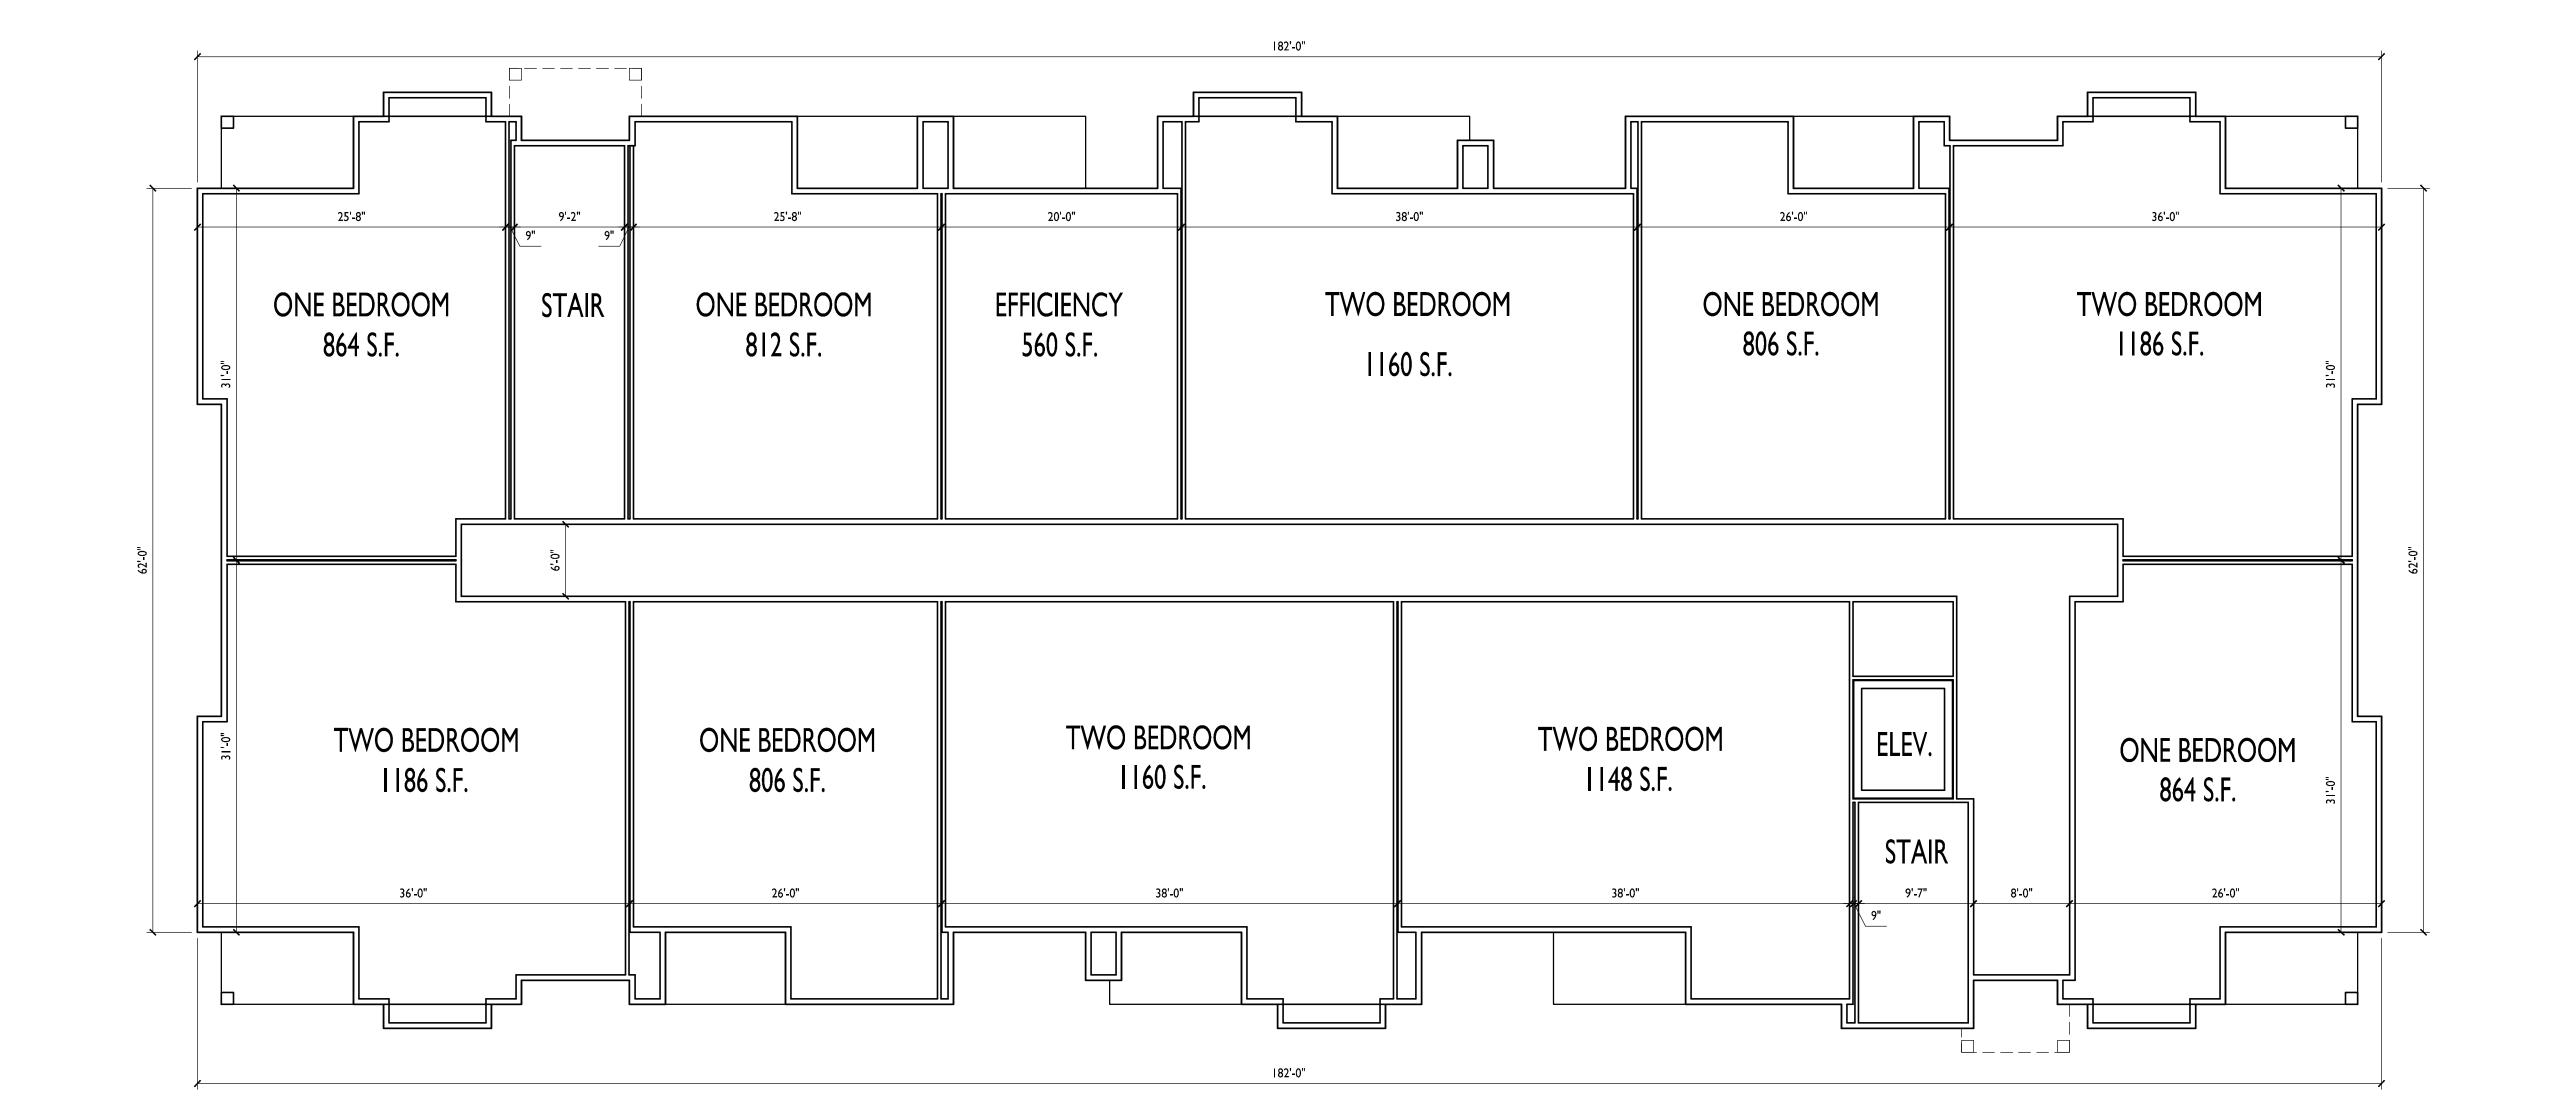
PROJECT TITLE
Village at Autumn
Lake

Lot 564
1704 Autumn Lake Pkwy
SHEET TITLE
Second Floor Plan
Building 2

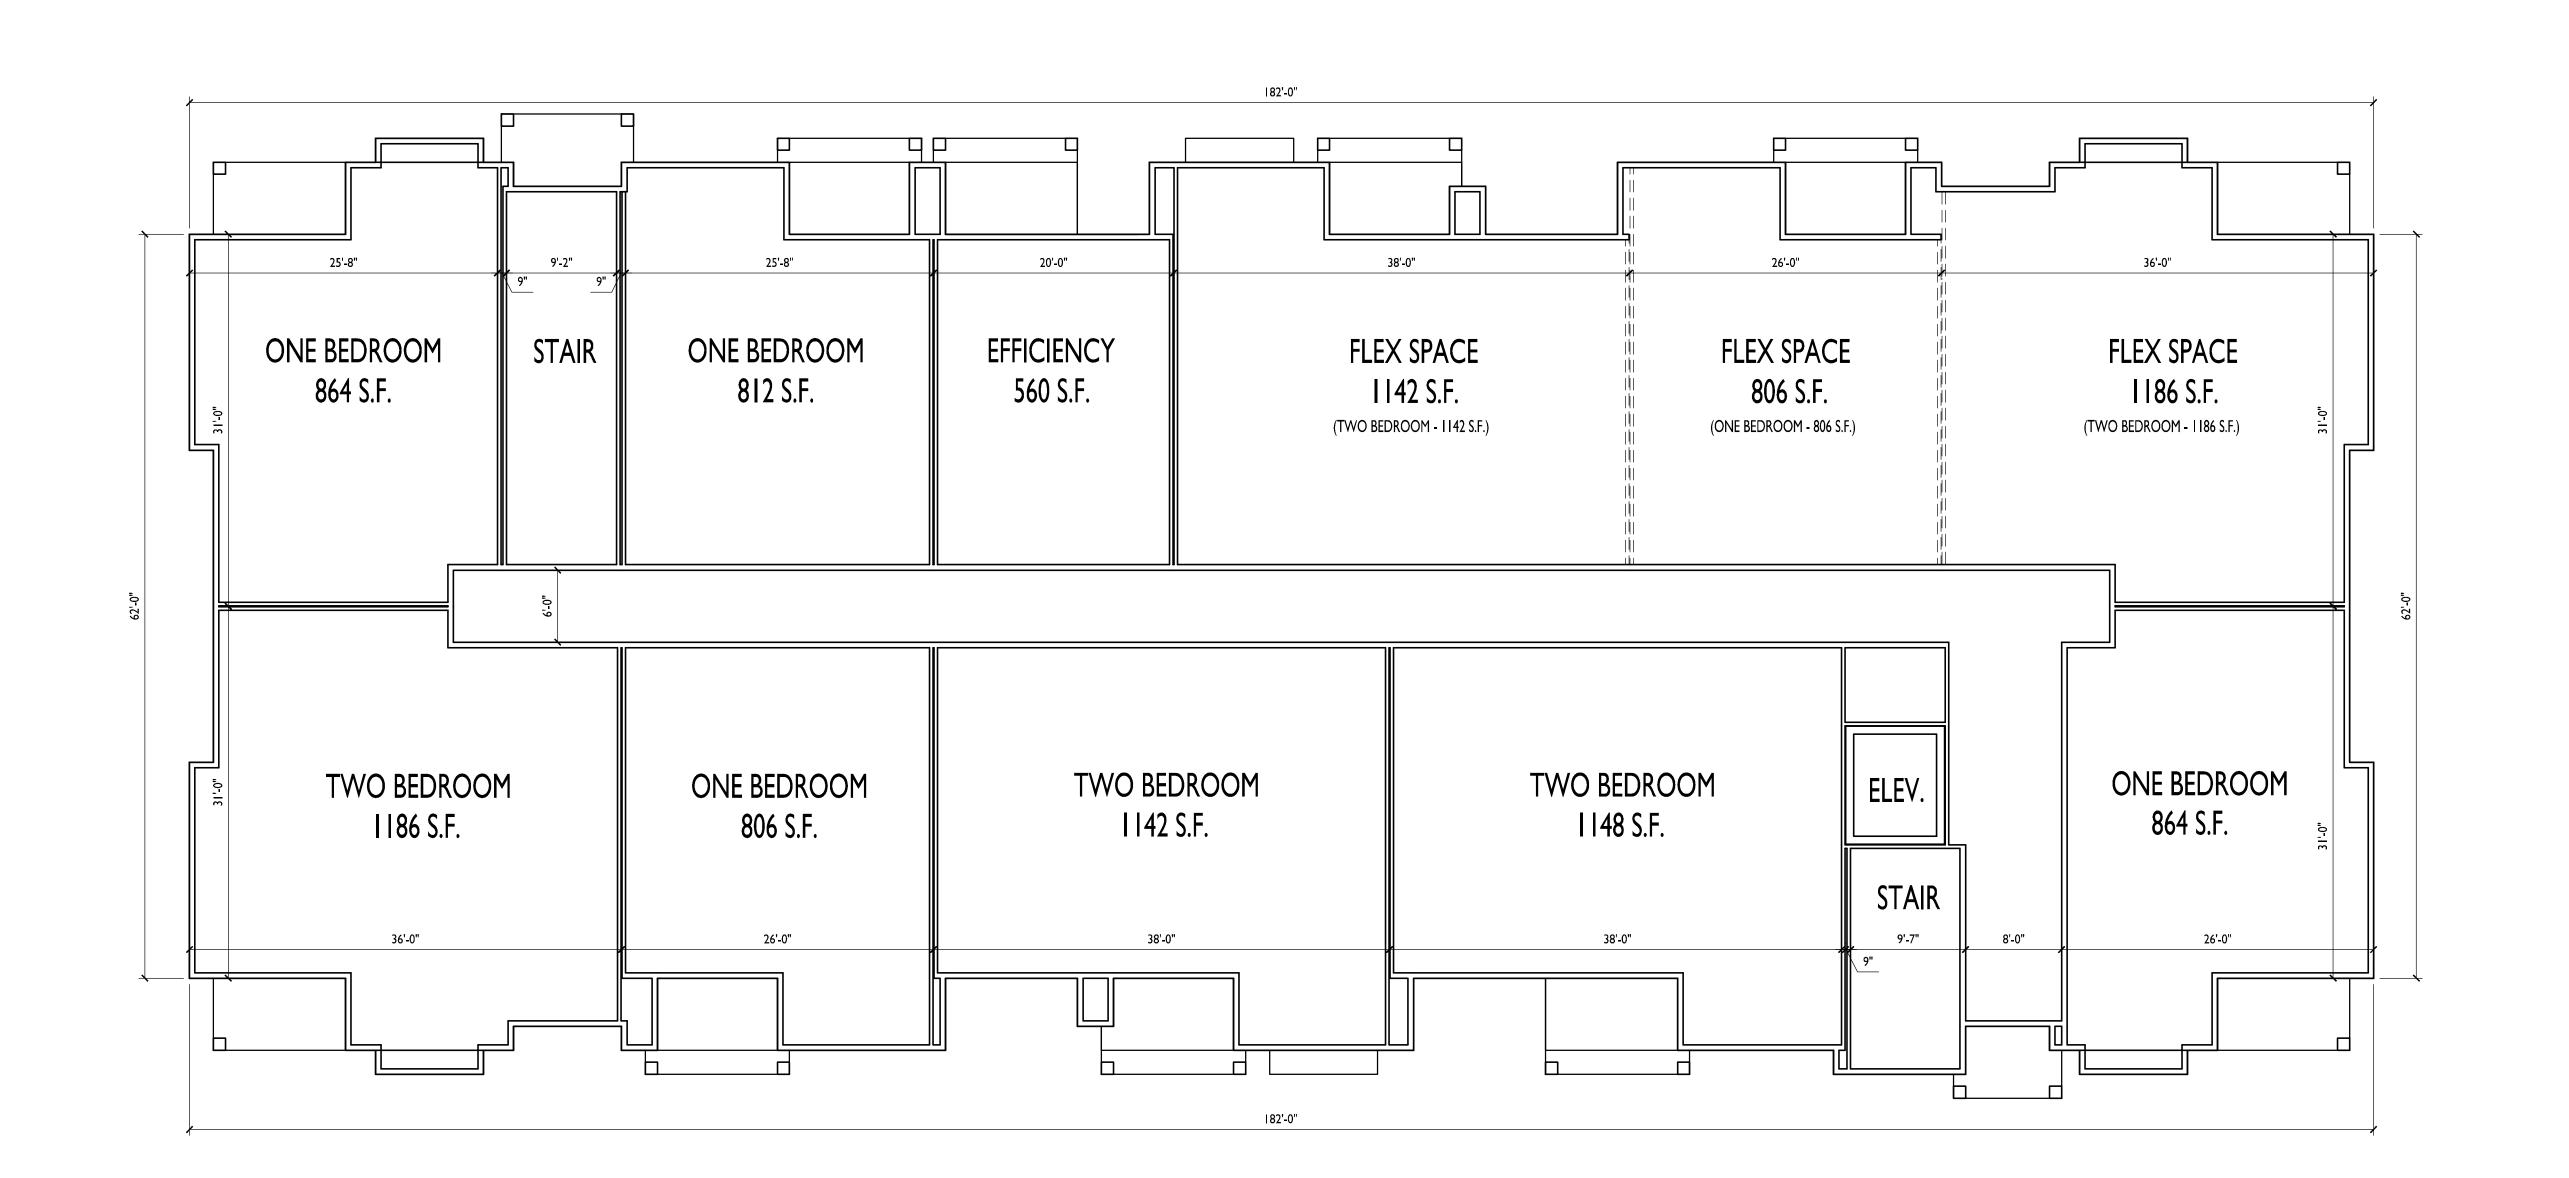
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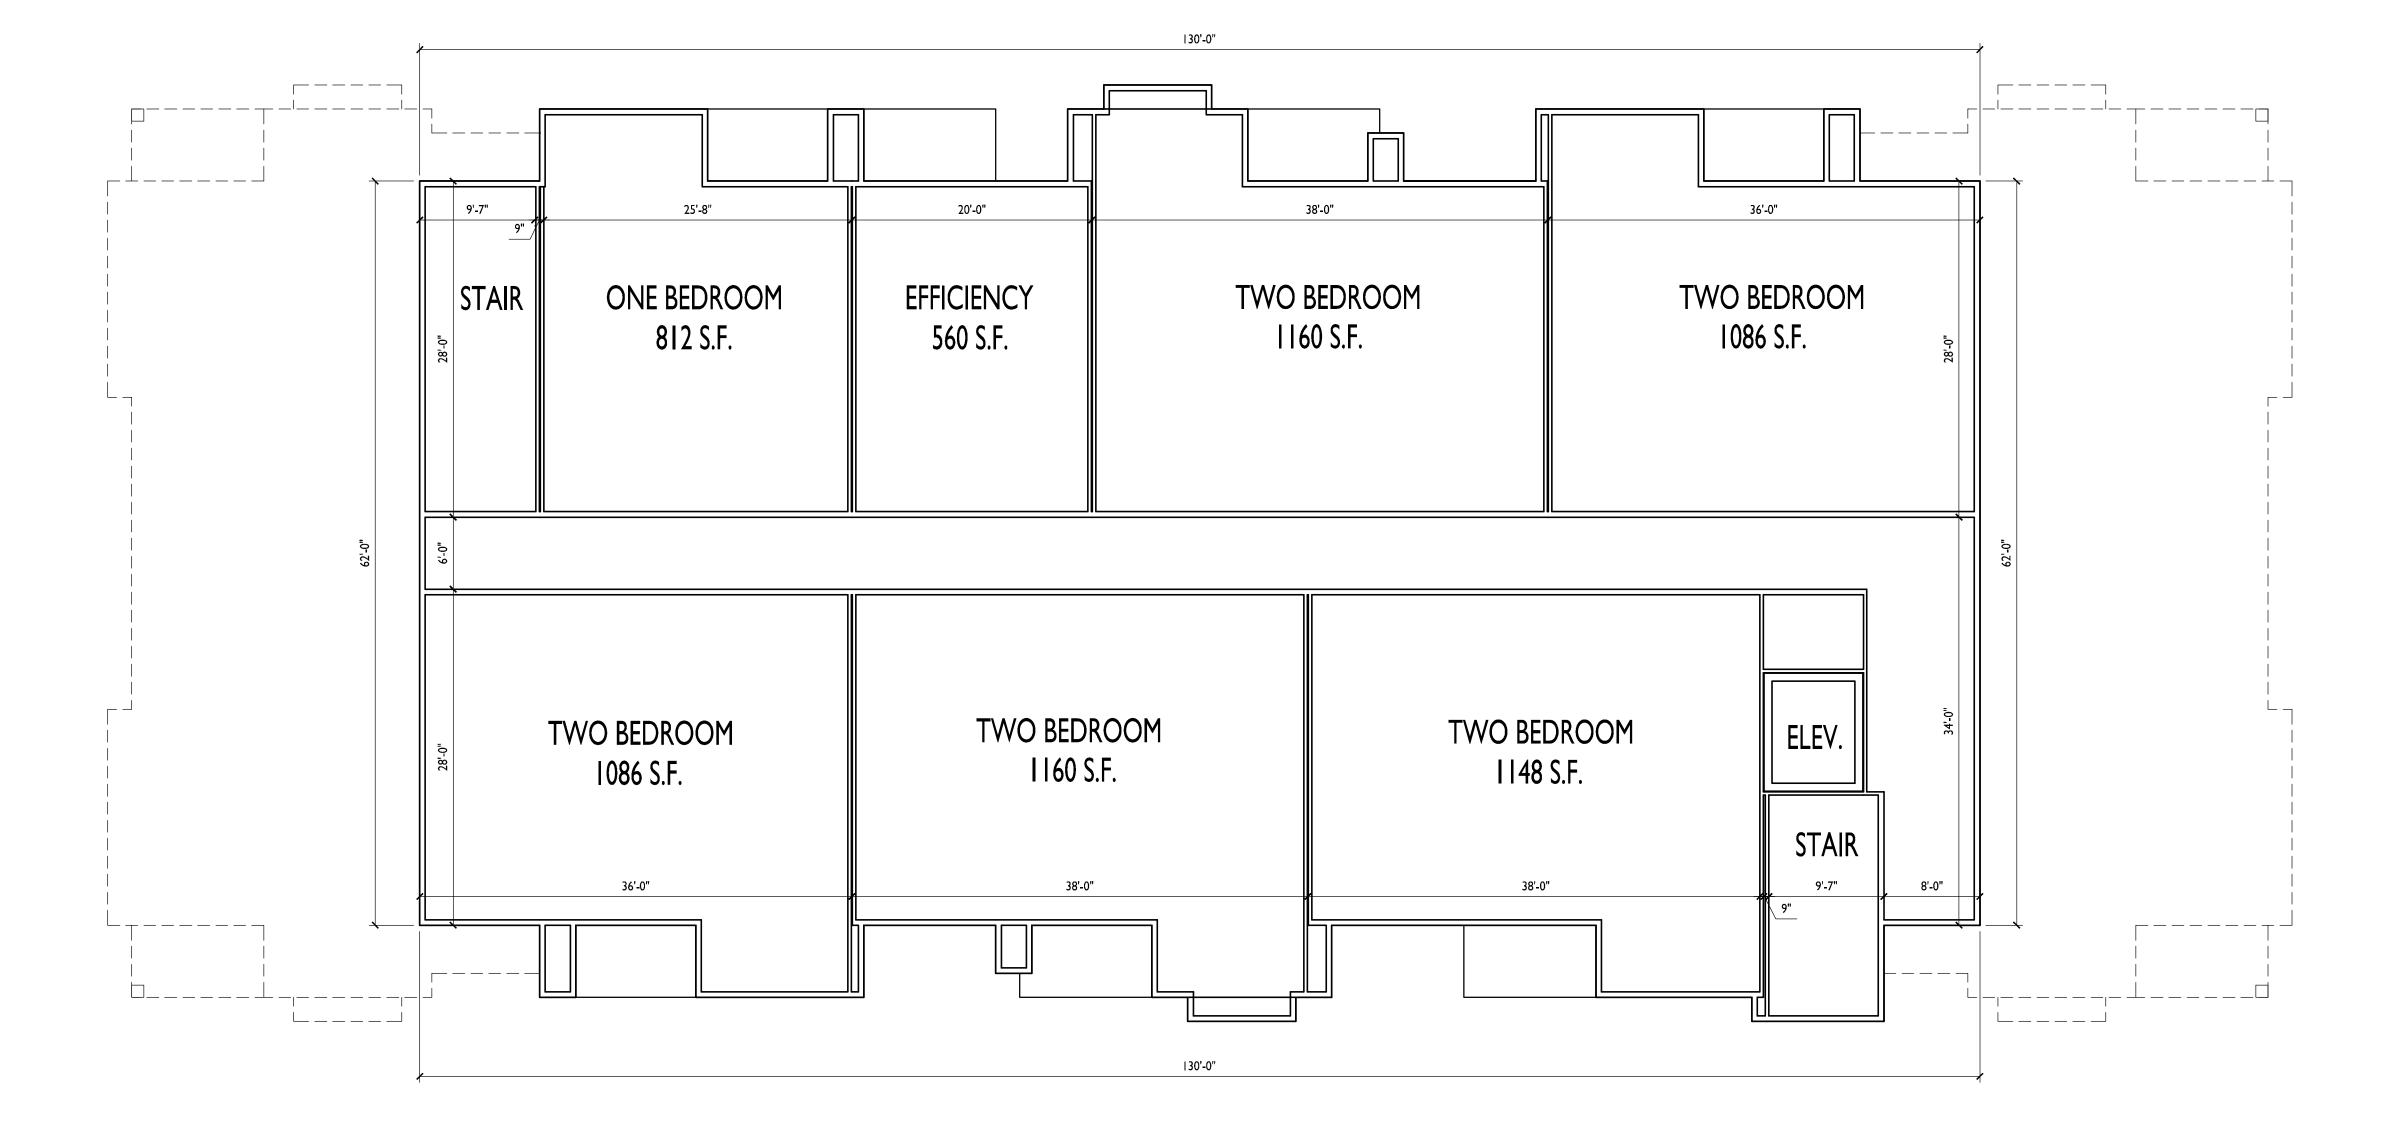
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PROJECT NO. 644



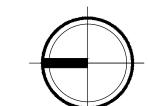



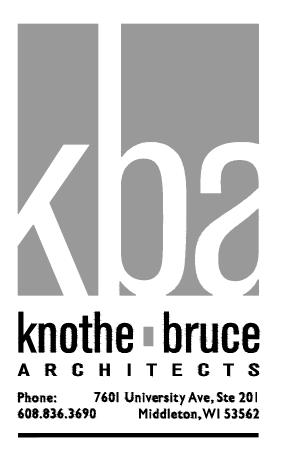

PROJECT TITLE

Village at Autumn Lake

Lot 564 1704 Autumn Lake Pkwy SHEET TITLE
Third Floor Plan Building 2

SHEET NUMBER


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PROJECT TITLE
Village at Autumn
Lake


Lot 564
1704 Autumn Lake Pkwy
SHEET TITLE
Exterior Elevations
Building 2

SHEET NUMBER

A-2.1

PROJECT NO. 6
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PROJECT TITLE
Village at Autumn
Lake

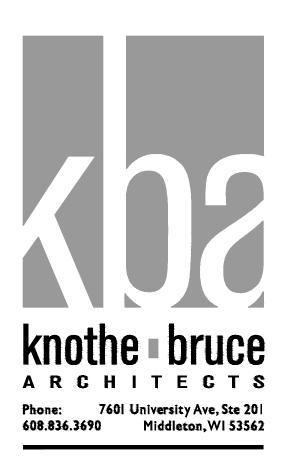Lot 564
1704 Autumn Lake Pkwy
SHEET TITLE

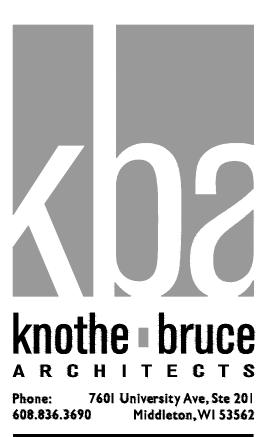Exterior Elevations
Building 2

SHEET NUMBER

A-2.2

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PROJECT NO.

NORTH ELEVATION
(ALONG SUMMER SHINE DR.)


SOUTH ELEVATION
(ALONG LIEN RD.)


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1/8"=1'-0"








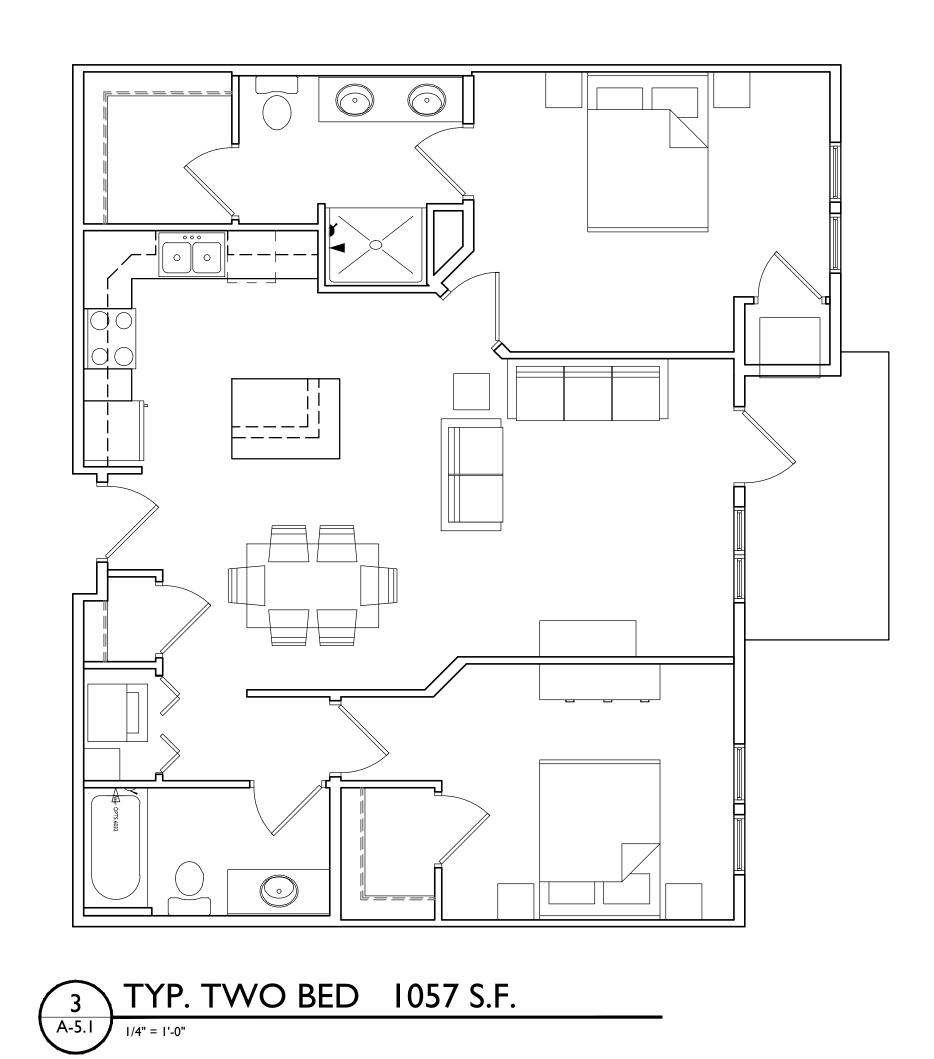

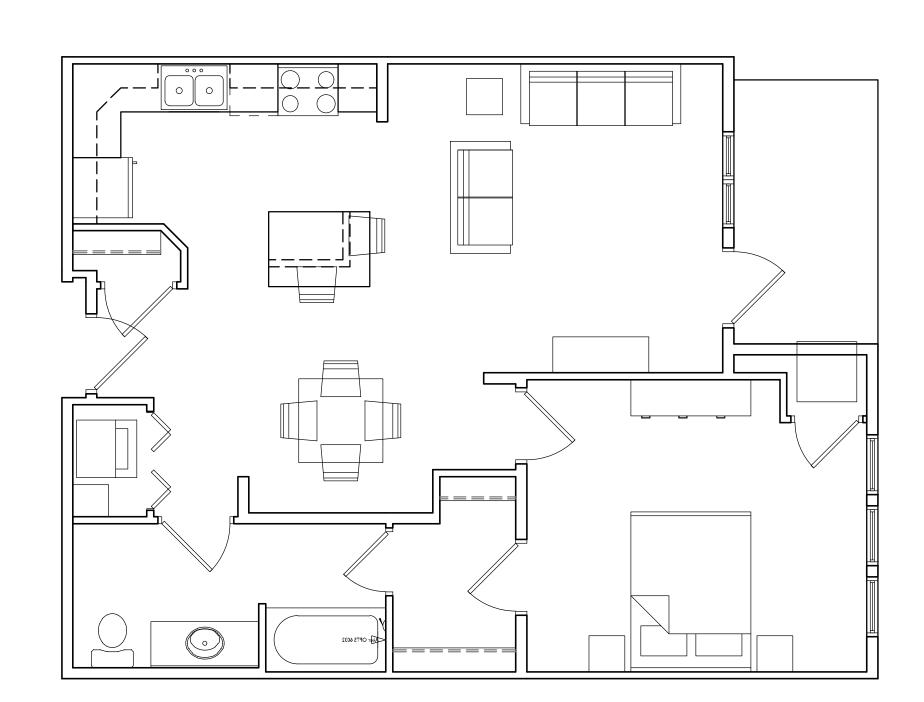2 TYP. ONE BED 809 S.F.

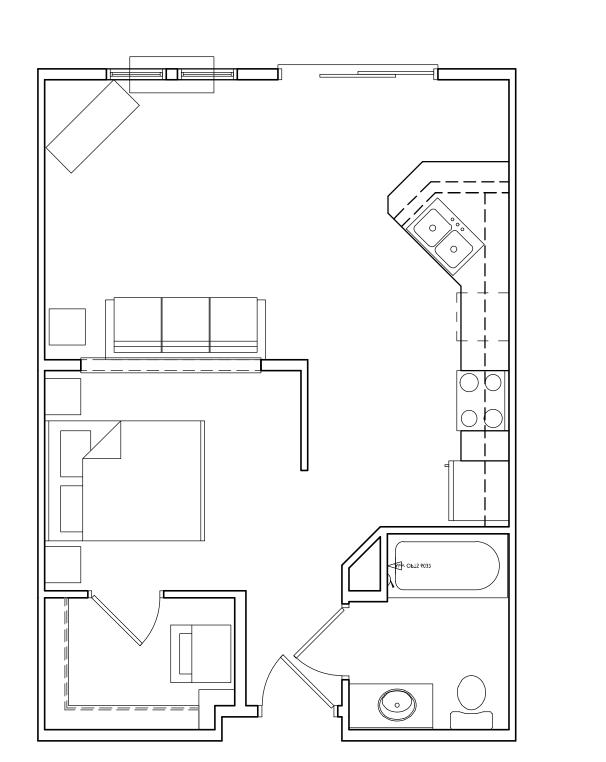

4 TYP. EFFICIENCY 560 S.F.



PROJECT TITLE
Village at Autumn
Lake

Lot 520 & 564
5501 Spring Tide Way
SHEET TITLE

SHEET TITLE
Typical Unit Plans

SHEET NUMBER

A-5.1

PROJECT NO. 6 Knothe & Bruce Architects, LLC