

## City of Madison

### Conditional Use

Location

202 South Gammon Road

Project Name

MMSD - Work and Learn Build Out

**Applicant** 

Livesy Co. / Steven Kieckhafer – Plunkett Raysich, LLP

Existing Use


Multi-tenant commercial building

Proposed Use


Construct school in existing multi-tenant commercial building

Public Hearing Date Plan Commission

17 October 2016

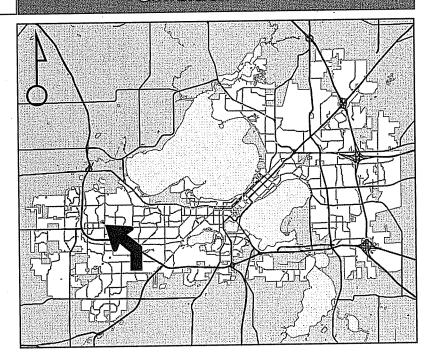

For Questions Contact: Chris Wells at: 261-9135 or cwells@cityofmadison.com or City Planning at 266-4635

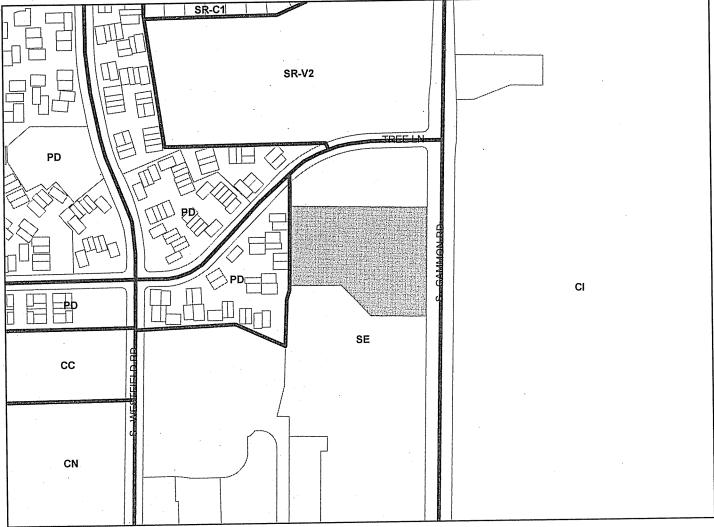


Scale: 1'' = 400'

City of Madison, Planning Division: PPE: Date: 11 October 2016



## City of Madison

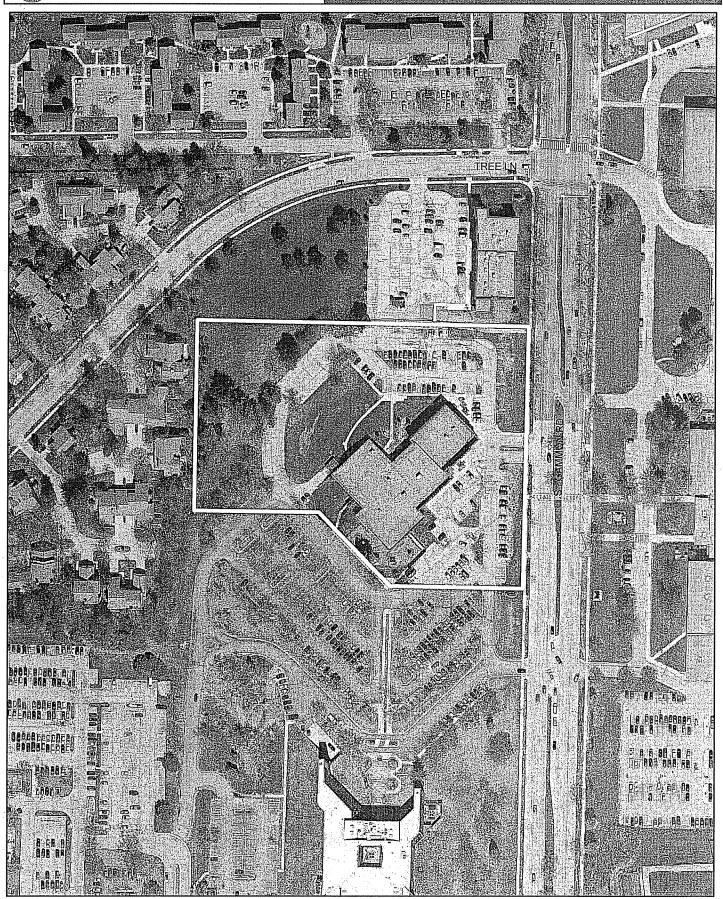

Date of Aerial Photography: Spring 2016



## LAND USE APPLICATION

**CITY OF MADISON** 

- All Αc
- Th Co sh
- Th W١

Madison <sub>n</sub> ,	
215 Martin Luther King Jr. Blvd; Room LL-100 PO Box 2985; Madison, Wisconsin 53701-2985 Phone: 608.266.4635   Facsimile: 608.267.8739	FOR OFFICE USE ONLY:  Amt. Paid Receipt No  Date Received
<ul> <li>All Land Use Applications should be filed with the Zoning Administrator at the above address.</li> </ul>	Aldermanic District 9-Paul Ski Duwe
<ul> <li>The following information is required for all applications for Plan Commission review except subdivisions or land divisions, which should be filed using the <u>Subdivision Application</u>.</li> </ul>	Zoning District  Special Requirements  Review Required By:
<ul> <li>This form may also be completed online at: <u>www.cityofmadison.com/developmentcenter/landdevelopment</u></li> </ul>	Urban Design Commission Plan Commission Common Council Other: Form Effective: February 21, 2013
1. Project Address: 202 S Gammon Ave	
Project Title (if any): Madison Metropolitan School District - Work and L	eam Build-Out
<ul> <li>□ Review of Alteration to Planned Development (By Plan Com</li> <li>□ Conditional Use, or Major Alteration to an Approved Condition</li> <li>□ Demolition Permit</li> <li>□ Other Requests:</li> <li>□ Applicant, Agent &amp; Property Owner Information:</li> </ul>	Major Amendment to Approved PD-SIP Zoning mission)  onal Use
Applicant Name: Rick Hopke Compan	y: Madison Metropolitan School District
Street Address: 545 W Dayton St. City/State: M	ladison, WI Zip: 53703
Telephone: (608) 204-7912 Fax: () E	mail: rhopke@madison.k12.wi.us
2240 Croopmade Dr. Cuite 2000	y: Plunkett Raysich Architects, LLP ladison, WI 7in: 53718
.608 . 240-9900	aki-akh-fa-Qh
Telephone: (600) 240-9900 Fax: () E	mail: skiecknaier@prarcn.com
Property Owner (if not applicant): Livesey Co.	
Street Address: 2248 Deming Way, Suite 200 City/State: M	liddleton, WI Zip: 53562
4. Project Information:  Provide a brief description of the project and all proposed uses of the to accommodate classroom space. Exiting toilet room facilities, custodial, and mechanical spaces to re	site: Interior renovation of existing 5,260 sf space

#### 4. P

Development Schedule: Commencement

August 2016

Completion

September 2016

#### 5. Required Submittal Information

All Land Use applications are required to include the following:

- **✓ Project Plans** including:\*
  - Site Plans (<u>fully dimensioned</u> plans depicting project details including all lot lines and property setbacks to buildings; demolished/proposed/altered buildings; parking stalls, driveways, sidewalks, location of existing/proposed signage; HVAC/Utility location and screening details; useable open space; and other physical improvements on a property)
  - Grading and Utility Plans (existing and proposed)
  - Landscape Plan (including planting schedule depicting species name and planting size)
  - Building Elevation Drawings (fully dimensioned drawings for all building sides, labeling primary exterior materials)
  - Floor Plans (fully dimensioned plans including interior wall and room location)

#### Provide collated project plan sets as follows:

- Seven (7) copies of a full-sized plan set drawn to a scale of 1 inch = 20 feet (folded or rolled and stapled)
- Thirty-two (32) copies of the plan set reduced to fit onto 11 X 17-inch paper (folded and stapled)
- One (1) sepy of the plan set reduced to fit onto 8 ½ X 11-inch paper
- \* For projects requiring review by the **Urban Design Commission**, provide **Fourteen** (14) additional 11x17 copies of the plan set. In addition to the above information, <u>all</u> plan sets should also include: 1) Colored elevation drawings with shadow lines and a list of exterior building materials/colors; 2) Existing/proposed lighting with photometric plan & fixture cutsheet; and 3) Contextual site plan information including photographs and layout of adjacent buildings and structures. The applicant shall <u>bring</u> samples of exterior building materials and color scheme to the Urban Design Commission meeting.

V	Letter of Intent: Provide one (1) Copy	per Plan Set describing this application in	n detail including, but not limited to:								
	<ul> <li>Project Team</li> <li>Existing Conditions</li> <li>Project Schedule</li> <li>Proposed Uses (and ft² of each)</li> <li>Hours of Operation</li> </ul>	<ul> <li>Building Square Footage</li> <li>Number of Dwelling Units</li> <li>Auto and Bike Parking Stalls</li> <li>Lot Coverage &amp; Usable Open Space Calculations</li> </ul>	<ul> <li>Value of Land</li> <li>Estimated Project Cost</li> <li>Number of Construction &amp; Full-Time Equivalent Jobs Created</li> <li>Public Subsidy Requested</li> </ul>								
	Filing Fee: Refer to the Land Use Appli	cation Instructions & Fee Schedule. Make	e checks payable to: City Treasurer.								
Ø	Electronic Submittal: All applicants are required to submit copies of all items submitted in hard copy with their application as Adobe Acrobat PDF files on a non-returnable CD to be included with their application materials, or by e-mail to pcapplications@cityofmadison.com.										
	Additional Information may be requir	ed, depending on application. Refer to t	he <u>Supplemental Submittal Requirements.</u>								

#### 6. Applicant Declarations

Pre-application Notification: The Zoning Code requires that the applicant notify the district alder and any nearby neighborhood and business associations in writing no later than 30 days prior to FILING this request. List the alderperson, neighborhood association(s), and business association(s) AND the dates you sent the notices:

→ If a waiver has been granted to this requirement, please attach any correspondence to this effect to this form.

☑ Pre-application Meeting with Staff: Prior to preparation of this application, the applicant is required to discuss the proposed development and review process with Zoning and Planning Division staff; note staff persons and date.

Tate	Planning Staff:	Date:	Zoning Staff:	Matt Tucker	Date:	9-1-16
------	-----------------	-------	---------------	-------------	-------	--------

The applicant attests that this form is accurately completed and all required materials are submitted:

Name of Applicant John K. Livesey Relationship to Property: Owner/Manager

Authorizing Signature of Property Owner\_

<sub>Date</sub> 9-1-16





September 1, 2016

Mr. Matt Tucker, Zoning Administrator Building Inspection Division City of Madison 215 Martin Luther King Jr. Blvd. Madison, WI 53701

Re: Letter of Intent

Work and Learn Tenant Build-Out - West 202 S Gammon, Madison, WI 53717 PRA Project No. 160160-01

Dear Mr. Tucker:

The following submittal is our request for Zoning review of Land Use Application.

#### **Organizational Structure:**

Owner:

**Livesey Company** 

2248 Deming Way, Suite 200

Middleton, WI 53562 Contact: Ryan Eley reley@liveseyco.cos

Tenant:

Madison Metropolitan School District

Architect:

Plunkett Raysich Architects, LLP 2310 Crossroads Dr., Ste. 2000

545 W Dayton Street Madison, WI 53703 Contact: Rick Hopke

Madison, WI 53718

rhopke@madison.k12.wi.us

Contact: Steve Kieckhafer SKieckhafer@prarch.com

#### Introduction:

The Madison Metropolitan School District is proposing to locate a long time established vocational education program, Work and Learn, to a dedicated space for students that are at risk of not graduating and allows the students to attain their high school diploma.





Work and Learn PRA PROJECT NO:160160-01 September 1, 2016 PAGE 2

#### **Project Description:**

Interior renovation to accommodate classroom space. Exiting toilet room facilities, custodial, and mechanical spaces to remain without renovation.

#### **Building Statistics**

Proposed renovation of Gross Floor Area 5,260 s.f.
Proposed addition of Gross Floor Area 0 s.f.
New total Gross Floor Area 5,260 s.f.

Vehicle Parking

On-site surface Parking, no minimum required 185 spaces 8 accessible (4 van)

**Bike Parking** 

Bike Storage available to students, 1 per 5 students 33 spaces

**Moped Parking** 

Moped parking not provided

#### **Project Schedule:**

This project is anticipated to start construction in August 2016 with completion scheduled for September 2016.

#### **Estimated Project Costs:**

The project costs are estimated to be \$40,000.00





Work and Learn PRA PROJECT NO.160160-01 September 1, 2016 PAGE 3

Please contact us with any questions or for additional information that you request.

Thank you for your time in reviewing our proposal.

Best regards,

Steven A. Kieckhafer, AIA

Architect

# Madison Metropolitan School District WORK & LEARN TENAN BUILT-OUT - WEST

prak

PLUNKETT RAYSICH ARCHITECTS, LLP

209 south water street milwaukee, wisconsin 53204
2310 crossroads drive suite 2000 madison, wisconsin 53718
205 north orange avenue suite 202 sarasota, florida 34236

414 359 3060 608 240 9900

intelligent designs. inspired results. | www.prarch.com

#### Sheet Index

General

000 TITLE SHEET S100 OVERALL SITE PLAN AICHITECTUM

A200 DEMOLITION, FLOOR PLANS, & REFLECTED CEILING PLANS
A890 DETAILS, DOORS SCHEDULE, ROOM FINISH SCHEDULE AND
MATERIAL SCHEDULE

202 S. Gammon Rd. Madison, Wisconsin

Plumbing - Scope Document Only

Mechanical - Scope Document Only

Electrical - Scope Document Only

#### **Project Information**

Project Date: PRA Project Number: Drawing Set: 07-29-16 R160160-01 Project Status

#### Applicable Codes and Zoning

2014 Wisconsin Commercial Building Code (SPS 360-366) 2009 International Existing Building Code 2009 International Building Code Buisniess occupancy, Group B Educational occupancy, Group E Zoning: City of Madison ordinances

#### Type of Construction

LEVEL 2 REMODEL (Tenant Remodel in Existing Building)
Type of construction, unprotected, type IIB - Non-Sprinklerer

#### ADA Access Route

Refer to D3/A200

#### Parking Requirements

 Regular
 Accessible
 Van
 To

 Parking
 Stalls
 Stalls
 Accessible
 Stalls

 Stalls
 185
 8
 4
 19

#### **Building Area**

Remodel: 5,260 SQ


#### Exiting

Required Aggregate Exit Width: 33° Proposed Aggregate Exit Width: 72°

#### Occupant Load

)	CLASSROOM	Educational - Classroom	395 SF	
	CLASSROOM	Educational - Classroom	641 SF	
2	CLASSROOM	Educational - Classroom	396 SF	
3	CLASSROOM	Educational - Dassroom	430 SF	
	CLASSROOM	Educational - Classroom	623 SF	
ō	CLASSROOM	Educational - Classroom	420 SF	
5	BOYS RESTROOM	Non Occupied Space	288 SF	
7	RESTROOM	Non Docupled Space	41 SF	
3	GIRLS RESTROOM	Non Occupied Space	253 SF	
9	MECHANICAL	Accessory Storage - Mechanical	£8 SF	
3	OFFICE	Business Areas	99 SF	
1	OFFICE	Excress Areas	100 SF	
2	WORKROOM	Business Areas	94 SF	
1	RECEPTION	Business Areas	330 SF	
	COMMON AREA	Business Areas	342 SF	
3	CORRDOR	Non Occupied Space	275 SF	
ı	CORRIDOR	Non Occupied Space	236 SF	

#### **Project Location**

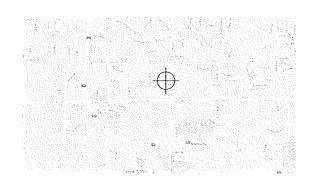

#### Project Team

#### **OWNER**


MADISON METROPOLITAN SCHOOL DISTRICT
4711 Pflaum Road
Tel (608) 204-7900
Madison, WI 53718

PLUMBING TO BE DETERMIND

MECHANICAL TO BE DETERMIND

ELECTRICAL FORWARD ELECTRIC

Tel (608) 221-1945

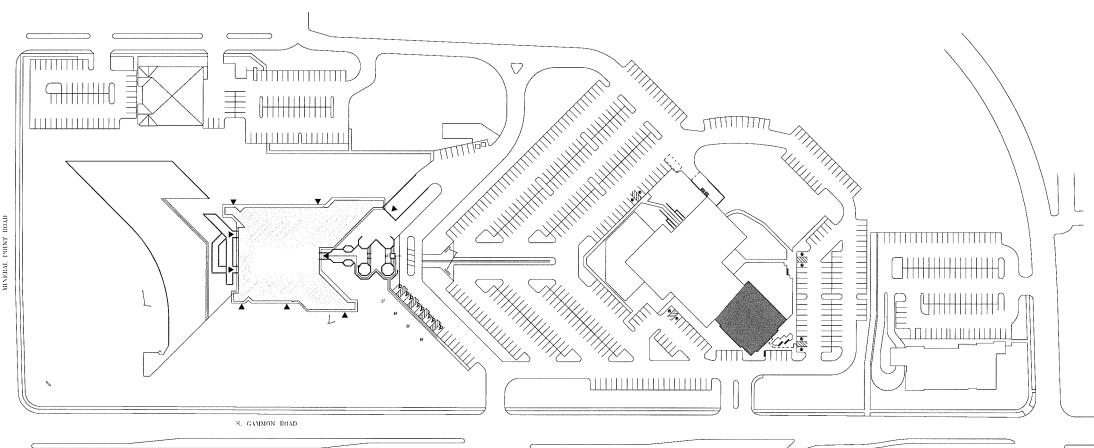

WORK & LEARN TENAN BUILT-OUT - WEST 202 S. Gammon Rd. Madison, Wisconsin

414 359 3060 608 240 9900 941 348 3619 Aprarch.com

200 south were street mileosises, wiscorin 53234
210 crossocial drive suts 2000 mislaton wiscorin 53718
200 crossocial drive suts 2000 mislaton wiscorin 53718
200 conto orango avenue suts 2001 canastro. Bindia 34730
ARCHITECTS, LLP intelligent designs. inspired results. | www

Revisions


NOT FOR CONSTRUCTION

Author

Date:
07-29-16

John No.:
R160160-01

Sheet No.:
S100 Job No.: R160160-01

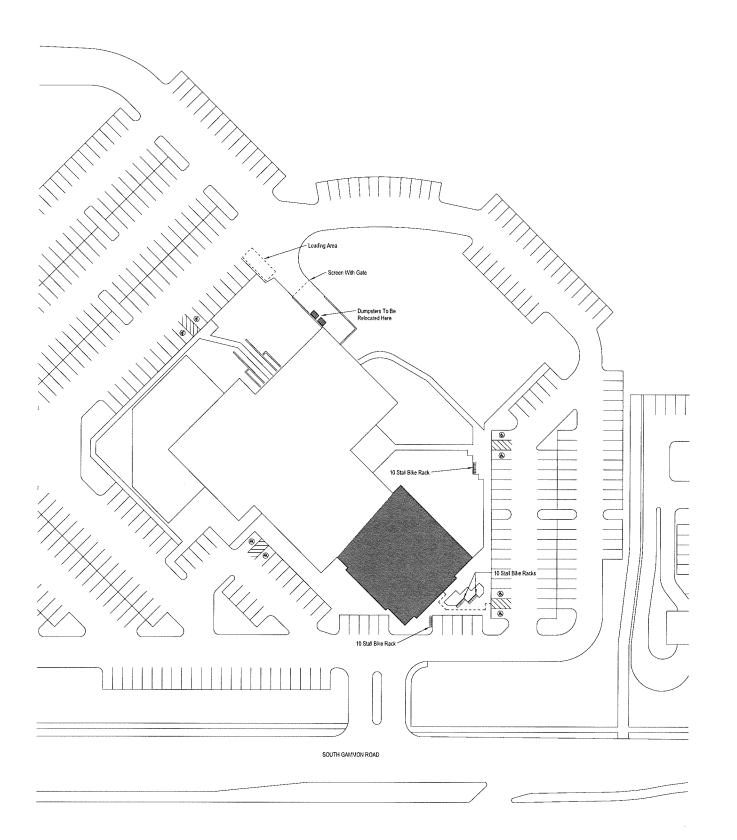

NOT FOR CONSTRUCTION

Plunkell Raysich Architects. LLP

Author

Date: 07-29-16 Job No.: R160160-01 Sheet No.: S110


WORK & LEARN TENAN BUILT-OUT - WEST 202 S. Gammon Rd. Madison, Wisconsin

200 south water street millenakee, wiscomin 52204
2010 ceasonads drive state 2000 modison, vectoran
2010 ceasonads drive state 2001 ceasona, fecréte 34
ARCHITECTS, LLP intelligent designs. Inspired results.

#### DEMOLITION PLAN - GENERAL NOTES

- A. VERIFY ALL DIMENSIONS AND CONDITIONS AT JOB SITE PORTIONS OF EXISTING CONSTRUCTION MAY HAVE BEEN REMOVED BY OWNER.
- B. VERFY EXACT COMPOSITION OF EXISTING WALLS TO BE FEMOLED
- REMAYE FLOOR FINSHES, INCLUDING SETTING BED IN CERAMIC TILE AREAS, WHERE NEW FLOORING IS MOJICATED IN ROOM FINSH SCHEDULF
- REMOVE SUSPENDED CELLNGS AND RELATED HANGERS, OR GYPSUM EGAPO: PLASTER CELLNGS WIEPE NEW CELLNGS ARE NOICHTED ON PERLECTED CELLNG PLAN OR ROOM FAIGH SCHEDULE.
- E. REJADVE ALL COLUMN FINSHES, INCLUDING GIPSUM BOARD AND FURRINGS, FROM EXISTING STRUCTURAL COLUMNS
- G REFER TO PLUMBING, KIAC AND ELECTRICAL PLANS FOR ASSOCIACIAL DEMOLITION ITEMS AND NOTES. COGRONATE WORK WITH PLUMBING, KIAC AND ELECTRICAL REQUIREMENTS.

- J CONSTRUCT A DUST-PROOF PARTITION TO SEPARATE AREAS OF CONSTRUCTION FROM ADJACENT OF OUTSIDE SCOPE OF CONSTRUCTION FEFER TO DETAIL XXAXXX

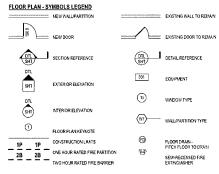

#### FLOOR PLAN - GENERAL NOTES

- A DIMENSIONS ON FLOOR PLAN ARE BASED ON FACE OF FINISHED WALL TO FACE OF FINISHED WALL (NOMINAL)
- 8 VERTY ALL DIMENSIONS AND CONDITIONS AT JOB SITE PORTIONS OF EXISTING CONSTRUCTION MAY HAVE BEEN REMOVED BY OWNER.
- C MAINTAIN CONTINUOUS UTLITY SERVICE TO ALL SPACES IN THE BUILDING NOT AFFECTED BY THIS WORK COORDINATE WITH OWNER ANY DISRUPTION IN SERVICES REQUIRED TO PERFORM WORK OR TO MODRY EXISTING PHON QUOCHYORK OR ANY ASSOCIATED GLOUPWART.
- D. CONTRACTOR TO VERIFY FLOOR TO FLOOR HEIGHTS
- F. REFER TO SHEET ASSO FOR DOOR SCHEDULES, DOOR TYPES, AND NOTES

	KEYNOTE LEGEND - INTERIOR PARTITION TYPES
TAG	ENTERBOR PARTITION DESCRIPTION
M	RITERIOR STEEL STUD FARTITION: 3.5% STEEL STUDS & 16" OC WITH 3" SOUND ATTENUATION INSULATION AND ONE LAYER 56" GIPSUM BOARD & EACH FACE
- 64	ACTION DEPONE AND TRANSPORT ASSESSED OF THE RESPONDED AND ACT INCRESS CONTRACTOR

#### GYPSUM BOARD PARTITIONS - GENERAL NOTES

ALL GYPSUM BOARD PARTITIONS SHALL BE (M) UNLESS OTHERWISE NOTED ON FLOOR PLAN. GYPSIAN BOARD PARTITION DIMENSIONS ON FLOOR PLAN ARE BASED ON FACE OF FINISHED PARTITION TO FACE OF FINISHED PARTITION RICHARD. REFER TO GYPSUM BOARD SPECIFICATION FOR LOCATION AND TYPE(S) OF GYPSUM BOARD MATERIAL REQUIRED

PROVIDE FIRE RATED GYPSUM BOARD AT ALL FIRE RATED PARTITIONS.

SEAL ALL WALL PENETRATIONS AT PERMETER AND FIRESTOP ALL FIRE RATED PARTITIONS EXTEND GYPSUM BOARD PARTITIONS TO THE FINISHED CEILING. REFER TO DETAIL AT : ASS).

ALL GYPSUM BOARD TO BE 55° TYPE X

1	ACOUSTIC CEILING TILE		
++		⊗	AUDIO SPEAKER
$\sqcup$	2-0" x 2-0" SUSPENDED EXPOSED GRID ACOUSTIC CELLING TILE	@	NURSE CALL STATION
$\square$	RETURN, TRANSFER EXHAUST GRILLE	6	SMOKE DETECTOR
$\boxtimes$	SUFPLY GRILLE	H	HEAT DETECTOR
		T	CEILING RECESSED TV BE
	SLOT D#FUSER		GYPSIALBOARD CELING
	1 x 4 FLUORESCENT LIGHT	9-50-50-55	BULKHEAD
	2 x 2 FLUORESCENT LIGHT	(0-0°)	CEILING HEIGHT
	2 x 4 FLUORESCENT LIGHT	①	REFLECTED CEILING PLAY
	FLUORESCENT SURFACE-MOUNT LIGHT	0	CONSTRUCTION LIMITS
	FLUORESCENT TROFFER LIGHT	1P 1P	ONE HOUR RATED FIRE PA
	FLUORESCENT COVE LIGHT		TWO HOUR RATED FAE B

#### REFLECTED CEILING PLAN - GENERAL NOTES

SURFACE MOUNTED LIGHT RECESSED DOWN LIGHT

REFLECTED CEILING PLAN - SYMBOLS LEGEND

Z-0" x 4-0" SUSPENDED EXPOSED GRID

A PERMETER CEILING TILES SHALL NOT BE LESS THAN 4"


 $\circ$ 

B LOCATE ALL SPRINKLER HEADS SMOKE DETECTORS ALONG SPEAKERS HEAT SENSORS IN THE CENTER OF CERLING TILE (OR IN THE CENTER OF THE RAISED RECESSED FIELD OF A PATTERNED TILE)


\_ 2B \_ 2B \_

- C. REMOVE EXISTING CELLING SYSTEM WHERE NEW WALLS FEMETRATE EXISTING CEILING SYSTEMS TO REMAIN PATCH TO MATCH EXISTING CEILING SYSTEM TO NEW WALL.
- CEILING HEIGHTS SHALL MATCH EXISTING (ASSUMED 9-6") UNLESS. NOTED OTHERWISE ON THE REFLECTED CEILING PLANS.


KEYNOTE LEGEND - REFLECTED CEILING PLAN NOTES REFLECTED CEILING PLAN NOTE 300 6" SOFFIT

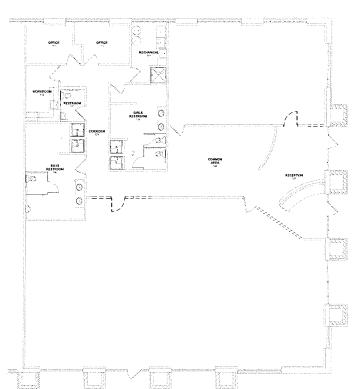



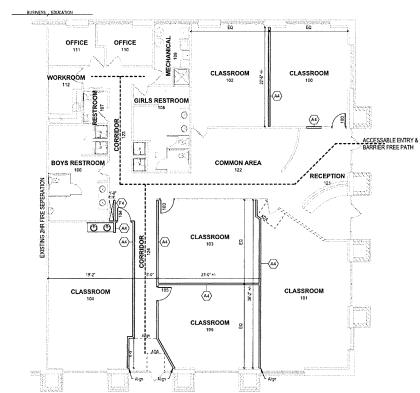

D3 FLOOR PLAN
A200 1/8" = 1'-0"

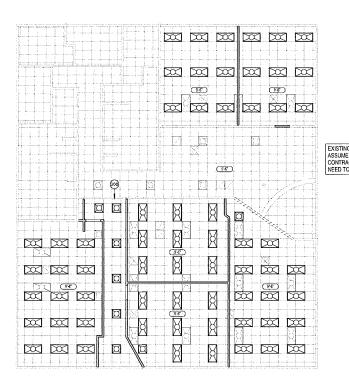


D5 REFLECTED CEILING PLAN
A200 1/8" = 1'-0"


pra


WORK & LEARN TENAN BUILT-OUT - WEST 202 S. Gammon Rd. Madison, Wisconsin


Revisions

Drawn By: GGW Date: 07-29-16 Joh No : R160160-01 Sheet No.: A200

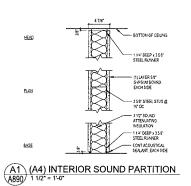

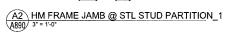


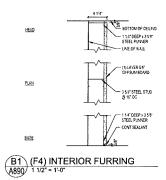

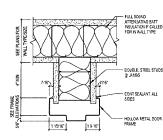



B2\ HM FRAME JAMB @ STL STUD PARTITION\_2

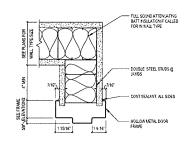

C2 HM FRAME JAMB @ STL STUD PARTITION\_3

3\* = 1'.0\*

		SCHEDULE - MATERIAL SCHEDULE		
Code	Material	Name & Number	Narvacture	R
Division 09 51 0	0 - ACOUSTICAL CELUNGS			
AC-1	Acoustical Ceiling			1 "
Division 03 65 0	0 - RESILIENT FLOOR NG			
R3-1	Resignt Base	BY OWNER		
VCT-1	Viryl Composition Tile	1.		
	Transition Strp			
Division 03 68 0 C-2	0 - CARPETING Corpet (Tite)			
	Transition Stree			
		sh Schedule for Finish Designation) PAE, PAF, PAS, PAT or PAX		
PA-1	Paint	BY OWNER		
	0 - MASC SPECIALTIES			
Division 10 (0 1 CG-1	Corner Guard			

#### ROOM FINISH SCHEDULE NOTES:

#### ROOM FINISH SCHEDULE GENERAL NOTES:

ALL METAL DOORS, FRAMES AND INSCIMENT, TO BE PAINTED XXXXX
ALL SLUS TO BE XXX.
ALL SLUS FOR XXX.
ALL FACES AND UNDERSIDES OF SOFFIIS TO BE PAINTED XXXXX
PART ALL MSC. METALGRALLES BIC. TO MATCH PAINTED
ALL MISCON METALGRALLES SIC. TO MATCH PAINTED
ALL MISCON METAL MANDARLES TO BE PAINTED XXXIV

ALL MISCON METAL MANDARLES TO BE PAINTED XXIV

OF THE PAINTED XXIV

OF THE PAINTED XXIV

ALL MISCON METAL MANDARLES TO BE PAINTED XXIV

OF THE PAINTED XXIV

ALL METAL MISCON METAL MISCON METAL

ALL MISCON METAL MANDARLES TO BE PAINTED XXIV

OF THE PAINTED XXIV

ALL METAL METAL MISCON METAL

METAL METAL

METAL

METAL

MET


							Door Sch	iedule								
						Door					Frame					
				Size				i i					1			ĺ
Door Number	Room≢	Room Name	Panel A Width	Panel B With	Height	Type	Material	Firish	Glass	Frame Type	Material	Finish	Hardware Group	Assembly Rating	Comments	Re
EVEL 1																
*)	100	CLASSROOM	3-0		7-0"	F1			I	ST1	T		(none)			_
)3	123	CORRIDOR	3-6		7-5	F1	l			511			(none)			
И	104	CLASSROOM	3'-6"		7-5"	FI				STI			(rene)			_
6	105	CLASSROOM	3'-0"	I	7-0"	F1		T	1	ST1			(rore)			

#### DOOR SCHEDULE NOTES:

- MAGNETIC HOLD-OPEN AUTOWATIC SWING DOOR OPERATOR ELECTRIC STRIKE OR LOCK CARD ACCESS

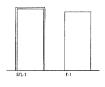

#### DOOR AND FRAME TYPES

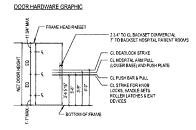

WORK & LEARN TENAN BUILT-OUT - WEST 202 S. Gammon Rd. Madison, Wisconsin

DYGN PUNKETT RAYSICH ARCHITECTS, LIP II

Drawn By: GGW Date:

Job No.: R160160-01

07-29-16

A890

OFFICE

BOYS RESTROOM

CLASSROOM

OFFICE 110

CLASSROOM

RECEPTION


CLASSROOM

CLASSROOM

COMMON AREA

CLASSROOM

CLASSROOM

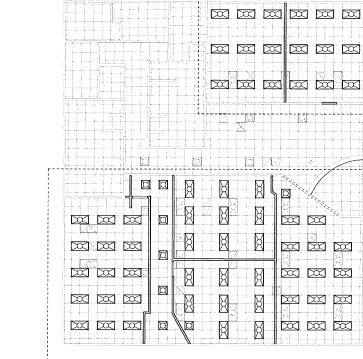

D5 ELECTRICAL SCOPE CEILING PLAN
[E200] 1/8\* = 1'-0"

Drawn By: GGW Date: 07-29-16


WORK & LEARN TENAN BUILT-OUT - WEST 202 S. Gammon Rd. Madison, Wisconsin

Revisions

209 south water streat milwauken, witconsin 53204
2310 crossroads drive sate 2000 madkon, wisconsin 53718
205 north orange avenue suite 202 sansatos, flordu 34230
intelligent designs. inspired results. | www

PTGN PUUNKETT RAYSICH ARCHTECTS, UP IN

Job No.: R160160-01 Sheet No.: E200

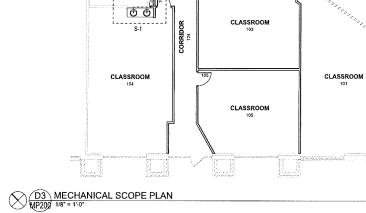

BOYS RESTROOM


TWO ADDITIONAL SINKS TO BE ADDED TO CLASSROOM 104

CLASSROOM 102

COMMON AREA

CLASSROOM 100

RECEPTION

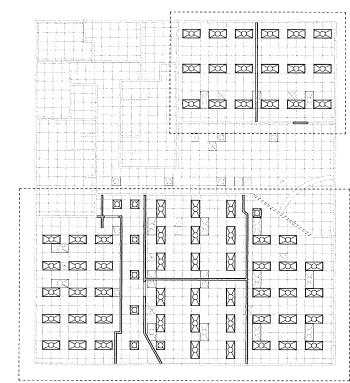

D5 MECHANICAL SCOPE CEILING PLAN
MP200 1/8" = 1'-0"

ASSIMED EXISTING MECHANICAL LAYOUT. TO REMOZE AND RENSITION DESIRATION DECIRATION OF REMOZE AND RENSITION DISTRICT PROPERS AND RETURNS FROVER EXCITORAL DIFFUSE AND RETURNS FROVER EXCITORAL DIFFUSE AND RETURNS THAT WHICH DESIRATION DECIMALS TO THE PROVIDED ACCOUNTANT OF THE PROVIDED ACCOUNTANT OF THE COCKNOWN TO THE ACCOUNTANT OF THE COCKNOWN TO THE ACCOUNTANT OF THE COCKNOWN TO THE ACCOUNTANT OF THE COCKNOWN THE ACCOUNTANT OF THE

E ARCHIECT PREPARED PLUMENO, HAVIC AND ELECTRICAL DESIGN OPE DOCUMENTS CORSISTINO OF ENAVINGE AND SECFECTATIONS THE OTHER CHECKER PRODUCEDES TO RESPOND, IT IS SPECIAL SELECTION OF THE PREPARENCE OF THE OTHER PROPAGATION SPECIAL SELECTION OF THE PREPARENCE OF THE OTHER PROPAGATION CONCENTRACION AND CONTINUED AND THE OTHER PROPAGATION ONCE AND THE OTHER PREPARENCE OF THE OTHER PROPAGATION THE SECON FROM CORSISTENCY OF THE OTHER PROPAGATION THE SECON FROM THE SECON THE SECON THE SECON FROM THE SECON THE SECON

R160160-01
Sheet No.:

MP200

MP200

DTG PRAYSICH PRAYSICH ARCHITECTS, LIP IN