

## URBAN DESIGN COMMISSION APPLICATION CITY OF MADISON

This form may also be completed online at: <a href="http://www.cityofmadison.com/planning/documents/UDCapplication.pdf">http://www.cityofmadison.com/planning/documents/UDCapplication.pdf</a>

215 Martin Luther King Jr. Blvd; Room LL-100 PO Box 2985; Madison, Wisconsin 53701-2985 Phone: 608.266.4635 | Facsimile: 608.267.8739

Please complete all sections of the application, including the desired meeting date and the type of action requested.

Date Submitted: October 12, 2016		☐ Informational Pres	sentation
UDC Meeting Date: October 26, 2016		☐ Initial Approval	
$ \textbf{Combined Schedule Plan Commission Date (if applicable): } \underline{ Nove :} $	mber 7, 2016_		
<ol> <li>Project Address: 489 Commerce Drive         Project Title (if any): Watts Hill Apartments     </li> <li>This is an application for (Check all that apply to this UDC application                \[                       \] New Development</li></ol>	n):	evelopment	
A. Project Type:  Project in an Urban Design District* (public hearing-\$300 fee) Project in the Downtown Core District (DC) or Urban Now Suburban Employment Center (SEC) or Campus Instituted Planned Development (PD) General Development Plan (GDP) Specific Implementation Plan (SIP) Planned Multi-Use Site or Planned Residential Completed	Aixed-Use District (UI		
B. Signage:  Comprehensive Design Review* (public hearing-\$300 fee) Signage Exception(s) in an Urban Design District (public C. Other:  Please specify:		Variance* (public hearing	z-\$300 fee)
3. Applicant, Agent & Property Owner Information:			
Applicant Name: Randy Bruce	Company: Knothe &	Bruce Architects,	HC
Street Address: 7601 University Ave., Suite 201	City/State: Middleto		zip: WI
Telephone: (608) 836-3690 Fax:( )	Email: rbruce@kno		P:
Project Contact Person: Same as applicant			
Street Address:			Zip:
Telephone:() Fax:()	Email:		
Project Owner (if not applicant): Fred Rouse/Rouse Managem Street Address: 2428 Perry Street Telephone: (608) 251-7471 Fax: ()	City/State: Madison	, WI Prousemgmt.com	zip: <u>53713</u>
B. The applicant attests that all required materials are included in this submi	August 17, 2016 (date of meeting) ttal and understands that i	f any required information	
the application deadline, the application will not be placed on an Urban Desi	_		
Name of Applicant Randy Bruce	Relationship to Property	, Architect	
Authorized Signature	Date October	12, 2016	

## 5. Submission Requirements

Application: Each submittal must include 14 collated paper copies (11" x 17" max.) and an electronic copy of all application materials. The electronic copy must include individual Adobe Acrobat PDF files compiled either on a non-returnable CD-ROM submitted with the paper copies, or in an e-mail sent to: UDCApplications@cityofmadison.com

The transmittal shall include the name of the project, address, and applicant. Applicants unable to provide the materials electronically should contact the Secretary of the Urban Design Commission at 267-8740 for assistance. For an application to be considered complete and scheduled for a UDC meeting, both the paper copies and electronic copy need to be submitted prior to the application deadline. Late materials will not be accepted. An application is required for each UDC appearance. For projects also requiring Plan Commission approval, applicants must have submitted an accepted application for Plan Commission consideration prior to obtaining any formal action (initial or final approval) from the UDC. All plans must be easily read when reduced.

<u>Fees</u>: Fees are required to be paid with the first application for either initial or final approval of a project, unless the project is part of the combined application process involving the Urban Design Commission in conjunction with Plan Commission and/or Common Council consideration. Make checks payable to City Treasurer, Madison, Wisconsin.

<u>Project Plans</u>: The items listed below are minimal application requirements for the type of approval indicated. Please note that the UDC and/or staff may require additional information in order to have a complete understanding of the project.

1.	<u>Info</u>	ormational Presentation
		Locator Map
		Brief Narrative Description of the Project, Site Plan, and 2-dimensional images of proposed buildings or structures. Additional information may provide for a greater level of feedback from the Commission.
		Contextual site information, including photographs and layout of adjacent buildings/structures
		Any and all relevant plans and information on which feedback from the UDC is requested.
2.	<u>Init</u>	<u>tial Approval</u>
		Locator Map
		Contextual site information, including photographs and layout of adjacent buildings/structures
		Site Plan showing location of existing and proposed buildings, walks, drives, bike lanes, bike parking, and existing trees over 18" diameter
		Landscape Plan and Plant List
		Building Elevations for all building sides
		PD text and letter of intent (if applicable)
3.	<u>Fin</u>	al Approval
	X	Locator Map
	X	Site Plan showing location of existing and proposed buildings
	X	Grading Plan
	X	Landscape Plan
	X	Plant List, including scientific name, size at planting, quantity and root condition for each species.
	X	Building Elevations for all building sides, colored with shadow lines, including exterior building materials and colors.
		Proposed Signage
	X	Lighting Plan, including fixture cut sheets and photometrics plan
		Utility/HVAC equipment location and screening details
	X	PD text and letter of intent (if applicable)
	X	Samples of the exterior building materials (presented at the UDC meeting)

<u>Signage</u>: The items listed below are minimal application requirements for the type of approval indicated. Please note that the UDC and/or staff may require additional information in order to have a complete understanding of the project.

1.	. <u>Initial Approval</u>	
	☐ Locator Map	
	☐ Signage as it relates to the Sign Control Ordinance provisions for Variances or C Signage	omprehensive Design Review of
	<ul> <li>Site Plan (show location of all existing and proposed buildings, and all existing a which existing signs, if any, are to be removed)</li> </ul>	and proposed signage, specifying
	☐ Scale drawing of each proposed sign, including awning graphics	
	☐ Photographs of site	
2.	. Final Approval	
	☐ Locator Map	
	☐ Signage as it relates to the Sign Control Ordinance provisions for Variances or C Signage	omprehensive Design Review of
	<ul> <li>Site Plan (show location of all existing and proposed buildings, and all existing a which existing signs, if any, are to be removed)</li> </ul>	and proposed signage, specifying
	☐ Scale drawing of each proposed sign, including awning graphics	
	☐ Description and/or samples of materials and colors for each proposed sign	
	☐ Photographs of site	
	☐ Context of signs in surrounding parcels, in addition to the site being discussed	

\*NOTE: If supplemental perspective renderings are provided, an emphasis should be placed on providing pedestrian/automobile scale viewsheds, in addition to the other required graphics.

\*NOTE: If applying for final approval without having received initial approval, all materials required for initial approval will be required.

NOTICE REGARDING LOBBYING ORDINANCE: If you are seeking approval of a development that has over 40,000 square feet of non-residential space, or a residential development of over 10 dwelling units, or if you are seeking assistance from the City with a value of \$10,000 (including grants, loans, TIF, or similar assistance), then you likely are subject to Madison's lobbying ordinance (Sec. 2.40, MGO). You are required to register and report your lobbying. Please consult the City's Clerk's Office for more information. Failure to comply with the lobbying ordinance may result in fines.



September 7, 2016

Ms. Heather Stouder Department of Planning & Development City of Madison 215 Martin Luther King Jr. Blvd PO Box 2985 Madison, Wisconsin 53701

Re:

Letter of Intent

Rezoning to PUD-SIP 489 Commerce Drive

Dear Ms. Stouder:

The following is submitted together with the plans, application and zoning text for staff for approval.

## Organizational structure:

Owner:

Fred Rouse

Rouse Management 2428 Perry Street Madison, WI 53713 608-251-5382 608-251-5350 fax Contact: Fred Rouse

info@rousemgmt.com

Engineer: Vierbicher

999 Fourier Drive Ste 201

Madison, WI 53717 608-826-0532 608-826-0530 fax Contact: Joe Doyle jdoy@vierbicher.com Architect:

Knothe & Bruce Architects, LLC

7601 University Avenue, Ste 201

Middleton, WI 53562

608-836-3690

Contact: Randy Bruce rbruce@knothebruce.com

Landscape Design:

The Bruce Company 2830 Parmenter Street

Middleton, WI 53562

(608) 836-7041

Contact: Sarah Ricker sricker@brucecompany.com

## Introduction:

The proposed site is located on the northwest corner of Commerce Drive and Watts Road. It is part of the PUD that contains the Princeton Health Club, a dental office and two existing hotels: Hampton Inn & Suites and Homewood Suites. Other surrounding uses in this mixed-use neighborhood include professional offices, a grocery, restaurants, coffee shop, a senior living community and market-rate multifamily housing.

Letter of Intent 489 Commerce Drive September 07, 2016 Page 2 of 3

A development proposal for a third hotel is being submitted at this same time for the site immediately east of the subject property. The site planning and civil engineering have been coordinated between the two sites.

In addition to this proposal and the proposed PD-SIP for the hotel, an Alteration to a PD-GDP is being submitted which will expand the allowable uses within the GDP area. A CSM will also be submitted that will redefine the lot line separating the two proposed developments.

## **Project Description:**

The project consists of an 80 unit, four-story multi-family building with enclosed parking at the basement and first floor levels. The building takes advantage of the topography and is set into the site to provide vehicular access to the two parking levels. The "L-shaped "building will front both Commerce Drive and Watts Road and features strong architecture at the street corner. Pedestrian access is located off the parking (north) and the Watts Road (south) sides of the building. Vehicular access is achieved from Homewood Way, the private internal street that serves the properties within the PUD.

## **Site Development Data:**

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$\boldsymbol{\smile}$	UI I	311		ο.

Lot Area 80,617 S.F. or 1.85 acres

Dwelling Units 80 units

Lot Area / D.U. 1,007 S.F./unit Density 43 units/acre

Building Height 4 stories

Usable Open Space 15,586 S.F. (194 S.F./unit)

Lot Coverage 48,859 S.F.

## **Dwelling Unit Mix:**

 Efficiency
 13

 One Bedroom
 47

 One Bedroom + Den
 4

 Two Bedroom + Den
 2

 Total
 80

## Vehicle Parking Stalls:

 Basement Level
 63

 First Floor Level
 18

 Surface
 43

 Total
 124

Parking Ratio 1.5 stalls/unit

## Bicycle Parking:

	Floor Mount	vvali Mount	i otal
Underground	23	12	35
First Floor	30	7	37
Total-Secured	53	19 (24%)	72 (90%)
Surface			8
Surface-Short Term			8 (10% of units)
Total			88 bike stalls

## **Project Schedule:**

The project is a single building and will be constructed starting in spring 2017 and be completed in summer 2018.

## **Social & Economic Impacts:**

This development will have a positive social and economic impact. Many construction industry jobs will be supported and additional high-quality, energy efficient housing will be provided to the marketplace.

Thank you for your time reviewing our proposal.

Sincerely,

Zoning Text 489 Commerce Drive PD -SIP September 07, 2016 KBA #1217

## Legal Description:

Lot 4, Certified Survey Map Number 11993, as recorded in Volume 73 of Certified Survey Maps, on pages 352-358, as Document Number 4257029, Dane County Registry and located in the Southwest Quarter of the Northwest Quarter of Section 26, Township 07 North, Range 08 East, City of Madison, Dane County, Wisconsin.

- A. Statement of Purpose: This zoning district is established to allow for the construction of a residential development with 80 dwelling units.
- B. Permitted Uses: Following are permitted uses:
  - 1. Multifamily residential uses as shown on approved plans.
  - 2. Accessory uses including but not limited to:
    - Accessory uses directly associated with those permitted uses including parking for residents and guests.
    - b. Temporary buildings for storage of building materials and equipment for construction purposes when on the same lot as a principle use for a period not to exceed the duration of such construction.
- C. Lot Area: As shown on the approved plans.
- D. Height Regulations: As shown on the approved plans.
- E. Yard Regulations: As shown on the approved plans.
- F. Landscaping: Landscaping will be provided as shown on the approved plans.
- G. Usable Open Space Requirements: Usable open space will be provided as shown on the approved plans.
- H. Parking & Loading: Off-street parking and loading shall be provided as shown on the approved plans.
- I. Family Definition: The family definition shall coincide with the definition given in M.G.O. for the TR-U2 zoning district.
- J. Signage: Signage for the residential building will be allowed as provided by M.G.O. and as further regulated for the TR-U2 zoning district, with signage as approved by the Urban Design Commission and Zoning Administrator.
- K. Alterations and Revisions: No alteration or revision of this Planned Unit Development shall be permitted unless approved by the City Planning Commission, however, the Zoning Administrator may issue permits for minor alterations or additions which are approved by the, Director Of Planning and Development and the alderperson of the district and are compatible with the concept approved by the City Planning Commission.

# Project # 1217 Preliminary Material Selections

Watts Hill Apartments 489 Commerce Drive Rouse Management

October 6, 2016

Material Manufacturer Color

Composite Fascia Hardie Rich Expresso

Heavy Timber TBD Stained Dark Mahogany

Composite Horizontal Upper Siding Hardie Downing Earth SW2820

Composite Vertical Siding Hardie Rich Expresso

Composite Horizontal Lower Siding Hardie Rich Expresso

Precast Band and Sills Rockcast Brindle- Smooth

Aluminum Railing TBD Black

Vinyl or Composite Windows Visions Heritage Brown

Metal Roof/Canopy/Panels CMG Burnished Slate

Cast Stone Rockcast Brindle-Split Face

## Cree Edge™ Series

LED Area/Flood Luminaire

### **Product Description**

The Cree Edge™ Series has a slim, low profile design. Its rugged cast aluminum housing minimizes wind load requirements and features an integral, weathertight LED driver compartment and high performance aluminum heat sinks. Various mounting choices: Adjustable Arm, Direct Arm, Direct Arm Long, or Side Arm (details on page 2). Includes a leaf/debris guard.

**Applications:** Parking lots, walkways, campuses, car dealerships, office complexes, and internal roadways

## **Performance Summary**

Patented NanoOptic® Product Technology

Made in the U.S.A. of U.S. and imported parts

CRI: Minimum 70 CRI

CCT: 4000K (+/- 300K), 5700K (+/- 500K) standard

Limited Warranty<sup>†</sup>: 10 years on luminaire/10 years on Colorfast DeltaGuard® finish


†See http://lighting.cree.com/warranty for warranty terms

### **Accessories**

Field-Installed					
Bird Spikes	Backlight Control Shields				
XA-BRDSPK	XA-20BLS-4				
Hand-Held Remote	- Four-pack				
XA-SENSREM	- Unpainted stainless steel				
- For successful implementation of the progra	mmable multi-level				
option, a minimum of one hand-held remote	is required				

## **DA Mount**



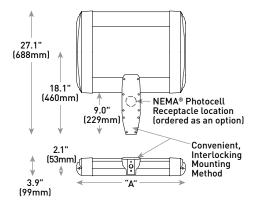

LED Count (x10)	Dim. "A"	Weight
02	12.1" (306mm)	21 lbs. (10kg)
04	12.1" (306mm)	24 lbs. (11kg)
06	14.1" (357mm)	27 lbs. (12kg)
08	16.1" (408mm)	28 lbs. (13kg)
10	18.1" (459mm)	32 lbs. (15kg)
12	20.1" (510mm)	34 lbs. (15kg)
14	22.1" (560mm)	37 lbs. (17kg)
16	24.1" (611mm)	41 lbs. (19kg)

AA/DL/SA Mount - see page 22 for weight & dimensions

## **Ordering Information**

Example: ARE-EDG-2M-AA-12-E-UL-SV-350

						E				
Product	Optic			Mounting*	LED Count (x10)	Series	Voltage	Color Options	Drive Current	Options
ARE- EDG	ZM Type II Medium ZMB Type II Medium WBLS ZMP Type II Medium W/BAS ZMP Type II Medium M/Partial BLS 3M Type III Medium  25 25° Flood	3MB Type III Medium w/BLS 3MP Type III Medium w/Partial BLS 4M Type IV Medium 4MB Type IV Medium w/BLS 70 70* Flood	Type IV Medium W/Partial BLS 5M Type V Medium 5S Type V Short	AA Adjustable Arm DA Direct Arm DL Direct Long Arm SA Side Arm - Available with 20-60 LEDs	02 04 06 08 10 12 14 16	E	UL Universal 120-277V UH Universal 347-480V	BK Black BZ Bronze SV Silver WH White	350 350mA 525 525mA 700 700mA - Available with 20- 60 LEDs	DIM 0-10V Dimming  - Control by others  - Refer to Dimming spec. sheet for details  - Can't exceed specified drive current  F Fuse  - Refer to ML spec sheet for availability with ML options  - Available with UL voltage only  - When code dictates fusing, use time delay fuse  HL Hi/Low [Dual Circuit Input]  - Refer to HL spec sheet for details  - Sensor not included  ML Multi-Level  - Refer to ML spec sheet for details  - Sensor not included  ML Multi-Level  - Refer to ML spec sheet for details  - Sensor mot included  ML Multi-Level  - Refer to ML spec sheet for details  - Con't exceed specified drive details  - Intended for downlight applications at 0° tilt  NEMA® Photocell Receptacle  - Intended for downlight applications with maximum details  - Photocell by others  - Refer to ML spec sheet for availability with ML options  - Refer to ML spec sheet for availability with ML options
	<b>40</b> 40° Flood	<b>SN</b> Sign								- Intended for downlight applications at 0° tilt - Color temperature per luminaire  - Refer to ML spec sheet for availability with ML options - Available with UL voltage only

<sup>\*</sup> Reference EPA and pole configuration suitability data beginning on page 19 NOTE: Price adder may apply depending on configuration






Rev. Date: V3 08/03/2016




## **Photometry**

All published luminaire photometric testing performed to IESNA LM-79-08 standards by a NVLAP accredited laboratory. To obtain an IES file specific to your project consult: http://lighting.cree.com/products/outdoor/area/cree-edge-series-1

### **3ME**

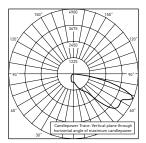

CSA Test Report #: 6448 ARE-EDG-3MB-\*\*-06-E-UL-700 Initial Delivered Lumens: 7,740

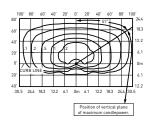


ARE-EDG-3MB-\*\*-12-E-UL-525-40K Mounting Height: 25' (7.6m) A.F.G. Initial Delivered Lumens: 12,420 Initial FC at grade

lium Distribution w	ı/BLS			
4000K		5700K		
Initial Delivered Lumens*	BUG Ratings** Per TM-15-11	Initial Delivered Lumens*	BUG Ratings** Per TM-15-11	
1,499	B1 U0 G1	1,557	B1 U0 G1	
2,999	B1 U0 G1	3,114	B1 U0 G1	
4,446	B1 U0 G1	4,617	B1 U0 G1	
5,929	B1 U0 G2	6,157	B1 U0 G2	
7,393	B1 U0 G2	7,677	B1 U0 G2	
8,872	B1 U0 G2	9,213	B1 U0 G2	
10,285	B1 U0 G2	10,680	B1 U0 G2	
11,754	B1 U0 G3	12,206	B1 U0 G3	
2,099	B1 U0 G1	2,180	B1 U0 G1	
4,198	B1 U0 G1	4,359	B1 U0 G1	
6,225	B1 U0 G2	6,464	B1 U0 G2	
8,300	B1 U0 G2	8,619	B1 U0 G2	
10,350	B1 U0 G2	10,748	B1 U0 G2	
12,420	B1 U0 G3	12,898	B1 U0 G3	
14,398	B1 U0 G3	14,952	B2 U0 G3	
16,455	B2 U0 G3	17,088	B2 U0 G3	
2,564	B1 U0 G1	2,662	B1 U0 G1	
5,127	B1 U0 G2	5,325	B1 U0 G2	
7,603	B1 U0 G2	7,896	B1 U0 G2	
	1,499 2,999 4,446 5,929 7,393 8,872 10,285 11,754  2,099 4,198 6,225 8,300 10,350 12,420 14,398 16,455	Initial Delivered Lumens' BUG Ratings" Per TM-15-11  1,499 B1 U0 G1 2,999 B1 U0 G1 4,446 B1 U0 G2 7,393 B1 U0 G2 8,872 B1 U0 G2 10,285 B1 U0 G2 11,754 B1 U0 G3  2,099 B1 U0 G1 4,198 B1 U0 G2 8,300 B1 U0 G2 10,350 B1 U0 G2 11,350 B1 U0 G2 12,420 B1 U0 G3 14,398 B1 U0 G3 14,398 B1 U0 G3 16,455 B2 U0 G3	Mathematical Part   Math	

<sup>\*</sup> Initial delivered lumens at 25°C (77°F). Actual production yield may vary between -10 and +10% of initial delivered lumens


lumens
\*\* For more information on the IES BUG (Backlight-Uplight-Glare) Rating visit: www.ies.org/PDF/Erratas/TM-1511BugRatingsAddendum.pdf. Valid with no tilt

### **AA Mount**

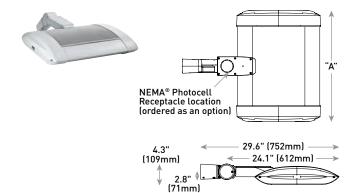


LED Count (x10)	Dim. "A"	Weight
02	12.1" (306mm)	21 lbs. (10kg)
04	12.1" (306mm)	24 lbs. (11kg)
06	14.1" (357mm)	27 lbs. (12kg)
08	16.1" (408mm)	28 lbs. (13kg)
10	18.1" (459mm)	32 lbs. (15kg)
12	20.1" (510mm)	34 lbs. (15kg)
14	22.1" (560mm)	37 lbs. (17kg)
16	24.1" (611mm)	41 lbs. (19kg)

### **DL Mount**

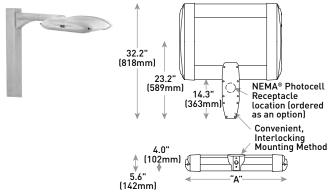

LED Count (x10)	Dim. "A"	Weight
02	12.1" (306mm)	23 lbs. (10kg)
04	12.1" (306mm)	26 lbs. (12kg)
06	14.1" (357mm)	29 lbs. (13kg)
08	16.1" (408mm)	30 lbs. (14kg)
10	18.1" (459mm)	34 lbs. (15kg)
12	20.1" (510mm)	36 lbs. (16kg)
14	22.1" (560mm)	42 lbs. (19kg)
16	24.1" (611mm)	44 lbs. (20kg)

## **SA Mount**

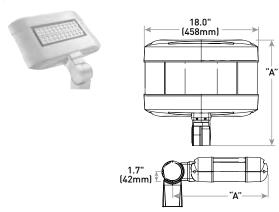

LED Count (x10)		
02	16.0" (406mm)	25 lbs. (11kg)
04	18.0" (457mm)	26 lbs. (12kg)
06	20.0" (508mm)	28 lbs. (13kg)

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## Cree Edge™ Series

LED Security Wall Pack Luminaire

### **Product Description**

The Cree Edge™ wall mount luminaire has a slim, low profile design. The luminaire end caps are made from rugged die cast aluminum with integral, weathertight LED driver compartments and high performance aluminum heat sinks specifically designed for LED applications. Housing is rugged aluminum. Includes a lightweight mounting box for installation over standard and mud ring single gang J-Boxes. Secures to wall with four 3/16" (5mm) screws (by others). Conduit entry from top, bottom, sides and rear. Allows mounting for uplight or downlight. Designed and approved for easy through-wiring. Includes leaf/debris guard.

Applications: General area and security lighting



Patented NanoOptic® Product Technology

Made in the U.S.A. of U.S. and imported parts

CRI: Minimum 70 CRI

CCT: 4000K (+/- 300K), 5700K (+/- 500K) standard


Limited Warranty<sup>†</sup>: 10 years on luminaire/10 years on Colorfast DeltaGuard® finish

†See http://lighting.cree.com/warranty for warranty terms

### Accessories

Field-Installed	
Bird Spikes	Hand-Held Remote
XA-BRDSPK	XA-SENSREM
	<ul> <li>For successful implementation of the programmable multi-level option, a minimum of one hand-held remote is required</li> </ul>



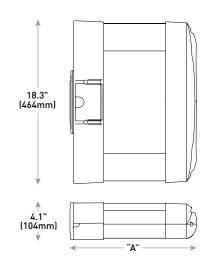

LED Count (x10)	Dim. "A"	Weight
02	9.9" (251mm)	20 lbs. (9.1kg)
04	11.9" (303mm)	22 lbs. (10.0kg)
06	13.9" (353mm)	25 lbs. (11.3kg)
08	15.9" (404mm)	27 lbs. (12.2kg)
10	17.9" (455mm)	31 lbs. (14.1kg)
12	19.9" (505mm)	32 lbs. (14.5kg)

## **Ordering Information**


Example: SEC-EDG-2M-WM-06-E-UL-SV-700

SEC-EDG		WM		E				
Product	Optic	Mounting	LED Count (x10)	Series	Voltage	Color Options	Drive Current	Options
SEC-EDG	2M Type II Medium 2MB Type II Medium w/BLS 2S Type II Short 2SB Type II Short w/BLS 3M Type III Medium 3MB Type III Medium w/BLS 4M Type IV Medium 4MB Type IV Medium w/BLS	WM Wall Mount	02 04 06 08 10 12	E	UL Universal 120-277V UH Universal 347-480V 34 347V	BK Black BZ Bronze SV Silver WH White	350 350mA 525 525mA -Available with 20-80 LEDs 700 700mA -Available with 20-60 LEDs	DIM 0-10V Dimming  - Control by others  - Refer to Dimming spec sheet for details  - Can't exceed specified drive current  F Fuse  - Refer to ML spec sheet for availability with ML options  - Available with UL voltage only  - When code dictates fusing, use time delay fuse  ML Multi-Level  - Refer to ML spec sheet for details  - Intended for downlight applications of 0° tilt  P Photocell  - Refer to ML spec sheet for availability with ML options  - Must specify UL or 34 voltage  PML Programmable Multi-Level  - Refer to PML spec sheet for details  - Intended for downlight applications of 0° tilt  40K 4000K Color Temperature  - Minimum 70 CRI  - Color temperature per luminaire








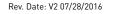




### **Photometry**


All published luminaire photometric testing performed to IESNA LM-79-08 standards by a NVLAP accredited laboratory. To obtain an IES file specific to your project consult: http://lighting.cree.com/products/outdoor/wall-mount/cree-edge-series-5

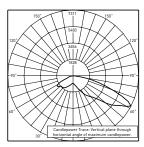

ITL Test Report #: 78793 SEC-EDG-4M-\*\*-06-E-UL-700-40K Initial Delivered Lumens: 11,607

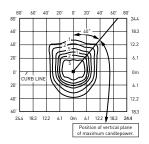


SEC-EDG-4M-\*\*-08-E-UL-525-40K Mounting Height: 10' (3.0m) A.F.G. Initial Delivered Lumens: 11,835 Initial FC at grade

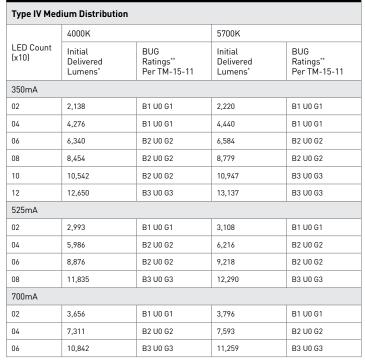

4MB

CSA Test Report #: 6449 ARE-EDG-4MB-\*\*-12-E-UL-525-40K Initial Delivered Lumens: 13,155

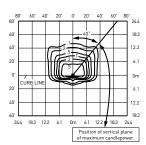

SEC-EDG-4MB-\*\*-08-E-UL-525-40K Mounting Height: 10' (3.0m) A.F.G. Initial Delivered Lumens: 8,915 Initial FC at grade

Type IV Medium Distribution w/BLS							
	4000K		5700K				
LED Count (x10)	Initial Delivered Lumens*	BUG Ratings** Per TM-15-11	Initial Delivered Lumens*	BUG Ratings** Per TM-15-11			
350mA							
02	1,610	B0 U0 G1	1,672	B0 U0 G1			
04	3,221	B1 U0 G1	3,345	B1 U0 G1			
06	4,776	B1 U0 G1	4,959	B1 U0 G1			
08	6,368	B1 U0 G2	6,613	B1 U0 G2			
10	7,941	B1 U0 G2	8,246	B1 U0 G2			
12	9,529	B1 U0 G2	9,895	B1 U0 G2			
525mA	525mA						
02	2,254	B0 U0 G1	2,341	B0 U0 G1			
04	4,509	B1 U0 G1	4,682	B1 U0 G1			
06	6,686	B1 U0 G2	6,943	B1 U0 G2			
08	8,915	B1 U0 G2	9,258	B1 U0 G2			
700mA							
02	2,754	B0 U0 G1	2,860	B0 U0 G1			
04	5,507	B1 U0 G1	5,719	B1 U0 G2			
06	8,167	B1 U0 G2	8,481	B1 U0 G2			

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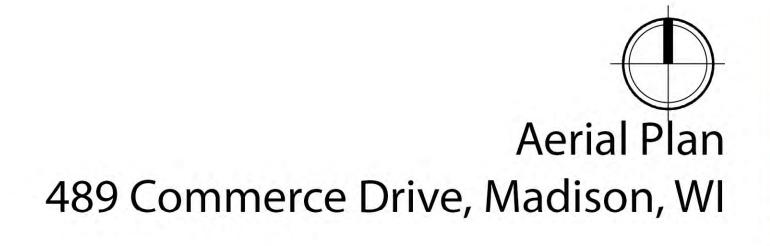


Initial delivered lumens at 25°C (77°F)
 For more information on the IES BUG (Backlight-Uplight-Glare) Rating visit: www.ies.org/PDF/Erratas/TM-15-11BugRatingsAddendum.pdf


<sup>\*</sup> Initial delivered lumens at 25°C (77°F)

\*\* For more information on the IES BUG (Backlight-Uplight-Glare) Rating visit: www.ies.org/PDF/Erratas/TM-15-11BugRatingsAddendum.pdf








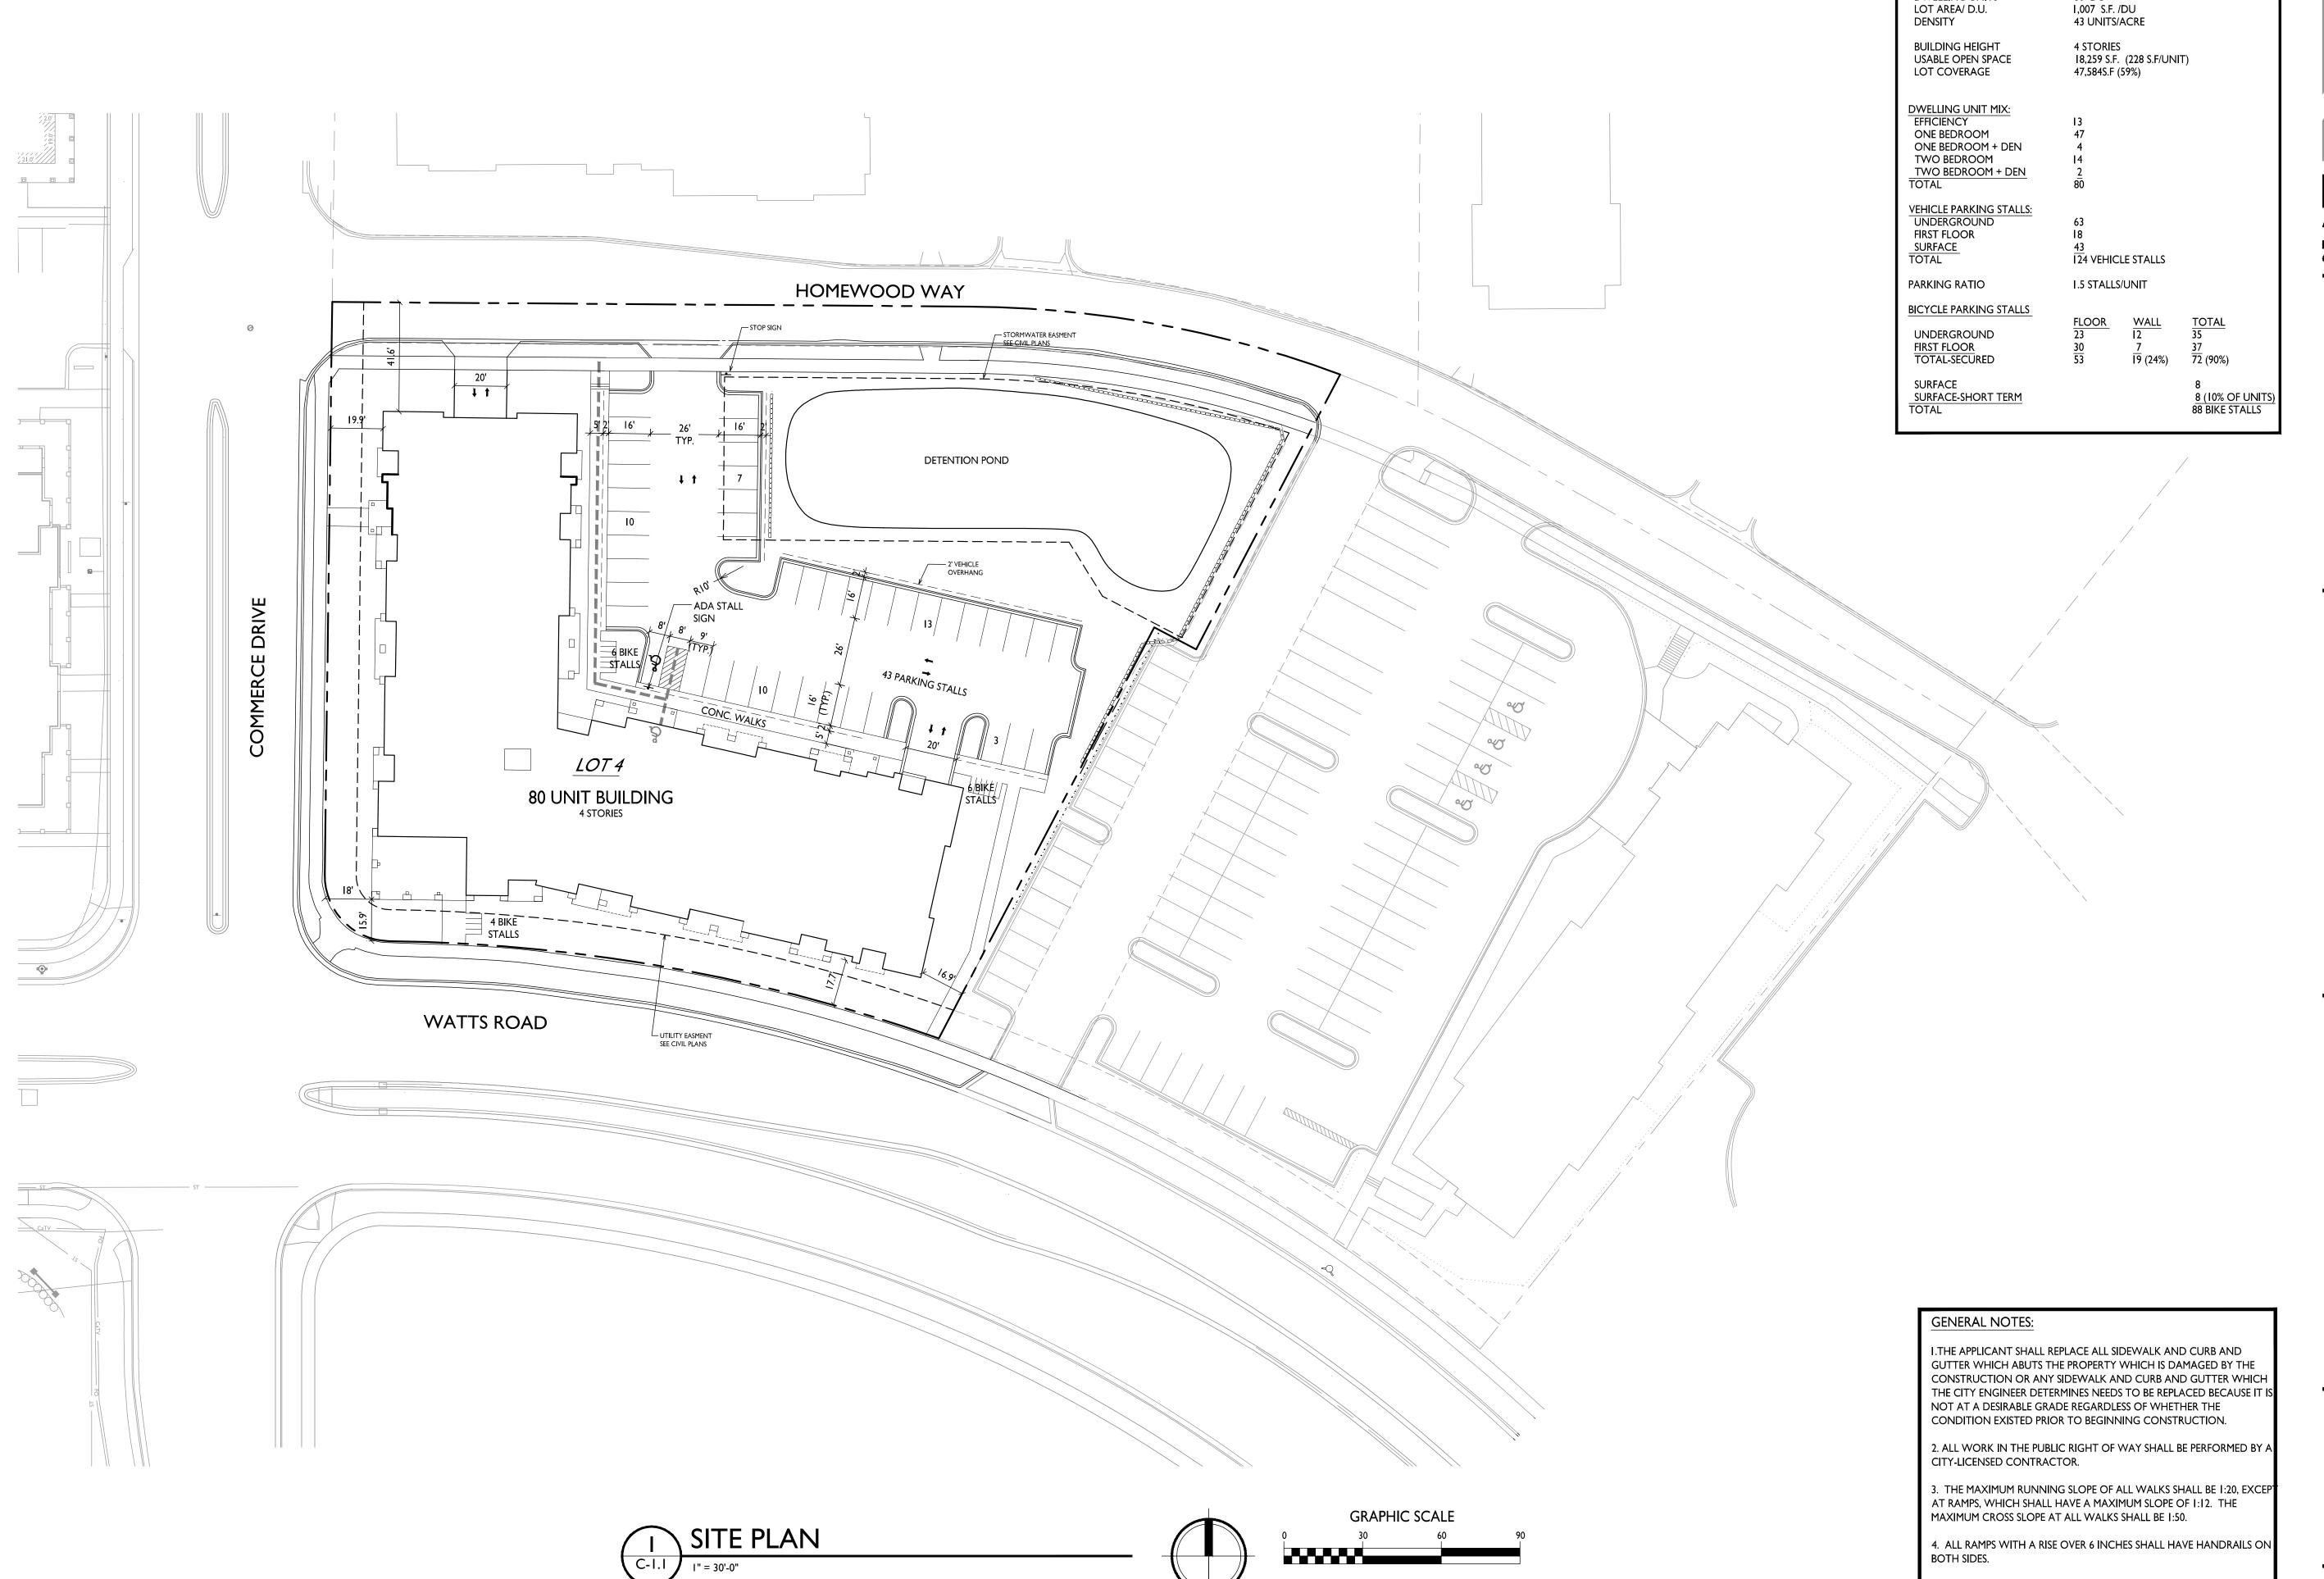

I INCH = 30 FT (24X36 PAPER)

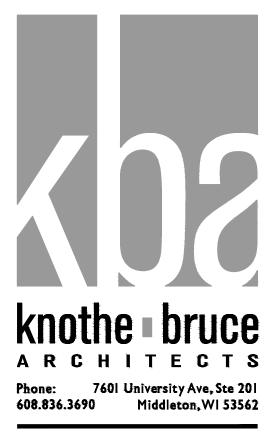

## ISSUED

Issued for Land Use - September 07, 2016 Issued for Diocese Review - September 23, 2016 Issued for Final UDC Submittal October 16, 2016

PROJECT TITLE

5. ALL STAIRWAYS WITH MORE THAN ONE RISER SHALL HAVE

SITE DEVELOPMENT DATA DENSITIES LOT AREA

DWELLING UNITS

LOT AREA/ D.U. DENSITY

80,617 S.F./1.8 ACRES

80 DU

HANDRAILS ON BOTH SIDES. 6.ALL DAMAGE TO THE PAVEMENT ON COMMERCE DRIVE & WATTS

ROAD ADJACENT TO THIS DEVELOPMENT SHALL BE RESTORED IN ACCORDANCE WITH THE CITY OF MADISON'S PAVEMENT PATCHING CRITERIA.

7.APPROVAL OF PLANS FOR THIS PROJECT DOES NOT INCLUDE ANY APPROVAL TO PRUNE, REMOVE, OR PLANT TREES IN THE PUBLIC RIGHT-OF-WAY. PERMISSION FOR SUCH ACTIVITIES MUST BE OBTAINED FROM THE CITY FORESTER, 266-4816.


SHEET TITLE Site Plan


SHEET NUMBER



PROJECT NO.

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## Plant Material List

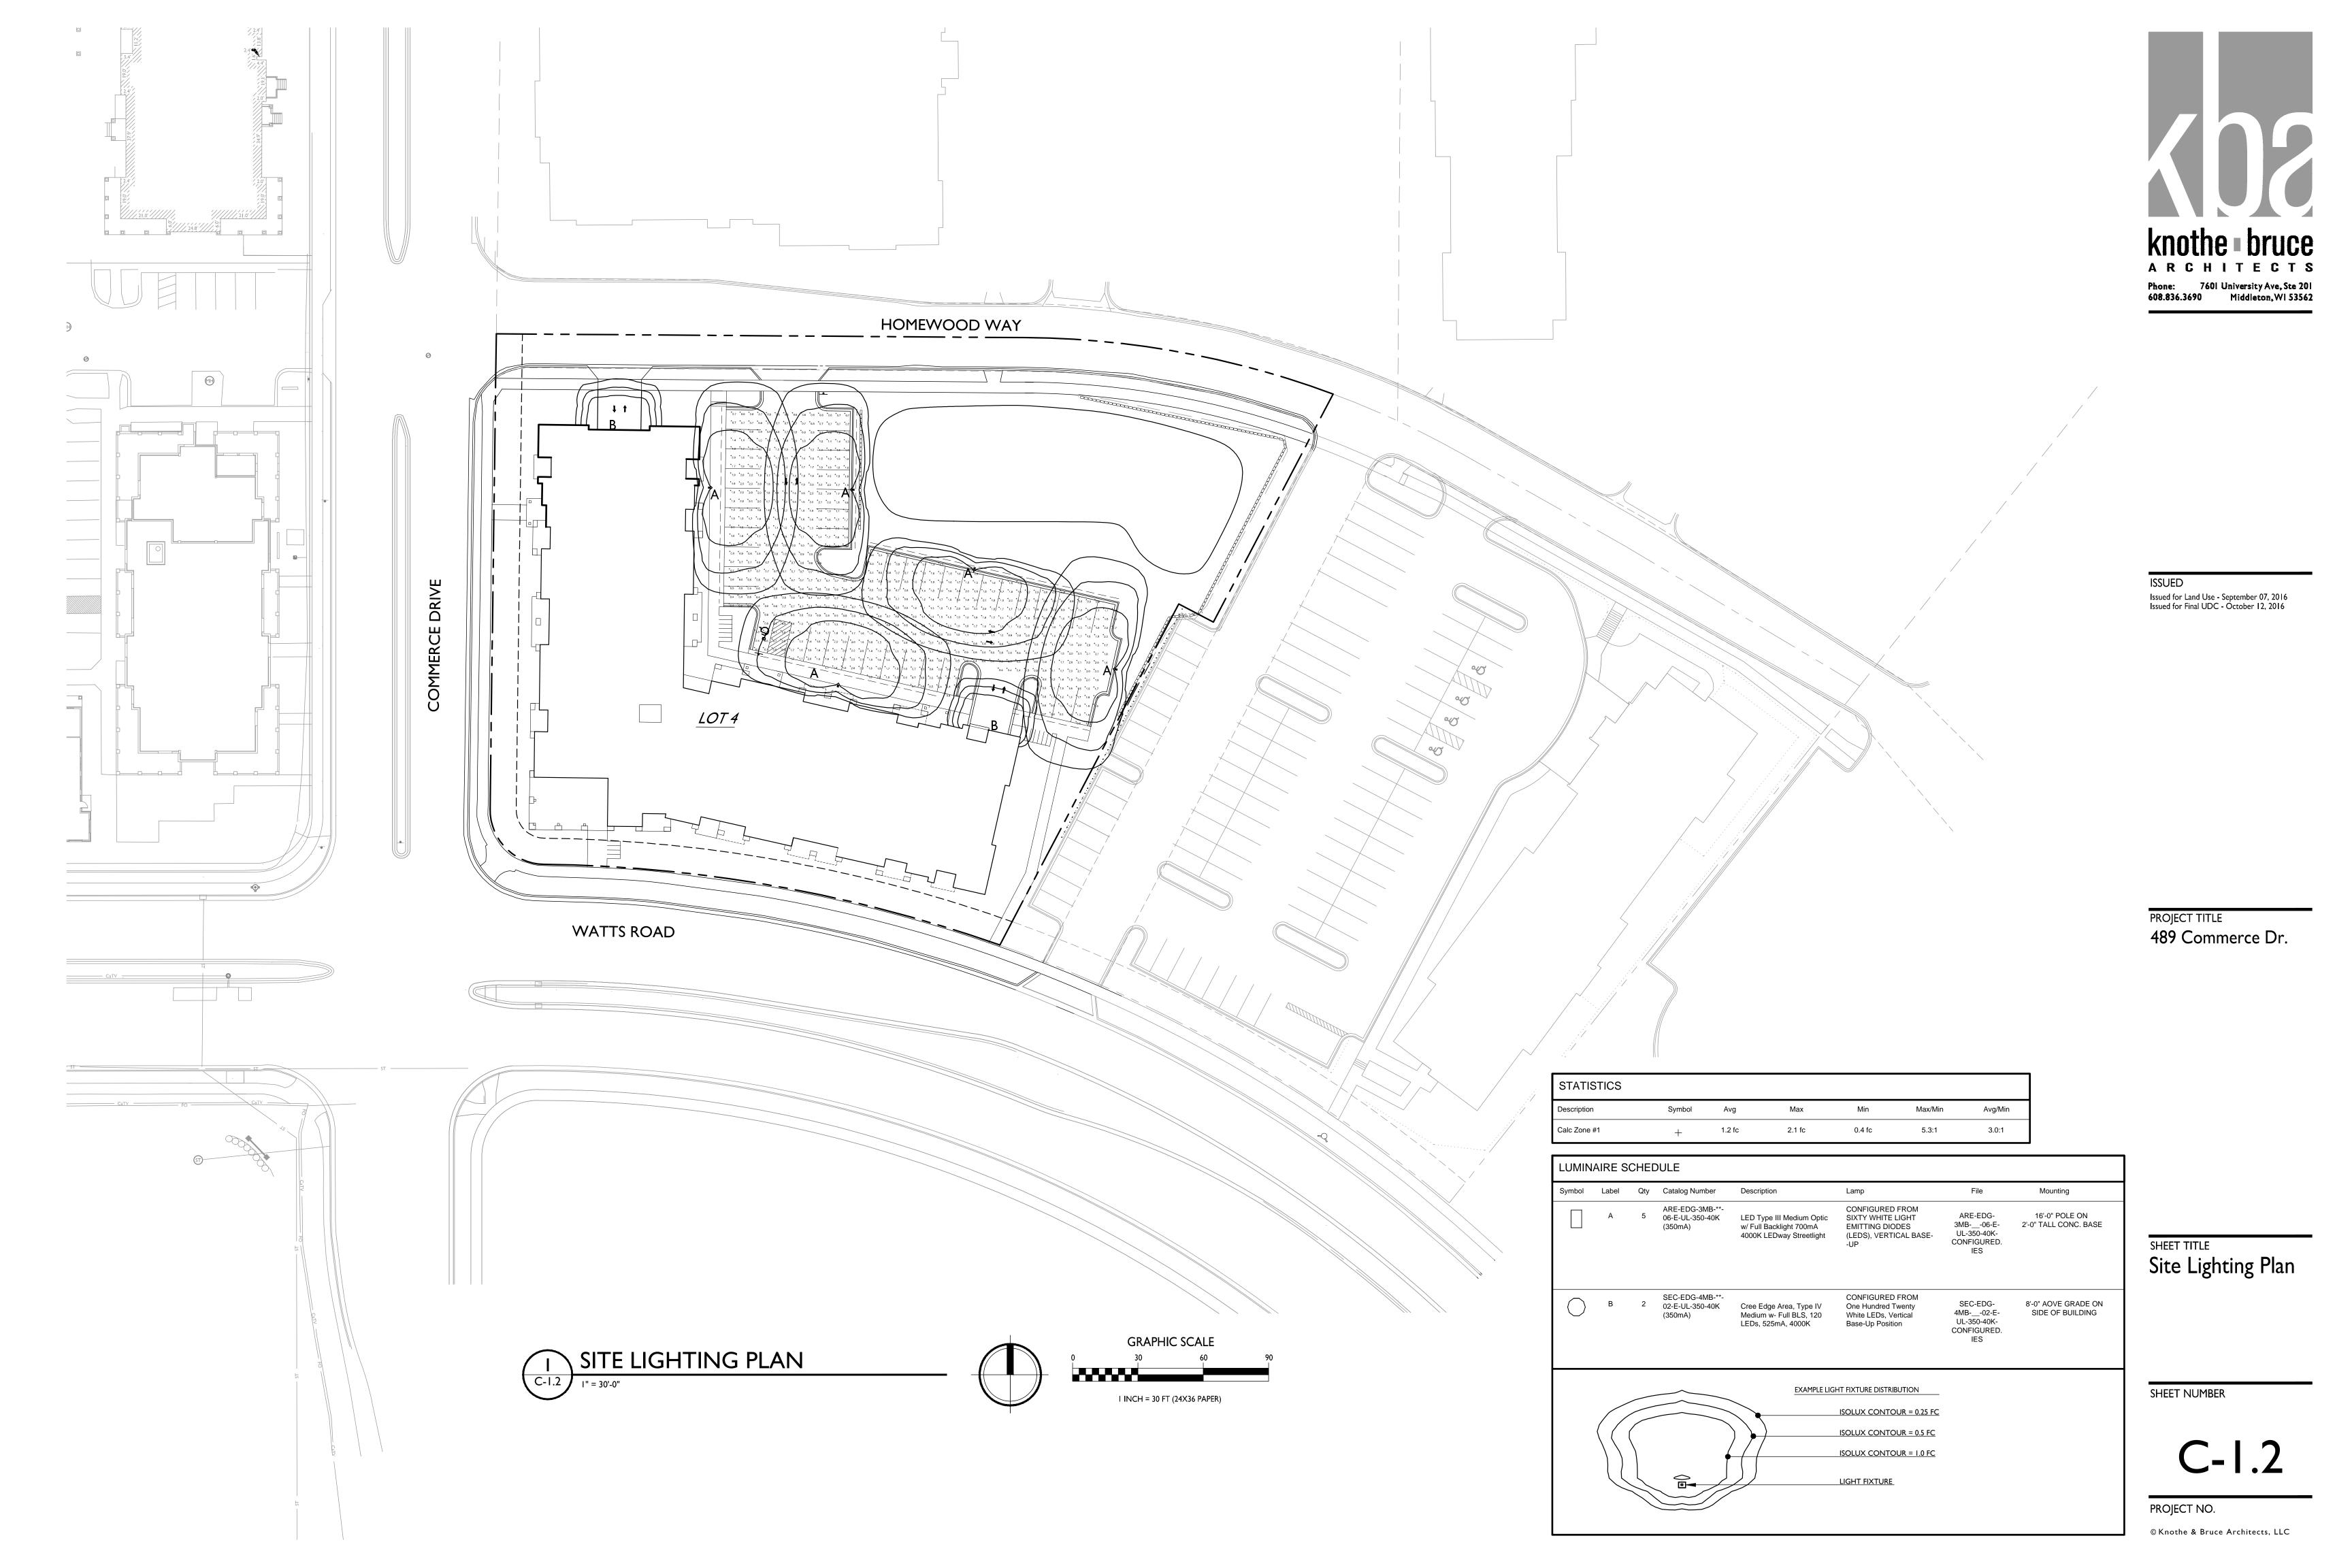Broadleaf Ded	ciduous			
Quantity	Code Name	Common Name	Scientific Name	Planting Size
4	ABM	Autumn Blaze Maple	Acer X Freemanii 'jeffersred'	2 I/2" B&B
3	ABS	Autumn Brill Serviceberry	Amelanchier X Grand 'autumn Brill'	6' B&B
2	СНВ	Common Hackberry	Celtis Occidentalis	2 I/2" B&B
1	PADWT	Pagoda Dogwood (tf)	Cornus Alternifolia (tf)	8' B&B
1	SKH	Street Keeper Honeylocust	Gleditsia Triacan 'draves'	2" B&B
2	PFC	Prairifire Crabapple	Malus 'prairifire'	2" B&B
4	SSC	Spring Snow Crabapple	Malus 'spring Snow'	2" B&B
2	TCS	Tina Crabapple (std)	Malus Sargentii 'tina' (std)	2" B&B
3	CCP	Chanticleer Callery Pear	Pyrus Calleryana 'chanticleer'	2 I/2" B&B
4	SWO	Swamp White Oak	Quercus Bicolor	2 I/2" B&B
4	GSL	Greenspire Littleleaf Linden	Tilia Cordata 'greenspire'	2 I/2" B&B
1	NHE	New Horizon Elm	Ulmus 'new Horizon'	2 I/2" B&B
Conifer Everg	reen			
Quantity	Code Name	Common Name	Scientific Name	Planting Size
3	MBJ	Mountbatten Juniper	Juniperus Chinen 'mountbatten'	5' B&B
6	MAJ	Mini Arcadia Juniper	Juniperus Sabina 'mini Arcadia'	#3 CONT.
7	BHS	Black Hills Spruce	Picea Glauca Var Densata	5' B&B
5	TY	Taunton Yew	Taxus X Media 'tauntonii'	18" B&B
18	EA	Emerald Arborvitae	Thuja Occidentalis 'smaragd'	5' B&B
Perennial				
Quantity	Code Name	Common Name	Scientific Name	Planting Size
50	KFG	Karl Foerster's Feather Reed Grass	Calamagrostis Acutiflora 'karl Foerster'	#2 CONT.
37	SDD	Stella De Oro Daylily	Hemerocallis 'stella De Oro'	#I CONT.
23	PMG	Purple Maiden Grass	Miscanthus Sinensis Var Purpurescens	#I CONT.
14	GBES	Goldsturm Black-Eyed Susan	Rudbeckia Ful Var Sullivan 'goldsturm'	#I CONT.
Shrub				
Quantity	Code Name	Common Name	Scientific Name	Planting Size
19	GBC	Glossy Black Chokeberry	Aronia Melanocarpa Var Elata	#5 CONT.
20	DBH	Dwf Bush-Honeysuckle	Diervilla Lonicera	#5 CONT.
5	SWN	Summer Wine Ninebark	Physocarpus Opulifolius 'seward'	#5 CONT.
8	RRSR	Red Ribbons Sh Rose	Rosa 'kortemma'	#3 CONT.
13	DKOR	Double Knock Out Rose	Rosa 'radtko'	#3 CONT.
3	MKL	Miss Kim Lilac	Syringa Pubescens Subsp. Patula 'miss Kim'	#5 CONT.
15	LJAV	Little Joe Arwd Viburnum	Viburnum Dentatum 'klmseventeen'	#5 CONT.

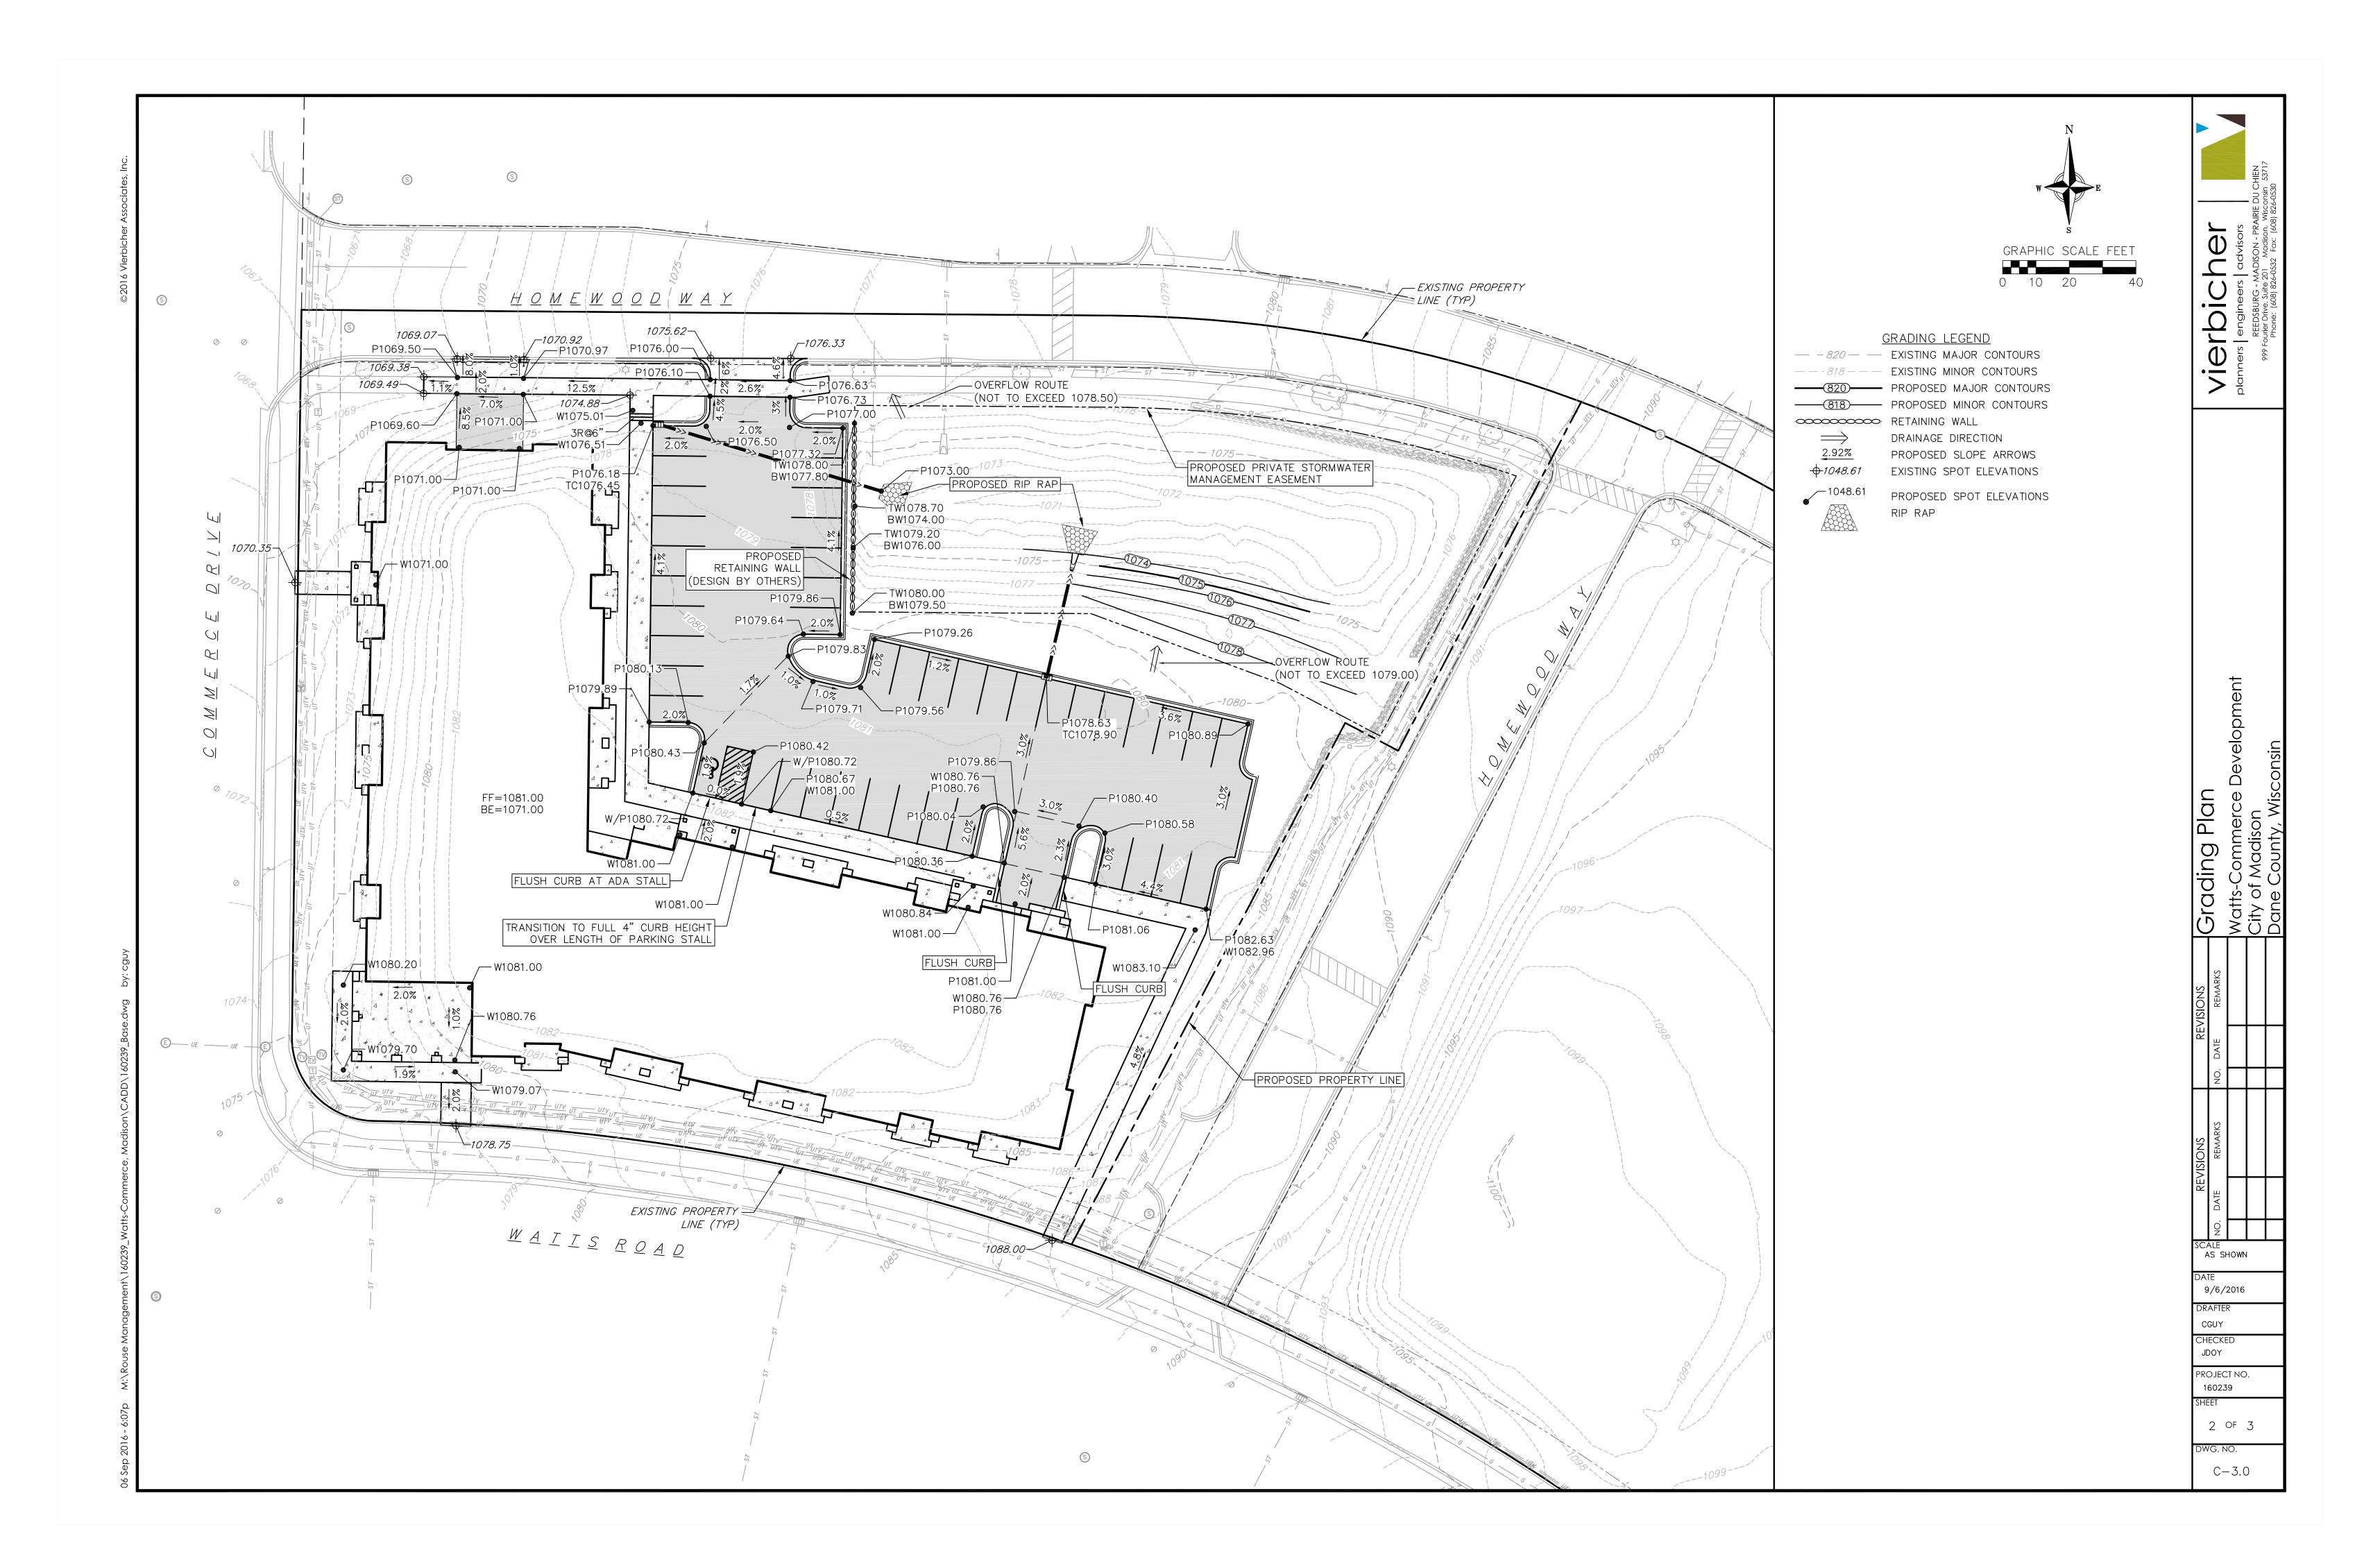A) Areas labeled "Brown Colored Wood Mulch" to receive a mixture of recycled wood mulch, colored brown, spread to a 3" depth over pre-emergent herbicide.

B) Individual trees (and shrub groupings) found along perimeter of property as well as those found within lawn areas to receive wood mulch rings (and wood mulch beds) consisting of a mixture of recycled wood mulch, colored brown, spread to a minimum 3" depth (3' wide beds for shrub groupings).

C) "Vinyl Edging" to be Valley View Black Diamond Vinyl Edging or equivalent.

D) Areas labeled "washed stone" to receive I-I/2" washed stone spread to a 3" depth over fabric weed barrier.

E) "Seed" areas shall be finish-graded and seeded at a rate of 4 lbs. per 1,000 sq. ft.

F) Seed shall consist of the following mixture: 10% Palmer IV Perennial Ryegrass 20% Dragon Kentucky Bluegrass 20% Diva Kentucky Bluegrass 20% Foxy II Creeping Red Fescue 15% Vail II Perennial Ryegrass

15% Ginney Kentucky Bluegrass

G) Areas labeled "Seed/Mat" shall be seeded with the above-noted premium lawn seed mixture and overlaid with DS75 straw erosion control netting that is then pegged into the soil with metal staples.

H) Areas labeled "Sod" shall receive only No. I grade nursery-grown bluegrass sod.

I) Plant beds adjacent to building foundation to be mulched with I-1/2" diameter washed stone mulch spread to a 3" depth over fabric weed barrier.

J) Existing street trees shall be protected. Contractor shall install tree protection fencing in the area between the curb and sidewalk and extend it at least 5 feet from both sides of the tree along the length of the terrace. No excavation is permitted within 5 feet of the outside edge of the tree trunk. If Excavation within 5 feet of any tree is necessary, contractor shall contact City Forestry (608)266-4816 prior to excavation to assess the impact to the tree and root system. Tree pruning shall be coordinated with City Forestry. Tree protection specifications can be found in section 107.13 of City of Madison Standard specifications for Public Works Constructionhttp://www.cityofmadison.com/business/pw/documents/StdSpecs/2013/Part1.pdf.

K) Contractor shall contact City Forestry (608)266-4816 at least one week prior to installing street trees to schedule inspecting the nursery stock and reviewing landscaping specifications with the landscaper.

> RICHARD J. **STROHMENGER**

## MADISON LANDSCAPE WORKSHEET

Total square footage of first 5 acres of developed area ÷ 300 square feet = ....

Zoning district is PUD/SIP

Total square footage of developed area ...

NUMBER OF LANDSCAPE POINT REQUIRED

						_	
	Point Value	NEW		existing			
PLANT TYPE or ELEMENT		Qty.	Points Achieved	Qty.	Points Achieved		
Overstory Deciduous Tree : 2-1/2" (dbh)	35	19	665				
Tall Evergreen Tree : 5-6 feet tall	35	7	245				
Ornamental Tree : I-I/2" Caliper (dbh)	15	12	180				
Upright Evergreen Shrub : 3-4 feet tall	10	21	210				
Shrub, deciduous : 3 gallon / 12"-24"	3	83	249				
Shrub, evergreen : 3 gallon / 12"-24"	4	П	44				
Ornamental grass/perennial :1gallon / 8"-18"	2	124	248				
Ornamental / Decorative fencing or wall	4 per 10 l.f.						
Existing significant specimen tree	I4 per Cal. In.					TOTAL	
Landscape furniture for public seating and /or transit connections	5 per 'seat'					POINTS PROVIDEI	
	Sub	Totals	1841	+	NA	= 1841	

Total square footage of 0 additional acres of developed area ÷ 100 square feet = .......0 Landscape Units

...19,184 SF


.....64 Landscape Units

## Street Frontage Landscape Required

Street Frontage = 812 LF Canopy Trees Required: I per 30 LF Frontage = Shrubs Required : 5 per 30 LF Frontage = ..

## Street Frontage Landscape Supplied

Proposed Canopy Trees = ......32 Proposed Shrubs = ......115

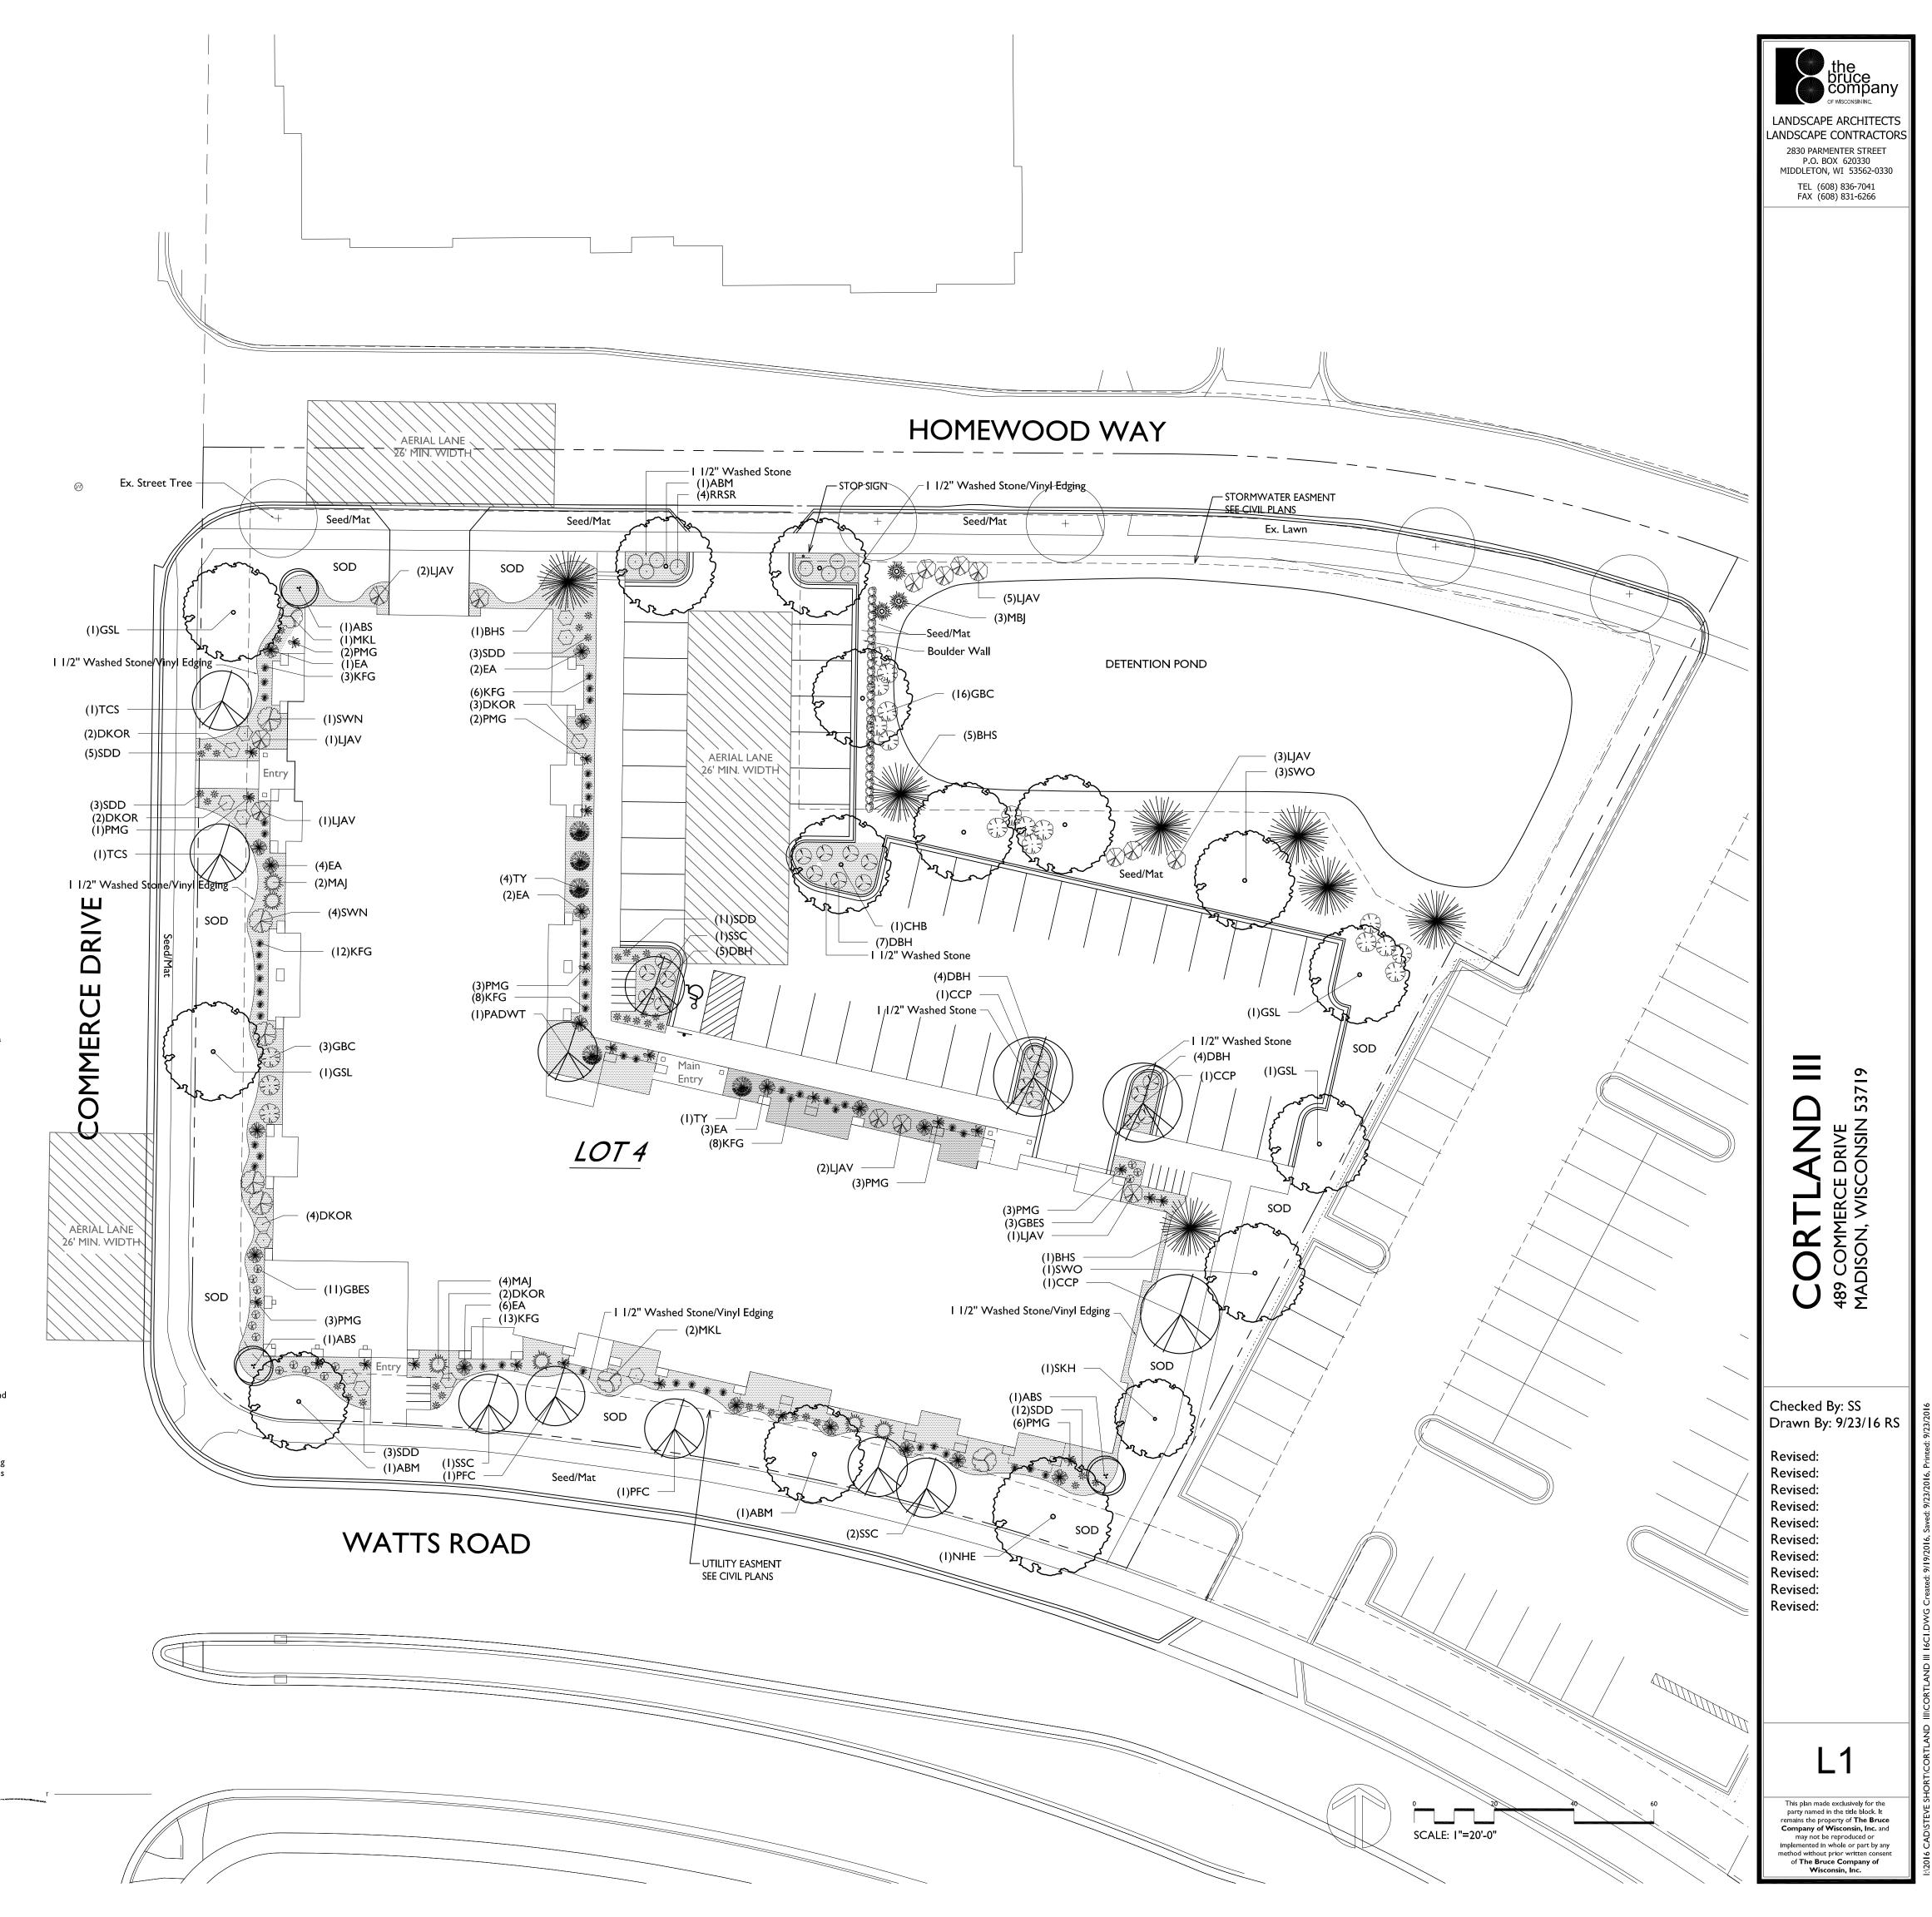










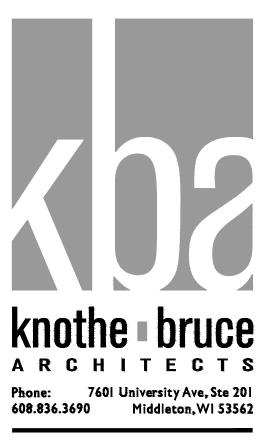

ISSUED

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Issued for Diocese Review - September 23. 2016
Issued for Final UDC Submittal October 16, 2016

PROJECT TITLE

Watts Hill

Apartments

489 Commerce Dr.

Madison, WI

SHEET TITLE

Elevations

SHEET NUMBER

A-2.1

PROJECT NO. 2

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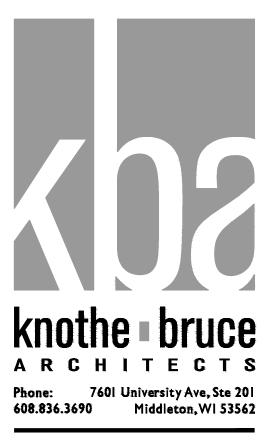


NORTH ELEVATION

A-2.2

3/32" = 1'-0"





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PROJECT TITLE

Watts Hill

Apartments

489 Commerce Dr. Madison, WI

SHEET TITLE Elevations

SHEET NUMBER

A-2.2

PROJECT NO. 1217

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West Elevation along Commerce Drive



South Elevation along Watts Road

