



City of Madison

Conditional Use and Demolition

Location
2901 Dryden Drive

Project Name
McDonald's Dryden Remodel

Applicant
McDonald's Corp/
Joel Jackson - Bishop Engineering


Existing Use
McDonald's restaurant

Proposed Use
Demolish street-facing façade as part of remodeling of restaurant and modifications to vehicle access sales and service window

Public Hearing Date
Plan Commission
08 August 2016




For Questions Contact: Jessica Vaughn at: 267-8733 or jvaughn@cityofmadison.com or City Planning at 266-4635

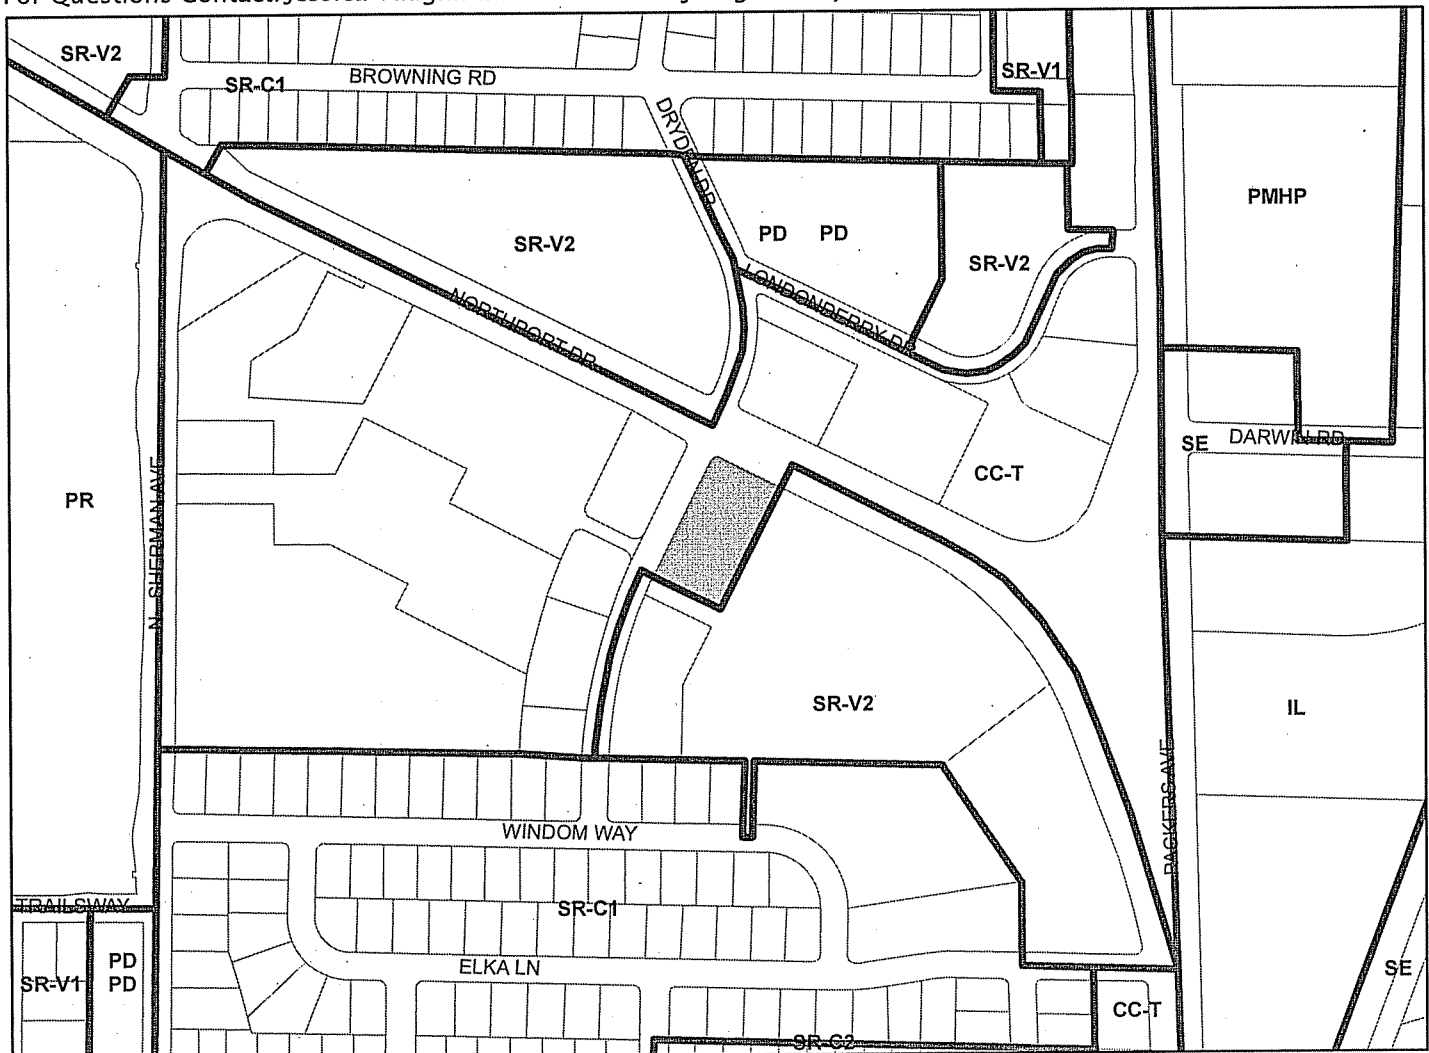

Scale : 1" = 400'

City of Madison, Planning Division : RPJ : Date : 29 July 2016

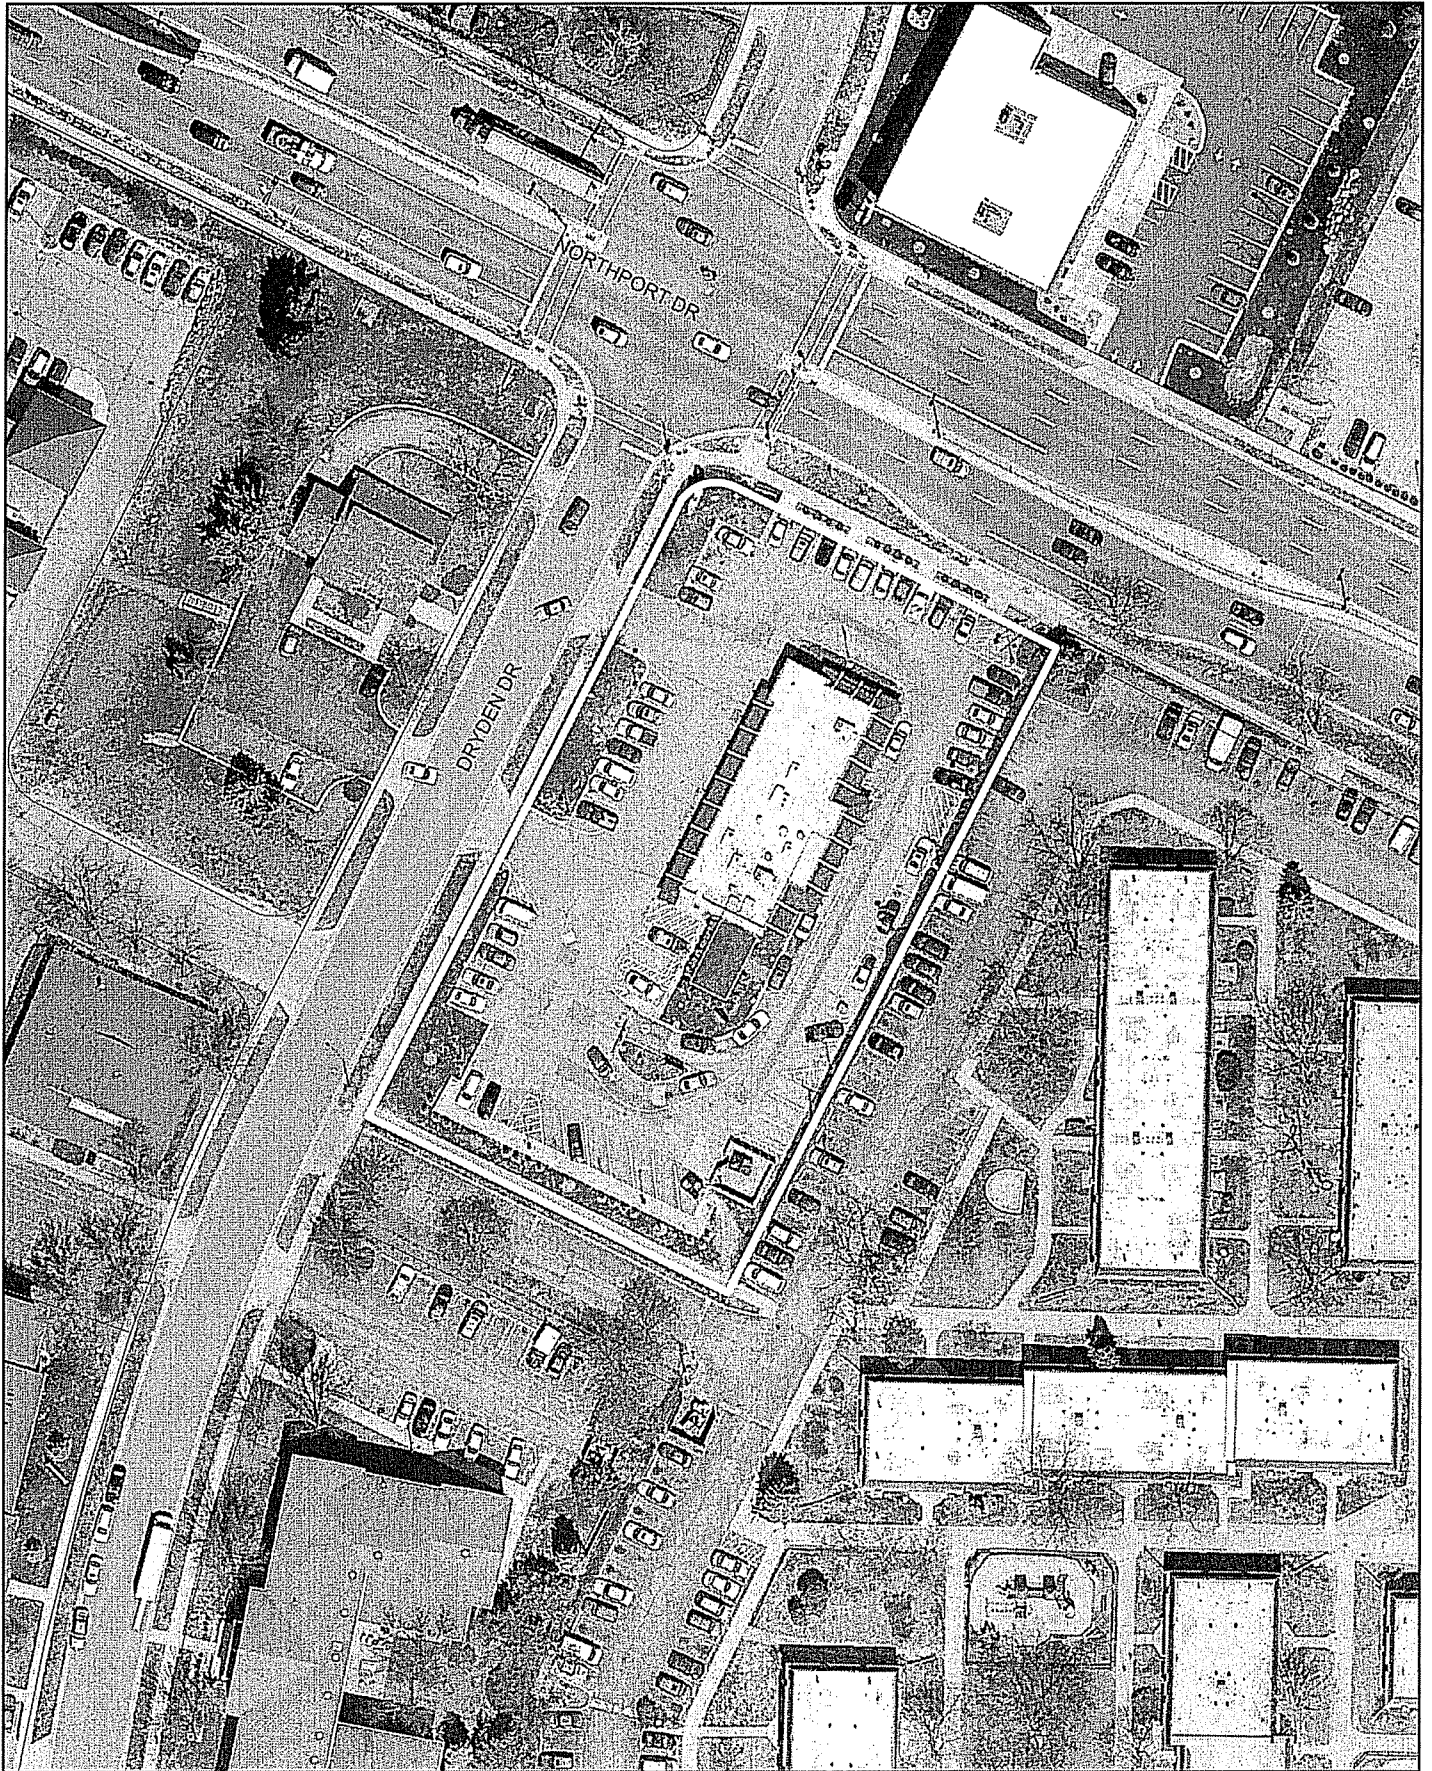



LAND USE APPLICATION

CITY OF MADISON

215 Martin Luther King Jr. Blvd; Room LL-100
PO Box 2985; Madison, Wisconsin 53701-2985
Phone: 608.266.4635 | Facsimile: 608.267.8739

- All Land Use Applications should be filed with the Zoning Administrator at the above address.
- The following information is required for all applications for Plan Commission review except subdivisions or land divisions, which should be filed using the Subdivision Application.
- This form may also be completed online at:
www.cityofmadison.com/developmentcenter/landdevelopment

FOR OFFICE USE ONLY:

Amt. Paid 600 Receipt No. 017974-
Date Received 6/29/16 0010
Received By JLK
Parcel No. 0810-303-0101-4
Aldermanic District 12-Larry Palmer
Zoning District CC-T
Special Requirements CU
Review Required By:
☐ Urban Design Commission ☐ Plan Commission
☐ Common Council ☐ Other: _____

Form Effective: February 21, 2013

1. Project Address: 2901 Dryden Dale
Project Title (if any): McDonald's Dryden Remodel Project

2. This is an application for (Check all that apply to your Land Use Application):

- ☐ Zoning Map Amendment from _____ to _____
- ☐ Major Amendment to Approved PD-GDP Zoning ☐ Major Amendment to Approved PD-SIP Zoning
- ☐ Review of Alteration to Planned Development (By Plan Commission)
- ☒ Conditional Use, or Major Alteration to an Approved Conditional Use
- ☒ Demolition Permit
- ☐ Other Requests: _____

3. Applicant, Agent & Property Owner Information:

Applicant Name: Vicky Staadler Company: McDonald's
Street Address: 1650 W. 82nd St #900 City/State: Bloomington, MN Zip: 55431
Telephone: (612) 275-5559 Fax: () N/A Email: vicky.staadler@us.mcd.com

Project Contact Person: Joel Jackson Company: Bishop Engineering
Street Address: 3501 104th St City/State: Urbandale, IA Zip: 50322
Telephone: (515) 276-0467 Fax: () N/A Email: jjackson@bishopengr.com

Property Owner (if not applicant): McDonald's Corp c/o Missata Mac Inc
Street Address: 143250 Canty Rd J City/State: Payette, WI Zip: 53955

4. Project Information:

Provide a brief description of the project and all proposed uses of the site: Remodel Existing Building, remove play place, make walks & drives ADA compliant, re-brand drive-thru.

Development Schedule: Commencement Sept 2016 Completion Nov 2016

5. Required Submittal Information

All Land Use applications are required to include the following:

☒ Project Plans including:*

- Site Plans (fully dimensioned plans depicting project details including all lot lines and property setbacks to buildings; demolished/proposed/alterd buildings; parking stalls, driveways, sidewalks, location of existing/proposed signage; HVAC/Utility location and screening details; useable open space; and other physical improvements on a property)
- Grading and Utility Plans (existing and proposed)
- Landscape Plan (including planting schedule depicting species name and planting size)
- Building Elevation Drawings (fully dimensioned drawings for all building sides, labeling primary exterior materials)
- Floor Plans (fully dimensioned plans including interior wall and room location)

Provide collated project plan sets as follows:

- ~~Seven (7) copies~~ of a full-sized plan set drawn to a scale of 1 inch = 20 feet (folded or rolled and stapled)
- ~~Twenty Five (25) copies~~ of the plan set reduced to fit onto 11 X 17-inch paper (folded and stapled)
- ~~One (1) copy~~ of the plan set reduced to fit onto 8 1/2 X 11-inch paper

* For projects requiring review by the **Urban Design Commission**, provide **Fourteen (14) additional 11x17 copies** of the plan set. In addition to the above information, all plan sets should also include: 1) Colored elevation drawings with shadow lines and a list of exterior building materials/colors; 2) Existing/proposed lighting with photometric plan & fixture cutsheet; and 3) Contextual site plan information including photographs and layout of adjacent buildings and structures. The applicant shall bring samples of exterior building materials and color scheme to the Urban Design Commission meeting.

☒ Letter of Intent: Provide one (1) Copy per Plan Set describing this application in detail including, but not limited to:

- | | | |
|---|---|---|
| • Project Team | • Building Square Footage | • Value of Land |
| • Existing Conditions | • Number of Dwelling Units | • Estimated Project Cost |
| • Project Schedule | • Auto and Bike Parking Stalls | • Number of Construction & Full-Time Equivalent Jobs Created |
| • Proposed Uses (and ft ² of each) | • Lot Coverage & Usable Open Space Calculations | • Public Subsidy Requested |
| • Hours of Operation | | |

☒ Filing Fee: Refer to the Land Use Application Instructions & Fee Schedule. Make checks payable to: City Treasurer. \$1000.00

☒ Electronic Submittal: All applicants are required to submit copies of all items submitted in hard copy with their application as Adobe Acrobat PDF files on a non-returnable CD to be included with their application materials, or by e-mail to pcapplications@cityofmadison.com.

☐ Additional Information may be required, depending on application. Refer to the Supplemental Submittal Requirements.

6. Applicant Declarations

- ☐ **Pre-application Notification:** The Zoning Code requires that the applicant notify the district alder and any nearby neighborhood and business associations in writing no later than 30 days prior to FILING this request. List the alderperson, neighborhood association(s), and business association(s) AND the dates you sent the notices:

→ If a waiver has been granted to this requirement, please attach any correspondence to this effect to this form.

- ☒ **Pre-application Meeting with Staff:** Prior to preparation of this application, the applicant is required to discuss the proposed development and review process with Zoning and Planning Division staff; note staff persons and date.

Planning Staff: JLV

Date: 6/13/16

Zoning Staff: Terry Livingston

Date: 6/13/16

The applicant attests that this form is accurately completed and all required materials are submitted:

Name of Applicant Vicky Stadther Relationship to Property: McDonald's Construction Manager

Authorizing Signature of Property Owner V Stadther

Date 6-13-16

June 27th, 2016

City of Madison, Wisconsin Permit Counter
Attn: Jenny Kirchgatter
Assistant Zoning Administrator
215 Martin Luther King, Jr. Blvd Ste. LL-100
Madison, WI 53703



Re: Letter of Intent for McDonald's: 2901 Dryden Drive

Dear Ms. Kirchgatter,

McDonald's Corporation is proposing improvements for the McDonald's restaurant located at 2901 Dryden Drive. The improvements will include maintenance of the parking lot and bringing the site up to ADA compliance for both sidewalks and ADA stall slopes. In addition, the building will be remodeled with a new façade the removal of the existing playplace off the front of the current building.

As part of this renovation, the function of the site will not change. The hours at this location will also stay the same with the lobby being open 5:00am-11:00pm and the drive-thru open 24-hours a day.

Summary of renovations:

ADA Modifications:

Currently the site sidewalks and handicap parking are not ADA compliant with current standards. This is because the site was constructed prior to the federal ADA code of 1992 being enacted. In making the site compliant, sidewalk will be removed and replaced, a connection to the public sidewalk on Northport Drive will be added and ADA stalls will be moved and repaved to make all slopes less than the 2% maximum slope requirement.

Maintenance:

As part of this project, there are several areas of the parking lot that need maintenance. The drive-thru areas and ADA stalls will be replaced with concrete and the remainder of the parking lot will get a new asphalt overlay and new parking lot stripes.

Building Remodel:

Both the interior and exterior of the existing building will be remodeled. In addition the existing playplace on the front of the building will be removed. New building elevations are being proposed to remove the mansard roof from the building to refresh the building. As part of the remodel, McDonald's has seen a shift in demographics on this store and a large reduction in sales of Happy Meals over the years. That said, this store no longer justifies having a playplace as part of this location and is using the remodel opportunity to remove the playplace. It shall be noted there is an additional McDonald's located 4 miles away at 4020 Milwaukee Street that has a playplace.

Sincerely,

Joel Jackson, PE











MCDONALD'S - MADISON, WI - DRYDEN DR.

SITE PLAN

SHEET INDEX:

C0.1	COVER SHEET
C0.2	SITE SURVEY
C1.1	DEMO PLAN
C2.1	LAYOUT PLAN
C2.2-C2.6	DRIVE THRU PLANS
C3.1	GRADING PLAN
C5.1	LANDSCAPE PLAN

PROPERTY DESCRIPTION:

LOT THIRTEEN (13), BLOCK SIX (6), 1ST ADDITION TO BRUNS, IN THE CITY OF MADISON, COUNTY OF DANE, STATE OF WISCONSIN.

ADDRESS:

2901 DRYDEN DRIVE
MADISON, WI 53704-3009

OWNER:

MCDONALD'S CORP % MISSOULA MAC INC
N3250 COUNTY RD J
POYNETTE, WI 53955-9256

PREPARED FOR:

MCDONALD'S USA, LLC
ATTN: VICKY STADTHER
1650 W 82ND ST., SUITE 900
BLOOMINGTON, MN 55431
PH: (952) 884-4355

ZONING:

CC-T - COMMERCIAL CORRIDOR - TRANSITIONAL DISTRICT

PARKING REQUIREMENTS:

CAR MINIMUM REQUIREMENT: 15% OF THE CAPACITY OF PERSONS
CAR MAXIMUM REQUIREMENT: 40% OF THE CAPACITY OF PERSONS
BICYCLE MINIMUM REQUIREMENT: 5% OF THE CAPACITY OF PERSONS

MINIMUM CAR PARKING = $92 \times 15\% = 14$ STALLS
MAXIMUM CAR PARKING $92 \times 40\% = 37$ STALLS
MINIMUM BICYCLE PARKING = $92 \times 5\% = 5$ STALLS

CAR PARKING PROVIDED = 37 STALLS (INCL 2 HC STALLS)
BICYCLE PARKING PROVIDED = 6 STALLS

BENCHMARK:

ELEVATIONS ON THE SURVEY ARE REFERENCED TO THE NORTH AMERICAN VERTICAL DATUM OF 1988 BASED ON A BENCHMARK ELEVATION OF 857.02 ON THE BRASS CAP MONUMENT AT THE EAST 1/4 CORNER OF SECTION 36, T8N, R9E AS PROVIDED BY THE CITY OF MADISON.

GENERAL NOTES:

- ALL WORK SHALL BE DONE IN ACCORDANCE WITH CITY OF MADISON STANDARD SPECIFICATIONS AND ANY AND ALL CITY/COUNTY SUPPLEMENTAL SPECIFICATIONS. THE CITY OF MADISON MUST BE NOTIFIED BY ALL CONTRACTORS 48 HOURS PRIOR TO COMMENCING WORK.
- THE CONTRACTOR SHALL BE RESPONSIBLE FOR THE LOCATION OF ALL UTILITIES. ANY DAMAGE TO SAID UTILITIES SHALL BE REPAIRED AT THE CONTRACTORS EXPENSE.
- ALL WORK SHALL BE DONE IN ACCORDANCE WITH THE CURRENT O.S.H.A. CODES AND STANDARDS. NOTHING INDICATED ON THESE PLANS SHALL RELIEVE THE CONTRACTOR FROM COMPLYING WITH THE APPROPRIATE SAFETY REGULATIONS.
- ALL NECESSARY CONSTRUCTION SIGNS, BARRICADES AND OTHER TRAFFIC CONTROL DEVICES REQUIRED DURING CONSTRUCTION WILL BE FURNISHED BY THE CONTRACTOR. SIGNS, BARRICADES AND OTHER TRAFFIC CONTROL DEVICES MUST BE IN CONFORMANCE WITH THE "MANUAL ON UNIFORM TRAFFIC CONTROL DEVICES FOR STREETS AND HIGHWAYS."
- BISHOP ENGINEERING SHALL NOT BE LIABLE FOR ANY INJURIES THAT HAPPEN ON SITE. THIS SHALL INCLUDE BUT NOT BE LIMITED TO TRENCH COLLAPSES FROM VARYING SOIL CONDITIONS OR INJURIES CAUSED BY UNDERGROUND UTILITIES INCLUDING UTILITIES THAT ARE NOT SHOWN ON PLAN.
- THE CONTRACTOR IS LIABLE FOR ALL DAMAGES TO PUBLIC OR PRIVATE PROPERTY CAUSED BY THEIR ACTION OR INACTION IN PROVIDING FOR STORM WATER FLOW DURING CONSTRUCTION. DO NOT RESTRICT FLOWS IN EXISTING DRAINAGE CHANNELS, STORM SEWER, OR FACILITIES.
- THE CONTRACTOR SHALL SUBMIT TO THE ENGINEER A SCHEDULE FOR PERFORMANCE OF WORK ITEMS. THIS SCHEDULE SHALL BE PROVIDED BY THE CONTRACTOR AT THE PROJECT PRECONSTRUCTION CONFERENCE. NO WORK SHALL BEGIN UNTIL A SCHEDULE HAS BEEN SUBMITTED AND ACCEPTED. THE CONTRACTOR SHALL THEN PERFORM WORK TO CONFORM TO THE ACCEPTED SCHEDULE.
- LABORATORY TESTS SHALL BE PERFORMED BY THE OWNER UNLESS OTHERWISE NOTED. THE CONTRACTOR SHALL PROVIDE SAMPLES OF MATERIAL REQUIRED FOR LABORATORY TESTS AND TESTING IN ACCORDANCE WITH THE URBAN STANDARD SPECIFICATIONS FOR PUBLIC IMPROVEMENTS.
- SOIL IMPORT OR EXPORT ON THIS PROJECT SHALL BE CONSIDERED INCIDENTAL AND WILL NOT BE MEASURED OR PAID FOR SEPARATELY.
- THE CONTRACTOR SHALL PROTECT ALL STRUCTURES NOT SHOWN AS REMOVALS ON THE PLANS.
- THE CONTRACTOR SHALL OBTAIN ANY AND ALL NECESSARY PERMITS PRIOR TO ANY CONSTRUCTION.
- GRADING AND EROSION CONTROL SHALL BE DONE IN ACCORDANCE WITH THE APPROVED EROSION CONTROL PLAN AND ANY AND ALL CITY, COUNTY OR STATE REQUIREMENTS.
- THE CONTRACTOR SHALL PICK UP ANY DEBRIS SPILLED ONTO THE ADJACENT RIGHT OF WAY OR ABUTTING PROPERTIES AS THE RESULT OF CONSTRUCTION, AT THE END OF EACH WORK DAY.
- THE CONTRACTOR IS RESPONSIBLE FOR THE PROMPT REMOVAL OF ALL MUD THAT HAS BEEN TRACKED OR WASHED UNTO ADJACENT PROPERTY OR RIGHT OF WAY UNTIL SUCH TIME THAT PERMANENT VEGETATION HAS BEEN ESTABLISHED.
- DISPOSE OF ALL EXCESS MATERIALS AND TRASH IN ACCORDANCE WITH FEDERAL, STATE, AND LOCAL REQUIREMENTS. PROVIDE WASTE AREAS OR DISPOSAL SITES FOR EXCESS MATERIALS NOT DESIRABLE FOR INCORPORATION INTO THE PROJECT.
- THE CONTRACTOR SHALL COORDINATE THE ADJUSTMENT OF ANY AND ALL EXISTING AND PROPOSED UTILITIES TO PROPOSED GRADES. EXISTING UTILITIES SHALL BE RAISED OR LOWERED IN ACCORDANCE WITH THE UTILITY OWNER REQUIREMENTS. ANY NECESSARY ADJUSTMENTS SHALL BE CONSIDERED INCIDENTAL TO CONSTRUCTION.
- ACTIVE EXISTING FIELD TILES ENCOUNTERED DURING CONSTRUCTION SHALL BE REPAIRED, REROUTED, OR CONNECTED TO PUBLIC OR PRIVATE STORM SEWER TO REMAIN IN SERVICE.

PAVING NOTES:

- SEE DETAILS FOR ALL PAVEMENT THICKNESS.
- ALL WALKS, PARKING LOTS, HANDICAP PARKING, RAMPS, ETC. SHALL COMPLY WITH ALL A.D.A. AND CITY CODES. HANDICAP PARKING SIGNAGE IS REQUIRED FOR ALL HANDICAP STALLS AND SHALL BE CONSIDERED INCIDENTAL. IN EVENT OF A DISCREPANCY BETWEEN THE PLANS AND THE A.D.A./CITY CODES THE A.D.A./CITY CODES SHALL GOVERN. CONTRACTOR SHALL BE RESPONSIBLE FOR ENSURING A.D.A. CODES ARE MET.

UTILITY CONFLICT NOTES:

- UTILITY CONFLICTS MAY EXIST ACROSS THE SITE WITH NEW UTILITIES, GRADING, PAVING ETC. MOST UTILITY CONFLICTS HAVE BEEN CALLED OUT FOR CONTRACTOR CONVENIENCE.
- CONTRACTOR IS RESPONSIBLE FOR ALL UTILITY CONFLICTS THAT ARE EITHER CALLED OUT ON THE PLANS OR THAT CAN BE SEEN ON THE PLANS BETWEEN AND EXISTING UTILITY AND PROPOSED CONSTRUCTION

SURVEY NOTES:

- SURVEY WORK WAS COMPLETED BY NOTBOHM MICHAELS SURVEYING INC ON MAY 9TH, 2016. SEE SITE SURVEY PROVIDED AS PART OF THIS SET OF PLANS FOR EXISTING SITE CONDITIONS AND BOUNDARY INFORMATION.

LAND USE SUMMARY TABLE			
SITE AREA	49,902 square feet		
	EXISTING	PROPOSED	
BUILDING AREA			
	First Floor	5,512	4,282
	Basement		
	Screened Porch		
	Garage		
Total	5,512	4,282	
LOT COVERAGE (sidewalks >5', driveways, building footprint, covered porches, etc.)	38,682	37,762	
OPEN SPACE (landscape areas, sidewalks <5', paver patios, decks, etc.)	11,220	12,140	

UTILITY NOTE:

THE LOCATION OF THE UTILITIES INDICATED ON THE PLANS HAVE BEEN TAKEN FROM THE FIELD SURVEY, EXISTING PUBLIC RECORDS, AND PLANS PROVIDED BY OTHERS. SURFACE UTILITY LOCATIONS HAVE BEEN FIELD LOCATED BY BISHOP ENGINEERING, UNLESS OTHERWISE NOTED. ALL UNDERGROUND UTILITY LOCATIONS ARE APPROXIMATE LOCATIONS ONLY. BISHOP ENGINEERING DOES NOT GUARANTEE THE UNDERGROUND LOCATION OF ANY UTILITIES SHOWN. IT SHALL BE THE DUTY OF THE CONTRACTOR TO DETERMINE THE LOCATION AND DEPTH OF ANY UNDERGROUND UTILITIES SHOWN AND IF ANY ADDITIONAL UTILITIES, OTHER THAN THOSE SHOWN ON THE PLANS, MAY BE PRESENT. A REQUEST WAS MADE TO IOWA ONE CALL FOR UTILITY PROVIDERS TO VERIFY, LOCATE, AND MARK THEIR UTILITIES IN THE FIELD.

SUBGRADE PREP NOTES:

SHAPE AND CONSOLIDATE SUBGRADE IN PREPARATION FOR THE PLACEMENT OF PAVEMENT.

A. UNIFORM COMPOSITION: PROVIDE UNIFORM COMPOSITION OF AT LEAST 12 INCHES BELOW TOP OF SUBGRADE UNDER NEW PAVING OR SUBBASE, PLUS 2 FEET ON EACH SIDE. USE SELECT SUBGRADE MATERIALS (SEE NOTES) UNLESS GRANULAR STABILIZATION MATERIALS OR SUBGRADE TREATMENT IS SPECIFIED.

- SUBGRADE COMPACTION IN FILL SECTIONS:
 - FOLLOW THE COMPACTION WITH MOISTURE AND DENSITY CONTROL REQUIREMENTS.
 - CONSTRUCT IN TWO 6 INCH LIFTS.
- SUBGRADE COMPACTION IN CUT SECTIONS:
 - EXCAVATE AND STOCKPILE THE TOP 6 INCHES OF SUBGRADE.
 - SCARIFY, MIX, AND RE-COMPACT THE NEXT 6 INCHES OF SUBGRADE.
 - REPLACE, MIX, AND COMPACT THE TOP 6 INCHES OF SUBGRADE.
- REMOVE STONES OVER 3 INCHES FROM SUBGRADE.
- CONSTRUCT TO ELEVATION AND CROSS-SECTION SUCH THAT, AFTER ROLLING, SURFACE WILL BE ABOVE REQUIRED SUBGRADE ELEVATION.
- SUBGRADE STABILITY:
 - PERFORM PROOF ROLLING WITH A TRUCK LOADED TO THE MAXIMUM SINGLE LEGAL AXLE GROSS WEIGHT OF 20,000 POUNDS OR THE MAXIMUM TANDEM AXLE GROSS WEIGHT OF 34,000 POUNDS. OPERATE TRUCKS AT LESS THAN 10 MPH. MAKE MULTIPLE PASSES FOR EVERY LANE. THE SUBGRADE WILL BE CONSIDERED TO BE UNSTABLE IF, UNDER THE OPERATION OF THE LOADED TRUCK, THE SURFACE SHOWS YIELDING (SOIL WAVE IN FRONT OF THE LOADED TIRES) OR RUTTING OF MORE THAN 2 INCHES, MEASURED FROM THE TOP TO THE BOTTOM OF THE RUT AT THE OUTSIDE EDGES.
 - IF SOFT OR YIELDING AREAS ARE LOCATED, REMOVE UNSTABLE MATERIALS AND REPLACE WITH SUITABLE FOUNDATION MATERIALS AS APPROVED BY THE SOILS ENGINEER. COMPACT SUBGRADE MATERIALS IN CUT SECTIONS AS REQUIRED BY THE SOILS ENGINEER. IF STABILIZATION MATERIAL IS USED, PLACE AND COMPACT AS REQUIRED FOR SUBBASE.
- FINAL SUBGRADE: COMPLETE FINAL SUBGRADE BY EXCAVATION TO GRADE BY USE OF STEEL-SHOD TEMPLATE SUPPORTED ON SIDE FORMS, SUPPORT ROLLERS, OR BY USE OF AN AUTOMATICALLY-CONTROLLED SUBGRADE EXCAVATING MACHINE.
- SUBGRADE CHECK: CHECK SUBGRADE ELEVATION AND GRADE BY METHOD APPROVED BY ENGINEER PRIOR TO PAVING.
- RUTS: IF RUTS OR OTHER OBJECTIONABLE IRREGULARITIES FORM IN SUBGRADE DURING CONSTRUCTION, RE-SHAPE AND RE-ROLL SUBGRADE BEFORE PLACING PAVEMENT. FILL RUTS OR OTHER DEPRESSIONS WITH MATERIAL SIMILAR TO OTHER SUBGRADE MATERIAL, AND COMPACT.

SUBGRADE MATERIALS NOTES:

- ALL SOILS REQUIRED FOR SELECT SUBGRADE MATERIALS MUST BE APPROVED BY THE SOILS ENGINEER. APPROVAL OF MATERIALS AND THEIR USE WILL BE BASED ON AASHTO M 145.
 - COHESIVE SOILS MUST MEET ALL OF THE FOLLOWING REQUIREMENTS:
 - 45% OR LESS SILT SIZE FRACTION.
 - DENSITY OF 110 PCF OR GREATER ACCORDING TO ASTM D 698 OR AASHTO T 99 (STANDARD PROCTOR DENSITY).
 - PLASTICITY INDEX GREATER THAN 10.
 - A-6 OR A-7-6 SOILS OF GLACIAL ORIGIN.
 - GRANULAR SOILS MUST MEET ALL OF THE FOLLOWING REQUIREMENTS:
 - DENSITY OF 110 PCF OR GREATER ACCORDING TO ASTM D 698 OR AASHTO T 99 (STANDARD PROCTOR DENSITY).
 - 15% OR LESS SILT AND CLAY.
 - PLASTICITY INDEX OF 3 OR LESS.
 - A-1, A-2, OR A-3 (0).
- CRUSHED STONE, CRUSHED PCC, CRUSHED COMPOSITE PAVEMENT, OR RAP, MIXTURES OF GRAVEL, SAND, AND SOIL, OR UNIFORMLY-BLENDED COMBINATIONS OF THE ABOVE, AS APPROVED BY THE SOILS ENGINEER.
- THE SOILS ENGINEER MAY AUTHORIZE A CHANGE IN SELECT SUBGRADE MATERIALS SUBJECT TO MATERIALS AVAILABLE LOCALLY AT TIME OF CONSTRUCTION.

ABBREVIATIONS:

AC	ACRES
ASPH	ASPHALT
BK	BOOK
CONC	CONCRETE
D	DEEDED DISTANCE
EX	EXISTING
ENCL	ENCLOSURE
FF	FINISHED FLOOR
FL	FLOW LINE
FRAC	FRACTIONAL
M	MEASURED DISTANCE
NH	MANHOLE
OPC	ORANGE PLASTIC CAP
P	PLATTED DISTANCE
PG	PAGE
POB	POINT OF BEGINNING
POC	POINT OF COMMENCEMENT
PRA	PREVIOUSLY RECORDED AS
PUE	PUBLIC UTILITY EASEMENT
ROW	RIGHT OF WAY
RPC	RED PLASTIC CAP
SF	SQUARE FEET
SAN	SANITARY
TYP	TYPICAL
YPC	YELLOW PLASTIC CAP
N	NORTH
S	SOUTH
E	EAST
W	WEST

I HEREBY CERTIFY THAT THESE PLANS HAVE BEEN PREPARED UNDER MY SUPERVISION AND THAT TO THE BEST OF MY KNOWLEDGE, THE SAME COMPLY WITH ALL RULES, REGULATIONS AND ORDINANCES OF THE CITY OF MADISON RELATING TO STRUCTURES AND BUILDINGS.


MY LICENSE RENEWAL DATE IS: JULY 31, 2016

JOEL E. JACKSON WI REG# E-42545 DATE 6/28/2016

PAGES OR SHEET COVERED BY THIS SEAL: C0.1, C1.1 - C5.1

LEGEND:

— SAN —	SANITARY SEWER	⊞	ELECTRIC VAULT
— ST —	STORM SEWER	⊞	POWER POLE
— W —	WATER LINE	⊞	TRANSFORMER POLE
— G —	GAS LINE	⊞	LIGHT POLE
— UE —	UNDERGROUND ELECTRIC	⊞	ELECTRIC JUNCTION BOX
— OE —	OVERHEAD ELECTRIC	⊞	ELECTRIC PANEL
— TELE —	TELEPHONE LINE	⊞	TRANSFORMER
— FIO —	FIBER OPTIC	⊞	GROUND LIGHT
— CATV —	CABLE TV	⊞	GUY WIRE
⊞	STORM MANHOLE	⊞	ELECTRIC HANDHOLE
⊞	CURB INTAKE	⊞	GAS METER
⊞	SURFACE INTAKE	⊞	GAS VALVE
⊞	FLARED END SECTION	⊞	AIR CONDITIONING UNIT
⊞	SANITARY MANHOLE	⊞	TELEPHONE RISER
⊞	CLEANOUT	⊞	TELEPHONE VAULT
⊞	FIRE HYDRANT	⊞	TELEPHONE MANHOLE
⊞	SPRINKLER	⊞	TRAFFIC SIGNAL MANHOLE
⊞	IRRIGATION CONTROL VALVE	⊞	FIBER OPTIC RISER
⊞	WATER MANHOLE	⊞	FIBER OPTIC FAULT
⊞	WELL	⊞	CABLE TV RISER
⊞	WATER VALVE	⊞	SIGN
⊞	WATER SHUT OFF	⊞	DENOTES NUMBER OF PARKING STALLS
⊞	YARD HYDRANT	⊞	PROPERTY CORNER - FOUND AS NOTED
⊞	ELECTRIC MANHOLE	⊞	PROPERTY CORNER - PLACED 3/4" IRON PIPE WITH YELLOW PLASTIC CAP ID #14775
⊞	ELECTRIC METER	⊞	SECTION CORNER - FOUND AS NOTED
⊞	ELECTRIC RISER	⊞	PROPERTY ADDRESS

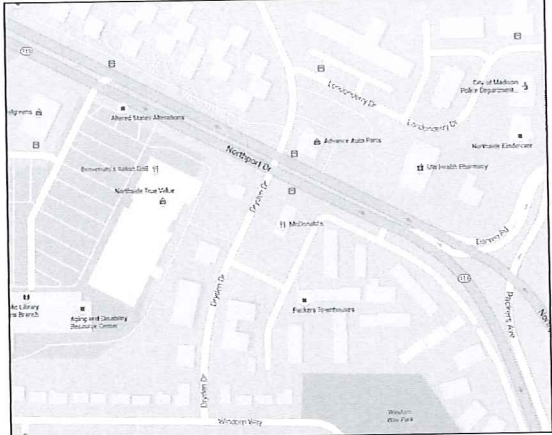

VICINITY MAP
SCALE: 1" = 300'



Bishop Engineering
"Planning Your Successful Development"
3301 104th Street
Des Moines, Iowa 50323-5807
Phone: (515) 281-0000 Fax: (515) 281-0007
Civil Engineering & Land Surveying Established 1959

M. McDonald's USA, LLC
These drawings and specifications are the confidential and proprietary property of McDonald's USA, LLC. The contract documents were prepared for use on this specific site in conjunction with its issue date and are not to be used for any other project without the express written consent of McDonald's USA, LLC. The reproduction of these drawings and specifications for any other project without the express written consent of McDonald's USA, LLC is prohibited.

TITLE: MADISON, WI
SITE PLAN
DESCRIPTION: COVER SHEET

SHEET NO. C0.1
REV: 1
DATE: 6/27/16
REV: 1
DATE: 6/27/16
DESCRIPTION: 1ST CITY SUBMITTAL

JOEL E. JACKSON
E-42545
URBAN DALE, IA
PROFESSIONAL ENGINEER



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PLAT OF SURVEY

DESCRIPTION: Lot Thirteen (13), Block Six (6), 1ST ADDITION TO BRUNS, in the City of Madison, County of Dane, State of Wisconsin

LEGEND

- 3/4" X 18" REBAR SET WEIGHING 1.50 LB/FT.
- ROUND IRON STAKE FOUND.
- 1-1/4" PIPE UNLESS OTHERWISE NOTED
- PREVIOUSLY RECORDED DIMENSION
- BOUNDARY OF PROPERTY SURVEYED
- OTHER LOT OR RIGHT-OF-WAY LINES
- EASEMENT LINES
- BUILDING SETBACK LINES
- STEEL FENCE
- WOODEN SPLIT RAIL FENCE
- SANITARY SEWER WITH MANHOLE
- WATER MAIN OR SERVICE WITH MANHOLE
- WATER VALVE
- FIRE HYDRANT
- STORM SEWER WITH MANHOLE
- STORM INLET IN CURB, CASTING DRAWN TO SCALE
- UNDERGROUND TELECOMMUNICATION LINE
- UNDERGROUND ELECTRIC LINE
- UNDERGROUND GAS LINE WITH VALVE
- TELEPHONE PEDESTAL
- ELECTRIC BOX, TO SCALE ±
- OVERHEAD UTILITY
- UTILITY POLE WITH GUY ANCHOR
- UTILITY POLE WITH STREET LIGHT
- LIGHT POLE
- TRAFFIC SIGNAL
- TRAFFIC SIGNAL WITH STREET LIGHT
- RECTANGULAR ELECTRIC MANHOLE
- PULL BOX
- BOLLARD
- FLAG POLE
- SIGN, DESCRIBED ON MAP
- WOODEN PLANTER - TO SCALE
- WASTE RECEPTACLE
- NEWSPAPER BOX
- LANDSCAPE BOULDER
- PERENNIAL PLANT
- DECIDUOUS SHRUB, DRAWN TO SCALE ±
- EVERGREEN SHRUB, DRAWN TO SCALE ±
- EVERGREEN TREE, TRUNK DIA. SHOWN, CANOPY NOT DRAWN TO SCALE
- DECIDUOUS TREE, TRUNK DIA. SHOWN, CANOPY NOT DRAWN TO SCALE
- UTILITY LOCATION IS APPROXIMATE, DRAWN USING PLANS OR RECORDS
- BRICK SURFACE
- CONCRETE SURFACE
- ASPHALT SURFACE
- GRAVEL SURFACE
- DARK MULCH SURFACE
- LAWN SURFACE
- STONE WALKWAY SURFACE
- 6" CONCRETE CURB
- 9" CONCRETE CURB
- 18" CONCRETE CURB & GUTTER
- 24" CONCRETE CURB & GUTTER WITH 12" HEAD
- 30" CONCRETE CURB & GUTTER
- CONCRETE JOINT
- MASONRY RETAINING WALL
- BOULDER RETAINING WALL

SCALE: 1"=20'

CURVE TABLE				
CURVE NO.	RADIUS	CENTRAL ANGLE	ARC LENGTH	CHORD BEARING
C1	15.00'	90°00'00"	23.56'	N 70°12'30" E 21.21'
C2	863.93'	0°41'35"	45.31'	N 23°52'01" E 45.30'

SURVEYOR'S CERTIFICATE:
I, Ross A. Michaels, Wisconsin Registered Land Surveyor No. S-1696, hereby certify that on November 29, 2012, I surveyed the property described hereon and the physical features and elevations shown hereon; and that on May 6, 2016, I re-surveyed the boundary of the property described hereon, inspected the property for visible above ground changes to improvements made since November 29, 2012, and surveyed and mapped the locations of any such visible above ground changes to improvements; and that the survey is correct to the best of my knowledge and belief.

Ross A. Michaels
Ross A. Michaels, Registered Land Surveyor, S-1696
Original date of map: January 22, 2013
Map revised: May 9, 2016

NOTES:

- The official Zoning Map of the City of Madison indicates the subject parcel is within the Commercial Corridor - Transition District (CC-T) zoning district. The Madison zoning ordinance was recently rewritten and became effective on January 2, 2013. Please consult City of Madison Zoning officials at 608-266-4551 and the City of Madison web site (www.cityofmadison.com) for the ordinance and questions. Editing of the written ordinance is still ongoing. Some building setback requirements are variable within this district. According to the ordinance the following setbacks apply in the CC-T district:
 - The front yard setback is a maximum distance (not a minimum) and is variable depending on several variables. The northeast line of the lot (Northport Drive right-of-way) is considered the front line. Consult the City of Madison Zoning Department.
 - The side yard setback along Dryden Drive is zero.
 - The side yard setback along the southeast line of the lot is 10 feet based on the fact that the adjoining lot is zoned and used for multifamily residential purposes.
 - The rear yard setback along the southwest side of the lot is 20 feet, based on the rule that it is the lesser of 20% of lot depth (60.52 feet) or 20 feet.
 - The maximum lot coverage is 85% and includes buildings and some paved areas.
- Elevations on this survey are referenced to the North American Vertical Datum of 1988 based on a benchmark elevation of 857.02 on the brass cap monument at the East 1/4 corner of Section 36, T8N, R9E as provided by the City of Madison. Additional benchmarks were established as shown hereon.
- Underground utilities locations were mapped hereon as part of a survey completed November 29, 2012 based on the following: surveyed locations of markings made by others; observed evidence of above ground features or features observed in structures such as manholes or inlets; and utility records provided by others. The locations of underground utilities may be approximate. There may be more underground utilities, some of which may have been installed since the November 29, 2012 survey (see note along Dryden Drive). Call Diggers Hotline (800-242-8511) for a markup of utilities before digging.
- The inverts of some storm sewer features are approximate since it is not possible to measure vertically from the structure opening down to the invert.
- Buried telecommunication lines may be fiber optic.
- There may be multiple underground electric lines within the same trench where shown as a single underground electric line on this map.
- A title report has not been provided by the client for this survey. As a result, there may be more recorded easements affecting the property than are shown hereon.
- There is no vehicular access allowed from the subject property to or from Northport Drive, including along the curve labeled "C1".



McDonald's USA, LLC

MADISON - DRYDEN DR



C0.2


BE# 20337

- (A) PROTECT EXISTING BEAM CURB IN PLACE. MATCH AND BLEND NEW PAVING INTO EXISTING WHERE OCCURS.
- (B) INSTALL NEW MENU BOARD. SEE SHEET C2.3 FOR FOUNDATION DETAIL, SHEET C2.5 FOR SCHEMATIC DETAIL AND SEE MANUFACTURER FOR INSTALLATION INSTRUCTIONS.
- (C) PRIMARY LAINE HIGH IMPACT COD AND CANOPY. LOCATE 80% FROM $\frac{1}{2}$ OF COD TO $\frac{1}{4}$ OF CASH WINDOW MEASURED ALONG $\frac{1}{2}$ OF TRAVEL PATH. SEE SHEET C2.3 FOR FOUNDATION DETAIL, SHEET C2.5 FOR SCHEMATIC DETAIL AND MANUFACTURER FOR INSTALLATION INSTRUCTIONS.
- (D) SECONDARY LAINE HIGH IMPACT COD AND CANOPY. LOCATE 14'-0" FROM NOSE OF CONCRETE ISLAND. SEE SHEET C2.3 FOR FOUNDATION DETAIL, SHEET C2.5 FOR SCHEMATIC DETAIL AND MANUFACTURER FOR INSTALLATION INSTRUCTIONS.
- (E) INSTALL PRIMARY LAINE DETECTOR LOOP. SEE DETAIL SHEET C2.4.
- (F) INSTALL SECONDARY LAINE DETECTOR LOOP 2'-0" FORWARD OF $\frac{1}{2}$ OF COD. FLIP LOOP FORWARD. SEE DETAIL SHEET C2.4.
- (G) EXISTING DOUBLE ARM GATEWAY SIGN. PROTECT IN PLACE.
- (H) LANDSCAPED AREA.
- (I) ANY LAINE ANY TIME SIGN. ATTACH SIGN TO GATEWAY 8' FROM BOTTOM OF POST. SEE SHEET C2.5 FOR SCHEMATIC DETAIL AND MANUFACTURER FOR INSTALLATION INSTRUCTIONS.
- (J) INSTALL DETECTOR LOOPS AT CASH AND PRESENT WINDOWS. SEE DETAIL 1 SHEET C2.4.
- (K) INSTALL BOLLARD AT THE CORNER OF THE BUILDING. BOLLARD SHALL BE FLUSH AGAINST THE BUILDING AND THE FACE OF THE BOLLARD SHALL BE TIGHT AGAINST THE BACK OF CURB. SEE DETAIL 4 ON SHEET C2.5.
- (L) INSTALL PULL FORWARD SIGN & BOLLARD. SEE DETAIL 3 SHEET C2.5
- (M) INSTALL COVER ON EXISTING BOLLARD TO MATCH BUILDING BASE. FOR COVER CONTACT: PUGLESEA COMPANY
ATTN: BRAD ERICKSON
1253 CONNELLY AVE
ARDEN HILLS, MN 55112
PH: (651) 636-8442

1. **SIGNAGE & DRIVE-THRU ELEMENTS:**
- COD. DRIVE-THRU PYLON/CLEARANCE POLE, BOLLARD SIGN, AND FREESTANDING MERCHANTZON SHALL BE CONSISTENT WITH THE 2013 STANDARD BUILDING DESIGN DRIVE-THRU ELEMENTS. **OTHER DESIGNS MAY NOT BE USED.**
2. **GENERAL CONTRACTOR SHALL COORDINATE WITH CIVIL PLANS, MCDONALD'S PROJECT MANAGER AND SIGNAGE CONTRACTOR TO DETERMINE THE EXACT LOCATION, ORIENTATION, MOUNTING HEIGHTS, AND NUMBER OF SIGNS AND OTHER DRIVE-THRU ELEMENTS TO BE INSTALLED AT THIS SITE. ALL WORK SHALL BE COORDINATED WITH OTHER TRADES.**
3. **CONTACT MCDONALD'S PROJECT MANAGER FOR SIGNAGE & DRIVE-THRU ELEMENT FOOTING AND WIRING REQUIREMENTS. SIGNAGE MANUFACTURER TO PROVIDE FOOTING ANCHORS & TEMPLATES TO G.C. PRIOR TO FOUNDATION POURING.**
4. **SEE SHEET C25 AND ELECTRICAL SHEETS FOR DRIVE-THRU WIRING INFORMATION.**
5. **GENERAL CONTRACTOR TO ASSURE THE RESPONSIBILITIES OF THE ELECTRICAL CONTRACTOR AND THE SIGN SUPPLIER.**
6. **GENERAL CONTRACTOR TO INSTALL PRE-FORMED, PRE-WIRED VEHICLE DETECTOR LOOP.**
7. **GENERAL CONTRACTOR SHALL VERIFY CONDUIT SIZES REQUIRED BY VEHICLE LOOP DETECTOR SUPPLIER.**

1. ALL DIMENSIONS ARE TO BACK OF CURB UNLESS NOTED OTHERWISE ON PLAN.
2. FIELD VERIFY AND CONFIRM EXISTING CONDITIONS AND DIMENSIONS PRIOR TO COMMENCING CONSTRUCTION. NOTIFY MCDONALD'S PROJECT MANAGER OF ANY DISCREPANCIES PRIOR TO COMMENCING CONSTRUCTION.
3. SEE SHEET C2.1 FOR ALL SITE DIMENSIONS.
4. SEE SHEET C2.6 FOR STRIPING.

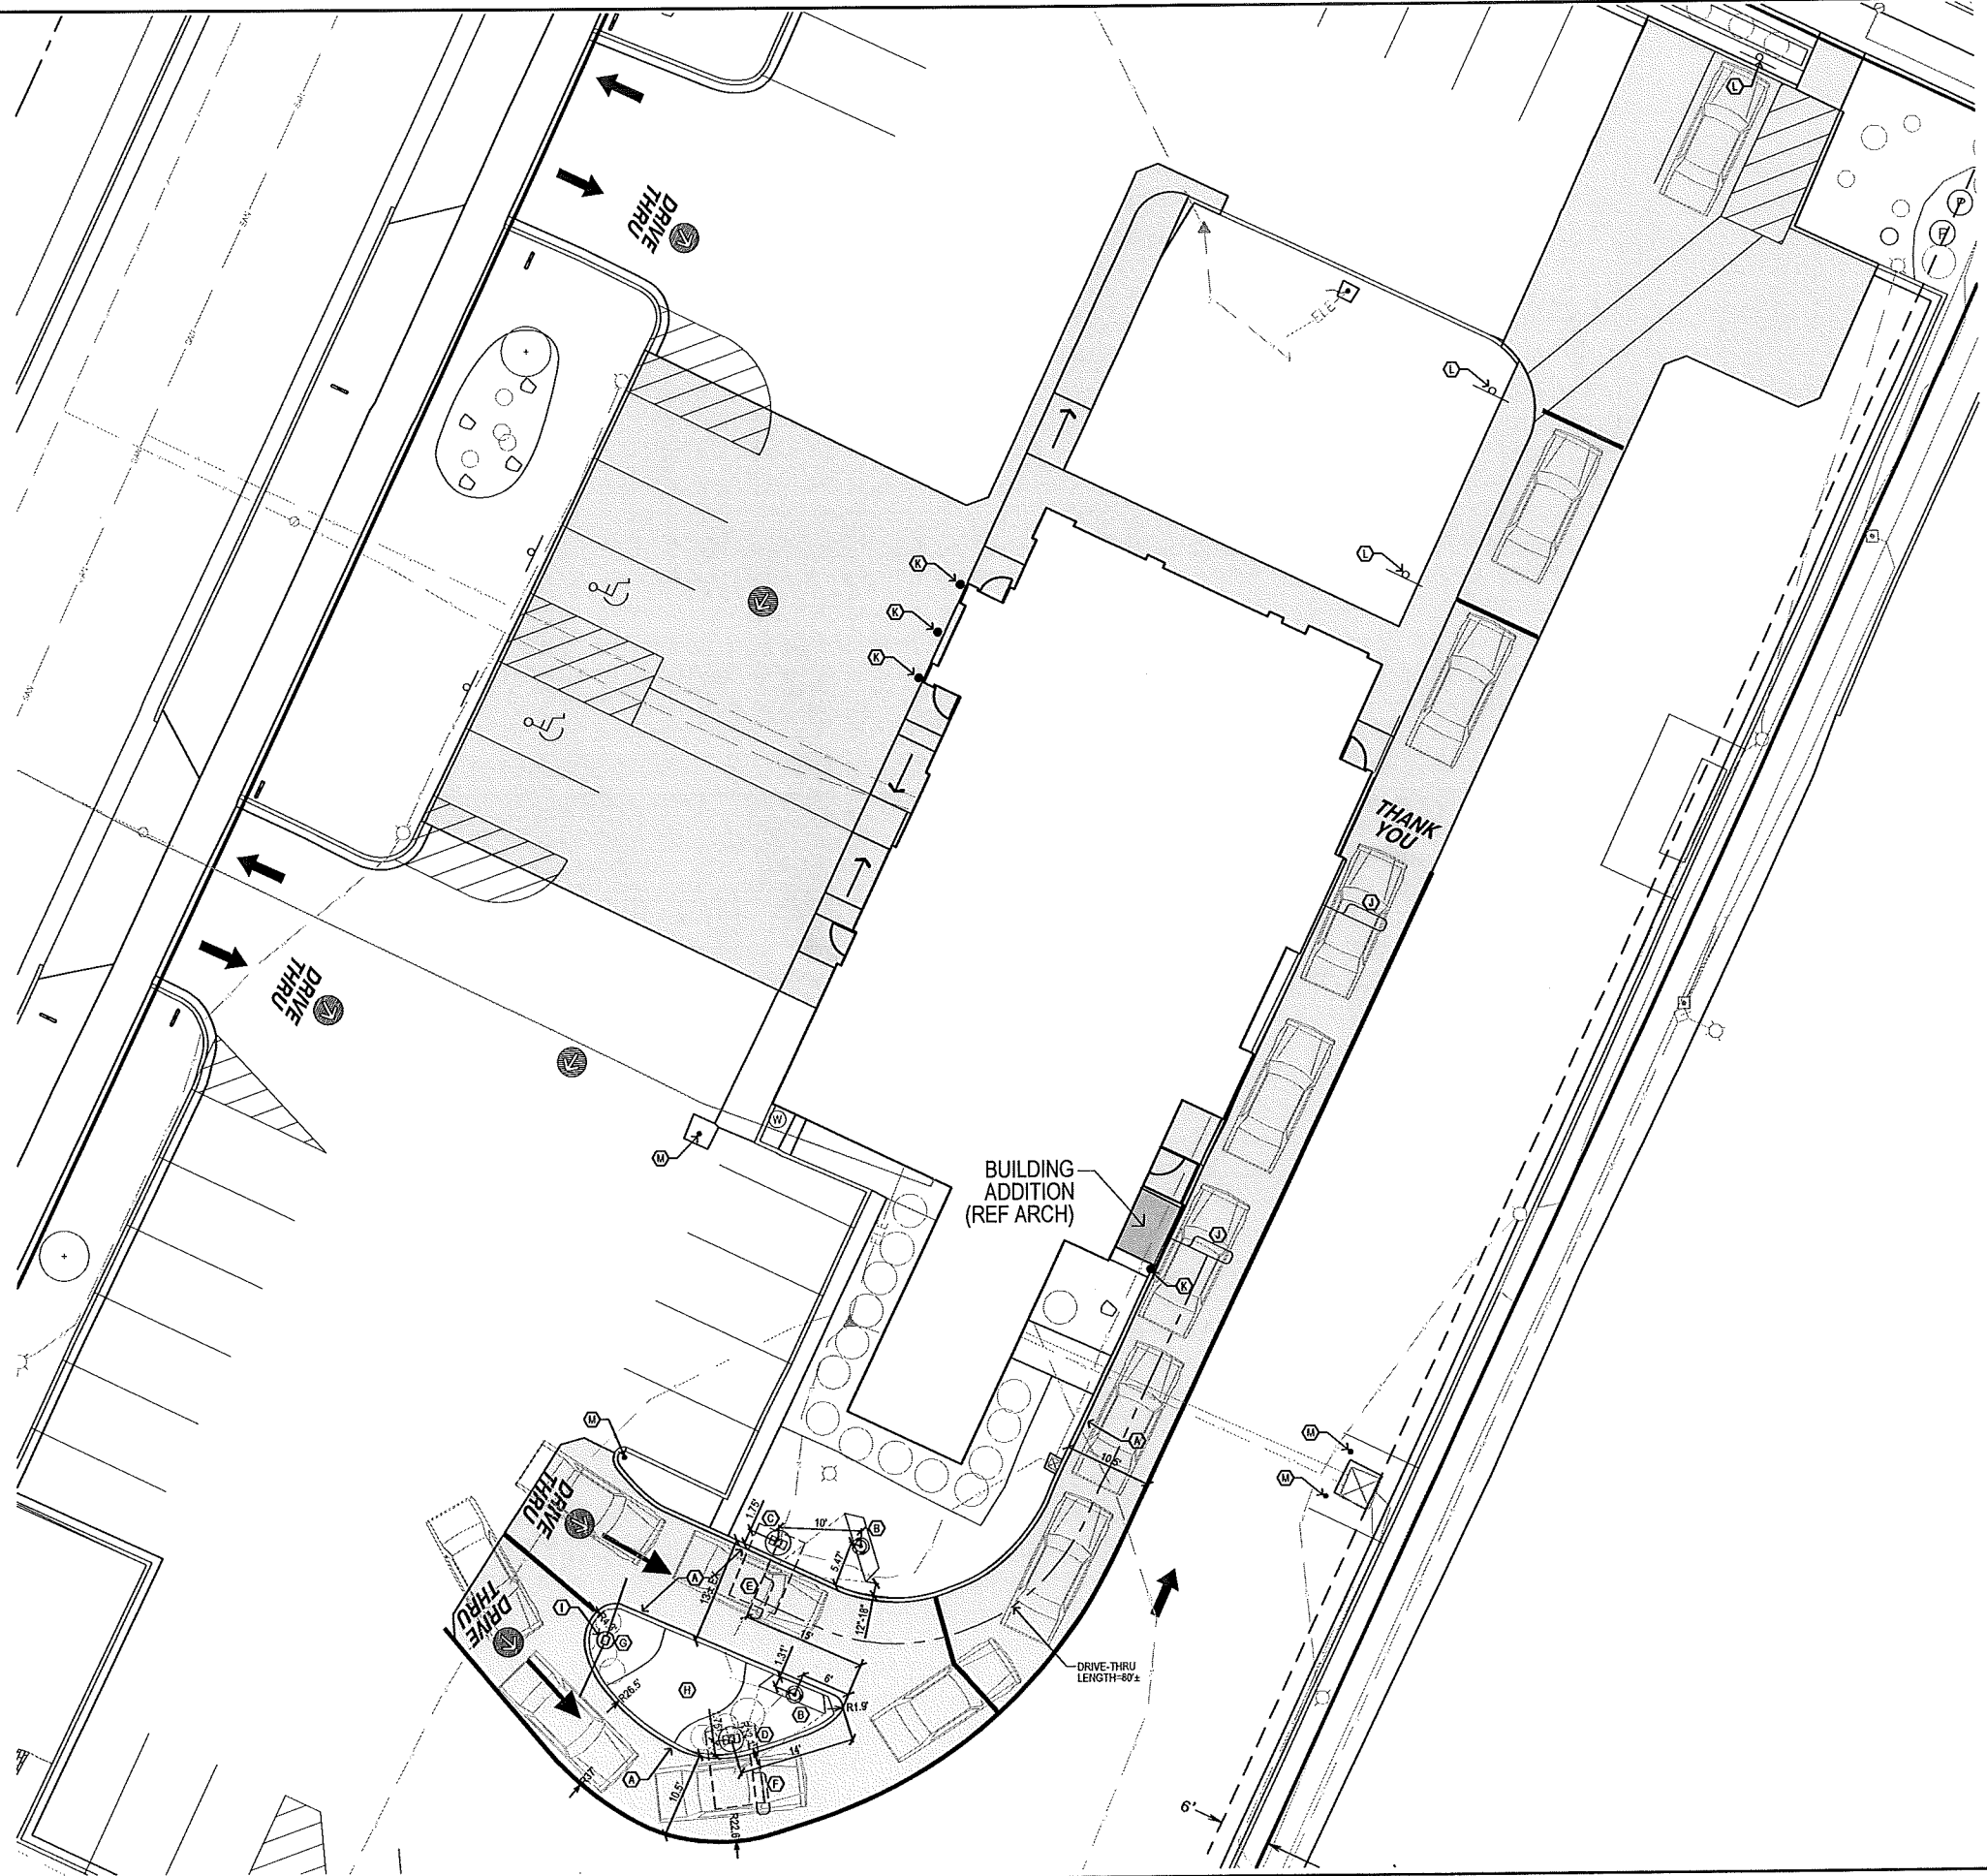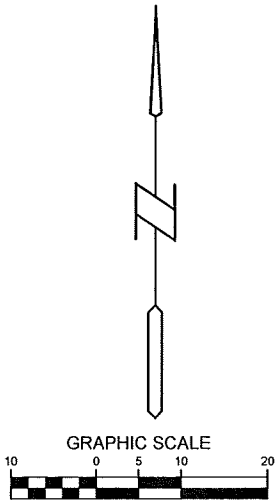[illegible]

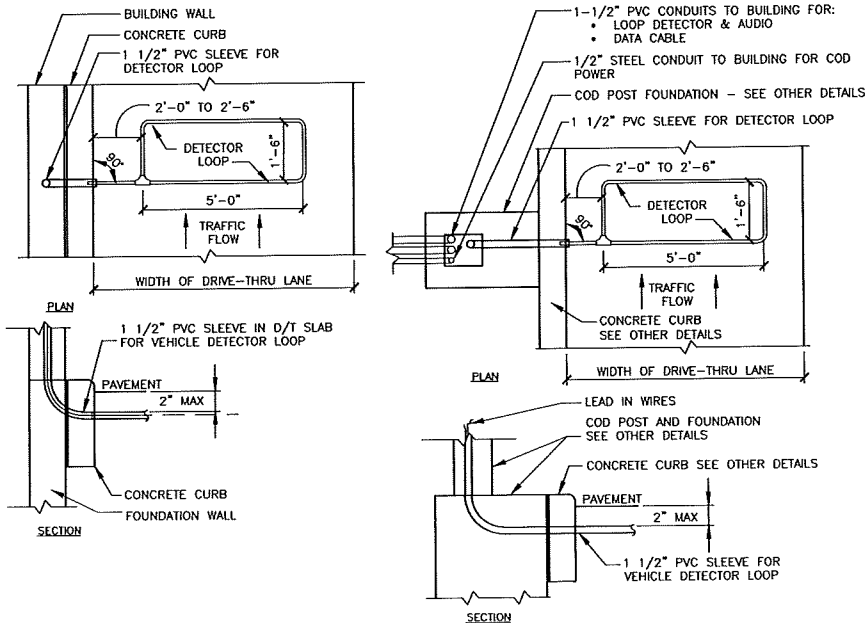

B - DT WINDOW DETECTOR LOOP

A - C.O.D. DETECTOR LOOP

- NOTES**
1. VERIFY CONDUIT SIZES AND LAYOUT WITH DETECTOR LOOP MANUFACTURER.
 2. CENTER VEHICLE DETECTOR LOOP (ITEM # 217.11E1) IN DRIVE THRU LANE. INSTALL PER MFR. RECOMMENDATIONS.
 3. SEE CIVIL FOR DIMENSIONS OF DRIVE-THRU LANE CONCRETE PAD FOR DETECTOR LOOP.
 4. NO STEEL (REBAR OR ELECTRICAL WIRE) SHALL BE USED WITHIN 2' OF LOOP.
 5. **DETECTOR LOOP MANUFACTURERS:**
DETECTOR LOOPS MAY BE BY ONE OF THE FOLLOWINGS COMPANIES OR EQUAL.
3M: 1-800-328-0033
HME: 1-800-848-4468
 6. **DETECTOR LOOP MATERIAL:**
FOR ANY AND ALL DETECTOR LOOPS THAT WILL BE PLACED IN EXISTING PAVEMENT, CONTRACTOR SHALL SAWCUT & PLACE LOOP DETECTOR INTO EXISTING SLAB. UPON PLACEMENT OF LOOP DETECTOR, FILL SAWCUT WITH GRAY MASTIC JOINT SEALER.
 7. **DETECTOR LOOP CONSTRUCTION:**
FORMED WITH ONE CONTINUOUS LENGTH OF PVC WITH NO SHARP CORNERS AS DETAILED. WIRE LOOPED, FORMED, & PIGTAILED AS DETAILED.

DETECTOR LOOP IN EXISTING PAVEMENT:
FOR ANY AND ALL DETECTOR LOOPS THAT WILL BE PLACED IN EXISTING PAVEMENT, CONTRACTOR SHALL SAWCUT & PLACE LOOP DETECTOR INTO EXISTING SLAB. UPON PLACEMENT OF LOOP DETECTOR, FILL SAWCUT WITH GRAY MASTIC JOINT SEALER.

1 DETECTOR LOOP DETAILS
C2.4 NOT TO SCALE


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Des Moines, Iowa 50323-3825
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MADISON, WI
SITE PLAN
DRIVE-THRU DETAILS

C2.4
BE # 120337


REV	DATE	DESCRIPTION
1	6/9/16	INITIAL CITY REVIEW
2	6/28/16	PERMIT SET



1 COD SCHEMATIC DETAIL
C2.5 NOT TO SCALE

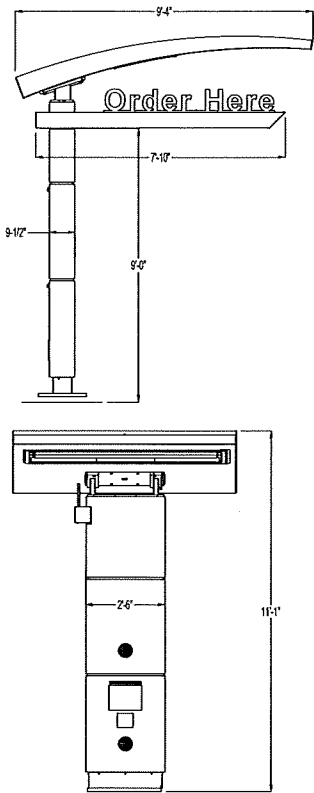
NOTE: THIS DRAWING IS SHOWN FOR SCHEMATIC PURPOSES ONLY. SEE MANUFACTURER FOR INSTALLATION INSTRUCTIONS

CONTRACTOR SHALL INSTALL ADDITIONAL ADA SIGNAGE (SUCH AS FINE AMOUNT) AS REQUIRED PER LOCAL ORDINANCE

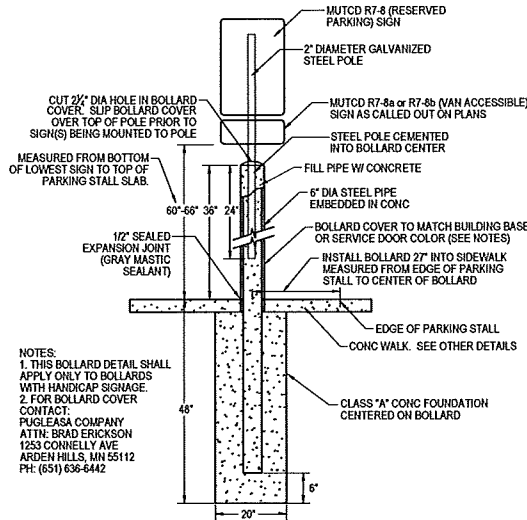


2 HANDICAP PARKING SIGN & BOLLARD DETAIL
C2.5 NOT TO SCALE

NOTES:
1. THIS BOLLARD DETAIL SHALL APPLY ONLY TO BOLLARDS WITH PULL FORWARD SIGNAGE.
2. FOR BOLLARD COVER CONTACT: PUGLEASA COMPANY, ATTN: BRAD ERICKSON, 1253 CONNELLY AVE, ARDEN HILLS, MN 55112, PH: (651) 636-6442

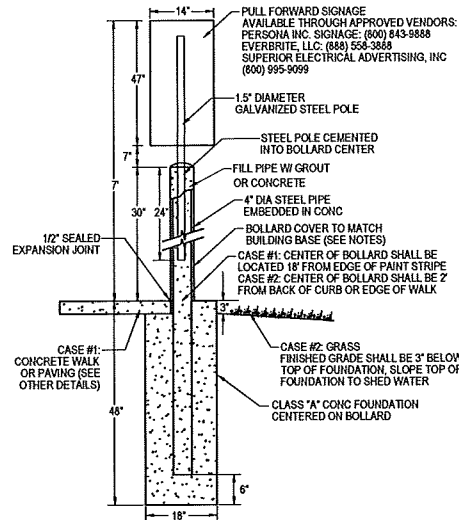

3 PULL FORWARD SIGN & BOLLARD DETAIL
C2.5 NOT TO SCALE

NOTES:
1. THIS BOLLARD DETAIL SHALL APPLY TO BOLLARD AT REAR CORNER OF BUILDING ADJACENT TO DRIVE-THRU AND EXTERIOR TRASH ENCLOSURE BOLLARDS.
2. FOR BOLLARD COVER CONTACT: PUGLEASA COMPANY, ATTN: BRAD ERICKSON, 1253 CONNELLY AVE, ARDEN HILLS, MN 55112, PH: (651) 636-6442

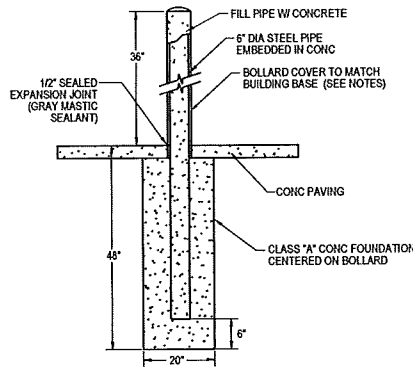


4 BOLLARD DETAIL
C2.5 NOT TO SCALE

KEY NOTES:

- (A) 2#12 & #12 GND, 3/4" CONDUIT TO LP-1 FOR COD CANOPY LIGHTING
- (B) 4#12 & #12 GND, 3/4" CONDUIT TO LP-1 FOR PRIMARY OPO MENUBOARD LIGHTING AND PLC
- (C) 2#12 & #12 GND & #12 ISOLATED GND, 3/4" CONDUIT TO CP FOR ISOLATED GROUND POWER TO COD'S. EACH COD SHALL BE ON ITS OWN DEDICATED CIRCUIT.
- (D) 2#12 & #12 GND, 3/4" CONDUIT TO LP-1 FOR SECONDARY OPO MENUBOARD AND PRESELL BOARD LIGHTING.
- (E) (1) 1-1/2" CONDUIT ONE FOR COD CABLING ONE FOR LOOP DETECTOR
- (F) 1" CONDUIT - FOR LOW VOLTAGE/ OPO CONTROLLER
- (G) 1-1/2" CONDUIT - FOR LOW VOLTAGE/ OPO CONTROLLER


GENERAL NOTES:

- 1. VERIFY EXACT CIRCUITS AND QUANTITIES OF CIRCUITS WITH PANEL SCHEDULES ON DRAWING EA2 AND MANUFACTURER'S INSTALLATION INSTRUCTIONS
- 2. PER MANUFACTURER'S INSTALLATION INSTRUCTIONS SEPARATE DEDICATED NEUTRALS ARE REQUIRED TO MENUBOARD AND PRESELL BOARD FOR EACH CIRCUIT (PLC AND LIGHTING)
- 3. IF ANY BENDS ARE REQUIRED, SWEEPS MUST BE PROVIDED IN CONDUITS.

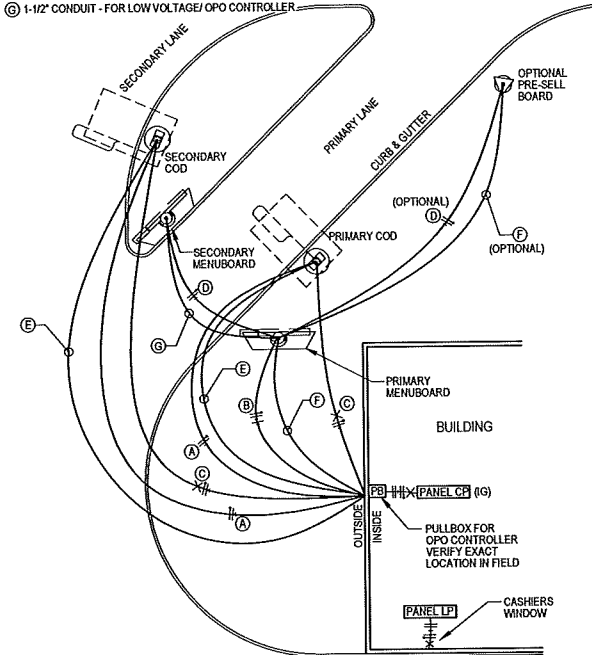


5 DRIVE-THRU WIRING DETAIL
C2.5 NOT TO SCALE

SKETCH CREATED FROM ELECTRICAL OPO UPDATE (E-OPO) DATED SEPT. 2012. MODIFIED PER REGIONAL INPUT AUG. 2014.

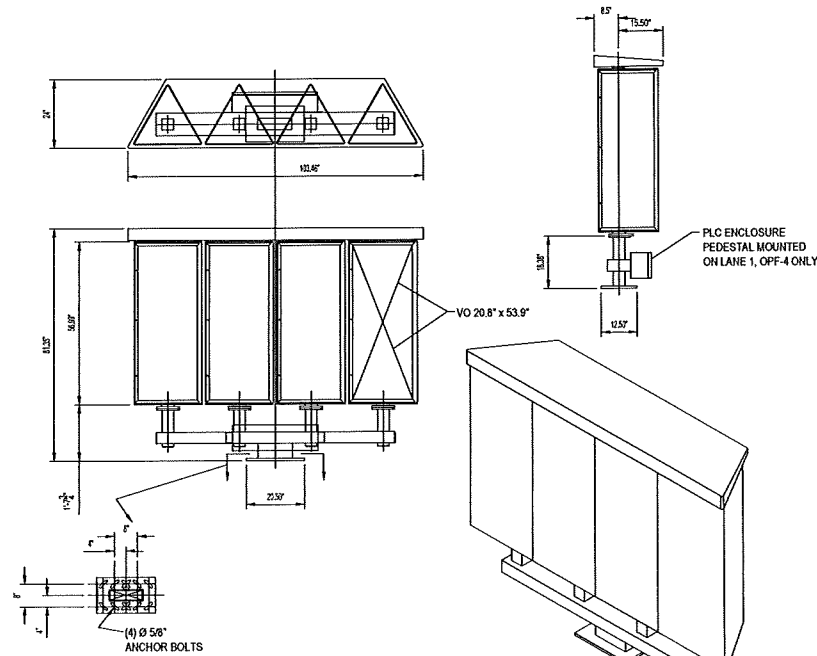

7 OPO-4 MENU BOARD SCHEMATIC DETAIL
C2.5 NOT TO SCALE

NOTE: THIS DRAWING IS SHOWN FOR SCHEMATIC PURPOSES ONLY. SEE MANUFACTURER FOR INSTALLATION INSTRUCTIONS

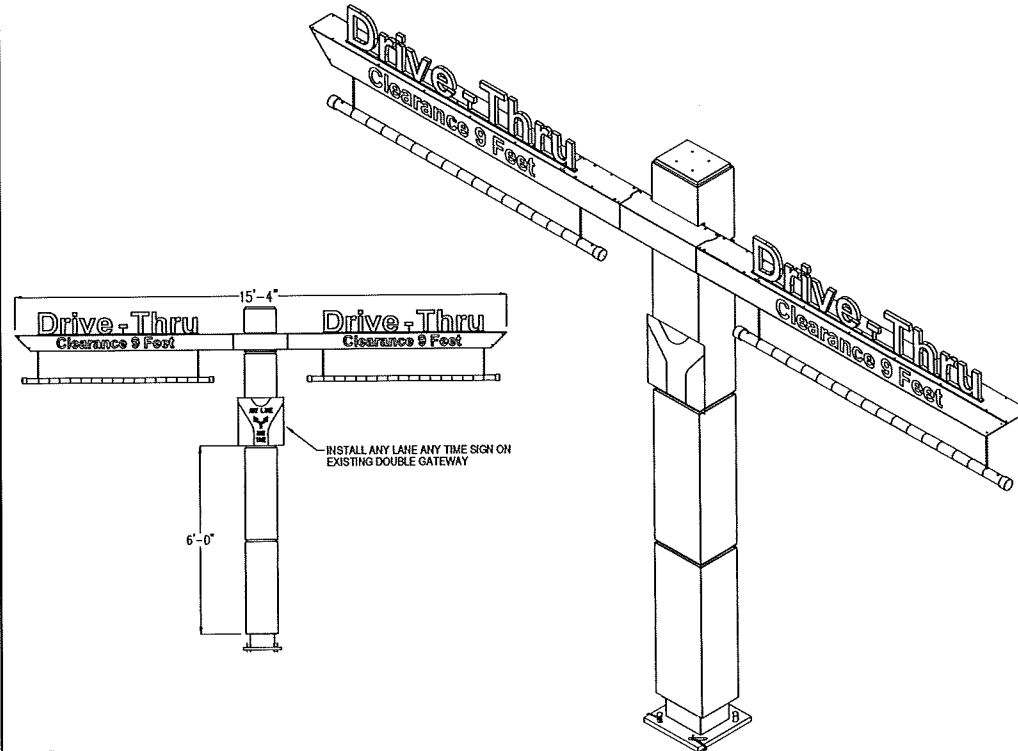

8 DOUBLE GATEWAY SCHEMATIC DETAIL
C2.5 NOT TO SCALE

NOTE: THIS DRAWING IS SHOWN FOR SCHEMATIC PURPOSES ONLY. SEE MANUFACTURER FOR INSTALLATION INSTRUCTIONS

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PREPARED FOR:
M. McDonald's USA, LLC

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DRAWN BY:
JMR

STD ISSUE DATE:
6/28/16

REVIEWED BY:
JEL

DATE SUBMITTED:
6/28/16

TITLE:
MADISON, WI
SITE PLAN

DESCRIPTION:
DRIVE-THRU DETAILS

SHEET NO:
C2.5

480101


1. STRIP AND STOCKPILE THE TOP 6" OF SOIL ON ALL DISTURBED AREAS.

2. RESPREAD TOPSOIL TO A MINIMUM DEPTH OF 6" ON ALL GREEN (NON-PURVED) AREAS. TOPSOIL SHALL BE NECESSARY TO ACHIEVE A MINIMUM DEPTH OF 6". TOPSOIL SHALL BE OF THE SAME OR BETTER QUALITY THAN THE ORIGINAL 6" OF SOIL. TOPSOIL IS DEFINED AS: FERTILE, FRIABLE, LOAM, CAPABLE OF SUSTAINING VIGOROUS PLANT GROWTH, FROM WELL DRAINED SITE FREE FROM FLOODING, NOT IN FROZEN OR MUDDY CONDITIONS, REASONABLE FREE FROM SUBSOIL, CLAY LUMPS, ROOTS, GRASS, WEEDS, STONES, LARGER THAN 3/4 INCH IN DIAMETER, AND FOREIGN MATTER. ACIDITY RANGE (PH) OF 5.5 TO 7.5, CONTAINING MINIMUM 4% NITROGEN AND MAXIMUM 1% SODIUM ON ORGANIC MATTER BASIS.

3. CONTRACTOR SHALL BE RESPONSIBLE FOR ENSURING ALL TOPSOIL REQUIREMENTS OF NPDES GENERAL PERMIT NO. 2 ARE MET.

EXISTING CONTOUR	---	150	---
PROPOSED CONTOUR	---	<u>150</u>	---
FINISHED GROUND ELEVATION	●	150.50	
TOP OF CURB ELEVATION	●	150.50TC	
GUTTER ELEVATION	●	150.50G	
TOP OF WALL ELEVATION	●	150.50TW	
BOTTOM OF WALL ELEVATION	●	150.50BW	
EDGE OF WALK ELEVATION	●	150.50EW	
TOP OF STAIR ELEVATION	●	150.50TS	
BOTTOM OF STAIR ELEVATION	●	150.50BS	

GRAPHIC SCALE

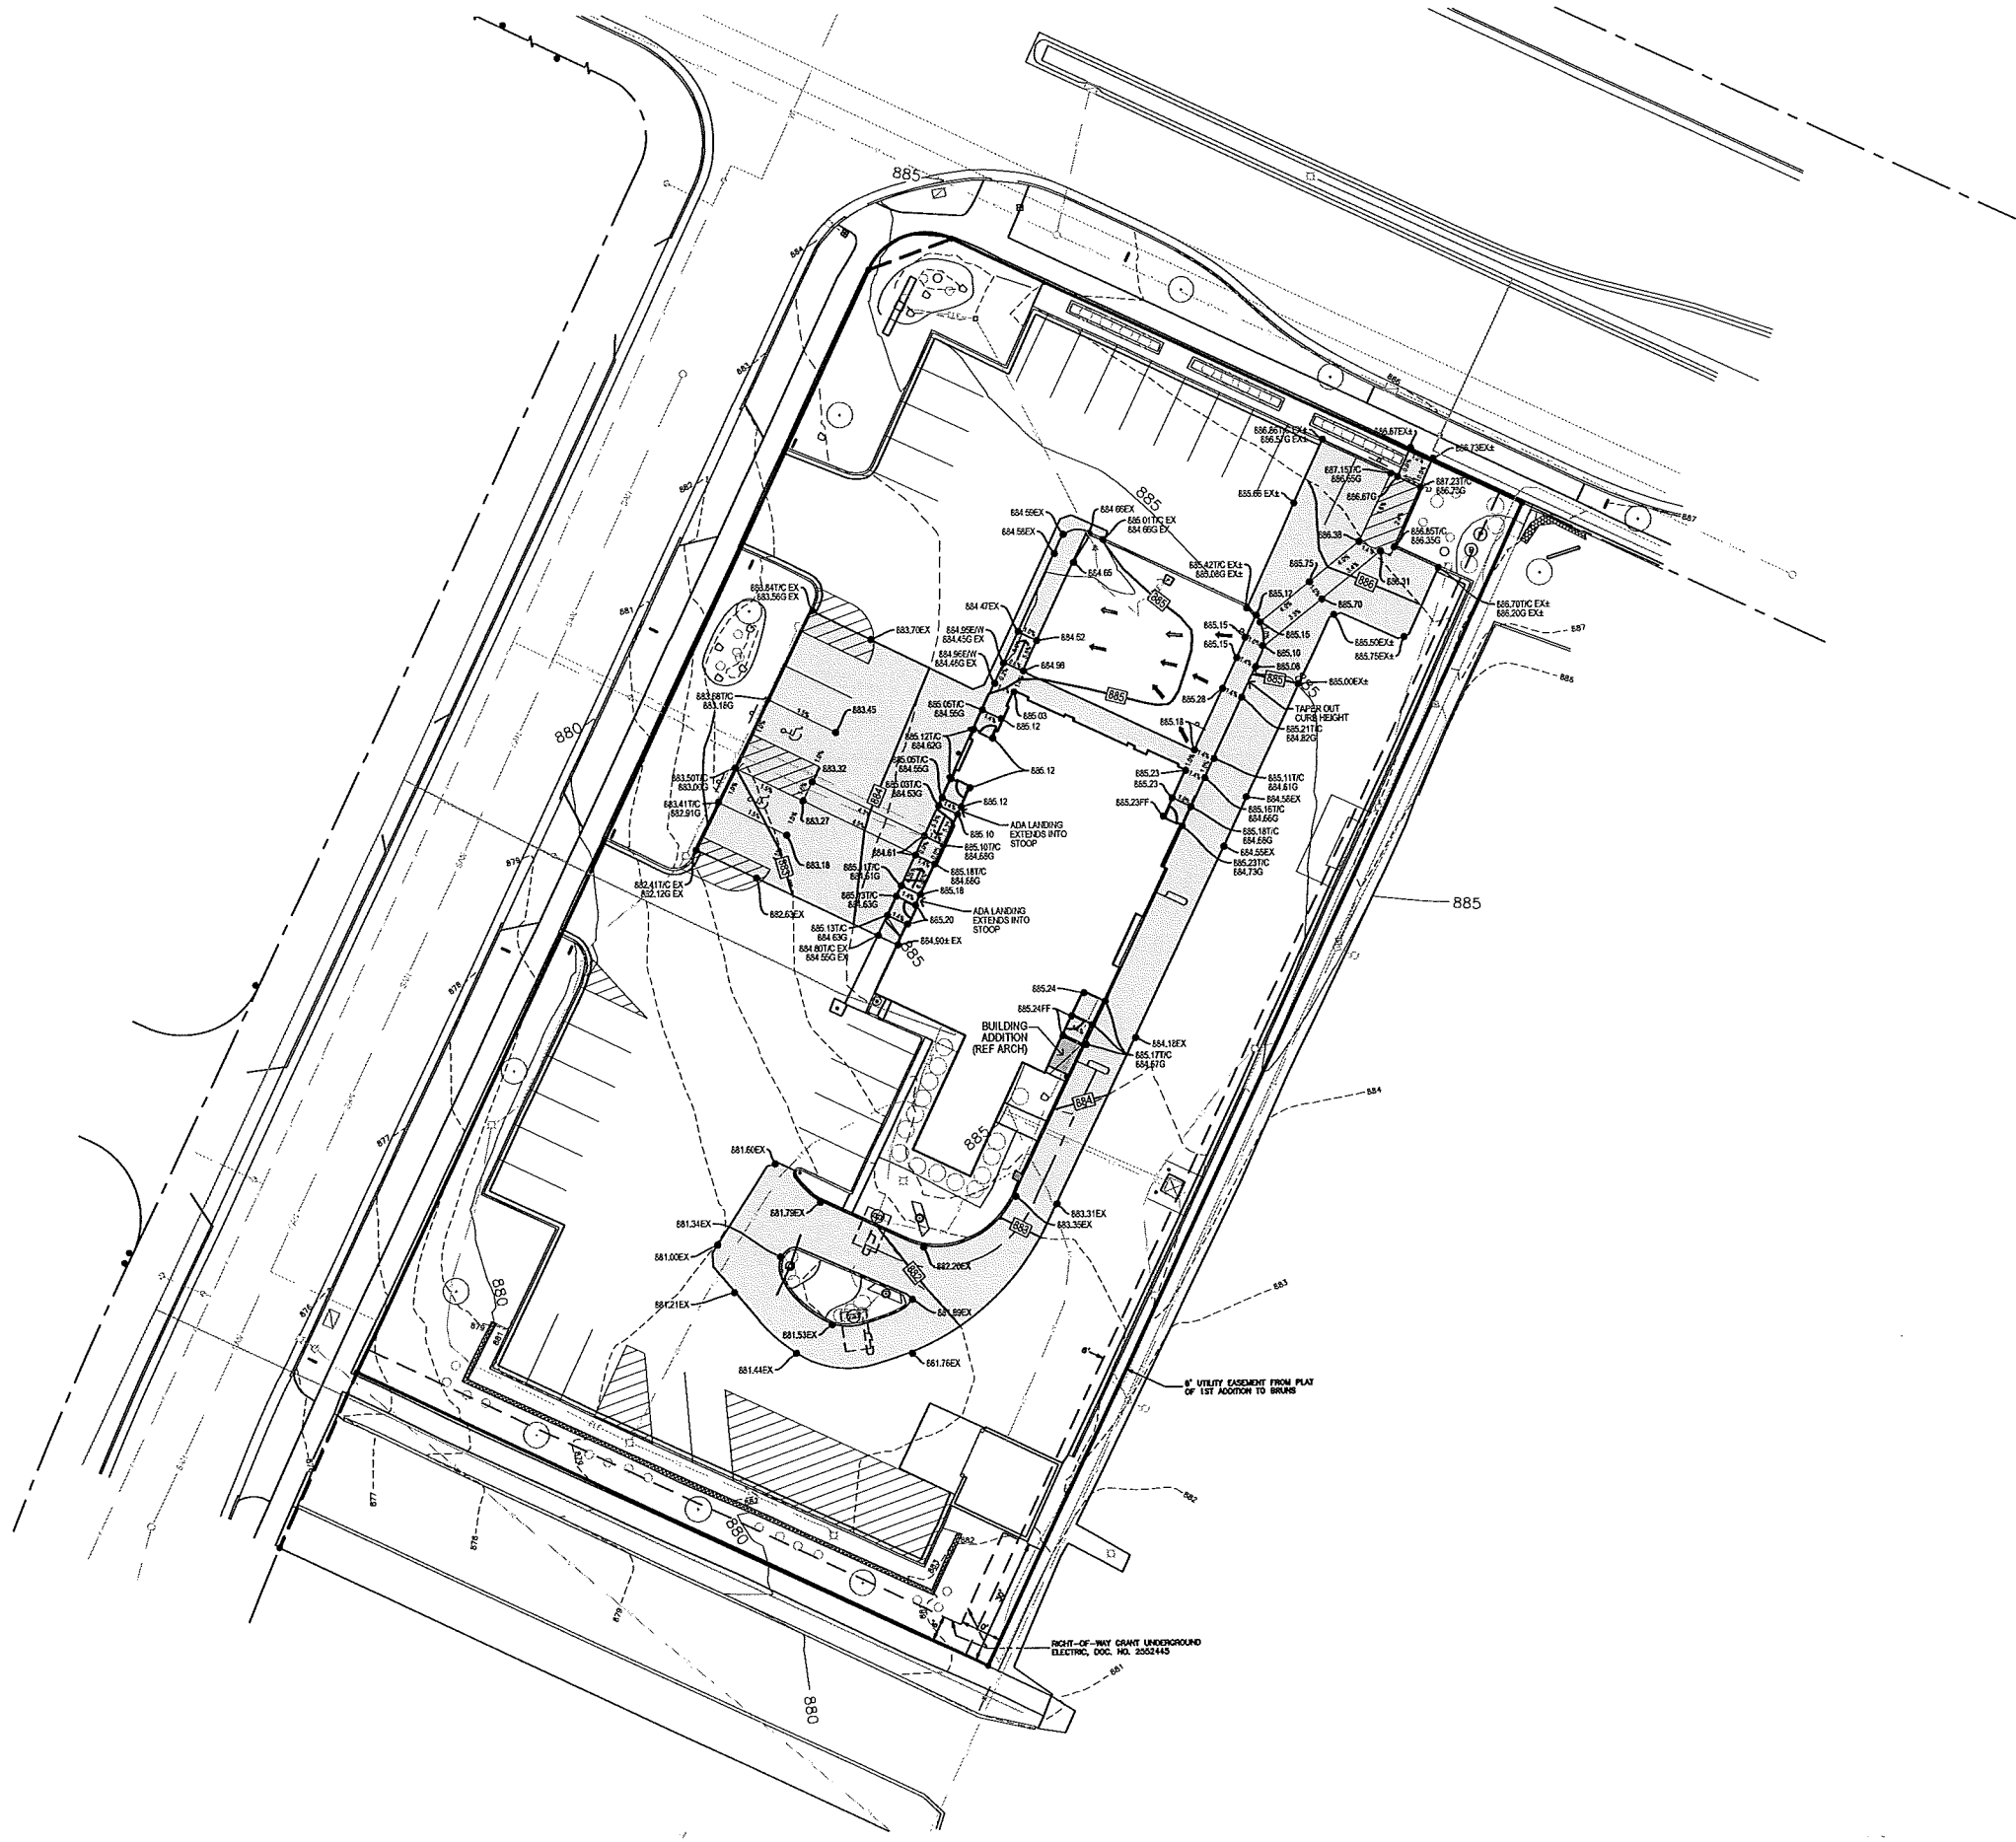

5/5/2016 1:40:13 PM M:\LAND PROJECTS 2012\120337 MADISON, WI - DRYDEN\DWG\C3 GRADING.DWG

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SITE PLAN	DESCRIPTION
GRADING PLAN	

EE# 120337

DATE	DESCRIPTION	JMNR BY
2	PERMIT SET	JMNR
1	INITIAL CITY REVIEW	JMNR
1		BY

SHEET NO.	C3.1	REF TO 120337
TITLE:	MADISON, WI SITE PLAN SUBSCRIPTION	GRADING PLAN
DESIGNED BY	JMR	DATE DESIGNED 6/28/16
CHECKED BY	JMR	DATE CHECKED 6/28/16
DATE	6/28/16	
DATE	6/28/16	

DESIGNED BY
JMR

CHECKED BY
JMR

DATE
6/28/16

DATE
6/28/16

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3501

LANDSCAPE NOTES:

1. ALL SODDING & LANDSCAPE PLANTINGS SHALL BE INSTALLED IN ACCORDANCE WITH THE URBAN STANDARD SPECIFICATIONS, UNLESS SPECIFIED OTHERWISE.
2. SOD ALL DISTURBED AREAS WITHIN THE CONTRACT LIMITS, UNLESS NOTED OTHERWISE.
3. PLANT QUANTITIES ARE FOR CONTRACTORS CONVENIENCE, THE DRAWING SHALL PREVAIL IF A CONFLICT OCCURS.
4. ALL PLANT MATERIAL SHALL CONFORM TO THE LATEST EDITION OF AMERICAN STANDARD FOR NURSERY STOCK (ANSI Z60.1).
5. CONTRACTOR SHALL GUARANTEE ALL PLANT MATERIAL FOR A PERIOD OF ONE YEAR FROM THE DATE OF ACCEPTANCE.
6. IT IS THE CONTRACTORS RESPONSIBILITY TO REMOVE IDENTIFICATION TAGS AND CORDS ON ALL PLANT MATERIAL PRIOR TO THE COMPLETION OF THE CONTRACT.
7. CONTRACTOR SHALL PLACE SHREDDED HARDWOOD MULCH AROUND ALL TREES AND SHRUB BEDS TO A DEPTH OF 4 INCHES, UNLESS NOTED.
8. STAKE AND WRAP ALL DECIDUOUS TREES IMMEDIATELY AFTER PLANTING. STAKE ALL TREES ACCORDING TO THE STAKING DETAILS. CONTRACTOR SHALL ADJUST AND MAINTAIN GUYING TENSION THROUGHOUT THE PLANT ESTABLISHMENT PERIOD.
9. THE LANDSCAPING CONTRACTOR SHALL HAVE ALL UTILITIES LOCATED BEFORE STARTING ANY SITE WORK OR PLANTING. THE CONTRACTOR SHALL BE RESPONSIBLE FOR THE PROTECTION OF ALL EXISTING UTILITIES.
10. NO LANDSCAPE MATERIAL SHALL BE SUBSTITUTED WITHOUT THE AUTHORIZATION OF THE LANDSCAPE ARCHITECT.
11. ALL EDGING SHALL BE DURAEDE 1/8" STEEL EDGING - COLOR GREEN, OR APPROVED EQUAL.
12. CONTRACTOR SHALL BE RESPONSIBLE MAINTAINING APPROPRIATE LEVEL OF WATERING FOR ALL NEW PLANTS FOR A PERIOD OF 30 DAYS.
13. ALL SHRUB AND PERENNIAL PLANTING BEDS SHALL BE MULCHED WITH 4 INCH THICK SHREDDED HARDWOOD MULCH.
14. ALL BEDS TO RECEIVE PRE-EMERGENT WEED CONTROL BEFORE AND AFTER MULCH IS INSTALLED.

5
XX
DENOTES EXISTING PLANT MATERIAL

11
XX
DENOTES PROPOSED PLANT MATERIAL



PLANTING SCHEDULE

CODE	QUAN	COMMON NAME	LATIN NAME	SIZE	ROOT	NOTES	POINTS EACH	TOTAL POINTS
PROPOSED LANDSCAPE PLANTINGS								
LC	2	LANCELOT CRABAPPLE	MALUS X LANCELOT	1.5' CAL	B&B	MATCHED SPECIMENS	15	30
GF	11	GOLD FLAME SPIREA	ROSAX RAD RAZ	#5	CONT	FULL FORM - MATCHED	3	33
EXISTING LANDSCAPE PLANTINGS								
MP	18	MUGO PINE	PNUS MUGO	36" +			4	72
UA	28	UPRIGHT ARBORVITAE	THUJA SP.	6" +			10	280
PH	75	PRIVET HEDGE	LIGUSTRUM SP.	48" +			3	225
3"M	5	MAPLE TREE	ACER SP.	3" CAL			35	175
6"M	2	MAPLE TREE	ACER SP.	6" CAL			84	168
TOTAL NUMBER OF POINTS								983


LANDSCAPE REQUIREMENTS:

TOTAL SQUARE FOOTAGE OF DEVELOPMENT 37,762 SF
TOTAL LANDSCAPE POINTS REQUIRED (5/1300 SF) 630
TOTAL LANDSCAPE POINTS PROVIDED 983


NOTE: IN ADDITION TO PLANT QUANTITIES SHOWN ABOVE, EXISTING PERENNIALS HAVE NOT BEEN QUANTIFIED, BUT WOULD COUNT TOWARDS ADDITIONAL LANDSCAPE POINTS.

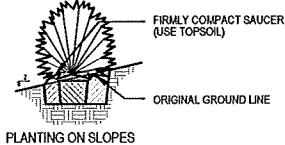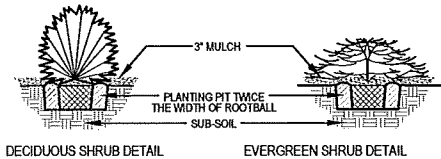

SHRUB PLANTING (TYP.)
SCALE: NOT TO SCALE

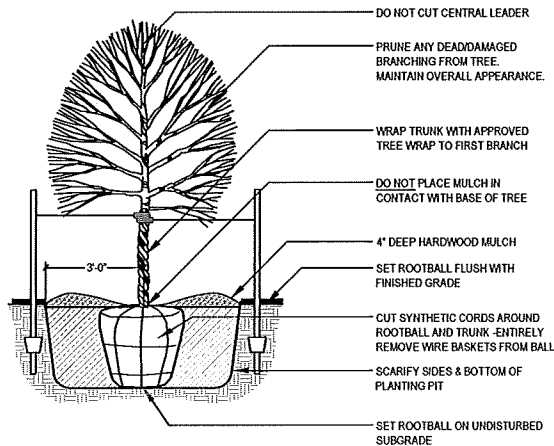


DECIDUOUS TREE PLANTING (TYP.)
SCALE: NOT TO SCALE

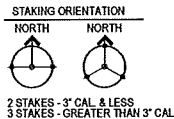


2 STAKES - 3" CAL. & LESS
3 STAKES - GREATER THAN 3" CAL.

USE HOSE GUARDS AROUND TRUNK ON STAKING WIRE. TIE WIRE TO STEEL POSTS PLACED OUTSIDE PLANT PIT.

LEAVE STAKES IN PLACE NO MORE THAN 1 YEAR FROM INSTALLATION. CONTRACTOR RESPONSIBLE FOR REMOVAL.

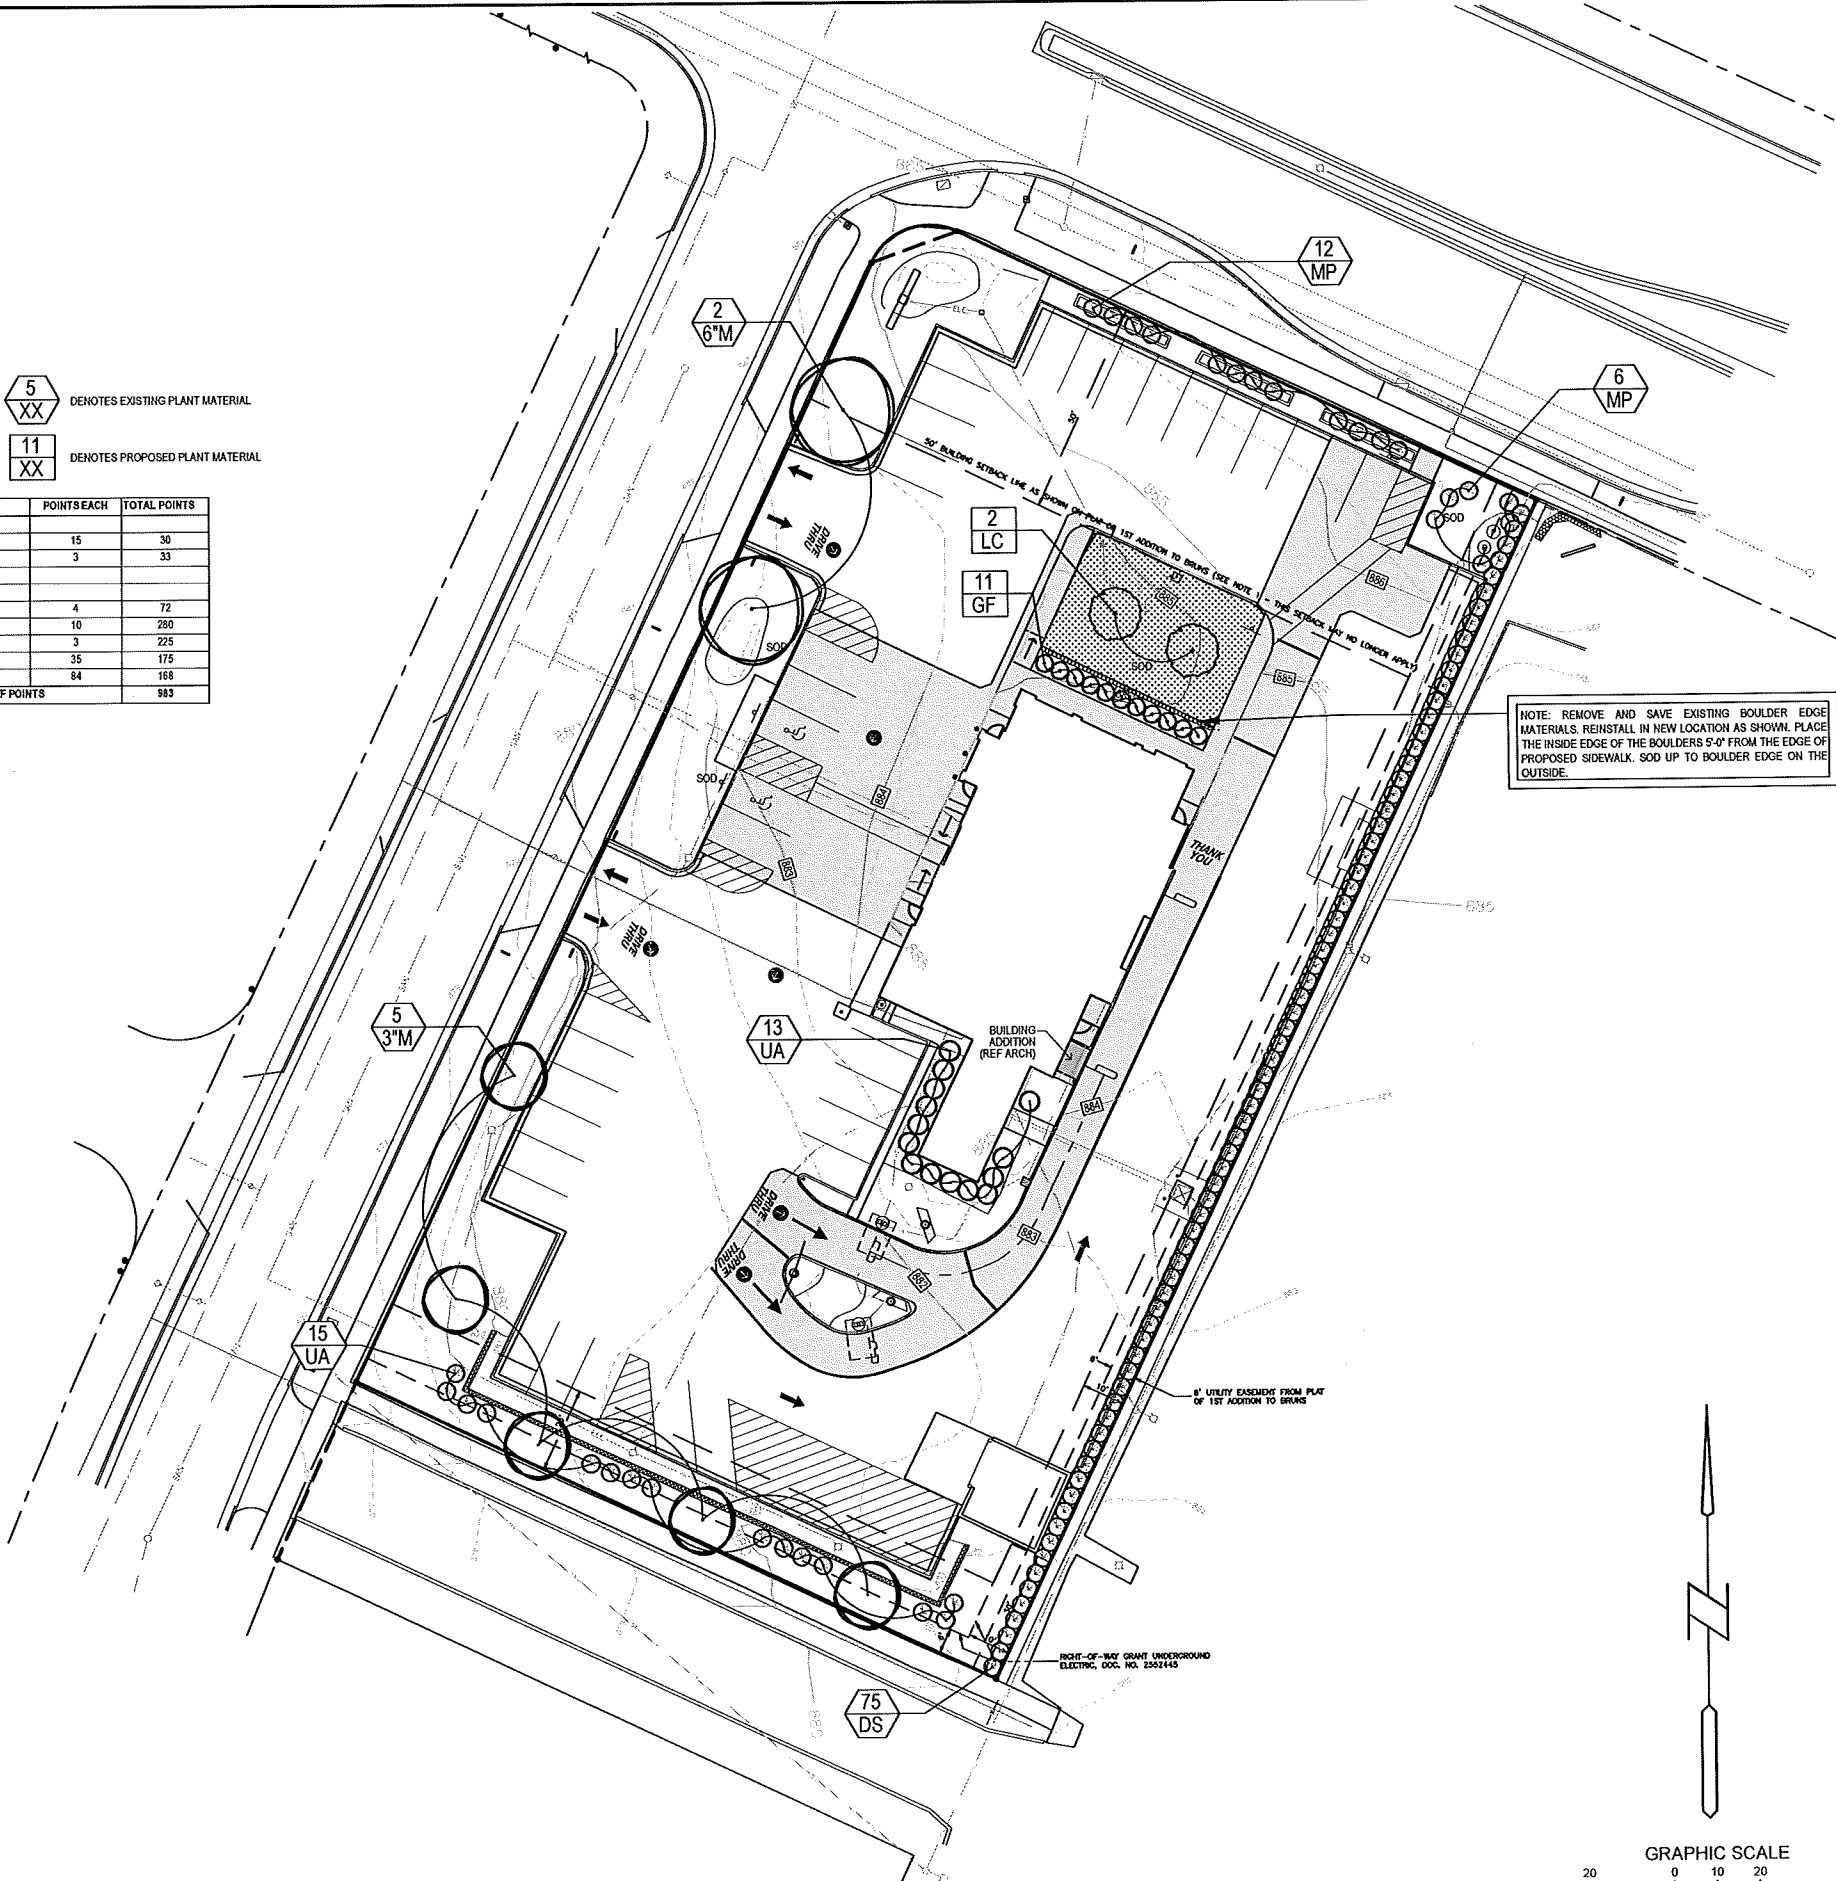

NOTE: REMOVE AND SAVE EXISTING BOULDER EDGE MATERIALS. REINSTALL IN NEW LOCATION AS SHOWN. PLACE THE INSIDE EDGE OF THE BOULDERS 5'-0\"/>

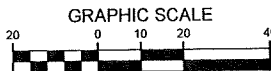

PREPARED FOR:
M. McDonald's USA, LLC

PREPARED BY:
Bishop Engineering
"Planning Your Successful Development"
3501 104th Street
Des Moines, Iowa 50322-3825
Phone: (515) 276-0467 Fax: (515) 276-0237
Civil Engineering & Land Surveying
Established 1959

DRAWN BY:
JMR

DATE:
6/28/16

REVIEWED BY:
JEL

DATE ISSUED:
6/28/16

TITLE:
**MADISON, WI
SITE PLAN**

DESCRIPTION:
LANDSCAPE PLAN

SHEET NO:
C5.1
REV: 120337

DATE:
6/28/16

REV:
1

DATE:
6/9/16

DESCRIPTION:
INITIAL CITY REVIEW

DATE:
6/28/16

REV:
2

DATE:
6/28/16

DESCRIPTION:
PERMIT SET

DATE:
6/28/16

REV:
1

DATE:
6/28/16


DESCRIPTION:
INITIAL CITY REVIEW

DATE:
6/28/16

REV:
1

DATE:
6/28/16

DESCRIPTION:
INITIAL CITY REVIEW

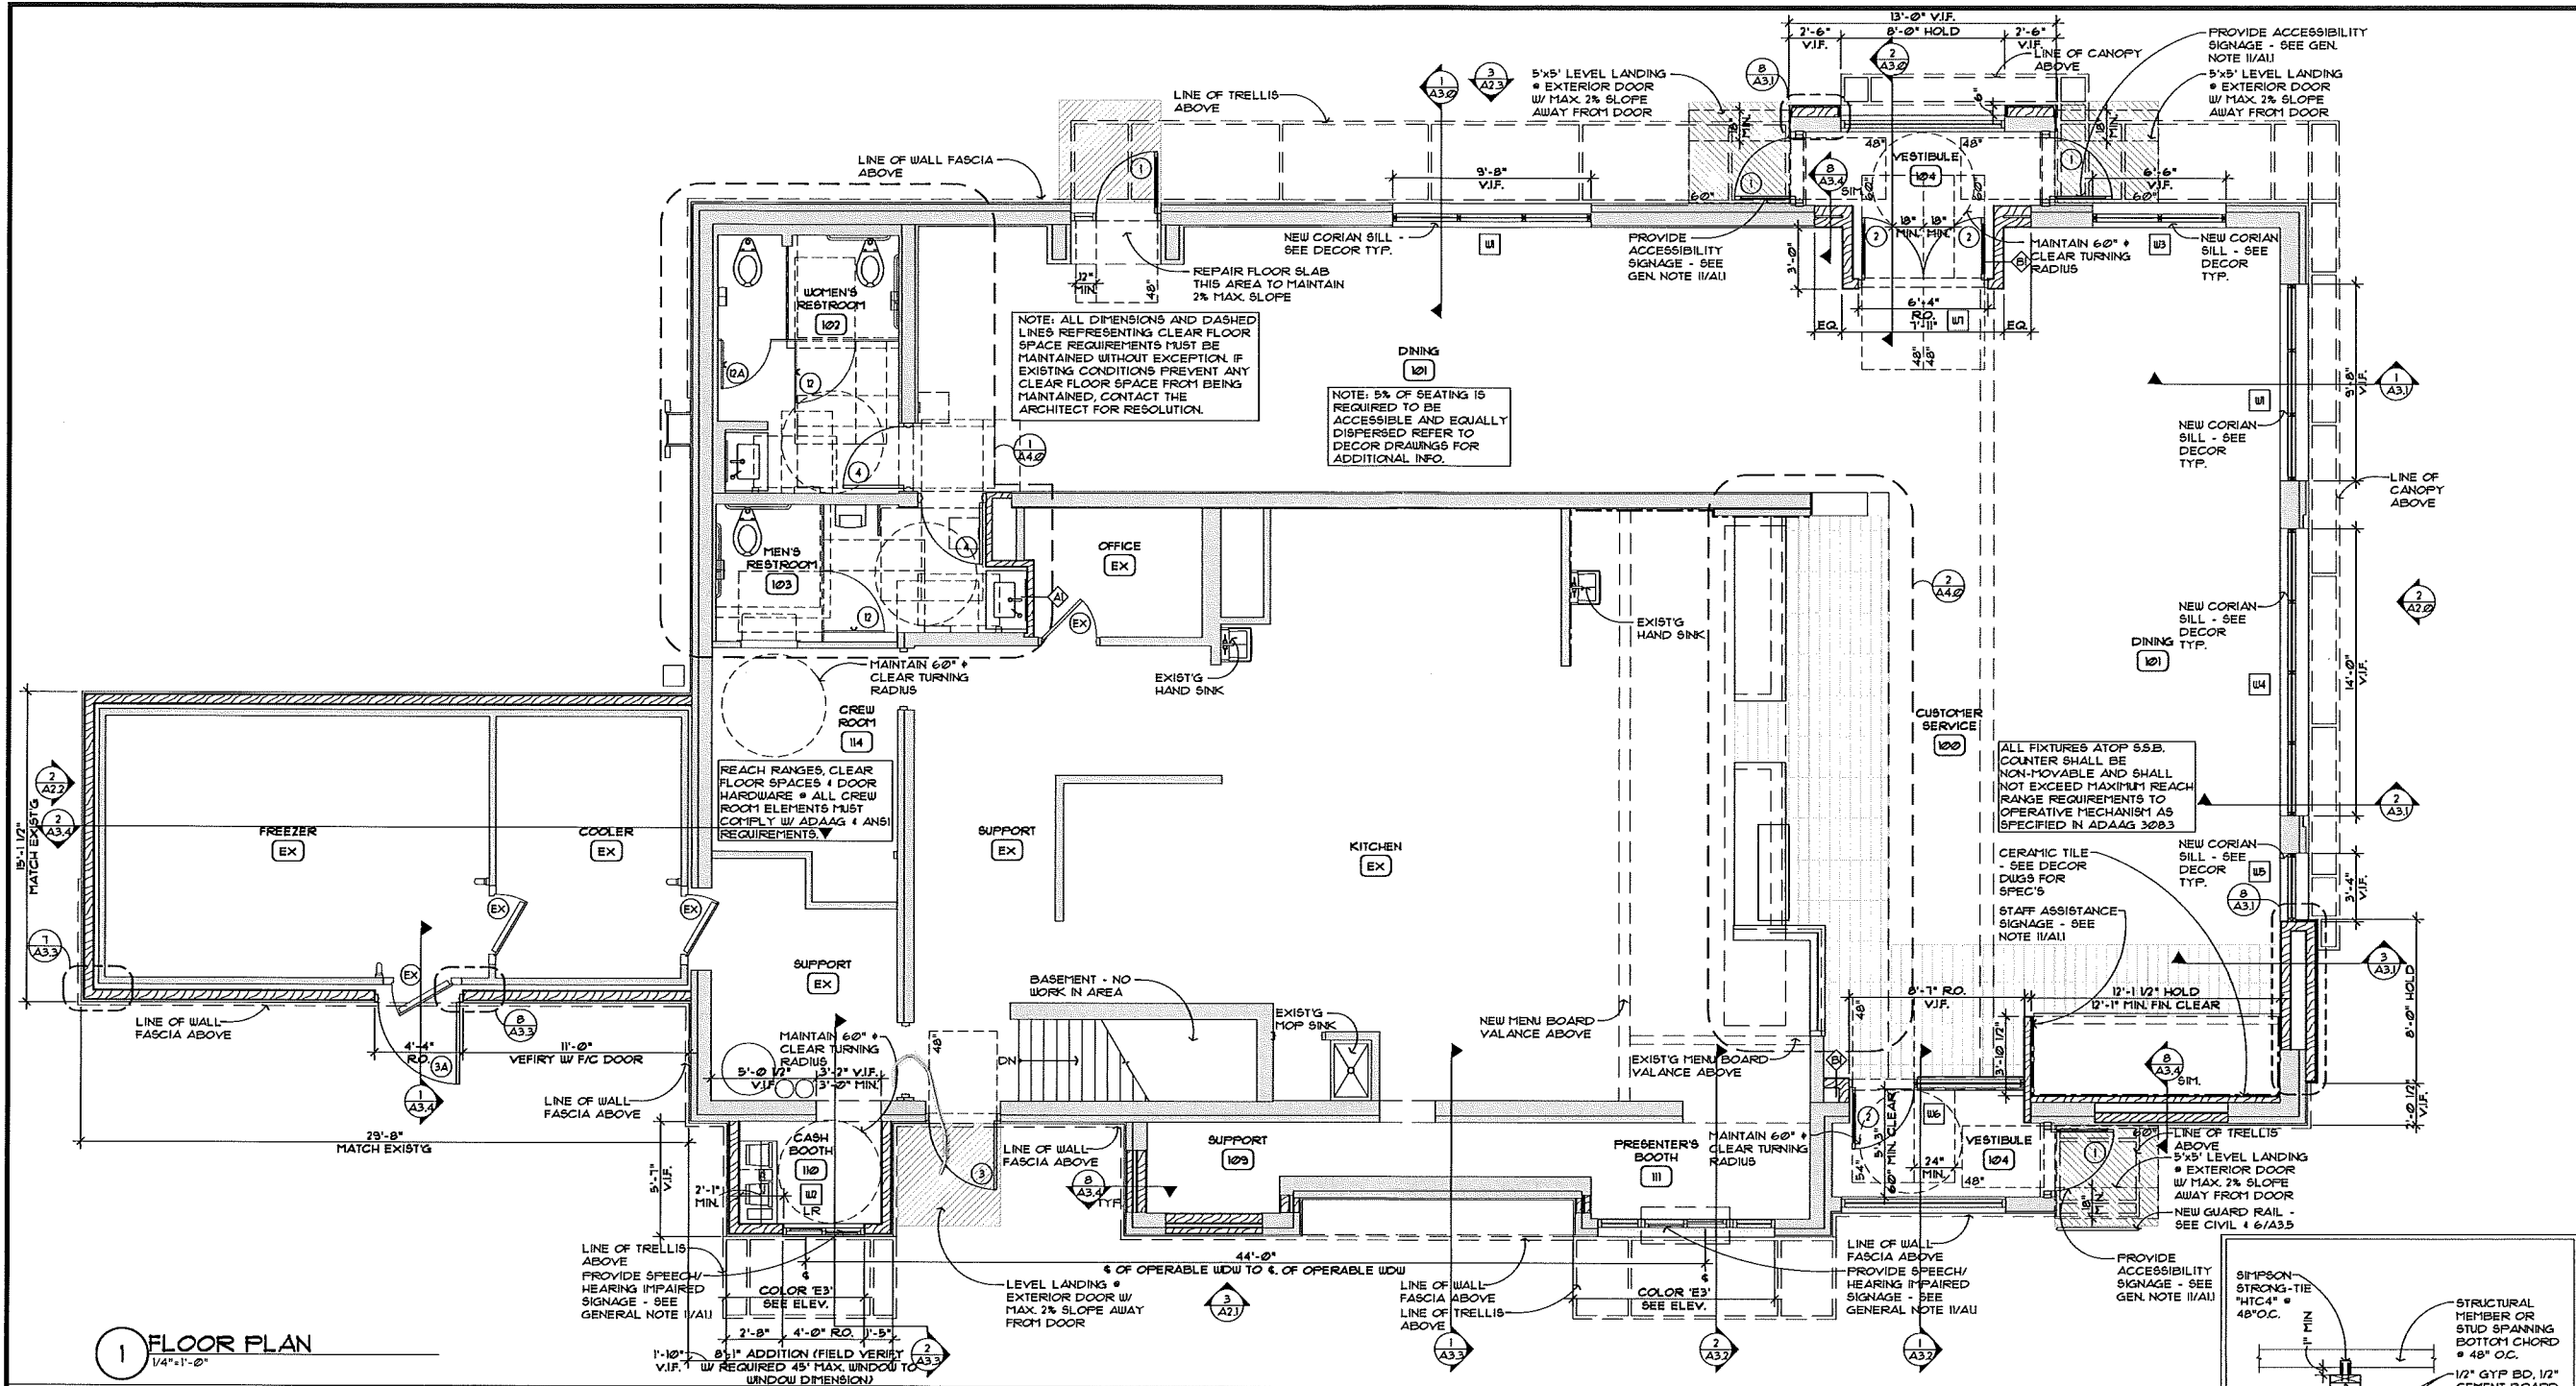

I hereby certify that this plan, specification or contract documents were prepared by me or under my direct supervision and that I am a duly registered ARCHITECT under the laws of the State of Wisconsin.

Signature: BRIAN R. JOHNSON
Date: 06/08/2016
Registration Number: 9143-005

MCDONALD'S RESTAURANT
2016 MAJOR REMODEL PROGRAM
State Site Code: 048-0101 Nat'l Number: 4067
2901 DRYDEN DR. MADISON, WISCONSIN

FLOOR PLAN


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McDonald's USA, LLC
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DATE ISSUED: 06/08/2016

DRAWN BY: AL
CHECKED BY: KD
JOB NO.: 16068



1 FRONT ELEVATION
1/4" = 1'-0"

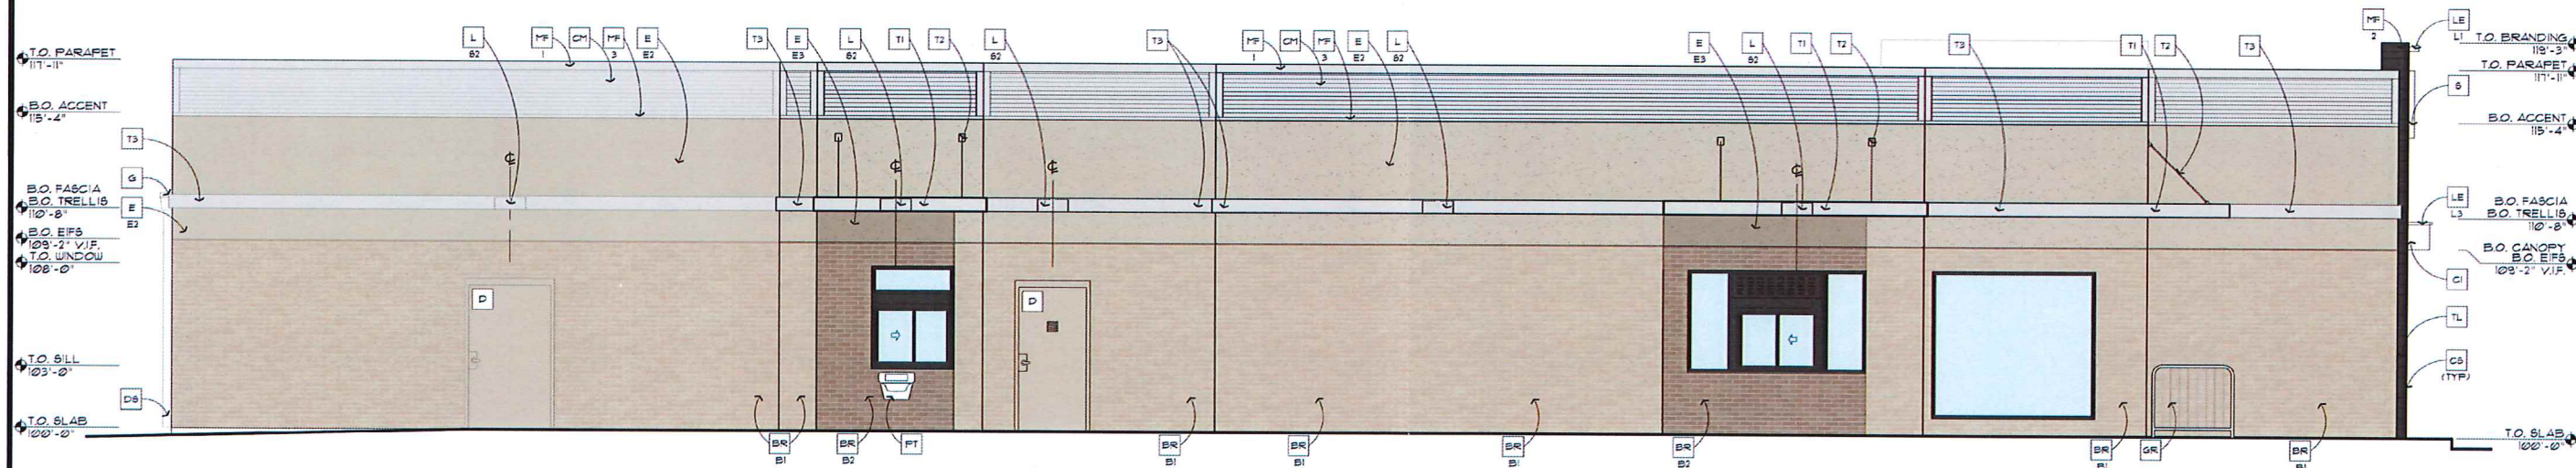

2 DRIVE THRU ELEVATION
1/4" = 1'-0"

KEY NOTES:

- BR THIN BRICK
- COLOR:
B1 = "TUMBLEWEED VELOUR" BY BELDEN OR EQUAL
B2 = "SEAL BROWN VELOUR" BY BELDEN OR EQUAL
- C1 ALUMINUM CANOPY SYSTEM (COLOR: WHITE)
- C2 ALUMINUM CANOPY TIE-BACK SYSTEM
- C3 CORRUGATED METAL PANEL, SEE ASSEMBLY NOTES ON A3.0. COLOR: CITYSCAPE BY METAL-ERA
- C4 OUTSIDE CORNER STRIPS
COLOR: BRUSHED ANTIQUE BRONZE
BY: SCHLUTER SYSTEMS L.P.
CONTACT: EARL MAIGUS (510) 324-3410
- D DOOR - PAINTED TO MATCH SURROUNDING MATERIAL E2
- D5 NEW DOWNSPOUT TO BE PAINTED TO MATCH SURROUNDING MATERIAL E2

- E EXTERIOR FINISH SYSTEM
E1 COLOR:
E1 = NOT USED
E2 = BENJAMIN MOORE 'BLEEKER BEIGE BM HC-80'
E3 = BENJAMIN MOORE 'ALEXANDRIA BEIGE BM HC-11'
- G NEW GUTTER TO BE PAINTED TO MATCH SURROUNDING MATERIAL E2
- GR NEW GUARDRAIL - STAINLESS STEEL/GALVANIZED
SEE DETAIL - X/AXX
- L LIGHT FIXTURE (WALL SCONCE) - SEE ELECTRICAL
- LI WALL SCONCE:
S1 = NOT USED
S2 = DOWN ONLY FIXTURE
S3 = UP AND DOWN FIXTURE
- LE ACCENT LIGHTING - SEE ELECTRICAL
- LI LED LIGHT:
L1 = DOWN ONLY FIXTURE
L2 = NOT USED
L3 = INTEGRAL CANOPY FIXTURE

- MF METAL FASCIA - COLOR TO MATCH CORRUGATED METAL PANEL, REFER TO SECTIONS FOR ADD'L INFO
- TYPE:
1 = PRE-FAB ANCHOR-TITE FASCIA
2 = PRE-FAB CUSTOM ARCADE FASCIA
3 = METAL COPING
- MJ TILE MOVEMENT JOINT - SEE 1/A3.0 FOR ADD'L INFO (MOVEMENT JOINTS MUST BE MAINTAINED OVER TIME W/ SEALANT)
- ML METAL LETTERING - BY OTHERS
- PT (RMHC) COIN COLLECTOR UNIT MPT DT2000 STD
CALL 1-888-143-1435 TO ORDER, SEE DETAIL X/AXX
- RL NEW ROOF LADDER - PAINTED TO MATCH SURROUNDING MATERIAL E2
- S McDONALD'S SIGNAGE BY OTHERS - UNDER SEPARATE PERMIT, SEE SIGNAGE SUPPORT NOTE ON THIS SHEET.

- T1 ALUMINUM TRELLIS
- T2 TRELLIS TIE-BACK
- T3 2x8 ALUMINUM WALL FASCIA
- TL TILE BY EUROWEST, E-WOOD COLLECTION
COLOR: R3 BLACK SIZE: 6"x36"
W/ SCHLUTER STRIP
CONTACT: JAN DETER 714-931-7500
- UX EXTERIOR WINDOW ASSEMBLY W/ TEMPERED GLASS - SEE ASSEMBLY NOTES 3/A2.1
- UX DRIVE-THRU WINDOW BY READY ACCESS 600 SERIES, 36" SERVICE HEIGHT WITH TRANSOM - CONFIRM OPTIONS WITH MCD AREA CONSTRUCTION MANAGER

SIGNAGE SUPPORT NOTE:
UNIBODY FASCIA SIGN WALL SUPPORTS TO BE VERIFIED WITH McDONALD'S ACM AND COORDINATED WITH SIGN MANUFACTURER.

I hereby certify that this plan, specification or report was prepared by me or under my direct supervision and that I am a duly registered ARCHITECT under the laws of the State of WISCONSIN

Signature: BRAN R. JOHNSON
XX/XX/XXXX
Date: 9143-005
Registration Number

McDonald's RESTAURANT
2016 MAJOR REMODEL PROGRAM
State Site Code: 048-0101 Nat'l Number: 4067
2901 DRYDEN DR. MADISON, WISCONSIN



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PREPARED FOR: McDonald's USA, LLC
DATE ISSUED: XX/XX/XXXX

DRAWN BY: AL
CHECKED BY: KD
JOB NO.: 16068

reprise
DESIGN
Architecture, Inc.
13400 Portland Avenue South
Suite 100, Portland, OR 97206
Phone: (503) 252-4042
Fax: (503) 252-4043

A2.0

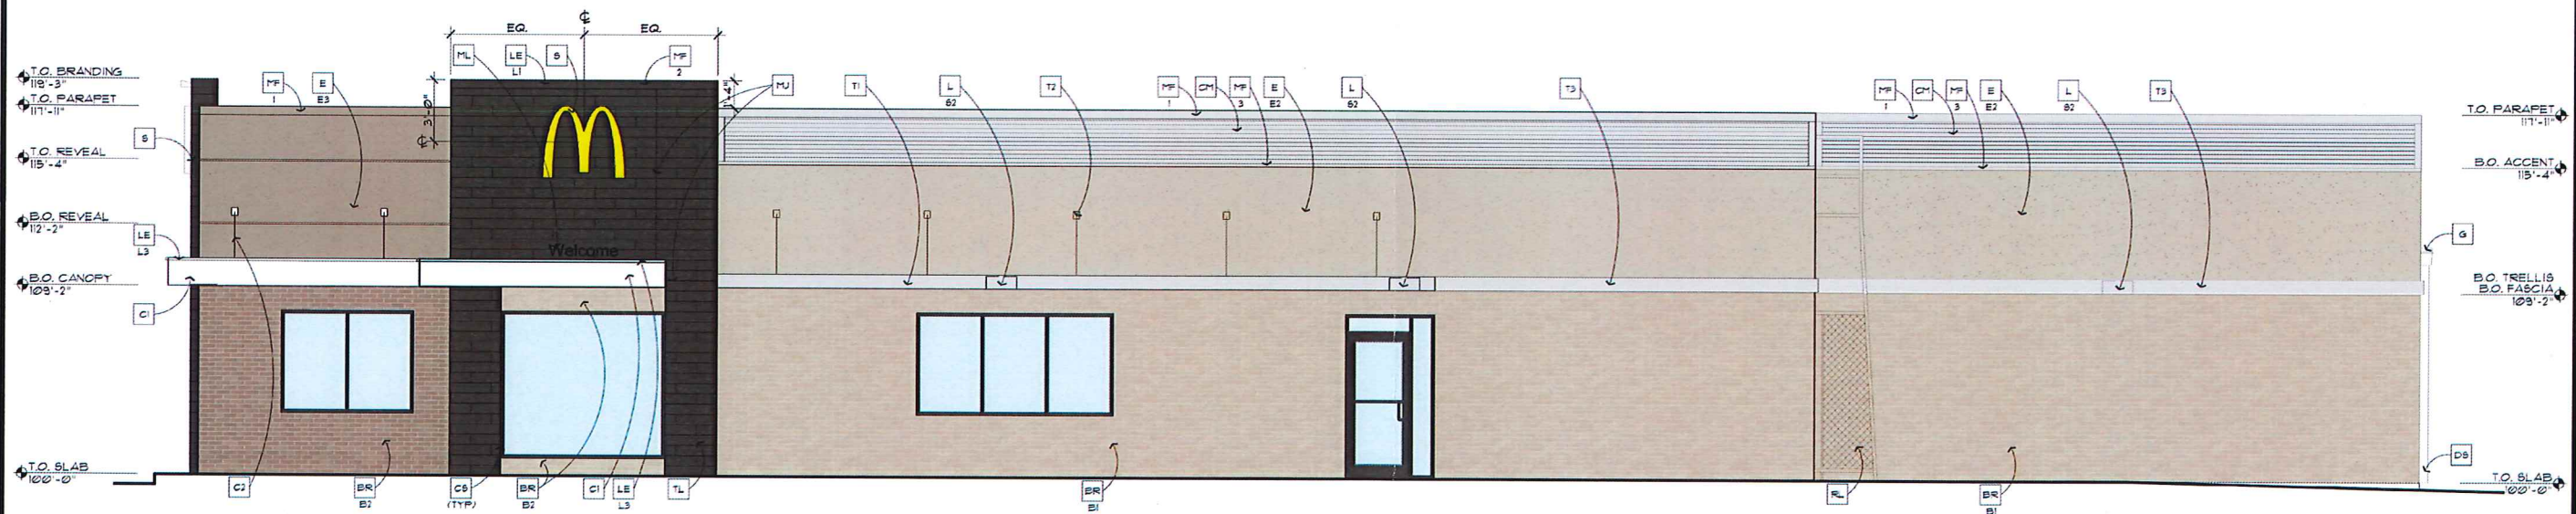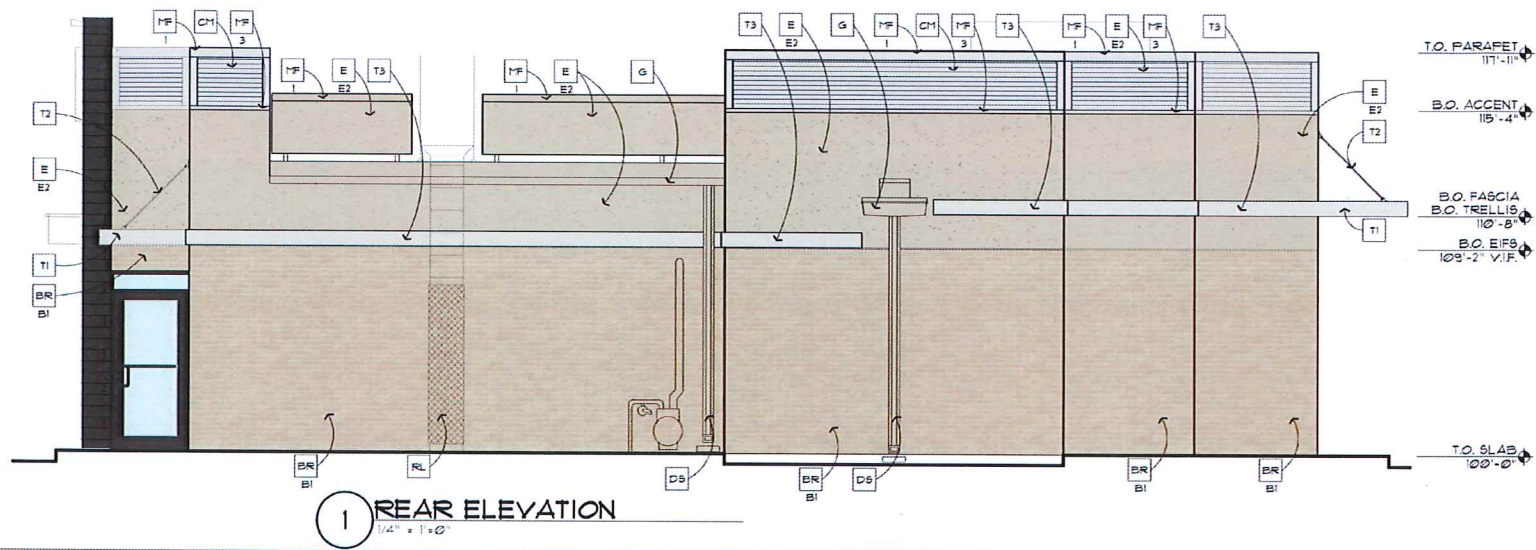

KEY NOTES:

- BR** THIN BRICK
COLOR:
B1 = "TUMBLEWEED VELOUR" BY BELDEN OR EQUAL
B2 = "SEAL BROWN VELOUR" BY BELDEN OR EQUAL
- C1** ALUMINUM CANOPY SYSTEM (COLOR: WHITE)
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- CH** CORRUGATED METAL PANEL, SEE ASSEMBLY NOTES ON A3.0. COLOR: CITYSCAPE BY METAL-ERA
- C8** OUTSIDE CORNER STRIPS
COLOR: BRUSHED ANTIQUE BRONZE
BY: SCHLUTER SYSTEMS L.P.
CONTACT: EARL MAICUS, (916) 324-3410
- D** DOOR - PAINTED TO MATCH SURROUNDING MATERIAL 'E2'
- D5** NEW DOWNSPOUT TO BE PAINTED TO MATCH SURROUNDING MATERIAL 'E2'
- E** EXTERIOR FINISH SYSTEM
COLOR:
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- G** NEW GUTTER TO BE PAINTED TO MATCH SURROUNDING MATERIAL 'E2'
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SEE DETAIL - X/XXX
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COLOR: R3 BLACK
SIZE: 6"x36"
W/ SCHLUTER STRIP
CONTACT: JAN DETER 714-937-1500
- Wk** EXTERIOR WINDOW ASSEMBLY W/ TEMPERED GLASS - SEE ASSEMBLY NOTES 3/A21
- XX** DRIVE-THRU WINDOW BY READY ACCESS 600 SERIES, 36" SERVICE HEIGHT WITH TRANSOM - CONFIRM OPTIONS WITH MCD AREA CONSTRUCTION MANAGER
- SLIDE DIRECTION:** RL = RIGHT TO LEFT
LR = LEFT TO RIGHT
- SIGNAGE SUPPORT NOTE:**
UNIBODY FASCIA SIGN WALL SUPPORTS TO BE VERIFIED WITH McDONALD'S ACM AND COORDINATED WITH SIGN MANUFACTURER.

reprise
Architecture, Inc.
12400 Park Road
Suite 100, Portland Corporate Center
Burlington, MN 55337
Office: (952) 252-4042
Fax: (952) 252-4043

I hereby certify that this plan, specification or report was prepared by me or under my direct supervision and that I am a duly registered ARCHITECT under the laws of the State of WISCONSIN

Signature: **BRAN R. JOHNSON**
Date: **XX/XX/XXXX**
Registration Number: **9143-005**

McDONALD'S RESTAURANT
2016 MAJOR REMODEL PROGRAM
State Site Code: 048-0101 Nat'l Number: 4067
2901 DRYDEN DR. MADISON, WISCONSIN



EXTERIOR ELEVATIONS

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DATE ISSUED: XX/XX/XXXX

DRAWN BY: **AL**
CHECKED BY: **KD**
JOB NO.: **16068**

A2.1

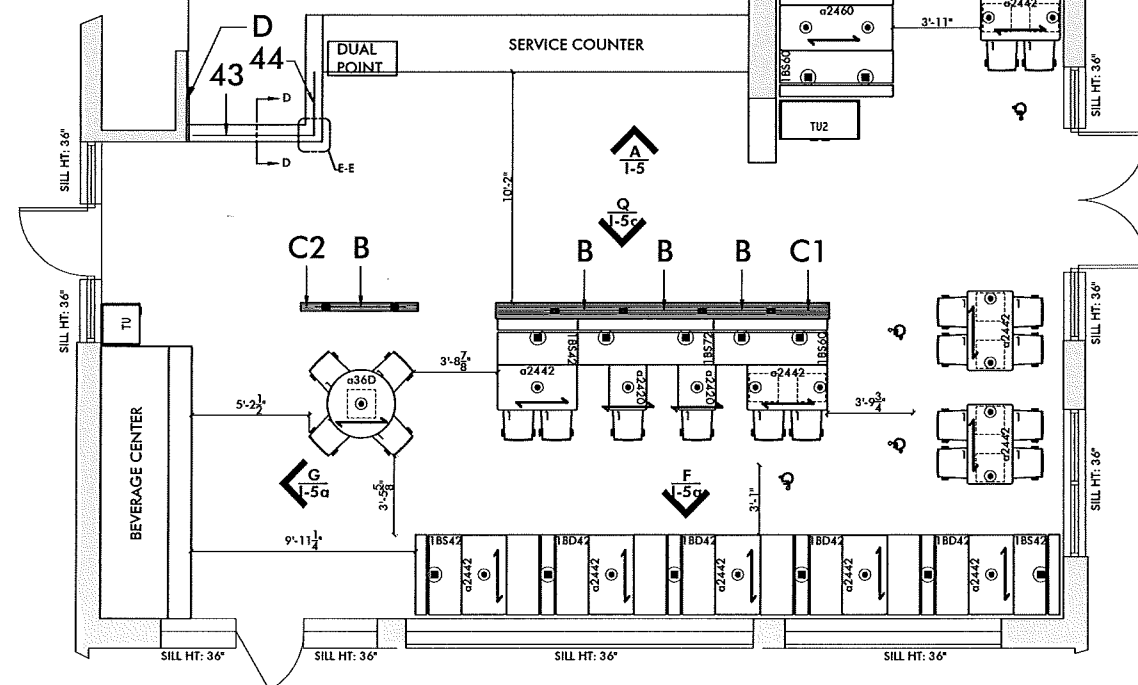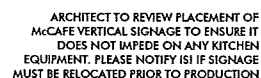

**MAIN DINING
SEATING RATIO:**

3.5


SEATS: 92	TABLES: 26
ONE'S <u>-</u>	-
TWO'S <u>18</u>	9
THREE'S <u>-</u>	-
FOUR'S <u>56</u>	14
FIVES & UP <u>18</u>	3
<u>5</u> 5% W.C. ACCESSIBLE	

NOTE:

- THIS IS PROPRIETARY TO ISI. ANY UNAUTHORIZED USE OR REPRODUCTION IS STRICTLY PROHIBITED.
- ISI WILL NOT BE HELD LIABLE FOR NON-ISI ITEMS THE CUSTOMER PURCHASED AND DO NOT FIT IN THE INTENDED SPACE.

FLOOR PLAN KEY

HIGH CHAIR

 WHEELCHAIR ACCESSIBLE

3" DIA. CORED SUPPORT
3" DIA. CORED SUPPORT
w/ LARGE PLATE
3" DIA. CORED SUPPORT
w/ OFF-SET PLATE

EXISTING HALF WALL

ISI HALFWALL

GRAIN DIRECTION

TOP CAP DECOR

SCOPE OF WORK

CHAIRS TO BE REPLACED
BOOTHS TO BE REPLACED
DINING TABLES TO BE REPLACED
TRASH UNITS TO BE REPLACED
GENERAL LIGHTING TO BE REPLACED
PENDANT LIGHTING TO BE REPLACED
GRAPHIC WALL COVERING TO BE INSTALLED
WAINSCOTING TO BE REPLACED
CHAIR RAIL TO BE REPLACED
HALF WALLS TO BE REPLACED
BEVERAGE CENTER TOP AND FACE TO BE
REFINISHED
FRONT SERVICE COUNTER FACE AND TOP TO BE
REFINISHED
TABLE, BOOTH, AND CHAIR STEEL TO BE REPLACED
DECOR ELEMENTS TO BE ADDED
RESTROOM STALL PARTITIONS TO BE REPLACED
RESTROOM WALL TILE TO BE REPLACED; WALL
COVERING TO BE REPLACED



National #: 4067
Site ID: 480101

Account Executive
Jim Zielinski
414-232-3502
jzielinski@niiamerica.com

Drawn By

Contact
Dion Conn
414-324-7004
charles.conn@partners.mscd.com


Designer

Designer
Kelley Bush
414-847-0659

Location
2901 Dryden Drive
Madison, WI
53704

Project Manager

Project Manager
Scott Wustrack
920.924.9071



INTERIOR
SYSTEMS

[illegible]

Project Number
106068

Sheet Title. **Floor Plan**

Scale. $\frac{3}{4}" = 1'-0"$

Sheet. **I-2**

**PRELIMINARY PLANS
NOT FOR CONSTRUCTION**