

City of Madison

Proposed Demolition

Location 4707 Pflaum Road


Project Name Perkin's Oil Inc.

Applicant Richard Perkins/Jim Daggett-Ideal Builders


Existing Use
Existing building

Proposed Use Demolish an existing 11,000 square foot building to allow for a 22,000 square foot warehouse addition

Public Hearing Date Plan Commission 08 February 2016

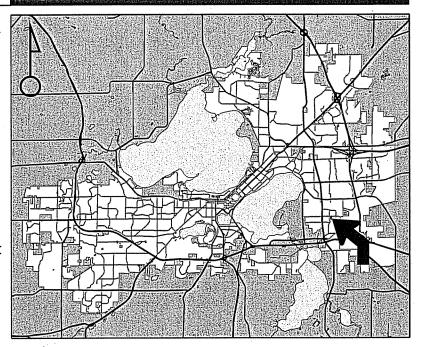


For Questions Contact: Chris Wells at: 261-9135 or cwells@cityofmadison.com or City Planning at 266-4635

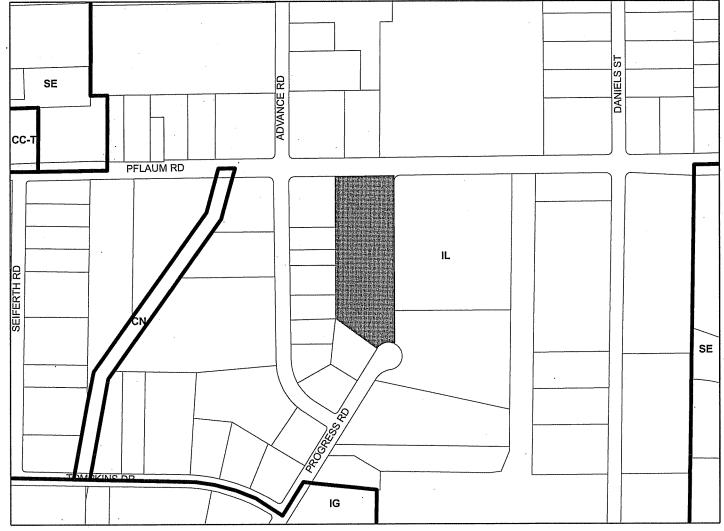

Scale: 1" = 400'

City of Madison, Planning Division: RPJ: Date: 01 February 2016

City of Madison

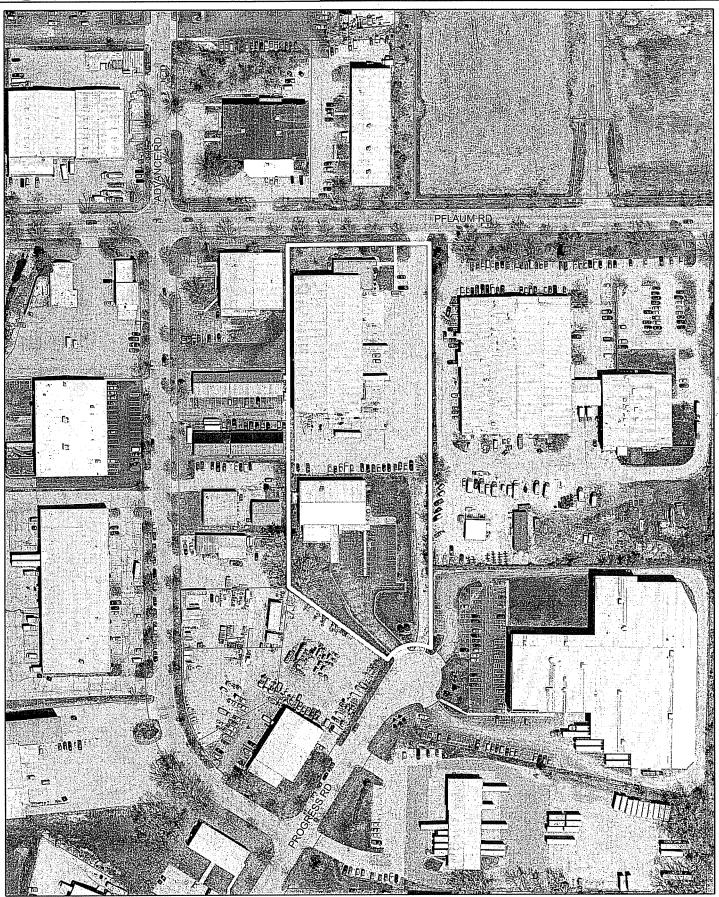

Date of Aerial Photography: Spring 2013





LAND USE APPLICATION

- Administrator at the above address.
- The following information is required for all applications for Plan Commission review except subdivisions or land divisions, which should be filed using the Subdivision Application.
- This form may also be completed online at: www.cityofmadison.com/developmentcenter/landdevelopment

IMAN LAND OSE ALL ELOANION	CITT OF WINDSON
Madison 11.	
215 Martin Luther King Jr. Blvd; Room LL-100 PO Box 2985; Madison, Wisconsin 53701-2985 Phone: 608.266.4635 Facsimile: 608.267.8739	Amt. Paid 4600 Receipt No. 01187-003 Date Received 12/21/15 Received By
 All Land Use Applications should be filed with the Zoning Administrator at the above address. 	Parcel No. 0710-222-0112-4 Aldermanic District #16-De May b
 The following information is required for all applications for Plan Commission review except subdivisions or land divisions, which should be filed using the <u>Subdivision Application</u>. 	Special Requirements Zoning Hold Review Required By:
 This form may also be completed online at: www.cityofmadison.com/developmentcenter/landdevelopment 	Urban Design Commission Plan Commission Common Council Other: Form Effective: February 21, 2013
1. Project Address: 4707 Pflaum Road	
Project Title (if any): Perkins Oil Inc.	1.5
 □ Review of Alteration to Planned Development (By Plan Conditional Use, or Major Alteration to an Approved Condition Demolition Permit ☑ Other Requests: Plan review for building demolition, addition, and new 	tional Use
3. Applicant, Agent & Property Owner Information:	Olivia Dita Dantum Inc.
Street Address: 805 Clinton St City/State:	Waukesha, WI Zip: 53186 Email: boydc@srdinc.biz
relephone. (Email:
4 400 First Ohns 4	Madison WI 52712
Street Address: 1406 Emil Street City/State:	Email: jjdaggett@idealbuilders.com
Property Owner (if not applicant): Richard Perkins	
Street Address: 4707 Pflaum Road City/State:	Madison, WI Zip: 53718
4. Project Information:	
Provide a brief description of the project and all proposed uses of the	e site: 22008 sq ft storage building addition, demolition

Applicant Name:	Boyd E Coleman II	I; PE	Company: Struc Rite Design, Inc.					
Street Address:	805 Clinton St		City/State:	Waukesh	a, WI	Zip:	53186	
Telephone: (262	549-3222 x2	Fax: (262) 89	06-2079	Email:	boydc@srdinc.biz			
Project Contact Per	son: Jim Daggett		Com	pany: Ideal	Builders			
Street Address: 1	406 Emil Street		City/State:	Madison,		Zip:	53713	
Telephone: (608	271-8111	Fax: (608) 27	71-6223	Email:	jjdaggett@idealbuilder	s.com		
Property Owner (if	not applicant): Ric	chard Perkins						
Street Address: 4	707 Pflaum Road		City/State:	Madison,	Wi	Zip:	53718	

Provide a brief description of the project and all proposed uses of t of an existing building and construction of a new 4,992 sq ft truck storage garage

2/8/2016 Development Schedule: Commencement

Completion

9/15/2016

5. Required Submittal Information
All Land Use applications are required to include the following:
✓ Project Plans including:*
 Site Plans (<u>fully dimensioned</u> plans depicting project details including all lot lines and property setbacks to buildings; demolished/proposed/altered buildings; parking stalls, driveways, sidewalks, location of existing/proposed signage; HVAC/Utility location and screening details; useable open space; and other physical improvements on a property)
Grading and Utility Plans (existing and proposed)
 Landscape Plan (including planting schedule depicting species name and planting size)
 Building Elevation Drawings (fully dimensioned drawings for all building sides, labeling primary exterior materials)
 Floor Plans (fully dimensioned plans including interior wall and room location)
Provide collated project plan sets as follows:
 Seven (7) copies of a full-sized plan set drawn to a scale of 1 inch = 20 feet (folded or rolled and stapled) Twenty Five (25) copies of the plan set reduced to fit onto 11 X 17-inch paper (folded and stapled) One (1) copy of the plan set reduced to fit onto 8 ½ X 11-inch paper * For projects requiring review by the Urban Design Commission, provide Fourteen (14) additional 11x17 copies of the plan set. In addition to the above information, all plan sets should also include: 1) Colored elevation drawings with shadow lines and a list of exterior building materials/colors; 2) Existing/proposed lighting with photometric plan & fixture cutsheet; and 3) Contextual site plan information including photographs and layout of adjacent buildings and structures. The applicant shall bring samples of exterior building materials and color scheme to the Urban Design Commission meeting. Letter of Intent: Provide one (1) Copy per Plan Set describing this application in detail including, but not limited to:
 Project Team Existing Conditions Project Schedule Proposed Uses (and ft² of each) Hours of Operation Building Square Footage Number of Dwelling Units Auto and Bike Parking Stalls Lot Coverage & Usable Open Space Calculations Value of Land Estimated Project Cost Number of Construction & Full-Time Equivalent Jobs Created Public Subsidy Requested
Filing Fee: Refer to the Land Use Application Instructions & Fee Schedule. Make checks payable to: City Treasurer.
Electronic Submittal: All applicants are required to submit copies of all items submitted in hard copy with their application as Adobe Acrobat PDF files on a non-returnable CD to be included with their application materials, or by e-mail to pcapplications@cityofmadison.com.
Additional Information may be required, depending on application. Refer to the Supplemental Submittal Requirements.
6. Applicant Declarations
Pre-application Notification: The Zoning Code requires that the applicant notify the district alder and any nearby neighborhood and business associations in writing no later than 30 days prior to FILING this request. List the alderperson, neighborhood association(s), and business association(s) AND the dates you sent the notices:
→ If a waiver has been granted to this requirement, please attach any correspondence to this effect to this form.

Name of Applicant Boyd E Coleman Relationship to Property: A/E Designer

Authorizing Signature of Property Owner Ruhard D Perbura Date 12/21/15 5

The applicant attests that this form is accurately completed and all required materials are submitted:

Pre-application Meeting with Staff: <u>Prior</u> to preparation of this application, the applicant is required to discuss the proposed development and review process with Zoning and Planning Division staff; note staff persons and date.

JEFF BENEBILT 10/21/13

Planning Staff: Zoning Staff: MATI TUCKER Date: 3-9-2015

JENNY KIRCHGATTER



Letter of Intent

Perkins Oil Company (Pflaum Investment, LLC.) located at 4707 Pflaum Road, Madison, Wi has purchased the adjacent property located at 2542 Progress Road, Madison, WI (formerly owned by C.L. Swanson Co.) and subsequently combined the two properties into one lot and recorded under CSM Map No. 13926 in 2014.

It is the intent of the owner to demolish the existing 11,000 sq.ft. building located on the adjoining property and construct a 22,000 sq.ft. warehouse addition together with a separate 5,000 sq.ft. garage storage building as detailed on the plans by Struc-Rite Design Inc. and Burse Surveying & Engineering, Inc.

The project team consists of the following:

Architect/Structural Engineer
Boyd Coleman (boydc@srdinc.com)
Struc-Rite Design, Inc.
805 Clinton St.
Waukesha, WI 53186
262-549-3222

Civil/Storm water Engineer
Michelle Burse (mburse@bse-inc.com)
Burse Surveying & Engineering, Inc.
2801 International Ln. – Ste. 101
Madison, WI 53704
608-250-9263

General Contractor
Jim Daggett (jjdaggett@idealbuildersinc.com)
Ideal Builders, Inc.
1406 Emil St.
Madison, WI 53713
608-271-8111

Demolition Contractor

Curt Diehl (diehlneumaier@yahoo.com)



Diehl & Neumaier Co. 5466 Norway Grove School Rd. Deforest, WI 53532 608-846-4824

Perkins Oil Company currently has 25 full time employees at the Pflaum Road facility and will be adding 2 more full time positions with this expansion.

There will be 28 parking stalls provided together with 2 handicap stalls and a bike rack.

Normal hours of operation are from 7am-5pm, Monday thru Friday.

The current value of the land in 1.25 million and the estimated value of the proposed expansion is 1.5 million.

With the completion of this expansion, the total impervious area will be 138,683 sq.ft. which provides for a lot of coverage if 74.5%

Demolition is anticipated to start in mid-February of 2016 with completion of the construction to include landscape and restoration of all disturbed areas established by mid-September later that year.

More specifically, refer to the Demolition Plan, C 1.2 prepared by Burse Surveying & Engineering, Inc.

Alderperson, Denise DeMarb, has been contracted with regard to obtaining a waiver of the preapplication notification and approval for the project.


The deconstruction of the metal building constructed in 1997 will be provided by Diehl & Neumaier Co. DeForest, WI.

All scrap metal will be removed and processed by Diehl & Neumaier. Preparation prior to starting together with the demolition will include removing items containing CFC's and mercury for recycling performed by Diehl & Neumaier.


All construction waste will be sorted by Diehl & Neumaier and hauled off site by Royal Container Service.

The concrete foundations, slabs, & asphalt will be re-ground on-site by TriCor and utilized as fill materials for the proposed expansion.

Royal Container Service will provide the amount of scrap metal and landfill waste hauled off site at the time the work is performed.

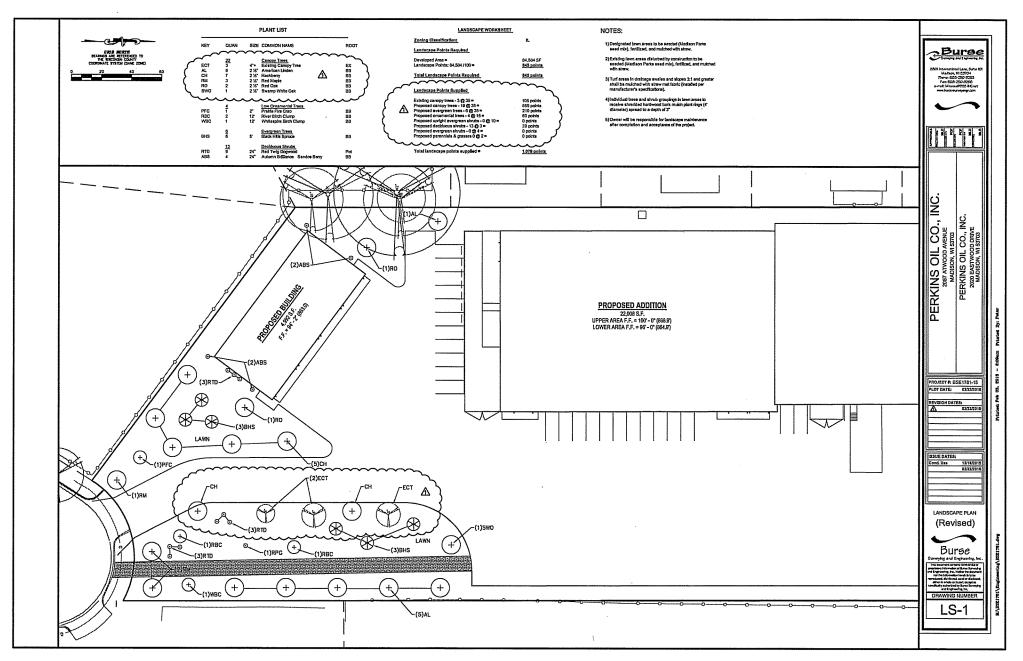

REVISED

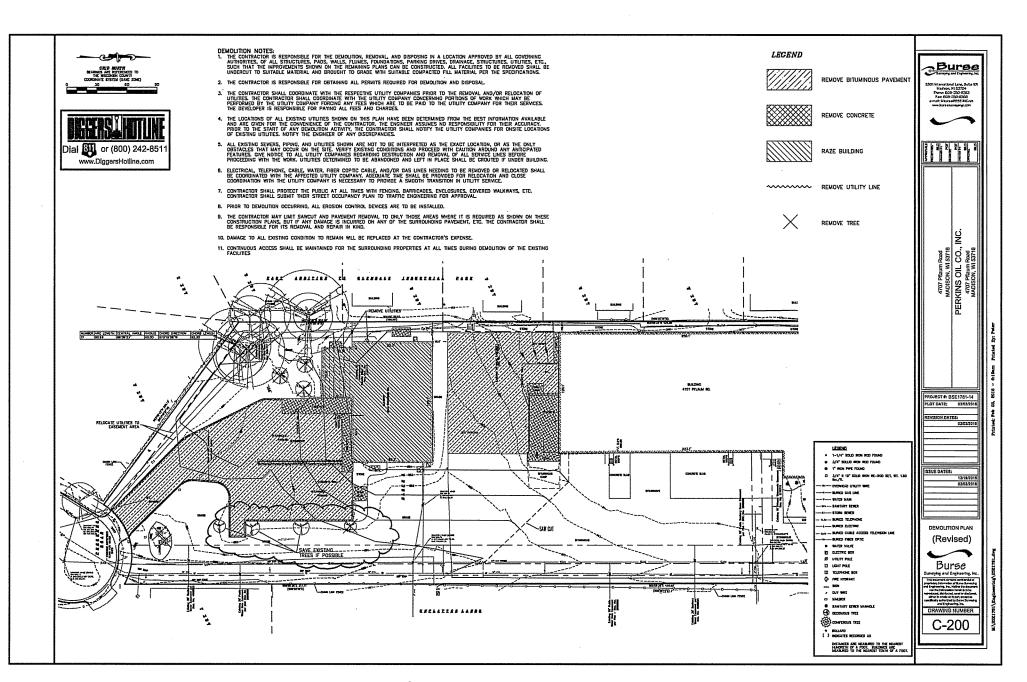




IDEAL BUILDERS

PERKINS OIL INC.

PLAN REVIEW

4707 PFLAUM ROAD **MADISON, WI 53718**

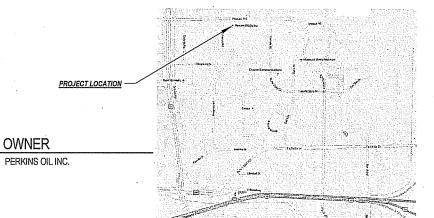

DESIGNER/SUPERVISING PROFESSIONAL

Struc Rite Design, Inc. Boyd E. Coleman, P.E. President, Engineer 805 Clinton Street Waukesha, WI 53186 262.549.3222 262.896.2079 www.srdinc.biz

CONTRACTOR

IDEAL BUILDERS JIM DAGGET BUILDING CONSULTANT 1406 EMIL STREET 608.271.8111 608.271.6233 IDEALBUILDERSINC.COM

SHEET INDEX

SHEET	Sheet Name	DESIGN DEVELOPMENT	PLAN REVIEW	STATE REVIEW	REVISION 1	REVISION 2
	*					
G1.0	COVER PAGE	12.02.2015	12,18,2015			
C1.0	ARCHITECTURAL SITE PLAN	12.02.2015	12.18.2015			
C1.1	CIVIL - EXISTING CONDITIONS		12.18.2015			
C1,2	CIVIL - DEMO PLAN		12.18.2015			
C1.3	CIVIL - GRADING AND EROSION CONTROL PLAN		12.18.2015			
C1.4	CIVIL - UTILITY PLAN		12,18,2015			
C1.5	CIVIL - SITE PLAN		12.18.2015			
LS1.0	LANDSCAPE PLAN	·	12.18,2015			
AD.9	BUILDING AREAS	12.02.2015	12.18.2015			
A1.1	ADDITION - FLOOR PLAN	12.02.2015	12.18.2015			
A1.2	ADDITION - ROOF PLAN	12.02.2015	12.18.2015			
A1.3	STORAGE GARAGE - FLOOR & ROOF PLAN	12.02.2015	12.18.2015			
A2,0	ADDITION - EXTERIOR ELEVATIONS	12.02.2015	12.18.2015			
A2.1	STORAGE GARAGE - EXTERIOR ELEVATIONS	12.02.2015	12.18.2015			
. A4.0	DETAIL PLANS	12.02.2015	12.21.2015			

Drawing Key:


DOOR TAG & DOOR PANEL TYPE 1a WINDOW TAG (a1) WALL TAG
(7) PROJECT KEYED NOTE FIRE ALARM HORN & STROBE FIRE ALARM BELL
FIRE ALARM PULL BOX
FIRE ALARM CONTROL PANE

EMERGENCY EXIT SIGN

	EXISTING CONSTRUCTION
	NEW CONSTRUCTION
* 6. *	TYPICAL DIMENSION
(6")	DIMENSION SHOWING FINISH TO F

	ADDITION CODE	INFORM	AT	ION:		2009 INTERNATIO	NAL BUILDING C	ODE w/ WIS	SCONSIN AME	NDMENT
	SUBMITTAL TYPE	ADDITION	ADDITION		MAXIMUM EXIT DISTANCE	MAXIMUM	250'-0"	ACTUAL		
	TYPE OF CONSTRUCTION	tiB .	tiB ·		MAXIMUM COMMON PATH	MAXIMUM	100'-0"	ACTUAL		
	NUMBER OF STORIES	1	1		MAXIMUM DEAD-END CORRIDOR	MAXIMUM	50'-0"	ACTUAL		
	SPRINKLED	YES				TOTAL NUMBER OF EXITS	REQUIRED		ACTUAL	
	SPRINKLER TYPE	WET	WET .		REQUIRED STAIR WIDTH	REQUIRED	44"	ACTUAL	NA	
	FIRE SUPPRESSION	NFPA-13	NFPA-13		REQUIRED EGRESS WIDTH	REQUIRED	NA	ACTUAL	NA	
	FIRE ALARM	YES				MAIN OCCUPANCY TYPE	S-1			
	ALARM TYPE	AUTOMATIC	AUTOMATIC			ALL OCCUPANCY TYPES	S S-1,B			
ISH	WATER CLOSET-MALE	REQUIRED	REQUIRED 1 PROVIDED 3		OCCUPANCY SEPARATIONS	NONE				
	WATER CLOSET-FEMALE	REQUIRED	1	PROVIDED	3	INCIDENTAL USES	5			
	LAVATORIES	REQUIRED	1	PROVIDED	4	* ALLOWABLE AREA	76,713 SQFT w	FRONTAG	E INCREASE	
	TUBS/SHOWERS	REQUIRED	NA	PROVIDED	NA	ACTUAL AREA FOR	EXIST B: 2,896 SQFT, EXIST S-1; 29,967 SQFT		SOFT	
	DRINKING FOUNTAINS	REQUIRED	3	PROVIDED	3	ACTUAL AREA FOR	OR NEW 8: 616 SQFT, NEW S-1: 21,392 SC		1: 21,392 SQF	Т
	OTHER					ACTUAL AREA FOR				
						TOTAL ACTUAL AREA	54,871 SQFT			
						TOTAL COOLIDANT LOAD	enn			

SUBMITTAL TYPE	ADDITION			MAXIMUM EXIT DISTANCE	MAXIMUM	300,-0.	ACTUAL	l
TYPE OF CONSTRUCTION	IIB			MAXIMUM COMMON PATH	MAXIMUM	100'-0"	ACTUAL	_
NUMBER OF STORIES	1			MAXIMUM DEAD-END CORRIDOR	MAXIMUM	20'-0"	ACTUAL	
SPRINKLED	NO			TOTAL NUMBER OF EXITS	REQUIRED	1	ACTUAL	
SPRINKLER TYPE	NONE	NONE		REQUIRED STAIR WIDTH	REQUIRED	NA	ACTUAL	NA
FIRE SUPPRESSION				REQUIRED EGRESS WIDTH	REQUIRED	NA	ACTUAL	NA
FIRE ALARM	NONE .			MAIN OCCUPANCY TYPE	5-2			
ALARM TYPE				ALL OCCUPANCY TYPES	S-2			
WATER CLOSET-MALE	REQUIRED	PROVIDED		OCCUPANCY SEPARATIONS	NONE			
WATER CLOSET-FEMALE	REQUIRED	PROVIDED		INCIDENTAL USES				
LAVATORIES	REQUIRED	PROVIDED		* ALLOWABLE AREA	A 26,000 SQFT.			
TUBS/5HOWERS	REQUIRED	PROVIDED		ACTUAL AREA FOR	S2 4,992 SQFT.			
DRINKING FOUNTAINS	REQUIRED	PROVIDED		ACTUAL AREA FOR				
OTHER				ACTUAL AREA FOR		,		
PLUMBING FIXTURES LOCATED IN ADJACENT BUILDING		TOTAL ACTUAL AREA	4,992 SQFT.					
		TOTAL OCCUPANT LOAD	10					

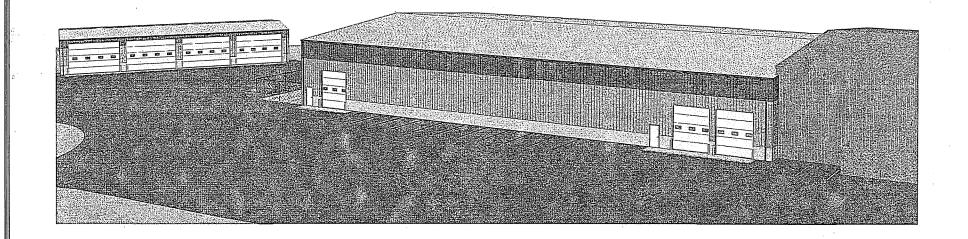


KEYNOTE LEGEND

PROPOSED SITE PLAN
1° = 30°-0°

SITE PLAN NOTES:

1. TOTAL SITE AREA 185,970 S.F.
2. TOTAL IMPERVIOS AREA 138,683 S.F. (74.5%)

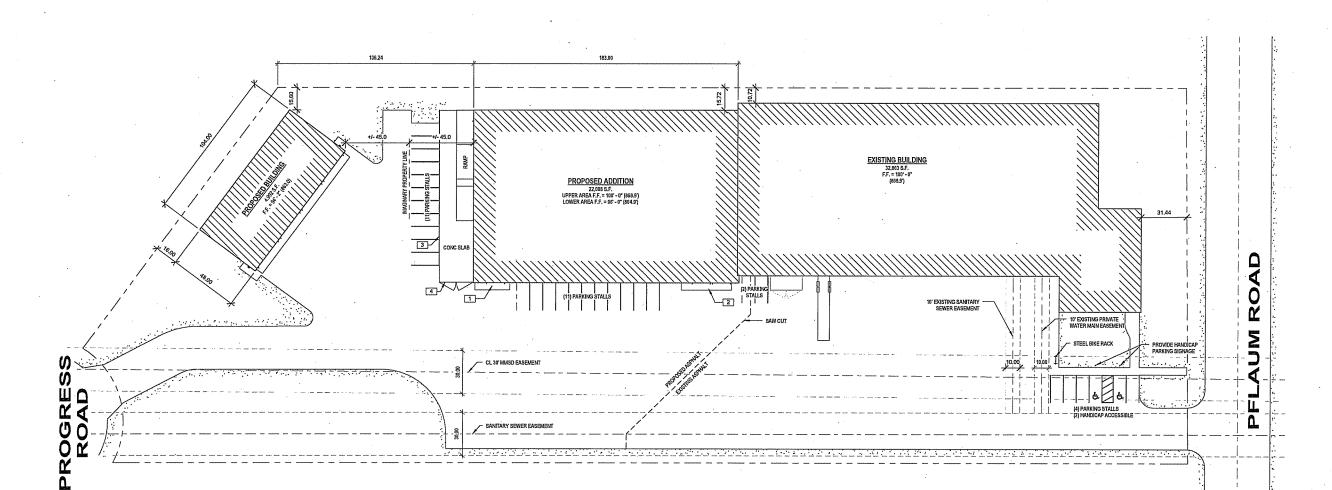

STRUC RITE **DESIGN, INC**

805 Clinton Street Waukesha, WI 53186 262.549.3222 www.srdinc.biz



1406 EMIL STREET MADISON, WI 608.2718111 608.2716233 IDEALBUILDERSINC.COM

PERKINS OIL INC. 4707 PFLAUM ROAD MADISON, WI 53718 BUILDERS IDEAL


SHEET TITLE

ARCHITECTURAL SITE PLAN


PLAN REVIEW

12.02.2015

12.18.2015

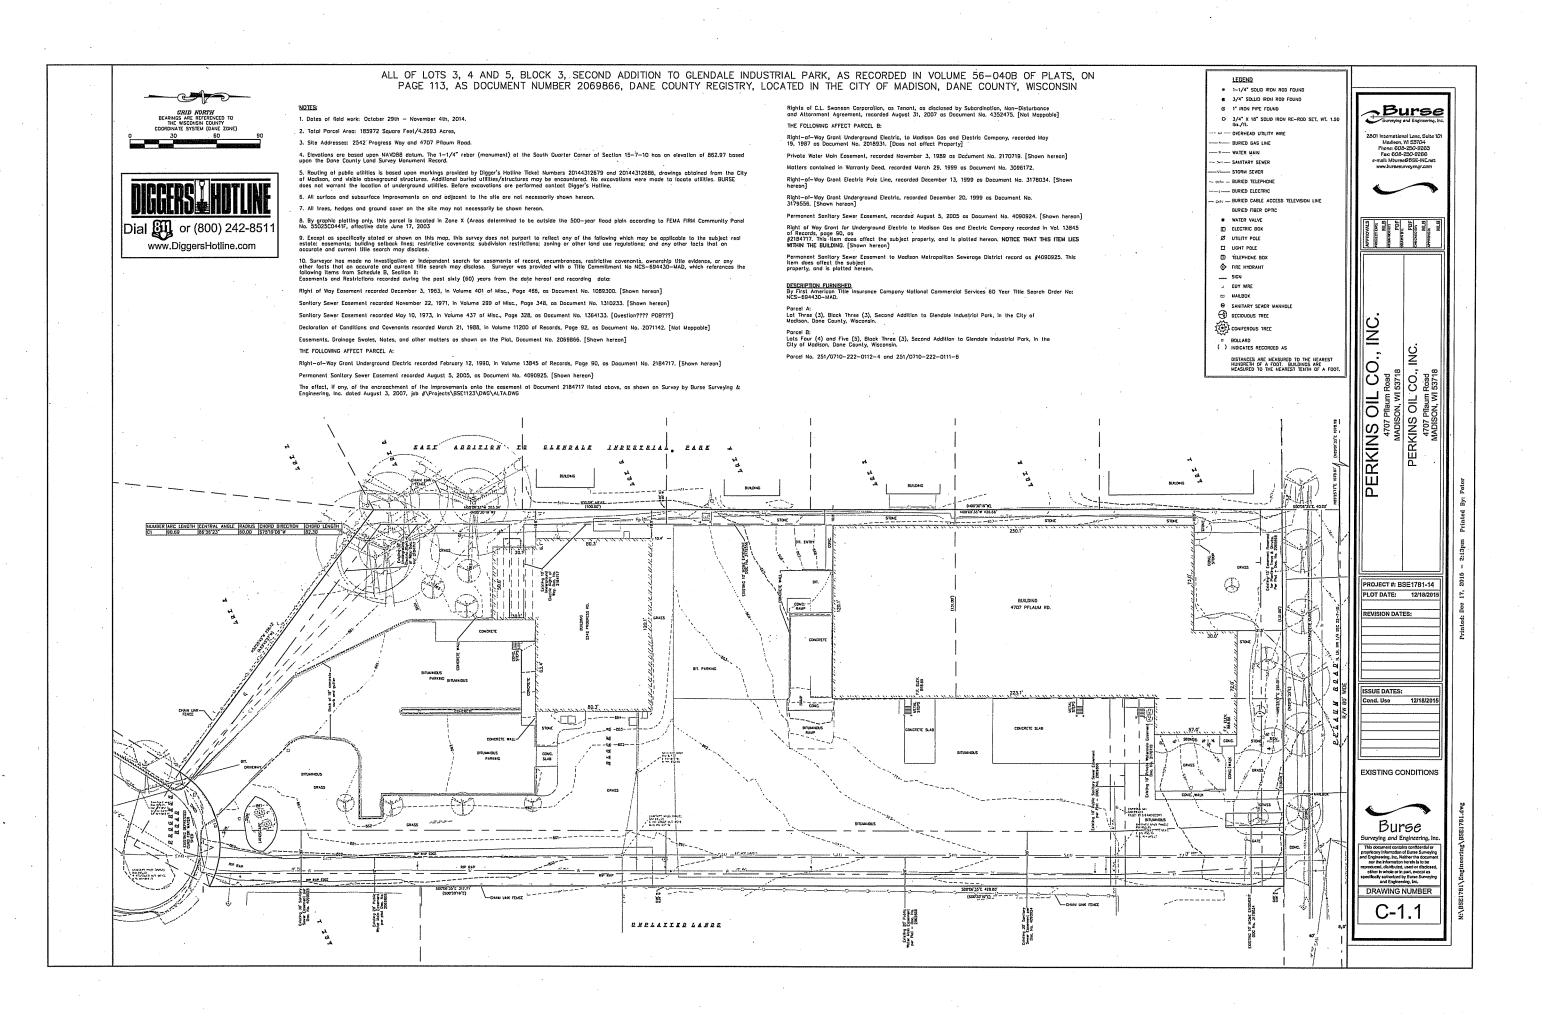



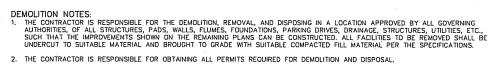

- 3. THE CONTRACTOR SHALL COORDINATE WITH THE RESPECTIVE UTILITY COMPANIES PRIOR TO THE REMOVAL AND/OR RELOCATION OF UTILITIES. THE CONTRACTOR SHALL COORDINATE WITH THE UTILITY COMPANY CONCERNING PORTIONS OF WORK WHICH MAY BE PERFORMED BY THE UTILITY COMPANY FORCING ANY FEES WHICH ARE TO BE PAID TO THE UTILITY COMPANY FOR THEIR SERVICES. THE DEVELOPER IS RESPONSIBLE FOR PAYING ALL FEES AND CHARGES.
- 4. THE LOCATIONS OF ALL EXISTING UTILITIES SHOWN ON THIS PLAN HAVE BEEN DETERMINED FROM THE BEST INFORMATION AVAILABLE AND ARE GIVEN FOR THE CONVENIENCE OF THE CONTRACTOR. THE ENGINEER ASSUMES NO RESPONSIBILITY FOR THEIR ACCURACY, PRIOR TO THE START OF ANY DEMOLITION ACTIVITY, THE CONTRACTOR SHALL NOTIFY THE UTILITY COMPANIES FOR ONSITE LOCATIONS OF EXISTING UTILITIES. NOTIFY THE ENGINEER OF ANY DISCREPANCIES.
- 5. ALL EXISTING SEWERS, PIPING, AND UTILITIES SHOWN ARE NOT TO BE INTERPRETED AS THE EXACT LOCATION, OR AS THE ONLY OBSTACLES THAT MAY OCCUR ON THE SITE. VERIFY EXISTING CONDITIONS AND PROCEED WITH CAUTION AROUND ANY ANTICIPATED FEATURES. GIVE NOTICE TO ALL UTILITY COMPANIES REGARDING DESTRUCTION AND REMOVAL OF ALL SERVICE LINES BEFORE PROCEEDING WITH THE WORK. UTILITIES DETERMINED TO BE ABANDONED AND LEFT IN PLACE SHALL BE GROUTED IF UNDER BUILDING.
- 5. ELECTRICAL, TELEPHONE, CABLE, WATER, FIBER COPTIC CABLE, AND/OR GAS LINES NEEDING TO BE REMOVED OR RELOCATED SHALL BE COORDINATED WITH THE AFFECTED UTILITY COMPANY. ADEQUATE TIME SHALL BE PROVIDED FOR RELOCATION AND CLOSE COORDINATION WITH THE UTILITY COMPANY IS NECESSARY TO PROVIDE A SMOOTH TRANSITION IN UTILITY SERVICE.
- CONTRACTOR SHALL PROTECT THE PUBLIC AT ALL TIMES WITH FENCING, BARRICADES, ENCLOSURES, COVERED WALKWAYS, ETC. CONTRACTOR SHALL SUBMIT THEIR STREET OCCUPANCY PLAN TO TRAFFIC ENGINEERING FOR APPROVAL.
- B. PRIOR TO DEMOLITION OCCURRING, ALL EROSION CONTROL DEVICES ARE TO BE INSTALLED.

EVEL VBDIETOR ZO

- 9. THE CONTRACTOR MAY LIMIT SAWCUT AND PAVEMENT REMOVAL TO ONLY THOSE AREAS WHERE IT IS REQUIRED AS SHOWN ON THESE CONSTRUCTION PLANS, BUT IF ANY DAMAGE IS INCURRED ON ANY OF THE SURROUNDING PAVEMENT, ETC. THE CONTRACTOR SHALL BE RESPONSIBLE FOR ITS REMOVAL AND REPAIR IN KIND.
- 10. DAMAGE TO ALL EXISTING CONDITION TO REMAIN WILL BE REPLACED AT THE CONTRACTOR'S EXPENSE.
- 11. CONTINUOUS ACCESS SHALL BE MAINTAINED FOR THE SURROUNDING PROPERTIES AT ALL TIMES DURING DEMOLITION OF THE EXISTING FACILITIES

REMOVE UTILITIES

· [2][2] .


CLEHDALE INQUERRIAL

EARK

TANGET IN

THELATIFE LANDS

-SAW CUT

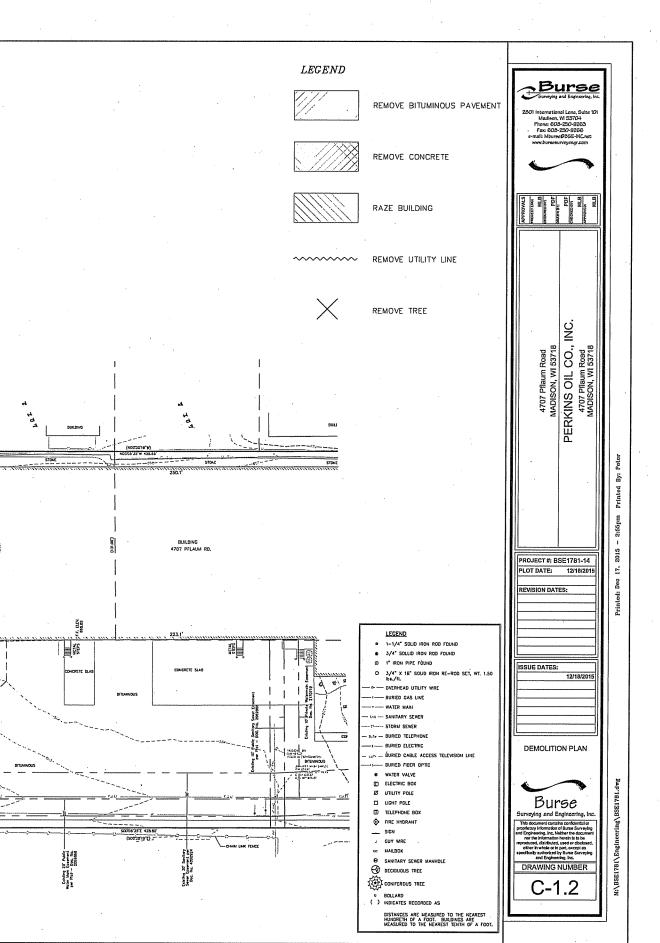





LEGEND EXISTING MINOR CONTOUR PROPOSED FLOOR ELEVATION 861.81 FF

Schedule:

February B, 2016

Begin site demolition

March 1, 2016

Begin foundation excavation/building construction.

August 1, 2016

Building substantially complete. Restore disturbed areas, install landscape installation.

September 15, 2016 Vegetation established.

Erosion Control Notes/Specifications:

1. Erosion control devices and/or structures shall be installed prior to demolition operations. These shall be properly maintained for maximum effectiveness until the site is


Burse


INC


- 2. Erosion control is the responsibility of the contractor until acceptance of this project. Erosion control measures as shown shall be the minimum precautions that will be allowed. The contractor shall be responsible for recognizing and correcting all erosion control problems that are the result of construction activities. Additional erosion control measures, as requested in writing by the state or local inspectors, or the developer's engineer, shall be installed within 24 hours.
- 3. All erosion control measures and structures serving the site must be inspected at least weekly or within 24 hours of the time 0.5 inches of rain is produced. All maintenance will follow an inspection within 24 hours. Inspection schedule and record keeping shall comply with NR 215.45(9), Wis. Adm. Code.
- 4. Construction Entrances Provide a stone tracking pad at each point of access. Install according to WDNR Standard 1057.
- 5. Dewatering Water pumped from the site shall be treated by using a geotextile bag. Sandy soil is expected to be found at the bottom of the excavation, therefore Geotextile Bags shall be Type I per DNR Technical Standard 1061. The following table identifies the size a bag required for a given sized pump. This water shall be discharged in a manner that does not induce erosion of the site or adjacent property.


Pump Size (Max GPM)	Type Boo Size (sq-ft)
50	25
100	50 -
150	75


- 6. Storm Sewer Inlets Provide WDOT Type D "CatchAll" inlet protection or equivalent. Refer to WDOT Product Acceptability List at: http://www.dot.wisconsin.gov/business/engrserv/pol.htm. Inlet protection shall be installed prior to the storm sewer system receiving site runoff. Other than for performing maintenance, these devices shall not be removed until site stabilization is complete.
- 9. Building and waste materials shall be prevented from running-off the site and entering waters of the state in conformance with NR151.12(6m).
- 10. No solid material shall be discharged or deposited into waters of the state in violation of Ch. 30 or 31 of the Wisconsin State Statutes or 33 USC 1344 permits,
- 11. Erosion control devices shall adhere to the technical standards found at: http://dnr.wi.gov/topic/stormwater/standards/const_standards.html and comply with all City of
- 12. All debris tracked onto public streets shall be be swept or scraped clean by the end of each workday.
- 13. All building and waste material shall be handled properly to prevent runoff of these materials off of the site. Contractor shall prepare a concrete management plan.

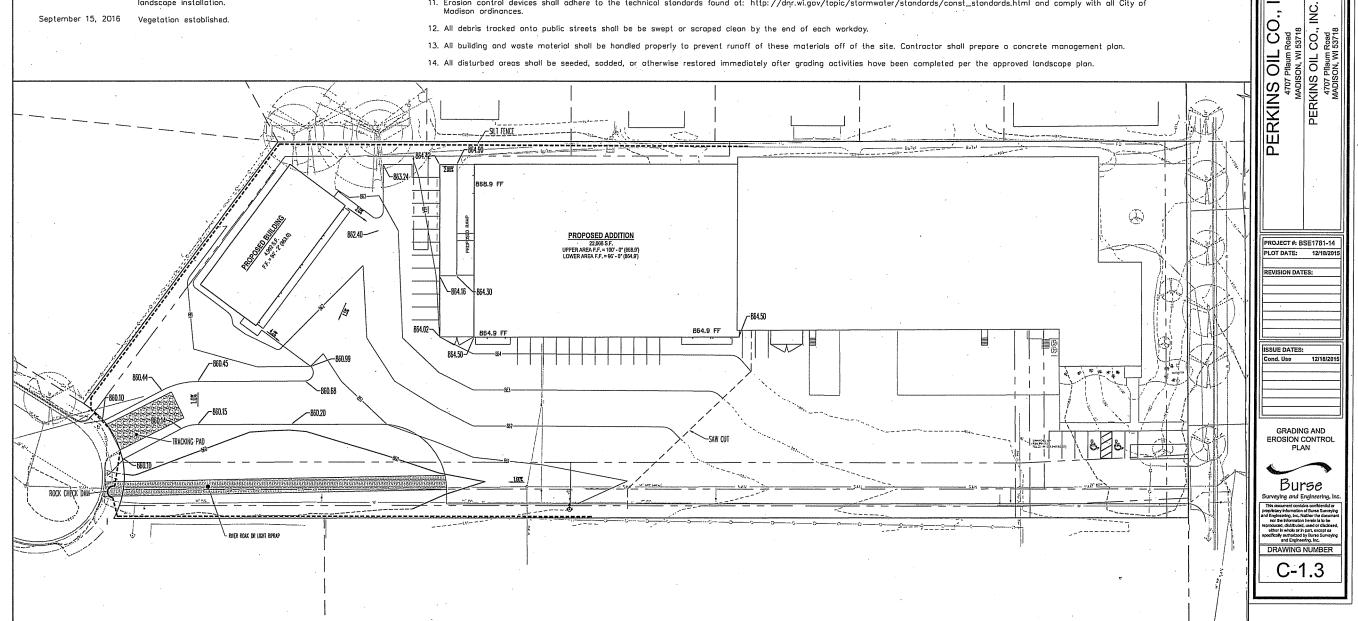

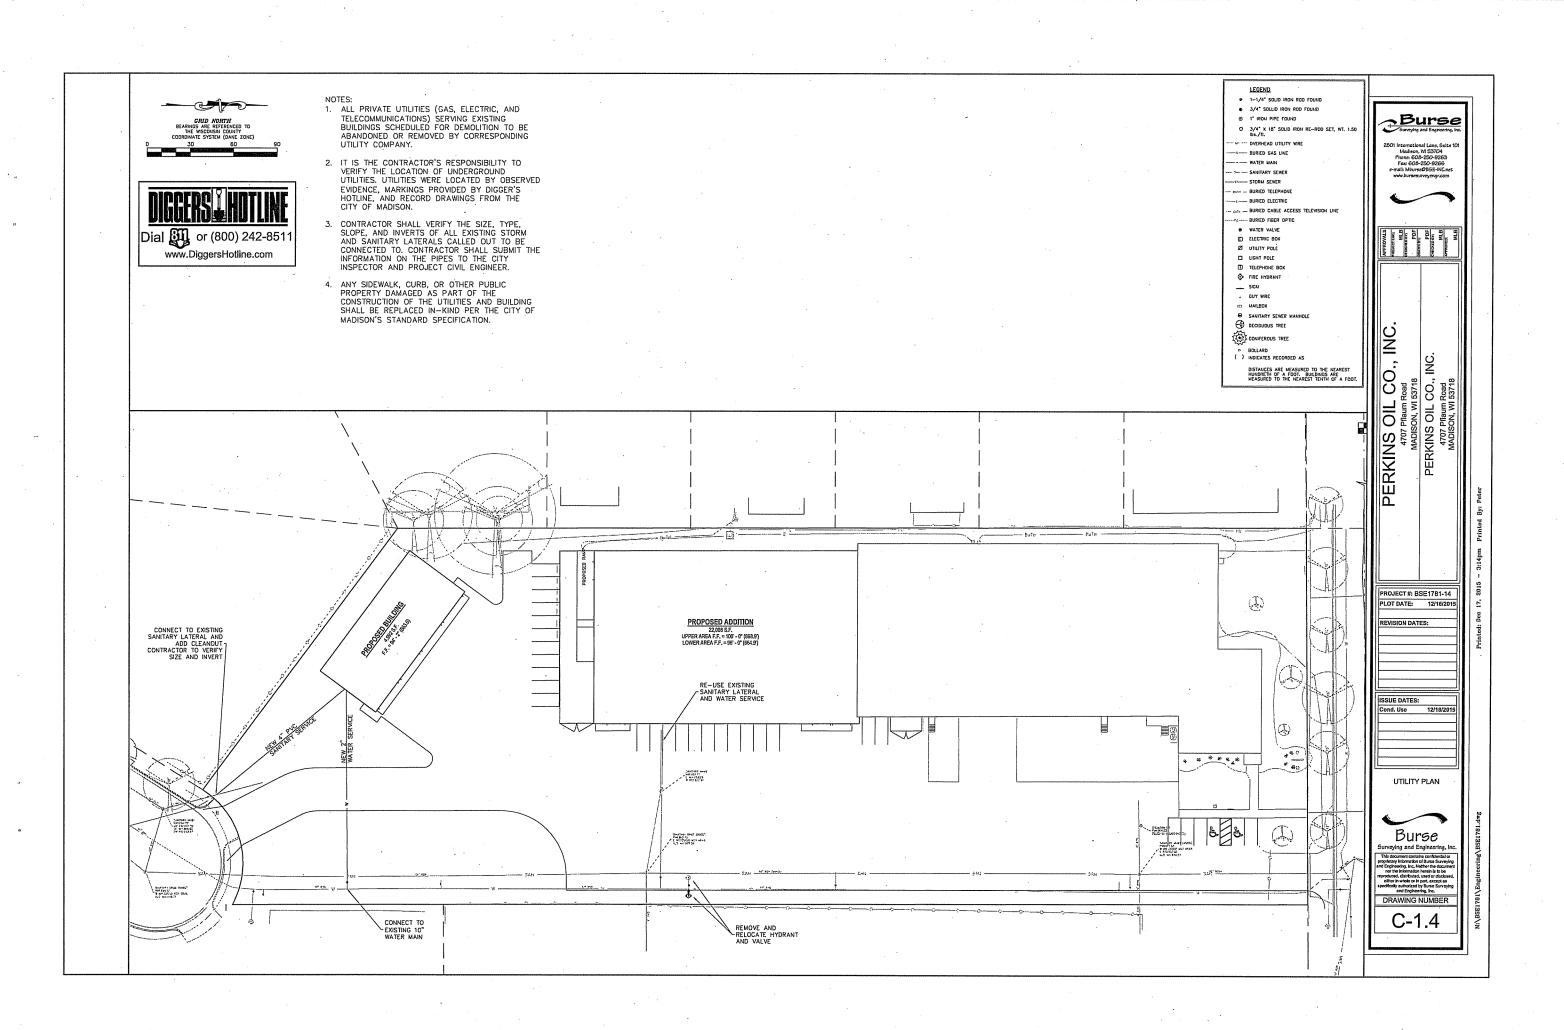

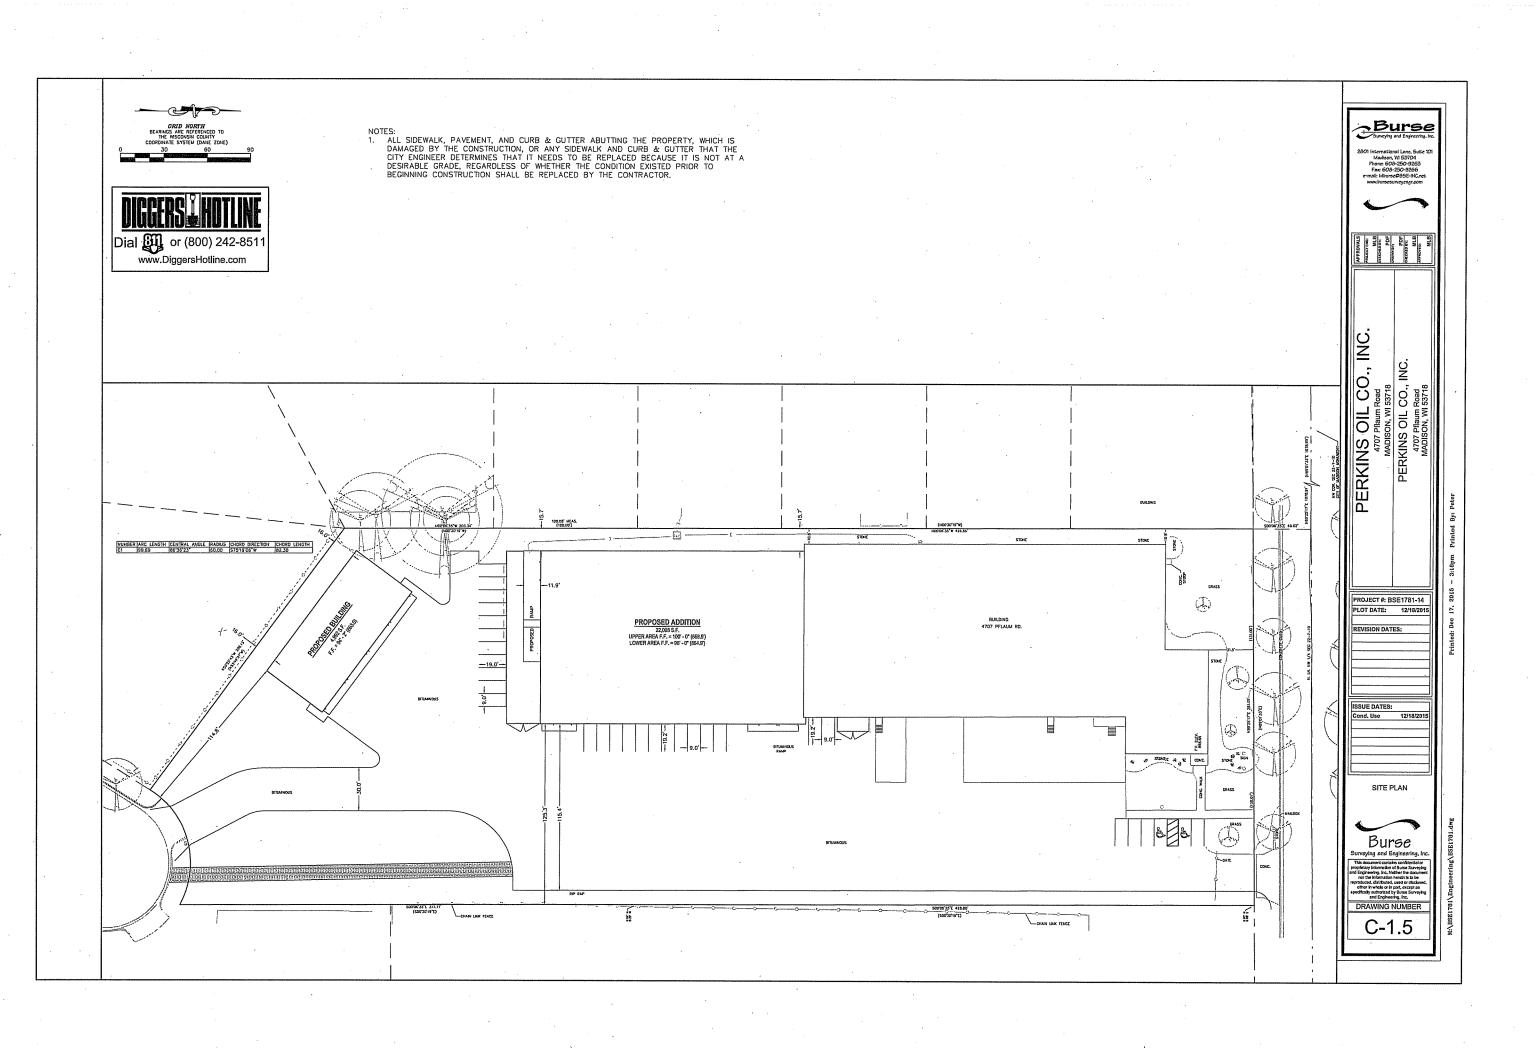

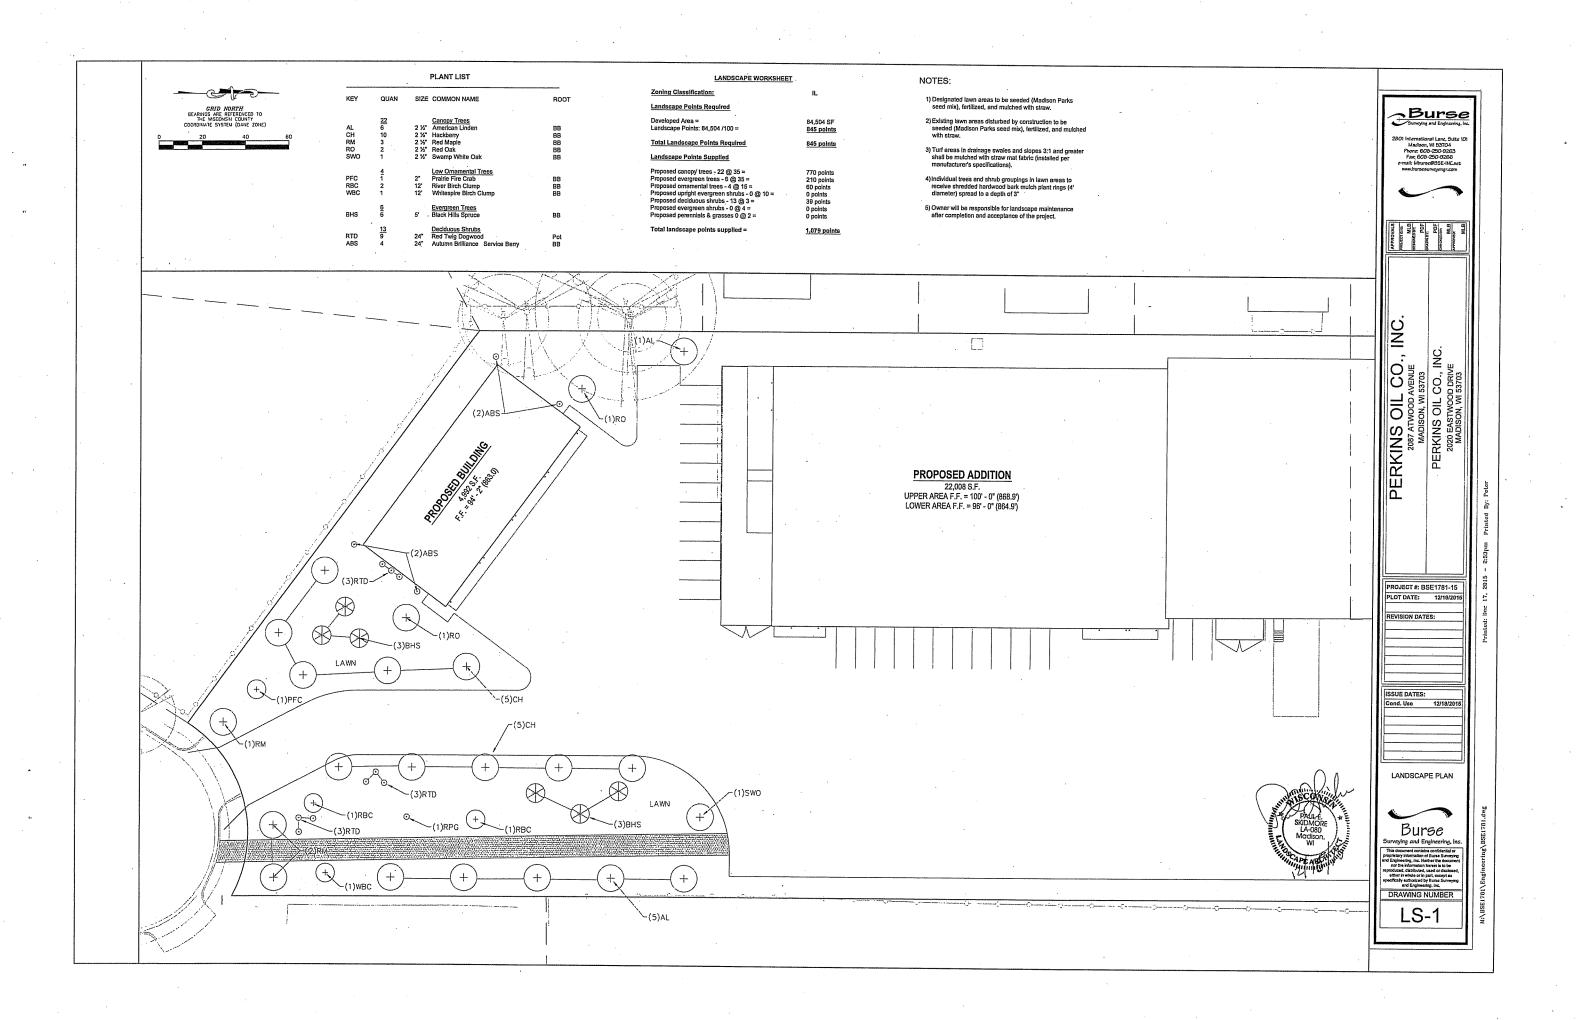

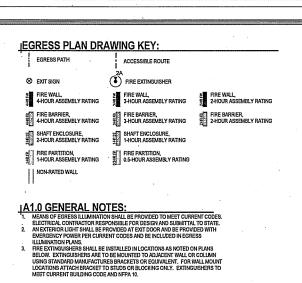

PROPOSED ADDITION 22,008 SF	EXISTING BUILDING 32,863 SF
gross building area	







OCCUPANCY TYPES

B
 S-1


OCCUPANCY AREAS



OCCUPANCY TYPES

3 S-2

4 STORAGE GARAGE OCCUPANCY AREAS

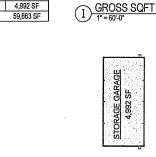

GROSS BUILDING AREA

OCCUPANCY AREAS

OCCUPANCY

S-1

S-2

32,863 SF

22,008 SF

AREA

2,896 SF 616 SF

51,359 SF 4,992 SF 59,863 SF

59,863 SF

EXISTING BUILDING

STORAGE GARAGE GRAND TOTAL:

PROPOSED ADDITION


GROSS BUILDING AREA


STORAGE GARAGE

3 STORAGE GARAGE GROSS SQFT

EXISTING BUILDING

PROPOSED ADDITION

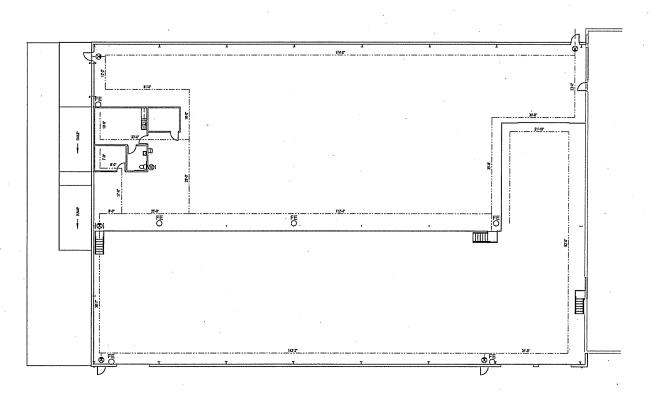

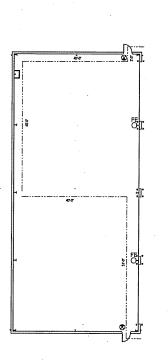

6 STORAGE GARAGE EGRESS PLAN



STRUC RITE

DESIGN, INC

805 Clinton Street

Waukesha, WI 53186 262.549.3222 www.srdinc.biz

1406 EMIL STREET MADISON, WI 608.2718111 608.2716233 IDEALBULDERSINCCOM


SHEET TITLE BUILDING AREAS

PLAN REVIEW

12.02.2015 12.18.2015

PROJECT DATA

5 ADDITION EGRESS PLAN
1/16" = 1'-0"

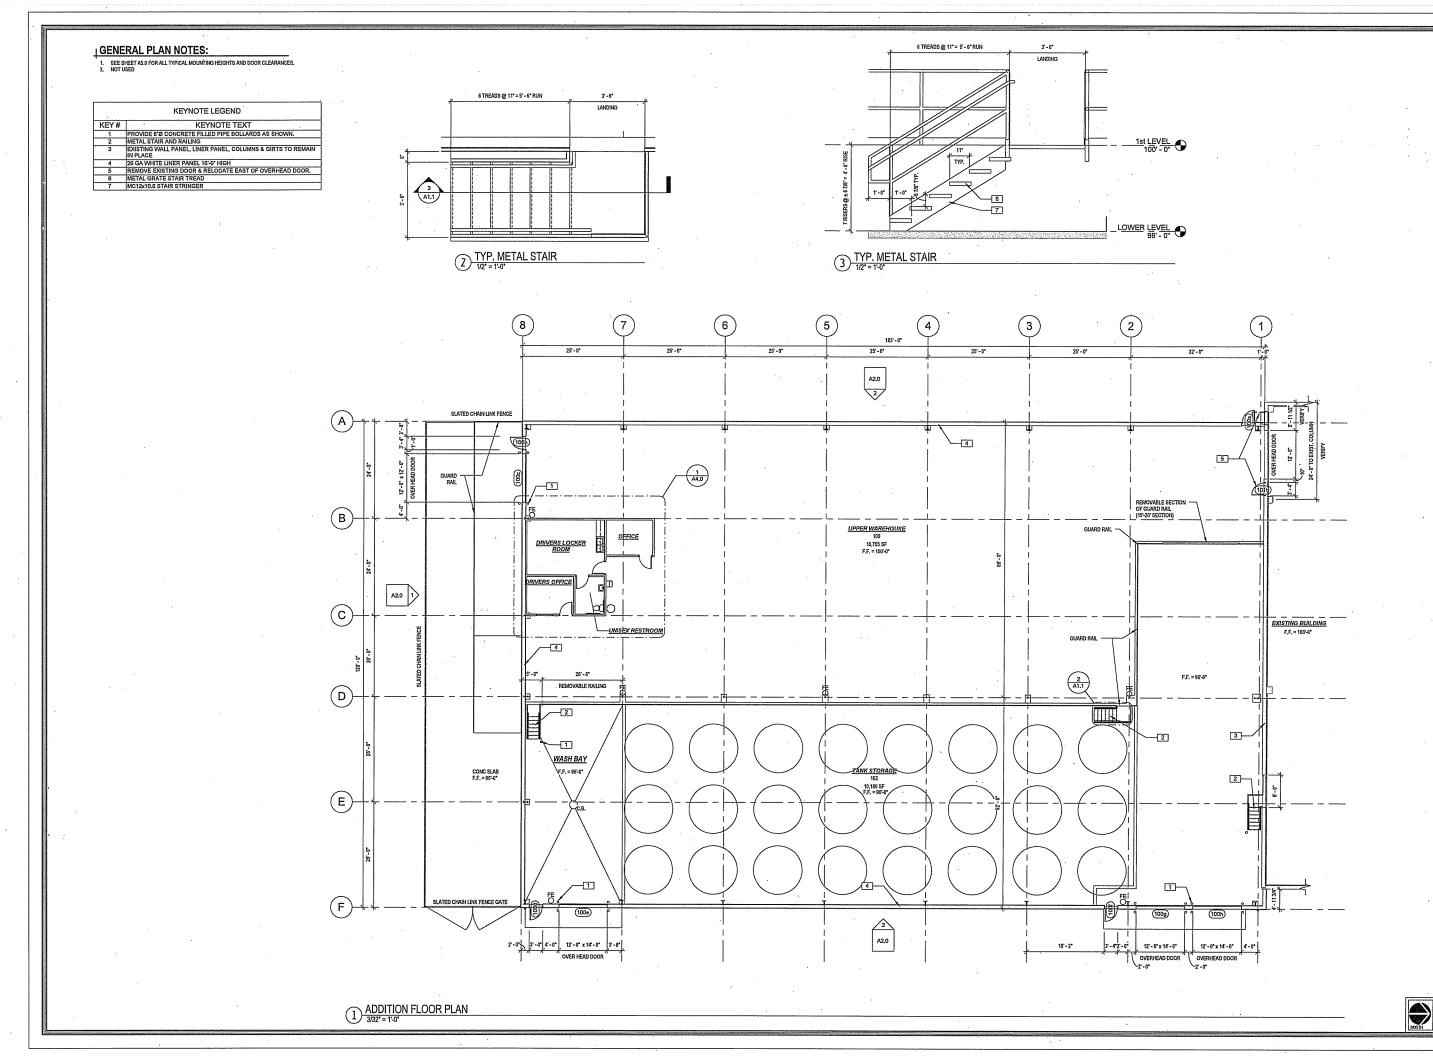





1406 EML STREET MADISON, WI 608.271.8111 608.2716233 IDEALBULDERSINCCOM

IDEAL BUILDERS
PERKINS OIL INC.
4707 PFLAUM ROAD
MADISON, WI 53718

SHEET TITLE

ADDITION - FLOOR PLAN

PLAN REVIEW

12.02.2015 12.18.2015

PROJECT DATA

14-007

ADER:


A1.1

GENERAL ROOF PLAN NOTES:

- ROOFING CONTRACTOR TO INSTALL ALL ROOFING AND INSULATION PER MANUFACTURER'S DETAILS AND SPECIFICATIONS (TYP). PROVIDE ALL REQUIRED MATERIALS AND ACCESSORIES FOR A COMPLETE, WATER-TIG

- COORDINATE ALL ROOF OPENINGS AND PENETRATIONS WITH PLUMBING, MECHANICAL, AND ELECTRICAL CONTRACTORS.
 ROOF-TOP EQUIPMENT SHOWN FOR REFERENCE. SEE MECHANICAL FOR ACTUAL EQUIPMENT AND LOCTIONS, TYPICAL.

	KEYNOTE LEGEND					
KEY#	KEYNOTE TEXT					
1	DELUX PRE-PAINTED GUTTER WITH OPEN DOWNSPOUTS -COLOR: FOX GRAY					
2	24 GA STANDING SEAM METAL ROOF PANEL W/ THERMAL BLOCKS AN					

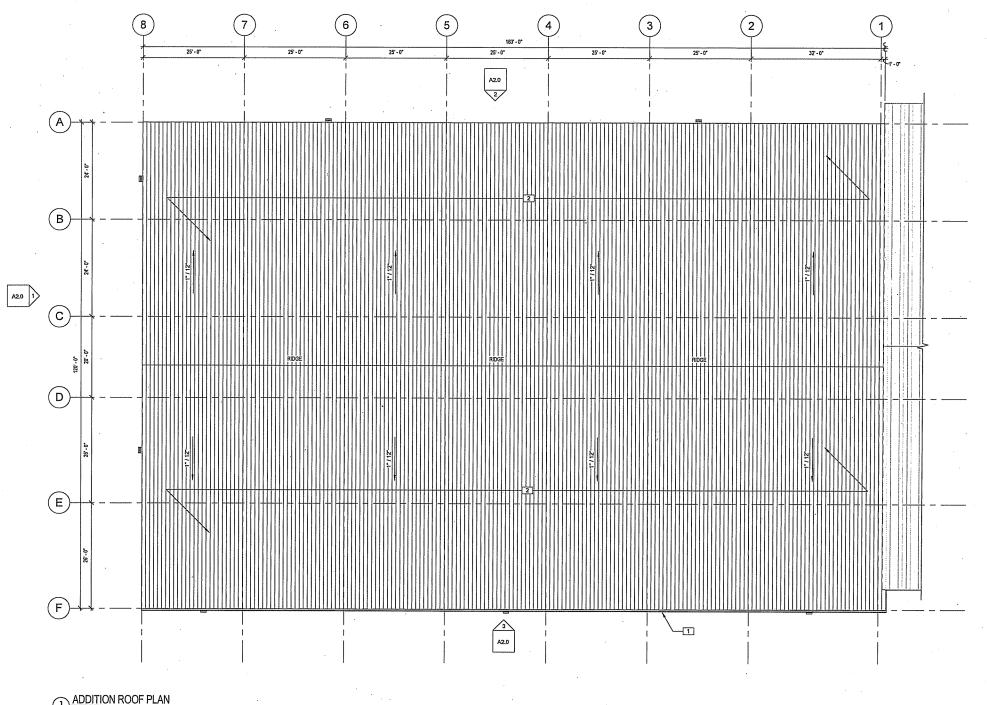



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PERKINS OIL INC. 4707 PFLAUM ROAD MADISON, WI 53718 BUILDERS IDEAL

SHEET TITLE

ADDITION - ROOF PLAN

PLAN REVIEW


12.02.2015

12.18.2015

GENERAL PLAN NOTES:

SEE SHEET A5.0 FOR ALL TYPICAL MOUNTING HEIGHTS AND DOOR CLEARANCES.
 NOT USED

KEYNOTE LEGEND
KEYNOTE TEXT
6" CONCRETE FLOOR SLAB W REINFORCEMENT PER SPEC & VAPOR BARRIER ON 6" COMPRESSED CRUSHED STONE BASE
6"x5"-0"x104"-0" CONCRETE APRON
8" CONCRETE CURB WALL W/ BI-PASS GIRTS (TYPICAL AT SIDE WALL & END WALL) W/ 26 GA WHITE LINER PANEL TO 8'-0" A.F.F.
EXTERIOR COLUMNS TO EXTEND TO 94'-2" (F.F.)
PROVIDE 6"Ø CONCRETE FILLED PIPE BOLLARDS AS SHOWN.
26 GA SCREW DOWN LAP ROOF PANEL -COLOR: GLAVALUME
18'x18' UTILITY SINK, COORDINATE LOCATION WITH GENERAL CONTRACTOR
COORDINATE FINAL LOCATION OF WATER HEATER WITH GENERAL CONTRACTOR

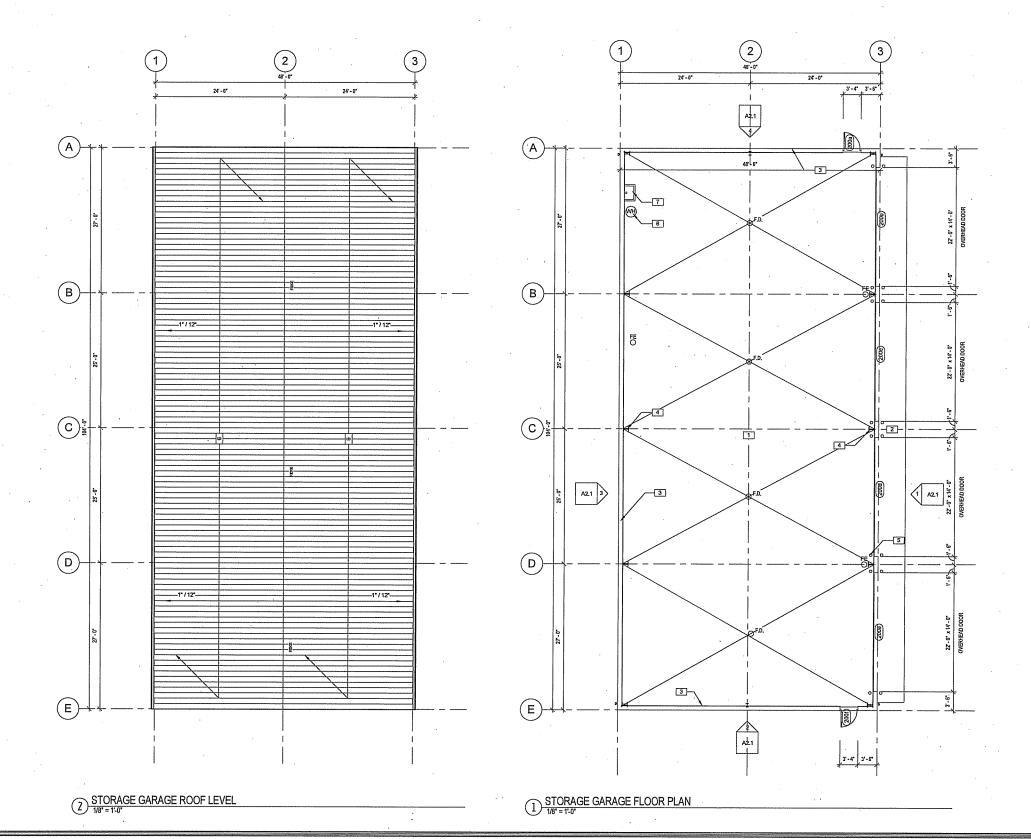



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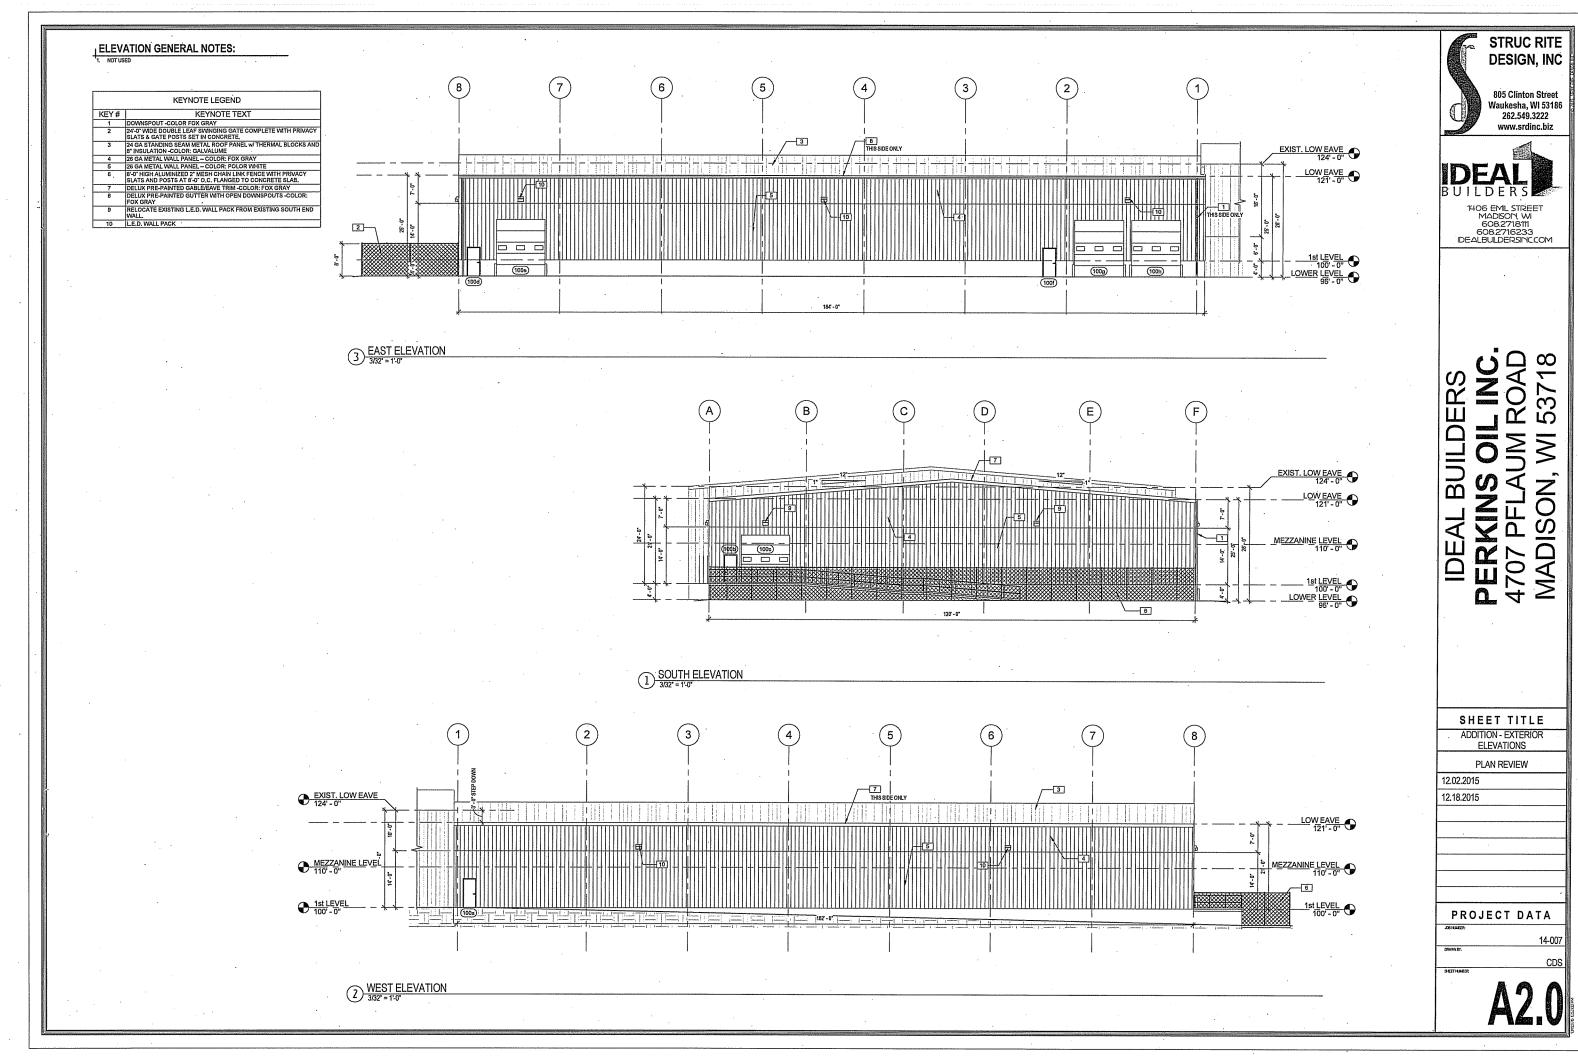
SHEET TITLE STORAGE GARAGE - FLOOR & ROOF PLAN

PLAN REVIEW

12.02.2015


12.18.2015

NONTH



ELEVATION GENERAL NOTES:

	KEYNOTE LEGEND
KEY#	KEYNOTE TEXT
1	DELUX PRE-PAINTED GABLE/EAVE TRIM -COLOR: FOX GRAY
2	26 GA METAL WALL PANEL - COLOR: FOX GRAY
3	26 GA METAL WALL PANEL - COLOR: POLOR WHITE
4	8" CONC CURB WALL - SEE STRUCTURAL DRAWINGS
5	26 GA SCREW DOWN LAP ROOF PANEL -COLOR: GLAVALUME
6	DELUX PRE-PAINTED GUTTER WITH OPEN DOWNSPOUTS -COLOR: FOX GRAY
7	DOWNSPOUT -COLOR FOX GRAY
8	PROVIDE 6"Ø CONCRETE FILLED PIPE BOLLARDS AS SHOWN.
9	L.E.D. WALL PACK

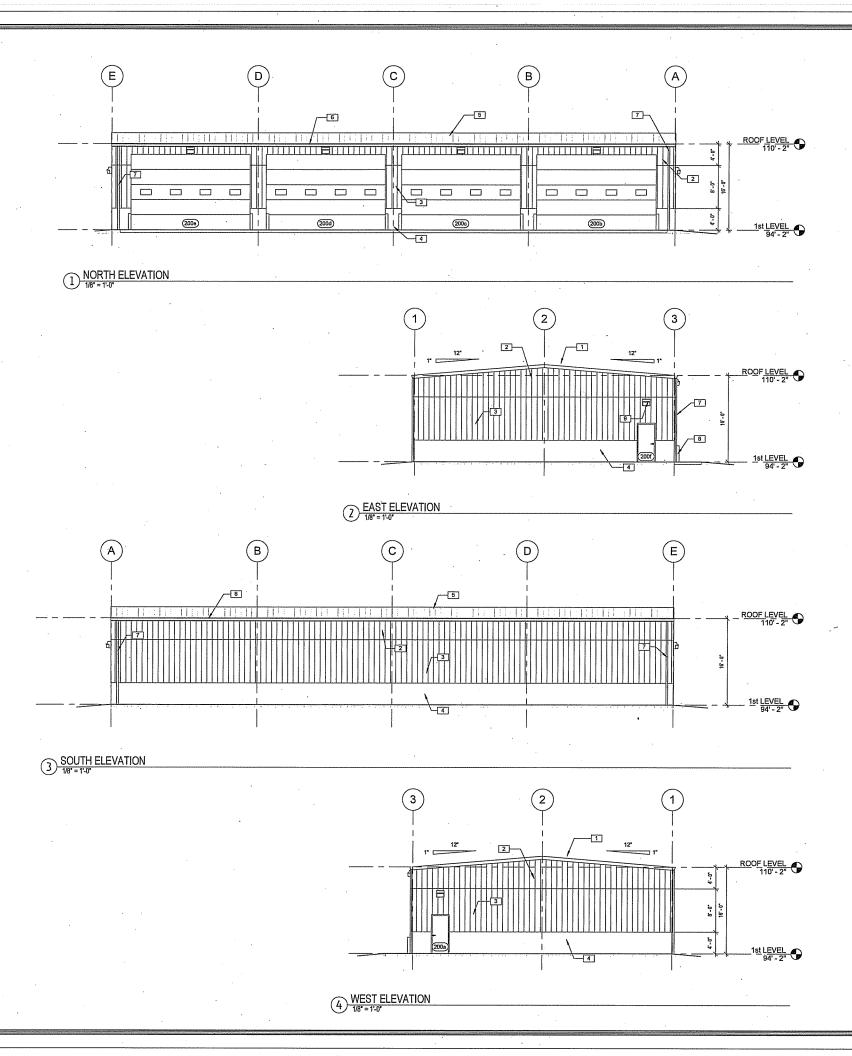





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SHEET TITLE
STORAGE GARAGE - EXTERIOR
ELEVATIONS

PLAN REVIEW


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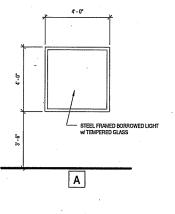
| RESTROOM NOTES:

1. IF FLOOR FINISHES ARE NOT SPECIFIED AND BEING DONE BY OTHERS THE MUST CONFORM WITH THE FOLLOWING. IN A TOILET AND BATHING ROOMS THE FLOOR SURFACE SHALL HAVE A SMOOTH, HARD, NOMASSORBERT SURFACE THAT EXTENDS UPWARD DONTO THE WALLS AT LEAST 6 INCIDENT OF THE PLOOR OF THE PLOOR AND THE WALLS AS THE NOT SPECIFIED AND BEING DONE BY OTHERS THE MUST CONFORM WITH THE FOLLOWING. ALL WALLS IN TOILET AND BATHING ROOMS SHALL HAVE A SMOOTH, HARD NOMASSORBENT SURFACE, TO A HEIGHT OF 4-0" THE FLOOR AND THE MATERIALS USED IN SUCH WALLS SHALL BE A TYPE THAT IS NOT ADVERSELY AFFECTED BY MOISTURE.


KEYNOTE LEGEND	
KEY#	KEYNOTE TEXT
1	PROVIDE 30"x36" RESTROOM MIRROR, SEE SHEET A5.0 FOR MOUNTING HEIGHTS. PROVIDE BLOCKING AS REQUIRED.
2	GRAB BARS, SEE SHEET A5.0 FOR MOUNTING HEIGHTS. PROVIDE BLOCKING AS REQUIRED.
3	PROVIDE TOILET PAPER DISPENSER, SEE SHEET A5.0 FOR MOUNTING HEIGHT AND LOCATION. PROVIDE BLOCKING AS REQUIRED.
4	PROVIDE A.D.A. SIGNAGE AS REQUIRED. SEE SHEET A5.D
5	8'-0" LAMINATED BASE AND WALL CABINETS
6	8'-0" LAMINATED COUNTER TOP.
7	PROVIDE 13'x13" CERAMIC TILE W/6" BASE TILE AT PERIMITER IN RESTROOM
В	PROVIDE VINYL COMPOSITE FLOOR TILE W 4" HIGH VINYL BASE AT BOTH SIDES OF WALL UNLESS NOTED OTHERWISE.
9	PROVIDE 2'x4' LAY-IN ACOUSTIC TILE WITH SUSPENDED CEILING GRID AT 8'-0' A.F.F.
10	PROVIDE 2'x4' SUSPENDED VINYL COVERED GYP BRD CEILING AT 8'-0' A.F.F.
11	WALL MOUNTED ELECTRIC WATER COOLER
12	STAINLESS STEEL SINK & FAUCET. TOP OF SINK TO BE 34" A.F.F. PER ADA REQUIREMENTS.
13	COORDINATE FINAL LOCATION OF WATER HEATER WITH GENERAL CONTRACTOR



<u>i2</u>

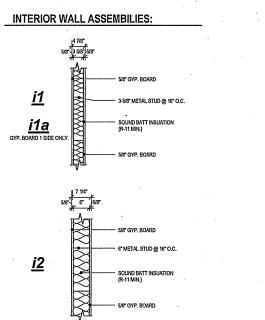

BORROWED LIGHT LEGEND

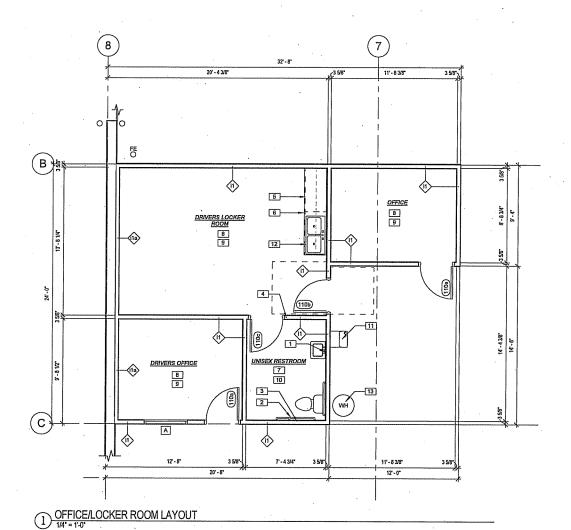





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DETAIL PLANS
PLAN REVIEW
12.02.2015
12.21.2015
PROJECT DATA
.58HARGER 14-
DRANKI BY:

SHEET TITLE