

Development Schedule: Commencement

LAND USE APPLICATION

CITY OF MADISON

- All Land Use Applications should be filed with the Zoning Administrator at the above address.
- The following information is required for all applications for Plan Commission review except subdivisions or land divisions, which should be filed using the Subdivision Application.
- This form may also be completed online at: www.cityofmadison.com/developmentcenter/landdevelopment

Provide a brief description of the project and all proposed uses of the site:

Above grade addition to house equipment for existing sewer pump station. Also, new public restrooms for the park.

Completion

Madison _m	•					
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	King Jr. Blvd; Room LL-100		ł	Rece		
	lison, Wisconsin 53701-298		Date Received			
Piloffe: 608.266.46	535 Facsimile: 608.267.87	3 9	Received By			
 All Land Use Applica 	tions should be filed with the Z	Zoning	Parcel No			
Administrator at the	above address.		Aldermanic Dis	trict		
The following inform	nation is required for all applica	ations for Plan	Zoning District		·	
_	except subdivisions or land div		Special Require	ements		
should be filed using	the Subdivision Application.		Review Require	ed By:		
This form may also b	e completed online at:		Urban Desi	gn Commission	Plan Con	nmission
	.com/developmentcenter/land	development	Common C	ouncil	Other: _	
			Fo	rm Effective: Febr	uary 21, 2013	
Drojoet Addross	1215 Allen Boulevard, Ma	adison WI 53705				
L. Project Address:		 		4 E		
Project Title (if a	ny): Madison Metropolitan Sev	werage District -	Pump Station	15		
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5.	Required Submittal Information
All	I Land Use applications are required to include the following:
1	Project Plans including:*
	 Site Plans (<u>fully dimensioned</u> plans depicting project details including all lot lines and property setbacks to buildings; demolished/proposed/altered buildings; parking stalls, driveways, sidewalks, location of existing/proposed signage; HVAC/Utility location and screening details; useable open space; and other physical improvements on a property)
	Grading and Utility Plans (existing and proposed)
	Landscape Plan (including planting schedule depicting species name and planting size)
	Building Elevation Drawings (fully dimensioned drawings for all building sides, labeling primary exterior materials)
	Floor Plans (fully dimensioned plans including interior wall and room location)
	Provide collated project plan sets as follows:
	 Seven (7) copies of a full-sized plan set drawn to a scale of 1 inch = 20 feet (folded or rolled and stapled) Twenty Five (25) copies of the plan set reduced to fit onto 11 X 17-inch paper (folded and stapled)
	 One (1) copy of the plan set reduced to fit onto 8 ½ X 11-inch paper
7	* For projects requiring review by the Urban Design Commission, provide Fourteen (14) additional 11x17 copies of the plan set. In addition to the above information, all plan sets should also include: 1) Colored elevation drawings with shadow lines and a list of exterior building materials/colors; 2) Existing/proposed lighting with photometric plan & fixture cutsheet; and 3) Contextual site plan information including photographs and layout of adjacent buildings and structures. The applicant shall bring samples of exterior building materials and color scheme to the Urban Design Commission meeting. Letter of Intent: Provide one (1) Copy per Plan Set describing this application in detail including, but not limited to: Project Team Building Square Footage Number of Dwelling Units Project Schedule Auto and Bike Parking Stalls Proposed Uses (and ft² of each) Lot Coverage & Usable Open Time Equivalent Jobs Created Public Subsidy Requested
	Filing Fee: Refer to the Land Use Application Instructions & Fee Schedule. Make checks payable to: City Treasurer.
<u></u>	Electronic Submittal: All applicants are required to submit copies of all items submitted in hard copy with their application as Adobe Acrobat PDF files on a non-returnable CD to be included with their application materials, or by e-mail to pcapplications@cityofmadison.com .
	Additional Information may be required, depending on application. Refer to the <u>Supplemental Submittal Requirements.</u>
6.	Applicant Declarations
V	Pre-application Notification: The Zoning Code requires that the applicant notify the district alder and any nearby neighborhood and business associations in writing no later than 30 days prior to FILING this request. List the alderperson, neighborhood association(s), and business association(s) AND the dates you sent the notices: Alder Mark Clear: notified in June. Open neighborhood meeting July 14, 2015

proposed development and review process with Zoning and Planning Division staff; note staff persons and date.

**Planning Staff: Tim Parks / Al Martin Date: March 20, 2015 Zoning Staff: Matt Tucker Date: December 8, 2015

**December 8, 2015 December 8, 2015 Date: Date: Date: December 8, 2015 Date: Date: December 8, 2015 Date: Date: Date: December 8, 2015 Date: Dat

→ If a waiver has been granted to this requirement, please attach any correspondence to this effect to this form.

Pre-application Meeting with Staff: Prior to preparation of this application, the applicant is required to discuss the

The applicant attests that this form is accurately completed and all required materials are submitted:

Name of Applicant Erik Rehr

Relationship to Property: MMSD Engineer

Authorizing Signature of Property Owner







Letter of Intent-City of Madison Planning Commission

Pumping Station 15 2115 Allen Boulevard

Madison Metropolitan Sewerage District December 18, 2015

Project Team

The project design team includes Baxter & Woodman (Lead), Potter Lawson, Inc. (Architect), Ken Saiki Design (Landscape Architecture), Sustainable Engineer Group (Solar Panel Design), Karen Kabbes (ISI Envision Coordinator), CGC, Inc. (Geotechnical) and MMSD District staff. Key personnel for each team are shown in Table 1.

TABLE 1
Project Design Team

Firm	Person	Role
Baxter & Woodman, Inc. (Lead)	Jim Kleinschmidt	Overall Project Manager
	Amanda Heller	Project Engineer
	Adam Stec	Structural Engineer
	Lee Rita Rigos	Controls
	Elizabeth Quimby	Electrical Engineer
Potter Lawson, Inc (Architect)	Doug Hursh	Project Manager
	Andy Laufenberg	Project Architect
Ken Saiki Design(Landscape Architect)	Nik Swartz	Landscape Architect
Karen Kabbes Engineering (ISI Envision Coordinator	Karen Kabbes	ISI Envision
CGC, Inc (Geotechnical)	Bill Wuellner	Geotechnical Engineering
Sustainable Engineering Group	Jon Evans	Solar Panel Design
	Andy DeRocher	Solar Panel Design

Firm	Person	Role
Madison Metropolitan Sewerage	Erik Rehr	Project Manager
District		
	Michael Mucha	Chief Engineer
	Bruce Borelli	Director of Engineering
	Claudia Haack	Director of Sustainable Asset
		Management
	Dave Lundey	Electrical Construction
		Supervisor
	John Bembinster	Electrical Engineer

Existing Conditions and Project Description

The pumping station is located within an easement in the northwest corner of Marshall Park on the far west site boundary between Madison and Middleton. The current station is mostly underground and extends about 24" above the grade. There is also a large external transformer and switch gear on the site for the station.

The original pumping station was built in 1974 and serves Madison, Middleton, and the town of Westport. The station operates on a continuous basis every day of the year. The proposed project will create a pumping station superstructure to house electrical and HVAC equipment. A building addition will also be constructed to the north of the existing pumping station. The new structure will house new electrical and mechanical equipment needed to upgrade and renovate the existing pump station. Restrooms are also included in the project. The restrooms will be owned and maintained by the City of Madison Parks Department but funding for the project will be provided by the Madison Metropolitan Sewerage District. There will also be an aquatic invasive species control center to allow boaters to remove materials from their boats prior to leaving Marshall Park.

The design process has followed the Institute for Sustainable Infrastructure (ISI) Envision guidelines and has taken into consideration community needs. A bike repair station will be located near the Allen Boulevard bike as an amenity for bikers; also a new sidewalk connection from the bike path will provide an accessible route to the bike station, pump station building, and Marshall Park. The restrooms and Aquatic Invasive Species Control Center were added after public comments requesting both project elements.

A public meeting was held on July 14, 2015 in Marshall Park. Alders for both Madison and Middleton were present in addition to about 20 members of the public. Presentations were made by the Design Team and were followed by questions from the public in attendance. The most overwhelming request was to provide better access to restrooms in Marshall Park and to provide an aquatic invasive species control center. After negotiations between the City of Madison Parks and Madison Metropolitan Sewerage District, the District agreed to finance and facilitate the construction of the restrooms. Upon completion of the restrooms and the aquatic invasive species control center, the District will deed these over to the City of Madison who will be responsible for the ongoing maintenance of these facilities. The restrooms will be open from 7 AM to 10 PM from about April 15th to November 15th.

As part of the MMSD's mission to protect water (groundwater and surface water), a green roof, bio swale/dry steam bed, bioretention basin, and permeable pavers are used to manage storm water runoff on-site. Runoff from the restrooms and the Aquatic Invasive Species Control Center will drain to a bioretention basin where the runoff can be temporarily staged and allowed to infiltrate back into the soil. The built storm water management control features are designed to enhance the site while showcasing the District's commitment to water quality.

Some minor grading will occur on the west and north sides of the pump station building to enhance and integrate the bio swale/dry stream bed with existing site drainage patterns. Invasive species within the MMSD easement will be eradicated during the site clearing and re-grading process and restored with a low-maintenance turf. Proposed plantings consist of native and native cultivar trees, shrubs and perennials that will provide multi-seasonal interest. The proposed species have been carefully selected to ensure a low-maintenance landscape that will require minimal supplemental water or fertilizer which is consistent with ISI Envision Guidelines and MMSD's mission of protecting water resources.

Indigenous and locally sourced decorative stone in the form of accent boulders, cobbles, and mulch will be concentrated around roof scuppers while directing runoff to the storm water management feature to dissipate concentrated roof runoff volumes and provide filtration, cooling, and temporary staging of runoff while directing runoff to the storm water management features. Decorative stone material will also be integrated throughout the site to create a holistic landscape composition.

The sloped roof allows for translucent clerestory panels that allow daylight into the both the pumping station and the restrooms. Windows will be provided along the south side of the building to allow people to see the inner workings of the facility.

The building will include photovoltaic panels to generate about 8kW of power at full sun. This will provide about 30 percent of the required kW to operate one of the pumps in PS 15. The sloped roof on both the Pumping Station and restrooms allow for translucent clerestory panels that allow daylight into the facility. Windows will be provided along the south side of the building to allow people to see the inner workings of the facility. There will be a station status display for visitors to view. An informational kiosk will also be provided for educational purposes. If approved by the County, we will also likely have a bike trail map located near the bike station.

The site development was designed to minimize the elimination of critically needed boat trailer parking in Marshall Park. Design features were included to maintain the existing boat trailer parking stalls and minimize the exposure of the pumping station to boat trailer parking. Equipment for the station will be removed from the building using the double door entrance on the east side of the building along with the concrete pad extension.

The building materials will be durable and cleanable. The walls are constructed of burnished concrete blocks in a range of warm neutral colors to create a subtle range similar to natural stone. Cement board and composite wood siding will be used for the clerestory and roof fascia.

The project is expected to create 27,000 hours of work for both contractors and consulting engineers. There will be no additional full time equivalent jobs created by this project.

Figures 1 and 2 show the existing location of PS 15 in relation to Marshall Park.

FIGURE 1 MMSD PS 15-Allen Boulevard towards Marshall Park



FIGURE 2

Relationship of MMSD PS 15 to Marshall Park



-Project Schedule

Table 2 shows the proposed bidding and construction schedule for PS 15.

TABLE 2

Bidding and Construction Schedule-PS 15

Urban Design Commission Information Meeting	August 12, 2015
City of Madison Planning Commission Submittal	December 21, 2015
Submittal to Madison Parks	December 21, 2015
Madison Parks Commission Meeting	January 13, 2016
Urban Design Commission Meeting	February 10, 2016
Madison Plan Commission Meeting	February 22, 2016
City Council Approval-Conditional Use Permit	March 1, 2016
Advertise Project for Bids	March 1, 2016
Open Bids	March 31, 2016
Project Award-Contractor	April 14, 2016
Construction Begins	May 2016
Project Erosion Controls Completed	May 31, 2016
Building Addition Foundation	August 31, 2016
Meter Vault and Force Main Connection Manhole	August 31, 2016
Site Work and Paving (Binder Course Only)-Start Date	September 6, 2016
Bathroom Construction	October 31, 2016
Site Work and Paving (Binder Course Only)	October 31, 2016
Pumping Station Building Completion	December 2016
Final Paving	May 31,2017
Project Completion	September 30, 2017

Building Sizes, Lot Coverage, Estimated Project Cost and Bike Stalls

The Pumping Station will be 1,650 square feet while the restrooms will be 380 square feet. The easement for PS 15 is 21,000 square feet. A portion of the construction will take place outside of the easement in both Marshall Park as well as in the City of Middleton storm sewer easement. The estimated project cost including the restrooms is \$3,800,000. The bike station will be provided with 4 stalls for bike parking.

RUBIX - model: WS-W2504, WS-W2505

LED Wall Mount

WAC LIGHTING

Responsible Lighting®



Fixture Type:	
Catalog Number:	
Project:	_
Location:	_

PRODUCT DESCRIPTION

Available in single- and twin-light configurations, this die cast aluminum LED wall luminaire is wet location listed for a broad range of exterior lighting applications. Designed with a square profile, this version of Rubix mounts upwards or downwards.

FEATURES

- Energy Star® rated
- CEC Title 24 Compliant
- · Mounts up or down
- IP65 Rated, ETL & cETL Wet Location Listed
- · Die-Cast Aluminum Construction
- Universal Voltage Input (120V 277V)
- Dimming: ELV (120V) or 0-10V

SPECIFICATIONS

Construction: Aluminum with etched glass. **Power:** Integral driver in luminaire. 120V - 277V input.

Light Source: High output LED

Mounting: Mounts directly to junction box **Dimming:** 0-10V Dimming: 100%-10%

ELV Dimming: 100%-15% (120V only)

Finish: Brushed Aluminum (AL), Black (BK), Bronze (BZ), Graphite (GH), White (WT)


Color Temp: 3000K

CRI: 90

Rated Life: 70,000 hours

Standards: Energy Star® rated, IP65 Rated, ETL & cETL Wet Location Listed,

CEC Title 24 Compliant, Dark Sky Friendly.

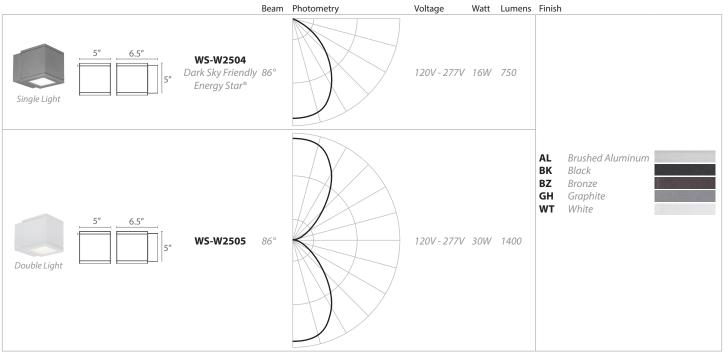




Example: WS-W2504-GH

waclighting.com Phone (800) 526.2588 Fax (800) 526.2585 Headquarters/Eastern Distribution Center 44 Harbor Park Drive Port Washington, NY 11050 Central Distribution Center 1600 Distribution Ct Lithia Springs, GA 30122 **Western Distribution Center** 1750 Archibald Avenue Ontario, CA 91760

MADISON METROPOLITAN SEWERAGE DISTRICT MADISON, WISCONSIN

PUMPING STATION 15 REHABILITATION CITY OF MADISON PLANNING COMMISION SUBMITTAL

Madison Metropolitan Sewerage District

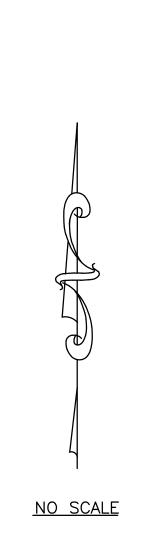



of Madison Planning Commission Submittal

List of Drawings

	List of Drawings				
Drawing	Title				
Number					
A-01	Floor Plan				
A-02	Elevations				
A-03	Elevations				
A-04	Perspectives				
A-05	Perspectives				
L-01	Landscape Plan				
L-02	Site Rendering				
C-1	Demolition Site Plan (Existing Conditions)				
C-2	Site Plan & Erosion Control				
C-3	Mechanical Site Plan (Utilities)				
C-6	Electrical Site Plan (Photometrics)				
M-3	Upper Plan-Mechanical				

-PROJECT LOCATION

EXISTING UTILITIES:

WHERE THE DRAWINGS INCLUDE INFORMATION PERTAINING TO THE LOCATION OF UNDERGROUND UTILITY FACILITIES, SUCH INFORMATION REPRESENTS ONLY THE OPINION OF THE ENGINEER AS TO THE LOCATION OF SUCH UTILITIES. THE INFORMATION IS INCLUDED ONLY FOR THE CONVENIENCE OF THE CONTRACTOR. THE UTILITY LOCATIONS WERE DETERMINED FROM THE BEST AVAILABLE RECORDS. THE ENGINEER AND OWNER ASSUME NO RESPONSIBILITY WHATEVER WITH RESPECT TO THE SUFFICIENCY OR ACCURACY OF THE INFORMATION SHOWN ON THE DRAWINGS REGARDING THE LOCATION OF UNDERGROUND UTILITY FACILITIES OR THE MANNER IN WHICH THEY ARE TO BE REMOVED OR ADJUSTED. IT SHALL BE THE CONTRACTOR'S RESPONSIBILITY TO DETERMINE THE ACTUAL LOCATION OF ALL SUCH FACILITIES. THE CONTRACTOR SHALL OBTAIN FROM THE RESPECTIVE UTILITY COMPANIES DETAILED INFORMATION REGARDING THE LOCATION OF THE UTILITY FACILITIES AND THE WORKING SCHEDULES OF THE UTILITY COMPANIES FOR REMOVING OR ADJUSTING THE FACILITIES.




TO OBTAIN LOCATION OF PARTICIPANT'S UNDERGROUND FACILITIES BEFORE YOU DIG IN WISCONSIN

1-800-242-8511
TOLL FREE

WIS. STATUTE 182.0175 (1974)
REQUIRES MIN. OF 3 WORK DAYS
NOTICE BEFORE YOU EXCAVATE.





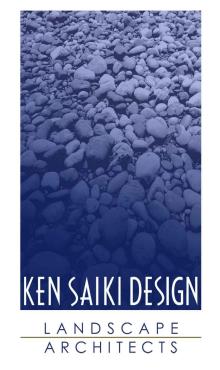




BAXTER & WOODMAN, INC. STATE OF WISCONSIN — PROFESSIONAL DESIGN FIRM LICENSE NO. — 484—011 — EXPIRES 1/31/2016


NOT FOR BIDDING

PROJECT NO.: 140963


DATE: 12/18/15

LAND USE SUBMITTAL

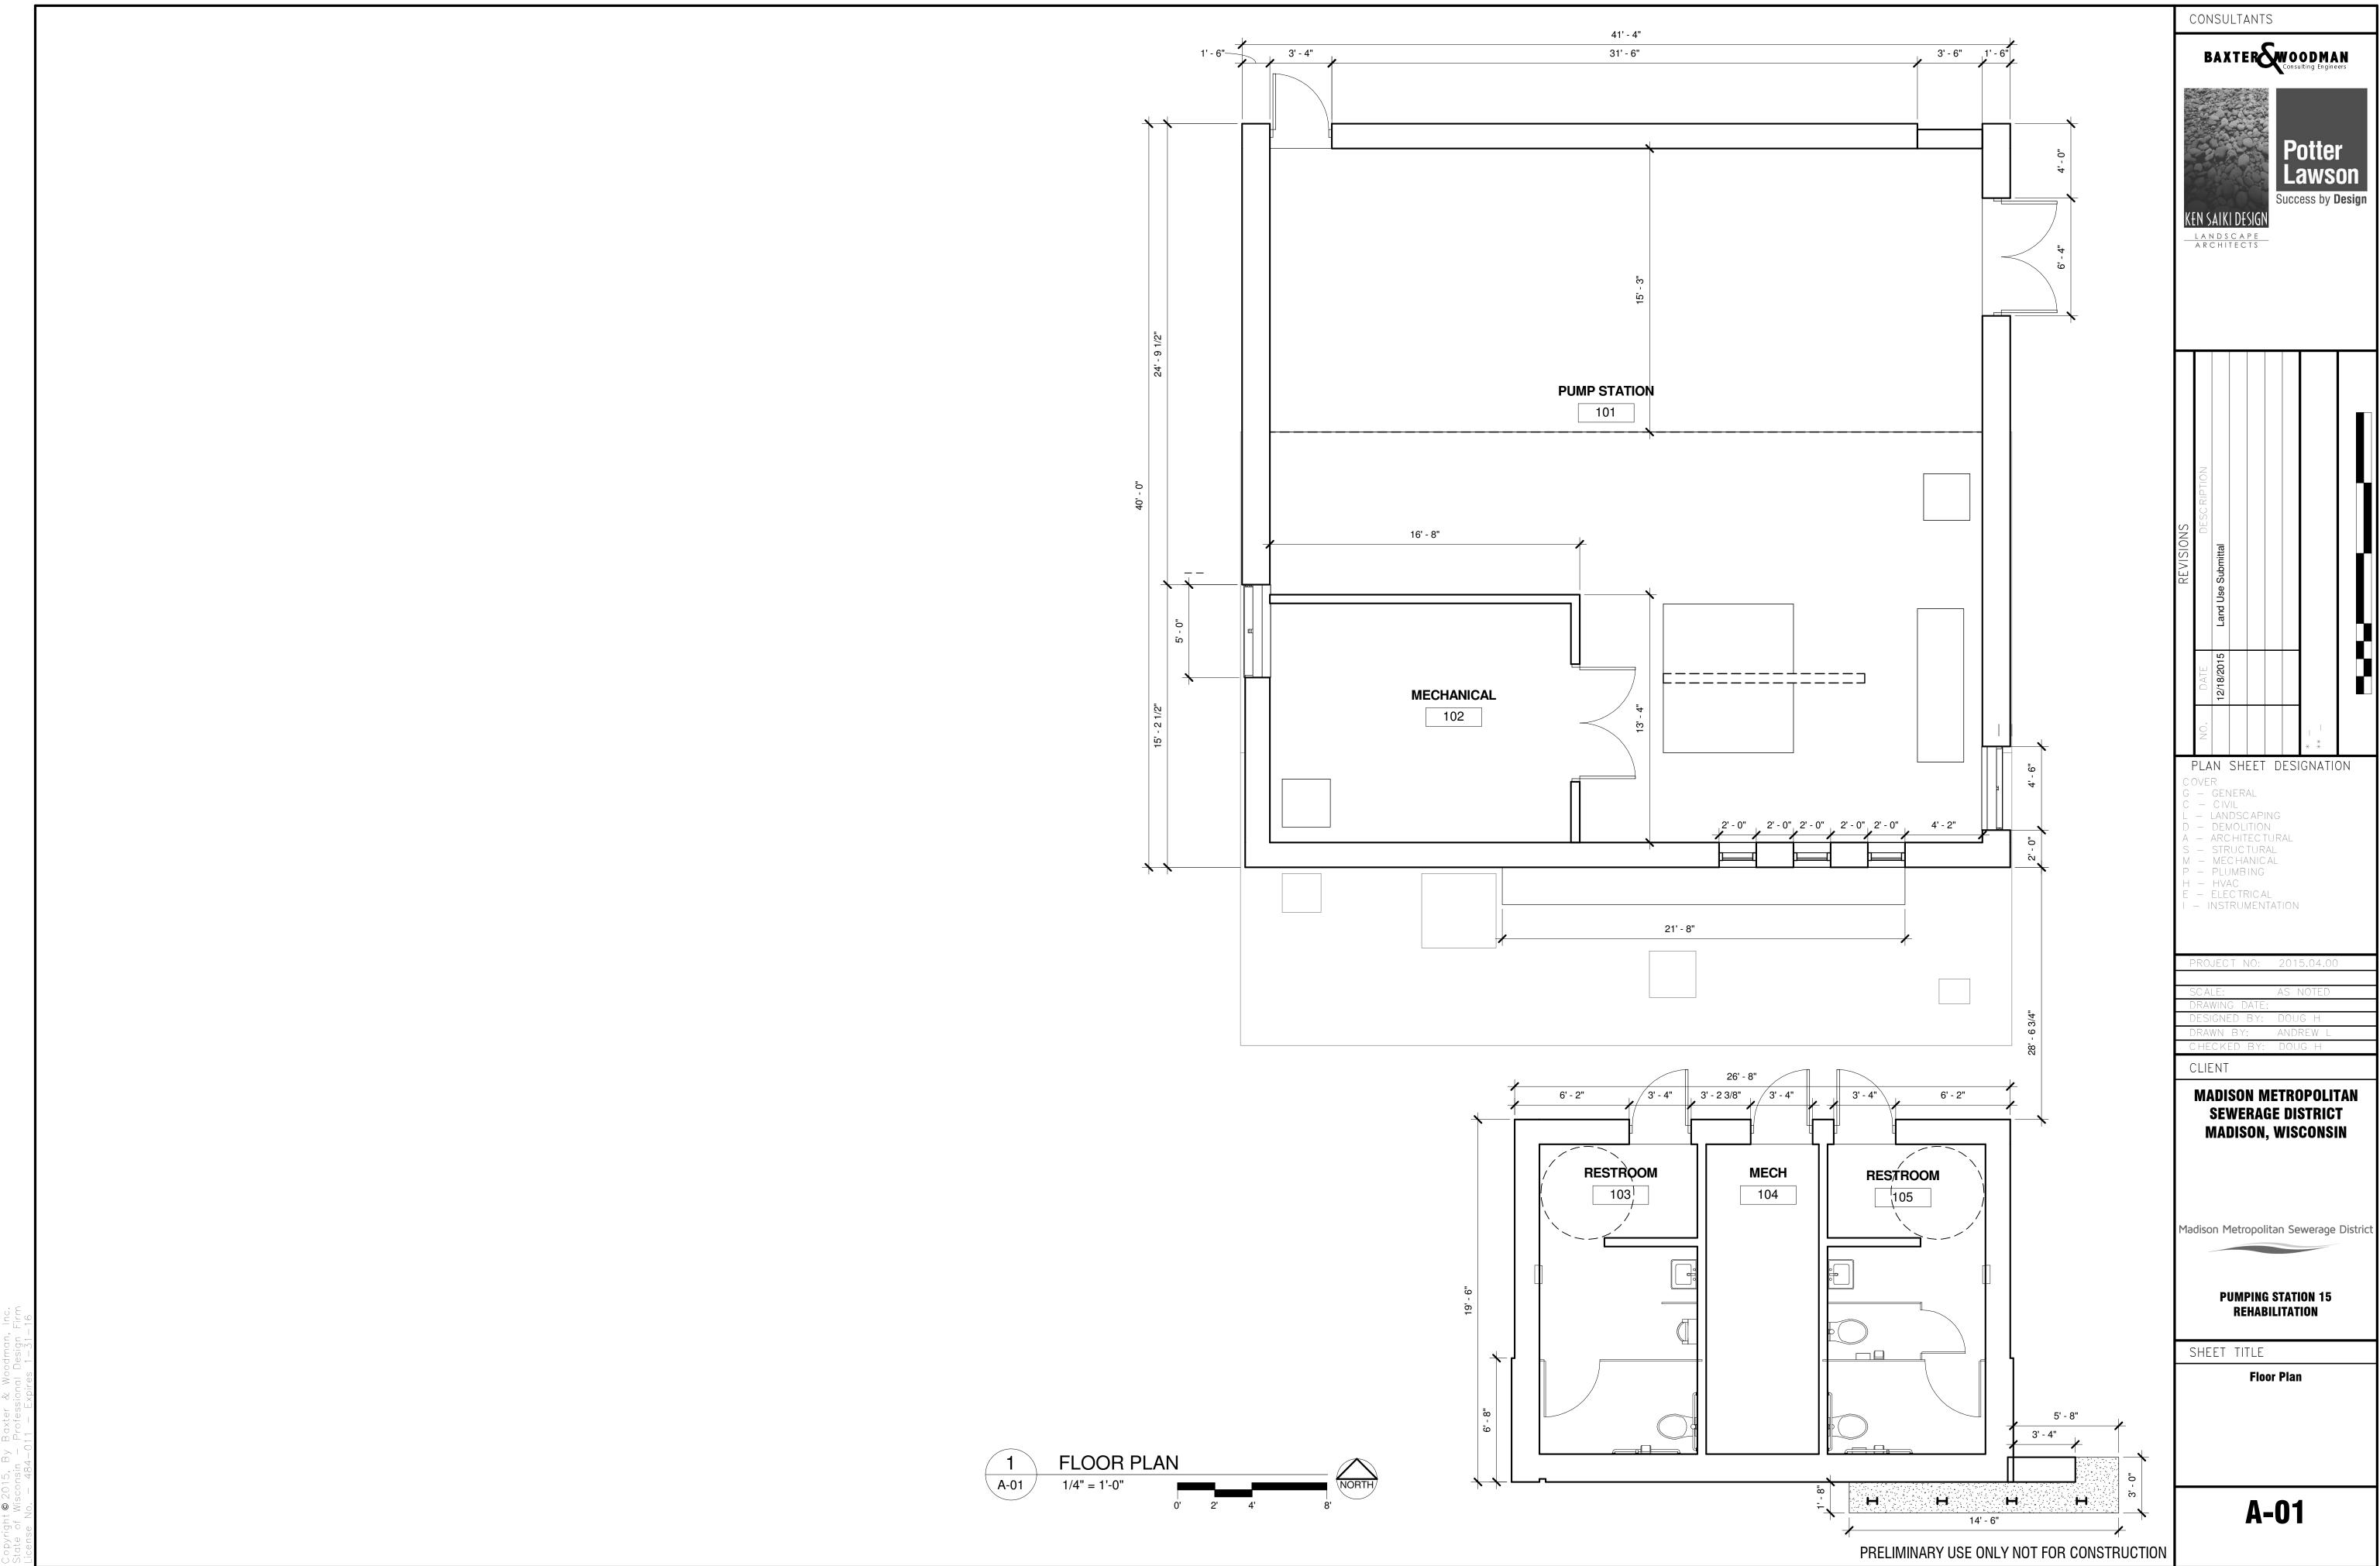


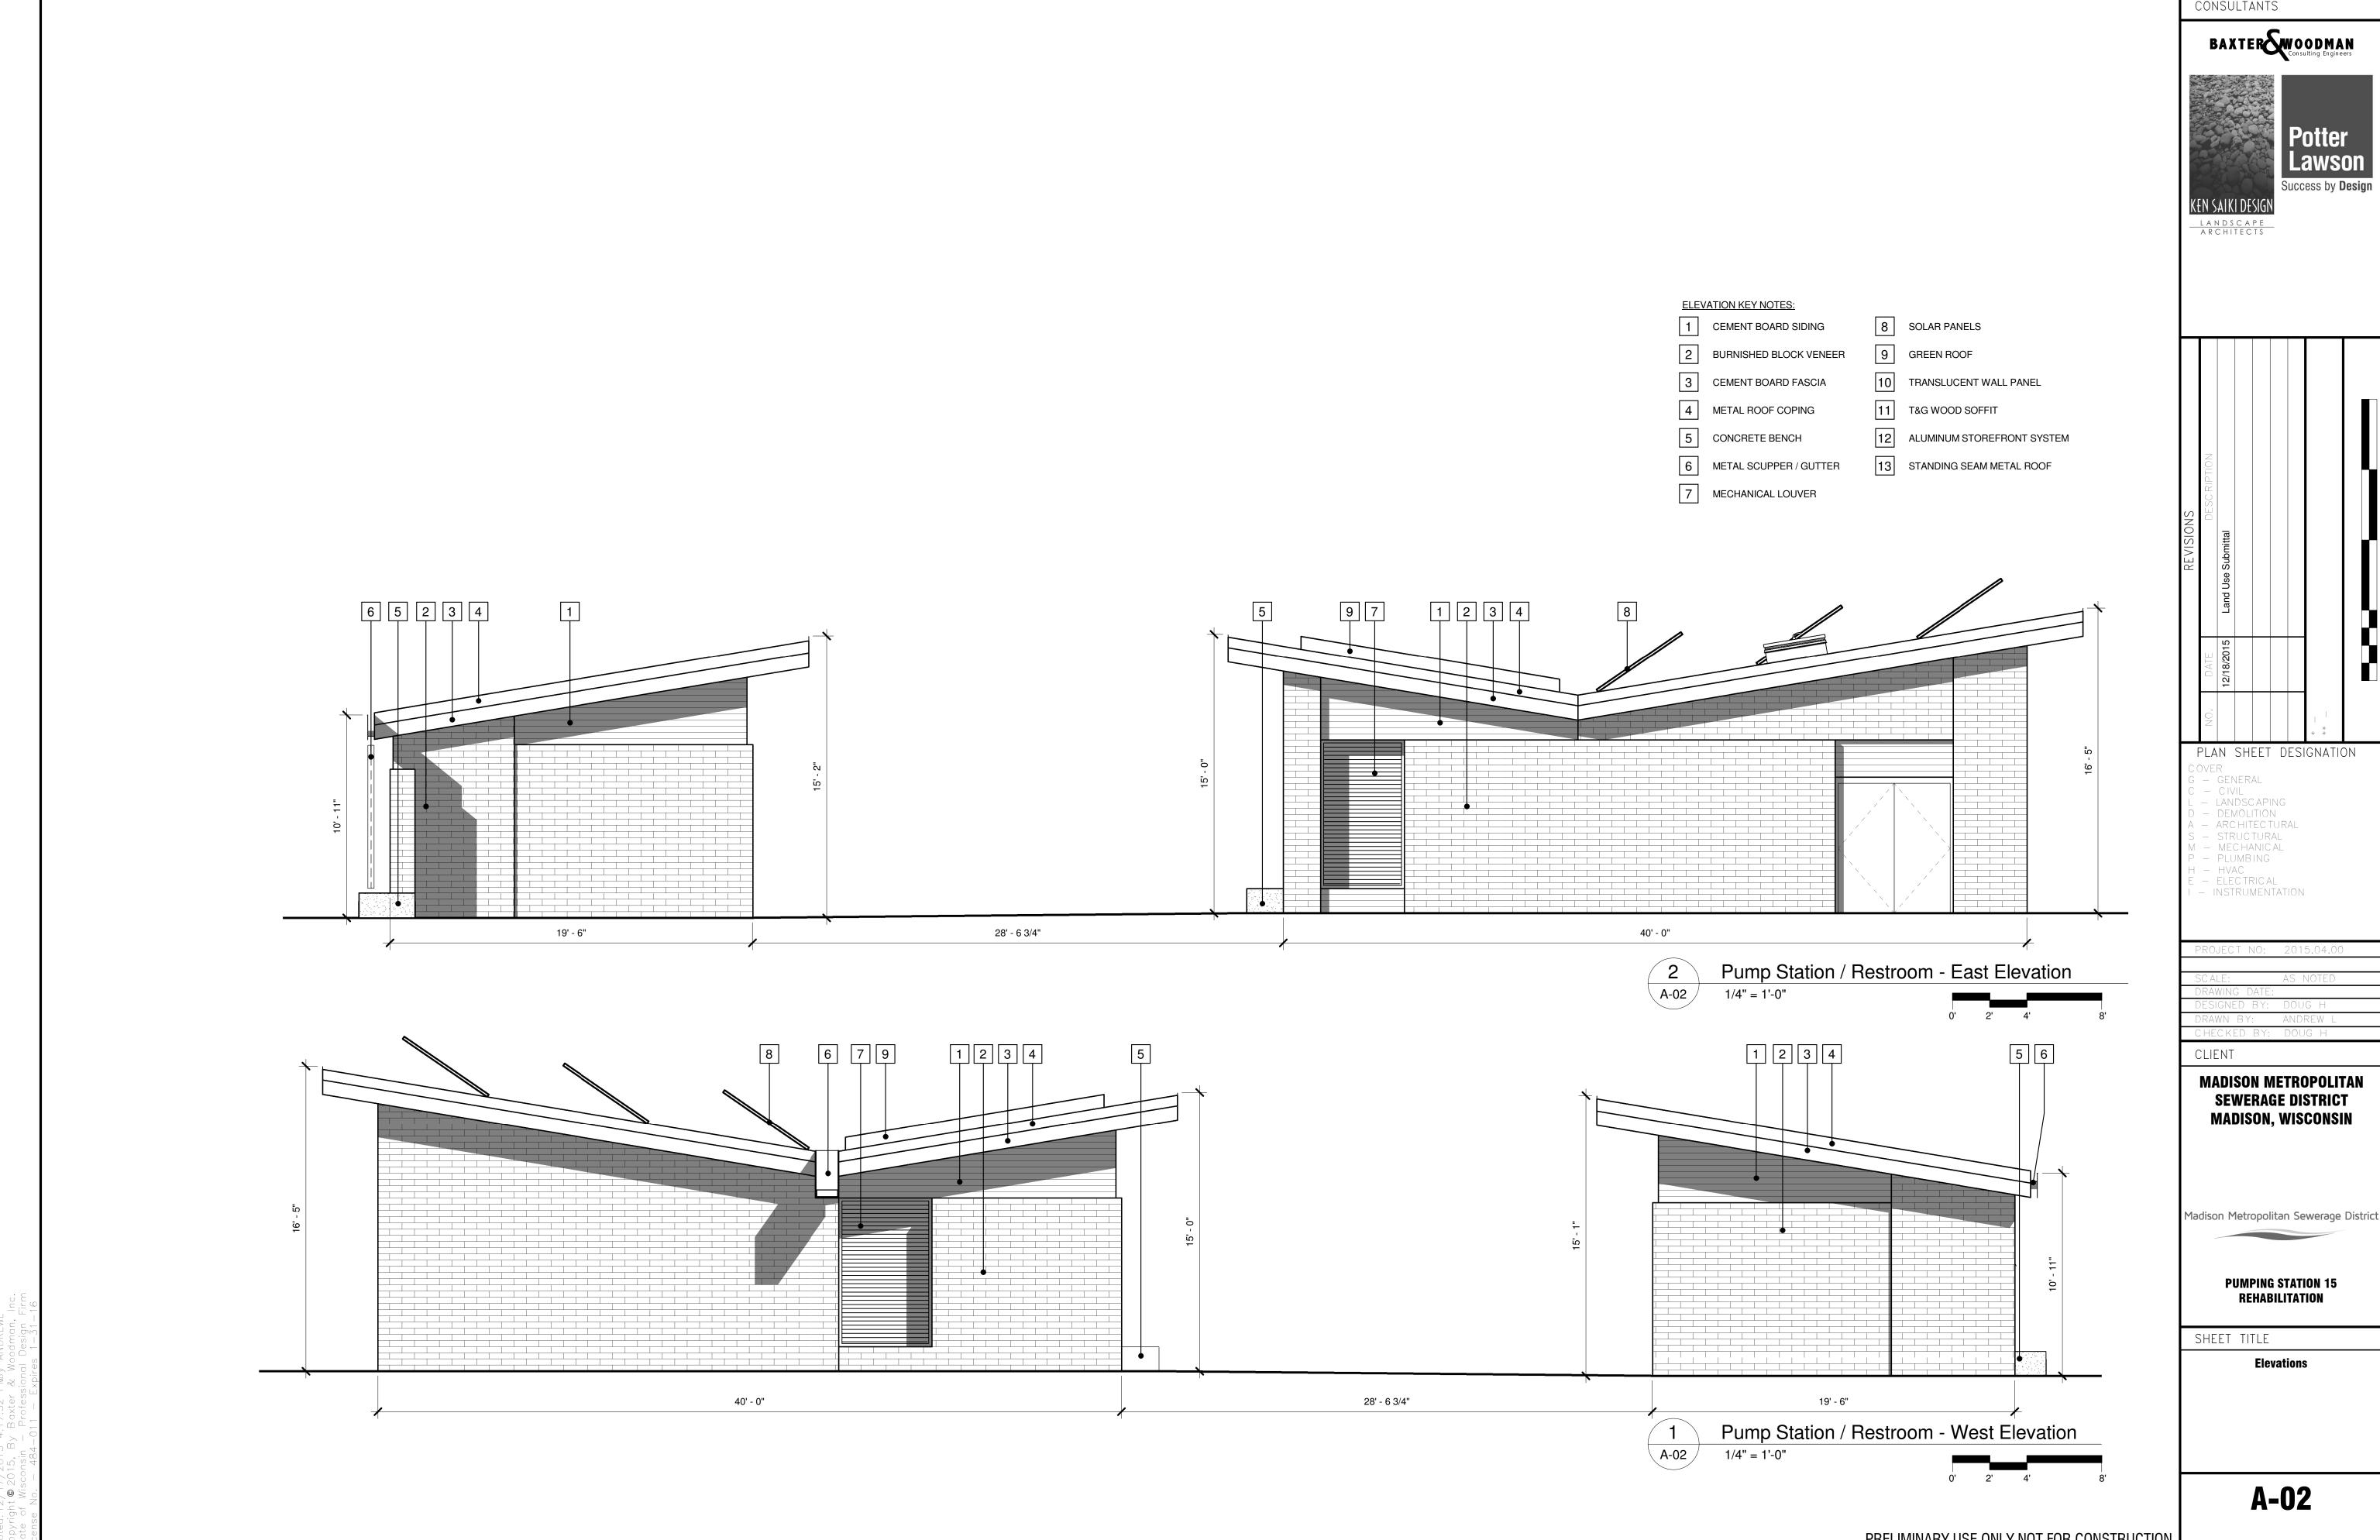

CONSULTANTS

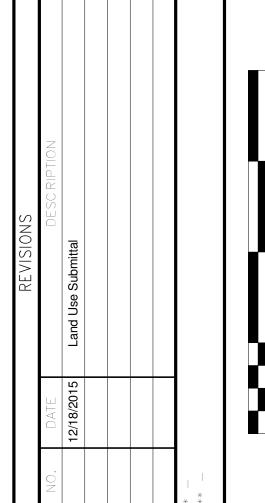

PRELIMINARY USE ONLY NOT FOR CONSTRUCTION

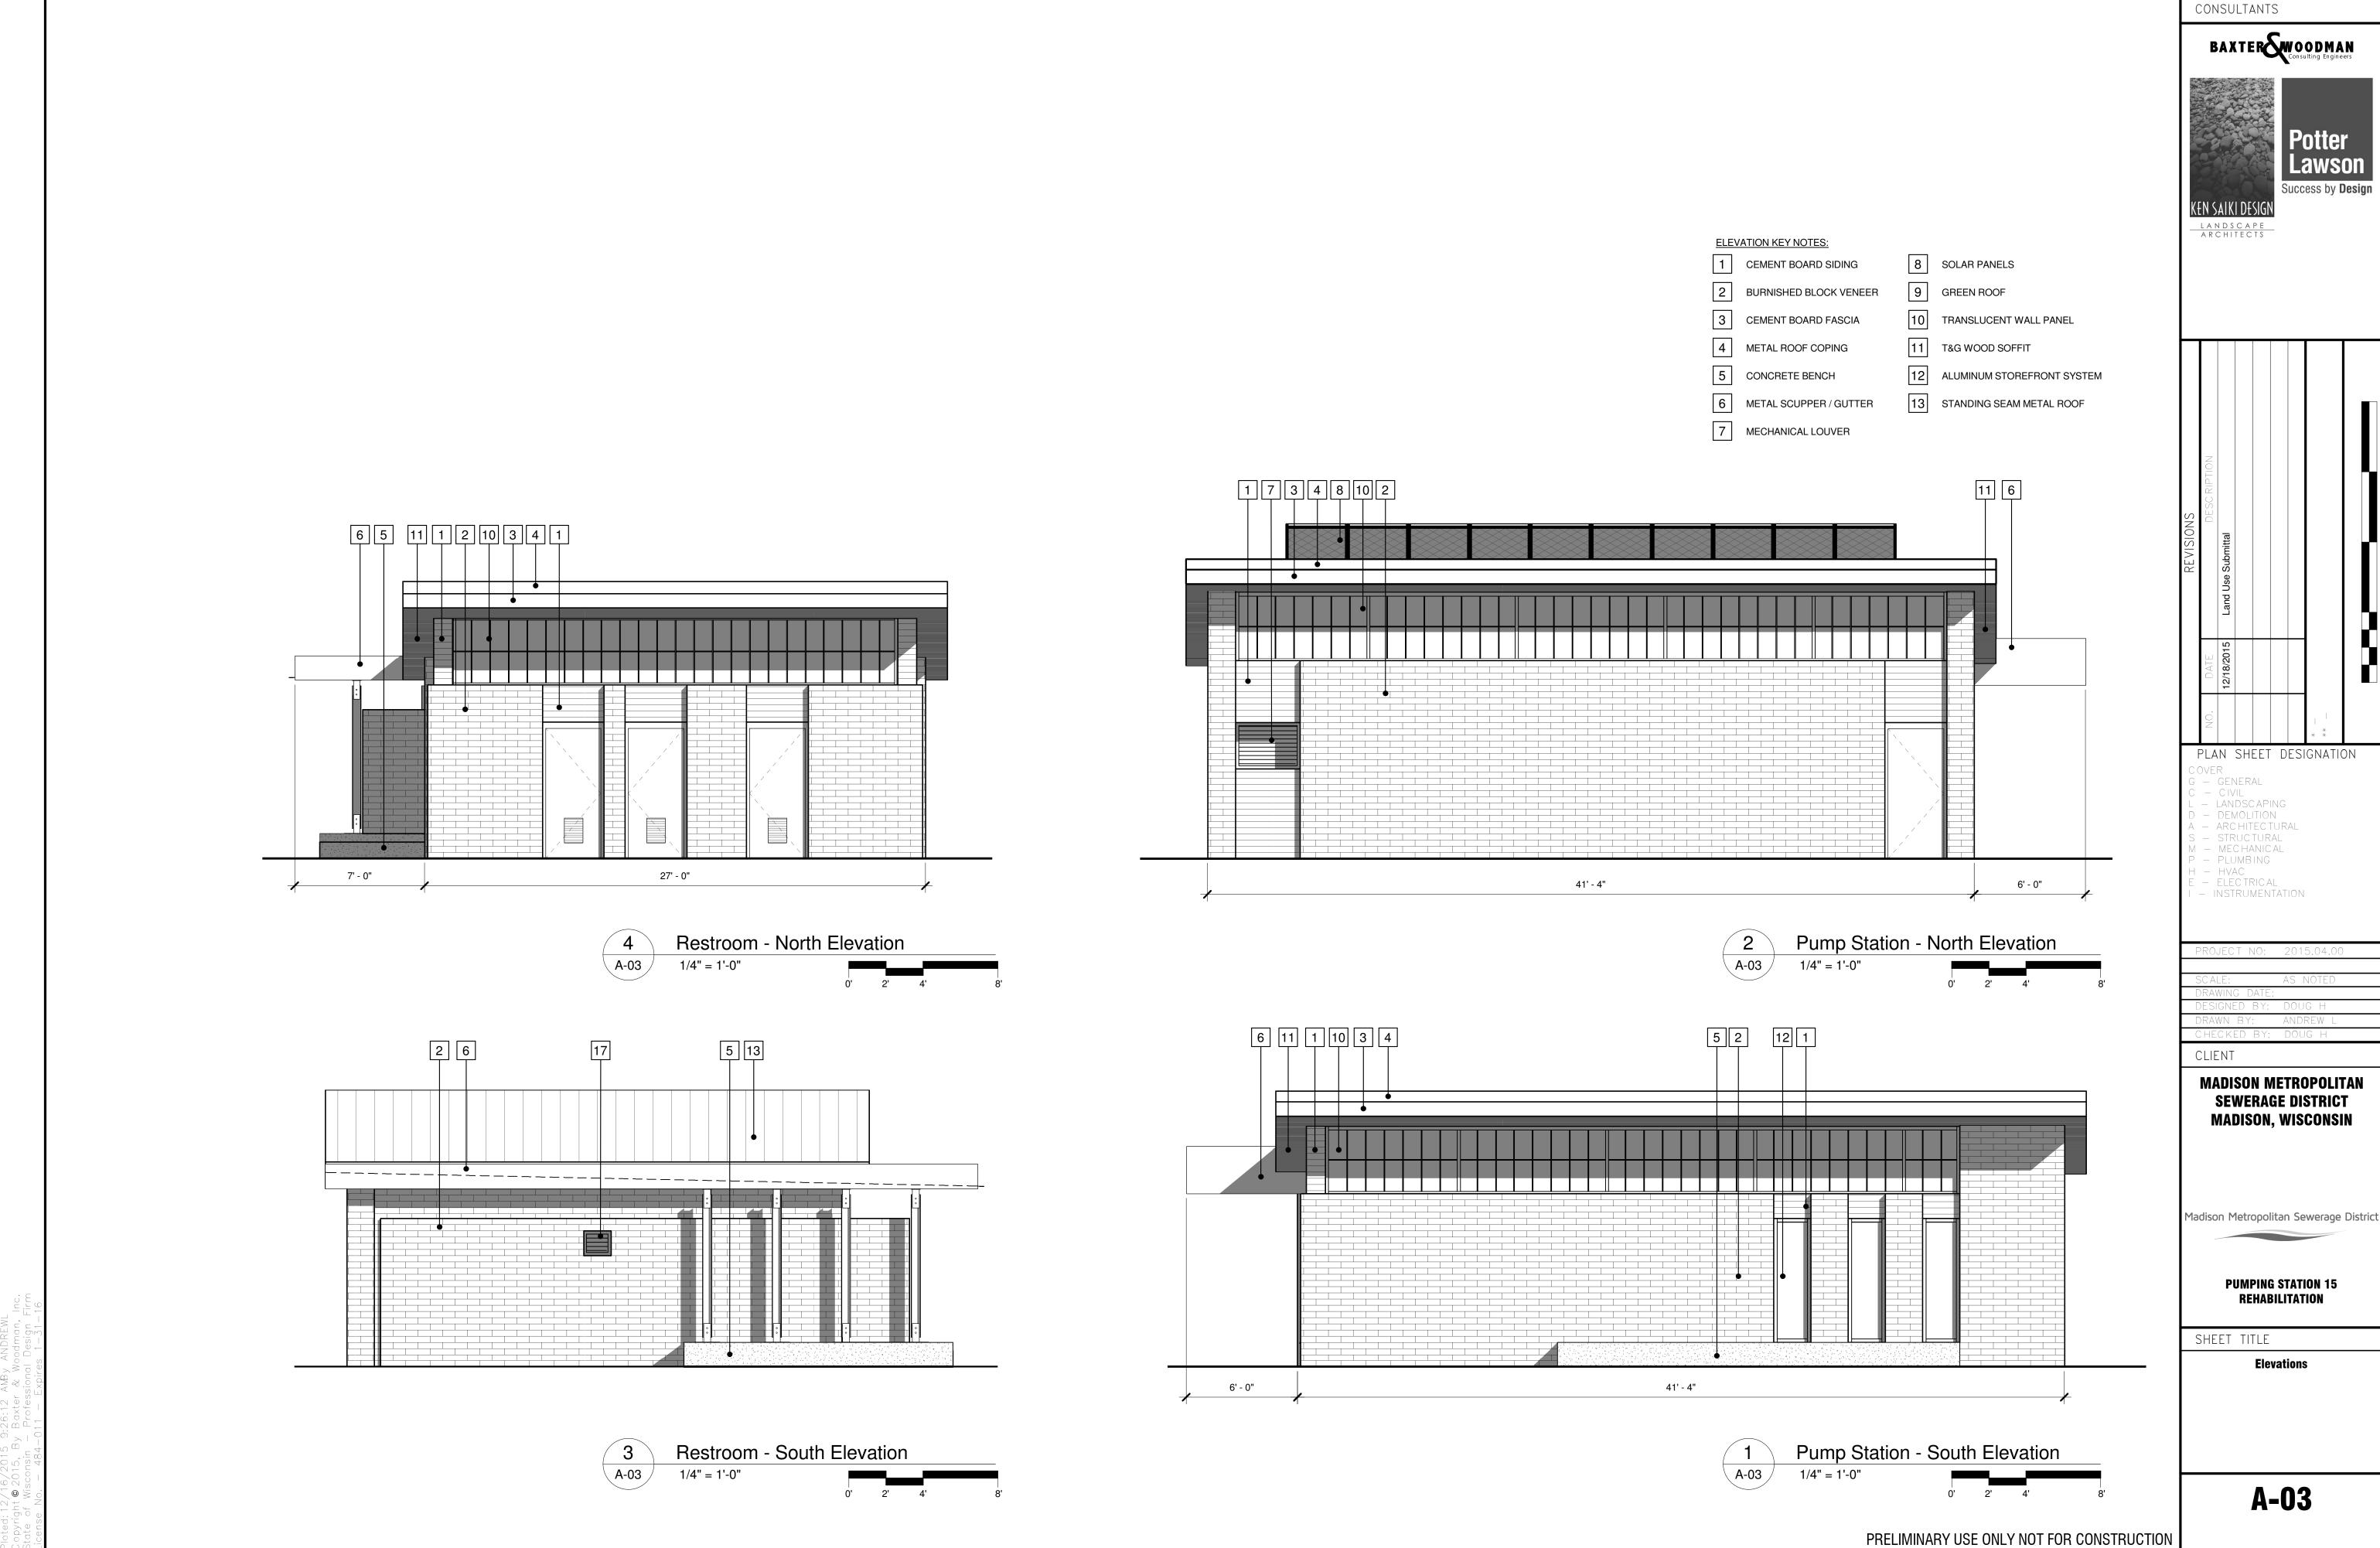








North-East Perspective North-N



South-West Perspective



North-West Perspective

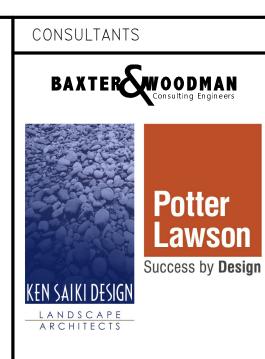

REVISIONS	DESCRIPTION	Land Use Submittal				
	DATE	12/18/2015				
	2				 * *	

PLAN	SHEET	DESIGNATION
COVER		
G - GF	NERAL	

L - LANDSCAPING D - DEMOLITION A - ARCHITECTURAL

S - STRUCTURAL
M - MECHANICAL
P - PLUMBING
H - HVAC

H — HVAC E — ELECTRICAL I — INSTRUMENTATION

DDO JECT NO. 2015 04 00

SCALE: AS NOTED
DRAWING DATE:
DESIGNED BY: DOUG H
DRAWN BY: ANDREW L

CLIENT

MADISON METROPOLITAN SEWERAGE DISTRICT MADISON, WISCONSIN

Madison Metropolitan Sewerage District

PUMPING STATION 15 REHABILITATION


SHEET TITLE

Perspectives

A-04





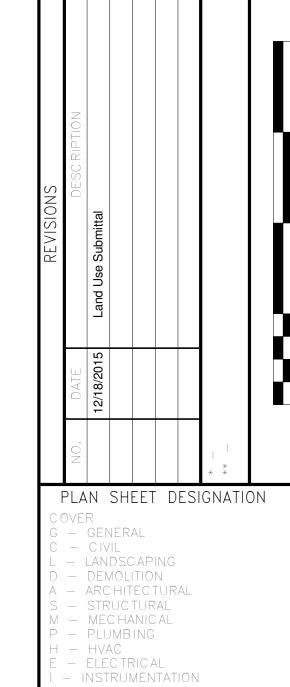

CONSULTANTS

BAXTER WOODMAN
Consulting Engineers

Success by **Design**





North-West Aerial

CLIENT

MADISON METROPOLITAN
SEWERAGE DISTRICT
MADISON, WISCONSIN

Madison Metropolitan Sewerage District


PUMPING STATION 15
REHABILITATION

SHEET TITLE

Perspectives

A-05

North-East Aerial

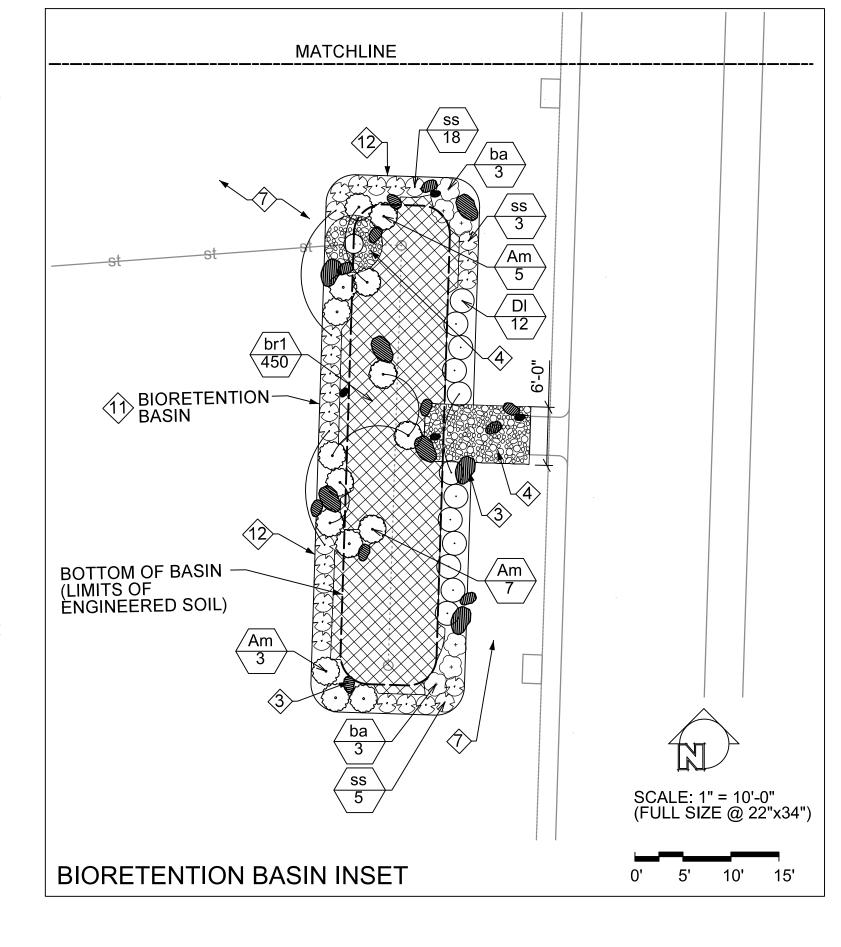

LEGEND

- MAINTENANCE EDGE, SEE DETAIL 2/L-2
- SHREDDED HARDWOOD BARK MULCH
 MULC
- ③ ACCENT BOULDER, SEE DETAIL 4/L-2
- DECORATIVE COBBLES, SEE DETAIL 5/L-2
- SHREDDED HARDWOOD BARK MULCH RING AT BASE OF TREE, SEE DETAIL 1/L-2
- SEEDED NO-MOW FESCUE LAWN WITH EROSION CONTROL MAT

- ⟨¬¬⟩ SEEDED BLUEGRASS LAWN
- 8 STEEL EDGING
- ∮ BENCH, SEE DETAIL 3/L-2
- EXTENSIVE GREEN ROOF SEDUM TILE & PERENNIALS PER
 PLANT SCHEDULE
- JUTE MESH OVER SHREDDED 11) HARDWOOD BARK MULCH (ENTIRE BIORETENTION BASIN)
- \$\frac{1}{2}\$ SHOVEL-CUT EDGING

PLANT SCHEDULE

PERMEABLE PAVERS. DO NOT TEMPORARILY STORE, STAGE OR DUMP LANDSCAPE MATERIALS IN THIS AREA. IF CLOGGING OF

PAVEMENT SYSTEM OCCURS
CONTRACTOR WILL BE
RESPONSIBLE FOR REPAIRS AT

NO ADDITIONAL COST TO

Plant	<u>List</u>					
Key	Botanical Name	Common Name	Quantity	Size	Root Condition	Comments
	Deciduous Trees					
CU	Carpinus caroliniana	American Hornbeam	1	2" Cal.	B&B	Space Per Plans
QB	Quercus bicolor	Swamp White Oak	2	2" Cal.	B&B	Space Per Plans
	Ornamental Trees					
AG	Amelanchier x grandiflora 'Robinhill'	Robinhill Serviceberry	3	6' Ht.	B&B	Multi-Stem Tree; Space Per Plans
	Deciduous Shrubs					
Am	Aronia melanocarpa 'Morton'	Iroquois Beauty Chokeberry	18	24" Ht.	Cont.	Space 3'-0" o.c.
DI	Diervilla Ionicera 'Copper'	Copper Dwarf Bush Honeysuckle	75	24" Sprd.	Cont.	Space 2'-6" o.c.
lvr	Ilex verticillata 'Red Sprite'	Red Sprite Winterberry	11	24" Ht.	Cont.	Space 2'-6" o.c.
lvj	Ilex verticillata 'Jim Dandy'	Jim Dandy Winterberry	1	24" Ht.	Cont.	Space Per Plans
	Perennials/Grasses/Groundcovers					
at	Allium tanguticum 'Summer Beauty'	Summer Beauty Allium	17	#1	Cont.	Space 12" o.c.
ac	Allium cemuum	Nodding Onion	120	2" sq. x 3.5" deep min.	Plug	Space 12" o.c. mix randomly into green roof
ba	Baptisia 'solar flare' Prairieblues	Solar Flare False Indigo	34	#1	Cont.	Space 30" o.c.
SS	Schizachyrium scoparium 'MinnblueA'	Blue Heaven Little Bluestem	63	#1	Cont.	Space 24" o.c.
rf	Rudbeckia fulgida 'Early Bird Gold'	Early Bird Gold Coneflower	18	#1	Cont.	Sapce 18" o.c.
ls	Liatris spicata 'Kobold'	Kobold Spiked Gayfeather	5	#1	Cont.	Sapce 18" o.c.
pν	Panicum virgatum 'Shenandoah'	Shenandoah Switchgrass	40	#1	Cont.	Space 30" o.c.
	Bioretention Area Mix					
br1	Asclepias tuberosa	Butterfly Weed	50	2" sq. x 5" deep min.	Plug	
	Aquilegia canadensis	Columbine	30	2" sq. x 5" deep min.	Plug	
	Carex bicknellii	Copper Shouldered Oval Sedge	170	2" sq. x 5" deep min.	Plug	
	Carex bebbii	Bebb's Oval Sedge	60	2" sq. x 5" deep min.	Plug	Mix evenly & Space 12" o.c.
	Carex sprengelli	Long Beaked Sedge	55	2" sq. x 5" deep min.	Plug	
	Carex vulpinoidea	Brown Fox Sedge	55	2" sq. x 5" deep min.	Plug	
	Rudbeckia speciosa sullivantii	Showy Black-Eyed Susan	30	2" sq. x 5" deep min.	Plug	

SCALE: 1" = 10'-0" (FULL SIZE @ 22"x34")

0' 5' 10' 15'

ELEMENTS DURING PLANTING OPERATIONS.

PROJECT REPRESENTATIVE OF ANY PROBLEMS.

SOIL PREPARATION.

BALL PRIOR TO INSTALLATION.

PLANTING.

3. SUBMIT TOPSOIL TESTING REQUIREMENTS PER SECTION 329113,

4. VERIFY THAT SPECIFIED PLANTING SOIL DEPTH IS PRESENT PRIOR

PLANTINGS FOR APPROVAL BY PROJECT REPRESENTATIVE PRIOR TO

7. ALL WRAPPINGS, WIRE BASKETS, BURLAP, TWINE AND OTHER MISCELLANEOUS MATERIAL SHALL BE REMOVED FROM ENTIRE ROOT

TO PLANTING PER SECTION 329113, SOIL PREPARATION. NOTIFY

5. LAYOUT, STAKE OR PAINT THE PROPOSED LOCATION OF ALL

6. SPACE SHRUBS AND PERENNIALS PER PLANT SCHEDULE.

LIMITED TO, UTILITY TRENCHING, ACCESS, OR MATERIALS STORAGE PROJECT REPRESENTATIVE OF ANY PROBLEMS. SHALL BE REPAIRED WITH SEED MIXES AS NOTED ON THE PLANS AND 2. PROTECT ALL PAVEMENTS, CURBS, UTILITIES, AND OTHER SITE PER SECTION 32 92 00, TURF AND GRASSES.

9. REPAIR TO ORIGINAL CONDITION ALL EXISTING VEGETATION NOTED TO REMAIN INCLUDING PLANTS, MULCH AND EDGING THAT HAVE BEEN DISTURBED BY CONSTRUCTION ACTIVITIES. 10. ALL PLANTING BEDS TO RECEIVE SHREDDED HARDWOOD BARK

MULCH UNLESS OTHERWISE NOTED. 11. HOLD CENTER OF PERENNIAL PLANTINGS A MINIMUM OF 18"AND CENTER OF SHRUB PLANTINGS A MINIMUM OF 24" FROM BACK OF CURB/EDGE OF PAVEMENT.

CONSULTANTS

BAXTER WOODMAN
Consulting Engineers



PLAN SHEET DESIGNATION

COVER
G - GENERAL
C - CIVIL
L - LANDSCAPING
D - DEMOLITION
A - ARCHITECTURAL

S - STRUCTURAL M - MECHANICAL P - PLUMBING

H - HVAC E - ELECTRICAL I - INSTRUMENTATION

PROJECT ND: 140963

AS NOTED SCALE DRAWING DATE: 12/18/2015 DESIGNED BY: NMS DRAWN BY: NMS

CHECKED BY: NMS CLIENT

MADISON METROPOLITAN SEWERAGE DISTRICT MADISON, WISCONSIN

Madison Metropolitan Sewerage District

PUMPING STATION 15 REHABILITATION

SHEET TITLE

LANDSCAPE PLAN

L-01

NOT FOR BIDDING



NOT FOR BIDDING

BENCHMARK

PUMPING STATION 15 BENCHMARK:
ON NORTHWEST CORNER OF PUMPING STATION 15 FOR MMSD AT MARSHALL PARK
ON ALLEN BOULEVARD — EL. 865.25'.

NOTES:

- 1. REFER TO CONSTRUCTION SEQUENCE IN SECTION 01 31 14 FOR SPECIFIC DEMOLITION REQUIREMENTS.
- STRIP TOPSOIL AND STOCKPILE IN ACCORDANCE WITH SECTION 31 16 00 FOR AREAS TO BE IMPROVED (NOT SHOWN). FOLLOW SCHEDULE INCLUDED IN SECTION 01 14 15 PUMPING STATION OPERATION DURING CONSTRUCTION.

BAXTER WOODMAN Consulting Engineers

Potter Lawson

KEN SAIKI DESIGN

Success by Design

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	Z						OP DRAV	
	DESCRIPTION						ER'S SHI	2"
REVISIONS	DESC	12/18/15 LAND USE SUBMITTAL					REFER TO EQUIPMENT MANUFACTURER'S SHOP DRAWING-	
		SN GNYT					QUIPMENT	0
	DATE	12/18/15					FER TO E	1,, 5,,
	ON.						* - REF	
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A — ARCHITECTURAL S — STRUCTURAL M — MECHANICAL

- ELECTRICAL - INSTRUMENTATION

P - PLUMBING H - HVAC

PRDJECT ND: 140963

SCALE: AS NOTED
DRAWING DATE:
DESIGNED BY: JWM
DRAWN BY: TLB
CHECKED BY: JEK

CLIENT

COVER

- GENERAL

- CIVIL - LANDSCAPING - DEMOLITION

MADISON METROPOLITAN
SEWERAGE DISTRICT
MADISON, WISCONSIN

Madison Metropolitan Sewerage District

PUMPING STATION 15
REHABILITATION


SHEET TITLE

DEMOLITION SITE PLAN

C-1 3 OF 59

SEDIMENTATION AND EROSION CONTROL NOTES

- 1. SOIL DISTURBANCE SHALL BE CONDUCTED IN SUCH A MANNER AS TO MINIMIZE EROSION. SOIL STABILIZATION MEASURES SHALL CONSIDER THE TIME OF YEAR, SITE CONDITIONS AND THE USE OF TEMPORARY OR PERMANENT MEASURES.
- 2. SOIL EROSION AND SEDIMENT CONTROL FEATURES SHALL BE CONSTRUCTED PRIOR TO THE COMMENCEMENT OF UPLAND DISTURBANCE.
- 3. TEMPORARY SOIL STABILIZATION SHALL BE APPLIED TO DISTURBED AREAS WITHIN 15 CALENDAR DAYS OF THE END OF ACTIVE HYDROLOGIC DISTURBANCE. PERMANENT STABILIZATION SHALL BE DONE WITHIN 15 DAYS AFTER COMPLETION OF FINAL GRADING OF THE SOIL.
- 4. ALL STORM SEWER FACILITIES THAT ARE OR WILL BE FUNCTIONING DURING CONSTRUCTION SHALL BE PROTECTED, FILTERED, OR OTHERWISE TREATED TO REMOVE SEDIMENT.
- 5. ALL TEMPORARY EROSION AND SEDIMENT CONTROL MEASURES SHALL BE REMOVED WITHIN 30 DAYS AFTER FINAL SITE STABILIZATION IS ACHIEVED OR AFTER THE TEMPORARY MEASURES ARE NO LONGER NEEDED. TRAPPED SEDIMENT AND OTHER DISTURBED SOIL AREAS SHALL BE PERMANENTLY STABILIZED.
- 6. ALL TEMPORARY AND PERMANENT EROSION CONTROL MEASURES MUST BE MAINTAINED AND REPAIRED AS NEEDED. THE GENERAL CONTRACTOR WILL BE RESPONSIBLE FOR INSPECTION AND REPAIR DURING CONSTRUCTION.

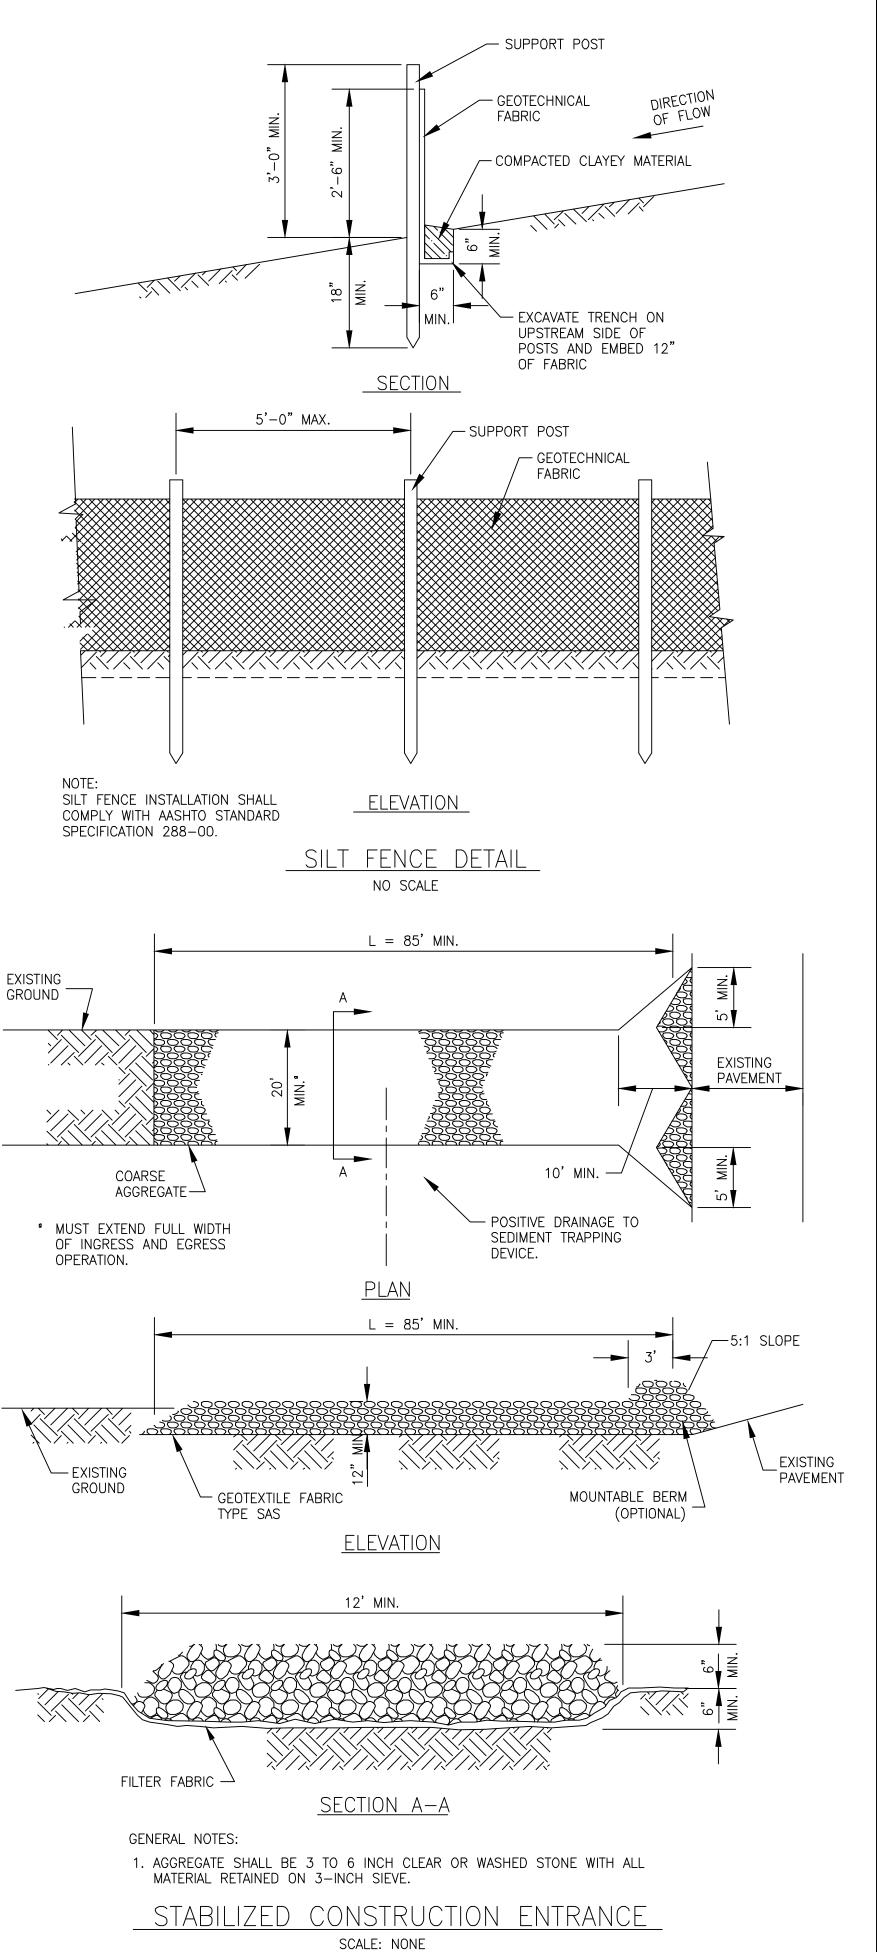


CONSULTANTS

BAXTER WOODMAN

Consulting Engineers



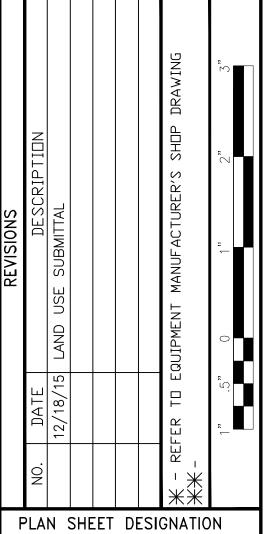

P - PLUMBING H - HVAC E - ELECTRICAL [- INSTRUMENTATION PROJECT NO: 140963

SCALE: AS NOTED

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DESIGNED BY: JWM

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COVER

- GENERAL

- LANDSCAPING

- DEMOLITION

- MECHANICAL

ARCHITECTURALSTRUCTURAL

- CIVIL

MADISON METROPOLITAN
SEWERAGE DISTRICT
MADISON, WISCONSIN

Madison Metropolitan Sewerage District

PUMPING STATION 15
REHABILITATION

SHEET TITLE


SITE PLAN &
EROSION CONTROL

C-2 4 OF 59

PLAN


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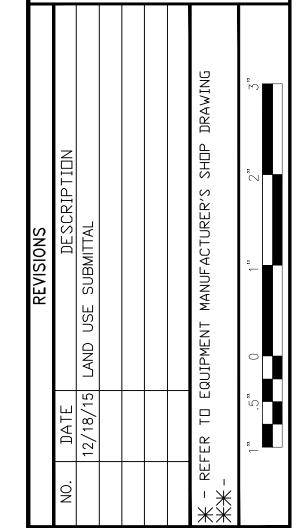


BENCHMARK

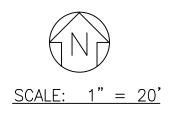PUMPING STATION 15 BENCHMARK: ON NORTHWEST CORNER OF PUMPING STATION 15 FOR MMSD AT MARSHALL PARK ON ALLEN BOULEVARD - EL. 865.25'.



CONSULTANTS

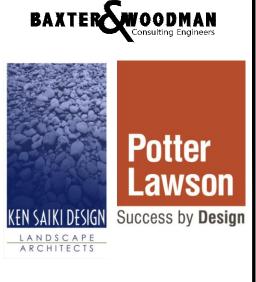

PLAN SHEET DESIGNATION COVER

- GENERAL

←EX. 30" GRAVITY SEWER

-INSTALL NEW STOP LOGS AND GUIDES

- CIVIL - LANDSCAPING - DEMOLITION - ARCHITECTURAL

- STRUCTURAL - MECHANICAL

- PLUMBING H - HVAC

- ELECTRICAL - INSTRUMENTATION

PROJECT NO: 140963 SCALE: AS AS NOTED DESIGNED BY: JWM

CHECKED BY: JEK CLIENT

DRAWN BY:

MADISON METROPOLITAN SEWERAGE DISTRICT MADISON, WISCONSIN

Madison Metropolitan Sewerage District

PUMPING STATION 15 REHABILITATION

SHEET TITLE

MECHANICAL SITE PLAN

C-3 5 OF 59


DEMO EX. STOP-PLATE & GUIDES EX. 30" GRAVITY SEWER — TO PUMPING STATION 15 EX. 30"
GRAVITY SEWER NOTE: WITHIN THE STRUCTURE AS NEEDED TO COMPLETE THE WORK


PUMPING STATION 15 FFE=865.80 PROPOSED GAS SERVICE BY MG&E, ---CONTRACTOR RESPONSIBLE FOR GAS SERVICE COORDINATIONS IN ACCORDANCE WITH SECTION 33 51 11 -4" PVC DRAIN -1" TYPE "K" COPPER WATER SERVICE (TYP) VENTURI METER VAULT -UNDERDRAIN SEE SH. C-4 RESTROOMS FFE=865.55 PVC DRAIN FORCE MAIN BYPASS MANHOLE -SEE SH. C-4 EX. CATCH BASIN— BIO-RETENTION BASIN-7 OVERFLOW STRUCTURE SEE DETAIL SH. CORE HOLE IN EX. CATCH BASIN, -INSTALL NEW STORM SEWER AND GROUT ANNULAR SPACE -\6|" CORRUGATED HDPE STORM SEWER @ 1.00% Bit. LEXISTING FLOW DIVERSION MANHOLE, SEE DETAIL THIS SH. 2

INSTALLATION OF NEW STOP LOGS AND GUIDES MUST BE DONE UNDER ACTIVE FLOW CONDITIONS, PREFERABLY DURING PERIODS OF LOW FLOW. CONTRACTOR IS RESPONSIBLE FOR FLOW DIVERSION

EXISTING FLOW DIVERSION MANHOLE

SCALE: ½" = 1'-0"

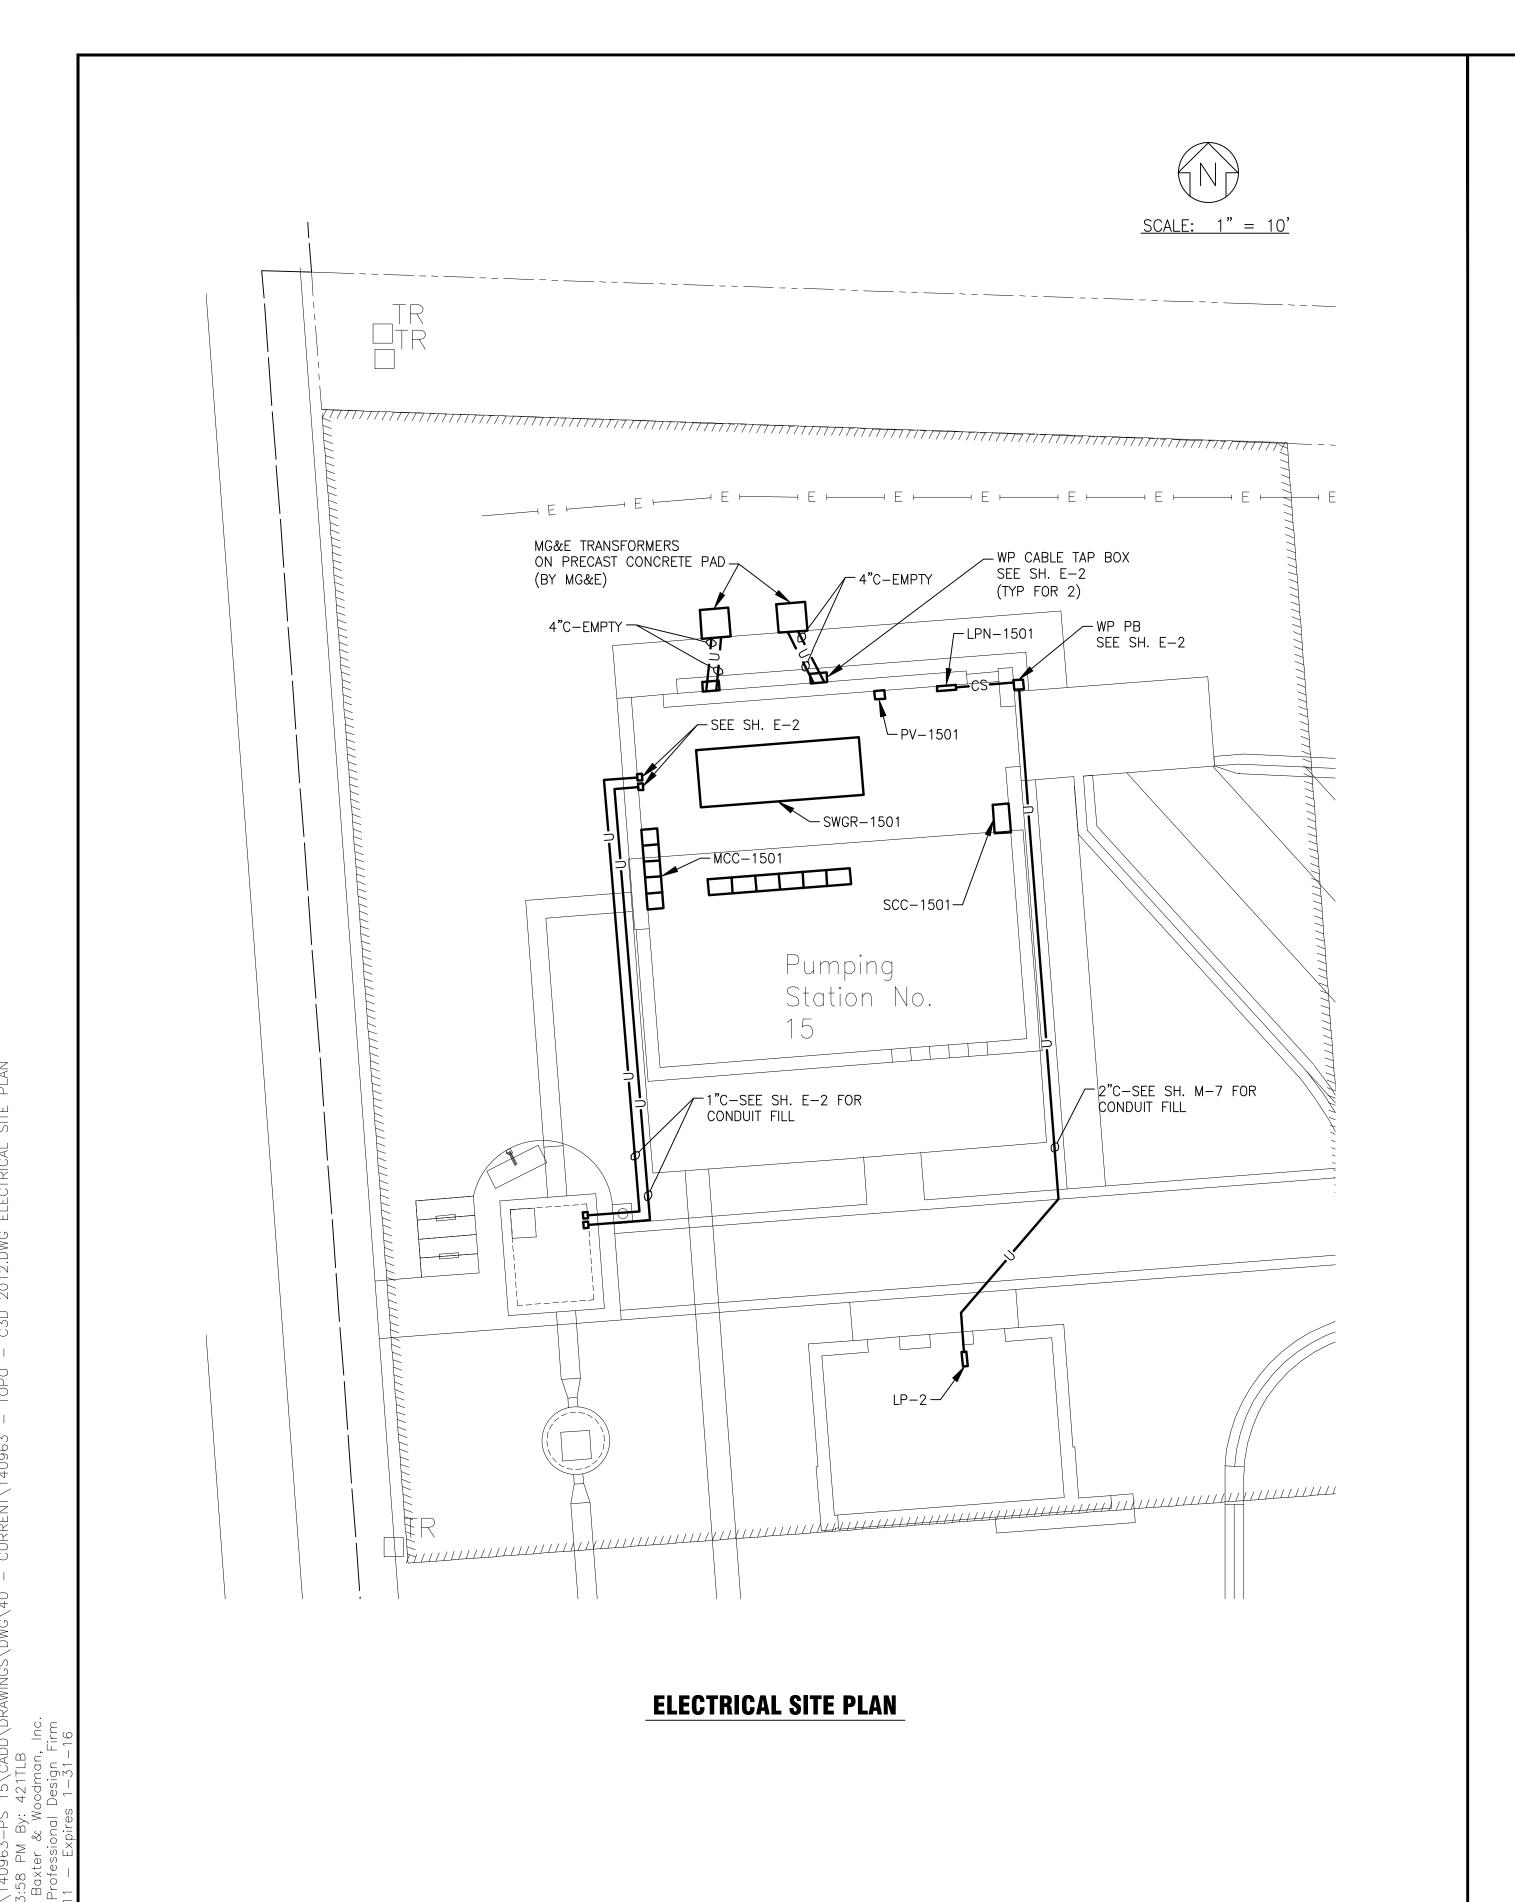

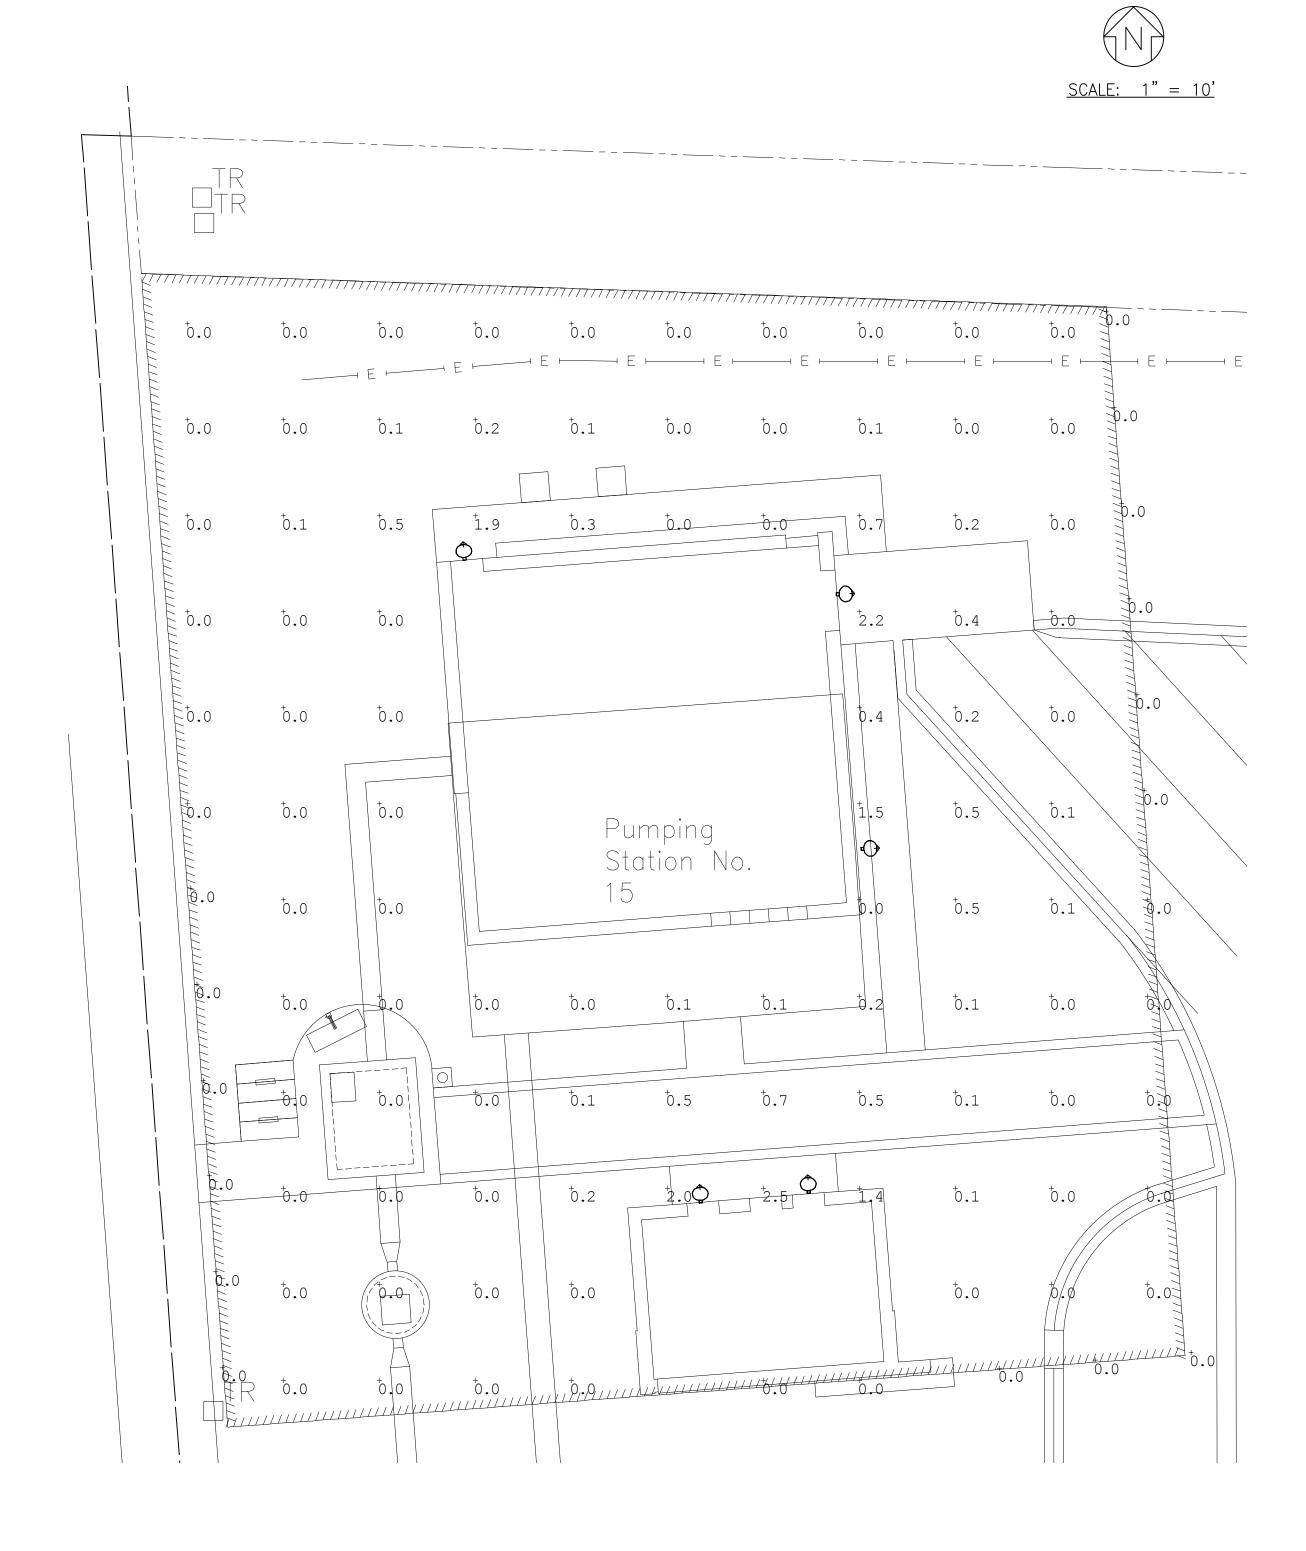

SITE LIGHTING CALCULATIONS

NOTE:

1. COORDINATE INSTALLATION OF NEW ELECTRICAL SERVICE WITH MG&E.

8 OF 59

Potter Lawson KEN SAIKI DESIGN Success by Design

BAXTER WOODMAN Consulting Engineers

CONSULTANTS

H - HVAC - ELECTRICAL - INSTRUMENTATION

PLAN SHEET DESIGNATION

COVER
G - GENERAL
C - CIVIL
L - LANDSCAPING
D - DEMOLITION
A - ARCHITECTURAL
- MECHANICAL
- PILIMBING

- PLUMBING

PROJECT NO: 140963 SCALE: AS NOTED
DRAWING DATE:
DESIGNED BY: ARH DRAWN BY: TLB
CHECKED BY: JEK

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MADISON METROPOLITAN SEWERAGE DISTRICT MADISON, WISCONSIN

Madison Metropolitan Sewerage District

PUMPING STATION 15 REHABILITATION

SHEET TITLE

ELECTRICAL SITE PLAN

AND SITE LIGHTING CALCULATIONS

C-6

NOT FOR BIDDING

BAXTER WOODMAN
Consulting Engineers

Potter
Lawson
Success by Design

REVISIONS	DESCRIPTION	12/18/15 LAND USE SUBMITTAL			米 – REFER TO EQUIPMENT MANUFACTURER'S SHOP DRAWING 米米-	0 1" 2" 3"
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PLAN SHEET DESIGNATION

G - GENERAL C - CIVIL L - LANDSCAPING

D - DEMOLITION
A - ARCHITECTURAL

S - STRUCTURAL M - MECHANICAL P - PLUMBING

H - HVAC E - ELECTRICAL I - INSTRUMENTATION

PR□JECT N□: 140963

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MADISON METROPOLITAN
SEWERAGE DISTRICT
MADISON, WISCONSIN

PUMPING STATION 15

Madison Metropolitan Sewerage District

PUMPING STATION 15
REHABILITATION

SHEET TITLE

UPPER PLAN - MECHANICAL

M-338 OF 59

WITH NEW CONCRETE FLOOR TOPPING.