

URBAN DESIGN COMMISSION APPLICATION CITY OF MADISON

This form may also be completed online at: http://www.cityofmadison.com/planning/documents/UDCapplication.pdf

215 Martin Luther King Jr. Blvd; Room LL-100 PO Box 2985; Madison, Wisconsin 53701-2985 Phone: 608.266.4635 | Facsimile: 608.267.8739

Please complete all sections of the application, including the desired meeting date and the type of action requested.

Date Submitted: September 09, 2015	Informational Present	tation
UDC Meeting Date: September 16, 2015		
Combined Schedule Plan Commission Date (if applicable):	Final Approval	
 Project Address:	or Previously-Approved Development ^{00 fee)} an Mixed-Use District (UMX) (\$150 fee, Minor Exterior Alt	
 □ Planned Development (PD) □ General Development Plan (GDP) □ Specific Implementation Plan (SIP) □ Planned Multi-Use Site or Planned Residential Cor B. Signage: □ Comprehensive Design Review* (public hearing-\$300 fee □ Signage Exception(s) in an Urban Design District (p C. Other: ▼ Please specify: Advisory presentation as requested 	mplex e)	0 fee)
3. Applicant, Agent & Property Owner Information:		
Applicant Name: John Fish	Company: McKenzie Place, LLC	
Street Address: 315 Lakewood Blvd.	City/State: Madison, WI Zip	53704
Telephone:(_608) 219.7766 Fax:() NA	Email: trout204@comcast.net	
Project Contact Person:	Company:	
Street Address: 2310 Crossroads Dr., Suite 2000		53718
Telephone:(608) 478.4013 Fax:() NA	Email: kkeller@prarch.com	
Project Owner (if not applicant) :		
Street Address:		:
Telephone:()Fax:()	Email:	
4. Applicant Declarations:		
A. Prior to submitting this application, the applicant is required to discus	' - ' 'i-	his
B. The applicant attests that all required materials are included in this su the application deadline, the application will not be placed on an Urban	ubmittal and understands that if any required information is no	ot provided by
Name of Applicant Kirk Keller	Relationship to Property Architect	
Authorized Signature	Date September 09, 2015	





































South Elevation



West Elevation



East Elevation

KEYNOTE LEGEND - CONSTRUCTION TYPES CONSTRUCTION DESCRIPTION R2 SINGLE PLY ROOFING SYSTEM, 1 HOUR RATED ASSEMBLY UL DESIGN #P522 : FULLY ADHERED TPO MEMBRANE ON TAPERED RIGID INSULATION ON 3/4" EXTERIOR WOOD SHEATHING ON 24" WOOD TRUSS ROOF FRAMING WITH FULL-CAVITY BLOWN IN INSULATION. 5/8" TYPE 'C' GYPSUM BOARD ON VAPOR RETARDER ON RESILIENT CHANNELS AT 16" O.C. DIRECTLY SECURED TO UNDERSIDE OF WOOD STRUCTURE. R2A SINGLE PLY ROOFING SYSTEM, 1 HOUR RATED ASSEMBLY UL DESIGN #P522 : FULLY ADHERED TPO MEMBRANE ON TAPERED RIGID INSULATION ON 3/4" EXTERIOR WOOD SHEATHING ON XXX" WOOD JOIST. ROOF FRAMING WITH FULL-CAVITY BLOWN IN INSULATION. 5/8" TYPE 'C' GYPSUM BOARD ON VAPOR RETARDER ON RESILIENT CHANNELS AT 16" O.C. DIRECTLY SECURED TO UNDERSIDE OF WOOD STRUCTURE. R9 ROOF PATIO SYSTEM: COMPOSITE DECKING ON ADJUSTABLE HEIGHT PEDESTALS, ON EPDM PROTECTION MAT ON ROOF TYPE BELOW. S1 X" REINFORCED CONCRETE SLAB ON VAPOR RETARDER ON X" DRAINAGE FILL. S2 X" REINFORCED CONCRETE TOPPING ON X" STRUCTURAL CONCRETE DECK. S5 FLOOR/CEILING ASSEMBLY, 1 HOUR RATED ASSEMBLY UL DESIGN #563: 1-1/2" LEVELING GYPSUM UNDERLAYMENT ON 3/4" T&G PLYWOOD SUBFLOOR ON 24" WOOD TRUSS FLOOR FRAMING WITH FULL-CAVITY BLOWN IN INSULATION. 5/8" TYPE 'C' GYP BD ON 1/2: RES CHANNELS AT 16" O.C. ON BOTTOM OF WOOD FRAMING S5A FLOOR/CEILING ASSEMBLY, 1 HOUR RATED ASSEMBLY UL DESIGN #563: 1-1/2" LEVELING GYPSUM UNDERLAYMENT ON 3/4" T&G PLYWOOD SUBFLOOR ON XX" WOOD JOIST FLOOR FRAMING WITH FULL-CAVITY BLOWN IN INSULATION. 5/8" TYPE 'C' GYP BD ON 1/2: RES CHANNELS AT 16" O.C. ON BOTTOM OF WOOD

NOTE # **FLOOR PLAN NOTE**

KEYNOTE LEGEND - EXTERIOR WALL TYPES

EXTERIOR WALL DESCRIPTION W1A EXTERIOR WALL: MASONRY CAVITY WALL CONSISTING OF 4" FACE BRICK (EDIT FOR OTHER MATERIALS). 1-3/4" AIR SPACE, 3" RIGID INSULATION, SPRAY APPLIED AIR AND VAPOR BARRIER SYSTEM ON XX" CAST IN PLACE CONCRETE BACK-UP WALL WITH ADJUSTABLE (TWO-PIECE) HORIZONTAL MASONRY JOINT REINFORCING @ 16" OC (REFER TO STRUCTURAL DRAWINGS FOR REQUIRED VERTICAL REINFORCING). PROVIDE CAVITY DRAINAGE MATERIAL, FLASHING, CAVITY WEEPS/VENTS @ 24" OC AND MASONRY EXPANSION AND CONTROL JOINTS. COMPARTMENTALIZE THE CAVITY AND PROVIDE CAVITY WEEPS/VENTS AT TOP/BOTTOM OF CAVITY.

W13 EXTERIOR WALL: MASONRY VENEER STUD WALL CONSISTING OF 4" FACE BRICK (EDIT FOR OTHER MATERIAL), 1-3/4" AIR SPACE, 1" RIGID INSULATION, BUILDING WRAP ON 1/2" EXTERIOR GRADE PLYWOOD/OSB SHEATHING (EDIT FOR THICKNESS, VERIFY SHEATHING TYPE W/STRUCTURAL), 2 X 6 WOOD STUDS @ 16" OC | WITH FULL THICKNESS BATT INSULATION, VAPOR RETARDER AND ONE LAYER 5/8" GYPSUM BOARD AT INTERIOR FACE. PROVIDE ADJUSTABLE MASONRY VENEER ANCHORS @ 16" OC EACH WAY, CAVITY DRAINAGE MATERIAL, FLASHING, CAVITY WEEPS/VENTS @ 24" OC AND MASONRY EXPANSION AND CONTROL JOINTS. COMPARTMENTALIZE CAVITY AND PROVIDE CAVITY WEEPS/VENTS AT TOP AND BOTTOM OF CAVITY. W14 EXTERIOR WALL: FIBER CEMENT CLAD WALL CONSISTING OF FIBER CEMENT LAP SIDING, 3/4" RIGID INSULATION, BUILDING WRAP ON 1/2" EXTERIOR GRADE PLYWOOD/OSB SHEATHING (VERIFY SHEATHING

TYPE W/STRUCTURAL), 2 X 6 WOOD STUDS @ 16" OC WITH FULL THICKNESS BATT INSULATION, VAPOR

WB4 EXTERIOR WALL (BELOW GRADE): 12" REINFORCED CAST-IN-PLACE CONCRETE FOUNDATION WALL WITH SHEET MEMBRANE WATERPROOFING. TERMINATE ALL MEMBRANE PERIMETER EDGES WITH 1/8" x 1" ALUMINUM COMPRESSION BAR WITH CONTINUOUS SEALANT. (EDIT FOR: DAMPPROOFING). SHEET MEMBRANE MUST INTERFACE WITH VERTICAL WALL AIR & VAPOR BARRIER LINE. PROVIDE 2" RIGID FOUNDATION INSULATION, EXTEND FULL HEIGHT VERTICALLY.

RETARDER AND ONE LAYER 5/8" GYPSUM BOARD AT INTERIOR FACE.

KEYNOTE LEGEND - INTERIOR PARTITION TYPES INTERIOR PARTITION DESCRIPTION FV4 INTERIOR FURRING (PARTITION): 3-1/2" WOOD STUDS @ 16" OC WITH ONE LAYER 5/8" GYPSUM BOARD.

FLOOR PLAN - SYMBOLS LEGEND NEW WALL/PARTITION EXISTING WALL TO REMAIN DETAIL REFERENCE SECTION REFERENCE **EQUIPMENT** EXTERIOR ELEVATION WINDOW TYPE INTERIOR ELEVATION W1 WALL/PARTITION TYPE FLOOR PLAN KEYNOTE — — — — CONSTRUCTION LIMITS FLOOR DRAIN -PITCH FLOOR TO DRAIN — — ONE HOUR FIRE RESISTIVE CONSTRUCTION _ 2 _ 2 _ TWO HOUR FIRE RESISTIVE CONSTRUCTION

FLOOR PLAN - GENERAL NOTES A. DIMENSIONS ON FLOOR PLAN ARE BASED ON FACE OF FINISHED WALL TO FACE OF FINISHED WALL (NOMINAL).

B. REFER TO SHEET A89X FOR ROOM FINISH SCHEDULE AND NOTES.

C. REFER TO SHEET A89X FOR DOOR SCHEDULES, DOOR TYPES, AND NOTES.

D. ALL EXPOSED STRUCTURAL STEEL AT THE LOWER LEVEL, NEEDS TO BE PROTECTED TO 2 HOURS W/SPRAY APPLIED FIRE PROTECTION.

GYPSUM BOARD PARTITIONS - GENERAL NOTES

MASONRY PARTITIONS - GENERAL NOTES

ALL GYPSUM BOARD PARTITIONS SHALL BE (VA) UNLESS OTHERWISE NOTED ON FLOOR PLAN.

ALL CORRIDOR WALLS SHALL BE VAROUNLESS OTHERWISE NOTED ON FLOOR PLAN.

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REFER TO GYPSUM BOARD SPECIFICATION FOR LOCATION AND TYPE(S) OF GYPSUM BOARD MATERIAL REQUIRED.

PROVIDE TYPE 'X' FIRE RATED GYPSUM BOARD AT ALL FIRE RATED PARTITIONS. SEAL ALL WALL PENETRATIONS AT PERIMETER AND FIRESTOP ALL FIRE RATED PARTITIONS.

EXTEND ALL GYPSUM BOARD PARTITIONS FULL HEIGHT TO UNDERSIDE OF DECK OR ROOF ASSEMBLY ABOVE.


MASONRY PARTITIONS INDICATED WITH THE FOLLOWING HATCH PATTERN:

ALL MASONRY PARTITIONS SHALL BE 8" CONCRETE BLOCK UNLESS OTHERWISE NOTED OR DIMENSIONED. REFER TO FLOOR PLAN FOR PARTITION THICKNESS.

PROVIDE UL RATED CONCRETE BLOCK AT ALL FIRE RATED PARTITIONS.

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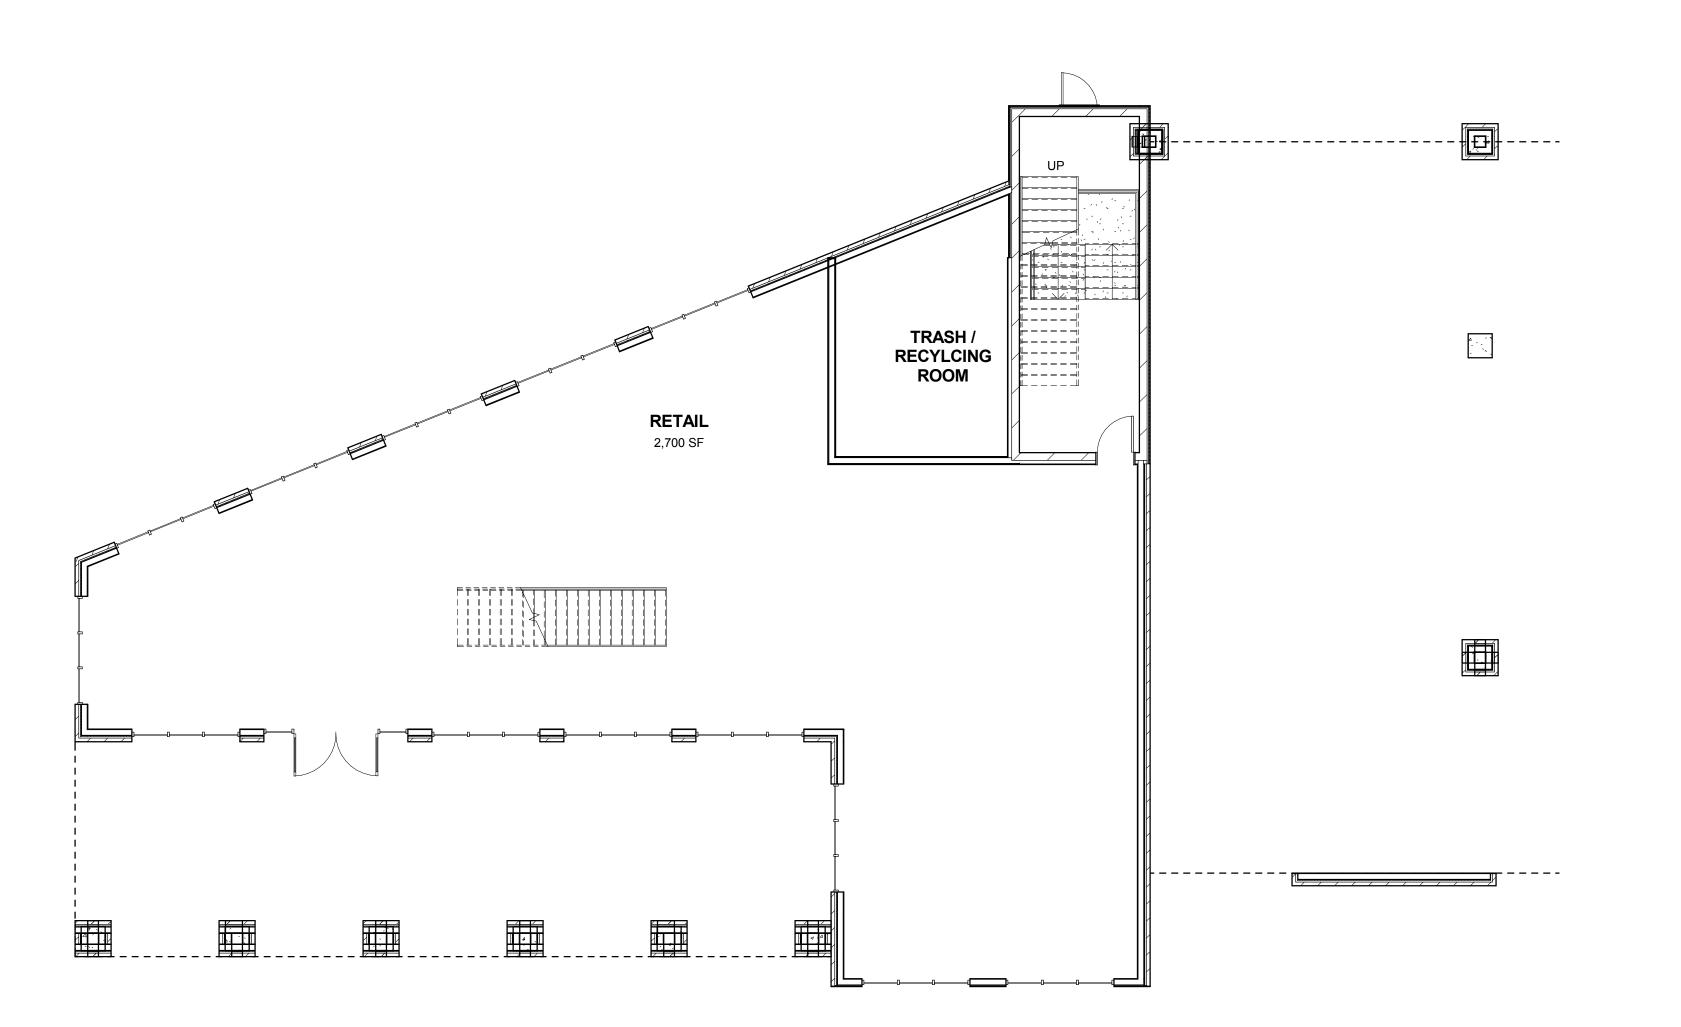


E1 LOWER LEVEL PARKING - SOUTH A200 1/8" = 1'-0"

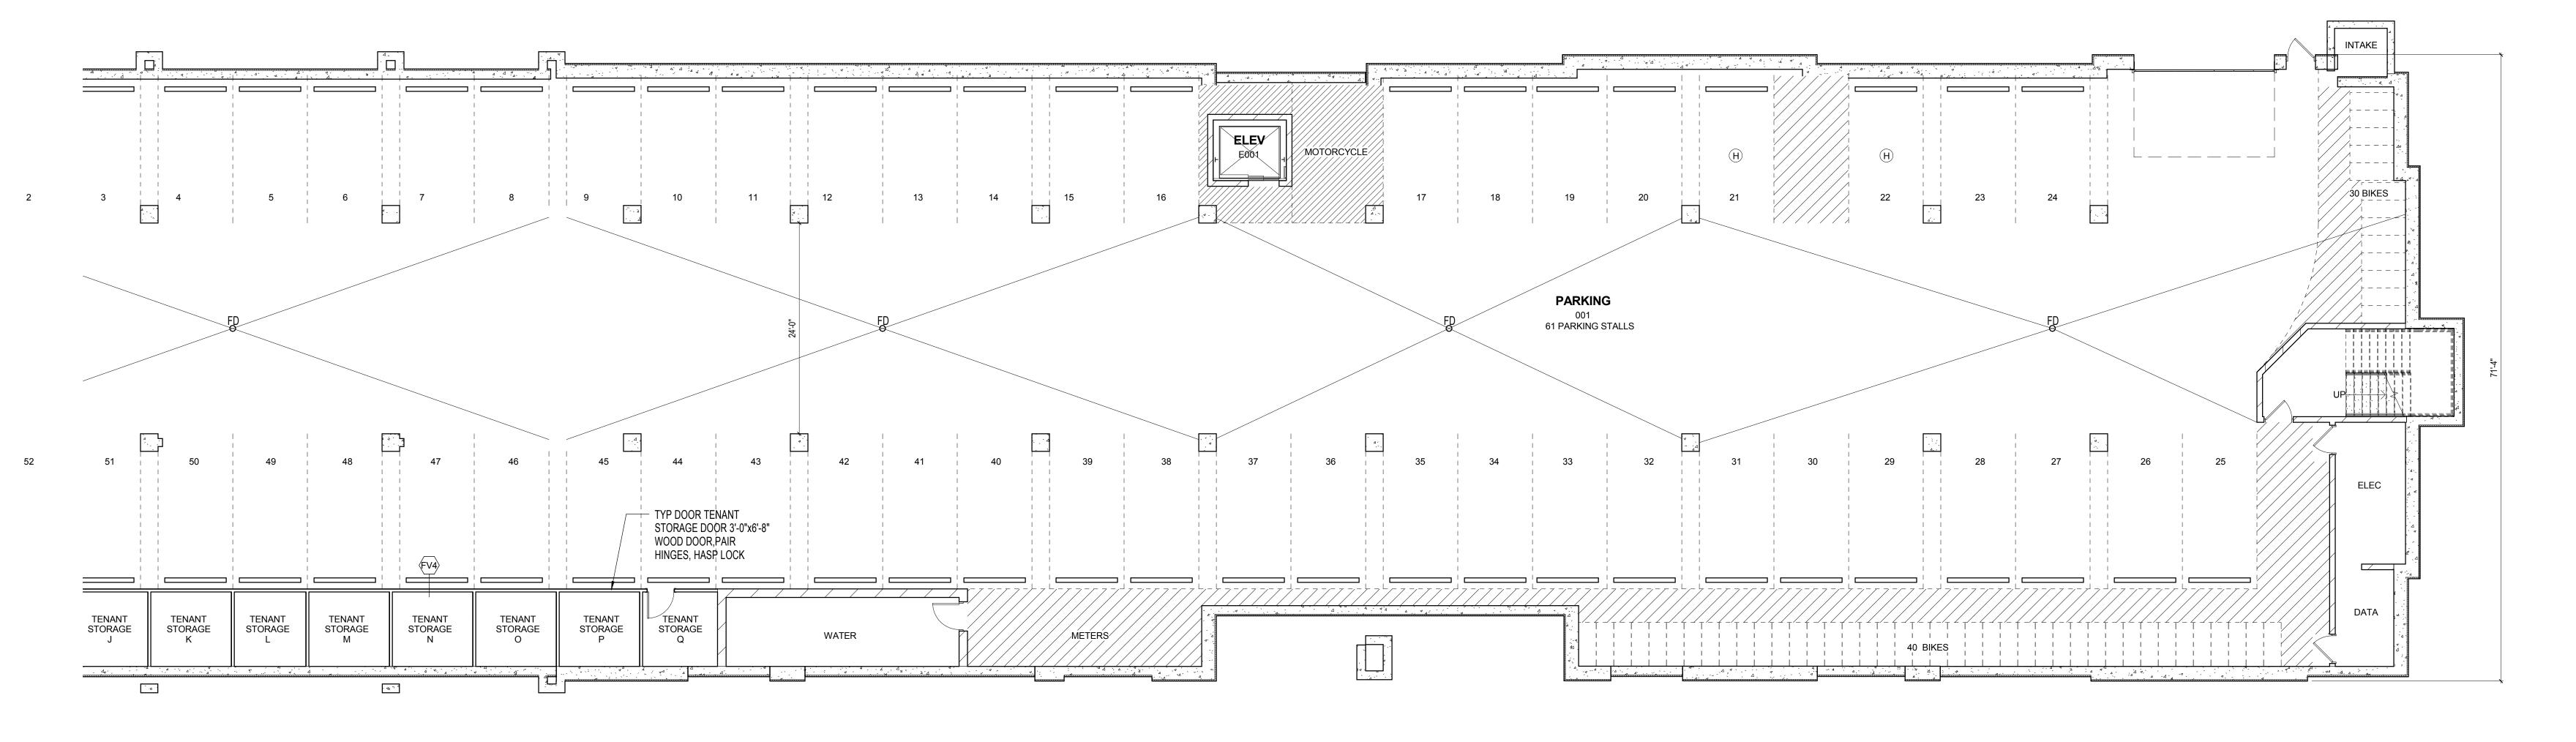C1 LOWER LEVEL PARKING - NORTH
A200 1/8" = 1'-0"

Drawn By:

130139-03



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UNDERLAYMENT ON 3/4" T&G PLYWOOD SUBFLOOR ON XX" WOOD JOIST FLOOR FRAMING WITH FULL-CAVITY

BLOWN IN INSULATION. 5/8" TYPE 'C' GYP BD ON 1/2: RES CHANNELS AT 16" O.C. ON BOTTOM OF WOOD

FRAMING

FLOOR PLAN - SYMBOLS LEGEND NEW WALL/PARTITION EXISTING WALL TO REMAIN EXISTING DOOR TO REMAIN NEW DOOR SECTION REFERENCE DETAIL REFERENCE EQUIPMENT EXTERIOR ELEVATION WINDOW TYPE INTERIOR ELEVATION WALL/PARTITION TYPE FLOOR PLAN KEYNOTE — — — — CONSTRUCTION LIMITS FLOOR DRAIN -PITCH FLOOR TO DRAIN — L ONE HOUR FIRE RESISTIVE CONSTRUCTION _ 2 _ 2 _ TWO HOUR FIRE RESISTIVE CONSTRUCTION

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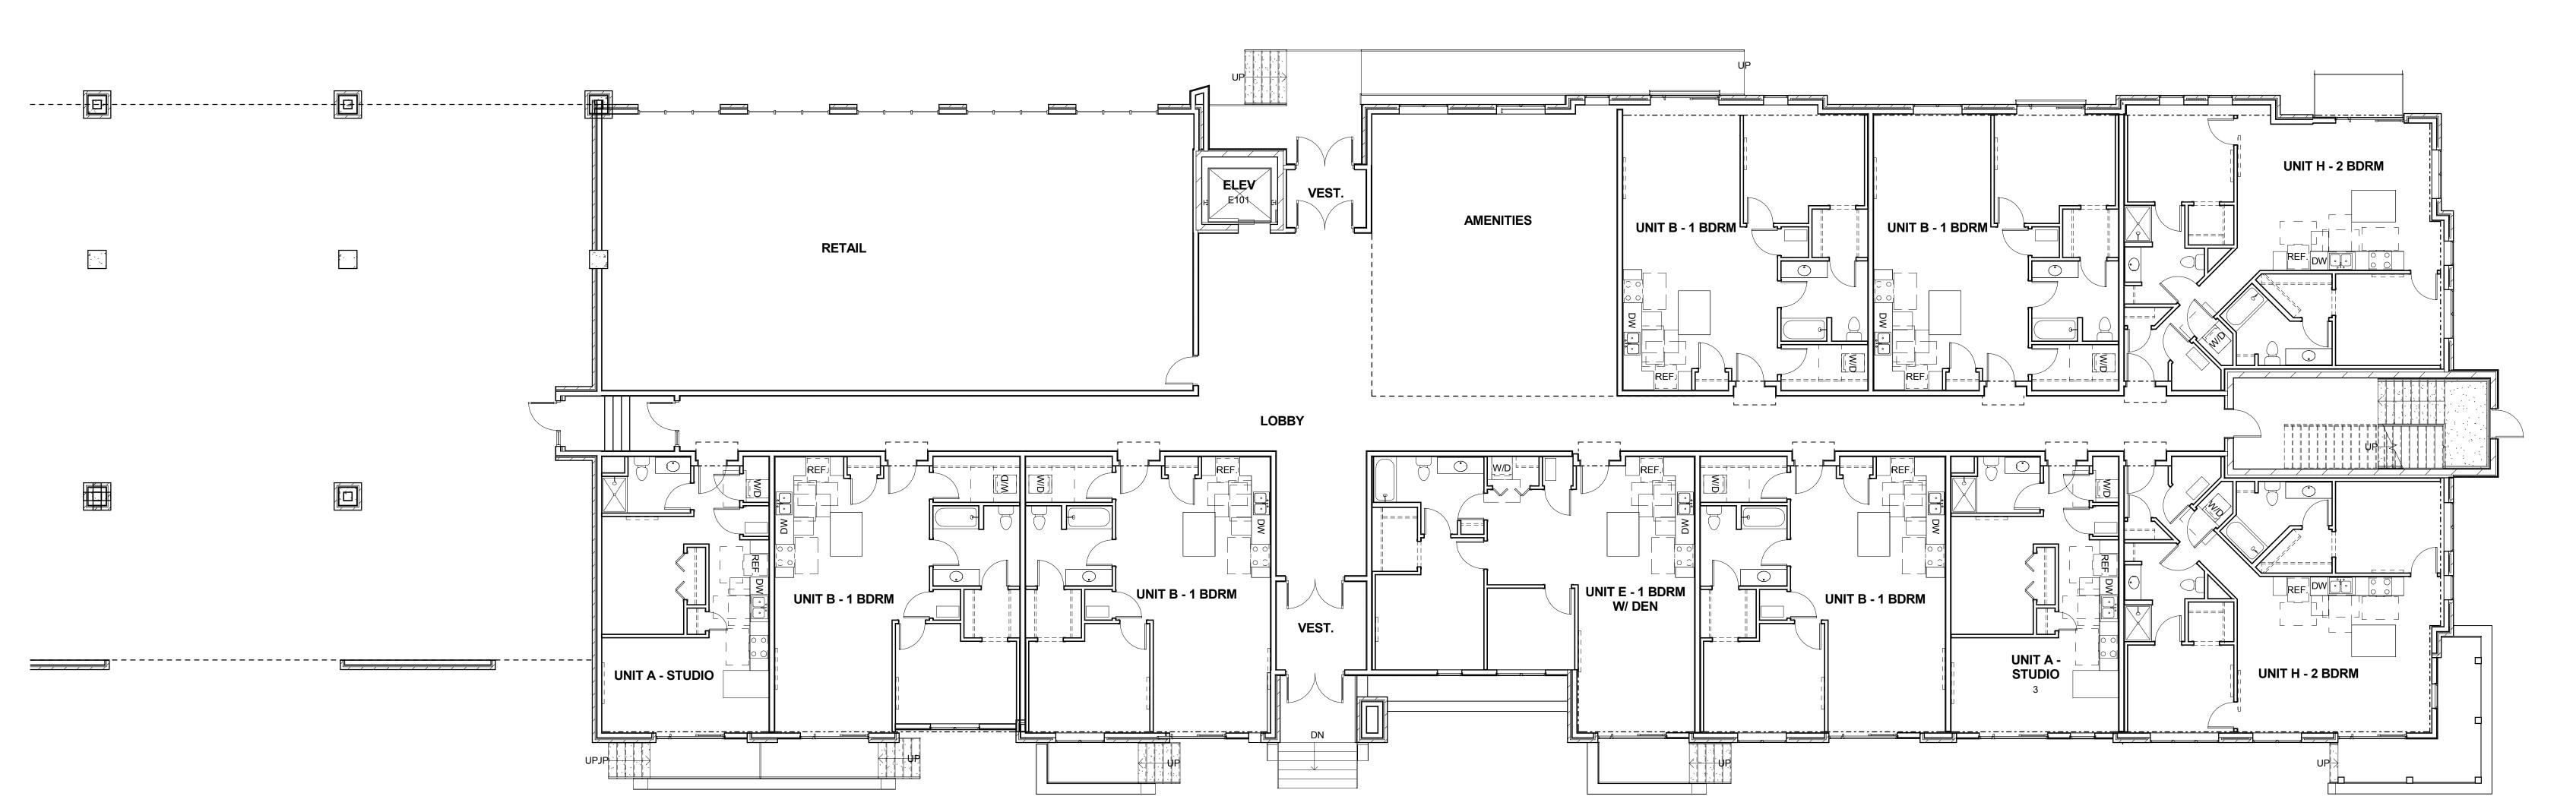
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C1 LEVEL 1 FLOOR PLAN - NORTH
A201 1/8" = 1'-0"



© Plunkett Raysich Architects, LLP


E1 LEVEL 1 FLOOR PLAN - SOUTH


HIN FISH KENZIE PLACE, LLC -2249 Sherman Avenue, Madison WI

Drawn By:
Author

Job No.: 130139-03

Sheet No.: **A201**

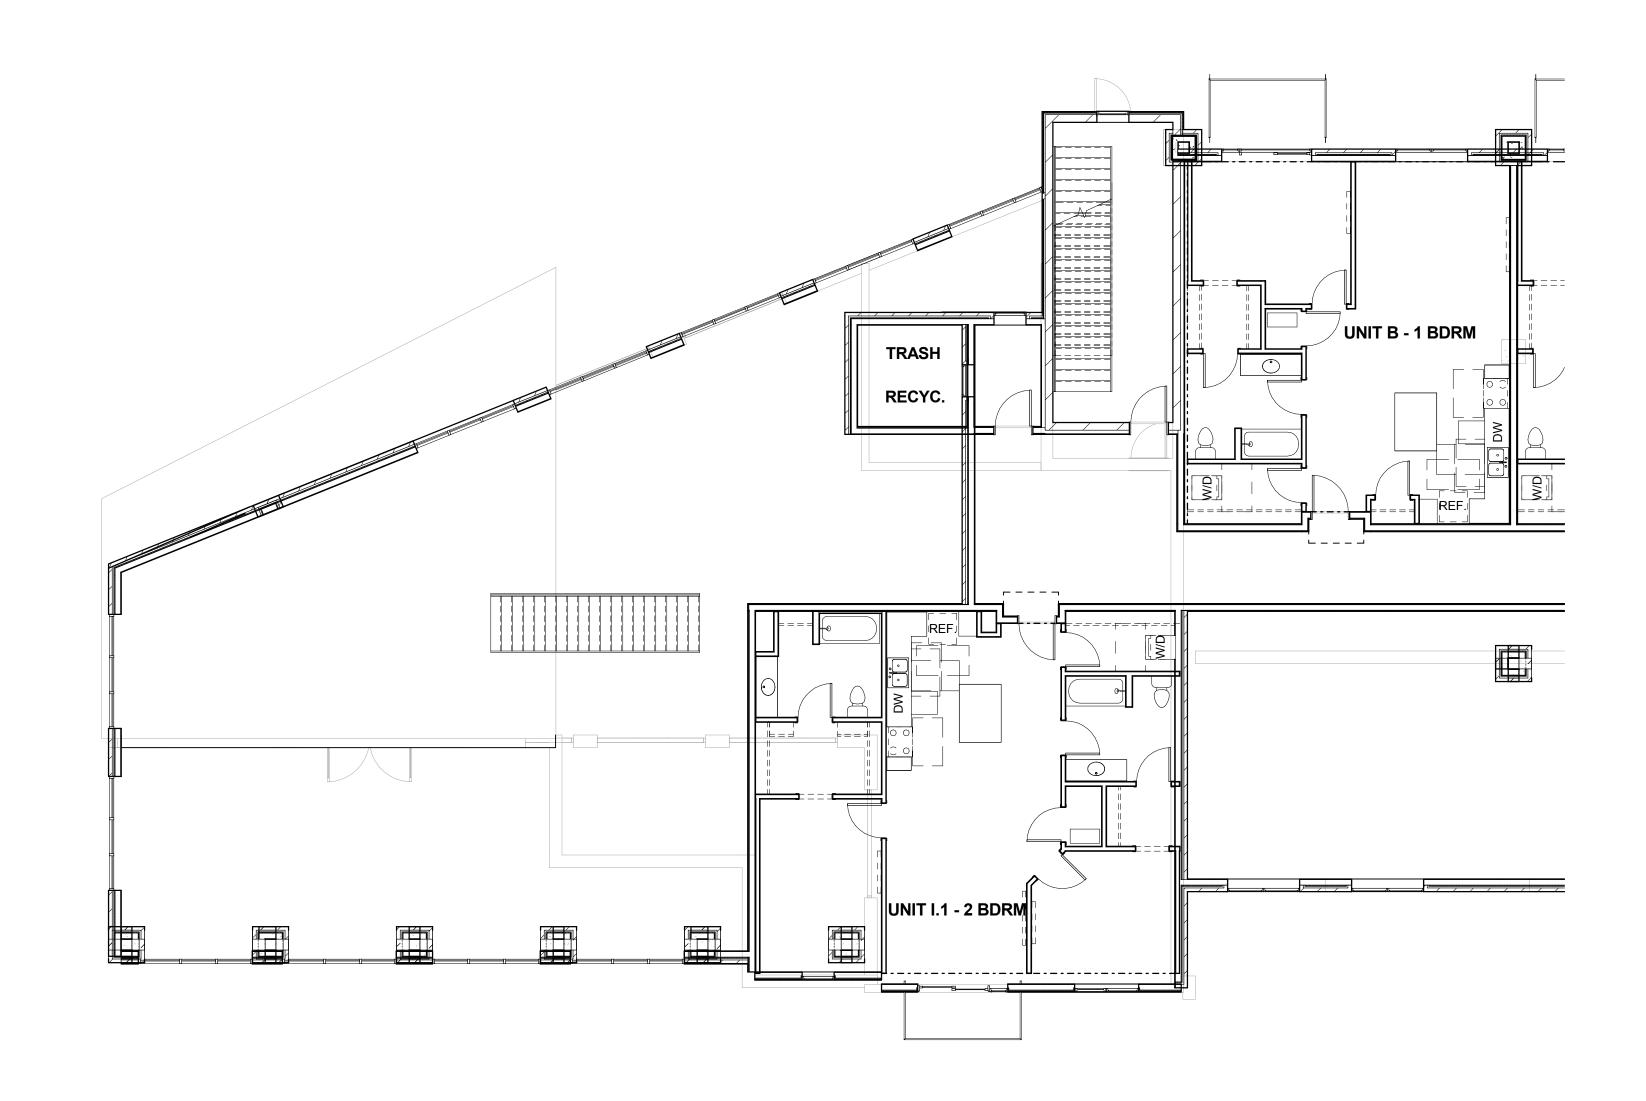


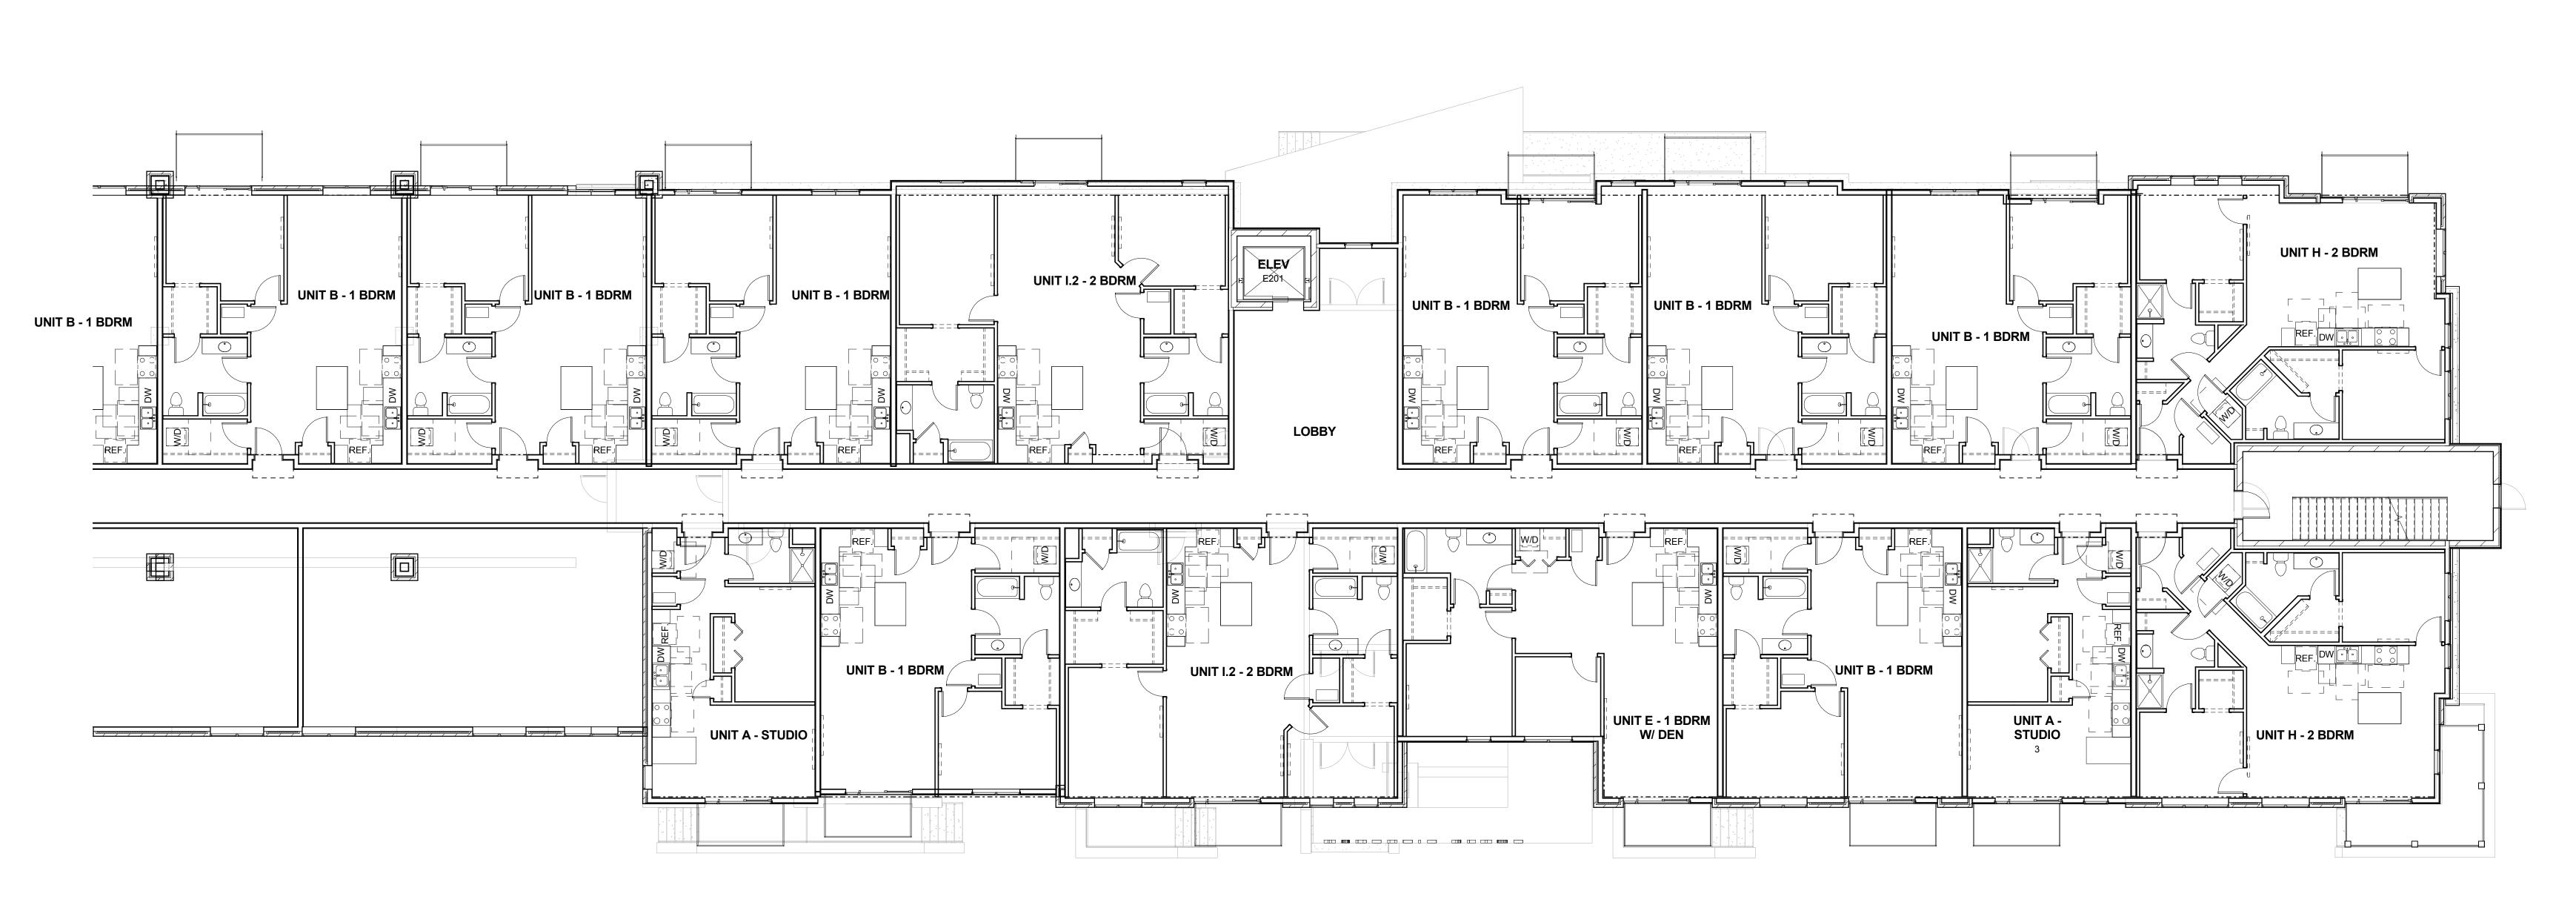

E1 LEVEL 2 FLOOR PLAN - SOUTH A202 1/8" = 1'-0"

C1 LEVEL 2 FLOOR PLAN - NORTH
A202 1/8" = 1'-0"

Drawn By:

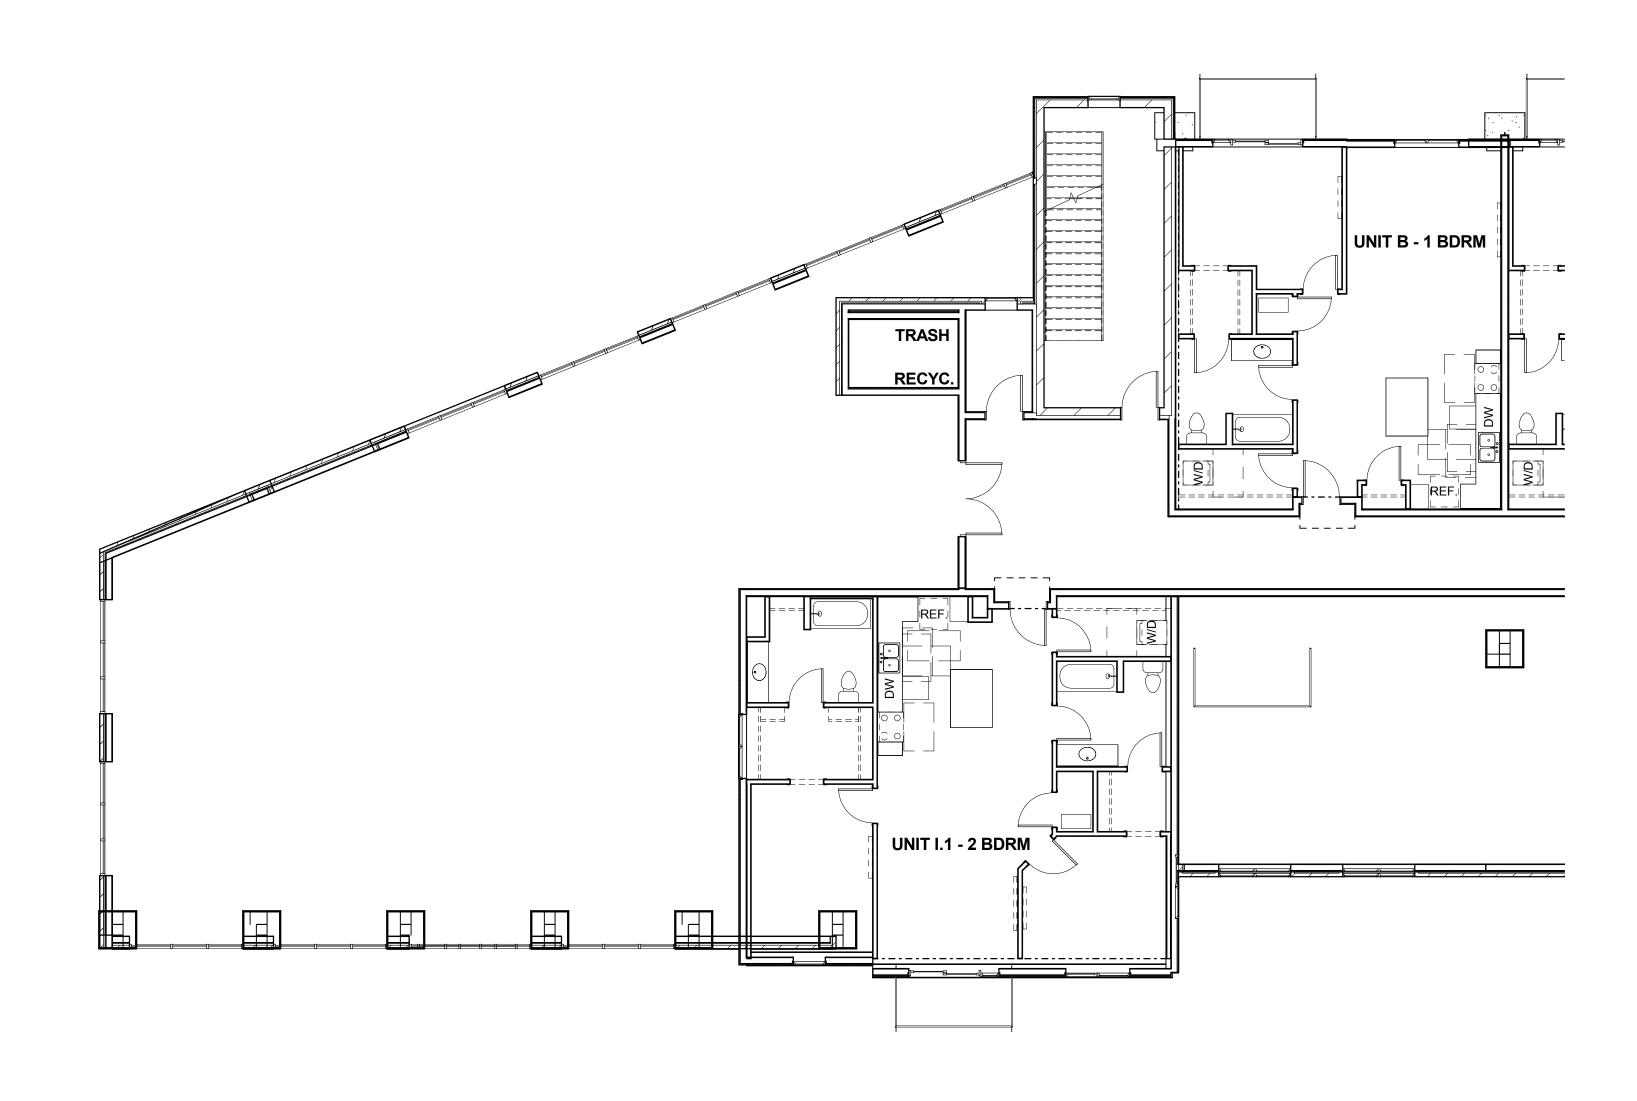



E1 LEVEL 3 FLOOR PLAN - SOUTH A203 1/8" = 1'-0"


C1 LEVEL 3 FLOOR PLAN - NORTH A203 1/8" = 1'-0"


130139-03

Revision Date 1

Drawn By:

07-26-15

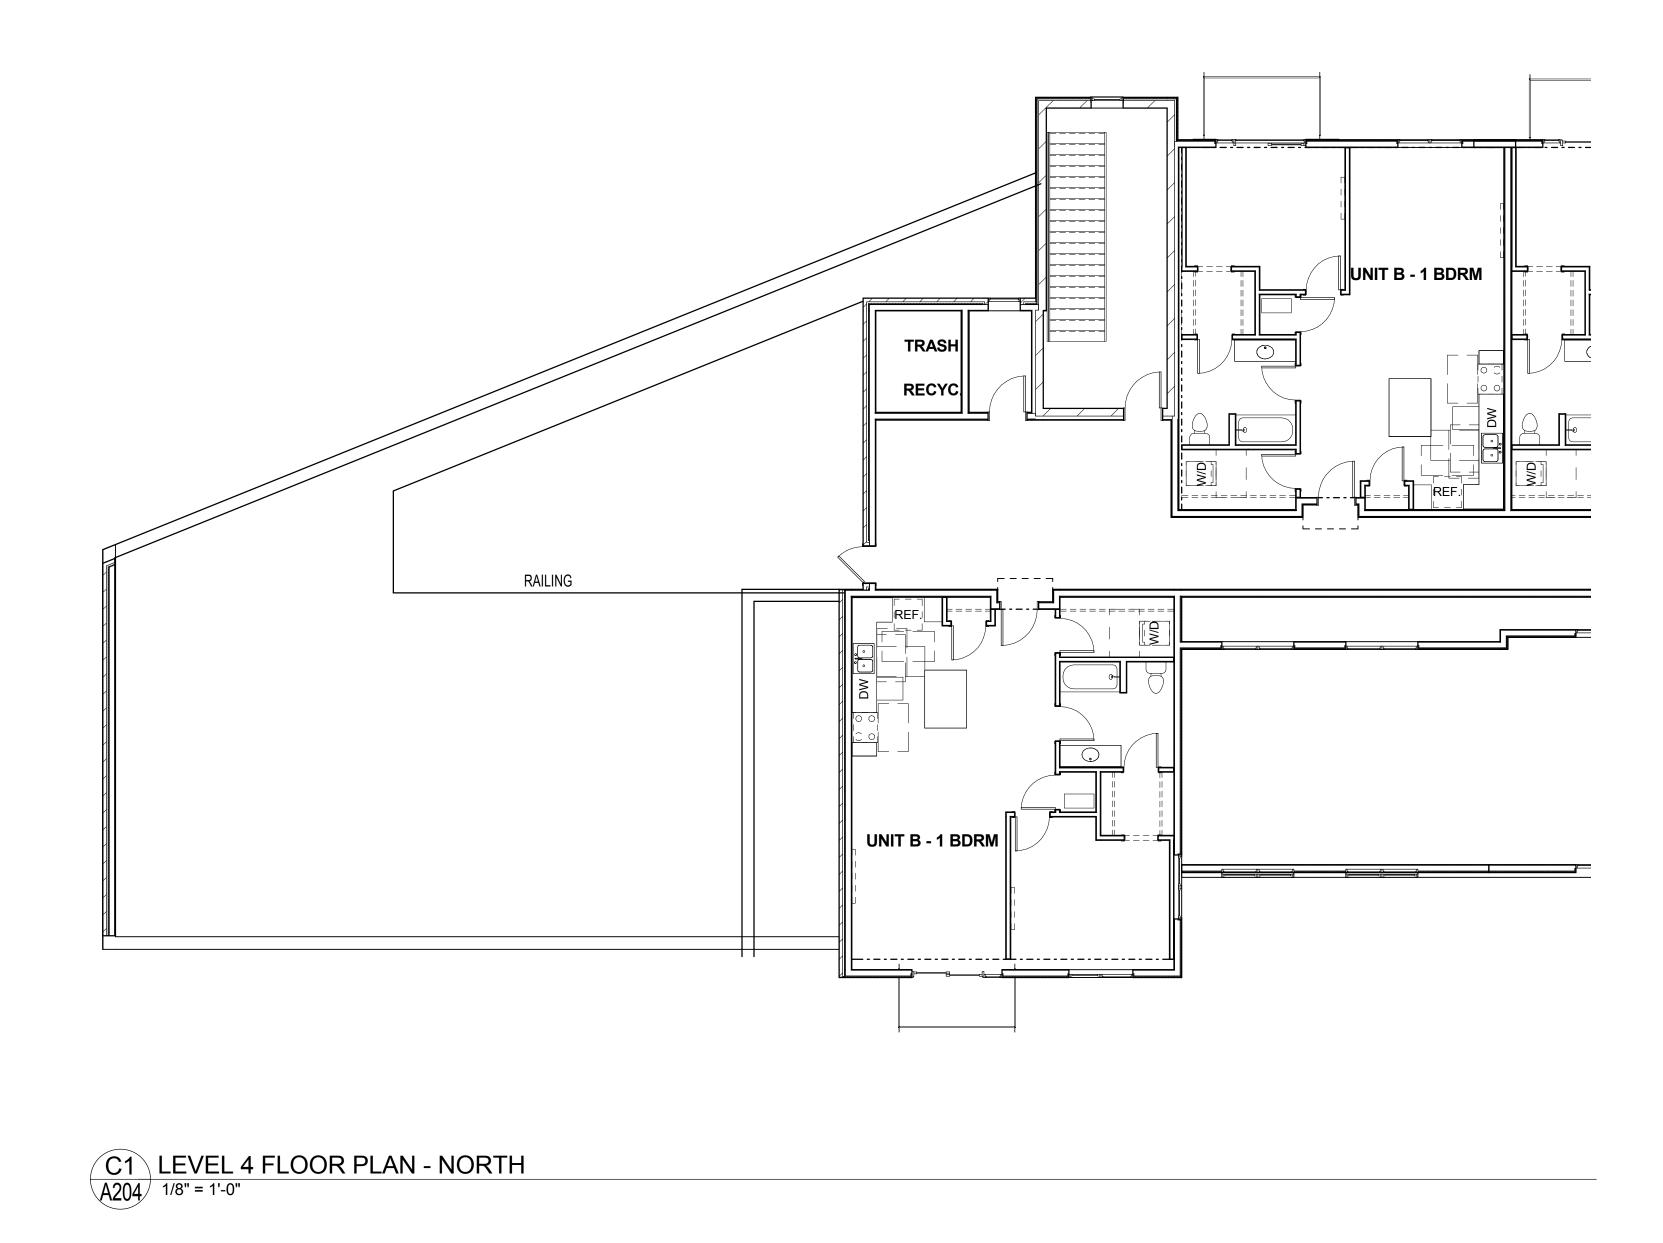

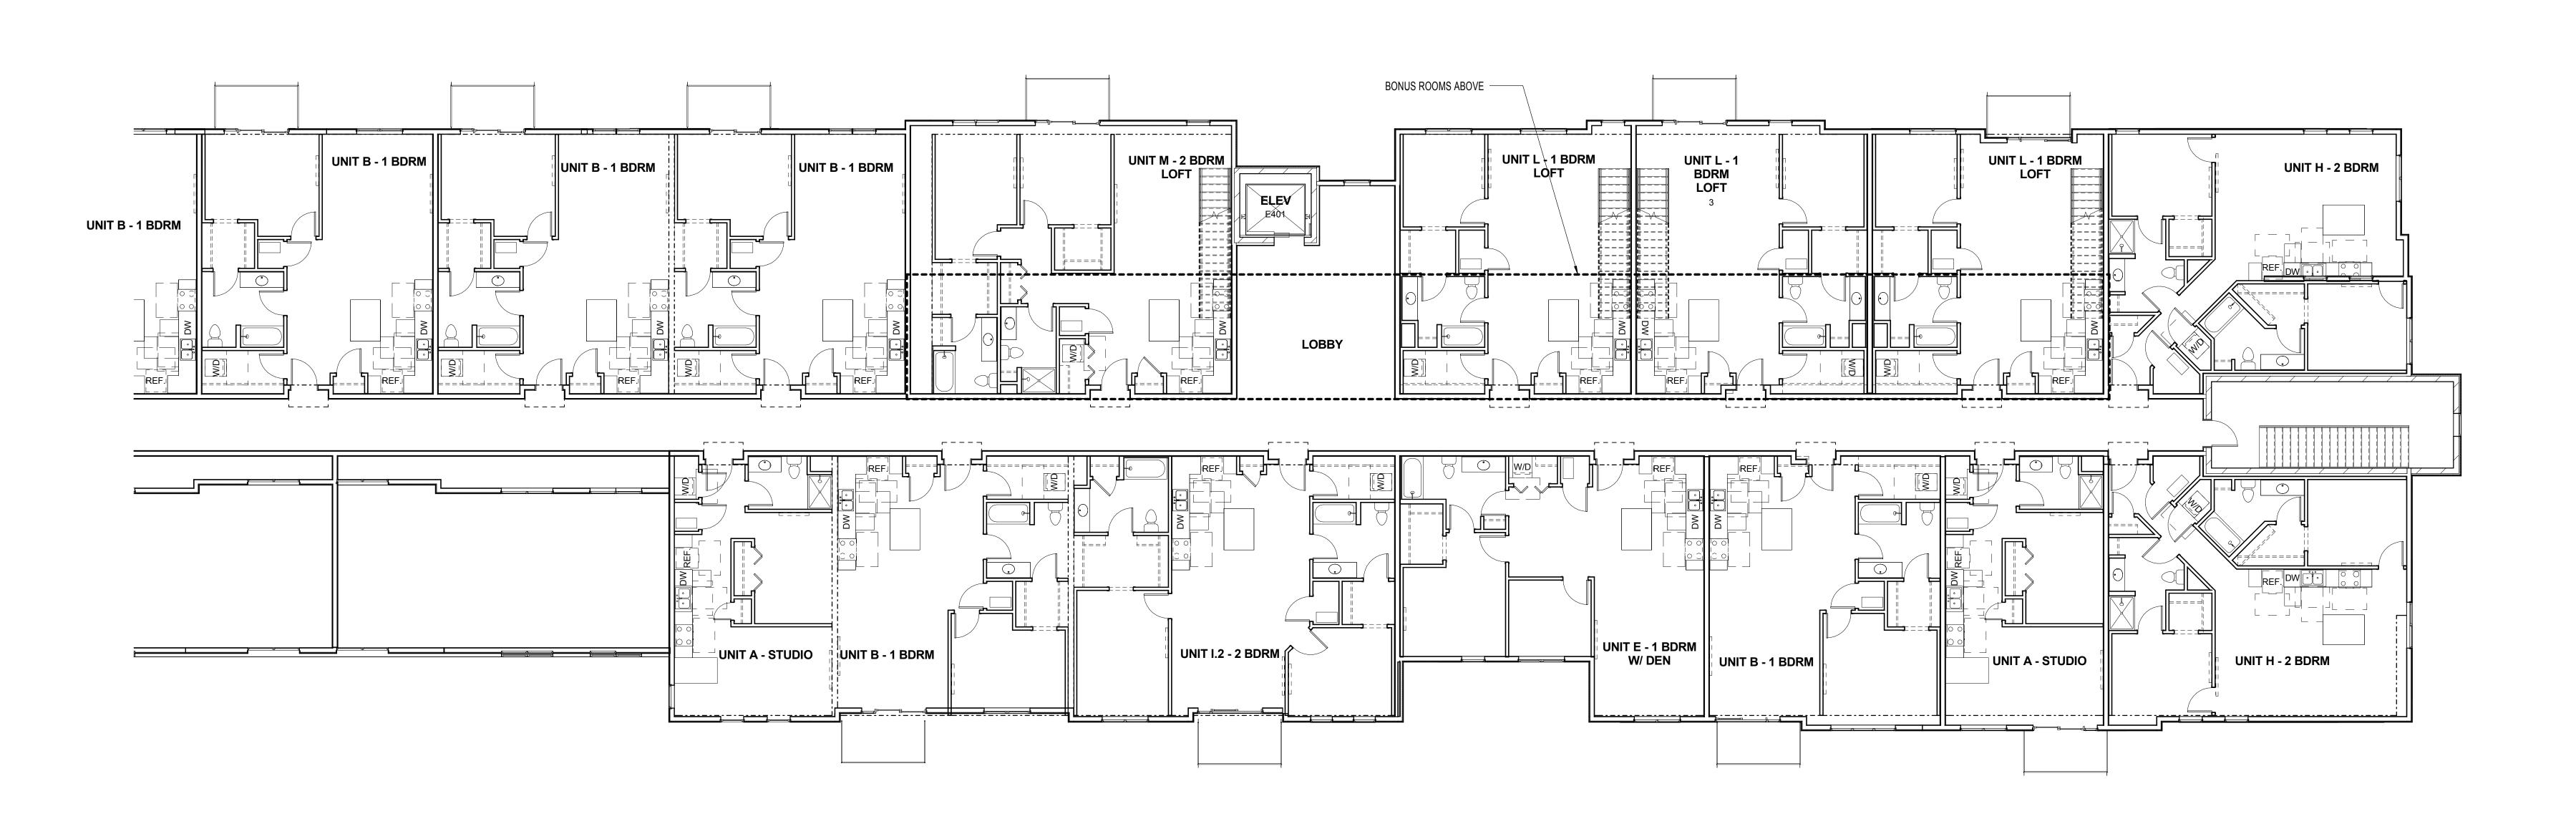

OT FOR CONSTRUCTION
Plunkett Raysich Architects, LLP

130139-03
Sheet No.:
A204

Revisions

Drawn By:



09 September 2015

Mr. Alan Martin
Department of Planning & Development
City of Madison
215 Martin Luther King Jr. Blvd
PO Box 2985
Madison, Wisconsin 53701

Re: McKenzie Place Mixed Use Development Urban Design Commission Advisory Review for a property in the NMX District 2107-2249 Sherman Avenue, Madison, WI

Mr. Alan Martin:

The following is submitted together with the plans and application for the staff and Plan Commission consideration of approval.

Organizational Structure:

Owner/Developer:

McKenzie Place LLC
315 Lakewood Blvd Madison, WI 53717
Madison, WI 53704
Contact: John Fish
Trout204@comcast.net

Architect:

Plunket Raysich Architects, LLP 2310 Crossroads Drive, Suite 2000 Madison, WI 53718 608-478-4013 Contact: Kirk Keller, AIA, NCARB kkeller@prarch.com Engineer & Landscaping: Vierbicher Associates, Inc. 999 Fourier Drive, Suite 201

608-821-3961 Contact: Matt Schreiner msch@vierbicher.com

Introduction:

The triangular, 1.10 acre, property located at the intersection of Sherman Avenue and Fordem Avenue in Madison, Wisconsin currently contains 3 vacant, former commercial buildings in various stages of dilapidation. The site is zoned Neighborhood Mixed-Use. In conjunction with this application, a 2-lot CSM will be submitted to combine the appropriately sub-divided the underlying lots.





Project Description:

The mixed-use project will consist of approximately 61 market rate apartments and approximately 6,700 square feet of commercial / retail space and will include 59 underground parking stalls. The project also includes a two level approximately square foot commercial / retail "pad" site along Fordem Avenue that will be developed in the future.

The main commercial suite at the "point" of the project will be highly visible and include interior mezzanine space with a private outdoor roof top patio. An approximately 21 stall surface parking lot, plus readily available street parking, will serve the commercial / retail space.

The residential component will include "walk-up" units that can be accessed directly from the sidewalk along Sherman Avenue. The building will step-back from the Sherman Avenue frontage, with the building being 4 stories tall along the Fordem Avenue frontage. Five to six of the units on the 4th floor will include a loft-room and private roof-top patio. All other units will enjoy either a balcony or patio. An approximately 59 stall underground parking level along with surface parking, plus immediately adjacent bus routes, and a plethora of bike parking options will accommodate the resident's transportation needs.

Anticipated building amenities will include a community roof-top patio and adjacent community room; an exercise room; dogwash area; external and internal canoe and kayak storage racks; private storage units; secure under –building bike storage; outdoor open space to include a landscaped plaza / seating area and garden plots.

Certified Survey Map

The CSM will create two lots, one to accommodate the mixed-use apartment project and the other to create a pad-site to accommodate the future development of an additional retail or commercial building along Fordem Avenue.

Demolition

The site currently contains three former commercial buildings ranging in size from 2,500 sf to 7,500 sf. The buildings are of no architectural significance and are functionally obsolete either due to a lack of up-keep or configuration. To the extent possible, prior to demolition, all interior materials will be either recycled or donated. Any building components containing asbestos will be properly abated prior to demolition.

Site Development Data:

Densities:

Lot Area: (1) 47,842 S.F. (apartment mixed use building)

(2) 4,000 S.F. (future retail or commercial pad site)


Dwelling Units: 61 units

Lot Area / D.U.: 797 S.F./unit

Density: 54.5 units/acre

Lot 1 Coverage: 35,868 S.F.

Usable Open Space required: 12,640 S.F. required (160 S.F. X 43 units & 320 S.F. X 18 units)

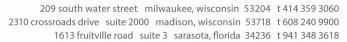



<u>Dwelling Unit Mix:</u> - Apartments Studio: 8

One Bedroom: 29 (includes 1 ADA unit)

One Bedroom plus Den: 4

Two Bedroom: 15 (includes 1 ADA unit)

One Bedroom plus Loft: 4
Two Bedroom plus Loft: 1
Total 61

Building Height: 4 Stories above grade

Floor Area Ratio:

Commercial ~5,600 S.F.

First Level Parking 24,543 (including circulation, storage and utility spaces)

Residential 76,959 (including circulation, amenity areas

Gross Floor Area 107,102 SF Floor Area Ratio 75% (74.97%)

Vehicle Parking Stalls

Surface 21 (16 full size & 3 handicap) <u>Underground</u> 59 (57 full size & 2 handicap)

Total 80

Bicycle parking Stalls

Surface 10 (10 required), (Provided in two locations with five stalls per bike rack)

<u>Underground</u> 65 (60 required), (Tenant and employee use)

Total 75

Project Schedule

Project construction will begin in October, 2015 and continue through August, 2016. The development of the commercial / retail pad site (lot 2) will follow as market demand dictates.

Hours of Operation

The hours of operation of the commercial spaces in the project will vary depending on the specific commercial user.

Thank you for your time reviewing our proposal.

Very Truly Yours,

Kirk Keller

Plunkett Raysich Architects, LLP

209 south water street milwaukee, wisconsin 53204 t 414 359 3060 2310 crossroads drive suite 2000 madison, wisconsin 53718 t 608 240 9900 1613 fruitville road suite 3 sarasota, florida 34236 t 941 348 3618

5. Submission Requirements

Application: Each submittal must include 14 collated paper copies (11" x 17" max.) and an electronic copy of all application materials. The electronic copy must include individual Adobe Acrobat PDF files compiled either on a non-returnable CD-ROM submitted with the paper copies, or in an e-mail sent to: UDCApplications@cityofmadison.com

The transmittal shall include the name of the project, address, and applicant. Applicants unable to provide the materials electronically should contact the Secretary of the Urban Design Commission at 267-8740 for assistance. For an application to be considered complete and scheduled for a UDC meeting, both the paper copies and electronic copy need to be submitted prior to the application deadline. Late materials will not be accepted. An application is required for each UDC appearance. For projects also requiring Plan Commission approval, applicants must have submitted an accepted application for Plan Commission consideration prior to obtaining any formal action (initial or final approval) from the UDC. All plans must be easily read when reduced.

<u>Fees</u>: Fees are required to be paid with the first application for either initial or final approval of a project, unless the project is part of the combined application process involving the Urban Design Commission in conjunction with Plan Commission and/or Common Council consideration. Make checks payable to City Treasurer, Madison, Wisconsin.

<u>Project Plans</u>: The items listed below are minimal application requirements for the type of approval indicated. Please note that the UDC and/or staff may require additional information in order to have a complete understanding of the project.

1.	Info	ormational Presentation
		Locator Map
		Brief Narrative Description of the Project, Site Plan, and 2-dimensional images of proposed buildings or structures. Additional information may provide for a greater level of feedback from the Commission.
		Contextual site information, including photographs and layout of adjacent buildings/structures
		Any and all relevant plans and information on which feedback from the UDC is requested.
2.	<u>Init</u>	tial Approval
		Locator Map
		Contextual site information, including photographs and layout of adjacent buildings/structures
		Site Plan showing location of existing and proposed buildings, walks, drives, bike lanes, bike parking, and existing trees over 18" diameter
		Landscape Plan and Plant List
		Building Elevations for all building sides
		PD text and letter of intent (if applicable)
3.	Fin	al Approval
		Locator Map
		Site Plan showing location of existing and proposed buildings
		Grading Plan
		Landscape Plan
		Plant List, including scientific name, size at planting, quantity and root condition for each species.
		Building Elevations for all building sides, colored with shadow lines, including exterior building materials and colors.
		Proposed Signage
		Lighting Plan, including fixture cut sheets and photometrics plan
		Utility/HVAC equipment location and screening details
		PD text and letter of intent (if applicable)
		Samples of the exterior building materials (presented at the UDC meeting)

<u>Signage</u>: The items listed below are minimal application requirements for the type of approval indicated. Please note that the UDC and/or staff may require additional information in order to have a complete understanding of the project.

1.	<u>Init</u>	ial Approval
		Locator Map
		Signage as it relates to the Sign Control Ordinance provisions for Variances or Comprehensive Design Review of Signage
		Site Plan (show location of all existing and proposed buildings, and all existing and proposed signage, specifying which existing signs, if any, are to be removed)
		Scale drawing of each proposed sign, including awning graphics
		Photographs of site
2.	<u>Fina</u>	al Approval
		Locator Map
		Signage as it relates to the Sign Control Ordinance provisions for Variances or Comprehensive Design Review of Signage
		Site Plan (show location of all existing and proposed buildings, and all existing and proposed signage, specifying which existing signs, if any, are to be removed)
		Scale drawing of each proposed sign, including awning graphics
		Description and/or samples of materials and colors for each proposed sign
		Photographs of site
		Context of signs in surrounding parcels, in addition to the site being discussed

*NOTE: If supplemental perspective renderings are provided, an emphasis should be placed on providing pedestrian/automobile scale viewsheds, in addition to the other required graphics.

*NOTE: If applying for final approval without having received initial approval, all materials required for initial approval will be required.

NOTICE REGARDING LOBBYING ORDINANCE: If you are seeking approval of a development that has over 40,000 square feet of non-residential space, or a residential development of over 10 dwelling units, or if you are seeking assistance from the City with a value of \$10,000 (including grants, loans, TIF, or similar assistance), then you likely are subject to Madison's lobbying ordinance (Sec. 2.40, MGO). You are required to register and report your lobbying. Please consult the City's Clerk's Office for more information. Failure to comply with the lobbying ordinance may result in fines.

Urban Design Commission Approval Process

INTRODUCTION

The City of Madison's Urban Design Commission (UDC) has been created to:

- Encourage and promote high quality in the design of new buildings, developments, remodeling, and additions so as to maintain and improve the established standards of property values within the City.
- Foster civic pride in the beauty and nobler assets of the City, and in all other ways possible assure a functionally efficient and visually attractive City in the future.

TYPES OF APPROVALS

<u>Informational Presentation</u>. Applicants may, at their discretion, request to make an Informational Presentation to the UDC prior to seeking any approvals to obtain early feedback and direction before undertaking detailed design. Applicants should provide details on the context of the site, design concept, site and building plans, and other relevant information to help the UDC understand the proposal and provide feedback.

<u>Initial Approval</u>. Applicants may, at their discretion, request initial approval of a proposal by presenting preliminary design information.

<u>Final Approval</u>. Applicants may request final approval of a proposal by presenting all final project details. Recommendations or concerns expressed by the UDC in the initial approval must be addressed at this time.

PRESENTATIONS TO THE COMMISSION

When presenting projects to the UDC, applicants must fill out a registration slip provided in the meeting room and present it to the Secretary. The applicant is encouraged to consider the use of various graphic presentation material including a locator map, photographs, renderings/model, scale drawings of the proposal in context with adjacent buildings/uses/signs, etc., as may be deemed appropriate to describe the project and its surroundings. Graphics should be mounted on rigid boards so that they may be easily displayed.

Primarily, the UDC is interested in the appearance and design quality of projects. Emphasis should be given to the site plan, landscape plan, lighting plan, building elevations, exterior building materials, color scheme, and graphics.

Presentations should generally be limited to 5 minutes or as extended by motion by consent of the Commission. The Commission will withhold questions until the end of the presentation.