

# URBAN DESIGN COMMISSION APPLICATION CITY OF MADISON

This form may also be completed online at: <a href="http://www.cityofmadison.com/planning/documents/UDCapplication.pdf">http://www.cityofmadison.com/planning/documents/UDCapplication.pdf</a>

215 Martin Luther King Jr. Blvd; Room LL-100 PO Box 2985; Madison, Wisconsin 53701-2985 Phone: 608.266.4635 | Facsimile: 608.267.8739

Please complete all sections of the application, including the desired meeting date and the type of action requested.

Date Submitted: August 26, 2015		☐ Informational Presentation
UDC Meeting Date: September 2, 2015		☐ Initial Approval
Combined Schedule Plan Commission Date (if applicable):		☐ Final Approval
<ol> <li>Project Address: 2107 - 2249 Sherman Ave. Final address: Project Title (if any): McKenzie Place, LLC</li> <li>This is an application for (Check all that apply to this UDC application X New Development Alteration to an Existing or Project Type:</li> </ol>	):	
<ul> <li>□ Project in an Urban Design District* (public hearing-\$300 fee)</li> <li>□ Project in the Downtown Core District (DC) or Urban N</li> <li>□ Suburban Employment Center (SEC) or Campus Institu</li> <li>□ Planned Development (PD)</li> <li>□ General Development Plan (GDP)</li> <li>□ Specific Implementation Plan (SIP)</li> <li>□ Planned Multi-Use Site or Planned Residential Comple</li> </ul>	lixed-Use District (Utional District (CI) o	
B. Signage:  Comprehensive Design Review* (public hearing-\$300 fee) Signage Exception(s) in an Urban Design District (public left) C. Other:	nearing-\$300 fee)	cs Variance* (public hearing-\$300 fee)
Please specify: Advisory presentation as requested by  Applicant Agent & Property Owner Information:	Jay Wentz. Informat	cional boxes checked on page 2
3. Applicant, Agent & Property Owner Information:		
3. Applicant, Agent & Property Owner Information:  Applicant Name: John Fish	Company: McKenzi	e Place, LLC
3. Applicant, Agent & Property Owner Information:  Applicant Name:John Fish  Street Address:315 Lakewood Blvd.  Telephone (608) 319 7766	Company: McKenzi City/State: Madison	e Place, LLC  ., WI Zip:53704
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3. Applicant, Agent & Property Owner Information:  Applicant Name:John Fish  Street Address:315 Lakewood Blvd.  Telephone:(_608) 219.7766 Fax:()NA	Company: McKenzi City/State: Madison Email: trout20	e Place, LLC  , WI Zip: _53704  04@comcast.net
3. Applicant, Agent & Property Owner Information:  Applicant Name:John Fish  Street Address:315 Lakewood Blvd.  Telephone:(_608) 219.7766 Fax:()_NA  Project Contact Person:	Company: McKenzi City/State: Madison Email: trout20 Company: City/State: Madison	e Place, LLC  , WI Zip: _53704  04@comcast.net
3. Applicant, Agent & Property Owner Information:  Applicant Name:John Fish	Company: McKenzi City/State: Madison Email: trout20  Company: City/State: Madison Email: kkeller@	e Place, LLC  7, WI Zip: _53704  94@comcast.net  7, WI Zip: _53718  Pprarch.com
3. Applicant, Agent & Property Owner Information:  Applicant Name:John Fish  Street Address:315 Lakewood Blvd.  Telephone:(_608) 219.7766 Fax:() NA  Project Contact Person:  Street Address:2310 Crossroads Dr., Suite 2000  Telephone:(_608)478.4013 Fax:() NA  Project Owner (if not applicant):  Street Address:	Company: McKenzi City/State: Madison Email: trout20 Company: City/State: Madison Email: kkeller@	e Place, LLC  2, WI Zip: _53704  24@comcast.net  Zip: _53718  2prarch.com  Zip: _53718
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28 August 2015

Mr. Alan Martin
Department of Planning & Development
City of Madison
215 Martin Luther King Jr. Blvd
PO Box 2985
Madison, Wisconsin 53701

Re: McKenzie Place Mixed Use Development Urban Design Commission Advisory Review for a property in the NMX District 2107-2249 Sherman Avenue, Madison, WI

Mr. Alan Martin:

The following is submitted together with the plans and application for the staff and Plan Commission consideration of approval.

#### **Organizational Structure:**

#### Owner/Developer:

McKenzie Place LLC 315 Lakewood Blvd Madison, WI 53704 Contact: John Fish Trout204@comcast.net

**Architect:** 

Plunket Raysich Architects, LLP 2310 Crossroads Drive, Suite 2000 Madison, WI 53718 608-478-4013 Contact: Kirk Keller, AIA, NCARB kkeller@prarch.com Engineer & Landscaping: Vierbicher Associates, Inc. 999 Fourier Drive, Suite 201 Madison, Wi 53717 608-821-3961 Contact: Matt Schreiner msch@vierbicher.com

### Introduction:

The triangular, 1.10 acre, property located at the intersection of Sherman Avenue and Fordem Avenue in Madison, Wisconsin currently contains 3 vacant, former commercial buildings in various stages of dilapidation. The site is zoned Neighborhood Mixed-Use. In conjunction with this application, a 2-lot CSM will be submitted to combine the appropriately sub-divided the underlying lots.





#### **Project Description:**

The mixed-use project will consist of 61 market rate apartments and approximately 6,700 square feet of commercial / retail space and will include 59 underground parking stalls. The project also includes a 6,667 square foot commercial / retail "pad" site along Fordem Avenue that will be developed in the future.

The main commercial suite at the "point" of the project will be highly visible and include interior mezzanine space with a private outdoor roof top patio. An approximately 23 stall surface parking lot, plus readily available street parking, will serve the commercial / retail space.

The residential component will include "walk-up" units that can be accessed directly from the sidewalk along Sherman Avenue. The building will step-back from the Sherman Avenue frontage, with the building being 4 stories tall along the Fordem Avenue frontage. Six of the units on the 4<sup>th</sup> floor will include a loft-room and private roof-top patio. All other units will enjoy either a balcony or patio. A 60 stall underground parking level along with surface parking, plus immediately adjacent bus routes, and a plethora of bike parking options will accommodate the resident's transportation needs.

Anticipated building amenities will include a community roof-top patio and adjacent community room; an exercise room; dogwash area; external and internal canoe and kayak storage racks; private storage units; secure bike storage; outdoor open space to include a landscaped plaza / seating area and garden plots.

#### **Certified Survey Map**

The CSM will create two lots, one to accommodate the mixed-use apartment project and the other to create a pad-site to accommodate the future development of an additional retail or commercial building along Fordem Avenue.

### **Demolition**

The site currently contains three former commercial buildings ranging in size from 2,500 sf to 7,500 sf. The buildings are of no architectural significance and are functionally obsolete either due to a lack of up-keep or configuration. To the extent possible, prior to demolition, all interior materials will be either recycled or donated. Any building components containing asbestos will be properly abated prior to demolition.

#### **Site Development Data:**

Densities:

Lot Area: (1) 47,842 S.F. (apartment mixed use building)

(2) 6,667 S.F. (future retail or commercial pad site)

Dwelling Units: 60 units

Lot Area / D.U.: 797 S.F./unit

Density: 54.5 units/acre

Lot 1 Coverage: 35,868 S.F.

Usable Open Space required: 12,480 S.F. required (160 S.F. X 42 units & 320 S.F. X 18 units)

209 south water street milwaukee, wisconsin 53204 t 414 359 3060 2310 crossroads drive suite 2000 madison, wisconsin 53718 t 608 240 9900 1613 fruitville road suite 3 sarasota, florida 34236 t 941 348 3618

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<u>Dwelling Unit Mix:</u> - Apartments

Studio: 8

One Bedroom: 30 (includes 1 ADA unit)

One Bedroom plus Den: 4

Two Bedroom: 15 (includes 1 ADA unit)

One Bedroom plus Loft: 3
Two Bedroom plus Loft: 1
Total 61

Building Height: 4 Stories above grade

Floor Area Ratio:

Commercial `5,500S.F.

First Level Parking 24,543 (including circulation, storage and utility spaces)

Residential 76,959 (including circulation, amenity areas

Gross Floor Area 107,591 SF Floor Area Ratio 75% (74.97%)

Vehicle Parking Stalls

Surface 19 (16 full size & 3 handicap) Underground 59 (57 full size & 2 handicap)

Total 78

Bicycle parking Stalls

Surface 10 (10 required)
Underground 65 (60 required)

Total 75

### **Project Schedule**

Project construction will begin in October, 2015 and continue through July, 2016. The development of the commercial / retail pad site will follow as market demand dictates.

#### **Hours of Operation**

The hours of operation of the commercial spaces in the project will vary depending on the specific commercial user.

Thank you for your time reviewing our proposal.


Very Truly Yours,


Kirk Keller

Plunkett Raysich Architects, LLP

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West Elevation

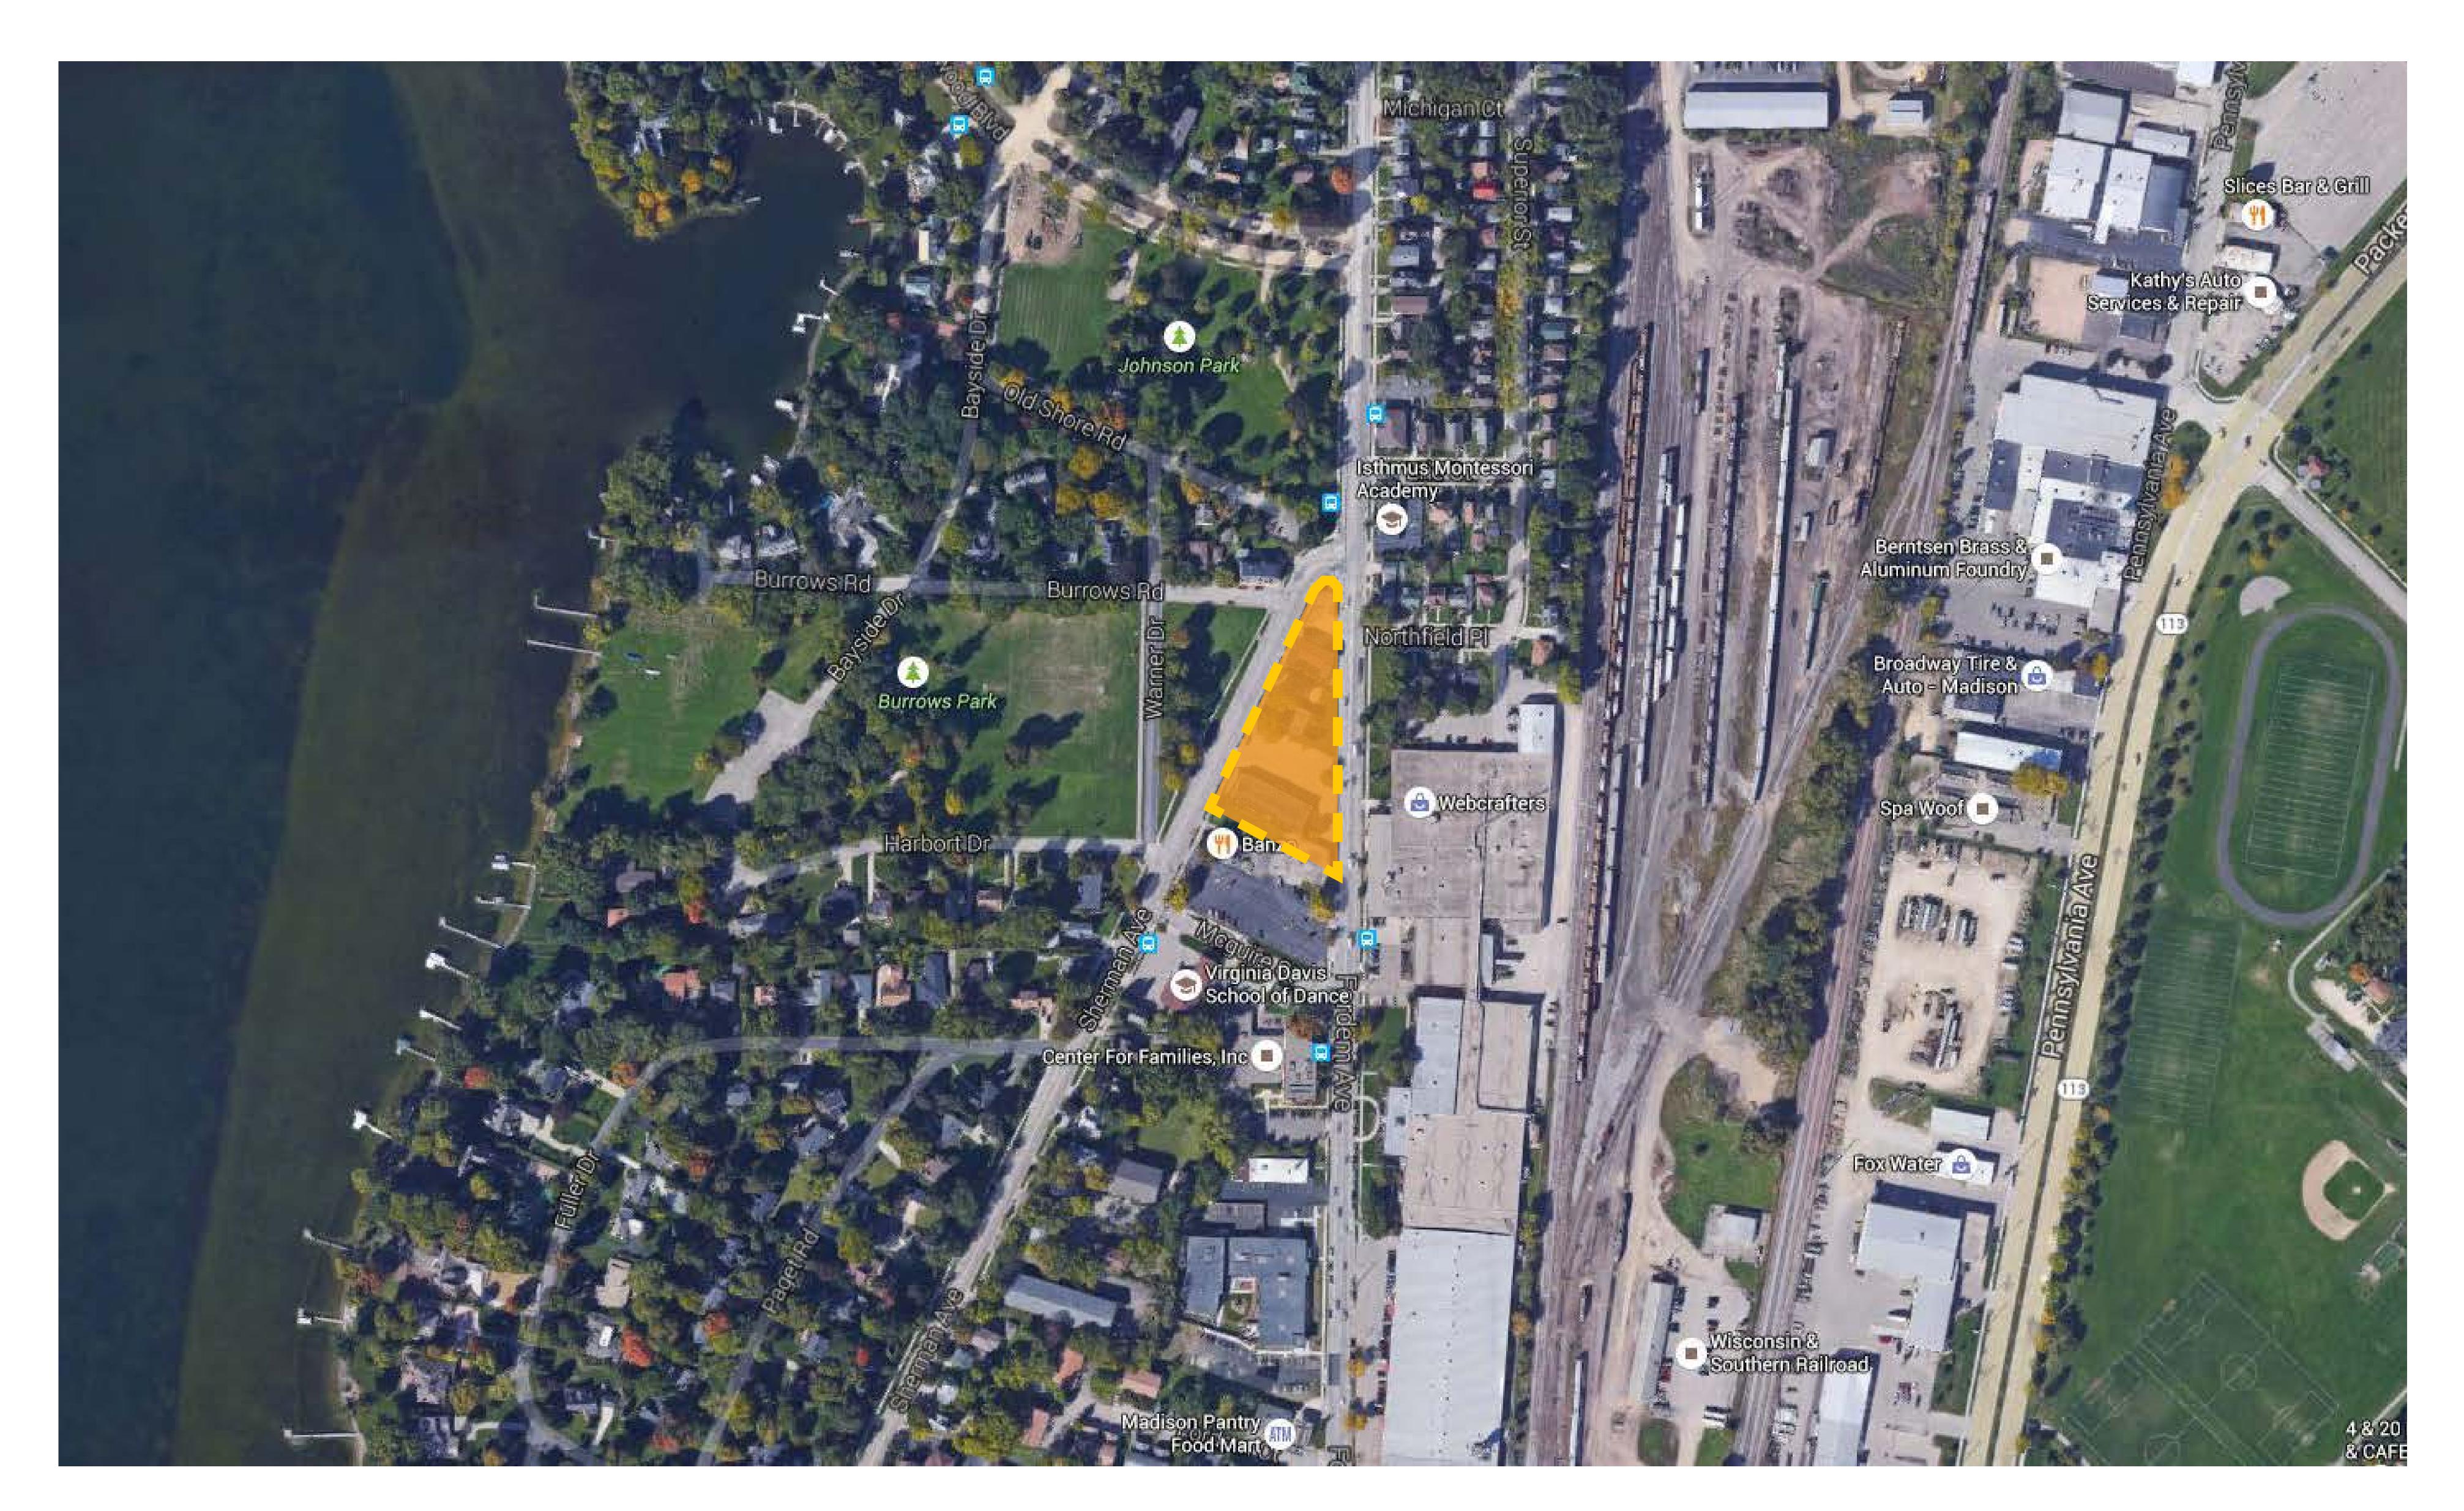

**East Elevation** 

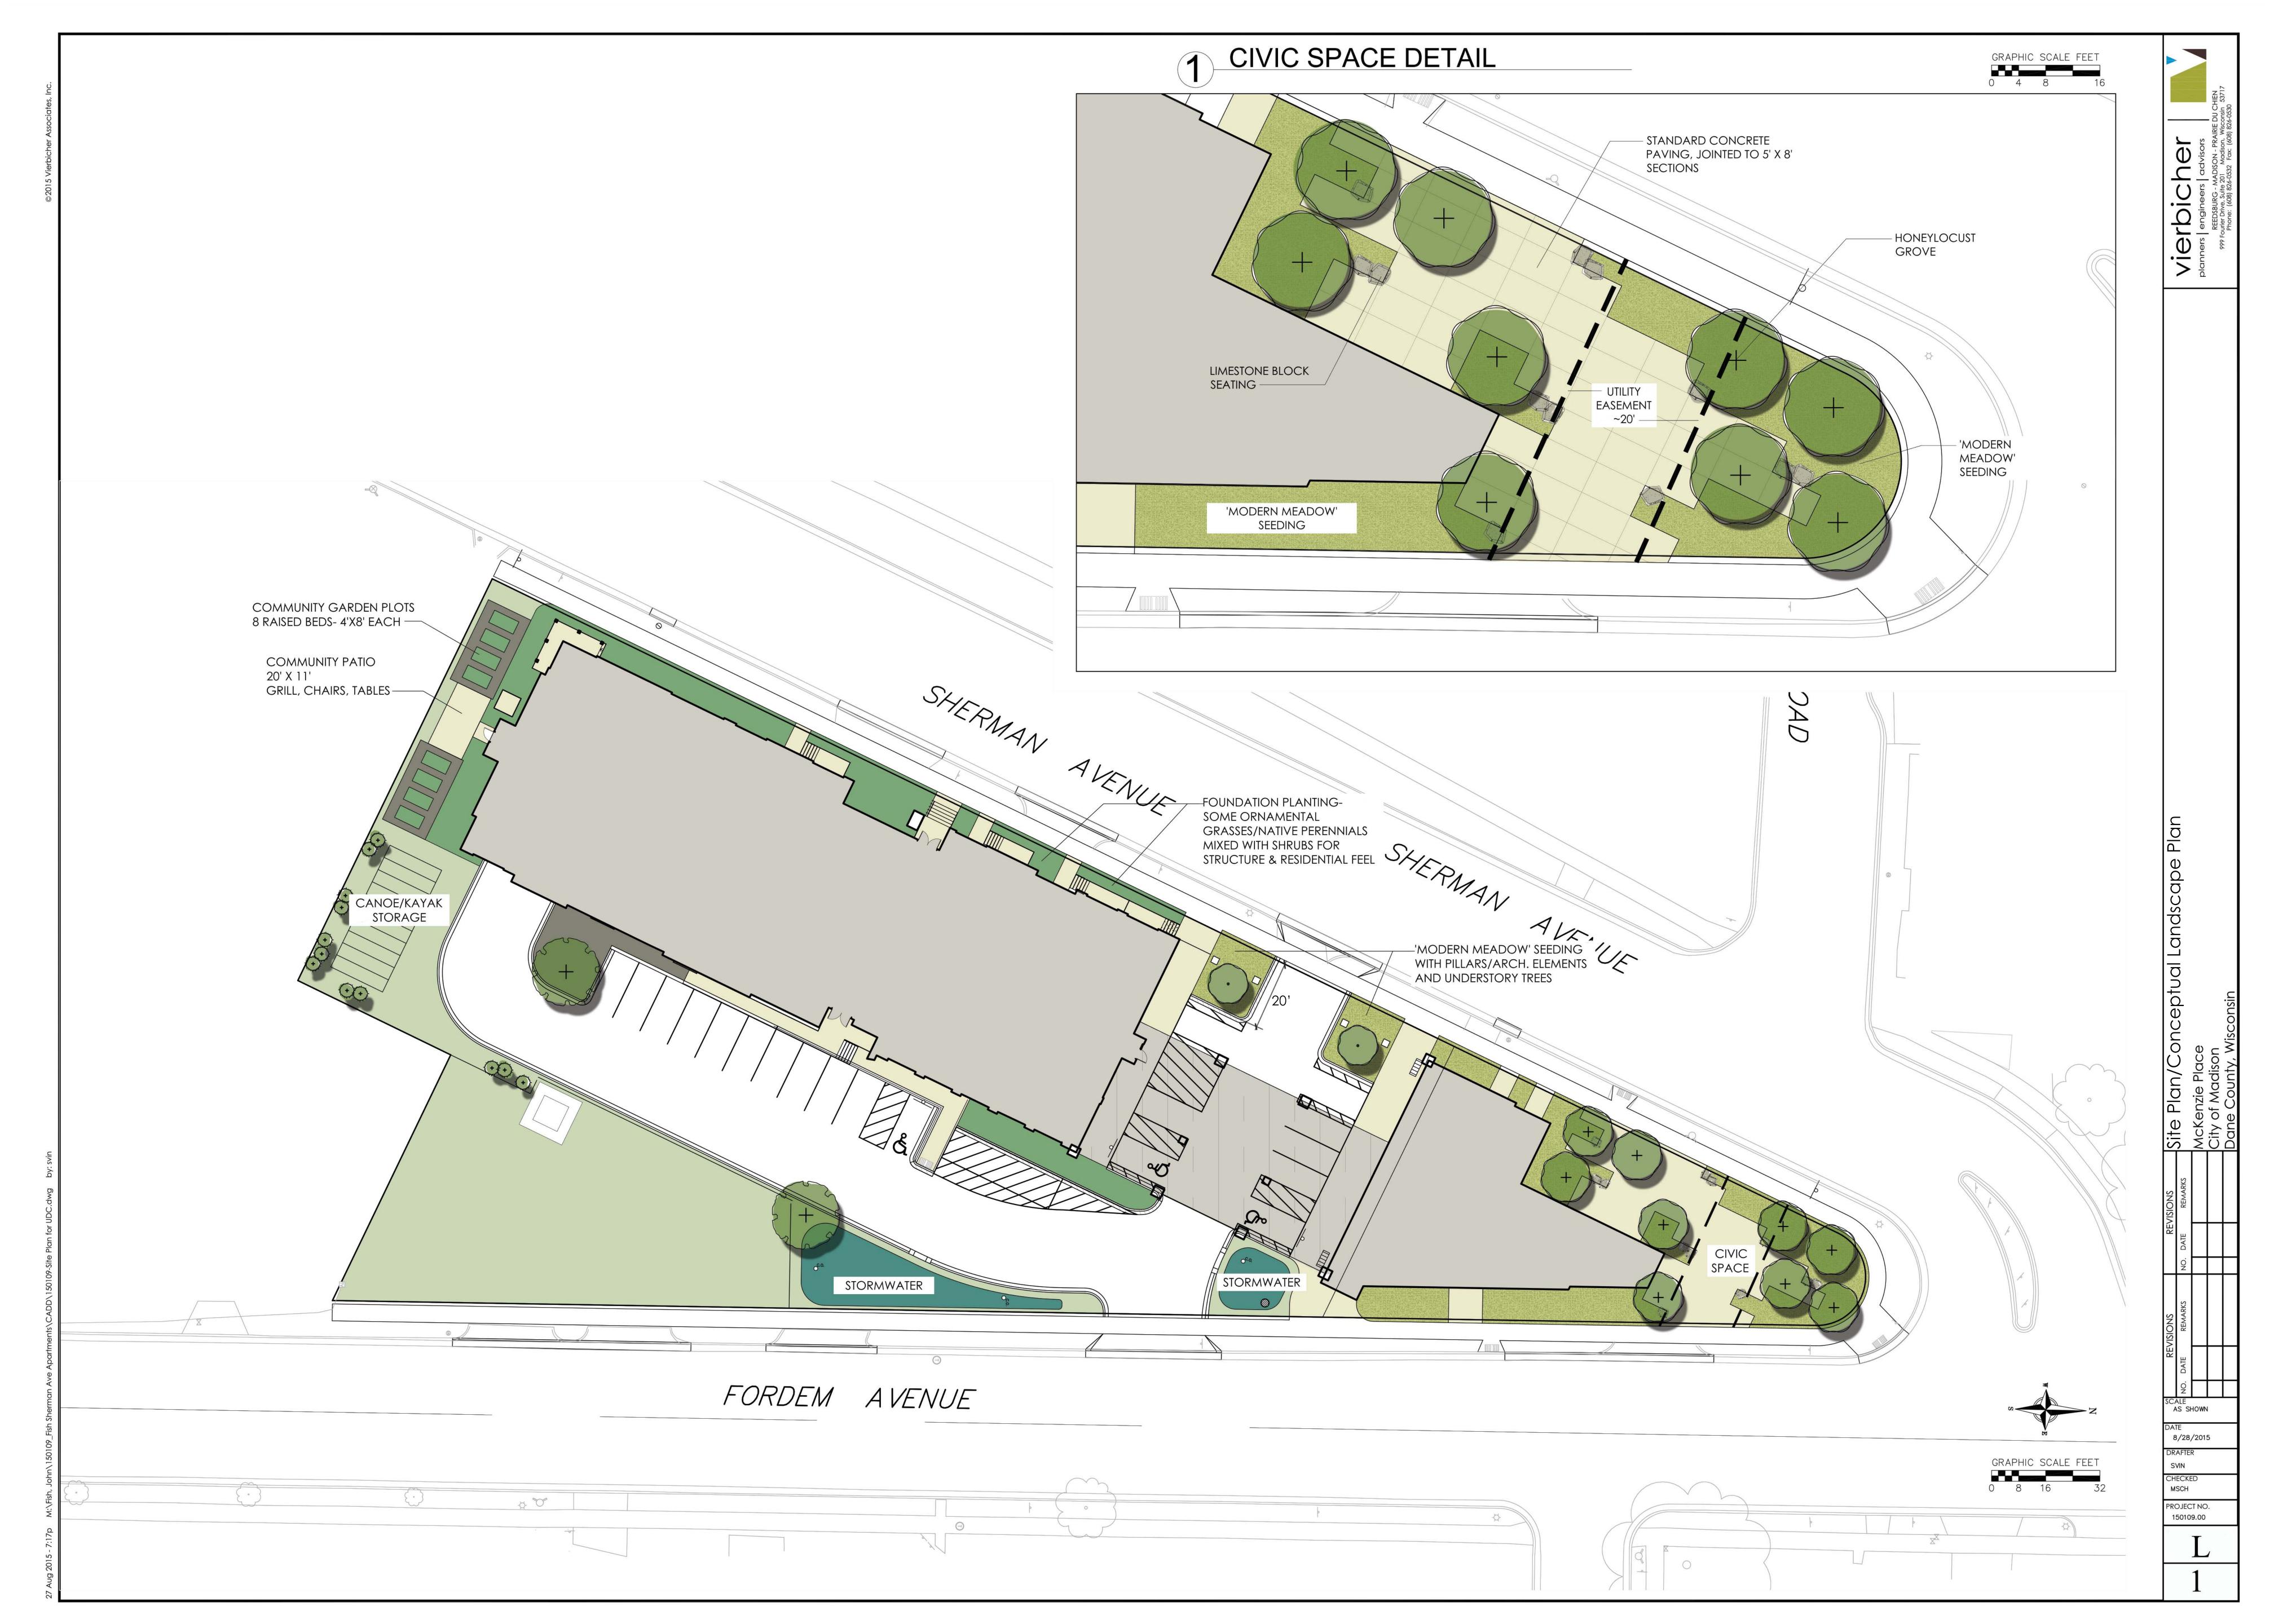**KEYNOTE LEGEND - CONSTRUCTION TYPES** CONSTRUCTION DESCRIPTION R2 SINGLE PLY ROOFING SYSTEM, 1 HOUR RATED ASSEMBLY UL DESIGN #P522 : FULLY ADHERED TPO MEMBRANE ON TAPERED RIGID INSULATION ON 3/4" EXTERIOR WOOD SHEATHING ON 24" WOOD TRUSS ROOF FRAMING WITH FULL-CAVITY BLOWN IN INSULATION. 5/8" TYPE 'C' GYPSUM BOARD ON VAPOR RETARDER ON RESILIENT CHANNELS AT 16" O.C. DIRECTLY SECURED TO UNDERSIDE OF WOOD R2A SINGLE PLY ROOFING SYSTEM, 1 HOUR RATED ASSEMBLY UL DESIGN #P522 : FULLY ADHERED TPO MEMBRANE ON TAPERED RIGID INSULATION ON 3/4" EXTERIOR WOOD SHEATHING ON XXX" WOOD JOIST. ROOF FRAMING WITH FULL-CAVITY BLOWN IN INSULATION. 5/8" TYPE 'C' GYPSUM BOARD ON VAPOR RETARDER ON RESILIENT CHANNELS AT 16" O.C. DIRECTLY SECURED TO UNDERSIDE OF WOOD STRUCTURE. R9 ROOF PATIO SYSTEM: COMPOSITE DECKING ON ADJUSTABLE HEIGHT PEDESTALS, ON EPDM PROTECTION MAT ON ROOF TYPE BELOW. S1 X" REINFORCED CONCRETE SLAB ON VAPOR RETARDER ON X" DRAINAGE FILL. S2 X" REINFORCED CONCRETE TOPPING ON X" STRUCTURAL CONCRETE DECK. S5 FLOOR/CEILING ASSEMBLY, 1 HOUR RATED ASSEMBLY UL DESIGN #563: 1-1/2" LEVELING GYPSUM UNDERLAYMENT ON 3/4" T&G PLYWOOD SUBFLOOR ON 24" WOOD TRUSS FLOOR FRAMING WITH FULL-CAVITY BLOWN IN INSULATION. 5/8" TYPE 'C' GYP BD ON 1/2: RES CHANNELS AT 16" O.C. ON BOTTOM OF WOOD FRAMING S5A FLOOR/CEILING ASSEMBLY, 1 HOUR RATED ASSEMBLY UL DESIGN #563: 1-1/2" LEVELING GYPSUM UNDERLAYMENT ON 3/4" T&G PLYWOOD SUBFLOOR ON XX" WOOD JOIST FLOOR FRAMING WITH FULL-CAVITY BLOWN IN INSULATION. 5/8" TYPE 'C' GYP BD ON 1/2: RES CHANNELS AT 16" O.C. ON BOTTOM OF WOOD

NOTE # **FLOOR PLAN NOTE** 

# **KEYNOTE LEGEND - EXTERIOR WALL TYPES**

- EXTERIOR WALL DESCRIPTION W1A EXTERIOR WALL: MASONRY CAVITY WALL CONSISTING OF 4" FACE BRICK (EDIT FOR OTHER MATERIALS). 1-3/4" AIR SPACE, 3" RIGID INSULATION, SPRAY APPLIED AIR AND VAPOR BARRIER SYSTEM ON XX" CAST IN PLACE CONCRETE BACK-UP WALL WITH ADJUSTABLE (TWO-PIECE) HORIZONTAL MASONRY JOINT REINFORCING @ 16" OC (REFER TO STRUCTURAL DRAWINGS FOR REQUIRED VERTICAL REINFORCING). PROVIDE CAVITY DRAINAGE MATERIAL, FLASHING, CAVITY WEEPS/VENTS @ 24" OC AND MASONRY EXPANSION AND CONTROL JOINTS. COMPARTMENTALIZE THE CAVITY AND PROVIDE CAVITY WEEPS/VENTS AT TOP/BOTTOM OF CAVITY.
- W13 EXTERIOR WALL: MASONRY VENEER STUD WALL CONSISTING OF 4" FACE BRICK (EDIT FOR OTHER MATERIAL), 1-3/4" AIR SPACE, 1" RIGID INSULATION, BUILDING WRAP ON 1/2" EXTERIOR GRADE PLYWOOD/OSB SHEATHING (EDIT FOR THICKNESS, VERIFY SHEATHING TYPE W/STRUCTURAL), 2 X 6 WOOD STUDS @ 16" OC | WITH FULL THICKNESS BATT INSULATION, VAPOR RETARDER AND ONE LAYER 5/8" GYPSUM BOARD AT INTERIOR FACE. PROVIDE ADJUSTABLE MASONRY VENEER ANCHORS @ 16" OC EACH WAY, CAVITY DRAINAGE MATERIAL, FLASHING, CAVITY WEEPS/VENTS @ 24" OC AND MASONRY EXPANSION AND CONTROL JOINTS. COMPARTMENTALIZE CAVITY AND PROVIDE CAVITY WEEPS/VENTS AT TOP AND BOTTOM OF CAVITY. W14 EXTERIOR WALL: FIBER CEMENT CLAD WALL CONSISTING OF FIBER CEMENT LAP SIDING, 3/4" RIGID INSULATION, BUILDING WRAP ON 1/2" EXTERIOR GRADE PLYWOOD/OSB SHEATHING (VERIFY SHEATHING

TYPE W/STRUCTURAL), 2 X 6 WOOD STUDS @ 16" OC WITH FULL THICKNESS BATT INSULATION, VAPOR

WB4 EXTERIOR WALL (BELOW GRADE): 12" REINFORCED CAST-IN-PLACE CONCRETE FOUNDATION WALL WITH SHEET MEMBRANE WATERPROOFING. TERMINATE ALL MEMBRANE PERIMETER EDGES WITH 1/8" x 1" ALUMINUM COMPRESSION BAR WITH CONTINUOUS SEALANT. (EDIT FOR: DAMPPROOFING). SHEET MEMBRANE MUST INTERFACE WITH VERTICAL WALL AIR & VAPOR BARRIER LINE. PROVIDE 2" RIGID FOUNDATION INSULATION, EXTEND FULL HEIGHT VERTICALLY.

RETARDER AND ONE LAYER 5/8" GYPSUM BOARD AT INTERIOR FACE.

**KEYNOTE LEGEND - INTERIOR PARTITION TYPES** INTERIOR PARTITION DESCRIPTION

FV4 INTERIOR FURRING (PARTITION): 3-1/2" WOOD STUDS @ 16" OC WITH ONE LAYER 5/8" GYPSUM BOARD.

FLOOR PLAN - SYMBOLS LEGEND NEW WALL/PARTITION EXISTING WALL TO REMAIN DETAIL REFERENCE SECTION REFERENCE **EQUIPMENT** EXTERIOR ELEVATION WINDOW TYPE INTERIOR ELEVATION W1 WALL/PARTITION TYPE FLOOR PLAN KEYNOTE — — — — CONSTRUCTION LIMITS FLOOR DRAIN -PITCH FLOOR TO DRAIN — — ONE HOUR FIRE RESISTIVE CONSTRUCTION \_ 2 \_ 2 \_ TWO HOUR FIRE RESISTIVE CONSTRUCTION

**FLOOR PLAN - GENERAL NOTES** 

# A. DIMENSIONS ON FLOOR PLAN ARE BASED ON FACE OF FINISHED WALL TO FACE OF FINISHED WALL (NOMINAL).

- B. REFER TO SHEET A89X FOR ROOM FINISH SCHEDULE AND NOTES.
- C. REFER TO SHEET A89X FOR DOOR SCHEDULES, DOOR TYPES, AND NOTES.
- D. ALL EXPOSED STRUCTURAL STEEL AT THE LOWER LEVEL, NEEDS TO BE PROTECTED TO 2 HOURS W/SPRAY APPLIED FIRE PROTECTION.

## **GYPSUM BOARD PARTITIONS - GENERAL NOTES**

ALL GYPSUM BOARD PARTITIONS SHALL BE (VA) UNLESS OTHERWISE NOTED ON FLOOR PLAN.

ALL CORRIDOR WALLS SHALL BE VAROUNLESS OTHERWISE NOTED ON FLOOR PLAN.

REFER TO GYPSUM BOARD SPECIFICATION FOR LOCATION AND TYPE(S) OF GYPSUM BOARD MATERIAL REQUIRED.

GYPSUM BOARD PARTITION DIMENSIONS ON FLOOR PLAN ARE BASED ON FACE OF FINISHED PARTITION TO FACE OF FINISHED

PROVIDE TYPE 'X' FIRE RATED GYPSUM BOARD AT ALL FIRE RATED PARTITIONS.

SEAL ALL WALL PENETRATIONS AT PERIMETER AND FIRESTOP ALL FIRE RATED PARTITIONS. EXTEND ALL GYPSUM BOARD PARTITIONS FULL HEIGHT TO UNDERSIDE OF DECK OR ROOF ASSEMBLY ABOVE.


**MASONRY PARTITIONS - GENERAL NOTES** 

MASONRY PARTITIONS INDICATED WITH THE FOLLOWING HATCH PATTERN: ALL MASONRY PARTITIONS SHALL BE 8" CONCRETE BLOCK UNLESS OTHERWISE NOTED OR DIMENSIONED. REFER TO

FLOOR PLAN FOR PARTITION THICKNESS.

PROVIDE UL RATED CONCRETE BLOCK AT ALL FIRE RATED PARTITIONS. SEAL ALL WALL PENETRATIONS AT PERIMETER AND FIRESTOP ALL RATED PARTITIONS.

EXTEND CONCRETE BLOCK PARTITIONS FULL HEIGHT TO UNDERSIDE OF PRECAST PLANK ABOVE IF APPLICABLE. REFER TO DETAIL XX/AXXX. PROVIDE HORIZONTAL MASONRY JOINT REINFORCEMENT AT 16" OC VERTICALLY. REFER TO STRUCTURAL DRAWINGS FOR VERTICAL REINFORCEMENT REQUIREMENTS.

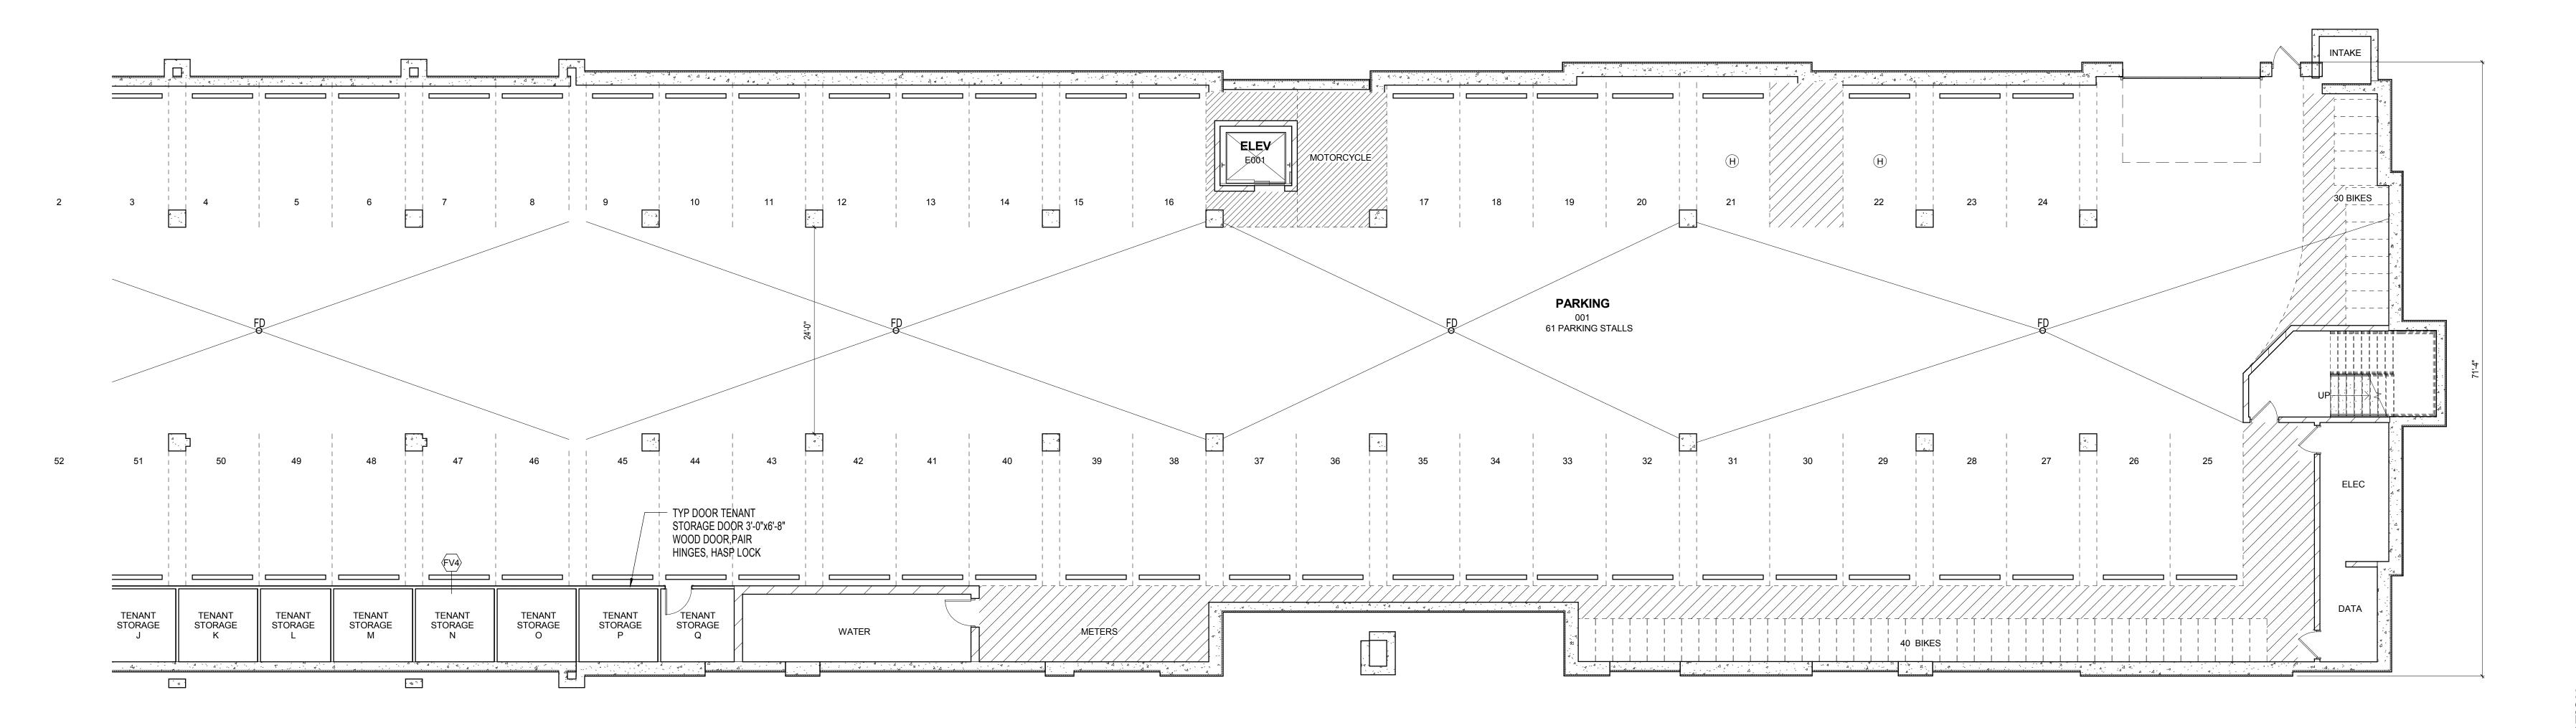


130139-03

Drawn By:

E1 LOWER LEVEL PARKING - SOUTH A200 1/8" = 1'-0"

C1 LOWER LEVEL PARKING - NORTH
A200 1/8" = 1'-0"

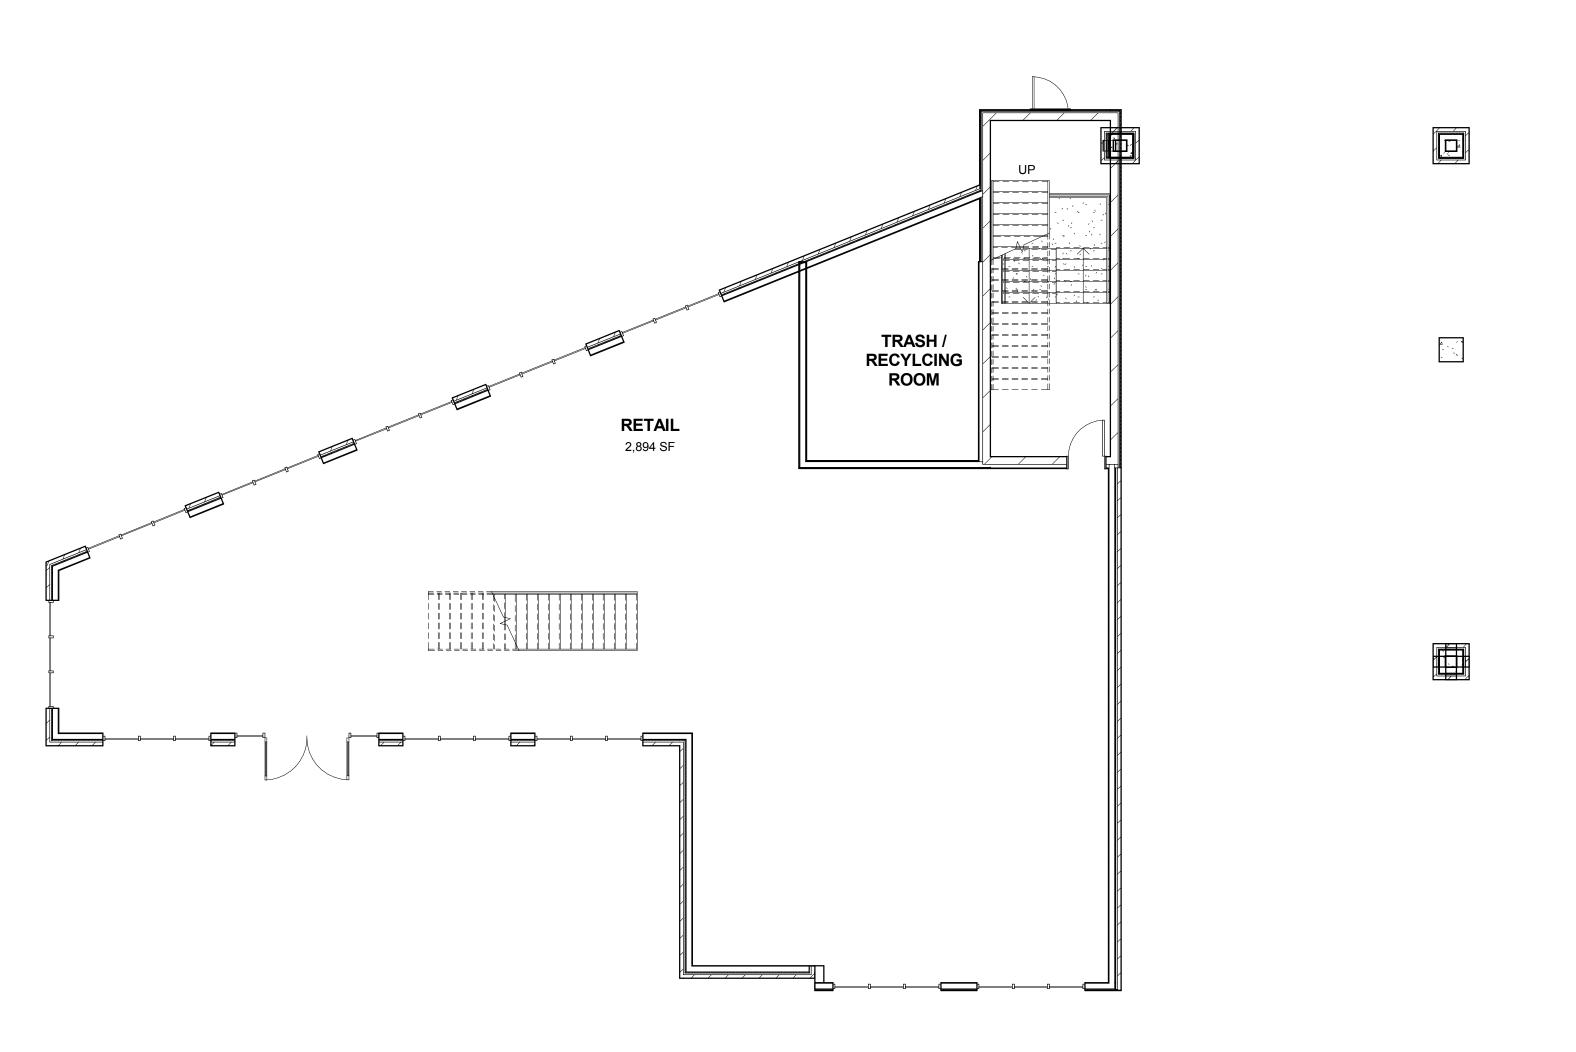

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S1 X" REINFORCED CONCRETE SLAB ON VAPOR RETARDER ON X" DRAINAGE FILL. S2 X" REINFORCED CONCRETE TOPPING ON X" STRUCTURAL CONCRETE DECK.

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FLOOR PLAN - SYMBOLS LEGEND EXISTING WALL TO REMAIN NEW WALL/PARTITION EXISTING DOOR TO REMAIN NEW DOOR \_\_\_\_\_ DETAIL REFERENCE SECTION REFERENCE EQUIPMENT EXTERIOR ELEVATION WINDOW TYPE

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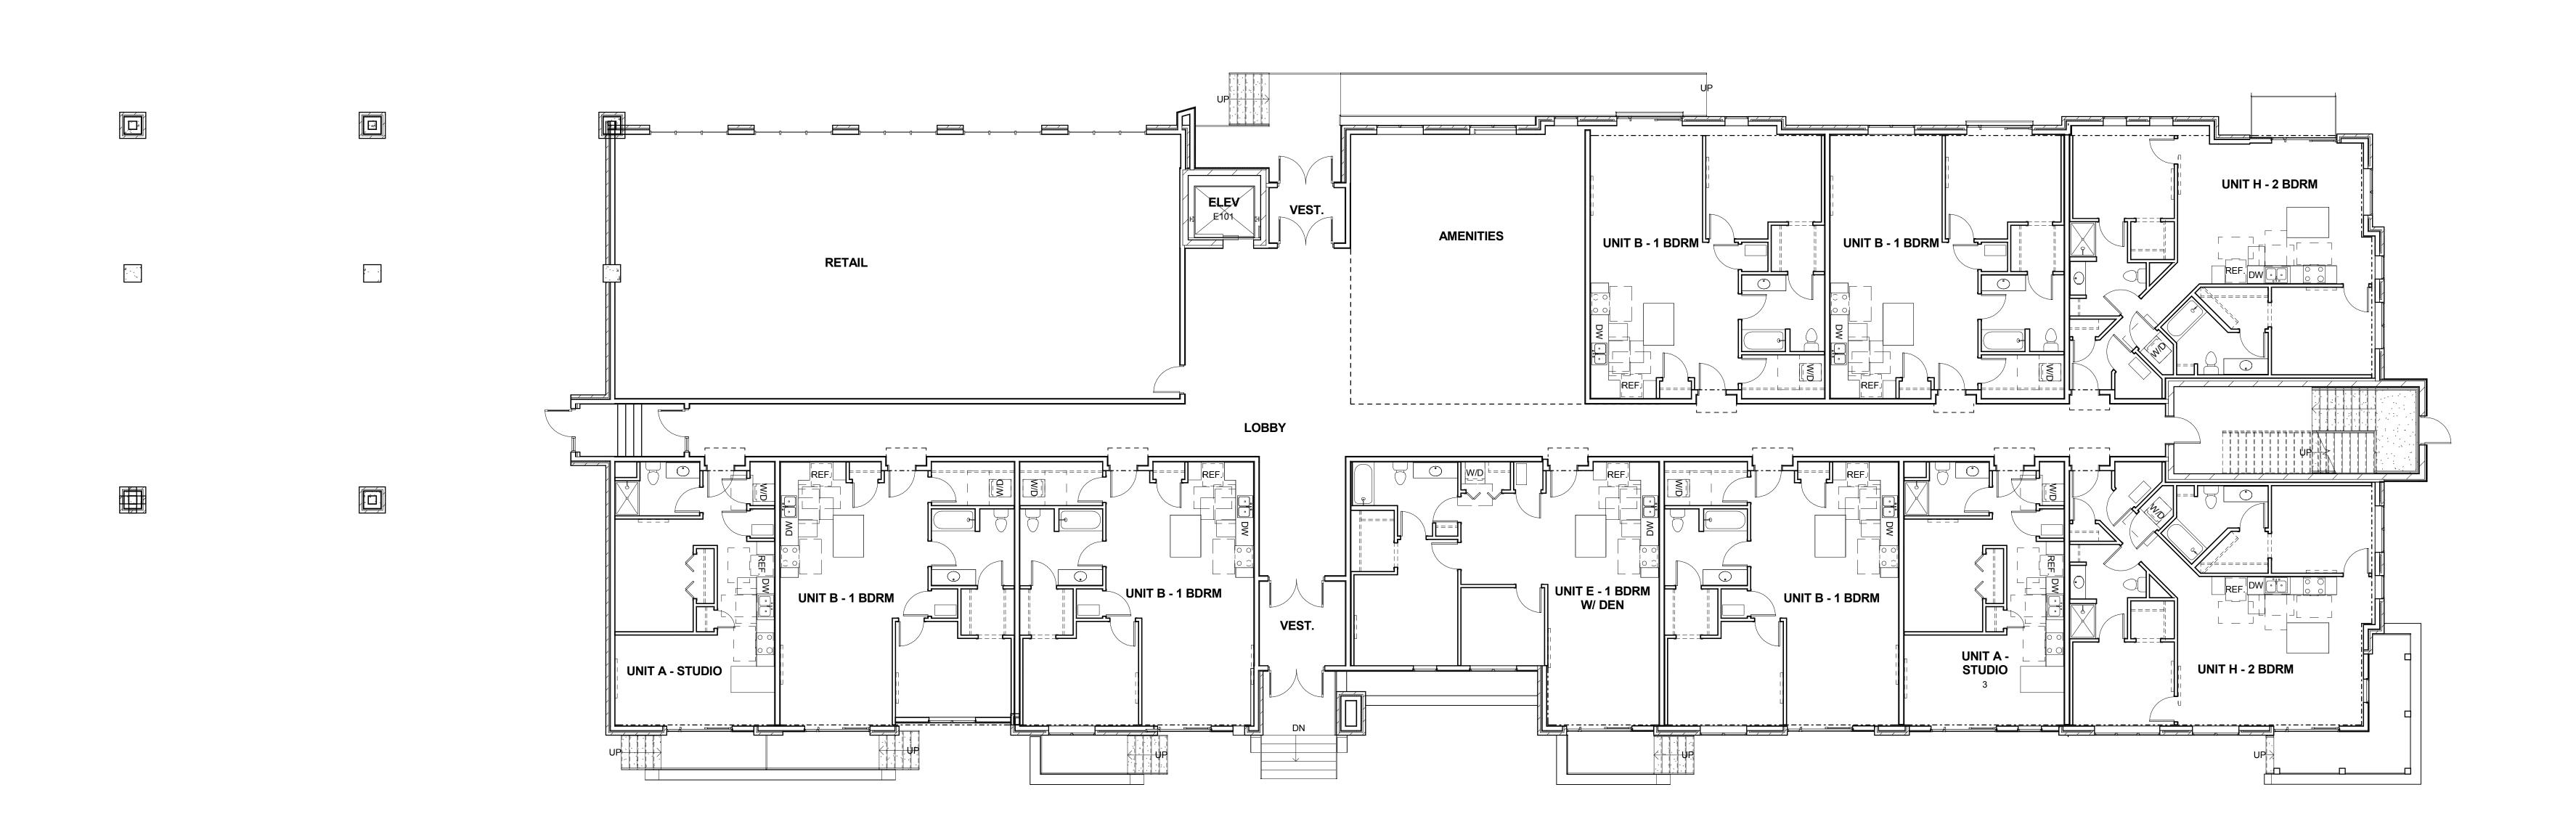
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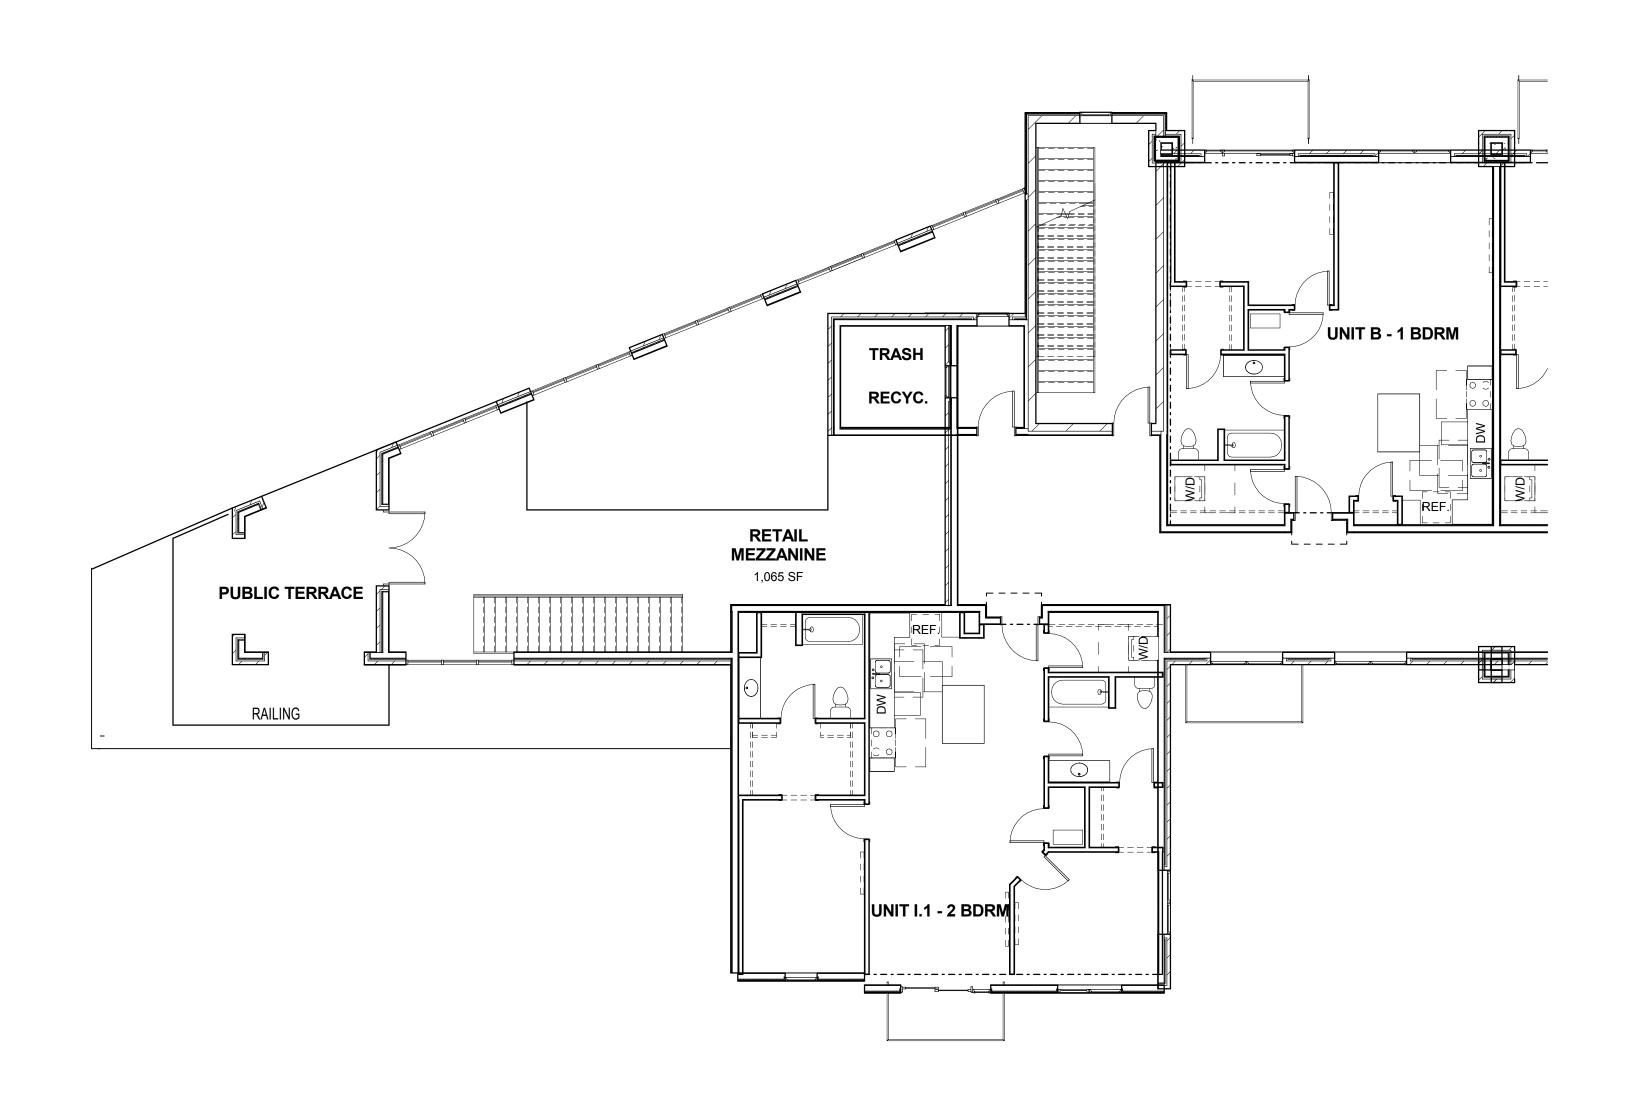
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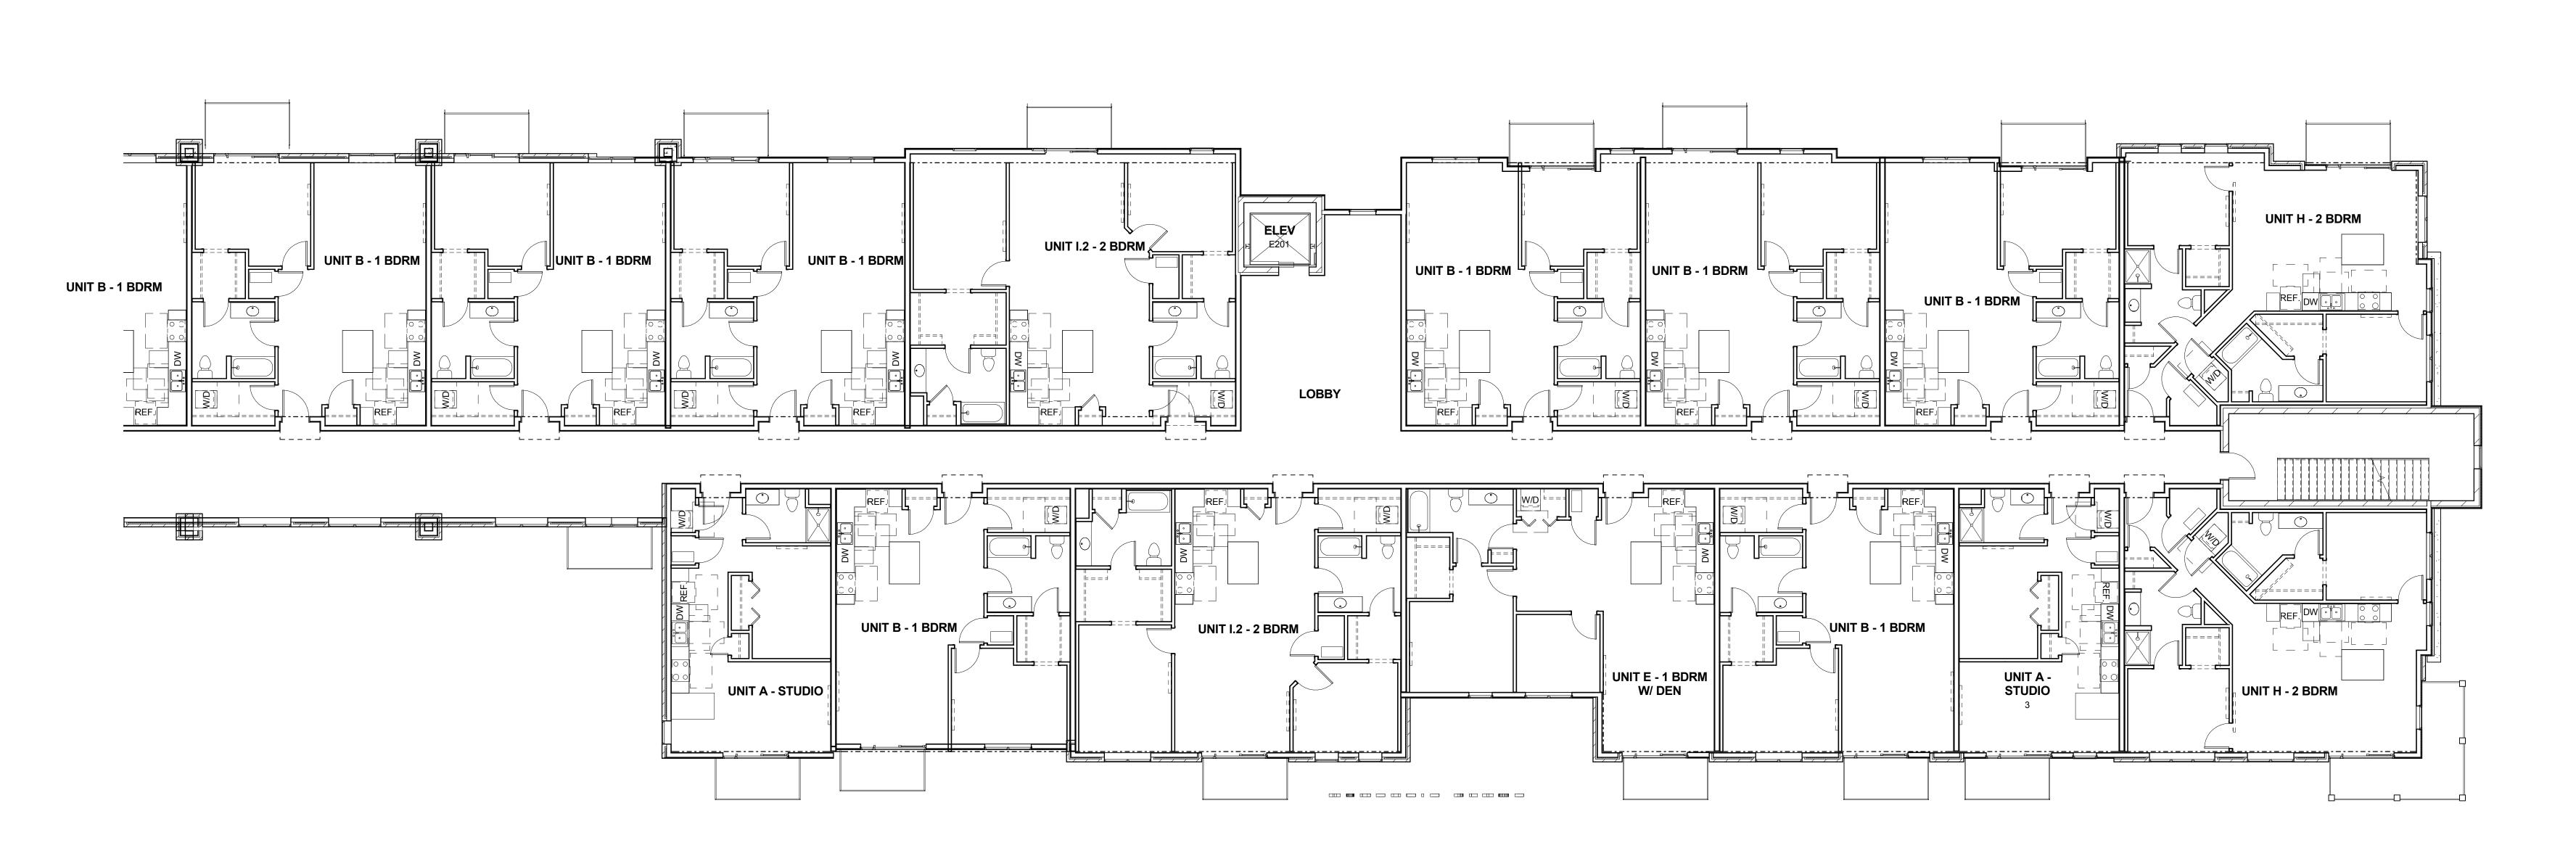
C1 LEVEL 1 FLOOR PLAN - NORTH A201 1/8" = 1'-0"



Drawn By:

E1 LEVEL 1 FLOOR PLAN - SOUTH





E1 LEVEL 2 FLOOR PLAN - SOUTH
A202 1/8" = 1'-0"

C1 LEVEL 2 FLOOR PLAN - NORTH
A202 1/8" = 1'-0"

NOT FOR CONSTRUCTIC

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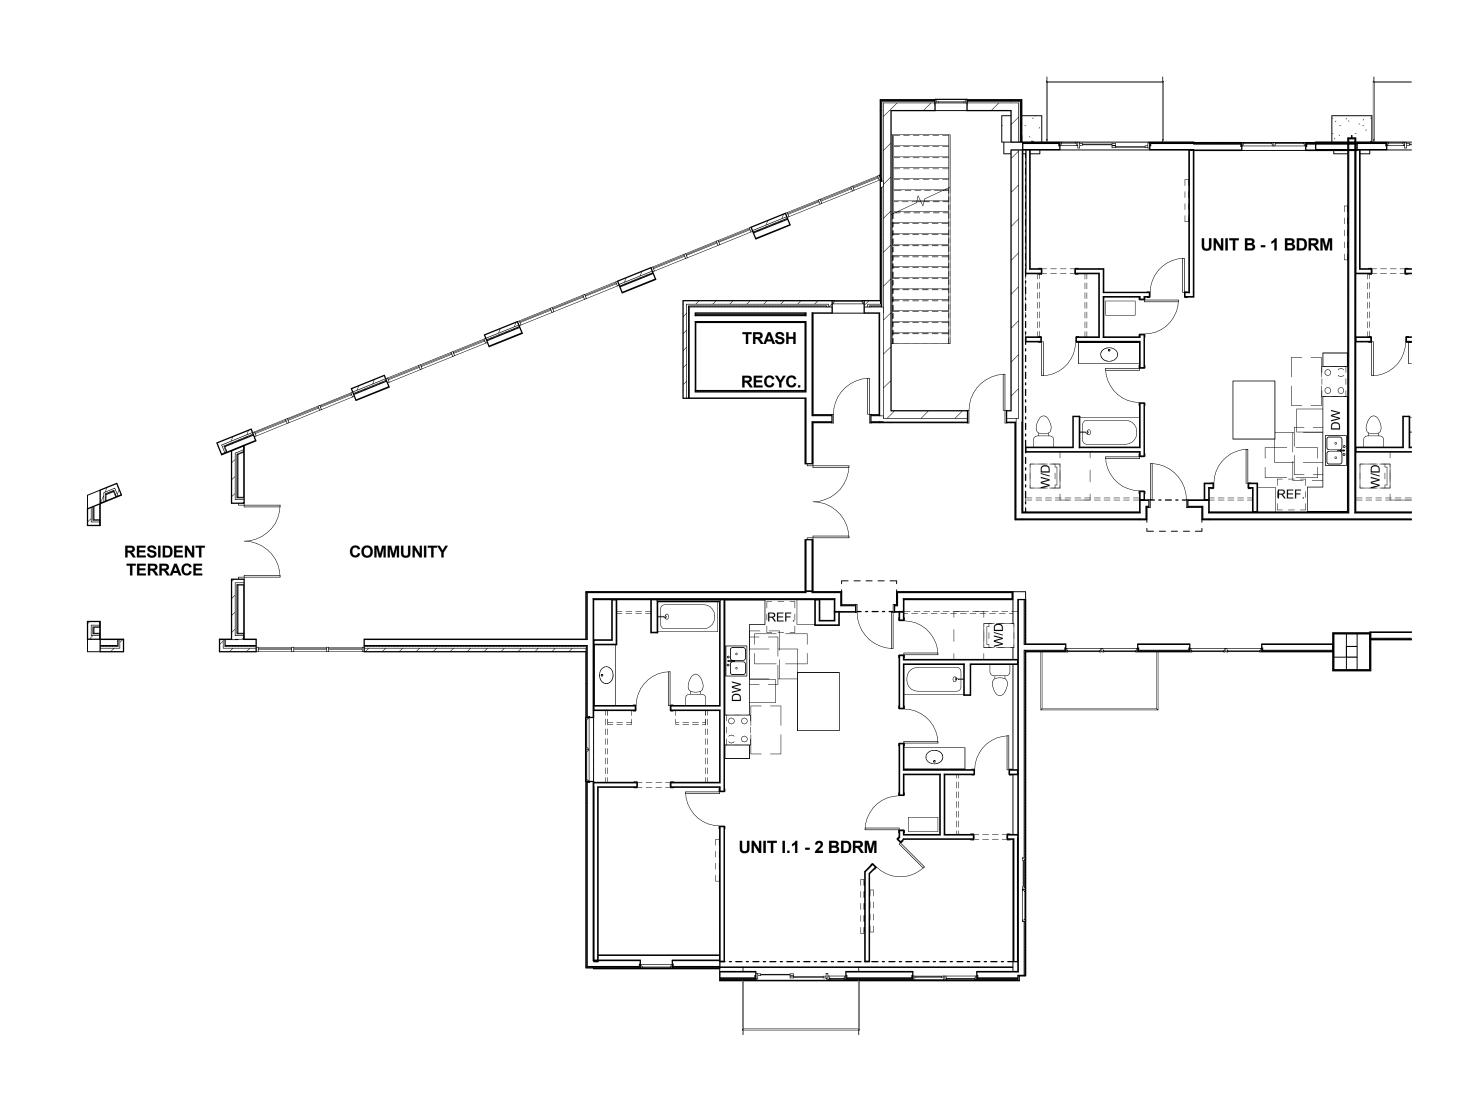
Job No.:

130139-03


Sheet No.:

A 202

Drawn By:



C1 LEVEL 3 FLOOR PLAN - NORTH A203 1/8" = 1'-0"

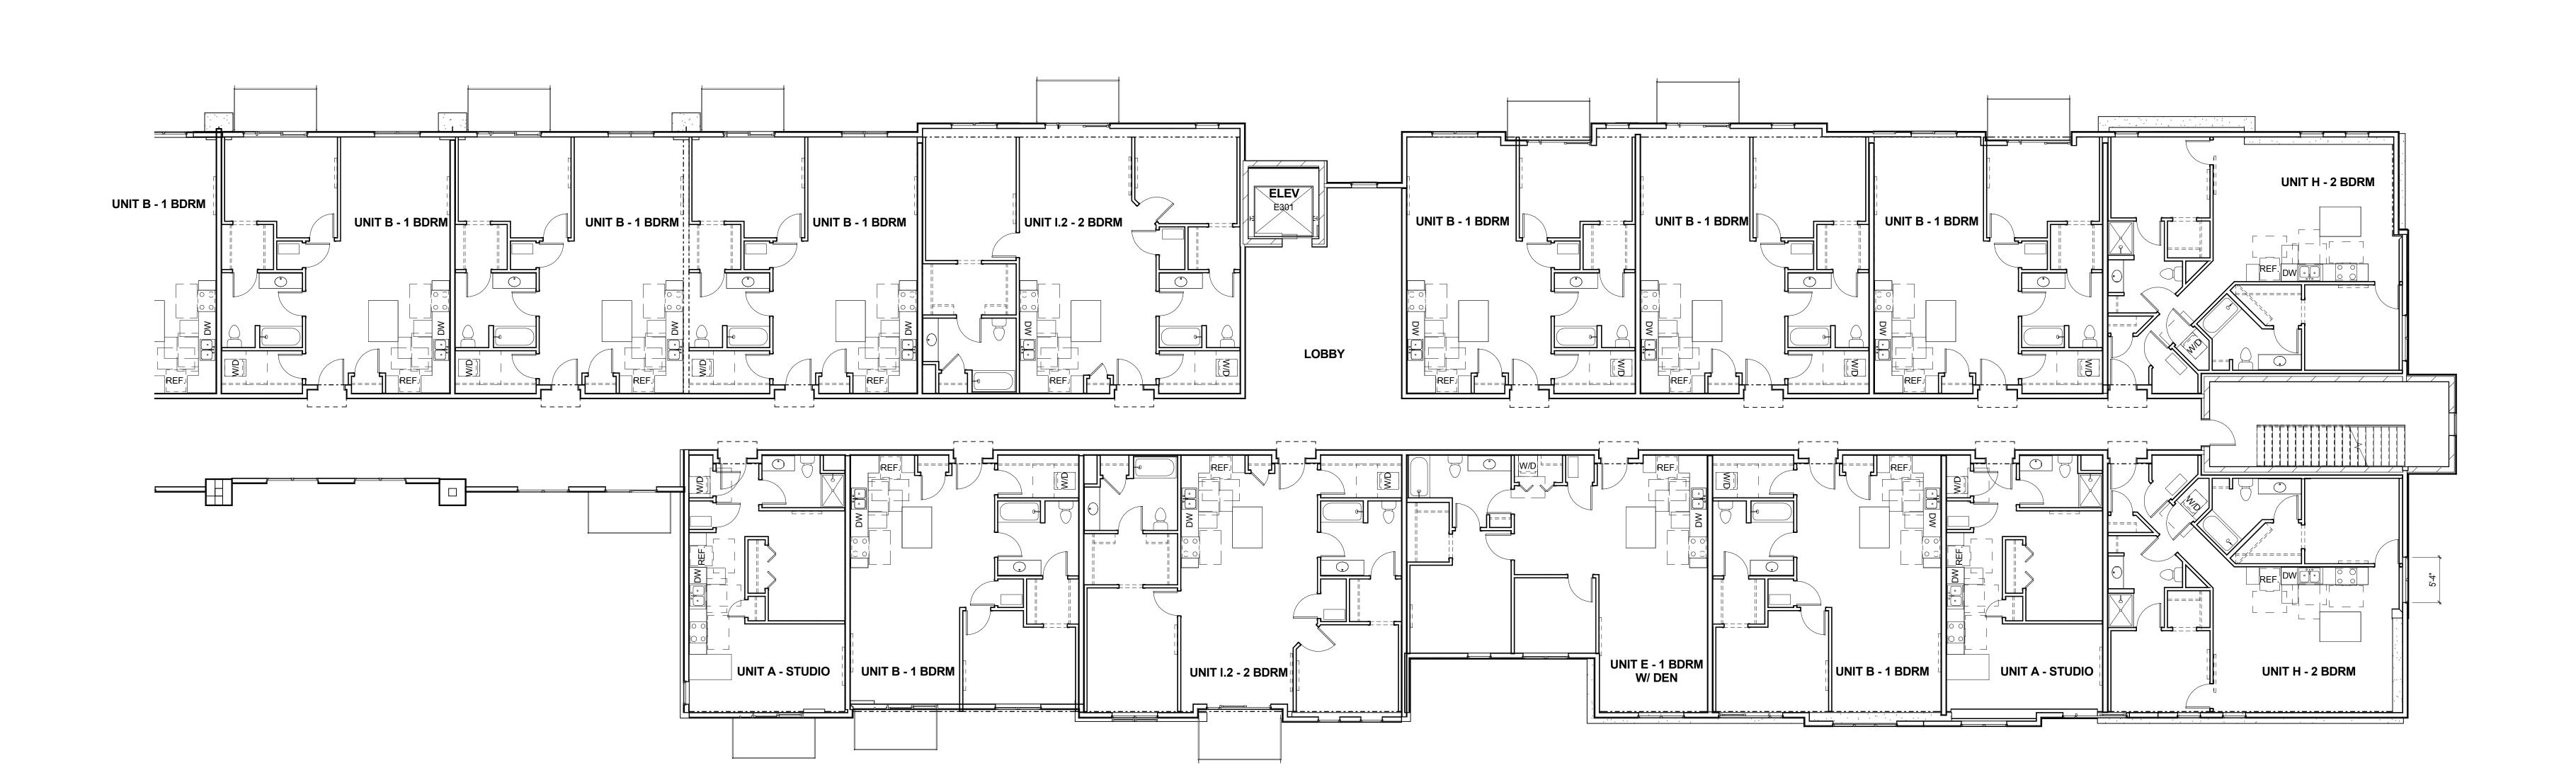

E1 LEVEL 3 FLOOR PLAN - SOUTH A203 1/8" = 1'-0"


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A203

Revision Date 1

Drawn By:

07-26-15



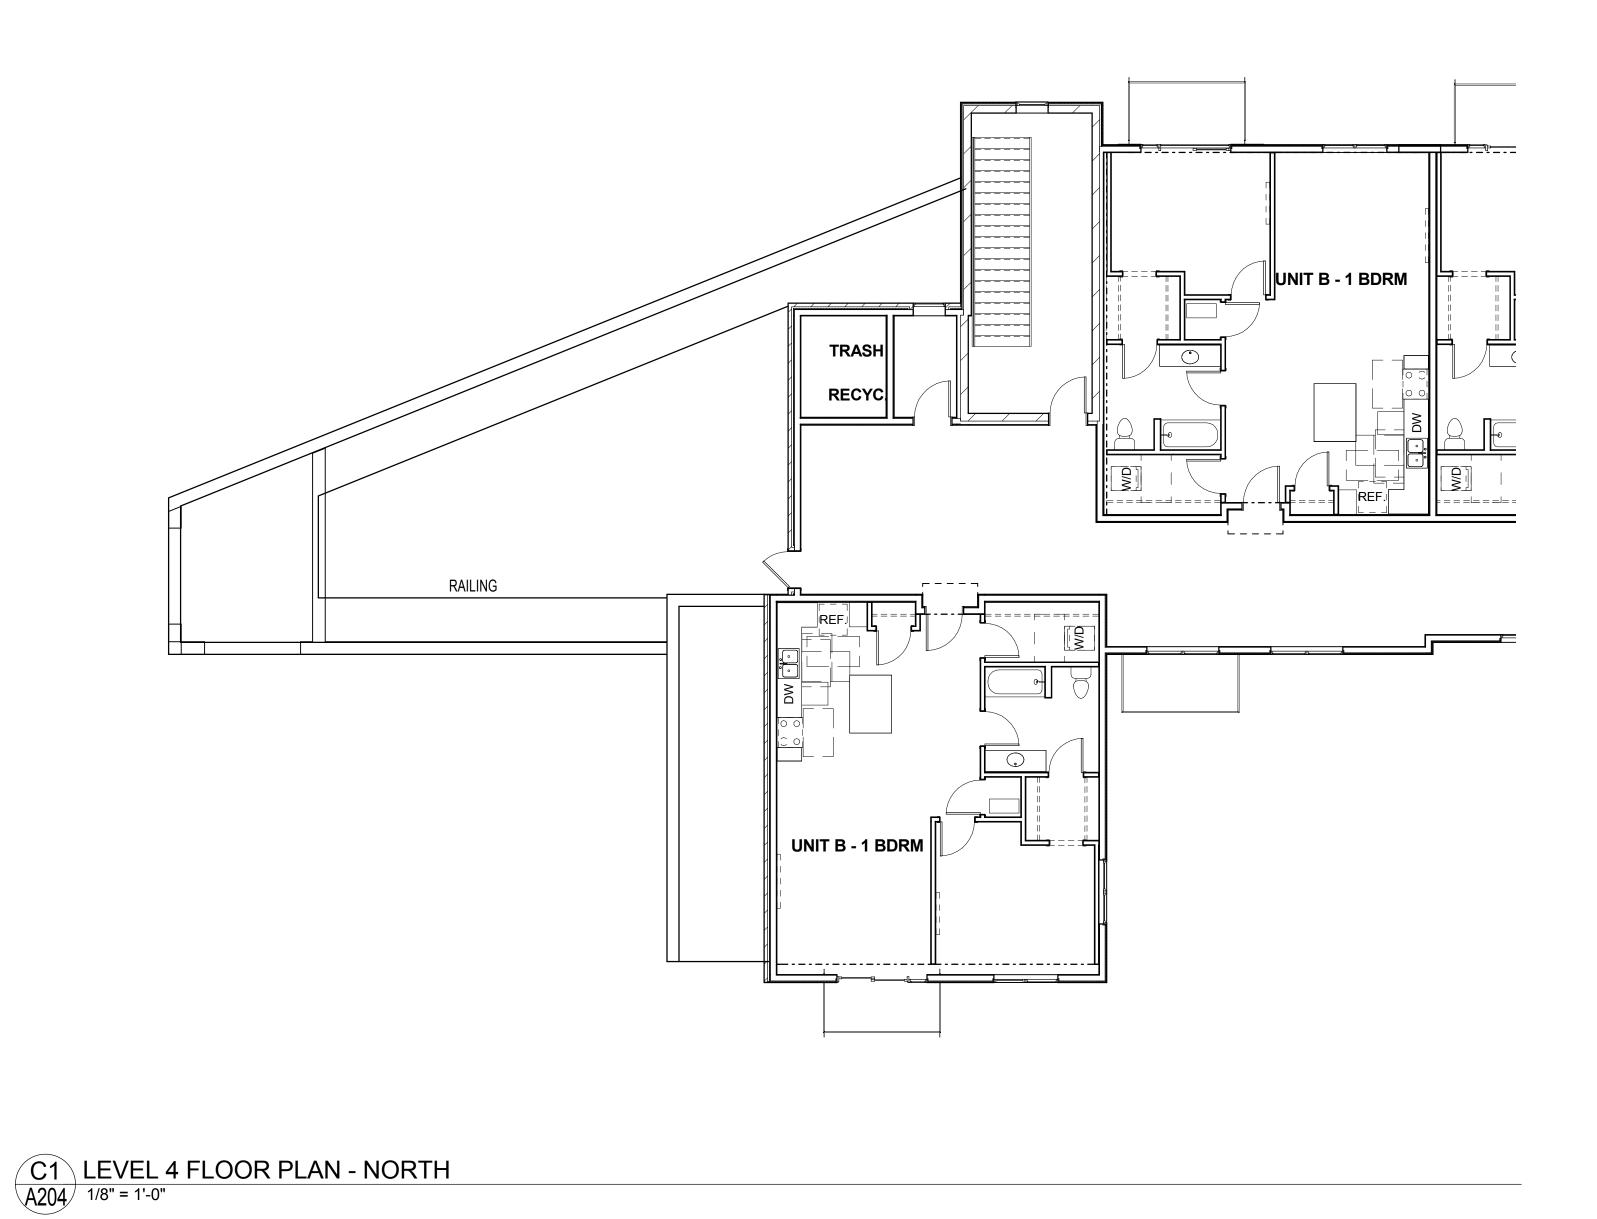

Revisions

Drawn By:

E1 LEVEL 4 FLOOR PLAN - SOUTH
A204 1/8" = 1'-0"