City of Madison

Location 1200-1212 East Washington Avenue

Project Name McGrath Mixed-Use


Applicant Lloyd Buchmeier & Ron Bambrough/ Lance McGrath – McGrath Property Group

Existing Use 3 commercial buildings


Proposed Use Demolish 3 commercial buildings to construct new mixed-use building with 3,700 sq. ft. of commercial space and 76 apartments

Public Hearing Date Plan Commission 18 May 2015

Proposed Demolition & Conditional Use

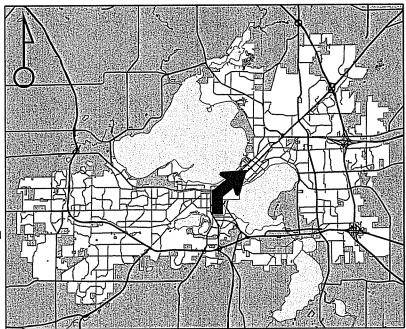

For Questions Contact: Tim Parks at: 261-9632 or tparks@cityofmadison.com or City Planning at 266-4635

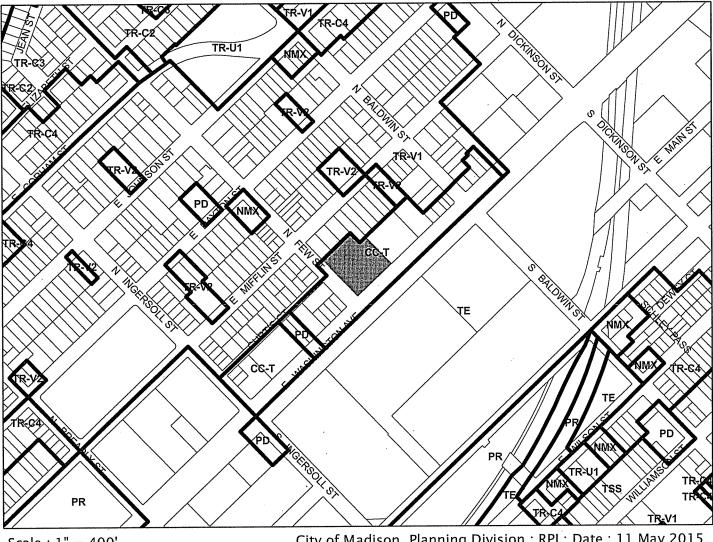

Scale : 1" = 400'

City of Madison, Planning Division : RPJ : Date : 11 May 2015

16

City of Madison

1200–1212 E Washington Ave



Date of Aerial Photography : Spring 2013

LAND USE APPLICATION	CITY OF MADISO
113621 71	FOR OFFICE USE ONLY:
5 Martin Luther King Jr. Blvd; Room LL-100	Amt. Paid Receipt No
O Box 2985; Madison, Wisconsin 53701-2985	Date Received
hone: 608.266.4635 Facsimile: 608.267.8739	Received By
II Land Use Applications should be filed with the Zoning	Parcel No
dministrator at the above address.	Aldermanic District
he following information is required for all applications for Plan	Zoning District
Commission review except subdivisions or land divisions, which	Special Requirements
hould be filed using the <u>Subdivision Application</u> .	Review Required By:
his form may also be completed online at: www.cityofmadison.com/developmentcenter/landdevelopment	Common Council Other:
ww.cryonnauson.com/acvelopmentcenter/landacvelopment	Form Effective: February 21, 2013
1700 1708 - 1713 E	INTERNICTON ATE - 9-12 N
Project Address: <u>/200, 1208 § /212 E.</u> Project Title (if any): <u>T.B.D.</u>	WARING I UN AVES 1-13M.
Project Title (if any): <u>1.0.0</u>	
This is an application for (Check all that apply to your Land	Use Application).
•••	
Zoning Map Amendment from	to
Major Amendment to Approved PD-GDP Zoning	Major Amendment to Approved PD-SIP Zoning
Review of Alteration to Planned Development (By Plan Con	nmission)
Review of Alteration to Planned Development (By Plan Con	-
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5. Required Submittal Information

All Land Use applications are required to include the following:

Project Plans including:*

- Site Plans (<u>fully dimensioned</u> plans depicting project details including all lot lines and property setbacks to buildings; demolished/proposed/altered buildings; parking stalls, driveways, sidewalks, location of existing/proposed signage; HVAC/Utility location and screening details; useable open space; and other physical improvements on a property)
- Grading and Utility Plans (existing and proposed)
- Landscape Plan (including planting schedule depicting species name and planting size)
- Building Elevation Drawings (fully dimensioned drawings for all building sides, labeling primary exterior materials)
- Floor Plans (fully dimensioned plans including interior wall and room location)

Provide collated project plan sets as follows:

- Seven (7) copies of a full-sized plan set drawn to a scale of 1 inch = 20 feet (folded or rolled and stapled)
- Twenty Five (25) copies of the plan set reduced to fit onto 11 X 17-inch paper (folded and stapled)
- One (1) copy of the plan set reduced to fit onto 8 ½ X 11-inch paper
- * For projects requiring review by the Urban Design Commission, provide Fourteen (14) additional 11x17 copies of the plan set. In addition to the above information, <u>all</u> plan sets should also include: 1) Colored elevation drawings with shadow lines and a list of exterior building materials/colors; 2) Existing/proposed lighting with photometric plan & fixture cutsheet; and 3) Contextual site plan information including photographs and layout of adjacent buildings and structures. The applicant shall <u>bring</u> samples of exterior building materials and color scheme to the Urban Design Commission meeting.

Letter of Intent: Provide one (1) Copy per Plan Set describing this application in detail including, but not limited to:

Project Team

- Building Square Footage
- Existing Conditions Project Schedule
- Number of Dwelling Units
- Estimated Project Cost
 - Number of Construction & Full-Time Equivalent Jobs Created

Value of Land

- Proposed Uses (and ft² of each)
 Hours of Operation
- Auto and Bike Parking Stalls
 Lot Coverage & Usable Open Space Calculations
- Public Subsidy Requested

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Filing Fee: Refer to the Land Use Application Instructions & Fee Schedule. Make checks payable to: City Treasurer.

Electronic Submittal: All applicants are required to submit copies of all items submitted in hard copy with their application as Adobe Acrobat PDF files on a non-returnable CD to be included with their application materials, or by e-mail to pcapplications@cityofmadison.com.

Additional Information may be required, depending on application. Refer to the Supplemental Submittal Requirements.

6. Applicant Declarations

Pre-application Notification: The Zoning Code requires that the applicant notify the district alder and any nearby neighborhood and business associations in writing no later than <u>30 days prior to FILING this request</u>. List the alderperson, neighborhood association(s), and business association(s) AND the dates you sent the notices:
ALDER LEDELL ZELLERS & TLNA - PATTY PRIME & PATRICK HELK: 11/19/14

→ If a waiver has been granted to this requirement, please attach any correspondence to this effect to this form.


Pre-application Meeting with Staff: <u>Prior</u> to preparation of this application, the applicant is required to discuss the proposed development and review process with Zoning and Planning Division staff; note staff persons and date.

Date: 10/29/14 Zoning Staff: MATT TUCKER Date: 10/29/14 Planning Staff: TIM PARKS

The applicant attests that this form is accurately completed and all required materials are submitted:

Name of Applicant LANCE MCG	RATH	Relationship to Property:	4	ONTRACT	OWNER
Authorizing Signature of Property Owner	lame).	MMA	Date _	3/17/	15

222 SOUTH BEDFORD STREET . SUITE A . MADISON, WI . 53703

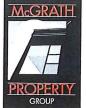

608.616.0705 • WWW.McGRATHPROPERTYGROUP.COM

March 18, 2015

Katherine Cornwell City of Madison Department of Planning & Community & Economic Development 115 Martin Luther King Jr. Blvd. Suite LL 100, Madison Municipal Building Madison, WI 53703

RE: LETTER OF INTENT NEW MIXED USE DEVELOPMENT 1200-1212 E. WASHINGTON AVE & 9-13 N. FEW ST MADISON, WI 53703

Dear Ms. Cornwell,

The following is submitted together with the subdivision application, associated plans and documents for review by City Staff, the Urban Design Commission, and the Plan Commission for consideration of approval.

PROJECT TEAM:

Owner: McGrath Property Group, 222 S. Bedford St. Suite A, Madison, WI 53703 Architect: JLA Architects & Planners, 2418 Crossroads Dr. Madison, WI 53718 Civil Engineer/Landscape: Ayres Associates, 101 E. Badger Road, Madison, WI 53713 Surveyor: Isthmus Surveying, 450 North Baldwin St, Madison, WI 53703

PROJECT OVERVIEW:

The proposed project consists of a 3-story wood frame building over one level of partially below grade parking. It will contain a total of 76 market rate apartments, providing a wide variety of living options with a diverse mix of residential units, ranging in size from a 440 SF studio up to a 1,445 SF 3-Bedroom. The parking level will include 76 parking stalls and several bike parking areas and a bike work room. The building will be approximately 73,065 SF on the three habitable levels.

The first floor frontage along E. Washington will include approximately 3,700 SF of commercial space broken up into a minimum of two distinct spaces, the residential entry lobby and a 600 SF professional quality fitness center for resident use. We hope to lease the commercial space to businesses that our residents and the neighborhood would consider an amenity.

Specific building areas and other pertinent information is provided in the attached plans. No public subsidy is being requested for this project.

DISTINCTIVE Page 100f3N APARTMENTS MANAGEMENT • INVESTMENT • DEVELOPMENT

SITE:

The project is located on a 5-parcel assembly that totals 44,308 SF (1.02 Acres). The site has 207 FT of frontage along E. Washington Avenue and 224 FT of frontage along N. Few Street. All 5-parcels are currently zoned Commercial Corridor-Transitional (CC-T) and is in Urban Design District #8 (UDD #8). The site is located in the 2nd Aldermanic District and sits within the confines of the Tenney-Lapham Neighborhood Association.

There are currently three one-story buildings on site that will be demolished prior to construction. A former gas station sits on 1200 E. Washington, a small metal building at 1208 E. Washington and a metal quonset hut building at 1212 E. Washington. The reminder of the site is predominantly asphalt parking lot. There are also two billboards on the 1212 E. Washington parcel - both billboard leases terminate at the end of April 2015 and are not being renewed. Photographs of the existing buildings are attached (Exhibit A).

There is existing soil and groundwater contamination on the 1200 E. Washington Avenue parcel from it's original gas station use. The gas station ceased operation in 1966. We will be working with the WDNR to remediate the site as part of this project. We will likely request a demolition permit in advance of obtaining a construction permit for the proposed project in order to allow us to begin the remediation work.

NEIGHBORHOOD INPUT:

The project is located in the Tenney-Lapham Neighborhood Association (TLNA). City staff, the Alder and the Neighborhood Association Chairperson were notified in writing of this project several months ago. A public notice meeting was held in December of 2014 and a steering committee was formed. The development team has met and shared information with this committee several times and will continue to meet on an as-needed basis as the final details of the project are worked thru. In March of 2015 the TLNA Council voted **Unanimously to Support** the proposed project (with some concerns).

ARCHITECTURE:

The building is designed with a "Modern Warehouse" aesthetic - meant to relate to the manufacturing history of the area and the older industrial buildings on the other side of E. Washington Avenue. It will be built with a very high quality exterior, primarily consisting of masonry with some cement fiber siding and very large window openings. The building wraps around the perimeter of the parking structure creating a landscaped courtyard area in the middle - over the below grade parking level. The parking level is accessed from N. Few Street. The landscaping, building exterior and the set-backs of the building have been designed to comply with the vision and the requirements of UDD #8.

REFUSE & RECYCLING:

Garbage and recycling containers serving the building will be located in an enclosed room in the lower parking level at the end of the access driveway. A private collection service will be used and their vehicles will pull into the driveway and temporarily park while the roll out containers are loaded for collection.

GREEN FEATURES:

We will be working with Focus on Energy to make the building as energy efficient as possible. We anticipate using energy efficient light fixtures, energy star appliances, high efficiency forced air furnaces and air conditioners, low flow plumbing fixtures, and Low-E glass on the windows. Common mechanicals will also be high efficiency.

We also intend to install photovoltaic solar panels on the roof - if our budget allows for it. We are working with a local installer who has applied for a Focus on Energy Grant to help subsidize the significant initial cost of the solar installation.

We will install a minimum of two electric car charging stations in the parking level and will have the ability to add more in the future if needed.

PROJECT SCHEDULE:

March 18, 2015:	Formal Application
May 6, 2015:	Urban Design Commission
May 18, 2015:	Plan Commission
June 1, 2015:	Start Demolition/Construction
May 1, 2016:	Certificate of Occupancy

Please feel free to contact me if additional information is needed.

Sincerely,

June). Mult

Lance T. McGrath, P.E. Owner - McGrath Property Group, LLC

Exhibit A McGrath Property Group.

1200-1212 E. Washington Demolition



1200 E. Wash (Front)



1208 E. Wash (Front)



1212 E. Wash (Front)



1212 E. Wash Interior



1200 E. Wash (Side from Few St.)



1208 E. Wash (Rear)



1212 E. Wash (Side from Few St.)



1212 E. Wash Interior

1200 LOFTS (WORKING NAME) 1200 EAST WASHINGTON AVENUE

MADISON, WISCONSIN




CONDITIONAL USE & UDC SUBMITTAL


JLA PROJECT NUMBER: 14-1010-01

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MARCH 18, 2015

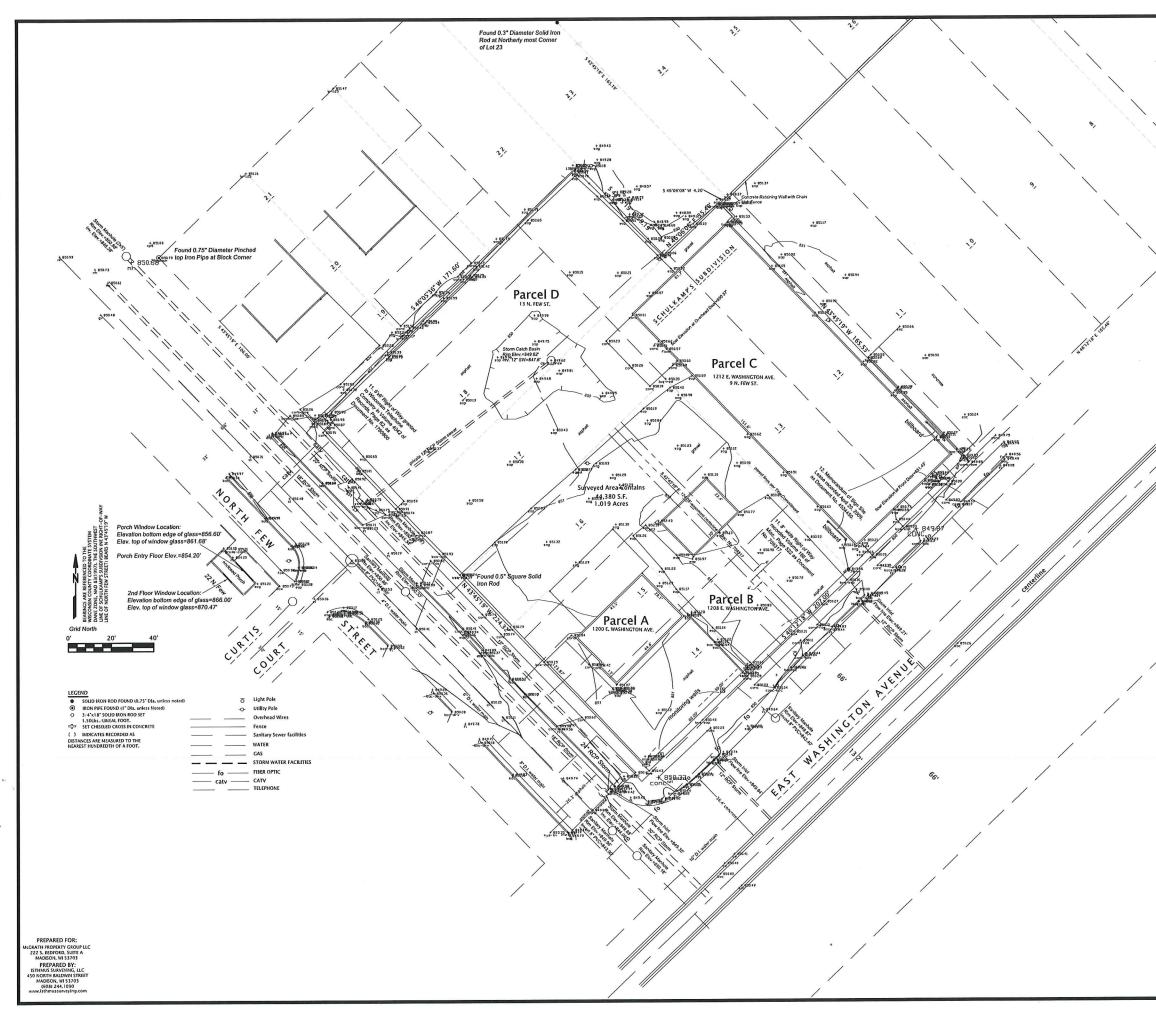

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	architectar planters
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	Madison, Wisconsin 53718 608.241.9500
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	Ph. 608.255.0800 Fx. 608.255.7750 www.saa-madison.com
	AYRES # 27-0169.00
	PLAN COMMISSION SUBMITTAL
	1200 LOFTS
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	PROGRESS DOCUMENTS These documents reflect progress and Intent and may
*	be subject to change, including additional detail. These are not final construction documents and should not be
	used for final bidding or construction-related purposes.
	DATE OF ISSUANCE MARCH 17, 2015
	REVISION SCHEDULE
	Mark Description Date
	Existing
	Conditions Plan
	SHEET NUMBER
	C100
C:\PROJECTS\2014	

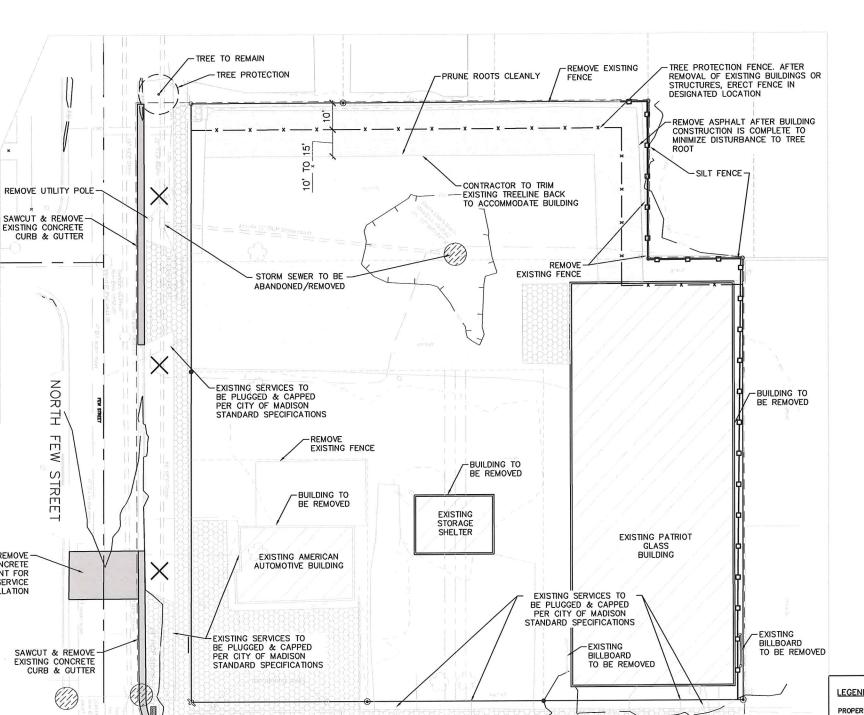

4

SAWCUT & REMOVE -EXISTING CONCRETE

CURB & GUTTER

PROTECT LIGHT

SAWCUT & REMOVE EXISTING -

CONCRETE CURB & GUTTER

EAST WASHINGTON AVENUE

TO REMAIN

SAWCUT & REMOVE

EXISTING CONCRETE

PAVEMENT FOR

UTILITY SERVICE

INSTALLATION



- B. DOWNSTREAM INLETS IN AND ADJACENT TO THE SITE SHALL HAVE TYPE D INLET PROTECTION ON EXISTING AND PROPOSED INLETS ONCE THEY ARE CONSTRUCTED

- E. ALL DISTURBED AREAS SHALL BE STABILIZED WITH SOIL STABILIZER TYPE B IF THERE IS A DELAY OF MORE THAN 7 CALENDAR DAYS BETWEEN INITIAL GRADING AND FINAL TOPSOIL AND SEEDING. SOIL STABILIZER APPLICATION SHALL BE AT THE CONTRACTOR'S EXPENSE.
- G. ALL TEMPORARY EROSION AND SEDIMENT CONTROL MEASURES SHALL BE REMOVED WITHIN 30 DAYS AFTER FINAL SITE STABILIZATION IS ACHIEVED OR AFTER THE TEMPORARY MEASURES ARE NO LONGER NEEDED.

ANTICIPATED CONSTRUCTION SCHEDULE:

- 1. INSTALL INLET PROTECTION AS DETAILED ON THE PLAN.
- 2. REMOVE EXISTING ITEMS AS DETAILED IN THE DEMOLITION PLAN.
- CONSTRUCTION
- 5. CONSTRUCT PAVEMENT, CURB & SIDEWALK.
- 7. TOPSOIL, SEED AND MULCH/EROSION MAT ALL DISTURBED AREAS.
- 8. INSTALL LANDSCAPING PLANTS.
- 9. REMOVE EROSION CONTROL ITEMS.
- AFTER SEPTEMBER 15TH, A COOL WEATHER SEEDING COVER CROP MUST BE APPLIED (I.E. OATS)

AFTER OCTOBER 15TH, A DORMANT SEEDING COVER CROP MUST BE APPLIED (I.E. WNTER WHEAT)

AFTER NOVEMBER 15TH, A DORMANT SEEDING MUST BE APPLIED WITH AN ACCEPTABLE SOIL STABILIZER. (POLYACRYLIMIDE)

LEGEND		
PROPERTY LINE		
PROJECT LIMITS		
REMOVE ASPHALT - PHASE 1		
REMOVE ASPHALT - PHASE 2		
REMOVE CONCRETE	UTTIN.	
REMOVE EXISTING BUILDING	77.77	
REMOVE TREE	×	
ELECTRICAL SERVICE	—_Е	
SANITARY SEWER	SAN	
TELEPHONE	T	
WATER MAIN	w	
CONTOUR - MINOR (1')	929	Ī
CONTOUR - MAJOR (5')	925	
SILT FENCE		
TYPE D INLET PROTECTION	@	
THE D MEET TROTEONON	w la	

A. THE CONTRACTOR SHALL MINIMIZE THE AMOUNT OF DISTURBED AREA AND UTILIZE EXISTING ASPHALT PAVEMENT TO PREVENT TRACKING ONTO FEW STREET.

PROTECTION ON EXISTING AND PROPOSED INLETS ONCE THEY ARE CONSTRUCTED. C. SUGGESTED LOCATIONS FOR INSTALLATION OF EROSION CONTROL ITEMS ARE SHOWN IN THE PLANS. FINAL LOCATIONS SHALL BE DETERMINED IN THE FIELD BY THE CONTRACTOR AND APPROVED BY THE ENGINEER. EROSION CONTROL ITEMS SHALL BE IN PLACE PRIOR TO CONSTRUCTION. EROSION CONTROL ITEMS SHALL BE MAINTAINED UNTIL SUCH TIME THAT THE ENGINEER DEEMS THE DEVICES NO LONGER NECESSARY.

D. SOIL DISTURBANCE SHALL BE CONDUCTED IN SUCH A MANNER AS TO MINIMIZE EROSION. SOIL STABILIZATION MEASURES SHALL CONSIDER THE TIME OF YEAR, SITE CONDITIONS AND THE USE OF TEMPORARY OR PERMANENT MEASURES. ALL DISTURBED AREAS OF LAWN SHALL BE PATCHED WITH SEED FERTILIZER AND MULCH/MAT

F. ALL DISTURBED AREAS SHALL BE STABILIZED WITH TEMPORARY OR PERMANENT MEASURES WITHIN 7 CALENDAR DAYS OF THE END OF ACTIVE HYDROLOGIC DISTURBANCE, OR RE-DISTURBANCE. THE CONTRACTOR SHALL USE EROSION MATTING ON ALL SLOPES STEEPER THAN 5:1 (20%)

H. A TRACKING MAT WILL NOT BE REQUIRED DUE TO THE LIMITED NATURE OF DISTURBANCE FOR THIS BUILDING. THE EROSION CONTROL MEASURES INDICATED ON THE PLANS ARE THE MINIMUM REQUIREMENTS. ADDITIONAL MEASURES MAY BE REQUIRED AS DIRECTED BY THE ENGINEER OR GOVERNING AGENCY.


CONSTRUCTION ACCESS TO THE SITE WILL ONLY BE FROM THE WESTERNMOST ENTRY. CONTRACTOR SHALL ENSURE THAT ACCESS TO THE SITE AND FEW STREET ARE CLEANED UP FROM DIRT AND TRACKED MUD AT THE END OF EACH DAY.

J. BORROW MATERIAL FOR SLOPE CONSTRUCTION NEED NOT BE STRUCTURAL FILL, BUT MUST BE REASONABLY FREE OF BOULDERS OR DEBRIS TO ALLOW EASE OF PLACEMENT K. BECAUSE OF THE SIGNIFICANT EXCAVATION BELOW THE SURFACE FOR UNDERGROUND PARKING, THE CONTRACTOR WILL NEED TO PUMP STORM WATER FROM THE EXCAVATION THE CONTRACTOR WILL USE APPROPRIATELY SIZED SEDIMENT BAGS FOR ANY TRENCH WATER DISCHARGE.

 CONSTRUCT BUILDING AND UTILITIES AS PRESCRIBED IN THE PLAN. CONTRACTOR SHALL INSTALL PHASE 1 STORM SEWER AS SOON AS POSSIBLE TO PROVIDE DRAINAGE FOR LOW SPOT ON THE NORTH PROPERTY LINE ONCE THE EXISTING 24" STORM SEWER HAS BEEN CUT OFF DUE TO FOUNDATION CONSTRUCTION.


4. GRADE AREA IMMEDIATELY ADJACENT TO THE NEW BUILDING FOR PAVEMENT AND CURB


RESTORE DISTURBED AREAS WITH TEMPORARY SEEDING IN CENTER OF PARCEL. FINAL RESTORATION MAY BE COMPLETED ALONG WEST AND NORTHWEST PROPERTY LINES.

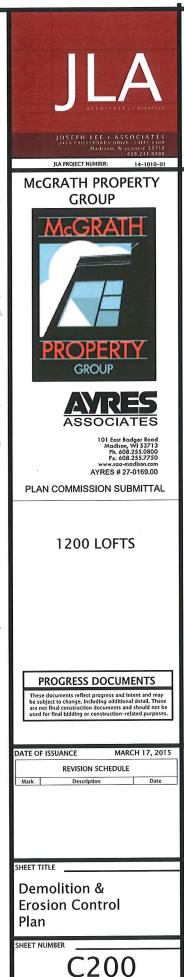



Milwaukee Area (414) 259-Hearing Impaired TDD (800) 542-2289 www.DiggersHotline.com

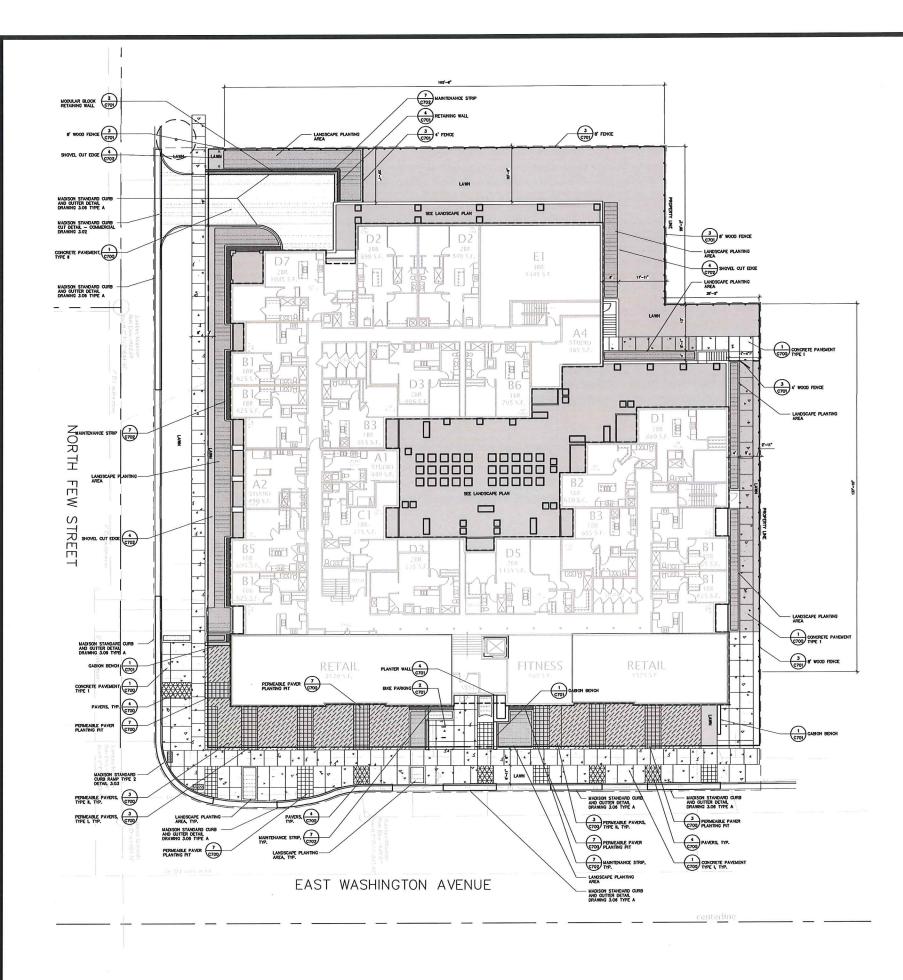

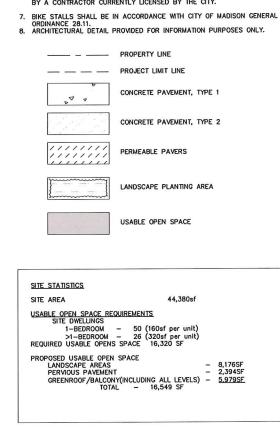

NOTES:




1. ALL WRITTEN DIMENSIONS SUPERSEDE SCALED DIMENSIONS. 2. CONTRACTOR SHALL INSTALL EXPANSION JOINTS BETWEEN CONCRETE PAVING, CURBS, AND EXISTING PAVING OR STRUCTURES. 3. THE CONTRACTOR IS RESPONSIBLE FOR SITE STAKING. ALL PROPOSED SITE FEATURES SHALL BE STAKED IN THE FIELD PRIOR TO CONSTRUCTION. 4. ALL PAVEMENT MARKINGS SHALL BE INSTALLED IN EPOXY.

MAXIMUM SLOPE AT ALL HANDICAP ACCESSIBLE WALKS SHALL BE 1:20; CROSS SLOPES SHALL BE 2% OR LESS.


6. ALL DRIVEWAYS, CURBS ADJACENT TO DRIVEWAYS AND SIDEWALK CONSTRUCTION WITHIN THE PUBLIC RIGHT-OF-WAY, SHALL BE COMPLETED IN ACCORDANCE WITH CITY OF MADISON STANDARD SPECIFICATIONS FOR PUBLIC WORKS CONSTRUCTION BY A CONTRACTOR CURRENTLY LICENSED BY THE CITY.

8,176SF 2,394SF

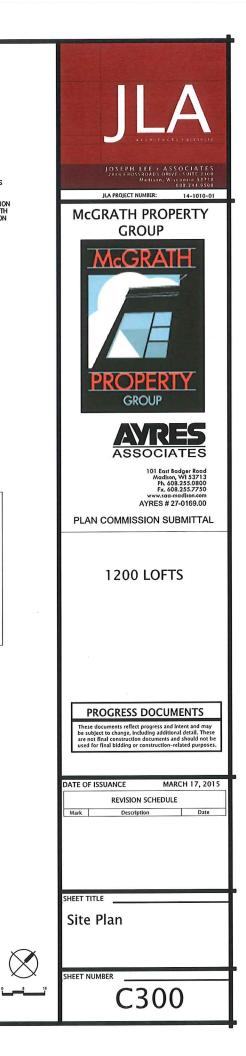



 $\bigotimes$ 

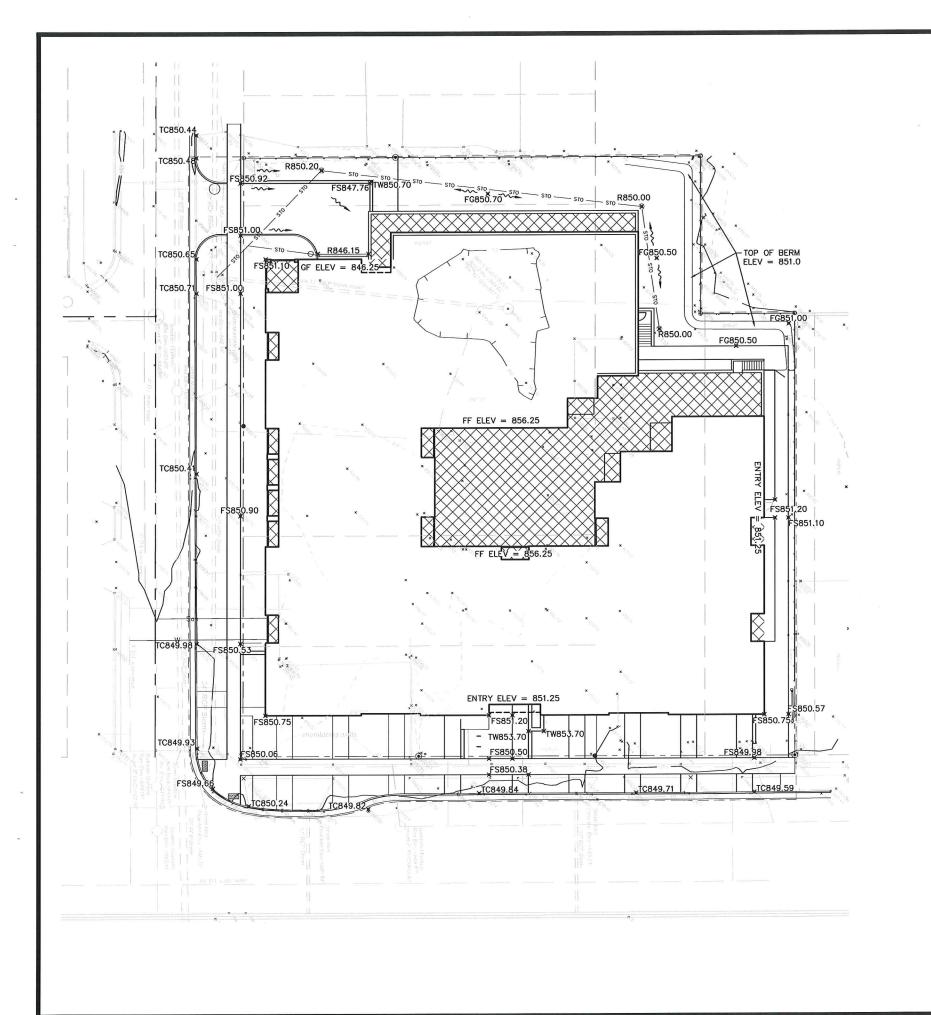

#### GRADING & EROSION CONTROL GENERAL NOTES:

- CONTRACTOR SHALL EMPLOY EROSION CONTROL METHODS AS SHOWN AND SPECIFIED IN THE WISCONSIN DEPARTMENT OF NATURAL RESOURCES CONSTRUCTION SITE TECHNICAL STANDARDS AND THE WISDOT EROSION CONTROL PRODUCT ACCEPTABILITY LISTS (PAL).
   ALL EROSION CONTROL MEASURES SHALL BE ADJUSTED TO MEET FIELD CONDITIONS AT THE TIME OF CONSTRUCTION AND SHALL BE INSTALLED PRIOR TO ANY GRADING OR DISTURBANCE OF EXISTING SURFACE MATERIAL ON THE SITE.
   ALL EROSION AND SEDIMENT CONTROL MEASURES WILL BE CHECKED FOR STABILITY AND OPERATION AFTER A RAINFALL OF 0.5 INCHES OR MORE BUT NOT LESS THAN ONCE EVERY WEEK. ANY NEEDED REPAIRS WILL BE MADE IMMEDIATELY. WRITTEN REPORTS WILL BE KEPT OF ALL EROSION AND SEDIMENT CONTROL INSPECTIONS AS REQUIRED BY THE WISCONSIN DEPARTMENT OF NATIBAL EFOSIONSIN DEPARTMENT OF

- Operation: Arter & Rampfall Operations inches of more But not less than once Every week. Any feebda reparks will be Made Invebulately, written Reports will be Kept of All EROSION AND SEDIMENT CONTROL INSPECTIONS AS REQUIRED BY THE WISCONSIN DEPARTMENT OF NATURAL RESOURCES (MDNR).
   Sult Fence Shall be Installed per Details. SeDIMENt Deposits will be REMOVED FROM BeHIND THE Sult Fence Shall be Installed per Details. SeDIMENt Deposits will be REMOVED FROM BEHIND THE Sult Fence Shall be Installed per Details. SeDIMENt Deposits will be REMOVED FROM BEHIND THE Sult Fence Shall be Installed per Details. SeDIMENt Deposits will be REMOVED FROM BEHIND THE Sult Fence Week Deposits Recards a Depart of e inches. The Sult Fence will be REPAIRED OR REPLACED ASIES SHALL BE COMPLETED WITH DORMANT SEEDING BY NOVEMBER 1.
   EROSIN CONTROL MESSURES WHILE BE TABILIZATION INVOLVING SEEDING WHICH IS NOT COMPLETED PERMANENTLY STABILIZED STITE SHALL SE COMPLETED WITH DORMANT SEEDING BY NOVEMBER 1.
   RICK OF CONTROL MESSURES WHIST BE IN PLACE AT THE END OF EACH WORK DAY.
   ALL OFT-STITE STABILIZATION SHALL BE CLEANED UP BY THE END OF EACH DAY. FUNCHING SHALL NOT BE ALMOST.
   WIENE STISTIGUETION ACTIVITES HAVE PERMANENTLY CEASED OR HAVE BEEN TEMPORARILY SUSPENDED FOR MORE THAN FOURTEEN DAYS. OR WHEN FINAL GRADES ARE REACHED IN ANY PORTION OF THE STABILIZATION SHALL BE IMPLEMENTED WITHIN SEVEN DAYS. TEMPORARILY SUSPENDED FOR MORE THAN FOURTEEN DAYS. OR WHEN FINAL GRADES ARE REACHED IN ANY PORTION OF THACK STATUCK AND HENDIZATION SHALL BE IMPLEMENTED WITHIN SEVEN DAYS. TEMPORARILY SUSPENDED FOR MORE THAN FOURTEEN DAYS. STABILIZATION MAR DAYS.
   MLE KECSS MARTARI, SHALL BE STOCKPLED AT LOCATIONS APPROVED BY THE CITY/DEVELOPER PERMANENT RESTORATION. WHEN STBUILTAKEND AS SOON AND RADAL UTILIZE THE METHODS OUTLINES SHALL BE STOCKPLED AT LOCATIONS APPROVED BY THE CITY/DEVELOPER PRING TO PLACEMENT OF ANY MATERIAL. STOCKPLES SHALL BE ENCLOSED WITH SLIT FENCE UNTIL TEMP

## THAN 6". 3. GRADING TOLERANCES: FINISH GROUND = $\pm 0.10^{\circ}$ SUBGRADE = $\pm 0.10^{\circ}$ GRAVEL GRADE = $\pm 0.05^{\circ}$

EGEND		SP01 P
PROPERTY LINE		EW EG EC
PROJECT LIMITS		FS FG
EXISTING BUILDING		TW BW TC
ELECTRICAL SERVICE	———E-———	TR TS
SANITARY SEWER	SAN	BS IE R
TELEPHONE	T	FLG
WATER MAIN	w	
CONTOUR - MINOR (1')	929	nicc
CONTOUR - MAJOR (5')	925	DIGO
FIELD INLET	8	Ti Milwo Hearing
		, iouning

NOTES: 1. CLASS I TYPE A EROSION MAT REQUIRED ON ALL 4:1 OR STEEPER SLOPES, TO BE INSTALLED PER MANUFACTURER'S STEEPER TIONS

STEEPER SLOPES, TO BE INSTALLED FER MANDFACTORER'S SPECIFICATIONS. 2. ALL IMPORTED GRANULAR FILL FOR USE UNDER ROADWAYS, SIDEWALKS OR STRUCTURES SHALL BE FREE OF ANY ORGANIC MATERIAL OR LARCE STONES. OTHER FILL IMPORTED FOR AREAS NOT UNDER PAVED OR GRAVELED AREAS SHALL BE REASONABLY FREE OF DEBRIS, ROOTS AND STONES LARGER


 $CONCRETE/ASPHALT = \pm 0.03'$ BERMS = +0.00' - 0.25'

OT ELEVATION ABBREVIATIONS:


=	PROPOSED ASPHALT
=	EXISTING WALK
=	EXISTING GRADE
=	EXISTING CONCRETE
	FINISHED SURFACE
=	FINISHED GRADE
	TOP OF WALL
=	BOTTOM OF WALL
=	TOP OF CURB
=	
=	TOP OF SLOPE
=	BOTTOM OF SLOPE
=	INVERT ELEVATION
=	RIM
=	FLANGE OF CURB





Toll Free (800) 242-8511 ilwaukee Area (414) 259-1181 ng Impaired TDD (800) 542-2289 www.DiggersHotline.com

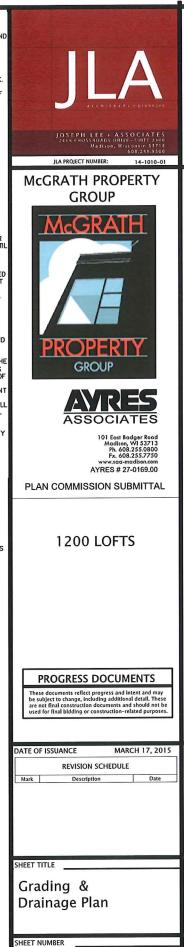


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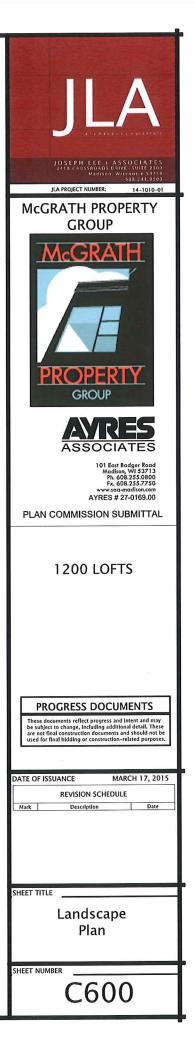


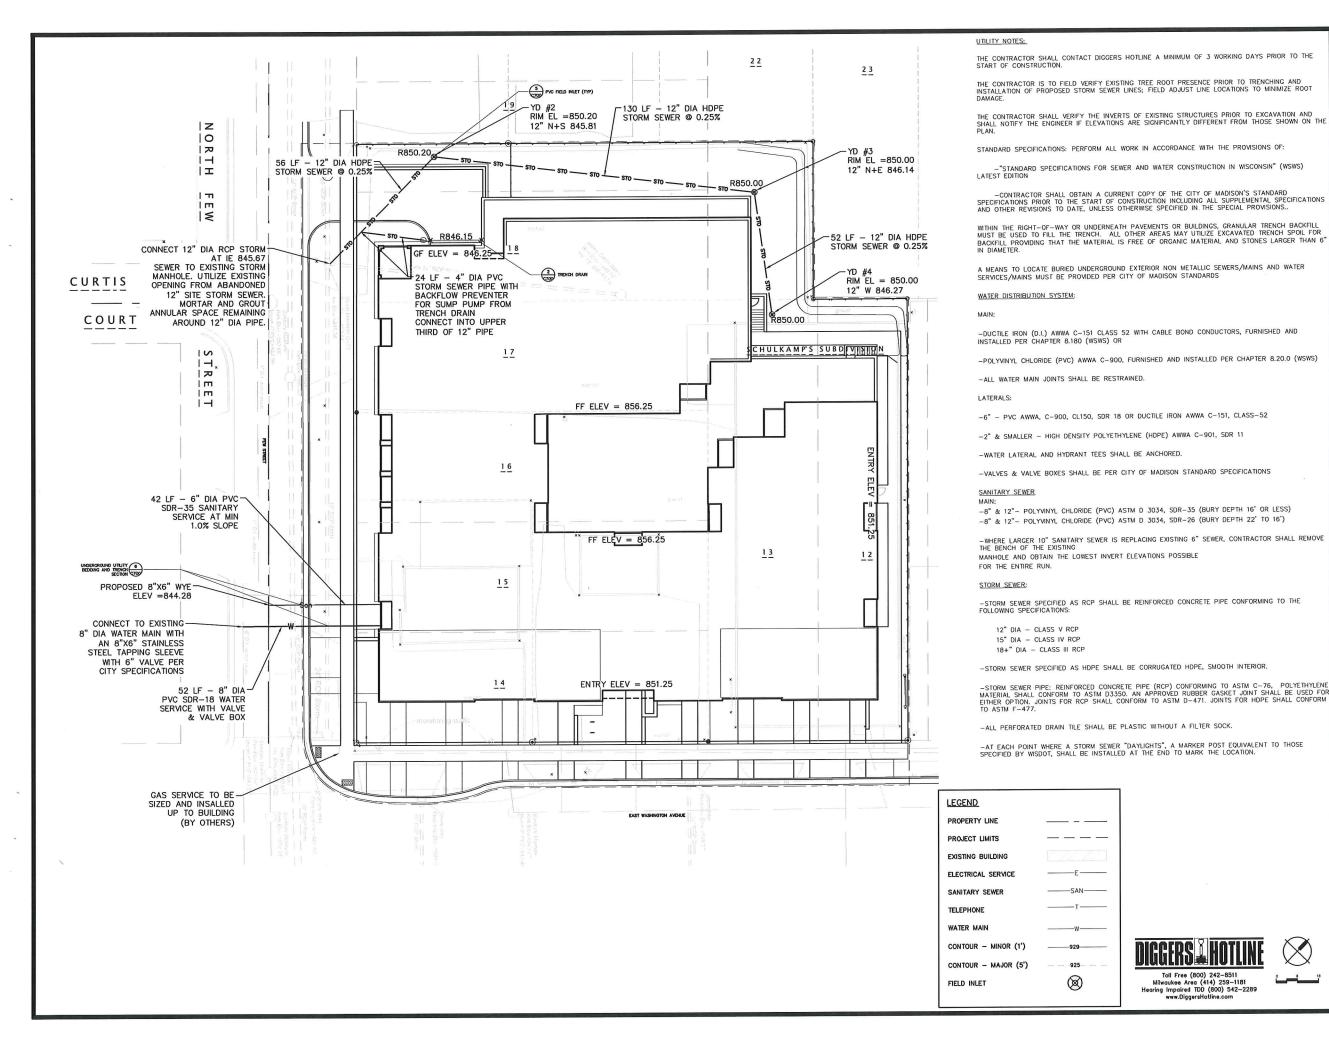

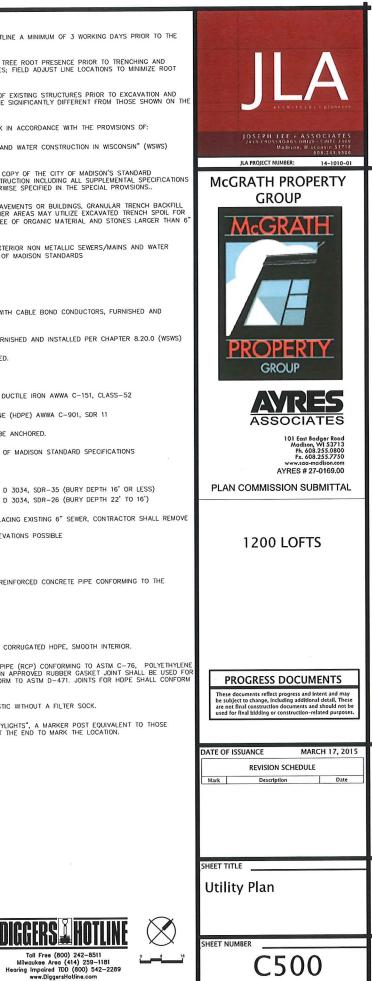

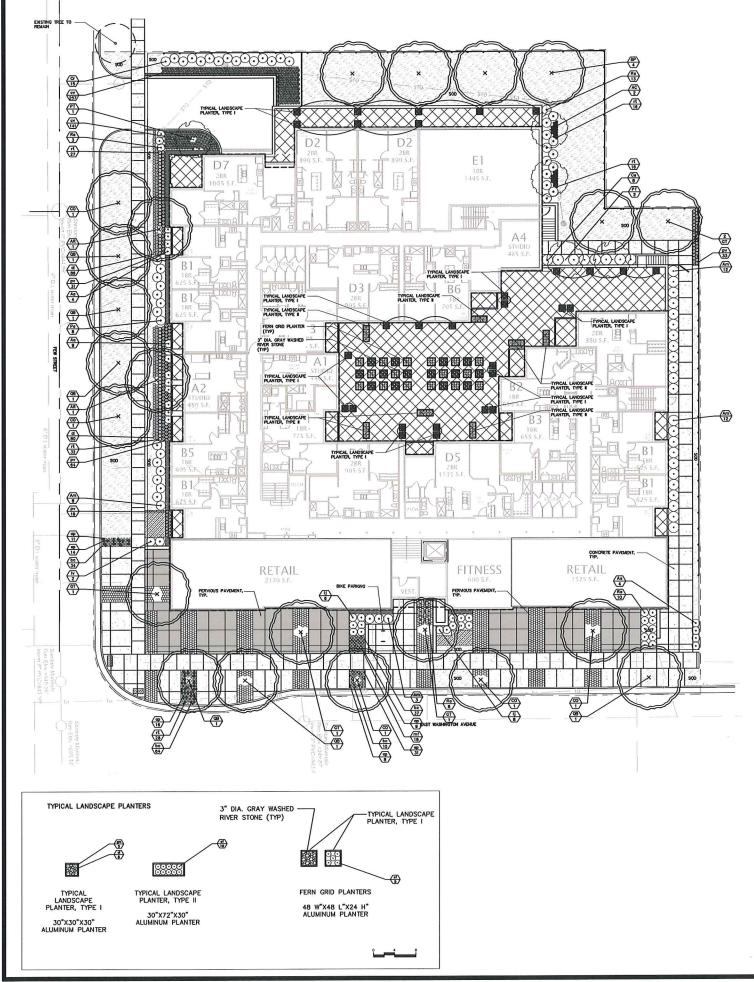Symbol	Botanical name	Common Name	Size	Root	Quantity	Spacing
TRE	ËS					
AC	Amelanchier canadensis	Shadblow Serviceberry	#10	Cont.	2	na
AR	Acer rubrum	Red Mople	2-1/2"	B&B	2	na
BP	Betula popyrifera	Paper Birch	1-1/2"	B&B	4	na
co	Celtis occidentalis	Common Hackberry	2-1/2"	B&B	5	na
GT	Gleditsia tricanthos	Skyline Honeylocust "Skycole"	2-1/2"	B&B	5	na
PT	Populus tremuloides	Quaking Aspen	2-1/2"	B&B	3	na
QB	Quercus bicolor	Swamp White Oak	2-1/2"	B&B	6	na
SHF	NUB					
Am	Aronia melanocarpa	Black Chokeberry	#3	Cont.	34	3'-6"
Aa	Aronia arbutifolia	Upright Red Chokeberry	#3	Cont.	17	3'
Ca	Ceanothus americanus	New Jersey Tea	#3	Cont.	8	3'
Cr	Cornus racemosa	Gray Dogwood	#3	Cont.	15	3'
ij	llex verticillata 'Jim Dandy'	Winterberry 'Jim Dandy'	#3	Cont.	14	4'
lv	llex verticillata	Winterberry	#3	Cont.	2	4'
Po	Physocarpus opulifolius	Ninebark "Little Devil"	#3	Cont.	8	4'
Ra	Rhus aromatica	Gro-Low Sumac	#3	Cont.	32	4'
M	Viburnum lentago	Nannyberry Viburnum	#5	Cont.	1	4'
PER	RENNIAL					
af	Athyrium filixfemina	Lady Fern	1 Gal	Cont.	160	As Show
al	Allium cernuum	Nodding Onion	Quart	Cont.	280	As Show
ap	Anemone patens	Pasque Flower	2"	Plug	44	As Show
bc	Bouteloua curtipendula	Side Oats Grama	2"	Plug	145	As Show
cl	Coreopsis lanceolata	Lance-leaf Coreopsis	Quart	Cont.	166	As Show
cv	Carex vulpinoidea	Fox Sedge	2"	Plug	398	As Show
ер	Echinacea purpurea	Purple Coneflower	2"	Plug	45	As Show
gm	Geranium macculatum	Bigroot Geramium	Quart	Cont.	175	As Show
mf	Monarda fistulosa	Wild Bergamot	2"	Cont.	18	As Show
pv	Panicum virgatum 'Shenandoah'	Shenandoah Switchgrass	1 Gal.	Cont.	141	As Show
rt	Rudbeckia triloba	Brown-eyed Susan	Quart	Cont.	119	As Show
MEA	ADOW PLANTING					
bc	Bouteloua curtipendula	Side Oats Grama	2"	Plug	84	12"
ls	Liatris spicata	Gayfeather	2"	Plug	12	12"
mf	Monarda fistulosa	Wild Bergamot	2"	Plug	12	12"
rt	Rudbeckia triloba	Brown-eyed Susan	2"	Plug	12	12"
TUR	RF					
	SOD	Mix	n/a	Roll	6253 sf	na




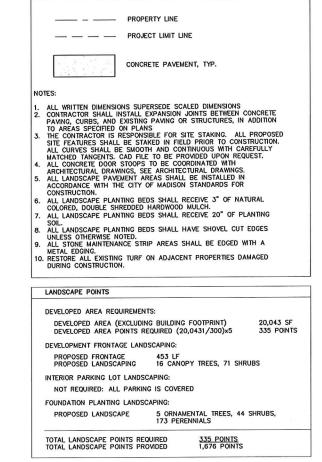





www.DiggersHotline.com




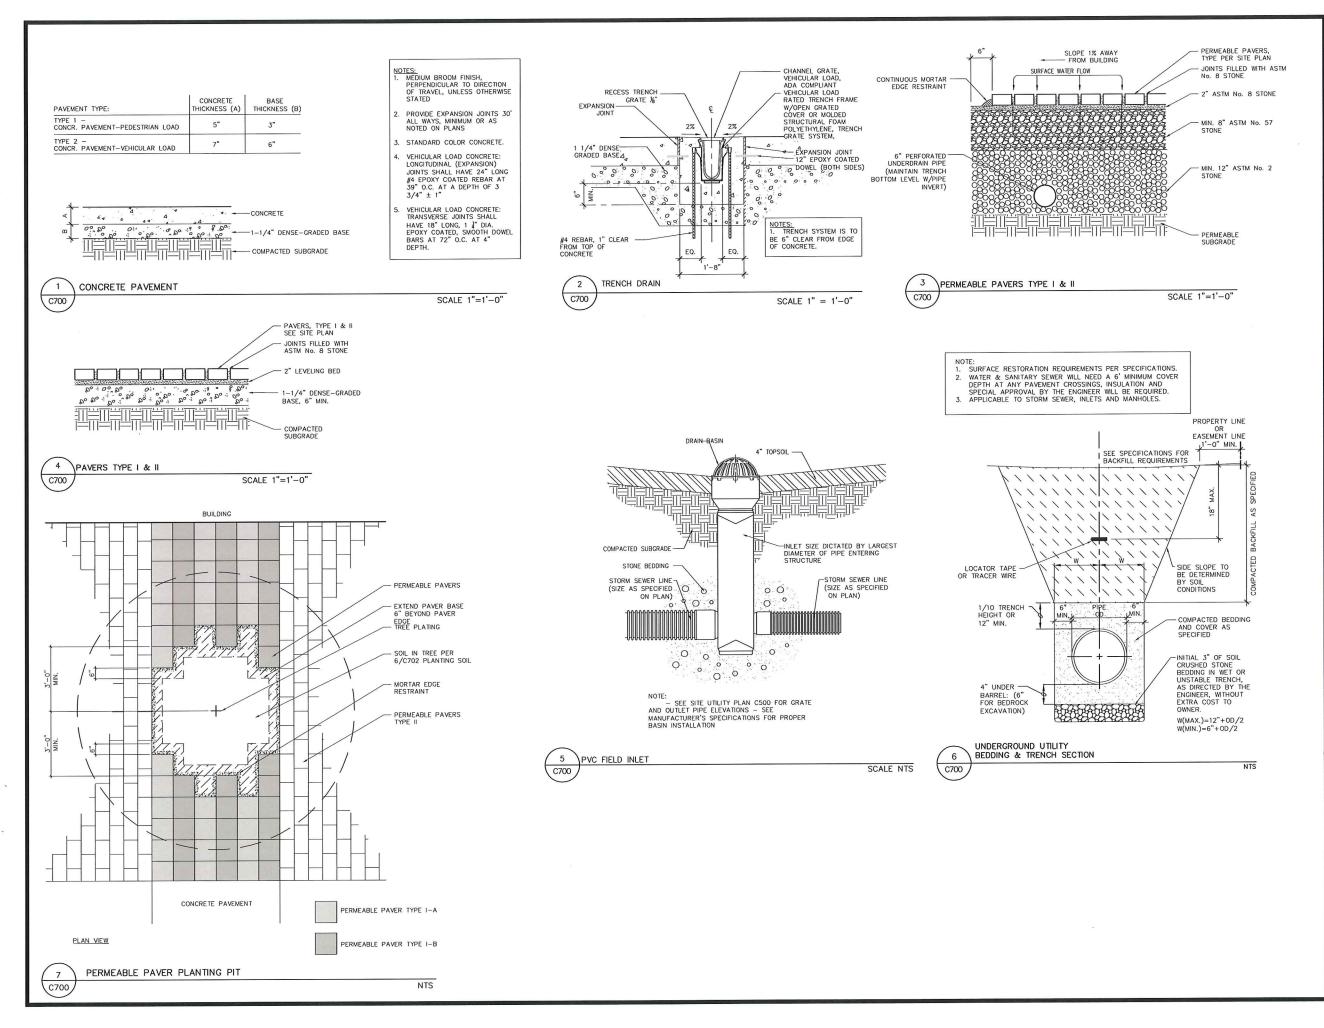


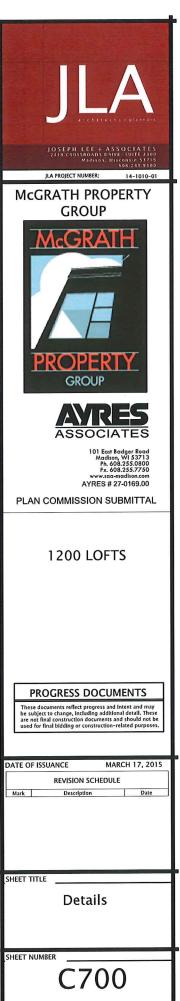


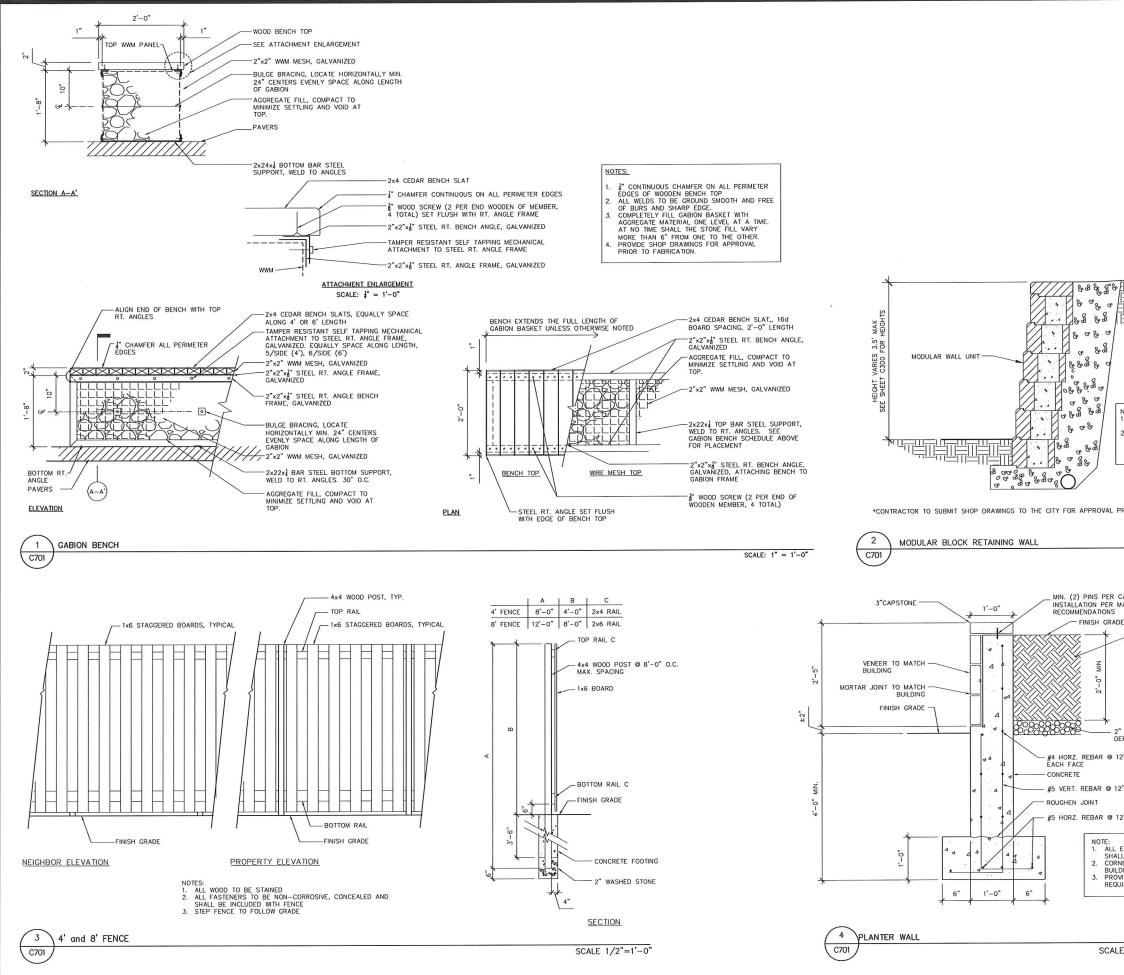

	8
	JUSEPHILEE+AASSOCIATES JAISSEPHILEE+AASSOCIATES Madiaa, Waaris Juga JA PROJECT NUMBER: 14-1010-01 MCGRATH PROPERTY GROUP
	McGRATH FROPERTY GROUP
NOTE: 1. CONSTRUCTION DETAILS SHOWN FOR DESIGN INTENT ONLY. 2. WALL SHALL BE DESIGNED & STAMPED BY A LICENSED STRUCTURAL ENGINEER BEFORE INSTALLING.	ASSOCIATES 101 East Badger Road Madion, WI 53713 Ph. 608.235.0780 Fx. 608.235.0750 Www.iaa-madion.com AYRES # 27-0169.00 PLAN COMMISSION SUBMITTAL
PRIOR TO CONSTRUCTING THE WALL.	1200 LOFTS
CAP. SIZE AND MANUFACTURER'S DE 5 C702 PLANTING SOIL	PROGRESS DOCUMENTS These documents reflect progress and intent and may be subject to change, including additional detail. These are not final construction documents and should not be used for final bidding or construction-related purposes.
" WASHED STONE, 6" MIN EPTH 2" O.C. 2" O.C.	DATE OF ISSUANCE MARCH 17, 2015           REVISION SCHEDULE           Mark         Description         Date
2° 0.C.	
EXPOSED SURFACES LL BE STONE. NER JOINTS TO MATCH DING CORNERS VIDE STONE ANCHORS AS JIRED.	Details
E 1" = 1'-0"	sheet number

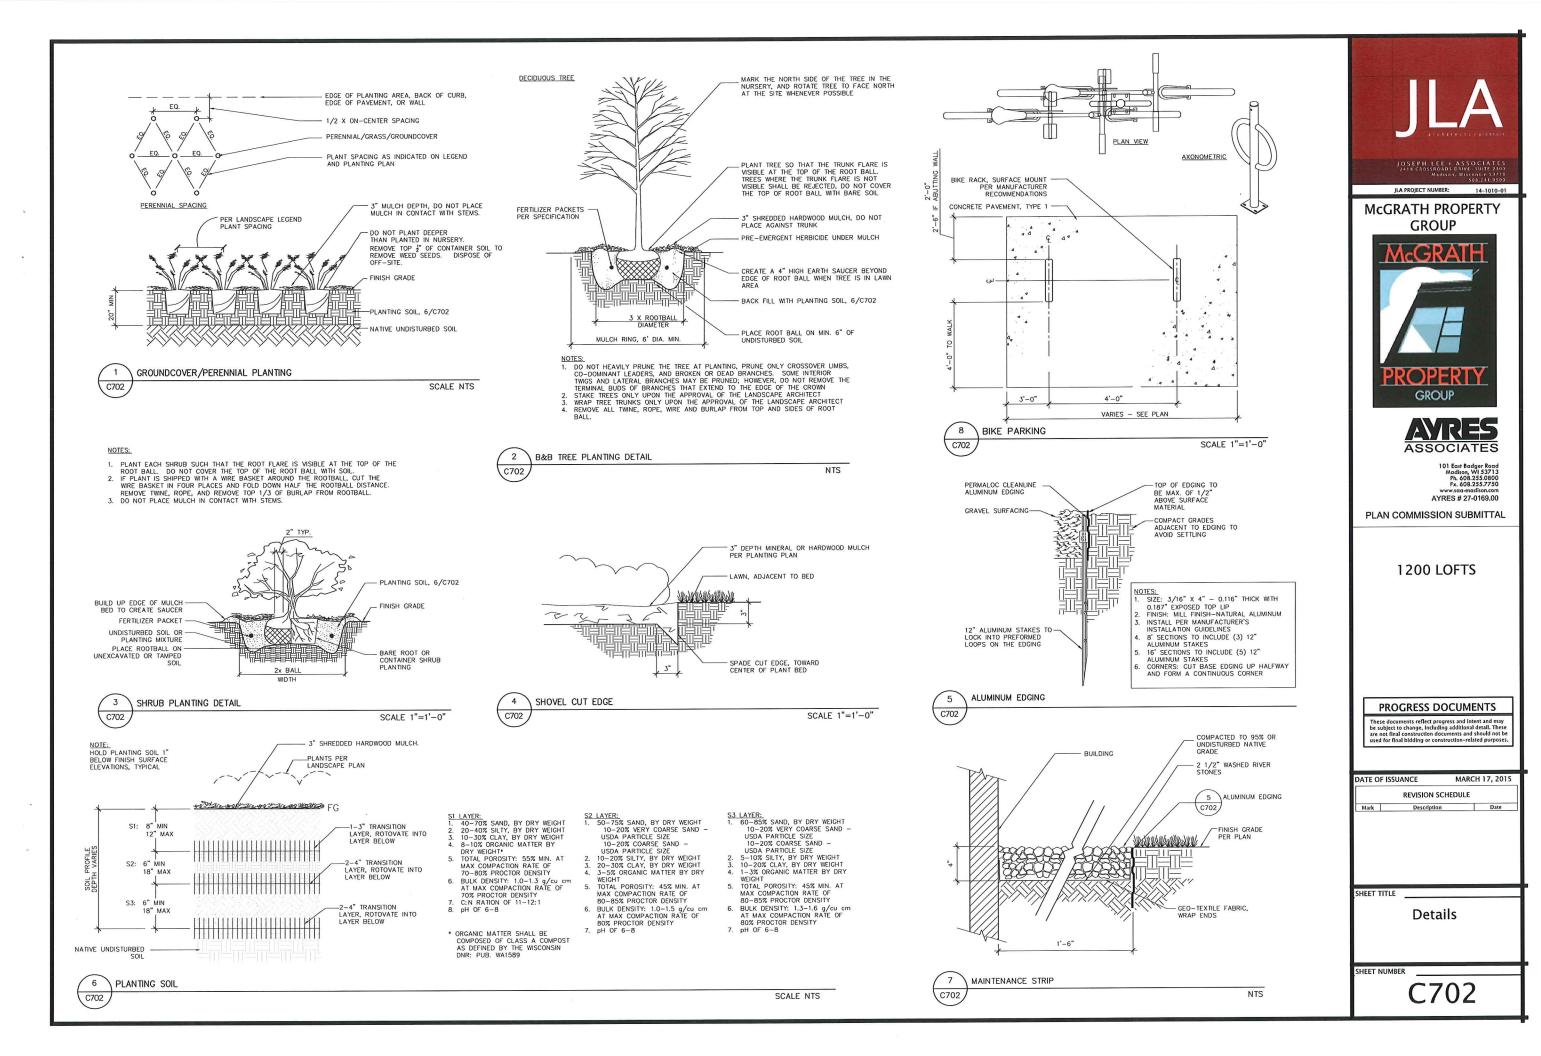


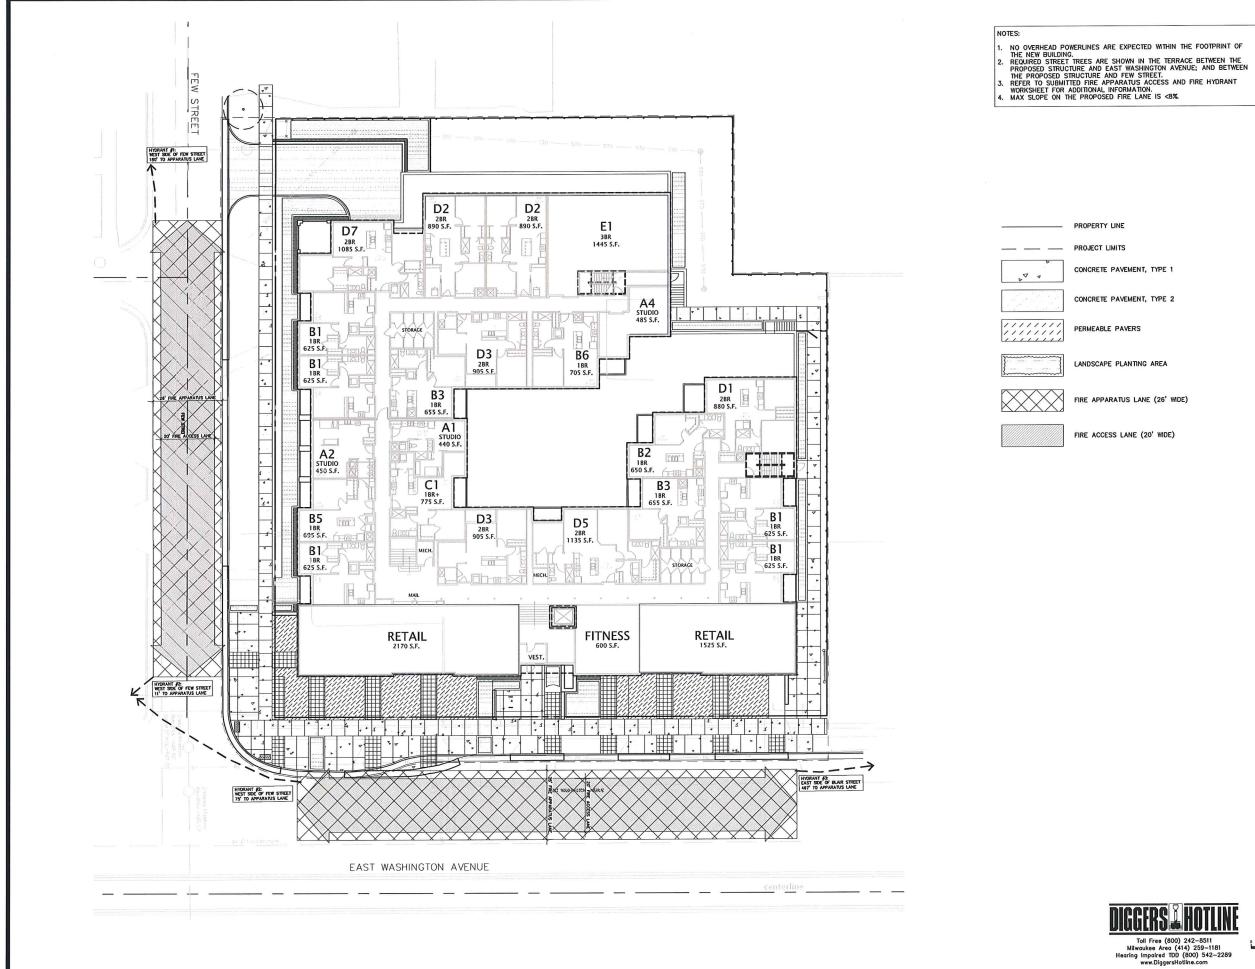


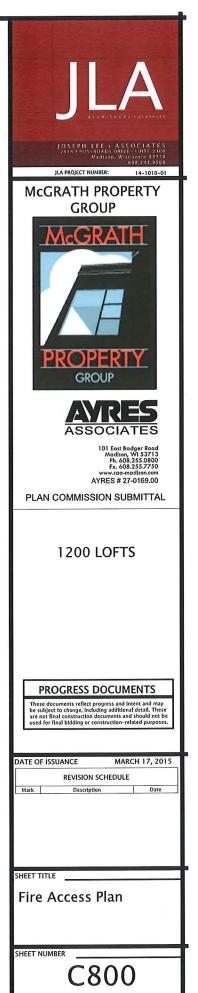





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	and the second	11-10-0	1 - Studio	Unit Al					. Studio	Linit At	C . Studie	a Uni	81 - 18R	Link 87	- 18R	Unit	3-18R		84 - 18R	Unit 85	-188	Unit 86	- 188	Unit 87	- 188	Unit C1	1-18R+	Unit C2	-18R+	Unit CX	- 1BR+	Unit D1	- 28R	Unit D	2 - 28R	Unit D	3-28R	Unit D	4-28R	Unit	D5 - 28R	Unit	6-28R	Unit D7	- 28R	Unit E1 - 38R		nit EX - 3BR	Unit	nit EX - 3BR	
	RETAIL	Unit A	1 - Studio 0 S.F.		S.F.	465 9			5.F.		S.F.	Unit of the	25 S.F.	635			S.F.		55 S.F.	695 5		705 5		720			S.F.		S.F.		S.F.	880	S.F.	890	S.F.	905	S.F.	905	S.F.	105	5.F.	1085	S.F.	1135	S.F.	1445 S.F.		1300 S.F.		Ø S.F.	
		Qty.		936	3.F.	Qty.					Area	Qty.		Qty.			Area		Area			Qty.				Qty.	Area	Qty.	Area	Qty.	A'ea	Qty.	Area	Qty.	Area	Qty.	Area	Qty.	Area	Qty.	Area	Qty.	Area	Qty.	Area	Qty. Area	a Qt	ty. Area	a Qty.	ty. Area	1
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Floor Z			440	1	450	1	465	-		1	56	5	7 4,375		635	1	650		2 1.310	1	695	1	705			1		5				1	000						-	-	410	-	1.085	1	1,135	1 1,4					
Floor 1	3,70	0	440	1	450			1	465				5 3,125			1	650		1.310	1	695	1	705			1	775	1.00		-		1	880	- 4	1,780		1,810								3,405	2 2,85		1 1 20	0.0		-
Totals	3,70	0	1.320	3	1,350	2	930	1	465	1	56	5 1	9 11.875	2	1,270	3	1,950		5 3,930	3	2,085	2	1,410	1	720	3	2,325	•		-	•	3	2,640	4	3,560	6	5,430	1	905	4	4,240	3	3,255		_			1 1,30	. 100	<u> </u>	_
		10		2.05		204		1.3%		1.35	6	25.0	144	2.6%		3.9%		7.9	76	3.9%		2.6%	1.1.1	1.3%		3.9%		0.0%		0.0%		3.9%		5.3%		7.9%		1.3%		5.39	6	3.9%		3.9%	2.	2.6%		1.3%		0.0%	_
Unit Breakdown		Tot	al Studios:	10	13.1%	Averag	e Studio		45	1.37			Total 1BRs:	36	47.4%	Av	erare 187		ŋ: 646				-			To	tal 18R+:	3	3.9%	Avg. Size:	775	Tot	tal 2BRs:	24	31.6%	Av	erage 288	R Size (sf):	: 97	6		3246	100.21			Total 38	Rs:	3 3.9	9% /	Average 31	BR

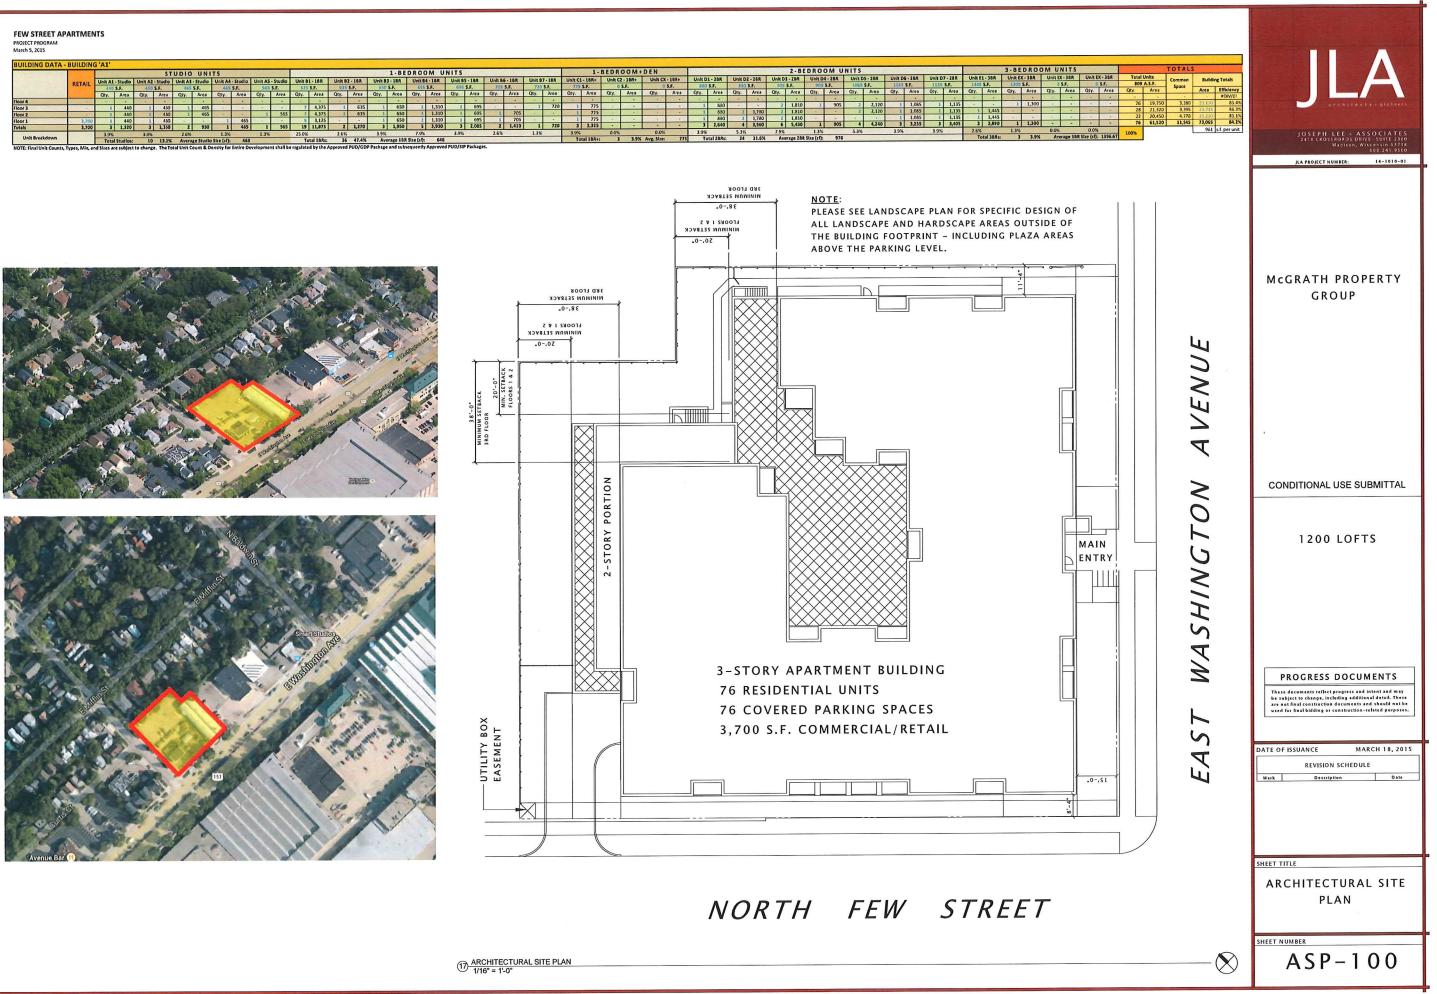

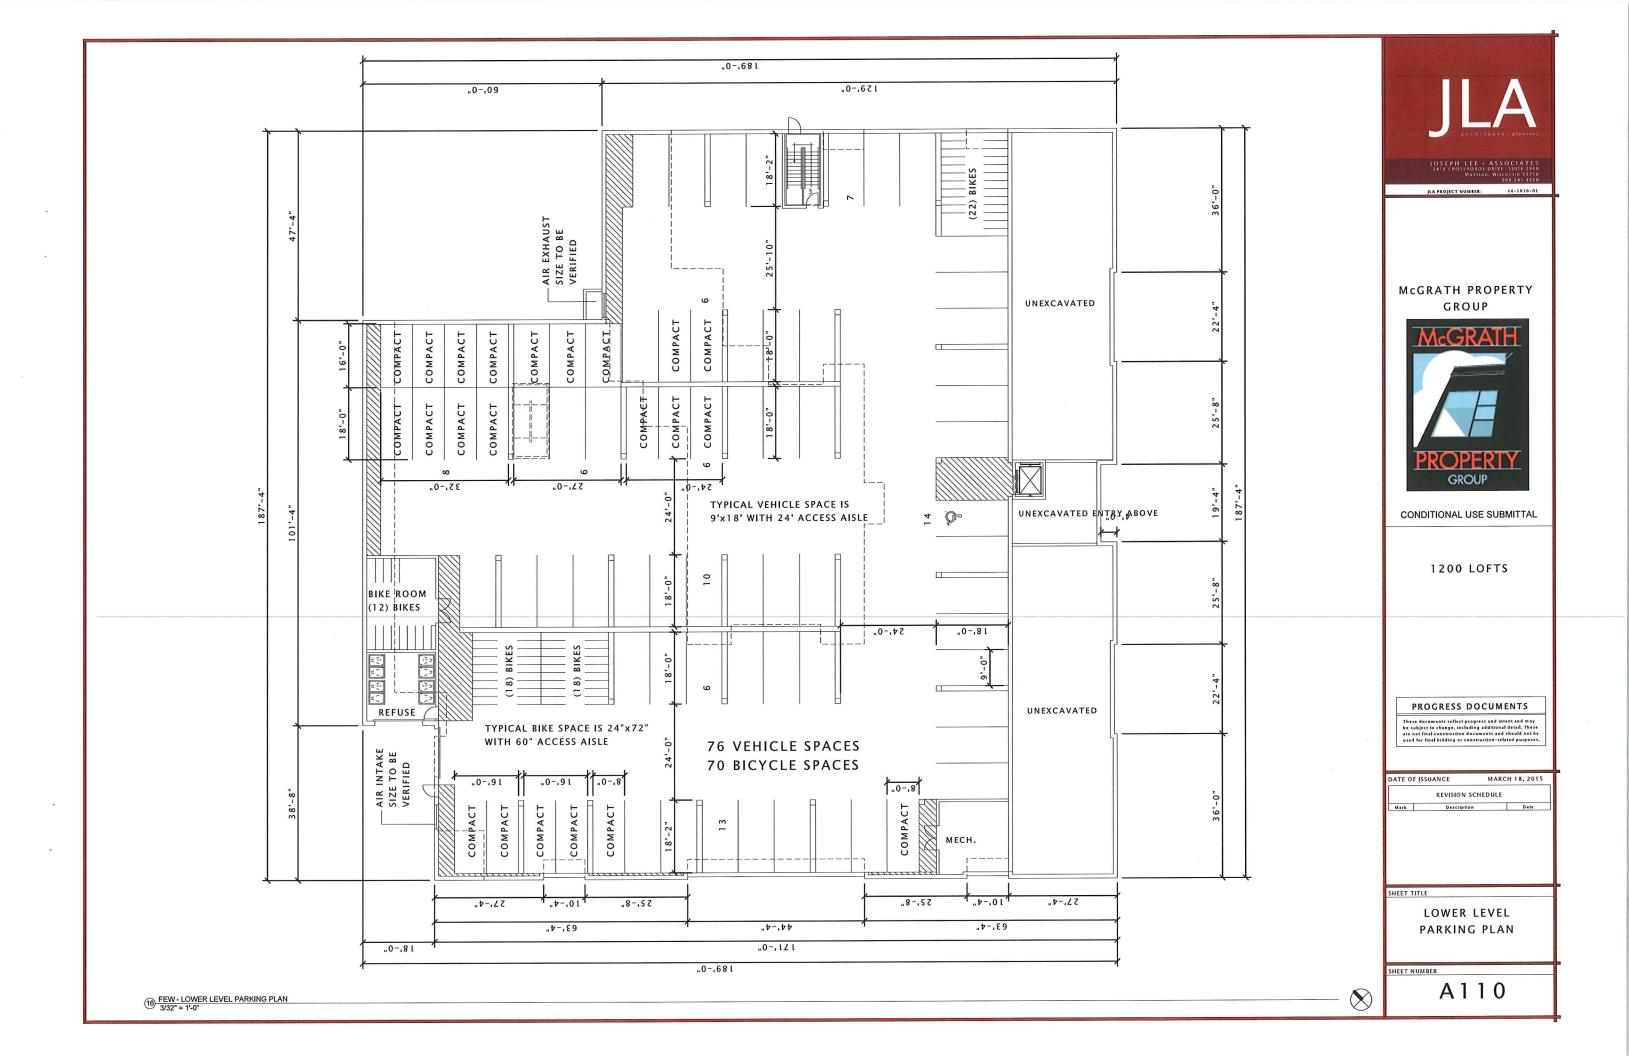


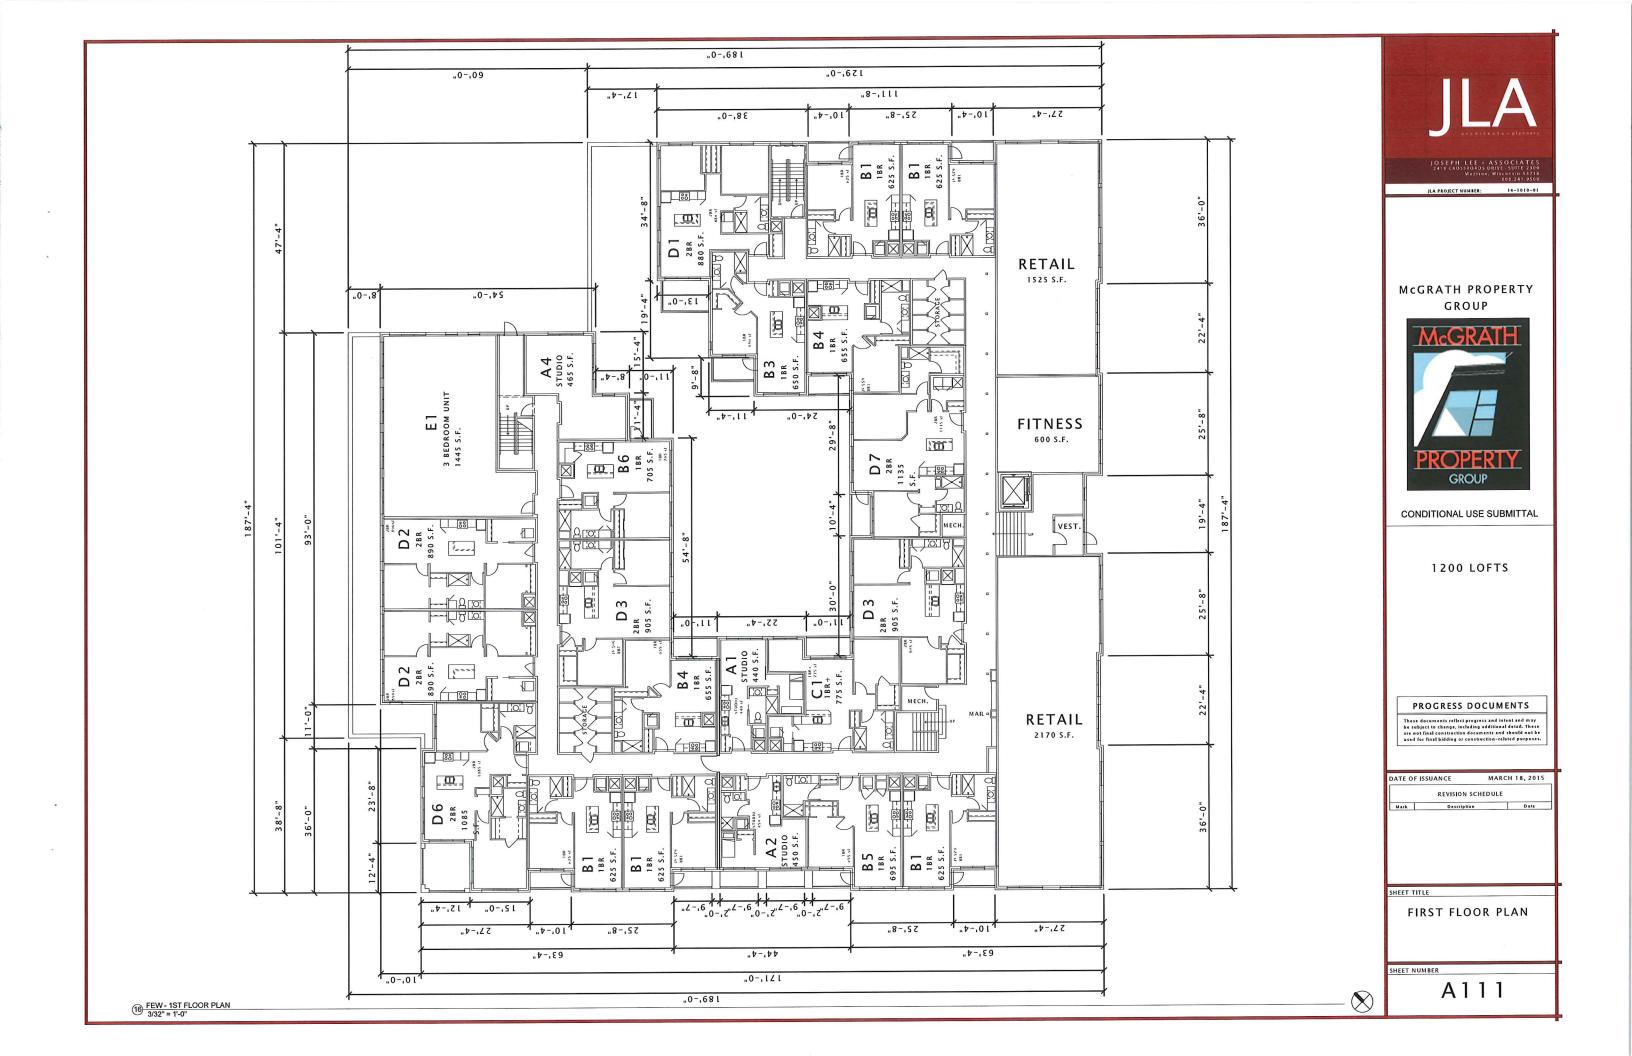

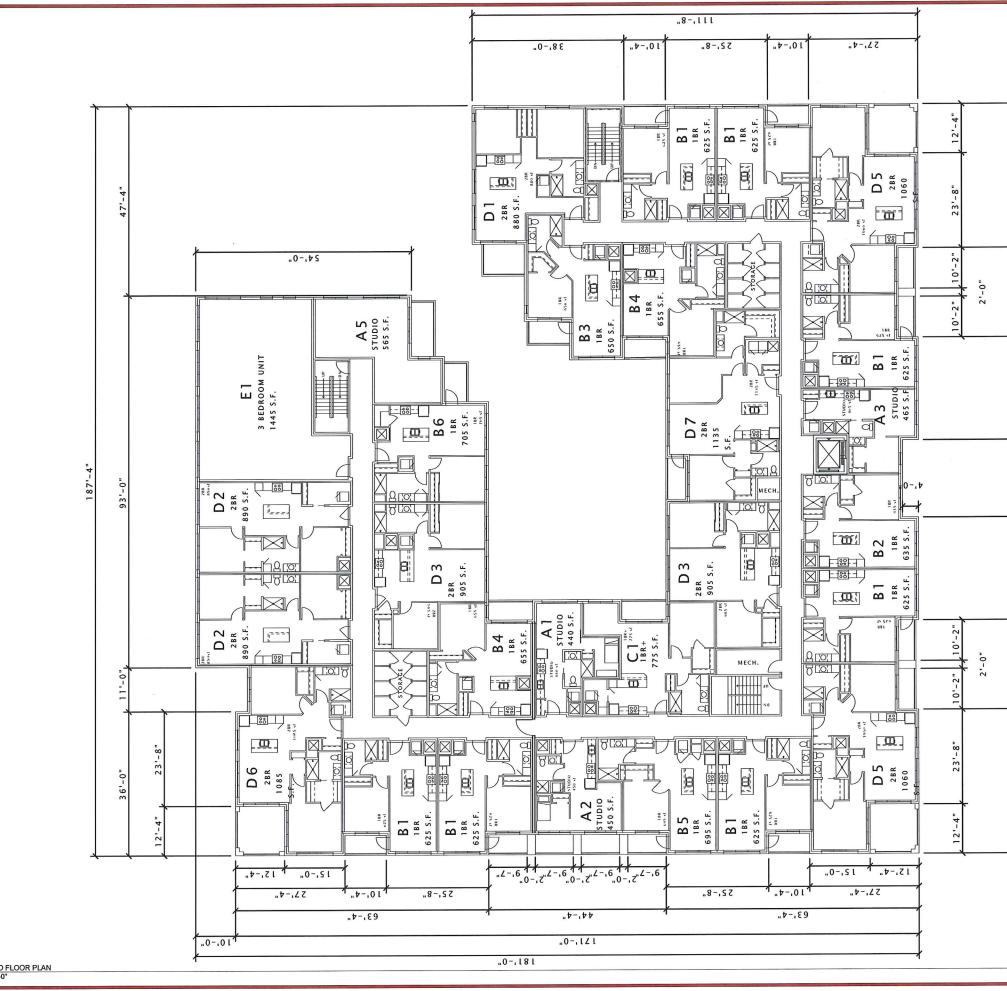

(16) FEW - 2ND FLOOR PLAN 3/32" = 1'-0"

		Т	JLA
36'-0"			JOSEPH LEE + ASSOCIATES 2418 CROSSROADS ORIVE - SUITE 2300 Wastion, Miscovin 33718 801241 - 300 JLA PROJECT NUMERE: 14-1010-01
22'-4"	<del>.</del>		McGRATH PROPERTY GROUP
25'-8"	Ŧ		PROPERTY GROUP
19'-4"	187'-4"		CONDITIONAL USE SUBMITTAL
25'-8"	-		1200 LOFTS
, 22'-4"			PROGRESS DOCUMENTS These documents reflect progress and intent and may be subject to change, including additional detail. These are not final construction documents and should not be used for final bidding or construction-related purposes.
36'-0"			DATE OF ISSUANCE MARCH 18, 2015 REVISION SCHEDULE Mark Description Date
		Ļ	SHEET TITLE
		&	SHEET NUMBER A 112

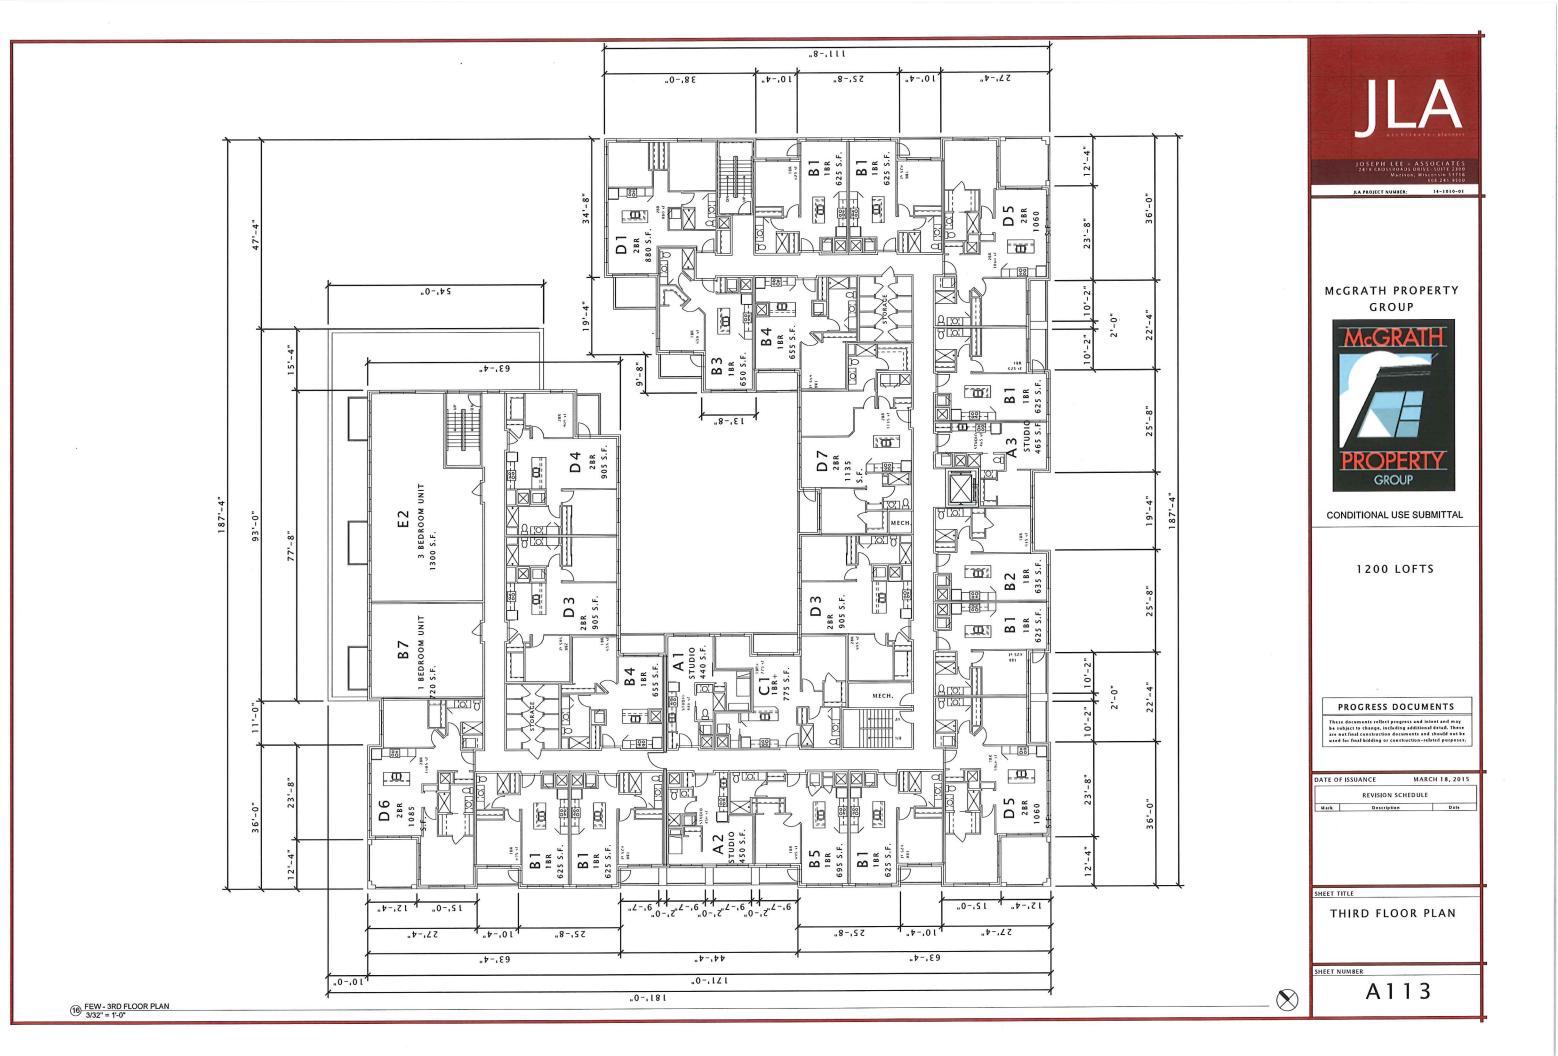

### 16 SOUTH' ELEVATION (FEW STREET)

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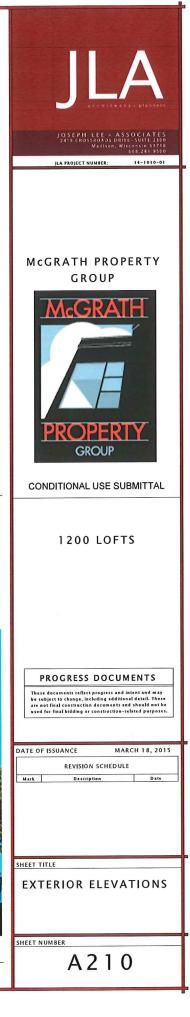
METAL PERGOLA SYSTEM WITH COMPOSITE WOOD PRIVACY SCREENS COMPOSITE/FIBERCEMENT CLAPBOARD SIDING (COLOR #1) AT ALL BALCONY RECESSES TYPICAL BALCONY - WOOD FRAMED WITH COMPOSITE DECKING WITH PREFINISHED ALUMINUM RAILINGS PREFINISHED METAL COPING SYSTEM (TYPICAL)							
FBEERGLASS WINDOWS & PATIO DOORS (TYPICAL) PRECAST CONCRETE LINTELS & SILLS (TYPICAL AT ALL MASONRY VENEER WALLS) BRICK VENEER - UTILITY SIZE WITH COLORED MORTAR PREFINISHED ALUMINUM RAILING SYSTEMS (TYPICAL) PRECAST CONCRETE BANDING							
4* + 8* PROFILES ARCHITECTURAL CAST STONE VENEER BASE PREFINISHED ALUMINUM RAILING (TYPICAL)	***					F	

RESIDENTIAL SIGNAGE -VERTICALLY MOUNTED ON WALL sum transfer Distance in case of the local division in th second texasion managine RETAILSIGNAGE **BERN** PREFINISHED ALUMINUM STOREFRONT WINDOWS AT COMMERCIAL AREA ALTERNATE - FIBERGLASS BRICK VENEER #2 -ARCHITECTURAL CAST STONE -UTILITY SIZE WITH COLORED MORTAR VENEER BASE & PLANTERS 6 EAST ELEVATION (EAST WASHINGTON AVENUE)





BERBERER





COMPOSITE/FIBERCEMENT CLAPBOARD SIDING (COLOR #2)														
BRICK VENEER	R						$\backslash$							
COMPOSITE/FIBERCEMENT CLAPBOARD SIDING AT ALL BALCONY RECESSES (COLOR #1)					BRICK VENEER (2ND 8			CAST STONE	CMU TRANSITION AT BASE					
COMPOSITE/FIBERCEMENT WINDOW TRIM & CORNERBOARDS (TYPICAL AT ALL SIDED WALLS)					ARCHITECTURAL CAST STO			FIBER-CEMENT/C	COMPOSITE SIDING (COLOR CHITECTURAL CMU BASE (19	#2-2ND & 3RD FLOORS) ST FLOOR)		FIBER-C	CEMENT/COMPOSITE SIDI BRICK VENEER ( ARCHITECT	
PREFINISHED METAL COPING														
PRECAST CONCRETE LINTELS												H		
BRICK VENEER - UTILITY SIZE WITH COLORED MORTAR	20		12.2		1			_	_					-
FIBERGLASS WINDOWS &		-						H						
PRECAST CONCRETE BANDING						m		11	T	T		THEFT	T	PRI
PREFINISHED METAL CANOPY														
PREFINISHED ALUMINUM STOREFRONT WINDOWS (FIBERGLASS ALTERNATE)									PREFINISHED ME	TAL CANOPY	, III.			
ARCHITECTURAL CAST STONE	Australiant II													
16 <u>'NORTH' ELEVATION</u> 1/8" = 1'-0"		STAIRS FROM PLAZA TO GRADE/											s	STAIRS FROM
1/8" = 1'-0"														

## 6 'WEST' ELEVATION 1/8" = 1'-0"






PREFINISHED ALUMINUM RAILING ON TOP OF PARAPET

BRICK VENEER -UTILITY SIZE WITH COLORED MORTAR

PRECAST CONCRETE BANDING 4" + 8" PROFILES

ARCHITECTURAL CAST STONE VENEER BASE


INSULATED METAL OVERHEAD DOOR

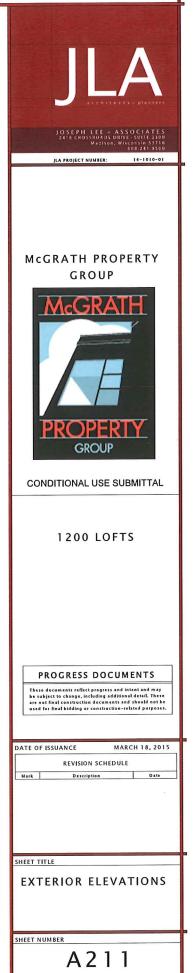







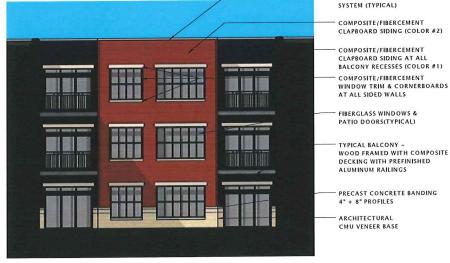

1/8" = 1'-0"



 PREFINISHED METAL COPING SYSTEM (TYPICAL) COMPOSITE/FIBERCEMENT CLAPBOARD SIDING (COLOR #2)

COMPOSITE/FIBERCEMENT

CLAPBOARD SIDING AT ALL BALCONY RECESSES (COLOR #1) COMPOSITE/FIBERCEMENT

WINDOW TRIM & CORNERBOARDS AT ALL SIDED WALLS

FIBERGLASS WINDOWS & PATIO DOORS(TYPICAL)

TYPICAL BALCONY -WOOD FRAMED WITH COMPOSITE DECKING WITH PREFINISHED ALUMINUM RAILINGS


PRECAST CONCRETE BANDING 4" + 8" PROFILES

ARCHITECTURAL CMU VENEER BASE

1/8" = 1'-0"

7 COURTYARD ELEVATION (EAST) 1/8" = 1'-0"



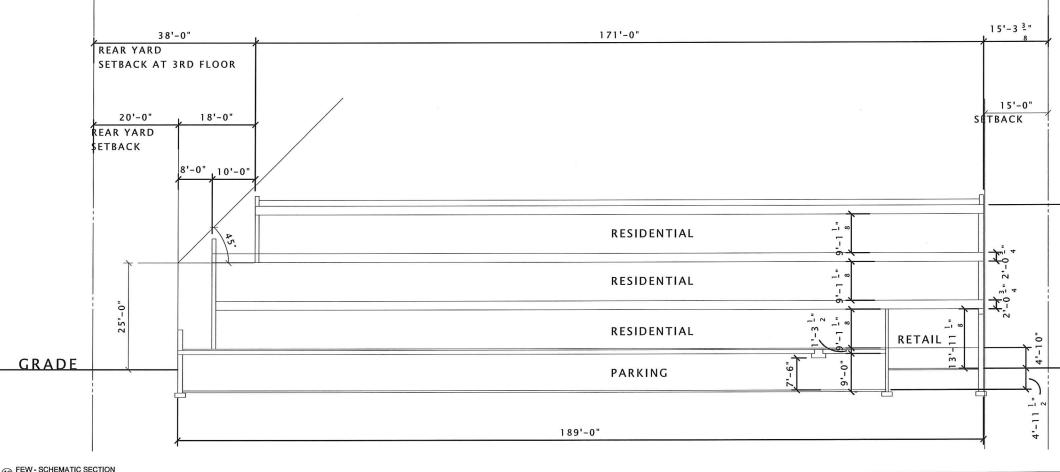

16 FEW - SCHEMATIC SECTION 1" = 10-0"

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