

Proposed Conditional Use

Location 4701 American Parkway


Project Name Kwik Trip Store #187

Applicant Jeff Osgood – Kwik Trip, Inc

Existing Use Vacant land

Proposed Use Construct auto service station, convenience store and car wash

Public Hearing Date Plan Commission 20 April 2015

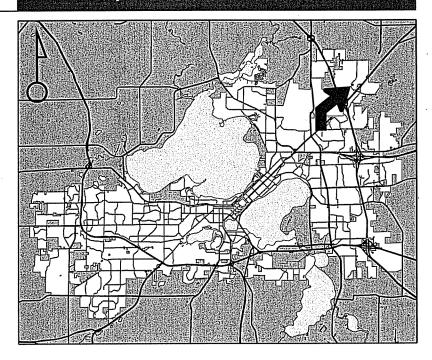

For Questions Contact: Tim Parks at: 261-9632 or tparks@cityofmadison.com or City Planning at 266-4635




Scale: 1" = 400'

City of Madison, Planning Division: RPJ: Date: 15 April 2015





City of Madison

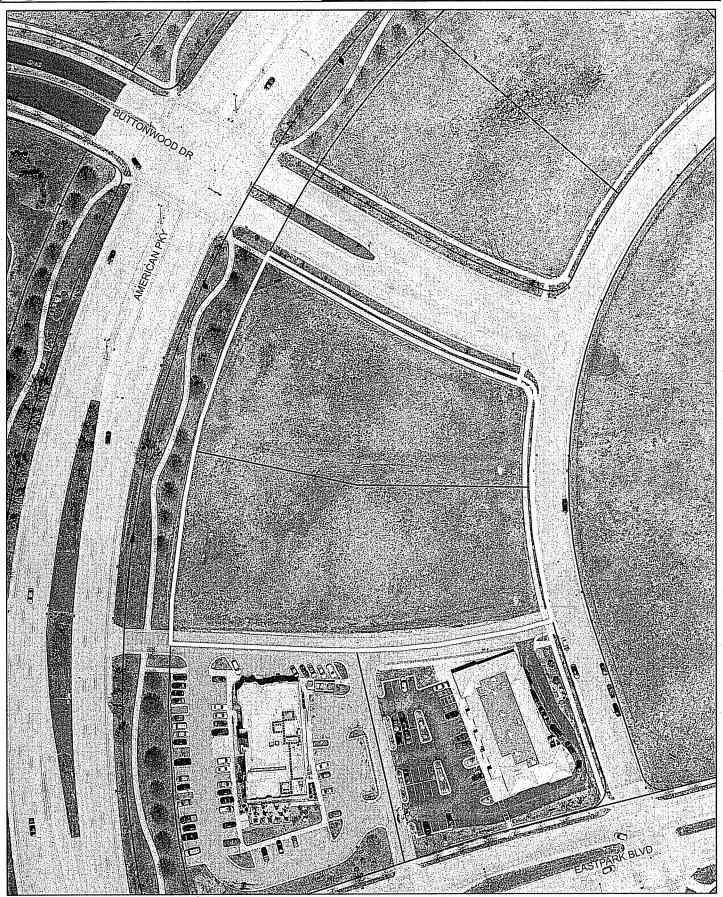

Date of Aerial Photography: Spring 2013



LAND USE AT LICATION	
Madison	TOD OFFICE UPP ONLY
247 Martin Luther King by Phydy Boom II 100	FOR OFFICE USE ONLY: Amt. Paid 1000 Receipt No. 1699 - 000 2
215 Martin Luther King Jr. Blvd; Room LL-100 PO Box 2985; Madison, Wisconsin 53701-2985	Amt. Paid <u>1000</u> Receipt No. <u>1699-000</u> L Date Received 3/4//5
Phone: 608.266.4635 Facsimile: 608.267.8739	Received By PDA
1101E. 005.204.4555 1 desiring 000.207.007	Parcel No. <u>08/0 -221 - 0/03-4 + 0/02-6</u>
 All Land Use Applications should be filed with the Zoning 	Aldermanic District / F, Jok CLAUSIUS
Administrator at the above address.	Zoning District C
The following information is required for all applications for Plan	Special Requirements
Commission review except subdivisions or land divisions, which	Review Required By:
should be filed using the <u>Subdivision Application</u> .	Urban Design Commission Plan Commission
 This form may also be completed online at: www.cityofmadison.com/developmentcenter/landdevelopment 	Common Council Other:
	Form Effective: February 21, 2013
4701 AMERICAN PKWY (5433	BUTTENCESCO DA.
1. Project Address: SE CORNER OF MMCRUAN PROCESSY	F BUTTONDOND PENS
Project Title (if any): <u>FWIL TRIP STORE # 107</u>	
2. This is an application for (Check all that apply to your Land	Use Application):
Zoning Map Amendment from	to
	Major Amendment to Approved PD-SIP Zoning
Review of Alteration to Planned Development (By Plan Con	
Conditional Use, or Major Alteration to an Approved Condit	cional Use
☐ Demolition Permit	
Other Requests:	
3. Applicant, Agent & Property Owner Information:	
	any: KWIK TRIP, INC
Approxime Frances	LA CROSSE, W7 Zip: S4602
Telephone: (608) 793-5547 Fax: (608) 793-4237	Email: 1039000 (a KOU) E 17 1/1. (180-
Project Contact Person: JEFF. 0.56 600 Compa	any: KWIK TRIP, INC
Street Address: /626 ONE ST City/State:	LACROSSE, WI Zip: 54602
Telephone: (608) 793 -5547 Fax: (608) 793-6237	Email: 1059000 @ Kerittip-cum
Property Owner (if not applicant):	
Street Address: City/State:	Zip:
4. Project Information:	

Provide a brief description of the project and all proposed uses of the site: Proposed (ON)

SEPTRITE FOLDING CANDEL HOLD ATTACKED 2-BAY CARDINGH; OUTDOOK ONSPE

Development Schedule: Commencement 08/01/7015

5. Required Submittal Information

All Land Use applications are required	to include the following:
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- Project Plans including:*
 - Site Plans (<u>fully dimensioned</u> plans depicting project details including all lot lines and property setbacks to buildings; demolished/proposed/altered buildings; parking stalls, driveways, sidewalks, location of existing/proposed signage; HVAC/Utility location and screening details; useable open space; and other physical improvements on a property)
 - Grading and Utility Plans (existing and proposed)
 - Landscape Plan (including planting schedule depicting species name and planting size)
 - Building Elevation Drawings (fully dimensioned drawings for all building sides, labeling primary exterior materials)
 - Floor Plans (fully dimensioned plans including interior wall and room location)

Provide collated project plan sets as follows:

- Seven (7) copies of a full-sized plan set drawn to a scale of 1 inch = 20 feet (folded or rolled and stapled)
- Twenty Five (25) copies of the plan set reduced to fit onto 11 X 17-inch paper (folded and stapled)
- One (1) copy of the plan set reduced to fit onto 8 ½ X 11-inch paper
- * For projects requiring review by the **Urban Design Commission**, provide **Fourteen** (14) additional 11x17 copies of the plan set. In addition to the above information, <u>all</u> plan sets should also include: 1) Colored elevation drawings with shadow lines and a list of exterior building materials/colors; 2) Existing/proposed lighting with photometric plan & fixture cutsheet; and 3) Contextual site plan information including photographs and layout of adjacent buildings and structures. The applicant shall <u>bring</u> samples of exterior building materials and color scheme to the Urban Design Commission meeting.

	shall <u>bring</u> samples of exterior building materials and color scheme to the Urban Design Commission meeting.
Ø	Letter of Intent: Provide one (1) Copy per Plan Set describing this application in detail including, but not limited to:
	 Project Team Existing Conditions Project Schedule Proposed Uses (and ft² of each) Hours of Operation Building Square Footage Number of Dwelling Units Auto and Bike Parking Stalls Lot Coverage & Usable Open Space Calculations Value of Land Estimated Project Cost Number of Construction & Full-Time Equivalent Jobs Created Public Subsidy Requested
凶	Filing Fee: Refer to the Land Use Application Instructions & Fee Schedule. Make checks payable to: City Treasurer.
Ø	Electronic Submittal: All applicants are required to submit copies of all items submitted in hard copy with their application as Adobe Acrobat PDF files on a non-returnable CD to be included with their application materials, or by e-mail to pcapplications@cityofmadison.com. Additional Information may be required, depending on application. Refer to the Supplemental Submittal Requirements.
6.	Applicant Declarations
×	Pre-application Notification: The Zoning Code requires that the applicant notify the district alder and any nearby neighborhood and business associations in writing no later than 30 days prior to FILING this request. List the alderperson, neighborhood association(s), and business association(s) AND the dates you sent the notices: ON SWIFT FROM MERICAN FIRMLY WAT IN DIRECT CONTROL ON 12/10/14 TO NOTIFY JOE CLASSING. If a waiver has been granted to this requirement, please attach any correspondence to this effect to this form.
X	Pre-application Meeting with Staff: Prior to preparation of this application, the applicant is required to discuss the

Name of Applicant JEFF 056000 Relationship to Property: Development punkage R-km k 7R of Authorizing Signature of Property Owner Myw. Aprol Date 03/03/2015 / 6

Date: 12/09/14 Zoning Staff: PAT ANDORSON

proposed development and review process with Zoning and Planning Division staff; note staff persons and date.

The applicant attests that this form is accurately completed and all required materials are submitted:

Anderson, Patrick

From:

Leeann Glover [leeann glover@gmail.com] Wednesday, March 04, 2015 2:43 PM

Sent: To:

Anderson, Patrick

Cc:

Dan T Swift; Joanne M Bernardi; LeeAnn Glover

Subject:

Kwik trip application

Hi Pat, please accept this email as indication that Kwik Trip has our permission to sign as owner for the conditional use application.

If you have any questions please feel free to contact me at 608.212.5216.

Thank you, LeeAnn Glover

LeeAnn Glover Director, Real Estate and Planning

Sent from my iPhone









City of Madison 215 Martin Luther King Jr Blvd Madison, WI 23701

Letter of Intent

March 4th, 2015

To whom it may concern,

This letter is intended to accompany our submittal for our application to the City of Madison for the requested Conditional Use Permit application for our proposed project at the southeast quadrant of American Family Parkway and Buttonwood Drive in the American Family Development.

Kwik Trip, Inc. is proposing the construction of a 7000 s.f. convenience store with attached 2-bay carwash and 4800 s.f. fueling canopy at the currently vacant 3.13 acre site. Included in the submittal are 1 copy (8.5 x 11), 25 copies (11x17), and 7 (24x36) full size copies of all documents requested.

The proposed method of operation for this development will be consistent with that for our existing convenience stores within the area. The requested hours of operation will be 24 hours for all uses. The type of products that will be sold will be similar to that of our existing stores: gasoline, in line diesel, E-85, groceries, bakery and dairy, hot and cold food and beverages, tobacco products, lotto, convenience store merchandise, ice, and propane. The outside merchandising of products is being requested next to the store (ice and propane) and miscellaneous merchandising under the gas canopy. The proposed store is projected to have between 15-20 full and part time employees, with 2-8 on staff at any given time. There are 8 total bike parking spaces as well as 29 general parking stalls including accessible parking stalls. We also have shown an additional 20 parking stalls which will be leased to the neighboring Irish Pub Restaurant. There is an existing development agreement/easement in place that these stalls will be a part of. American Family's Real Estate team is also involved with the approval of these additional parking stalls. We are aware that the maximum parking stalls for this site is 15. We are requested a variance for the additional parking stalls to operate efficiently.

The proposed architectural plan will consist of a brick facade with standing seam metal roof. The building and canopy fascia will tie in with franchise colors. The 2015 prototype building is larger than previous years building. We have expanded the retail floor area as well as kitchen and mechanical space all on the main level with no basement. The total estimated project costs including land is \$3,800,000.

Kwik Trip would be happy to provide any additional information or answer any questions or concerns you may have with our submission. Please feel free to call me with any questions.

Sincerely,

Jeff Osgood

Kwik Trip, Inc - Store Engineering Development/Project Manager

608-793-5547

josgood@kwiktrip.com





EXHIBIT D

LANDSCAPE POINT CALCULATIONS (To be completed by applicant)

TOTAL NUMBER OF PARKING SPACES	PROVIDED:	<u> 50</u>	
CANOPY TREE REQUIREMENTS: (Required at 1 tree per 12 parking spaces of	or fraction thereof)		
Number Required:		4_	
Number Provided:		4	
LANDSCAPE POINT COMPUTION (Required at the rate of 15 points per parki	ng space - exclusive of canopy trees	•	
	Total Required Points:	750	
Land Elements:	Number of Elements	Points per Element	
Canopy Trees (2-2.5" caliper) @ 50 pts	s. each $\frac{2}{ave}$ * replace	cing 2 existing trees being removed dur	ing +
Canopy Trees (8-10' height) @ 30 pts.	each	30	nstruci
Evergreen Trees @ 30 pts. Each	· ·		
Ornamental Trees @ 20 pts. each	14	280	
Tall Shrubs @ 9 pts. each	7	63	
Medium Shrubs @ 6 pts. each	28	168	
Low Shrubs @ 3 pts. each	70	210	
	TOTAL POINTS PROVIDED:	751	
Source: Architectural and Development	t Guidelines/Chapter 6 (Landscapii	ng)	

The American Center, Madison, Wisconsin

Note:

Applicant may request points for decorative fences, earth berms, ground covers, existing vegetation and shrubs of less that 2' height. The number of points credited may be negotiated.

Applicant shall also comply with City of Madison standards which may require a higher level of landscaping.

March 10, 2009



Owner / Conta	ct
Contact Phone	
Jointage 1 Hork	Official Linitia
	** Landscape plans for zoning lots greater than ten thousand (10,000) square feet in size MUST be prepared by a registered landscape architect. **
Applicability	
ouildings, stru heir accessor	standards apply to all exterior construction and development activity, including the expansion of existing ctures and parking lots, except the construction of detached single-family and two-family dwellings and structures. The entire development site must be brought up to compliance with this section unless all of the ditions apply, in which case only the affected areas need to be brought up to compliance:
(a) Th	e area of site disturbance is less than ten percent (10%) of the entire development site during any ten-(10)
•	ar period.
(b) G1	oss floor area is only increased by ten percent (10%) during any ten-(10) year period.
(c) No	demolition of a principal building is involved.
(d) A1	y displaced landscaping elements must be replaced on the site and shown on a revised landscaping plan.
Required land lefined as the locking/loading	alculations and Distribution scaped areas shall be calculated based upon the total developed area of the property. Developed area is at area within a single contiguous boundary which is made up of structures, parking, driveways and ag facilities, but excluding the area of any building footprint at grade, land designated for open space uses
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per one hundred (100) square feet of developed area.

Plant Type/ Element	Installation	Pomts	Quantity	Points Achieved	Quantity	Points Achieved
Overstory deciduous tree	2½ inch caliper measured diameter at breast height (dbh)	35			32	1120
Tall evergreen tree (i.e. pine, spruce)	5-6 feet tall	35				
Ornamental tree	1 1/2 inch caliper	15			7	105
Upright evergreen shrub (i.e. arborvitae)	3-4 feet tall	10			14	140
Shrub, deciduous	#3 gallon container size, Min. 12"-24"	3			91	273
Shrub, evergreen	#3 gallon container size, Min. 12"-24"	4			39	156
Ornamental grasses/ perennials	#1 gallon container size, Min. 8"-18"	2			97	194
Ornamental/ decorative fencing or wall	n/a	4 per 10 lineal ft.				
Existing significant specimen tree	Minimum size: 2 ½ inch caliper dbh. *Trees must be within developed area and cannot comprise more than 30% of total required points.	14 per caliper inch dbh. Maximum points per tree: 200	5	210		
Landscape furniture for public seating and/or transit connections	* Furniture must be within developed area, publically accessible, and cannot comprise more than 5% of total required points.	5 points per "seat"			32	114 5% of 2275
Sub Totals						2102

Total Number of Points Provided 23|2

^{*} As determined by ANSI, ANLA- American standards for nursery stock. For each size, minimum plant sizes shall conform to the specifications as stated in the current American Standard for Nursery Stock.

KWIK TRIP STORE #187

CONDITIONAL USE PERMIT APPLICATION SUBMITTAL

OWNER

KWIK TRIP, INC
JEFF OSGOOD
1626 OAK STREET
LA CROSSE, WI 54602
PHONE: 608-793-5547
EMAIL: josgood@kwiktrip.com

CIVIL ENGINEER
SNYDER & ASSOCIATES
SCOTT ANDERSON
5010 VOGES RD
MADISON, WI 53718
PHONE: 608-838-0444

EMAIL: sanderson@snyder-associates.com

SURVEYOR

SNYDER & ASSOCIATES 5010 VOGES RD MADISON, WI 53718 PHONE: 608-838-0444

SHEET INDEX

TRUCK CIRCULATION SP1 SITE PLAN SP1.1 SITE PLAN KEYNOTES SP2 **GRADE PLAN** SP2.3 ACCESSIBLE PLAN STORM SEWER PLAN SP4 UTILITY PLAN SWPPP1 **EROSION CONTROL PLAN** PRELIMINARY LANDSCAPE PLAN L1 A120A MAIN FLOOR PLAN - UNIT A A120B

SURVEY SHEET 2

A120B MAIN FLOOR PLAN - UNIT B
A200 BUILDING ELEVATIONS
COLOR 1 COLORED BUILDING ELEVATIONS
COLOR 2 COLORED CANOPY ELEVATIONS





PH. (608) 781-8988 FAX (608) 781-8960

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DATE





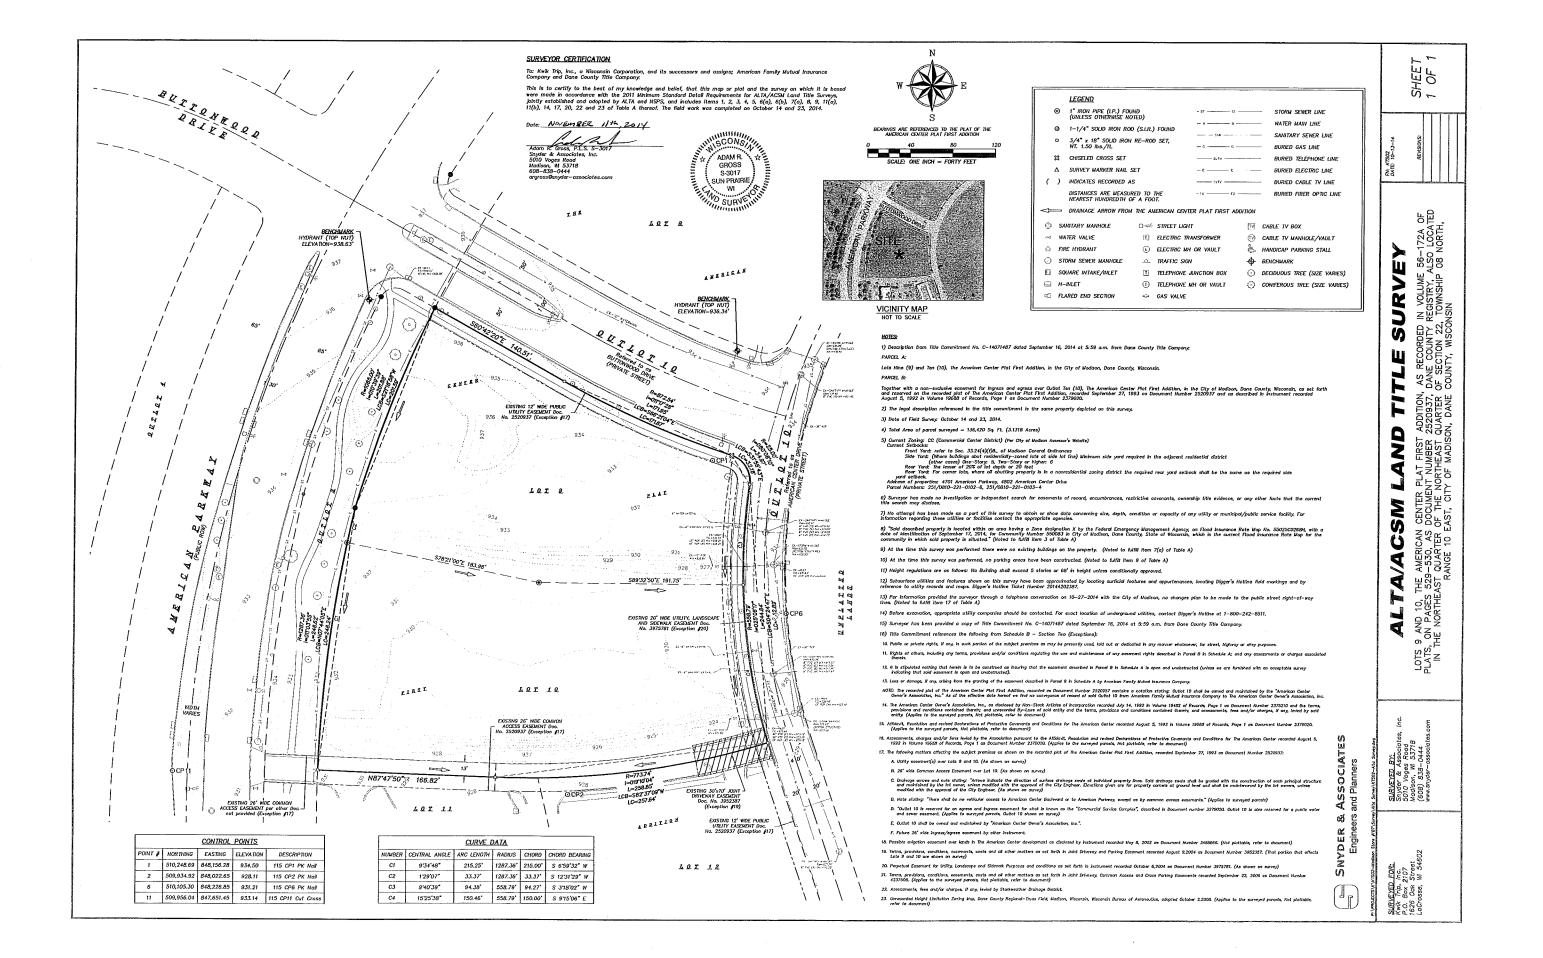

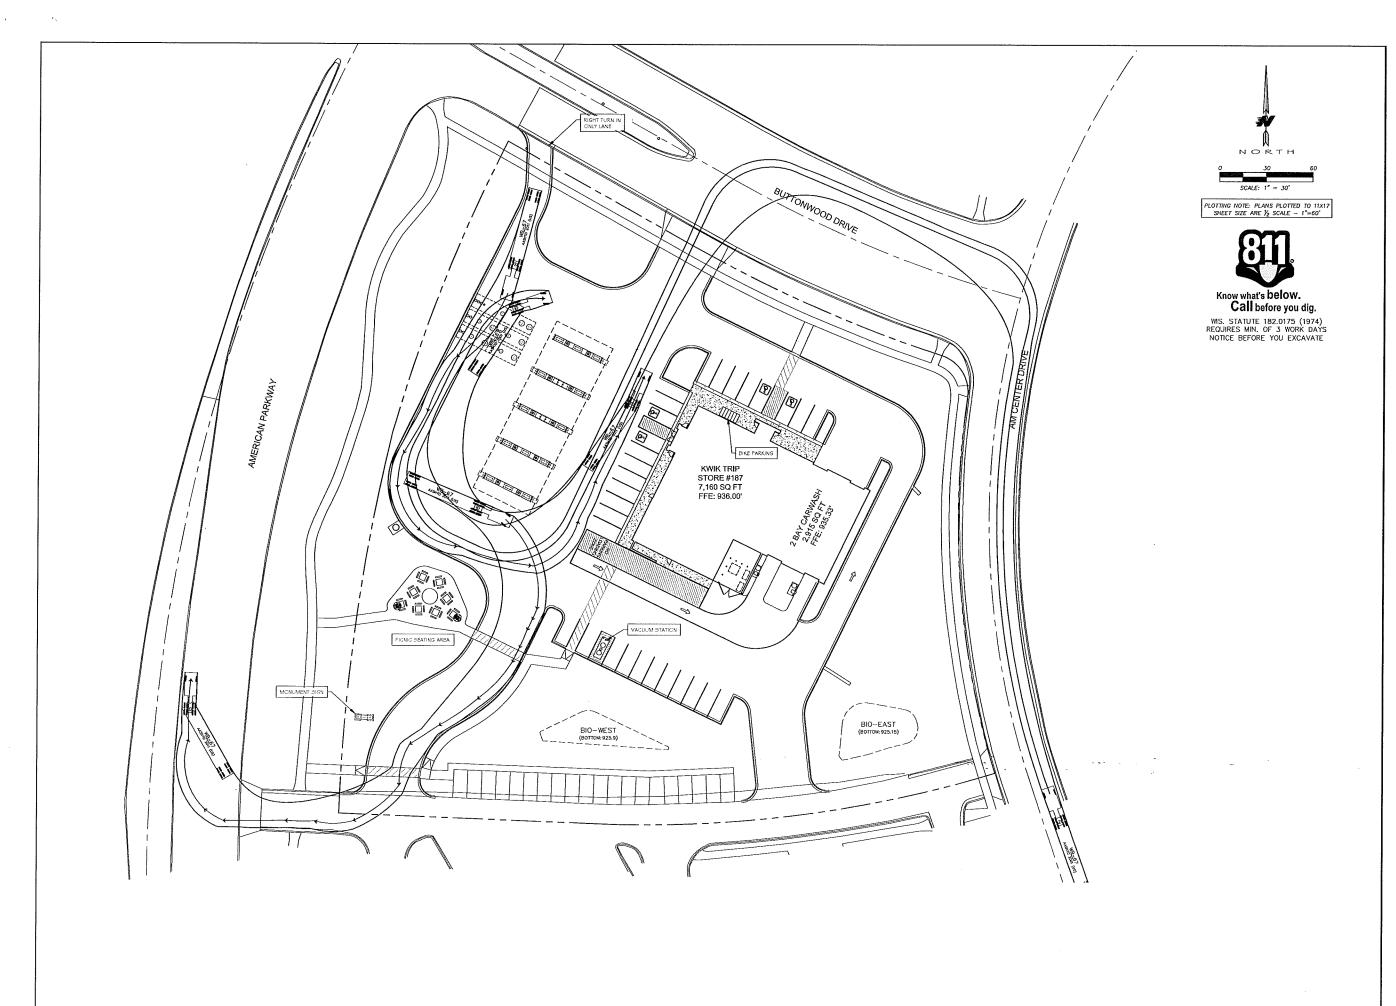STORES



STORES

KWIK TRIP, Inc. P.O. BOX 2107 1626 OAK STREET LA CROSSE, WI 54602-2107 PH. (608) 781-8988 FAX (608) 781-8960




SNYDER & ASSOCIATES 5010 VOGES ROAD MADISON, WISCONSIN 53718 608-838-0444 KTS01 www.snyder-associates.com

SITE PLAN - TURNING MOVEMENTS

187 STORE CONVENIENCE

SITE PLAN - TURNING	CONVENIENCE STORE	4701 AMERICAN PARKWAY MADISON, WISCONSIN 53718
NO. DATE	DESCRIPTION	
DRAWN BY		M. WAHL
SCALE		1" = 30'
PROJ. NO.		KTS02
DATE		3-4-15
SHEET	SP	

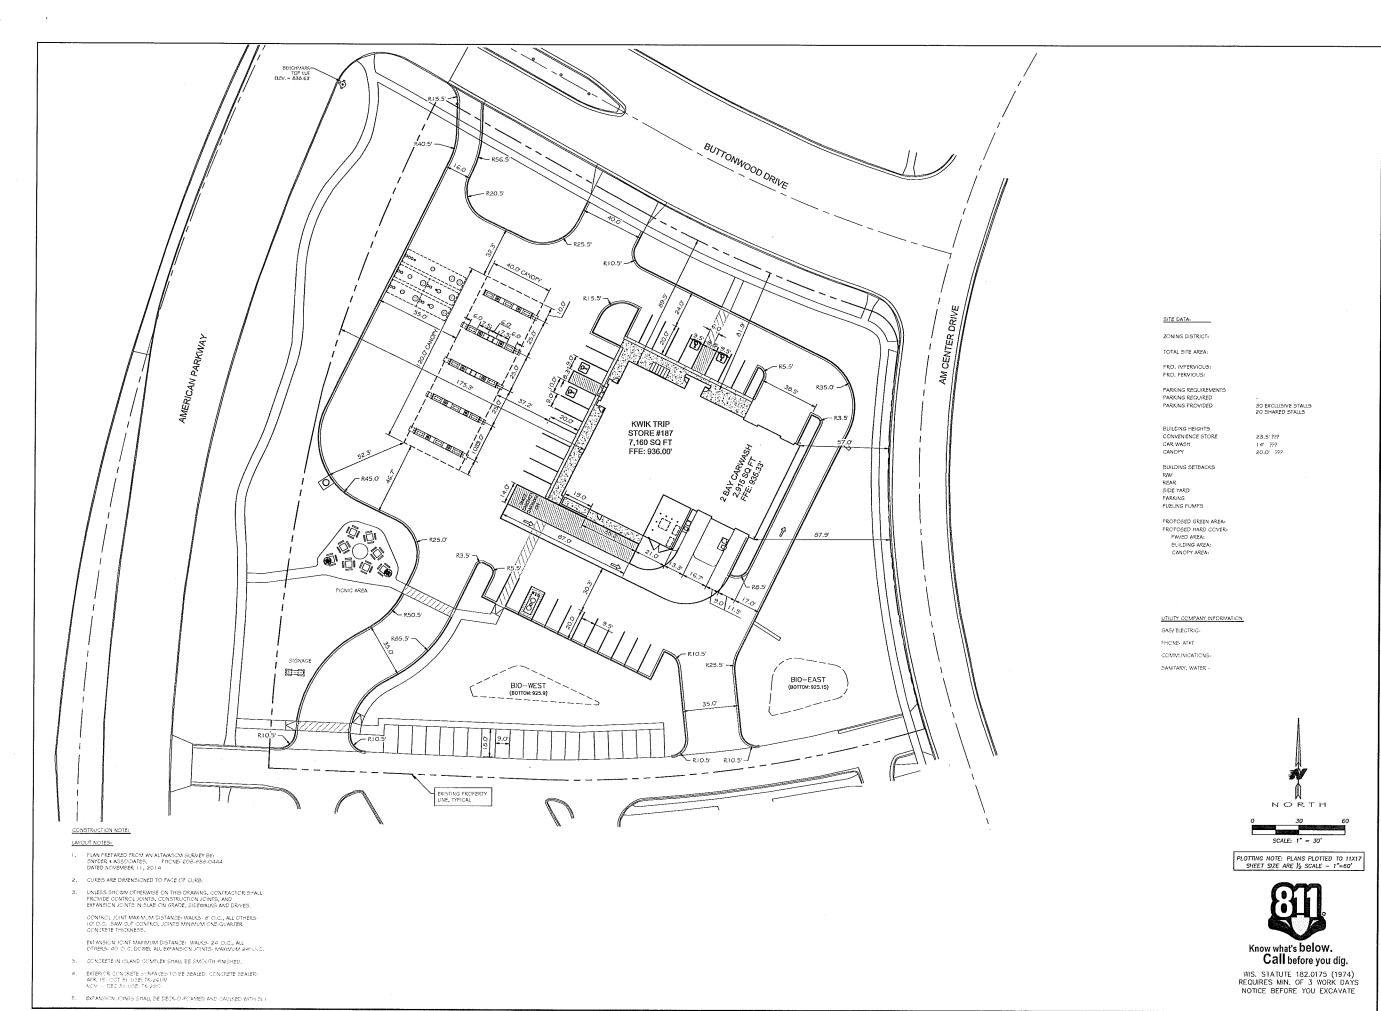



STORES

KWIK TRIP, Inc. P.O. BOX 2107 1626 OAK STREET LA CROSSE, WI 54602-2107 PH. (608) 781-8988 FAX (608) 781-8960




SNYDER & ASSOCIATES 5010 VOGES ROAD MADISON, WISCONSIN 53718 608-838-0444 KTS01 www.snyder-associates.com

187 PARKWAY V 53718 PLAN LAYOUT


STORE CONVENIENCE SITE

SITE PLAN LA	CONVENIENCE	4701 AMERICAN I MADISON, WISCONSIN
NO. DATE	DESCRIPTION	
DRAWN BY		M. WAHL
SCALE		1" = 30
PROJ. NO.		KTS02
DATE		3/4/15
SHEET	SP1	

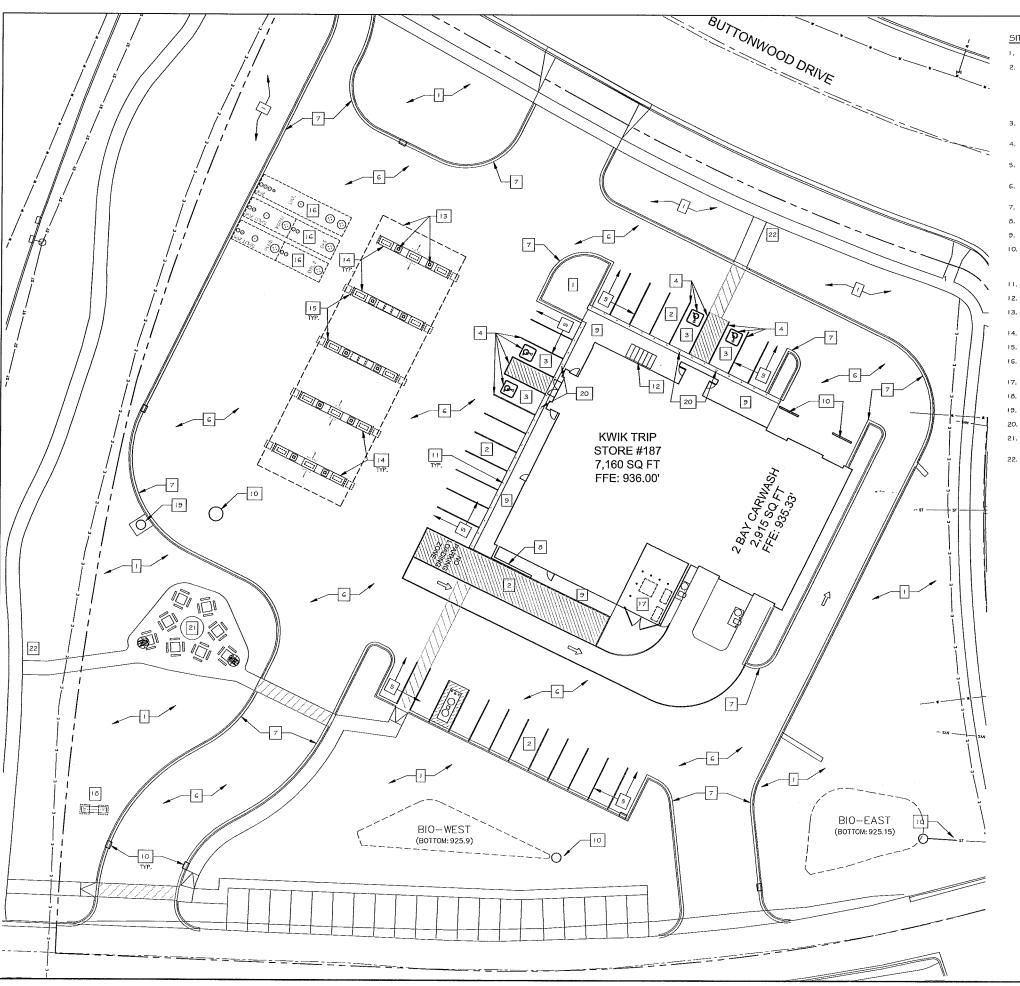

SITE PLAN KEYNOTES

- I. LANDSCAPE AREA, SEE SHEET LI.
- OFF-STREET PARKING STALLS
 STRIPING 4" WIDE STALL LINES, USE HIGH VISIBILITY WHITE PAINT.
 SPACES PROVIDED
 (25) 9:09:20-0" (MIN.) GENERAL PARKING
 (4) 9:09:20-0" ACCESSIBLE PARKING WITH
 (1) 14-0" 87-0" LOADING ZOILE
- 3. A.D.A. ACCESSIBLE PARKING SPACE WITH LOADING ZONE. PROVIDE APPROPRIATE STRIPING AND PAVEMENT MARKINGS.
- 4. 4" WIDE, HIGH VISIBILITY, PAVEMENT STRIPING, LANE MARKINGS AND TEXT, COLOR: HC MARKINGS- BLUE, ALL OTHERS- YELLOW.
- 5. G' DEPTH (MIN.) CONCRETE SLAB-ON-GRADE WITH #3 REBAR. CONCRETE SEALER: TK-2GUV
- 6" DEPTH (MIN.) CONCRETE SLAB-ON-GRADE WITH #3 REBAR. CONCRETE SEALER: TK-2GUV
- 7. CONCRETE CURB AND GUTTER FER DETAILS.
- 8. CONCRETE CURB WALL PER DETAILS.
- 9. G' INTEGRAL CONCRETE CURBY WALK, SEE DETAILS, CONCRETE SEALER: TK-2GUV
- 10. STORM STRUCTURE. SEE SHEETS 5P2-5P4 FOR FURTHER STORM SEWER INFORMATION, A. CATCH BASHI CURB HILET PER DETAILS B. OIL SKIMMER PER DETAIL ON SHEET 5P3 C. TRENCH DRAIN FER DETAIL
- 11. 30° HT., 6° DIA. CONCRETE FILLED PIFE BOLLARD PER DETAILS.
- 12. G STALL BIKE RACK WITH 5' CLEARANCE ALL AROUND,
- 40-0% I 20-0" DISPENSER ISLAND CANOPY. VERIFY SIZE, PLACEMENT, COLUMN AND FOOTING SIZE WITH CANOPY AND STRUCTURAL PLANS. CANOPY GRAPHICS PER OWNER..
- 14. 3'-G'x G'-O' CONCRETE ISLANDS W/ G' EXPOSURE WITH FUEL DISPENSERS. DISPENSER PER OWNER.
- 15. U-PIPE BOLLARD. 36" HT ABOVE GRADE, SLEEVE WITH DR-18, 4" BLUE PLASTIC WATERMAIN PIPE.
- 16. UNDERGROUND FUEL STORAGE TANKS FER OWNER, PROVIDE PIPING AND VEHTING PER OWNER'S SPECIFICATIONS.
- 17. EXTERNAL TRASH ENCLOSURE TO MATCH BUILDING. SEE ARCHITECTURAL DETAILS.
- 18. KMK TRIP TRADEMARK SIGN (VERIFY LOCATION WITH SIGN PERMIT)
- 19. 'FREE AIR' COMPRESSOR. PROVIDE SIGNAGE PER OWNER.
- 20. HC PVC BOLLARD SLEEVE PER OWNER, VAN ACCESS SIGNAGE AT 48" HT. STALL PARKING AT 60" HT.
- 21. PICNIC TABLE PER OWNER, PROVIDE 2 HC. ACCESS TABLE SPACE, PROVIDE TRASH CONTAINER PER
- 22. EXISTING CONCRETE WALK TO REMAIN. REPAIR/ REPLACE AS NEEDED PER CITY.

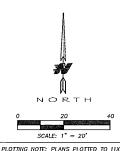

PLOTTING NOTE: PLANS PLOTTED TO 11X17 SHEET SIZE ARE 1/2 SCALE - 1=40'



Know what's below.
Call before you dig.

WIS. STATUTE 182.0175 (1974) REQUIRES MIN. OF 3 WORK DAYS NOTICE BEFORE YOU EXCAVATE



KWIK TRIP, Inc. P.O. BOX 2107 1626 OAK STREET LA CROSSE, WI 54602-2107 PH. (608) 781-8988 FAX (608) 781-8960




SNYDER & ASSOCIATES 5010 VOGES ROAD MADISON, WISCONSIN 53718 608-838-0444 KTS01 www.snyder-associates.com

SITE PLAN KEYNOTE	CONVENIENCE STORE 187	4701 AMERICAN PARKWAY MADISON, WISCONSIN 53718
DATE	DESCRIPTION	
AWN BY		M. WAHL
ALE OJ. NO.		1" = 20' KTS02
TF		3-4-15

SP1.1

SHEET

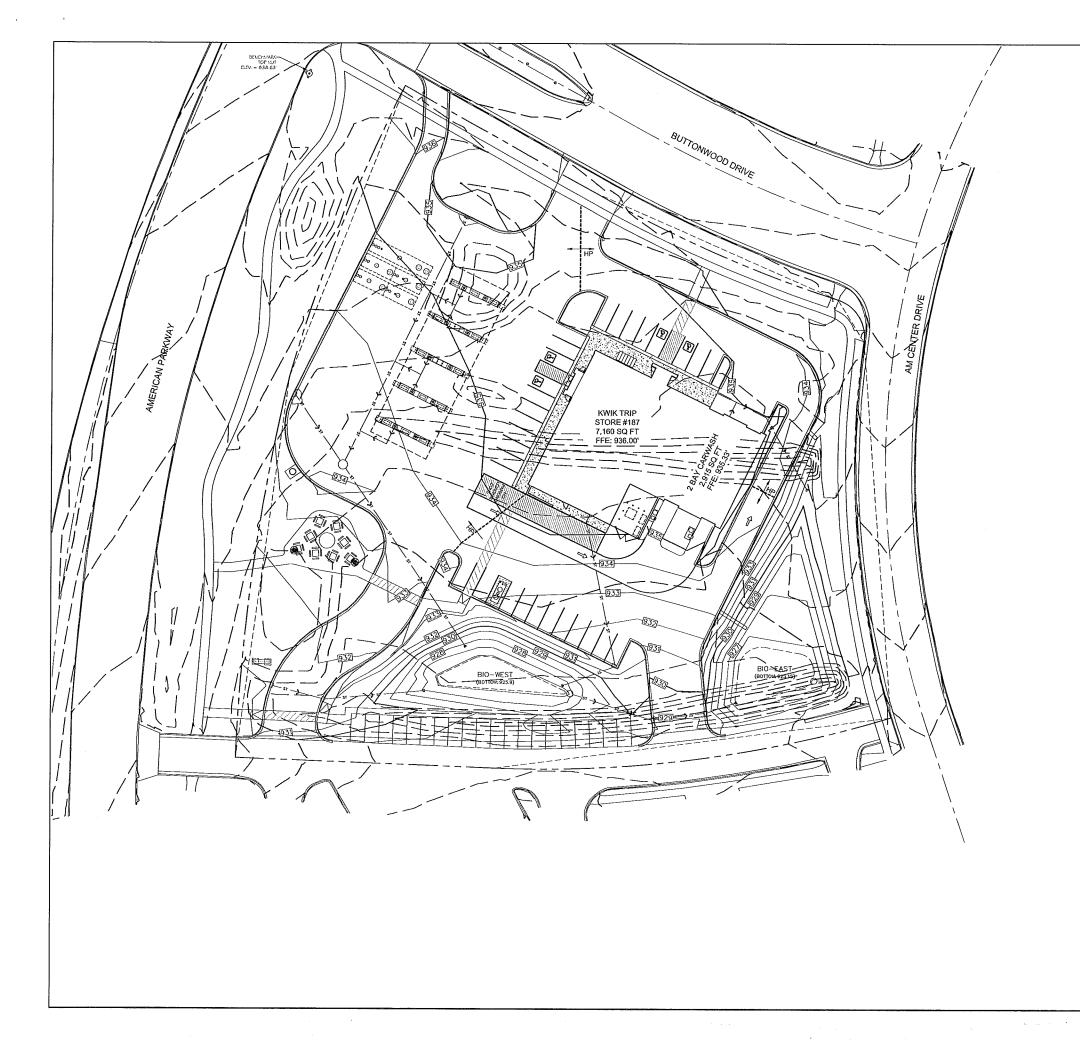

NOTE GRADING CONTRACTOR:

ANY PROPERTY IRONS THAT ARE DISTURBED IN THE GRADING PROCESS SHALL BE RESET BY A LICENSED LAND SURVEYOR AT NO ADDITIONAL COST TO THE OWNER.

PLAN NOTE

- REFER TO OTHER PROJECT PLANS AND INFORMATION RELATED TO THIS PROJECT PRIOR TO BEGINNING ANY GRADING WORK.

- PLAN PREPARED FROM AN ALTA/ASCM SURVEY BY:

SNYDER & ASSOCIATES PHONE: GO8-838-0444 DATED NOVEMBER 11, 2014

CONSTRUCTION NOTES:

-CONSTRUCTION FENCING TO BE INSTALLED AROUND ENTIRE CONSTRUCTION SITE. COORDINATE WITH OWNER FOR FENCING AND GATE LOCATIONS AND APPROPRIATE SIGNAGE INSTALLATION.

-CONTRACTOR SHALL OBTAIN AN EXCAVATION IN THE RIGHT-OF-WAY FERMIT FROM THE CITY ENGINEER PRIOR TO FERFORMING ANY WORK WITHIN THE RIGHT-OF-WAY.

- CONTRACTOR SHALL LOCATE ALL UTILITIES WHICH MAY AFFECT THIS WORK AND NOTIFY OWNER OF ANY CONFLICTS.

- CONTRACTOR SHALL VERIFY ALL EXISTING AND PROPOSED ELEVATIONS PRIOR TO START OF CONSTRUCTION. VERIFY CRITICAL ELEVATIONS TO ENSURE CONFORMANCE WITH GRADING FLAN, PARTICULARLY WITH WALK AND/ OR PAVEMENTS TO REMAIN. MEET EXISTING GRADES ALONG STREETS, PROPERTY LINES AND DRIVEWAY ENTRANCES, RESTORE ALL EXISTING PAVEMENTS THAT REWAIN TO THEIR ORIGINAL, IF NOT BETTER CONDITION. NOTIFY OWNER OF ANY CONFLICTS.

- AREAS NOT PAVED AND TO BE LANDSCAPED SHALL RECEIVE MINIMUM OF $4^{\rm s}$ DEPTH COMPACTED TOPSOIL.

- CONTRACTOR SHALL COORDINATE GRADING AND INSTALLATION OF DRIVES IN R.O.W. WITH APPROPRIATE GOVERNMENT AGENCIES. OBTAIN APPROPRIATE PERMITS FOR GRADING AND DRAINAGE IN ALL R.O.W.

- REFER TO OWNERS SPECIFICATIONS FOR CURB, APPROACH, BITUMINOUS, AND CONCRETE PROFILES, AS WELL AS ADDITIONAL SITE STANDARDS RELATED TO THIS PROJECT.

ELEVATION NOTES:

FROPOSED FINISHED FLOOR ELEV. STORE = 936.00 FEET & CAR WASH = 935.33 FEET

31014 - 338.00 1221 4 CAN WASH - 333.33 12

BENCHMARK (AS SURVEYED)
TOP NUT ON HYDRANT @ SE CORNER OF AMERICAN PARKWAY AND BUTTONWOOD AVENUE ELEVATION = 838.63 FEET



PLOTTING NOTE: PLANS PLOTTED TO 11X17
SHEET SIZE ARE 1/2 SCALE - 1"=60"



Know what's below.

Call before you dig.

WIS. STATUTE 182.0175 (1974) REQUIRES MIN. OF 3 WORK DAYS NOTICE BEFORE YOU EXCAVATE



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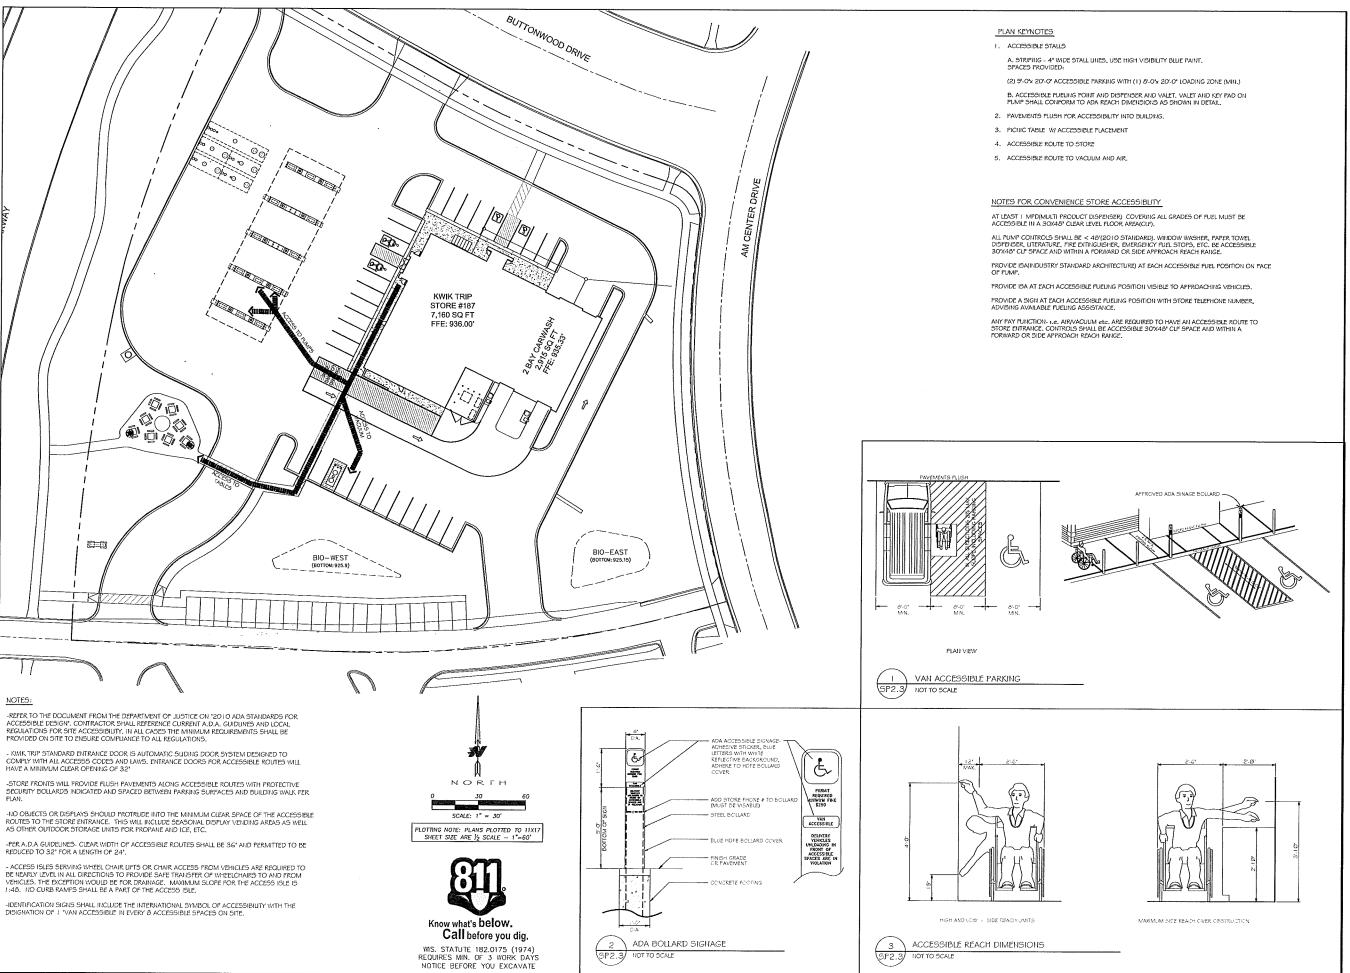


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187	> -
ONVENIENCE STORE 187	701 AMERICAN PARKWAY
NO	701

PLAN

GRADING	CONVENIE	4701 AMERIC MADISON, WISCO
NO. DATE	DESCRIPTION	
DRAWN BY		M. WAH
SCALE		1" = 30
PROJ. NO.		KTS0
DATE		3-4-1
SHEET	SP2	









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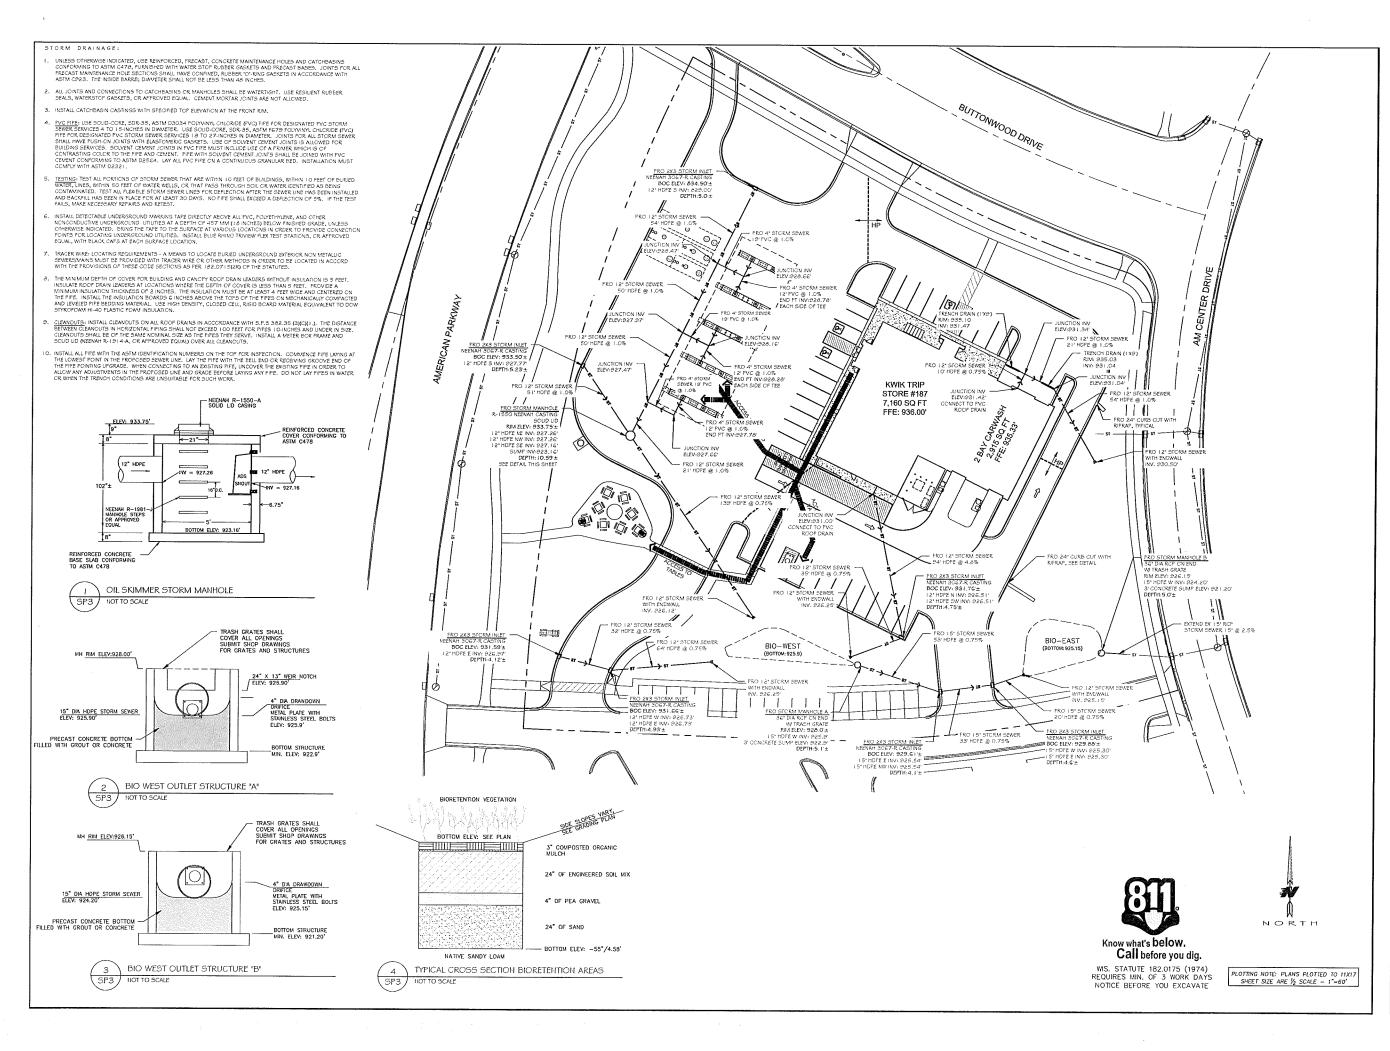


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> 187 PARKWAY 1 53718 STORE -701 AMERICAN ADISON, WISCONSIN

PLAN CONVENIENCE ACCESSIBLE

		4 ≥
NO. DATE	DESCRIPTION	
DRAWN BY		M. WAI
SCALE		1" = 3
PROJ. NO.		KTS
DATE		3-4-
SHEET	SP2.3	





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187 PLAN PARKWAY I 53718 Ш STOR SEWER ENCE 4701 AMERICAN I MADISON, WISCONSIN ONVENI Ö


NO. DATE DESCRIPTION DRAWN BY M. WAHL 1" = 30' SCALE PROJ. NO. KTS02 DATE 3-4-15

SP3

ORM

ST

SHEET

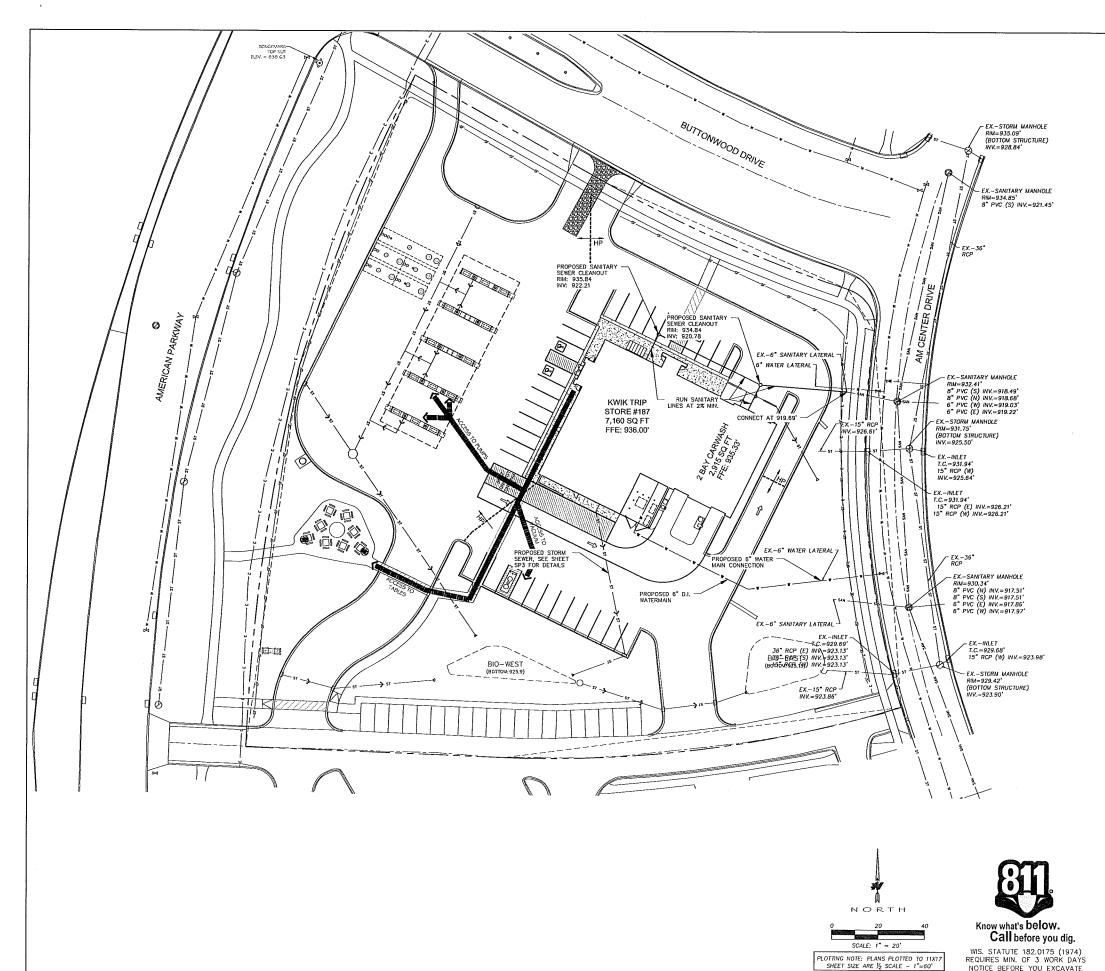

WATER DISTRIBUTION SYSTEM

- BRING ALL SITE UTILITIES TO 5' OUTSIDE OF THE BUILDING LINE WITH THE EXCEPTION OF THE WATER SERVICE. EXTEND WATER SERVICE INTO THE BUILDING AND UP TO THE FLANGE FOR THE WATER METER.
- SEPARATION OF WATER AND SEWER: PROVIDE A MINIMUM HORIZONTAL SEPARATION OF 10 FEET BETWEEN ALL WATER AND SEWER LINES. PROVIDE A MINIMUM SEPARATION OF 18 INCHES AT ALL WATER LINE AND SEWER LINE CROSSINGS.
- 3. WATERMAIN DEPTH: MANTAIN 7.5 FEET OF COVER OVER THE TOP OF THE WATER LINES TO THE FINISHED GRADE. VERIFY ELEVATION OF PROPOSED AND EXISTING WATER LINES AT ALL UTILITY CROSSINGS. INSTALL THE WATER LINES AT GREATER DEPTH'S IN ORDER TO CLEAR STORM SEWERS, SANTIARY SEWERS, OR OTHER UTILITIES AS REQUIRED. INCLIDE COSTS TO LOWER WATER LINES IN THE BASE
- 4. IESTING: PRESSURE TEST AND PERFORM BACTERIOLOGICAL TESTS ON ALL WATER LINES UNDER THE SUPERVISION OF THE CITY OF MADISON. NOTIFY THE CITY AT LEAST 24 WORKING HOURS PRIOR TO ANY TESTING. PRESSURIZE THE WATERLINE TO 1034—KPA (150—PSI) GAUGE PRESSURE (MEASURED AT THE POINT OF LOWEST ELEVATION) BY MEANS OF A PUMP CONNECTED TO THE PIPE IN A SATISFACTORY MANNER, MAINTAIN THE TEST PRESSURE FOR A MINIMUM OF 2 HOURS. DO NOT ADD WATER TO THE WATERMAIN IN ORDER TO MAINTAIN THE REQUIRED PRESSURE DURNING THE WATER MAN PRESSURE TESTING. THE TEST SECTION OF PIPE IS ACCEPTABLE WITH A PRESSURE DROP OF 14 KPA (2 PSI) OR LESS.
- 5. USE MECHANICAL JOINT RESTRAINT DEVICES FOR JOINT RESTRAINT ON ALL WATERMAIN BENDS HAYING A VERTICAL OR HORIZONTAL DEFLECTION OF 22-1/2 DEGREES OR GREATER, ALL VALVES, STUBS, EXTENSIONS, TEES, CROSSES, PLUGS, ALL HOPANT VALVES, AND ALL HYDRAINTS IN ACCORDANCE WITH CITY REQUIREMENTS. USE "SERIES 1100 MEGALUG" MANUFACTURED BY EBAA IRON INC., EASTLAND, TEMAS, DAY PROPOVED EQUAL, INSTALLED IN ACCORDANCE WITH MANUFACTURER'S RECOMMENDATIONS FOR RESTRAINT ON DUCTILE IRON PIPE.
- 6. AT ALL VALVE LOCATIONS WHICH REQUIRE A 12" OR SMALLER VALVE, INSTALL GATE VALVES WHICH ARE OF THE COMPRESSION RESILIENT SEATED (CRS) TYPE. USE AMERICAN FLOW CONTROL'S SERIES 2500 DUCTILE IRON RESILIENT WEDGE CATE VALVE, OR APPROVED EOUAL. GATE VALVES SHALL CONFORM TO AWAR C509. INSTALL CAST IRON VALVE BOXES CONFORMING TO ASTM A88 AT EACH VALVE LOCATION. VALVE BOXES SHALL BE THE THEEP—FIECE TYPE WITH 5-1/4" SHAPTS. USE TYLER 6860-G WITH NO. 6 BASE, OR EQUIVALENT. VALVE BOXES SHALL HAVE AT LEAST 6" OF ADJUSTMENT ABOVE AND BELOW FINISHED GRADE. DROP COVERS ON VALVE BOXES SHALL BE ROUND AND BEAR THE WORD "WATER" CAST ON THE TOP. USE TYLER 6860-G "STAYPUT" COVERS WITH EXTENDED SKIRT, OR EQUIVALENT.
- USE MUELLER H 10300 OR FORD EM 2 7057, OR APPROVED EQUAL, AT ALL CURE STOP LOCATIONS. STATIONARY ROD IS REQUIRED ON ALL CURB STOPS.
- POLYMIN'L CHLORIDE (PVC) BUILDING WATER SERVICES: ASTM D2241 OR ASTM D1785; PRESSURE RATED FOR WATER.
- 9. POLYMINI CHIORIDE (PVC) WATERMAIN: USE AWWA C900 FOR ALL PVC WATERMAIN FURNISHED WITH INTEGRAL ELASTOMERIC BELL AND SPIGOT JOINTS; MINIMUM PRESSURE CLASS 150; DIMENSION RATIO NOT GREATER THAN 18: L'AYING LENGTH PROPER OF TELL USE EPAA RON, INC., SERIES 2000 PV MEGALUG, OR APPROVED EQUAL FOR RESIRANT ON C900 PVC WATERMAIN. LAY TRACE WIRE WITH ALL C900
- 10. TRACER WIRE: LOCATING REQUIREMENTS A MEANS TO LOCATE BURIED UNDERGROUND EXTERIOR NON METALLIC SEWERS/MANIS MUST BE PROVIDED WITH TRACER WIRE OR OTHER METHODS IN ORDER TO BE LOCATED IN ACCORD WITH THE PROVISIONS OF THE WISCOISIN STATUTES 182.0175(2R) AND THE WISCOISIN DEPARTMENT OF COMMERCE COMM BZ.0(11)(H).
- 11. WHERE EXISTING CAS, ELECTRIC, CABLE, OR TELEPHONE UTILITIES CONFLICT WITH THE WORK, COORDINATE THE ABANDONMENT, RELOCATION, OFFSET, OR SUPPORT OF THE EXISTING UTILITIES WITH THE APPROPRIATE LOCAL UTILITY COMPANIES, COORDINATE NEW GAS METER AND GAS LINE INSTALLATION, ELECTRIC METER AND ELECTRIC SERVICE INSTALLATION, CABLE SERVICE, AND TELEPHONE SERVICE INSTALLATION WITH THE LOCAL UTILITY COMPANIES.
- 12. COORDINATE BUILDING UTILITY CONNECTION LOCATIONS AT 5 FT. OUT FROM THE PROPOSED BUILDING WITH THE WITH THE INTERIOR PLUMBING CONTRACTOR PRIOR TO CONSTRUCTION. VERIFY WATER AND SEWER SERVICE LOCATIONS AND ELEVATIONS WITH THE MECHANICAL ENGINEER PRIOR TO CONSTRUCTION.
- 13. THE LOCATIONS OF EXISTING UTILITIES SHOWN ON THIS PLAN ARE FROM RECORD INFORMATION. THE ENGINEER DOES NOT GUARANTEE THAT ALL ENSTRING UTILITIES ARE SHOWN OR, IF SHOWN, EXIST IN THE LOCATIONS WIDICATED ON THE PLAN. IT IS THE CONTRACTOR'S RESPONSIBILITY TO ASCERTAIN THE FINAL VERTICAL AND HORIZONTAL LOCATION OF ALL EXISTING UTILITIES (INCLUDING WATER AND SEWER LINES AND APPURIEWANCES). NOTIFY THE ENGINEER OF ANY OISCREPANCIES

SANITARY SEWER:

- 1. PIPE: USE SOUD-CORE, SDR-35, ASTM D3034 (OR APPROVED EQUAL) POLYMINI. CHIORIDE (PVC) PLASTIC PIPE FOR ALL DESIGNATED PVC SANITARY SEWER SERVICES. JOINTS FOR ALL SANITARY SEWER SHALL HAVE PUSH-ON JOINTS INTO HELP STOMERIC GASKETS. USE OF SOLVENT CEMENT JOINTS IS ALLOWED FOR BUILDING SERVICES. SOLVENT CEMENT JOINTS IN PVC PIPE MUST INCLUDE USE OF A PRIMER WHICH IS OF CONTRASTING COLOR TO THE PIPE AND CEMENT. PIPE WITH SOLVENT CEMENT JOINTS SHALL BE JOINED WITH PVC CEMENT CONFORMING TO ASTM D2554. LAY ALL PVC PIPE ON A CONTINUOUS GRAHULAR BED. INSTALLATION MUST COMPLY WITH ASTM D2321.
- CLEANOUTS: INSTALL CLEANOUTS ON ALL SANITARY SEWER SERVICES. THE
 DISTANCE BETWEEN CLEANOUTS IN HORIZONTAL PIPING SHALL NOT EXCEED 100
 FEET FOR PIPES 4-INCH AND OVER IN SIZE. CLEANOUTS SHALL BE OF THE SAME
 NOMINAL SIZE AS THE PIPES THEY SERVE. INCLUDE FROST SLEEVES AND
 CONCRETE FRAME AND PIPE SUPPORT. INSTALL A METER BOX FRAME AND SOLID
 LID (NEENAH R-1914-A, OR APPROVED EQUAL) OVER ALL CLEANOUTS.
- 3. TESTING: PRESSURE TEST ALL SANITARY SEWER LINES. TEST ALL FLEXIBLE SANITARY SEWER LINES FOR DEFLECTION AFTER THE SEWER LINE HAS BEEN INSTALLED AND BACKFILL HAS BEEN IN PLACE FOR AT LEAST 30 DAYS. NO PIPE SHALL EXCEED A DEFLECTION OF 5%. IF THE TEST FAILS, MAKE RECESSARY REPAIRS AND RETEST.
- 4. UNLESS OTHERWISE INDICATED, USE REINFORCED, PRECAST, CONCRETE MAINTENANCE HOLES CONFORMING TO ASTM C478, FURNISHED WITH PRECAST BASES. SANITARY SEWER MAINTENANCE HOLES SHALL BE SUPPLIED WITH PRE-FORMED INVERTS AND FLEXIBLE NEOPRENE SLEEVE CONNECTIONS FOR ALL LATERAL LITES 375 MM (15 INCHES) IN DIAMETER OR LESS. UNLESS OTHERWISE INDICATED. JOINTS FOR ALL PRECAST MAINTENANCE HOLE SECTIONS SHALL HAVE CONFINED, RUBBER "O"-RING CASKETS IN ACCORDANCE WITH ASTM C323. THE INSIDE BARREL DIAMETER SHALL NOT BE LESS THAM 46 INCHES.
- INSTALL FLEXIBLE WATERTIGHT FRAME/CHIMNEY SEALS ON ALL SANITARY SEWER MAINTENANCE HOLES. USE EITHER MANUFACTURED MAINTENANCE HOLE FRAME/CHIMNEY SEALS OR ELASTOMERIC WATERPROOFING FRAME/CHIMNEY SEALS.
- USE NEENAH FOUNDRY CO. R-1642 CASTING WITH SELF-SEALING, SOULD, TYPE B LID, OR APPROVED EQUAL, ON ALL SANITARY SEWER MAINTENANCE HOLES. COVERS SHALL BEAR THE "SANITARY SEWER" LABEL.
- 7. THE MINIMUM DEPTH OF COVER FOR SANITARY SEWER WITHOUT INSULATION IS 5
 FEET. INSULATE SANITARY SEWER SERVICES AT LOCATIONS WHERE THE DEPTH OF
 COVER IS LESS THAN 5 FEET. PROVIDE A MINIMUM INSULATION THICKNESS OF 2
 INCHES. THE INSULATION MUST BE AT LEAST 4 FEET WIDE AND CENTERED ON THE
 PIPE. INSTALL THE INSULATION BOARDS 6 INCHES ABOVE THE FOPS OF THE PIPES
 ON MECHANICALLY COMPACTED AND LEVELED PIPE BEDDING MATERIAL USE HIGH
 DENSITY, CLOSED CELL RIGID BOARD MATERIAL EQUIVALENT TO DOW STYROFOAM
 HI-40 PLASTIC FOAM INSULATION.
- 8. TRACER WIRE: LOCATING REQUIREMENTS A MEANS TO LOCATE BURIED UNDERGROUND EXTERIOR NON METALLIC SEVERS/MAINS MUST BE PROVIDED WITH TRACER WIRE OR OTHER METHODS IN ORDER TO BE LOCATED III ACCORD WITH THE PROVISIONS OF THE WISCONSIN STATUTES 182.0175(2R) AND THE WISCONSIN DEPARTMENT OF COMMERCE COMM 82.30(11)(H).



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CONVENIENCE


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4701 AMERICAN I

MADISON, WISCONSIN

NO. DATE	DESCRIPTION	
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DRAWN BY		M. WAH
SCALE		1" = 20
PROJ. NO.		KTS0
DATE		3-4-1
SHEET	SP4	

PLAN

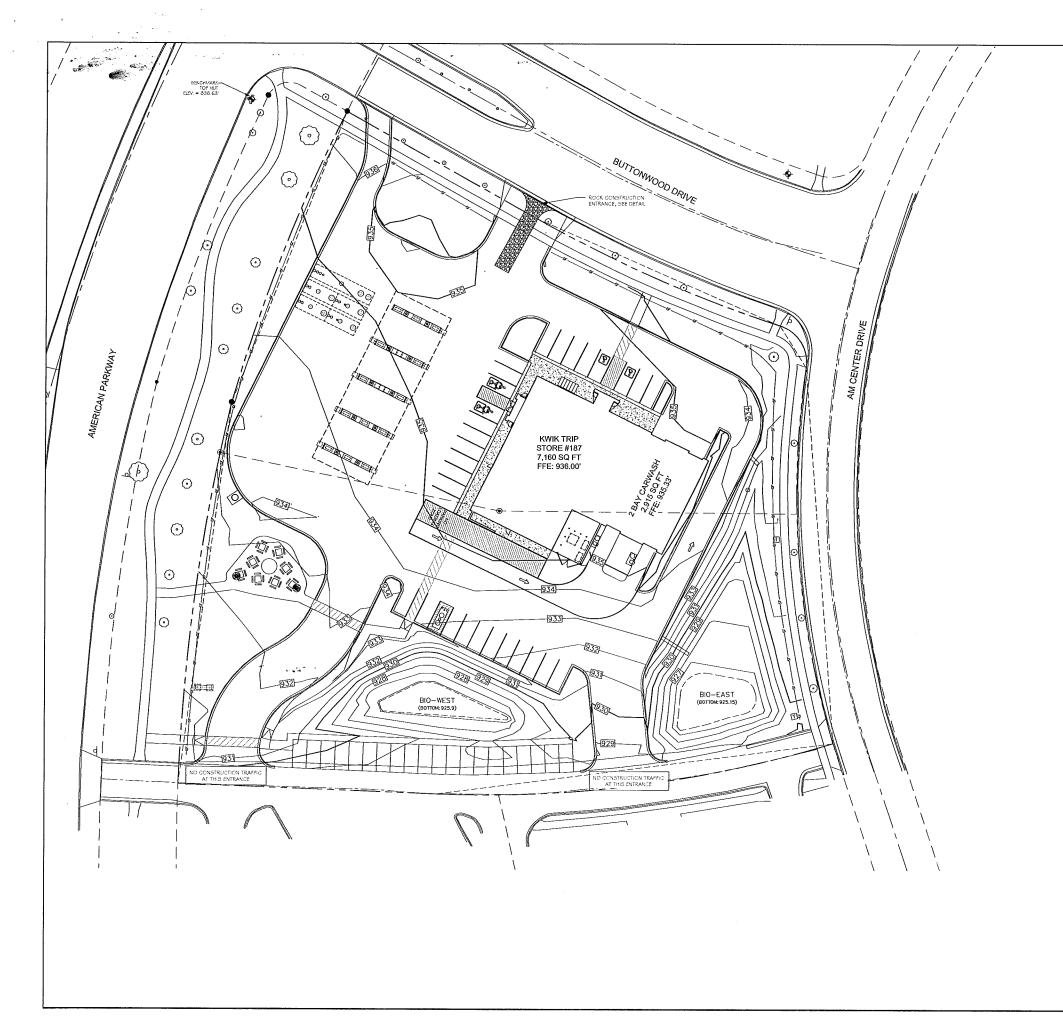

-ALL SILT FENCE MUST BE INSTALLED BY THE CONTRACTOR AND INSPECTED BY THE CITY FRICK TO AMY SITE WORK.

-SITE EROSION CONTROL MEASURES MUST BE IN FLACE AT ALL TIMES. SHOULD DEVICES BE REMOVED FOR WORK ACCESS, THEY SHALL BE RENGSTALLED AT THE BUT OF EACH WORK DAY UNTIL FAVENENTS HAVE EER IN STALLED AND ALL ANDSCAFE AREAS HAVE BEEN MULCHED AND LOSDODED. SEEDED AREAS MUST EXHIBIT MINIMUM OF 70% SOIL COVERAGE.

-REFER TO THE SWFFP PLAN NOTES AND DETAIL SHEETS $\underline{\text{SWFFP2.4}}$ FOR MORE INFORMATION.

CONTACT BRAD FRY KMK TRIP, INC FO BOX 2107 LACROSSE, WI 54602 608-783-8020

CONSTRUCTION SEQUENCE

INSTALL EROSION/SEDIMENT CONTROL MEASURES

*INSTALL STORMWATER MANAGEMENT SEGMENT BASINS

*INSTALL STORM SEWER

*INSTALL STRUCTURES

*INSTALL PAVEMENTS

*INSTALL LAWNY LANDSCAFE

"FLUSH STORM SEWER

*REMOVE EROSION CONTROL MEASURES ONLY AFTER ALL PAVEMENTS HAVE BEEN INSTALLED AND ALL SOILS HAVE BEEN STABIUZED

PROJECT DATA

SITE AREA DATA
DISTURBED AREA
FRE-CONSTRUCTION IMPERVIOUS AREA
POST-CONSTRUCTION IMPERVIOUS AREA
AFFROX, AREA OF LAND DISTURBANCE

??? 5F ??? 5F ??? 5F 100%

SOIL DATA SURFACE SOIL

CONCRETE W/ GRAVEL BASE OVER FILL

ESTIMATED PRELIMINARY EROSIONI CONTROL QUAVITITES (ACTUAL QUANTITIES SUBJECT TO CHANGE)			
ITEM	QUANTITY		
ROCK CONSTRUCTION ENTRANCE	??? 5Q,YD,		
EROSION CONTROL BLANKET (BASIN)	AS NEEDED		
RIF RAP	77?		
SILT FENCE	797 L.F.		

NOTE: FOR MAINTENANCE FURPOSES CONTRACTOR SHALL ALL SUPFICIENT GUANTITIES FOR REPAIR AND REFLACEMENT OF EROSION CONTROL DEVICES THROUGHOUT ALL PHASES OF THE PROJECTS CONSTRUCTION.



SCALE: 1" = 20'

PLOTTING NOTE: PLANS PLOTTED TO 11X17 SHEET SIZE ARE ½ SCALE - 1"=60"



Know what's below. Call before you dig.

WIS. STATUTE 182.0175 (1974) REQUIRES MIN. OF 3 WORK DAYS NOTICE BEFORE YOU EXCAVATE



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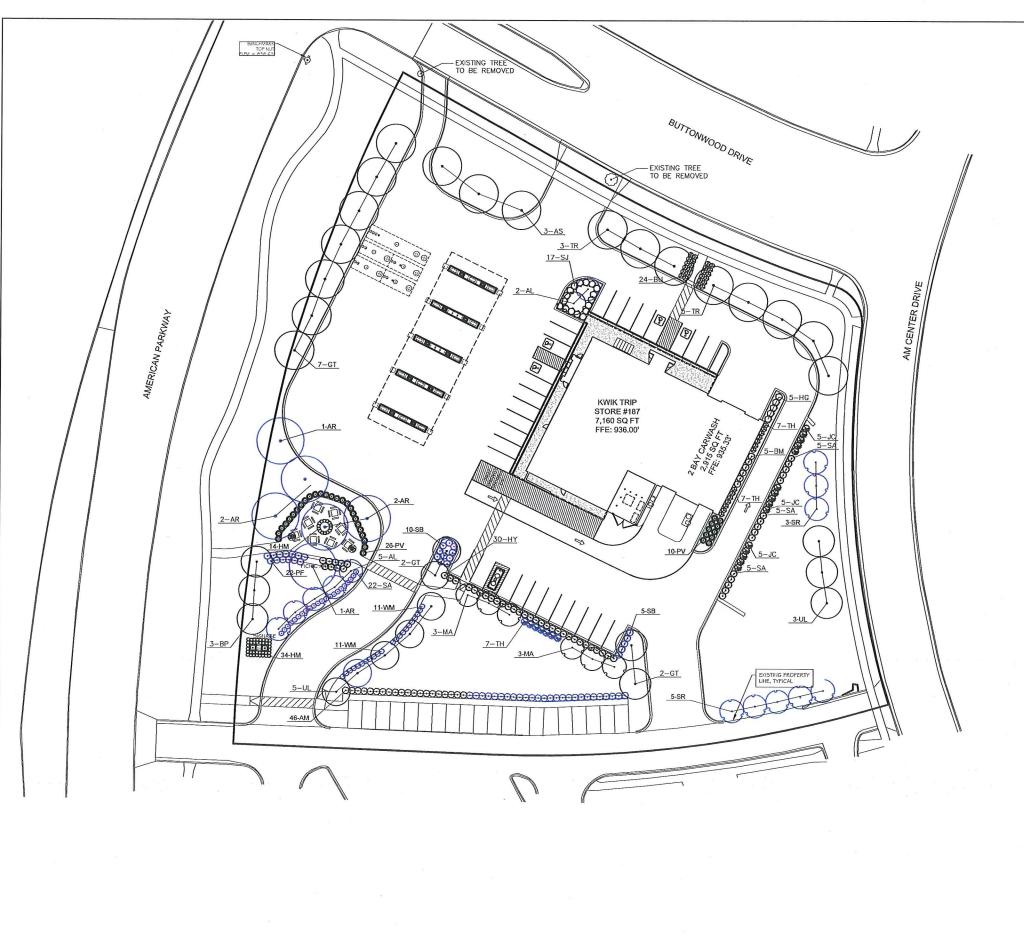


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> 187 PARKWAY 1 53718 STORE 701 AMERICAN PADISON, WISCONSIN ONVENIENCE

ROSION CONTROL PLAN

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NO. DATE	DESCRIPTION	
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	-	
DRAWN BY		M. WAHL
SCALE		1" = 30'
PROJ. NO.		KTS02
DATE		3-4-15
SHEET	SWP1	





	QTY	KEY	BOTANICAL NAME	COMMON NAME	SIZE	COMMENTS
TREES	6	AR	Acer rutrum Brandywine'	BRANDYWINE MAPLE	212	B&B
	3	AS	Acer saccharum Endownent	ENDOYMENT SUGAR MAPLE	212"	888
	7	AL	Arrelandier laevis	ALLEGANY SERVICEBERRY	6° HT.	888
	3	BP	Betula papyrifera	PAPER BIRCH	212	888
	11	GT	Ged tisis tracardhos var. inertris Imperial	STREET KEEPER HONEYLOCUST	212"	888
	6	HA	Malus 'Adams'	ADAMS CRABAPPLE	1 1/2"	848
	8	SR	Syringa refoulata thory SIK'	IVORY SILK JAPANESE TREE LILAC	6' HT.	888
	21	TH	Thuja cocidentalis Holmstup*	HOLMSTRUP ARBORVITAE	6' HT.	688
	8	TR	Tila Greenspire'	GREENSPIRE LINDEN	2 1/2"	683
	8	UL	Ulmus New Horizon'	NEW HORIZON ELM	2 1/2	883
	45	M	Aronia melanocaroa Worton'	IROQUOIS BEAUTY BLACK CHOKEBERRY	24" HL	\$3 GAL (4" O.C.
	24	BU	Bass x Green Velvet	GREEN VELVET BOXWOOD	16" HL	#364L(30.C)
	30	HY	Hydranosa paniculata 'Jane'	LITTLE LIME HYDRANGEA	24" HL	#3 G4L (# O.C.)
	15	JC	Juniperus chinensis 'Old Gold'	OLD GOLD JUNPER	24° Ht.	#3 GAL (# O.C.)
SE	22	PF	Potentilla frutcosa 'Jackmani'	JACKMAN POTENTILLA	24" HL	#3 G4L (4' O.C.
SHRUBS	15	98	Soireaa betut tala 'Tor'	TOR BIRCHLEAF SPIREA	16" Ht.	#3 GAL (4 O.C.)
L'S	37	SA	Spirasa bulmakta 'Arthony Waterer'	ANTHONY WATERER SPIREA	24" Ht.	#3 GAL (# O.C.)
	17	SJ	Spirzea japonica 'Goldmound'	GOLDMOUND JAPANESE SPIREA	18"Ht	#3 GAL (4 O.C.)
	22	kM.	Yieigela Minuet	MNUET NEGELA	18" HL	43 GAL (3" O.C.
	5	BM	Baotsia Widnisht FP 2X432	MICNIGHT FALSE INDIGO 'PRAREBLUES'	24" Ht.	#1 GAL (4' D.C.)
SS	48	НМ	Herrerocalis Yigity Chestrut	MIGHTY CHESTNUT DAYLLY	12" Ht.	#1 G4L (2 0.C.)
N SE	5	HC	Hosta 'Guazamole'	QUACAMOLE HOSTA	12" Ht.	#1 GAL (4' D.C.)
GRASSES & PERENNIALS	36	PV	Panioum vigatum Prairie Fre*	PRAIRIE FIRE SWITCH GRASS	24" HL	#1 G4L (#'0.C.)
*	5	EXPUT	OVERSTORY TREE (FRONTAGE REQUIREMENT)			
EXISTING PLANT MATERIAL						
ANTIN	-					
NG PL						
EXIST					_	

PLANTING PLAN REQUIREMENTS

TOTAL DEVELOPED AREA
TOTAL AREA: 136,420 SQ. FT.
REQUIREMENT: 136,420 SQ. FT.
REQUIREMENT: 136,420 SQ. FT.
(2312 PROVIDED)
EXISTING PLANT MATERIAL. ON SITE: 210 PTS.
LANDSCAPE FURNITURE: 32 SEATS X 5 = 180 OR 5% OF TOTAL POINTS = 114
(114 PROVIDED)
PROPOSED PLANT MATERIAL: 1988 PTS.

STREET FRONTAGES LINEAR FEET: 539 LF REQUIREMENT: 1 TREE AND 5 SHRUBS/30 LF REQUIRED: 18 TREES (5 - EXISTING) AND 90 SHRUBS (130 PROVIDED)

INTERIOR PARKING LOT LANDSCAPING
TOTAL STALLS: 38
REQUIREMENT: 8% OF TOTAL PARKING LOT AREA TO BE INTERIOR PLANTING AREA
79,097 SF OF PARKING LOT X 8% = 6,328 SF DIV. 160 SF = 40 TREES REQUIRED (41 PRO

AMERICAN CENTER CANOPY TREE REQUIREMENTS
TOTAL STALLS: 50
REQUIREMENT: 1 TREE PER 12 STALLS OR FRACTION THEREOF
REQUIRED: 4 TREES (4 PROVIDED)

AMERICAN CENTER LANDSCAPE REQUIREMENTS TOTAL STALLS: 50 REQUIREMENT: 15 POINTS/STALL = 15 X 50 = 750 POINTS REQUIRED (751 PROVIDED)

TWO EXISTING TREES WITH AN APPROXIMATE 2" CALIPER SHALL BE REMOVED DURING CONSTRUCTION AND ARE NOTED ON THE DEMOLITION PLAN. TWO (2) 2 1/2" CALIPER TREES ARE PROPOSED ON THE LANDSCAPE PLAN TO REPLACE THESE EXISTING TREES. NO POINTS HAVE BEEN ADDED TO THE POINTS FOR THE AMERICAN CENTER REQUIREMENTS OR THE CITY OF MADISON REQUIREMENTS.

- SEED ALL OTHER AREA'S DISTURBED FROM CONSTRUCTION WITH GRASS SEED MIX IN ACCORDANCE WITH PROPOSED EROSION CONTROL PLAY; UNLESS, OTHERWISE NOTED.
- PLANTING BEDS TO BE MULCHED WITH SHREDDED BARK OR STONES PER THE OWNER'S INSTRUCTION



SCALE: 1" = 30'

PLOTTING NOTE: PLANS PLOTTED TO 11X17 SHEET SIZE ARE ½ SCALE — 1"=60'



Know what's below. Call before you dig.

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REQUIRES MIN. OF 3 WORK DAYS
NOTICE BEFORE YOU EXCAVATE



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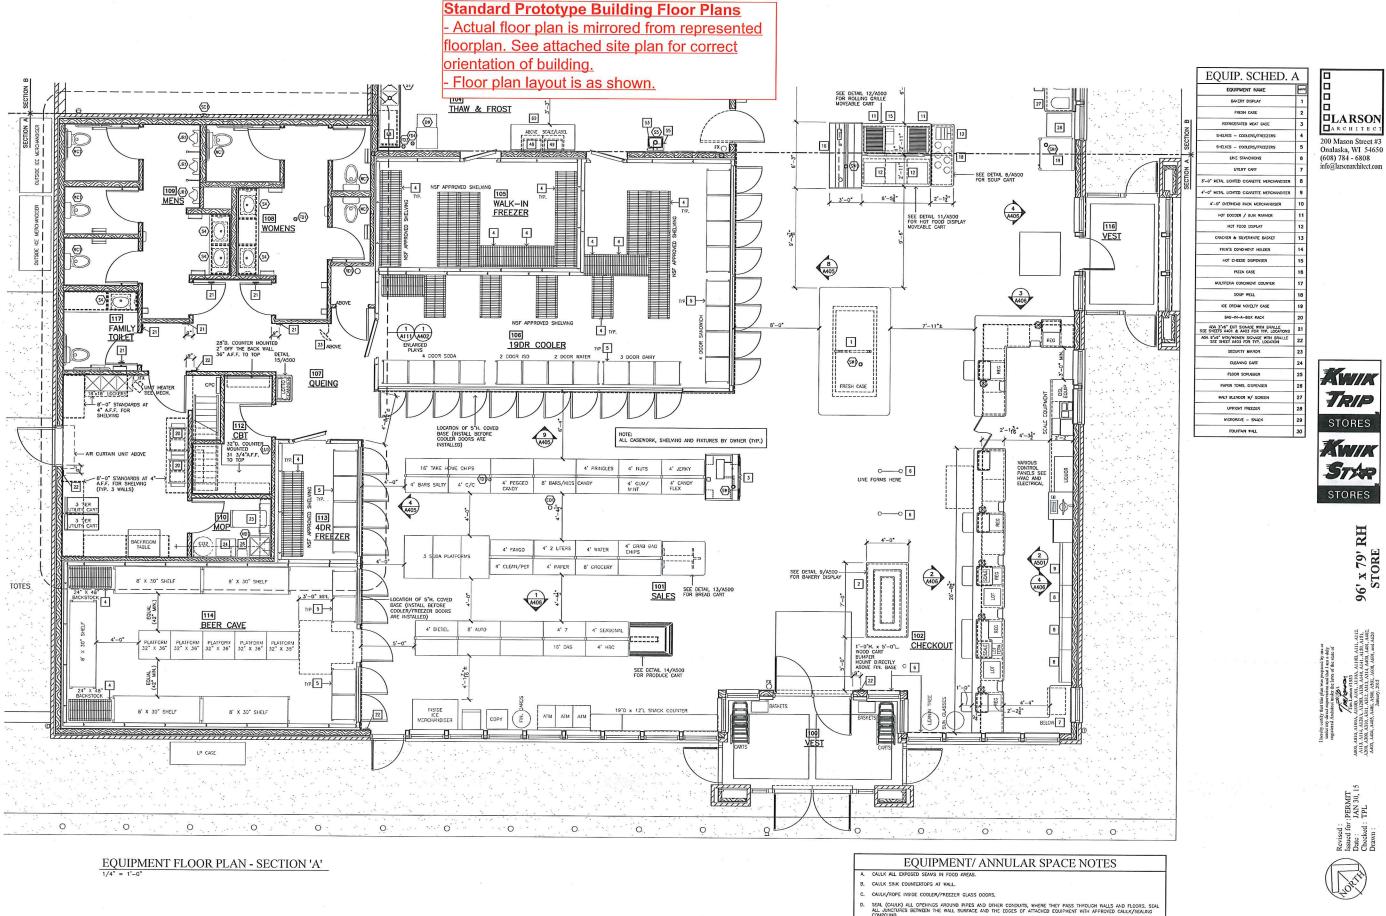
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187 STORE PLAN

701 AMERICAN PARKWAY ADISON, WISCONSIN 53718 CONVENIENCE

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NO. DATE	DESCRIPTION	
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DRAWN BY		M. WAHL
SCALE		1" = 30'
PROJ. NO.	KTS02	
DATE		
SHEET	L1	

LANDSCAPING




A120A

EXTEND CONDUIT PIPES FOR BEVERAGE LINES AT LEAST FOUR INCHES ABOVE THE FINISHED FLOOR ELEVATION AT BOTH ENDS. THE SPACE BETTEEN THE BEVERAGE LINES AND THE CONDUIT PIPE MUST BE SEALED WITH A HARD MATERIAL AND PROVIDE A CLEMARIFE FINISH.

Standard Prototype Building Floor Plans

- Actual floor plan is mirrored from represented floorplan. See attached site plan for correct orientation of building.

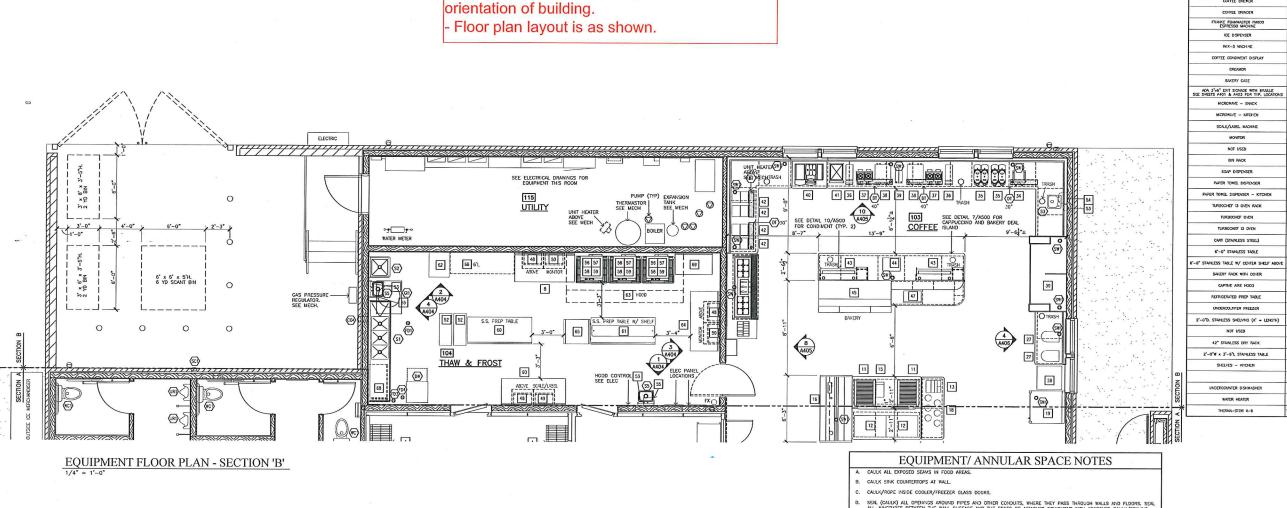

- SEAL (CADLY) ALL OPENINGS AROUND PIPES AND OTHER CONDUITS, WHERE THEY PASS THROUGH WALLS AND FLOORS
 ALL JUNCTURES BETWEEN THE WALL SURFACE AND THE EDGES OF ATTACHED EQUIPMENT WITH APPROVED CAULK/SEAL
 COMPOUND.
- ENDS. THE SPACE BETWEEN THE BEVERAGE LINES AND THE CONDUIT PIPE MUST BE SEALED WITH A HARD MATERIAL PROVIDE A CLEMARIE FUNCH.



EQUIP. SCHED. B

200 Mason Street #3 Onalaska, WI 54650 (608) 784 - 6808 info@larsonarchitect.com




96' x 79' RH STORE


I biseriey cenity that that ghan was prepared by me or under my direct supervision and last fram a day replaced Abrillottic under the farm of the cate of the properties of th



A120B

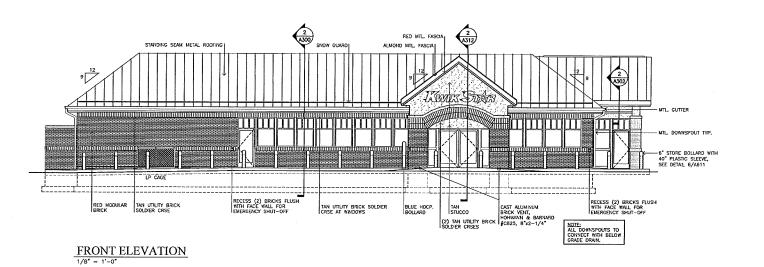



RIGHT SIDE ELEVATION

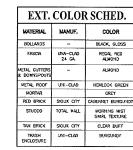




200 Mason Street #3 Onalaska, WI 54650 (608) 784 - 6808 info@larsonarchitect.com

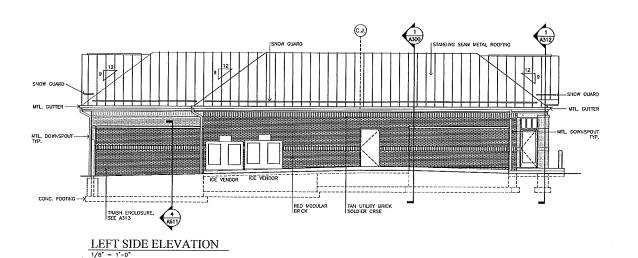

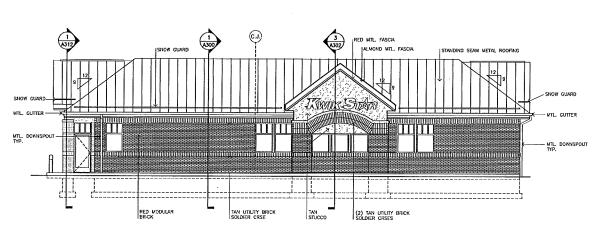



96' x 79' RH STORE

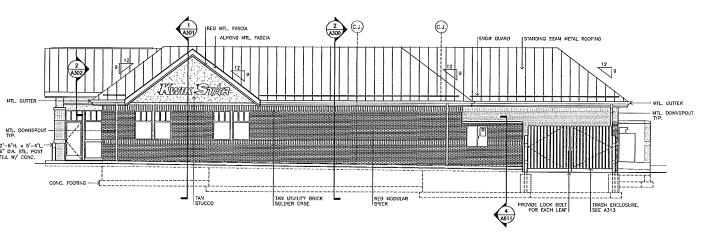

BACK ELEVATION

A200









Flat Canopy w/ Brick

10 MPD

