

## Madison Landmarks Commission **APPLICATION**

City of Madison Planning Division

215 Martin Luther King Jr. Blvd. | Room LL.100 | P.O. Box 2985 | Madison, WI 53701-2985

1. LOCATION			
Project Address: 3414 Manu	ROE ST.	Aldermanic Dist	rict: 13
2. PROJECT		Date Submitted:	2.9.15
Project Title / Description:	ILEN, NEW	MIXED-USE	BUILDING.
This is an application for: (check all that apply	v)		
☐ Alteration / Addition to a Designa	ated Madison Landmark		
Alteration / Addition to a building	g adjacent to a Designated	d Madison Landmark	
☐ Alteration / Addition to a building	g in a Local Historic Distric	ct (specify):	
□ Mansion Hill	☐ Third Lake Ridge	☐ First Settlement	
□ University Heights	☐ Marquette Bungalo	ws	
☐ New Construction in a Local Histo	oric District (specify):		
□ Mansion Hill	☐ Third Lake Ridge	☐ First Settler	ment
□ University Heights	☐ Marquette Bungalo	ws	
Demolition			
☐ Variance from the Landmarks Or	dinance		
☐ Referral from Common Council, F	Plan Commission, or other	referral	
□ Other (specify):			
3. APPLICANT			
Applicant's Name: Park Cutta	Company:	CaSA And	405-7710-
Address: 3414 Monroe ST.	City/State:	12015 ON WI	Zip: 53711
Telephone: (28-709-1250	E-mail:	ol e castarch	.com.
	zick Concolex	al.	
Address: 2417 UNIVOLSITY A	City/State: 🔽	LADISON, WI	Zip: <u>5372 (</u>
Property Owner's Signature:	10	Date:	2/9/15

#### GENERAL SUBMITTAL REQUIREMENTS

Twelve (12) collated paper copies and electronic (.pdf) files of the following: (Note the filing deadline is 4:30 PM on the filing day)

- Application
- Brief narrative description of the project
- Scaled plan set reduced to 11" x 17" or smaller pages. Please include:
- Site plan showing all property lines and structures
- Building elevations, plans and other drawings as needed to illustrate the project
- Photos of existing house/building
- Contextual information (such as photos) of surrounding properties

Questions? Please contact the Historic Preservation Planner:

Amy Scanlon

Phone: 608.266.6552

Email: ascanlon@cityofmadison.com

Any other information that may be helpful in communicating the details of the project and how it complies with the Landmarks Ordinance, including the impacts on existing structures on the site or on nearby properties.

NOTICE REGARDING LOBBYING ORDINANCE: If you are seeking approval of a development that has over 40,000 square feet of non-residential space, or a residential development of over 10 dwelling units, or if you are seeking assistance from the City with a value of \$10,000 (including grants, loans, TIF or similar assistance), then you likely are subject to Madison's lobbying ordinance (Sec. 2.40, MGO). You are required to register and report your lobbying. Please consult the City Clerk's Office for more information. Failure to comply with the lobbying ordinance may result in fines.

#### Project Narrative - Landmarks Commission Submittal

The Glen is a proposed new mixed-use project located at 3414 Monroe Street. It is comprised of 41,038 gross square feet (based on new Madison Zoning standards) on five levels including limited commercial space, support space at level one, below grade parking for residents and at grade parking for the commercial space. Levels two, three and four provide a total of 19 rental residential units including a mix of studio, one, two, and three bedroom units. All units with the exception of two studio units have exterior space in the form of a balcony or terrace and have been designed to maximize views to the adjoining amenities while trying to respect sensitive adjacencies. The two studio units have french balconies plus a small common space with an exterior terrace is provided for all residents on level four. In addition to the commercial space and residential entry, the main level includes 9 parking spaces, 9 exterior bicycle parking spaces, 4 exterior moped parking spaces. There are 21 automobile parking spaces and 16 bicycle parking spaces provided in the lower level. The project also provides a bicycle repair station and a dog water station along Glenway Street to provide community convenience and benefit to the many neighbors passing by this active corner.

The site is zoned TSS (Traditional Shopping Street District). The proposed design is in compliance with the prescribed City zoning requirements and the adopted neighborhood development plan. It will require a conditional use approval as it proposes below grade parking combined with an allowable 4<sup>th</sup> story and resulting increase in square footage. The design is the direct result of site responsive design informed by community concerns shared with the design team in previous neighborhood and City meetings. Several concerns addressed include but were not limited to looking at providing more setback along the East side, the breakdown of scale to avoid the perceived "big dumb box feel" of the neighboring development project, sensitivity to the pedestrian experience along the street, scale and massing stepping back at the SE corner of the site to help preserve views of the adjoining property, material palette compatibility, parking / traffic concerns and sustainability.

The architectural solution for the Glen is composed of a series of wood clad forms highlighted with details of natural plaster. These forms are supported by a masonry base that is eroded along the street scape, allowing the forms above to float over the commercial space. The step back at the first floor allows the building to present an improved pedestrian experience along the sidewalk while also improving street level views. The wood forms are modulated and scaled to transition to the single family residential scale ascending Glenway's streetscape as well as the adjoining neighbors. The wood forms are articulated with a combination of large windows and natural plaster elements that step back to help articulate the massing. The forth level is set back on all for sides as it caps the building as a plaster clad form. Usable exterior space is provided four the residential units via balconies and terraces which are located and designed to maximize the views to the adjoining arboretum while trying to minimize impact on immediate neighbors. The building form is purposefully setback from the East and North property lines to help mitigate impact on adjoining neighbors. Extensive (tray system) green roofs are provided at the building step-backs/terraces. The primary materials of masonry, wood, and plaster are purposely used and executed in the composition to be respectful of the neighborhood and adjoining properties while striving to represent a building of the period and continued evolution of our neighborhoods, city and its rich history.

## the GLEN – 3414 Monroe Street

## Materials - Landmarks Commission Submittal

Plaster | Cedar

Masonry



Structural Engineering:

**ECHELON STRUCTURES, LLC** 

1521 Sunset Ct. Middleton, WI 53562

Civil Engineering/Landscape Architecture:

SAA DESIGN GROUP, INC.

101 Fast Badger Rd

DESIGN GROUP #2573

The Glen by Patrick Properties

3414 Monroe Street Madison, WI 53711

Project #: 13002.00

**Plan Commission Submittal** 


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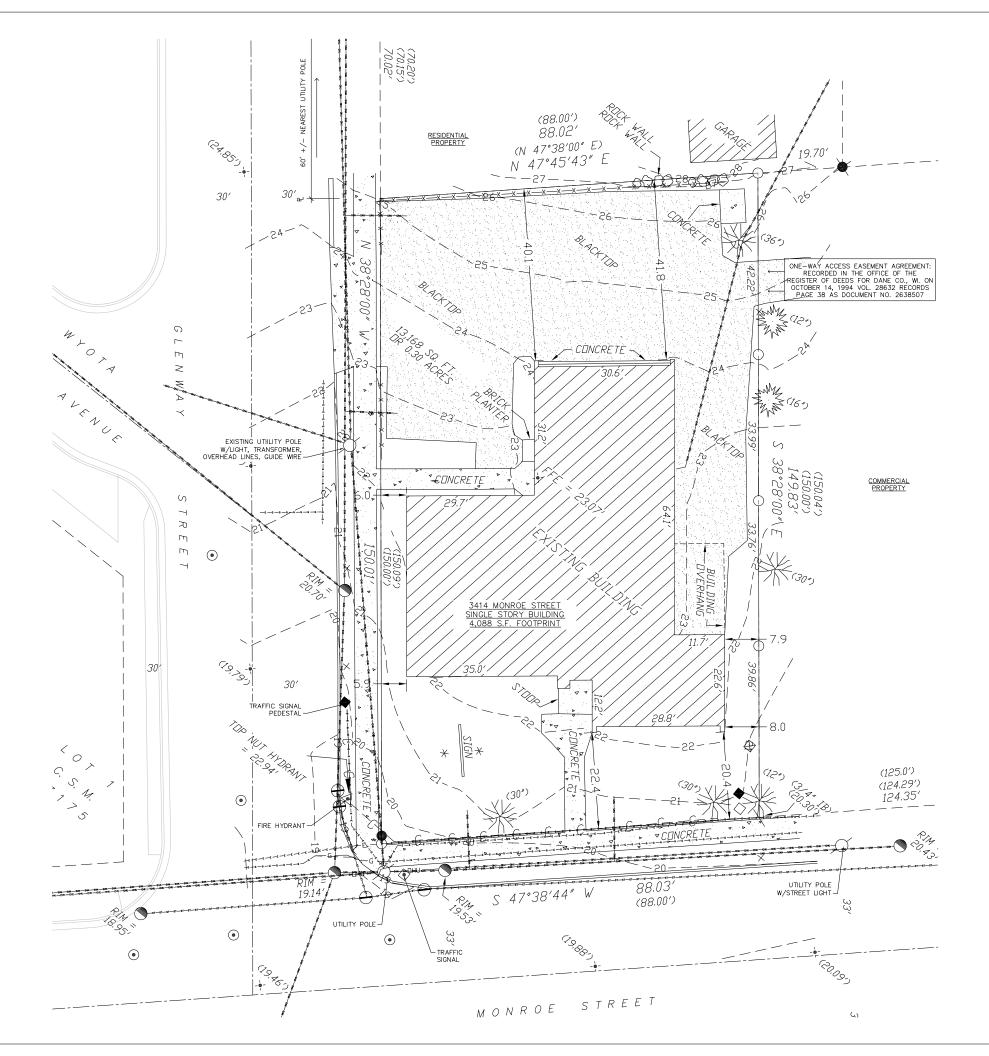
No.	Description	Date
01	MGE EVALUATION	8-28-20

Drawn by: AW Checked by: SAA Design Group, Inc.

**EXISTING CONDITIONS** PLAN

C100



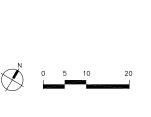

GENERAL NOTE:
ALL OVERHEAD AND UNDERGROUND UTILITIES SHOWN ON THE MAP ARE APPROXIMATE AND WERE FIELD LOCATED FROM GROUND MARKINGS PLACED BY THE UTILITY COMPANIES OR THEIR AGENTS OR ESTABLISHED FROM PLANS PROVIDED BY UTILITY COMPANIES OR CITY ENGINEERS. THE SURVEYOR CAN CERTIFY ONLY TO THE LOCATION OF UTILITIES AS PROVIDED BY OTHERS, EXCEPT WHERE SNOW AND OTHER OBSTACLES MAY HAVE OBSCURED THE LOCATION OF THE UTILITIES. CONTRACTOR TO FIELD VERIFY.

- 1. THIS SURVEY WAS PREPARED WITHOUT BENEFIT OF A TITLE REPORT FOR THE SUBJECT TRACT OR ADJOINERS AND IS THEREFORE SUBJECT TO ANY EASEMENTS, AGREEMENTS, RESTRICTIONS AND STATEMENT OF FACTS REVEALED BY EXAMINATION OF SUCH DOCUMENTS.
- 2. ELEVATIONS ARE REFERENCED TO THE CITY OF MADISON DATUM. SITE BENCHMARK IS THE TOP NUT OF HYDRANT LOCATED AT THE NORTH CORNER OF THE INTERSECTION OF MONROE STREET GLENWAY STREET. ELEVATION = 22.94'.
- 3. TREES LOCATED ARE 12 INCHES OR LARGER.
- 4. FIELD WORK WAS COLLECTED ON OCTOBER 17, 2013.
- 5. WETLANDS, IF PRESENT, HAVE NOT BEEN DELINEATED OR SHOWN.
- 6. FLOOD PLAIN, IF PRESENT, HAS NOT BEEN LOCATED OR SHOWN.

\*SITE SURVEYING PERFORMED BY WILLIAMSON SURVEYING & ASSOCIATES 104A WEST MAIN STREET, WAUNAKEE, WI 53597 608-255-5705

ADDITIONAL UTILITY INFORMATION WAS PROVIDED BY THE CITY OF MADISON.

LEGEND

O = SET 3/4"x24" REBAR WT 1.5 LB PER LIN FT

• = FOUND 1" PIPE

■ FOUND 3/4" PIPE

■ FOUND 3/4" REBAR (##) = RECORDED AS

= SET WOOD LATH ON

PROPERTY LINE × = SPOT GRADE

\* = GROUND LIGHT

+ = STREET/PARKING SIGN

= TRAFFIC LIGHTS

STORM INLET/ GRATE INLET

= MANHOLE

= WATER VALVE

■ UTILITY PEDESTAL

■ = UTILITY BOX

□ = UTILITY BASE VAULT

 $\bigcirc\bigcirc\bigcirc\bigcirc\bigcirc\bigcirc\bigcirc\bigcirc\bigcirc$  = ROCK WALL

= DECIDUOUS TREE (SIZE NOTED)

= CONIFEROUS TREE (SIZE NOTED)

LINE LEGEND

-SAN - = SANITARY SEWER

---ST--- = STORM SEWER 

--- W --- = WATER MAIN

--- T --- = UNDERGROUND TELEPHONE ---- E ---- = UNDERGROUND ELECTRIC

--- G --- = UNDERGROUND GAS MAIN

—X —— X — = WOOD FENCE

DIGGERS HOTLINE TICKET # 20134015794
BEFORE CONSTRUCTION CALL DIGGERS HOTLINE FOR EXACT LOCATION OF UNDERGROUND UTILITIES.

1-800-242-8511



3414 Monroe Street Madison, WI 53711 ph 608-709-1250

Structural Engineering:

### **ECHELON STRUCTURES, LLC**

1521 Sunset Ct. Middleton, WI 53562

Civil Engineering/Landscape Architecture:

## SAA DESIGN GROUP, INC.

101 East Badger Rd. Madison, WI 53713



#### The Glen

by Patrick Properties

3414 Monroe Street Madison, WI 53711

Project #: 13002.00

No. Description

#### Plan Commission Submittal

Date


Issued for:

Drawn by: AW Checked by: SAA Design Group, Inc.

ILLUSTRATIVE SITE PLAN

C900

Project Name: the Gle Project #: 2573

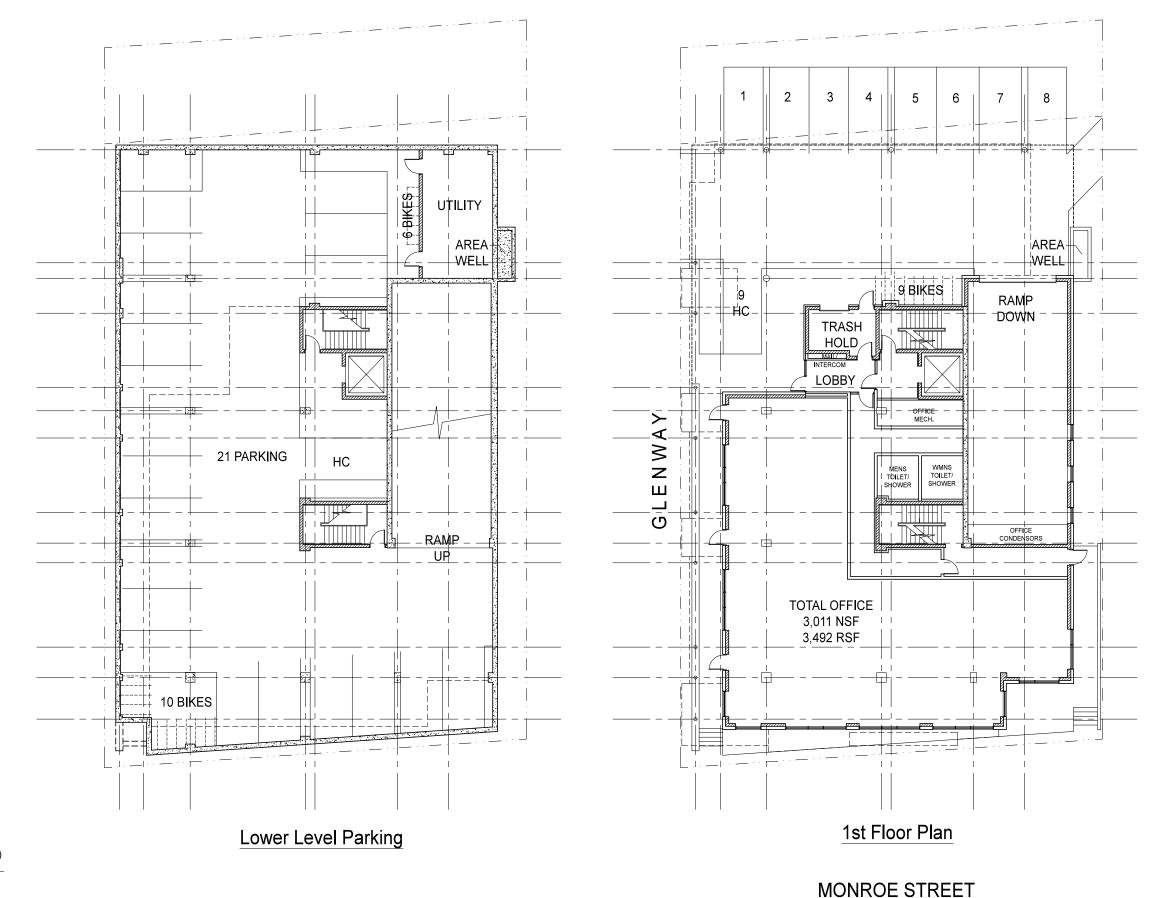

## **BUILDING TOTALS**

MADISON CALCULATED AREA = 41,038 GSF **BUILDING ENCLOSED AREA** = 35,798 GSF RESIDENTIAL RENTABLE AREA = 17,842 RSF PARKING STALLS TOTAL = 30 TOTAL REQUIRED FOR COMM. = 8 = 3,190 NSF/(400 NSF PER STALL) PROVIDED FOR COMM. = 9 PROVIDED = 19 REQUIRED (1 PER DWELLING UNIT) REQUIRED FOR UNITS PROVIDED FOR UNITS = 21 PROVIDED **UNIT MIX** STUDIO = 2 1 BEDS = 8 3 BEDS = 4

**BIKE PARKING REQUIRED** 

COMMERCIAL = 2 TOTAL (1 PER 2,000 SF OF OFFICE SPACE) = 15 (1 PER 2 BEDROOM UNIT) UNITS

2 (1/2 STALL PER BEDROOM OVER 2 BEDROOM = 4\*(1/2)) 2 (1 GUEST STALL PER 10 UNITS = 19 UNITS / 10)


TOTAL BIKE STALLS REQUIRED = 21 TOTAL BIKE STALLS PROVIDED = 25

## Lower Level Parking and 1st Floor the GLEN by Patrick Properties

Scale: 1" = 20' - 0"






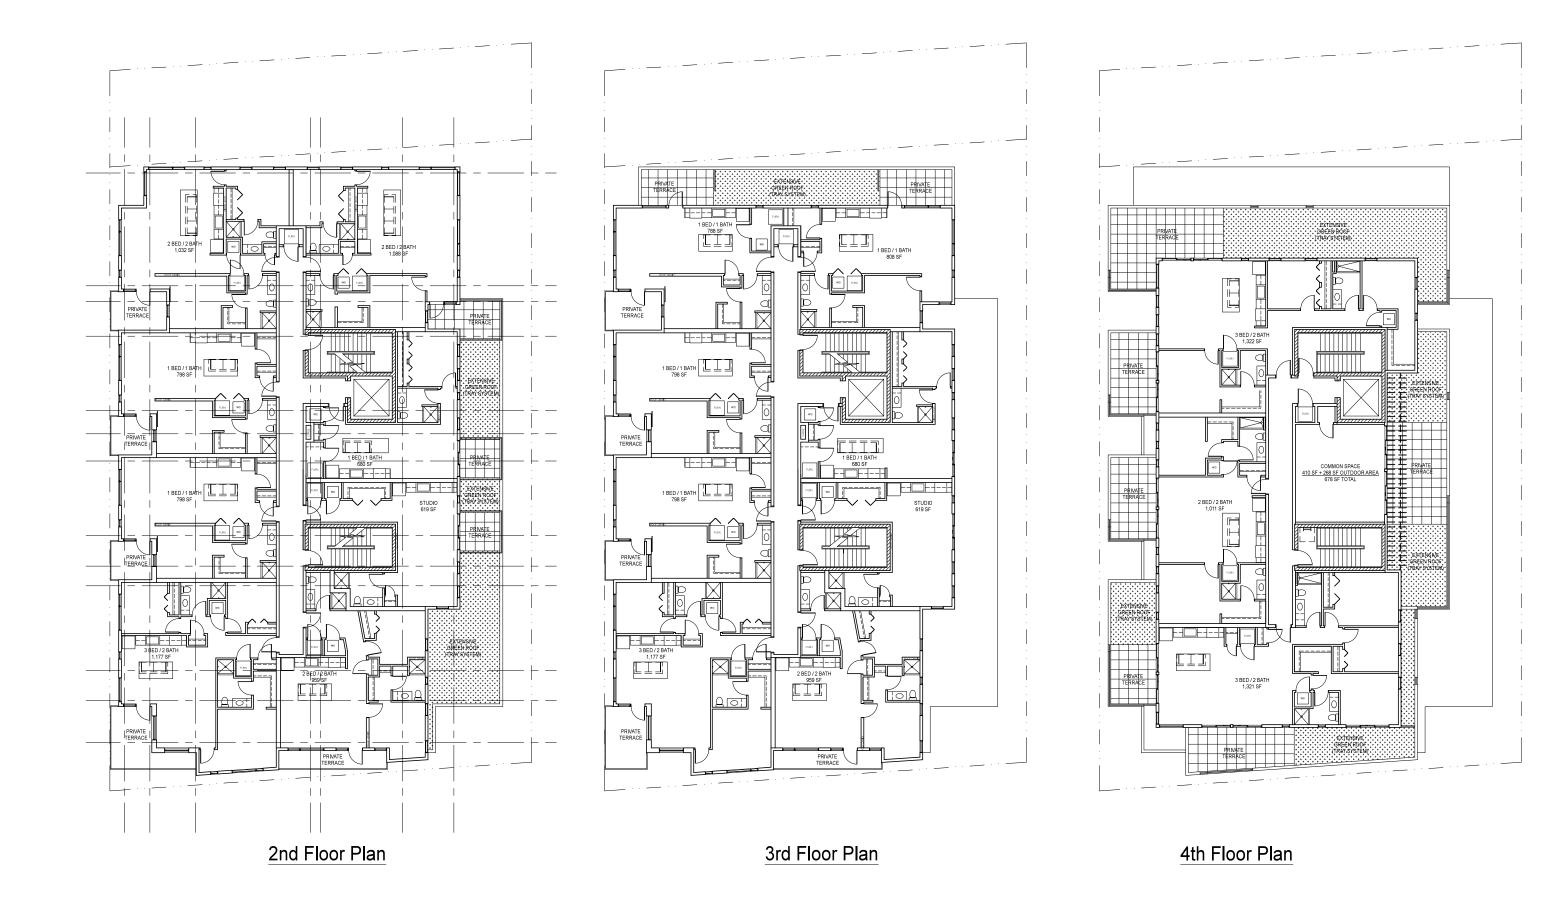



the GLEN by Patrick Properties Scale: 1" = 20' - 0"



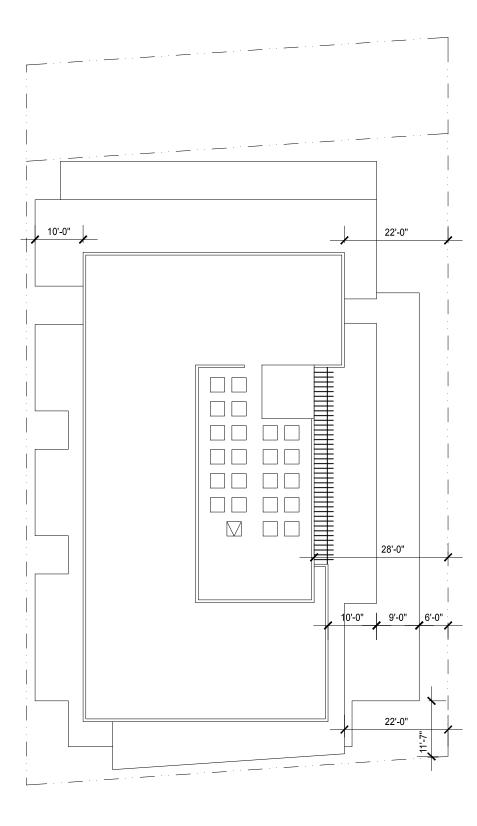

Roof Plan

Roof Plan
the GLEN by Patrick Properties
Scale: 1" = 20'-0"





1 CAST CONCRETE - SANDBLASTED NATURAL

2 GROUND FACE MASONRY - DARK GRAY

3 6" T&G FIBER CEMENT SIDING - NAT. CEDAR COLOR

4 NATURAL PLASTER - WARM WHITE

5 PRE-FINISHED METAL COPING

6 GALVANIZED STEEL COLUMN

7 GALVANIZED STEEL BEAM

8 PRE-FINISHED ALUMINUM RAILING

9 | FIBERGLASS WINDOW WITH INSULATED GLASS

10 CLAD WOOD DOOR

11 INSULATED METAL DOOR

12 INSULATED OVERHEAD DOOR

CLEAR ANODIZED ALUMINUM STOREFRONT SYSTEM WITH INSULATED GLASS

14 ALUMINUM LOUVER

15 CEDAR FENCE / PRIVACY SCREEN

GALVANIZED STEEL ANGLE LIGHT SHIELD FOR LINEAR LED LIGHT ROPE

17 PRE-FINISHED LED SIGN LIGHT



18 SIGNAGE LOCATION - RAISED ANODIZED ALUMINUM LETTER (1'-4"' x 6' along Glenway, 20" h along Monroe).

19 ROOFTOP MECHANICAL SCREEN WALL - SEE NOTE 3.

20 WOOD BENCH ON CAST CONCRETE WALL




Scale: 3/32" = 1' - 0"

SCALE: 1/8"=1'-0"



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## Monroe Street Elevation

the GLEN by Patrick Properties Scale: 3/32" = 1' - 0"

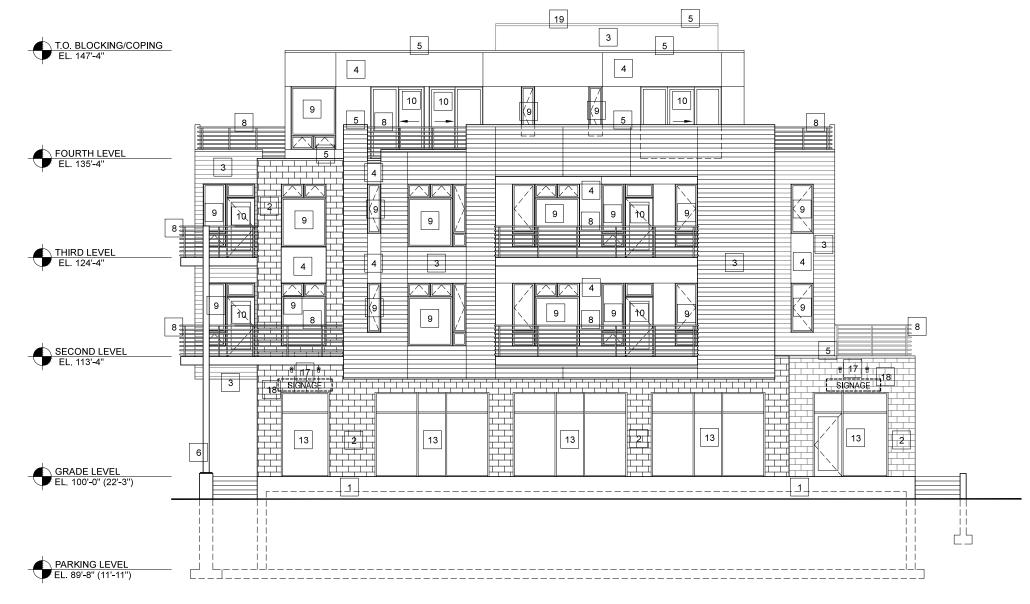

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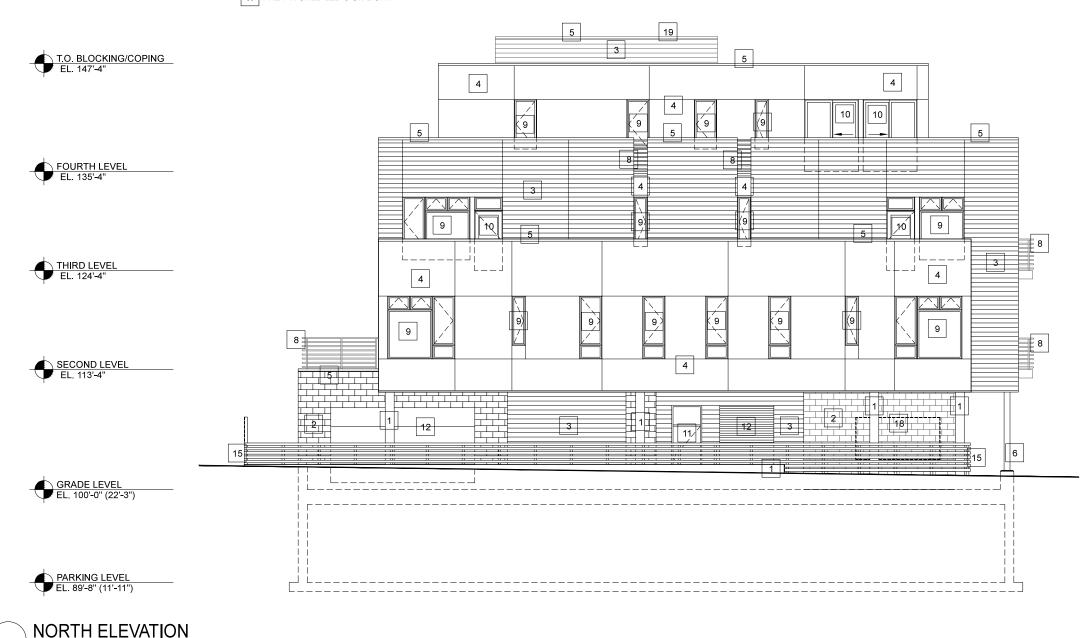


the GLEN by Patrick Properties Scale: 3/32" = 1' - 0"



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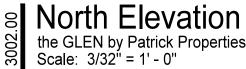


18 SIGNAGE LOCATION - RAISED ANODIZED ALUMINUM LETTER

(1'-4"' x 6' along Glenway, 20" h along Monroe).

20 WOOD BENCH ON CAST CONCRETE WALL

19 ROOFTOP MECHANICAL SCREEN WALL - SEE NOTE 3.



SCALE: 1/8"=1'-0"

the GLEN by Patrick Properties Scale: 3/32" = 1' - 0"



Building along Glenway Street



Building from Glenway Street and Monroe Street



Building along Monroe Street



**Building along Monroe Street** 

Building Images the GLEN - Patrick Properties


Scale: NTS


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architecture, Ilc







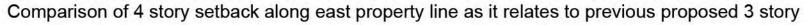

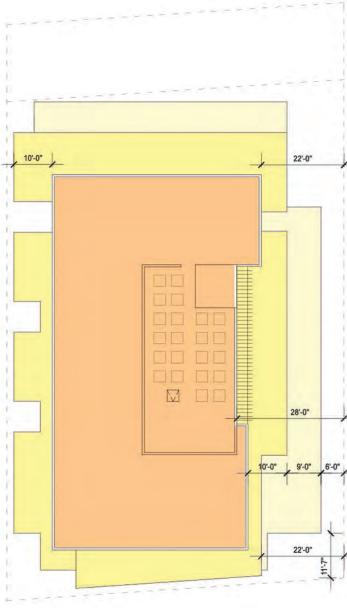Roof Plan of 4 story proposal

Monroe Street Elevation Comparison the GLEN - Patrick Properties

Scale: NTS

architecture, Ilc





View of 3 story building from NE corner of site looking out to Monroe Street

View of 4 story building from NE corner of site looking out to Monroe Street

Setback Comparison the GLEN - Patrick Properties



View of 3 story building from Copeland Street

View of 4 story building from Copeland Street

# View from Copeland Comparison the GLEN - Patrick Properties

Scale: NTS

architecture, Ilc



Parman Place along Glenway Street



View of Residential up Glenway Street from site



View from site looking up Wyota Avenue



View of Residential up Glenway Street from site



View along Monroe Street from the West



View along Monroe Street from the East



Parman Place at Glenway Street and Monroe Street



Arbor House to the east of property along Monroe Street



Apartments along Monroe Street east of Arbor House


Existing Site Context the GLEN - Patrick Properties

Scale: NTS

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Adjacent Site / Monroe Street Elevation Along West Tree Line



Existing Tree Line Along East Edge of Project Site

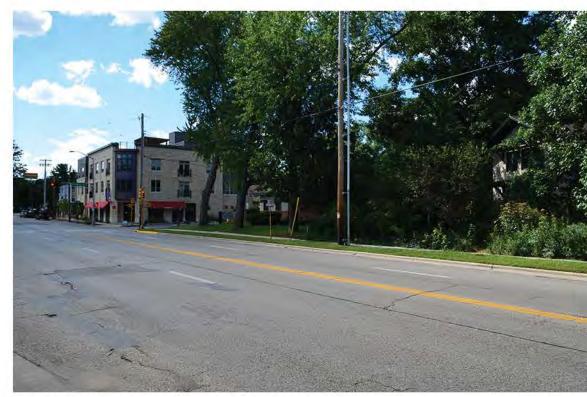

Adjacent Site / Monroe Street Elevation



Oblique View of Adjacent Site and West Edge Tree Line





Existing Building along Glenway Street



Existing Building parking accessed off of Glenway Street



Existing Building along Monroe Street



Existing Building adjacent to Arbor House property



Existing Office Area within original building



Existing Office Area within original building



Mechanical room within original building



Existing Area within the building addition



Corridor to building addition



Restroom within original building

## Existing Building Interior Photos the GLEN - Patrick Properties