

City of Madison

Proposed Rezoning

Location 2504 Winnebago Street

Applicant Edward Markom – Gorman & Company


From: PD(SIP)

To: Amended PD(SIP)

Existing Use Vacant land

Proposed Use Construct 2 mixed-use buildings containing a total of 18,000 square feet of retail and 90 apartments

Public Hearing Date Plan Commission 26 January 2015 Common Council 03 February 2015

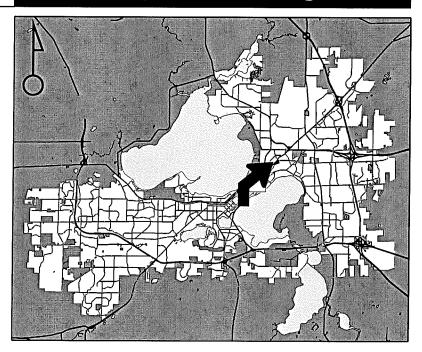

For Questions Contact: Tim Parks at: 261-9632 or tparks@cityofmadison.com or City Planning at 266-4635



Scale: 1" = 400'

City of Madison, Planning Division: RPJ: Date: 20 January 2015





Date of Aerial Photography : Spring 2013





LAND USE APPLICATION

- All Land Use Applications sho Administrator at the above a
- The following information is Commission review except s should be filed using the Sub
- · This form may also be comple www.cityofmadison.com/de

Madison 115					
PO Box 2985; Madisor	g Jr. Blvd; Room LL-100 n, Wisconsin 53701-2985 Facsimile: 608.267.873		FOR OFFICE Amt. Paid \$1900 Rec Date Received 11-5-18 Received By 211	eipt No. <u>159</u>	797V
should be filed using the	ve address. n is required for all applica pt subdivisions or land divis <u>Subdivision Application</u> .	tions for Plan	Parcel No	mel	
 This form may also be co www.cityofmadison.com 	mpleted online at: /developmentcenter/lando	development	Common Council Form Effective: Febr	Other:	
 Project Address: Project Title (if any): 	2500 Winnebago Street, M Union Corners Buildings F				
✓ Zoning Map Amen☐ Major Amendment	to Approved PD-GDP Zon	ing	to SIP Major Amendment to Appr	oved PD-S	IP Zoning
☐ Conditional Use, or ☐ Demolition Permit	on to Planned Developmen Major Alteration to an Ap	pproved Cond	tional Use		
s. Applicant, Agent & Pi pplicant Name: Edward M	roperty Owner Informat atkom		_{any:} Gorman & Company		
treet Address: 200 N. Ma elephone: (414) 617-9997	in Street Fax: (608) 835-30	City/State:	Oregon, WI Email: tmatkom@gorman	Zip:	53575
oject Contact Person: Marc		Comp	any: Gorman & Company		
treet Address: 200 N. Main elephone: (608) 835-6388	Street (608) 835-30	City/State:	Oregon, WI Email: mott@gormanusa.	Zip: com	53575
roperty Owner (if not applicant) treet Address: 200 N. Main		C. City/State:	Oregon, WI	Zip:	53575

4. Project Information:

Provide a brief description of the project and all proposed uses

containing 90 rental apartments, ground floor retail, and structured basement parking. Site improvements include a pedestrian/ bike path.

Development Schedule: Commencement

10/2015 Completion 10/2016

5. Required Submittal Information

All Land Use applications are required to include the following:

- ✓ Project Plans including:*
 - Site Plans (fully dimensioned plans depicting project details including all lot lines and property setbacks to buildings; demolished/proposed/altered buildings; parking stalls, driveways, sidewalks, location of existing/proposed signage; HVAC/Utility location and screening details; useable open space; and other physical improvements on a property)
 - Grading and Utility Plans (existing and proposed)
 - Landscape Plan (including planting schedule depicting species name and planting size)
 - Building Elevation Drawings (fully dimensioned drawings for all building sides, labeling primary exterior materials)
 - Floor Plans (fully dimensioned plans including interior wall and room location)

Provide collated project plan sets as follows:

- Seven (7) copies of a full-sized plan set drawn to a scale of 1 inch = 20 feet (folded or rolled and stapled)
- Twenty Five (25) copies of the plan set reduced to fit onto 11 X 17-inch paper (folded and stapled)
- One (1) copy of the plan set reduced to fit onto 8 ½ X 11-inch paper
- * For projects requiring review by the Urban Design Commission, provide Fourteen (14) additional 11x17 copies of the plan set. In addition to the above information, all plan sets should also include: 1) Colored elevation drawings with shadow lines and a list of exterior building materials/colors; 2) Existing/proposed lighting with photometric plan & fixture cutsheet; and 3) Contextual site plan information including photographs and layout of adjacent buildings and structures. The applicant shall bring samples of exterior building materials and color scheme to the Urban Design Commission meeting.

• Pro	ting Conditions lect Schedule oosed Uses (and ft ² of each)	Number of Dwelling UnitsAuto and Bike Parking StallsLot Coverage & Usable Open	 Estimated Project Cost Number of Construction & Full- Time Equivalent Jobs Created
 Hoι 	rs of Operation	Space Calculations	 Public Subsidy Requested

Letter of Intent: Provide one (1) Copy per Plan Set describing this application in detail including, but not limited to:

Adobe Acrobat PDF files on a non-returnable CD to be included with their application materials, or by e-mail to pcapplications@cityofmadison.com. Additional Information may be required, depending on application. Refer to the Supplemental Submittal Requirements. 6. Applicant Declarations Pre-application Notification: The Zoning Code requires that the applicant notify the district alder and any nearby neighborhood and business associations in writing no later than 30 days prior to FILING this request. List the alderperson, neighborhood association(s), and business association(s) AND the dates you sent the notices: → If a waiver has been granted to this requirement, please attach any correspondence to this effect to this form. Pre-application Meeting with Staff: Prior to preparation of this application, the applicant is required to discuss the proposed development and review process with Zoning and Planning Division staff; note staff persons and date. Planning Staff: Tim Parks Date: 10/28/14 Zoning Staff: N/A Date: ______ The applicant attests that this form is accurately completed and all required materials are submitted: Relationship to Property: Developer

Date 11/5/2 Name of Applicant Edward Matkom

Authorizing Signature of Property Owner

Zoning Text

Rezoning PD-GDP to PD-SIP Union Corners – Bldg 4 & 5 2500 Winnebago Road Lot 3 & 4 of Union Corner November 5, 2014

Legal Description: Lot 3 & 4 of Union Corners

- A. **Statement of Purpose:** Re-zoning of Lot 3 & 4 from PD-GDP PD-SIP to allow for the construction of two four story mixed-use buildings. Buildings will consist of retail space on the ground floor, and 90 dwelling units on the upper three floors. Tenant parking will be provided in one shared underground parking garage.
- B. Permitted Uses: Uses as shown on Exhibit A, attached hereto
- C. **Lot Area:** Lot 3 & 4 48,701 s.f. (1.118 acres)
- D. Floor Area Ratio: 0.21
- E. Yard Requirements: As shown on the attached plans
- F. Landscaping: Site landscaping provided as shown on the attached landscape plan.
- G. Accessory Off-Site Parking: Off-street and surface parking shall be provided as shown the attached plans.
- H. **Lighting:** Site lighting will be provided along north pedestrian path, plaza, and building façade and meeting MGO requirements. Exhibit to follow.
- I. Signage: Retail tenant, and apartment signage will be located on building façade, and meet MGO requirements. See attached plans. Signage approval will made in a separate submittal.
- J. Alterations and Revisions: No alteration or revision of the planned unit development shall be permitted unless approved by the City Plan Commission, however, the Zoning Administration may issue permits for minor alterations or additions which are approved by the Director of Planning and Development and the alderperson of the district and are compatible with the concept approved by the City Plan Commission.

Exhibit A - Permitted Uses

Residential - Family Living

- Live/work unit
- Multi-family dwelling (>8 dwelling units)

Residential - Group Living

- · Adult family home
- Cohousing community
- Community living arrangement (> 15 residents)
- Housing cooperative

Civic and Institutional Uses

- Counseling, community services organization
- Community center
- Day care center
- Library, museum
- Recreational, community, and neighborhood centers

Agriculture and Resource Uses

- Community garden
- Market garden

Accessory Uses and Structures

- Management office, restaurant, limited retail, recreation facilities within multi-family building
- Non-accessory temporary outdoor events
- On-site agricultural retail, farm stand
- Outdoor display
- Outdoor eating area associated with food & beverage establishment
- Outdoor sales event
- Temporary outdoor events
- Walk-up service windows

Offices

- Artist, photographer studio, etc.
- Insurance office, real estate office, sales office
- General office
- Professional office

Medical Facilities

- Physical, occupational or message therapy
- Dentist
- Chiropractor

Retail Sales and Services

- Animal grooming
- Artisan workshop
- Bank, financial institution
- Business sales and services
- Dry cleaning plant, commercial laundry
- Farmers' market
- Food and related goods sales
- Furniture and household goods sales
- General retail
- Health/sports club
- Home occupation
- Indoor recreation
- Package delivery service
- Printing and publishing
- Post office
- Real estate sales office
- Secondhand goods sales
- Service business
- Telecommunications center
- Tobacco shop

Food and Beverage

- Catering
- Coffee shop, tea house
- Restaurant
- Restaurant-tavern
- Tavern, brewpub



200 N. Main Street • Oregon, WI 53575

P: (608) 835-3900

F: (608) 835-3922

www.GormanUSA.com

REAL ESTATE DEVELOPMENT

MILWAUKEE MIAMI PHOENIX CHICAGO DENVER

January 7, 2015

Mr. Tim Parks **Urban Design Commission** 215 Martin Luther King Jr. Blvd P.O. Box 2985 Madison, Wi 53701

CITY OF MADISON

JAN 1 4 2015

Re:

Letter of Intent PD-SIP Re Zoning 2500 Winnebago Street

Madison, Wi 53704

Planning & Community & Economic Development

Dear Mr. Parks:

The following is submitted together with the plans, and application for staff approval.

Project Organizational Structure:

Owner:

Gorman & Company, Inc.

200 N. Main Street Oregon, WI 53575 414-617-9997

Contact: Edward Matkom tmatkom@gormanusa.com

Architect: Gorman & Company, Inc.

200 N. Main Street Oregon, WI 53575 608-835-3900 Contact: Marc Ott mott@gormanusa.com

Civil:

JSD Professional Services, Inc.

Engineer

161 Horizon Dr, Suite 101

Madison, WI 53593 608-848-5060

Contact: Hans Justeson hans.justeson@jsdinc.com Landscape: JSD Professional Services, Inc.

Design 161 Horizon Dr, Suite 101

> Madison, WI 53593 608-848-5060

Contact: Justin Frahm justin.frahm@jsdinc.com

Introduction:

The site property is located on the east side of Madison, on Winnebago Street just off of East Washington Boulevard. The property is within the Union corners General Plan Development. The site is currently vacant.

Zoning:

The site is currently within the Union Corners General Plan Development.

Project Description:

The Project consists of two four story buildings with a shared basement parking structure. The ground floor contains retail suites, building common areas/ amenity spaces, live/work apartments, and lobbies. The upper three floors are rental apartments. The project includes improvements to Winnebago street outside of the property line of this phase, including new sidewalks, and angled street parking. Additionally, the project constructs a new serpentine pedestrian pathway and stormwater management swales.

Project Development Data:

Site Density:

Lot area:

48,701 s.f. (1.118 acres)

Dwelling Units:

90 Units

Lot Area / D.U.

541 s.f / d.u.

Density

80.50 d.u. / acre

Site Coverage:

Building:

30,244 s.f. (62.1%)

Ramp:

1,465 s.f. (3.0 %)

Sidewalks:

1,012 s.f. (2.1 %)

Plaza:

4,708 s.f. (9.6%)

Building Patios:

3,641 s.f. (7.7%)

Pedestrian Path:

1,123 s.f. (2.2%)

Pervious:

6,508 s.f. (13.3 %)

Building Ratio:

Retail Shell:

65,211 s.f. (28.4 %)

Apartments & Amenities

72,330 s.f. (31.5 %)

Underground Parking:

9,666 s.f. (4.2 %)

Misc (corridor, mech, stairs):

52,280 s.f. (22.7 %)

229,682 s.f. Total Building Area

Dwelling Unit Mix

Bike Parking:

One Bedroom 19

Enclosed:

Two Bedroom

57

Surface: 44

Three Bedroom 14

112 Total

68

90 Total

Vehicular Parking:

Enclosed

97

Surface

33 (In City R.O.W.)

130 Total

Schedule:

The development schedule calls for construction to start October of 2015, with a scheduled completion in October 2016.

Social & Economic Impacts:

This development will have a positive social and economic impact on the surrounding community. The redevelopment of this property will provide high quality affordable housing, create new retail establishments, and infuse local businesses with new revenue sources.


Thank you for your time in reviewing our proposal.

Sincerely,

Edward Matkom

President – Wisconsin Market

Gorman & Company, Inc.

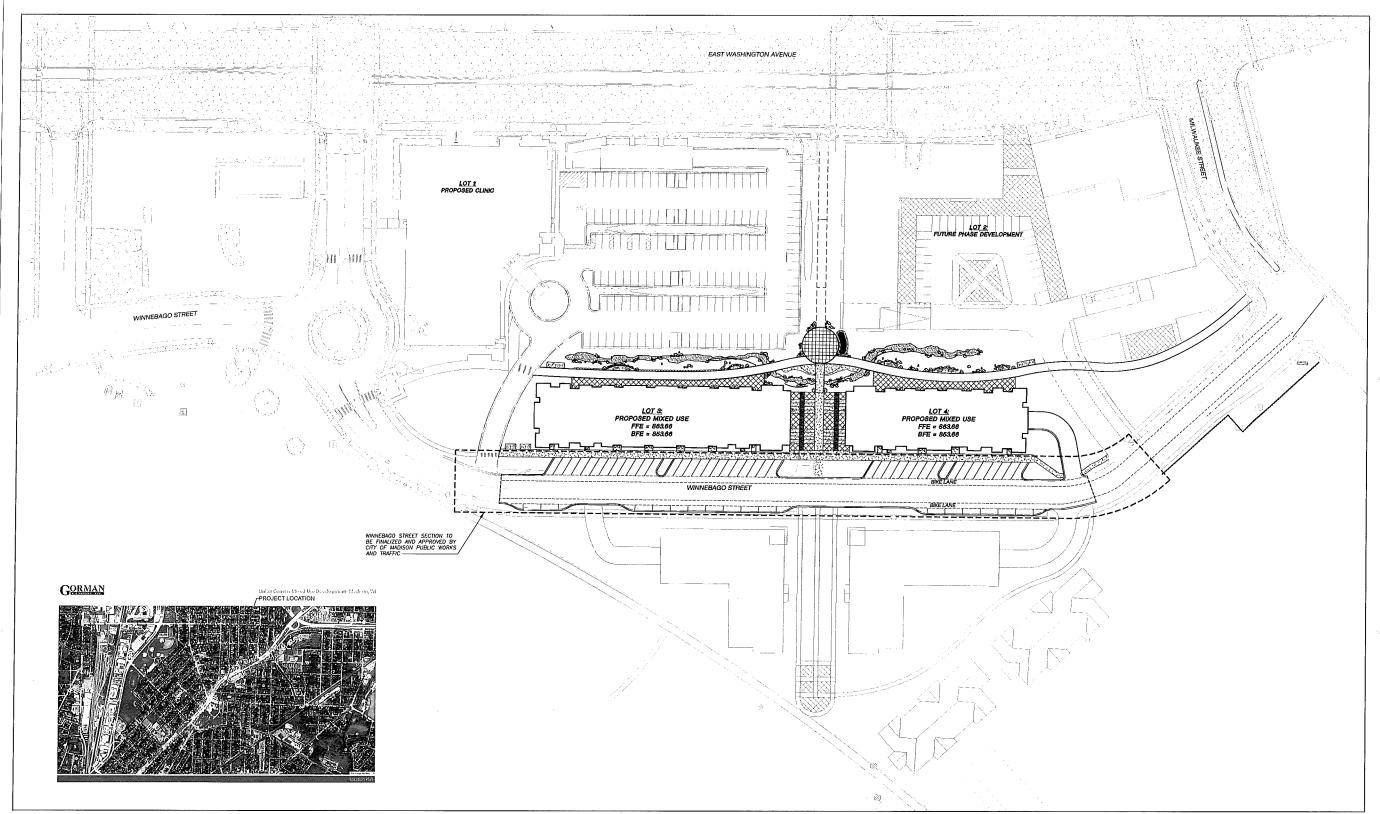

CONCRETE PAVEMENT

LIMESTONE BOULDERS (VARY IN SIZE AND COLOR)

GENERAL NOTES

- JSD SHALL BE HELD HARMLESS AND DOES NOT WARRANT ANY DEVAILORS BY THE OWNER/CONTRACTOR FROM THE APPROVED CONSTRUCTION PLANS THAT MAY RESULT IN DISCIPLINARY ACTIONS BY ANY OR ALL REGULATORY AGENCIES.
- DRAWING FOR REVIEW NOT FOR CONSTRUCTION UNLESS OTHERWISE NOTED IN THE TITLE BLOCK.

Sheet Title

OVERALL SITE PLAN

Sheet No.

C100

GORMAN RECOMPANY INCO

REAL ESTATE DEVELOPMENT & MANAGEMENT 200 N. MAIN STREET OREGON, WI 53575

www.isdinc.com

UNION CORNERS SPECIFIC

COMPANY

GORMAN &

Project No.

Plot Date:

Drawn by:

Date

GDP

SIP

UDC/PC

RESUBMITTAL

IMPLEMENTATION PLAN

MADISON, WI

14-6534

JLF, KJY, MG

Issue Description

06-25-14

11-05-14

1-14-15

TO DETAIN LOCATIONS OF PARTICIPANT UNDERCROUNG FACULTES BEFORE YOU DO'S IN INSCONSIN



CALL DIGGERS HOTLINE
1-800-242-8511 TOLL FREE
1-800-342-8511 TOLL FREE



SHEET INDEX: C100 - OVERALL SITE PLAN

C200 - BUILDING 4 SITE PLAN C201 - BUILDING 5 SITE PLAN

C300 - GRADING AND EROSION CONTROL PLAN

C400 - UTILITY PLAN

C500 - DETAILS

L100 - OVERALL LANDSCAPE PLAN L200 - BUILDING 4 LANDSCAPE PLAN L201 - BUILDING 5 LANDSCAPE PLAN


L300 - LANDSCAPE DETAILS, NOTES AND SPECIFICATIONS

A200 - BUILDING FLOOR PLANS A400 - BUILDING ELEVATIONS A401 - BUILDING ELEVATIONS








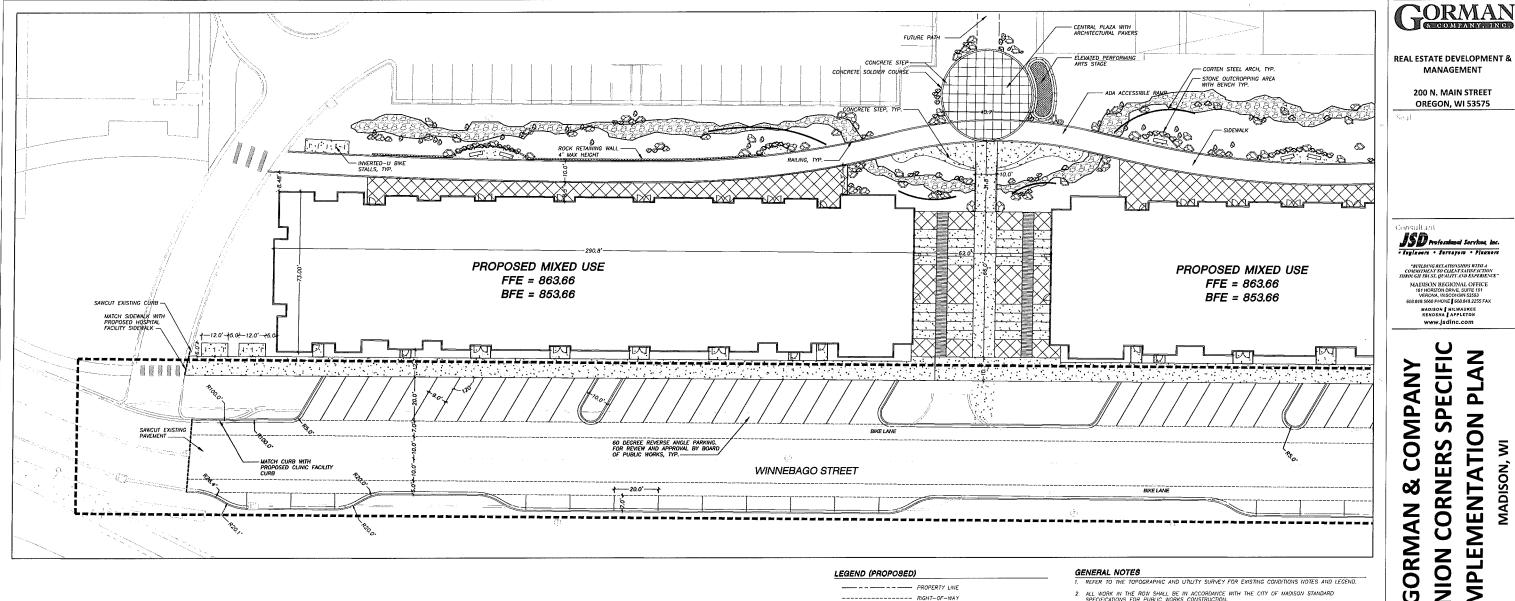

ALL WORK IN THE ROW SHALL BE IN ACCORDANCE WITH THE CITY OF MADISON STANDARD SPECIFICATIONS FOR PUBLIC WORKS CONSTRUCTION.

JSD SHALL BE HELD HARMLESS AND DOES NOT WARRANT ANY DEVATIONS BY THE OWNER/CONTRACTOR FROM THE APPROVED CONSTRUCTION PLANS THAT MAY RESULT IN DISCIPLINARY ACTIONS BY ANY OR ALL REGULATOR'S AGENCIES.

4. DRAWING FOR REVIEW - NOT FOR CONSTRUCTION UNLESS OTHERWISE NOTED IN THE TITLE BLOCK.

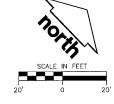

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Sheet Title

BUILDING 4 SITE PLAN

Sheet No.

C200

CORMAN

MANAGEMENT

200 N. MAIN STREET OREGON, WI 53575

JSD Profondezed Services, Inc.

MADISON MILWAUKEE KENOSHA APPLETON WWW.jsdinc.com

UNION CORNERS SPECIFIC

GORMAN & COMPANY

Project No.

Plot Date:

Drawn by:

Date

GDP

SIP

UDC/PC

RESUBMITTAL

IMPLEMENTATION PLAN

MADISON, WI

14-6534

JLF, KJY, MG

Issue Description

06-25-14

11-05-14

_ _ _ _ _ _ _ _ _ _ _ WINNEBAGO STREET PUBLIC WORKS APPROVAL

- BUILDING LINE

ARCHITECTURAL BRICK PAVERS 2

--- EDGE OF PAVEMENT

MASONRY BRICK (RECYCLED)


LIMESTONE BOULDERS (VARY IN SIZE AND COLOR)

---- FUTURE PATH ---- SAWCUT

__x ___x ___x ___x PROPOSED RAILING

CONCRETE PAVEMENT ARCHITECTURAL BRICK PAVERS



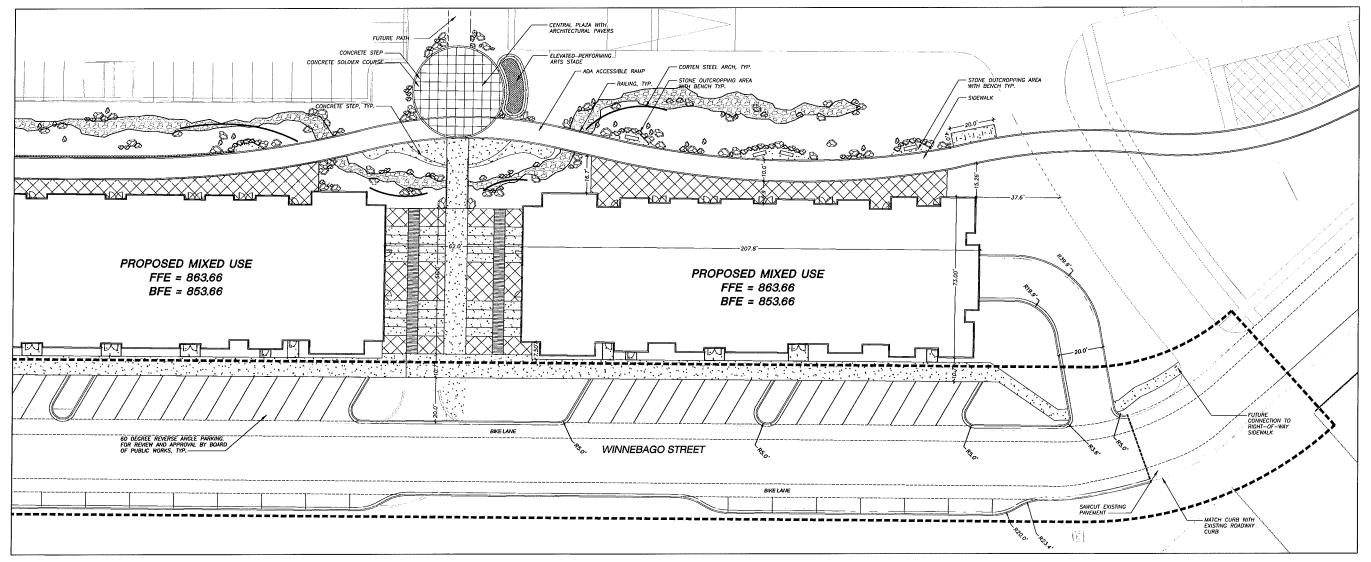

PROPERTY LINE
RIGHT-OF-WAY
WINNEBAGO STREET PUBLIC WORKS APPROVAL

BUILDING LINE

EDGE OF PAVEMENT

X X Y PROPOSED RAILING

CONCRETE PAVEMENT

ARCHITECTURAL BRICK PAVERS

ARCHITECTURAL BRICK PAVERS 2


MASONRY BRICK (RECYCLED)

LIMESTONE BOULDERS (VARY IN SIZE AND COLOR)

GENERAL NOTE

1. REFER TO THE TOPOGRAPHIC AND UTILITY SURVEY FOR EXISTING CONDITIONS NOTES AND LEGEND.

- ALL WORK IN THE ROW SHALL BE IN ACCORDANCE WITH THE CITY OF MADISON STANDARD SPECIFICATIONS FOR PUBLIC WORKS CONSTRUCTION.
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TO OBTAIN LOCATIONS OF PARTICIPANT UNCERCROUND FACILITIES BEFORE YOU DIG IN MISCONSIN

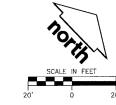

CALL DIGGERS HOTLINE
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GORMAN GRANNY, INC.

REAL ESTATE DEVELOPMENT & MANAGEMENT

200 N. MAIN STREET OREGON, WI 53575

Consultant

JSD Prolombad Services, Inc.

"BUILDING RELATIONSHIPS WITH A COUNTINENT TO CLIENT SUTSET. CITED THROUGH TREST, QUALITY AND EXPERIENCE"

MADISON REGIONAL OFFICE 161 HORIZON GRIVE, SUITE 101 VEROLA, WISCONSHI S5593

608 BH 5000 PHONE | 608 BH 2255 FAX

VERONA, MISCONISMI S1993
693 848 5060 PHONE | 608 648 2255 FA
MADISON | MILWAUKEE
KENOSHA | APPLETON
WWW. JS dinc. com

GORMAN & COMPANY UNION CORNERS SPECIFIC IMPLEMENTATION PLAN


Project No.	14-6534
Plot Date:	
Drawn by:	JLF, KJY, MG

Date Issue Description
GDP 06-25-14
SIP 11-05-14
UDC/PC 1-14-15
RESUBMITTAL

Sheet Title

BUILDING 5 SITE PLAN

Sheet No.

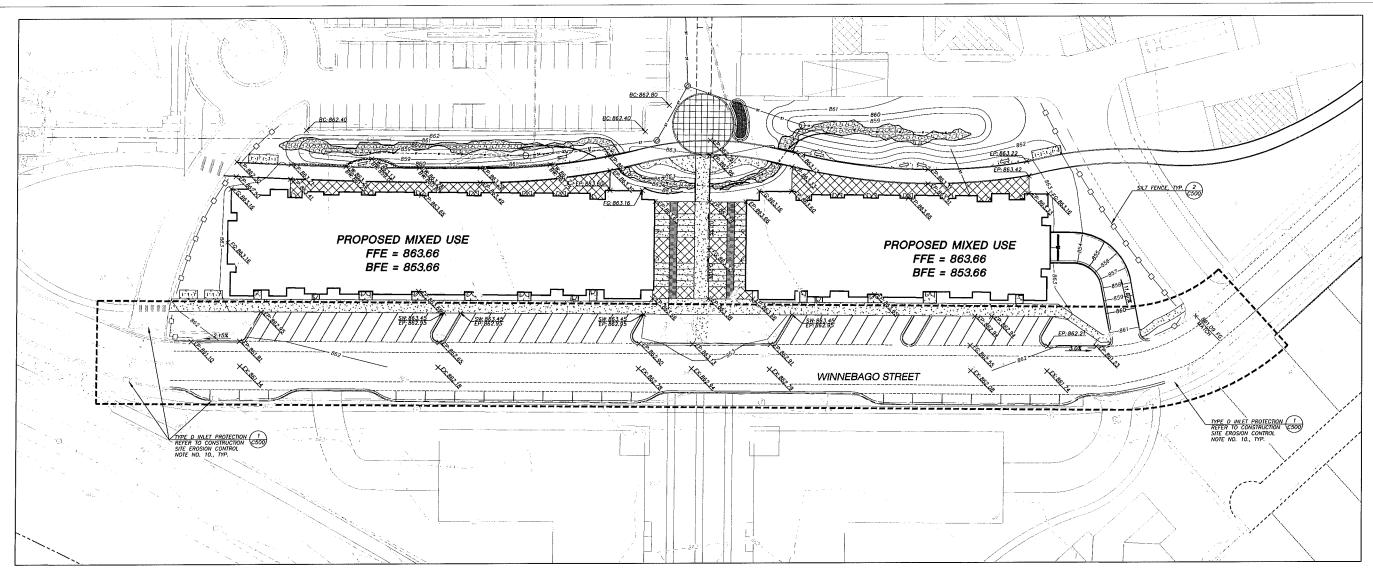

- BUILDING LINE ---- RIGHT-OF-WAY ---- WINNEBAGO STREET PUBLIC WORKS APPROVAL ____ EUTURE PATH



— SILT FENCE

GENERAL NOTES

- REFER TO THE TOPOGRAPHIC AND UTILITY SURVEY FOR EXISTING CONDITIONS NOTES AND LEGEND
- 2. EXISTING CONDITION SURVEY AS PROVIDED BY POINT OF BEGINNING, INC. ON 4-14-2014. ANY DISCREPANCIES TO BE REPORTED TO JSD IMMEDIATELY UPON DISCOVERY.
- 3. ALL WORK IN THE ROW SHALL BE IN ACCORDANCE WITH THE CITY OF MADISON STANDARD SPECIFICATIONS FOR PUBLIC WORKS CONSTRUCTION.
- 4. JSD SHALL BE HELD HARMLESS AND DOES NOT WARRANT ANY DEVATIONS BY THE OWNER/CONTRACTOR FROM THE APPROVED CONSTRUCTION PLANS THAT MAY RESULT IN DISCIPLINARY ACTIONS BY ANY OR ALL REGULATORY AGENCIES.
- 5 DRAWING FOR REVIEW NOT FOR CONSTRUCTION UNLESS OTHERWISE NOTED IN THE TITLE BLOCK

CONSTRUCTION SITE EROSION CONTROL REQUIREMENTS

- ALL EROSION AND SEDIMENT CONTROL PRACTICES SHALL BE DESIGNED AND IMPLEMENTED IN ACCORDANCE WITH THE CURRENT DEPARTMENT OF NATURAL RESOURCES EROSION AND SEDIMENT CONTROL TECHNICAL STANDARDS WHICH ARE AVAILABLE AT:
- 2. INSTALL EROSION CONTROL MEASURES PRIOR TO ANY SITE WORK, HICLIDING GRADING OR DISTURBANCE OF EXISTING SURFACE MATERIALS AS SHOWN ON PLANT, MODIFICATIONS TO SEMINABELY CONTROL DESIGN MAY BE CONDUCTED TO MEET UNFORESEEN FIELD CONDITIONS IF MODIFICATIONS CONFORM TO MORRI TECHNICAL STANDARDS.
- 4. INSPECT EROSION CONTROL MEASURES AFTER EACH 1/2" OR GREATER RAINFALL. REPAIR ANY DAMAGE OBSERVED DURING THE INSPECTION.
- 5. EROSION CONTROL MEASURES SHALL BE REMOVED ONLY AFTER SITE CONSTRUCTION IS COMPLETE WITH ALL SOIL SURFACES HAWING AN ESTABLISHED VEGETATIVE COVER.
- INSTALL EROSION CONTROLS ON THE DOWNSTREAM SIDE OF STOCKPILES AND PROVIDE TEMPORARY SEEDING ON STOCKPILES WHICH ARE TO REMAIN IN PLACE FOR MORE THAN 7 DAYS.
- INSTALL CHECK DAMS WITHIN DRAINAGE-DITCHES AND IN FRONT OF SILT FENCING IN ANY LOW AREA ALL IN ACCORDANCE MITH WDNR TECHNICAL STANDARDS.
- 8. EROSION CONTROL FOR UTILITY CONSTRUCTION (STORM SEWER, SANITARY SEMER, WATER MAIN, ETC.):
 A. PLACE EXCAVATED TRENCH MATERIAL ON THE HIGH SIDE OF THE TRETICH.
 B. BACKFILL, COMPACT, AND STABILIZE THE TRETICH MIMEDIATELY AFTER PIPE CONSTRUCTION.
 C. DISCHARGE TRETICH WATER INTO A SEDMENTATION BASIN OR FLITERING TANK IN ACCORDANCE WITH THE DEWATERING TECHNICAL STANDARD MO. 1061 PRIOR TO RELEASE INTO THE STORM SEWER, RECEVENDS STREAM, OR DRAINAGE DITCH.
- 10. NISTALL TYPE D INLET PROTECTION AROUND ALL STORM SEWER INLETS AND CATCH BASINS THAT MAY RECEIVE RUNOFF FROM AREAS UNDER CONSTRUCTION. REFER TO WISDOT FDM FOR RESPECTIVE DETAILS.
- 11. APPLY ANIONIC POLYMER TO DISTURBED AREAS IF EROSION BECOMES PROBLEMATIC.
- 12. ADDITIONAL EROSION CONTROL MEASURES, AS REQUESTED BY STATE INSPECTORS, LOCAL INSPECTORS, AND/OR ENGINEER SHALL BE INSTALLED WITHIN 24 HOURS OF REQUEST.
- 13. ALL SLOPES EXCEEDING 5:1 (20%) SHALL BE STABILIZED WITH A CLASS II, TYPE B EROSION MATTING AND DRAINAGE SWALES SHALL BE STABILIZED WITH CLASS I, TYPE BEROSION MATTING OR APPLICATION OF A WOOT APPROVED POLYMER SOL STABILIZATION TREATMENT OR A COMBINATION THEREOF, AS RECOURTED. CONTRACTOR SHALL PROVIDE PRODUCT SPECIFICATIONS TO PROJECT ENGINEER FOR APPROVIAL
- 14. CONTRACTOR SHALL TAKE ALL NECESSARY STEPS TO CONTROL DUST ARISING FROM CONSTRUCTION OPERATIONS, REFER TO WIDIN TECHNICAL STANDARD
- 15 CONTRACTOR TO PROVIDE SOLID UD OR METAL PLATE ON ALL OPEN MANHOLES DURING CONSTRUCTION TO MINIMIZE SEDIMENT FROM ENTERING THE STORM SEVER SYSTEM.

GRADING AND SEEDING NOTES

- 1. ALL DISTURBED AREAS IN R.O.W. SHALL BE SODDED IMMEDIATELY FOLLOWING GRADING ACTIVITIES SOD TO BE IN ACCORDANCE WITH LANDSCAPE PLAN.
- 2. ALL PROPOSED GRADES SHOWN ARE FINISHED GRADES CONTRACTOR SHALL VERIFY ALL GRADES, MAKE SURE ALL AREAS DRAIN PROPERLY AND SHALL REPORT ANY DISCREPANCIES TO THE ENGINEER PRIOR TO CONSTRUCTION.
- 3. CONTRACTOR SHALL PROTECT ADJACENT PROPERTIES WITH SLIT FENONG OR OTHER APPLICABLE MEASURES FOR EROSION CONTROL UNTIL CONSTRUCTION IS COMPLETED AND NOTICE OF TERMINATION FILED.
- 4. CONTRACTOR SHALL WATER ALL HEWLY SODDED AREAS IN R.O.W. DURING THE SUMMER MONTHS WHENEVER THERE IS A 7 DAY LAPSE WITH 110 SIGNIFICANT RANGFALL.
- 5 CONTRACTOR TO DEEP TILL ALL COMPACTED PERMOUS SURFACES PRIOR TO SODDING OR SEEDING AND MULCHING. THIS MUST BE VERIFIED BY THE ENGINEER AS PART OF THE AS-BUILT CERTIFICATION.
- 6. THE CONTRACTOR SHALL NOTIFY THE CITY OF MADISON A MINIMUM OF TWO (2) WORKING DAYS IN ADVANCE OF ANY SOIL DISTURBING ACTIVITY.





TO GETAM LOCATIONS OF PARTICIPANT UNDERGROUND FACULTIES BETTINE YOU NO N WOYACSN





GORMAN G COMPANY, INC.

REAL ESTATE DEVELOPMENT & MANAGEMENT

200 N. MAIN STREET **OREGON, WI 53575**

JSD Profosskand Servicas, In · Ivelneers · Serveyors · Planver

"BUTLDING RELATIONSHIPS HTTH A COMMITMENT TO CLIENT SATISFACTIO IROUGH TRUST, QUALITY AND EXPERIE MADISON REGIONAL OFFICE 161 HORIZON DRIVE, SUITE 101 VERONA, WISCONSIN 53593 608 848 5060 PHONE | 508 848 2255 FAX

MADISON MILWAUKEE KENOSHA APPLETON WWW.JSdinc.com

SPECIFIC **PLAN** COMPANY **IMPLEMENTATION UNION CORNERS** જ GORMAN

MADISON, WI

Project No.	14-6435	
Plot Date:		
Drawn by:	JFL, MG, KJY	
Date	Issue Description	
GDP	06-25-14	
SIP	11-05-14	

1-14-15


Sheet Title

UDC/PC

RESUBMITTAL

GRADING AND EROSION CONTROL PLAN

Sheet No.

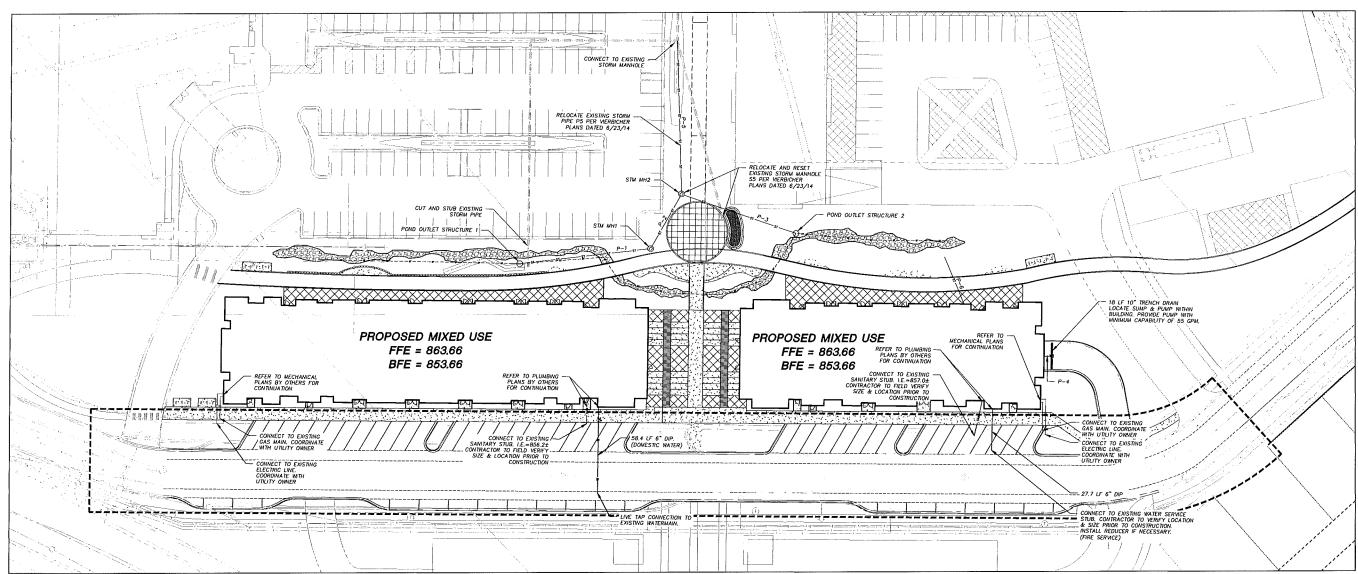

PROPOSED STORM SEWER STRUCTURES SCHEDULE					
LABEL	INVERTELEV. (FT)	RIM ELEV. (FT)	DEPTH (FT)	STRUCTURE DESCRIPTION	GRATE
POND OUTLET STRUCTURE 1	855.45	860.00	4.55	36" DIA, CONCRETE INLET	TYPE C GRATE
STMMH1	854.92	862.50	7.58	36°DIA. CONCRETE INLET	TYPE C GRATE
POND OUTLET STRUCTURE 2	854.92	860.00	5.08	2X3'PRECAST BOX	TYPE C GRATE
STM MH2	855.35	852.50	6.07	36*DIA. CONCRETE INLET	TYPE C GRATE
TRENCH DRAIN	851.91	853,51	1.02	10° CONCRETE TRENCH DRAIN	R-4990-CX, TYPE C COVER

	PROPOSED STORM SEWER PIPE SCHEDULE						
PIPE LABEL	FROM	то	LENGTH (FT)	INVERT ELEVATION (FT)	DISCHARGE ELEVATION (FT)	SLOPE (%)	PIPE SIZE & TYPE
P-1	POND OUTLET STRUCTURE 1	STMMH1	90	856.34	855.45	1.00%	12"HDPE
P-2	STMMH1	STMMH2	43	855.35	854.92	1.00%	12"HDPE
P-3	POND OUTLET STRUCTURE 2	STMMH2	83	855.33	854.92	0.50%	12"HDPE
P-4	TRENCH DRAIN	BUILDING	20,00	851.91	851.71	1.00%	6°PVC
P-5	STMM-12	EX STM MH	104.25	854.82	854.30	0.50%	18°RCP
P-6	BUILDING	BIORETENTION POND	34.43	960.34	960.00	1.00%	6°PVC

PROPERTY LINE STORM SEWER
SIN SANITARY SEWER

7//////// TRENCH PATCH LIMITS
ASPHALTIC PAVEMENT

CONCRETE PAVEMENT

WATER MAIN

GAS SERVICE (DESIGN BY UTILITY)

UNDERGROUND ELECTRIC SERVICE (DESIGN BY UTILITY)

UNDERGROUND TELEPHONE SERVICE (DESIGN BY UTILITY)

GENERAL NOTES

- 1. REFER TO THE TOPOGRAPHIC AND UTILITY SURVEY FOR EXISTING CONDITIONS NOTES AND LEGEND.
- 2 EXISTING CONDITIONS SURVEY DATED 11-18-2013 ANY DISCREPANCIES TO BE REPORTED TO JSD IMMEDIATELY UPON DISCOVERY.
- 3. ALL WORK IN THE ROW SHALL BE III ACCORDANCE WITH THE CITY OF MADISON STANDARD SPECIFICATIONS FOR PUBLIC WORKS CONSTRUCTION.
- JSD SHALL BE HELD HARMLESS AND DOES NOT WARRANT ANY DEVIATIONS BY THE OWNER/CONTRACTOR FROM THE APPROVED CONSTRUCTION PLANS THAT MAY RESULT IN DISCIPLINARY ACTIONS BY ANY OR ALL REGULATORY AGENCIES.
- 5 DRAWING FOR REVIEW NOT FOR CONSTRUCTION UNLESS OTHERWISE NOTED IN THE TITLE BLOCK.

UTILITY NOTES

- DIMENSIONS TAKE PRECEDENCE OVER SCALE. CONTRACTOR TO VERIFY ALL DIMENSIONS IN FIELD
- IF ANY ERRORS, DISCREPANCIES, OR OMISSIONS WITHIN THE PLAN BECOME APPARENT, IT SHALL BE BROUGHT TO THE ATTENTION OF THE ENGINEER PRIOR TO CONSTRUCTION SO THAT CLARIFICATION OR REDESIGN MAY OCCUR.
- 3. LENGTHS OF ALL UTILITIES ARE TO CENTER OF STRUCTURES OR FITTINGS AND MAY VARY SLIGHTLY FROM PLAN. LENGTHS SHALL BE VERIFIED IN THE FIELD DURING CONSTRUCTION
- 4. ALL CONSTRUCTION SIGNING TO BE IN ACCORDANCE WITH THE CITY OF MADISON AND WISCONSIN DEPARTMENT OF TRANSPORTATION REQUIREMENTS.
- 5. THE CONTRACTOR SHALL INSTALL A PEDESTRIAN FENCE AROUND ALL EXCAVATIONS TO BE LEFT OPEN OVER NIGHT AS REQUIRED.
- THE PROPOSED IMPROVEMENTS MUST BE CONSTRUCTED IN ACCORDANCE WITH ENGINEERING PLANS DESIGNED TO MEET ORDINANCES AND REQUIREMENTS OF THE MUNICIPALITY AND MISDOT, WIDCOMM, AND WIDNE.
- PRIOR TO CONSTRUCTION, THE CONTRACTOR IS RESPONSIBLE FOR:

 * EXAMBING ALL SITE CONDITIONS RELATIVE TO THE CONDITIONS INDICATED ON THE ENGINEERING DRAWINGS, ANY DISCREPANCIES ARE TO BE REPORTED TO THE ENGINEER AND RESOLVED PRIOR TO THE FLAT OF CONSTRUCTION.

 * GETAMBING ALL PERMITS INCLUDING PERMIT COSTS, TAP FEES, METER DEPOSITS, BONDS, AND ALL OTHER FEES REQUIRED FOR PROPOSED WORK TO OBTAIN OCCUPANCY.

 * VERIFICIAL SILE SEVATIONS AND NOTETING ENGINEER OF ANY DISCREPANCY. NO WORK SHALL BE PERFORMED UNTIL THE DISCREPANCY IS RESOLVED.
- VOID HIM O HALT ELEVATIONS AND HOLD THAT CHARLY OF ANY UNDERGROUND IMPROVEMENTS.

 NOTEHING ALL UTILITIES PRIOR TO THE INSTALLATION OF ANY UNDERGROUND IMPROVEMENTS.

 NOTEHING THE DESIGN ENGINEER AND MUNICIPALITY 48 HOURS PRIOR TO THE START OF CONSTRUCTION TO ARRANGE FOR APPROPRIATE CONSTRUCTION OBSERVATION.
- THE PRIME CONTRACTOR IS RESPONSIBLE FOR COORDINATING ALL CONSTRUCTION WITH OTHER CONTRACTORS INVOLVED WITH CONSTRUCTION OF THE PROPOSED DEVELOPMENT AND FOR REPORTING ANY ERRORS OR DISCREPANCIES BETWEEN THESE PLANS AND PLANS PREPARED BY OTHERS.
- 10. ANY SANTARY SEWER, SANTARY SEWER SERVICES, WATER MAIN, WATER SERVICES, STORM SEWER, OR OTHER UTILITIES, WHICH ARE DAMAGED BY THE CONTRACTOR'S EXPENSE.
- 11. CONTRACTOR IS RESPONSIBLE FOR SITE SAFETY DURING THE CONSTRUCTION OF IMPROVEMENTS.
- 12 CONTRACTOR SHALL HOTIFY THE CITY OF MADISON PUBLIC WORKS DEPARTMENT A MINIMUM OF 48 HOURS BEFORE CONNECTING TO PUBLIC UTILITIES.
- 13. ALL PRIVATE STORM BUILDING PIPE AND TUBING SHALL CONFORM TO S&B 384.30, TABLE 384.30-6.
- 14. WATER SERVICE SHALL BE MAINTAINED AT ALL TIMES DURING CONSTRUCTION. CONTRACTOR TO FIELD VERIFY LOCATION AND SIZE. REPORT DISCREPANCIES TO ENGNEER PRIOR TO CONSTRUCTION. CONSTRUCTION TO BE IN ACCORDANCE WITH THE CITY OF MADISON STANDARD SPECIFICATIONS FOR PUBLIC WORKS CONSTRUCTION PART VI. CONTACT CITY OF MADISON DEPARTMENT OF PUBLIC WORKS 48 HOURS PRIOR TO CONSTRUCTION.
- 15. ALL WORK WITHIN THE RIGHT-OF-WAY SHALL BE INSTALLED PER CITY OF MADISON STANDARD SPECIFICATIONS FOR PUBLIC WORKS CONSTRUCTION.

 PRE-CONSTRUCTION MEETING WITH THE CITY OF MADISON IS REQUIRED PRIOR TO INSTALLATION.
- 16. THE CONTRACTOR SHALL DETERMINE LOCATION, DEPTH AND SIZE OF EXISTING SANITARY AND WATER SERVICES AND NOTIFY ENGINEER PRIOR TO CONSTRUCTION.



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200 N. MAIN STREET OREGON, WI 53575

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SPECIFIC PLAN COMPANY **IMPLEMENTATION UNION CORNERS** MADISON, WI જ

Project No. 14-6534 Plot Date: JLF, MG, KJY Drawn by:

GORMAN


Date Issue Description GDP 06-25-14 11-05-14 SIP UDC/PC 1-14-15 RESUBMITTAL

Sheet Title

UTILITY PLAN

Sheet No.



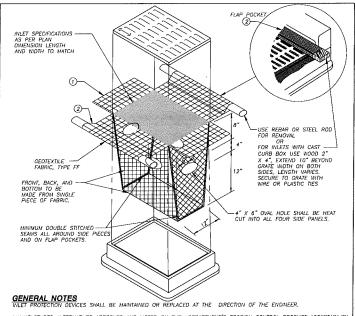

MANUFACTURED ALTERNATIVES APPROVED AND LISTED ON THE DEPARTMENT'S EROSION CONTROL PRODUCT ACCEPTABILITY LIST MAY BE SUBSTITUTED.

WHEN REMOVING OR MAINTAINING INLET PROTECTION, CARE SHALL BE TAKEN SO THAT THE SEDMENT TRAPPED ON THE GEOTEXTILE FABRIC DOES HOT FALL INTO THE MILET. AIM MATERIAL FALLING INTO THE INLET SHALL BE REMOVED IMMEDIATELY.


- ① FINISHED SIZE, INCLUDING FLAP POCKETS WHERE REQUIRED, SHALL EXTEND A MINIMUM OF 10* AROUND THE PERIMETER TO FACILITATE MAINTENANCE OR REMOVAL.
- (2) FLAP POCKETS SHALL BE LARGE ENOUGH TO ACCEPT WOOD 2X4.


INSTALLATION NOTES
DO NOT INSTALL PREIT PROTECTION TYPE D IN HILETS SHALLOWER THAN 30°, MEASURED FROM THE BOTTOM OF THE
MILET TO THE TOP OF THE GRATE.


TRIM EXCESS FABRIC IN THE FLOW LINE TO WITHIN 3" OF THE GRATE.


THE INSTALLED BAG SHALL HAVE A MINIMUM SIDE CLEARANCE, BETWEEN THE INLET WALLS AND THE BAG, NEASURED AT THE BOTTOM OF THE OVERTLOW HOLES, OF 3", WHERE NECESSARY THE CONTRACTOR SHALL CINCH THE BAG, USING PLASTIC ZIP, TIES, TO ACHIEVE THE 3", CLEARANCE, THE TIES SHALL BE PLACED AT A MAXIMUM OF 4" FROM THE BOTTOM OF THE BAG.




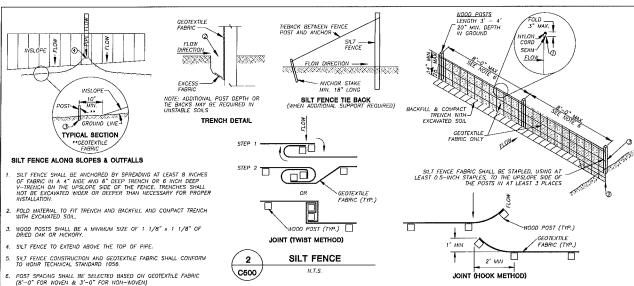


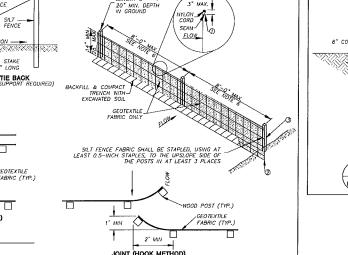

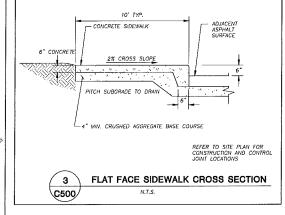

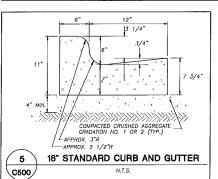

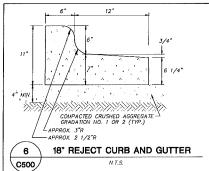

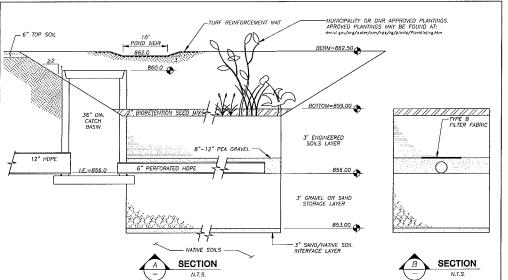

GENERAL NOTES:


ALL CONSTRUCTION PRACTICES SHALL MEET THE SPECIFICATIONS OF THE WOHR TECHNICAL STANDARD 1004 — BIORETENTION FOR INFILTRATION. IT IS THE CONTRACTOR'S RESPONSIBILITY TO OBTAIN A COPY OF THIS STANDARD AND CONSTRUCT THE BIORETENTION DEVICE IN ACCORDANCE WITH THE REQUIREMENTS OUTLINED THEREIN.

- 2. CONTRACTOR SHALL INSTALL 36" OF ENGINEERED SOIL CONSISTING OF: 40% ASTM C33 SAND, 30% CERTIFIED COMPOST (SEE GENERAL NOTE 3), AND 30% TABLED COMPOST (SEE GENERAL NOTE 3).
- 3. CERTIFIED COMPOST SHALL CONSIST OF: >40% ORGANIC MATTER, <60% ASH CONTENT, ph OF 6-8, AND MOISTURE CONTENT OF 35-50% BY WEIGHT.
- 4. SAID/NATIVE SOIL INFILTRATION LAYER SHALL BE FORMED BY A LAYER OF SAID 3 INCHES DEEP, WHICH IS VERTICALLY MIXED WITH THE NATIVE SOIL TO A DEPTH OF 2-4 INCHES.

- RUNOFF MUST INFILITATE WITHIN 48-HOURS. BASINS UNABLE TO MAINTAIN THESE RATES MUST BE DEEP TILLED, REGRADED, AND IF NECESSARY REPLANTED TO RESTORE ORIGINAL INFILITATION RATES.
- ALL WORK TO BE CONDUCTED IN CONFORMANCE WITH APPLICABLE LOCAL, REGIONAL, AND STATE STORMWATER STANDARDS FOR THE PROJECT SITE AS APPROVED BY THE REGULATORY ENGINEER.
- 9. OWNER OR CONTRACTOR MUST CONSULT LANDSCAPE ARCHITECT OR ECOLOGICAL PLANTING AGENCY FOR APPROPRIATE PLANTS AND PLANTING CONFIGURATIONS.
- 10. BIORETENTION DEVICE SHALL NOT BE INSTALLED UNTIL THE SITE IS STABILIZED
- 11. FILTER FABRIC SHALL COVER THE UNDERDRAIN AND SHALL NOT EXTEND LATERALLY FROM EITHER SIDE OF THE PIPE MORE THAN TWO FEET.
- 12. ONCE CONSTRUCTION OF BIORETENTION DEVICE BEGINS, THE BIORETENTION DEVICE SHALL BE CORDONED OFF AND PROTECTED FROM COMPACTION FROM HEAVY EQUIPMENT.
- 14. ENGINEERED SOIL PLACED IN THE BIORETENTION DEVICE SHALL NOT BE COMPACTED.
- 15. PLACEMENT OF ENGINEERED SOILS SHALL BE SUSPENDED IN PERIODS OF RAINFALL AND SNOWMELT AND SHALL REMAIN SUSPENDED IN PONDED WATER IS

INFI TRATION DEVICES ARE DESIGNED IN ACCORDANCE WITH THE SPECIFICATIONS OF THE WISCONSIN DEPARTMENT OF NATURAL RESOURCES (WDNR), COUNTY, INFLINATION DEVICES AND DESIGNED IN ACCORDANCE WITH THE SPECIFICATIONS OF THE WISCONSIN DEPARTMENT OF INTURAL RESOURCES (WONR), COUNTY, MUNICIPALTY, AND ENGINEERING STANDARD OF CARE, ALL DESIGNATED INFLITATION AREA (E.g., RAM GARDEL, INFLITATION BASINS, BIORETENTHON DEVICES) SHALL BE FERCED PRIOR TO CONSTRUCTION AND REMAIN UNDISTURBED AND PROPECTED DURING THE CONSTRUCTION OF PROPOSED SITE IMPROVMENTS. PROPOSED BOORTENHON DEVICES SHALL NOT BE CONSTRUCTION OF UNDIFFICATION OF PROPOSED SITE IMPROVMENTS. FOR CONSTRUCTION OF PROPOSED SITE IMPROVMENTS IN THE PR

THE CONTRACTOR IS REQUIRED TO PROVIDE QUALIFIED STAFF FOR INSPECTION AND OBSERVATION OF THE CONSTRUCTION ACTIVITIES RELATING TO ALL JOB SITE REQUIRANCE INCLUDING THE PROTECTION AND CONSTRUCTION OF ALL STORMANTER MANAGEMENT FEATURES. ANY OBSERVATION OF FLAN OR SITE DISCREPANCES SHALL BE REPORTED TO THE ENDINEER OF RECORD PRIOR TO CONSTRUCTION.

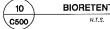

BIORETENTION DEVICE

COMPANY **MENTATION UNION CORNERS** જ GORMAN IMPLE

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> 200 N. MAIN STREET OREGON, WI 53575

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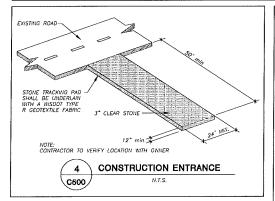
Project No.	14-6534
Plot Date:	
Drawn by:	JLF, MG, KJY
Date	Issue Description
GDP	06-25-14
SIP	11-05-14
UDC/PC RESUBMITTAL	1-14-15


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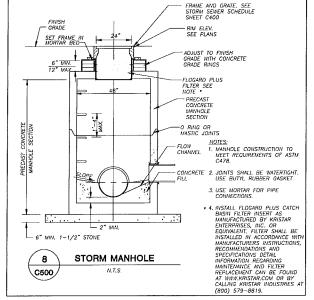
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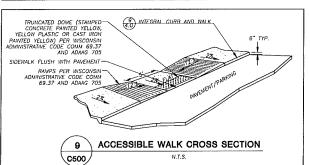
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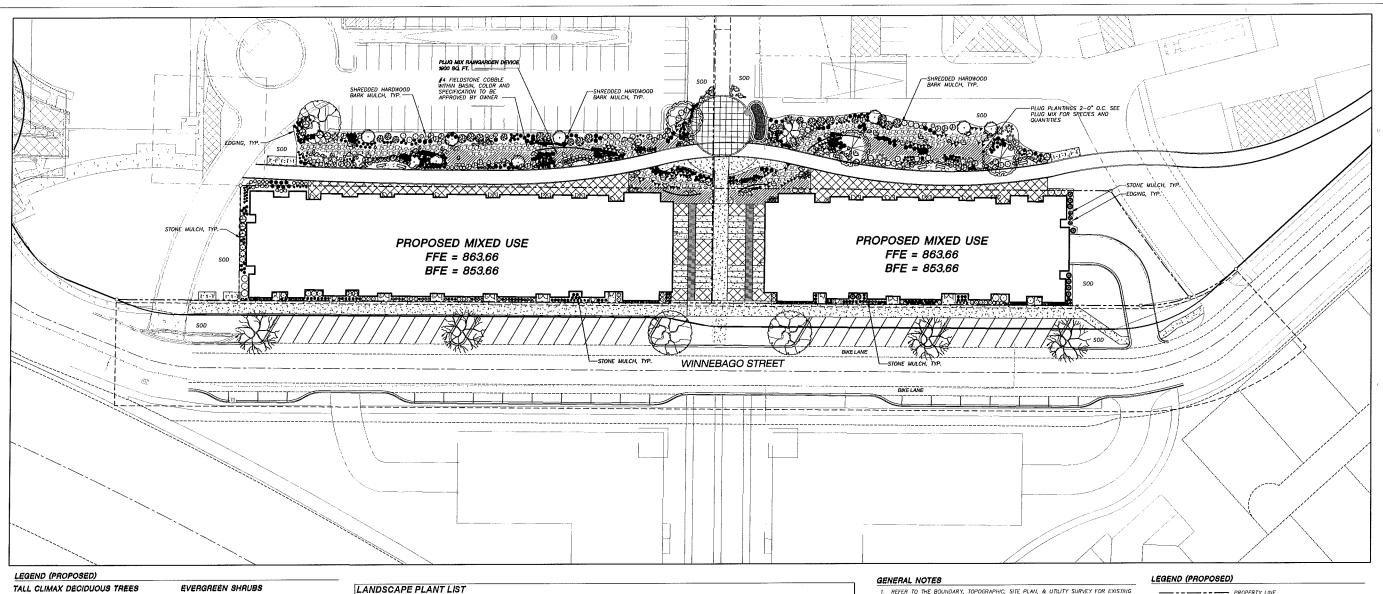
C500









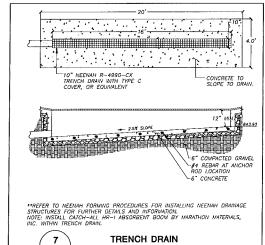

ROOT LS POINTS TOTAL POINTS

150

184

172

140

330 1314

3688

TALL CLIMAX DECIDUOUS TREES

PERENNIALS



Karl Foerester Feather Ree

ORNAMENTAL GRASSES

ORNAMENTAL TREES







DECIDUOUS SHRUBS

0

Knack Out Rose

Floribunda Rose

Gold Star Potentillo \odot Gro-Lo Sumac

Red Twig Dogwood

Yellow Twig Dogwood

Spring Red Compact Cranberrybush Vib

		APE PLANT LIST					TAT
		COMMON NAME IX DECIDUOUS TREES	BOTANICAL NAME	SIZE	ROOT	LS POINTS	TOT
	3	Autumn Blaze Maple	ACER x freemanii 'Jeffersred'	2-1/2*Cal.	888	35	
	4	Burt Oak	QUERCUS macrocarpa	2-1/2" Cal.	888	35	
	ORNAMENT	AL TREES					
	3	Eastern Redbud (Tree Form)	CERCIS canadensis 'Columbus Strain'	1 1/2°Cal.	8&8	15	
	1	Cornus alternifolia 'Argentea'	PAGODA dogwood	1 1/2°Cal.	B&B	15	
	10	Little King River Birch	BETULA nigra 'Little King' FOX VALLEY	1 1/2" Cal.	₿&B	15	
	DECIDUOUS	SHRUBS					
	35	Iroquois black chokeberry	ARONIA melanocarpa 'Morton' IROQUOIS BEAUTY	12-24" Min. Ht.	#3 Conl.	3	
	3	Endless Summer Hydrangea	HYDRANGEA macrophylla 'Endless Summer'	12-24" Min. Ht	#3 Conl.	3	
	11	Indian Current Corelberry	SYMPHORICARPOS orbiculatus	12-24" Min. Ht	#3 Cont.	3	
	55	Knock Out Rose	ROSA 'RADrazz'	12-24" Min. HL	#3 Conl.	3	
	- 11	Floribunda Rose	ROSA 'Nearly Wild'	12-24" Mn. Ht	#3 Cont.	3	
	35	Gold Star Potentilla	POTENTILLA fruiticosa 'Gold Star'	12-24" Mn. Ht.	#3 Cont.	3	
	9	Gro-Lo Surnac	RHUS aromactica 'Gro-Low'	12-24" Mn. Ht	#3 Cont.	3	
ed Grass	12	Red Twig Dogwood	CORNUS sericea 'Insanti'	12-24" Mn. HL	#3 Cont.	3	
rass	7	Yellow Twig Dogwood	CORNUS sericea 'Flaviramea'	12-24" Min. HL	#3 Cont.	3	
	10	Spring Red Compact Cranberrybush Vib.	VIBURNUMtrilobum 'Spring Red'	12-24" Mn. HL	#3 Cont.	3	
	EVERGREEN	I SHRUBS					
	10	Taunton Yew	TAXUS x media 'Tauntonii'	12-24" Min. HL	#3 Cont.	4	
	46	Mini Arcade Juniper	JUNIPERUS sabina 'Mni Arcade'	12-24° Min. Ht	#3 Cont.	4	
	PERENNIALS	3					
	43	Coreopsis Moonbeam	COREOPSIS verticitata	10 - 12"HL	# 1 Cont.	2	
	89	Little Spire Russian Sage	PEROVSKIA etriplicifolia 'Little Spire'	10 - 12"HL	#1 Cont.	2	
	28	Black-Eyed Susan	RUDIBECKIA fulgida var. fulgida	10 - 12"HL	#1 Cont.	2	
	86	Iris 'Caesar's Brother'	IRIS SIBERICA 'Ceasar's Brother'	10 - 12°HL	# 1 Cont.	2	
	21	May Night Salvia	SALVIA NEMEROSA Mainacht	10 - 12*HL	# 1 Cont.	2	
	ORNAMENTA	L GRASSES					
	52	Karl Foerester Feather Reed Grass	CALAMAGROSTIS x acutifiora 'Karl Foerester'	10 - 12"HL	# 1 Cont.	2	
	40	Dwarf Hameln Fountain Grass	PENNISETUM alopacuroides 'Hameln'	10 - 12"Ht	#1 Cont.	2	
	20	Blue Oat Grass	HELICTOTRICHON sempervirens	10 - 12"Ht	#1 Cont.	2	
	70	Little Bluestern	SCHIZACHYRIUM scoperium	10 - 12"HL	#1 Cont.	2	
	44	Big Bluestern	ANDROPOGON gerardii	10 - 12"HL	# 1 Conl.	2	
	165	Prairie Dropseed	SPOROBOLOUS heterolepsis	10 - 12"Ht	#1 Cont.	2	
	657	Common Oak Sedge	CAREX pensylvenica	PLUG	PLUG	2	

- REFER TO THE BOUNDARY, TOPOGRAPHIC, SITE PLAN, & UTILITY SURVEY FOR EXISTING CONDITIONS NOTES AND LEGEND.
- ALL WORK IN THE ROW AND/OR PUBLIC EASEMENTS SHALL BE IN ACCORDANCE WITH THE CITY OF MADISON STANDARD SPECIFICATIONS FOR PUBLIC WORKS CONSTRUCTION AND PERFORMED BY A CITY LICENSED CONTRACTOR.
- JSD SHALL BE HELD HARMLESS AND DOES NOT WARRANT ANY DEMATIONS BY THE OWNER/CONTRACTOR FROM THE APPROVED CONSTRUCTION PLANS THAT MAY RESULT IN DISCIPLIARY ACTIONS BY ANY OR ALL REGULATORY ACENCIES.
- 4. DRAWING FOR REVIEW NOT FOR CONSTRUCTION UNLESS OTHERWISE HOTED IN THE TITLE BLOCK.
- 5. THE LANDSCAPE CONTRACTOR SHALL COORDINATE ALL FINE GRADING AND TOPSOILING WITH GENERAL CONTRACTOR
- 6. REFER TO SHEET LZOO FOR ADDITIONAL DETAILS, NOTES AND SPECIFICATION MFORMATION INCLUDING MATERIALS, GUARANTEE AND EXECUTION RELATED TO LANDSCAPE PLAN

Raingarden Plug Plant Mi	x 1900 sq. ft.		
Botanical Name	Common Name	Quantity	Spacing
Permanent Grasses:			
Carex grayii	Common Bur Sedge	26	2'-0" On Center
Carex stipata	Common Fox Sedge	26	2'-0" On Center
Panicum virgatum	Switch Grass	26	2'-0" On Center
Spartina pectinata	Prairie Cord Grass		2'-0" On Center
Forbs:			
Aster novae-angilae	New England Aster	26	2'-0" On Center
Asclepias incarnata	Swamp Milkweed	26	2'-0" On Center
Echinacea purpurea	Broad-Leaved Purple Coneflower	26	2'-0" On Center
Eryngium yuccifolium	Rattlesnake Master	26	2'-0" On Center
Eupatorium maculatum	Spotted Joe-Pye Weed	26	2'-0" On Center
Liatris spicata	Marsh Blazing Star	26	2'-0° On Center
Lobelia cardinalis	Cardinal Flower	26	2'-0" On Center
Monarda fistulosa	Wild Bergamot	26	2'-0" On Center
Penstemon digitalis	Foxglove Beardtongue	26	2'-0" On Center
Pycnanthemum virginianum	Common Mountain Mint	26	2'-0" On Center
Ratibida pinnata	Yellow Coneflower	26	2'-0" On Center
Rudbeckia hirta	Black-Eyed Susan	26	2'-0" On Center
Veronicastrum virginianum	Culver's Root	26	2'-0" On Center
Zizia aurea	Golden Alexanders	26	2'-0" On Center
	TOTAL	442	

	RIGHT-OF-WAY
	WINNEBAGO STREET PUBLIC WORKS APPR
	FUTURE PATH
	BUILDING LINE
	EDGE OF PAVEMENT
xxx	PROPOSED RAILING
	18" STANDARD CURB & GUTTER
	18" REJECT CURB & GUTTER
. 4 .	PROPOSED CONCRETE PAVEMENT
	PROPOSED ASPHALT PAVEMENT
	POLYETHYLENE EDGING
	PLUG MIX RAINGARDEN AREA
	WASHED #4 FIELDSTONE COBBLE



JLF, KJY, MG Drawn by:

UNION CORNERS SPECIFIC

COMPANY

GORMAN &

Project No.

Plot Date:

Date Issue Description GDP 06-25-14 11-05-14 SIP

GORMAN

REAL ESTATE DEVELOPMENT & MANAGEMENT

200 N. MAIN STREET

OREGON, WI 53575

JSD Profosskand Services, Inc.

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PLAN

IMPLEMENTATION


MADISON, WI

14-6534

Sheet Title

OVERALL LANDSCAPE PLAN

Sheet No.

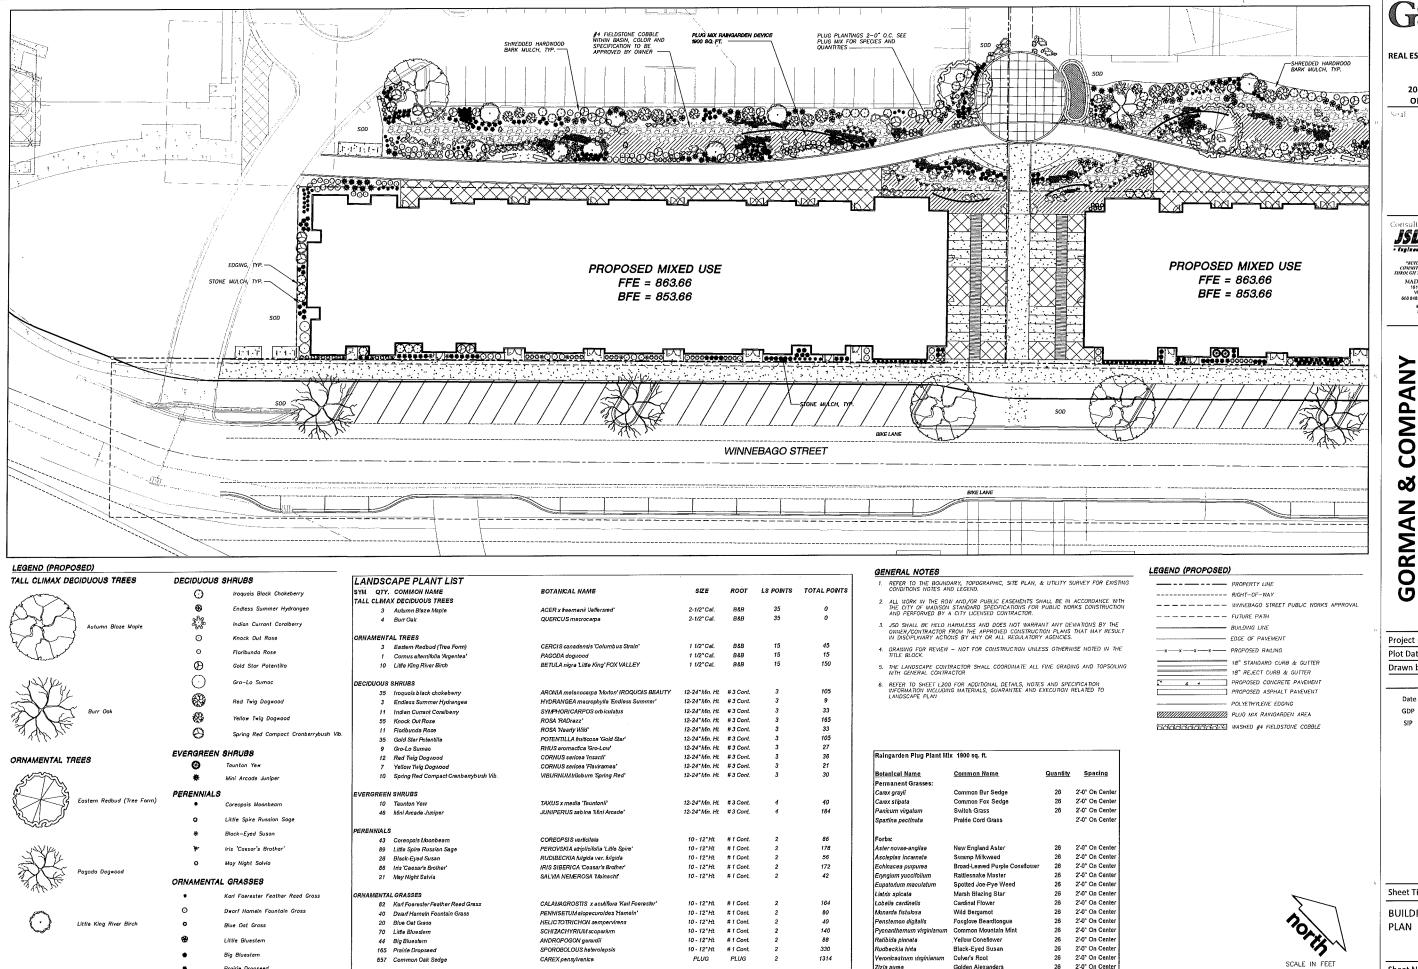

TOTAL POINTS:

TOTAL

GORMAN

REAL ESTATE DEVELOPMENT & MANAGEMENT

> 200 N. MAIN STREET **OREGON, WI 53575**

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SPECIFIC PLAN COMPANY **IMPLEMENTATION UNION CORNERS** MADISON, WI Ø


Project No.	14-6534
Plot Date:	
Drawn by:	JLF, KJY, MG

Issue Description GDP 06-25-14 11-05-14

Sheet Title

BUILDING 4 LANDSCAPE

Sheet No.

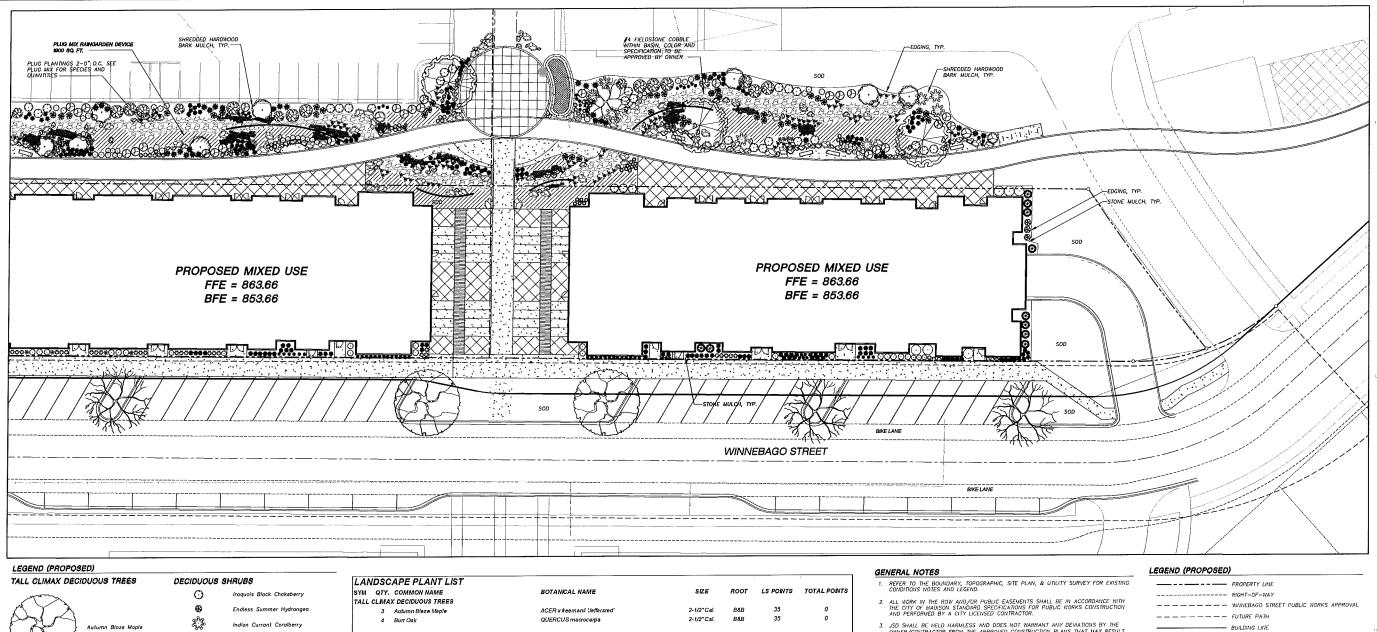





ORNAMENTAL TREES





rry ngea	LA SYM TAL
ry	ORN
	DEC
ranberrybush Vib.	
	EVE
	PERI

3	Autumn Blaze Maple	ACER x freemanii 'Jeffersred'
4	Burr O≅k	QUERCUS macrocarpa
ORNAMENT	AL TREES	
3	Eastern Redbud (Tree Form)	CERCIS canadensis Columbus
l .		010001

CIDUOUS SHRUBS

Gro-Lo Sumac	
Red Twig Dogwood	
Yellow Twig Dogwood	
Spring Red Compact Cranberrybush	Vib

Knock Out Rose

Floribundo Rose

Gold Star Potentill

EVERGREEN SHRUBS

0

Ø

 \odot

88

(3)

⊌	Taunton Yew		
*	Mini Arcade Junipe		

PERENNIALS

O	Little Spire Russian
*	Black-Eyed Susan

ORNAMENTAL GRASSES

•	Karl Foerester Feather Reed Grass
0	Dwarf Hameln Fountain Grass
0	Blue Oat Grass

1 1/2"Cal. 888 150

1 1/2"Cal. 10 Little King River Birch BETULA nigra 'Little King' FOX VALLEY 1 1/2"Cal. 35 Iroquois black chokeberry ARONIA melanocarpa "Morton" IROQUOIS BEAUTY 12-24" Min. Ht. # 3 Cont. 12-24" Min. Ht. #3 Cont. HYDRANGEA macrophyila Endless Summer 3 Endless Summer Hydrangea 12-24" Min. HL #3 Cont. SYMPHORICARPOS orbiculatus 11 Indian Current Coralberry 12-24"Min. HL #3 Conl. 12-24"Min. HL #3 Conl. 55 Knock Out Rose ROSA "RADrazz" 11 Floribunda Rose ROSA 'Nearly Wild' 35 Gold Star Potentilla POTENTILLA fruiticosa 'Gold Star' 12-24" Min. Ht. # 3 Cont. RHUS aromactica 'Gro-Low' CORNUS sericea 'Insanti' 12-24" Min. Ht. # 3 Cont. 9 Gro-Lo Sumac 12-24"Mn. HL #3 Conl. 12 Red Twig Dogwood

Yellow Twig Dogwood CORNUS sericea 'Flaviramea 10 Spring Red Compact Cranbarry bush Vib

165 Prairie Dropseed

GKEE	SHRUBS				
10	Taunton Yew	TAXUS x media 'Teuntonii'	12-24" Min. Ht	#3 Cont.	4
46	Mini Arcade Juniper	JUNIPERUS sabīna 'Mni Arcade'	12-24" Min. HL	#3 Cont.	4
NNIALS	}				
43	Coreopsis Moonbeam	COREOPSIS verticilata	10 - 12"Ht	# 1 Cont.	2
89	Little Spire Russian Sage	PEROVSKIA atriplicifolia 'Little Spire'	10 - 12"HL	# 1 Cant.	2
28	Black-Eyed Susan	RUDIBECKIA fulgida var. fulgida	10 - 12*HL	#1 Cont.	2
86	Iris 'Caesar's Brother'	IRIS SIBERICA 'Ceasar's Brother'	10 - 12"Ht	# 1 Conl.	2
21	May Night Salvia	SALVIA NEMEROSA "Mainacht"	10 - 12"HL	# 1 Cont.	2
MENTA	LGRASSES				
82	Karl Foerester Feather Reed Grass	CALAMAGROSTIS x acutifiora 'Karl Foerester'	10 - 12"HL	# f Cont.	2
40	Dwarf Hameln Fountain Grass	PENNISETUM alopecuroides 'Hameln'	10 - 12*HL	#1 Cont.	2
20	Blue Oat Grass	HELICTOTRICHON sempervirens	10 - 12"HL	#1 Cont.	2
70	Little Bluestern	SCHIZACHYRIUM scoperium	10 - 12"Ht	# 1 Cont.	2
44	Big Bluestern	ANDROPOGON gerardii	10 - 12"HL	#1 Cont.	2

SPOROBOLOUS helerol

CAREX pensylvanica

- JSD SHALL BE HELD HARMLESS AND DOES NOT WARRANT ANY DEVIATIONS BY THE OWNER/CONTRACTOR FROM THE APPROVED CONSTRUCTION PLANS THAT MAY RESULT IN DISCIPLINARY ACTIONS BY ANY OR ALL REGULATORY ACENCIES.
- 4. DRAWING FOR REVIEW HOT FOR CONSTRUCTION UNLESS OTHERWISE NOTED IN THE TITLE BLOCK.
- 5. THE LANDSCAPE CONTRACTOR SHALL COORDINATE ALL FINE GRADING AND TOPSOLING WITH GENERAL CONTRACTOR
- 6. REFER TO SHEET L200 FOR ADDITIONAL DETAILS, NOTES AND SPECIFICATION INFORMATION INCLUDING MATERIALS, GUARANTEE AND EXECUTION RELATED TO LANDSCAPE PLAN

105

165

105 27

140

330 1314

12-24" Mn. Ht. #3 Cont. 12-24* Min. Ht. #3 Cont.

10 - 12 Ht # 1 Cont.

PLUG


TOTAL POINTS:

PLUG

Raingarden Plug Plant Mix 1900 sq. ft.					
Botanical Name	Common Name	Quantity	Spacing		
Permanent Grasses:					
Carex grayii	Common Bur Sedge	26	2'-0" On Center		
Carex stipata	Common Fox Sedge	26	2'-0" On Center		
Pankum virgatum	Switch Grass	26	2'-0" On Center		
Spartina pectinata	Prairie Cord Grass		2'-0" On Center		
Forbs:					
Aster novae-angilae	New England Aster	26	2'-0" On Center		
Asclepias incarnata	Swamp Milkweed	26	2'-0" On Center		
Echinacea purpurea	Broad-Leaved Purple Conellower	26	2'-0" On Center		
Erynglum yuccifolium	Rattlesnake Master	26	2'-0" On Center		
Eupatorium maculatum	Spotted Joe-Pye Weed	26	2'-0" On Center		
Liatris spicata	Marsh Blazing Star	26	2'-0" On Center		
Lobelia cardinalis	Cardinal Flower	26	2'-0" On Center		
Monarda fistulosa	Wild Bergamot	26	2'-0" On Center		
Penstemon digitalis	Foxglove Beardtongue	26	2'-0" On Center		
Pycnanthernum virginianum	Common Mountain Mint	26	2'-0" On Center		
Ratibida pinnata	Yellow Coneflower	26	2'-0" On Center		
Rudbeckia hirta	Black-Eyed Susan	26	2'-0" On Center		
Veronicastrum virginianum	Culver's Root	26	2'-0" On Center		
Zizia aurea	Golden Alexanders	26	2'-0" On Center		
	TOTAL	442			

	PROPERTY LINE
	RIGHT-OF-WAY
	WINNEBAGO STREET PUBLIC WORKS APPROVAL
	FUTURE PATH
	BUILDING LINE
	EDGE OF PAVEMENT
x x x	PROPOSED RAILING
	18" STANDARD CURB & GUTTER
	18" REJECT CURB & GUTTER
4 . 4 .	PROPOSED CONCRETE PAVEMENT
	PROPOSED ASPHALT PAVEMENT
	POLYETHYLENE EDGING
	PLUG MIX RAINGARDEN AREA

EN TEST SEE SEE SEE WASHED #4 FIELDSTONE COBBLE

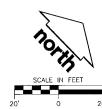

COMPANY **IMPLEMENTATION UNION CORNERS GORMAN &**

GORMAN R COMPANY, INC.

REAL ESTATE DEVELOPMENT & MANAGEMENT 200 N. MAIN STREET OREGON, WI 53575

JSD Profossional Services, Inc · Englacors · Surveyors · Placetors

MADISON REGIONAL OFFICE
181 HORIZON DRIVE, SUITE 101
VERONA, WISCONSIN 53593
608 848.5060 PHONE | 608 848.2255 FAX

MADISON | MILWAUKEE KENOSHA | APPLETON

www.jsdinc.com

SPECIFIC

PLAN

MADISON, WI


Project No.	14-653
Plot Date:	
Drawn by:	JLF, KJY, MO


Issue Description
06-25-14
11-05-14


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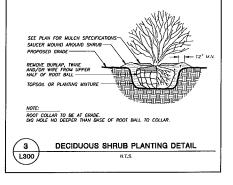
BUILDING 5 LANDSCAPE PLAN

Sheet No.



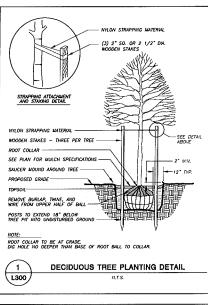

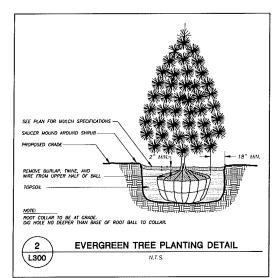

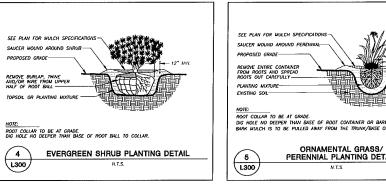

SYM	OTY	COMMON NAME	BOTANICAL NAME	SIZE	ROOT	LS POINTS	TOTAL POINT
	•	SHRUBS	De l'Alliera III.		.,		
,	3	Endless Summer Hydrangea	HYDRANGEA macrophylla 'Endless Summer'	12-24"Min. HL	#3 ConL	3	9
	9	Gro-Lo Sumac	RHUS aromactica 'Gro-Low'	12-24"Mn. Ht	#3 Cont.	3	27
	29	Knock Out Rose	ROSA 'RADrazz'	12-24°Mn. HL	#3 Cont.	3	87
	10	Iroquois black chokeberry	ARONIA melanocarpa 'Morton' IROQUOIS BEAUTY	12-24"Mn. Ht	#3 Cont.	3	30
	3	Spring Red Compact Cranberrybush Vib.	VIBURNUMtrilobum 'Spring Red'	12-24"Mn. Ht	#3 Cont.	3	9
	2	Gold Star Potentilla	POTENTILLA fruiticosa 'Gold Star'	12-24°Mn. Ht	#3 Cont.	3	6
EVERG	REEN	SHRUBS					
	8	Taunton Yew	TAXUS x media 'Tauntonii'	12-24"Mn. HL	#3 Cont.	4	32
	4	Mini Arcade Juniper	JUNIPERUS sabina 'Mní Arcade'	12-24"Min. HL	#3 Cont.	4	16
PEREN	NIALS						
	39	Little Spire Russian Sage	PEROVSKIA atriplicifolia "Little Spire"	10 - 12°Ht.	# 1 Cont.	2	78
	10	Black-Eyed Susan	RUDIBECKIA fulgida var. fulgida	10 - 12*HL	#1 Cont.	2	20
	18	Coreopsis Moonbeam	COREOPSIS verticiteta	10 - 12°HL	# 1 Cont.	2	36
	2	Iris 'Caesar's Brother'	IRIS SIBERICA 'Ceaser's Brother'	10 - 12"HL	#1 Cont.	2	4
	3	May Night Salvia	SALVIA NEMEROSA "Mainacht"	10 - 12°HL	# 1 Cont	2	6
ORNAN	(ENTAI	GRASSES					
	47	Kerl Foerester Feather Reed Grass	CALANAGROSTIS x acutiflora 'Karl Foerester'	10 - 12"HL	# 1 ConL	2	94
	6	Blue Oat Grass	HELICTOTRICHON sempervirens	10 - 12°HL	#1 Conl.	2	12
	40	Little Bluestern	SCHIZACHYRIUMscoparium	10 - 12 HL	#1 ConL	2	80
	60	Prairie Dropseed	SPOROBOLOUS heterolepsis	10 - 12"HL	#1 Cont.	2	120
	11	Dwarf Hameln Fountain Grass	PENNISETUMalopecuroides 'Hameln'	10 - 12"HL	# 1 Cont.	2	22
	12	Common Oak Sedge	CAREX pensylvanica	PLUG	PLUG	2	24
						TOTAL POINTS:	712

LANDSCAPE NOTES AND SPECIFICATIONS

- 1. GENERAL: ALL WORK IN THE R-O-W AND PUBLIC EASEMENTS SHALL BE IN ACCORDANCE WITH THE CITY OF MADISON REQUIREMENTS. JSD SHALL BE HELD HARMLESS AND DOES NOT WARRANT ANY DEVATIONS BY THE OWNER/CONTRACTOR FROM THE APPROVED CONSTRUCTION PLANS THAT MAY RESULT IN DISCIPLINARY ACTIONS BY ANY OR ALL REQULATORY AGENCIES. LOCATE ALL UTLITES PRIOR TO CONSTRUCTION. THE CONTRACTOR IS RESPONSIBLE FOR REPAIRING MYY DAMAGE DONE TO UTILITYS. CONTRACTOR MUST CALL 1-BANDS THAN ENEAR EXISTENCE UTILITYS. PROTECT PREVIOUSLY INSTALLED WORK OF OTHER TRADES. CONTRACTOR IS RESPONSIBLE FOR STAKING THE PLANT MATERIALS FOR REVIEW BY OTHER PRIOR TO DIGGING AND PLACEMENT, THE LANDSCAPE CONTRACTOR SHALL COORDINATE ALL FINE GRADING AND RESTORATION WITH THE GRADING CONTRACTOR.
- 2. DELIVERY AND HANDLING: DO NOT DELIVER MORE PLANT MATERIALS THAN CAN BE PLANTED IN ONE DAY, DELIVER PLANTS WITH LEGIBLE IDENTIFICATION LABELS. PROTECT PLANTS DURING DELIVERY, IF THIS IS NOT POSSIBLE, PROTECT THAT STOCK NOT PLANTED BY STORING STOCK IN A SHADED AREA PROTECTING THE ROOT MASS WITH WET SOIL, MOSS OR OTHER SUITABLE MEDIA AND KEEPING WELL WATERED. DO NOT REMOVE CONTAINS GROWN STOCK FROM CONTAINERS BEFORE TIME OF PLANTING. DO NOT PICK UP CONTAINER ONLY WHEN WEATHER AND SOIL CONDITIONS ARE SUITABLE IN ACCORDANCE WITH LOCALLY ACCEPTED PRACTICES.
- 3. GURANTEE: THE CONTRACTOR SHALL GURANTEE ALL PLANTS THROUGH ONE (1) YEAR AFTER ACCEPTANCE BY OWNER. PLANTS SHALL BE ALVE AND IN GOOD HEALTHY AND FLOURISHING CONDITION AT THE END OF THE GURANTEE PERIOD. THE CONTRACTOR SHALL REPLACE
 WITHOUT COST TO THE OWNER ANY PLANTS THAT ARE DEAD OR NOT IN A VIGOROUS THROWING CONDITION. REPLACEMENT PLANTS SHALL BE OF THE SAME KIND AND SIZE AS ORIGINALLY SPECIFIED UNLESS OTHERWISE DIRECTED BY OWNER. RESTORE BEDS AS NECESSARY FOLLOW
 PLANT REPLACEMENT, INCLUDING BUT NOT LIMITED TO BEDDING, EDGING, MULCH, ETC. REPAIR DAMAGE TO OTHER PLANTING AREAS DURING PLANT REPLACEMENT, INCLUDING BUT NOT LIMITED TO BEDDING, EDGING, MULCH, ETC. REPAIR DAMAGE TO OTHER PLANTING AREAS DURING PLANT REPLACEMENT, INCLUDING BUT NOT LIMITED TO BEDDING, EDGING, MULCH, ETC.

 ALL TREES.
- 4. MATERIALS PLANTS: ALL PLANTS: ALL CONFORM TO THE AMERICAN STANDARD FOR NURSERY STOCK ANSI Z60.1-2004. PLANTS SHALL BE TRUE TO SPECIES AND VARIETY SPECIFIED AND NURSERY GROWN IN ACCORDANCE WITH GOOD HORTICULTURAL PRACTICES UNDER CLIMATIC CONDITIONS SIMILAR TO THOSE IN THE LOCALITY OF THE PROJECT FOR AT LEAST 2 YEARS. PLANTS SHALL BE FRESHLY DUG (DURING THE MOST RECENT FAVORABLE HARVEST SEASON). PLANTS SHALL BE SOT TRANDED IN DEVELOPMENT AND APPEARANCE AS TO BE UNDUSTRIONABLY SUPERIOR IN FORM, COMPACTIESS, AND INSECTS (PUPLE OF MICHAEL AND INSECTS (PUPLE OF MICHAEL). THEY SHALL BE SOUND, HEALTHY, NOGONUS AND ENERGY FOUNDED WHEN IN LEAF, AND FREE OF DISEASE, AND INSECTS (PUPLE OF MICHAEL). THEY SHALL BE AND INSECTS SHALL HAVE A MINIMUM BRANCHING HOTHER OF SIX (6) FEET ABOVE THE GROWTH HAND SHALL BE OF THE HIGHEST OUALITY, HAVE TYPICAL GROWTH HABITS FOR THEM SPECIES, BE SOUND, HEALTHY, NGOROUS AND FREE OF INJURY. PARKINGY TREES AND PRACTISES SHALL HAVE A MINIMUM BRANCHING HOTHER OF SIX (6) FEET ABOVE THE GROWTH ADDITIONAL AND PHYSICAL CLEARANCE.
- 5. MATERIALS SOIL: PLANTING SOIL/COMPACTED TOPSOIL SHALL MEET THESE REQUIREMENTS:

PLANTING SOIL TO BE A MINIMUM 24" DEPTH, UNLESS OTHERWISE SPECIFIED AS ABOVE OR ON DETAILS. TOPSOIL TO BE CLEAN, FRABLE LOAM FROM LOCAL SOURCE, FREE FROM STONES OR DEBRIS OVER 3/4" IN DIAMETER, AND FREE FROM TOXINS. TOPSOIL SHALL BE TESTED TO CONFORM TO THESE SPECIFICATIONS AND SHALL BE AMENDED TO MEET THESE SPECIFICATIONS DO NOT PLACE FROZEN OR MUDDY TOPSOIL. APPLY SOIL AMENDMENTS TO ALL LANGSCAPE BEDS PER SOIL TEST.

- 6. MATERIALS ALL PLANTING AREAS LABELED ON PLAN SHALL RECEIVE FINELY SHREDDED, WEED FREE, HARDWOOD BARK MULCH (DYE-FREE) SPREAD TO A CONSISTENT DEPTH OF THREE INCHES OVER ENTIRE PLANTING AREA, UNLESS OTHERWISE SPECIFIED ON PLANS. FERTILIZER SHALL BE IN ACCORDANCE WITH APPLICABLE LOCAL, COUNTY AND STATE OF MISCONSIN REQUIREMENTS.
- RAINGARDEN PLUG PLANTINGS: ALL PLUG PLANTINGS SHALL BE PLANTED 2'-0' ON CENTER. CONTRACTOR IS TO RAINDOMIZED PLUG PLANTING SELECTION THROUGHOUT BASIN AND DISTRIBUTE SPECIES VARIETY THROUGHOUT PLUG PLANTING AREAS. PRIOR TO PLANTING, BIODEGRADABLE PLANT CONTAINERS SHALL BE SPLIT AND NON-BIODEGRADABLE CONTAINERS BE REMOVED. THE ROOT SYSTEMS OF ALL SUCH PLANTS SHALL BE SPLIT OR CRUMBLED BY HAND PRIOR TO INSTALLATION.
- 8. MATERIALS ALL PLANTING AREAS LABELED ON PLAN SHALL RECEIVE WASHED STONE MUICH AS APPROVED BY OWNER. STONE SHALL BE SPREAD TO A CONSISTENT DEPTH OF THREE INCHES OVER ENTIRE PLANTING AREA, UNLESS OTHERWISE SPECIFIED ON PLANS, FERTILIZER SHALL BE IN ACCORDANCE WITH APPLICABLE LOCAL, COUNTY AND STATE OF WISCONSIN REQUIREMENTS.
- 9. MATERIALS -- RAINWATER DRY STREAM ADJACENT TO BUILDING SHALL RECEIVE WASHED #4 FIELDSTONE COBBLE STONE. SHALL BE SPREAD TO A CONSISTENT DEPTH OF THREE INCHES OVER ENTIRE PLANTING AREA, UNLESS OTHERWISE SPECIFIED ON PLANS.
- 10. MATERIALS TREE RINGS: ALL TREES PLANTED IN SODDED LAWN AREAS TO BE INSTALLED WITH A MINIMUM 3' DIAMETER SHREDDED HARDWOOD MULCH TREE RING SPREAD TO A CONSISTENT DEPTH OF 3 INCHES, ALL TREE RINGS SHOULD BE INSTALLED WITH A 5' DEPTH SHOVEL CUT EDGE, ANGLED 45 DEGREES INTO SOIL AT A 3' DIAMETER ABOUT THE CRITER OF THE TREE PLANTING, A PRE-EMERGENT GRANULE WEED-PREVENTER SHOULD BE MIXED WITH MULCH USED TO INSTALL TREE RING AS WELL AS TOPICALLY APPLIED TO FINISHED INSTALLATION OF
- 11. MATERIALS: SOD ALL DISTURBED AREAS AS SPECIFIED IN THESE NOTES: TURFGRASS SOD: CLASS OF TURFGRASS SOD SHALL BE PREMIUM GRADE APPROVED TURFGRASS SOD. ONLY IMPROVED TYPES OF SOD (ELITE) ARE ACCEPTABLE. TURFGRASS SHALL BE MACHINE CUT AT A UNFORM THICKNESS OF 60 INCH. PLUS OF MANUS. 25 INCH. AT THE OF CLITTING INFASIBREIGHT FOR THE PROPERTY FOR THE PROPERTY OF THE PROPERTY FOR MATERIALS. SOD ALL DISTURBED AREAS AS SPECIFIED IN THESE NOTES: TURFGRASS SOD CLASS OF TURFGRASS SOD SHALL BE PREMIUM GRADE APPROVED TURFGRASS SOD. ONLY IMPROVED TOPES OF SOD (ELITE) ARE ACCEPTABLE. TURFGRASS SOD CLASS OF TURFGRASS SOD SHALL BE STRONG ROWTH AND THAT THAT CH. LARGE ROLL TURFGRASS SOD SHALL BE CUIT TO THE BE CUIT TO THE BE CUIT TO THE SUPPLIER'S STANDARD WIDH (36-48 INCHES) AND LENGTH.

 BROKEN PADS AND TON OR UNEXEN ENDS WILL NOT BE ACCEPTABLE. STANDARD WIDH (36-48 INCHES) AND LENGTH.

 WHEN MOISTURE CONTENT (EXCESSIVELY DRY OR WET) HAV ADVERSELY FEFECT ITS SURVIVAL. POST-PUT INFROMANS AND END CH.

 WHEN MOISTURE CONTENT (EXCESSIVELY DRY OR WET) HAV ADVERSELY FEFECT ITS SURVIVAL. POST-PUT INFROMANS AND ENCORA
 WHEN MOISTURE CONTENT (EXCESSIVELY DRY OR WET) HAV ADVERSELY FEFECT ITS SURVIVAL. POST-PUT INFO OF ACCEPTANCE

 BY THE OWNER. TURFGRASS SOD SHALL BE HARVESTED, DELIVERED, AND INSTALLED/TRANSPLANTED WITH A PERIOD OF 24 HOURS. TURGRASS SOD SHALL BE RELATIVELY FREE OF THATCH, UP TO .5 INCH ALLOWABLE (UNCOUPRESSED), TURFGRASS SOD SHALL BE REASONABLY FREE (10 WEEDS/100 SO, FT.) OF DISEASES, NEWATORS SOD.

 WATERING SCHEDULE SHOULD BEGIN IMMEDIATELY AFTER SOD IS INSTALLED.
- 12. MATERIALS WEED BARRIER FABRIC: ALL PLANTING BEDS SHALL BE INSTALLED WITH WOVEN WEED BARRIER FABRIC. NO PLASTIC/IMPERVIOUS BARRIERS WILL BE PERMITTED. EXAMPLE: BLACK VISOUEEN.
- 13 HATERIALS FOCING FOCING SHALL BE 5" DEEP POLYETHYLENE FOCING OWNER SHALL APPROVE SPECIFICATION PROVIDED BY LANDSCAPE CONTRACTOR.
- 14. PRUNING: THE CONTRACTOR SHALL PRUNE ALL TREES AND REPAIR ANY INJURIES THAT OCCURRED DURING THE PLANTING PROCESS, DOUBLE LEADERS, DEAD BRANCHES, AND LIMBS DAMAGED OR BROKEN DURING THE PLANTING PROCESS SHALL BE PRUNED. THIS SHALL BE THE ONLY PRUNING ALLOWED AT PLANTING, PRUNING SHALL CONFORM TO AMERICAN STANDARD FOR TREE CARE OPERATIONS, ANSI ASDO. PRUNE TREES IN ACCORDANCE WITH NAM GUIDELINES. DO NOT TOP TREES. PRUNE SHRUBS ACCORDING TO STANDARD HORRICULTURAL PRACTICES. ON CUTS OVER 3/4" IN DUMLETER AND BRUISES OR SCARS ON BARK, TRACE THE INJURED CAMBIUM LAYER BACK TO LIVING TISSUE AND REMOVE. SMOOTH AND SHAPE WOUNDS SO AS NOT TO RETAIN WATER AND COAT THE TREATED AREA WITH AN APPROVED ANTISEPTIC TREE PAINT.
- 16. MAINTENANCE: (CONTRACTOR) FOR ALL PLANTINGS, BUFFER AREAS AND SODDED LAWN AREAS: THE CONTRACTOR SHALL MAINTAIN ALL PLANTINGS AND LAWN AREAS FOR AT LEAST A PERIOD OF 30 DAYS, OR UNTIL FINAL ACCEPTANCE FROM THE OWNER. THE CONTRACTOR IS RESPONSIBLE FOR ADEQUATELY WATERING PLANTS AND LAWN/TURFGRASS DURING THIS 30 DAY ESTABLISHMENT PERIOD. CONTRACTOR IS RESPONSIBLE FOR THE ESTABLISHMENT OF HEALTHY VIGOROUS PLANT MATERIALS AND LAWN/TURFGRASS GROWTH. CONTRACTOR IS ALSO RESPONSIBLE FOR ANY PRUNING OF PLANT MATERIALS, AND SHAPING AND/OR REPLACEMENT OF DEFICIENT BARK MULCH DURING THIS PERIOD. LONG TERM PLANT MATERIALS AND LAWN/TURFGRASS MAINTENANCE AND ANY PROGRAM FOR SUCH IS THE RESPONSIBILITY OF THE OWNER. ALL PLANTINGS AND LAWN/TURFGRASS AREAS SHALL BE AUNTRINGED IN A MANICURED CONDITION.
- 17. MAINTENANCE: (OWNER) THE OWNER IS RESPONSIBLE FOR THE CONTINUED MAINTENANCE, REPAIR AND REPLACEMENT OF ALL LANDSCAPING MATERIALS AND WEED BARRIER FABRIC AS NECESSARY FOLLOWING THE ONE (1) YEAR CONTRACTOR GUARANTEE PERIOD



CITY OF MADISON LANDSCAPE WORKSHEET

Project Location	Address UNION CORNERS - M	ADISON, WI		
Name of Project	Name of Project UNION CORNERS BUILDING 4 & 5 SPECIFIC IMPLEMENTATION PLAN			
Owner / Contact GORMAN & COMPANY				
Contact Phone	(608) 848-5060	Contact Email JUSTIN, FRAHM@USDING, COM		
-	7555			

** Landscape plans for zoning lots greater than (en thousand (10,000) square feet in size
MUST be prepared by a registered landscape architect. **

Applicability

The following tendards apply to all exterior construction and development activity, including the expansion of existing buildings, structures and pathing lets, except the construction of detached single-family and two-family dwellings and thoir accessing stuttures. The entire decolopment site imme be brought up to compliance with its section unless all of the following conditions apply, in which case only the affected areas need to be brought up to compliance:

- (a) The area of site disturbance is less than ten percent (10%) of the entire development site during any ten (10)
- (b) Gross floor area is only increased by ten percent (10%) during any test-(10) year period (c) No demolition of a principal building is involved.
- (d) Any displaced landscaping elements must be replaced on the site and shown on a revised landscaping plan.

Lankeupe Calculations and Distribution
Required Insheaped areas shall be calculated based upon the total developed area of the property. Developed area is defined as that area within a single contiguous boundary which is made up of structures, parking, driveways and docking loading Endilities, but eveloding the area of any building footprint at grade, land designated for open space uses such as authoric fields, and underchoped load area on the same zoning lot. There are three methods for calculating landscape points depending on the size of the lot and Joning District

(a) For all lots except those described in (b) and (c) below, five (5) landscape points shall be provided for each three burded (300) suggested of developed area.

	Total landscape points required
Ь) For lots larger than five (5) acres, points shall be provided at five (5) points per three hundred (30) feet for the first five (5) developed acres, and one (1) point per one hundred (100) square feet for all a cerus.
	Total square footage of developed area
	Five (5) acres = 217,800 square feet
	First five (5) developed acres = 3.630 points
	Remainder of developed area
	Total landscape points required
c	e) For the Industrial - Limited (IL) and Industrial - General (IG) districts, one (1) point shall be

per one hundred (100) square feet of developed are:

Total square footage of developed area Total landscape paints required

Total square footage of developed area 8,524

10/2013

Tabulation of Points and Credits

Use the table to indicate the quantity and points for all existing and proposed landscape elements

Plant Type/ Element	Minimum Size at	Points	Lands	caping	Landscaping			
ram rype riement	Houseste	Tomas	Quantity	Points Achieved	Quantity	Points Achieved		
Overstory deciduous tree	2½ inch caliper measured diameter at breast height (dbh)	35						
Tall evergreen tree (i.e. pine, sprace)	5-6 feet tall	35						
Omamental tree	1 1/2 inch caliper	15						
Upright evergreen shrub (i.e. arborvitae)	3→ feet tall	10						
Shrub, deciduous	#3 gallon container size, Min. 12"-24"	3			56	168		
Shrub, evergreen	#3 gallon container size, Min. 12"-24"	4	i 		12	48		
Ornamental grasses! perennials	#1 gallon container size, Min. 8"-18"	2			248	496		
Ornamental/ decorative fencing or wall	n/a	4 per 10 lineal ft.						
Existing significant specimen tree	Minimum size: 2 ½ inch caliper dbh. *Trees must be within developed area and camot comprise more than 30% of total required points.	14 per caliper inch dbh. Maximum points per tree: 200						
Landscape furniture for public seating and/or transit connections	* Furniture must be within developed area, publically accessible, and cannot comprise more than 5% of total required points.	5 points per "seat"						
Sub Totals	V; V		ĺ			712		

Total Number of Points Provided 712

* As determined by ANSI, ANLA- American standards for nursery stock. For each size, minimum plant sizes shall conform to the

REAL ESTATE DEVELOPMENT & MANAGEMENT

> 200 N. MAIN STREET OREGON, WI 53575

Consultant



PLAN SPECIFI COMPANY **IMPLEMENTATION CORNERS** જ GORMAN NOINO

MADISON, WI

Project No. xxx-000-xxx-0000 Plot Date: Drawn by: XXX

> Issue Description Date GDP 06-25-14 11-05-14

Sheet Title

LANDSCAPE DETAILS, NOTES, AND **SPECIFICATIONS**

Sheet No.



REAL ESTATE DEVELOPMENT & MANAGEMENT 200 N. MAIN STREET OREGON, WI 53575

Soot.

Consultant

UNION CORNERS BUILDINGS 4 & 5 Z500 WINNEBAGO STREET MADISON, WI


Project No.	130020-43
Plot Date:	2014/11/04 11 00 AN
Drawn by:	JK/MO
Date	Issue Description

Sheet Title

BLDG 4 & 5 PLAN

Sheet No.

A101

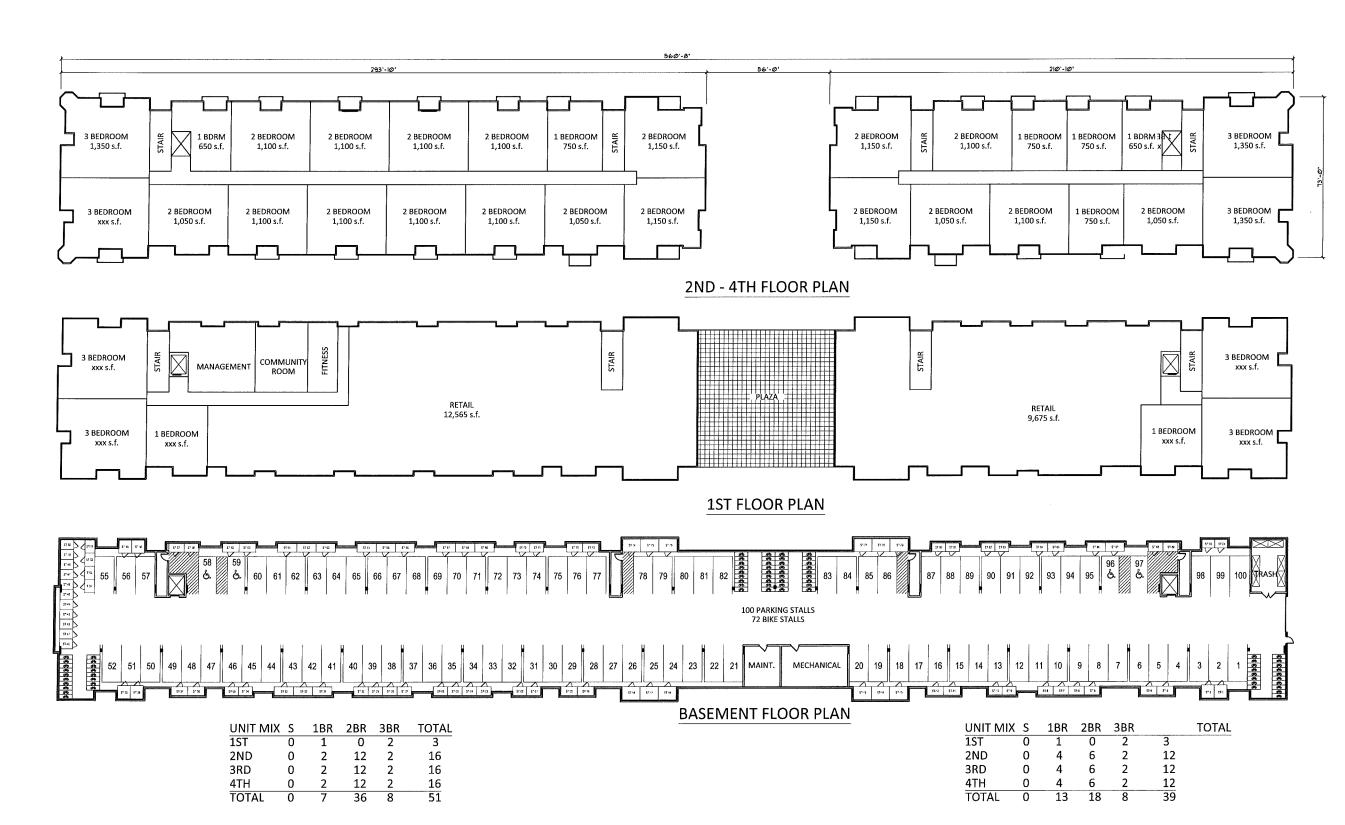



BLDG #4 - WINNEBAGO STREET ELEVATION

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BLDG #4 - PLAZA ELEVATION

SCALE: 1" = 10" - 0"

	BLDG #4 - SOUTH ELEVATION
(4)	SCALE: 1" = 10' - 0"

Project No. 130020-43 Plot Date: 2014/11/04 11:00 AM JK/MO Drawn by: Date Issue Description

UNION CORNERS

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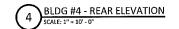
BUILDINGS 4 & 2500 WINNEBAGO STREET MADISON, WI

Sheet Title

BLDG # 4 ELEVATIONS

Sheet No.

A401





1 BLDG # 5 - WINNEBAGO STREET ELEVATION
SCALE: 1" = 10' - 0"

BLDG # 5 - NORTH ELEVATION



3 BLDG #5 - PLAZA ELEVATION
SCALE: 1" = 10' - 0"



REAL ESTATE
DEVELOPMENT &
MANAGEMENT

DEVELOPMENT & MANAGEMENT 200 N. MAIN STREET OREGON, WI 53575

Seal

Consultant

UNION CORNERS BUILDINGS 4 & 5 2500 WINNEBAGO STREET MADISON, WI

Project No.	130020-43
Plot Date:	2014/11/04 11:00 AN
Drawn by:	JK/MO

Date Issue Description

Sheet Title

BLDG # 5 ELEVATIONS

Sheet No.

A402

BLDG # 5 - REAR ELEVATION

SCALE: 1" = 10" - 0"