

URBAN DESIGN COMMISSION APPLICATION CITY OF MADISON

This form may also be completed online at: http://www.cityofmadison.com/planning/documents/UDCapplication.pdf

215 Martin Luther King Jr. Blvd; Room LL-100 PO Box 2985; Madison, Wisconsin 53701-2985 Phone: 608.266.4635 | Facsimile: 608.267.8739


Please complete all sections of the application, including the desired meeting date and the type of action requested.

0.5-14	
Date Submitted: 8-15-14-	☐ Informational Presentation
UDC Meeting Date: <u>UCT \</u> Combined Schedule Plan Commission Date (Happilcable):	UC7 (0 ☐ Initial Approval
Combined Schedule Flan Commission Date (rappincable).	DC 1 (/)
1. Project Address: 433 WEST JOH Project Title (if any): JOHNSON BEND	HUSON
2. This is an application for (Check all that apply to this UDC applic	
New Development	r Previously-Approved Development
A. Project Type:	
Project in an Urban Design District* (public hearing-\$300	
	an Mixed-Use District (UMX) (\$150 fee, Minor Exterior Alterations) stitutional District (CI) or Employment Campus District (EC)
	titutional district (Ci) of Employment Campus district (EC)
Planned Development (PD)General Development Plan (GDP)	CITY OF MADISON
Specific Implementation Plan (SIP)	and an interpret
☐ Planned Multi-Use Site or Planned Residential Com	nplex
P. Signagor	AUG 1 5 2014
B. Signage: Comprehensive Design Review* (public hearing-\$300 fee)	13:280
Signage Exception(s) in an Urban Design District (pu	iblic hearing-\$300 fee) Planning & Community
C. Other:	& Economic Development
Please specify:	
3. Applicant, Agent & Property Owner Information:	Curry Assertation
Applicant realies	Company: SUTTON ARCHITECTURIZ City/State: MADISON Zip: 53703
Street Address: 104 KING STREET Telephone: (608) 419-1528 Fax: (1)	City/State: MANISON Zip: <u>53703</u> Email: JOHN & SUTTONANCHITECTURE. CON
	Entail: Opmid to 10 Fort Meditiectors con
Project Contact Person: JOHN W. SUTTON	Company:
Street Address:	City/State: Zip:
Telephone:()Fax:()	Email:
Project Owner (if not applicant): LEG UROSZ	
Street Address: 505 UNIVERSITY AVE.	
Telephone:() Fax:()	Email:
4. Applicant Declarations:	
A. Prior to submitting this application, the applicant is required to discuss	- · · · · · · · · · · ·
application was discussed with AL MARTIA o	OR [date of meeting]
	omittal and understands that if any required information is not provided by
the application deadline, the application will not be placed on an Urban D	
Name of Applicant JOTA W. SUTTON	Relationship to Property ALCHI TICC?
Autoritadistration (N. (1)	8/15/14
Authorized Signature / Kun W	- Date
/	




SUTTON



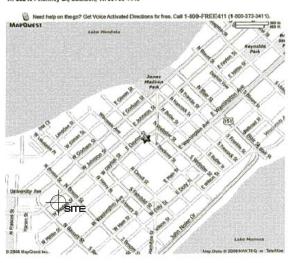

http://www.mapquest.com/maps?city=Madison&state=WI&address=202+N.+Pinckney 12/1/2008

ZONING MAP

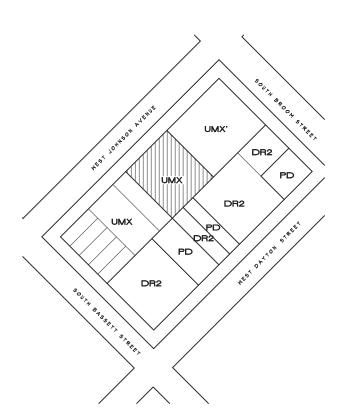

OWNER

_es Orosz

505 University Avenue Madison, Wisconsin 53703

(608) 256-7368





PROJECT

Johnson Bend

433 West Johnson Street Madison, Wisconsin 53703

SITE DATA

	1,375 SQUARE FEET 126,909 SQUARE FEET 31,903 SQUARE FEET
ONE BDRM UNITS TWO BDRM UNITS TOTAL UNITS TOTAL BDRMS	39 2 60 8
USEABLE OPEN SPACE REAR YARD COURTYARD PLANTERS COURTYARD PLAZA BALCONIES ROOF PLANTERS GREEN ROOF ROOF TERRACE	1,295 SQUARE FEET 15,708 SQUARE FEET
TOTAL	26,005 SQUARE FEET
PARKING BIKE STALLS	149 (TWELVE ADA) 158 INTERIOR, 38 EXTERIOR, 196 TOTAL


INDEX

TI	TITLE SHEET
CI.2 CI.3	EXISTING SITE PLAN SITE PLAN GRADING/EROSION CONTROL PLAN UTILITY PLAN
	GROUND FLOOR LANDSCAPE PLAN ROOF TERRACE LANDSCAPE PLAN
Al.2 Al.3 Al.4 Al.5 Al.6 Al.7 Al.8 Al.9	PARKING LEVEL P2 FLOOR PLAN PARKING LEVEL PI FLOOR PLAN FIRST FLOOR PLAN MEZZANINE FLOOR PLAN SECOND FLOOR PLAN THIRD FLOOR PLAN TYPICAL FLOOR PLAN TWELFTH FLOOR PLAN ROOF TERRACE PLAN
A2.2 A2.3	NORTHWEST ELEVATION NORTHEAST ELEVATION SOUTHEAST ELEVATION SOUTHWEST ELEVATION

TITLE SHEET LOCATION/ZONING MAP

Project # 201303 **T1.1**


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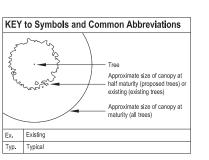


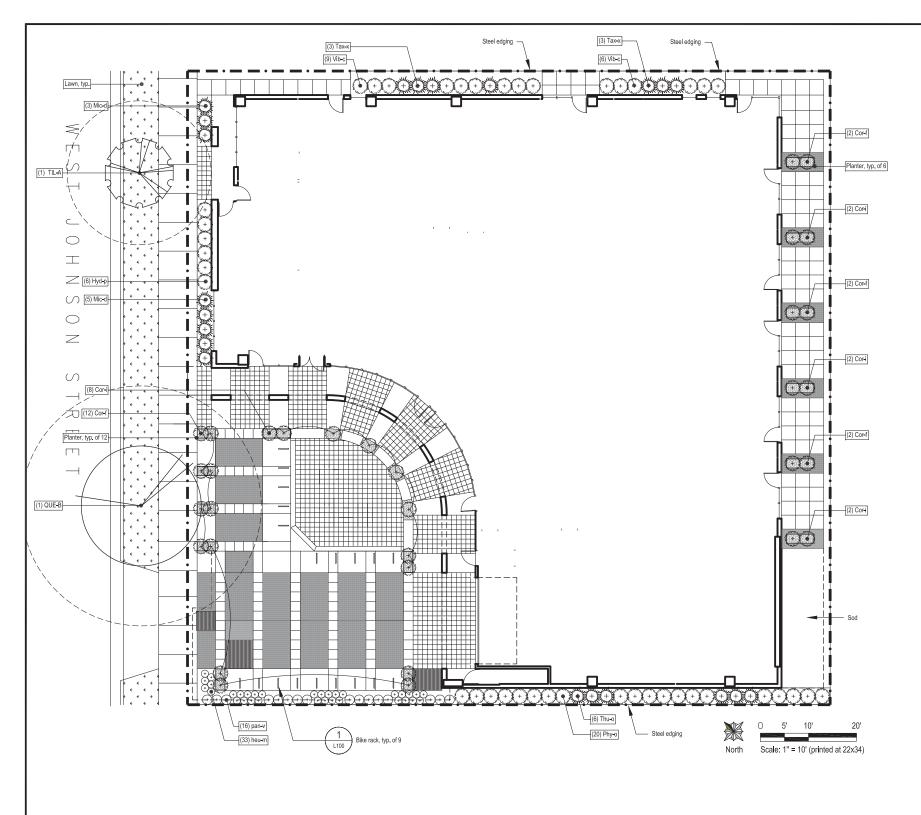SYMBOL	BOTANICAL NAME	COMMON NAME	SIZE	ROOT	NOTES	MATURE SIZE	DET.
CANOPY T	REES (NOTE: Sizes indicated shall be used	l unless noted otherwise on plans)					
QUE-B	Quercus bicolor	Swamp White Oak	3.5" cal	B&B	Full, symmetrical, strong central leader	50' H x 50' W	
TIL-A	Tilia americana 'McKSentry'	American Sentry Linden	3.5" cal	B&B	Full, symmetrical, strong central leader	45" H x 30' W	1/L1.1
ORNAMEN	TAL TREES					•	
MAL-r	Malus 'Red Jewel'	'Red Jewel' Crabapple	8' ht	B&B	Full, matched, single-stem tree form	15' H x 12' W	1/L1.1
EVERGREE	N SHRUBS					•	
Jun-s	Juniperus sabina 'Mona'	Calgary Carpet Juniper	3 gal	cont.		9" H x 8' W	
Mic-d	Microbiotta decusatta	Russian Cypress	3 gal	cont.		12" H x 8" W	
Pin-m	Pinus mugo v. mugo	Mugho Pine	18"	cont.		3" H x 4' W	3/L1.1
Тах-х	Taxus x media 'Taunton'	Taunton Yew	18" H	cont		3' H x 4' W	1
Thu-o	Thuja occidentalis 'Holmstrup'	'Holmstrup' Arborvitae	36" H	cont.	Full, matched	6' H x 3' W	1
DECIDUOU	S SHRUBS	<u>'</u>					
Cor-f	Comus sericea 'Flaviramea'	'Flaviramea' Yellow Twig Dogwood	24"	cont.			5/L1.1
Cor-i	Comus sericea 'Isanti'	'Isanti' Red Twig Dogwood	24"	cont.			5/L1.1
Hyd - p	Hydrangea paniculata 'Silver Dollar'	'Silver Dollar' Hydrangea	24"	cont.		3' H x 4' W	
Phy-d	Physocarpus opulifolius 'Dart's Gold'	Compact Ninebark	18"	cont.		4' H x 4' W	0.144
Vib-c	Viburnum carlesii 'Compactum'	Compact Koreanspice Viburnum	18"	cont.		3' HW	3/L1.1
Wei-x	Weigela 'Minuet'	'Minuet' Weigela	18"	cont.		2' H x 3' W	
PERENNIA	LS & ORNAMENTAL GRASSES					•	
cor-v	Coreopsis verticilalata 'Zagreb'	Threadleaf Coreopsis	1 gal	cont.	18" o.c. triangular spacing		
heu-m	Heuchera micrantha 'Palace Purple'	Coralbells 'Palace Purple'	1 gal	cont.	15" o.c. triangular spacing		1
lia-s	Liatris spicata 'Kobold'	Kobold Spike Gayfeather	1 gal	cont.	15" o.c. triangular spacing		
pan-v	Panicum virgatum 'Shenandoah'	'Shenandoah' Red Switchgrass	3 gal	cont.	3' o.c. triangular spacing		4/L1.1
per-a	Perovskia atriplicifolia 'Filigran'	'Filigran' Russian Sage	1 gal	cont.	3' o.c. triangular spacing		
sed-a	Sedum 'Autumn Joy'	'Autumn Joy' Sedum	1 gal	cont.	18" o.c. triangular spacing		
ver-s	Veronica spicata 'Red Fox'	'Red Fox' Speedwell	1/2 gal	cont.	12" o.c. triangular spacing		

GENERAL LANDSCAPE & PLANTING NOTES

- 1. Plant material to be installed and maintained by a qualified and experienced landscape installer.
- All materials, plant locations and plant bed conditions are subject to the approval of the Landscape Architect and Owner at any time. Plants are to be freshly dug. Transporting of plants shall be done in a manner as to not destroy the natural shape, compromise the health, or alter the characteristics of plant materials.
- Rootballs shall meet or exceed size standards as set forth in 'American Standards for Nursery Stock'. MAIN LEADERS OF ALL TREES SHALL REMAIN INTACT.
 Remove from the site any plant material that turns brown or defoliates within five (5) days after planting. Replace immediately with approved, specified material.
- 4. Plant counts indicated on drawings are for Landscape Architect's use only. Contractor shall make own plant quantity takeoffs using drawings, and plant schedule requirements (i.e., spacing), unless otherwise directed by Landscape Architect. Contractor to verify bed measurements and install appropriate quantities as governed by plant spacing per schedule.
- All plant beds shall receive 3" minimum of genuine shredded hardwood bark mulch (unless otherwise noted). Apply pre-emergent herbicide as directed by the manufacturer prior to installing mulch.
- 6. The Contractor shall install and/or amend topsoil in all proposed bed areas to meet ASTM D5268 standards. Landscaper shall verify depth and quality of topsoil prior to plant installation. A minimum of 4" of topsoil is required for seeded areas; 12" for plant beds. Topsoil sources shall include the reuse of surface soil stockpiled on site, clean of roots, plants, sod, stones, day lumps, and other extraneous or foreign materials larger than 1". Supplement with imported topsoil from off-site sources when quantities are insufficient. Do not obtain supplemental topsoil from agricultural land, bogs, or marshes. Inorganic amendments, organic amendments, and fertilizers shall be used to amend topsoil as needed for long-term plant health.
- Verify all utility locations in the field prior to beginning work. Repair all damaged utilities to satisfaction of the Owner and Operating Authority at no additional cost.
 Install all plant material in accordance with all local codes and ordinances. Obtain any required permits necessary to complete work. All workmanship and materials shall be guaranteed by the Contractor for a period of one (1) calendar year after Final Acceptance.
- Maintain all new lawn and plant material for a three (3) month period from date of Substantial Completion. Maintanenace shall include pruning, cultivating, watering, weeding, fertilizing, restoring plant saucers, spraying for disease and insects, and replacing tree wrappings. Recommended long-term maintenance procedures shall be provided to the Owner before expiration of this period.
- 10. Recondition soil and seed/re-reseed all areas disturbed by construction activities that are not to receive other surface treatment (i.e. pavement, planting bed, etc.). Seed with WiDOT 40 or equal.
- 11. All plant beds to receive steel edge (see Detail 8/L301) where bed is not bounded by a structure or pavement unless otherwise noted.
- 12. Scientific names of plants to take precendence over common names.
- 13. SOD: Provide Highland type, nursery-grown sod of dense growth, with a strong, fibrous root system, and shall be composed of at least seventy-five (75) percent Kentucky Bluegrass, mixed with fescue and perennial rye grasses, and free of pernicious weeds. Cut the sod at a length of approximately 2" (5.1 cm), and rake the sod free of debris.



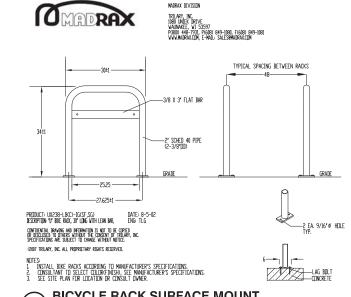

Total points required = Total Landscape Units (Total SF	of dev	eloped ar	ea / 30	0) x 5
points = (17,673 SF / 300) x 5 = 295 points				,
TARLE ATION OF ROUNTS A OREDITS	Grour	d Level	Roof	
ABULATION OF POINTS & CREDITS Overstony deciduous trees (min 2.5" caliner) @ 35 pts as	Qty	Pts	Qty	Pts
Overstory deciduous trees (min 2.5" caliper) @ 35 pts ea.				
Ornamental trees (1.5" caliper) @ 15 pts ea.	4	60		
Evergreen trees (min 3' height) @ 15 pts ea.				
Shrub, deciduous (min 18" ht or 3 gal cont) @ 2 pts ea	73	146	9	18
Shrub, evergreen (min 18" ht or 3 gal cont) @ 3 pts ea	21	63	14	42
Ornamental grasses (min 18" ht or 3 gal cont) @ 2 pts ea.	16	32	23	46
Decorative fence @ 4 points / 10 linear feet				
Subtotals		201		106
Total proposed landscape points achieved				307



Approval Drawings for Johnson Bend Apartments 425 W Johnson Street, Madison, WI 53703

Drosz ersity Avenue, Madison, MI, (608) with: Sutton Architecture 104 King Street, Madison, V

Owne

Issued for: Approval
Issue Date: 2014-08-08
Job No: 2014-045
Drawn by: ASA


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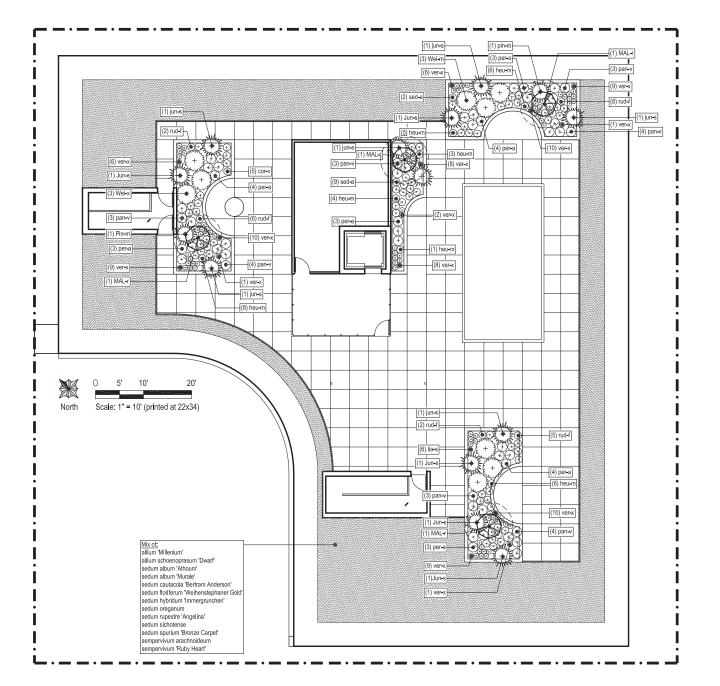
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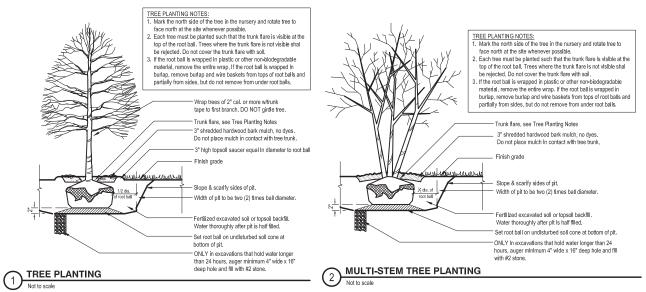


Sheet Title:
Ground Level
Landscape Plan


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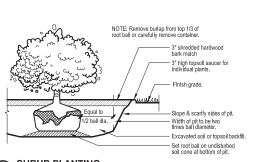





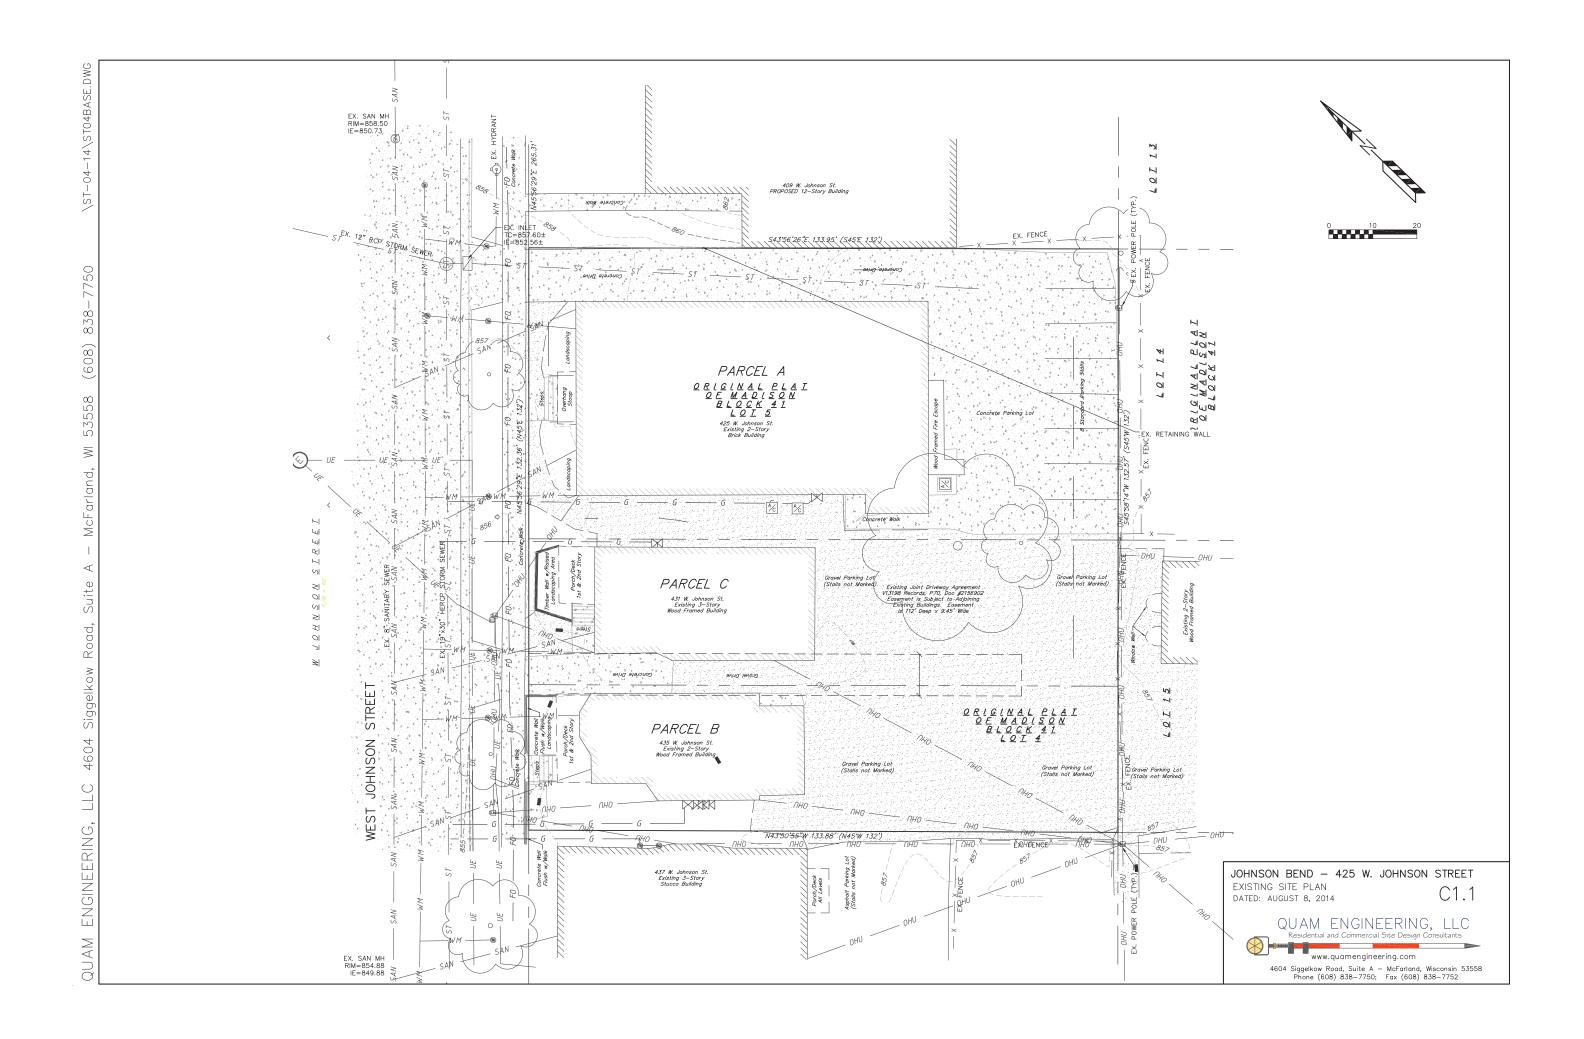


PLANT	SCHEDULE						
SYMBOL	BOTANICAL NAME	COMMON NAME	SIZE	ROOT	NOTES	MATURE SIZE	DET.
CANOPY TI	REES (NOTE: Sizes indicated shall be used unl	ess noted otherwise on plans)					
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TIL-A	Tilia americana 'McKSentry'	American Sentry Linden	3.5" cal	B&B	Full, symmetrical, strong central leader	45" H x 30' W	1/21.1
ORNAMEN	TAL TREES						
MAL-r	Malus 'Red Jewel'	'Red Jewel' Crabapple	8' ht	B&B	Full, matched, single-stem tree form	15' H x 12' W	1/L1.1
EVERGREE	N SHRUBS						
Jun-s	Juniperus sabina 'Mona'	Calgary Carpet Juniper	3 gal	cont.		9" H x 8' W	
Mic-d	Microbiotta decusatta	Russian Cypress	3 gal	cont.		12" H x 8" W	1
Pin-m	Pinus mugo v. mugo	Mugho Pine	18"	cont.		3" H x 4' W	3/L1.1
Tax-x	Taxus x media 'Taunton'	Taunton Yew	18" H	cont		3' H x 4' W	1
Thu-o	Thuja occidentalis 'Holmstrup'	'Holmstrup' Arborvitae	36" H	cont.	Full, matched	6' H x 3' W	1
DECIDUOU	S SHRUBS		•				
Cor-f	Cornus sericea 'Flaviramea'	'Flaviramea' Yellow Twig Dogwood	24"	cont.			5/L1.1
Cor-i	Comus sericea 'Isanti'	'Isanti' Red Twig Dogwood	24"	cont.			5/L1.1
Hyd-p	Hydrangea paniculata 'Silver Dollar'	'Silver Dollar' Hydrangea	24"	cont.		3' H x 4' W	
Phy-d	Physocarpus opulifolius 'Dart's Gold'	Compact Ninebark	18"	cont.		4' H x 4' W	3/L1.1
Vib-c	Viburnum carlesii 'Compactum'	Compact Koreanspice Viburnum	18"	cont.		3' HW	3/L1.1
Wei-x	Weigela 'Minuet'	'Minuet' Weigela	18"	cont.		2' H x 3' W	1
PERENNIAI	LS & ORNAMENTAL GRASSES						
cor-v	Coreopsis verticilalata 'Zagreb'	Threadleaf Coreopsis	1 gal	cont.	18" o.c. triangular spacing		
heu-m	Heuchera micrantha 'Palace Purple'	Coralbells 'Palace Purple'	1 gal	cont.	15" o.c. triangular spacing		1
lia-s	Liatris spicata 'Kobold'	Kobold Spike Gayfeather	1 gal	cont.	15" o.c. triangular spacing		1
pan-v	Panicum virgatum 'Shenandoah'	'Shenandoah' Red Switchgrass	3 gal	cont.	3' o.c. triangular spacing		4/L1.1
per-a	Perovskia atriplicifolia 'Filigran'	'Filigran' Russian Sage	1 gal	cont.	3' o.c. triangular spacing		1
sed-a	Sedum 'Autumn Joy'	'Autumn Joy' Sedum	1 gal	cont.	18" o.c. triangular spacing		
ver-s	Veronica spicata 'Red Fox'	'Red Fox' Speedwell	1/2 gal	cont.	12" o.c. triangular spacing		



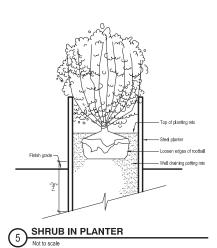


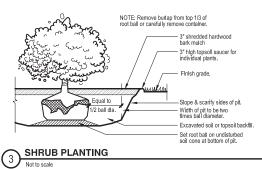

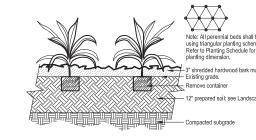



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	Finished grade
	P Area to receive hardwood bank mulch Topsot, to Include a min. of 5% organic matter, Remove all stones 1" & larger and other extraneous materials. COL-MET Steel Landscaping Edging, 3/16" x x 10°, dark brown firsh, Collier Metal Specialis
6 STEEL EDGE Not to scale	Inc. Garland, Texas (800) 829-5225 or equal.

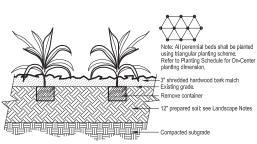

Sheet Title: Roof Landscape Plan

 Issued for:
 Approval

 Issue Date:
 2014-08-08

 Job No:
 2014-045

 Drawn by:
 ASA

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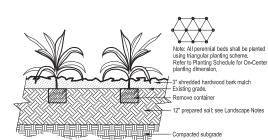
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plandesign LAND-VISION-PASSION

Approval Drawings for Johnson Bend Apartments 425 W Johnson Street, Madison, WII 53703

Plandesign LLC · Tel 608.318.1217

Sheet No: 2 of 2







OWNER

Les Orosz

(608) 347-5432 University Avenue Madison, Wisconsin 53703

PROJECT

Johnson Bend

433 West Johnson Street Madison, Wisconsin 53703

DRAWING

PARKING LEVEL P2 PLAN


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Project # 201303 A1.1







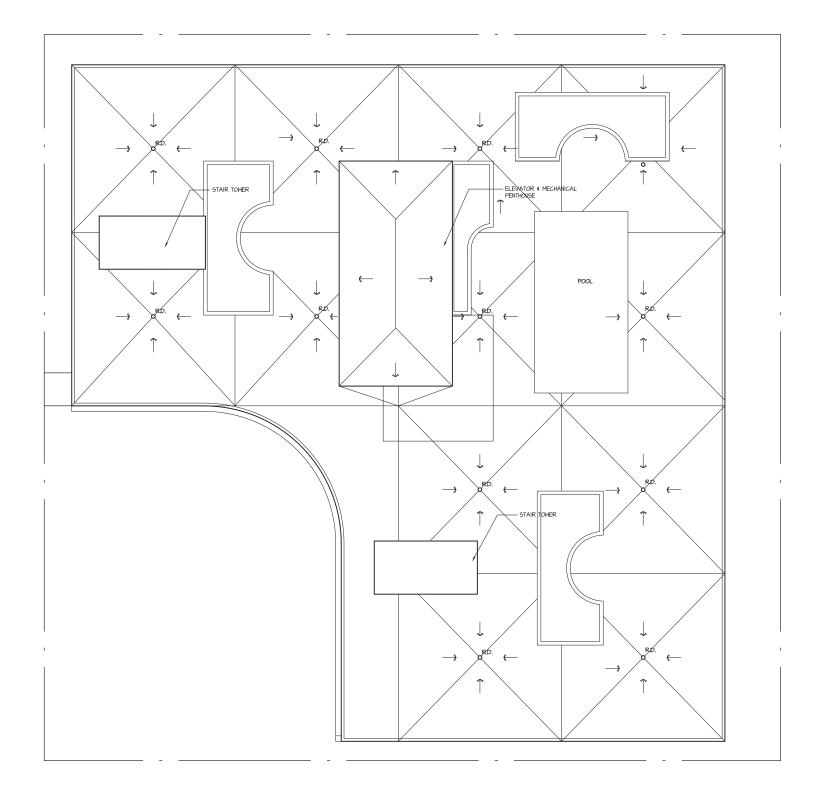

ROOF PLAN

Al.IO SCALE: 1/8" = 1'-0"



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(608) 347-5432 University Avenue Madison, Wisconsin 53703

PROJECT

Johnson Bend

433 West Johnson Street Madison, Wisconsin 53703

DRAWING

ROOF PLAN

DATA







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PARKING LEVEL PI 72 VEHICLES SCALE: 1/0" = 1'-0"	
	NORTH

OWNER

Les Orosz

(608) 347-5432 University Avenue Madison, Wisconsin 53703

PROJECT

Johnson Bend

433 West Johnson Street Madison, Wisconsin 53703


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PARKING LEVEL P1 PLAN

DATA





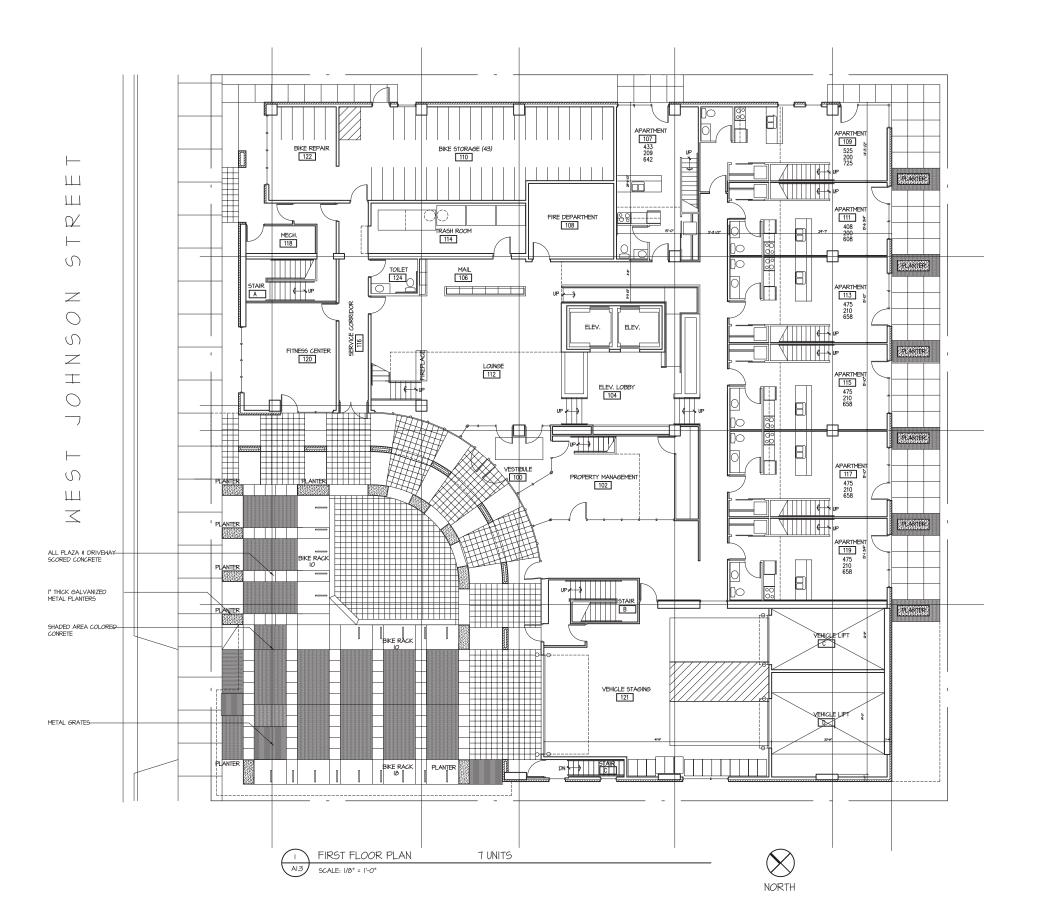

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Les Orosz (608) 347-5432

University Avenue Madison, Wisconsin 53703

PROJECT


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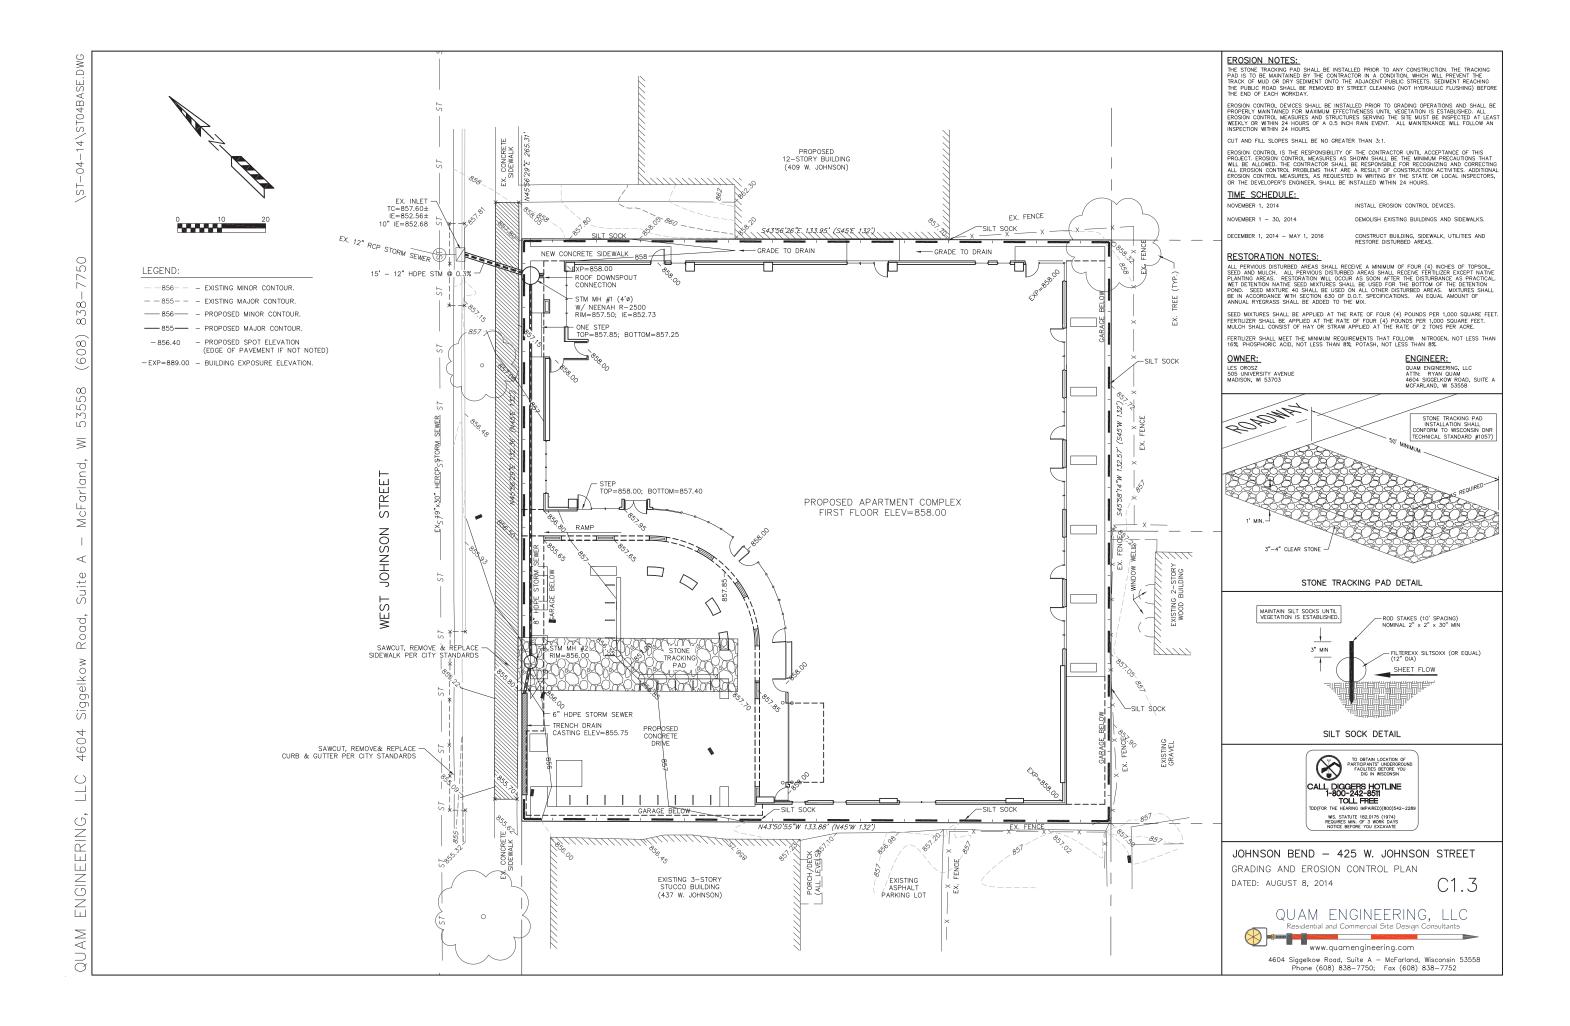
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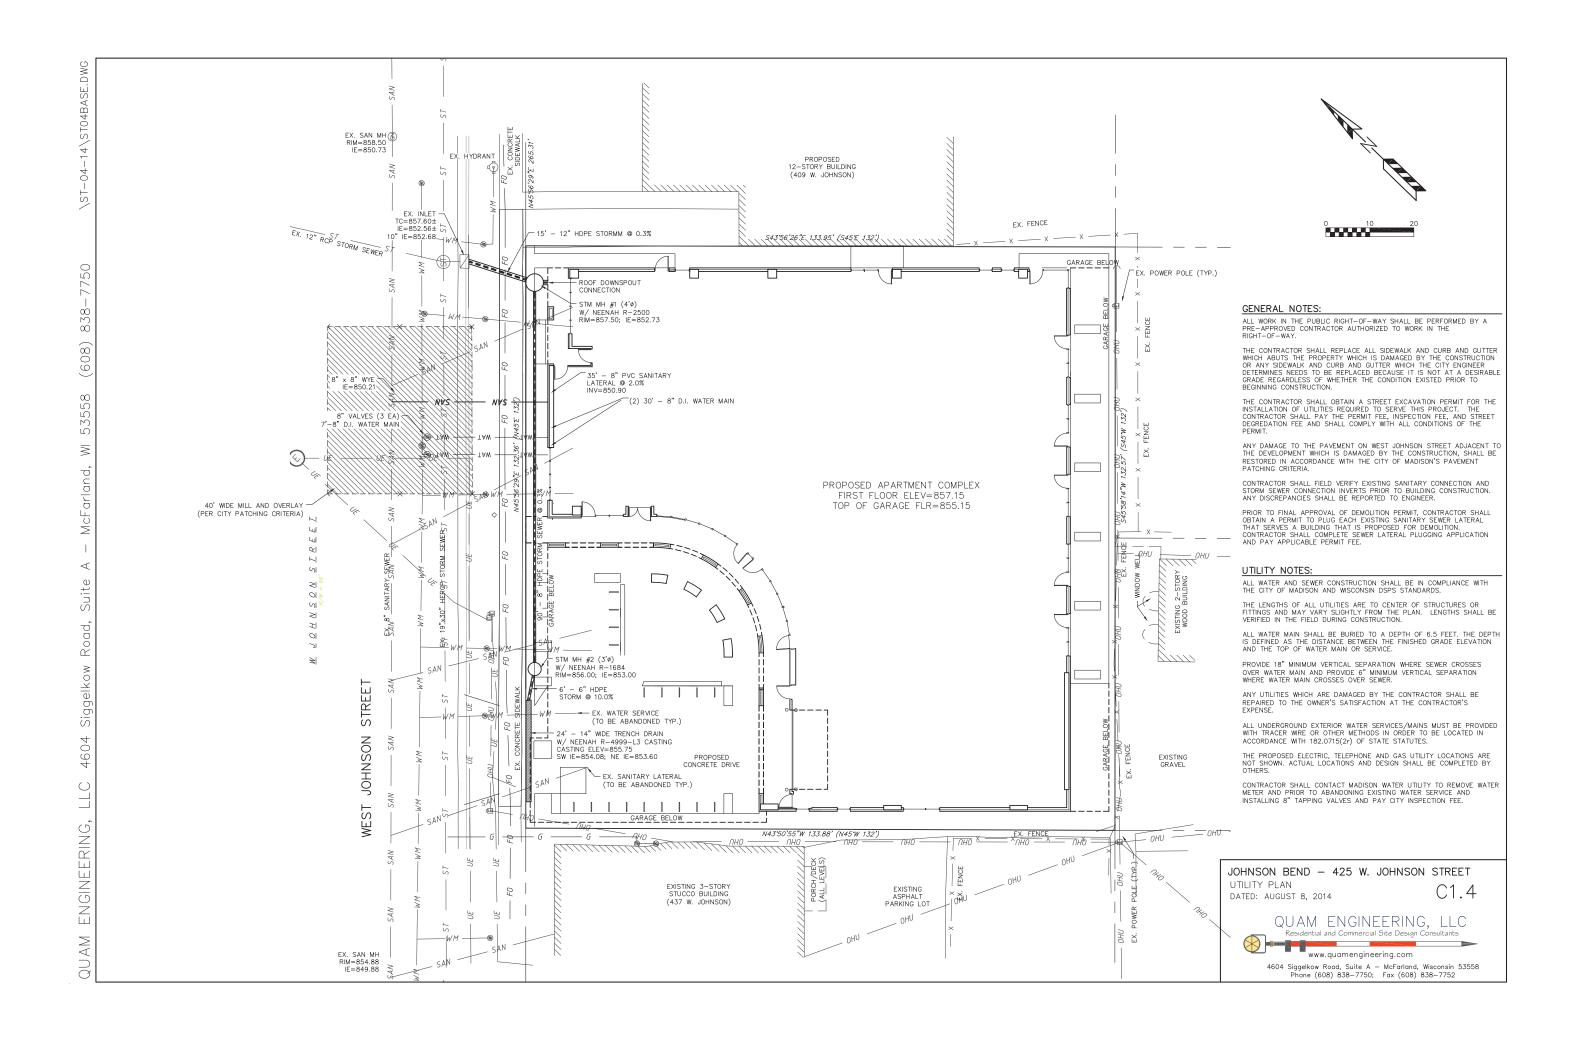
DRAWING

FIRST FLOOR PLAN

DATA





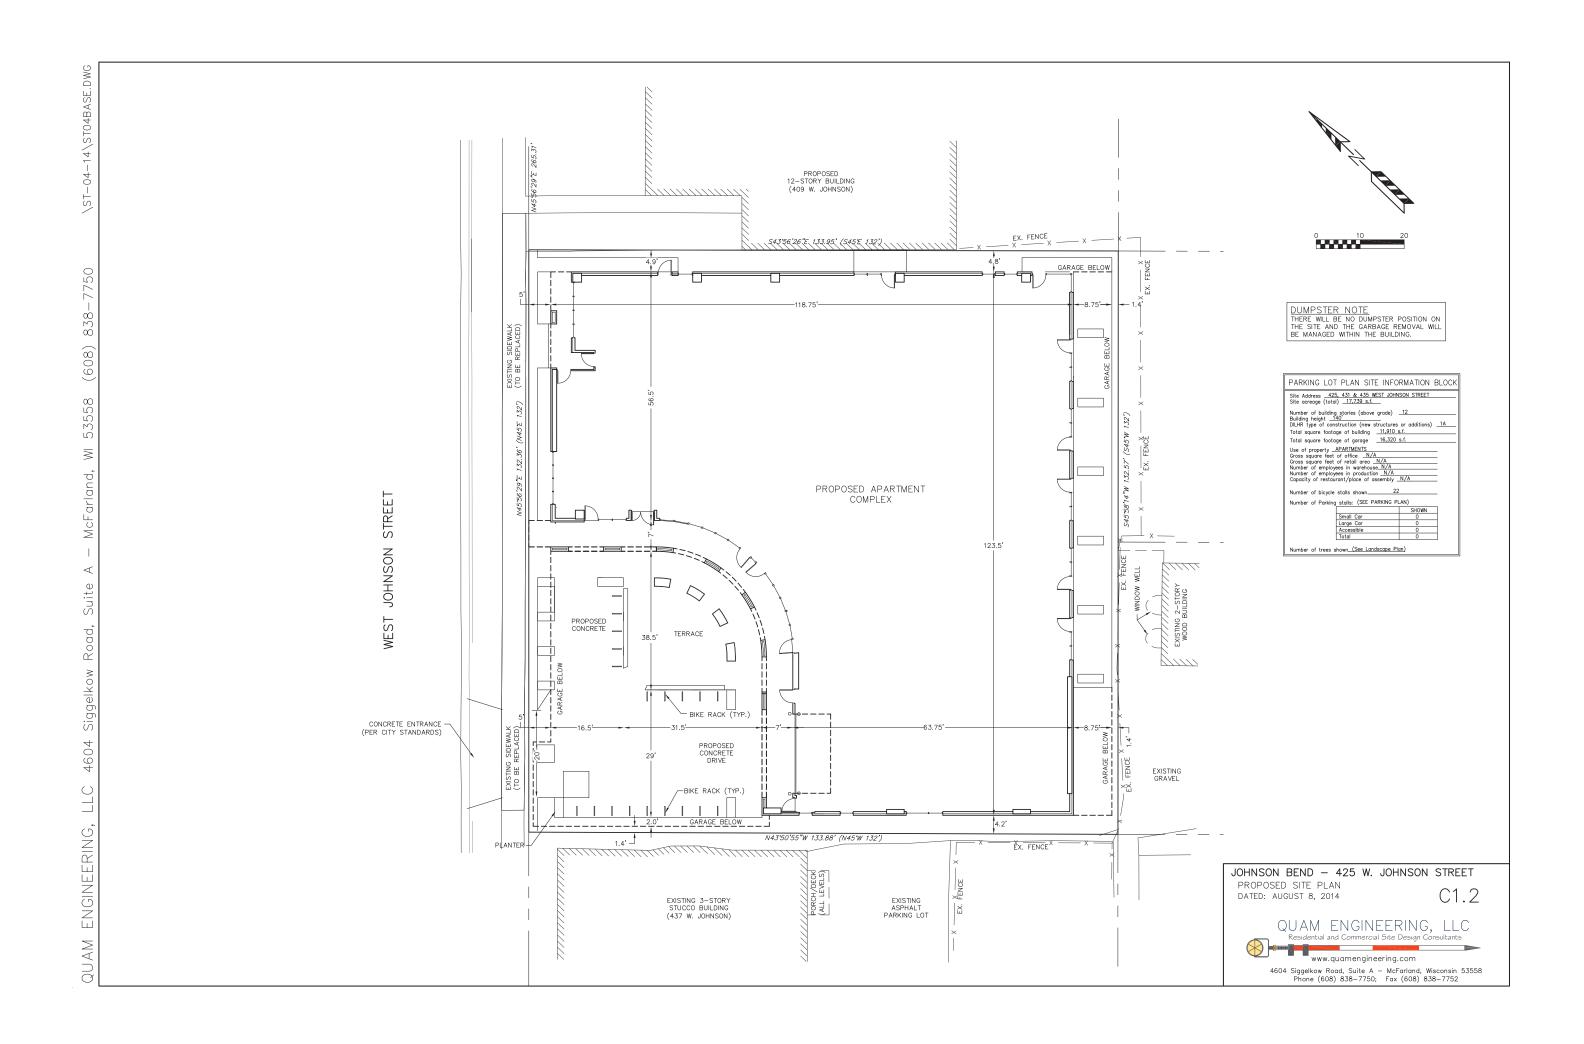



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OWNER

Les Orosz (608) 347-5432

University Avenue Madison, Wisconsin 53703

PROJECT

Johnson Bend

433 West Johnson Street Madison, Wisconsin 53703

DRAWING

FIRST FLOOR MEZZANINE

DATA







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(SECOND FLOOR PLAN AI.5 SCALE: 1/8" = 1"-0"			\bigotimes	

OWNER

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(608) 347-5432 University Avenue Madison, Wisconsin 53703


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Johnson Bend


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SECOND FLOOR PLAN



architecture

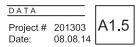

OWNER

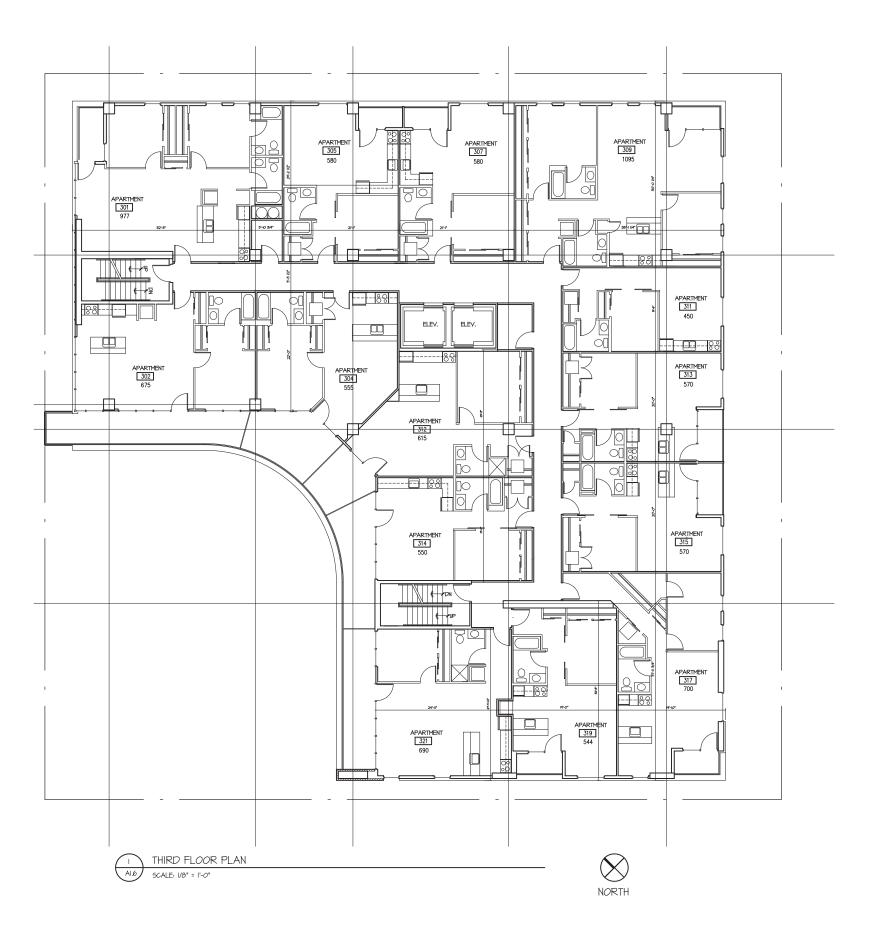Les Orosz (608) 347-543

(608) 347-5432 University Avenue Madison, Wisconsin 53703

PROJECT

Johnson Bend

433 West Johnson Street Madison, Wisconsin 53703

DRAWING

THIRD FLOOR PLAN

DATA





APASTIPENT OTS OTS OTS APASTIPENT OTS OTS OTS OTS OTS OTS OTS O	
TYPICAL FLOOR PLAN SCALE: 1/8" = 1'-0"	

OWNER

Les Orosz

(608) 347-5432 University Avenue Madison, Wisconsin 53703

PROJECT


Johnson Bend

433 West Johnson Street Madison, Wisconsin 53703

DRAWING

TYPICAL FLOOR PLAN

DATA

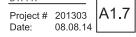





APARIMENT 1202	APARTMENT 1205 510 N-0 MV	APARIMENT 1203 516 APARIMENT 1212 615 APARIMENT 1212 550 APARIMENT 1213 550	APARTMENT 1709 833 90 800 100 100 100 100 100 100 100 100 10	MENT	
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OWNER

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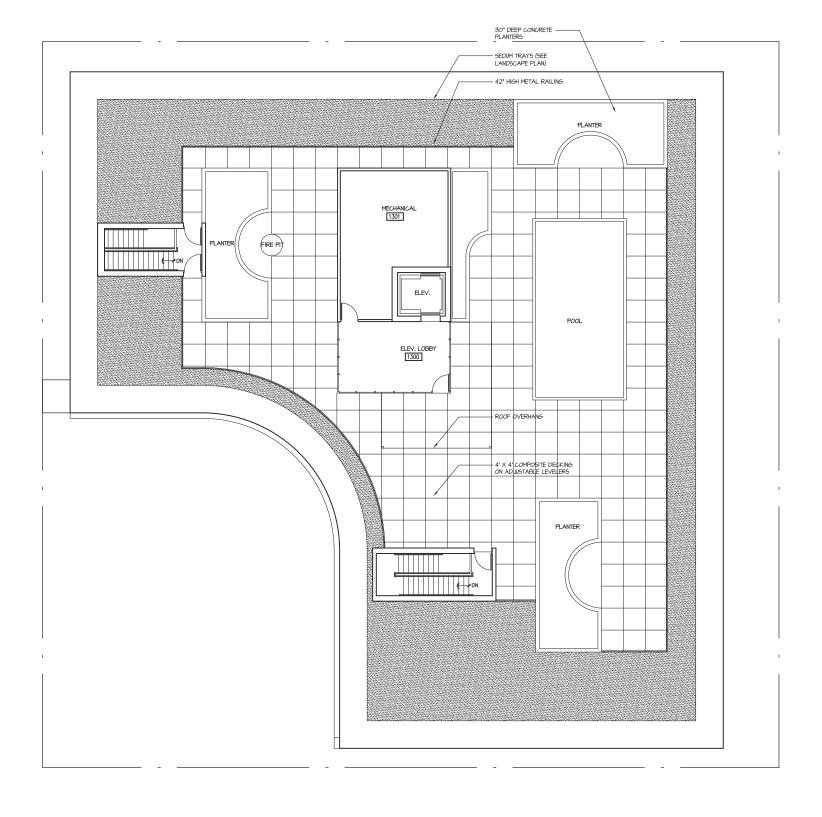
Johnson Bend

433 West Johnson Street Madison, Wisconsin 53703

DRAWING

TWELVETH FLOOR PLAN





ROOF TERRACE PLAN

Al.9 SCALE: 1/8" = 1'-0"



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University Avenue Madison, Wisconsin 53703

PROJECT

Johnson Bend


433 West Johnson Street Madison, Wisconsin 53703

DRAWING

ROOF TERRACE PLAN

DATA




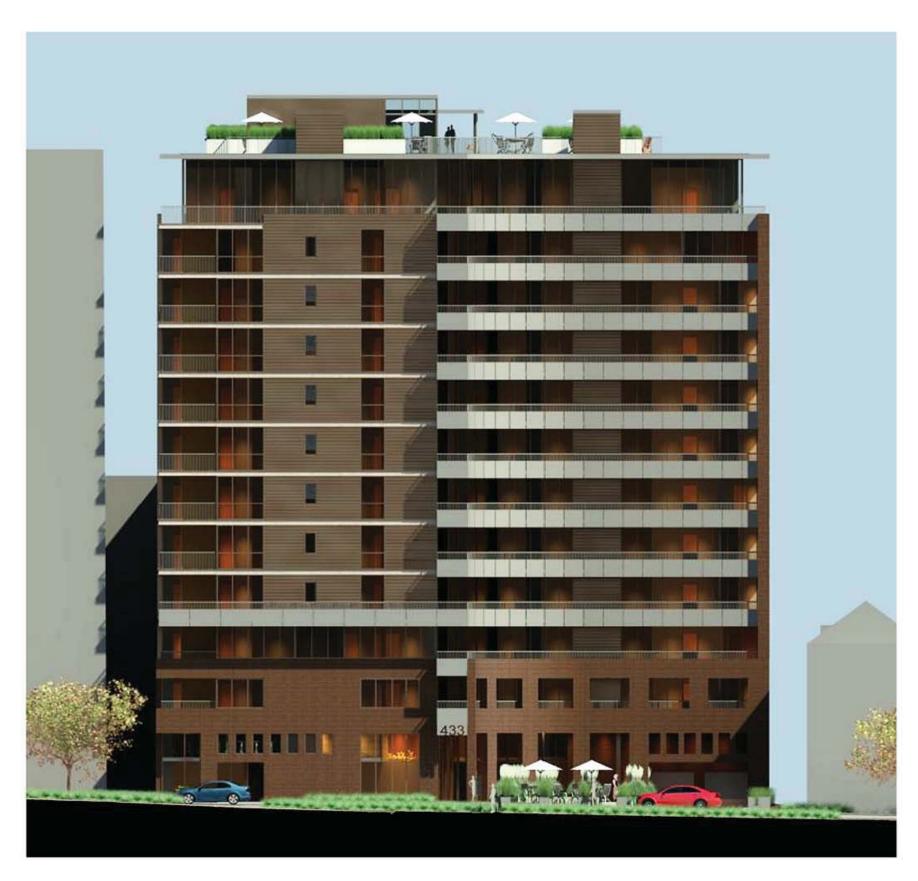

North West Elevation





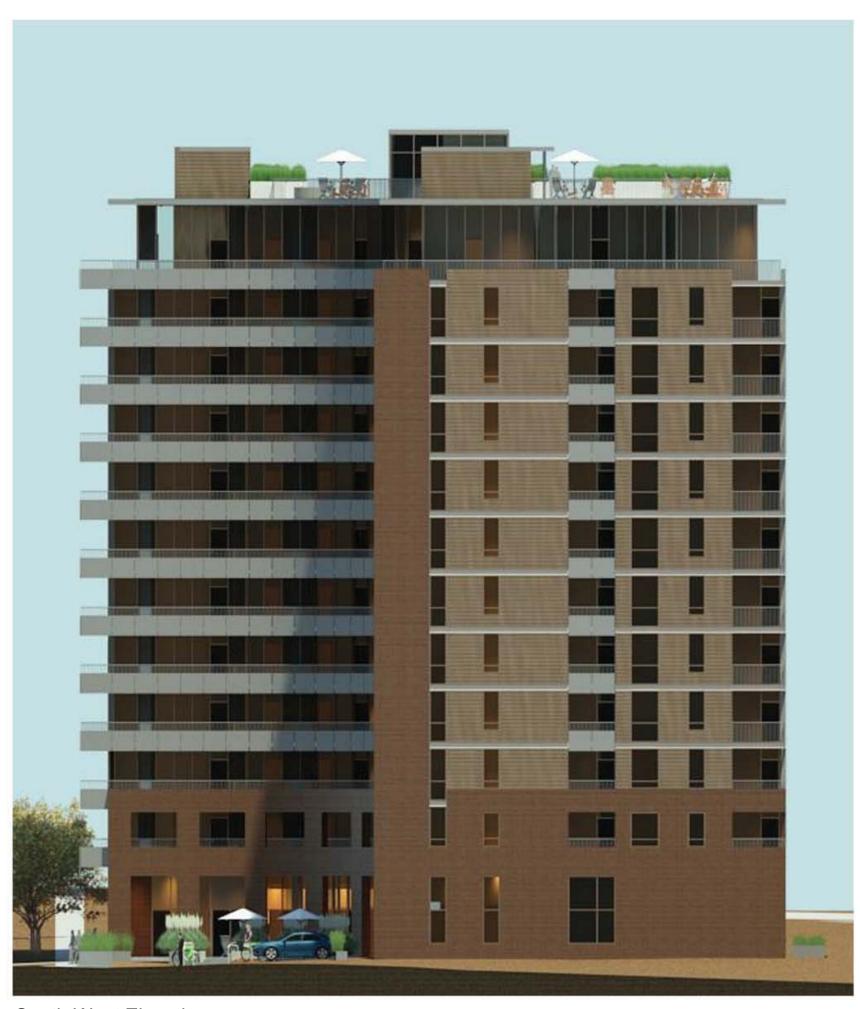

South West Elevation











- Brick masonry Utility Medium Ironspot 46 Velour (Endicott Clay Products)

- 5. EIFS

 - Figure 2 Dryvit Outsulation X System
 Color: #364b Totem Pole
 Texture: Sandpebble Fine NT
 Galvanized steel plate w/ concealed fasteners
 Guardrail (vertical balusters @ 4* o.c.)
 Galvanized steel channel MC12x10
- Opening in masonry wall

- 10. 20" masonry wall brick veneer on both sides
 11. 1" Galvanized steel plate w/ plasma cut address



OWNER

Les Orosz

(608) 347-5432 University Avenue Madison, Wisconsin

PROJECT

Johnson Bend

433 West Johnson Street Madison, Wisconsin 53703

DRAWING

NORTH WEST ELEVATION 1/8" = 1'-0"

DATA

Project # 201303 A2.1. Date: 08.01.14







- 1. Brick masonry
 Utility Medium Ironspot 46 Velour (Endicott Clay Products)
 2. Architectural metal panel w/ concealed fasteners
 'Centria' concept series metal panel system CS-620
 Substrate: 22 ga Galvalume
 Color: 9987 Bronze II
 3. 1" Galvanized steel planter
 4a. Thermally broken aluminum storefront system ('Kynar' color to match metal panel)
 w/ 1" insulated glazing unit or 1" insulated spandrel unit
 1/4" Solarban 60 #2
 1/2" Black Tech/Argon
 1/4" Clear

 4b. Thermally broken aluminum curtainwall system ('Kynar' color to match metal panel)
- 5. EIFS
 - EIFS
 'Dryvit' Outsulation X System
 Color: #364b Totem Pole
 Texture: Sandpebble Fine NT
 Galvanized steel plate w/ concealed fasteners
 Guardrail (vertical balusters @ 4* o.c.)
 Galvanized steel channel MC12x10
 Openion is presentated.

- Opening in masonry wall
- 10. 20" masonry wall brick veneer on both sides
 11. 1" Galvanized steel plate w/ plasma cut address



OWNER

Les Orosz

(608) 347-5432 University Avenue Madison, Wisconsin

PROJECT

Johnson Bend

433 West Johnson Street Madison, Wisconsin 53703

DRAWING


SOUTH WEST ELEVATION 1/8" = 1'-0"

DATA

Project # 201303 A2.2. Date: 08.01.14





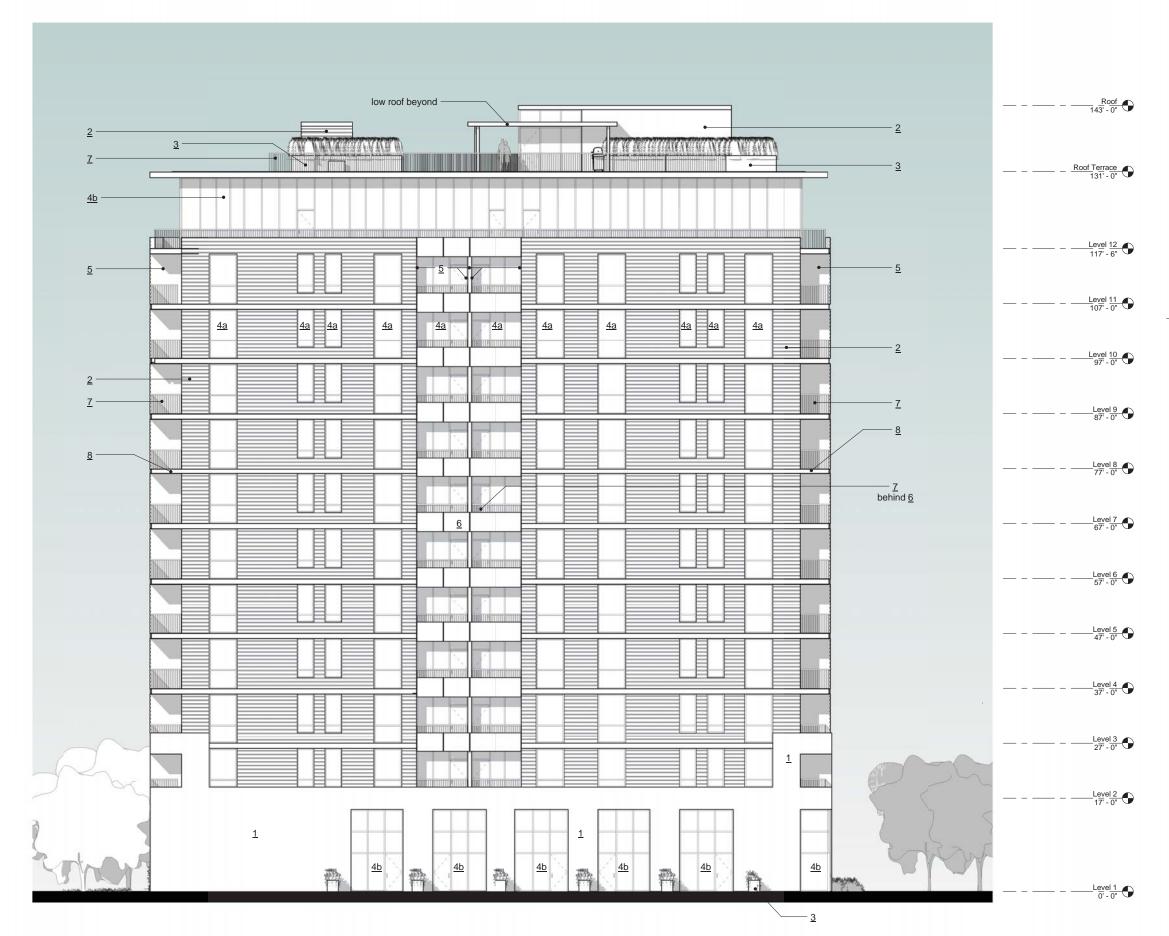

- Brick masonry
 Utility Medium Ironspot 46 Velour (Endicott Clay Products)
- Architectural metal panel w/ concealed fasteners
 'Centria' concept series metal panel system CS-620
 Substrate: 22 ga Galvalume
 Color: 9987 Bronze II

 1" Galvanized steel planter
- 1" Galvanized steel planter
 Thermally broken aluminum storefront system ('Kynar' color to match metal panel)
 w/ 1" insulated glazing unit or 1" insulated spandrel unit
 1/4" Solarban 60 #2
 1/2" Black Tech/Argon
 1/4" Clear
- 4b. Thermally broken aluminum curtainwall system ('Kynar' color to match metal panel) w/ 1" insulated glazing unit or 1" insulated spandrel unit
 1/4" Solarban 60 #2
 1/2" Black Tech/Argon
 1/4" Clear
- 5. EIFS
 - 'Dryvit' Outsulation X System Color: #364b Totem Pole Texture: Sandpebble Fine NT Galvanized steel plate w/ concealed fasteners
- Guardrail (vertical balusters @ 4" o.c.)
 Galvanized steel channel MC12x10

- Opening in masonry wall 20" masonry wall brick veneer on both sides 1" Galvanized steel plate w/ plasma cut address



OWNER

Les Orosz

(608) 347-5432 University Avenue Madison, Wisconsin

PROJECT

Johnson Bend

433 West Johnson Street Madison, Wisconsin 53703

DRAWING

SOUTH EAST ELEVATION

1/8" = 1'-0"

DATA Project # 201303 A2.3.

Date: 08.01.14







- Brick masonry
 Utility Medium Ironspot 46 Velour (Endicott Clay Products)
- Utility Medium Ironspot 46 Velour (Endicott Clay Products)

 Architectural metal panel w/ concealed fasteners

 'Centria' concept series metal panel system CS-620

 Substrate: 22 ga Galvalume
 Color: 9987 Bronze II

 1" Galvanized steel planter

 Thermally broken aluminum storefront system ('Kynar' color to match metal panel)

 w/ 1" insulated glazing unit or 1" insulated spandrel unit

 1/4" Solarban 60 #2

 1/2" Black Tech/Argon
 1/4" Clear

 Thermally broken aluminum curtainwall system ('Kynar' color to match metal panel)

- 5. EIFS
- Figure 2 Dryvit Outsulation X System
 Color: #364b Totem Pole
 Texture: Sandpebble Fine NT
 Galvanized steel plate w/ concealed fasteners
 Guardrail (vertical balusters @ 4* o.c.)
 Galvanized steel channel MC12x10
- Opening in masonry wall
- 10. 20" masonry wall brick veneer on both sides
 11. 1" Galvanized steel plate w/ plasma cut address



OWNER

Les Orosz (608) 347-5432

University Avenue Madison, Wisconsin

PROJECT

Johnson Bend

433 West Johnson Street Madison, Wisconsin 53703

DRAWING

NORTH EAST ELEVATION

1/8" = 1'-0" DATA

Project # 201303 A2.4.

Date: 08.01.14



View from West Johnson Street



