

City of Madison

Proposed Demolition & Conditional Use

Location 330 East Wilson Street


Project Name Palladia Mixed–Use Building

Applicant Palladia, LLC/Josh Wilcox -Gary Brink & Associates


Existing Use
Office building

Proposed Use Demolish office building to allow construction of mixed-use building with 1,300 square feet of commercial space and 30 apartments

Public Hearing Date Plan Commission 28 July 2014

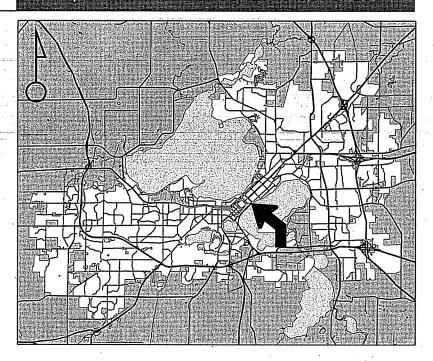


For Questions Contact: Heather Stouder at: 266–5974 or hstouder@cityofmadison.com or City Planning at 266–4635

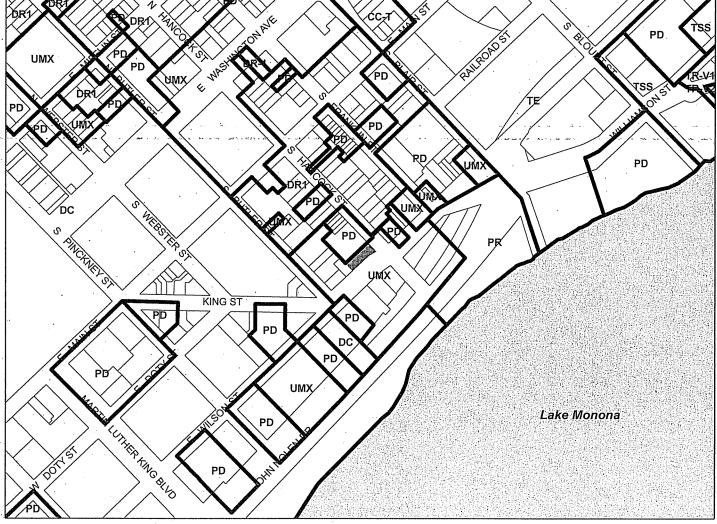

Scale: 1" = 400'

City of Madison, Planning Division: RPJ: Date: 17 July 2014



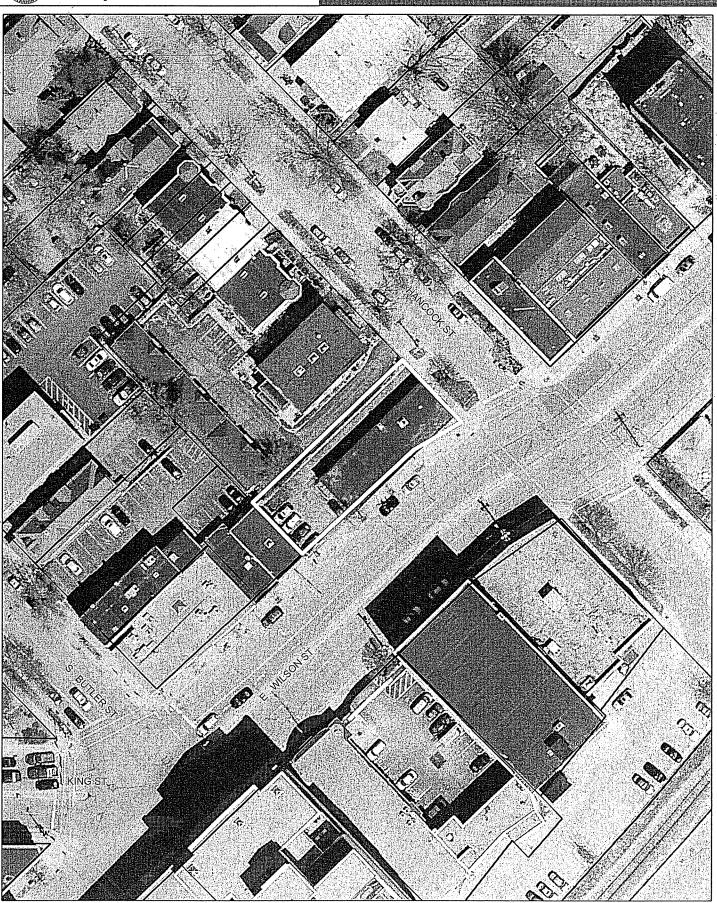

Date of Aerial Photography : Spring 2013



LAND USE APPLICATION

CITY OF MADISON

- All Land Use Applications should be filed with the Zoning Administrator at the above address.
- The following information is required for all applications for Plan Commission review except subdivisions or land divisions, which should be filed using the Subdivision Application.
- This form may also be completed online at: www.cityofmadison.com/developmentcenter/landdevelopment

Demolition and re-development of property located at 330 E. Wilson Street

August 2014

Development Schedule: Commencement

Madison 11	
215 Martin Luther King Jr. Blvd; Room LL-100 PO Box 2985; Madison, Wisconsin 53701-2985 Phone: 608.266.4635 Facsimile: 608.267.8739	FOR OFFICE USE ONLY: Amt. Paid 1550 Receipt No. 153376 Date Received 4/23//4 Received By 84
 All Land Use Applications should be filed with the Zoning Administrator at the above address. 	Parcel No. 0709-133-2624-9 Aldermanic District 6 Rummel Zoning District UMX
 The following information is required for all applications for Plan Commission review except subdivisions or land divisions, which should be filed using the <u>Subdivision Application</u>. 	Zoning District VMX Special Requirements Review_Required By:
This form may also be completed online at: <u>www.cityofmadison.com/developmentcenter/landdevelopment</u>	Urban Design Commission Plan Commission Common Council Other: Form Effective: February 21, 2013
1. Project Address: 330 E. Wilson Street	
Project Title (if any):	
 Zoning Map Amendment from	to Major Amendment to Approved PD-SIP Zoning nmission) ional Use
445 F. Maria Olivert O. U. 040	Nothe Real Estate Partners
609 460 0050	Madison/WI Zip: 53703 Email: kevin@kotherep.com
rax. (Email: Kevin@komerep.com ny: Gary Brink & Associates, Inc.
Street Address: 7780 Elmwood Avenue, Suite 204 City/State:	Middleton/WI zip: 53562
Telephone: (608) 829-1750 Fax: (608) 829-3056	Email: josh.wilcox@garybrink.com
Property Owner (if not applicant):	
Street Address: City/State:	Zip:
4. Project Information: Provide a brief description of the project and all proposed uses of the Demolition and re-development of property located at 330 F. Wilson Street	e site:

May 2015

Completion

5. Required Submittal Information

All Land Use applications are required to include the following:

$\overline{\mathbf{V}}$	Project	Plans	includir	rg:*
-------------------------	---------	--------------	----------	------

- Site Plans (<u>fully dimensioned</u> plans depicting project details including all lot lines and property setbacks to buildings; demolished/proposed/altered buildings; parking stalls, driveways, sidewalks, location of existing/proposed signage; HVAC/Utility location and screening details; useable open space; and other physical improvements on a property)
- Grading and Utility Plans (existing and proposed)
- Landscape Plan (including planting schedule depicting species name and planting size)
- Building Elevation Drawings (fully dimensioned drawings for all building sides, labeling primary exterior materials)
- Floor Plans (fully dimensioned plans including interior wall and room location)

Provide collated project plan sets as follows:

- Seven (7) copies of a full-sized plan set drawn to a scale of 1 inch = 20 feet (folded or rolled and stapled)
- Twenty Five (25) copies of the plan set reduced to fit onto 11 X 17-inch paper (folded and stapled)
- One (1) copy of the plan set reduced to fit onto 8 ½ X 11-inch paper
- * For projects requiring review by the **Urban Design Commission**, provide **Fourteen (14) additional 11x17 copies** of the plan set. In addition to the above information, <u>all</u> plan sets should also include: 1) Colored elevation drawings with shadow lines and a list of exterior building materials/colors; 2) Existing/proposed lighting with photometric plan & fixture cutsheet; and 3) Contextual site plan information including photographs and layout of adjacent buildings and structures. The applicant shall <u>bring</u> samples of exterior building materials and color scheme to the Urban Design Commission meeting.

✓	Letter of Intent: Provide or	ne (1) Copy per Plan Set describing this appli	cation in detail including, l	out not limited to:

- Project Team
- Existing Conditions
- Project Schedule
- Proposed Uses (and ft² of each)
- Hours of Operation

- Building Square Footage
- Number of Dwelling Units
- Auto and Bike Parking Stalls
- Lot Coverage & Usable Open Space Calculations
- Value of Land
- Estimated Project Cost
- Number of Construction & Full-Time Equivalent Jobs Created
- Public Subsidy Requested

	- Hours or Operation	Space Ca	culations	• Public Sui	usidy Requested
✓	Filing Fee: Refer to the	Land Use Application Instruction	<u>is & Fee Schedule</u> . Make che	ecks payable to	: City Treasurer.
✓		l applicants are required to submles on a non-returnable CD tonadison.com.			
	Additional Information	n may be required, depending or	application. Refer to the <u>S</u>	upplemental S	ubmittal Requirements.
5.	Applicant Declaration	ns			
√	neighborhood and bu alderperson, neighbor	cation: The Zoning Code requesiness associations in writinges hood association(s), and businesha Rummel); 2/12/14 (Jim	no later than <u>30 days press</u> association(s) AND the	r <mark>ior to FILING</mark> dates you sen	this request. List the
	→ If a waiver has been	n granted to this requirement,	please attach any correspo	ondence to thi	s effect to this form.
√		ng with Staff: Prior to prepara t and review process with Zoni			
	Planning Staff: Heath	ner Stouder Date: 1/23/1	4 Zoning Staff: Matt	Tucker	_ _{Date:} 1/23/14

The	applicant	t attests	that this	form is accurately	completed	and all r	equired r	materials a	are submitte	:d
		. P	eihelle	II C				Do	weloner	

name of Applicant	i diladia, LLO		Relationship to Property	A: Developel	
		A CONTRACTOR OF THE PARTY OF TH		4/00/44	•••••
Authorizing Signati	ire of Property Owner			Date 4/23/14	

GARY BRINK & ASSOCIATES, Inc.



April 23, 2014

Matthew Tucker Zoning Administrator Madison Municipal Building, LL 100 215 Martin Luther King, Jr. Blvd PO Box 2984 Madison, WI 53701-2984

Re: Co

Conditional Use

Letter of Intent for 330 E. Wilson Street

Dear Matt:

This is our Letter of Intent (Conditional Use) for the property located at 330 E. Wilson Street.

The proposed project consists of a 6-story, 30-unit residential apartment project with 1,283 sf of commercial space. The total square footage of the building is 29,405 sf. There are provisions for (38) bicycle stalls. Trash and recyclables will be located on the first floor.

The new structure will house a total of 30 apartment units with a unit mix as indicated below:

<u>Unit size</u>	Qty Units	# of bedrooms
Efficiency/Studio	10	10
(1) Bedroom	10	10
(2) Bedroom	5	10
(3) Bedroom	5	15
Total	30	45

The usable open space is as follows:

Balcony: 580 sfRoof Deck: 321 sfTotal 901 sf

The lot coverage is as follows:

Proposed 1st Floor Building Footprint: 36%
 Proposed 2nd Floor Building Footprint: 81%

The proposed construction schedule is for demolition of the existing structure to commence August, 2014 with new construction to commence immediately thereafter, and construction completion to be May, 2015. The development shall include the demolition of the existing structure on the building site.

The current assessed value of the land is \$309,000.

The people involved in the project are as follows:

Owner:

Palladia, LLC

c/o Kothe Real Estate Partners 115 E. Main Street, Suite 210

Madison, WI 53703 Contact: Kevin Page Phone: 608-469-0059 kevin@kotherep.com

General Contractor:

Landgraf Construction 5964 Executive Drive Madison, WI 53719 Contact: Mark Landgraf

Contact: Mark Landgraf Phone: 608-274-4700

 $\underline{mark.landgraf@landgrafconstruction.com}$

Landscape Designer:

Ken Saiki Design, Inc.

303 S. Paterson

Suite One

Madison, WI 53703 Contact: Abbie Moilien

Phone: 608-251-3600 amoilien@ksd-la.com

Architect:

Gary Brink & Associates, Inc. 7780 Elmwood Avenue, Suite 204

Middleton, WI 53562 Contact: Josh Wilcox Phone: 608-829-1750 josh.wilcox@garybirnk.com

Civil Engineer:

Quam Engineering

4604 Siggelkow Road, Suite A

McFarland, WI 53558 Contact: Ryan Quam Phone: 608-838-7750

rquam@quamengineering.com

Please refer to the attached plans for additional information.

Sincerely,

Josh Wilcox

VP/Senior Project Manager

- feel Willen

330 E. WILSON MIXED USE

330 E. WILSON STREET MADISON, WI 53703

UDC / PLAN COMMISSION SUBMITTAL APRIL 23, 2014



ZONING CODE: . MINMM FRONT YARD SETBACK • 0'-0', MAXMM FRONT YARD SETBACK • 10'-0' - FROPOSED = 1'-0' . SIDE YARD SETBACK . Ø'-Ø' . USABLE OPEN SPACE * 10° SF. PER BEDROOM * 450° SF. REQUIRED TOTAL BALCOM SF. * 560° SF. TOTAL ROOF DECK SF. * 33' SF. PROPOSED USABLE OPEN SPACE * \$0' SF. BKE PARKING REQUIREMENTS: 1 STALL FER MINT UP TO 2 BEDROOMS, \$ STALL FER ADDITIONAL BEDROOM. 1 GLEST SPACE FER UP MINTS. 2 STALLS REQUIRED FOR COMMERCIAL SPACE. ID. AREA OF THE SITE = 6,711 SQ. FT. IMPERVIOUS AREAS = 2,861 SQ. FT. 330 E. WILSON MIXED USE



GARY BRINK & ASSOCIATES

7780 ELMWOOD AVE. STE. 204 MIDDLETON, WI 53562 608-829-1750 608-829-3056 (FAX)

SHEET INDEX

T-1 COVER SHEET & PROJECT CONTACTS

CIVIL DRAWINGS

C1.00 EXISTING SITE PLAN
C1.01 GRADING AND EROSION CONTROL PLAN
C1.02 UTILITY PLAN

LANDSCAPE DRAWING

L1.00 PLANTING PLAN

ARCHITECTURAL DRAWINGS A1.00 PHOTOMETRICS
A2.00 BASEMENT FLOOR PLAN

A2.01 FIRST FLOOR PLAN / SITE PLAN
A2.02 SECOND THROUGH SIXTH FLOOR PLAN
A2.03 ROOF FLOOR PLAN

EXTERIOR SOUTH ELEVATION

EXTERIOR EAST & WEST ELEVATIONS EXTERIOR NORTH ELEVATION

CONCEPTUAL RENDERING

CITY OF MADISON

JUL 18 2014

Planning & Community & Economic Development

OWNER/DEVEOPER:

PALLADIA, LLC c/o KOTHE REAL ESTATE PARTNERS 115 E. MAIN ST., SUITE 210 MADISON, WISCONSIN 53703 PHONE: (608) 469-0059 EMAIL: kevin*kotheREP.com PRINCIPAL CONTACT: KEVIN PAGE

ARCHITECT:

GARY BRINK & ASSOCIATES. INC. 7780 ELMWOOD AVENUE, SUITE 204 MIDDLETON, WISCONSIN 53562 PHONE: (608) 829-1750 EMAIL: josh.wilcoxegarybrink.com PRINCIPAL CONTACT: JOSH WILCOX

GENERAL CONTRACTOR:

LANDGRAF CONSTRUCTION 5964 EXECUTIVE DRIVE MADISON, WISCONSIN 53719 PHONE: (608) 274-4700 EMAIL: mark.landgrafelandgrafconstruction.com PRINCIPAL CONTACT: MARK LANDGRAF

CIVIL/SITE ENGINEER:

QUAM ENGINEERING, LLC 4604 SIGGELKOW ROAD, SUITE A McFARLAND, WISCONSIN 53558 PHONE: (608) 838-7750 EMAIL: rquamengineering.com PRINCIPAL CONTACT: RYAN QUAM

LANDSCAPE DESIGNER:


KEN SAIKI DESIGN, INC. 303 S. PATERSON, SUITÉ ONE MADISON, WISCONSIN 53703 PHONE: (608) 251-3600 EMAIL: amoilien*ksd-la.com PRINCIPAL CONTACT: ABBIE MOILIEN OTHE REAL ESTATE PARTNERS


E. MAIN STREET SUITE 210


PROJECT: DRAWN BY:

DATE: SCALE: AS NOTED

> COVER SHEET

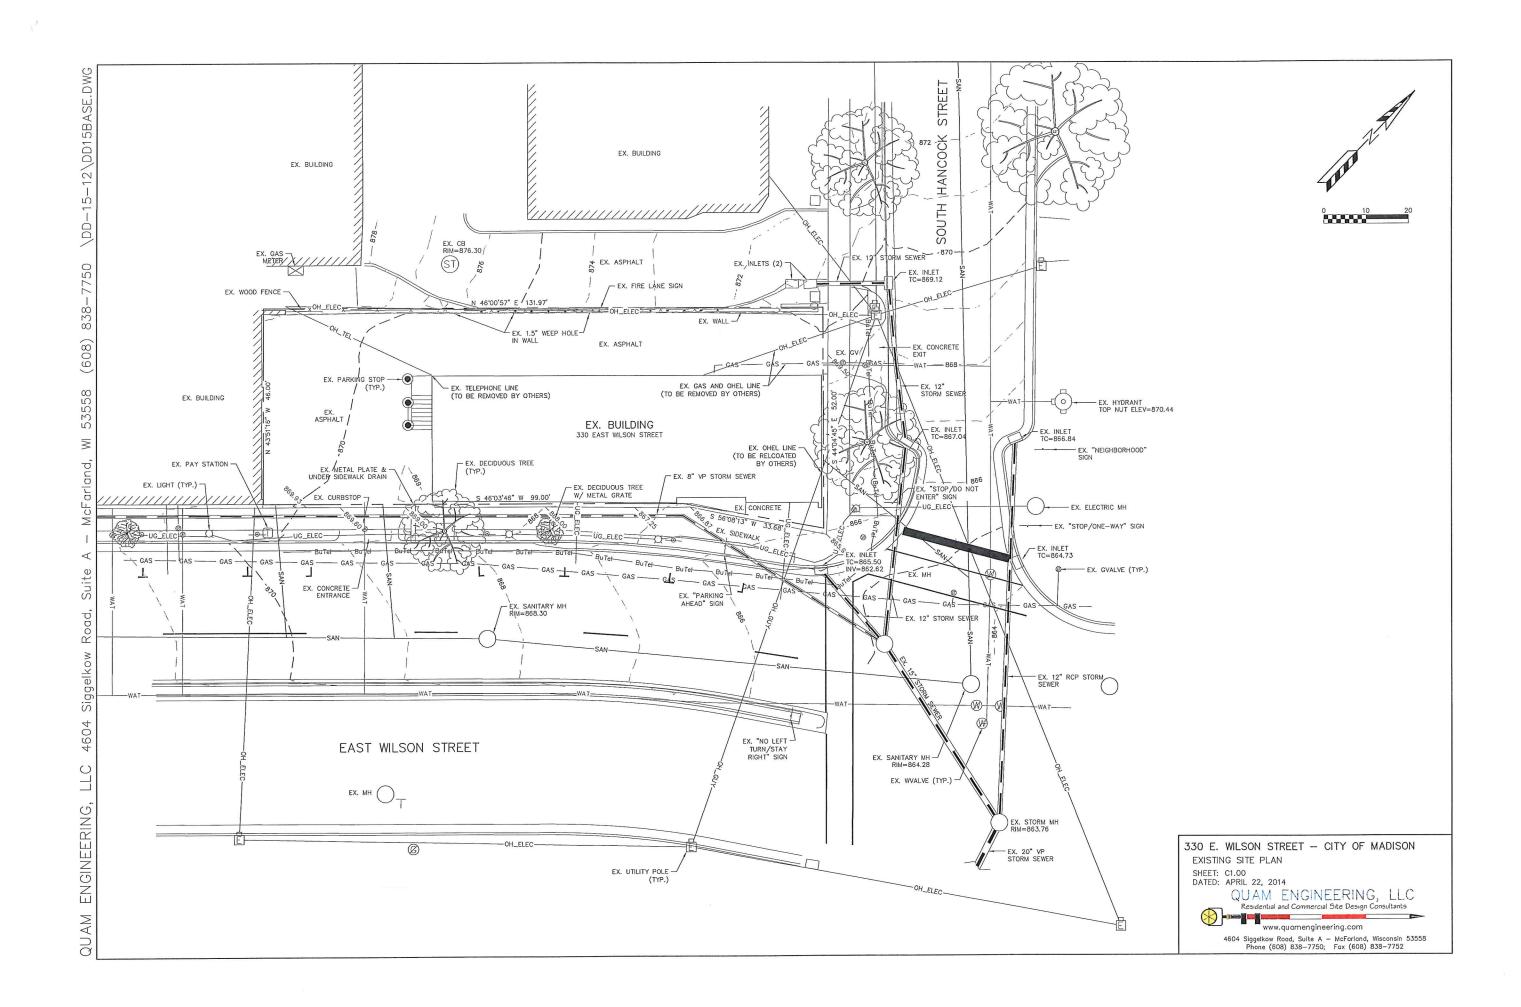

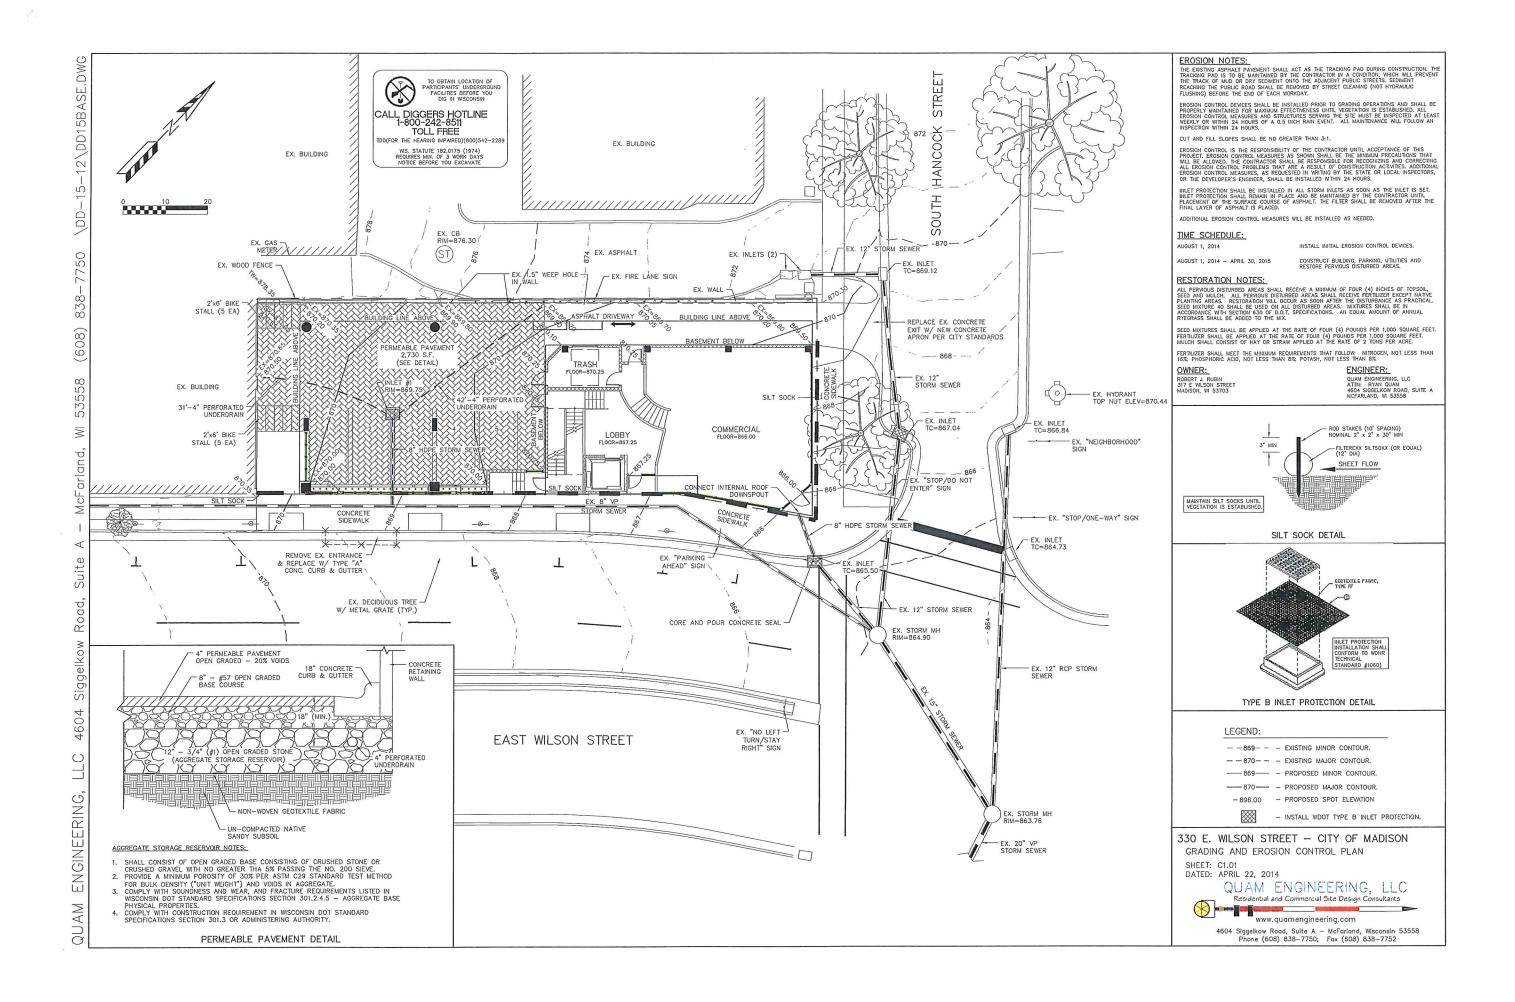

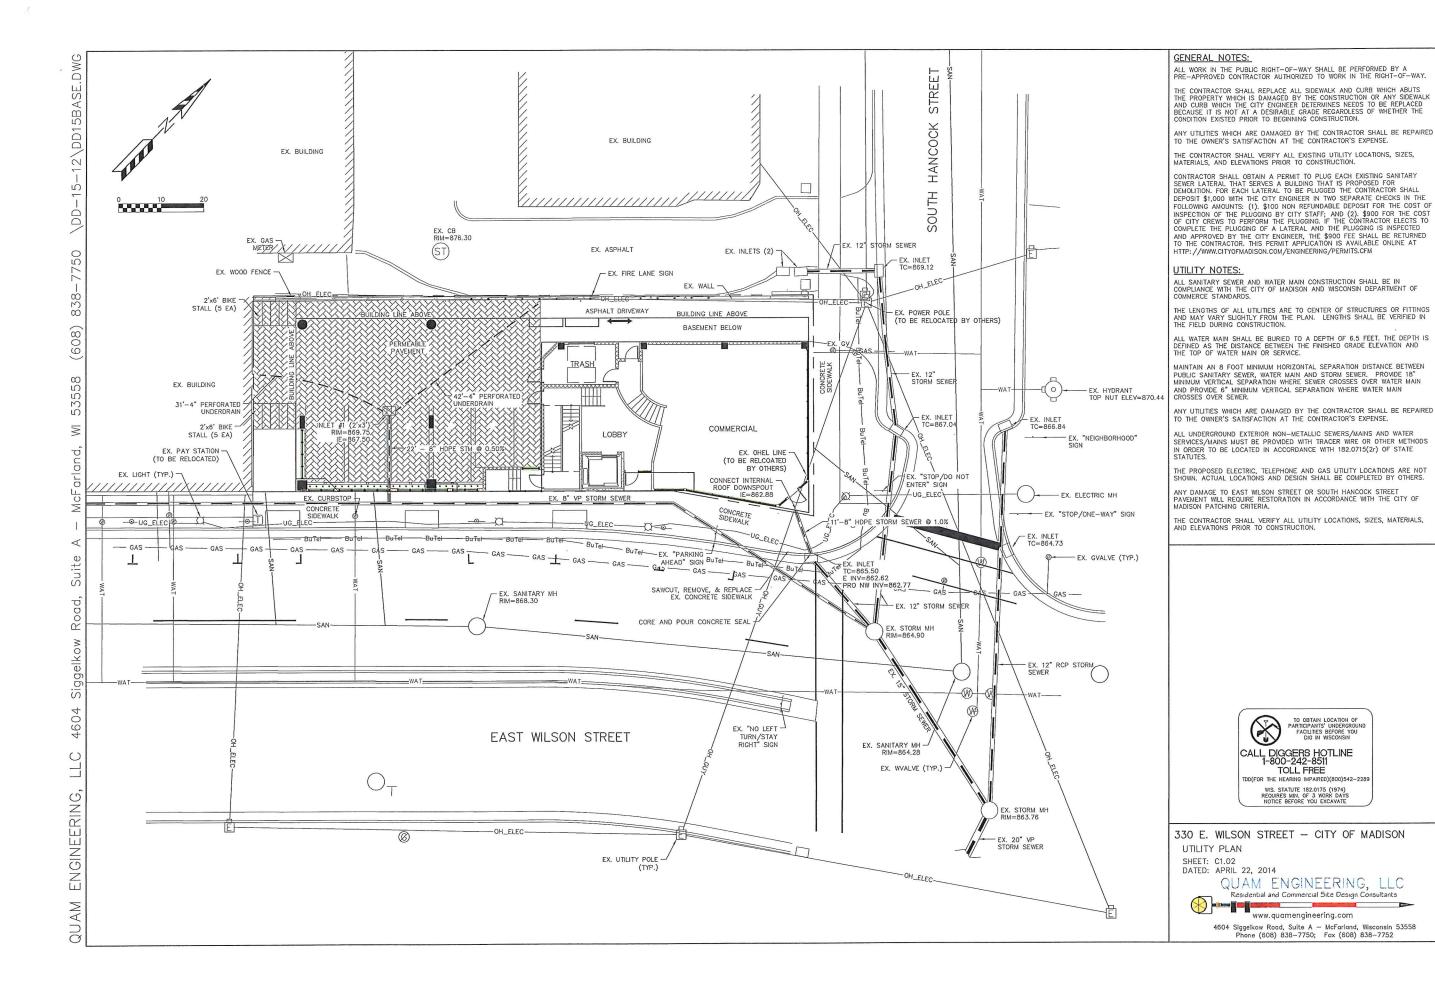

NOTE:
1. Protect all existing pavements, curbs, utilities, and other improvements during planting.

- 2. All plant beds shall have shredded hardwood bark mulch unless otherwise noted.
- 3. Plantings shall not be permanently irrigated.
- 4. Contractor shall notify City Forestry at least 48 hours prior to pouring terrace concrete so the planting site can be located in the field.
- 5. Contractor shall contact City Forestry at least 48 hours prior to any work on street trees. Contact Dean Kahl, 608—266—4816, DKahl@cityofmadison.com
- 6. Street trees shall be planted in $4^\prime x 8^\prime$ tree grates as determined by City Engineering.

City of Madison, WI Landscape Worksheet

22-Apr-14 Urban Mixed Use

		Landscape Units	
Developed Lots	SF	Required	
Total Developed Area	6,180	21	
		Landscape Points Required	

LF	Required	Shrubs Required
15	1	
	15	

Element	Point Value	Quantity Proposed	Quantity Existing	Points Achieved
Ornamental Tree	15	1		15
Shrub, evergreen	3	8		24
		Development From	tage Deduction Total	39

Element	Point Value	Quantity Proposed	Quantity Existing	Points Achieved
Overstory Deciduous Tree	35			0
Ornamental Tree	15	1		15
Evergreen Tree	15			0
Shrub, deciduous	2			0
Shrub, evergreen	3	6		18
Ornamental Grass	2	52		104
Ornamental/Decorative Fence or Wall (4 pts/10 LF)	4			0
		Genera	I Site Plantings Total	137

TOTAL LANDSCAPE POINTS ACHIEVED



GARY BRINK & ASSOCIATES

7780 ELMWOOD AVE. STE. 204 MIDDLETON, WI 53562 608-829-1750 608-829-3056 (FAX)



LANDSCAPE

PROJECT:
330 E. WILLSON
330 E. WILSON
MADISON, WI 53703
CLIENT:
KOTHE REAL ESTATE PARTNERS
115 E. MAIN STREET
MADISON, WI 53703

PROJECT: 201249 DRAWN BY: ARM DATE: 04/22/2014 AS NOTED SCALE:

> **PLANTING** PLAN

> > L1.00


2 ROOF PLANTING PLAN 0' 2.5' 5' 10' 15' Plant List

Key Botanical Name Mature Size Common Name Quantity Size Spec Comments Deciduous Trees Ginkgo biloba 'Princeton Sentry' Gleditsia triacanthos var. Inermis 'Skycole' Ulmus x 'NewHorizon' 40' ht x 15-30' sp 50-60' ht x 35-45' sp 50-60' ht x 40-50' sp 1 2.5° Cal. B&B Single, straight leader, match specimens; branching shall start at 5-0° min.
1 2.5° Cal. B&B Single, straight leader; match specimens; branching shall start at 5-0° min.
1 2.5° Cal. B&B Single, straight leader; match specimens; branching shall start at 5-0° min. inceton Sentry Ginkgo Ornamental Trees Imelanchier arborea 15-25' ht x 10-12' sp 20' nt x 25' sp 1 6° ht. B&B Multistem, min. 3 leaders; well-developed crown; no overlapping leaders
1 2° Cal. B&B Single, straight leader, match specimens; branching shall start at 5-0° min Downy Serviceberry Summer Snow Tree Lilac yringa reticulata 'Summer Snow Evergreen Shrubs Buxus x 'Green Velvet' 14 5 gal. Cont Space 3'-6" o.c. 3-4' ht x 4-5' sp Green Velvet Boxwood namental Grasses 1.5-2.5' ht x 1.5-2' sp 1.5-2' ht x 1.5' sp 23 1 gal. Cont. Space 18" o.c. 27 1 gal. Cont. Space 18" o.c. The Blues Little Bluestem 2.5-3' hl x 1.5-2' sp 1.5' ht x 1.5' sp 1.5-2' ht x 1-1.5' sp 1.5-2' ht x 1.5-2.5' sp Blue Fortune Agastache Summer Beauty Allium Pixie Meadowbrite Purple Conellower Little Spire Russian Sage
 24
 1 qt.
 Cont.
 Space 18" o.c.

 27
 1 qt.
 Cont.
 Space 18" o.c.

 28
 1 gal.
 Cont.
 Space 18" o.c.

 23
 1 qt.
 Cont.
 Space 18" o.c.

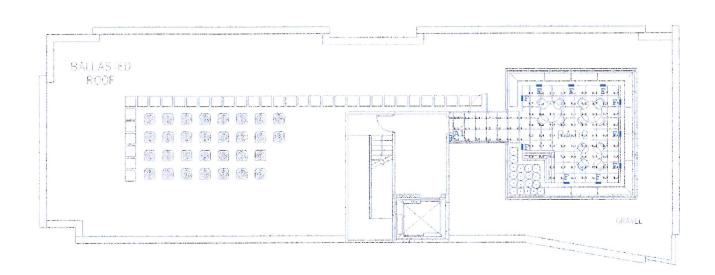


Qty	Label	Arrangement	Lum. Lumens	LLF	Description	
6	Α	SINGLE	735	0.900	LUMARK + XTOR1A	
2	В	SINGLE	5170	0.900	McGRAW-EDISON + TT-A3-LED-E1-WQ	
4	С	SINGLE	1477	0.900	PORTFOLIO + LD4A13D010TE-ERM4A13835-4LM1LI	
8	D	SINGLE	405	0.900	LUMENPULSE + LBS-120-27K-WFL-SI	
10	F	SINGLE	25	0.900	COLE + L158W-N-J	

Calculation Summary							
Label	CalcType	Units	Avg	Max	Min	Avg/Min	Max/Min
BIKE RACKS & PLANTING AREA	Illuminance	Fc	2.96	6.6	0.7	4.23	9.43
COMMERCIAL ENTRY	Illuminance	Fc	17.25	28.8	3.7	4.66	7.78
DRIVE ACCESS	Illuminance	Fc	2.51	17.8	0.4	6.28	44.50
EXIT TO DRIVE	Illuminance	Fc	29.15	30.3	28.0	1.04	1.08
LOBBY ENTRY	Illuminance	Fc	24.95	32.1	21.0	1.19	1.53
PARKING	Illuminance	Fc	3.47	6.5	0.9	3.86	7.22
ROOF PATIO	Illuminance	Fc	0.48	1.3	0.2	2.40	6.50
ROOF PATIO_1	Illuminance	Fc	2.59	7.2	0.4	6.48	18.00
STAIR EXIT	Illuminance	Fc	13.87	28.8	3.8	3.65	7.58



GARY BRINK & ASSOCIATES
ARCHITECTS

7780 ELMWOOD AVE. STE. 204
MIDDLETON, WI 53562
608-829-1750
608-829-3056 (FAX)

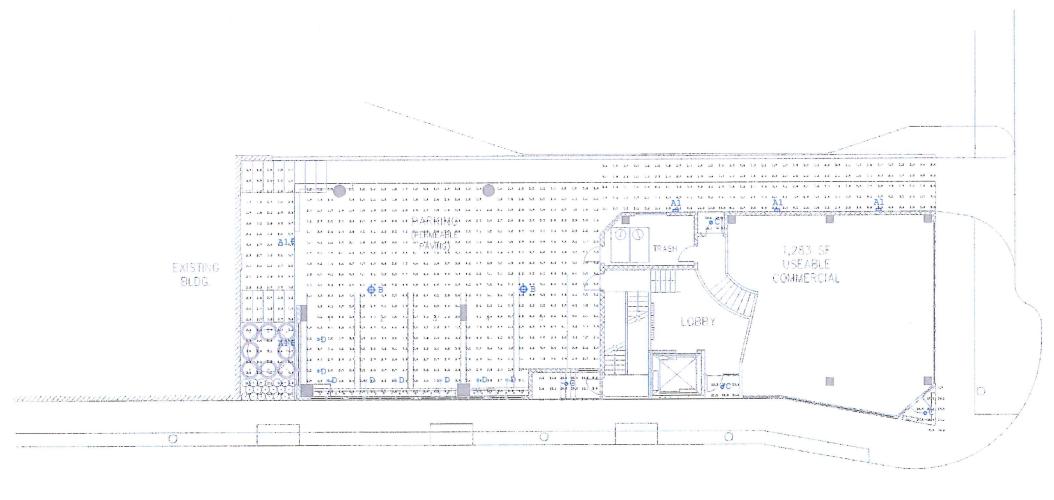

E. WILSON ST.

PROJECT:
330 E. WILLSON
390 E. WILSON
MADISON, WI 53703
CLENT:
115 E. MAN STREET
MADISON, WI 53703
MADISON, WI 53703

© 2014 GARY BRINK & ASSOC Any displication, reproduction, or use by other party is prohibited unless prior with authorization is received from GARY ER ASSOC

PROJECT: DRAWN BY: DATE:

SCALE: AS NOTED

SITE
LIGHTING
CALCULATIONS

A1.00



Optical
Silicone scaled optical LED
Silicone scaled optical LED
Silicone scaled optical LED
Silicone scaled optical scaled
reflector providing high-afficiency litumination, Optical assembly includes impact-resistent
litumination, Optical assembly includes impact-resistent
litumination, Optical assembly includes impact-resistent
requirements for full cutoff compliance. Solid state LED
Crostsout inflamatels as net hermally optimized with five fig lumen
control optical litumination of the compliance of the complia





XTOR CROSSTOUR LED

conduction and natural convection to transfer heat rapidly away from the LED source. 10W models operate in 40°C to 40°C L40°F to 104°FI. 20W and 30W models operate in -30°C to 40°C [-22°F to 104°FI, High ambient 50°C models available. Crosstour luminaires maintain greater than 70% of initial	Warranty Five-year limited warranty	WALL / SUI POST / BOI LOW FLOOD WAY! SITE LIGH
ESCUTCHEON PLATE	S 1354maj	GERTIFICATION DATA Useds Visit Cestion Used FOICE Compliant ABAL Compliant

ECHNICAL DATA PC Maximum Ambient ternal Supply Wiring SC



APPLICATIONS: WALL / SURFACE POST / BOLLARD LOW LEVEL FLOODLIGHT WYERTED SITE LIGHTING

XTOR CROSSTOUR LED DRAW LUMEN MAINTENANCE

UMEN MAI	NTENANCE		LUMENS - CRI/CCT	TABLE					CURREN	TORA	V	
Ambient TN1-21 Lumes	Theoretical L70	LEO Information XTORIA XTO	XTORZA	TORZA XTORZA-N	XTORJA	XTOR3A-N		Model Sories				
Temperature		(Hours)	Delivered Lumena NYAR Mounts	734	1432	1223	2540	2273	Voltage	10W	20W	309
10W Model			Delivered Lumana				-	-	120V	ABO.0	0.214	
25°C	>91%	>350,000	(With Flood 713 1424 1315 26	2814	2243	2067	0.04A	0.134	0.15			
42°C	+915	> 340,000	Accessory Krit						2407	0.04A	0.12A	0 15
sorc	> 21%	>330,000	B.U.G. Rading*	81-U0-G0	B1-U0-G0	B1-L'0-G0	81-U0-G0	B1-U0-G0	277V	0.024	0.104	0.14
20W Model	77.4	730.00	CCT (kelvin)	5000	5000	3500	5000	3500	347V	0.034	0.08A	0.11
25°C	>91%	> 310,000	CRI	87	*5	£8	45	63				
40°C	> 90%	> 320,000	(Cofor Rendering Indus)									
50°C	> 90%	> 300,000	Power Consumption (Wats)	8/4	21W	21W	sow	WOC				
30W Model			* B.U.G. Rating does not	apply to floo	diphona.		-	_				
25°C	> 91%	> 340,000										
45°C	>91%	> 220,000										
50°C	> 90%	> 300,000										

50°C	2,30%	> 300,000			
ORDERING	INFORMATIO	N.			
Sample Numb	er XTOR2A-N-W	T-PC1			
C. t. at	1	CONT. L. C. L. C.	Manager Cates	Contractant or F. M.A.	1

Sample Number 2 Series 1 XTORIA-Small C XTORIA-Small C XTORIA-Small C

10W Series	20W Steles	30W Series
XTORIA 10VV 5000K, Carbon Bronne	XTORZA=20VI, 5000K, Cartion Bronze	XTCR3A=30W, 5000K, Carbon Bronze
XTORIA-WT=10W, 5000K, Summit White	XTORZA-N+20W, 3500K, Carbon Bronza	XTOR3A-N+30V/, 3600K, Carbon Bronze
XTORIA-PCI+10W, 5000K, 120V PC, Carlon Bronze	XTOR2A-WT=20V, Surrent White	XTOR3A-WTx30W, Summit White
	XTORZA PC1s20W, 120V PC, Carbon Bronza	XTOR3A-PC1+30VL 120V PC. Carbon Bronza



10VY Secies	20W Series	30W Suries
XTORIA-WEFC1+10W, 5000K, Summit White, 120V FC	XTOR2A-FC2+20W, \$000K, 203-277V PC, Carbon Bronza	XTOR3A-PC2+30W, 5000K, 209-277V PC, Carson Bronze
	XTORZA WTPC1-20W. 5000K, Summit White, 120V FC	XTOR2A-WTFC1-30W, 5000K, Summit White, 120V PC
	XTORIA-WT-PC2+20W, 5000K, Summit White, 208-277V PC	XTOR2A-WTFC2+30W, 5000K, Summer White, 205 277V PC
	XTOR2A-N-WT+20W, 3500K, Summit White	XTDRIA N-WT-30W, 35COK, Summit White
	XTORIA N-PC1+20VV, 3500K, 120V PC, Carbon Bronus	XTOR2A N-FC1+30W, 3500K, 120V PC, Carbon Bronze
	X10R2A-N-PC2-20V 3500K, 208-277V PC, Carbon Bronze	XTORIJA N-PCZ-30V, 3500K, 208-277V PC, Cartion Branze
	XTORZA-N-WHT-PC1+20W, 2500K, Surramit White, 120V PC	KTORSA N-WHTPC1+30W, 3520K, Surren I Winig, 120V PC

Cooper Lighting

McGRAW-EDISON®

UESCRIPTION

The TopTier® Parking Garage and Canopy Luminaire is an Innovative solution that delivers an unparalleled combination of performance and visual combiner. The passinet of Versiferam® once is technology and the particular of the particular of Versiferam of Versiferam on the inhology and the particular of Versiferam on the particular of Versiferam on the Versif

Finish House finished to the Mouse finished with the Mouse finished to the Mouse finished finished to the Mouse finished finished to the Mouse finished finished

Champe of the Control of the Control



TT TOPTIER LED ARKING GARAGE AND CANOPY LUMINAIRE

SHIPPING DATA Approximate Net Weight 16 los 17.2 Loss **1**

Cooper Lighting

ORDERING INFORMATION

Sample Number T-mO-ALDEL WO-AP

Product Early

Tintip Tiss

All-Nomined Scotl

Listense

All-Nomined Scotl

All-Nomined Scot

Exten State Content of the Content o Spectromer and distriction subsect to characteristics makes

Cooper Lighting

DIMENSIONS

4 inch LED recessed medium beam downlight with 50° cut off specially designed for LED technology. Two stage reflector system produces smooth distribution with excellent light control and low aperture

3-5-8: (92mm) 3-5-8: (92mm) 4: (102mm)

Cooper Lighting

9 13

fifthlight

PORTFOLIO™

Type C LD4A13D010TE ERM4A13835

amoient temperatures above av Code Compillace
Thermally protected and cULus listed for protected wet location 1696 rated when used with 1666 gastat lix accessor. Optional City of Chicago environmental at rCCEAP matting for pletume at rCCEAP matting for pletume at rCCEAP matting for pletume at rCCEAP part 18 Class 8 consumer limits. Non-Crated-Insulation must be kept 3" from top and sides of housing. Robit Scompilant. ARIA Compilant. ARIA Compilant. Protomotic testing compileted in source and compileted in source data of the compileted in source data of th

LD4A09 LD4A13 4LM

900 Lumen LED 1300 Lumen LED 4-Inch Medium Beam Downlight New Construction

T24

Outlife and Compilate Refor to the EXEST STAN 'Outlife A product List and ICE (CR) Appliance Dubbase for Estings.



MAIR COUNTY TO 100V Step Down Transformer, 200VA MSAA+ Stope Adopter for 4* Aperture Housings, Speedy Stope TRAMAP Adopted Time Ring, White! TRAMAP Adopted Time Ring, Bladd TRAM-Rindsoffer Ring! (GSKT9960F60 Gode KE AMNS-4" Medium Perlenter Land Anne Milly White Physics Land Medium Anne Anne Cell Broyce Commission of the Commission of the Cell Broyce Commission of the Commission of the Cell Broyce Commission of the Cell Broyce Cell Broyce Commission of the Cell Brown Cell Broyce Commission of the Cell Brown White Cell Brown Land Commission of the Cell Brown Land Cell Brown Commission of the Cell Brown Cel HEZE-C-channel Bar Hanger. 26" Long, Pair HBS-C-Channel Bar Hanger, 50" Long, Per BMB22-Wood Joint Bar Hanger, 22" Long, Per HZTP-427" to 120" Step Down Transfermer, 50"VA HSH* 347 to 120" Step Down Transfermer, 75"VA PHOTOMETRICS ENGOGRA PARATER Downlight

OTE ERMAA1335 4LMOLIL4" LEO Medium Beam Reflector Lens, 1300 fumen, 3,500 K Color with Universal 120 - 277V, 0 - 10 Driver Housing Lumens' | BESIDO-3-close| | BESIDO-3-close| | Control | Control

Average Cardella Average 0*

Degrees Lummonce

45 3501

55 0

65 0

75 0

65 0 900 Luners 64 1000 Luners 45 Cooper Lighting

CCT Multiplication Factors		CCTPG	Mutiliplier from 35,00K	80 → 90 CR
		2/00	0.93	
	800 Luman	3300	0.93	
i		3500	100	
PO CDI		4300	1.01	
EUCH	1300 Lumen	2700	0.93	
		3000	0.99	
i i		3500	1.00	
		4000	1.01	
		2700	0.63	0.79
i	900 Lumen	3000	0.95	0.20
		3500	100	0.84
		4300	1 103	0 26
90 CF8		2700	0.68	0.79
1		3000	0.94	0.79
1	1300 Lumen	3500	1.00	0.34

Cooper Lighting

Cooper Lighting

GARY BRINK & ASSOCIATES ARCHITECTS 7780 ELMWOOD AVE. STE. 204 MIDDLETON, WI 53562 608-829-1750 608-829-3056 (FAX)

PROJECT:
330 E. WILLSON
330 E. WILLS

© 2014 GARY BRINK & ASSOC.


Any duplication, reproduction, or use by any other party is prohibited unless prior written authorization is received from GARY BRINK & ASSOC.

PROJECT: DRAWN BY: DATE: SCALE: AS NOTED

SITE LIGHTING **FIXTURE CUT SHEETS**

A1.01

Client: Project name:	WHITE & STATIC OF 333 E. Wilson Type D LBS-X-27K-V
Order #:	
Type:	
FEATURES AND BENEFITS	
Physical:	
low copper content high pressure directed aluminum housing Heavy aluminum formed yoke	
Stain'ess sheel hardware Silicana scaling dayees	
Clear tempered plass	(() (1) (1)
Dual chamber design for heat management and ease of maintenance Electro-statically applied polyester pander coal finish	
 2.40 kg / 5.20 lbs EPA: Front = 0.35 sq ft / 0.033 sq.m. Side = 0.31 sq fr/0.029 sq m. 	
• IP66	
Constantes and option for marine environments	
Performance: • 6°, 10°, 20°, 40°, 60°, Elliptical distribution on 10° and 40° optics	•
CRI volves: 78+	:(U): (E
 Iumen ma menance 120,000 hrs [1/0 @ 25°C] Operating temperatures: -25° C to 50° C [-13F to 122F] 	Wiring detail
	· ·
Electrical: • Uine voltage luminaire for 120 to 277V	WIRE COLOR / USE
Power and data in 1 coole, 3ft/1m cord (#16-5) 14 wals	GREEN GROUND WHITE NEUTRAL
C-10 valt, DMX or DAU dimming options	BLACK UVE 120-27 RED 0-10V / DA
4 ½ 118 mm	ORANGE 0-10V/DA
03.5 m 05.5 m 0	
Standard Yoke Nourting Option 5 year warranty	ET .
(8 tempole (2) Thinks we still standard about the kind of the TRANCES (1) (4) (4) (5) (5) (4) (4) (4) (5) (6) (6) (6) (6) (6) (6) (6) (6) (6) (6	umenpulse
13. 111.5 Lumenpulse reserves the right to make changes to this product of any time without prior notice	
Susta	inable architectural LED lighting sys

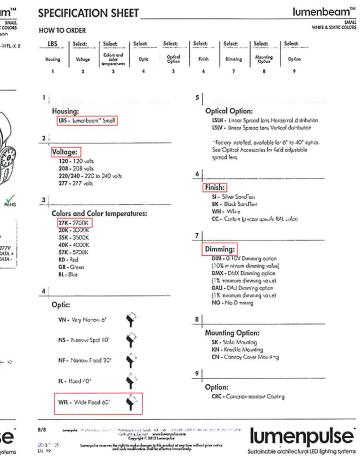













Cole Stepliles may be field mounted to the back or bottom of the fixture.

Dascription
The 158 Series of Stepfiles is a low-profile,
trick size site fixture with LEO, fluorescent,
and incandescent tamp options. It is available for
availey of inition or entieric apple calities. This
ruppes construction, engineering excellence, and
quality make have fluores deal for specification
in most public areas.

Features:

Applications
The 156 Series Steplites are suitable for the too sense steples are shallow to concrete pour/block wall and stud wall mounting in indoor or outdoor installations. They are ideal in low walls and side mounting at statis.

LED and incandescent listures will work well in extremely coid climates. The LED and lonescent lamp opinions may be specified for interior combustible conditions. They are ideal in low walls and step risers

walls and step risers

Custom
If your project demands a special fedure we would be pleased to discuss the production of modified standard fedures or custom fedures to sail your specific conditions. For more information on our custom capabilities, please contact your local Cole representative




158 SERIES

Features
Louvers in the 158 Series are more widely spaced than most fixtures of this type, allowing for significantly greater forward projected illumination Exceptional durability is provided by the thick cast aluminum faceptate and the tempered glass diffuser. Louvered models offer even greater pro-tection to the diffuser while controlling the distri-bution of light. Cole Steplites feature an optional field mounted to either the back or bottom of the housing to best suit installation conditions.



C.W. Cole & Company, Inc. 2560 N. Rosemead Boulevard South El Monte, CA 91733-1593

Tel. (626) 443-2473 Fax (626) 443-9253 Info@colellghting.com

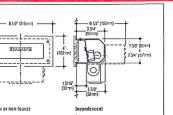

COLE LIGHTING

8 1/2" (216mm) ------

Catalog Numbers	Faceplate	
Lamp	Louver	Non-louver
LED 1.5W, (126 lm @ 3000°K)	L158W	L158GW
LED 3 6W, (215 Im 12 3000°K)	L158W-H0	L158GW-H0
LED 7.2W. (430 lm @ 3000°K)	L158W-H0-2	L158GW-H0-2
One 7W or 9W (2G7 base) compact fluorescent	F158W-7 or-9	F158GW-7 or -9
One 40W T10 medium base incandescent	T158W	T158G

Junction box: Bottom or back mounted junction Tamperproof screws: Tamperproof socket head box for feed-thru. Add suffix -J. Stainless steel faceplace: 3/16" thick narrow louvered faceplate. Add suff/x -N. Sharp cutoff louver; Reduces illumination

Tamperproof screws: Emperproof scoket head baceplate screws. Add suffix -TP.

LED colors:
-(400 K (146 lm). -H0 (249 lm). -H0-2 (498 lm) add suffix. -AMB

Blue, add suffix -AMB

Blue, add suffix -BLU Sharp cutoff louver: Heddes filtumination pattern. Add sulfix -SCL.

Bronze faceplate: Satin finish, clear coated Add sulfix -B. Vollage: Fluorescent 277V ballast. Add suffix -277. (LED Universal vollage standard) Dimming: Universal vollage 0-10V driver Add suffix-DIM


Faceplate color: Black or white Add suffix -BLK or -WHT

C14

How to Specify

1. Select catalog number with desired features

2. Add suffices for options required to meet job

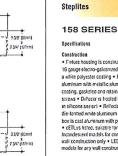

Construction Foture housing is constructed from die-forme 16 gauge electro-galvanued steel finished with a white polyester coating • Faceplate is cast aluminum with metallic aluminum polyester coating, gasketed and retained by stainless steel screws • Diffuser is frosted tempered glass, set in silicone sealant • Reflector is constructed of die-formed white aluminum • Optional junction box is cast a/uminum with polyester coaling • cETLus listed, suitable for wet locations • Incandescent models for concrete pour/block wali construction only • LED and fluorescent models for any wall construction

Electrical
• Fixture Is wised with high performance LEDs, one compact fluorescent or one 40W A19 incandescent temp • Driver is standard universal voltage • Ballast is standard 120V (277V op-tional) electronic • Optional junction box allow 8 wire thru wiring, 4 in and 4 out. Provided with two 1/2* tapped conduit entrances in the bottom and one 1/2* conduit entrance in each side

Mounting Housing has Itange with holes for mounting



C.W. Cole & Company, Inc. 2560 N. Rosemead Boulevard South El Monte, CA 91733-1593

Tel. (626) 443-2473 Fax (626) 443-9253 info@colelighting.com www.colelighting.com

GARY BRINK & ASSOCIATES

7780 ELMWOOD AVE. STE. 204 MIDDLETON, WI 53562 608-829-1750 608-829-3056 (FAX)

PROJECT:

330 E. WILSON
300 E. WILSON
300 E. WILSON
MADISON, WI 53703
CLIENT:


ROSTON STREET
MADISON, WI 53703
MADISON, WI 53703
MADISON, WI 53703

© 2014 GARY BRINK & ASSOC.
Any duplication, reproduction, or use by any other party is prohibited unless prior written authorization is received from GARY BRINK & ASSOC.

PROJECT: DATE: SCALE: AS NOTED

> SITE LIGHTING **FIXTURE CUT SHEETS** A1.02

7780 ELMWOOD AVE. STE. 204 MIDDLETON, WI 53562 608-329-1730 608-829-3056 (FAX)

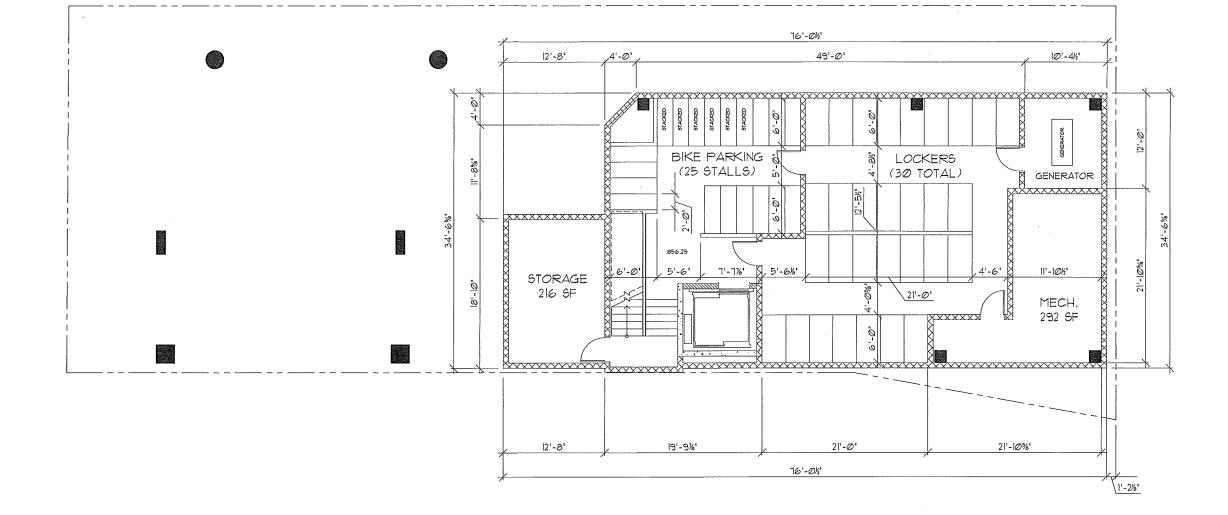

PROJECT:
330 E. WILLSON
330 E. WILSON
MADISON, WI 53703
TIS E. MALL STREET
MADISON, WI 53703
MADISON, WI 53703


© 2014 GARY BRENK & ASSOC.
Any displacation, reproduction, or use by any other party is prohibited unless prior written extraction is received from GARY BRENK & ASSOC.

PROJECT: DRAWN BY: DATE:

SCALE: AS NOTED

BASEMENT FLOOR PLAN

BEALE: 3/6' · 1'-0' Ø' l' 2' 4' 8' BASEMENT FLOOR PLAN A2.00

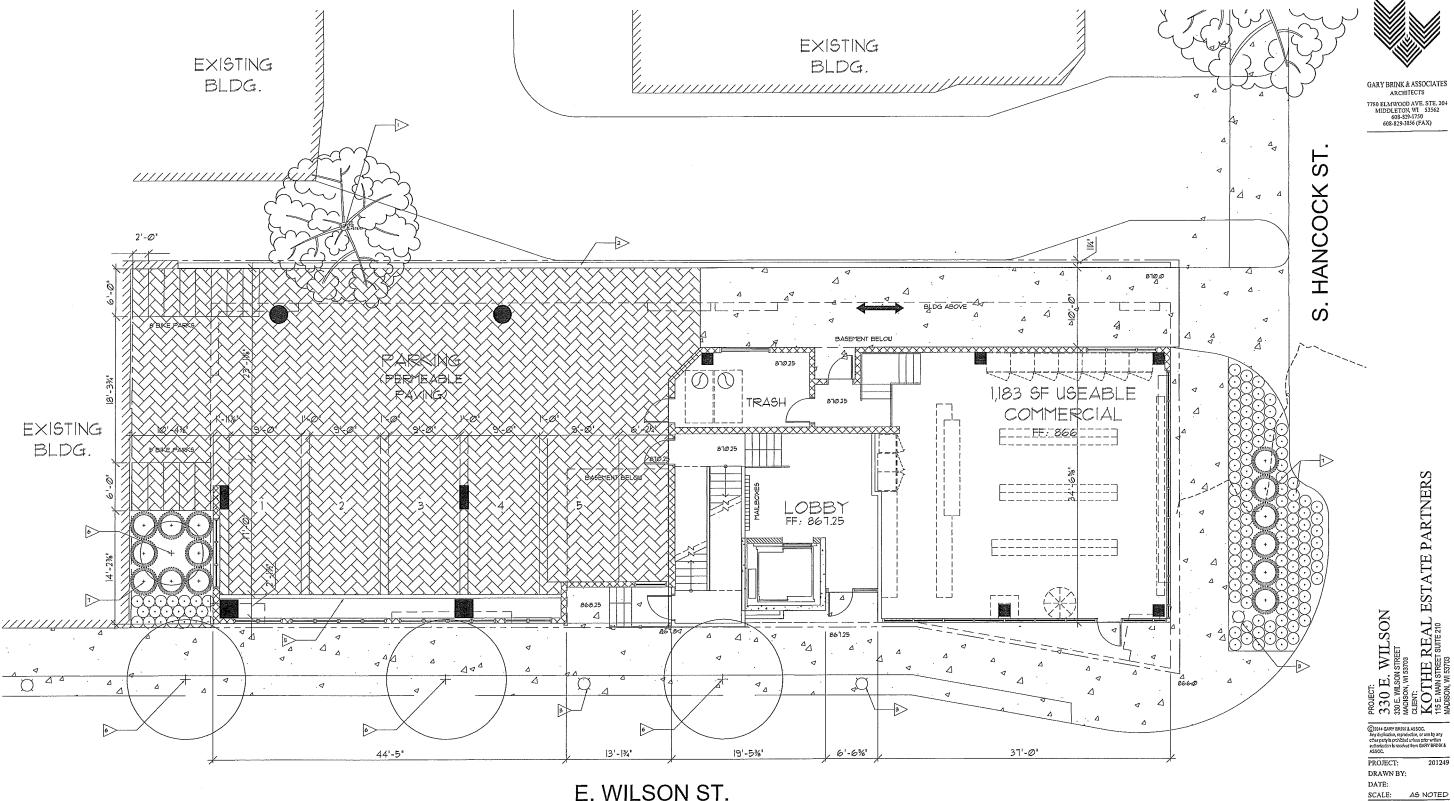


E. WILSON ST.



- 2. EXISTING RETAINING WALL
- 3. EXISTING STREET LAMP
- 4. NOT USED
- NEW TREE REFERENCE LIGO FOR DETAILS

FIRST FLOOR PLAN/SITE PLAN A2.01

GARY BRINK & ASSOCIATES ARCHITECTS 7780 ELMWOOD AVE. STE. 204 MIDDLETON, WI 53562 608-829-1750 608-829-3056 (FAX)

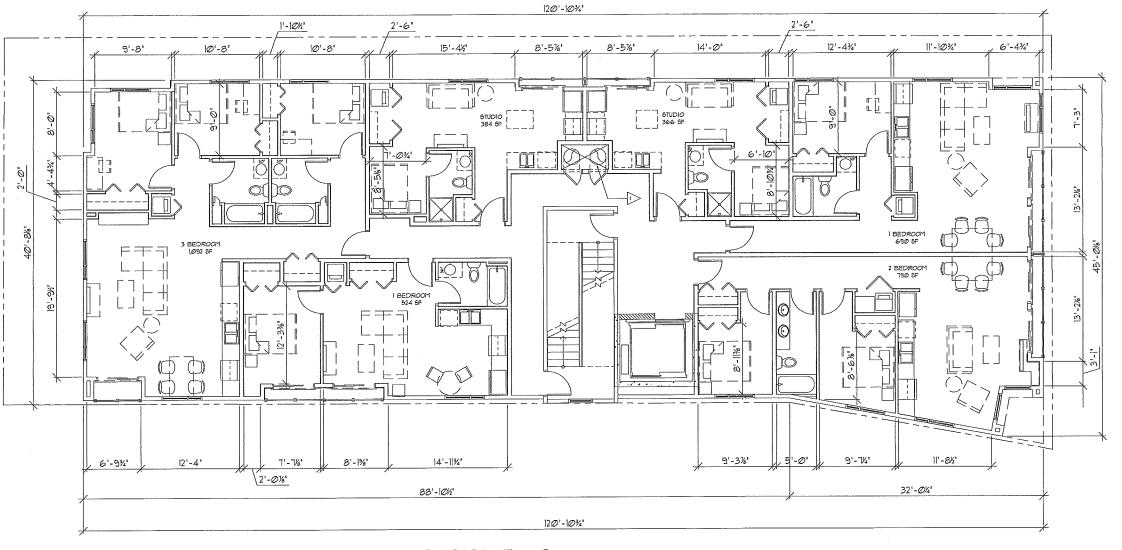

ACCE66IBLE I BEDROOM 524 SF 7'-6%' 14'-11¾"

2nd FLOOR ACCESSIBLE PLAN 2 2 4 2 5 1 2 4 2 5 1

KEYED NOTES

TRASH CHUTE FROM 2ND TO 15T FLOOR ONLY


FLOOR PLAN


PROJECT: DRAWN BY: DATE:

SCALE: AS NOTED

2ND THROUGH 6TH A2.02

PROJECT:
330 E. WILSON
330 E. WILSON
330 E. WILSON
40150N, WI 33703
415 E. MANN STREET SUITE 210
MADISON, WI 33703
MADISON, WI 33703

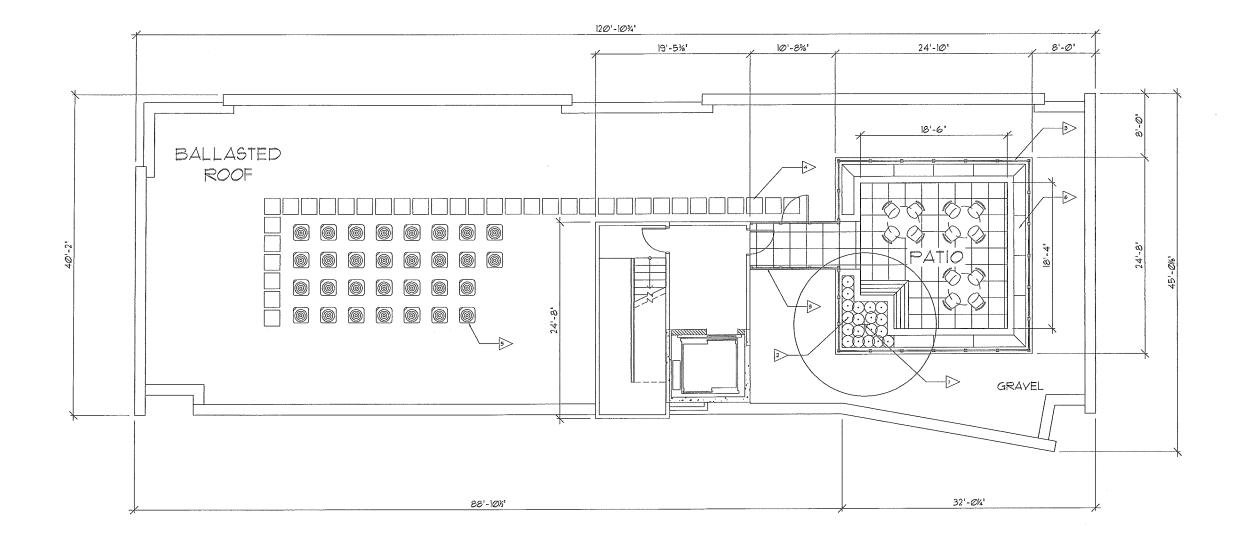

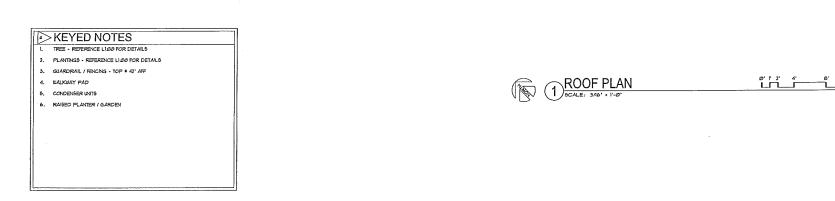

PROJECT:
330 E. WILSON
330 E. WILSON
330 E. WILSON
MASTOR
MADION, WI 53703
KOTHE REAL ESTATE PARTNERS
115 E. MAIN STREET SUITE 210
MADISON WI 53703

© 2014 GARY BRIDGE & ASSOC.

Any displication, reproduction, or use to other party is prohibited unless prior we extractive to its received from GARY BI ASSOC.

PROJECT: DRAWN BY: DATE:

SCALE: AS NOTED

ROOF PLAN

A2.03





GRAPHIC	KEY	EXERIOR FINISH DESCRIPTION
	(ডা-1)	MASONRY FIELD MFGR: ARRISCRAFT INTERNATIONAL SIZE: 8"x24" COLOR: SMOOTH GINGER
	(4-1)	ALUMINUM PANEL MFGR: DRI DESIGN SIZE: N.A. COLOR: SMOKE EMBERS
stra	(W-2)	ALUMINUM PANEL NFGR: DRI DESIGN SIZE: N.A. COLOR: REGAL BLUE
14	@L-D	CLASS FIELD (CLEAR) INFGR: MRACON SIZE: REFER TO SPECIFICATIONS TYPE: WRACON SOLARSCREEN VE4-2M
	@-2	GLASS FIELD (FROSTED) NFGR: MRACON SIZE: REFER TO SPECIFICATIONS TYPE: FROSTED WRACON SOLARSCREEN
	@-3)	CLASS FIELD (SPANDRIL) INFGR: WRACON SIZE: REFER TO SPECIFICATIONS TYPE: FROSTED SPANDRIL

PLAN SOUTH ELEVATION SCALE: 1/8" = 1"-0"

PROJECT:

330 E. WILSON

330 E. WILSON

MADISON, WI 53703

CLIENT:

KOTHE REAL ESTATE PARTNERS

MADISON, WI 53703

© 2014 GARY BRINK & ASSOC.
Any duplication, reproduction, or use by any
other party is prohibited unless prior written
authorization is received from GARY BRINK &
ASSOC.

PROJECT: 201249

DRAWN BY: DATE: SCALE: AS NOTED

PLAN SOUTH ELEVATION A6.01



7780 ELMWOOD AVE. STE. 204 MIDDLETON, WI 53562 608-829-1750 608-829-3056 (FAX)



PLAN WEST ELEVATION

SCALE: 1/8" = 1'-0"

GRAPHIC KEY EXERIOR FINISH DESCRIPTION

MASORRY FELD

MFGR. ARRISCRAFT INITERNATIONAL

STD. 152-6 1524*
COLOR: SMOOTH GNOER

ALUVINUM PANEL
MFGR: DRI DESIGN
SIZE: N.A.
COLOR: SMOKE EMBERS

COLOR: SMOKE BUBERS

ALUMANUA PIANEL

FICE DO DESIGN

STE: NA.

COLOR: BEAL BUF

COLOR: BUF

COLOR: BEAL BUF

COLOR: BUF

COLOR:

0' 4' 8' 16' 32'

PLAN EAST ELEVATION

SCALE: 1/8" = 1'-0"

DRAWN BY:
DATE:
SCALE: AS NOTED

PROJECT:

© 2014 GARY BRINK & ASSOC. Any duplication, reproduction, or use by any other party is prohibited unless prior written authorization is neceived from GARY BRINK & ASSOC.

201249

PROJECT:

330 E. WILSON
330 E. WISON STREET
330 E. WISON STREET
MADISON, WI 53703
CLENT:
KOTHE REAL ESTATE PARTNERS
115 E. MADISON, WI 53703
MADISON, WI 53703

PLAN EAST/WEST ELEVATION

A6.02





GRAPHIC KEY EXERIOR FINISH DESCRIPTION

WASONRY DELD

WEGE. ARRISCRAFT INTERNATIONAL

SEE 8*24*
COLOR: SALOOHI GINGER

WED. BRI DESIGN
SEE NOOKE EMBERS

COLOR: SANCE EMERS

ALUMNUM PANEL

MITCH, UNI DESCAN

BURE, UNI DESCAN

GLOSE FEEL (LEAR)

MITCH VARACON

STREETE TO SPORTATIONS

TIPE: VARACON SOLARSCREEN VE4-2M

GLOSS FEEL (TROSTE)

MITCH VARACON

SER ESTER TO SPORTATIONS

TIPE: RIGITED VARACON SOLARSCREEN

GLOSS FEEL (SPANIOR)

GLOSS FEEL (SPANIOR)

STREETE TO SPORTATIONS

TIPE: RIGITED VARACON SOLARSCREEN

GLOSS FEEL (SPANIOR)

STREETE TO SPORTATIONS

TIPE: RIGITED SPANIORL

PROJECT:
330 E. WILSON
300 E. WILSON
MADISON, WI 53703
CLIENT
THE REAL ESTATE PARTINERS
115 E. MAN STREET
MADISON, WI 53703

PROJECT: 201249 DRAWN BY:

DATE: SCALE: AS NOTED

PLAN NORTH

A6.03