

CITY OF MADISON ZONING BOARD OF APPEALS

VARIANCE APPLICATION

\$300 Filing Fee

Ensure all information is typed or legibly printed using blue or black ink.

	000011	*(- A	
	ct Property: 2302 Univers		
Name of Owner:	Casablanca, LLC - Gold	leaf Development	
Address of Owner	(if different than above):	2379 University Ave Madison, WI 53726	
Daytime Phone:	608-233-4423	Evening Phone:	608-233-4423
Email Address: _			
Name of Applican	t (Owner's Representative): Randy Bruce	
Address of Applic	ant: Knothe & Bruce Ard 7601 University Ave	chitects, LLC e, Suite 201, Middleton, W	I 53562
Daytime Phone:	608-836-3690	Evening Phone:	608-836-3690
Email Address: [†]	bruce@knothebruce.com		
	quested Variance: ce to allow conversion of	management office space	into two efficiency apartments.
			(See reverse side for more instructions)
Amount Paid: Receipt: Filing Date: Received By: Parcel Number: Zoning District: Alder District:	300- 155 251 6-19-14 must 0709-211-0104- 5- BILAT	Hearing Date: Published Date: Appeal Number: GQ: Code Section(s):	7-10-14 7-3-14 671014-1 28A 28.065(3)(6)

Standards for Variance

The Zoning Board of Appeals shall not grant a variance unless it finds that the applicant has shown the following standards are met:

1. There are conditions unique to the property of the applicant that do not apply generally to other properties in the district.

This property has 64,047 square feet of lot area and 150 apartments with the following unit mix: Efficiency Apartments - 38, One-Bedroom Apartments - 88, Two-Bedroom Apartments - 23, Three-Bedroom Apartment - 1, Total = 150. The proposed variance will convert an existing management office into two efficiency apartments for a total of 152 apartments. The property originally had over 167,000 square feet of lot area prior to the construction of Campus Drive. The apartment building was developed under the C-2 zoning district and has obtained two similar variances in the past. The existing building size will not change and there will not be any changes to the exterior of the building or the site improvements.

2. The variance is not contrary to the spirit, purpose, and intent of the regulations in the zoning district and is not contrary to the public interest.

The TSS district does not have a lot area requirement for properties with a majority of non-residential use on the first floor. However, this property was constructed prior to the implementation of the TSS zoning and since this property is all residential, the density limits of the TR-V2 District apply. The existing district is designed to allow for higher densities and the additional units are not contrary to the intent of the district.

3. For an area (setbacks, etc) variance, compliance with the strict letter of the ordinance would unreasonably prevent use of the property for a permitted purpose or would render compliance with the ordinance unnecessarily burdensome.

The applicant believes that strict compliance with the Lot Area Requirement is unnecessarily burdensome. There are no open space requirements that limit the additional units and the location has been determined suitable for higher densities in the City plans.

4. The alleged difficulty or hardship is created by the terms of the ordinance rather than by a person who has a present interest in the property.

The code language for the TSS District requiring first floor non-residential use for higher densities causes the difficulty. The building was constructed prior to the implementation of the new zoning code.

5. The proposed variance shall not create substantial detriment to adjacent property.

The addition of the two apartments is a minimal increase in the density and the adjacent properties will not perceive the change.

6. The proposed variance shall be compatible with the character of the immediate neighborhood.

The immediate neighborhood consists of similar higher density apartment buildings and commercial uses and the variance will be compatible with the neighborhood character.


Application Requirements

Please provide the following Information (Please note any boxes left uncheck below could result in a processing delay or the Board's denial of your application):

	Pre-application meeting with staff: Prior to submittal of this application, the applicant is strongly encouraged to discuss the proposed project and submittal material with Zoning staff. Incomplete applications could result in referral or denial by the Zoning Board of Appeals.			
	Site plan, drawn to scale. A registered survey is recommended, but not required. Show the following on the site plan (Maximum size for all drawings is 11" x 17"): Lot lines Existing and proposed structures, with dimensions and setback distances to all property lines Approximate location of structures on neighboring properties adjacent to variance Major landscape elements, fencing, retaining walls or other relevant site features Scale (1" = 20' or 1' = 30' preferred) North arrow			
	Elevations from all relevant directions showing existing and proposed views, with notation showing the existing structure and proposed addition(s). (Maximum size for all drawings is $11'' \times 17''$)			
	Interior floor plan of existing and proposed structure, when relevant to the variance request and required by Zoning Staff (Most additions and expansions will require floor plans). (Maximum size for all drawings is $11'' \times 17''$)			
	Front yard variance requests only. Show the building location (front setback) of adjacent properties on each side of the subject property to determine front setback average.			
	Lakefront setback variance requests only. Provide a survey prepared by a registered land surveyor showing existing setbacks of buildings on adjacent lots, per MGO 28.138.			
	Variance requests specifically involving slope, grade, or trees. Approximate location and amount of slope, direction of drainage, location, species and size of trees.			
	CHECK HERE. I acknowledge any statements implied as fact require supporting evidence.			
	CHECK HERE. I have been given a copy of and have reviewed the standards that the Zoning Board of Appeals will use when reviewing applications for variances.			
Owner's Signature: Date: 6/19/14 (Do not write below this line/For Office Use Only)				
DECISION The Board, in accordance with its findings of fact, hereby determines that the requested variance for (is) (is not) in compliance with all of the standards for a variance. Further findings of fact are stated in the minutes of this public hearing.				
The Zoning Board of Appeals: Approved Denied Conditionally Approved				
The Zonning Board of AppealsApproved				
Zoning Board of Appeals Chair:				
Date	:			

SHEET INDEX: C-1.1 SITE PLAN
A-1.1 FIRST FLOOR PLAN
A-1.2 AREA OF ALTERATION FIRST
FLOOR PLAN CAMPUS DRIVE WALNUT STREET ISSUED <u>CSM No.</u> 370 LOT I AREA OF ALTERATION ON FIRST FLOOR: REPLACING EXISTING OFFICE WITH (2) NEW EFFICIENCY DWELLING UNITS CASABLANCA : APARTMENTS : 2300 UNIVERSITY AVE : PROJECT TITLE

Casablanca **Apartments** UNIVERSITY AVENUE 2300 University Ave Madison, WI
SHEET TITLE
Site Plan SITE PLAN
C-1.1 SCALE: 1"=20'-0" C-I.I * Presine varionce Afrond For exusing PROJECT NO. 1335 02013 Knothe & Bruce Architects, LLC

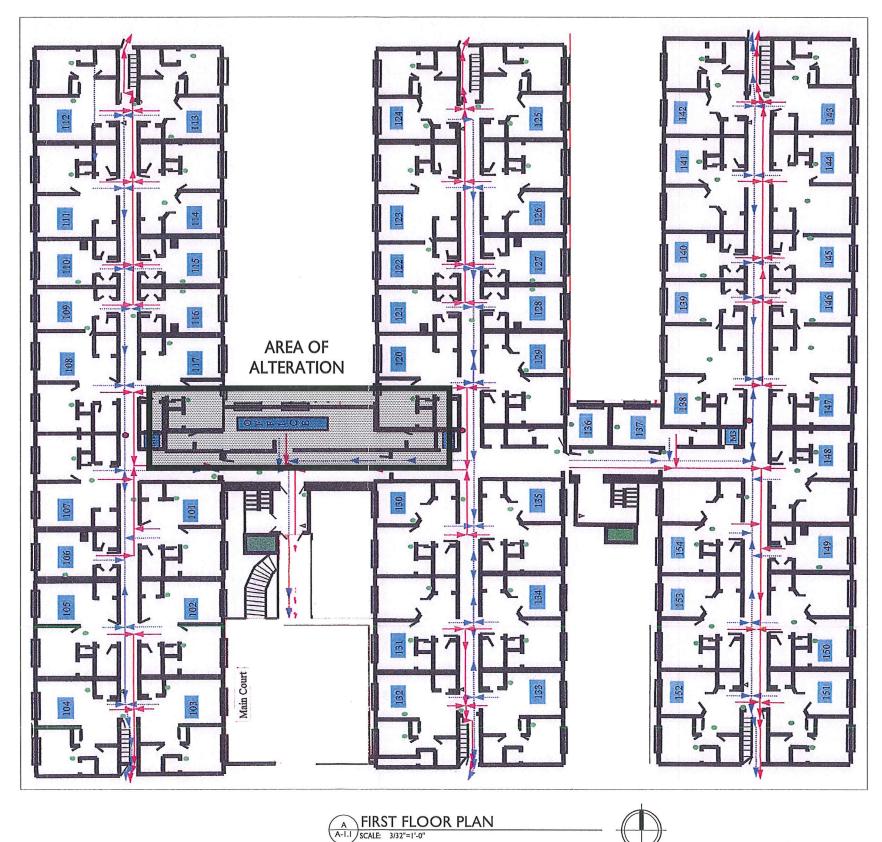



ISSUED Issued For Plan Review - Nov. 20, 2013

PROJECT TITLE

Casablanca **Apartments**

2300 University Ave Madison, WI
SHEET TITLE
First Floor Plan

SHEET NUMBER

PROJECT NO. 1335 © 2013 Knothe & Bruce Architects, LLC




Elevation along University Avenue




Elevations at corner of Walnut Avenue and Campus Drive



Elevations along University Avenue

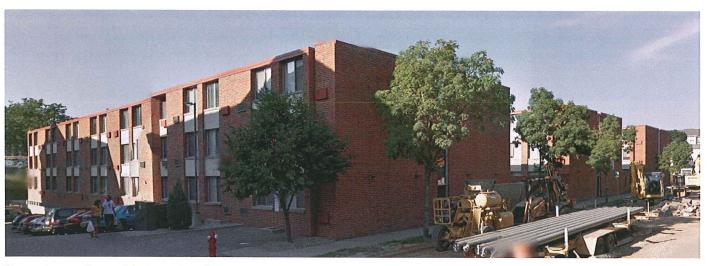


Elevations along University Avenue

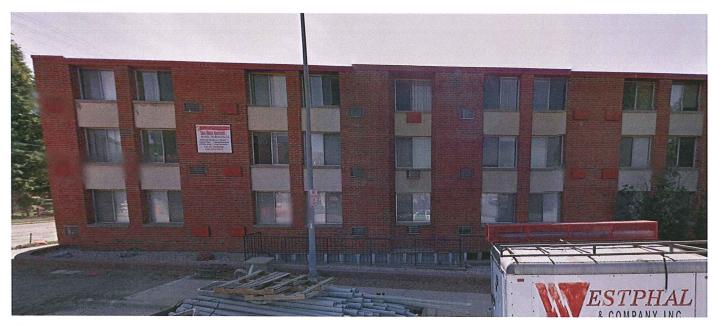


Elevation along Walnut Avenue




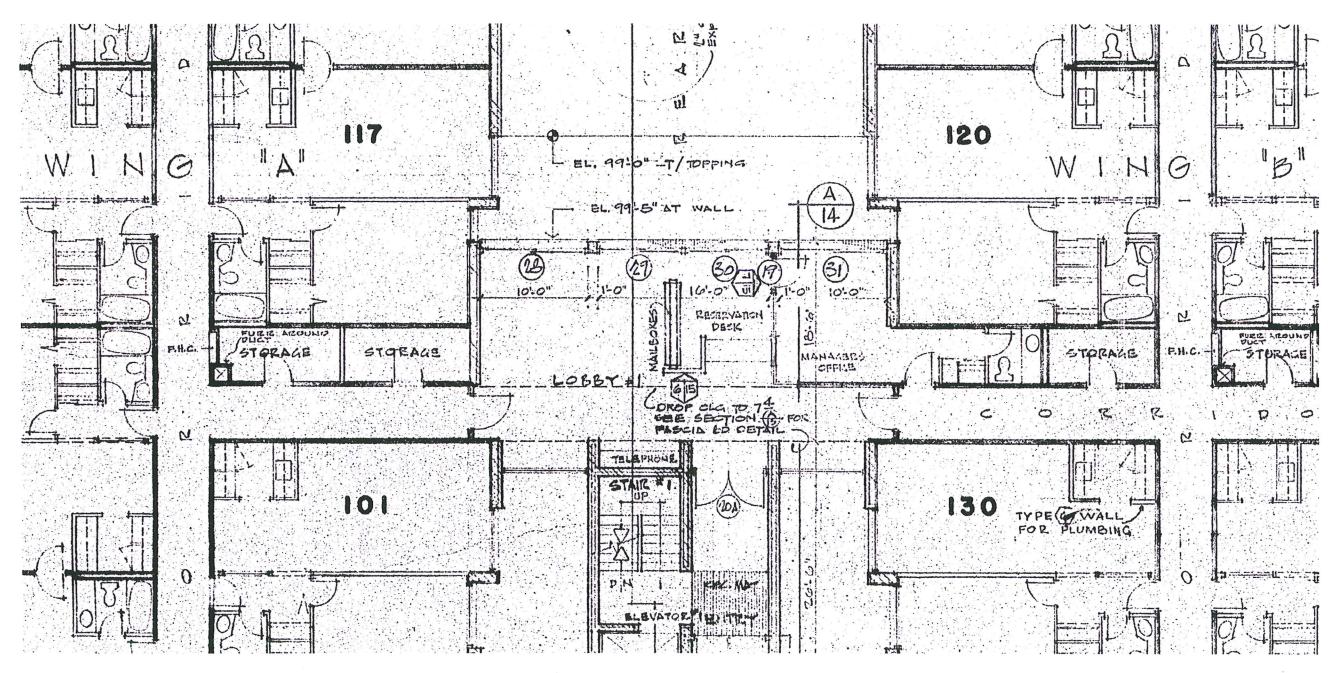

Area of Alteration on First Floor - Replacing existing office with 2 new efficiency apartments



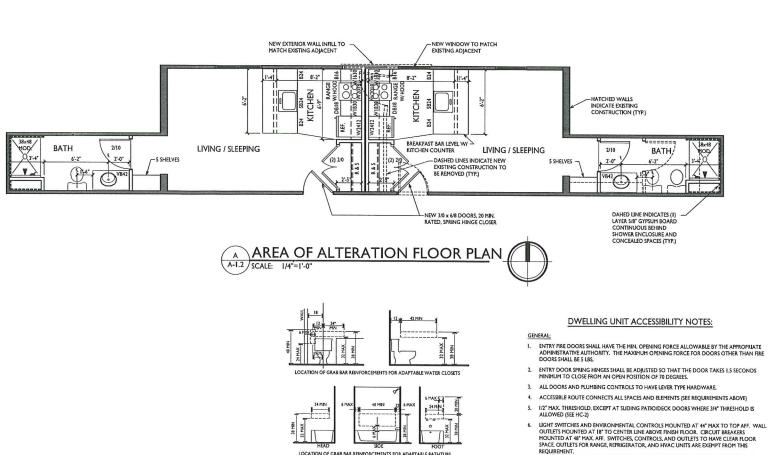

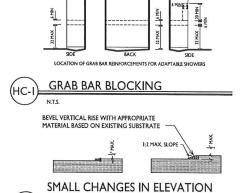

ALONG ACCESSIBLE ROUTE

- REQUIREMENT.

 (PER WISCONSIN DEPARTMENT OF COMMERCE VARIANCE TO ICCIANSI 2003 SECTION 1004.9:

 ACCESSIBLE KITCHEN SWITCHES, CONTROLS, AND OUTLETS MAY BE LOCATED BEHIND

 COUNTERTOPS THAT 36" HIGH MAX. AND 25-1/2" DEEP MAX.)
- PROVISION FOR VISUAL ALARM TO BE CONNECTED TO BUILDING ALARM SYSTEM IN EACH UNIT AND EACH SLEEPING AREA OF UNIT.
- ALL DOORS, INCLUDING BOTH LEAVES OF DOUBLE LEAVE DOORS SHALL HAVE ALL OPERATING HARDWARE BETWEEN 34" & 48" A.F.F.
- ALL CARPET TO HAVE A LEVEL LOOP, TEXTURED LOOP, LEVEL CUT PILE, OR LEVEL CUTAUNCUT PILE TEXTURE. CARPET PILE SHALL BE 1/2" MAX.

BATHROOMS:

- 10. BATHROOM WALLS SHALL HAVE REINFORCING IN WALLS FOR FUTURE GRAB BAR AND SEAT INSTALLATION. REINFORCING SHALL BE IN LOCATIONS SHOWN IN DIAGRAMS PER DETAIL HC-I.
- VANITY SINK BOWLS SHALL HAVE A MINIMUM OF 24* FROM THE CENTER LINE OF THE FIXTURE TO THE ADJOINING WALL, U.N.O.
- 12. OFFSET TUB & SHOWER CONTROLS REQUIRED, CENTERLINE OF CONTROLS TO BE LOCATED 9° FROM APRON OF TUB OR SHOWER OR ADJOINING HEADWALL (WHICHEVER IS FURTHER), U.N.O.
- 13. ALL PLUMBING CONTROLS TO HAVE SINGLE LEVER TYPE HARDWARE.
- 14. BATHTUBS AND SHOWERS SHALL DELIVER WATER THAT IS 120 DEGREES F MAX.
- 15. SHOWER COMPARTMENT SHALL HAVE INTERIOR CLEAR DIMENSIONS OF 36" MIN. X 36" MIN.
- ALL BATHTUBS AND SHOWERS TO HAVE PERMANENT NON-SKID PATTERN COVERING 75% MIN. OF THE TUB/SHOWER FLOOR.

17. ALL PLUMBING CONTROLS TO HAVE SINGLE LEVER TYPE HARDWARE.

18. SLIDE-IN RANGE W/ ANTI-TIP HARDWARE

NOTE: INSTALL PERIMETER ISOLATION MATERIAL AS RECOMMENDED BY GYPSUM MANUFACTURER TO ACHIEVE RESULTS OF SOUND TESTING NOTE CONTINUOUS ACOUSTICAL SEALANT AT TOP AND BOTTOM TERMINATION OF GYP. BD. - EXISTING FLOOR / CEILING CONSTRUCTION (TYP.) IEW FIBERGLASS INSULATION BATTS, FRICTION HT IN CAVITY, THICKNESS TO BE EQUAL TO DEPTH OF STUD CAVITY EXISTING WOOD STUD WALL — REMOVE UNIT-SIDE LAYER OF GYPSUM BOARD.

INSTALL (I) LAYER 58" 'TYPE "X" GYP. BD. ON 12" RESILIENT
CHANNEL AT 24" O.C. VERTICALLY TO WOOD STUDS. TAPE
AND RINSH ALL JOINTS AND ASTENERS. RESILIENT
CHANNELS TO BE "RC DELUXE" BY DIETRICH INDUSTRIES OR

CONTINUE 2X4 STUD WALLS W/ INSULATION TO UNDERSIDE OF FLOOR DECK CONT. FIRESTOP, MECHANICALLY FASTEN IN PLACE -I HR RATED WALL:

(SEE UL. #UJAII, http://www.ml.com/ FOR ADD, SPECIFICATIONS)

-(1) LVATE SIST TYPE "X" GYP. 8D, EA, SIDE

-(2) 224 WOOD STUD WALLS, STAGGERED STUDS, SPACING
PER STRUCT, (LOS STUDS WHERE SHOWN ON PLANS)

-1 "SEPARATION BETWEEN WALLS

-1 "SEPARATION BETWEEN THE STUDY

THICKNESS TO 8E EQUAL TO DEPTH OF STUD CAVITY

-TAPE AND PINISH ALL JOINTS AND FASTENESS

-CONTINUOUS ACOUSTICAL SEALANT AT TOP AND

BOTTOM TERMINATION OF GYP. BD.

-PRAIMFER BOLATION MATERIAL AS RECOMMENDED BY

GYSJUM HANUFACTURER TO ACHIEVE RESULTS OF SOUND XISTING FLOOR / CEILING CONSTRUCTION (TYP.) (I) LAYER 5/8" TYPE "X" GYP. BD. BOTH SIDES OF WALL. TAPE AND FINISH ALL JOINTS AND FASTENERS. — MEP BOXES FROM DIFFERENT DWELLING UNITS SHALL NOT BE LOCATED IN THE SAME STUD CANTY. PUTTY PACK AGOUND ALL BOSE OF HEP BOXES THAT FENETRATE RATED WALL ASSENBLES FER HANDFACTURERS INSTRUCTIONS. (ATTERNATE PROVIDE BOXES RATED FOR WALL SYSTEM). COMPLETELY SEAL GAP BETWEEN BOXES AND GYP. BD. WI ACOUSTICAL SEALANT. 2x4 STUDS @ 16* O.C.-GYPSUM MANUFACTURER TO ACHIEVE RESULTS OF SOUND FIBERGLASS INSULATION BATTS AT -BATHROOM WALLS CONTINUE TO UNDERSIDE OF RATED CEILING CEILING MEP BOXES - SEE WALL TYPE 2 FOR TYP. REQUIEMENTS WOOD STUD PARTITION UNRATED DOUBLE WOOD STUD UNIT SEPARATION WALL WOOD STUD UNIT SEPARATION WALL / CORR. WALL I HR RATED I HR RATED U.L. DESIGN NO. U341 - 1 HR. STC RATING - 53 | WALL TYPES | 1'-0'

RUN O.S.B. CONTINUOUS AS FIRESTOP

(HC-2)

Area of Alteration First Floor Plan

Madison, WI

SHEET TITLE

2300 University Ave

knothe • bruce

Phone: 7601 University Ave, Ste 201 608.836.3690 Middleton, WI 53562

ISSUED

PROJECT TITLE

Casablanca

Apartments

SHEET NUMBER

9 2013 Knothe & Bruce Architects, LLC