
## APPLICATION FOR URBAN DESIGN COMMISSION REVIEW AND APPROVAL

AGENDA ITEM #	
<b>Project</b> #	

DATE SUBMITTED: June 18, 2014  UDC MEETING DATE: June 25, 2014	Action Requested Informational Presentation Initial Approval and/or Recommendation X Final Approval and/or Recommendation
PROJECT ADDRESS: 901 Sugar Maple	Lane - Sugar Maple Plat
ALDERMANIC DISTRICT: Lisa Subecl	κ - District #1
OWNER/DEVELOPER (Partners and/or	Principals) ARCHITECT/DESIGNER/OR AGENT:
Sugar Maple, LLC	Knothe & Bruce Architects, LLC
1910 Hawks Ridge Drive #322	7601 University Avenue, Suite 201
Verona, WI 53593	Middleton, Wisconsin 53562
CONTACT PERSON: J. Randy Bruce/Knothe & Bruce Architects, LLC	
Address: 7601 University Ave	nue, Suite 201
Middleton, Wisconsi	n 53562
Phone: <u>608-836-3690</u>	
Fax: <u>608-836-6934</u>	
E-mail address: rbruce@knothebruce	<u>.com</u>
required as well as a fee)  School, Public Building or Space (Fee r  New Construction or Addition to or Rer 50,000 Sq.Ft.  Planned Commercial Site	P) D) P) P) P) O) ing in an Urban Design District* (A public hearing is
(See Section B for:)  New Construction or Exterior Remodel	ing in C4 District (Fee required)
(See Section C for:)  R.P.S.M. Parking Variance (Fee require	ed)
(See Section D for:)  — Comprehensive Design Review* (Fee rown Street Graphics Variance* (Fee Require	•
X Other Conditional Use *Public Hearing Required (Submission Deadle	ine 3 Weeks in Advance of Meeting Date)

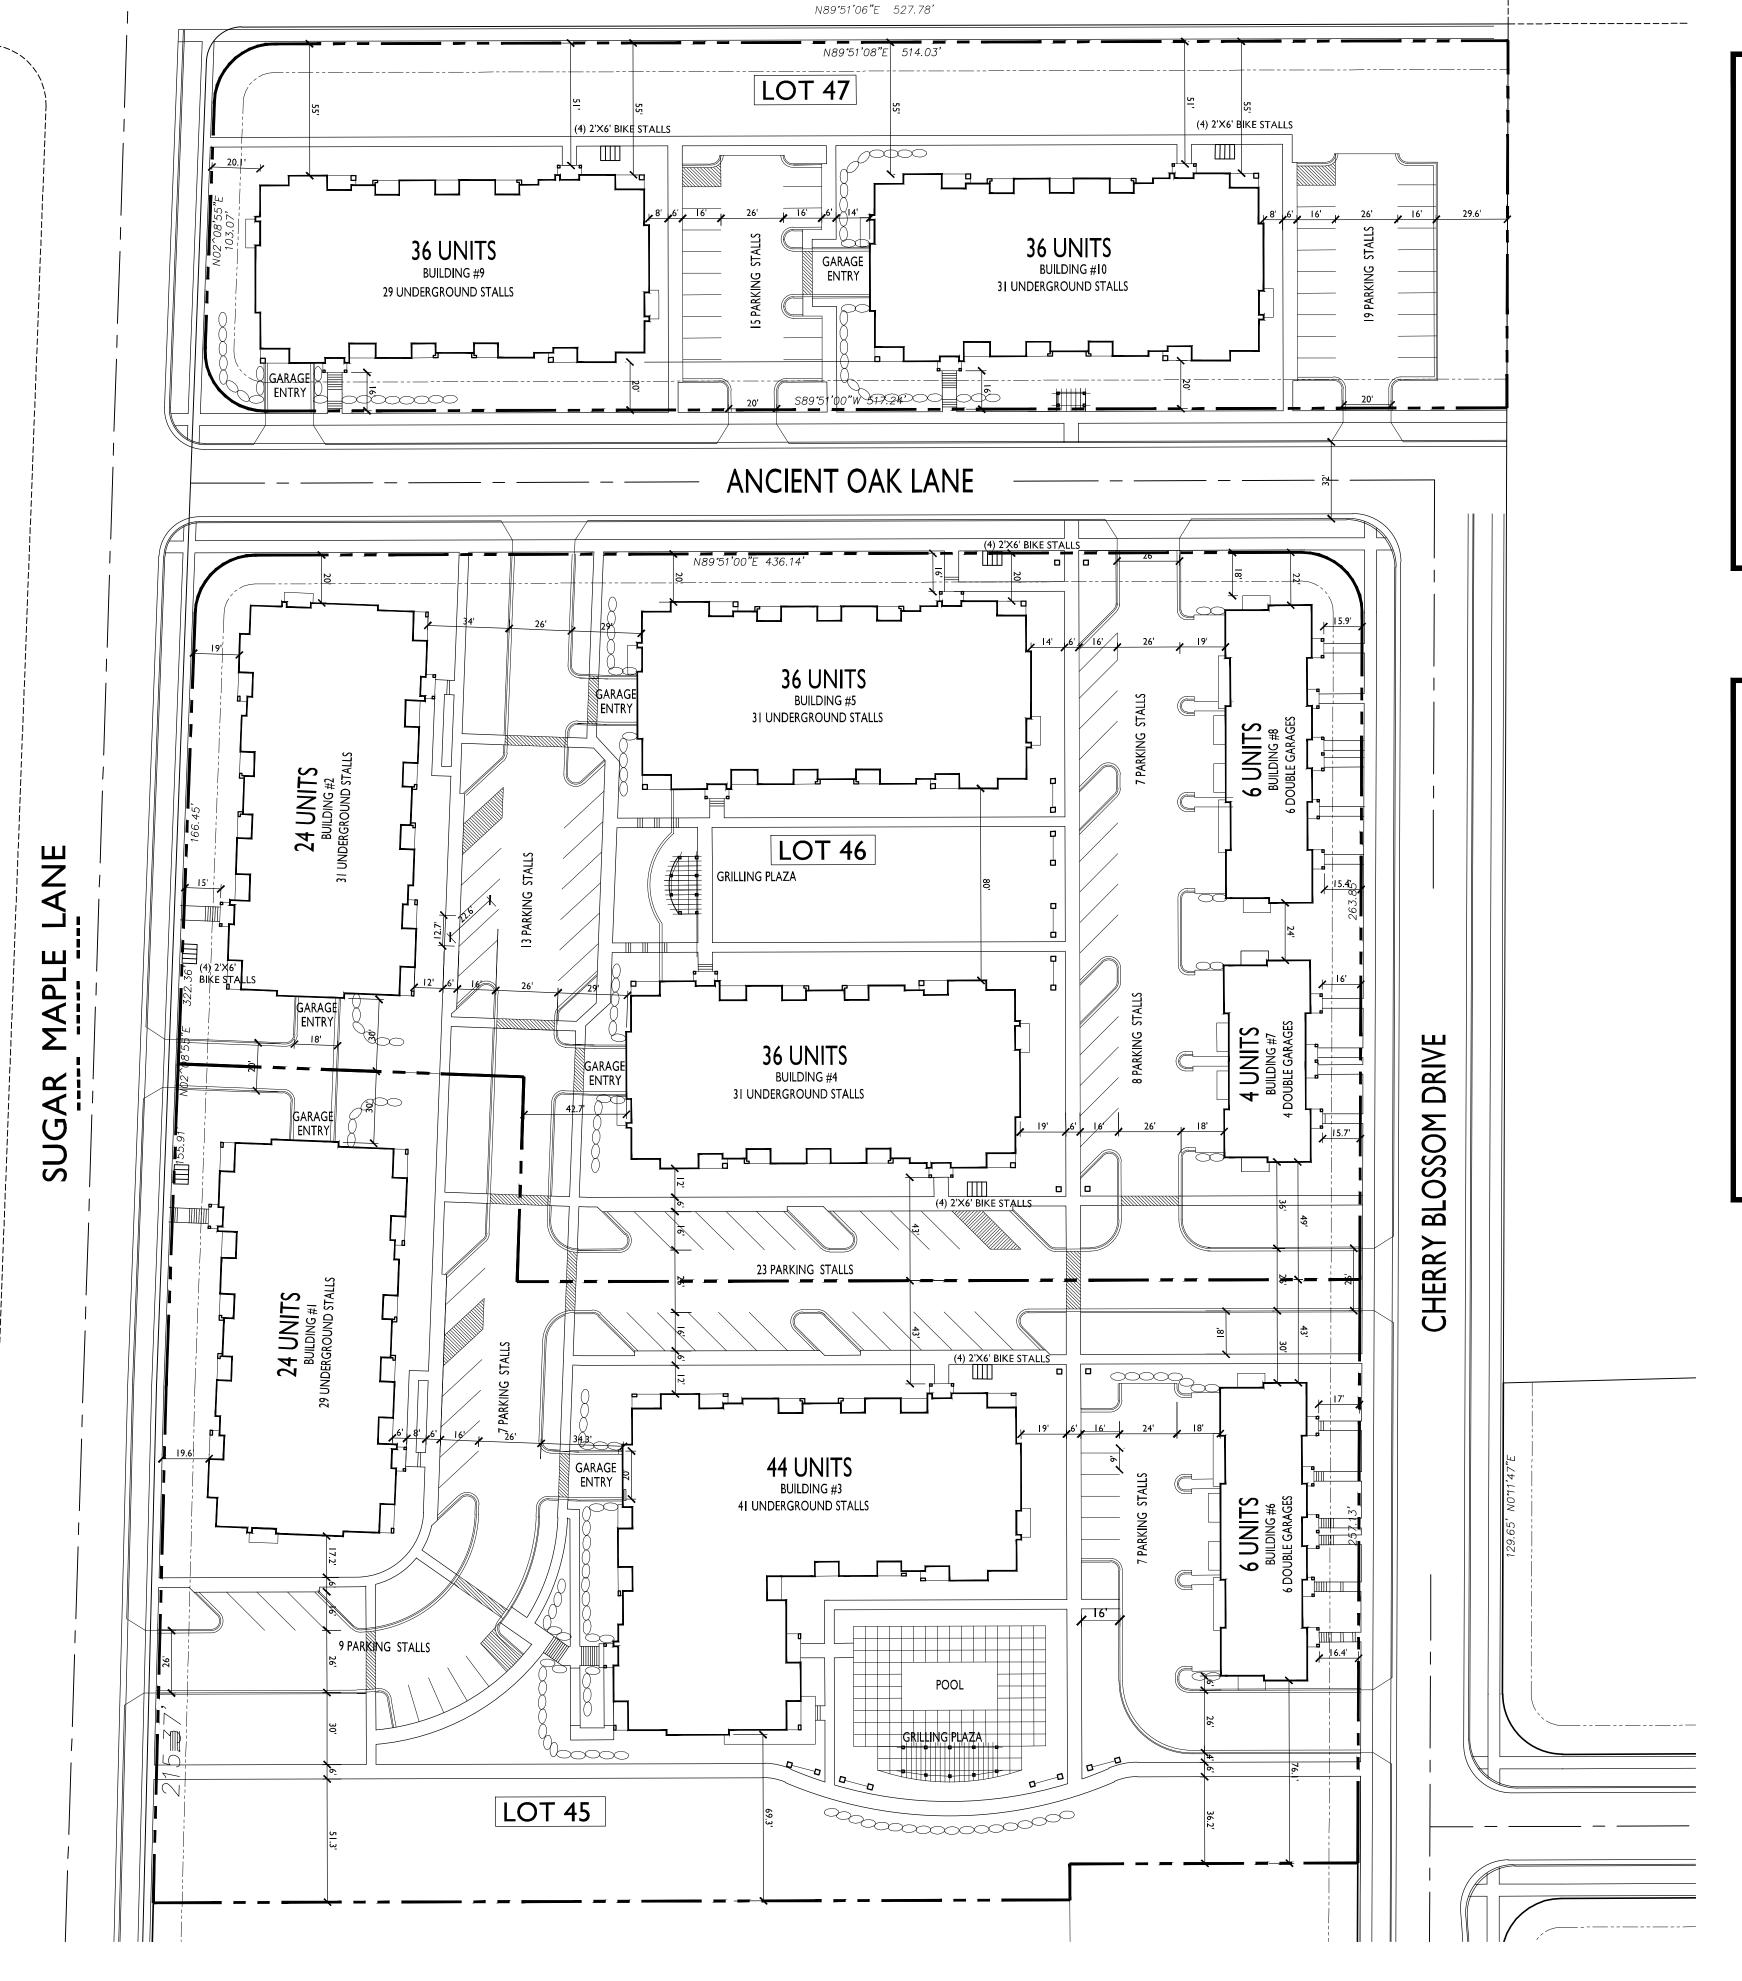

SITE PLAN
C-1.0 SCALE: I"=40'-0"

SITE INDEX SHEET SITE PLAN FIRE DEPARTMENT ACCESS PLAN SITE LIGHTING PLAN OPEN SPACE C-1.3 GRADING AND EROSION CONTROL PLAN GRADING AND EROSION CONTROL PLAN C-2.2 C-2.3 SITE UTILITY PLAN C-2.4 SITE UTILITY PLAN OVERALL LANDSCAPE PLAN UNIT LANDSCAPE PLANS L-1.1 ARCHITECTURAL - LOT 47 BASEMENT PLAN - 36 UNIT BLDG 9 BASEMENT PLAN - 36 UNIT BLDG 10 FIRST FLOOR PLAN - 36 UNIT BLDG 9 & 10 SECOND FLOOR PLAN - 36 UNIT BLDG 9 & 10 THIRD FLOOR PLAN - 36 UNIT BLDG 9 & 10 LOFT FLOOR PLAN - 36 UNIT BLDG 9 & 10 ELEVATIONS - 36 UNIT BLDG 9 ELEVATIONS - 36 UNIT BLDG 9 ELEVATIONS - 36 UNIT BLDG 10 ELEVATIONS - 36 UNIT BLDG 10

SITE DEVELOPMENT STATISTICS - LOT 47 LOT AREA 82,440 SF/ I.89 ACRES DWELLING UNITS 72 DU LOT AREA/ D.U. 1,145 SF/DU DENSITY 38.1 UNITS/ACRE BUILDING HEIGHT 3 STORIES + LOFT GROSS FLOOR AREA 101,920 SF INCLUDING GARAGE LEVEL FLOOR AREA RATIO 1.24 INCLUDING GARAGE LEVEL **UNIT MIX** EFFICIENCY STUDIO/LOFT ONE BEDROOM TWO BEDROOM TWO BEDROOM LOFT TOTAL **VEHICLE PARKING** SURFACE 34 STALLS UNDERGROUND 60 STALLS GARAGE TOTAL 94 STALLS BIKE PARKING SURFACE - 2x6 GARAGE - Wall Hung GARAGE - 2x6

Knothe bruce
ARCHITECTS

Phone: 7601 University Ave, Ste 201
608.836.3690 Middleton, WI 53562

CONSULTANT

ISSUED Issued For SIP Submittal - January 28, 2014

PROJECT TITLE
Sugar Maple

Madison, WI


SHEET TITLE
SITE PLAN

LOT 47
SHEET NUMBER

C-I.0B

PROJECT NO. |3|0

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SITE GRADING AND EROSION CONTROL NOTES

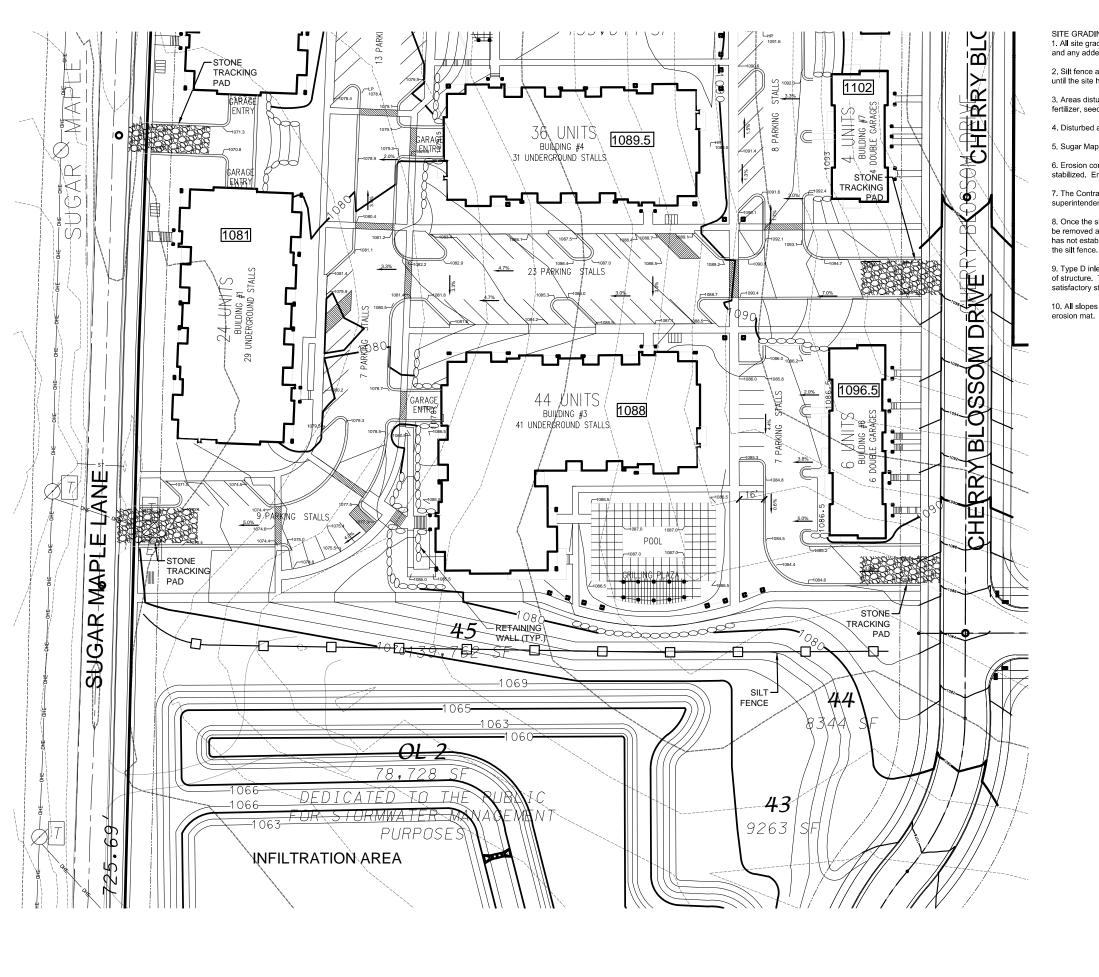1. All site grading and erosion control shall conform to the City of Madison Chapter 37 Ordinance and any addendums prior to the contract bid date.

2. Silt fence and the stone tracking pad shall be installed at the start of site grading and maintained until the site has been stabilized.

3. Areas disturbed within the Sugar Maple Lane right-of-way shall be restored with 4" topsoil, fertilizer, seed and mulch.

4. Disturbed areas within the site shall be restored per the approved landscape plan.

5. Sugar Maple Lane shall be cleaned daily as necessary. Hydraulic flushing will not be allowed.

6. Erosion control shall be the responsibility of the Earthwork Contractor until the site has been stabilized. Erosion measures as listed shall be the minimum that will be acceptable.

7. The Contractor shall install additional erosion measures as requested in writing by the project superintendent or the City of Madison within 24 hours of notification.

8. Once the site has undergone final restoration and vegetation has established, the silt fence shall be removed and if necessary, restored with fertilizer, seed and mulch. Alternatively, if vegetation has not established, erosion matting must be placed on all disturbed areas that may drain toward the silt fence.

Type D inlet filter bags shall be installed in all inlets receiving runoff immediately upon placement
of structure. They shall be cleaned and maintained throughout construction and removed after a
satisfactory stand of grass has been achieved.

10. All slopes 4:1 or steeper shall be restored with 4" topsoil, fertilizer, seed and Class I, Type A erosion mat. Seed mix shall be consistent with the approved landscape plan.

SUGAR MAPLE APARTMENTS




DATE: 06-17-14

REVISED:

DRAWN BY: NGO

FN: 14-05-101

umber: C-2.1

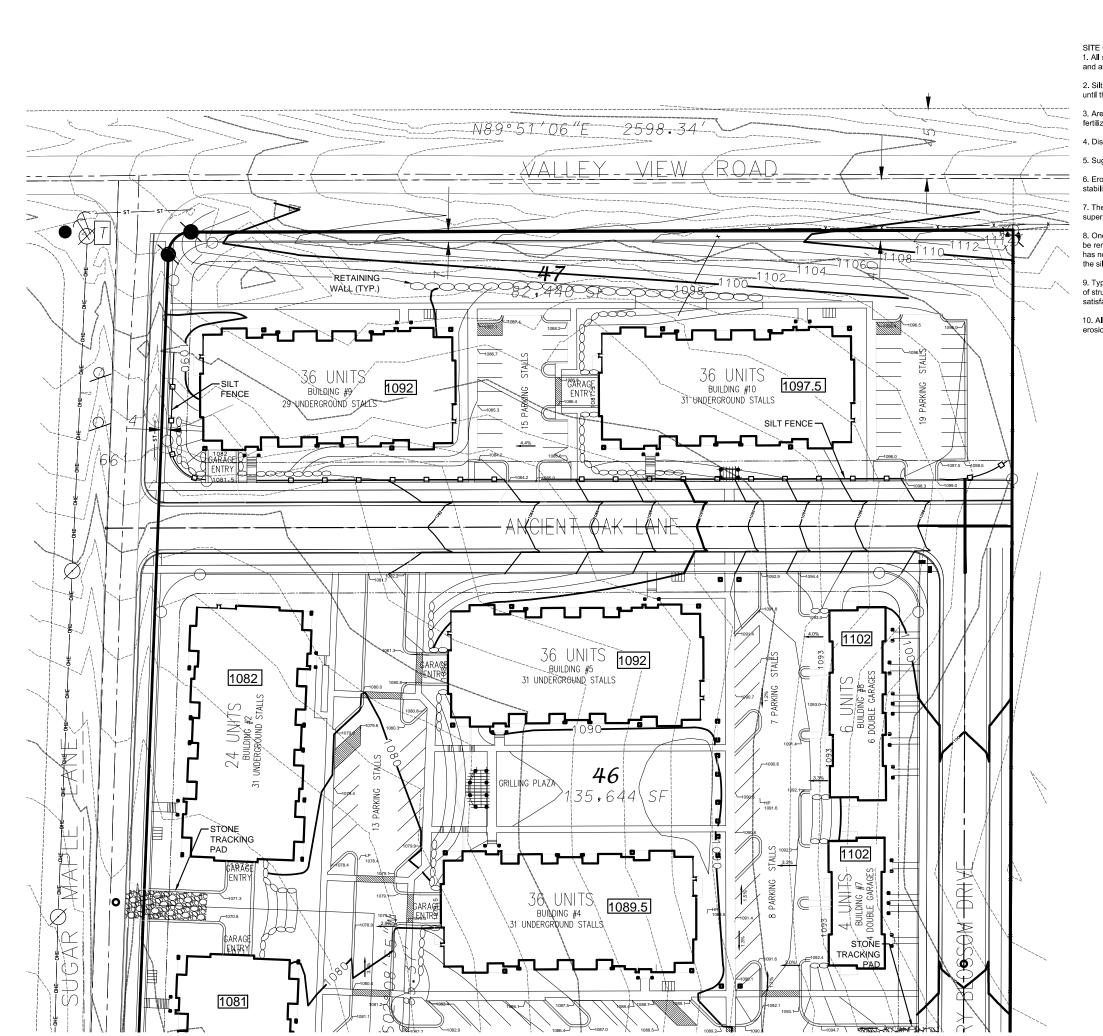

SITE GRADING AND EROSION CONTROL NOTES

All site grading and erosion control shall conform to the City of Madison Chapter 37 Ordinance and any addendums prior to the contract bid date.

- 2. Silt fence and the stone tracking pad shall be installed at the start of site grading and maintained until the site has been stabilized.
- 3. Areas disturbed within the Sugar Maple Lane right-of-way shall be restored with 4" topsoil, fertilizer, seed and mulch.
- 4. Disturbed areas within the site shall be restored per the approved landscape plan.
- 5. Sugar Maple Lane shall be cleaned daily as necessary. Hydraulic flushing will not be allowed.
- 6. Erosion control shall be the responsibility of the Earthwork Contractor until the site has been stabilized. Erosion measures as listed shall be the minimum that will be acceptable.
- 7. The Contractor shall install additional erosion measures as requested in writing by the project superintendent or the City of Madison within 24 hours of notification.
- 8. Once the site has undergone final restoration and vegetation has established, the silt fence shall be removed and if necessary, restored with fertilizer, seed and mulch. Alternatively, if vegetation has not established, erosion matting must be placed on all disturbed areas that may drain toward the silt fence.
- 9. Type D inlet filter bags shall be installed in all inlets receiving runoff immediately upon placement of structure. They shall be cleaned and maintained throughout construction and removed after a satisfactory stand of grass has been achieved.
- 10. All slopes 4:1 or steeper shall be restored with 4" topsoil, fertilizer, seed and Class I, Type A erosion mat. Seed mix shall be consistent with the approved landscape plan.






DATE: 06-17-14

REVISED:

DRAWN BY: NGO

FN: 14-05-101

Sheet Number: C-2.2

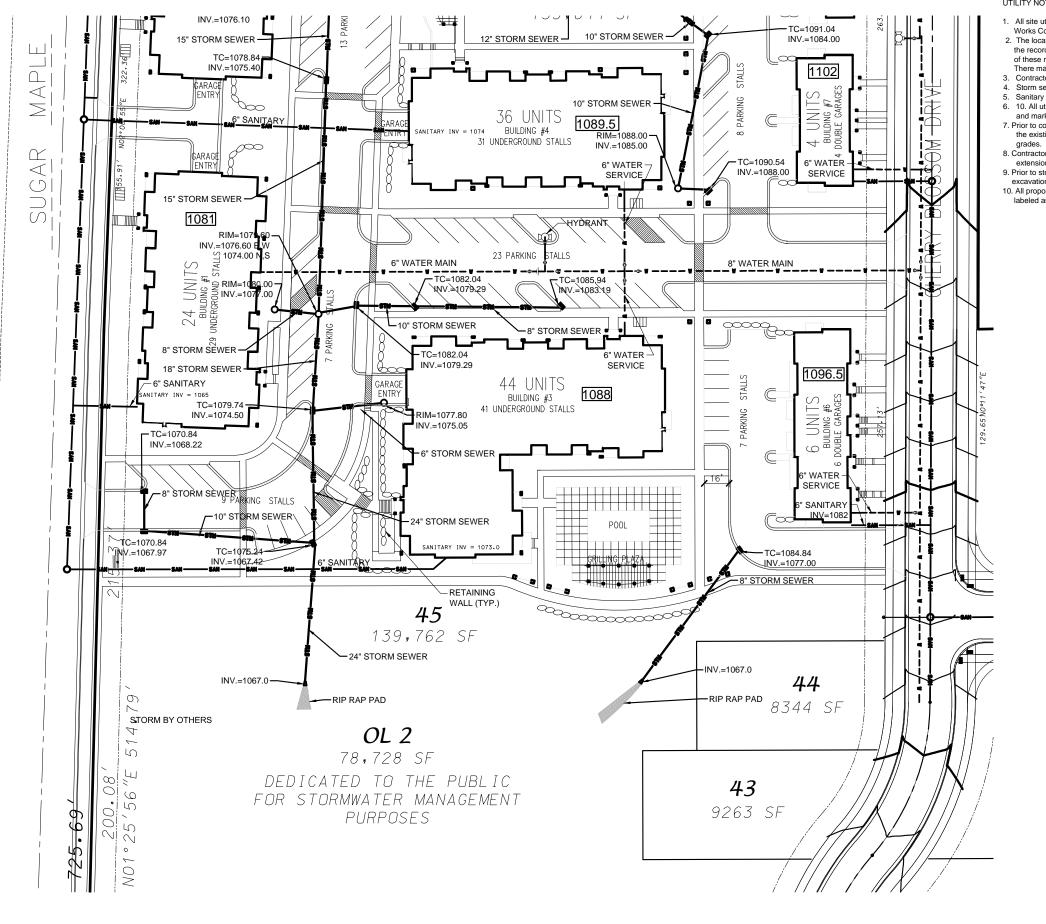

## UTILITY NOTES:

- 1. All site utilities shall conform to the City of Madison Standard Specifications for Public Works Construction, latest edition.
- 2. The locations of existing utility installations as shown on this drawing were obtained from the records of municipality, local utility records and Diggers Hotline locations. The accuracy of these records or the locations by Diggers Hotline cannot be certified or guaranteed. There may be other underground utility installations within the project area that are not shown.

  3. Contractor shall provide 6.5' of cover for the new water service.
- Storm sewer shall be installed with water tight joints.
- Sanitary sewer lateral shall be PVC, SDR-35.
- 6. 10. All utilities serving the proposed building shall be stubbed 5 feet inside of the building and marked using a 4" x 4" hardwood post.
- Prior to connecting to existing storm sewer or sanitary sewer the contractor shall verify the existing inverts and notify project superintendent if discrepancies are found from plan
- 8. Contractor to coordinate with the respective companies for gas, electric, telephone, cable extensions and/or abandonment.
- 9. Prior to storm sewer construction, the Utility Contractor shall obtain a connection and excavation permit from the City.
- 10. All proposed storm sewer, sanitary sewer and water services within Lots 45-47 are private except where


MAPLE APARTMENTS SUGAR

DATE: 06-17-14 REVISED:

DRAWN BY: NGO

FN: 14-05-101

C-2.3

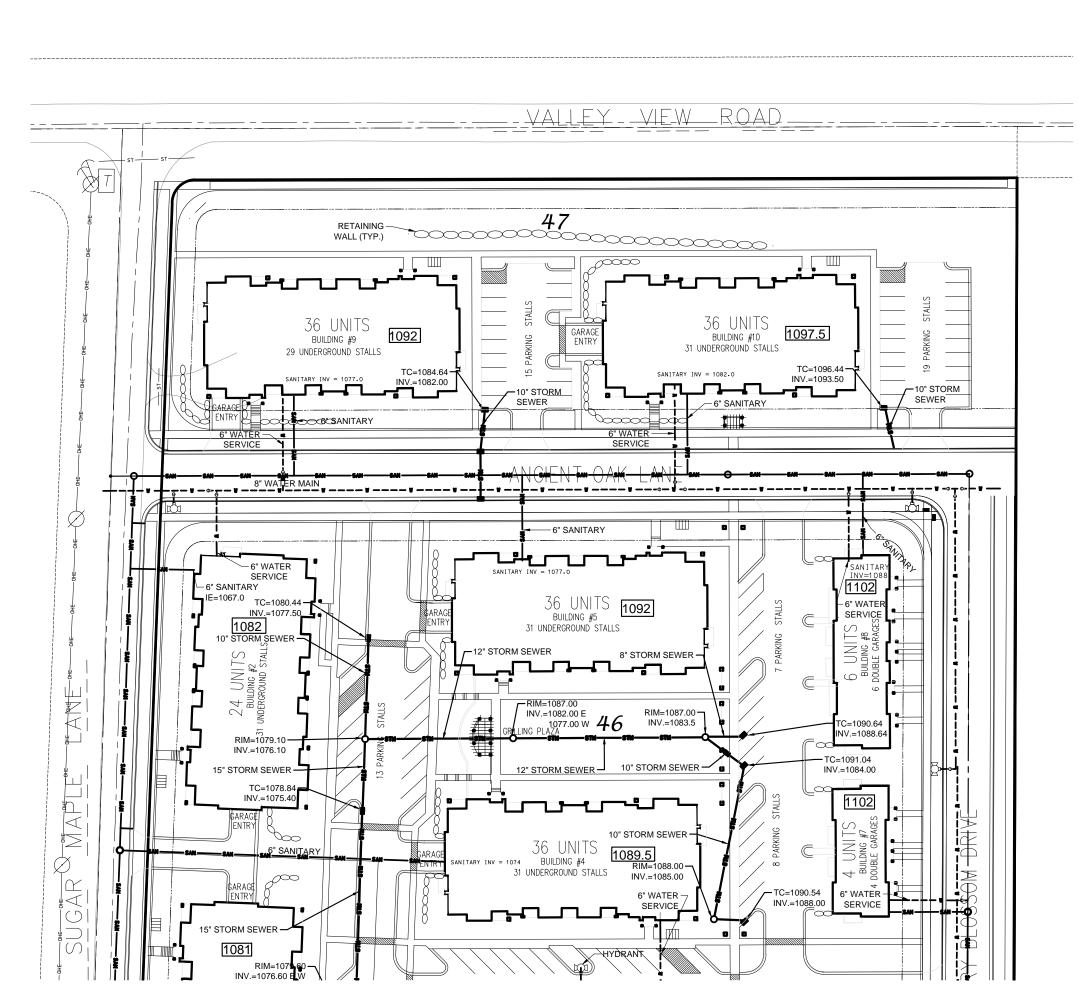

## UTILITY NOTES:

- All site utilities shall conform to the City of Madison Standard Specifications for Public Works Construction, latest edition.
- The locations of existing utility installations as shown on this drawing were obtained from the records of municipality, local utility records and Diggers Hotline locations. The accuracy of these records or the locations by Diggers Hotline cannot be certified or guaranteed. There may be other underground utility installations within the project area that are not shown.
- Contractor shall provide 6.5' of cover for the new water service.
- Storm sewer shall be installed with water tight joints.
- Sanitary sewer lateral shall be PVC, SDR-35.
- 10. All utilities serving the proposed building shall be stubbed 5 feet inside of the building and marked using a 4" x 4" hardwood post.
- Prior to connecting to existing storm sewer or sanitary sewer the contractor shall verify
  the existing inverts and notify project superintendent if discrepancies are found from plan
  grades.
- Contractor to coordinate with the respective companies for gas, electric, telephone, cable extensions and/or abandonment.
- Prior to storm sewer construction, the Utility Contractor shall obtain a connection and excavation permit from the City.
- excavation permit from the City.

  10. All proposed storm sewer, sanitary sewer and water services within Lots 45-47 are private except where labeled as public.

D'ONGFRIO KOTTKE AND ASSOCIATES, IN 17330 Wessemmel West, Datadison, WT, 5871 Promost GOS, 638,77300 « Kina GOS, 6393, 10 Koul Matterial, Incommer For Lang Reveal of

SUGAR MAPLE APARTMENTS





DATE: 06-17-14

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FN: 14-05-101

Number: C-2.4



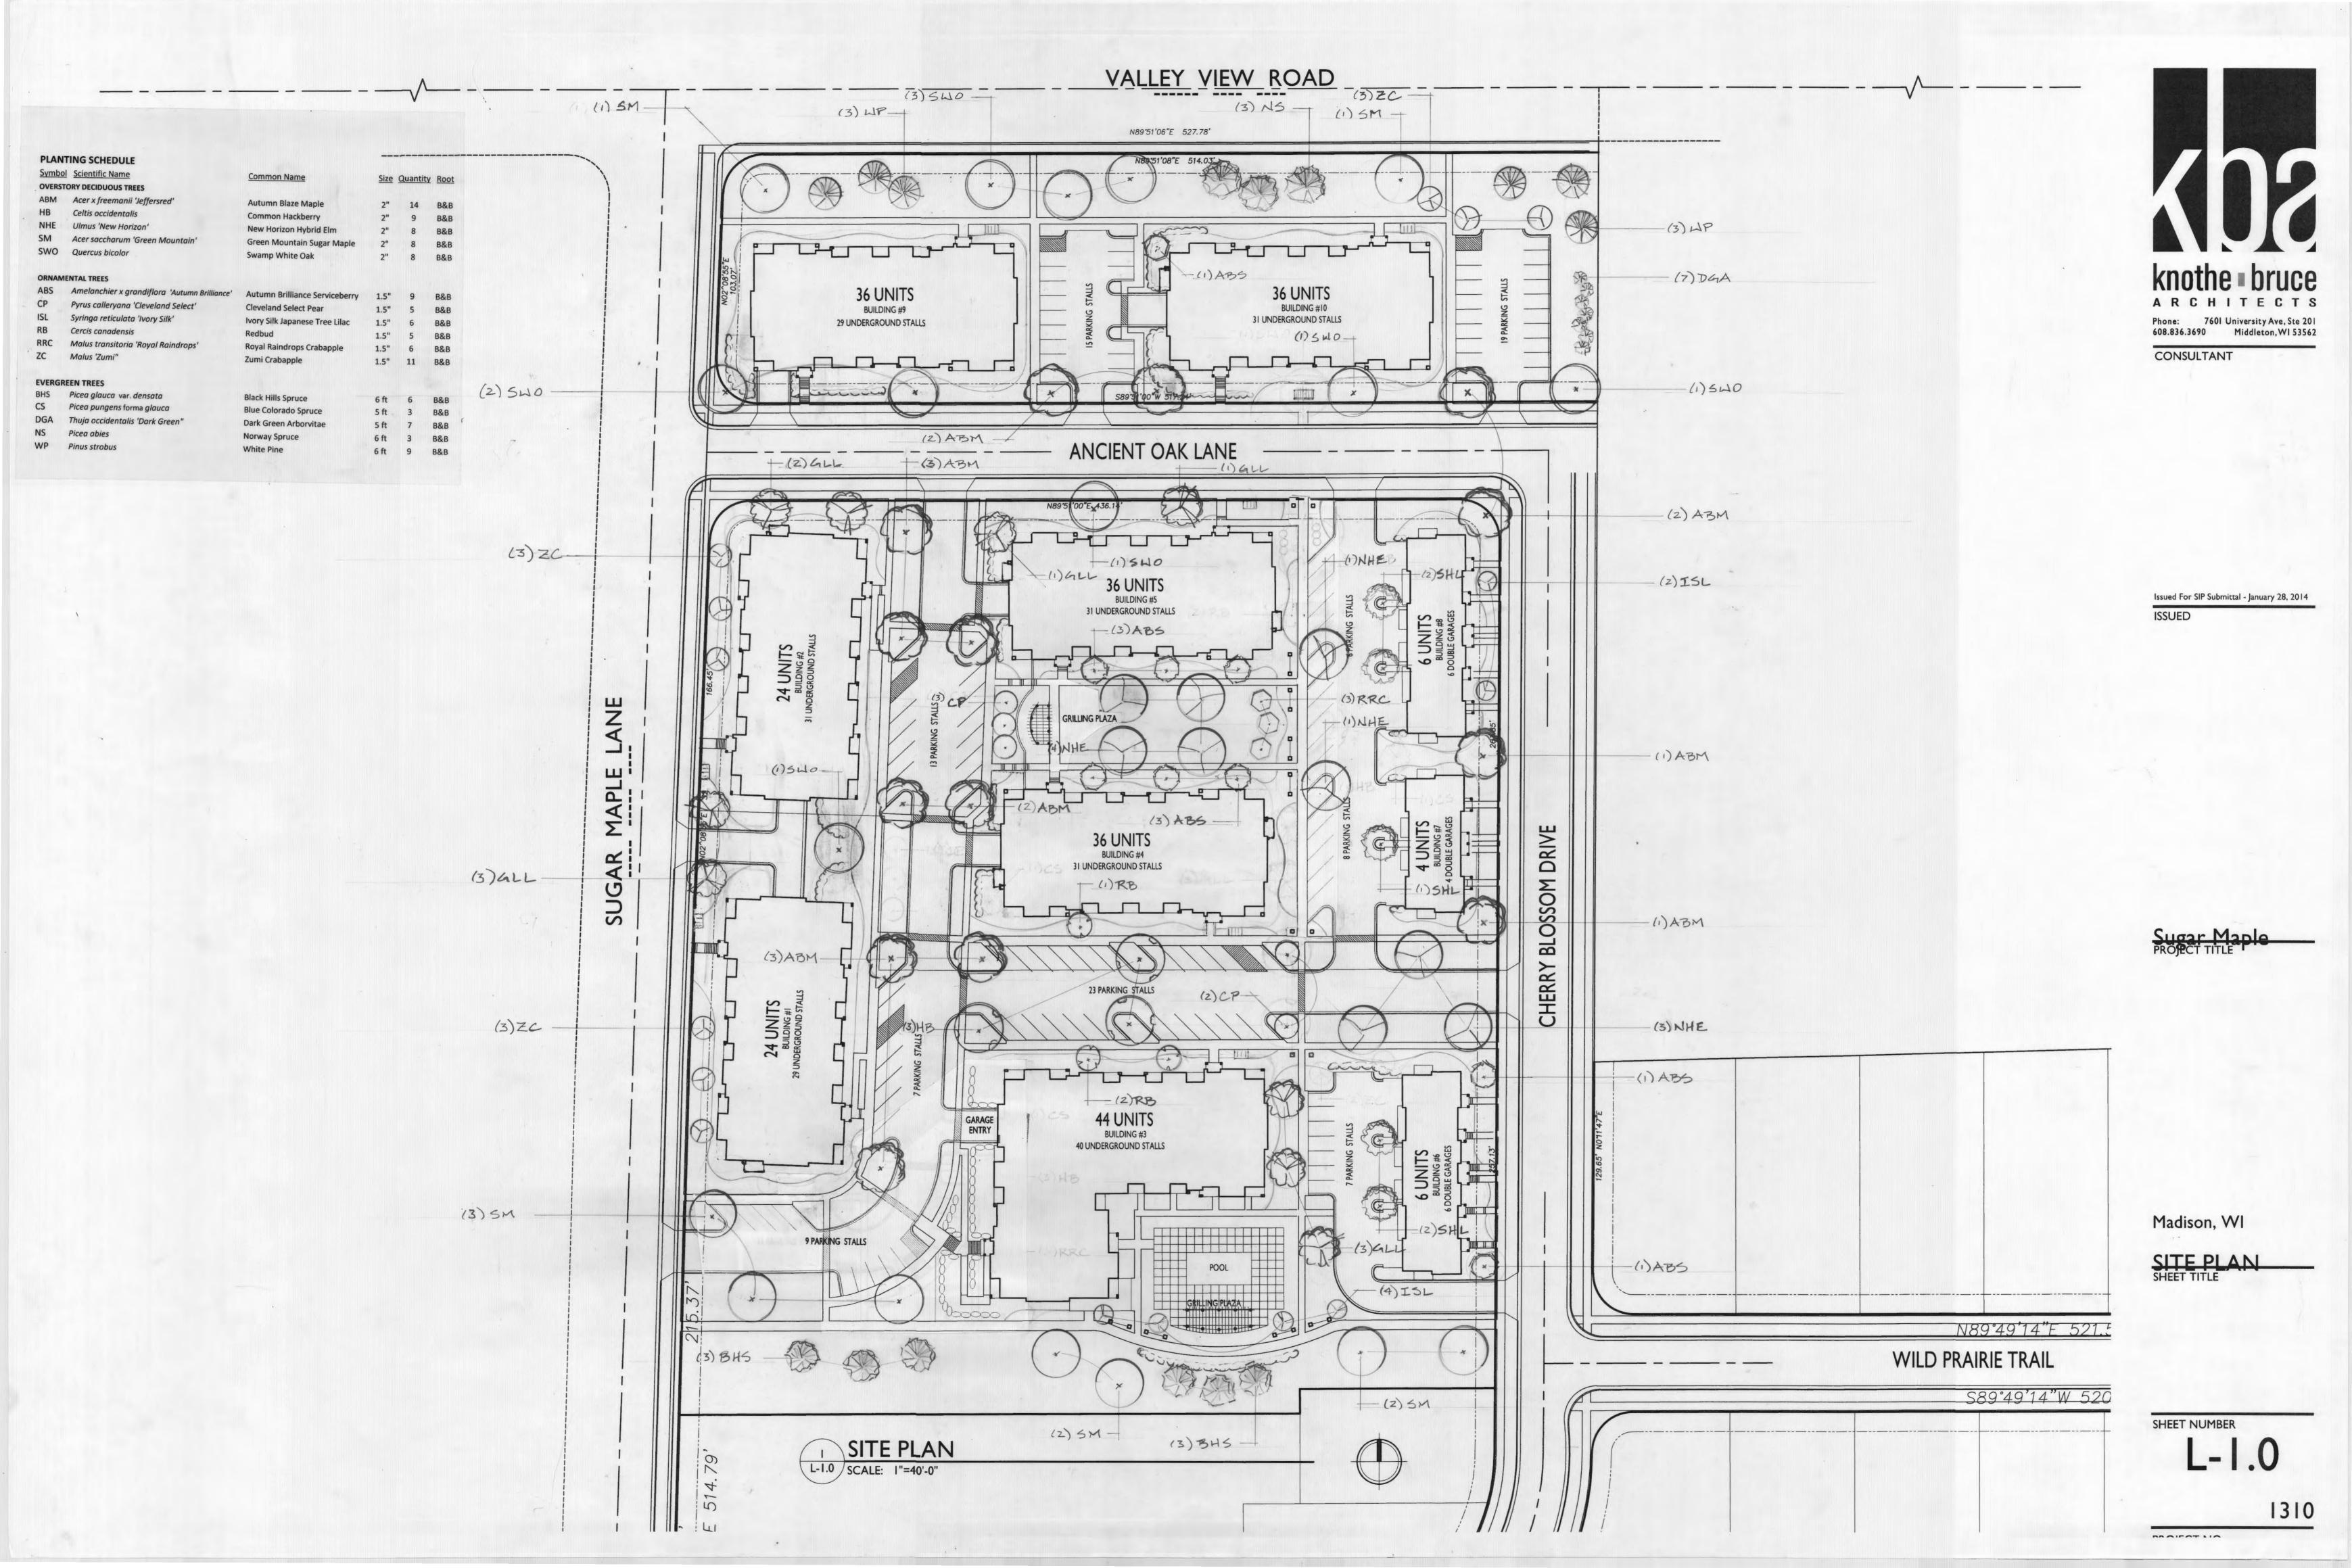


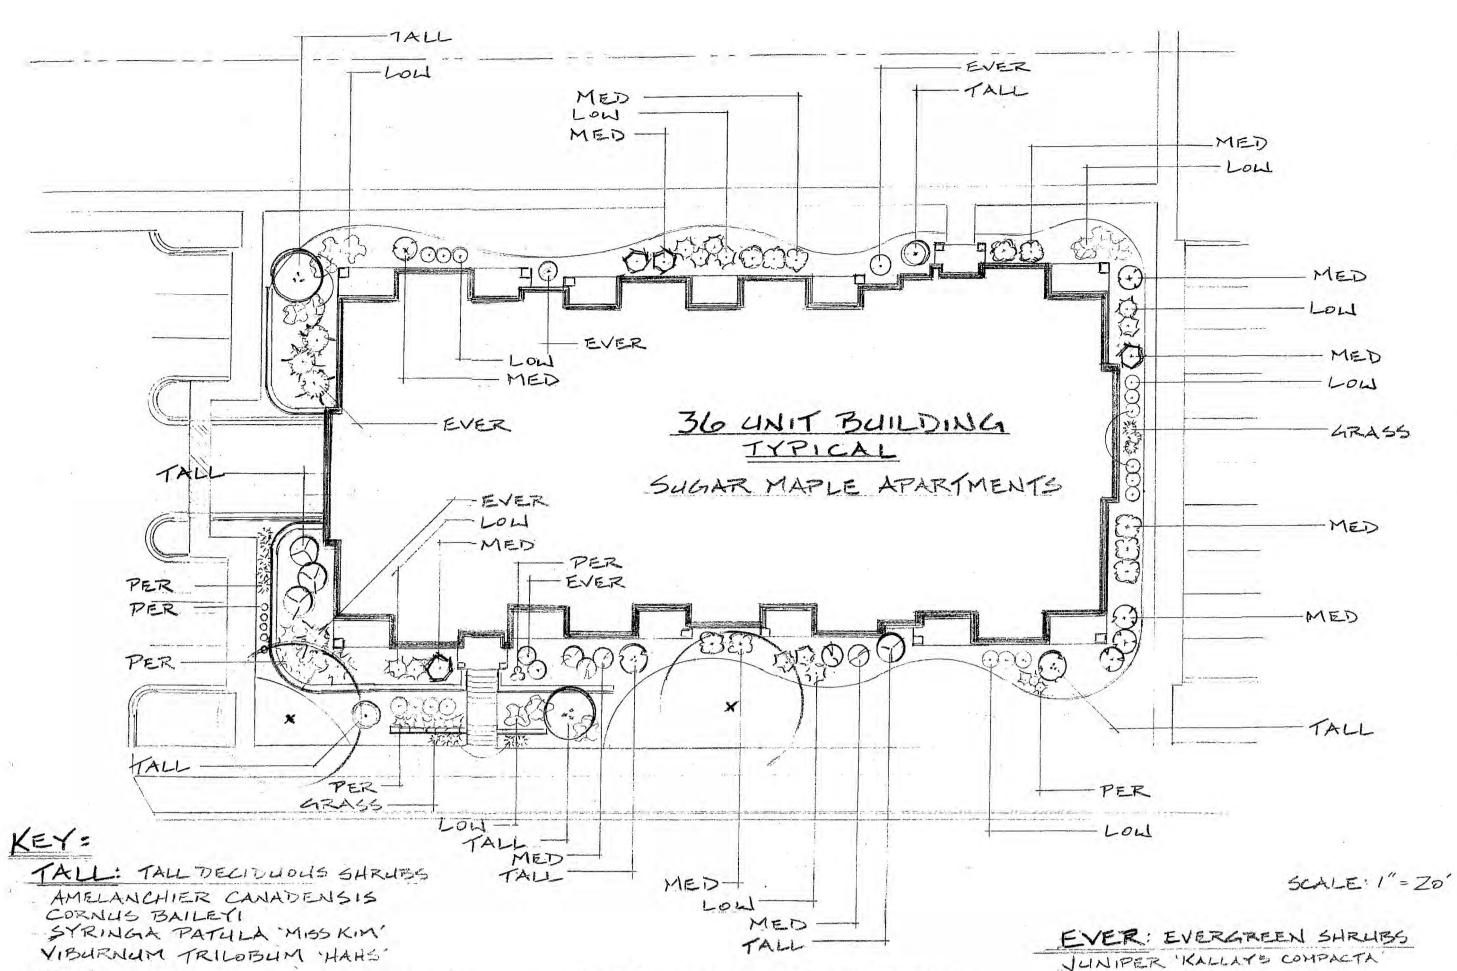LOW: LOW DECIDUOUS SHRUBS

RIBES ALPINUM GREEN MOUND

RHUS AROMATICA GRO-LOW

FORSYTHIA VIRIDISSIMA BRONYENSIS"

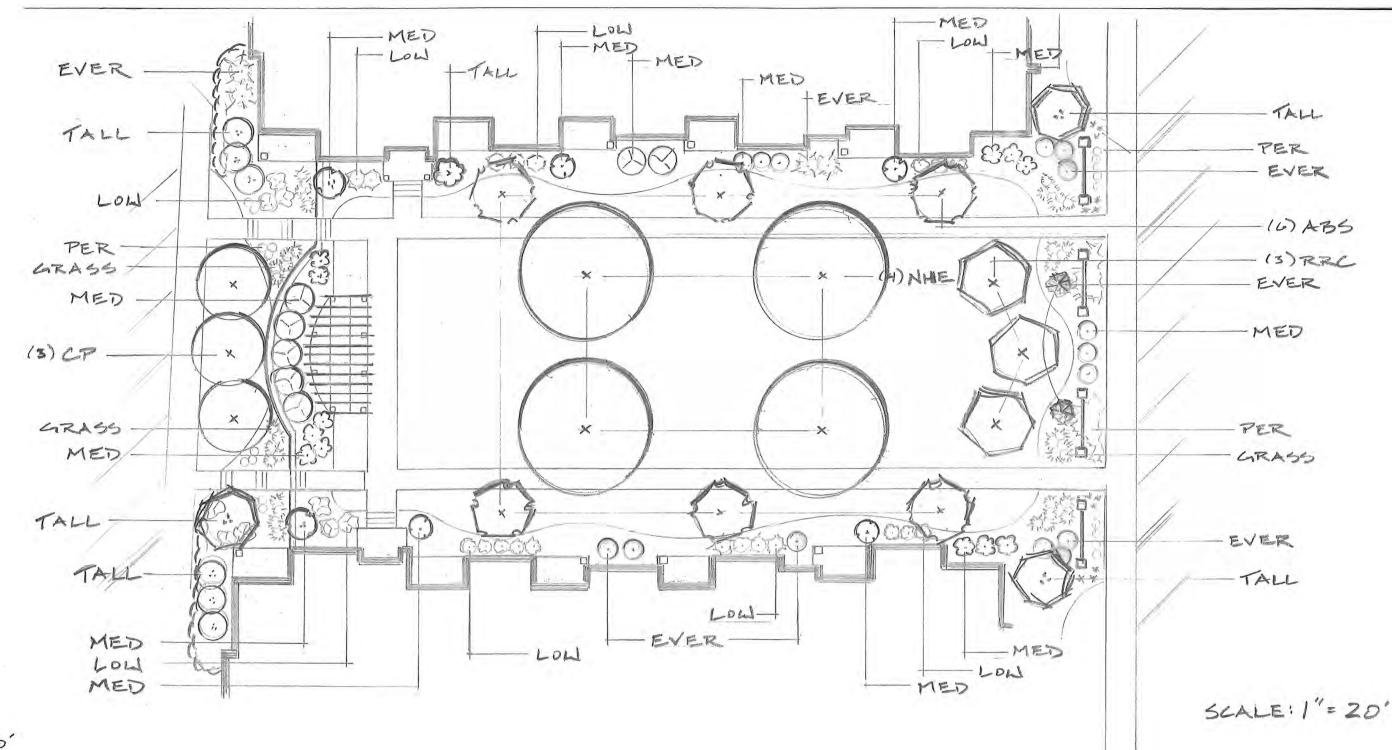

knothe • bruce ARCHITECTS 7601 University Ave, Ste 201 CONSULTANT

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GRILLING PLANTING PLAN

SHAR MAPLE APARTMENTS

JUNE ZOIH

PROJECT TITLE
Sugar Maple

KEY:

TALL: TALL DECIDUOUS SHRUB AMELANCHIER CANADENSIS CORNUS BAILEY! PHYSOCARPUS OPULIFOLIUS DIABOLD

MED: MEDIUM DECIDUOUS SARUB ARONIL MELANDEARPA VAR ELATA HYDRANGEA ARBORESCENS 'ANNABELLE' SYRINGIA MEYER! PALIBIN VIBURNUM TRILOBUM SPRING RED' HEIGELA FLORIDA CARNAVAL'

FORSYTHIA VIRIDISSIMA BRONXENSIS'
RHUS AROMATICA GRO-LOW'
RIBES ALPINUM GREEN MOUND

EVER: EVERGREEN SHRUB OR TREE JUNIPER KALLAY'S COMPACTA TAXUS MEDIA 'TAUNTONII' THUJA OCCIDENTALIS HOLMSTRUP PER: PERENNIALS - HEMEROCALLIS

HEUCHERA

SEDUM GRASS: ORNAMENTAL GRASS

FOR TREE KEY, SEE FULL SITE LANDSCAPE PLAN


Madison, WI

SHEET TITLE LANDSCAPE PLAN

SHEET NUMBER

L- I . I 1310

PROJECT NO. © 2013 Knothe & Bruce Architects, LLC

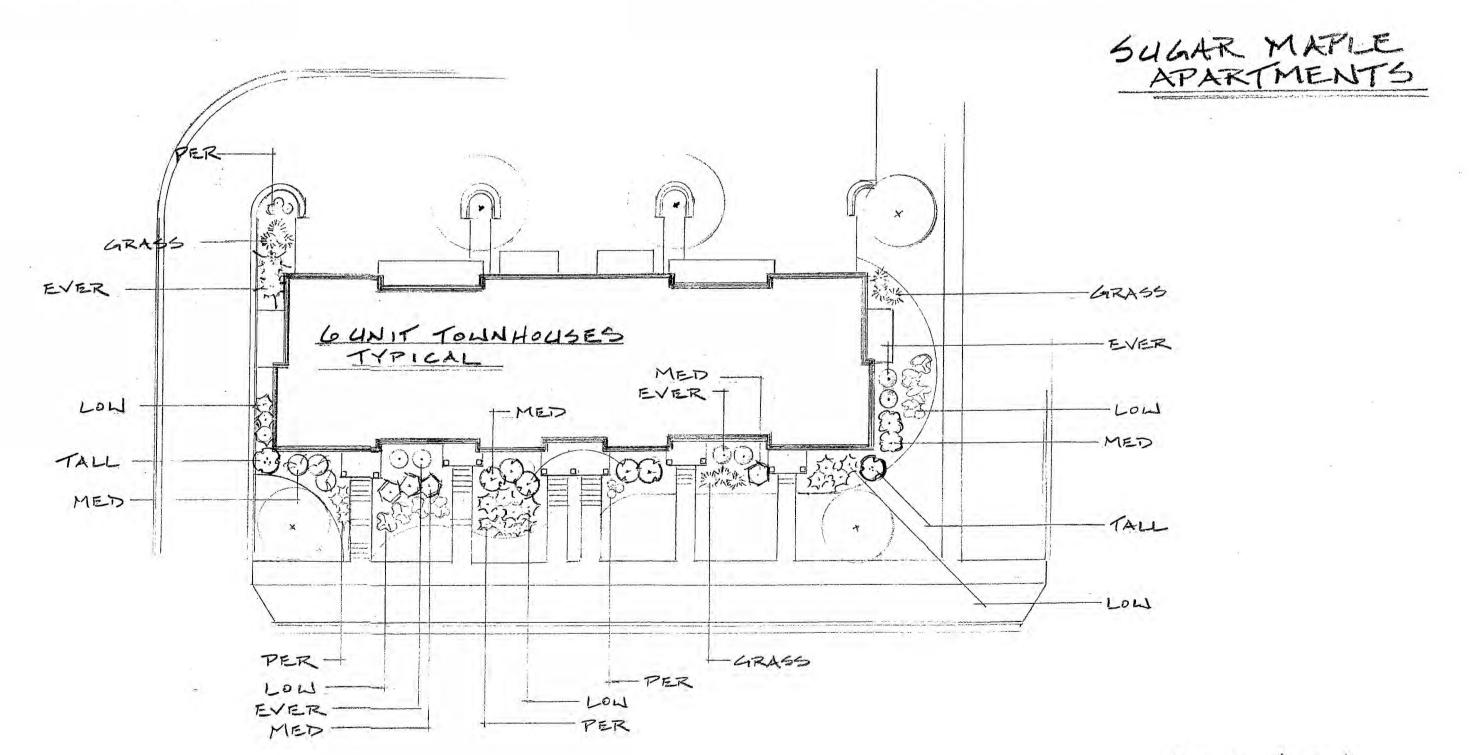

SCALE: 1"= 20"

TAXUSIMEDIA TAUNTONII

GRASSI ORNAMENTAL GRASS

PER: PERENNIALS - HEMEROCALLIS
HEUCHERA

KEY:

TALL: TALL DECIDUOUS SHRUBS SYRINGA PATULA 'MISS KIM'

MED: MEDIUM DECIDUOUS SHRUBS

ARONIA MELANOCARPA VAR ELATA HYDRANGEA ARBORESCENS 'ANNABELLE


PHYSOCARPUS OPULIFOLIUS SUMMERLINE" WEIGELA FLORIDA CARNAVAL


MED: MEDIUM DELIDUOUS SHRUBS ARONIA MELANOCARPA VAR ELATA HYDRANGEL ARBORESCENS 'ANNABELLE' PHYSOCARPUS OPULIFOLIUS 'SUMMERLINE' WEIGELA FLORIDA CARNAVAL


LOW: LOW DECIDUOUS SHRUBS FORSYTHIA VIRIDISSIMA BRONXENSIS RHUS AROMATICA GRO-LOW RIBES ALPINA GREEN MOUND

EVER: EVERGREEN SHRUBS JUNIPER KALLAYS COMPACTA TAXUS . MEDIA 'TAUTOMII'

PER: PERENNIALS - HEMEROCALLI HEHCHERA GRASS: BENAMENTAL GRASS

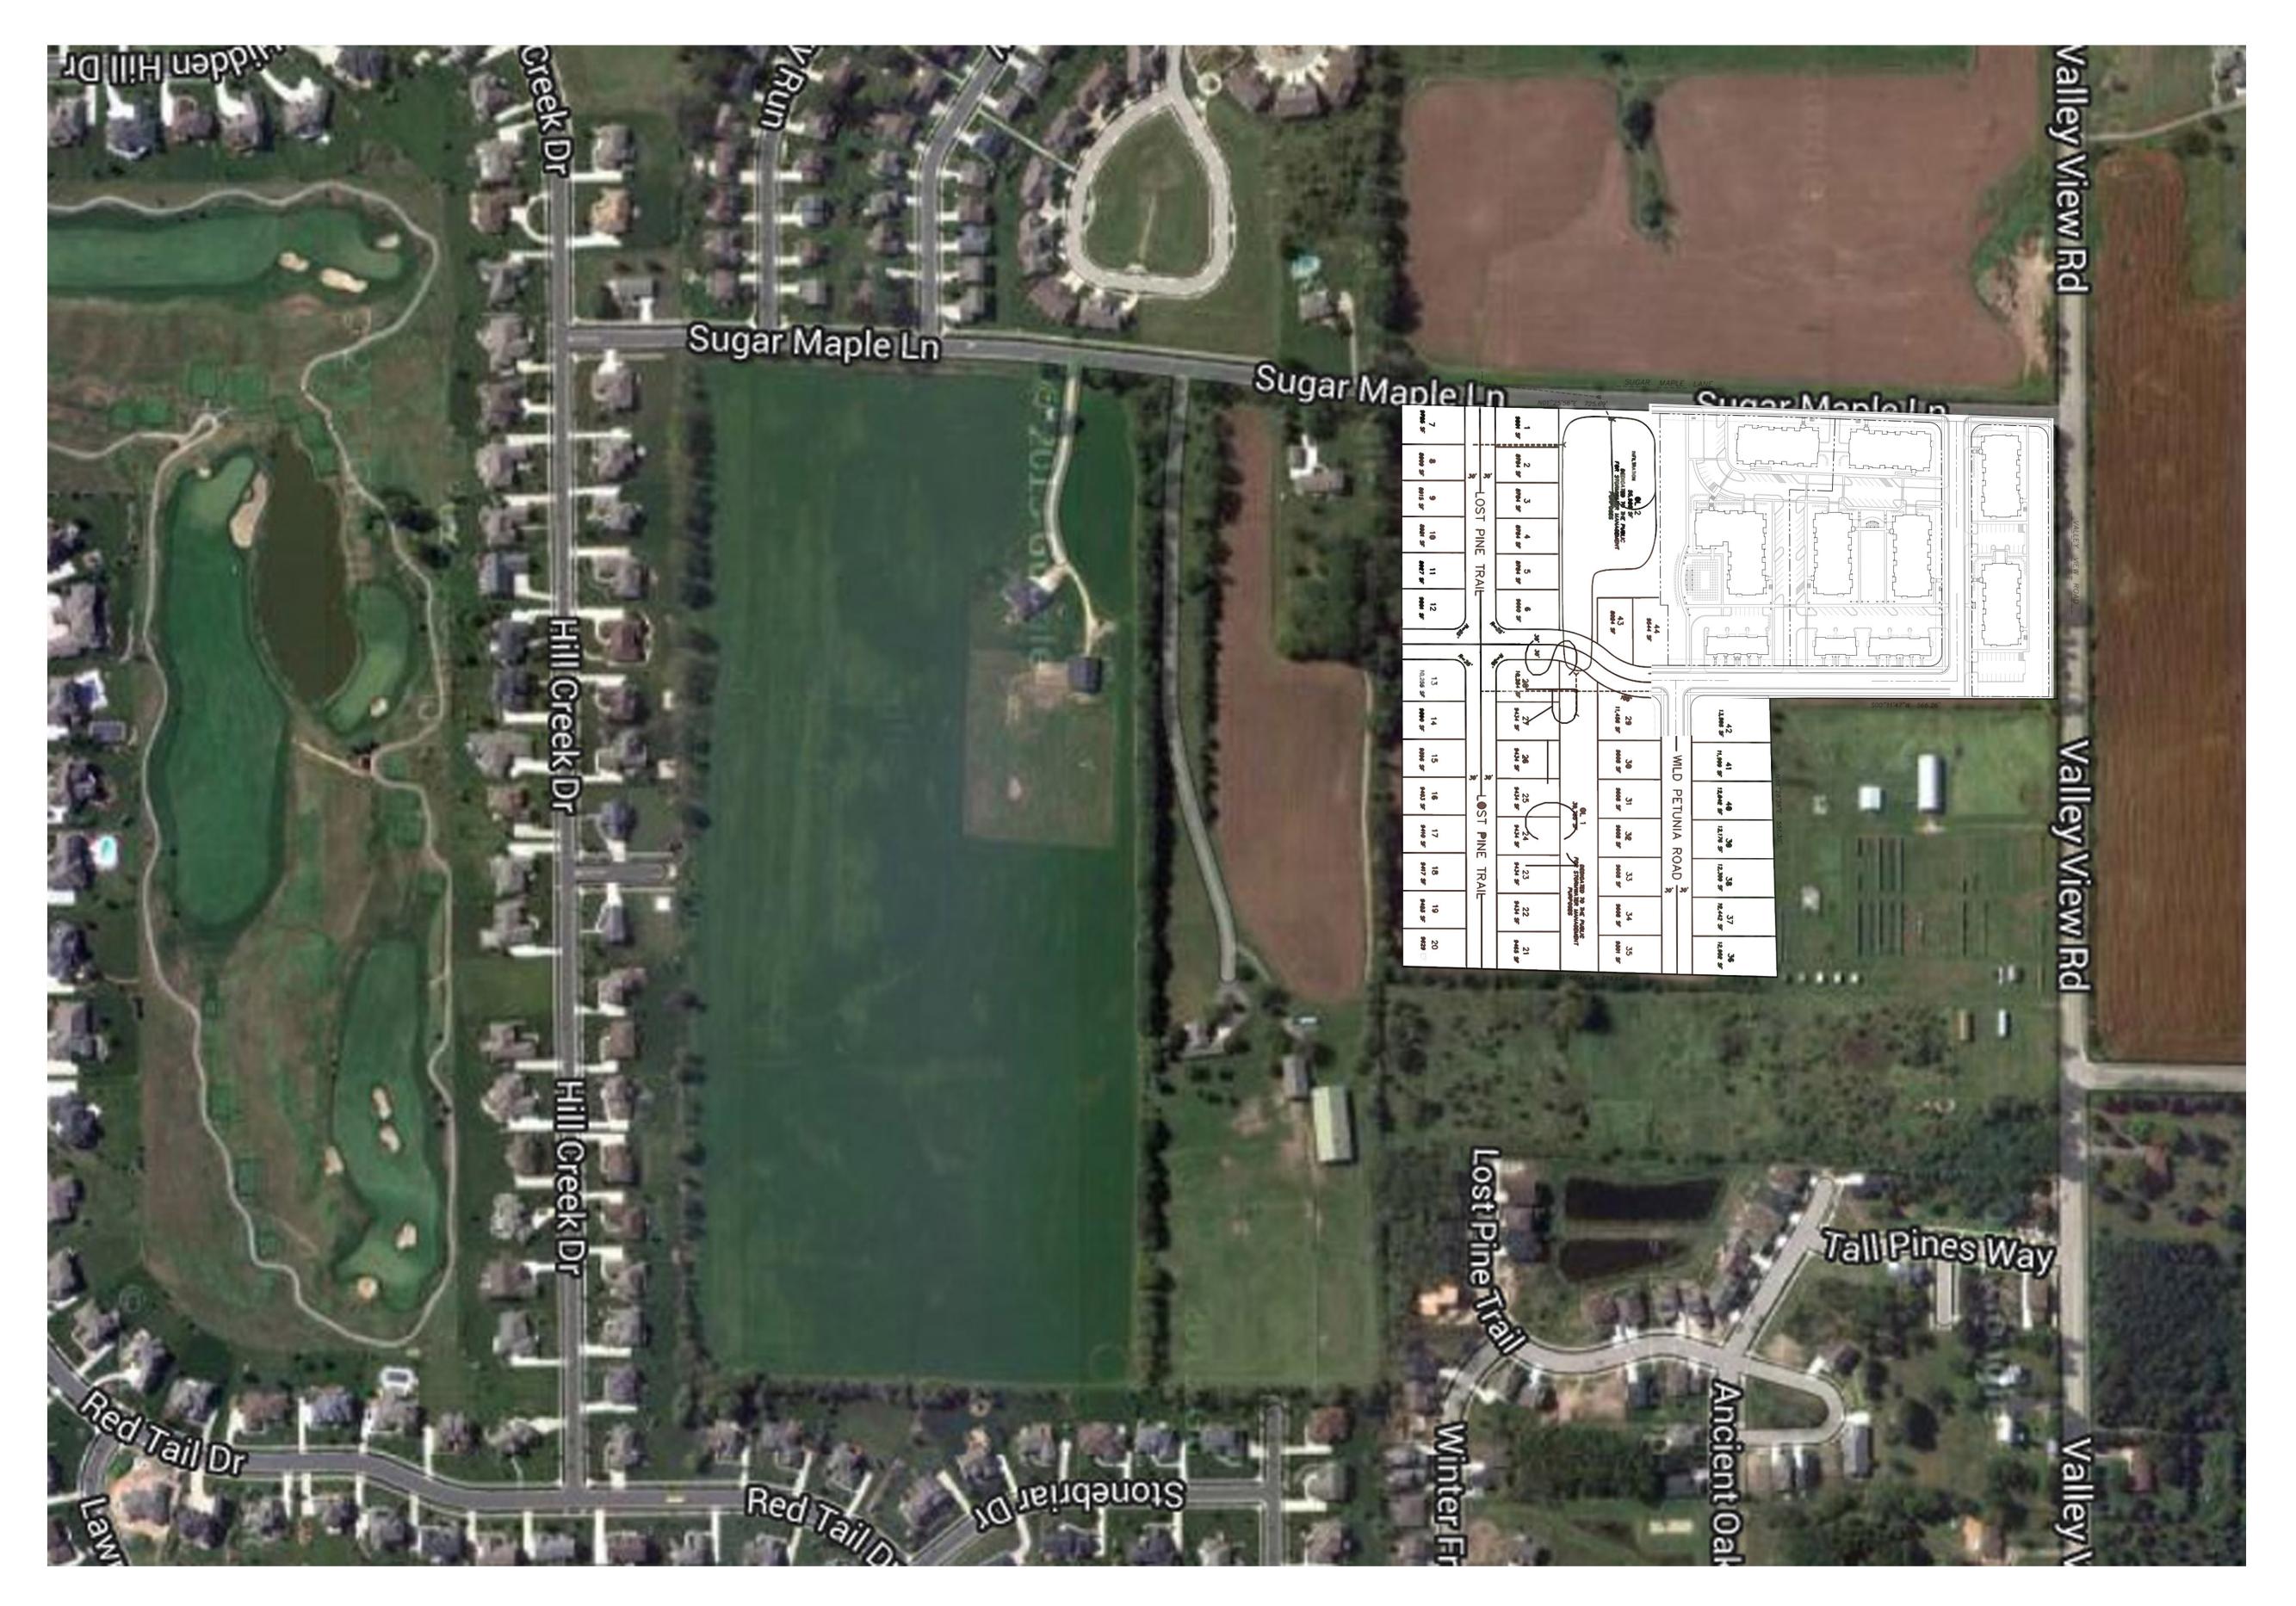

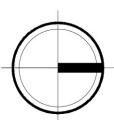


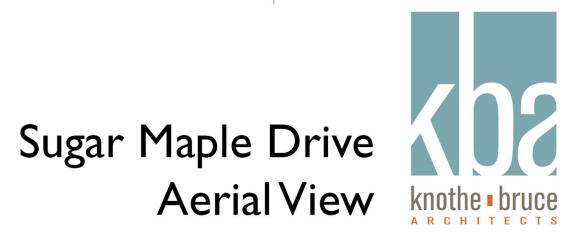




NORTH ELEVATION - 36-UNIT

9 SCALE: 1/8"=1'-0"

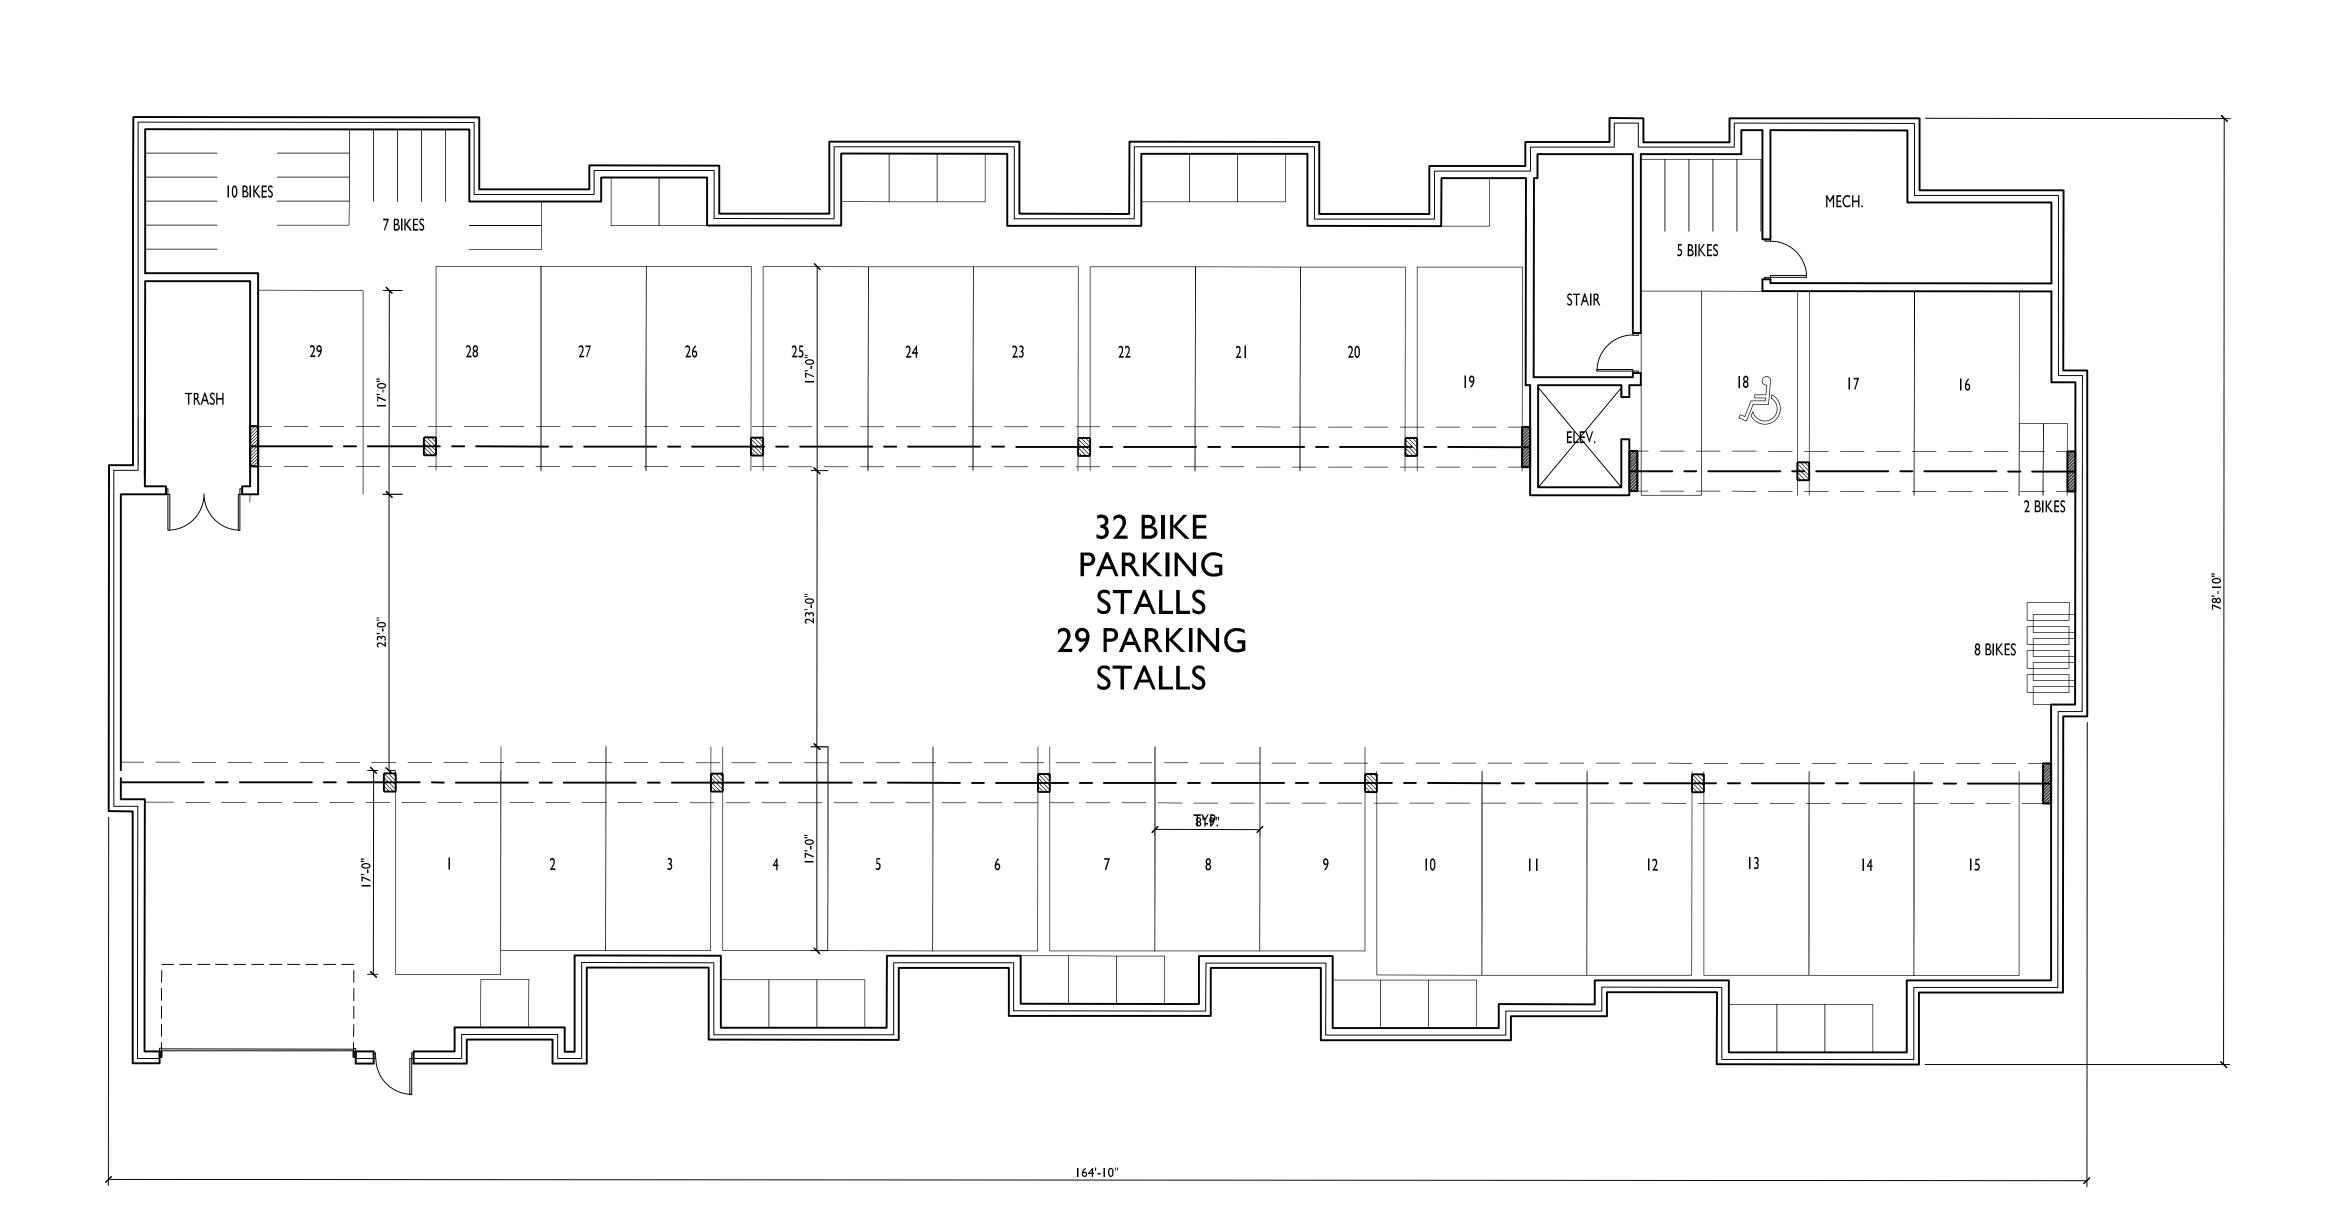

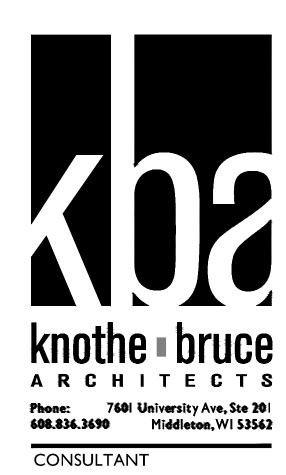

PROJECT TITLE

Sugar Maple

Madison, WI

SHEET TITLE
BASEMENT
PLAN
36-UNIT
BLDG #9

SHEET NUMBER





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PROJECT TITLE

Sugar Maple

Madison, WI

SHEET TITLE
BASMENT
PLAN
36-UNIT
BLDG #10

SHEET NUMBER





PROJECT TITLE


Sugar Maple

Madison, WI

SHEET TITLE
FIRST FLOOR
PLAN
36-UNIT
BLDG #9 & #10

SHEET NUMBER



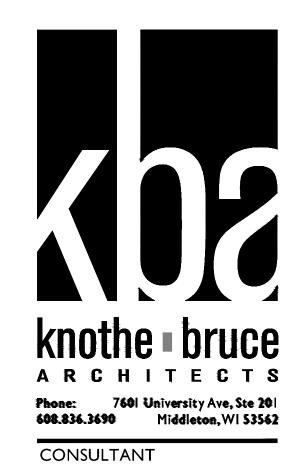

PROJECT TITLE

Sugar Maple

Madison, WI

SHEET TITLE
SECOND
FLOOR PLAN
36-UNIT
BLDG #9 & #10

SHEET NUMBER

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PROJECT TITLE


Sugar Maple


Madison, WI

SHEET TITLE
THIRD FLOOR
PLAN
36-UNIT
BLDG #9 & #10

SHEET NUMBER



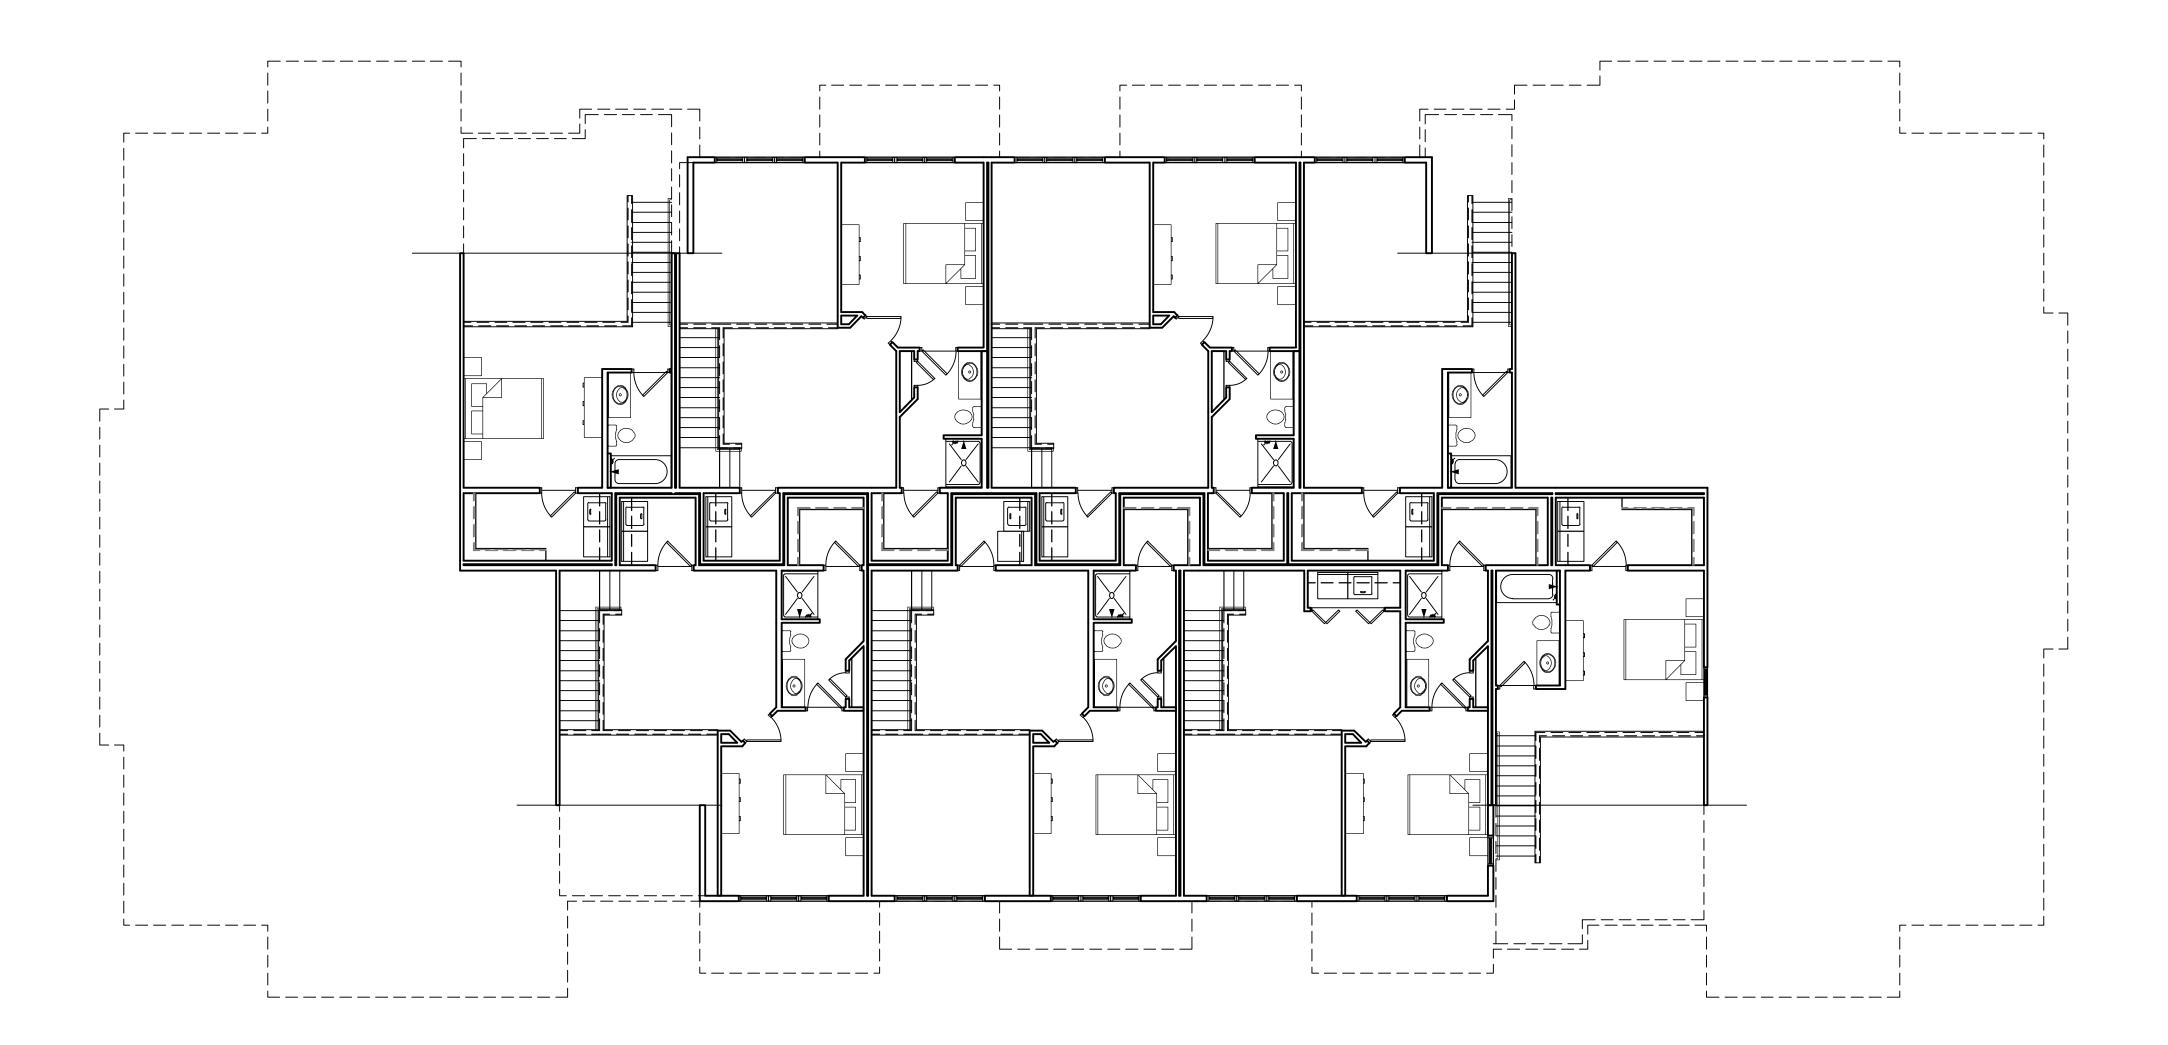

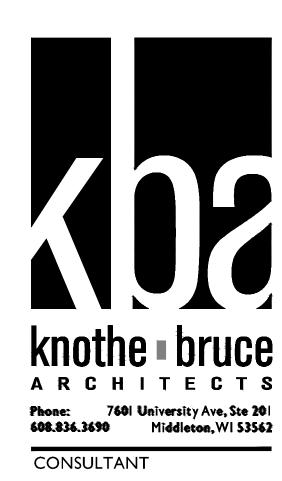

PROJECT TITLE

Sugar Maple

Madison, WI

SHEET TITLE
LOFT FLOOR
PLAN
36-UNIT
BLDG #9 & #10

SHEET NUMBER

E








EAST ELEVATION - 36-UNIT

SCALE: 1/8"=1'-0"

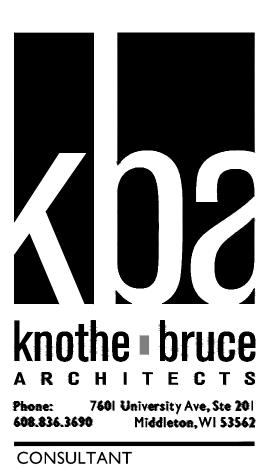

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PROJECT TITLE

Sugar Maple

Madison, WI
SHEET TITLE
ELEVATIONS
36-UNIT

BUILDING #9

SHEET NUMBER

\_



SCALE: 1/8"=1'-0"



WEST ELEVATION - 36-UNIT

8 SCALE: 1/8"=1'-0"



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PROJECT TITLE

Sugar Maple

Madison, WI

SHEET TITLE
ELEVATIONS
36-UNIT
BLDG #9

SHEET NUMBER

8



## NORTH ELEVATION - 36-UNIT 9 SCALE: 1/8"=1'-0"







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PROJECT TITLE

Sugar Maple

Madison, WI
SHEET TITLE
ELEVATIONS
36-UNIT
BLDG #10

SHEET NUMBER

9








WEST ELEVATION - 36-UNIT

SCALE: 1/8"=1'-0"

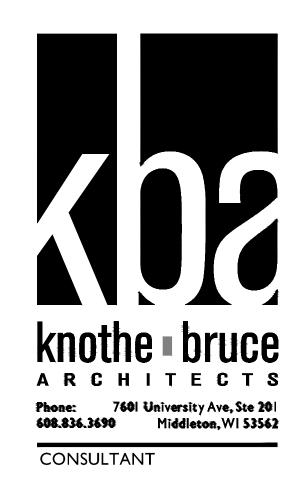

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PROJECT TITLE

Sugar Maple

Madison, WI
SHEET TITLE
ELEVATIONS
36-UNIT
BLDG #10

SHEET NUMBER

10