### APPLICATION FOR URBAN DESIGN COMMISSION REVIEW AND APPROVAL

AGENDA ITEM # \_\_\_\_\_ Project # \_\_\_\_\_

DATE SUBMITTE UDC MEETING D	D: <u>April 16, 2014</u> ATE <u>: April 23, 2014</u>	Action Requested Informational Presentation Initial Approval and/or Recommendation x Final Approval and/or Recommendation
PROJECT ADDRE	SS: 617 N. Segoe Road	
ALDERMANIC DI	STRICT: Chris Schmidt District #11	-
OWNER/DEVELO	PER (Partners and/or Principals)	ARCHITECT/DESIGNER/OR AGENT:
Venture II, LLC-	Jim Stopple	Knothe & Bruce Architects, LLC
1202 Regent Stre	et	7601 University Avenue, Suite 201
Madison, WI 537	15	Middleton, Wisconsin 53562
CONTACT PERSON	I: J. Randy Bruce/Knothe & Bruce Arch	hitects, LLC
Address:	7601 University Avenue, Suite 201	
	Middleton, Wisconsin 53562	
Phone:	608-836-3690	
Fax:	608-836-6934	
E-mail addres	ss: <u>rbruce@knothebruce.com</u>	
General I     x Specific I     Planned Comm     General I     Specific I     Planned Reside     New Construct:     required as wel     School, Public     New Construct:     50,000 Sq.Ft.     Planned Comm	Development (PUD) Development Plan (GDP) Implementation Plan (SIP) Junity Development (PCD) Development Plan (GDP) Implementation Plan (SIP) Implementation Plan (SIP) Impleme	
(See Section B for:) — New Construct: (See Section C for:)	ion or Exterior Remodeling in C4 Distric	t (Fee required)
· · · · · · · · · · · · · · · · · · ·	ng Variance (Fee required)	
	e Design Review* (Fee required) Variance* (Fee Required)	
X Other <u>Rezoning</u> *Public Hearing Requ	g to PD uired (Submission Deadline 3 Weeks in A	Advance of Meeting Date)



Segoe Road Elevation



**Rear Elevation** 



South Elevation





## North Elevation

Elevations

Segoe Road Development 2014-04-16



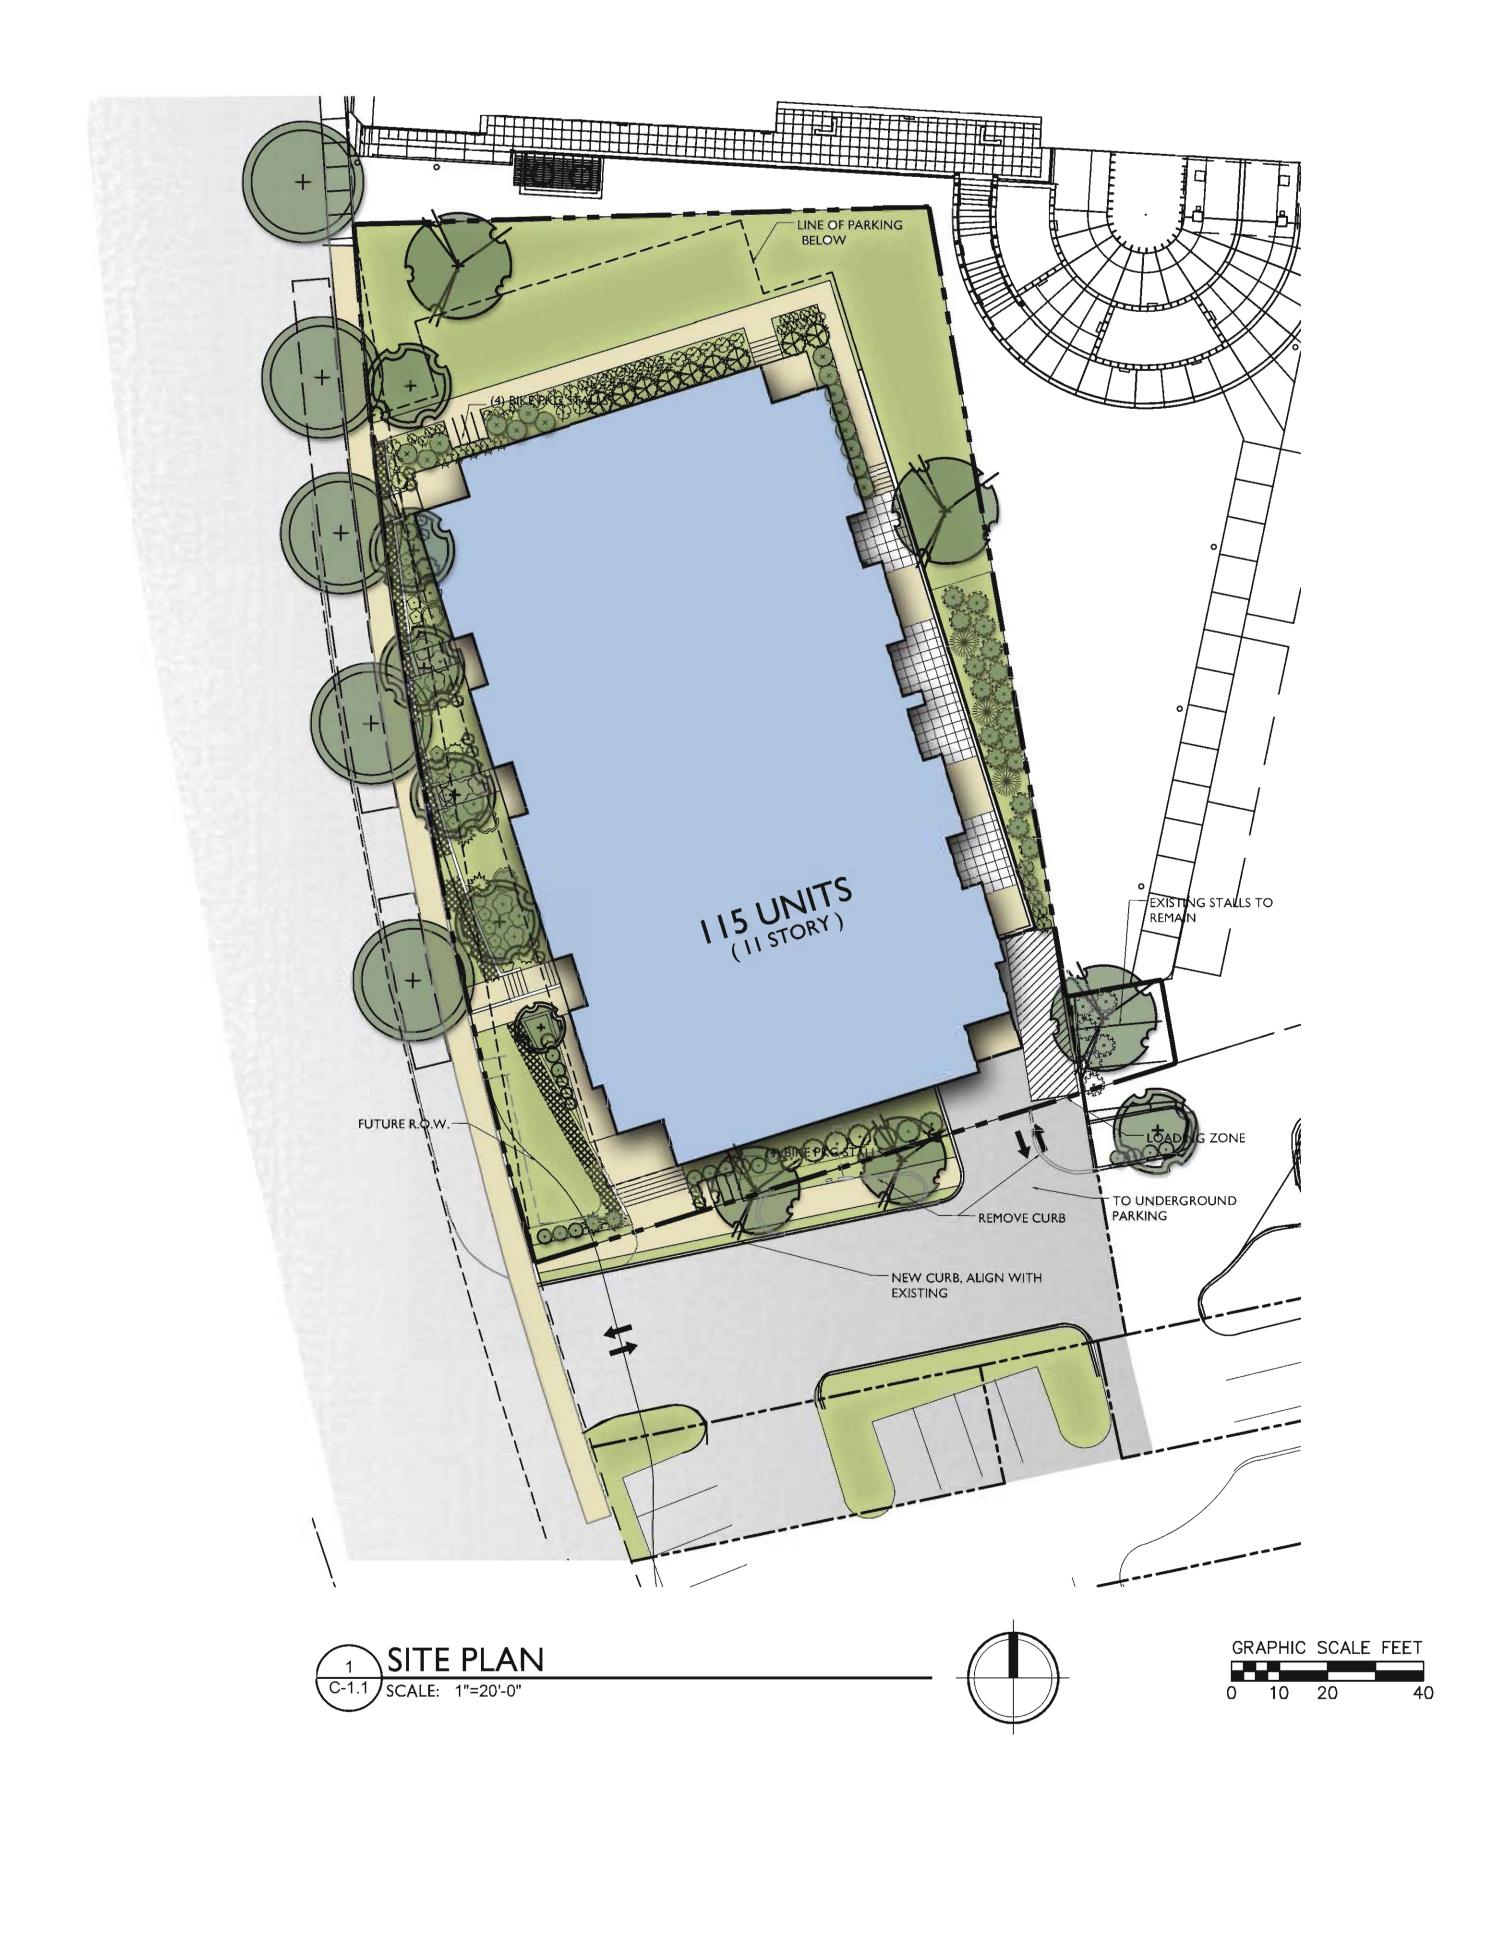

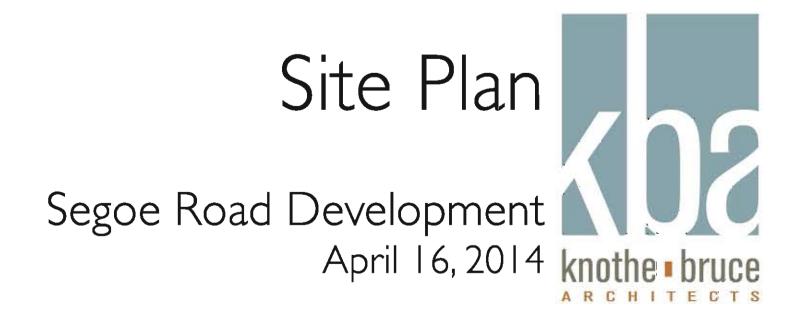

	FOR	OFFICE USE ONLY:
LAND USE APPLICATION Madison Plan Commission	Amt. Paid	Receipt No.
Madison The Madison Flan Commission	Date Received	
215 Martin Luther King Jr. Blvd; Room LL-100	Received By	
PO Box 2985; Madison, Wisconsin 53701-2985	Parcel No.	
Phone: 608.266.4635   Facsimile: 608.267.8739	Aldermanic District	
• The following information is required for all applications for Plan	GQ	
Commission review except subdivisions or land divisions, which	Zoning District	
should be filed using the <u>Subdivision Application</u> .		omplete Submittal
<ul> <li>A separate Urban Design Commission application is no longer required for projects requiring both Urban Design Commission</li> </ul>	Application	Letter of Intent
and Plan Commission approvals.	Photos	Legal Descript.
• This form may also be completed online at	Plan Sets	Zoning Text
http://www.cityofmadison.com/developmentcenter/landdevelo	Ngbrhd. Assn Not.	Waiver
<u>pment</u>	Date Sign Issued	
<ul> <li>All Land Use Applications should be filed with the Zoning Administrator at the above address.</li> </ul>		
1. Project Address:	Project	Area in Acres:
Project Title (if any):		
2. This is an application for (Check all that apply to your Land	Use Application).	
Zoning Map Amendment from	to	
Major Amendment to Approved PD-GDP Zoning	Major Amendment	to Approved PD-SIP Zoning
Conditional Use, or Major Alteration to an Approved Cond	itional Use	
Demolition Permit		
Review of Minor Alteration to Planned Development by th	o Plan Commission (	)nly
		/iiiy
3. Applicant, Agent & Property Owner Information:		
5. Applicant, Agent & Toperty Owner Information.		
	ompany:	
Applicant's Name: Co		Zip:
Applicant's Name:     Control       Street Address:     City/State:       Telephone:     ( )	Email:	Zip:
Applicant's Name:  Construction    Street Address:  City/State:    Telephone:  ()	Email:	Zip:
Applicant's Name:  Color    Street Address:  City/State:    Telephone:  )    Project Contact Person:  Color	Email:	Zip: Zip:
Applicant's Name:  Cd    Street Address:  City/State:    Telephone:  Fax:    Project Contact Person:  Cd    Street Address:  City/State:	Email: ompany: Email:	Zip:
Applicant's Name:  Cd    Street Address:  City/State:    Telephone:  Fax:    Project Contact Person:  Cd    Street Address:  City/State:    Telephone:  Fax:    City/State:	Email: ompany: _ Email:	Zip:
Applicant's Name:Cd   Street Address:City/State:   Telephone:Fax:   Project Contact Person:Cd   Street Address:City/State:   Telephone:Fax:   Telephone:Fax:   Property Owner (if not applicant):	Email: ompany: _ Email:	Zip:
Applicant's Name:	Email: ompany: Email:	Zip:
Applicant's Name: Cd   Street Address: City/State:   Telephone: Fax:   Project Contact Person: Cd   Street Address: City/State:   Telephone: Fax:   City/State: City/State:   Telephone: City/State:	Email: ompany: Email:	Zip:

### 5. Required Submittals:

- Site Plans, fully dimensioned and describing pertinent project details, submitted as follows below and depicting all lot lines; existing, altered, demolished and/or proposed buildings; parking areas and driveways; sidewalks; the location of any new signs; existing and proposed utility locations; building elevations, materials and floorplans, and; landscaping:
  - Seven (7) copies of a full-sized plan set drawn to a scale of 1 inch = 20 feet (collated, stapled and folded)
  - Twenty (20) copies of the plan set reduced to fit onto 11 X 17-inch paper (collated, stapled and folded)
  - For projects also being reviewed by the Urban Design Commission, twelve (12) additional 11 X 17-inch copies.
  - One (1) copy of the plan set reduced to fit onto 8 ½ X 11-inch paper
- REVISED! Letter of Intent: Twelve (12) copies describing this application in detail including, but not limited to: existing conditions; the project schedule; names of persons involved (contractor, architect, civil engineer, etc.); details of the project, including proposed uses, building square footage, number of dwelling units, auto and bike parking stalls, etc.; hours of operation; value of land; project cost; any public subsidy requested, and; number of construction and full-time equivalent jobs created. For projects also being reviewed by the Urban Design Commission, provide twelve (12) additional copies of the letter.
- Filing Fee: Refer to the Land Use Application Information & Fee Schedule. Make checks payable to: City Treasurer.
- Electronic Submittal: All applicants are required to submit copies of all items submitted in hard copy with their application (including this application form, the letter of intent, complete plan sets, etc.) as Adobe Acrobat PDF files on a non-returnable CD to be included with their application materials, or by e-mail to *pcapplications@cityofmadison.com*.

#### In Addition, The Following Items May Also Be Required With Your Application:

- Legal Description of Property: For any application for rezoning, the description must be submitted as an <u>electronic word</u> document via CD or e-mail. For applications requesting rezoning to more than one district, a separate description of each district shall be submitted.
- For any applications proposing **Demolition or Removal** of existing buildings, the following items are required:
  - Prior to the filing of an application, the applicant or his/her agent is required to notify a list of interested persons
    registered with the City 30 or 60 days prior to filing their application using the online notification tool found at:
    <a href="https://www.cityofmadison.com/developmentCenter/demolitionNotification/">https://www.cityofmadison.com/developmentCenter/demolitionNotification/</a>
  - A photo array (6-12 photos) of the **interior and exterior** of the building(s) to be demolished or removed. A written assessment of the condition of the building(s) to be demolished or removed is highly recommended.
  - Approval of a Reuse & Recycling Plan by the City's Recycling Coordinator is required prior to issuance of permits.
- A Zoning Text shall accompany all Planned Development District (PD/PCD/PUD) applications.

### 6. Applicant Declarations:

- Conformance with adopted City plans: The site is located within the limits of the <u>Compresention of the PUPW</u> Plan, which recommends <u>OPMMWW/179</u> MIXEP USE + T.O.D. for this property.
- Pre-application Notification: Section 28.12 of the Zoning Code requires that the applicant notify the district alder and any nearby neighborhood and business associations in writing no later than *30* days prior to filing this request. List the alderperson, neighborhood association(s), and business association(s) AND the dates you sent the notices: 10/9,11/26 with Alder Schmidt, 12/05 neighborhood mtg, 1/4-neighborhood steering,

→ If a waiver has been granted to this requirement, please attach any correspondence to this effect to this form.

- Pre-application Meeting with Staff: <u>Prior</u> to preparation of this application, the applicant is required to discuss the proposed development and review process with Zoning and Planning Division staff; note staff persons and date.
   *Planning Staff:* Kevin Firchow, Katherine Cornwell Date: 5/7,10/28 Zoning Staff: traffic Date: 1/28
- → The applicant attests that this form is accurately completed and all required materials are submitted:

Name of Applicant	Jim Stopple	Relation to Prop	erty Owner Owner
Authorizing Signatur	e of Property Owner	A	Date 2-18-14



February 19, 2014 (REVISED April 11, 2014)

Ms. Katherine Cornwell Department of Planning & Development City of Madison 215 Martin Luther King Jr. Blvd PO Box 2985 Madison, Wisconsin 53701

Re: Letter of Intent – Rezoning from NMX to PD 617 Segoe Road Madison, Wisconsin KBA Project # 1012

Ms. Katherine Cornwell:

The following is submitted together with the plans, application and zoning text for staff, Plan Commission and consideration of approval.

#### **Organizational Structure:**

Owner:	Venture II, LLC 1202 Regent Street Madison, VVI 53715 (608) 251-8777 Contact: Jim Stopple jim@madisonproperty.com	Architect:	Knothe & Bruce Architects, LLC 7601 University Avenue, Ste 201 Middleton, WI 53562 (608) 836-3690 Contact: Randy Bruce <u>rbruce@knothebruce.com</u>
Engineer:	Vierbicher 999 Fourier Drive Ste 201 Madison, WI 53717 (608) 826-0532 Contact: Joe Doyle jdoy@vierbicher.com	Landscape Design:	Ken Saiki Design, Inc. 303 Paterson Suite I Madison, WI 53703 (608) 251-3600 Contact: Stevie Koepp SKoepp@ksd-la.com

Letter of Intent –PD 617 Segoe Road Page 2 of 4

### Introduction:

The following letter is submitted to accompany the application materials for the rezoning application for the property at 617 N. Segoe Road.

### **Demolition Standards:**

In order to provide new, high quality, energy efficient housing this proposed development envisions the deconstruction of an existing 8400 sf commercial building.

The building to be deconstructed is located at 617 N. Segoe Road. It is an 8400sf, 2 story commercial building. The building was built in 1979 as a bank. The building is steel frame construction with facebrick exterior and a concrete foundation. Images of the existing structure have been attached.

Section 28.04(22) of the Madison Zoning Code outlines the standards by which a demolition permit may be issued. These standards require that the Plan Commission find that the requested demolition and proposed use are compatible with the intent and purposes of the zoning code. Although the zoning code clearly encourages the preservation of existing structures, its purpose also includes promoting the general welfare of the city, encouraging the most appropriate land uses and conserving and enhancing the taxable value of lands and buildings.

As the Plan Commission considers the demolition request the following standards are to be considered:

- The effects the proposed demolition and use would have on the normal and orderly development and improvement of the surrounding properties.
- Reasonableness of efforts to relocate the buildings including the costs of relocation and the limits that the location of the building would have on its relocation.
- Availability of affordable housing after giving due consideration of the master plan.
- Encourage the reuse and recycling of the materials from the buildings.

We believe that the demolition standards can be met. A Re-use and Recycling Plan will be submitted prior to the deconstruction of the structure.

### **Project Description:**

The project consists of 115 apartments. The building has 11 stories of housing over three and a half levels of parking. The mechanical penthouse, common room, exercise facility and roof terrace are located above the eleventh floor.

The building is well articulated with vertical modulation and horizontal stepbacks. The articulation is achieved by incorporating a variety of floor plans, unit sizes and types and is reinforced with the use of exterior materials. The exterior spandrel panels, brick and composite metal panel provide a high-quality building shell.

Vehicular access to the site is achieved from Segoe Road. Underground parking for 140 cars is provided for the residents. In addition, a total of 11 visitor stall are provided at the upper parking level. Bicycle parking is well distributed in the basement and on site. A loading zone is provided at the south east

Letter of Intent –PD 617 Segoe Road Page 3 of 4

corner of the site.

The exterior open space of the development provides attractive private and public areas for the residents and guests. Each apartment has access to a private patio or balcony. In addition, a common roof terrace provides residents with an outdoor gathering area with expansive views.

The building will be professionally managed and an on-site management office on the first floor of the building will provide a continuous management presence. The building will have security entrances and cameras in the public areas to promote safety and well-being of the residents.

#### **Rezoning:**

We initially thought this development could be handled with a conditional use using the existing UMX zoning. However, in consultation with City staff we concluded that a planned development would work best for the project in the long term, allowing the new development to fit in with the existing context.

#### Site Development Data:

Densities:	
Lot Area	25,352 sf
Acres	.58
Dwelling Units	115 units
Lot Area/D.U.	220 sf/ unit
Density	198 units/acre
Dwelling Unit Mix:	
Efficiency	19
One Bedroom	42
One Bedroom + Den	11
Two Bedroom	24
Three Bedroom	<u>19</u>
Total dwelling Units	115
Building Heights:	11 Stories
<u>Floor Area:</u>	
Gross Floor Area (floors I-II)	
	136,368sf (Excludes Underground parking)
<u>Floor Area Ratio:</u>	5.38
Vehicle Parking Stalls	
Surface	0
Underground	151 (11 Visitor stalls)
Total	151

Letter of Intent –PD 617 Segoe Road Page 4 of 4

Ratio

1.31 stall/unit

Bicycle Parking Stalls	
Surface	8
<u>Underground</u>	<u>107 (107 @ 2'x6')</u>
Total	115

#### **Project Schedule:**

It is currently anticipated that construction will begin once the development approvals are in place in the summer of 2014 and is anticipated to be completed in the Summer of 2015.

Thank you for your time in reviewing our proposal.

Sincerely,

J. Randy Bruce AIA Managing Member

December 31, 2013

Chris Schmidt Alderperson – District #11 City-County Building Common Council Office 210 Martin Luther King Jr. Blvd Madison, Wisconsin 53703



Re: 617 N. Segoe Road KBA Project #1012

Dear Alder Schmidt,

On behalf of Jim Stopple and Knothe & Bruce Architects, I would like to take this opportunity to formally notify you that we plan on submitting our application to the City of Madison for the redevelopment of the site at 617 N. Segoe Road next month.

The development as currently proposed includes a new multi-family apartment building consisting of approximately 115 units.

We look forward to working with you to create a successful development for this site. If you have any questions, please contact me at 608-836-3690 or <u>rbruce@knothebruce.com</u>.

Sincerely, J. Randy Bruce Managing Member

### Jessica Thompson

From: Sent: To: Subject: Schmidt, Chris <district11@cityofmadison.com> Tuesday, February 18, 2014 9:58 AM Jessica Thompson RE: 617 Segoe Road

You mean the 30 day demolition filing notice? Yes, I will waive that. This email should suffice for that purpose.

Thanks, Chria

-----Original Message----- **From:** Jessica Thompson [JThompson@knothebruce.com] **Received:** Tuesday, 18 Feb 2014, 9:17AM **To:** Schmidt, Chris [district11@cityofmadison.com] **Subject:** 617 Segoe Road


Hey Chris, we are submitting this Wednesday for 617 Segoe Road. I have the official alder notification in Word, but not the one Randy signed. Any chance you have a copy, assuming we did send it to you? If not, could you please waive the 30 day notice considering we have been engaged in the process? Thanks, Jess

Jessica Thompson, AIA, CID, LEED AP | Architect | Knothe & Bruce Architects, LLC | Ph: 608.836.3690

7601 University Avenue; Suite 201, Middleton, WI 53562 | jthompson@knothebruce.com

### DEMOLITION PHOTOS

617 Segoe Road Rezoning to PD Madison, WI 53715

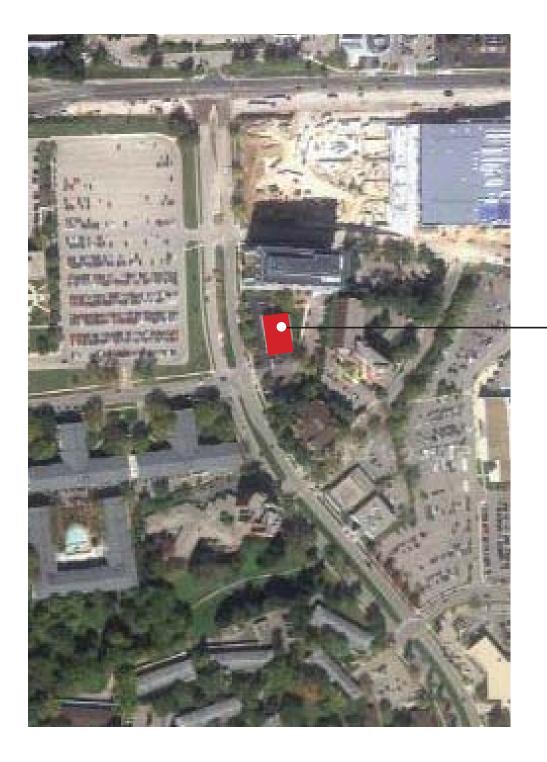

617 Segoe Road





WEST ELEVATION

NORTHWEST ELEVATION





SOUTH ELEVATION

SOUTHEAST ELEVATION





Interior-office

Interior-office





Interior-office

Interior-office

Zoning Text 617 N. Segoe Road KBA 1012 REVISED 3/3/14

Legal Description: See Exhibit A

A. Statement of Purpose: This zoning district is established to allow for the construction of a multifamily housing development with 115 dwelling units.

- B. Permitted Uses: Following are permitted uses:
  - I. Multifamily residential uses as shown on approved plans.
  - 2. Accessory uses including but not limited to:
    - a. Accessory uses directly associated with those permitted uses including parking for residents and guests.
    - b. Temporary buildings for storage of building materials and equipment for construction purposes when on the same lot as a principle use for a period not to exceed the duration of such construction.
- C. Lot Area: As shown on the approved plans.
- D. Height Regulations: As shown on the approved plans.
- E. Yard Regulations: As shown on the approved plans.
- F. Landscaping: Site Landscaping will be provided as shown on the approved plans.

G. Usable Open Space Requirements: Usable open space will be provided as shown on the approved plans.

H. Parking & Loading: Off-street parking and loading shall be provided as shown on the approved plans.

I. Family Definition: The family definition shall coincide with the definition given in M.G.O. for the NMX zoning district.


J. Signage: Signage for the residential building will be allowed as provided by M.G.O. and as further regulated for the NMX zoning district, with signage as approved by the Urban Design Commission and Zoning Administrator.

K. Alterations and Revisions: No alteration or revision of this Planned Unit Development shall be permitted unless approved by the City Planning Commission, however, the Zoning Administrator may issue permits for minor alterations or additions which are approved by the, Director Of Planning and Development and the alderperson of the district and are compatible with the concept approved by the City Planning Commission. Zoning Text 617 N. Segoe Road KBA 1012

### <u>Exhibit A</u>

Legal Description:

LOT 2, CERTIFIED SURVEY MAP NO. 10358, RECORDED IN VOLUME 61 OF CERTIFIED SURVEY MAPS, ON PAGE 74, AS DOCUMENT NO. 3472661, LOCATED IN THE NE 1/4 - NW 1/4 OF SECTION 20, TOWNSHIP 07 NORTH, RANGE 09 EAST, IN THE CITY OF MADISON, DANE COUNTY, WISCONSIN.

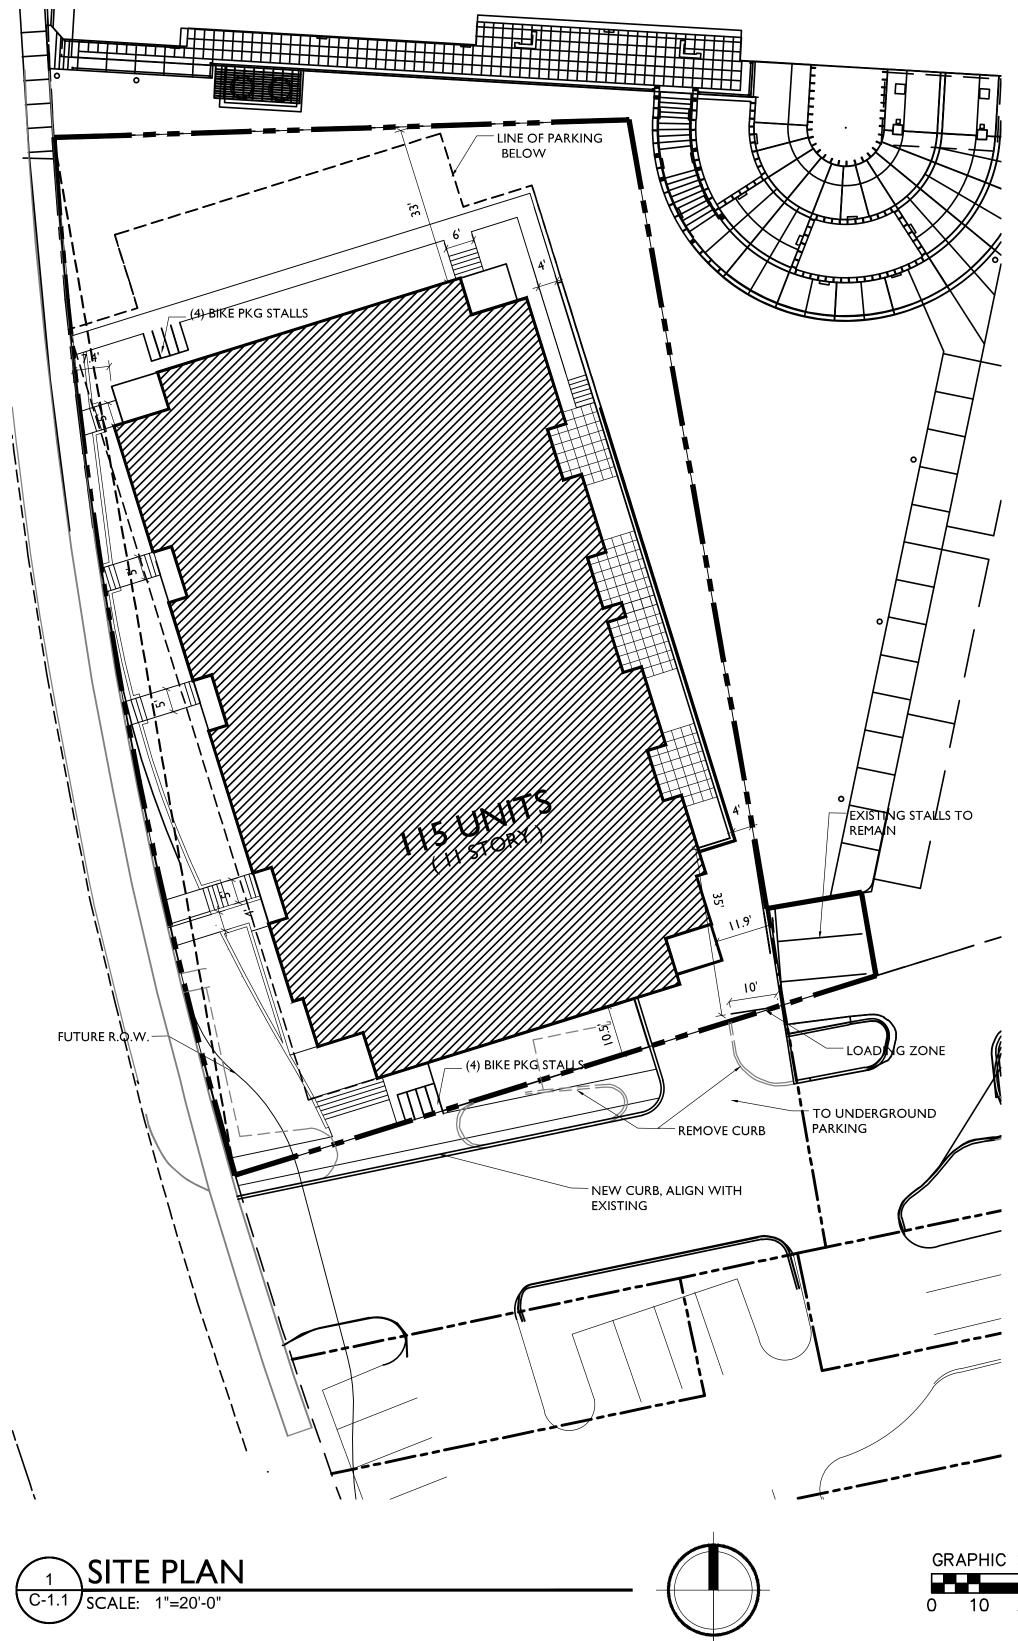

	T
SITE	
C-I.I	SITE PLAN
C-1.0	EXISTING CONDITIONS
C-1.2	SITE PLAN WITH FUTURE R.O.W.
C-1.3	OPEN SPACE
C-2.0	PRELIMINARY GRADING & EROSION CONTROL PLAN
C-3.0	PRELIMINARY UTILITY PLAN
C-4.0	FIRE DEPARTMENT ACCESS PLAN
L-1.0	PLANTING PLAN
L-2.0	PLANTING DETAILS AND NOTES
ARCHITECTURAL	
A-PI.4	PARKING LEVEL 4
A-P1.3	PARKING LEVEL 3
A-P1.2	PARKING LEVEL 2
A-PI.I	PARKING LEVEL I
A-1.1	FIRST FLOOR PLAN
A-1.2	SECOND FLOOR PLAN (THIRD - EIGHTH SIM)
A-1.3	
A-1.4	TENTH FLOOR PLAN (ELEVENTH SIM)
A-1.5	PENTHOUSE PLAN
A-2.1	SEGOE ROAD ELEVATION
A-2.2	SOUTH ELEVATION
A-2.3	EAST ELEVATION
A-2.4	NORTH ELEVATION

CONSULTANT

REVISIONS REZONING APPLICATION -FEBRUARY 19 2014 REVISED REZONING APPLICATION -APRIL 11, 2014


SITE DEVELOPMEN	NT STATISTICS
LOT AREA	25,352 S.F./.58 ACRES
DWELLING UNITS	115 D.U.
LOT AREA/ D.U.	220 S.F./D.U.
DENSITY	198 UNITS/ACRE
BUILDING HEIGHT	I I STORIES
GROSS FLOOR AREA	136,368 S.F.
(excluding underground	d parking)
FLOOR AREA RATIO	5.38
UNIT MIX	
EFFICIENCY	19
ONE BEDROOM	42
ONE BEDROOM + D	DEN II
TWO BEDROOM	24
THREE BEDROOM	19
TOTAL	115
VEHICLE PARKING	
SURFACE	0
UNDERGROUND	151 (11 Visitor)
TOTAL	151
BIKE PARKING	
FLOOR STALL, SURF	ACE 8
FLOOR STALL, UND	ERGROUND 107
TOTAL	115


GRAPHIC SCALE FEET 0 10 20 40 PROJECT TITLE
617 SEGOE RD

Madison, WI SHEET TITLE Site Plan

SHEET NUMBER

C-I.I

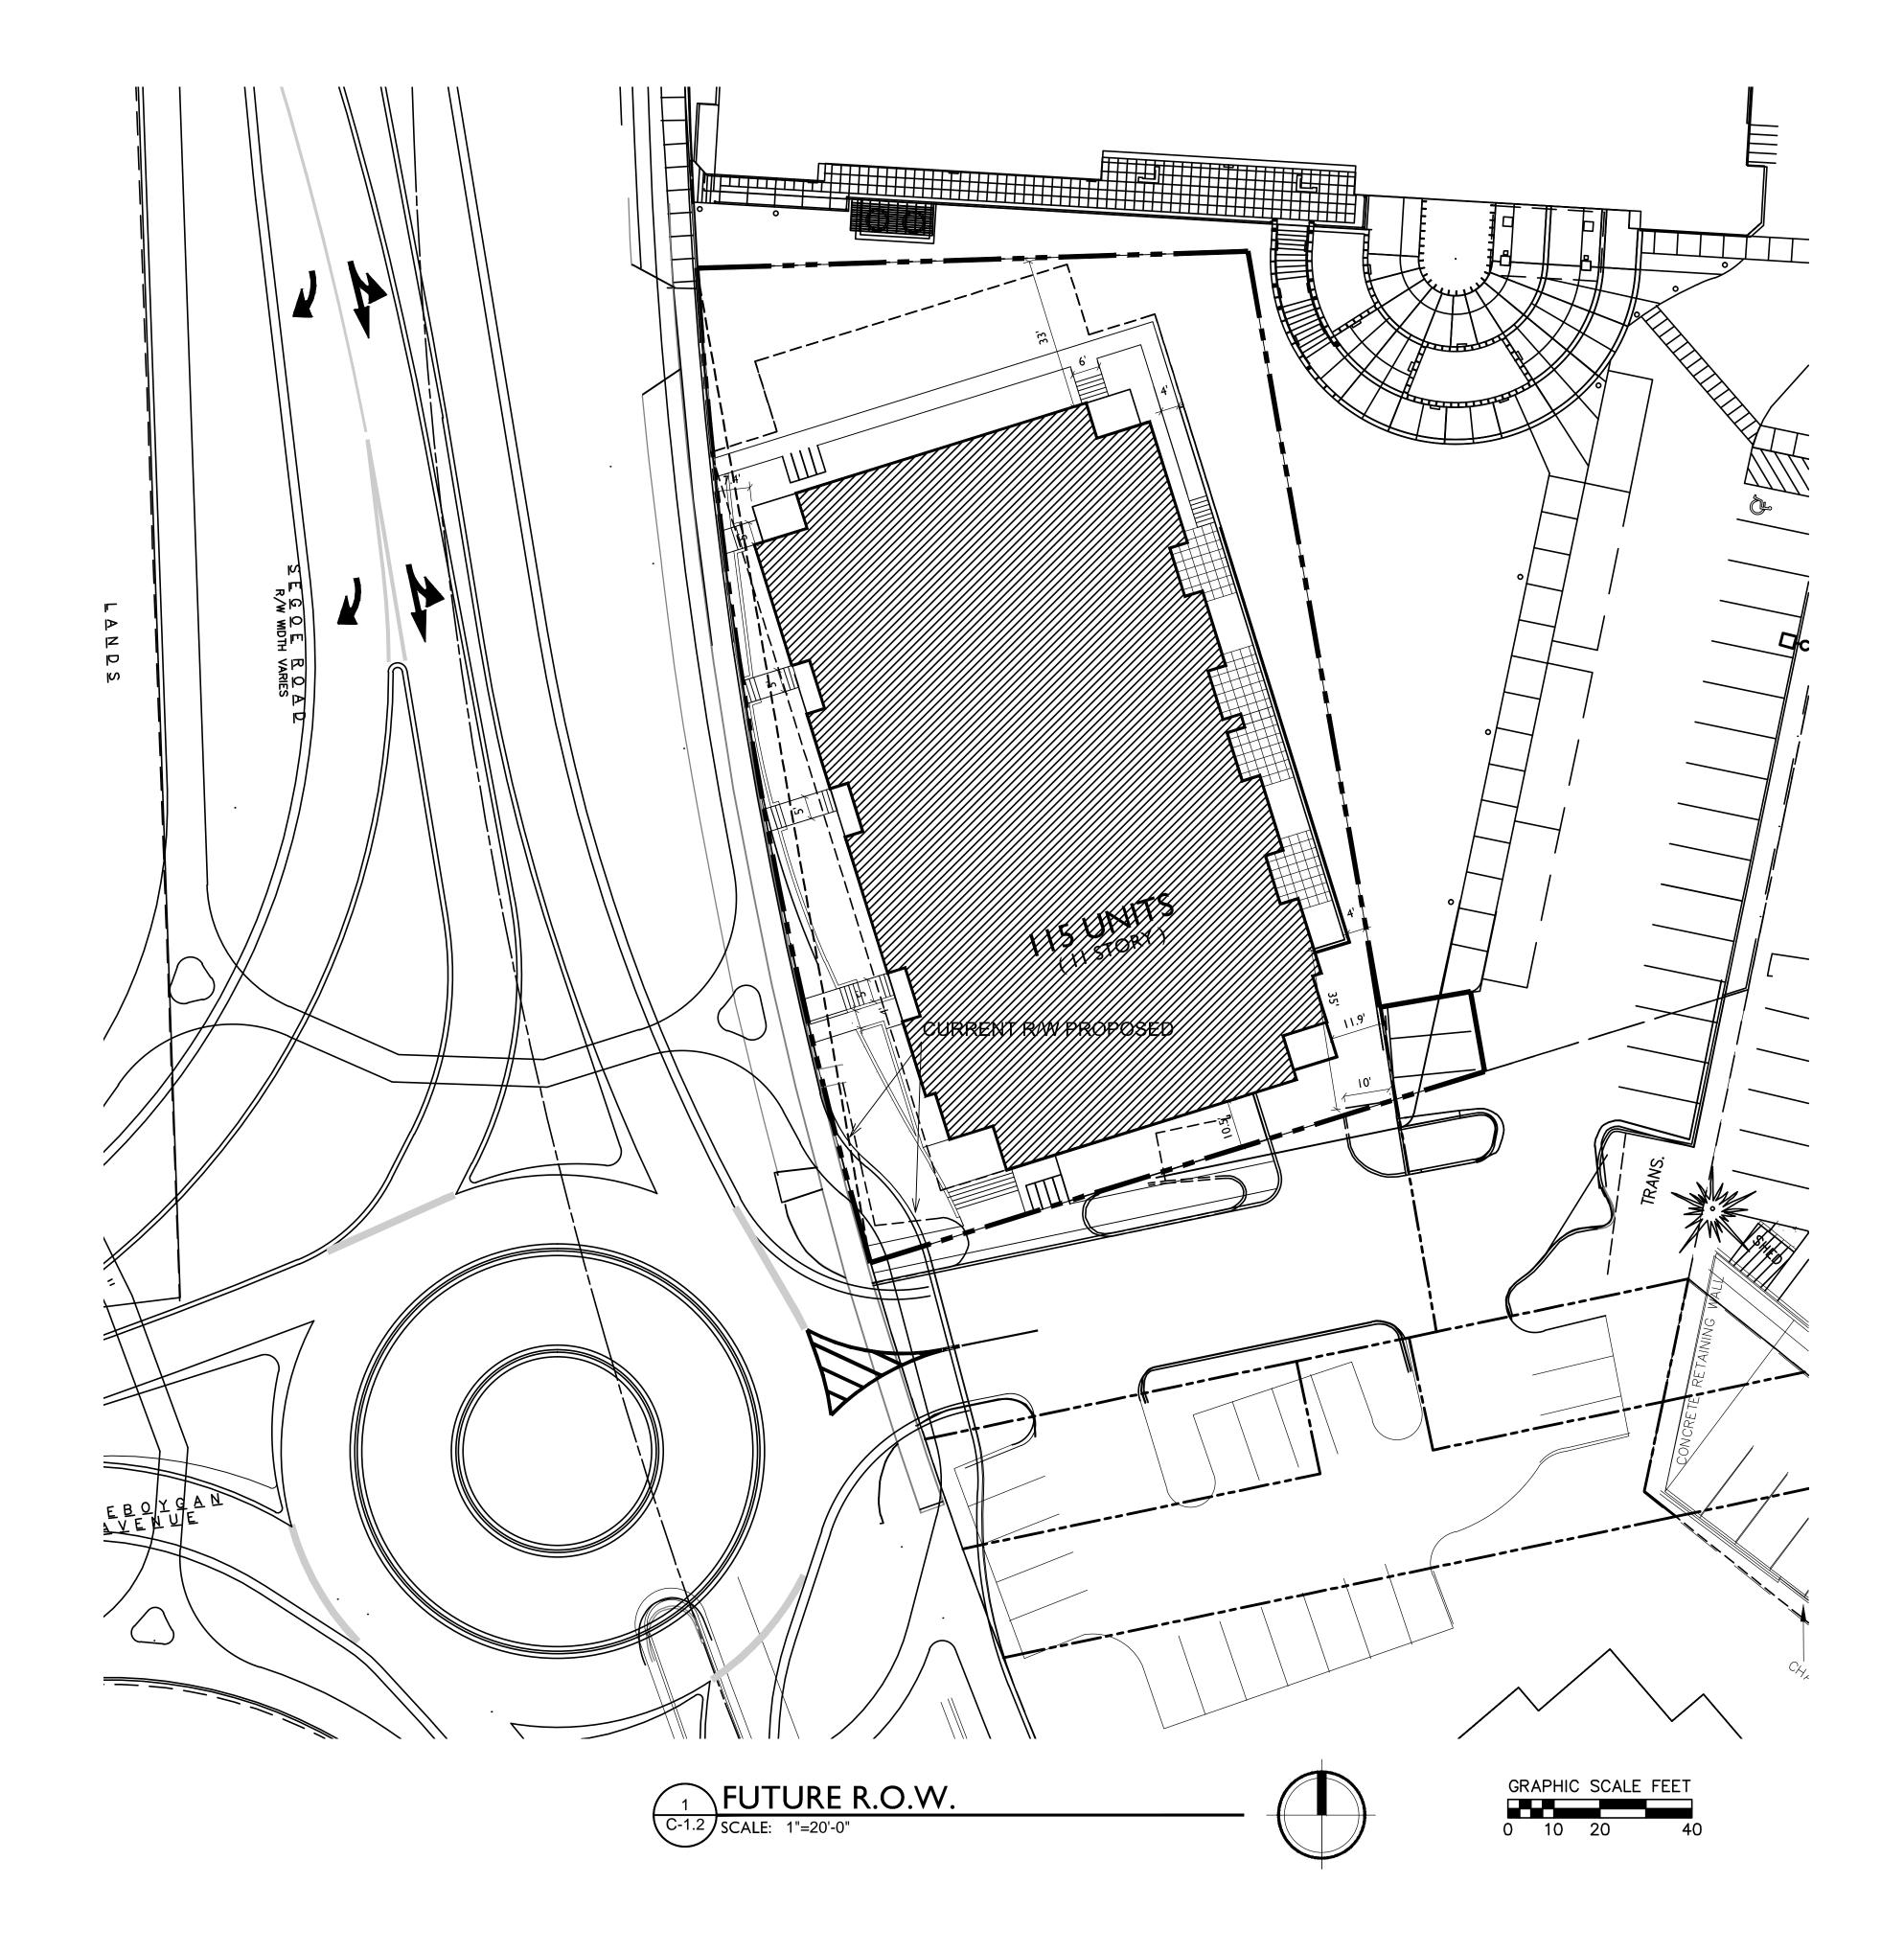

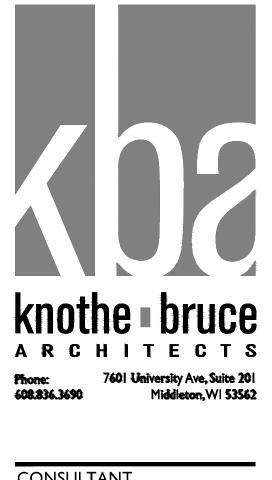

CONSULTANT


REVISIONS REZONING APPLICATION -FEBRUARY 19 2014 REVISED REZONING APPLICATION - APRIL 11, 2014


### PROJECT TITLE 617 SEGOE RD

Madison, WI SHEET TITLE Site Plan with Future R.O.W.

SHEET NUMBER

C-1.2

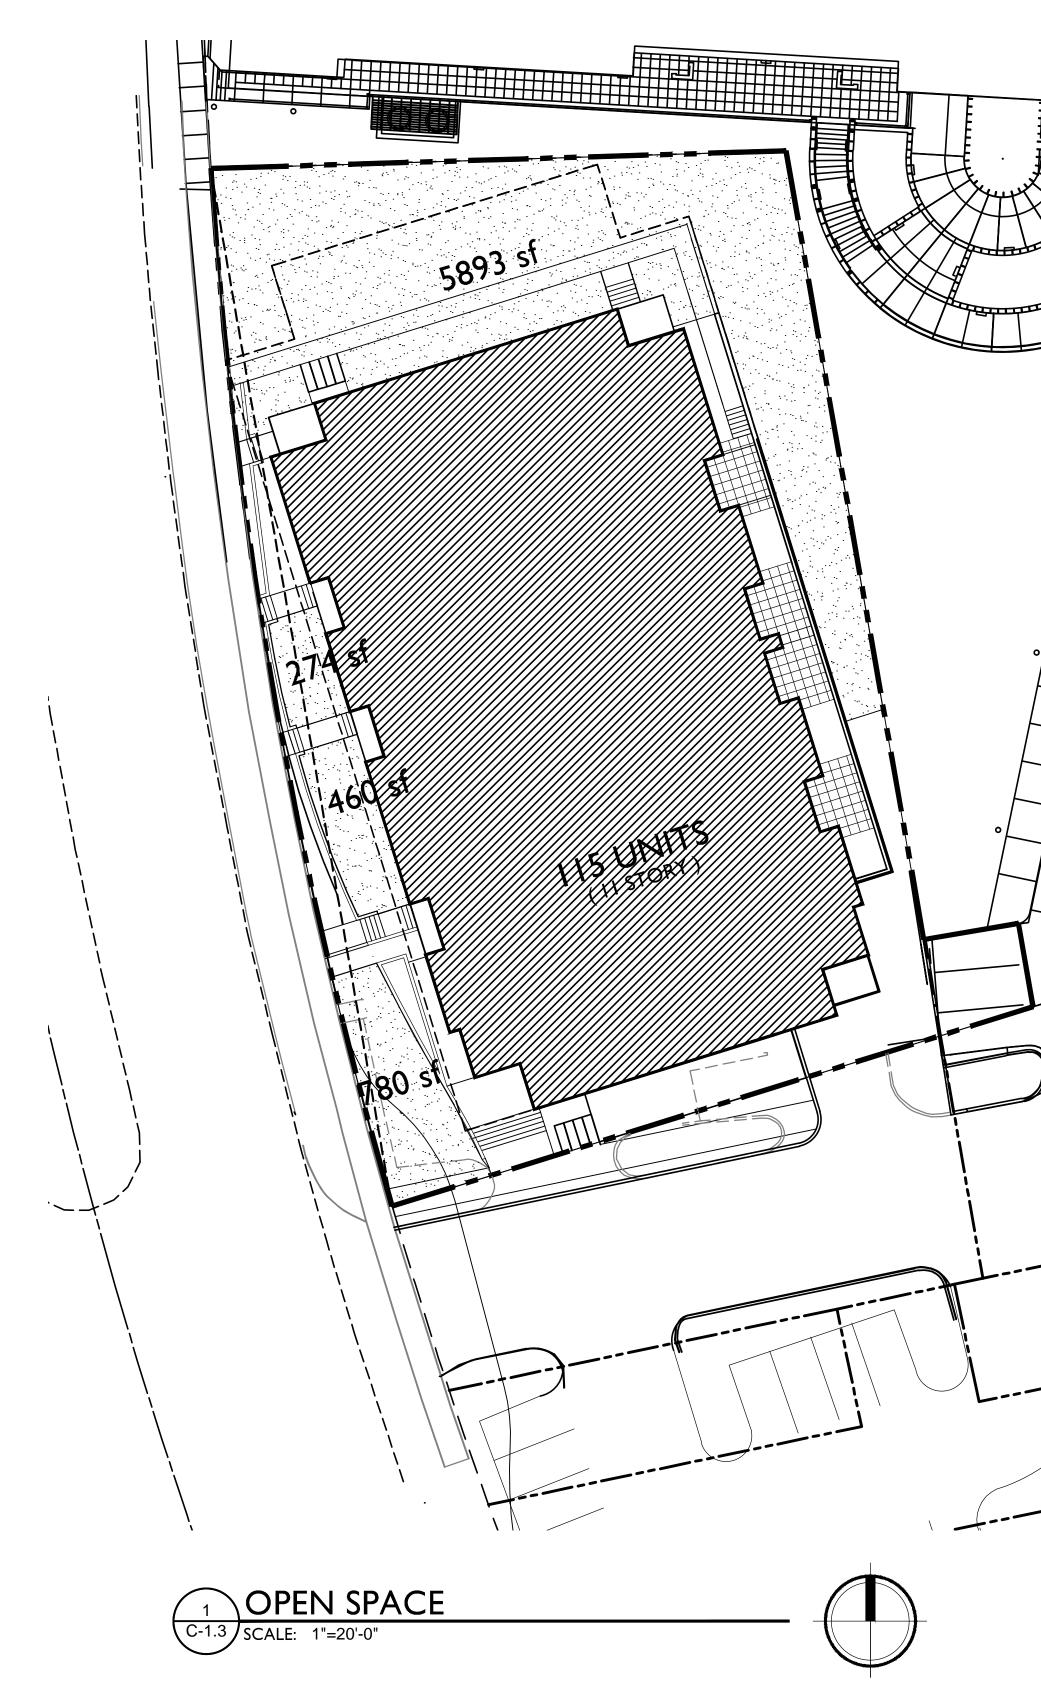

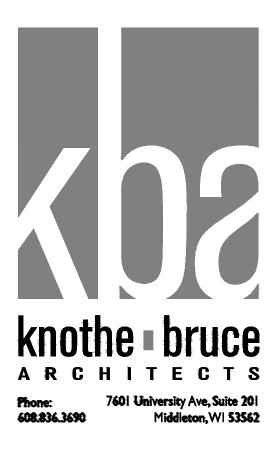

CONSULTANT

# USABLE OPEN SPACE

SITE =	7,407 SF
PENTHOUSE DECK=	2,451 SF
BALCONIES =	7,572 SF
TOTAL =	17,430 SF

REVISIONS

REZONING APPLICATION -FEBRUARY 19 2014 REVISED REZONING APPLICATION - APRIL 11, 2014


PROJECT TITLE 617 SEGOE RD

### Madison, WI SHEET TITLE OPEN SPACE


SHEET NUMBER


C-1.3




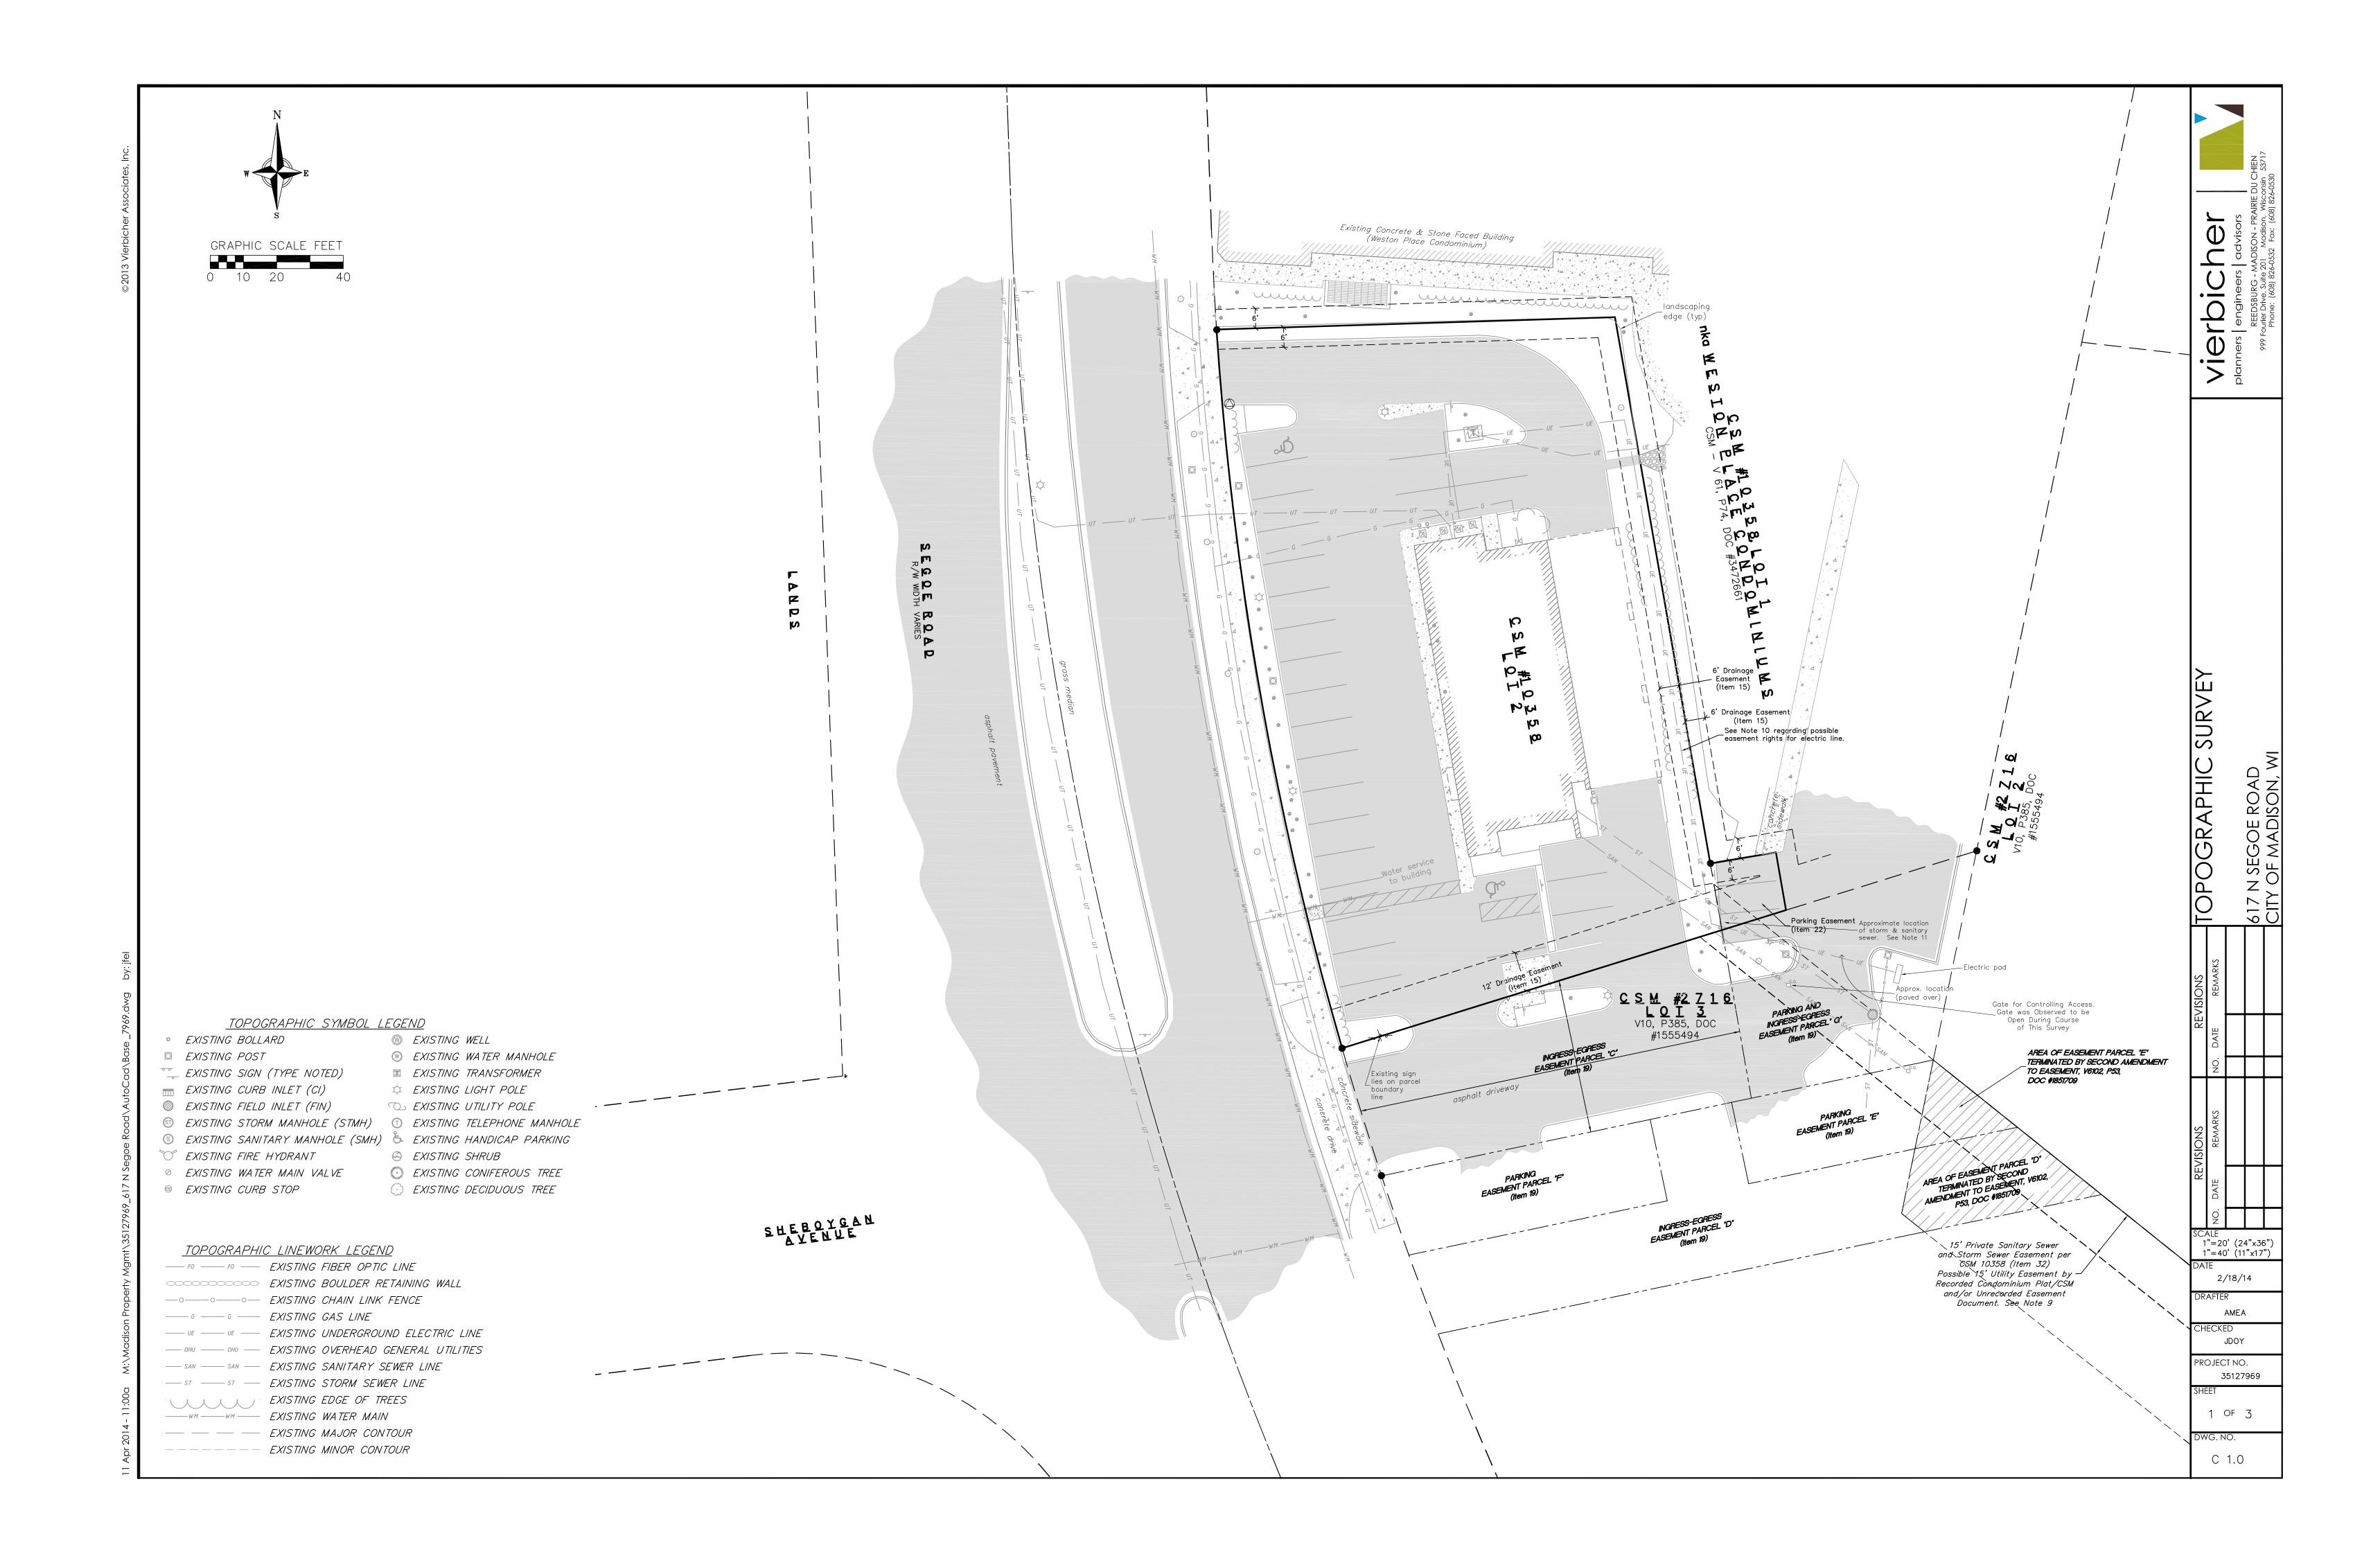


©2013 Vierbicher Associates, Inc.	C853.55PROPOSED SPOT ELEVATIONSC - TOP OF CURB FF - FINISHED FLOOR W - TOP OF WALK P - EDGE OF PAVEMENT R - RISERS	N
ier Asso	GENERAL NOTES:	W E
3 Vierbich	<ol> <li>CONTOURS ARE SHOWN FOR PURPOSES OF INDICATING ROUGH GRADING. FINAL GRADE SHALL BE ESTABLISHED ON PAVED SURFACES BY USING SPOT GRADES ONLY.</li> </ol>	V S
©20	2. ALL ABANDONED DRIVEWAYS ADJACENT TO THE SITE SHALL BE REPLACED WITH CURB AND THE TERRACE SHALL BE RESTORED WITH GRASS.	GRAPHIC SCALE FEET
	<ol> <li>CONTRACTOR SHALL OBTAIN ANY NECESSARY DRIVEWAY CONNECTION, WORK IN RIGHT-OF-WAY AND EXCAVATION PERMITS PRIOR TO CONSTRUCTION.</li> </ol>	0 10 20 40
	4. ANY SIDEWALK AND CURB & GUTTER ABUTTING THE PROPERTY SHALL BE REPLACED IF IT IS DAMAGED DURING CONSTRUCTION OR IF THE CITY ENGINEERING DEPARTMENT DETERMINES THAT IT IS NOT AT A DESIRABLE GRADE, REGARDLESS OF WHETHER THE CONDITION EXISTED PRIOR TO BEGINNING CONSTRUCTION.	EXISTING PAVEMENT PROPOSED PAVEME
	SEEDING RATES:	EXISTING PAVEMEN
	<u>TEMPORARY</u> : 1. USE ANNUAL OATS AT 3.0 LB./1,000 S.F. FOR SPRING AND SUMMER PLANTINGS. 2. USE WINTER WHEAT OR RYE AT 3.0 LB./1,000 SF FOR FALL PLANTINGS STARTED AFTER SEPTEMBER 15.	PROPOSED PAVEME
	<u>PERMANENT:</u> 1. USE WISCONSIN D.O.T. SEED MIX #40 AT 2 LB./1,000 S.F.	
	FERTILIZING RATES:	
	<u>temporary and permanent</u> : USE WISCONSIN D.O.T. TYPE A OR B AT 7 LB./1,000 S.F.	
	MULCHING RATES:	
	TEMPORARY AND PERMANENT: USE ½" TO 1-½" STRAW OR HAY MULCH, CRIMPED PER SECTION 607.3.2.3, OR OTHER RATE AND METHOD PER SECTION 627, WISCONSIN D.O.T. STANDARD SPECIFICATIONS FOR HIGHWAY AND STRUCTURE CONSTRUCTION	
	EROSION CONTROL MEASURES 1. EROSION CONTROL SHALL BE IN ACCORDANCE WITH THE CITY OF	
	MADISON EROSION CONTROL ORDINANCE AND CHAPTER NR 216 OF THE WISCONSIN ADMINISTRATIVE CODE.	
by: jfel	<ol> <li>CONSTRUCT AND MAINTAIN ALL EROSION AND SEDIMENT CONTROL MEASURES IN ACCORDANCE WITH WISCONSIN DNR TECHNICAL STANDARDS (http://dnr.wi.gov/runoff/stormwater/techstds.htm) AND WISCONSIN CONSTRUCTION SITE BEST MANAGEMENT PRACTICE HANDBOOK.</li> </ol>	
_7969.dwg	<ol> <li>INSTALL SEDIMENT CONTROL PRACTICES (TRACKING PAD, PERIMETER SILT FENCE, ETC.) PRIOR TO INITIATING OTHER LAND DISTURBING CONSTRUCTION ACTIVITIES.</li> </ol>	
	4. THE CONTRACTOR IS REQUIRED TO MAKE EROSION CONTROL INSPECTIONS AT THE END OF EACH WEEK AND WHEN 0.5 INCHES OF RAIN FALLS WITHIN 24 HOURS. INSPECTION REPORTS SHALL BE	
toCad/	PREPARED AND FILED AS REQUIRED BY THE DNR AND/OR CITY. ALL MAINTENANCE WILL FOLLOW AN INSPECTION WITHIN 24 HOURS.	9. INLET FILTERS ARE TO BE PLACED STRUCTURES AS SOON AS THEY ARE
Road\AutoCad\Base	5. EROSION CONTROL IS THE RESPONSIBILITY OF THE CONTRACTOR UNTIL ACCEPTANCE OF THIS PROJECT. EROSION CONTROL MEASURES AS SHOWN SHALL BE THE MINIMUM PRECAUTIONS THAT WILL BE	AREA STORM INLETS NEED WISCONSI PROTECTION. THE FILTERS SHALL B CITY HAS ACCEPTED THE BINDER CO
Segoe	ALLOWED. ADDITIONAL EROSION CONTROL MEASURES, AS REQUESTED IN WRITING BY THE STATE OR LOCAL INSPECTORS, OR THE DEVELOPER'S ENGINEER, SHALL BE INSTALLED WITHIN 24 HOURS.	10. RESTORATION (SEED, FERTILIZE AND SPECIFICATIONS ON THIS SHEET UNLI IS CALLED FOR ON THE LANDSCAPE
969_617 N :	6. A 3" CLEAR STONE TRACKING PAD SHALL BE INSTALLED TO PREVENT SEDIMENT FROM BEING TRACKED ONTO THE ADJACENT	11. ALL AREAS WHICH ARE NOT PAVED OF 4" TOPSOIL PRIOR TO SEEDING.
Property Mgmt\35127969	PAVED PUBLIC ROADWAY. SEDIMENT TRACKING PAD SHALL CONFORM TO WISDNR TECHNICAL STANDARD 1057. SEDIMENT REACHING THE PUBLIC ROAD SHALL BE REMOVED BY STREET CLEANING (NOT HYDRAULIC FLUSHING) BEFORE THE END OF EACH WORK DAY.	12. SEED, FERTILIZER AND MULCH SHALL DAYS AFTER FINAL GRADE HAS BEEN
erty Mgn	<ul> <li>7. <u>SITE DE-WATERING:</u> WATER PUMPED FROM THE SITE SHALL BE TREATED BY TEMPORARY SEDIMENTATION BASINS OR OTHER</li> </ul>	DISTURBED AREAS WILL NOT BE RES Rough grading, temporary seed
	APPROPRIATE CONTROL MEASURES. SEDIMENTATION BASINS SHALL HAVE A DEPTH OF AT LEAST 3 FEET, BE SURROUNDED BY SNOWFENCE OR EQUIVALENT BARRIER AND HAVE SUFFICIENT	13. FOR THE FIRST SIX WEEKS AFTER RE MULCH, SOD) OF A DISTURBED AREA WATERING PROVISIONS OF ALL NEWL' AREAS WHENEVER 7 DAYS ELAPSE V
M:\Madison	SURFACE AREA TO PROVIDE A SURFACE SETTLING RATE OF NO MORE THAN 750 GALLONS PER SQUARE FOOT PER DAY AT THE HIGHEST DEWATERING PUMPING RATE. WATER MAY NOT BE DISCHARGED IN A	14. SILT FENCE TO BE USED ACROSS AF SLOPE TOWARDS A PUBLIC STREET (
	MANNER THAT CAUSES EROSION OF THE SITE, A NEIGHBORING SITE, OR THE BED OR BANKS OF THE RECEIVING WATER. POLYMERS MAY BE USED AS DIRECTED BY DNR TECHNICAL STANDARD 1061	15. SEDIMENT SHALL BE CLEANED FROM
Apr 2014 - 10:59a	(DE-WATERING). PUMPING OF WATER FROM FOUNDATION AREA DURING CONSTRUCTION SHALL NOT EXCEED A RATE OF 70 GALLONS PER MINUTE. SUMP PUMP SHALL BE PLACED ON A CLEAR STONE BEDDING AND A CLOTH/MESH SOCK SHALL BE PLACED ON THE OUTLET END OF THE PIPE TO CONTROL SEDIMENT LOSS.	EACH RAINFALL AND PRIOR TO PROU 16. THE CITY OF MADISON, OWNER AND/ ADDITIONAL EROSION CONTROL MEAS CONSTRUCTION.
11 Aµ	UUILLI LIND OF THE FIFE TO CONTROL SEDIMENT LUSS.	

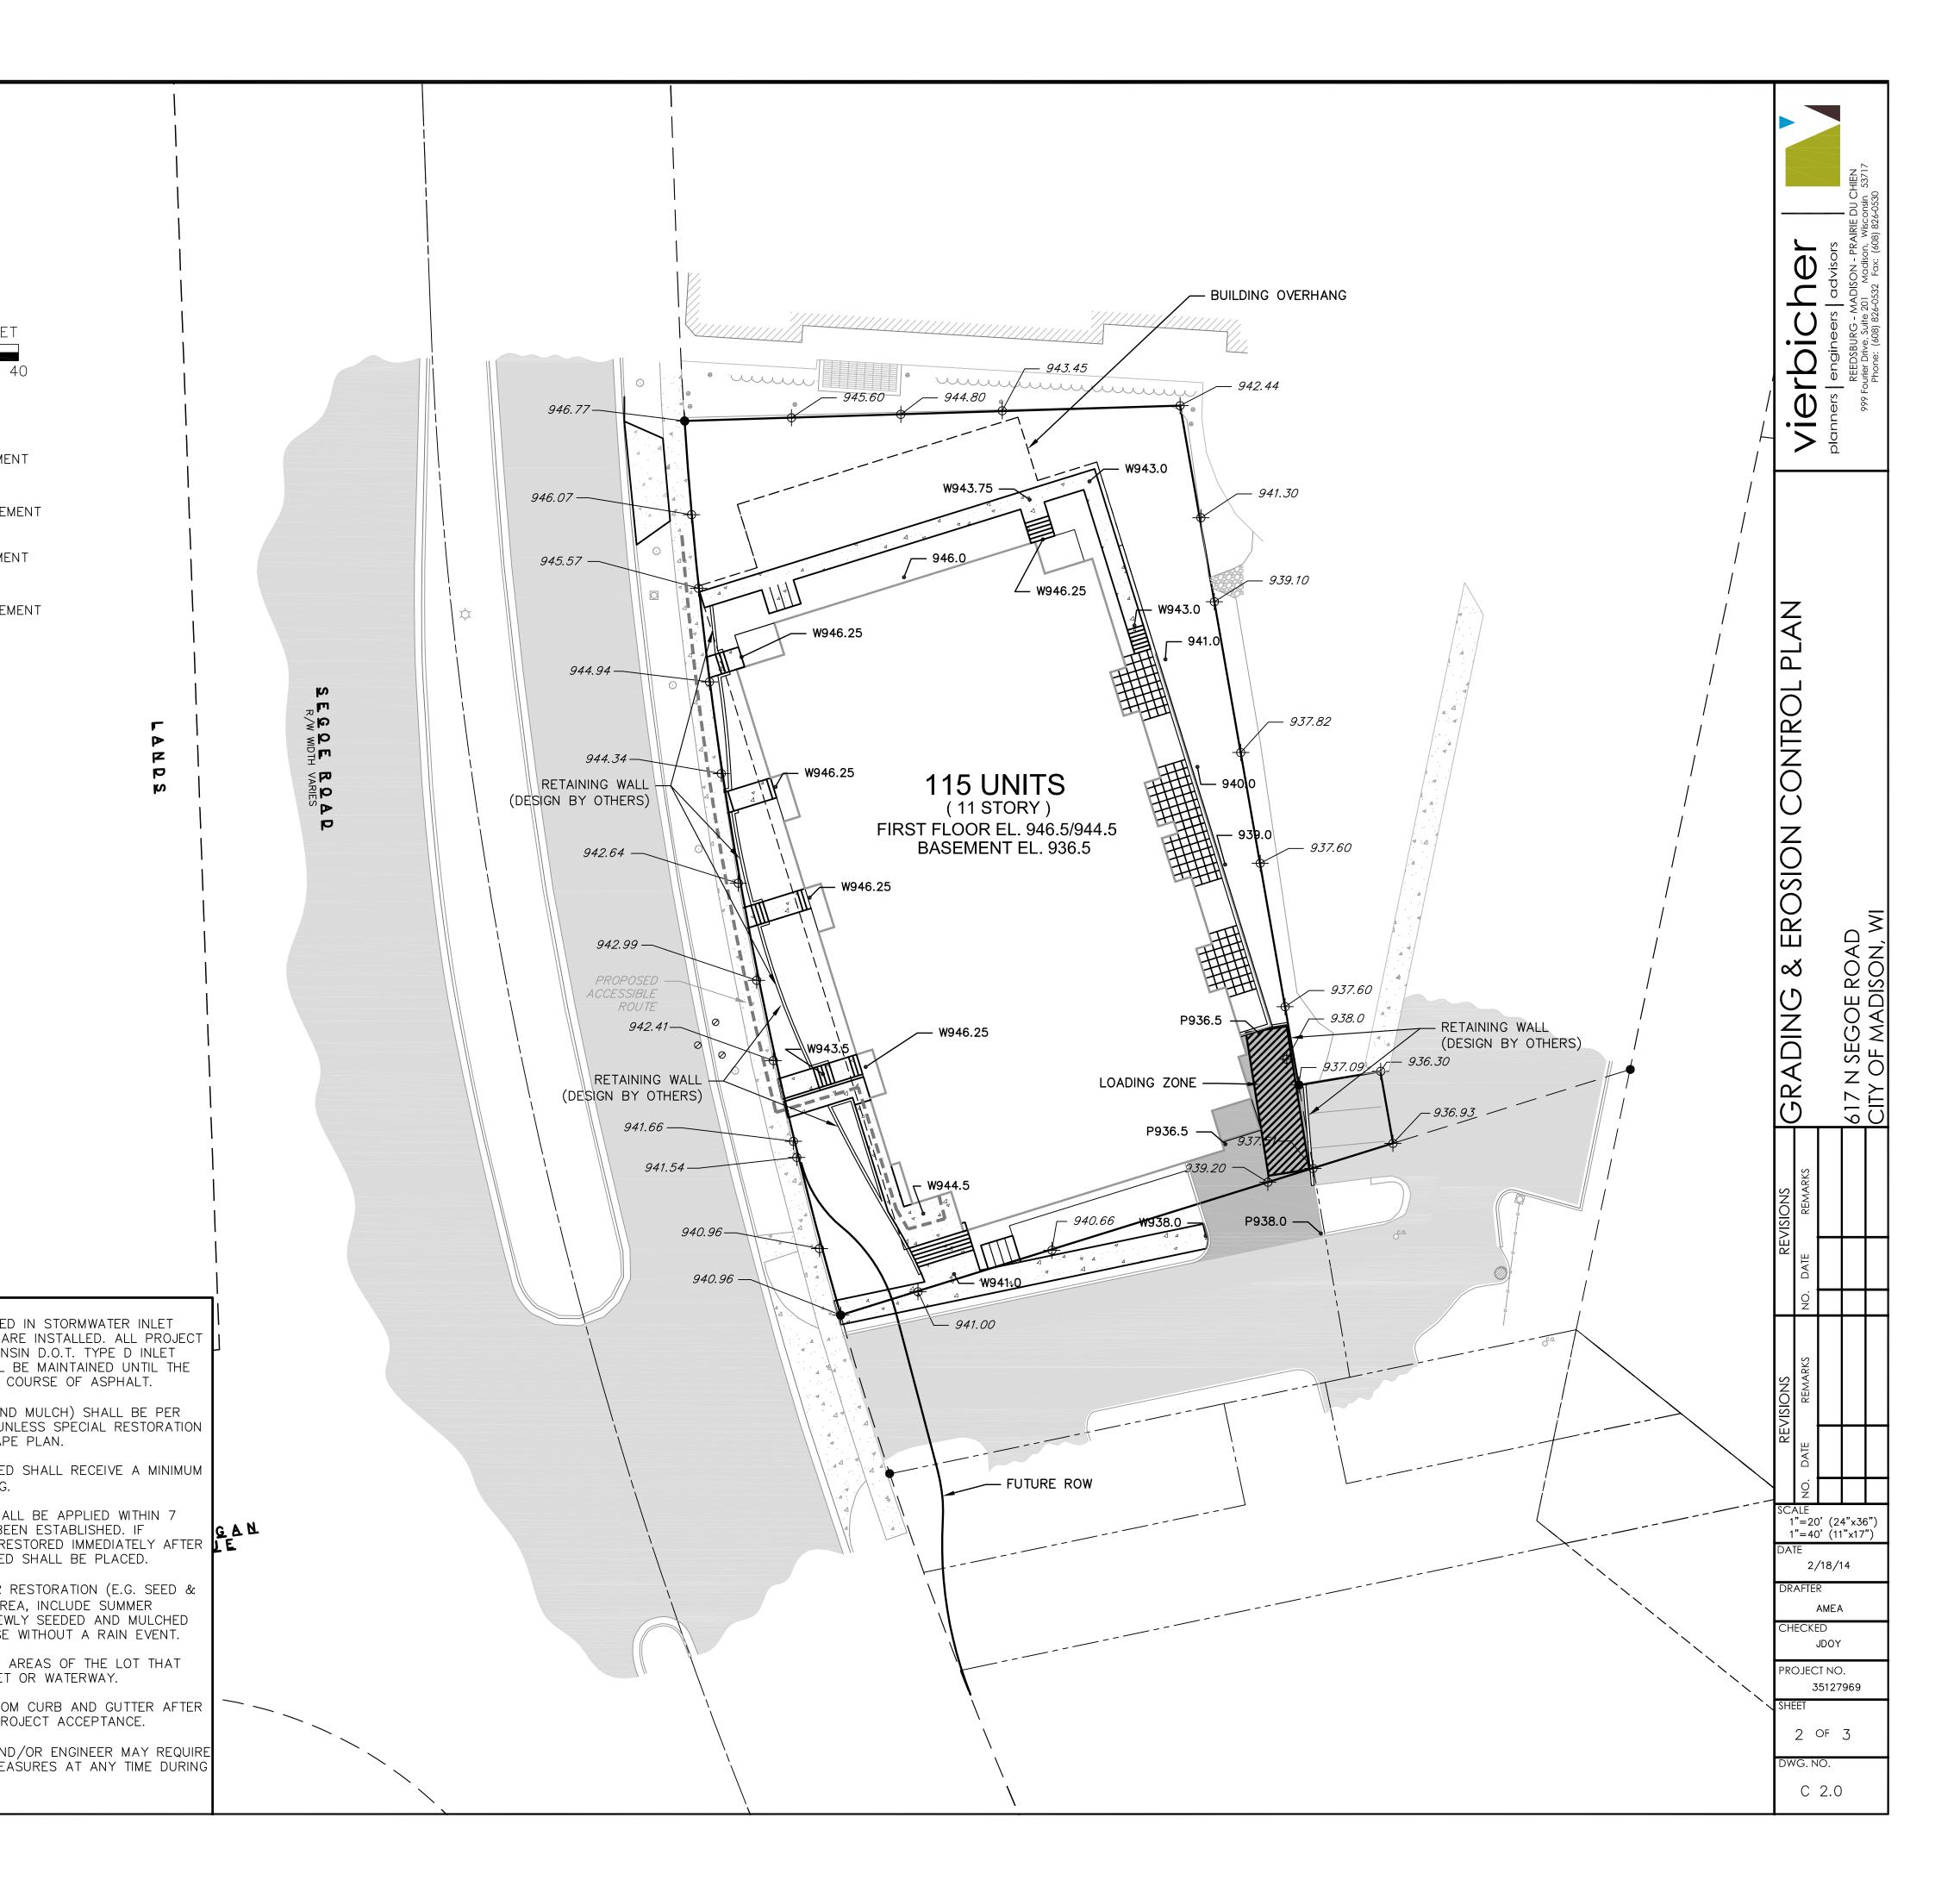

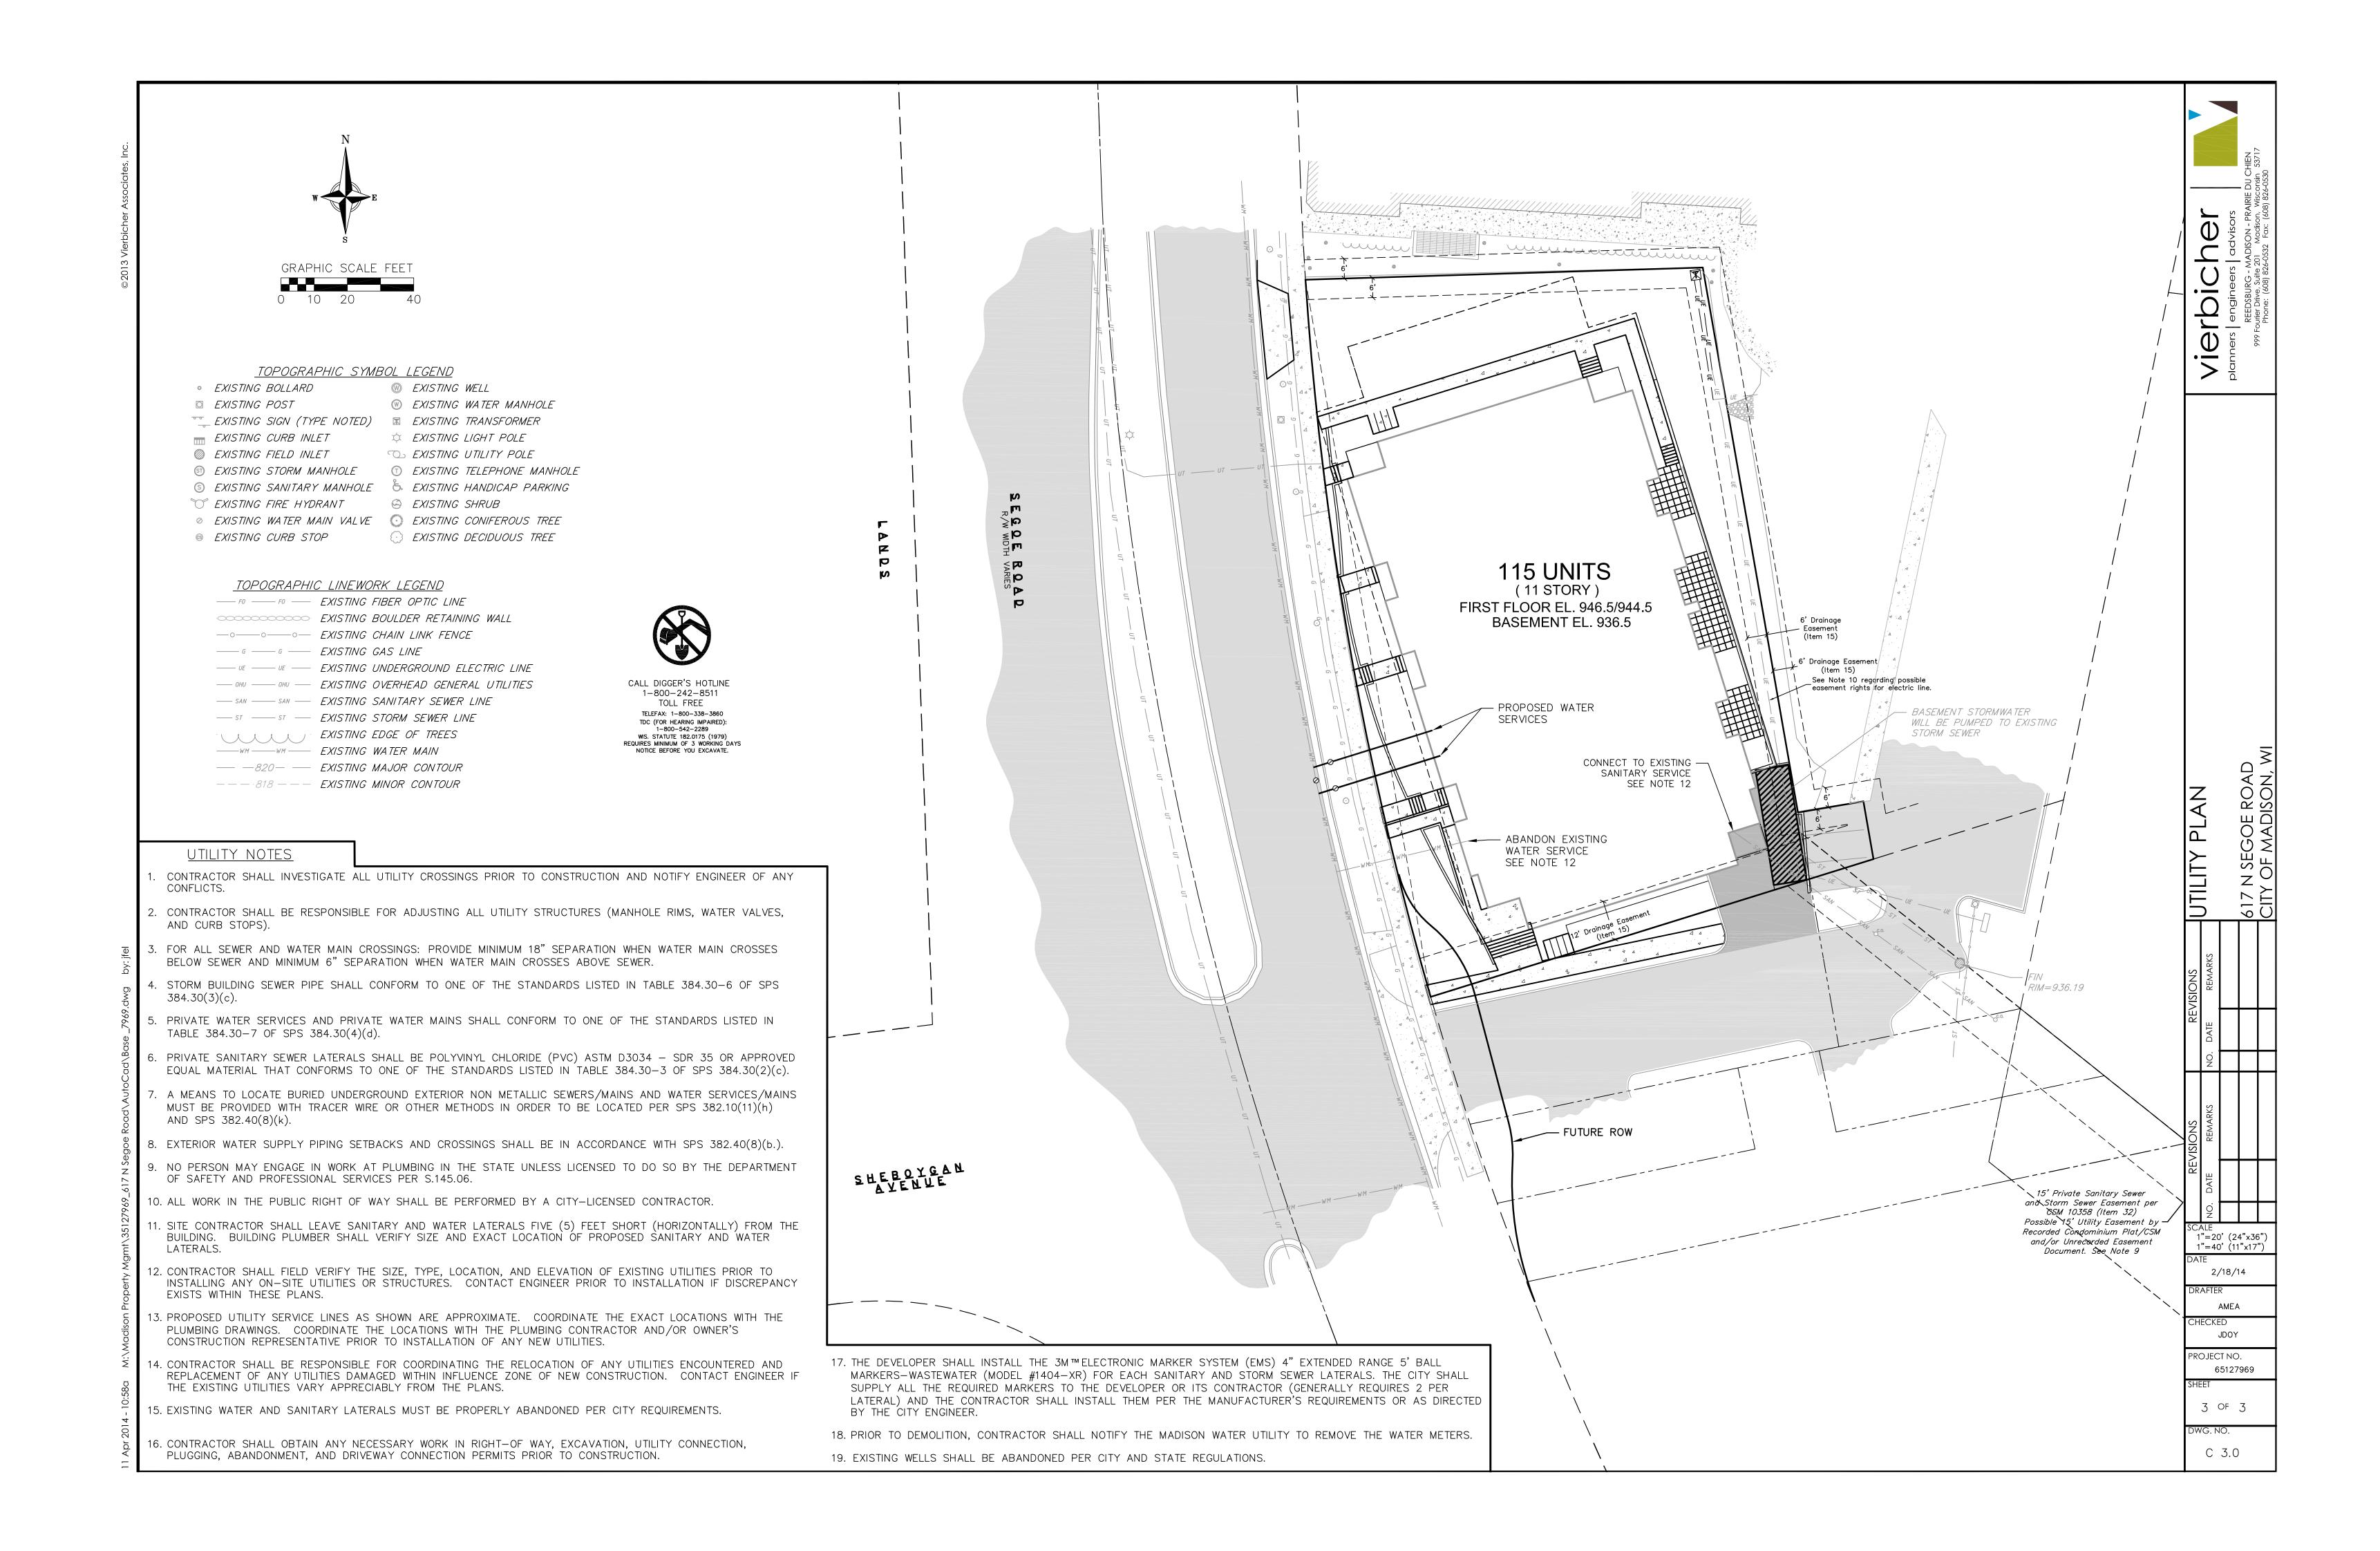

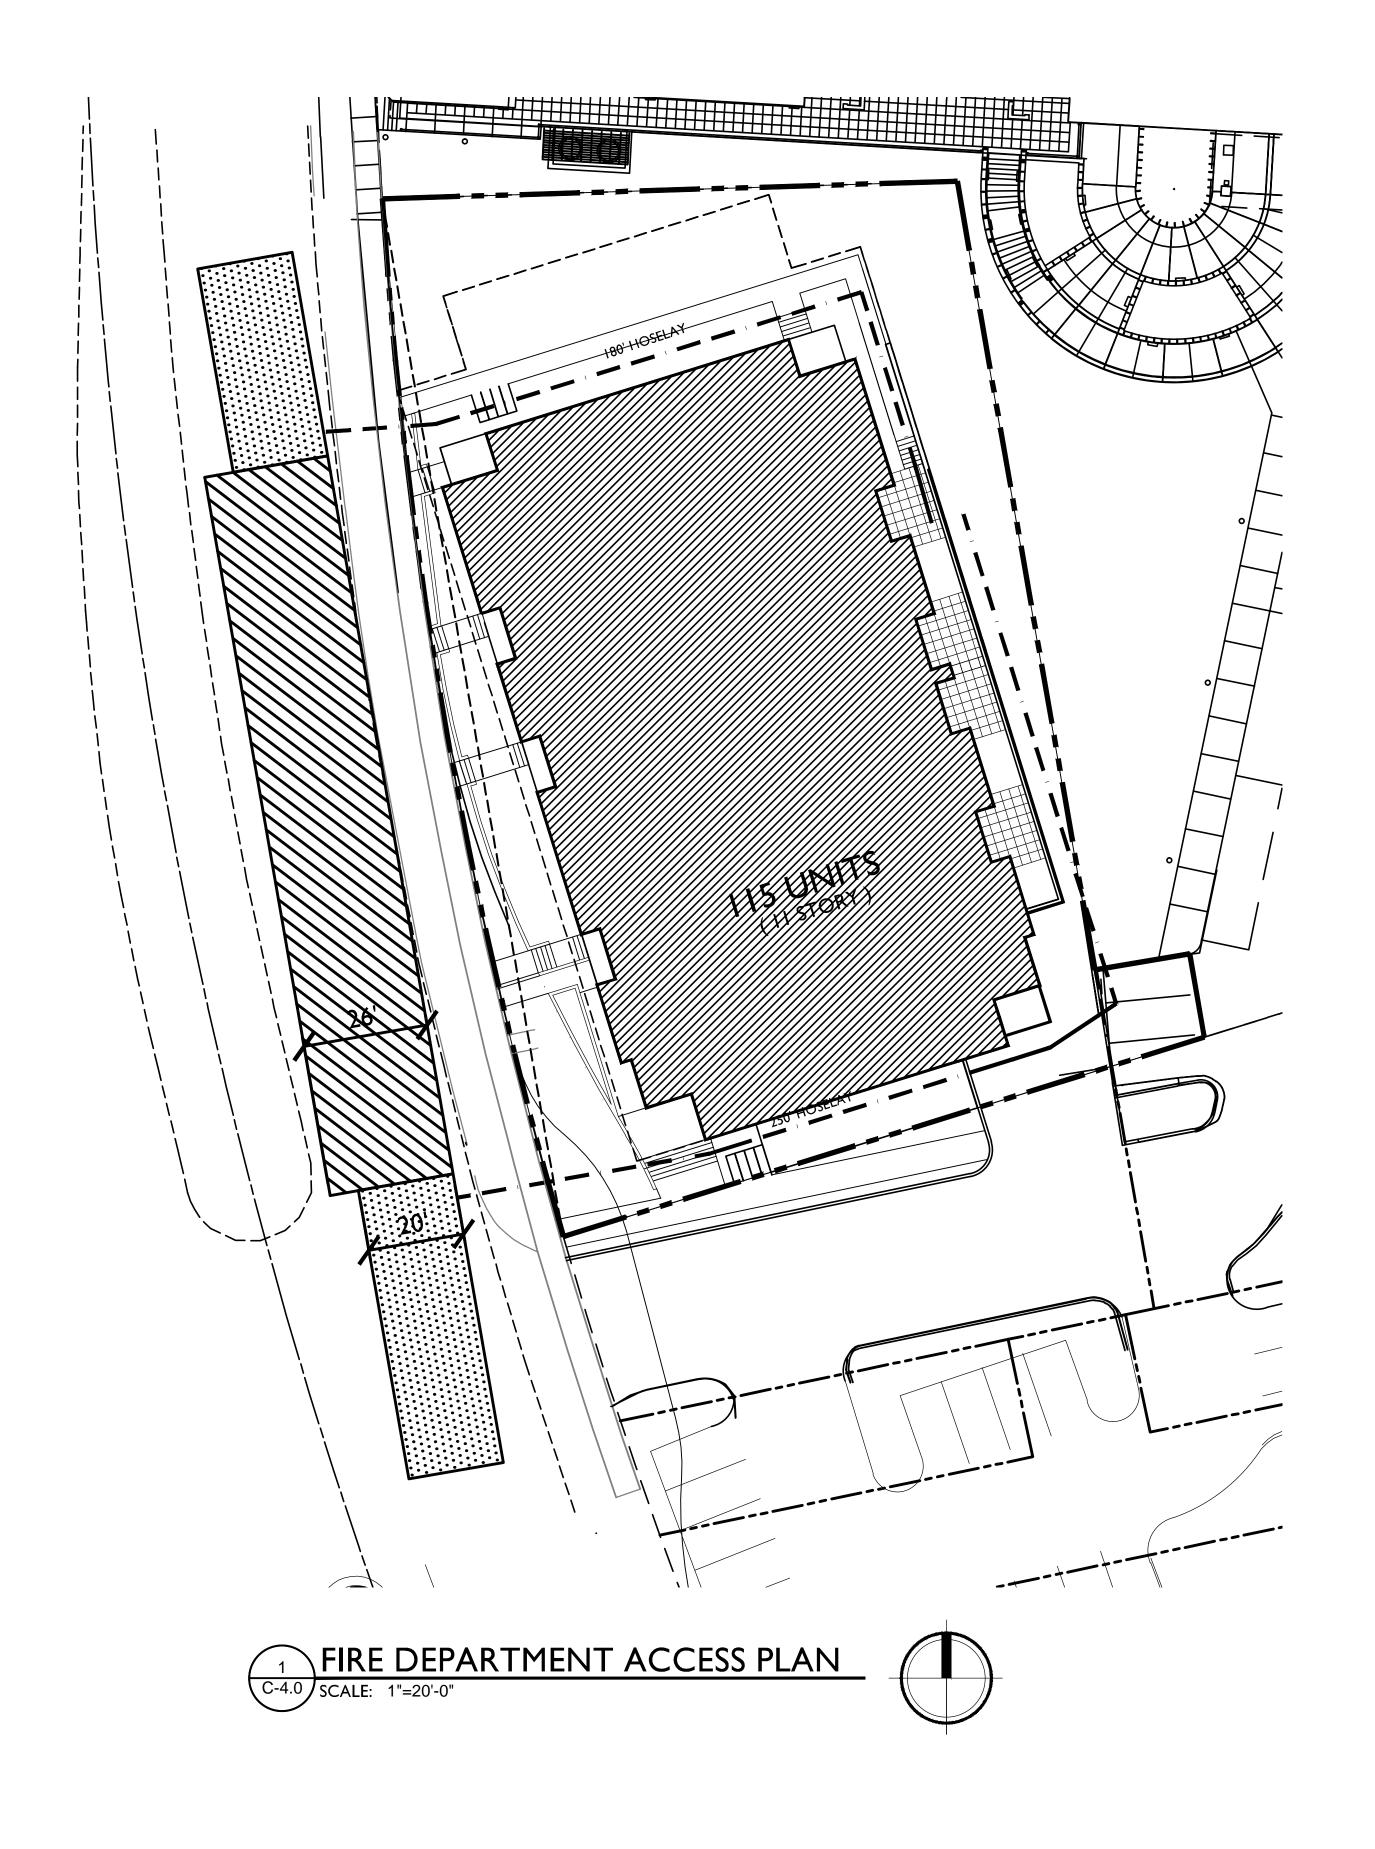

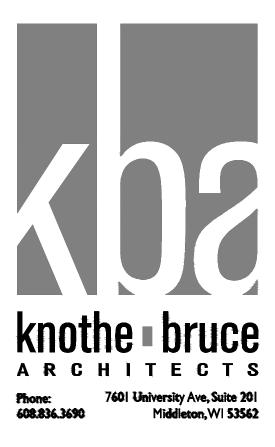

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REVISIONS REZONING APPLICATION -FEBRUARY 19 2014 REVISED REZONING APPLICATION -APRIL 11, 2014


PROJECT TITLE
617 SEGOE RD

MADISON, WI SHEET TITLE FIRE DEPARTMENT ACCESS PLAN

SHEET NUMBER

C-4.0

PROJECT NO. **IOI2** © 2013 Knothe & Bruce Architects

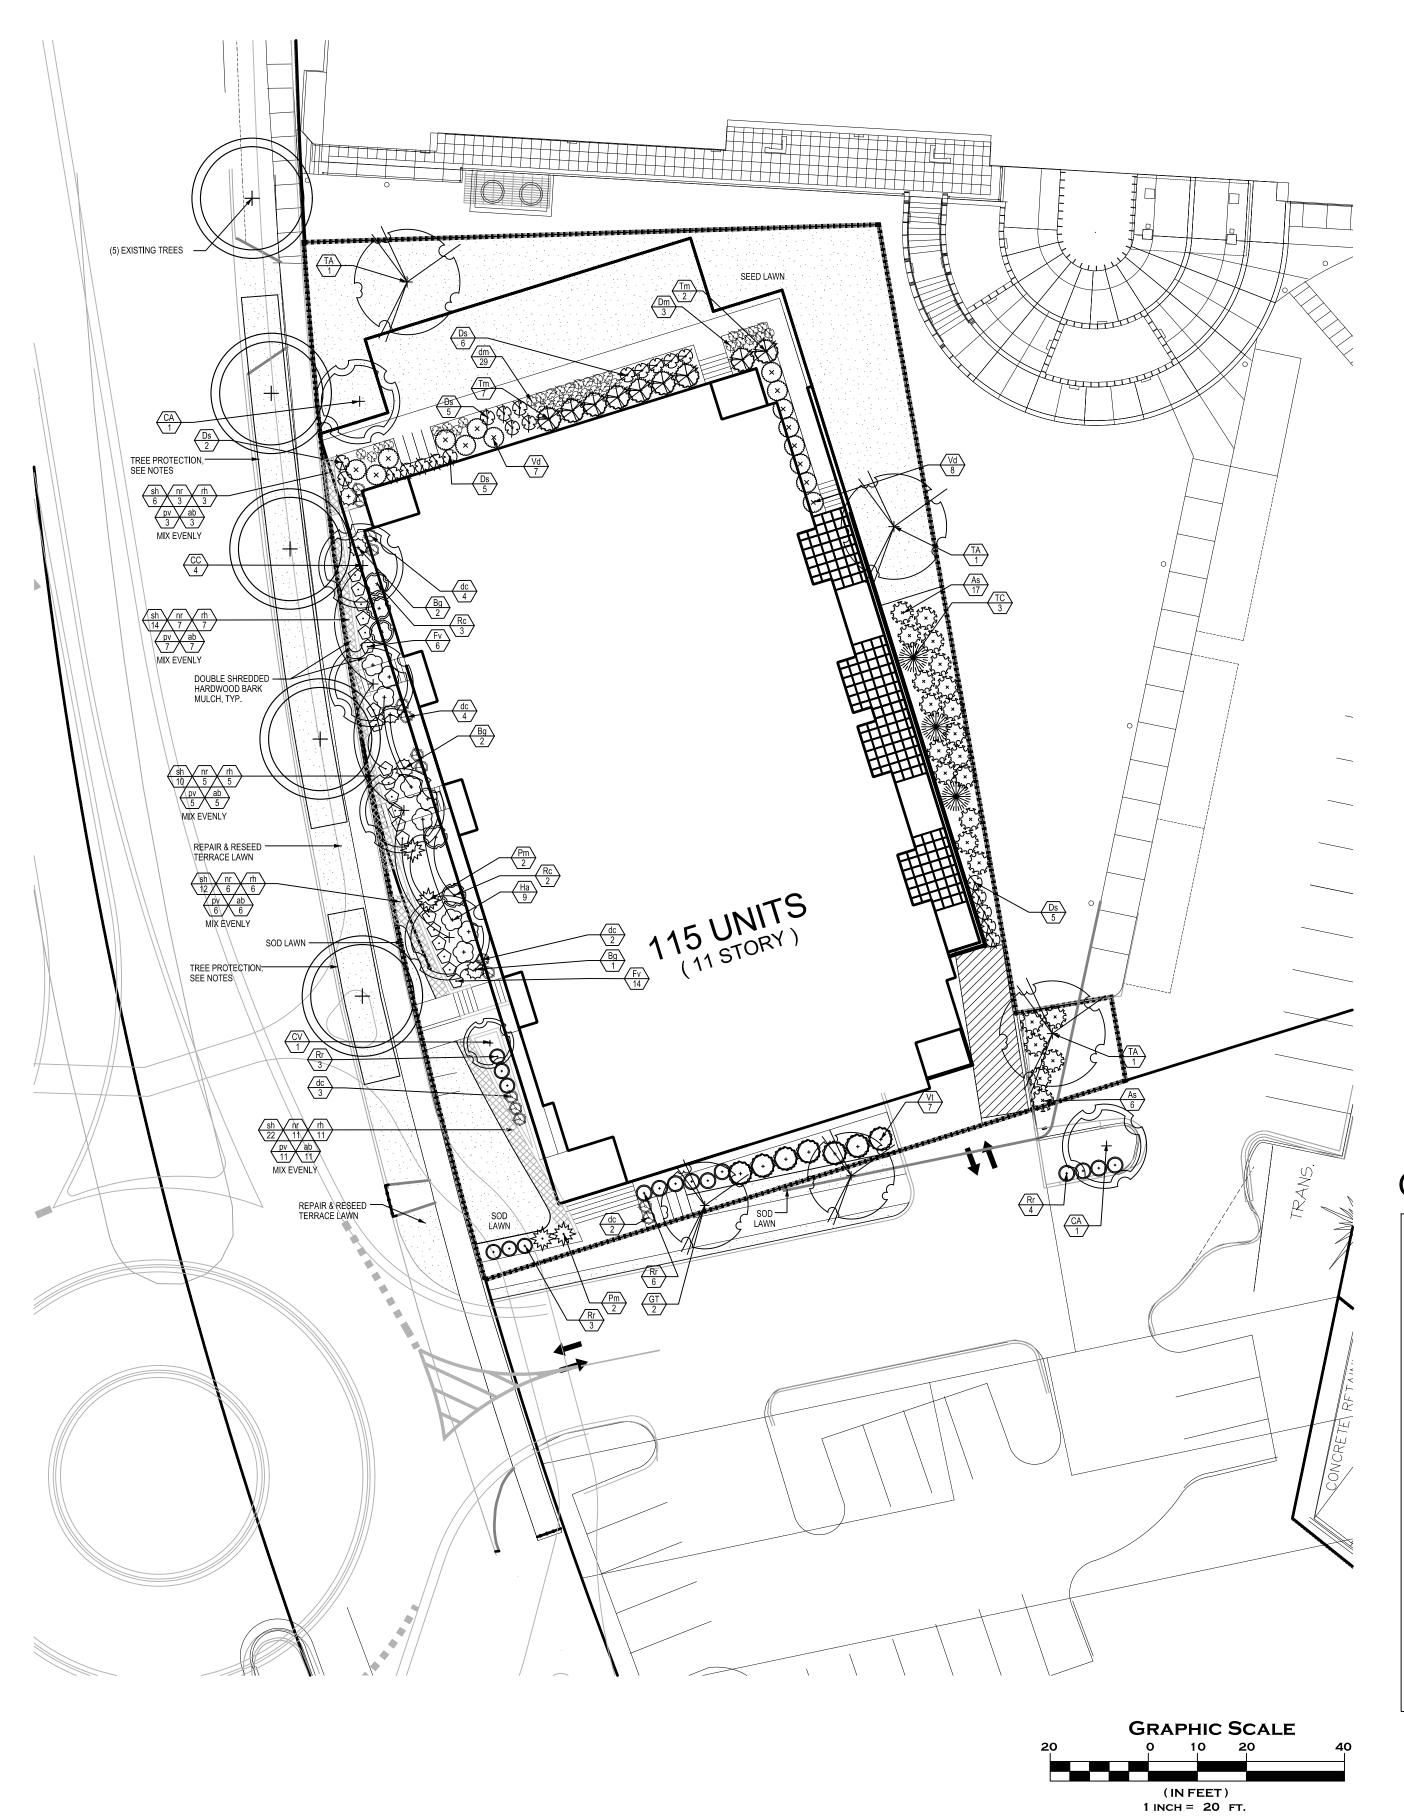





t					The firm
Botanical Name	Common Name	Quantity	Size	Spec	Comments
Deciduous Trees					
Gleditsia triacanthos var. inermis 'Skyline'	Thornless Honeylocust	2	2.5" Cal.	BB	
Tilia americana 'Sentry'	Sentry American Linden	3	2" Cal.	BB	
Deciduous Trees					
	American Hornbeam	2	2.5" Cal.	BB	tree form, space per plan; trunk free of branches to 6.5
					Columbus, WI strain
Chionanthus virginicus	White Fringetree	1	1.5" Cal.	BB	
Evergreen Trees					
Tsuga canadensis 'Geneva'	Eastern Hemlock	3	4' ht.	BB	
Deciduous Shrubs					
Amelanchier stonlonifera	Running Serviceberry	23	5 gal.	CG	space 5' on center
Diervilla sessilifolia 'Butterfly'					space 3.5' on center
Forsythia viridissima 'Broxensis'		20		CG	space 3' on center
		9			space 4' on center
		5		CG	space 5' on center
	Dwarf Pavement Rose	16		CG	space 3' on center
	Blue Muffin Viburnum			CG	space 4' on center
Viburnum trilobum 'Bailey's Compact'	American Cranberrybush Viburnum	7	5 gal.	CG	space 6' on center
Evergreen Shrubs					
	Green Velvet Boxwood	5	18"-24" spr	CG	
		-			
Taxus x media 'Tauntonii'	Taunton Yew		24"-36" spr.	CG	space 5' on center
Perennials/Grasses/Groundcovers					
	Gold Dew Tufted Hair Grass	13	1 gal	CG	space 2' on center
					space 2' on center
					space 2 on center
			-		space 18" on center
					space 18" on center
	,		<u> </u>		space 18" on center
					space 18" on center
	Gleditsia triacanthos var. inermis 'Skyline' Tilia americana 'Sentry' Deciduous Trees Carpinus caroliniana Cercis canadensis Chionanthus virginicus Evergreen Trees Tsuga canadensis 'Geneva' Deciduous Shrubs Ameianchier stonlonifera Diervilla sessilifolia 'Butterfly' Forsythia viridissima 'Broxensis' Hydrangea arborescens 'Annabelle' Rhus copallina var. latifolia 'Morton' Rosa rugosa 'Dwarf Pavement' Viburnum dentatum 'Christom' Viburnum trilobum 'Bailey's Compact' Evergreen Shrubs Buxus x 'Green Velvet' Pinus mugo var. Pumilo	Gleditisa triacanthos var. inermis 'Skyline'       Thornless Honeylocust         Tilia americana 'Sentry'       Sentry American Linden         Deciduous Trees       Carpinus caroliniana         Carpinus caroliniana       American Hornbeam         Cercis canadensis       Eastern Redbud         Chionanthus virginicus       White Fringetree         Evergreen Trees       Eastern Hemlock         Tsuga canadensis 'Geneva'       Eastern Hemlock         Deciduous Shrubs       Ameianchier stonlonifera         Ameianchier stonlonifera       Running Serviceberry         Diervilla sessilifolia 'Butterfly'       Butterfly Bush Honeysuckle         Forsythia viridissima 'Broxensis'       Bronx Forsythia         Hydrangea arborescens 'Annabelle'       Annabelle Hydrangea         Rhus copallina var. latifolia 'Morton'       Prairie Flame Shining Sumac         Rosa rugosa 'Dwarf Pavement'       Dwarf Pavement Rose         Viburnum dentatum 'Christom'       Blue Muffin Viburnum         Viburnum trilobum 'Bailey's Compact'       American Cranberrybush Viburnum         Viburnum trilobum 'Bailey's Compact'       American Cranberrybush Viburnum         Viburnum trilobum 'Bailey's Compact'       Green Velvet Boxwood         Pinus mugo var. Pumilo       Dwarf Mugo Pine         Taxus x media 'Tauntonii'       T	Gleditisia triacanthos var. inermis 'Skyline'       Thornless Honeylocust       2         Tilia americana 'Sentry'       Sentry American Linden       3         Deciduous Trees       Carpinus caroliniana       American Hornbeam       2         Carois canadensis       Eastern Redbud       4         Chionanthus virginicus       White Fringetree       1         Evergreen Trees       1         Tsuga canadensis 'Geneva'       Eastern Hemlock       3         Deciduous Shrubs       1         Ameianchier stonlonifera       Running Serviceberry       23         Diervilla sessilifolia 'Butterfly'       Butterfly Bush Honeysuckle       22         Forsythia viridissima 'Broxensis'       Bronx Forsythia       20         Hydrangea arborescens 'Annabelle'       Annabelle Hydrangea       9         Rhus copallina var. latifolia 'Morton'       Prairie Flame Shining Sumac       5         Rosa rugosa 'Dwarf Pavement'       Dwarf Pavement Rose       16         Viburnum dentatum 'Christom'       Blue Muffin Viburnum       15         Viburnum trilobum 'Bailey's Compact'       American Cranberrybush Viburnum       7         Evergreen Shrubs       1       1       1         Buxus x 'Green Velvet'       Green Velvet Boxwood       5	Gleditsia triacanthos var. inermis 'Skyline'       Thornless Honeylocust       2       2.5" Cal.         Tilia americana 'Sentry'       Sentry American Linden       3       2" Cal.         Deciduous Trees       2       2.5" Cal.         Carpinus caroliniana       American Hornbearn       2       2.5" Cal.         Cercis canadensis       Eastern Redbud       4       1.75" Cal.         Chionanthus virginicus       White Fringetree       1       1.5" Cal.         Evergreen Trees       7       3       4" ht.         Deciduous Shrubs       3       4" ht.         Deciduous Shrubs       2       5 gal.         Diervilla sessilifolia 'Butterfly'       Butterfly Bush Honeysuckle       22       5 gal.         Forsythia viridissima 'Broxensis'       Bronx Forsythia       20       5 gal.         Piervilla sessilifolia 'Butterfly'       Butterfly Bush Honeysuckle       22       5 gal.         Rhus copallina var. latifolia 'Morton'       Prairie Flame Shining Sumac       5       5 gal.         Rosa rugosa 'Dwarf Pavement'       Dwarf Pavement Rose       16       2 gal.         Viburnum dentatum 'Christom'       Blue Mufin Viburnum       15       5 gal.         Viburnum trilobum 'Bailey's Compact'       American Cranberrybush Viburnum	Gleditisia triacanthos var. inermis 'Skyline'       Thornless Honeylocust       2       2.5" Cal.       BT         Tilia americana 'Sentry'       Sentry American Linden       3       2" Cal.       BB         Deciduous Trees



## GENERAL NOTES

1. SEE SHEET L-2.0 FOR PLANTING DETAILS.

2. SEE CIVIL DOCUMENTS FOR TREE PROTECTION DETAILS.


3. TREE PROTECTION FENCING SHALL BE PROVIDED FOR THE EXISTING STREET TREES FOR THE DURATION OF CONSTRUCTION. FENCING SHALL COVER THE WIDTH OF THE TERRACE AND EXTEND AS SHOWN ON THE PLANS.

4. IF EXCAVATION IS NECESSARY WITHIN 5 FT OF ANY EXISTING TREE, CITY FORESTRY (DEAN KAHL, 608-266-4816, DKAHL@CITYOFMADISON.COM) SHALL BE CONTACTED SO THAT THEY MAY INSPECT AND PROVIDE RECOMMENDATIONS TO PROTECT THE ROOT SYSTEMS OF THE TREES.

5. CITY FORESTRY SHALL BE CONTACTED AT LEAST TWO WEEKS PRIOR TO DEMOLITION TO REVIEW ANY PRUNING NEEDS.



City of Madison, WI La 10-Apr-14	andooupo		
то-Арі- 14			
Developed Lot	SF	Landscape Units Req.	Landscape Points
Total Developed Area	25,351	85	
Element	Point Value	Quantity	Total Points
Overstory Deciduous Tree	35	11	385
Ornamental Tree	15	7	105
Evergreen Tree	15	3	45
Shrub, deciduous	2	117	234
Shrub, evergreen	3	18	54
Ornamental Grass	2	110	220
Ornamental/Decorative Fence or Wall (4 pts/10 LF)	4	0	0
		<u> </u>	
Development Frontage	LF	Overstory Tree Req (or x2 for Orn./Evergreen Tree Sub.)	Shauba Dag
Total LF of Street Frontage	LF	Thee Sub.)	Shrubs Req.
Between Bldg./Parking & street	219	7	
Element	Point Value	Quantity	
Overstory Deciduous Tree	35	4	140
Ornamental Tree	15	6	90
Evergreen Tree	15	0	0
Shrub, deciduous	2	49	98
Shrub, evergreen	3	9	27

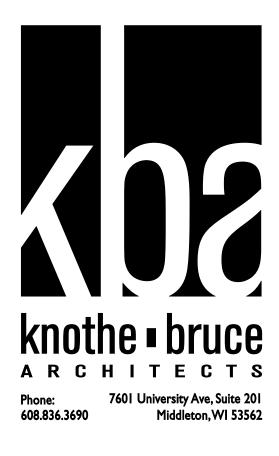

CONSULTANT



303 S. PATERSON S U I T E O N E MADISON, WI 53703 Phone: 608 251-3600 Fax: 608 251-2330 www.ksd-la.com

REVISIONS

Revised - February 19, 2014 Revised - April 3, 2014 Revised - April 10, 2014


PROJECT TITLE SEGOE ROAD

MADISON, WI SHEET TITLE

PLANTING PLAN

SHEET NUMBER

L-1.0

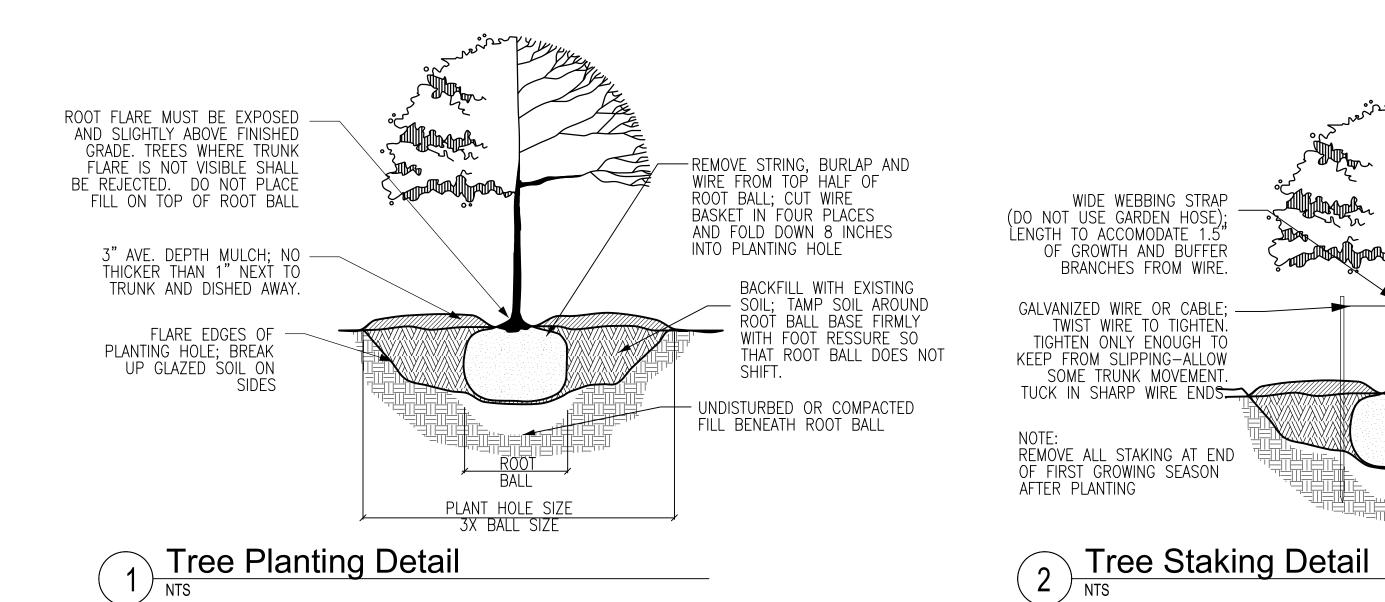

### SOIL

1. Contractor shall provide a suitable amended topsoil blend for all planters and areas where existing soil conditions are unsuitable for planting, seeding, or sodding. Topsoil shall be clean salvaged or imported material capable of passing the 1" sieve and meeting the requirements of Section 625.2(1) of the Standard Specifications for Highway Construction. The material shall be free of 16. No soil is to cover the top of the root flare. All plants shall be mulched rocks, gravel, wood, debris, and of noxious weeds and their seeds.

2. Remove all rocks, debris, and litter from the site and all planting/seeding/sodding areas. Till or disc the subsoil to a depth of 2"-4" to allow aeration. Provide a minimum of 6" of topsoil in areas where existing soil conditions are unsuitable for sodding and seeding. Provide a minimum of 12" of topsoil in planting areas.

3. Soil depths will vary by planter. See Architectural for details.

4. Do not apply topsoil to saturated or frozen subgrades.

has been determined acceptable by a soil test, no ammendments are needed. construction, the appraised value of the tree(s) will need to be paid. The Uniformly apply any organic soil ammendments and incorporate into the top 4"-6" of soil by tilling or discing.

### PLANTS

2. All plant material shall be true to the species and variety/hybrid/cultivar specified, and nursery-grown in accordance with good horticultural practices, and under climatic conditions similar to those of the site location.

Nursery-dug material shall be freshly dug and properly prepared for planting Contact Landscape Architect, in writing, to request any plant material substitutions due to availability issues.

3. Trees and shrubs shall have superior form, compactness, and symmetry. Damaged trees and shrubs, by weather, insects, fungus, knots, abrasions, or clut Seed shall be delivered to the site in its original, unopened container, limbs or leaders and trees with multiple leaders, unless specified otherwise, will be rejected.

physical damage

5. Plants shall conform to the measurements specified within the contract documents.

that damages trunks or breaks branches. Plants are not to be dragged, lifted, or pulled by the trunk, branches or foliage. Plants are not to be thrown off of a truck or loader.

7. Prior to installation, plants must be protected from sun and drying winds, kept in shaded areas, and kept well-watered. Install all plants within three days of delivery to site.

8. All plants shall be guaranteed to be in healthy and flourishing condition during the growing season. The guarantee does not cover damage from guarantee period, the Contractor shall remove or replace, without cost to the owner, all plants not in a healthy and flourishing condition as determined by the Landscape Architect.

9. All plant material shall be guaranteed for one (1) year from time of installation. Only one replacement per plant shall need to be made. 10. Organic Mulch is to be double shredded hardwood bark, free of material 8. All sod is to be harvested, delivered, stored, and handled according to detrimental to healthy plant growth. Shredded bark mulch shall be 1/8" nominarequirements in TPI's "Specifications for Turfgrass Sod Materials" and thickness, with at least 50% having an area of not less than 1 sq. inch, and no "Specifications for Turfgrass Sod and Transplanding and Installation" in its piece having an area of more than 4 sq. inches.

11. Stake all planting and notify Digger's Hotline (1-800-242-8511) to verity location of all underground utilities prior to excavation.

12. The planting pit for containerized and balled and burlapped plants shall at least 2.5 to 3 times the diameter of the soil ball. The soil beyond the edges is to be loosened. The soil at the base of the pit is to remain undisturbed.

13. The depth of the planting pit shall correspond to the distance from the bottom of the soil ball to the root flare, or slightly less. Plant material set too low will need to be re-set by the contractor pending the Landscape Architect's instructions. Pits shall be backfilled with excavated soil so long as it is not muddy or frozen.

14. The planters shall be prepared for planting by placing topsoil on top of filter fabric and crushed aggregate (to be provided by general contractor); tamp and/or water to ensure that large air pockets have been removed from planter; allow for settling and re-fill so that topsoil is 2" below cap of lower wall; mound planting beds slightly in the center for added height.

(PLANTS CONT'D)

15. Root balled plants shall have rope, string, burlap and/or other wrapping 13. Provide and maintain temporary piping, hoses, and watering equipment to material cut away and removed from top half of the root ball after the plant convey water from sources and keep sodded lawn uniformily moist to a depth has been set in the hole. Cut wire basket in four places and fold down 8 of 4". After first week, water sodded lawn at a minimum rate of 1" per week. inches into planting hole. 14. All lawn areas of seed or sod are to be mowed to a height of 2"-3" by scheduled mowings. Repeat mowing to maintain specified height without with a 3" layer of specified mulch immediately after planting. Mulch is to be cutting more than 40% of grass height. Remove no more than 40% of pulled back no less than 3" and no more than 6" from trunks. grass-leaf growth in initial or subsequent mowings. Do not delay mowing until 17. Thoroughly water plants immediately after planting and before mulching. grass blades bend over and become matted. Do not mow when grass is wet. 18. Remove all twine and labels and prune any dead or broken branches after Mow to maintain during entire 60-day maintenance period. 15. Maintain and establish seeded and sodded lawn areas by watering,

19. Maintenance for plant material shall be 30 days. Plants shall be watered, staked, pruned, dead-headed, and planting beds shall be weeded during this time period.

5. Provide organic soil amendments as recommended by soil analysis. If topsoff<sup>0.</sup> If any street trees are damaged or need to be removed to accommodate 16. At the end of the maintenance period, a healthy, well-rooted, even-colored, viable lawn will have been established, free of weeds, open planned removal of the two street trees includes all brush and stump removal. joints, bare areas, and surface irregularities. 21. Tree protection fencing shall be provided for each of the existing street trees for the duration of the construction. The fencing shall cover the width of the terrace and extend as shown on the plans. If excavation is necessary 1. All plant material shall conform to the American Standards of Nursery Stock. within 5 ft of any existing tree, City Forestry (Dean Kahl, 608-266-4816, dkahl@cityofmadison.com) shall be contacted so that they may inspect and provide recommendations to protect the root systems of the trees. 22. City Forestry shall be contacted at least two weeks prior to demolition to review any pruning needs. City Forestry will prune the existing street trees they will need building plans to determine how much they will need to prune off the building side of the trees.

LAWNS & GRASSES

labeled as to weight, analysis, and manufacturer. Store any seed delivered prior to use in a manner safe from damage from heat, moisture, rodents, or 4. Trees and shrubs shall have healthy, well-developed root systems, free from ther causes. Any seed damaged after acceptance shall be replaced by the Contractor.

2. The Contractor shall guarantee the germination of seed installed during the regular seeding season (May 1 - October 15).

6. During transportation, no plant shall be bound with rope or wire in a manner 3. Grass seed shall meet the requirements of Section 630.2.1 of Standards Specifications for Highway Construction. Unless otherwise specified, provide Kentucky Bluegrass seed blend.

4. Place and anchor clean straw or hay mulch that is well-seasoned, and free of rot, mildew, and seeds of noxious weeds over the seeded area according to the methods outlined by Section 627.3 of Standards Specifications for Highway Construction.

5. Erosion control mat shall be used on slopes greater than 1:4. 6. Seeded areas are to be watered daily to maintain adequate surface soil vandalism, animals, freezing rain, or winds over 60 mph. During any time of the moisture for proper seed germination. Watering shall continue for not less than 60 days following seeding. Thereafter, apply 1/2" of water twice weekly until final acceptance.

7. All sod is to be turfgrass species Kenucky Bluegrass (Poa pratensis), a minimum of three cultivars, of uniform density, color, and texture, strongly rooted, and capable of vigorous growth and development when planted.

"Guideline Specifications to Turfgrass Sodding" 9. Lay sod within 24 hours of harvesting. Do not lay sod if dormant or if

ground is frozen or muddy.


be 10. Lay sod to form a solid mass with tightly fitted joints. Butt ends and sides of sod; do not stretch or overlap. Stagger strips or pads to offset joints in adjacent courses. Avoid damage to subgrade or sod during installation. Tamp and roll lightly to ensure contact with subgrade, eliminate air pockets, and form a smooth surface. Work sifted soil or fine sand into minor cracks between sod pieces; remove excess soil. 11. Lay sod across angle of slopes exceeding 1:3. Anchor sod on slopes exceeding 1:6 with wood pegs space as recommended by sod manufacturer but not less than two (2) anchors per strip.


12. Saturate sod with fine water spray within two hours of planting. During the first week, water daily or more frequently as necessary to maintain moist soil to a min. depth of 1-1/2" below sod.


13. Maintenance of sodded lawn is to begin immediately after each area is planted and continue until acceptable lawn is established, but not less than 60 days from date of substantial completion.


### (LAWNS & GRASSES CONT'D)

fertilizing, weeding, mowing, trimming, replanting, and other operations. Roll, regrade, and replant bare or eroded areas and remulch to produce a uniformly smooth lawn.

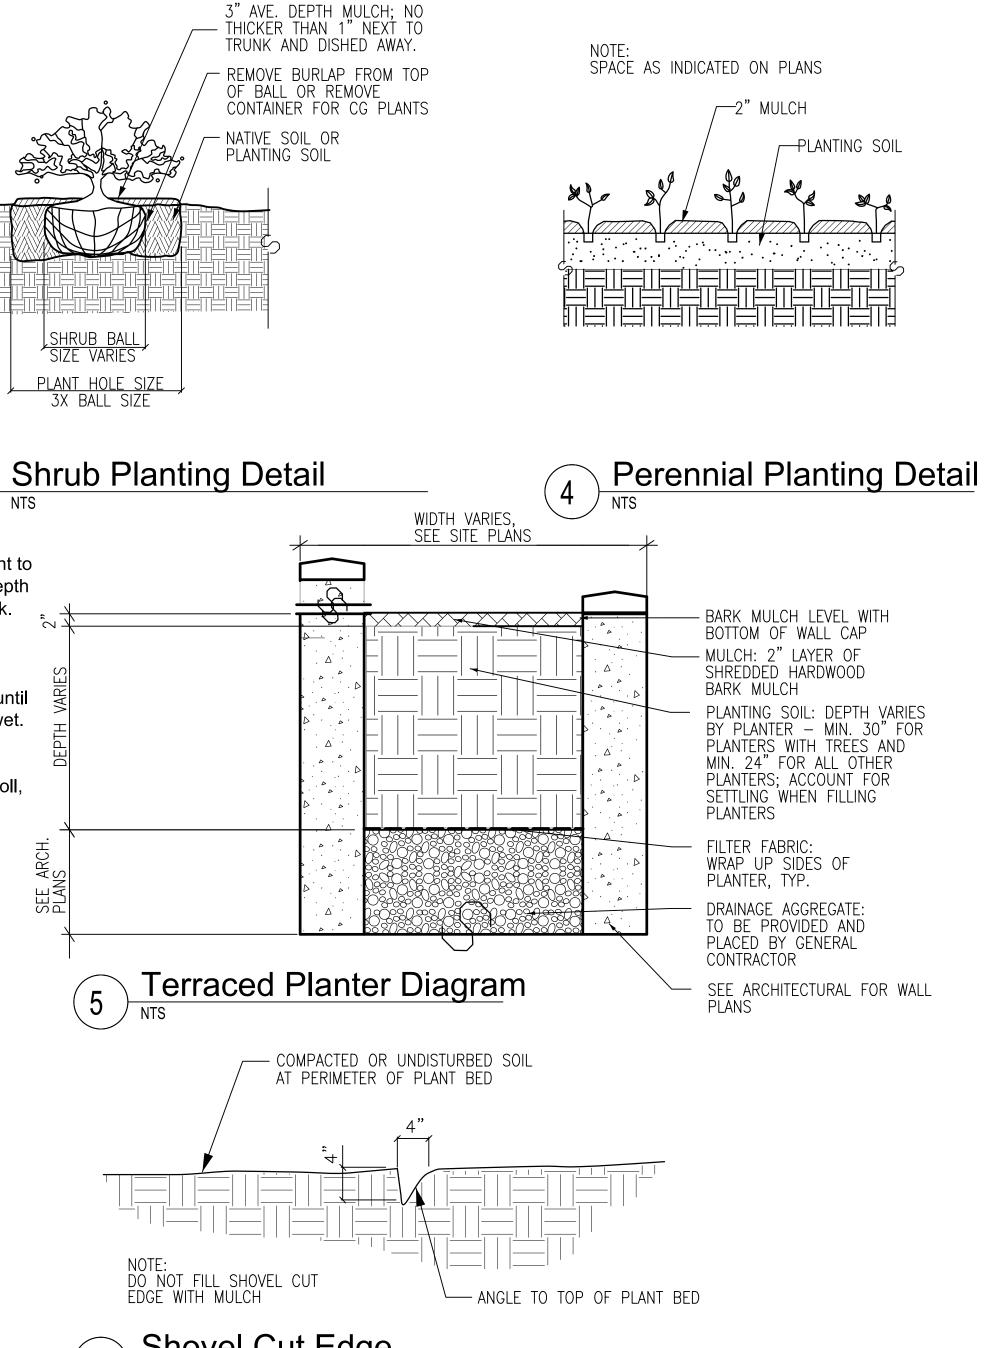


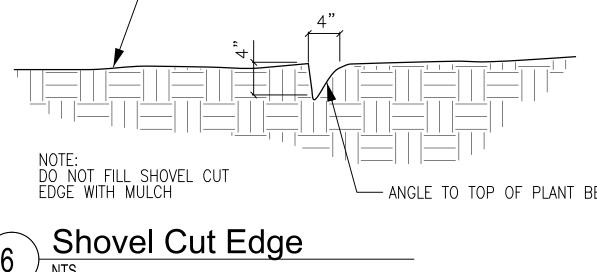


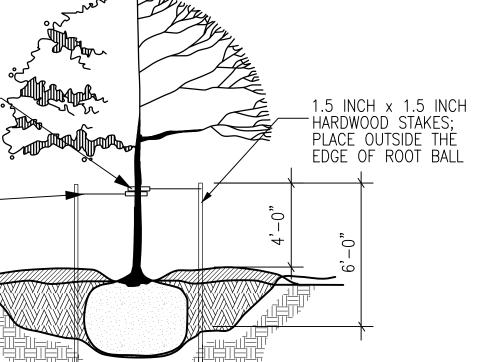

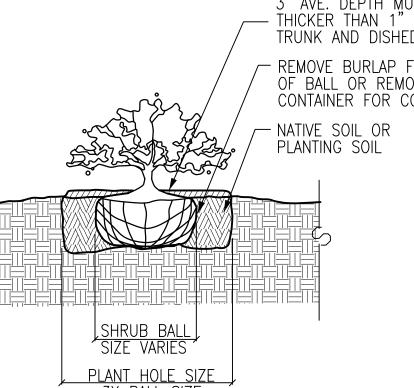

3)

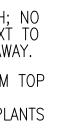

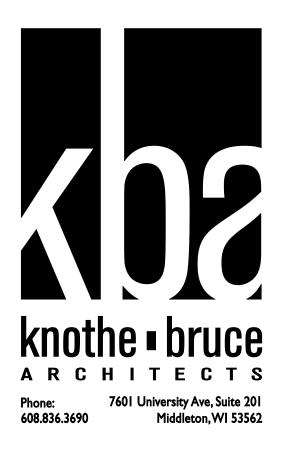

CONSULTANT (EN SAIK DESIGN INC LANDSCAPE ARCHITECTS 303 S. PATERSON S U I T E O N E MADISON, WI 53703 Phone: 608 251-3600 Fax: 608 251-2330 www.ksd-la.com

REVISIONS Revised - April 3, 2014 Revised - April 10, 2014


**PROJECT TITLE** SEGOE ROAD



SHEET NUMBER





1012 PROJECT NO. © 2013 Knothe & Bruce Architects

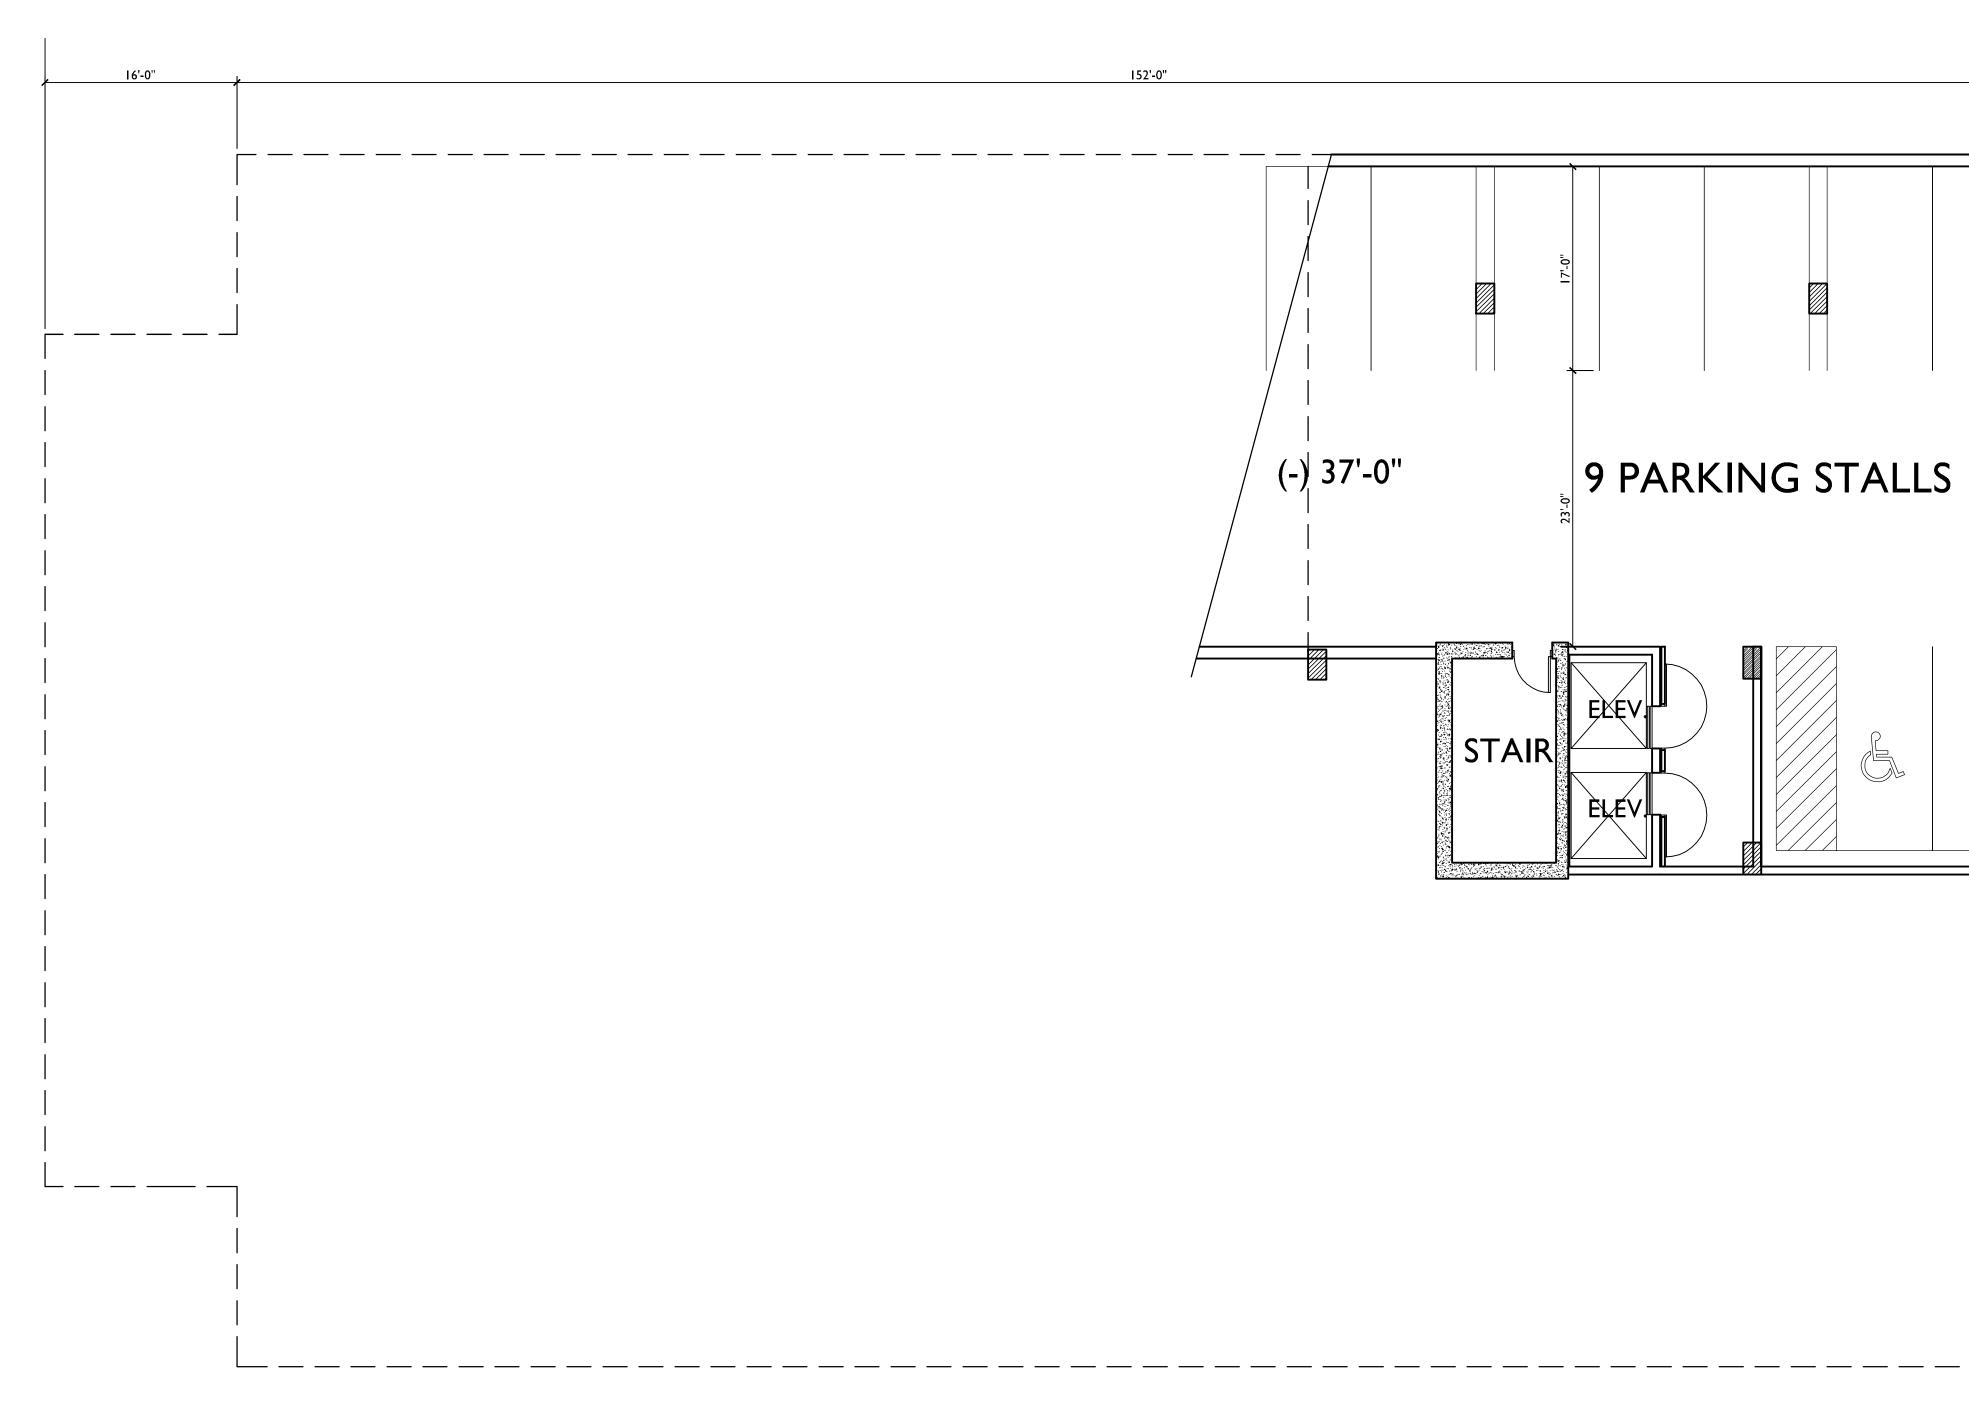






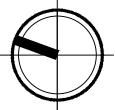


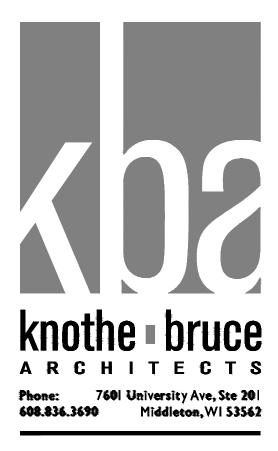


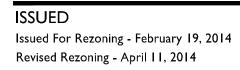


# PROJECT TITLE 617 SEGOE RD

Madison, WI SHEET TITLE PARKING LEVEL 4

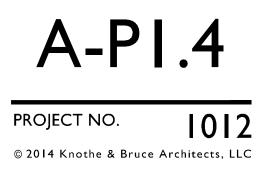


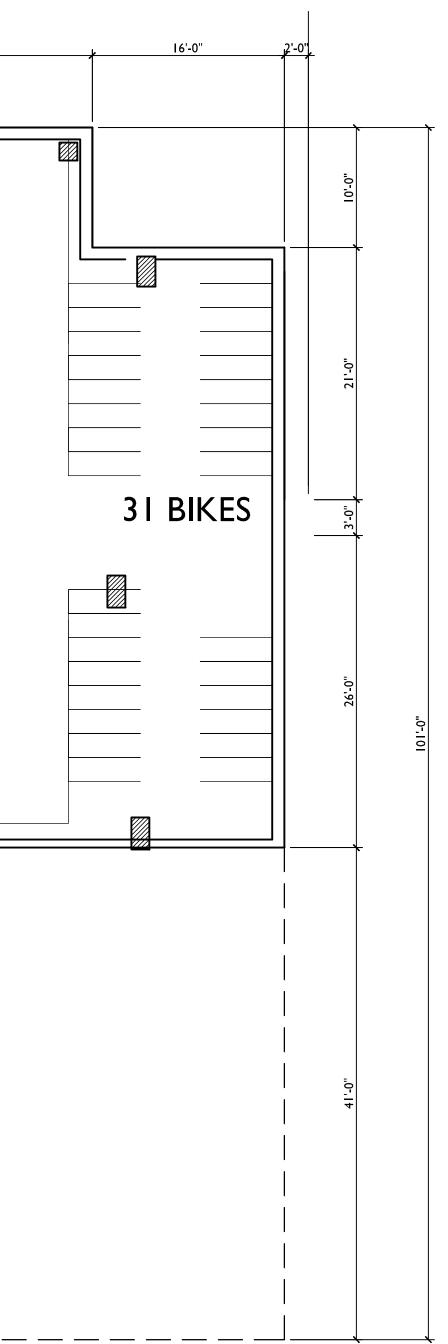


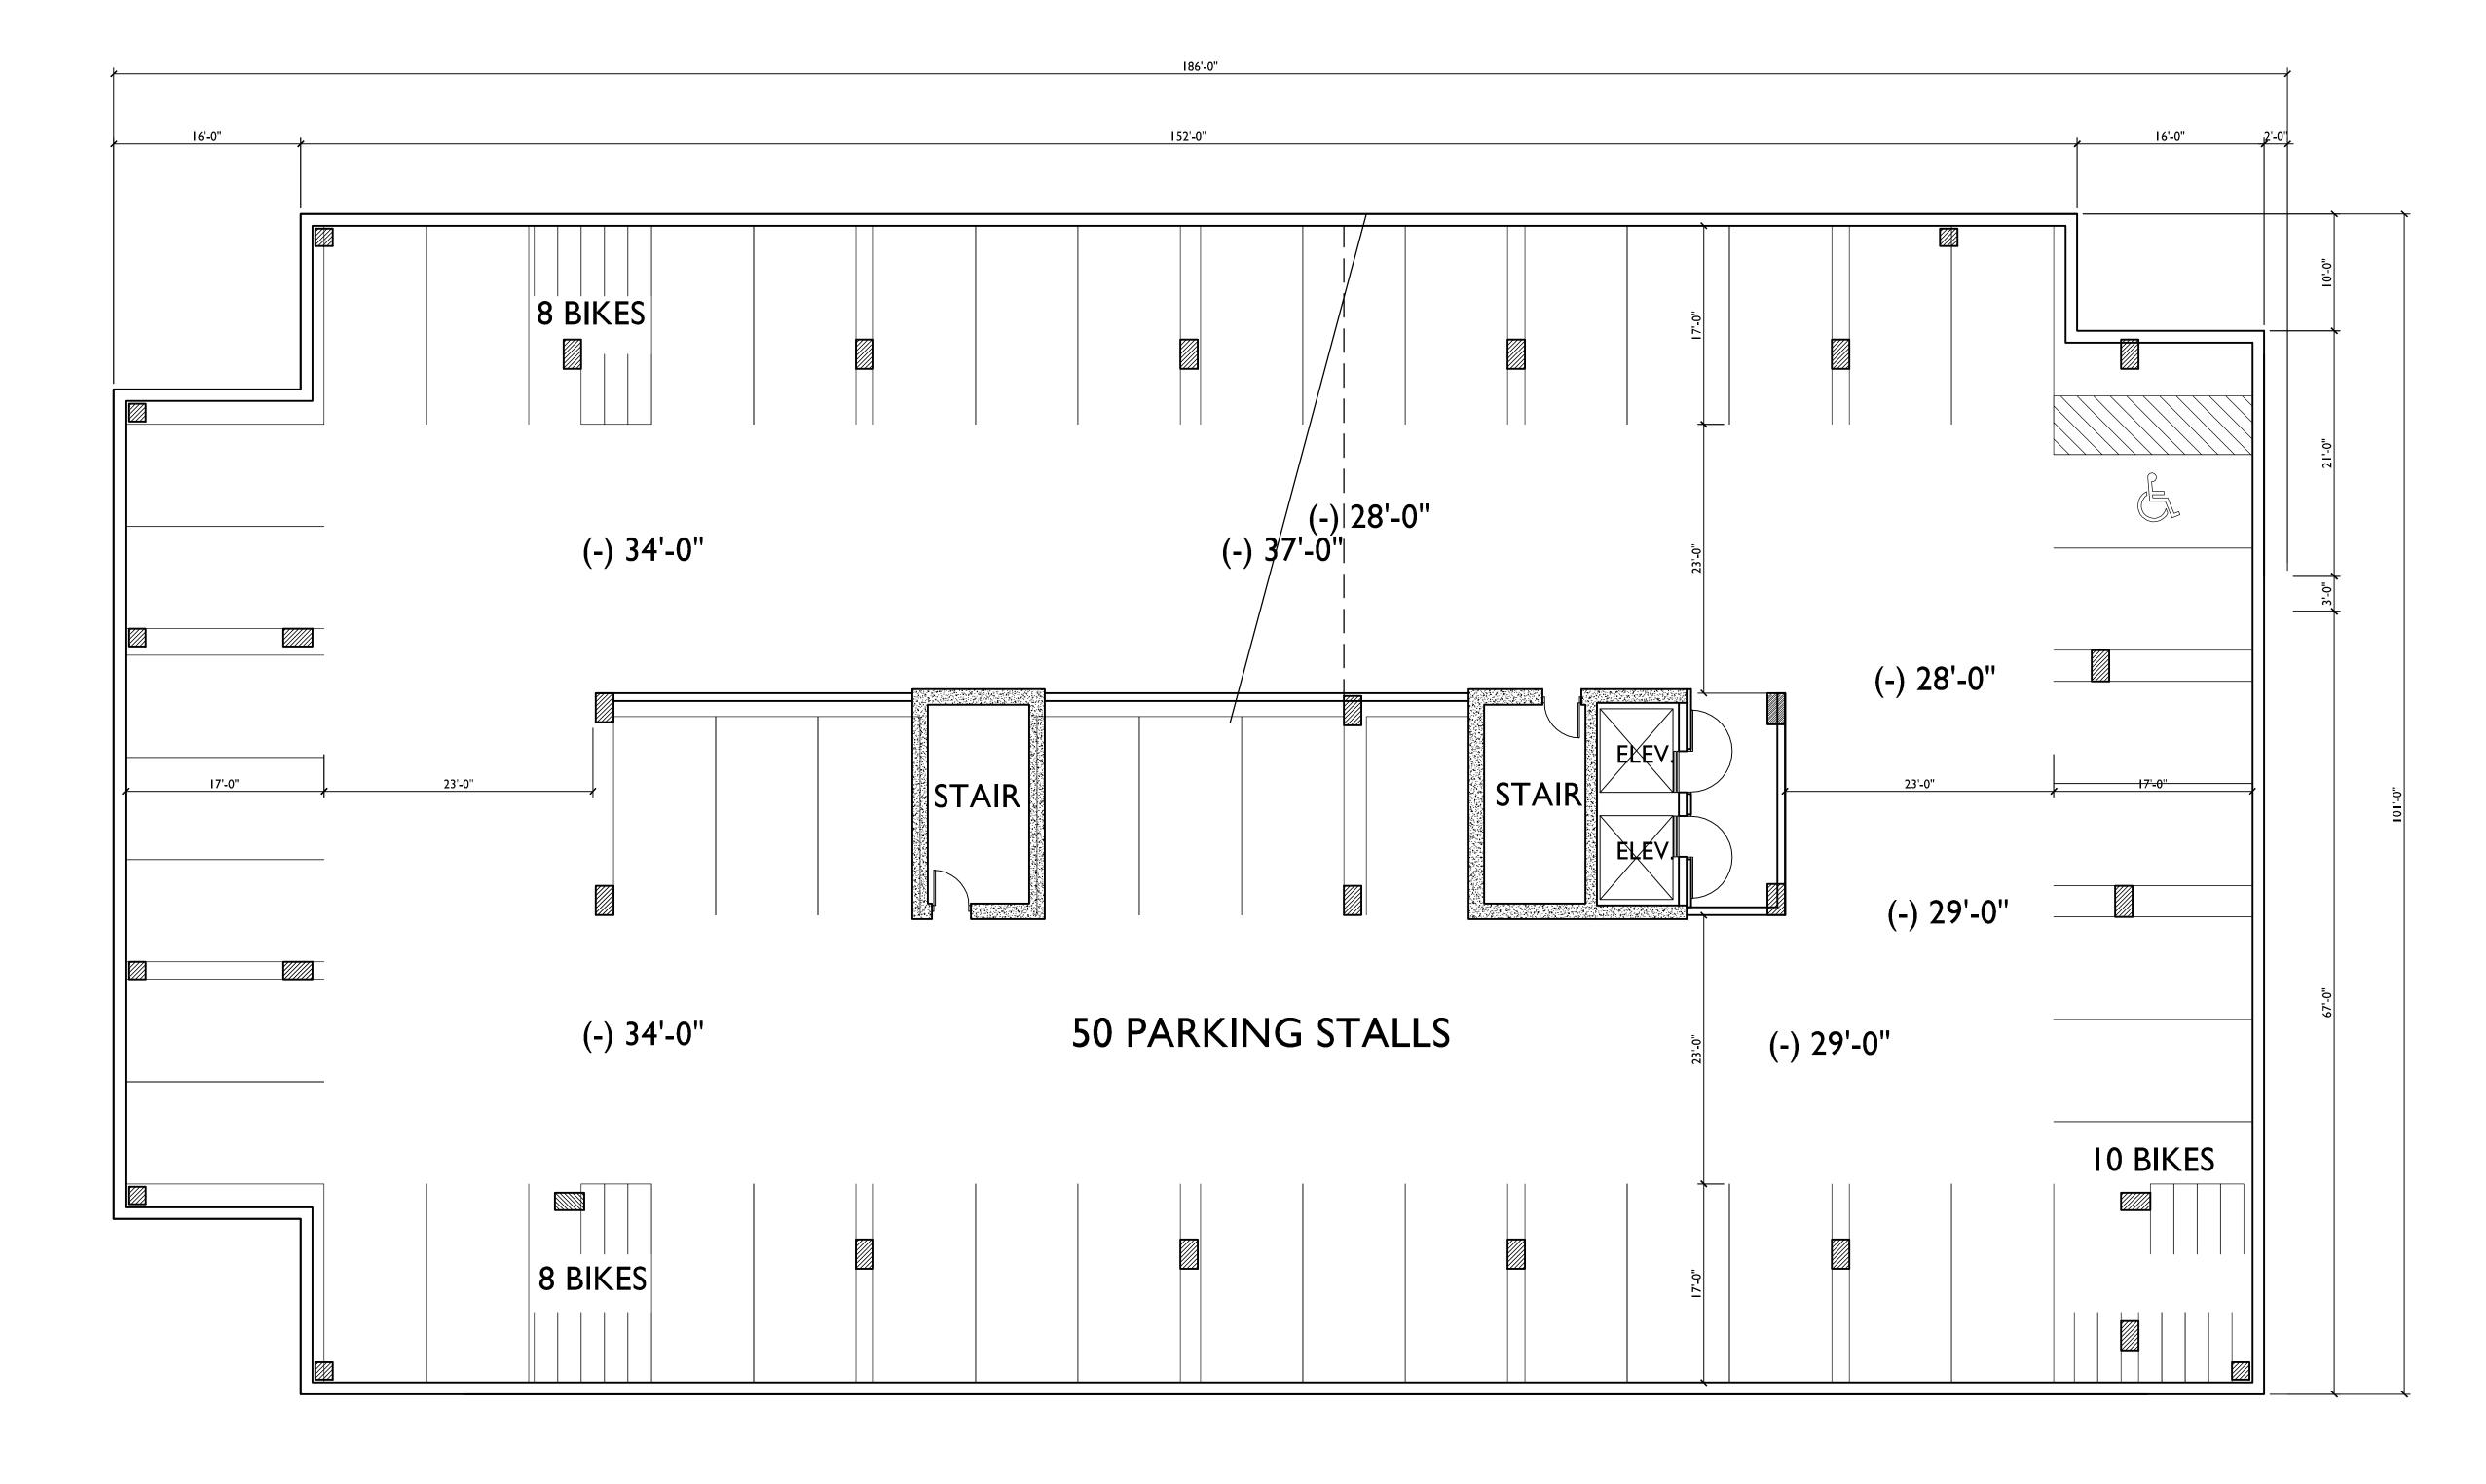



I PARKING LEVEL 3 A-P1.3 SCALE: 1/8"=1'-0"

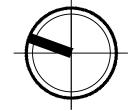


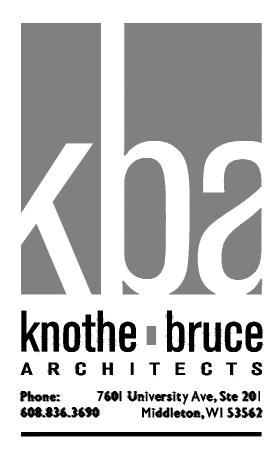


ISSUED Issued For Rezoning - February 19, 2014 Revised Rezoning - April 11, 2014

# PROJECT TITLE 617 SEGOE RD


Madison, WI SHEET TITLE PARKING LEVEL 3

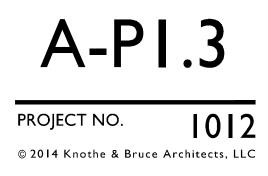


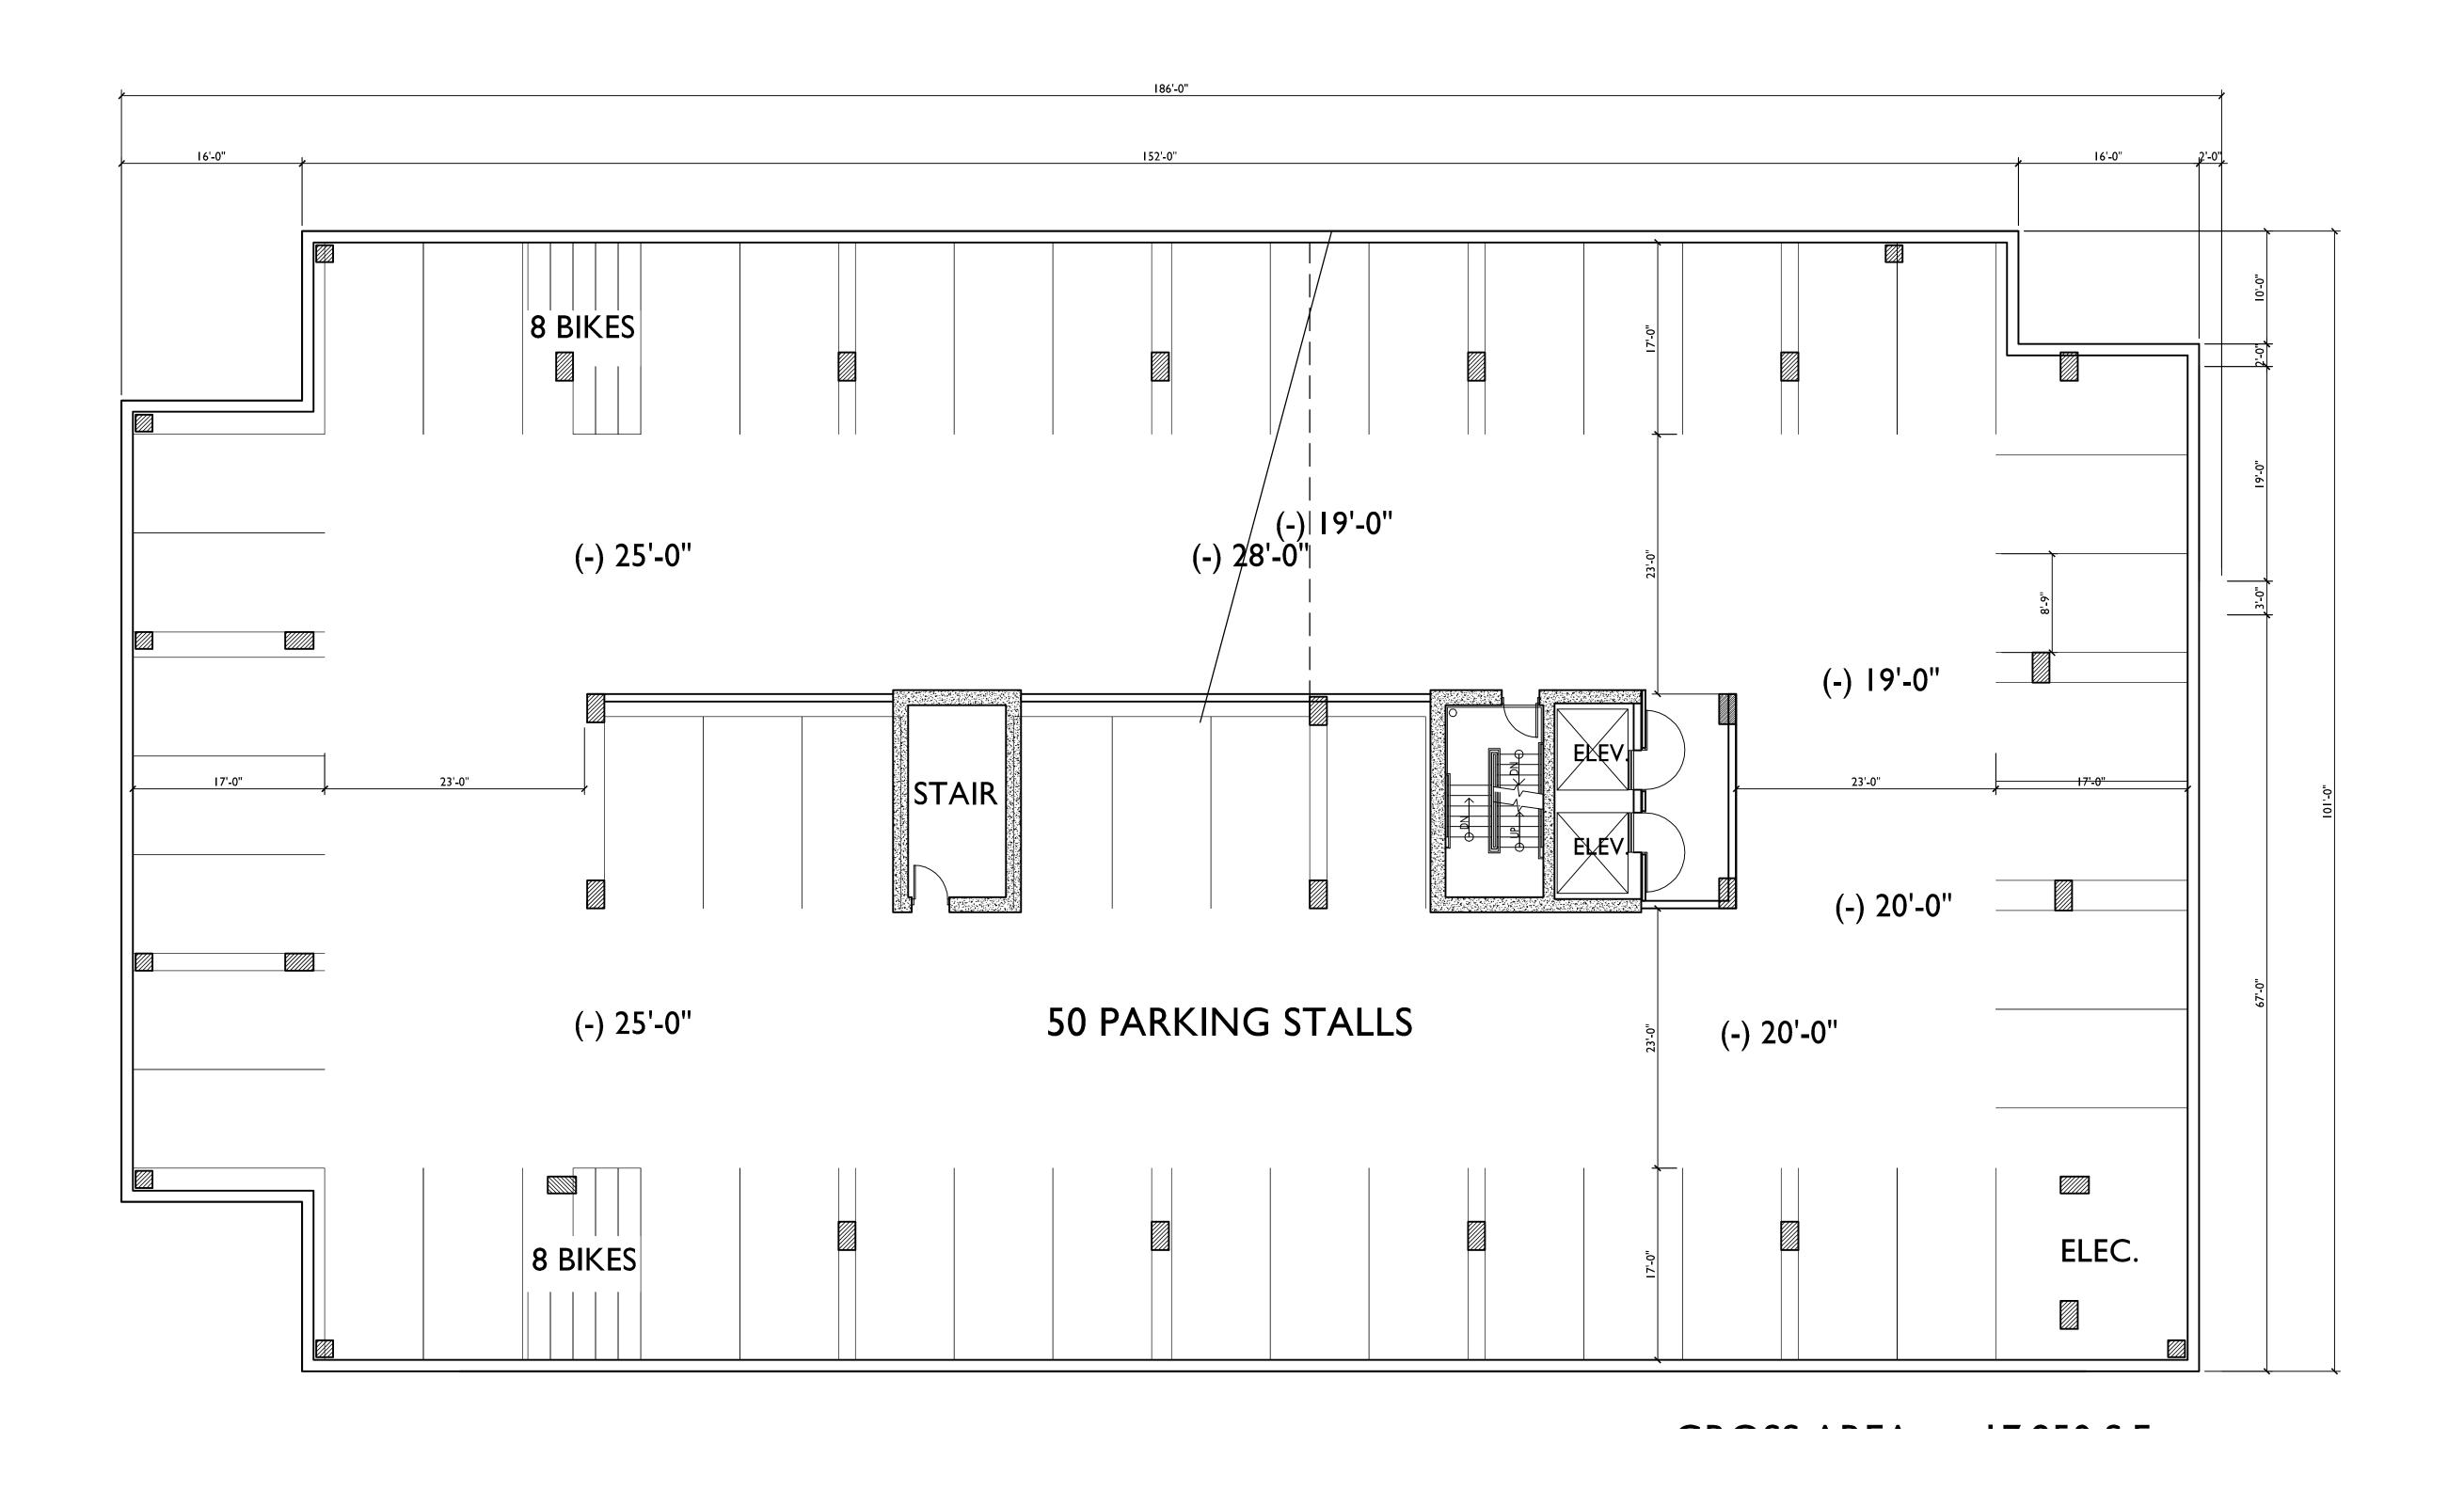



I PARKING LEVEL 2 A-P1.2 SCALE: 1/8"=1'-0"

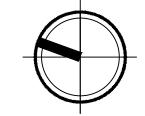


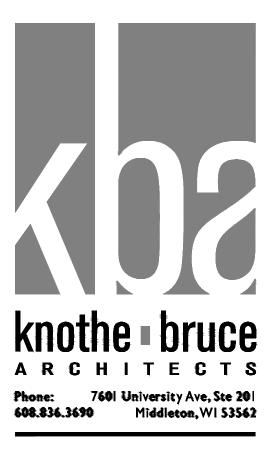


ISSUED Issued For Rezoning - February 19, 2014 Revised Rezoning - April 11, 2014

# PROJECT TITLE 617 SEGOE RD


Madison, WI SHEET TITLE PARKING LEVEL 2

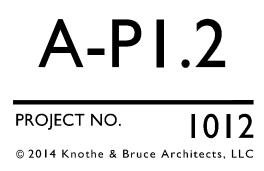


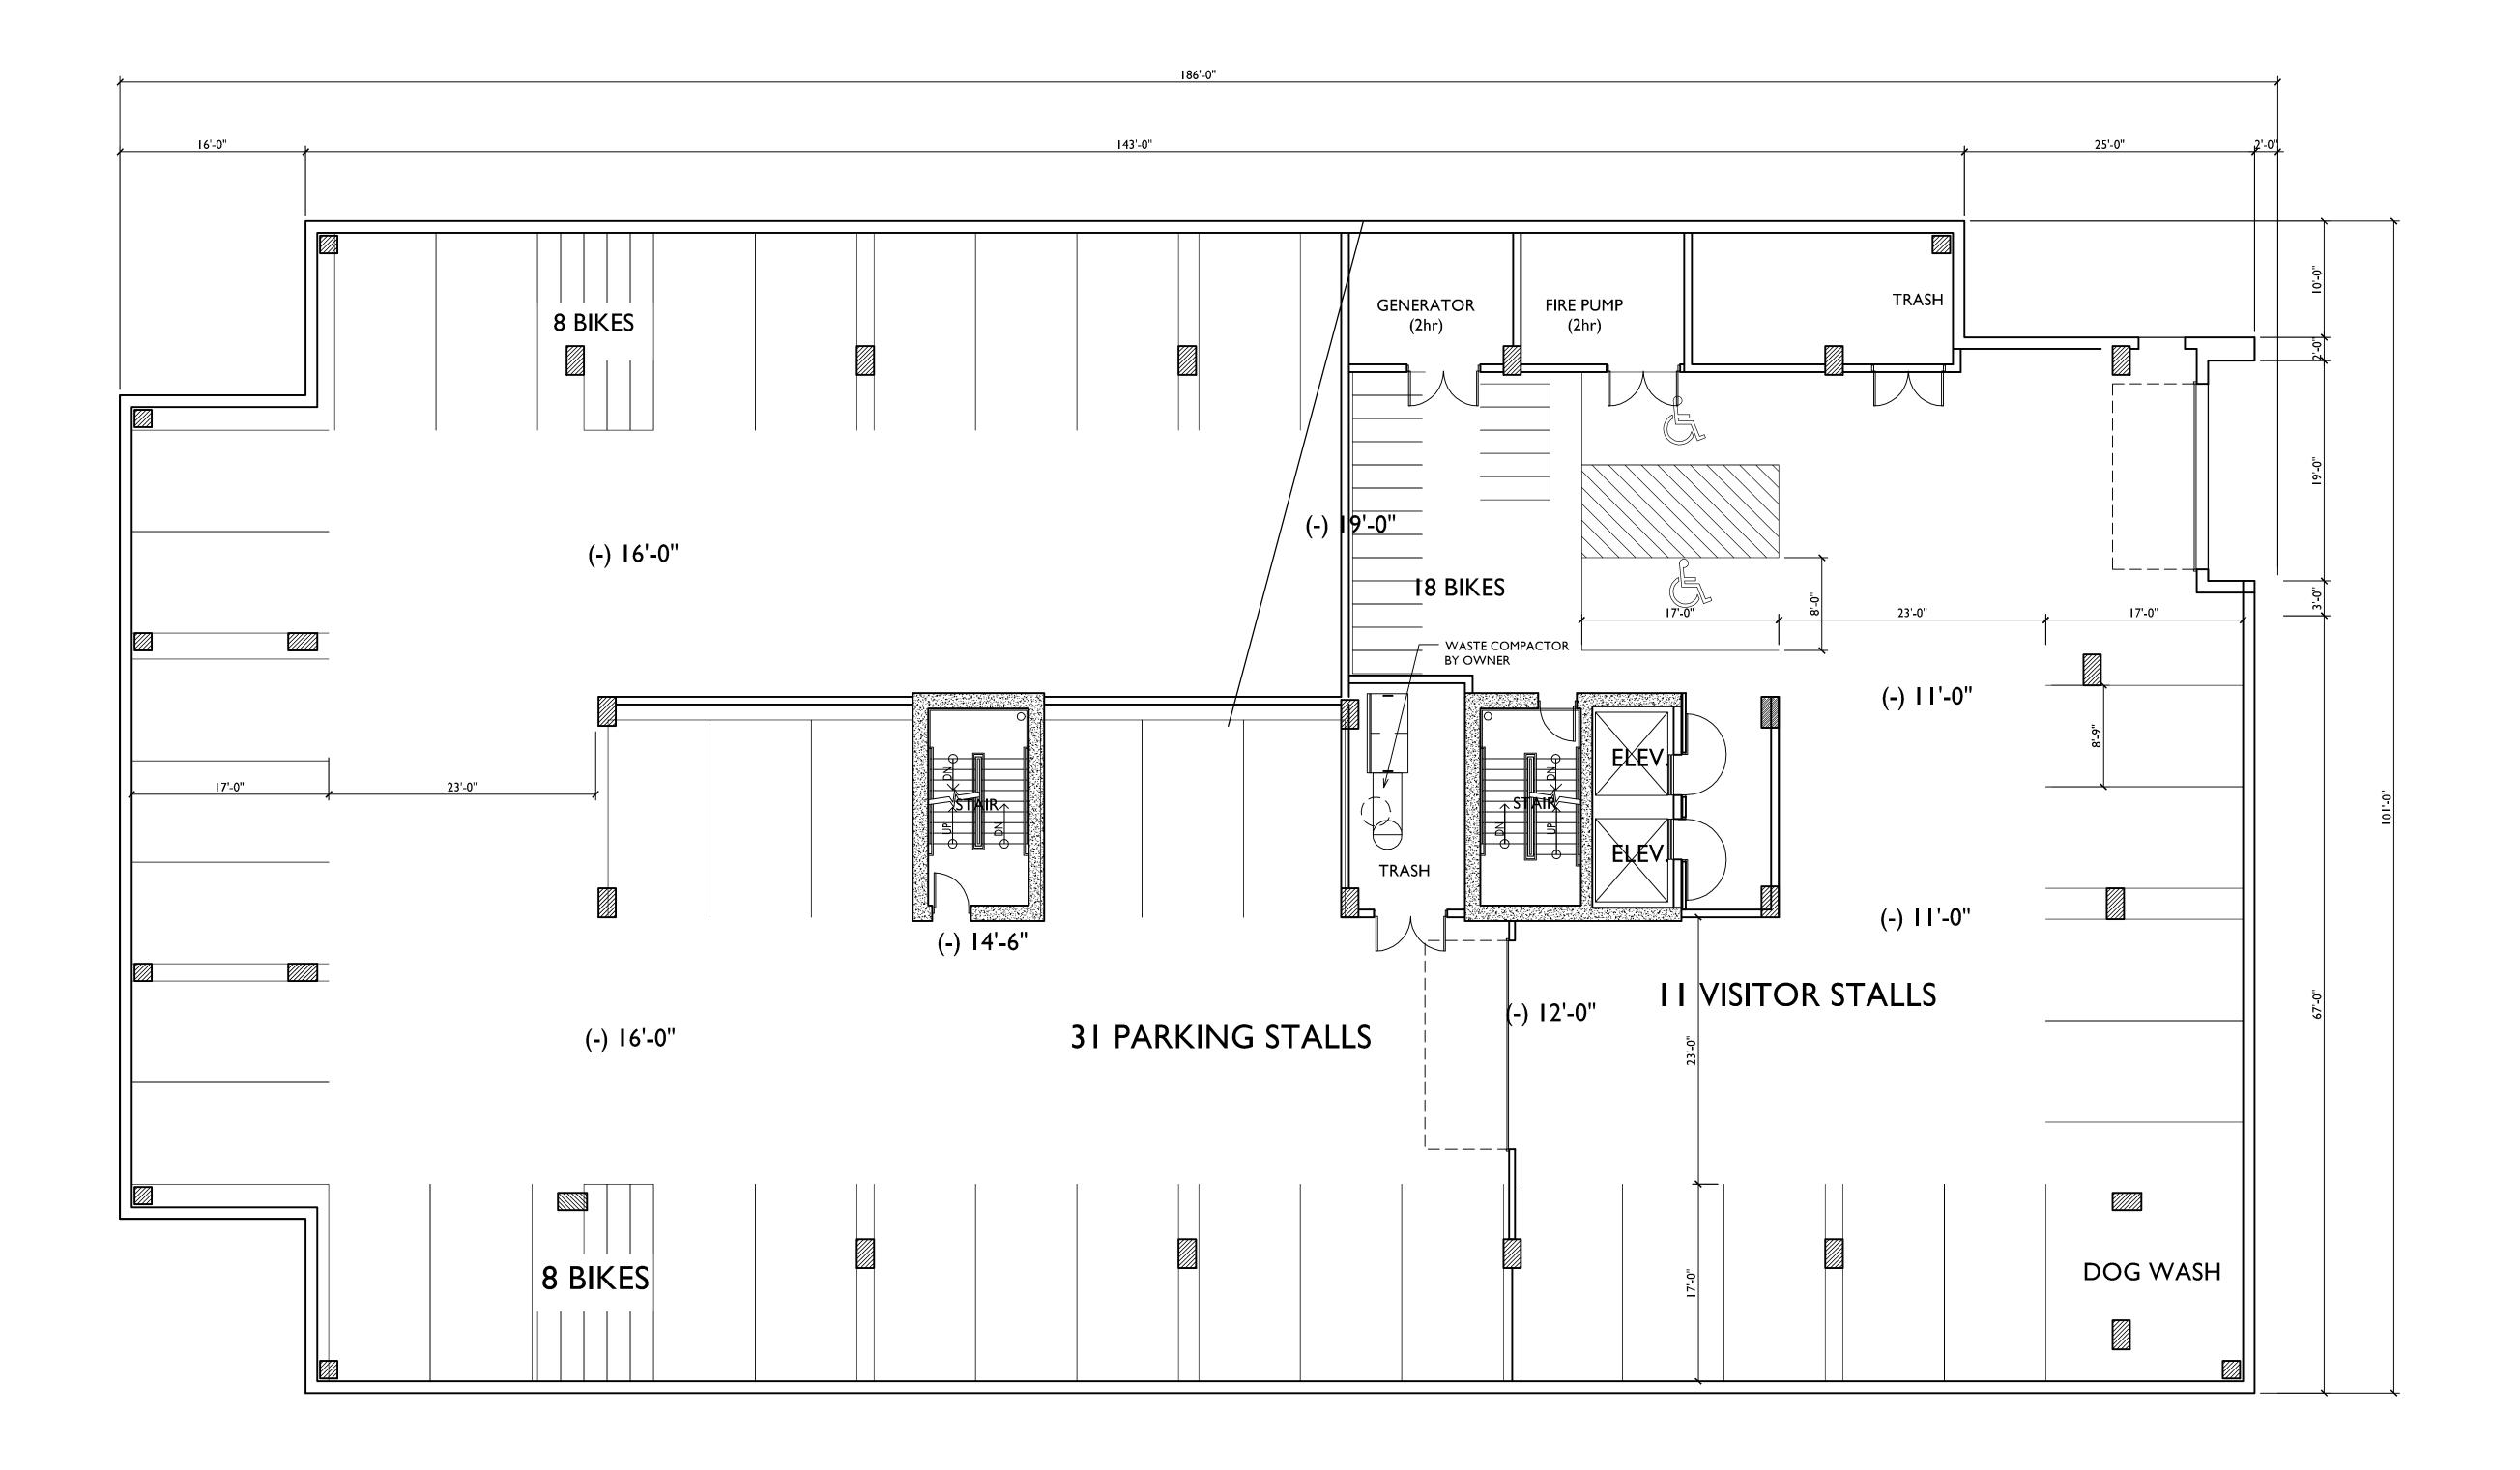



I PARKING LEVEL I A-P1.1 SCALE: 1/8"=1'-0"

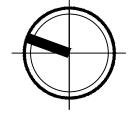


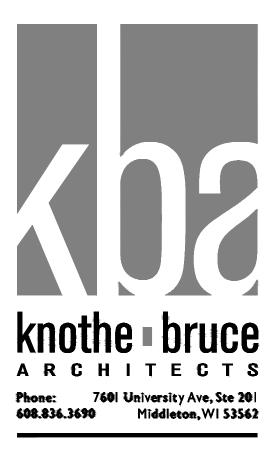


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# PROJECT TITLE 617 SEGOE RD


Madison, WI SHEET TITLE PARKING LEVEL I



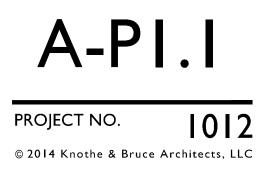


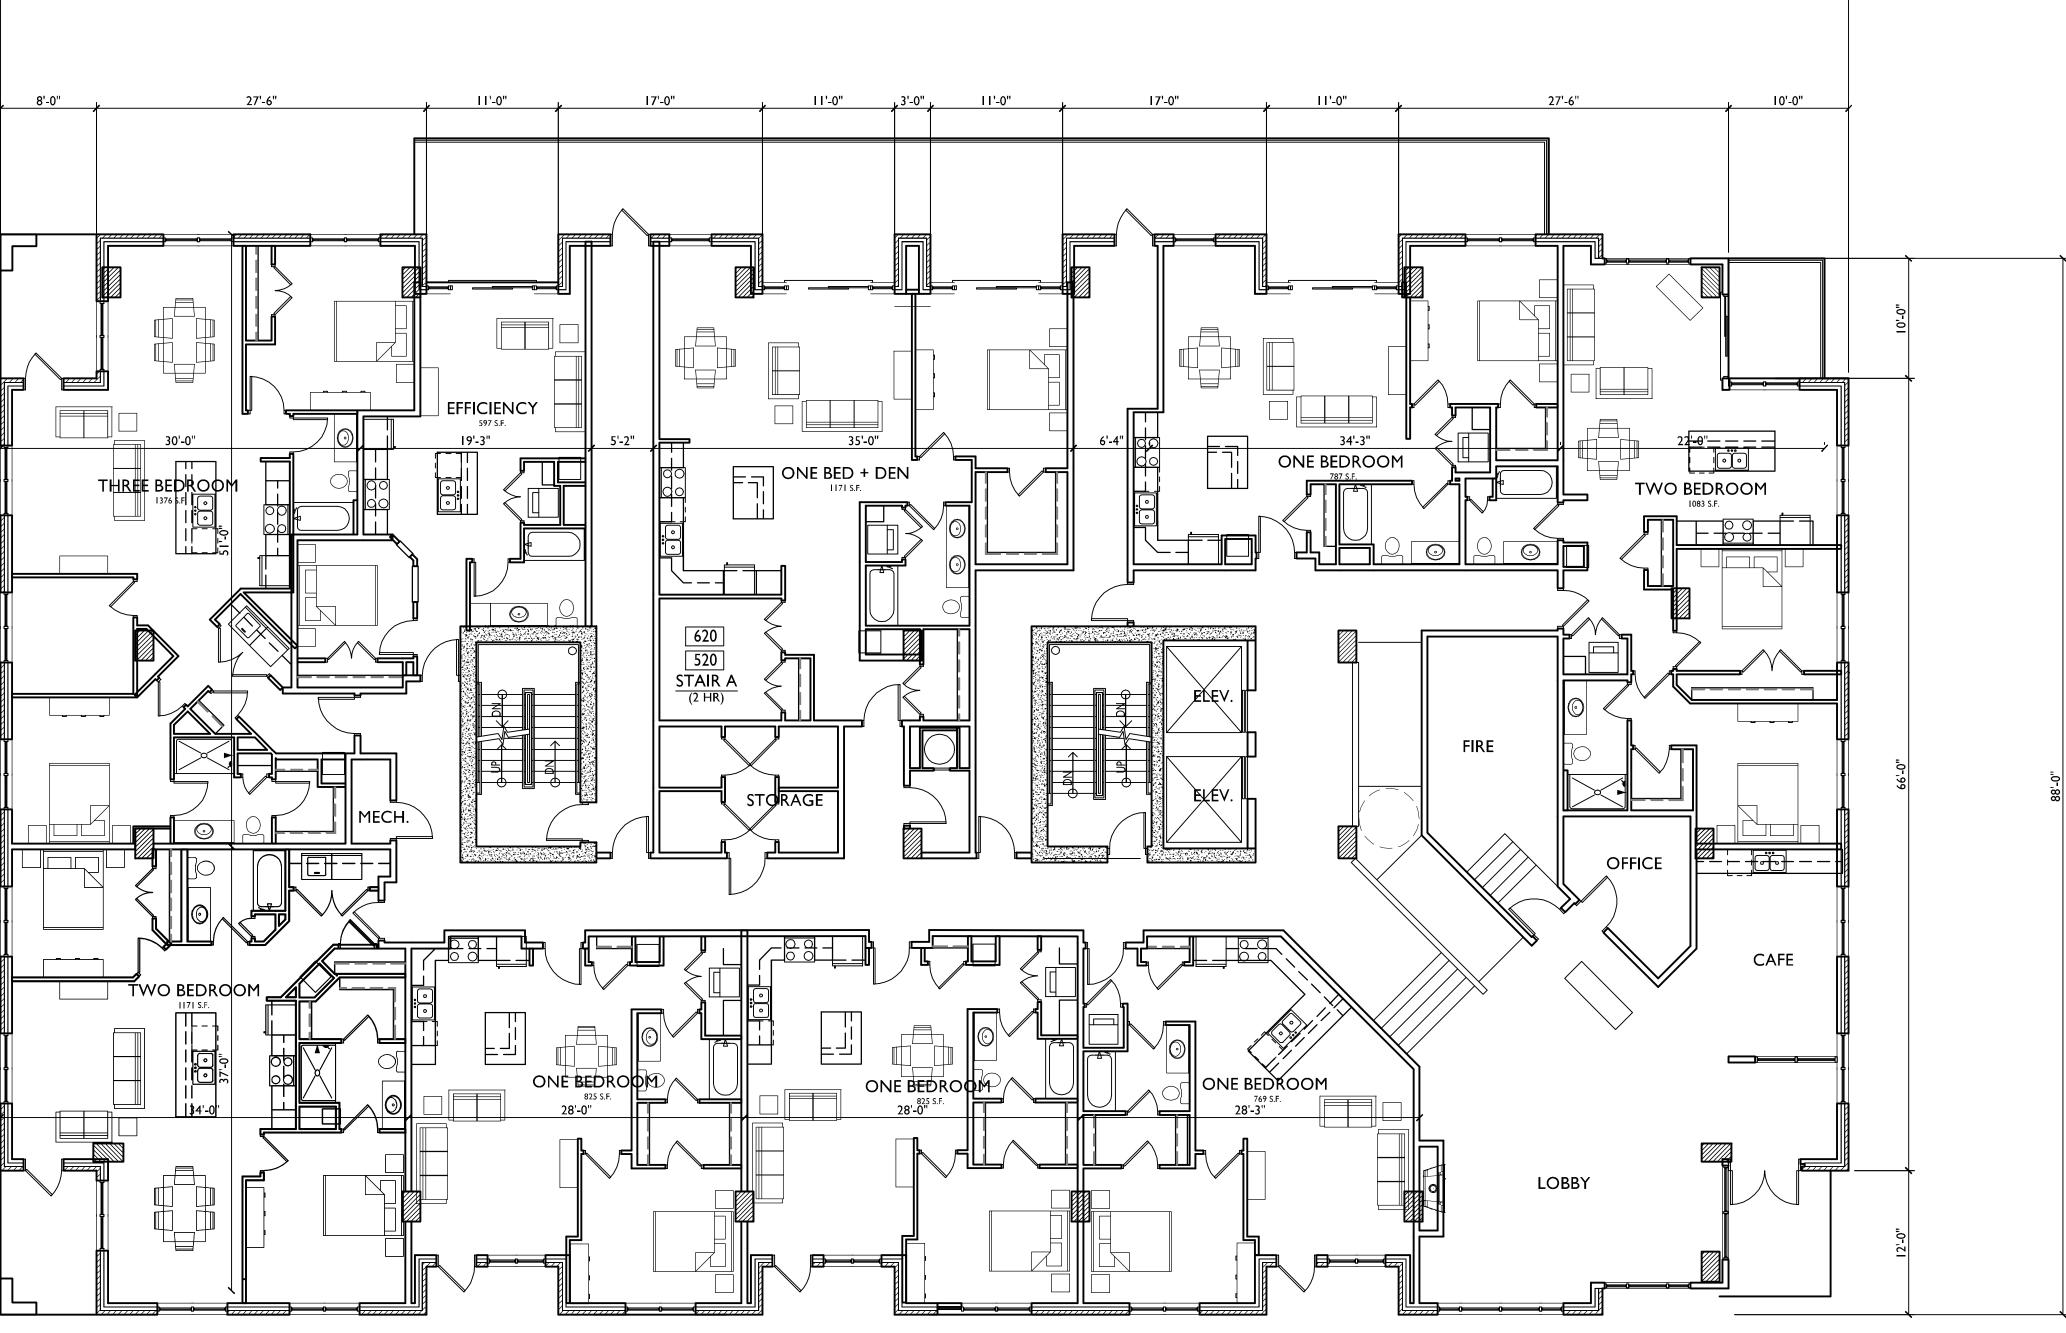

I FIRST FLOOR PLAN A-1.1 SCALE: 1/8"=1'-0"

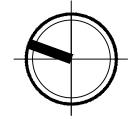

154'-0"

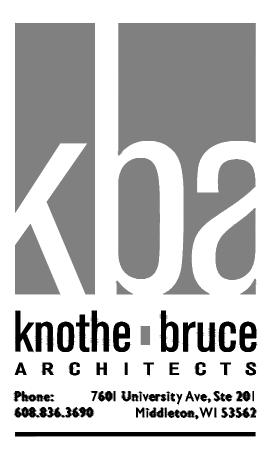


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# PROJECT TITLE 617 SEGOE RD


Madison, WI sheet title FIRST FLOOR PLAN

A-1.1 PROJECT NO. 1012 © 2014 Knothe & Bruce Architects, LLC



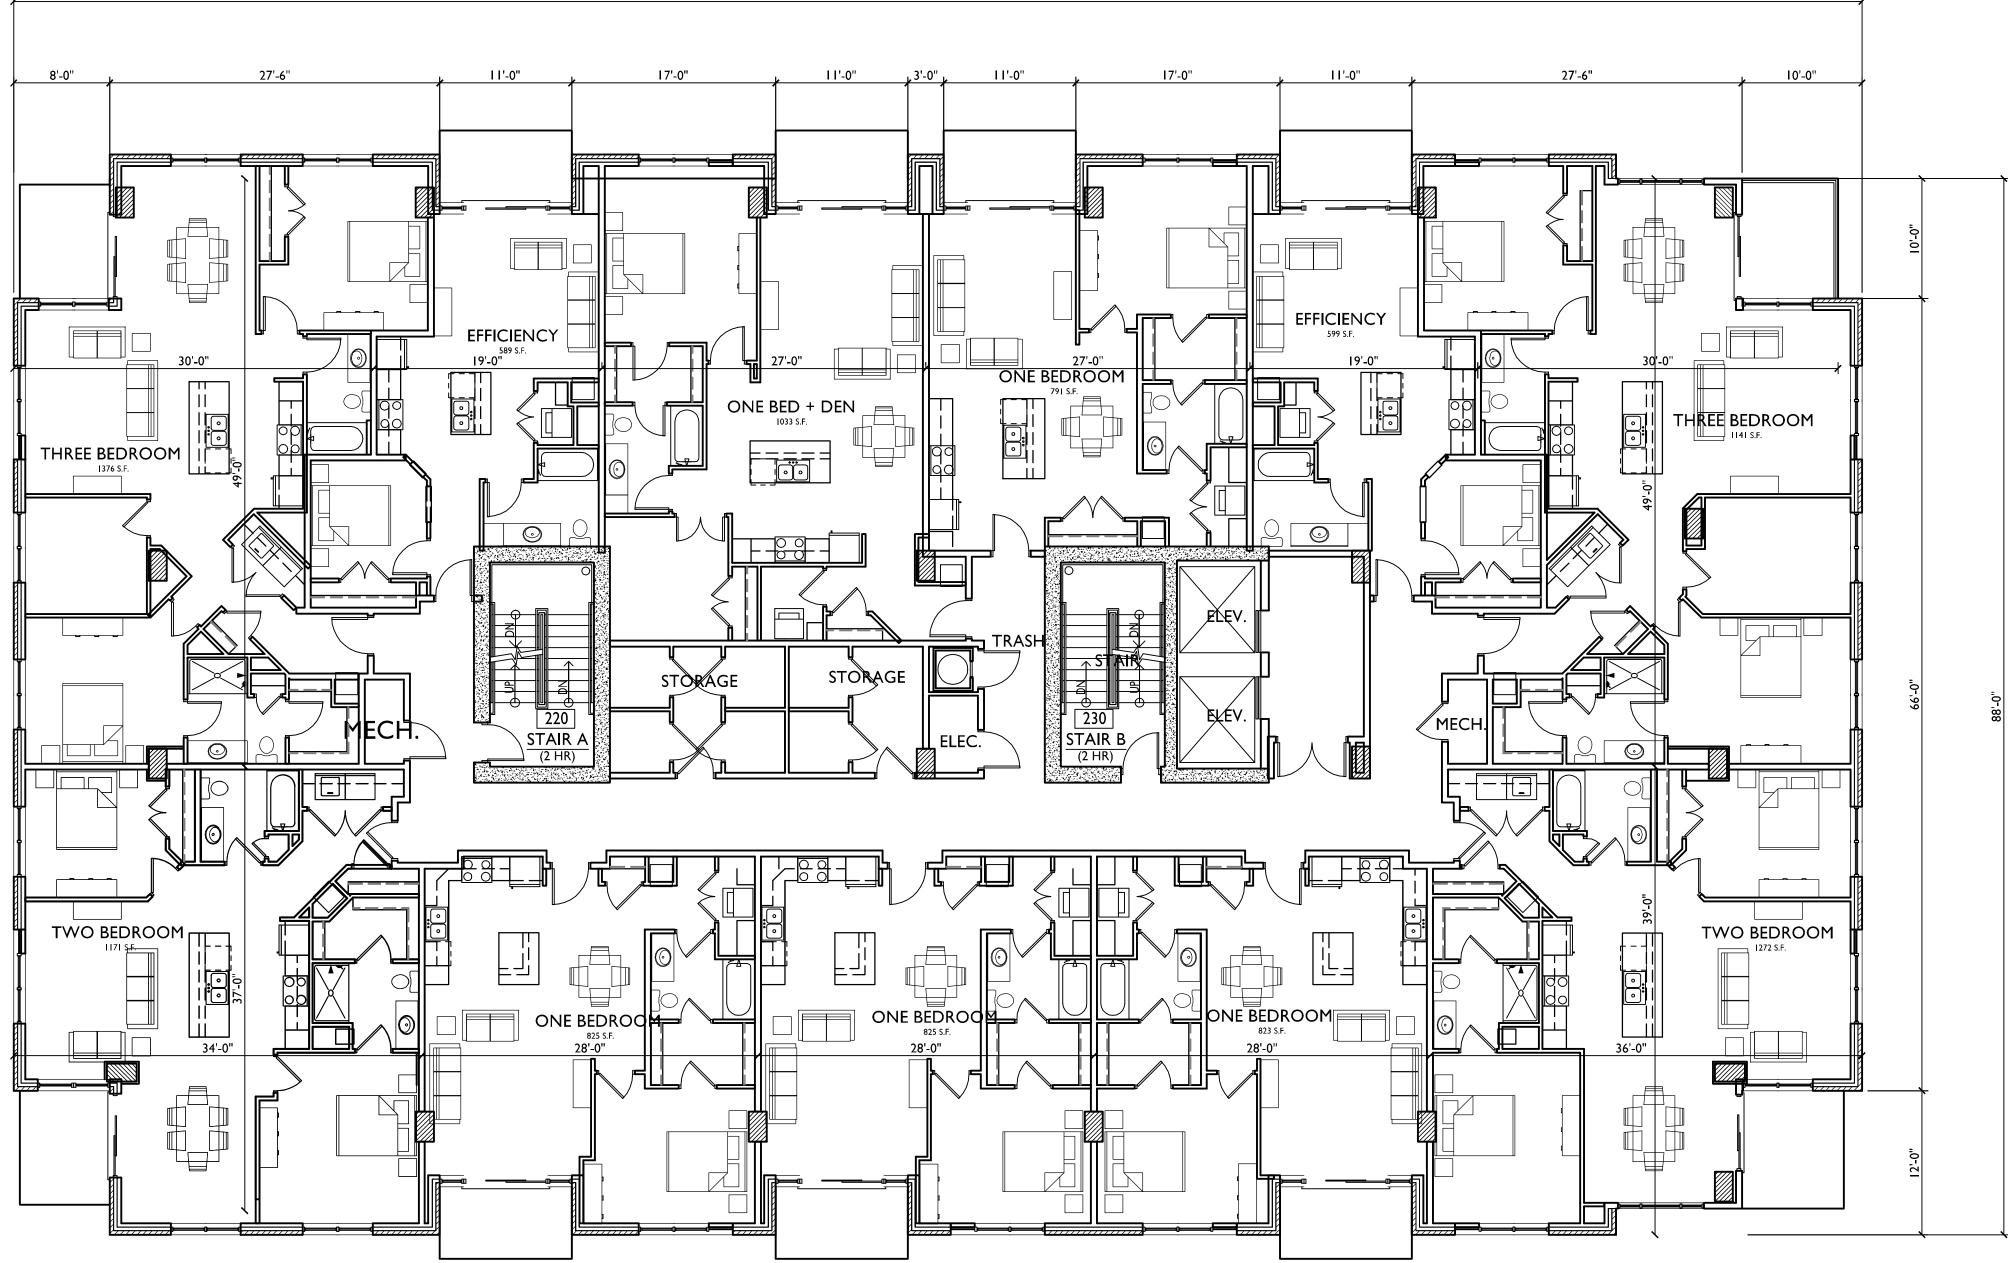

154'-0"

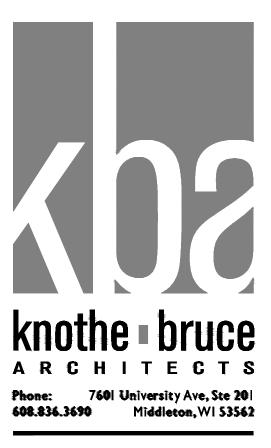

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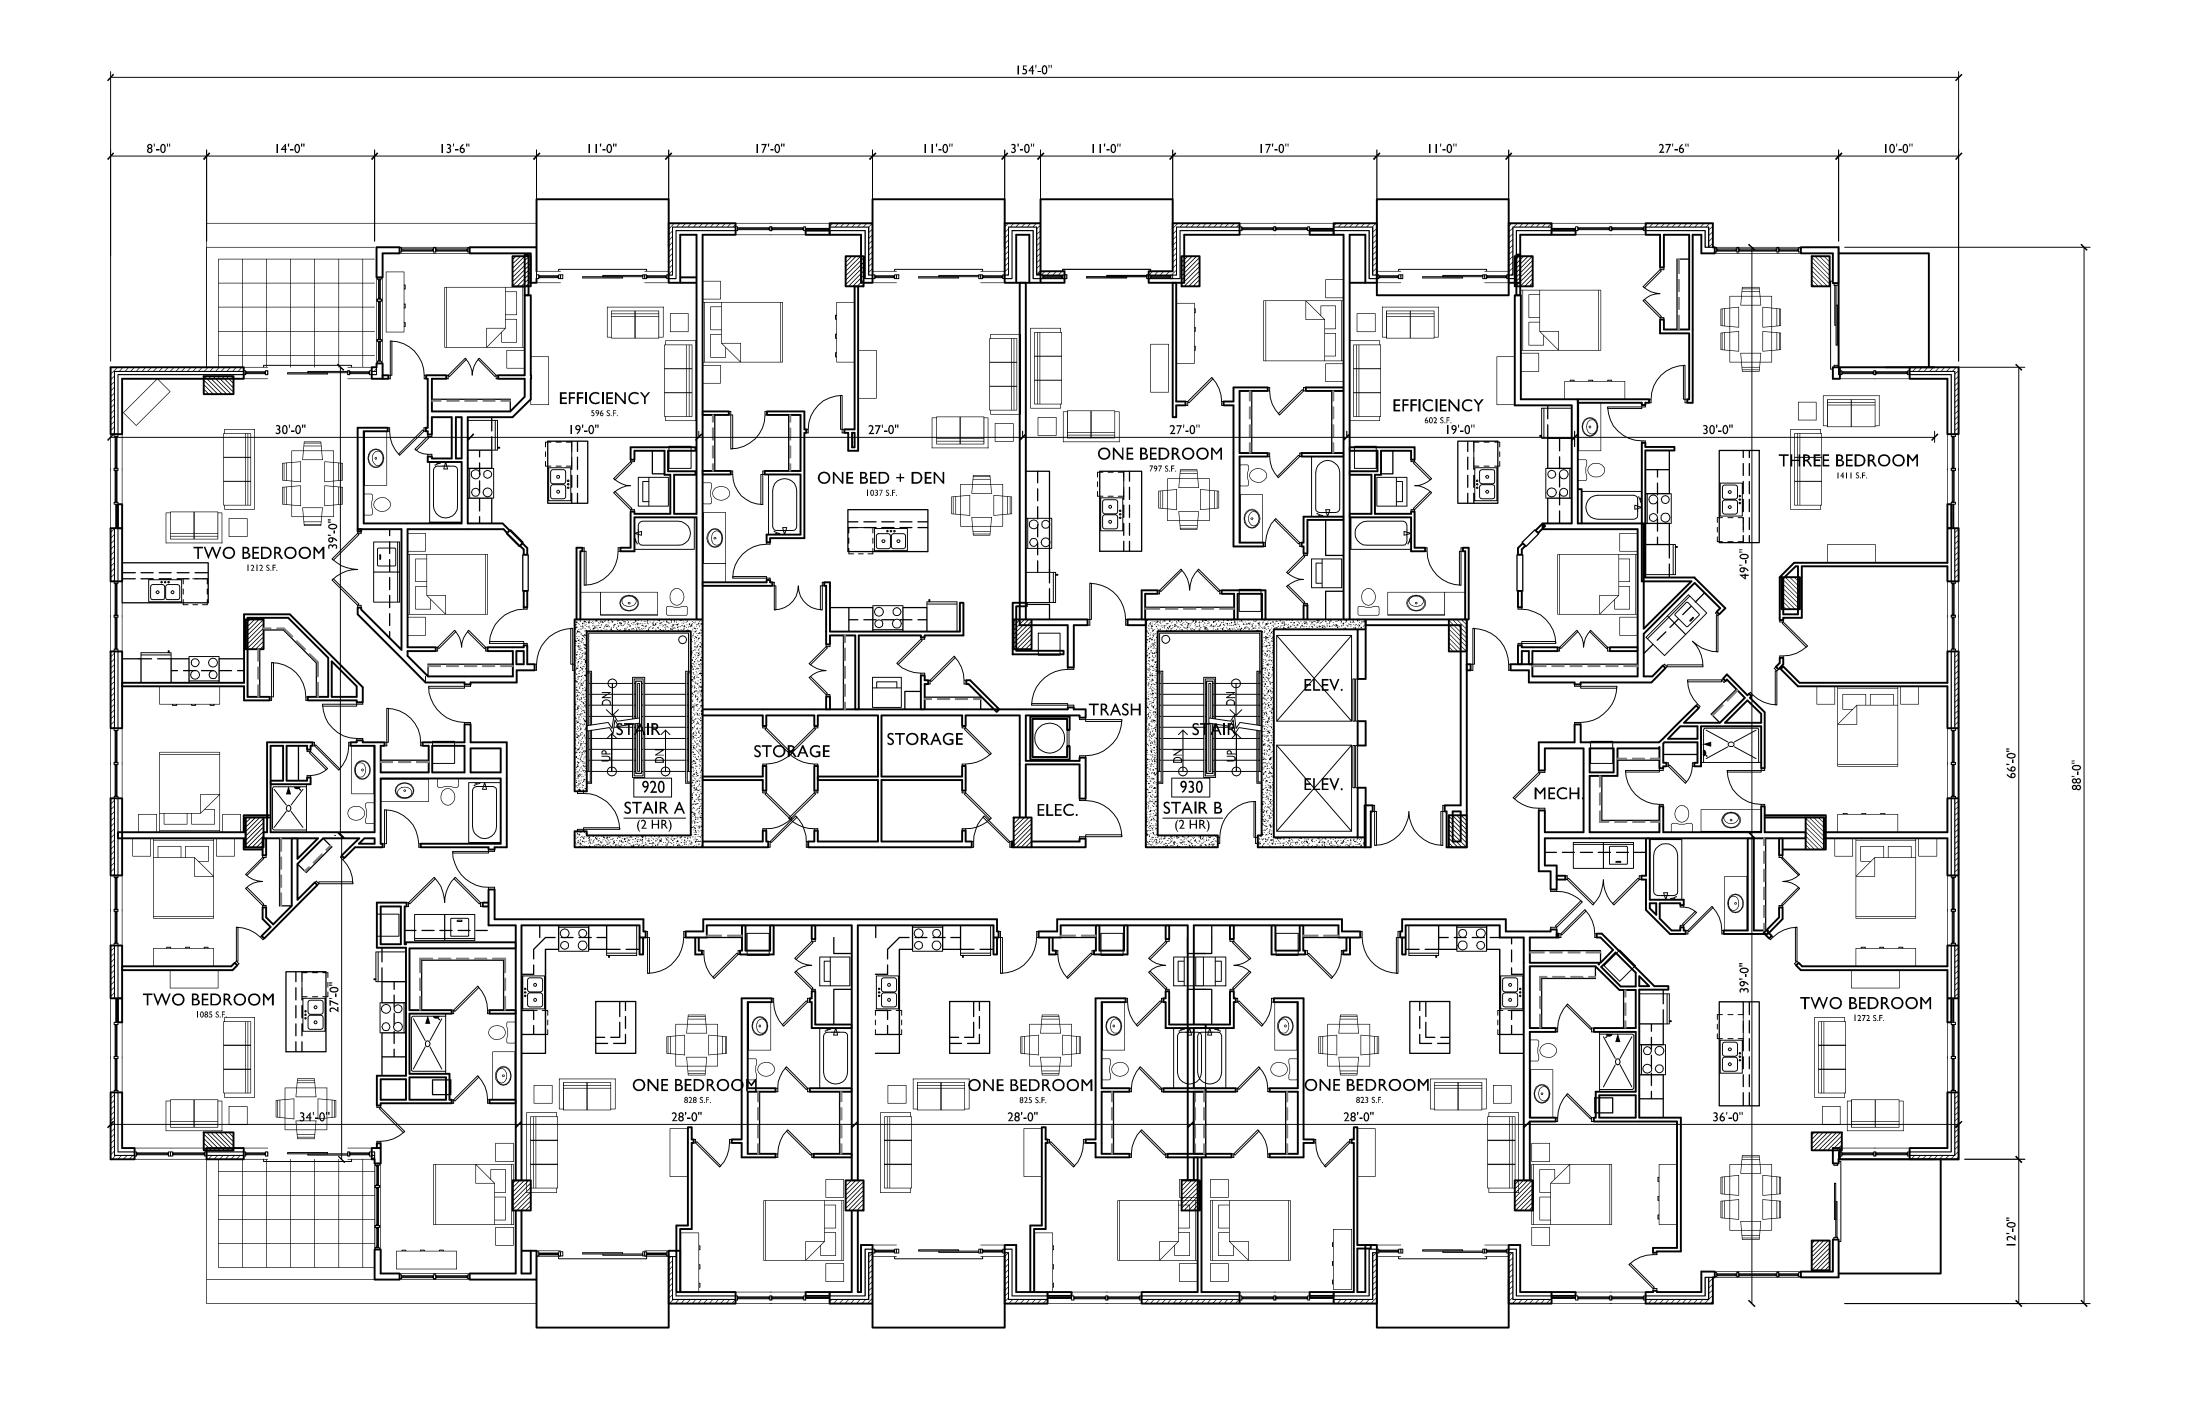
# PROJECT TITLE 617 SEGOE RD

Madison, WI SHEET TITLE SECOND-EIGHTH FLOOR PLAN

SHEET NUMBER


A-1.3 PROJECT NO. 1012


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I NINTH FLOOR PLAN A-1.3 SCALE: 1/8"=1'-0"





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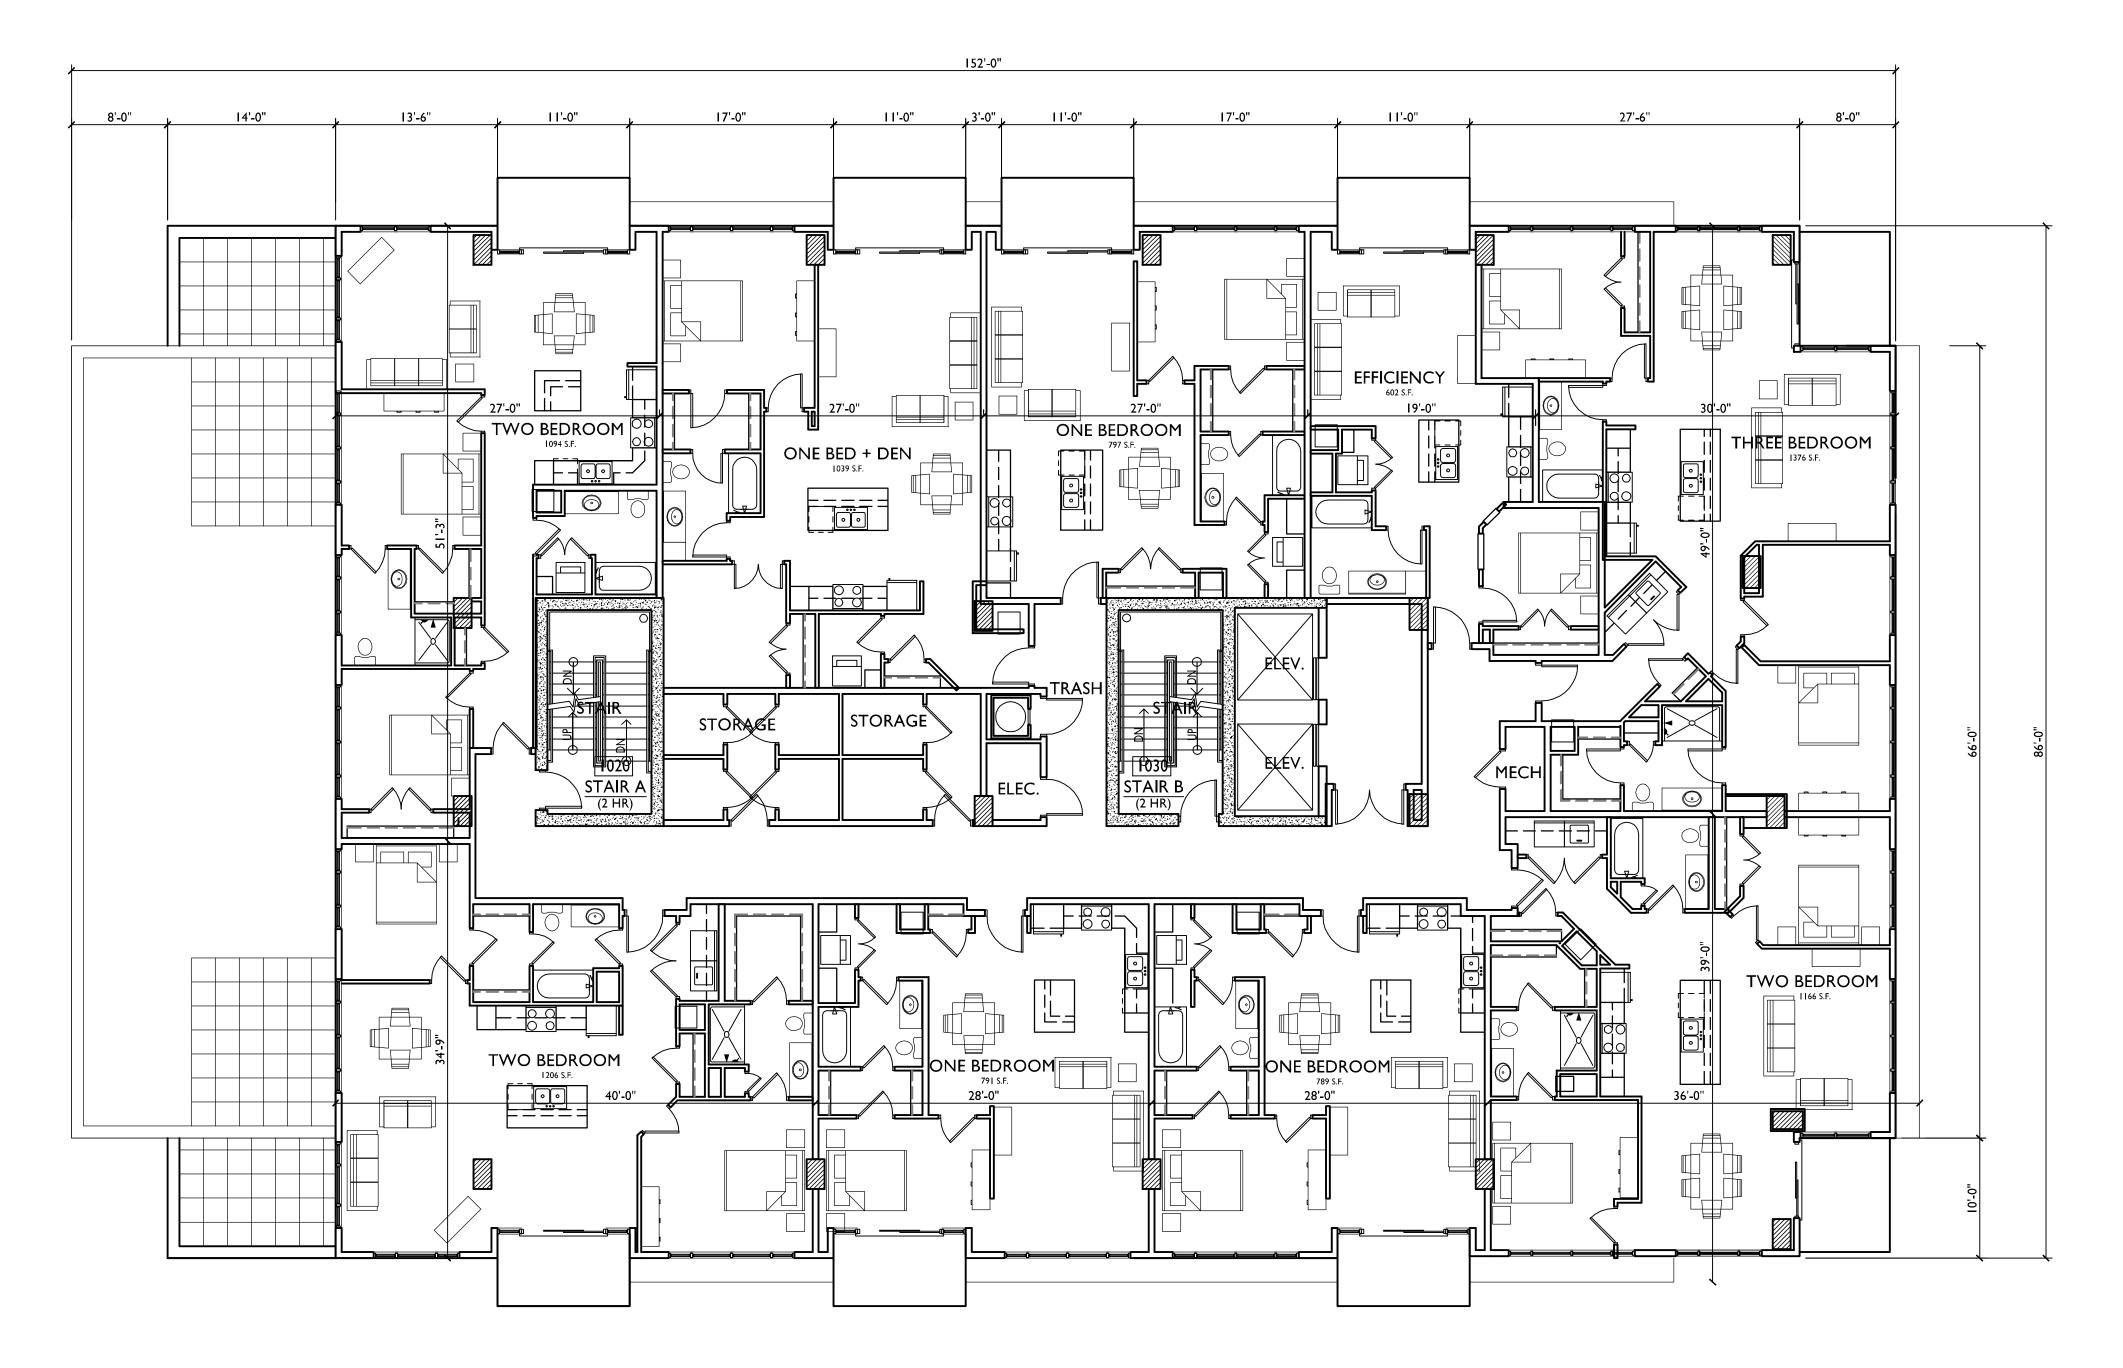
# PROJECT TITLE 617 SEGOE RD

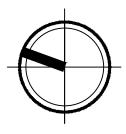Madison, WI SHEET TITLE NINTH FLOOR PLAN

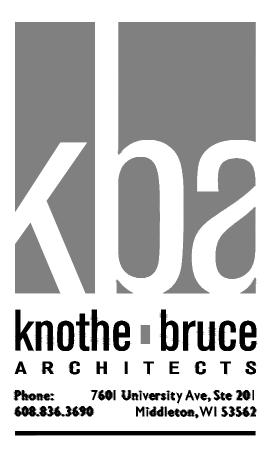SHEET NUMBER


A-1.3 PROJECT NO. 1012


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# I TENTH & ELEVENTH FLOOR PLAN SCALE: 1/8"=1'-0"






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# PROJECT TITLE 617 SEGOE RD

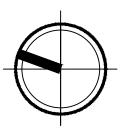Madison, WI sheet title TENTH & ELEVENTH FLOOR PLAN

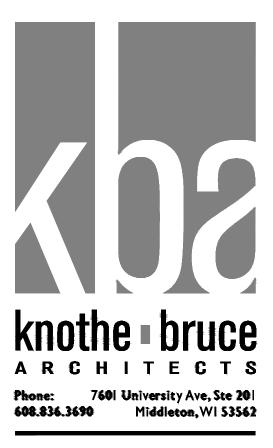
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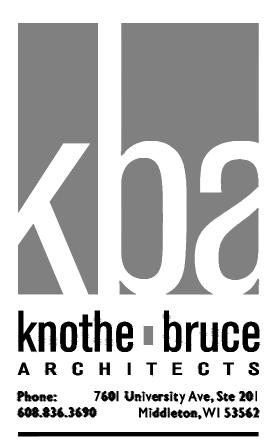
A-1.4



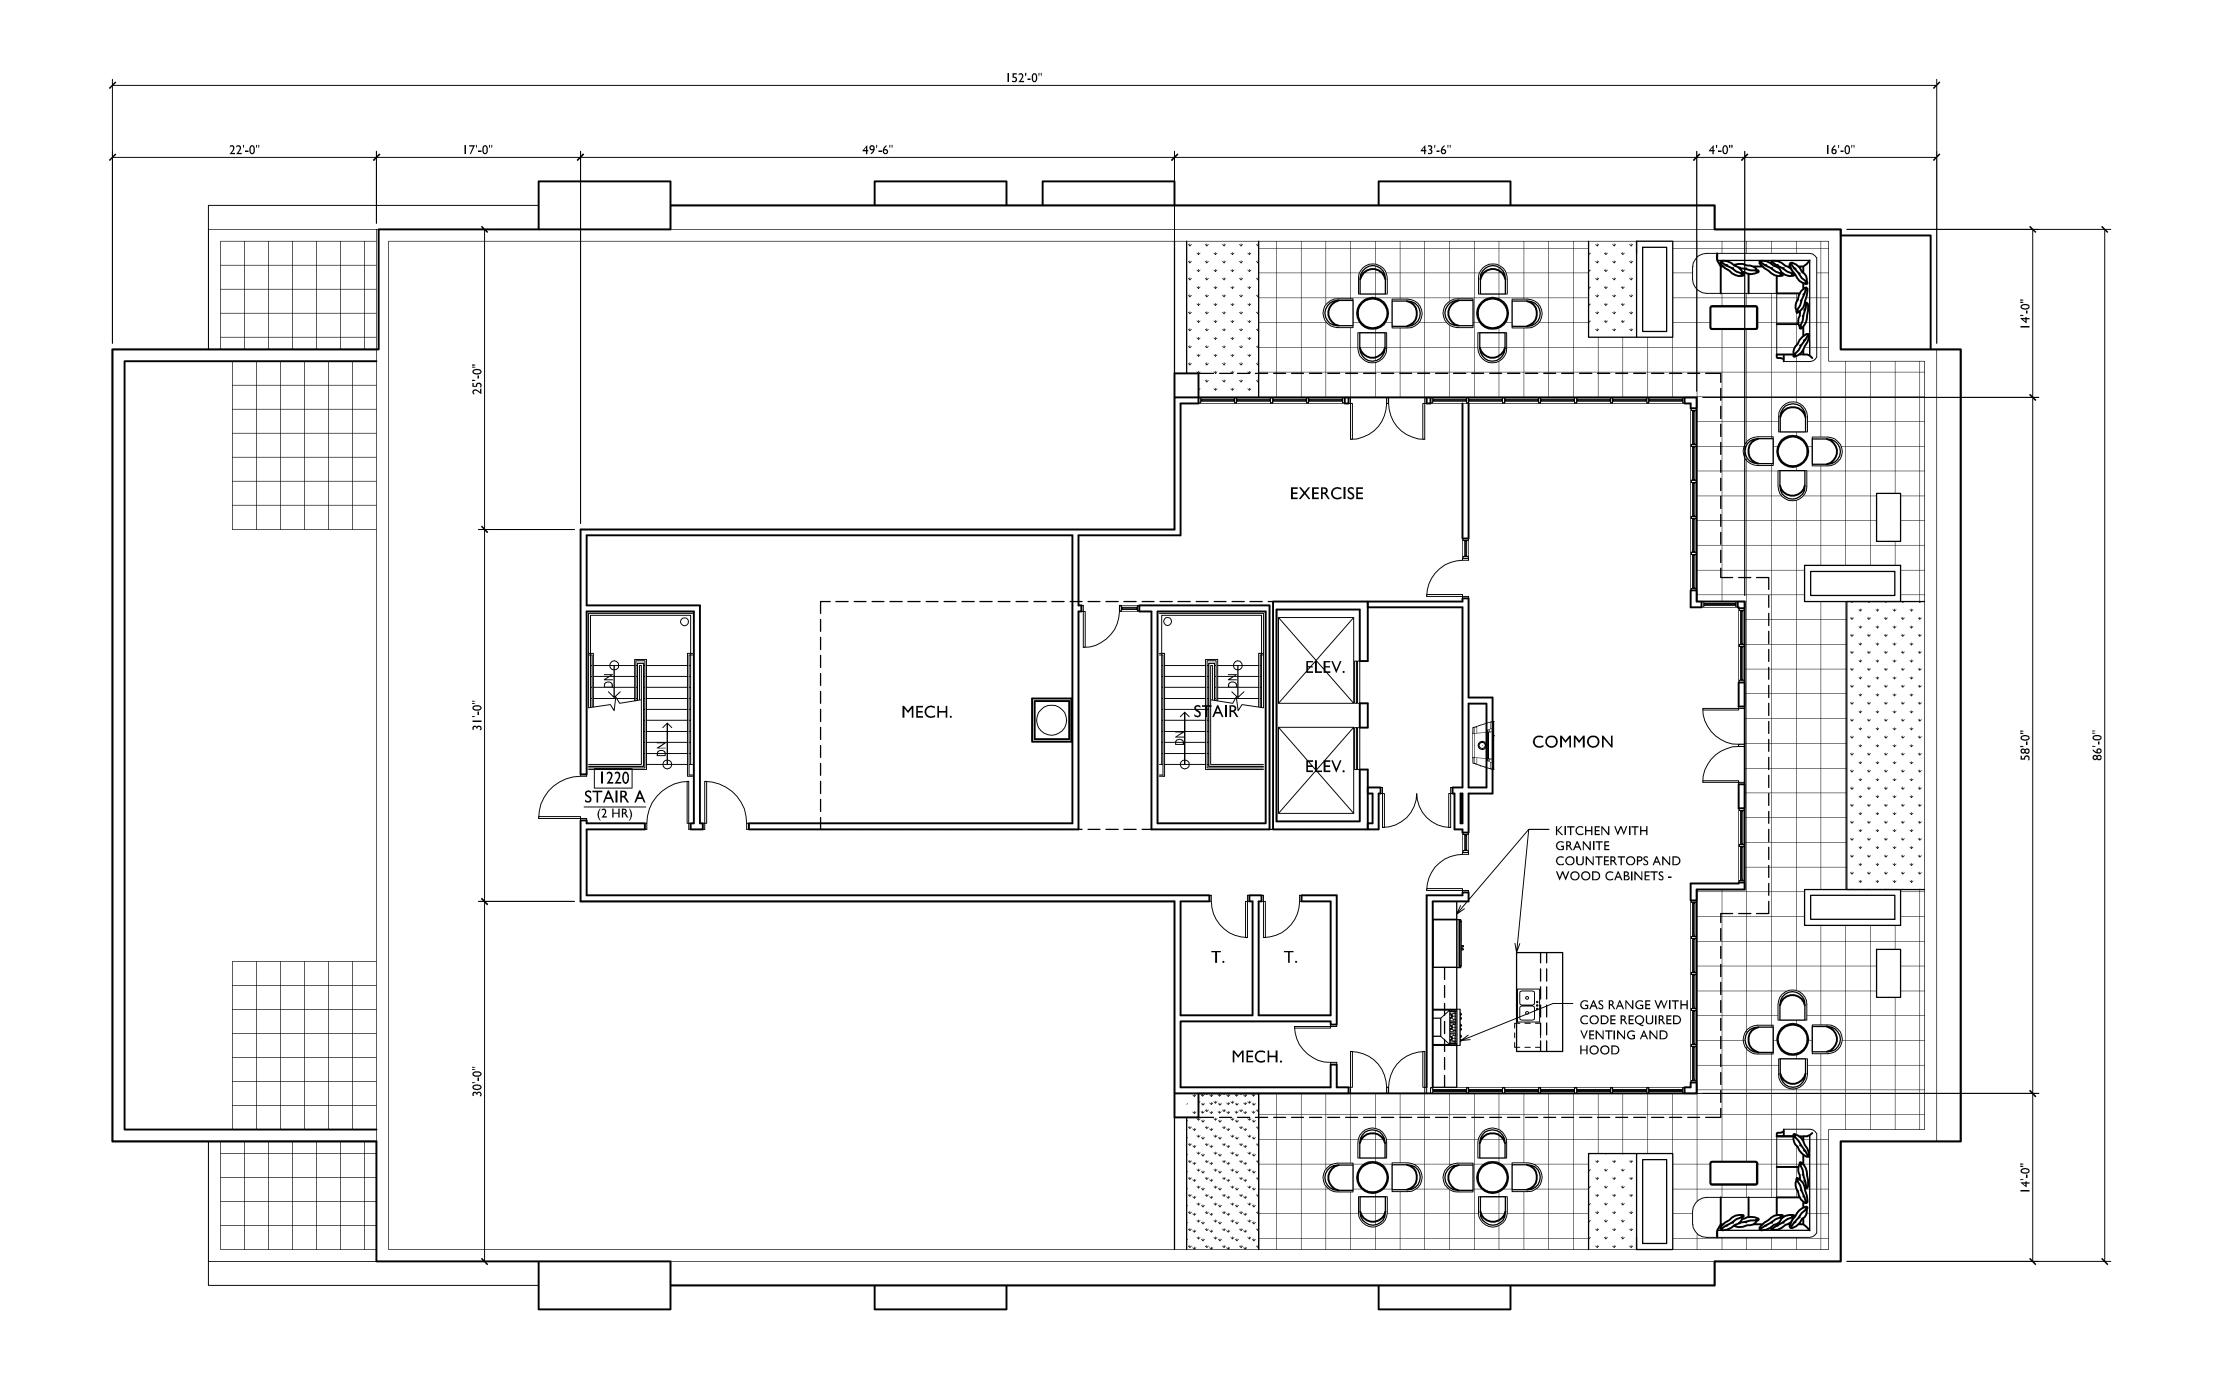

I PENTHOUSE PLAN A-1.5 SCALE: 1/8"=1'-0"



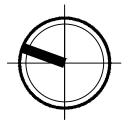

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# PROJECT TITLE 617 SEGOE RD


Madison, WI sheet title PENTHOUSE PLAN

SHEET NUMBER

A-1.5 PROJECT NO. 1012

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SEGOE ROAD ELEVATION

A-2.1 SCALE: 1/8"=1'-0"

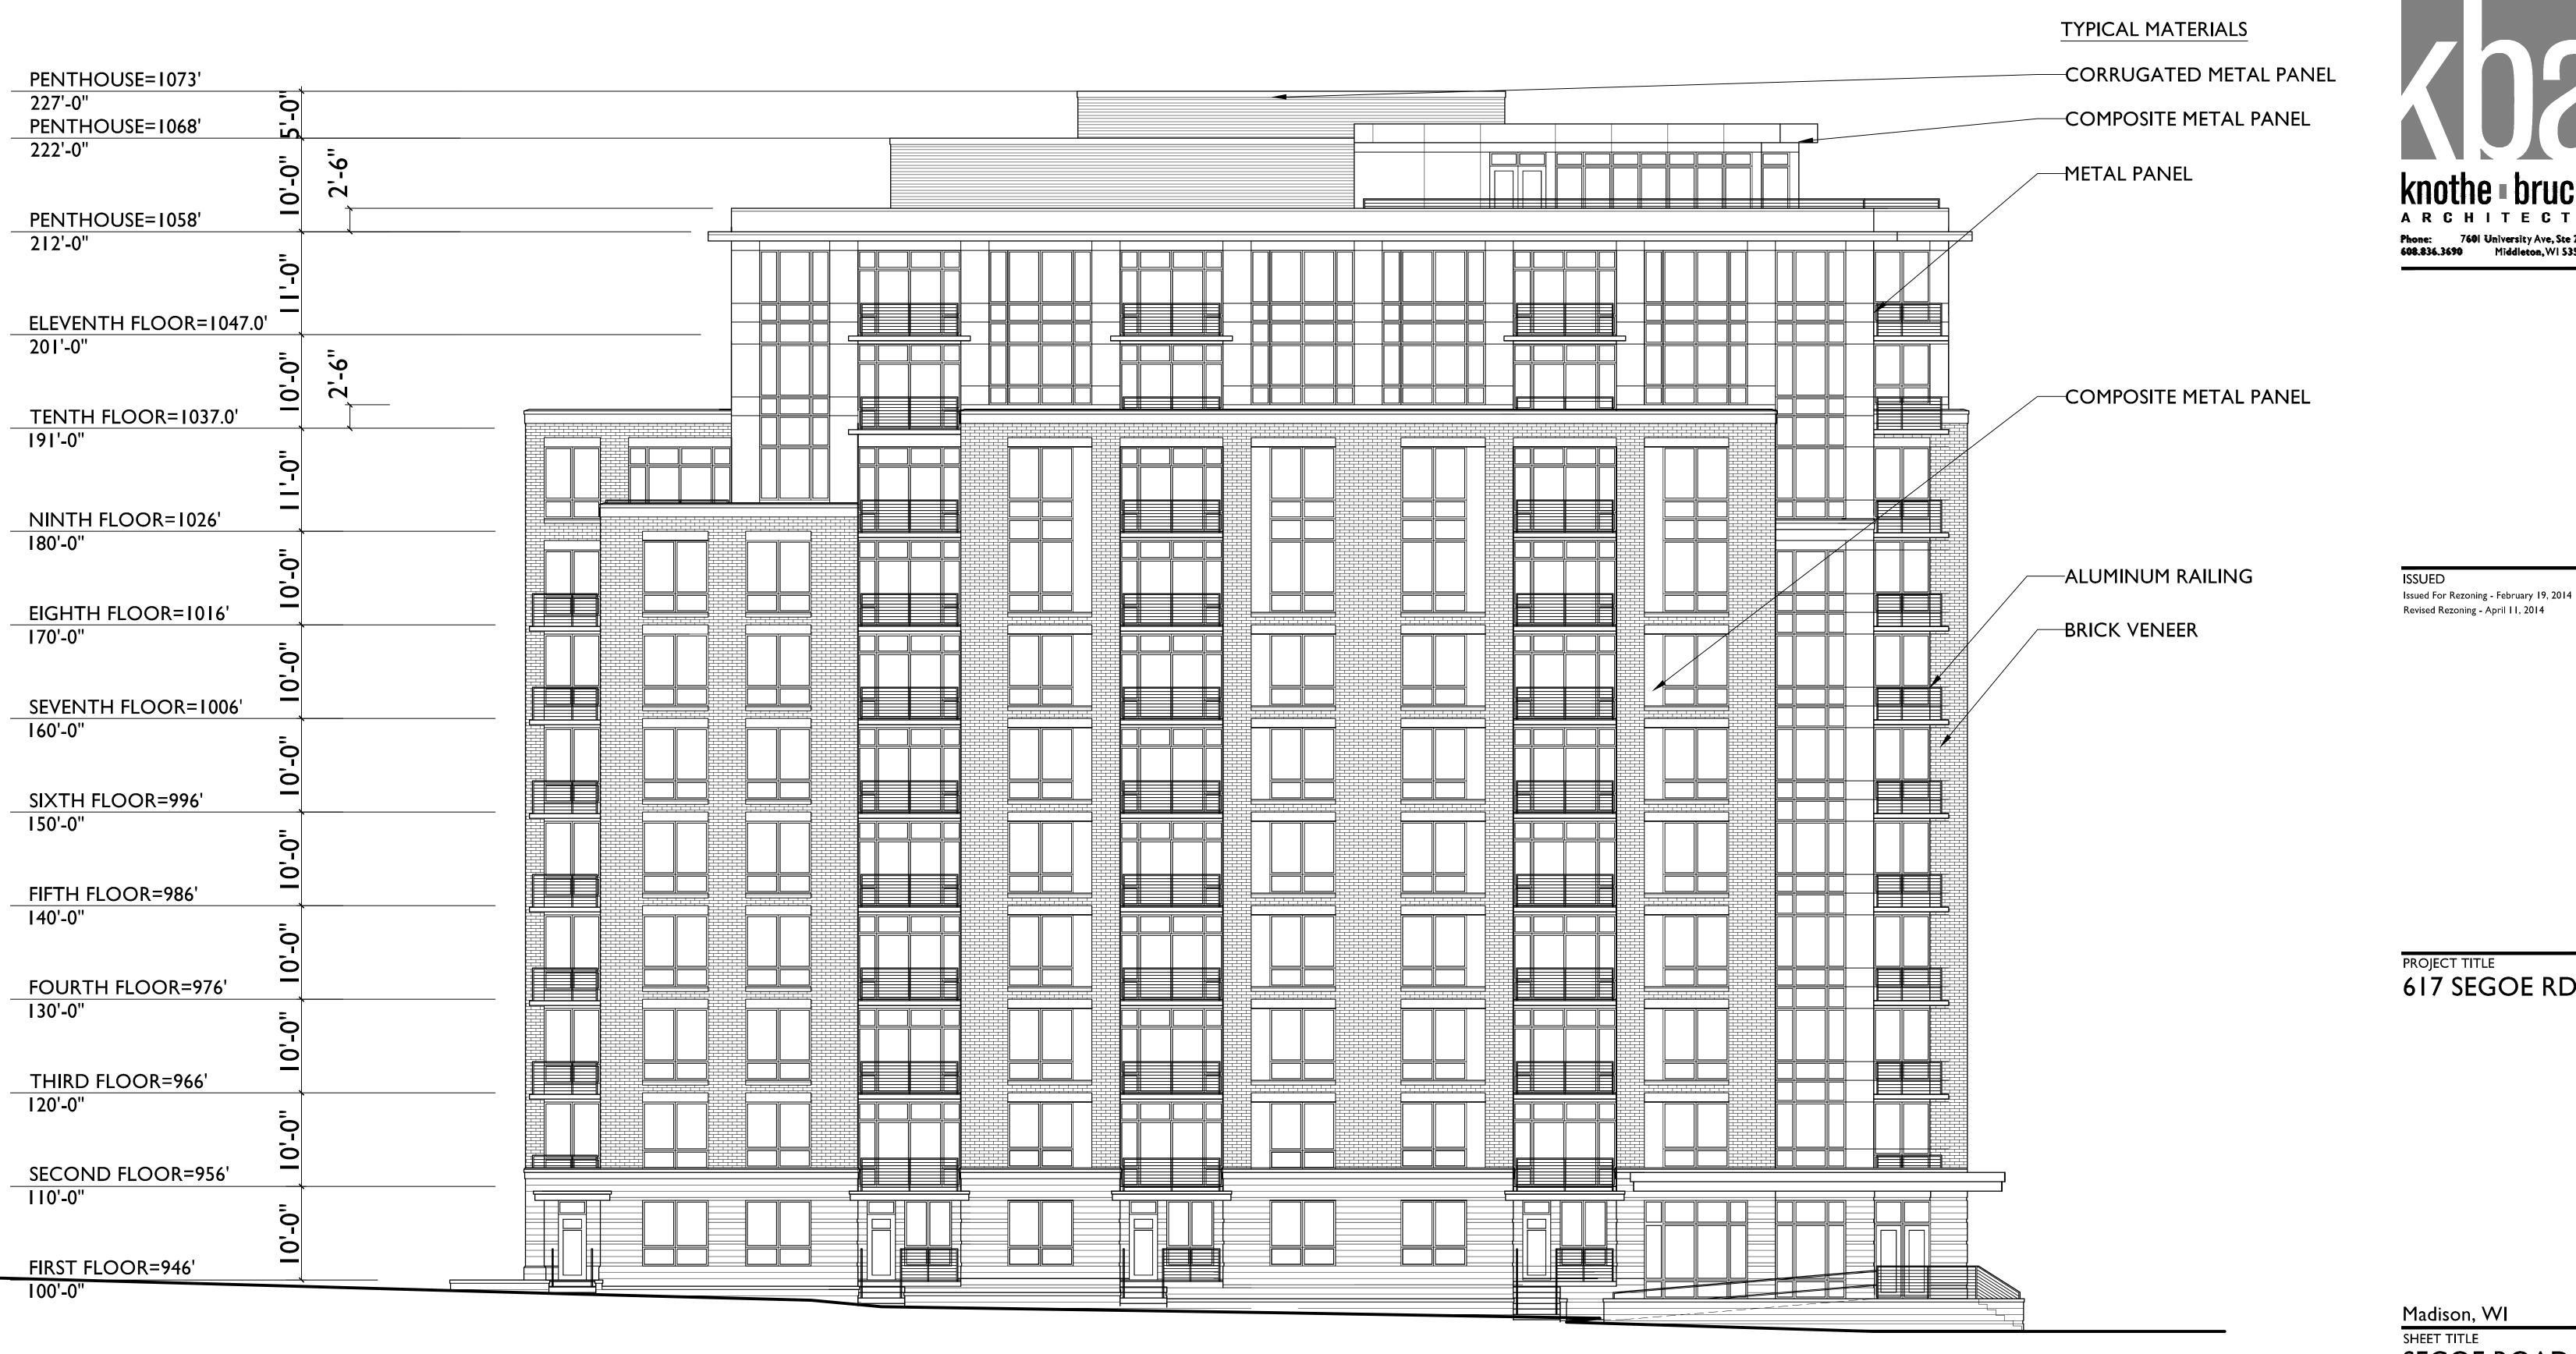
knothe • bruce ARCHITECTS 760 University Ave, Ste 20 608.836.3690 Middleton, WI 53562

PROJECT TITLE 617 SEGOE RD

Madison, WI SHEET TITLE SEGOE ROAD ELEVATION


SHEET NUMBER

A-2.1

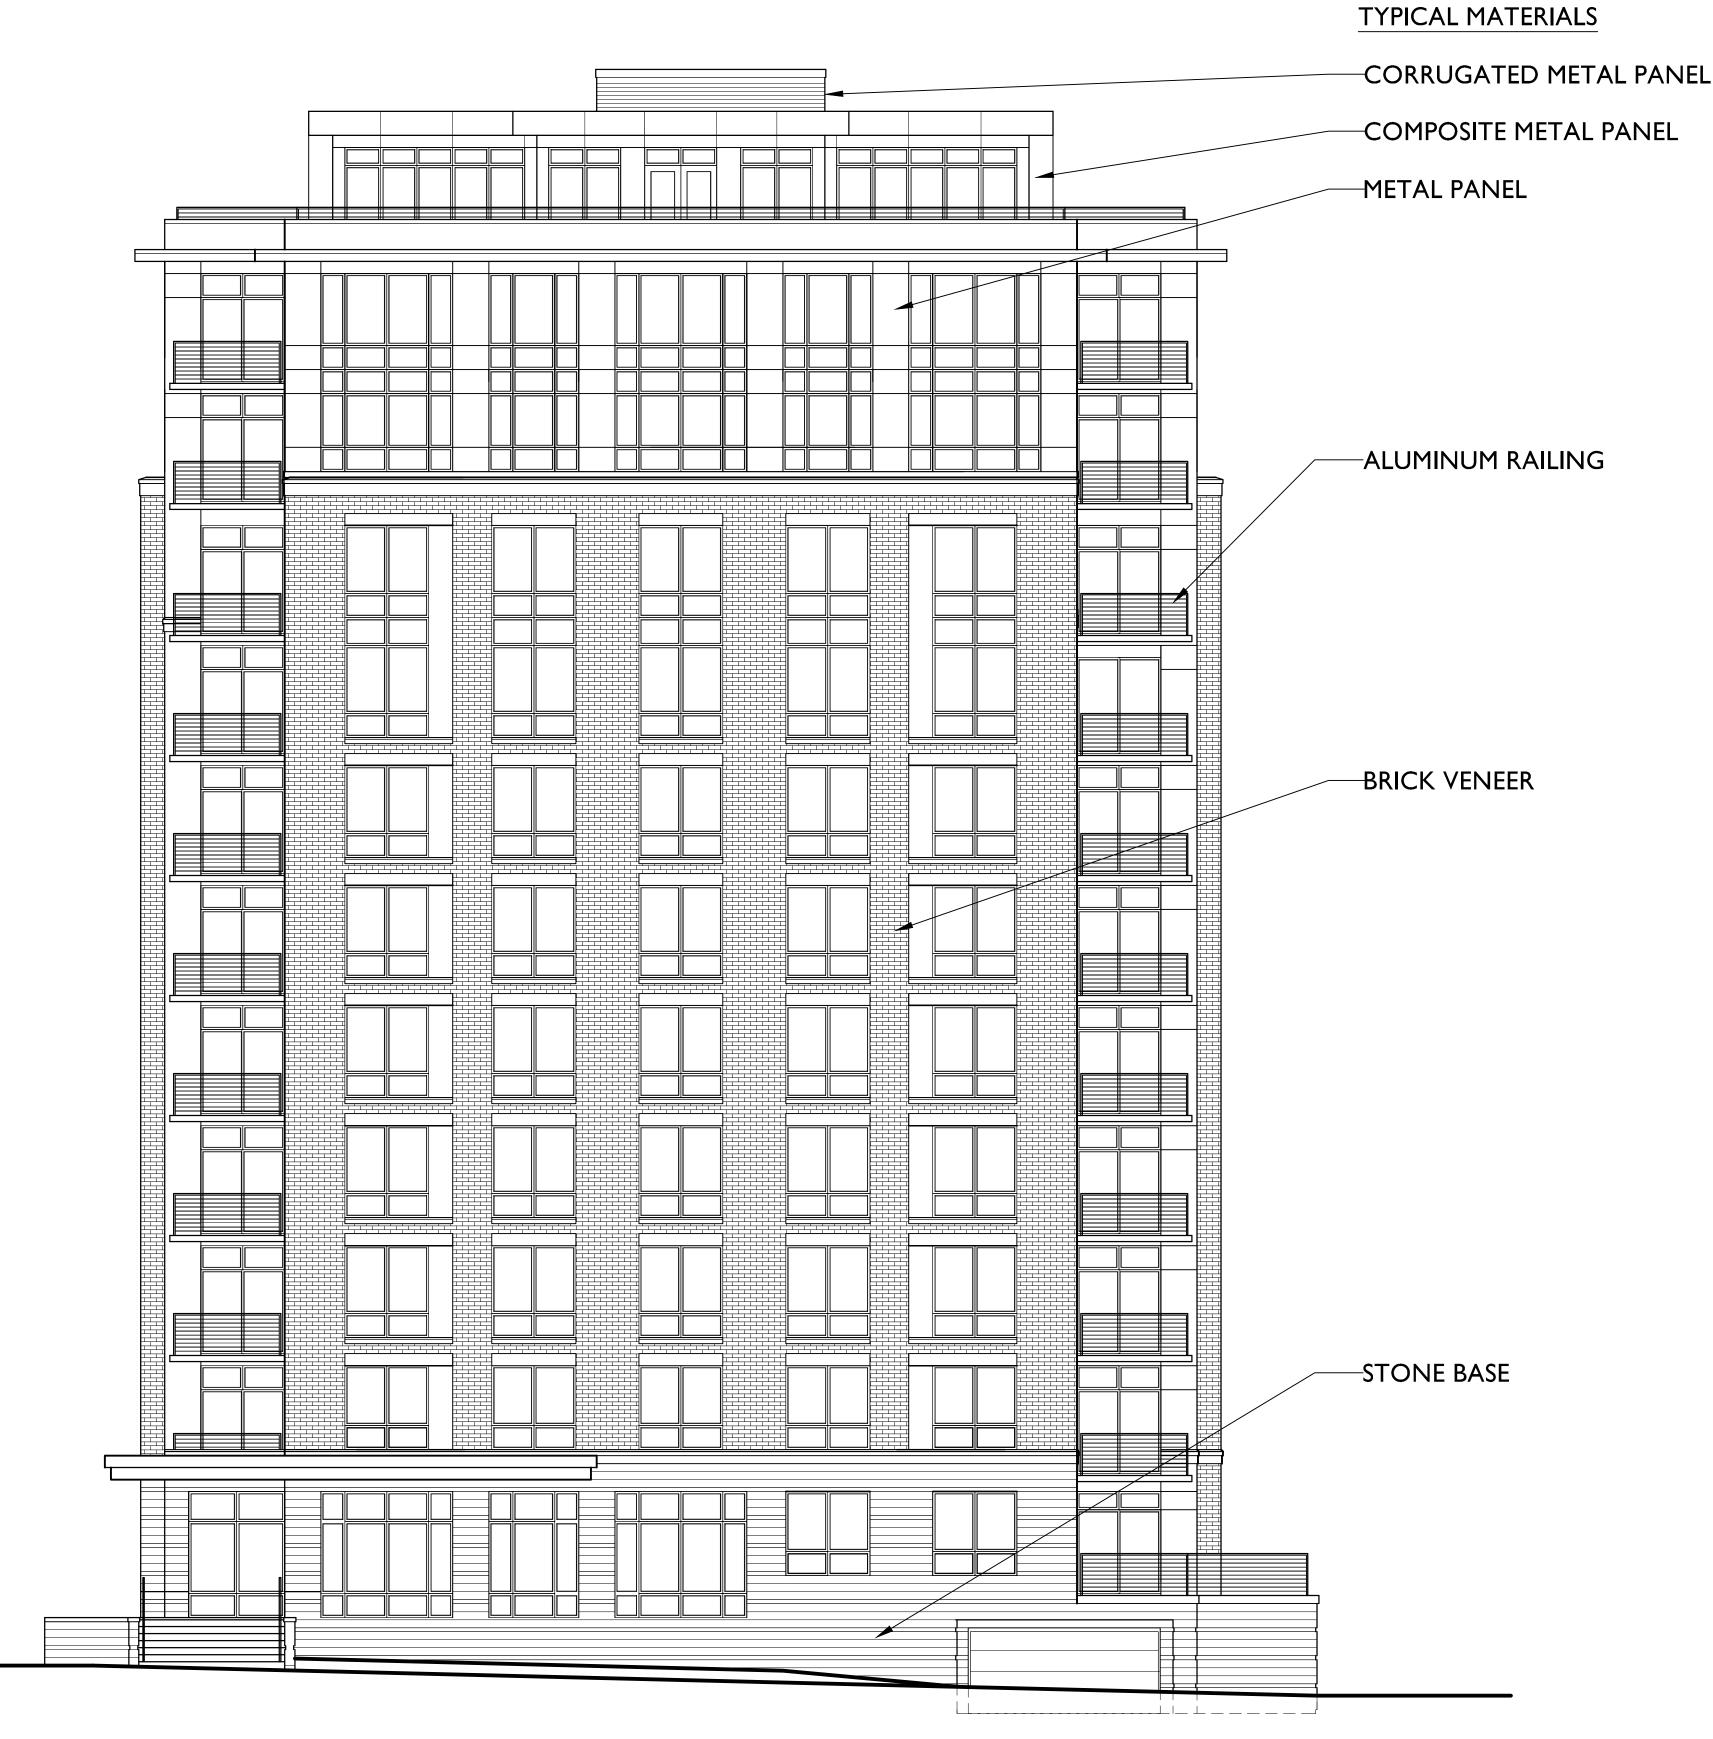



I SOUTH ELEVATION A-2.2 SCALE: 1/8"=1'-0"

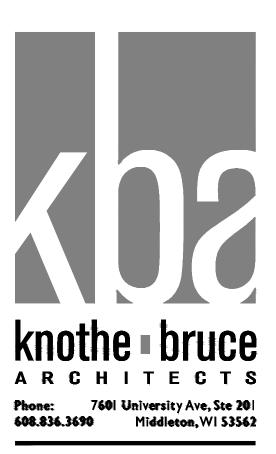

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# PROJECT TITLE 617 SEGOE RD

Madison, WI sheet title SOUTH ELEVATION

SHEET NUMBER


A-2.2

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I EAST ELEVATION A-2.3 SCALE: 1/8"=1'-0"




ISSUED Issued For Rezoning - February 19, 2014 Revised Rezoning - April 11, 2014

# PROJECT TITLE 617 SEGOE RD

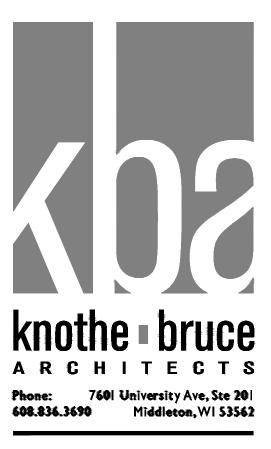
Madison, WI sheet title EAST ELEVATION

SHEET NUMBER

A-2.3

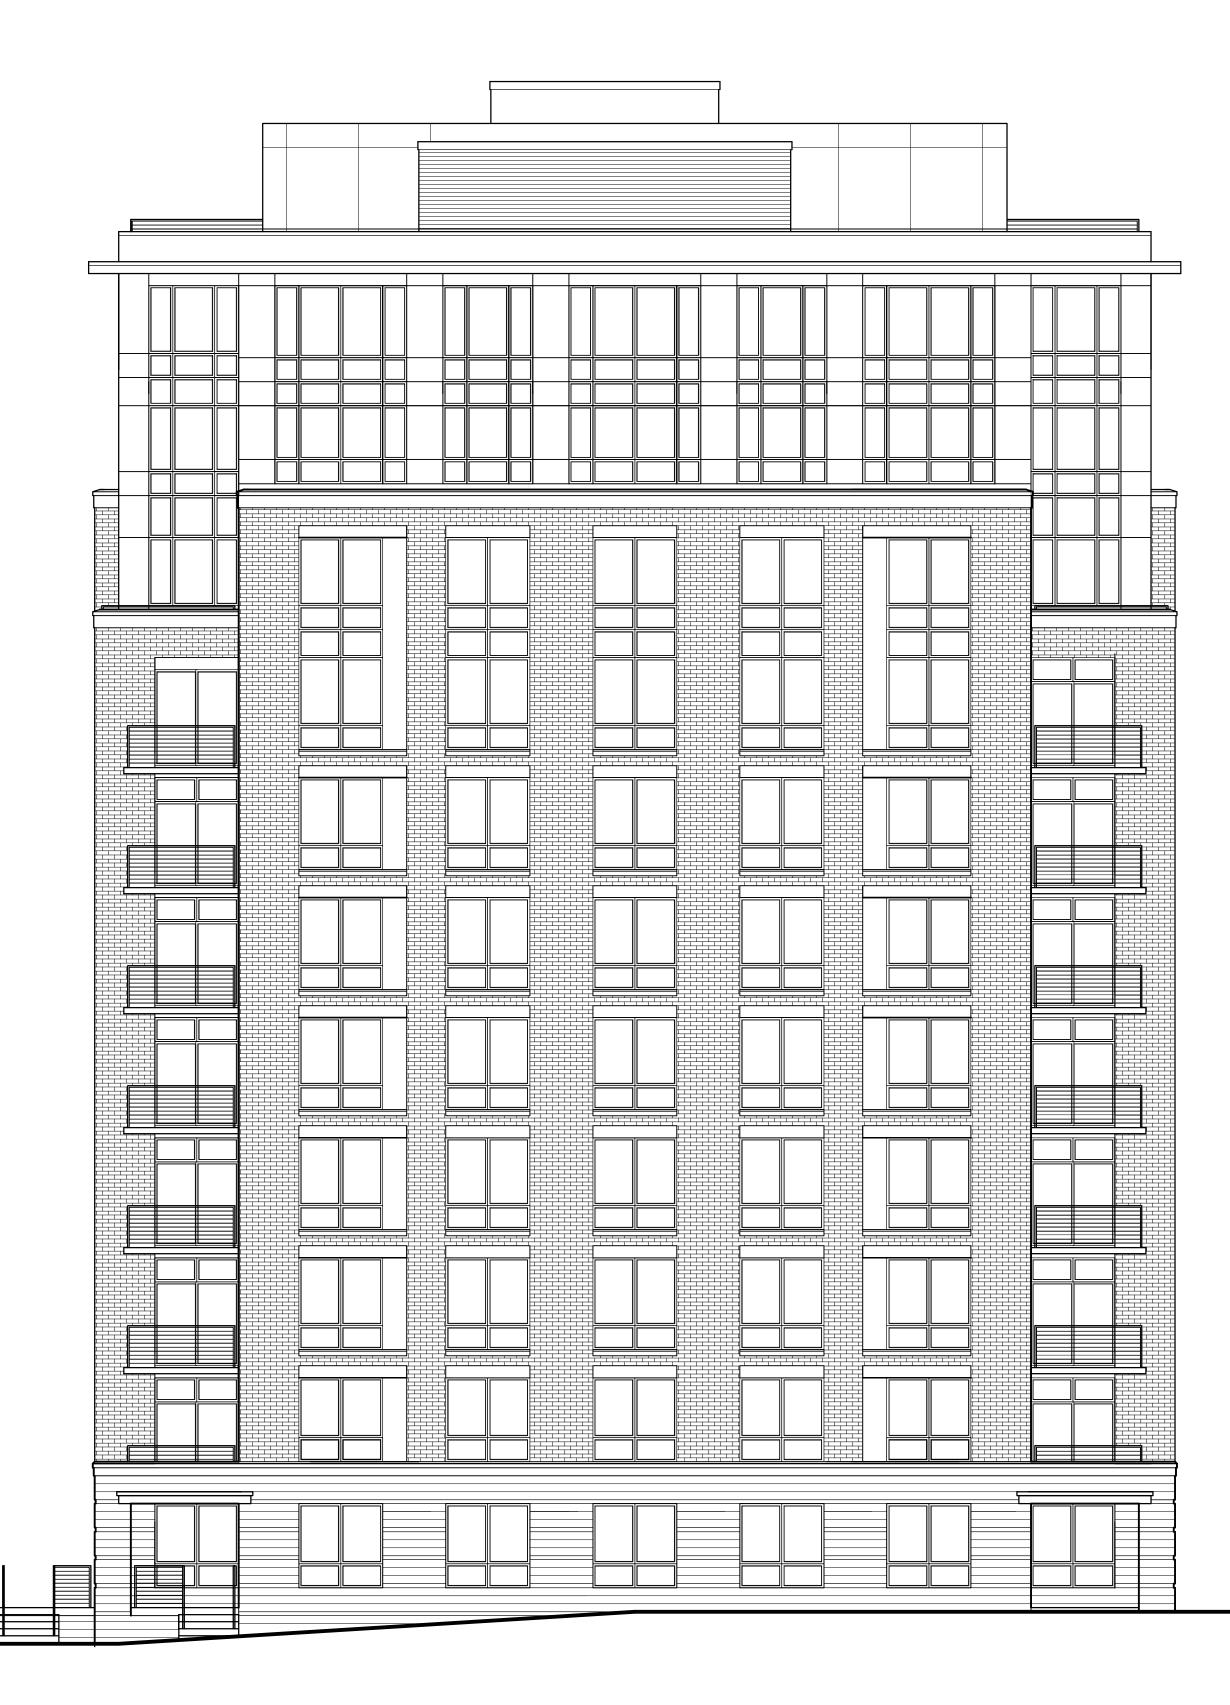



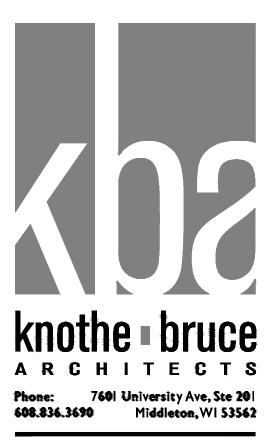

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# PROJECT TITLE 617 SEGOE RD

Madison, WI SHEET TITLE NORTH ELEVATION

Sheet Number

A-2.4