CITY OF MADISON 2014 PARKING GARAGE MAINTENANCE MADISON, WISCONSIN

CITY OF MADISON CONTRACT NO. 7283 **BID DRAWINGS**

STATE STREET CAMPUS (LAKE) GARAGE-415 NORTH LAKE STREET

STATE STREET CAPITOL GARAGE 214 NORTH CARROLL STREET

CAPITOL SQUARE NORTH GARAGE 218 EAST MIFFLIN STREET

GOVERNMENT EAST GARAGE 215 SOUTH PINCKNEY STREET



DRAWING INDEX

TITLE SHEET T1

CAPITOL SQUARE NORTH GARAGE CN1

STATE STREET CAPITOL GARAGE SC1

STATE STREET CAMPUS (LAKE) GARAGE SL1 THRU SL3

GOVERNMENT EAST GARAGE GE1. GE2

DETAILS D1. D2

STORM SEWER MODIFICATIONS (SC) P000, P100D, P100, P101

PARTIAL CITY OF MADISON LOCATION MAP



THE LOCATION OF DETERIORATED CONCRETE AND CRACKS SHOWN AND CRACKS TO BE REPAIRED WILL BE DESIGNATED BY THE

NUMBER IN HEXAGON REPRESENTS BID/WORK ITEM



UNSOUND CONCRETE

CRACK

- CIVIL ENGINEERING
- SURVEYING & MAPPING CONSTRUCTION SERVICES
- WATER RESOURCES
- PLANNING & DEVELOPMENT
- TRANSPORTATION ENGINEERING
- I ANDSCAPE ARCHITECTURE

MADISON REGIONAL OFFICE MADISON REGIONAL OFFICE 161 HORIZON DRIVE, SUITE 101 VERONA, WISCONSIN 53593 608.848.5060 PHONE ▮ 608.848.2255 FAX

MADISON MILWAUKEE KENOSHA APPLETON

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CITY OF MADISON.

UTILITY



13-5576

215 MARTIN LUTHER KING JR. BLVI

2014 PARKING RAMP RESTORATION

ROJECT LOCATION

ISD PROJECT NO.:

DESIGN:	JEE
DRAWN:	PGE


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TITLE SHEET

THE ACTUAL EXISTING FIELD CONDITIONS, ISD, INC. MAKES NO WARRANTY AS TO THEIR ACCURACY. CONTRACTOR TO FIELD VERIFY EXISTING CONDITIONS IMPERATIVE TO THE NEW WORK. REPORT DISCREPANCIES BETWEEN DRAWINGS AND FIELD CONDITIONS TO THE ENGINEER FOR REVIEW. ANY WORK PERFORMED PRIOR TO RESOLUTION OF DISCREPANCIES BY THE ENGINEER IS SUBJECT TO REMOVAL AND REPLACEMENT AT NO ADDITIONAL COST TO THE

INFORMATION PERTAINING TO EXISTING CONDITIONS GIVEN ON THESE DRAWINGS REPRESENTS TO THE BEST OF OUR KNOWLEDGE

CONTRACTORS ARE RESPONSIBLE FOR THE MEANS, METHODS, TECHNIQUES, SEQUENCES, AND PROCEDURES OF CONSTRUCTION INCLUDING, BUT NOT LIMITED TO TEMPORARY SUPPORTS, SHORING, AND FORMING TO SUPPORT IMPOSED LOADS AND OTHER SIMILAR

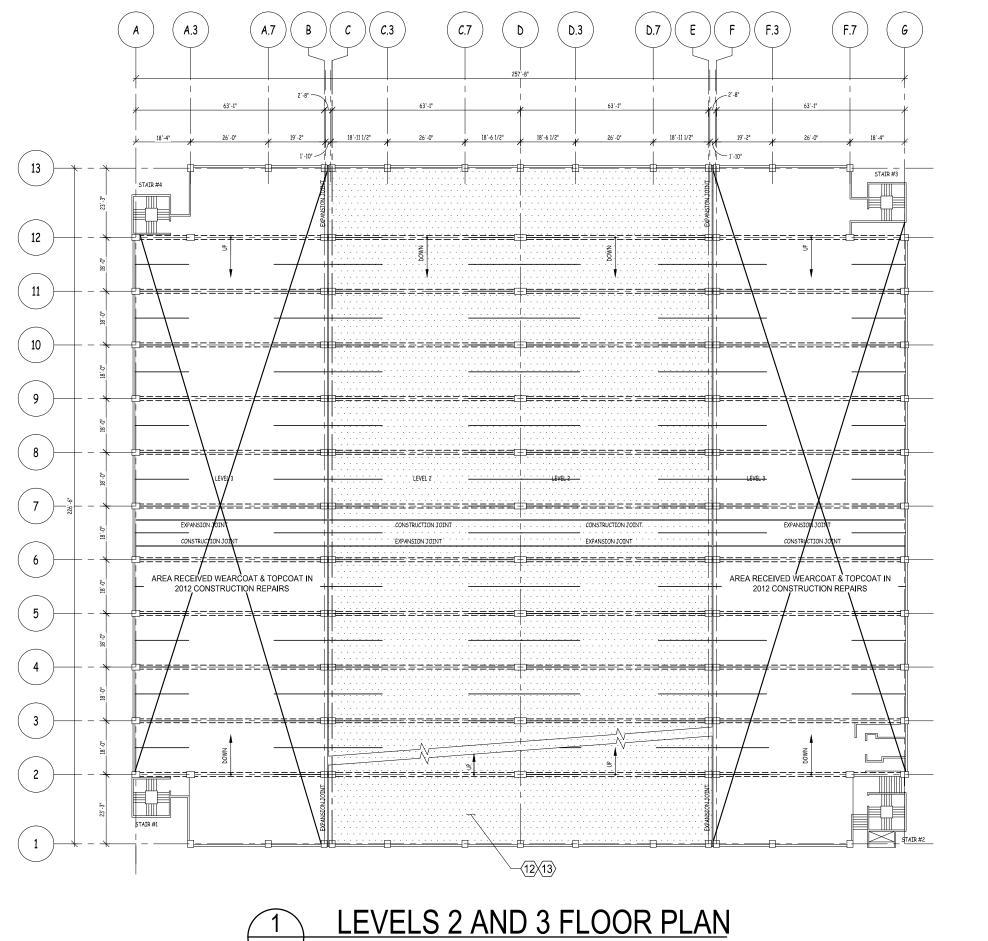

LEGEND

AREA TO RECEIVE NEW MEMBRANE WEARCOAT & TOPCOAT. SELECTED AREAS WILL RECEIVE COMPLETE FULLY ADHERED MEMBRANE SYSTEM.

N. BUTLER STREET

KEY PLAN

N. HAMIL TOW STREET

X REPAIR ITEM



- CIVIL ENGINEERING
- SURVEYING & MAPPING
 CONSTRUCTION SERVICES
- WATER RESOURCES
 PLANNING & DEVELOPMENT
- TRANSPORTATION ENGINEERING
- STRUCTURAL ENGINEERING

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UTILITY

2014 PARKING RAMP RESTORATION

PROJECT LOCATION: CAPITOL SQUARE NORTH

SEAL/SIGNATURE:

ALTHOUGH EVERY EFFORT HAS BEEN MADE N PREPARING THESE PLANS AND CHECKING THEM FOR ACCURACY, THE CONTRACTOR ND SUBCONTRACTORS MUST CHECK ALL ETAIL AND DIMENSIONS OF THEIR TRADE


DESIGN:	JJE
DRAWN:	PGE
ADDDOVED.	115



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LEVELS 2 AND 3 FLOOR PLAN

SCALE: 1/32" = 1'-0"

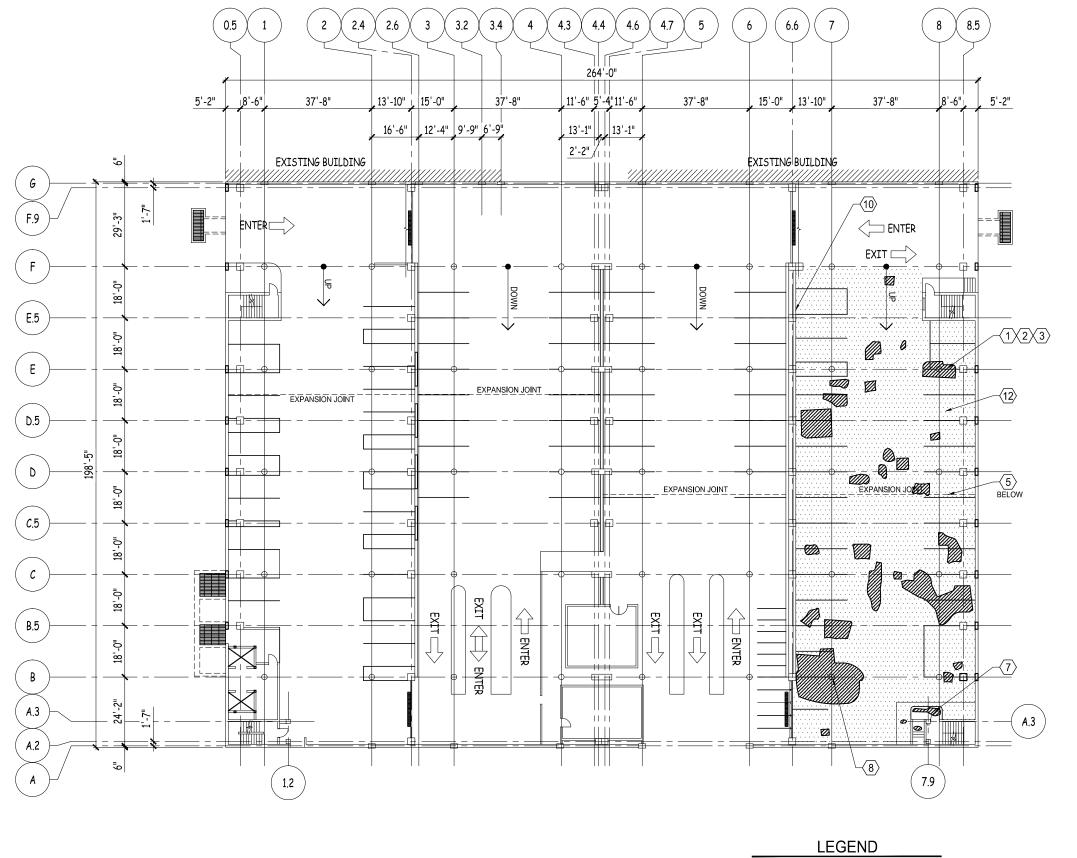

CONCRETE DELAMINATION

 $\langle X \rangle$ REPAIR ITEM

FULL SYSTEM MEMBRANE REPLACEMENT

"BUILDING RELATIONSHIPS WITH A COMMITMENT TO CLIENT SATISFACTION 'HROUGH TRUST, QUALITY AND EXPERIENCE

- CIVIL ENGINEERING

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- STRUCTURAL ENGINEERING LANDSCAPE ARCHITECTURE
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2014 PARKING RAMP RESTORATION

PROJECT LOCATION: STATE STREET CAPITOL

JSD PROJECT NO.

SEAL/SIGNATURE:


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FIRST LEVEL TOPSIDE PLAN

LEVEL 1 FLOOR PLAN

SCALE: 1/32" = 1'-0"





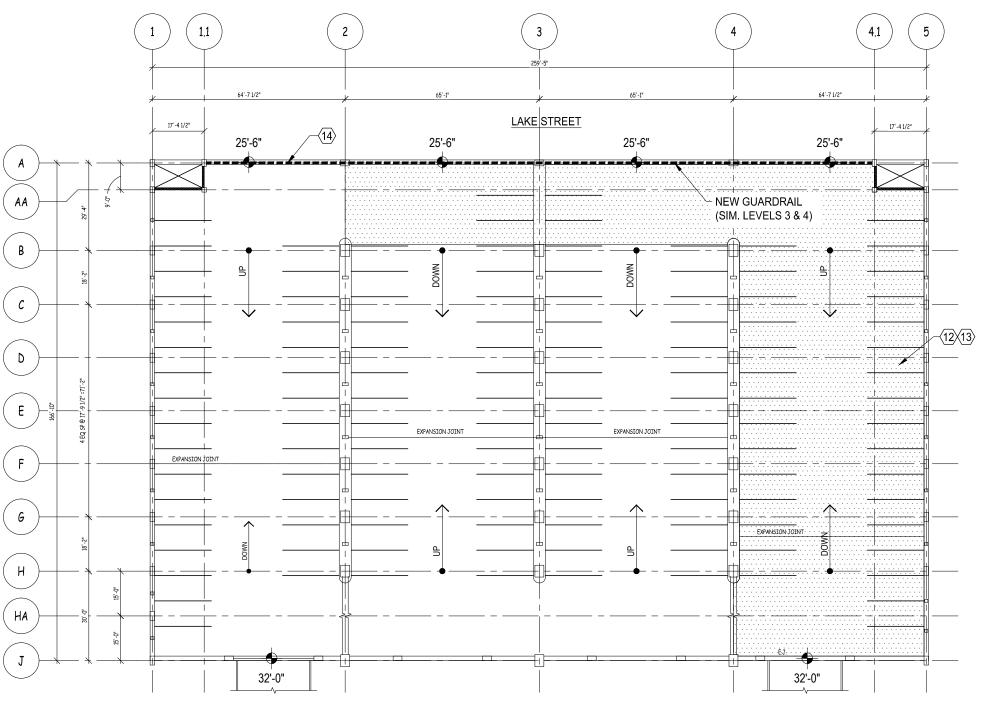

AREA TO RECEIVE NEW MEMBRANE WEARCOAT & TOPCOAT. SELECTED AREAS WILL RECEIVE COMPLETE FULLY ADHERED MEMBRANE SYSTEM.

X REPAIR ITEM

====== VEHICULAR BARRIER **GUARDRAIL**

- CIVIL ENGINEERING
- SURVEYING & MAPPING
 CONSTRUCTION SERVICES

- WATER RESOURCES
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2014 PARKING RAMP RESTORATION

PROJECT LOCATION: STATE STREET CAMPUS - LAKE

SEAL/SIGNATURE:

ALTHOUGH EVERY EFFORT HAS BEEN MADE IN PREPARING THESE PLANS AND CHECKING THEM FOR ACCURACY, THE CONTRACTOR AND SUBCONTRACTORS MUST CHECK ALL DETAIL AND DIMENSIONS OF THEIR TRADE AND BE RESPONSIBLE FOR THE SAME.

DESIGN: JJE DRAWN: PGB PPROVED: JJE

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SECOND LEVEL **TOPSIDE PLAN**

LEVEL 2 TOPSIDE PLAN SCALE : 1/32" = 1'-0"






LAKE STREET

KEY PLAN

HAWTHORNE COURT

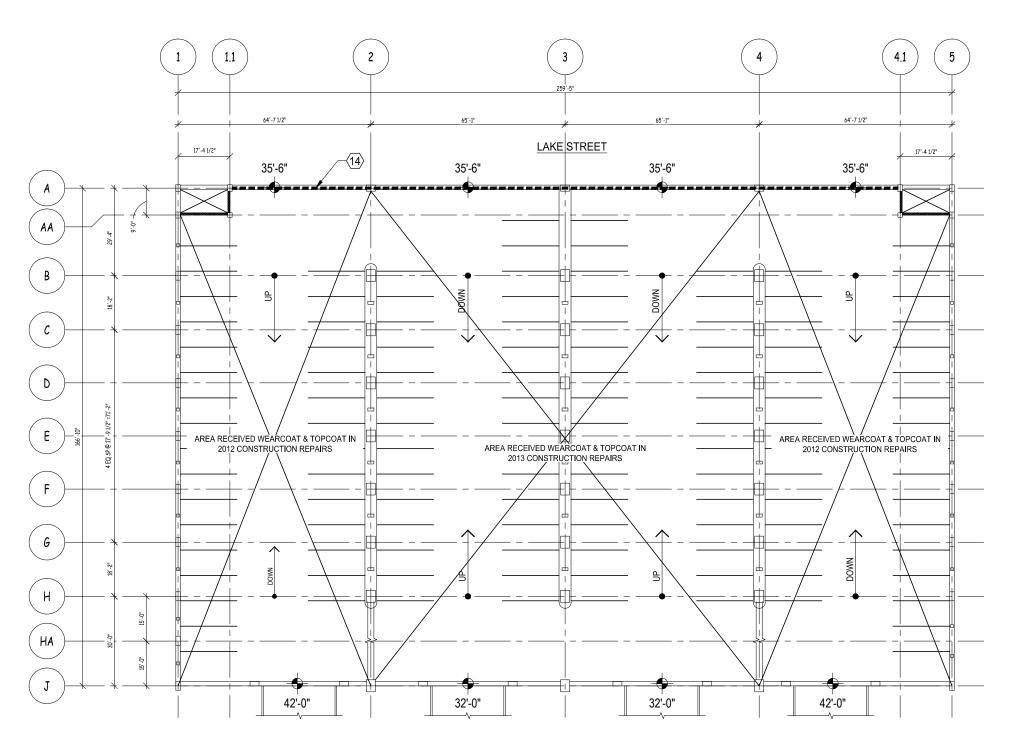



======= VEHICULAR BARRIER **GUARDRAIL**

REPAIR ITEM

- CIVIL ENGINEERING
- SURVEYING & MAPPING
 CONSTRUCTION SERVICES

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215 MARTIN LUTHER KING JR. BLVD MADISON, WISCONSIN 53701-2986

2014 PARKING RAMP RESTORATION

PROJECT LOCATION: STATE STREET CAMPUS - LAKE

SEAL/SIGNATURE:

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THIRD LEVEL **TOPSIDE PLAN**


LEVEL 3 TOPSIDE PLAN

SCALE : 1/32" = 1'-0"

LAKE STREET

KEY PLAN

HAWTHORNE COURT

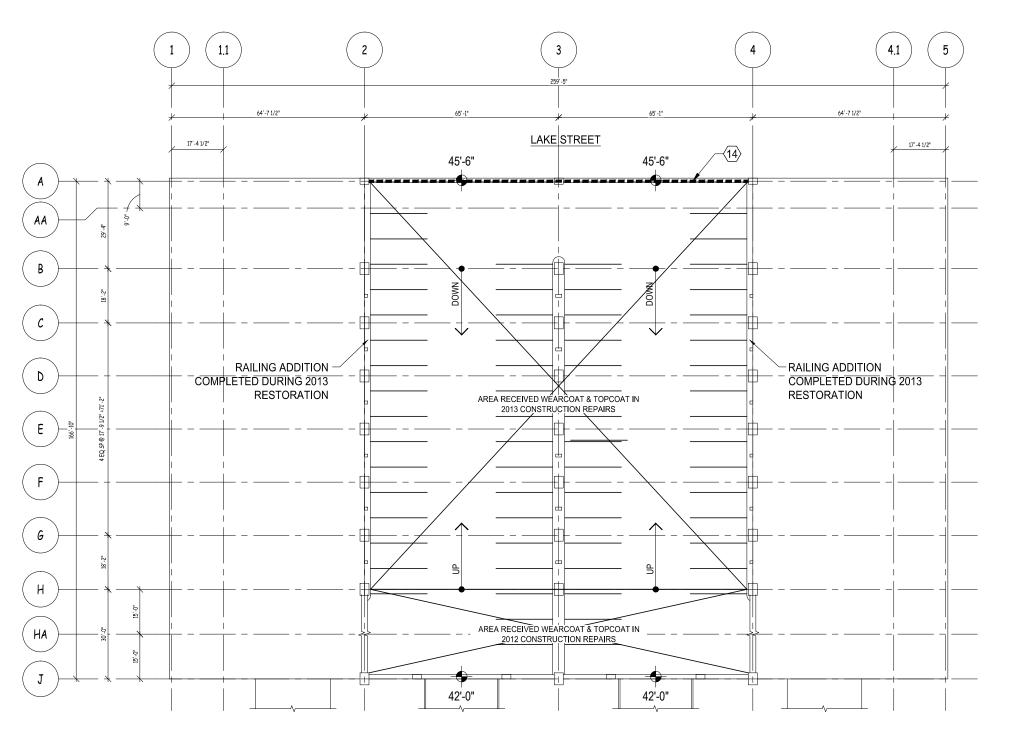

LEGEND

======= VEHICULAR BARRIER **GUARDRAIL**

REPAIR ITEM

- CIVIL ENGINEERING
- SURVEYING & MAPPING
 CONSTRUCTION SERVICES

- WATER RESOURCES
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 STRUCTURAL ENGINEERING
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2014 PARKING RAMP RESTORATION

PROJECT LOCATION: STATE STREET CAMPUS - LAKE

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FORTH LEVEL **TOPSIDE PLAN**

LEVEL 4 TOPSIDE PLAN SCALE : 1/32" = 1'-0"




LAKE STREET

KEY PLAN

HAWTHORNE COURT



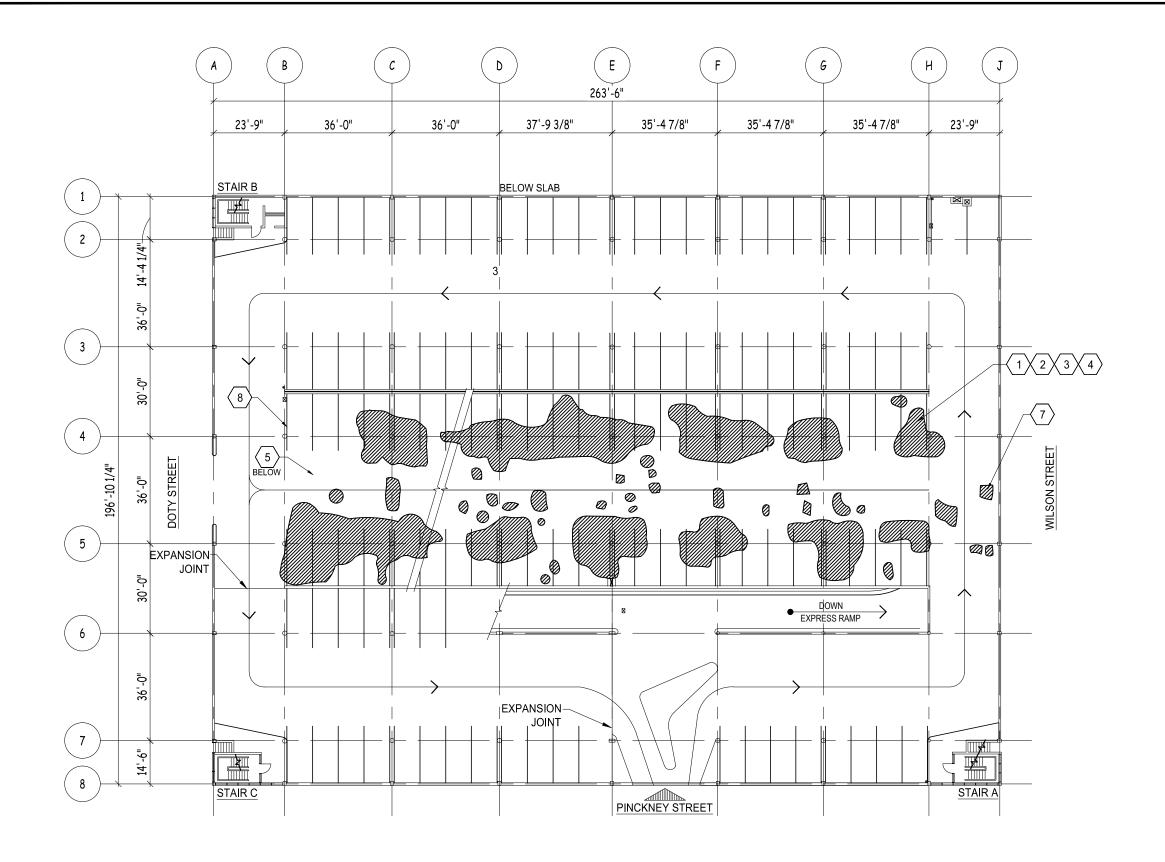



FIRST LEVEL TOPSIDE PLAN

SCALE: 1/32" = 1'-0"





LEGEND

CONCRETE DELAMINATION

X REPAIR ITEM



- CIVIL ENGINEERING
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2014 PARKING RAMP RESTORATION

13-5576

PROJECT LOCATION: GOVERNMENT EAST

SEAL/SIGNATURE:

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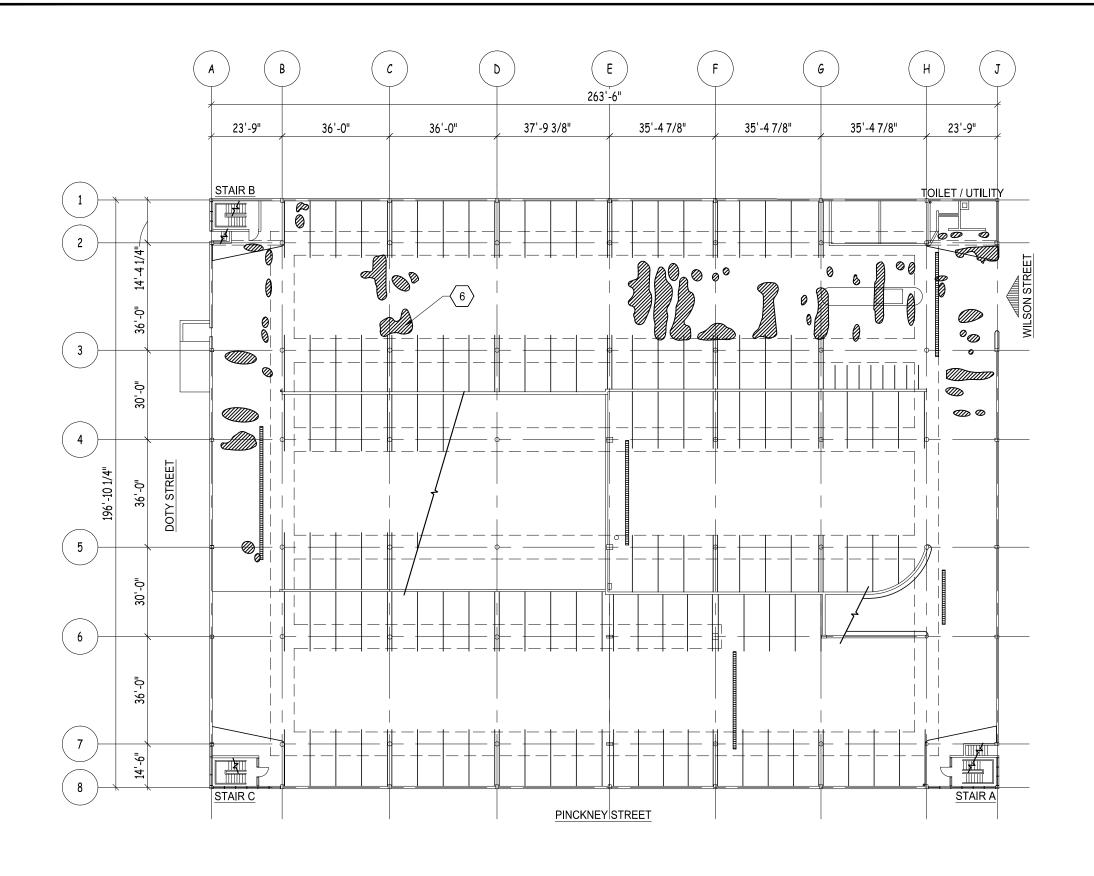
DESIGN: JJE RAWN: PGB PPROVED: JJE



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FIRST LEVEL **TOPSIDE PLAN**

GE1



FIRST LEVEL UNDERSIDE PLAN

SCALE: 1/32" = 1'-0"





LEGEND

CONCRETE DELAMINATION

X REPAIR ITEM

KEY PLAN PINCKNEY STREET

- CIVIL ENGINEERING
- SURVEYING & MAPPING
 CONSTRUCTION SERVICES

- WATER RESOURCES
 PLANNING & DEVELOPMENT
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2014 PARKING RAMP RESTORATION

PROJECT LOCATION: GOVERNMENT EAST

SEAL/SIGNATURE:

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DESIGN: JJE RAWN: PGB PPROVED: JJE

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FIRST LEVEL UNDERSIDE PLAN

GE2

NOTE: REMOVAL OF CONCRETE TO TOP OF UNDERLYING REINFORCING IS AT NO ADDITIONAL CHARGE

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TOPSIDE SLAB RESTORATION


SCALE: NTS (UNBONDED OVERLAY)

CONCRETE OVERLAY SAWCUT 1/2" DEEP - CHIP VERTICAL EDGES SQUARE OR UNDERCUT SLIGHTLY - SANDBLAST REINFORCING TO NEAR WHITE METAL CONDITION BEFORE PLACING NEW CONCRETE REMOVE UNSOUND CONCRETE AND REPLACE w/ NEW CONCRETE PER SPECIFICATIONS. CONCRETE PATCH AND OVERLAY ARE TO BE PLACE MONOLITHICALLY PRIMER "SCRUB COAT" SOUND CONCRETE 3/4" MIN ALL AROUND BAR, TYP ADDED STUB BARS FOR SUPPORT OF REINFORCING MAT AS NEEDED NOTE: REMOVAL OF CONCRETE BELOW SUPPORT BARS IS REQUIRED BY SPECIFICATION. NO ADDITIONAL PAYMENT FOR DEEPER REMOVAL IN THESE AREAS TOPSIDE SLAB RESTORATION SCALE: NTS (1 LAYER REINFORCING)


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(2 LAYERS REINFORCING)


SCALE: NTS



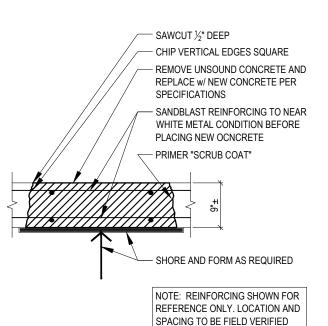




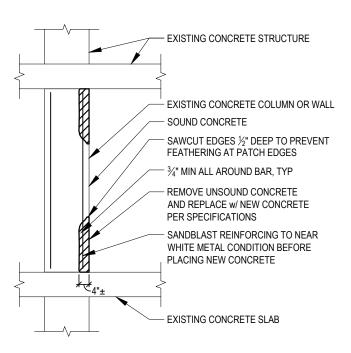

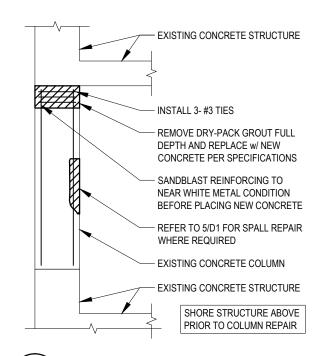


REPAIR AT SSCL COLUMNS

SCALE: NTS

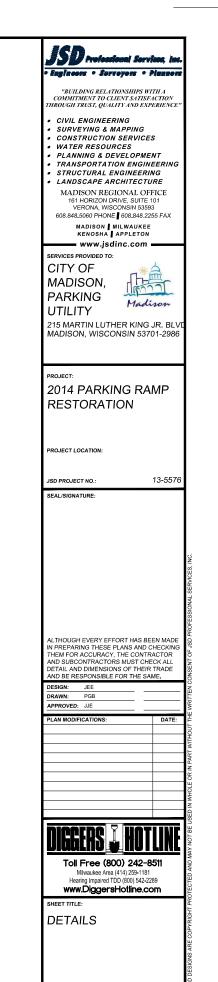

IUMBER:

)1

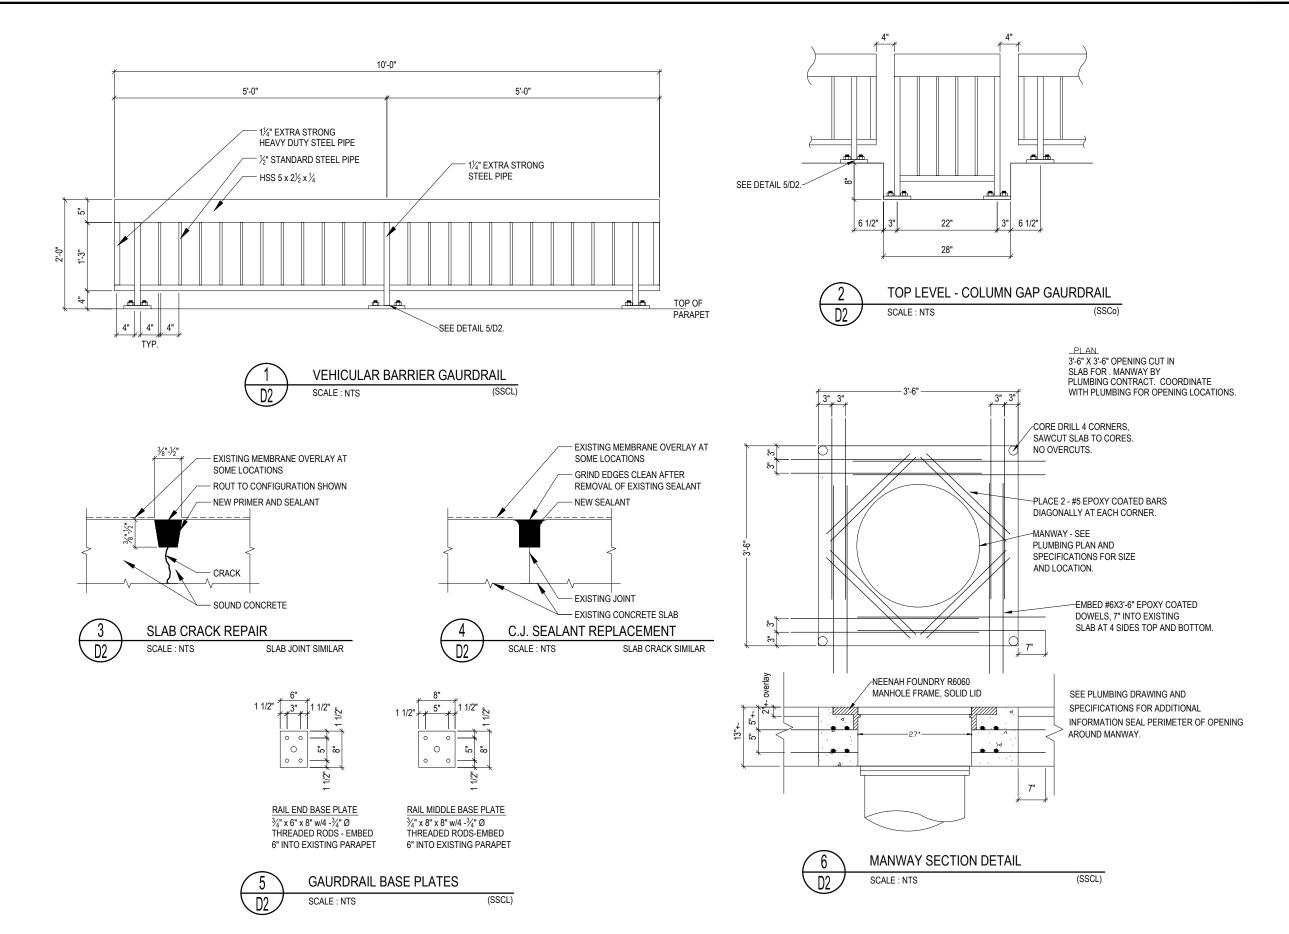

COMMITMENT TO CLIENT SATISFACTION ROUGH TRUST, QUALITY AND EXPERIENCE

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SERVICES PROVIDED TO:

CITY OF MADISON, PARKING UTILITY

Madison

13-5576

215 MARTIN LUTHER KING JR. BLV MADISON, WISCONSIN 53701-2986

PROJECT:

2014 PARKING RAMP RESTORATION

PROJECT LOCATION:

LTHOUGH EVERY EFFORT HAS BEEN MADE N PREPARING THESE PLANS AND CHECKING THEM FOR ACCURACY, THE CONTRACTOR AND SUBCONTRACTORS MUST CHECK ALL DETAIL AND DIMENSIONS OF THEIR TRADE

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DETAILS

D2


GENERAL NOTES: PLUMBING

- 1. VISIT THE BUILDING SITE AND BECOME THOROUGHLY FAMILIAR WITH ALL EXISTING CONDITIONS AFFECTING THE WORK.
- 2. VERIFY ALL MEASUREMENTS, PIPE SIZES, PIPE LOCATIONS, ELEVATIONS, ETC. AT SITE.
- 3. REVIEW DRAWINGS OF ALL OTHER TRADES. COORDINATE THE INSTALLATION AND SCHEDULING OF THE WORK WITH OTHER TRADES TO PREVENT INTERFERENCE WITH THEIR RESPECTIVE INSTALLATION.
- 4. INSTALL ALL WORK SUBSTANTIALLY AS SHOWN ON THE DRAWINGS. DEVIATIONS FROM LOCATIONS OF PIPING INDICATED ON THE DRAWINGS MAY HAVE TO BE MADE AT NO ADDITIONAL COST TO THE OWNER IN ORDER TO CLEAR THE WORK OF THE OTHER TRADES. HOWEVER, ALL SUCH DEVIATIONS SHALL BE PREVIOUSLY APPROVED BY THE OWNER'S REPRESENTATIVE.
- 5. PLUMBING CONTRACTOR SHALL BE RESPONSIBLE FOR ALL CUTTING AND PATCHING OF HOLES AND OPENINGS IN EXISTING WALLS AND FLOORS.
- 6. IT IS THE INTENT OF THESE DRAWINGS THAT A COMPLETE WORKING SYSTEM PROPERLY TESTED, WILL BE OPERATIONAL UPON COMPLETION OF INSTALLATION.
- 7. WHERE EXISTING PIPING IS REMOVED AND NOT RE-CONNECTED WITH NEW WORK CAP EXISTING SERVICES SO THAT DEAD END PIPE RUNS ARE NOT CREATED.
- 8. CONFLICT BETWEEN DRAWINGS AND SPECIFICATIONS SHALL BE BROUGHT TO THE ATTENTION OF THE ENGINEER PRIOR TO BID OPENING. THE ENGINEER RESERVES THE RIGHT TO FINAL DECISION.

NO SCALE

9. UNLESS NOTED OTHERWISE ALL GRAVITY WASTE PIPING SHALL BE INSTALLED AT A SLOPE OF 1/8" PER FOOT.

← 6'-0" DIA. x 19'-0" LONG 4,000 GALLON INTERCEPTOR **~ I**.E. = 36.50′ ∕ 24"Ø MANWAY (TYPICAL) -8" OUTLET CONNECTION -8" DIA. OUTLET CONNECTION ✓ WATER LEVEL 10" INLET €34.16' } 12" OUTLET -- I.E. = 33.83' —4" DRAIN 8" INLET CONNECTION — MATCH INVERT **ELEVATIONS** TANK SADDLE CONCRETE PAD EXISTING LEVEL L FLOOR-FFE. = 27.50' **FRONT** SIDE SAND INTERCEPTOR DETAIL

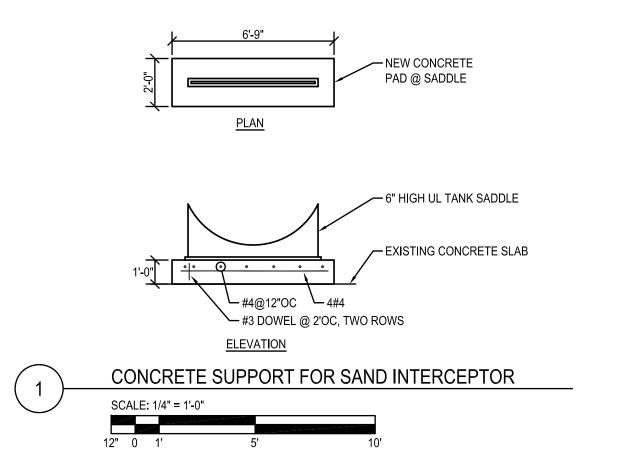

GENERAL DEMOLITION & NEW WORK NOTES:

- 1.) THIS CONTRACTOR SHALL VERIFY THE EXISTING CONDITIONS AT THE PROJECT SITE BEFORE SUBMITTING BID. CONT'R IS ADVISED THAT ALL LOCATIONS ARE APPROXIMATE.
- 2.) AN ATTEMPT HAS BEEN MADE TO SHOW ALL PIPING, FIXTURES, AND EQUIPMENT.
 THIS CONTRACTOR SHALL VISIT THE SITE TO VERIFY COMPONENTS, LOCATIONS AND SIZES
 SHOWN OR NOT SHOWN. ALL COMPONENTS NEED TO BE REMOVED IN THE DEMOLITION AREA
 UNLESS NOTED ON THE DRAWINGS.
- 3.) THIS CONTRACTOR SHALL BE RESPONSIBLE FOR HIS OWN DEMOLITION, REMOVAL, CAPPING, STORING, ABANDONING, DISCONNECTING, RELOCATING AND RECONNECTION OF EXISTING EQUIPMENT AND MATERIAL. ALL CUTTING, PATCHING, REPAIRING, REPLACEMENT AND REFINISHING, SHALL MATCH THE EXISTING CONSTRUCTION AS NEARLY AS POSSIBLE.
- 4.) EXCEPT WHERE OTHERWISE SHOWN OR NOTED ON DRWG. "TO BE RETAINED, RELOCATED" OR HEREINAFTER NOTED, ALL EXISTING EQUIPMENT AND MATERIAL IN AREAS TO BE REMODELED/ALTERED SHALL BE REMOVED WHERE THEY INTERFERE WITH PROPOSED NEW CONSTRUCTION &/OR INTERFERE W/PROPOSED USAGE OF SPACE BY OWNER AS FOLLOWS:
- (A) REMOVE ANY PIPES PROTRUDING ABOVE FINISHED FLOOR OR THROUGH WALL AND CAP
- 5.) THESE DRAWINGS ARE NECESSARILY DIAGRAMMATIC IN NATURE. NOT ALL FITTINGS, OFFSETS, VENTS, OR DRAINS ARE SHOWN. THE CONTRACTOR SHALL VISIT THE SITE PRIOR TO BIDDING AND INCLUDE ALL FITTINGS, OFFSETS, VENTS, CLEANOUTS AND DRAINS AS REQUIRED TO PROVIDE A COMPLETE AND FUNCTIONING SYSTEM.
- 6.) ALL PLUMBING PIPE RELATED CUTTING, PATCHING AND/OR REMOVAL AND REPLACEMENT OF EXISTING WALLS, FLOORS & CEILINGS SHALL BE BY P.C.
- 7.) PATCH ALL HOLES WITH NON-SHRINK GROUT.

	PLUMBING ABBREVIATIONS
ABBR	DESCRIPTION
ADW	ABOVE DUCTWORK
AF AFCH	ABOVE FLOOR AMERICAN FAMILY CHILDREN'S HOSPITAL
AFF AHU	ABOVE FINISHED FLOOR AIR HANDLING UNIT
ALP	ALARM PANEL
AO	AIR OUTLET ACCESS PANEL
AP ASC	ABOVE SUSPENDED CEILING
AV AW	ACID VENT ACID WASTE
BDW	BELOW DUCTWORK
BF BFP	BELOW FLOOR BACKFLOW PREVENTER
BV	BALL VALVE
CB CI	CATCH BASIN CAST IRON
CLG	CEILING
CO CO ₂	CLEANOUT CARBON DIOXIDE
CO ₂ V CP	CARBON DIOXIDE RELIEF VENT CIRCULATION PUMP
CSS	CLINICAL SERVICE SINK
CS CW	COLD SOFT WATER COLD WATER
CWV	CLEARWATER VENT
CWW DF	CLEARWATER WASTE DRINKING FOUNTAIN
DFU	DRAINAGE FIXTURE UNITS
DN EC	DOWN ELECTRICAL CONTRACTOR
EEWS	EMERGENCY EYE WASH EMERGENCY EYE WASH/SHOWER
EWC	ELECTRIC WATER COOLER
F FCO	FIRE FLOOR CLEANOUT
FD	FLOOR DRAIN
FFA FFB	FROM FLOOR ABOVE FROM FLOOR BELOW
FHC	FIRE HOSE CABINET
FIS FPC	FROM INTERSTITIAL SPACE FIRE PROTECTION CONTRACTOR
FS FT	FLOOR SINK
FWCO	FOOT FINISHED WALL CLEANOUT
G GC	GAS GENERAL CONTRACTOR
GO	GAS OUTLET
GPM HB	GALLONS PER MINUTE HOSE BIBB
HC	HEATING CONTRACTOR
HD HW	HUB DRAIN HOT WATER
HWD	HOT WATER DECIDENT ATTOM/DETURN
HWR IE	HOT WATER RECIRCULATION/RETURN INVERT ELEVATION
JS L	JANITORS SINK LAVATORY (LAV)
LVC	LOCK VALVE CLOSED
LVO MA	LOCK VALVE OPEN MEDICAL AIR
MAC MA-I	MEDICAL AIR COMPRESSOR MEDICAL AIR INTAKE
MALP	MASTER ALARM PANEL
MB MH	MOP BASIN MANHOLE
MV	MEDICAL VACUUM
MV-E MVP	MEDICAL VACUUM EXHAUST MEDICAL VACUUM PUMP
N ₂ N ₂ -V	NITROGEN NITROGEN RELIEF VENT
N ₂ O-V	NITROGEN RELIEF VENT
NC NCC	NORMALLY CLOSED NITROGEN CONTROL CABINET
NIC	NOT IN CONTRACT
NO N ₂ O	NORMALLY OPEN NITROUS OXIDE
NPCS	NON-POTABLE COLD SOFT WATER
O ₂ OSD	OXYGEN (O2) OPEN SITE DRAIN
PC PRV	PLUMBING CONTRACTOR PRESSURE REDUCING VALVE
PSI	POUNDS PER SQUARE INCH
RD RM	ROOF DRAIN ROOM
RO	REVERSE OSMOSIS REDUCED PRESSURE BACKFLOW PREVENTER
RPBP RV	RELIEF VENT
S SAN	SINK SANITARY
SCSK	SCRUB SINK
SFU SH	SUPPLY FIXTURE UNITS SHOWER
SS	SANITARY STACK
SVB ST	BACK SIPHONAGE BACKFLOW VACUUM BREAKER STORM
SV TC	STACK VENT TEMPERATURE CONTROLS
TD	TRENCH DRAIN
TFA TFB	TO FLOOR ABOVE TO FLOOR BELOW
TIS	TO INTERSTITIAL SPACE
TMV TW	THERMOSTATIC MIXING VALVE TEMPERED WATER PIPING
UR UF	URINAL UNDER FLOOR
UWHC	UW HOSPITAL AND CLINIC
V VB	VENT VALVE BOX (MEDICAL GAS)
VTR	VENT THRU ROOF
W WAGD	WASTE WASTE ANESTHETIC GAS DISPOSAL
WB WC	WALL BOX WATER CLOSET
WF	WATER FILTER
WH WHA	WALL HYDRANT WATER HAMMER ARRESTOR
WSFU	WATER SUPPLY FIXTURE UNITS
	A COMPOSITE LIST OF ABBREVIATIONS, NOT ALL
PERTA	IN SPECIFICALLY TO THIS JOB.

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SYMBOL	DESCRIPTION
	COLD WATER SUPPLY PIPING
	HOT WATER SUPPLY PIPING
	HOT WATER RECIRCULATION/ RETURN
///////////	PIPING /EQUIPMENT TO BE REMOVED
	VENT PIPING
——60A <i>—</i> —	60 PSI COMPRESSED AIR PIPING
—— 225A ——	225 PSI COMPRESSED AIR PIPING
— — AV — —	ACID VENT PIPING
—— AW ——	ACID WASTE PIPING
—	CARBON DIOXIDE PIPING
CO2-V	CARBON DIOXIDE RELIEF VENT PIPING
cww	CLEAR WATER WASTE PIPING
CWV	CLEAR WATER VENT PIPING
cs	COLD SOFT WATER PIPING
D	INDIRECT DRAIN
—_F—	FIRE PROTECTION PIPING
—NPCS—	NONPOTABLE COLD SOFT PIPING
O2	OXYGEN PIPING
RO	REVERSE OSMOSIS WATER PIPING
— SAN —	SANITARY LINE ABOVE FLOOR
SAN	SANITARY LINE BELOW FLOOR
ST	STORM PIPING
TW	TEMPERED WATER PIPING
− 94249−	BACKFLOW PREVENTER
8	BALANCING VALVE
_	BALL VALVE
	BUTTERFLY VALVE
	CHECK VALVE
— ю FCO	CLEANOUT - FLOOR OR YARD
<u>—</u> 	OUTSIDE SCREW & YOLK (OS&Y) GATE VALVE
	ELBOW TURNED DOWN
O 	ELBOW TURNED UP
F-1	FIXTURE DESIGNATION & NUMBER
	FLANGED UNION
⊘ 2"FD-A	FLOOR DRAIN, DESIGNATION NUMBER & SIZE
-	FLOW
P	FLOW SWITCH
	GATE VALVE
	GLOBE VALVE
	MECHANICAL SHOCK ARRESTOR
	NEW CONNECTION TO EXISTING BEGINNING/END POIN
DN	PIPING DOWN
UP	PIPING UP
	PRESSURE REDUCING VALVE
	SCREWED UNION
	TEE - BOTTOM OUTLET
	TEE - TOP OUTLET
<u></u> ,	TEMPERATURE & PRESSURE RELIEF VALVE
<u> </u>	THERMOMETER
	WALL CLEANOUT
<u> </u>	WALL HYDRANT
<u> </u>	ZONE VALVE BOX
<u> </u>	EXISTING SPRINKLER HEAD
	NEW CONCEALED SPRINKLER HEAD
	NEW CONCEALED SPRINKLER HEAD WITH GASKET

LUMBING SHEET INDEX

P000 PLUMBING LEGEND, NOTES AND DETAILS
P100 LEVEL L PLUMBING PLAN - NEW WORK
P100D LEVEL L PLUMBING PLAN - DEMOLITION
P101 LEVEL 1 PLUMBING PLAN

"BUILDING RELATIONSHIPS WITH A THROUGH TRUST, QUALITY AND EXPERIENCE CIVIL ENGINEERING SURVEYING & MAPPING CONSTRUCTION SERVICES WATER RESOURCES PLANNING & DEVELOPMENT TRANSPORTATION ENGINEERING STRUCTURAL ENGINEERING LANDSCAPE ARCHITECTURE MADISON REGIONAL OFFICE 161 HORIZON DRIVE, SUITE 101 VERONA, WISCONSIN 53593 608.848.5060 PHONE 608.848.2255 FAX MADISON MILWAUKEE KENOSHA APPLETON Madison:

1232 Fourier Drive, Suite 101
Madison, Wisconsin 53717-1960
T 608.833.7000 F 608.833.6996
Email: info@henneman.com
Website: http://www.henneman.com
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JOB NO. 13-8002

CITY OF
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MACKING

215 MARTIN LUTHER KING JR. BLVD MADISON, WISCONSIN 53701-2986

PROJECT: 2014 PARKING

RAMP RESTORATION

PROJECT LOCATION:
STATE STREET CAPITOL

JSD PROJECT NO.: 13-5576

JSD PROJECT NO.: 13-

SEAL/SIGNATURE:

ALTHOUGH EVERY EFFORT HAS BEEN MADE IN PREPARING THESE PLANS AND CHECKING THEM FOR ACCURACY, THE CONTRACTOR AND SUBCONTRACTORS MUST CHECK ALL DETAIL AND DIMENSIONS OF THEIR TRADE AND BE RESPONSIBLE FOR THE SAME.


ESIGN: JJE
RAWN: PGB
PPROVED: JJE



PLUMBING LEGEND, NOTES AND DETAILS

SHEET NUMBER:

P000

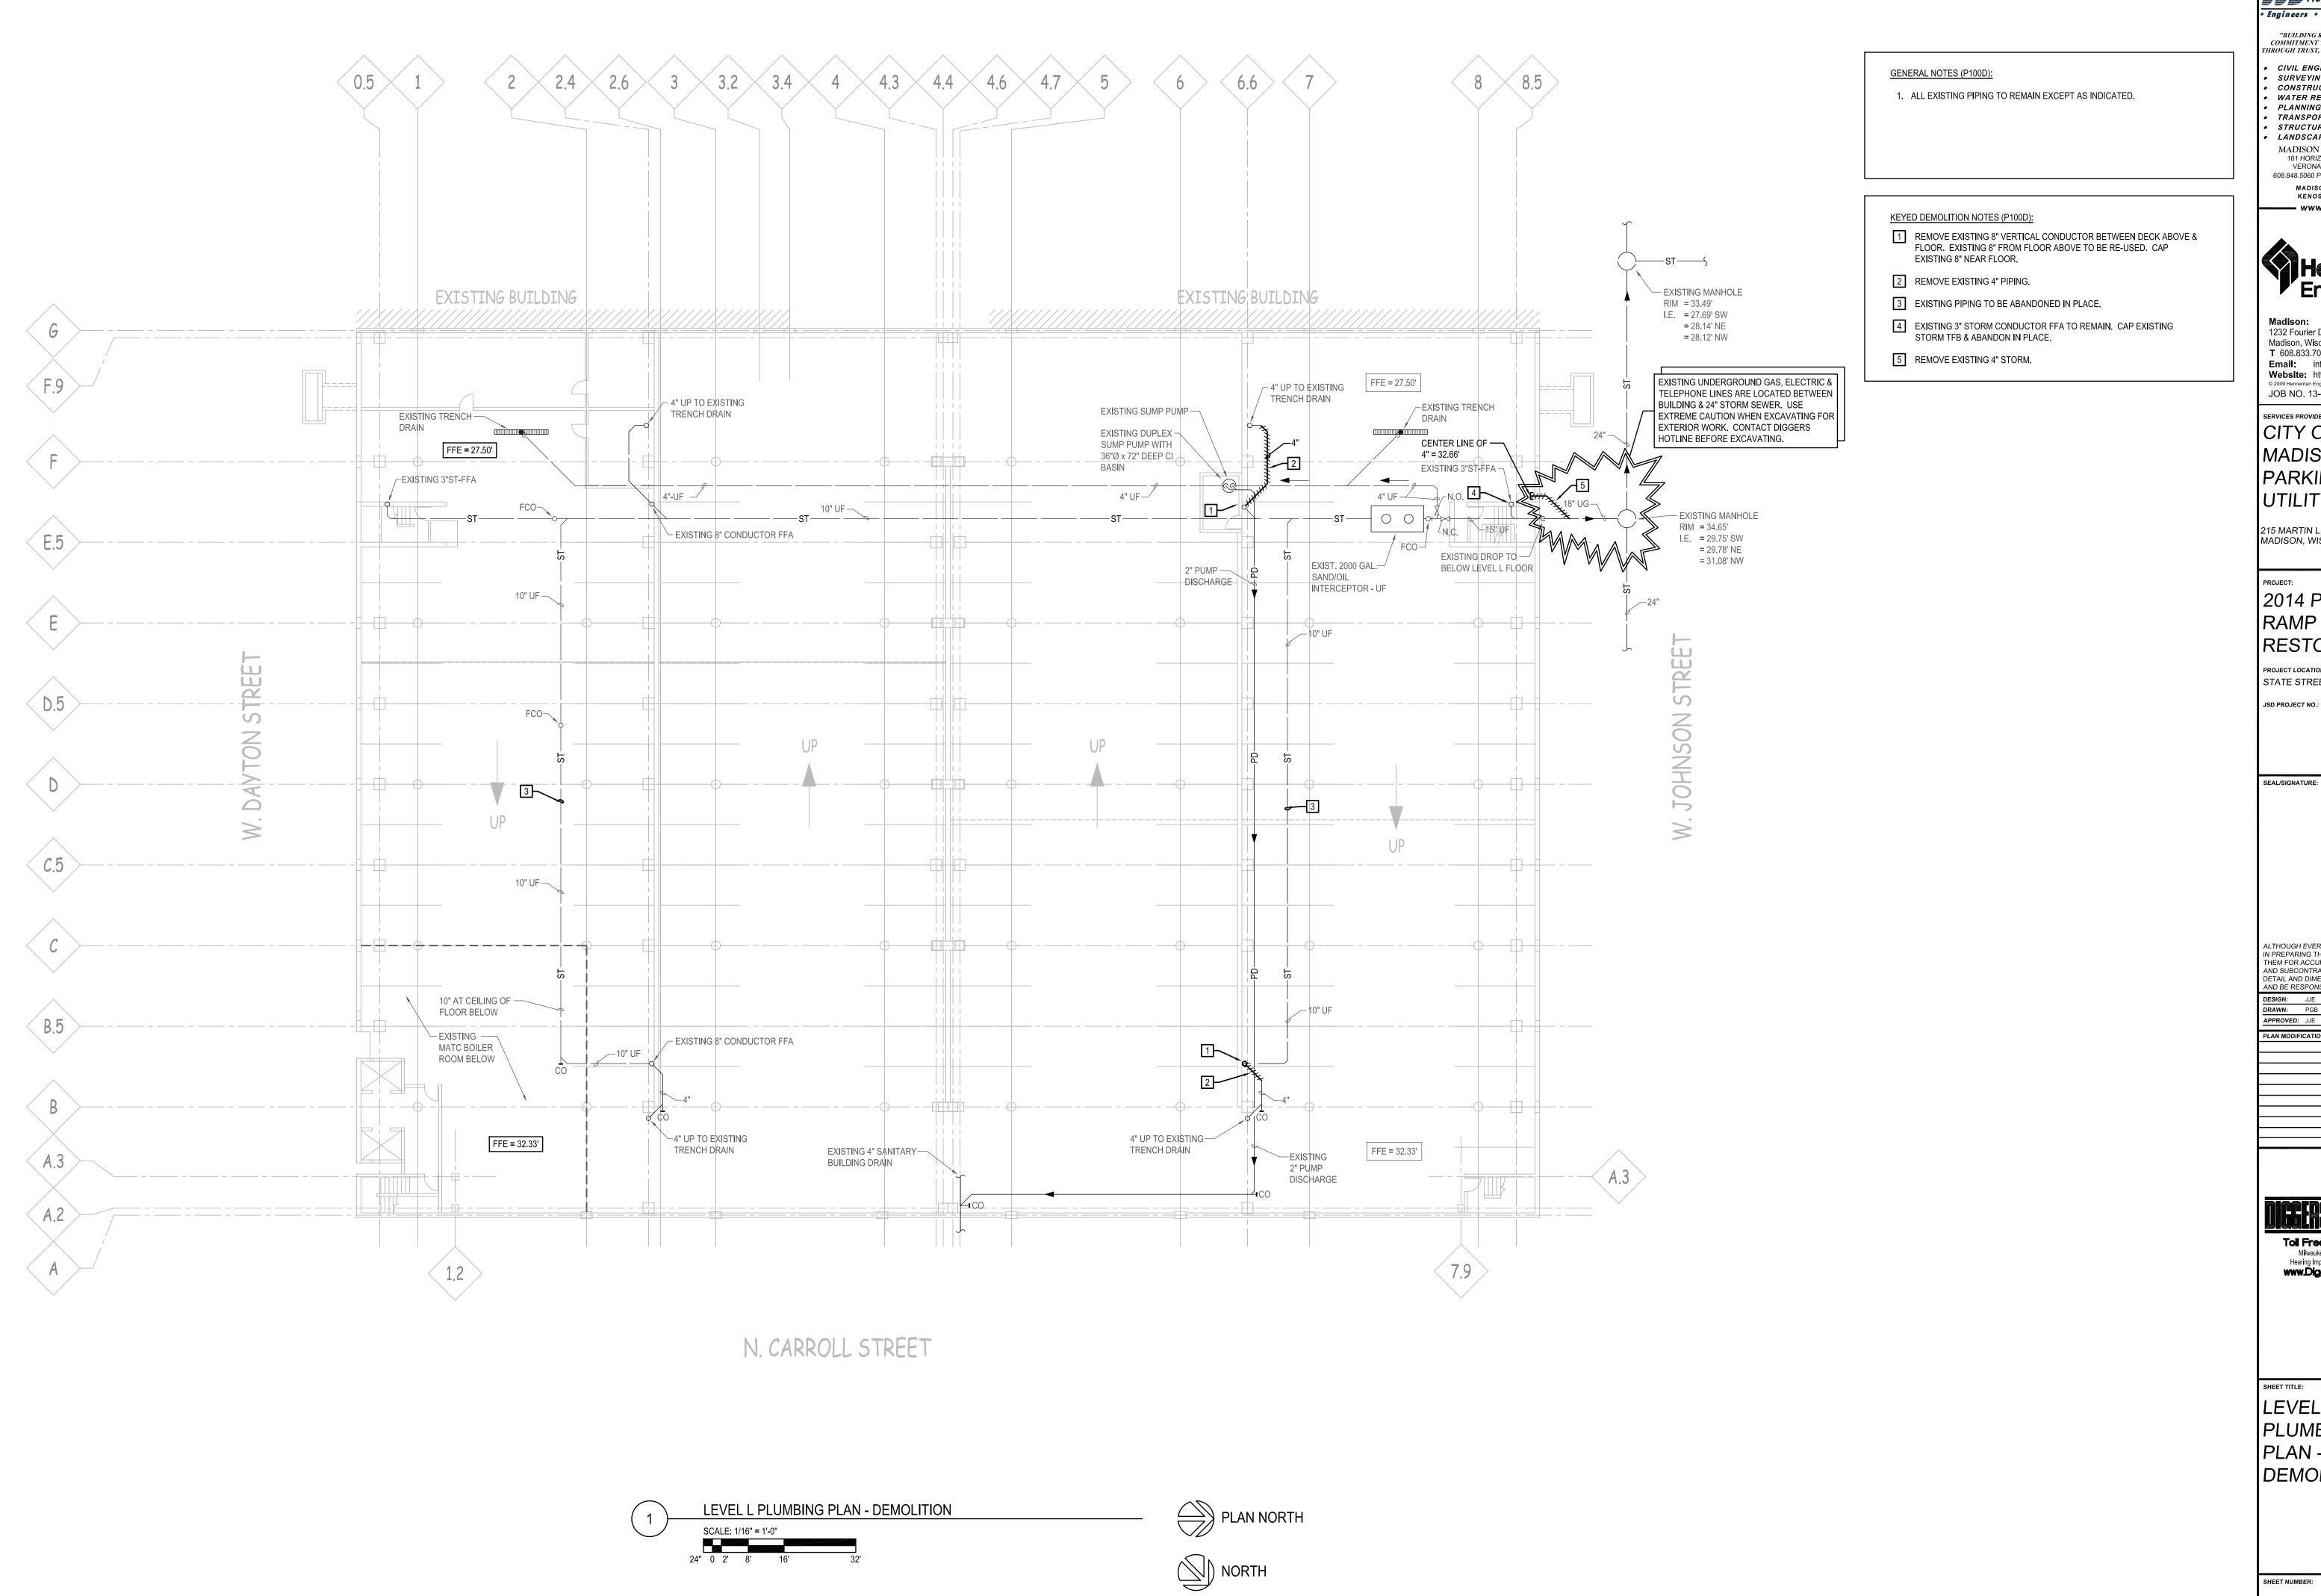

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Madison: 1232 Fourier Drive, Suite 101 Madison, Wisconsin 53717-1960 T 608.833.7000 **F** 608.833.6996 Email: info@henneman.com Website: http://www.henneman.com JOB NO. 13-8002

MADISON, PARKING Madison UTILITY

215 MARTIN LUTHER KING JR. BLVD MADISON, WISCONSIN 53701-2986

2014 PARKING RAMP RESTORATION

PROJECT LOCATION: STATE STREET CAPITOL

ALTHOUGH EVERY EFFORT HAS BEEN MADE IN PREPARING THESE PLANS AND CHECKING THEM FOR ACCURACY, THE CONTRACTOR


AND SUBCONTRACTORS MUST CHECK ALL DETAIL AND DIMENSIONS OF THEIR TRADE


PLAN MODIFICATIONS:

Toll Free (800) 242-8511 Milwaukee Area (414) 259-1181 Hearing Impaired TDD (800) 542-2289 www.DiggersHotline.com

LEVEL L PLUMBING PLAN -DEMOLITION

P100D

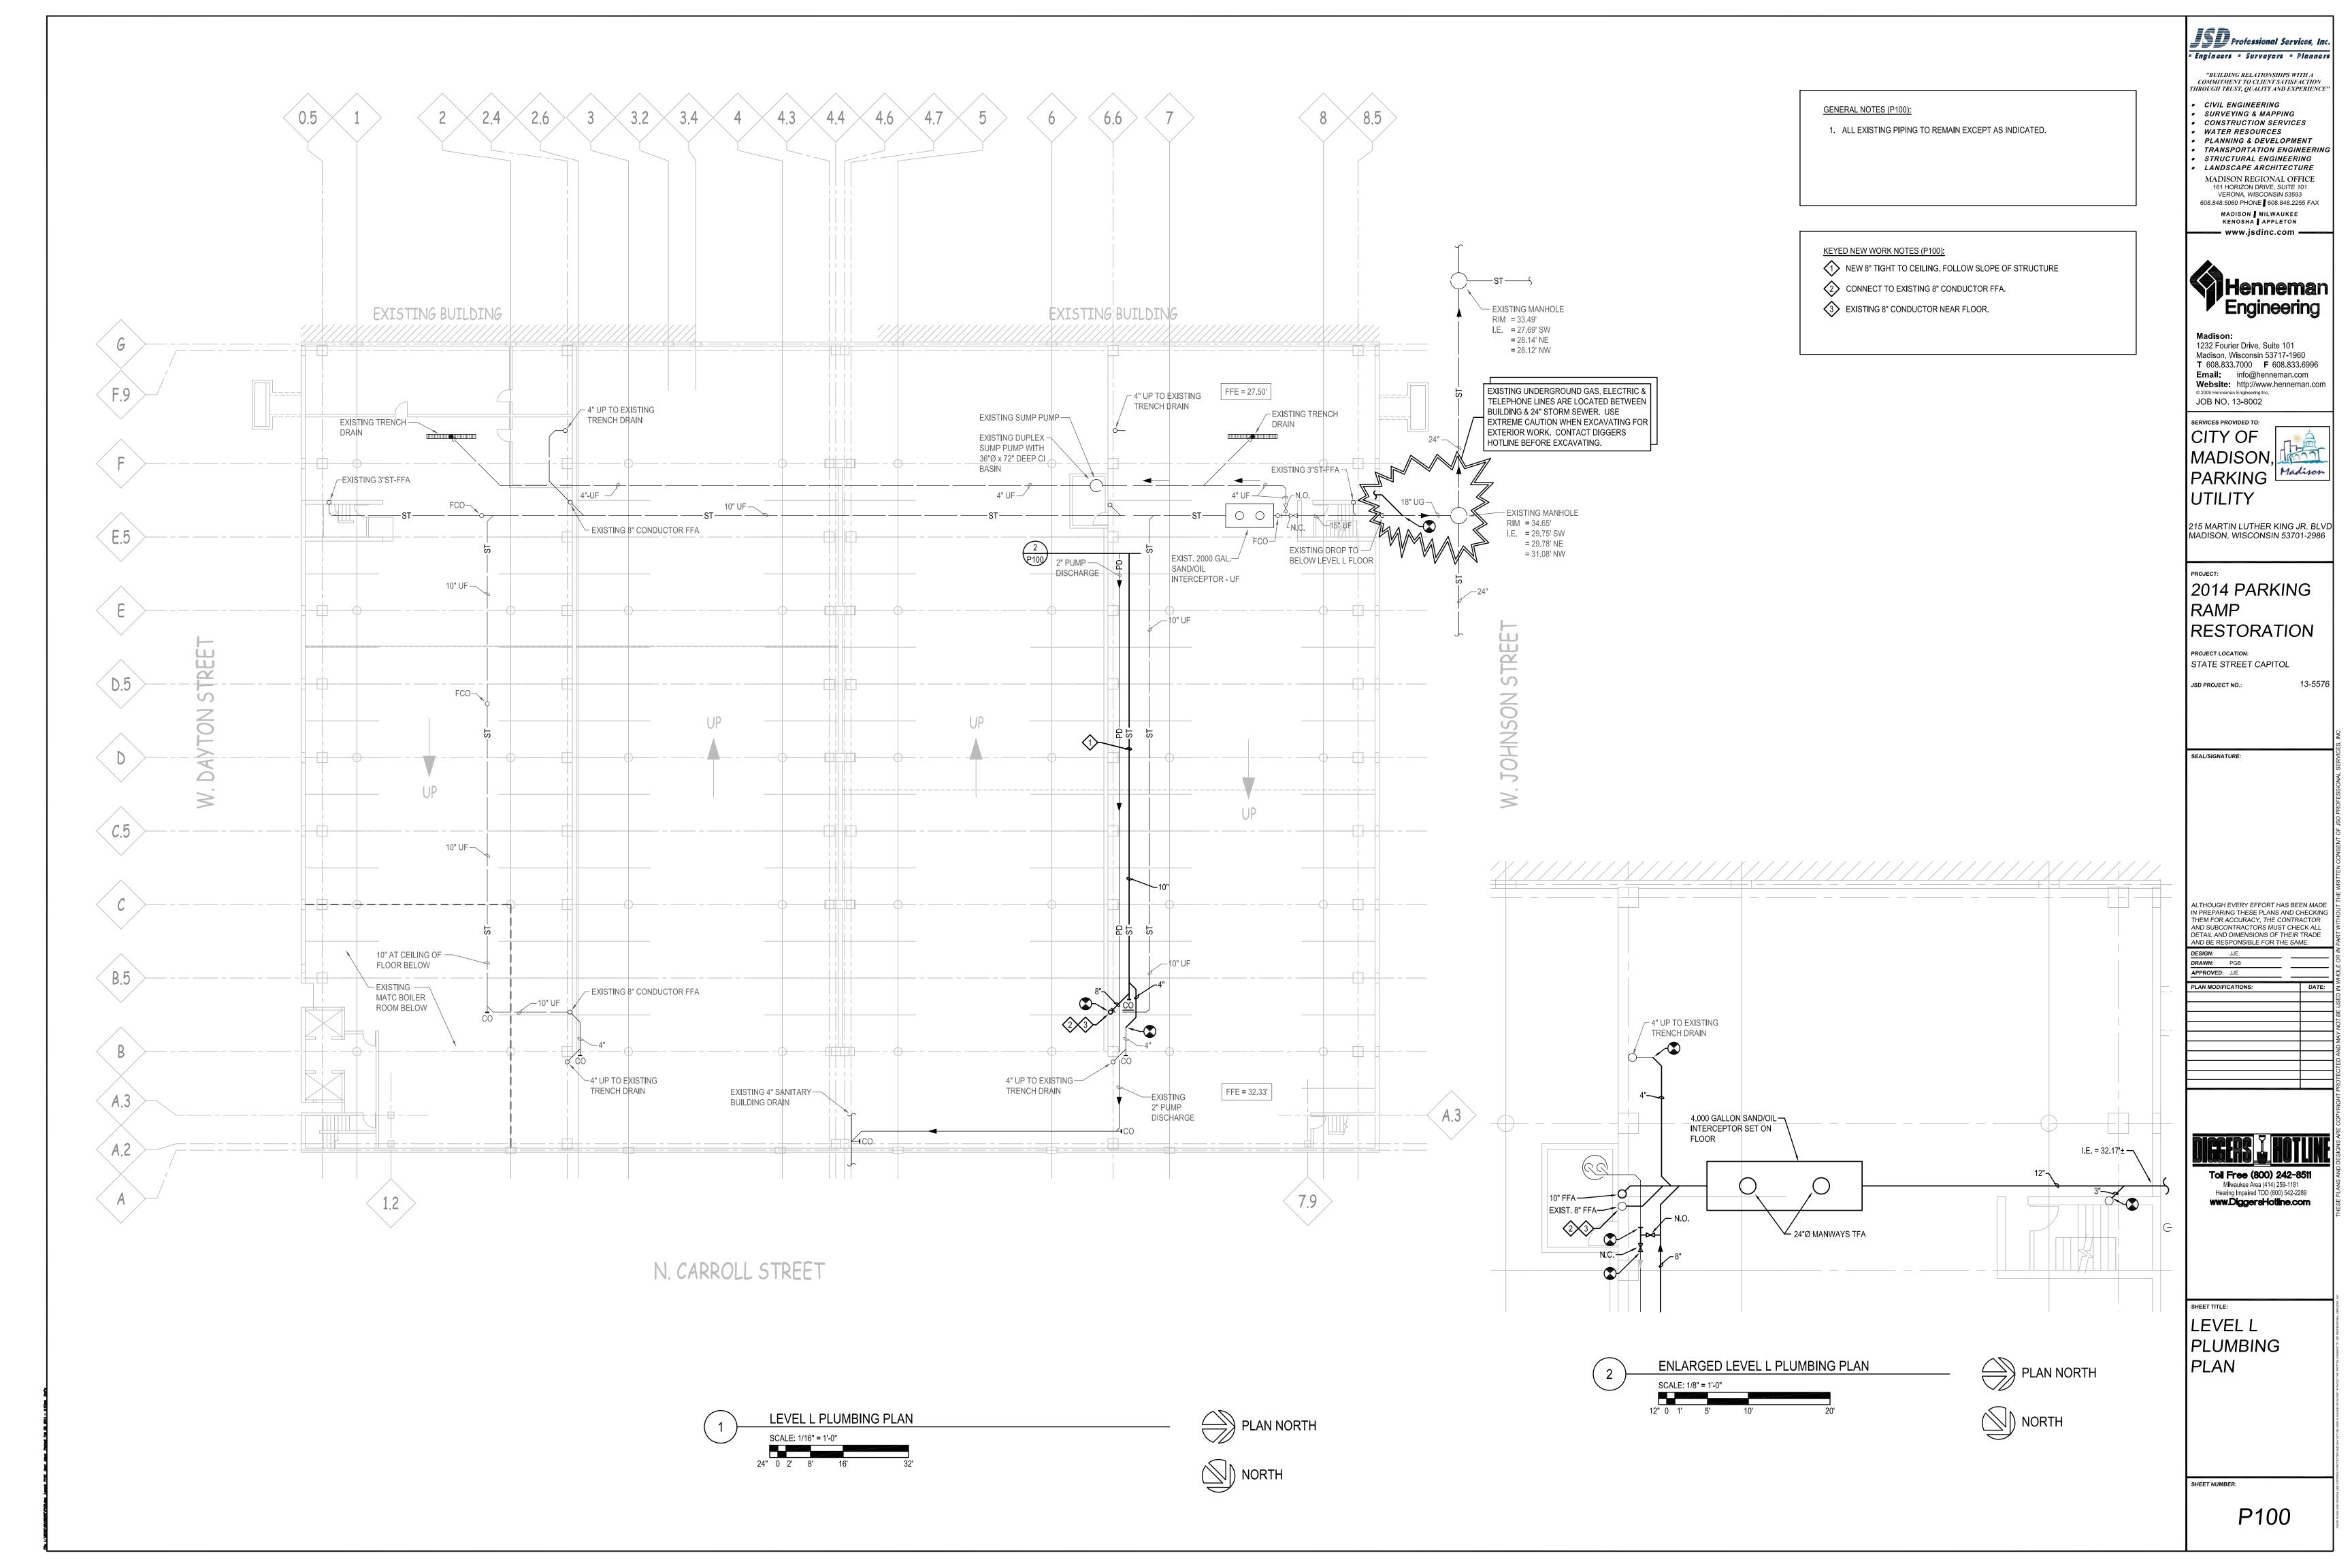

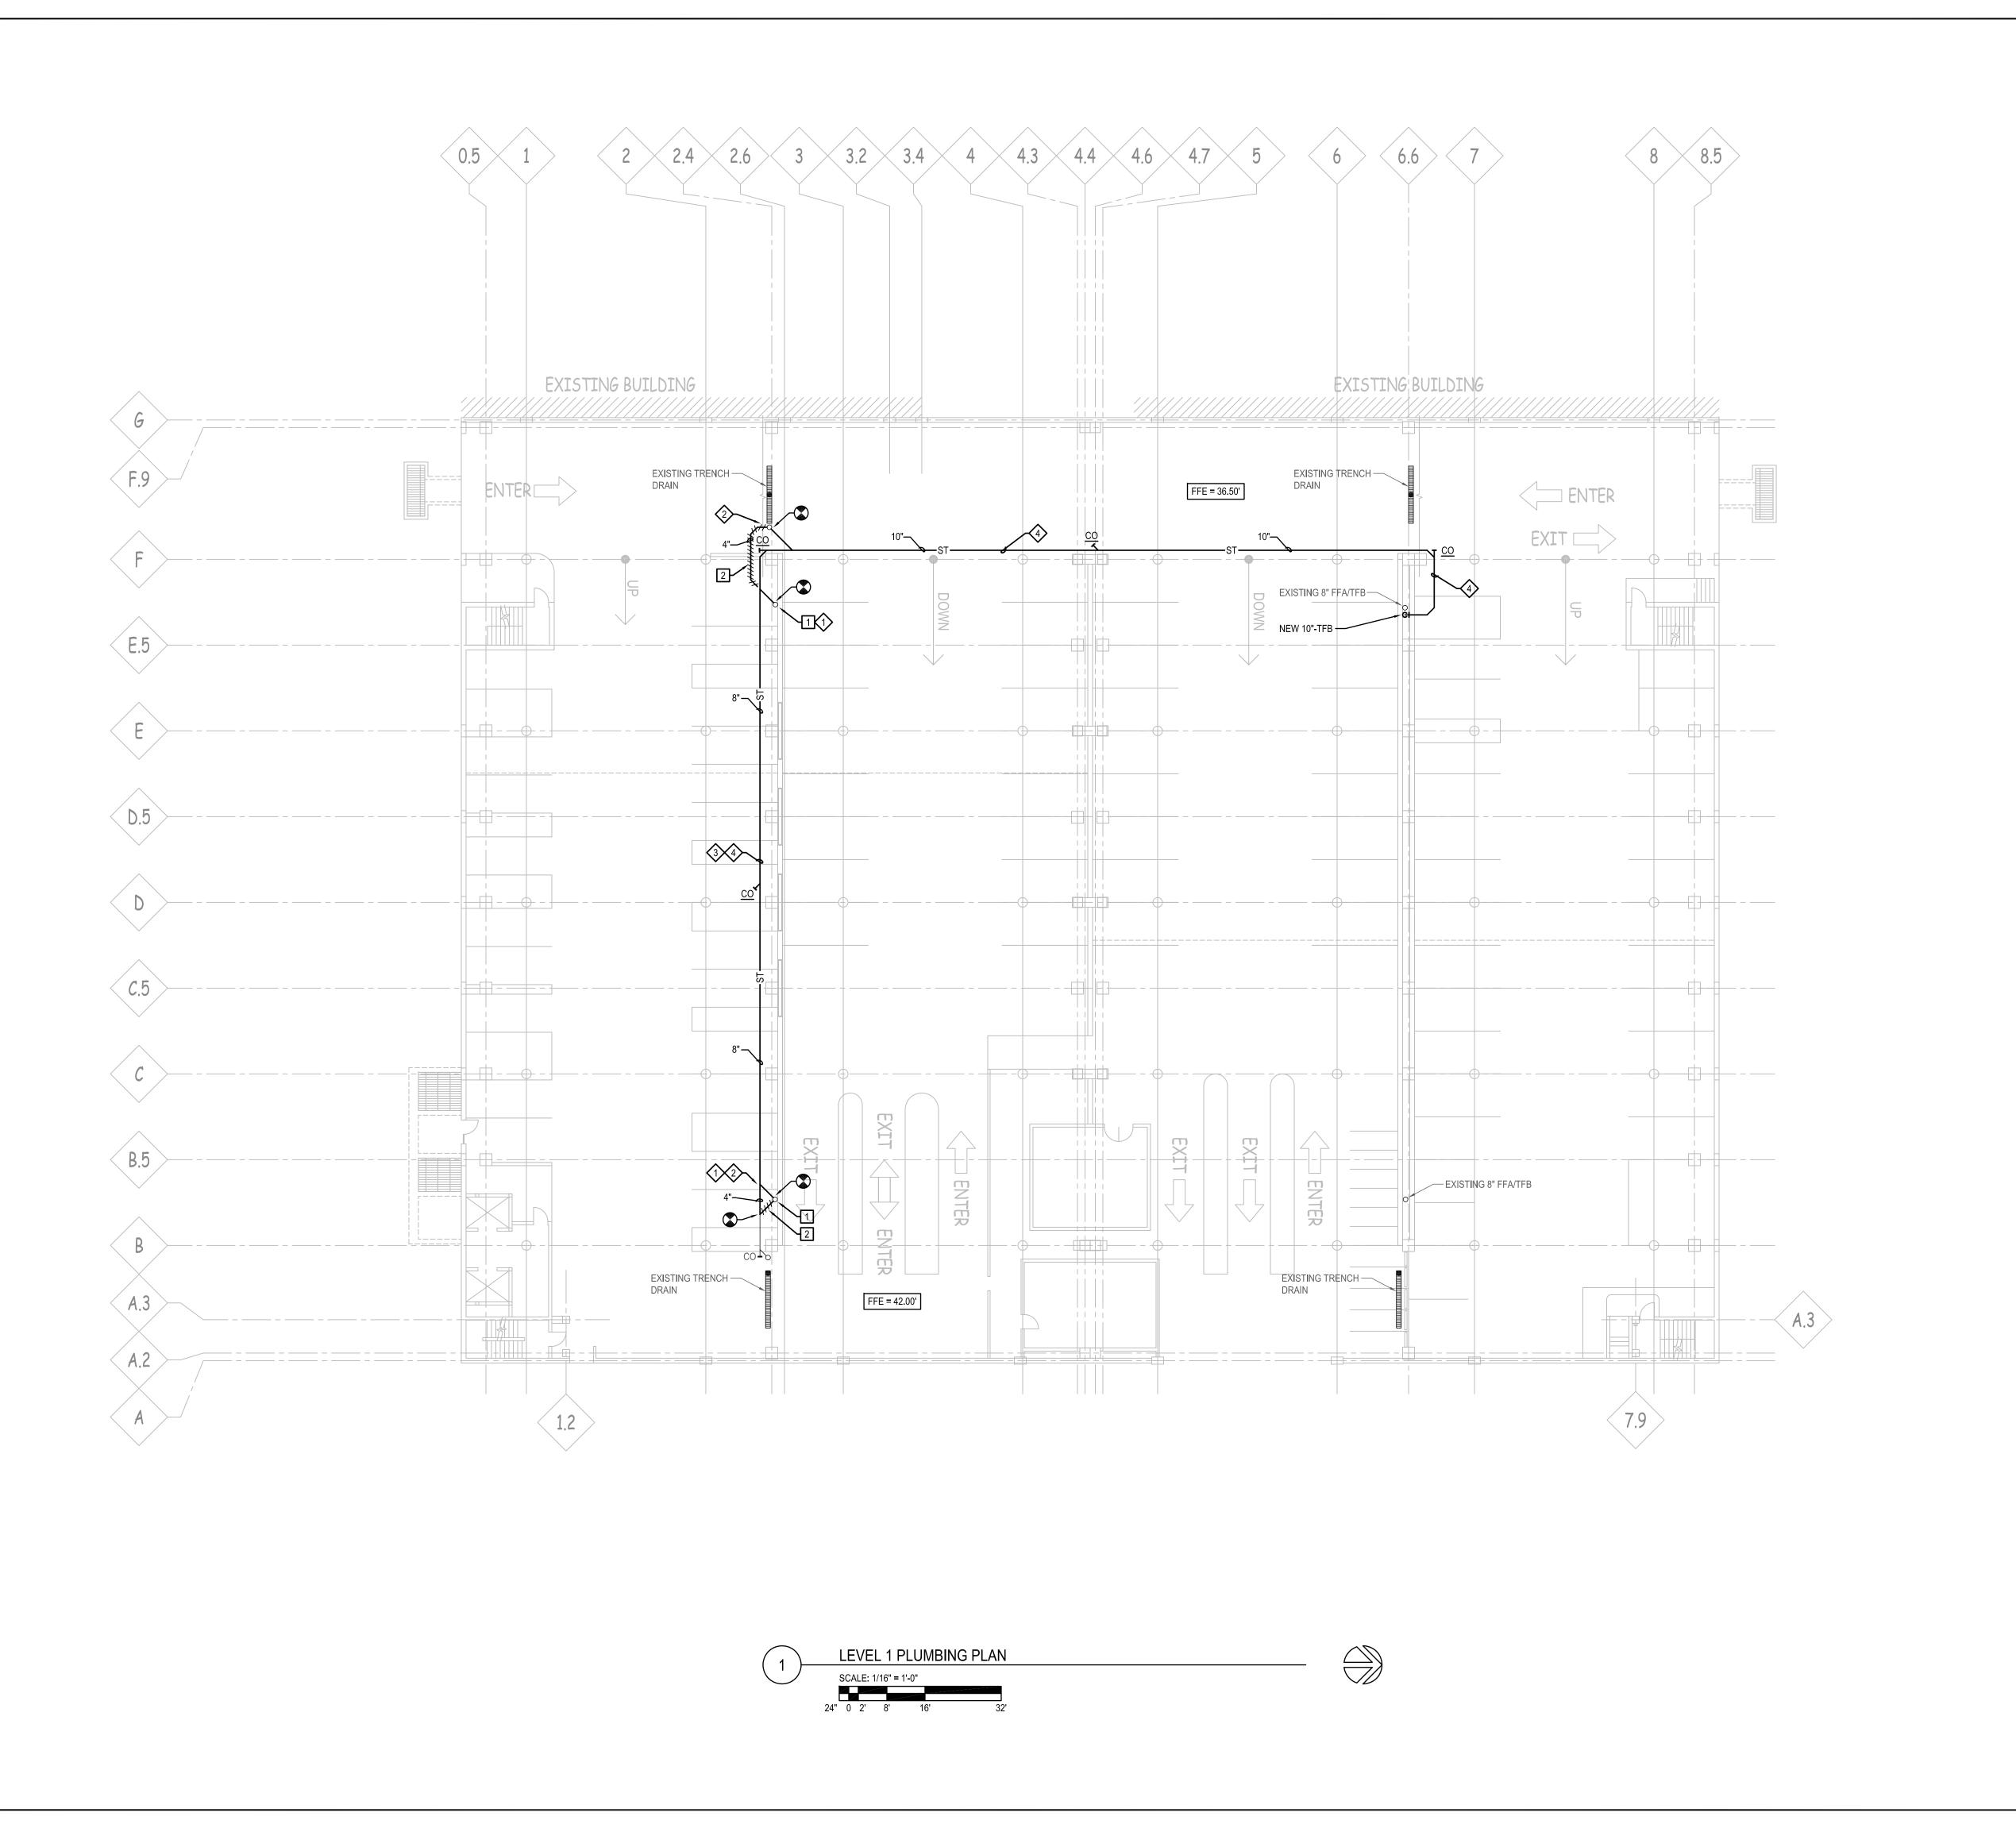

GENERAL NOTES (P101):

1. ALL PIPING SHOWN IS RUN AT CEILING.

KEYED DEMOLITION NOTES (P101):

1 REMOVE EXISTING 8" STORM CONDUCTOR FFA. CAP NEAR FLOOR.

2 REMOVE EXISTING 4" STORM PIPING.

KEYED NEW WORK NOTES (P101):

CONNECT TO EXISTING 8" STORM FFA.

2 RE-CONNECT EXISTING 4" STORM PIPING FROM FD/TD ON FLOOR ABOVE.

3 FOLLOW SLOPE OF DECK ABOVE.

4 INSTALL AS HIGH AS POSSIBLE.

2. ALL EXISTING PIPING TO REMAIN EXCEPT AS INDICATED.

Henneman Engineering

Madison:
1232 Fourier Drive, Suite 101
Madison, Wisconsin 53717-1960
T 608.833.7000 F 608.833.6996 Email: info@henneman.com Website: http://www.henneman.com JOB NO. 13-8002

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MADISON REGIONAL OFFICE 161 HORIZON DRIVE, SUITE 101 VERONA, WISCONSIN 53593 608.848.5060 PHONE 608.848.2255 FAX MADISON MILWAUKEE KENOSHA APPLETON

CITY OF UTILITY

215 MARTIN LUTHER KING JR. BLVD MADISON, WISCONSIN 53701-2986

2014 PARKING RAMP RESTORATION

PROJECT LOCATION: STATE STREET CAPITOL

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LEVEL 1 PLUMBING PLAN

P101