# LETTER OF INTENT February 19, 2014

# PUD/SIP Submission - THE **Johnson Bend** residential

# Proposed by

Les Orosz 505 University Avenue Madison, WI 53703

(608) 256-7368

Prepared by

Sutton Architecture 104 King Street Madison, WI 53703

(608) 469-2528

Architect Sutton Architecture

104 King Street

Madison, WI 53703

Design Consultant KEE Architecture

1111 Williamson Street Madison, WI 53703

Landscape Architecture Plandesign

Maynard Drive

Sun Prairie, WI 55555

Civil Engineering Quam Engineering

4604 Siggelkiow Road McFarland, WI 53558

Construction start June 2014

Construction completion August 2015

## STATEMENT OF RATIONALE (MARKET)

We are submitting within the UMX zoning for this site that will allow us to develop a mixed unit with 168 underground parking stalls, 2,107 square feet of commercial space, and 148 market- rate apartments.

Housing development has been very successful, but tenants have been requesting units with more amenities and contemporary design. By developing this site with a variety of one- and two-bedroom units, it will complement the available types of units renters are looking for. This area is very attractive because of the easy access to the Central Business District (CBD) and State Street area. Our marketing studies and all housing studies show the need for higher density in an area this close to the Square.

All housing projects in the downtown area have 99% occupancy and are rented 6 to 9 months in advance. We have talked to all of the downtown management groups and have obtained the same data. The downtown area has no vacancies. Some management groups are receiving up to 30 calls a week, even without advertising. This is across the board—market apartments and student units. Apartment buildings on the west side of Madison have a vacancy rate of 11%, while the vacancy rate on the east side of Madison is  $8\frac{1}{2}$ %.

Currently, there is a high demand for housing closer to the CBD for Epic employees, which makes this an ideal time to develop this site. There is absolutely no doubt that the market is there. All reports written in the last 10 years, along with all the evidence in renting trends bears this out. The number of apartment units is clearly less than the current demand. That demand is obviously growing due to the success at Epic and projections for growth.

#### **FEASABILITY**

We have surveyed the apartment market with respect to cost also. We surveyed apartment projects with at least 30 units. We have placed these into two categories. The first is older, well-maintained units. The second are the newer or unique apartments. We priced studios through four-bedroom apartments. This is the range we found: studio; \$450 - \$725, one-bedroom; \$725 - \$1,225, two-bedroom; \$1,275 - \$1,850, three-bedroom; \$1,500 - \$2,275. Our units will be priced near the high-end and very similarly to newer.

#### PROJECT DESCRIPTION

The proposed project occupies approximately .407 acre (17,451 s.f.) on three lots, 425, 431, and 435 West Johnson Street. The project requires demolition of one existing two-story brick veneer, 24-unit apartment building, one two-story wood frame apartment building, and one three-story wood frame apartment building. The new building will have two levels of parking with 168 stalls, 12 floors of residential apartments totaling 148 units, and two commercial spaces. We will have 125 one-bedroom units (565 to 770 s.f.) and 23 two-bedroom units (865 to 1,050 s.f.). We average 1.16 bedrooms per apartment.

Each unit has a laundry room. All units will have a full-size kitchen, upgraded finishes, and high efficiency heat pumps for HVAC. This project will total 2,107 square feet of commercial space, 126,371 square feet of residential space, and 32,052 square feet for parking.

POTENTIAL IMPACTS (AMENITIES)

Within a 4-block area there are restaurants, coffee shops, retail businesses, services (e.g., dry cleaning, travel agencies, medical), churches, banks, and recreation areas that will serve these tenants. Access to the State Street area is only 3 blocks away. All markets are showing the downtown to be the most desirable apartment location for new renters.

Our site is on the city bus route for easy access anywhere in the city. Also, we are close to two bike paths that are widely used. These are great transportation amenities for the tenants.

This type of development will also be an easy fit for all city services and utilities, not adding to the cost for the city. With a predominantly adult population, there will be no significant increase for local public schools. With new construction, there will be very little demand for city services. And with on-site management and security, there should be very little need for police calls. This project will, however, add over \$7,000,000 in taxes over the next 10 years with no city financial assistance. This project will also create 80 full-time jobs during construction and 12 full-time jobs upon completion.

#### NEIGHBORHOOD CONTEXT (DENSITY)

The proposed development takes into consideration the character of the planned neighborhood changes, as well as the use. All architectural features draw from the neighboring developments as well as the revised downtown plan and new zoning requirements.

We will have planters all around this building to develop a very friendly pedestrian feel. We are also going to replace the sidewalk, terrace, and curb for the entire length of the site. We can improve the amount of the terrace landscape and eliminate some of the utility poles in the rear of the site. We can also replace the one street light that does not match the newer historic ones.

Our site is four blocks off the Square and just off West Washington Avenue, a major artery, which contains a number of larger buildings. It is reasonable to have higher density and taller structures with the number of amenities and CBD facilities so close by.

#### OPEN SPACE

The open space on the site will be predominantly private patios and roof top terraces with composite deck finishes and planters. Built-in planters will be provided on the rooftop terrace area as well. The courtyard will have bike parking for visitors. The street terrace will have new grass and trees that will be maintained and improved.

Overall, the proposed project provides approximately 1,500 square feet of open space on

the first-floor terraces, 15,780 square feet on private balconies, and an additional 4,625 square feet of rooftop terrace. All the apartments will have exterior space that will allow for plants. The rear yard will add 1,320 square feet of open space.

#### PARKING AND ACCESS

We are constructing underground parking, using an automated parking technology. We feel the scale of this project will be better served in the long run with as many parking stalls as we can get in excess of 1 to 1. The mechanical system allows more stalls for the square footage. This will give us a ratio of 1.14 stalls per unit, almost one stall per bedroom. We have a surplus of parking during the day with a minimum of 25% of the stalls vacant. That will allow for shared parking during the day with the commercial use. The mechanical system has built-in redundancy to assure its reliability. Each parking deck will have three automated retrieval vehicles and will continue to work even if two are out of commission. There will also be two vehicle elevators. During peak times, both will be available for incoming as well as outgoing. In addition, we have sufficient driveway length to stack four deep for incoming traffic.

#### **MANAGEMENT**

Orosz Properties will provide full-time professional management and maintenance services, including an onsite resident manager and regular daily office hours. Management will include all aspects of renting, maintenance, and resident relations, including all snow removal and repairs. The building will be served by 24-hour emergency maintenance services. Fire alarms and elevator service is monitored 24 hours per day. Management includes all operations of the parking garage including, but not limited to, overhead door maintenance, lighting, carbon monoxide and exhaust maintenance, lighting, and cleaning. Parking management includes daily and regular attendance to approved users and monitoring of illegal/unauthorized users. Video surveillance and key fob entry for entry doors and garage entry will be state of the art.

Allowed resident rooftop usage hours are posted and noticed in lease addendum per historically ideal operating hours. This notice includes operating hours, expectations of behavior, clean up, and acceptable noise levels.

#### BIKE PARKING

Bicycle racks will be provided for the tenants within a secured area on the first floor. A minimum of 133 stalls will be provided inside two levels. An additional 22 stalls will be provided in the plaza for visitors, along with an additional 4 stalls for mopeds.

# **CURRENT ZONING**

The existing zoning is UMX. Below is a comparison of what is provided to what is required.

	actual lot	required		
Lot Area:	17,739 s.f.	3,000 s.f. minimum		
Yard Requirement:	0 front 5' left side 3.5' right side 10' rear	0 front 0 side 0 side 10' rear		
Useable Open Space: Rear yard Courtyard Balconies Roof Terrace Roof Planters	23,448 s.f. 1,320 s.f. 870 s.f. 15,708 s.f. 4,625 s.f. 925 s.f.	1,710 s.f.		
Lot coverage:	66%	90% maximum		
Off Street Parking:	1.14 per unit	0 per unit		
Bike stalls:	155	148		
Motorcycles	3	0		
Mopeds	4	0		
Building Height (max.)	998'	1032'		
Bedrooms per unit	1.16	N.A.		
Permeable area	27%	10%		

#### GENERAL DESIGN STANDARD

## Architectural Design

This mixed use building is located mid-block on the 400 block of Johnson Street. It is designed to enhance the street frontage through its L-shaped plan, creating a tall building elevation along part of the street, with a courtyard along the remainder of the site. The partially landscaped courtyard provides respite along the street edge, allows the building plan to be developed with sweeping balconies to capture views, both distant and close, and acts as a staging area for underground parking. An arcade encircles the building edge along the courtyard, created by a two-story masonry wall with large punched openings. This wall establishes a noble scale to the entrance and courtyard, while also serving as a visual base for the building. The masonry base continues around all sides of the building.

Above the masonry base from the third through the 11<sup>th</sup> floors, the enclosing material is horizontal metal in a bronze color, using a box shaped profile at 8 inch centers. Floors are articulated by 12" galvanized "C" channels which provide visual interest as well as good detailing opportunities for the "rain screen" wall construction. The top floor is characterized by a stepped-back balcony around the entire perimeter. We are endeavoring to make all walls of this level of glass to create transparency and a sense of a floating roof overhead.

The roof terrace will have a swimming pool for use by residents. A guardrail will define the occupied terrace area, with the remainder of the roof having intensive vegetation. This level is accessed by elevator with emergency exiting through two stairs extensions.

Except for the "townhouse" units on first floor, all apartments will have balconies, many with colorful side walls which will be constructed of EFIS for both durability and for the color opportunity. All of these locations are inboard of the enclosing walls and our intention is to create a sort of glowing signifier of the human activity within. We are currently experimenting with various colors.

The design provides a rigorous but straightforward use of clay masonry, galvanized steel, clear glass, and bronze-colored aluminum. Our desire is to provide a truthful use of materials where interest is achieved through composition in plan and in elevation, and through articulation of the elements of construction.

#### Utilities

All utility service within the proposed development will be provided underground. Water, gas, sanitary sewer, storm sewer, telephone, and cable currently run along West Johnson Street (see utility sheet C1.4).

## Storm Drainage

All storm water for the structure will drain to either roof drains or floor drains. We will slope the entrance driveway from the garage door to the street curb, which will limit the amount of water entering the parking garage. Over half of the entire site will have plantings to assist filtering the water of sediment before entering the storm sewer system.

#### Site Lighting

The design of all site lighting will be coordinated to complement the site design and architectural character of the building.

Site lighting will include recessed cans for all entrances and walkways under the structure and recessed wall mount pedestrian lighting at the first floor planters for the courtyard area.

All fixtures will be positioned with care taken to direct light away from windows and street traffic and will use LED bulbs.

# Signs

The building will be identified with street numbers on the face of the structure, laser cut into a one-inch thick galvanized steel plate, as shown on the renderings and building elevations. Any commercial signage will meet required guidelines and approvals.

Informational signage will be located on the interior of the entrance to the building. Appropriate site signage will be used for vehicle access from West Johnson Street, including stop sign and drive lanes.

#### Service Area

Trash collection will utilize space on the first floor with direct access to the exterior. We will use two compactors, one for trash and one for recyclables. Tenants will have access on each floor level to one trash chute and one recycle chute within there own trash room. The main trash room will be vented, have a water supply for cleaning, and a floor drain.

Mailboxes will be near the elevators on the first floor on the private residence side for security.

#### Landscaping

Open space areas will be planted with groundcover, shrubs, and trees to complement the site design, architectural character, and neighborhood. Most units will have access to their own area for planting as well.

A large planter in the courtyard will serve as a major focal point as well as separate the pedestrians from the vehicles.

The existing street terrace will be replanted at the completion of this project with canopy trees between 6" and 8" diameter of a species approved by the city forestry department.

### Walkways

All walkways and driveways will be constructed of concrete. The existing sidewalk will be replaced and widened along the entire site. We will restore the terrace and also replace the existing concrete curb for the abandoned driveway being removed.

The first floor courtyard will have a concrete wear surface that incorporates color and patterns to create more of a terrace feeling, blending the driveway and sidewalks together.

The rooftop terrace will be constructed with composite boards for walking surface, concrete planters, and metal railings to match the decks. The rail will be kept at least 6' from the roof edge.






View from West Johnson Street





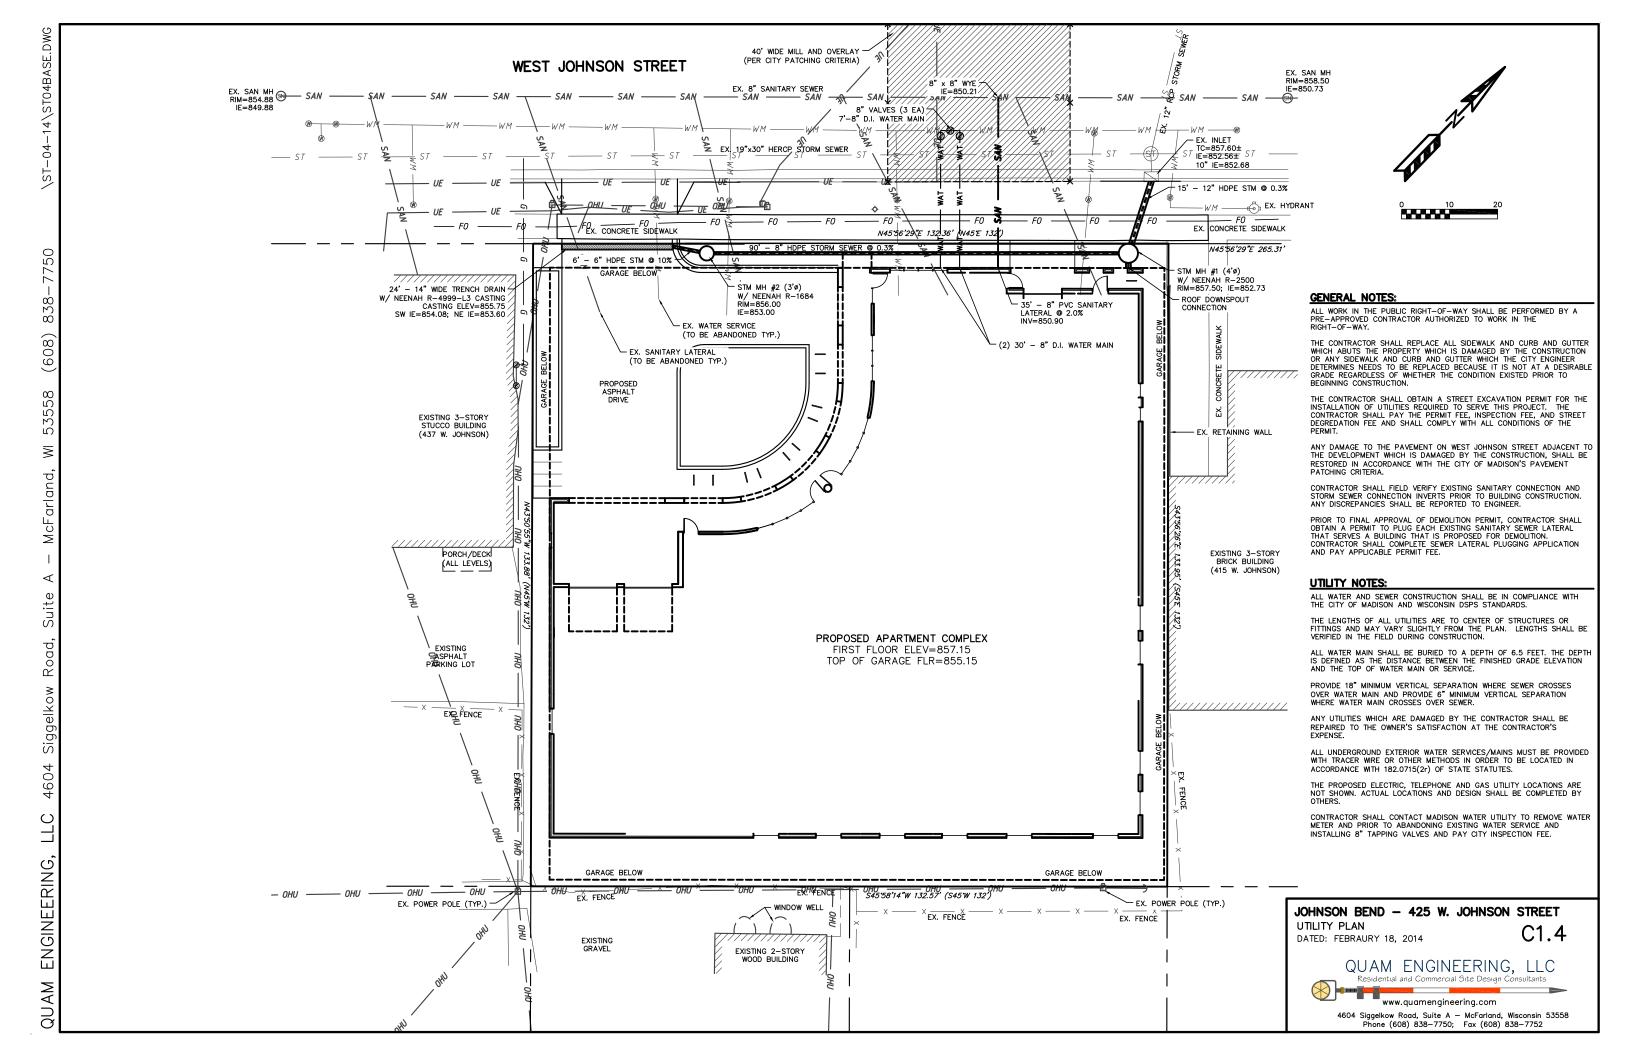



South West Elevation






## **LOCATION MAP**




#### A: 202 N Pinckney St, Madison, WI 53703-4149

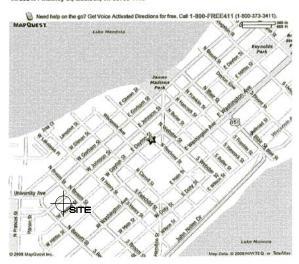

http://www.mapquest.com/maps?city=Madison&state=WI&address=202+N.+Pinckney

# ZONING MAP

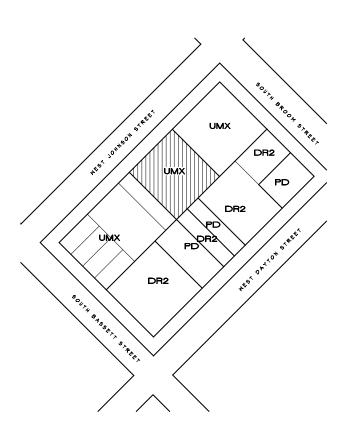

**OWNER** 

# es Orosz

505 University Avenue Madison, Wisconsin 53703

(608) 256-7368





### **PROJECT**

# Johnson Bend

433 West Johnson Street Madison, Wisconsin 53703

# SITE DATA

MOTORCYCLE

3 INTERIOR

#### TITLE SHEET LOT SIZE 17,739 SQUARE FEET (0.41 ACRES) TI.I 10,785 SQUARE FEET BUILDING FOOTPRINT COMMERCIAL 2,107 SQUARE FEET EXISTING SITE PLAN **APARTMENTS** 126,909 SQUARE FEET CI.2 SITE PLAN GARAGE 32,640 SQUARE FEET CI.4 UTILITY PLAN ONE BORM UNITS 125 TWO BORM UNITS 23 TOTAL UNITS 148 TOTAL BORMS 171 USEABLE OPEN SPACE REAR YARD AI.3 FIRST FLOOR PLAN 1,320 SQUARE FEET COURTYARD PLANTERS 870 SQUARE FEET BALCONIES 15,708 SQUARE FEET ALG THIRD FLOOR PLAN ROOF PLANTERS 925 SQUARE FEET GREEN ROOF 4,500 SQUARE FEET ROOF TERRACE 4,625 SQUARE FEET TOTAL ALIO ROOF PLAN 27,948 SQUARE FEET PARKING 168 (84 ADA ACCESSIBLE) BIKE STALLS 133 INTERIOR, 22 EXTERIOR, 155 TOTAL MOPEDS 4 EXTERIOR

INDEX


GRADING/EROSION CONTROL PLAN GROUND FLOOR LANDSCAPE PLAN ROOF TERRACE LANDSCAPE PLAN PARKING LEVEL P2 FLOOR PLAN AI.2 PARKING LEVEL PI FLOOR PLAN AI.4 FIRST FLOOR MEZZANINE PLAN AL5 SECOND FLOOR PLAN ALT TYPICAL FLOOR PLAN AI.8 TWELFTH FLOOR PLAN AI.9 ROOF TERRACE PLAN A2.I NORTHWEST ELEVATIONS A2.2 NORTHEAST ELEVATIONS A2.3 SOUTHEAST ELEVATIONS A2.4 SOUTHWEST ELEVATIONS

DRAWING

TITLE SHEET

Project # 201303 |T1.1




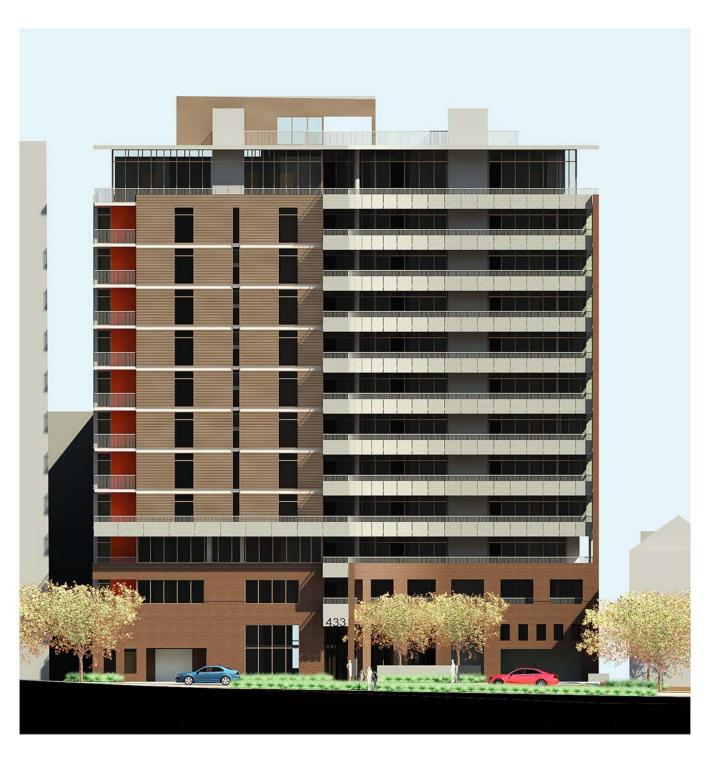

North West Elevation





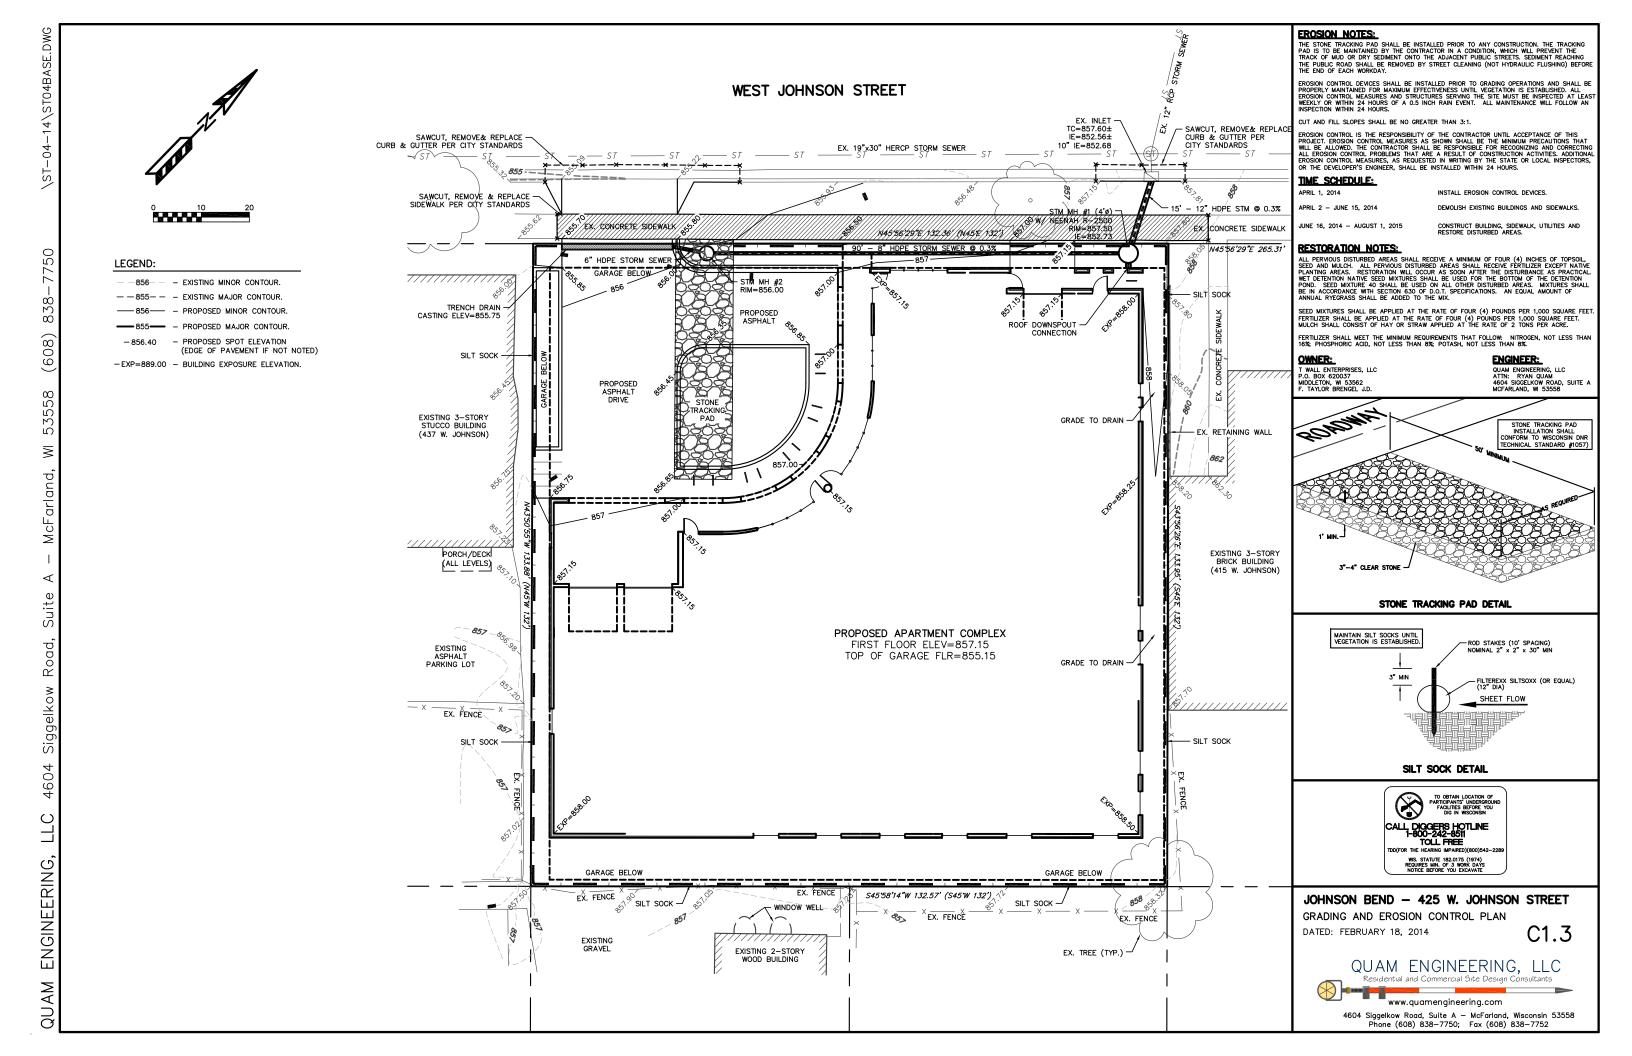



Aerial View looking North








Aerial View looking East





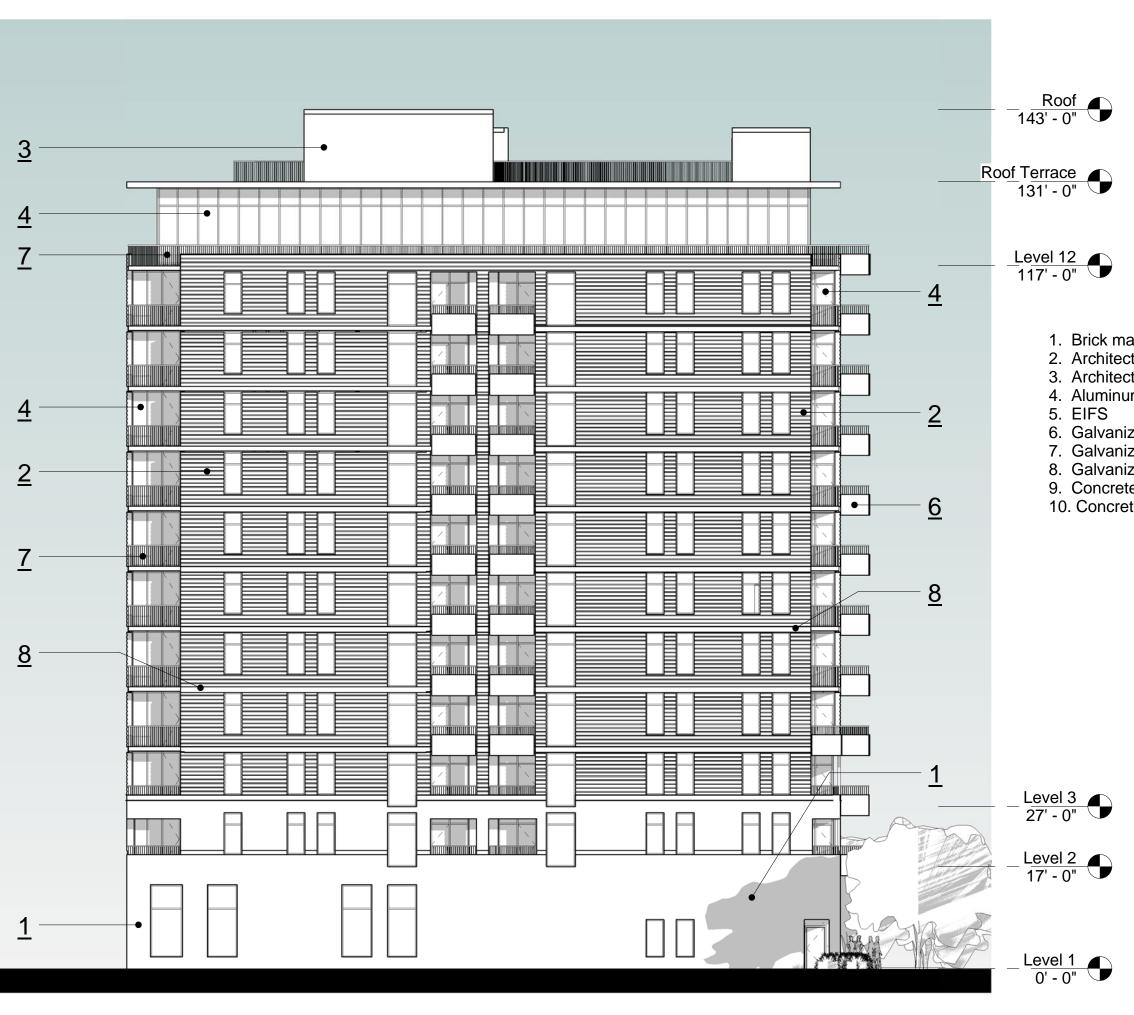






1. Brick masonry

- 2. Architectural metal panel (Type '1')
- 3. Architectural metal panel (Type '2')
- 4. Aluminum window system
- 6. Galvanized steel guardrail w/ 1/4" steel plate
- 7. Galvanized steel guardrail
- 8. Galvanized steel channel
- 9. Concrete column
- 10. Concrete planter

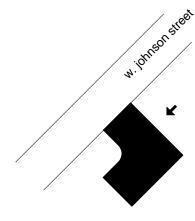

OWNER

Les Orosz (608) 347-5432 University Avenue Madison, Wisconsin

PROJECT

433 Johnson Bend

433 West Johnson Street Madison, Wisconsin 53703


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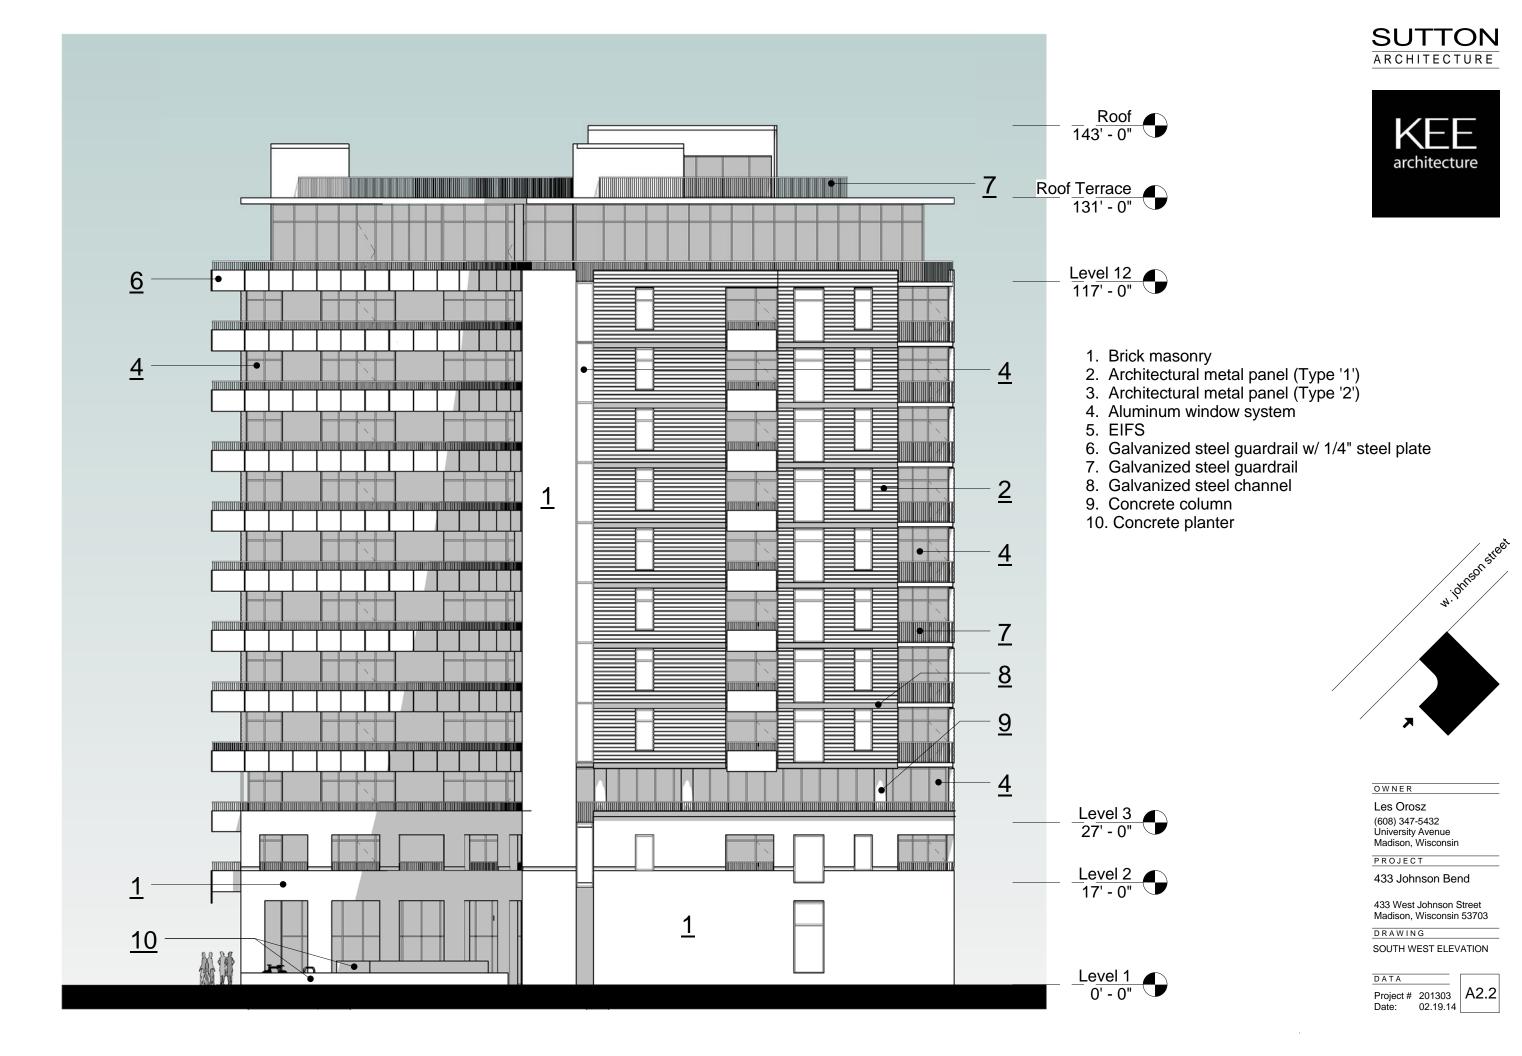
NORTH EAST ELEVATION


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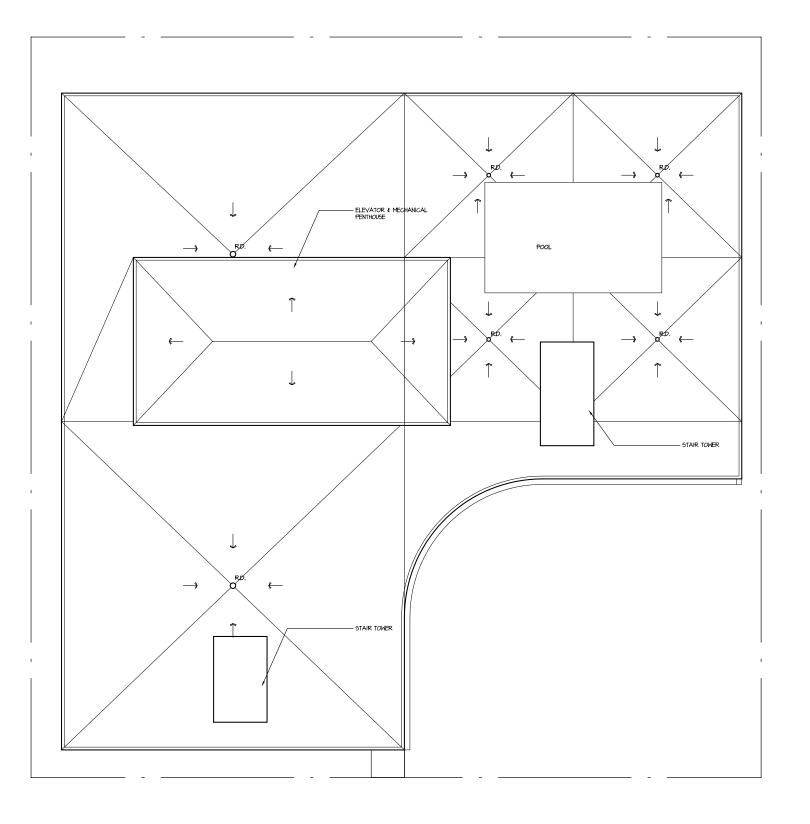
Project # 201303 | A2.4 Date: 02.19.14







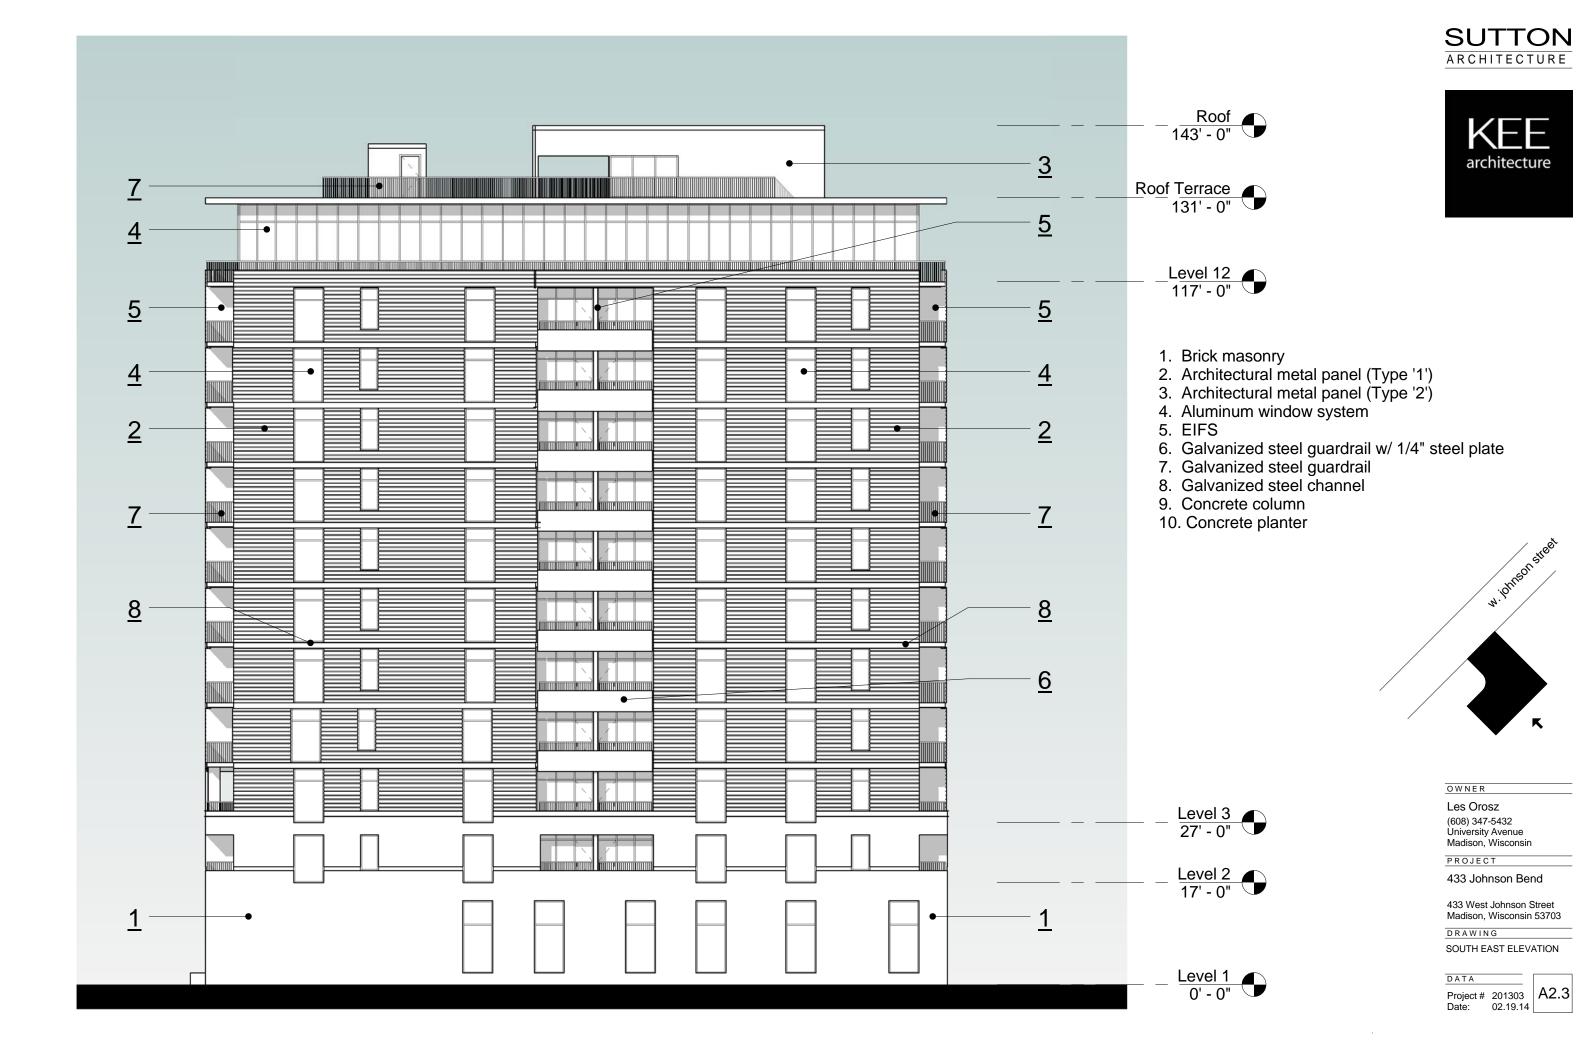

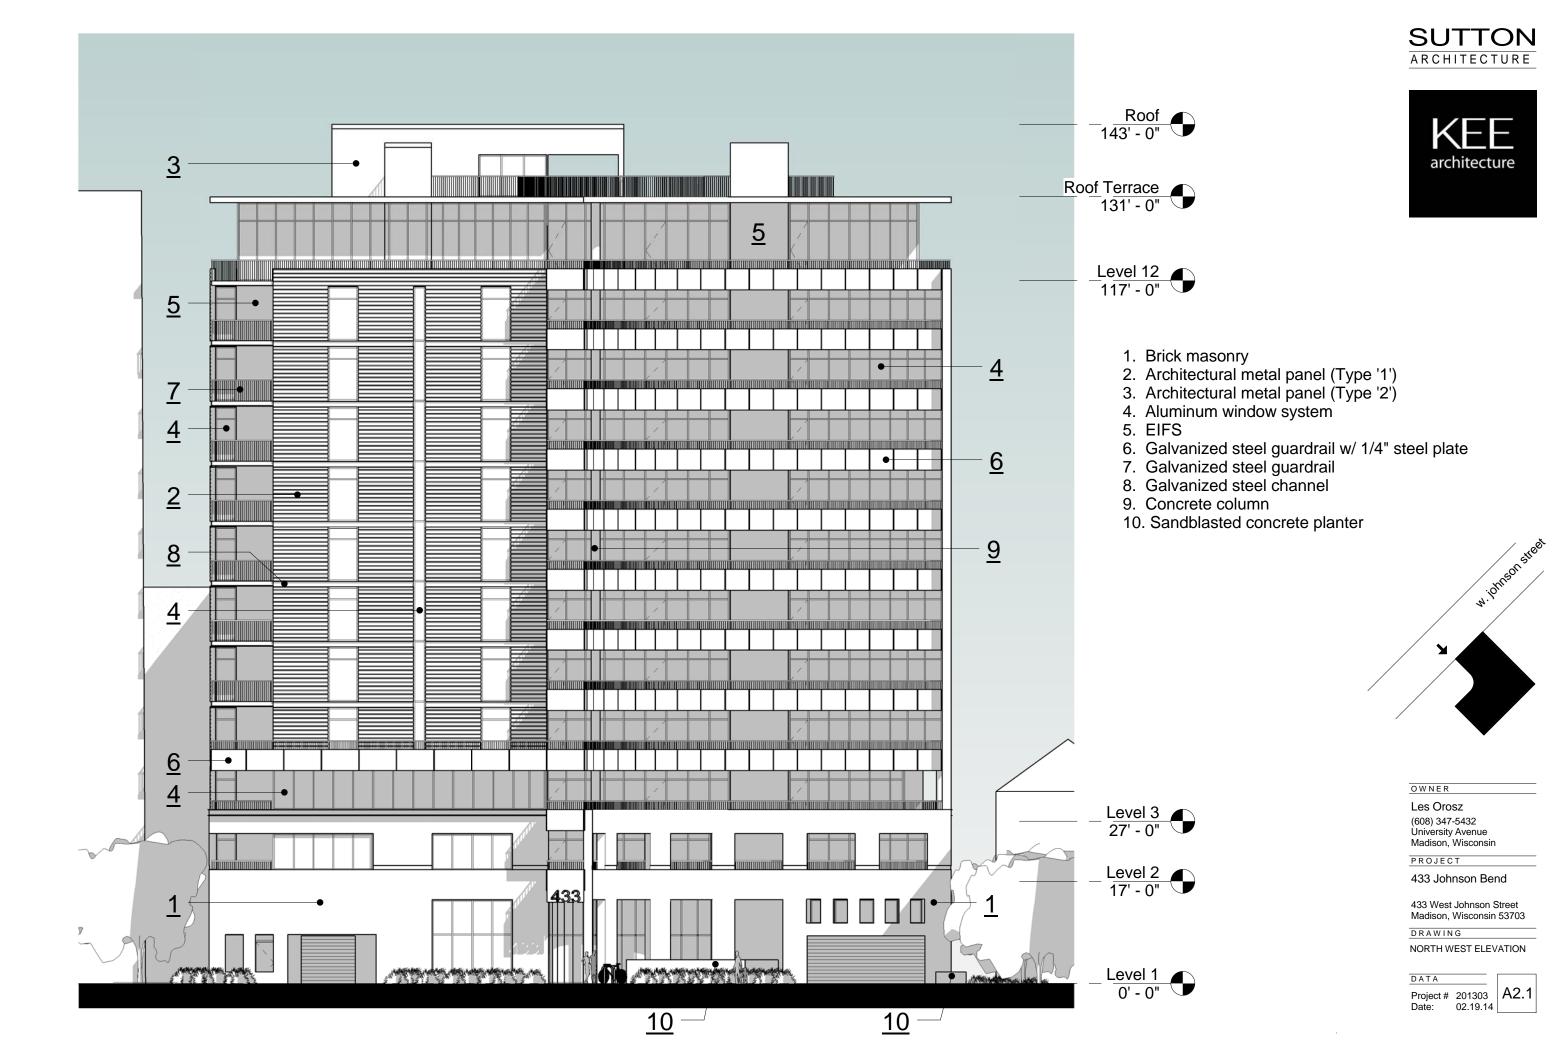





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PROJECT

Johnson Bend

433 West Johnson Street Madison, Wisconsin 53703

DRAWING

ROOF PLAN


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| ROOF TERRA

ROOF TERRACE PLAN



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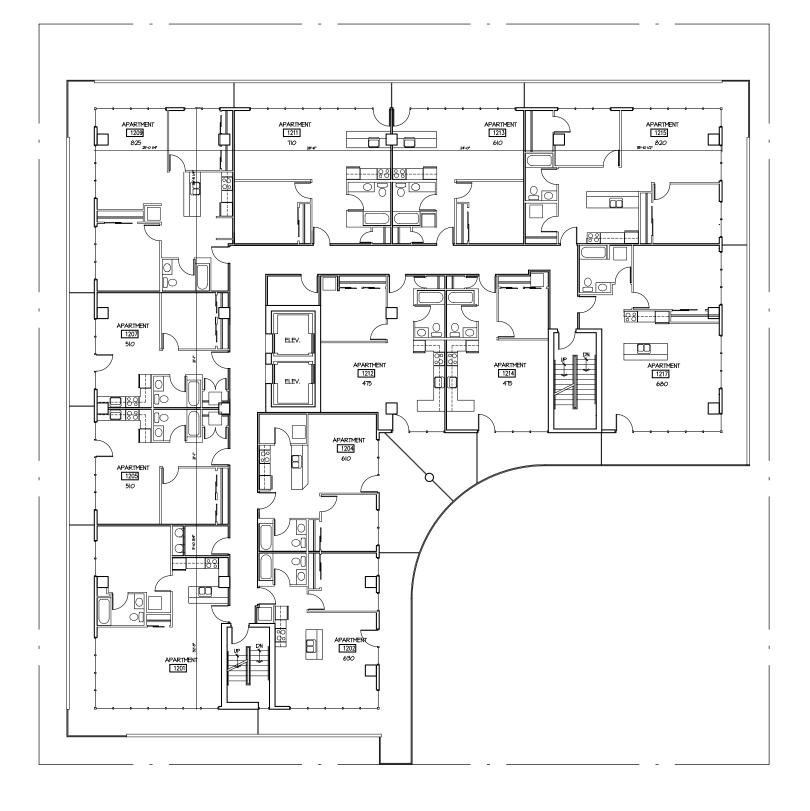
DRAWING

ROOF TERRACE PLAN
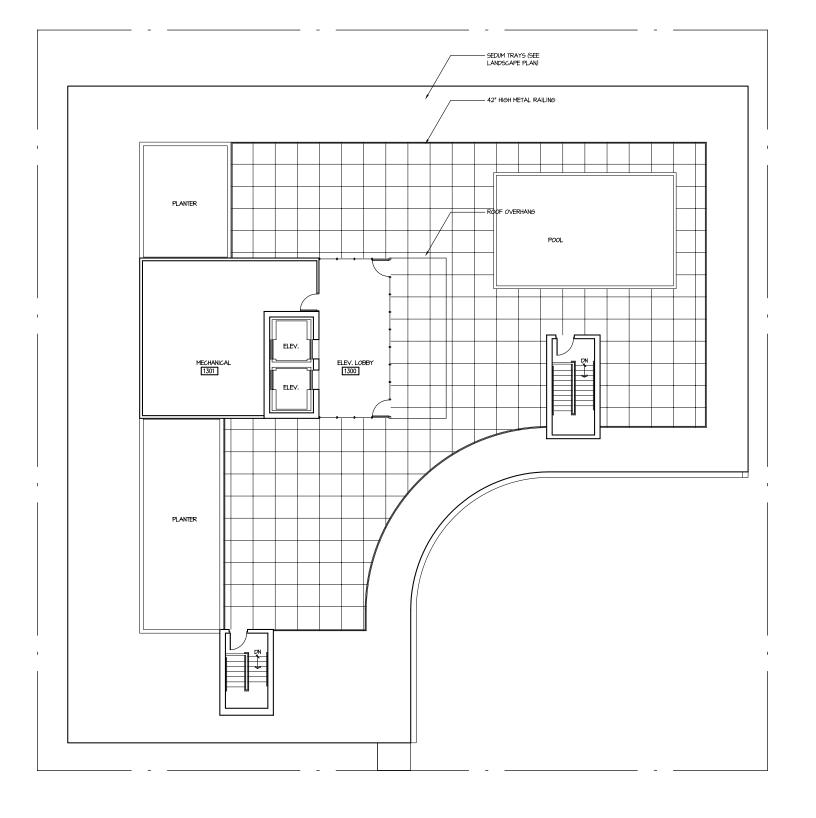
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TWELFTH FLO

TWELFTH FLOOR PLAN

12 UNITS



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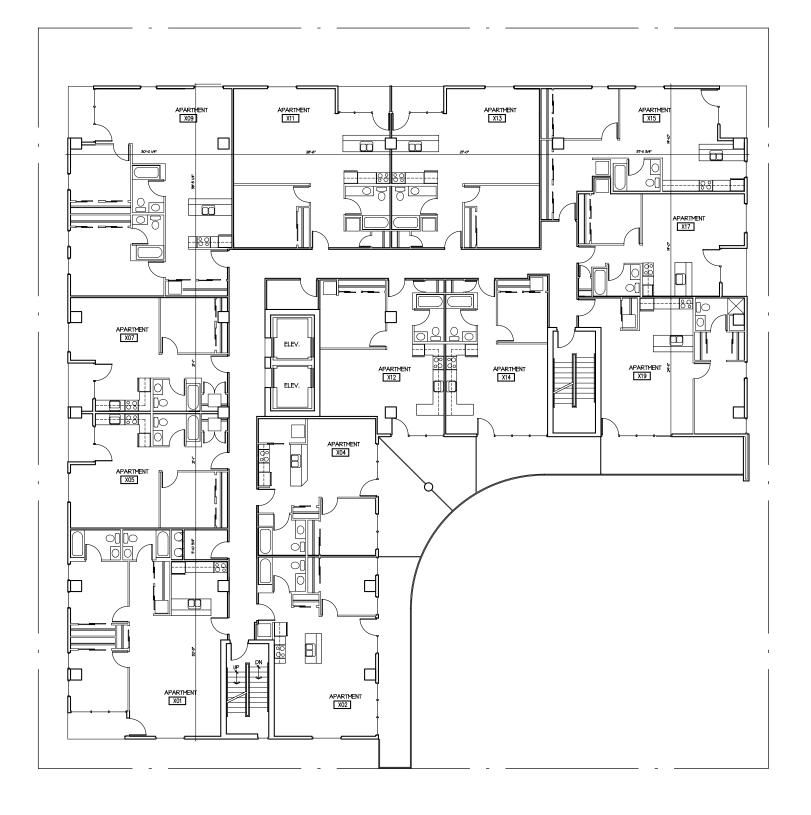
DRAWING

TWELVETH FLOOR PLAN

DATA







TYPICAL FLOOR PLAN

AI.7 SCALE: 1/8" = 1'-0"

13 UNITS



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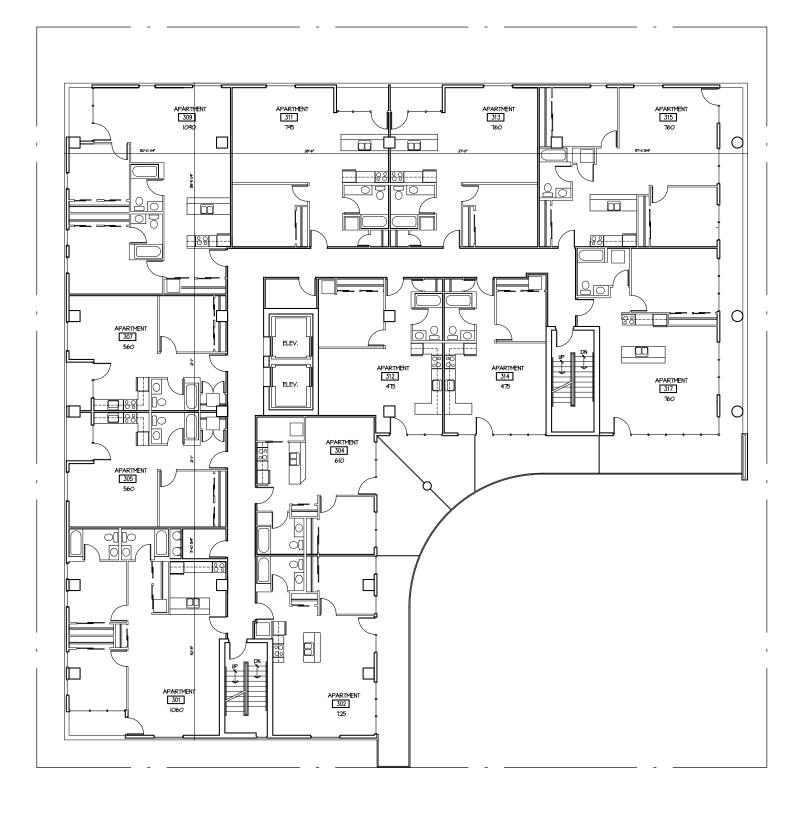
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TYPICAL FLOOR PLAN

DATA







Al.6

THIRD FLOOR PLAN

SCALE: 1/8" = 1'-0"

12 UNITS

NORTH

OWNER

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Johnson Bend

433 West Johnson Street Madison, Wisconsin 53703


DRAWING

THIRD FLOOR PLAN

DATA





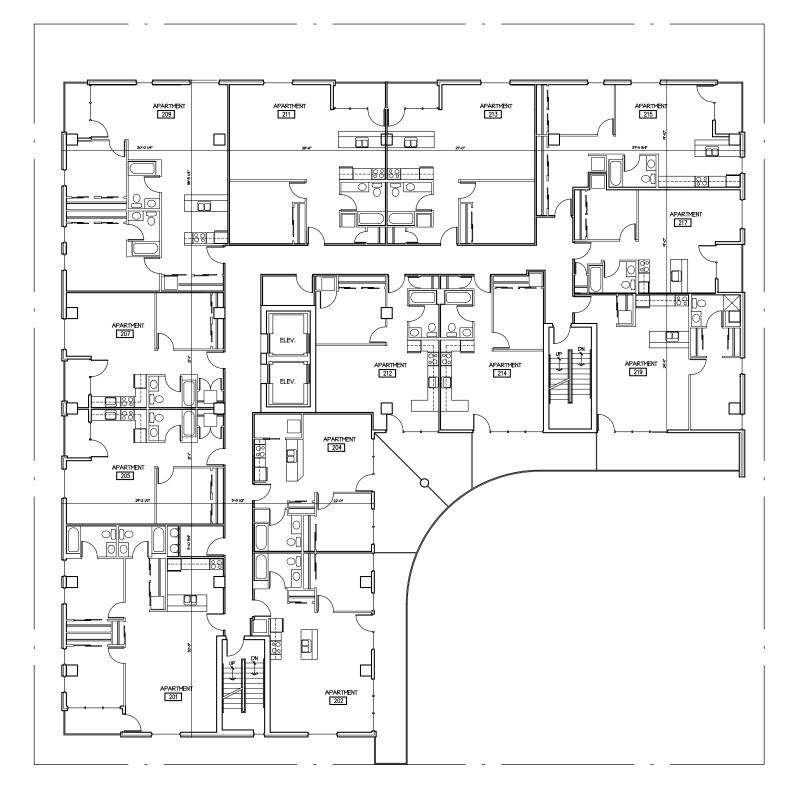

SECOND FLOOR PLAN

ALS SCALE: 1/8" = 1'-0"

13 UNITS



OWNER

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433 West Johnson Street Madison, Wisconsin 53703

DRAWING

SECOND FLOOR PLAN

DATA





APARIMENT APARIMENT APARIMENT APARIMENT III III III III III III III III III I
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BIKE STORAGE (18)  LOINGE 112  TRASH ROOM
FIRST FLOOR MEZZANINE PLAN  SCALE: 1/8" = 1'-0"  NORTH

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DRAWING

FIRST FLOOR MEZZANINE

DATA





Heave 9-412
VEHICLE STAGING VEHICLE STAGIN
FIRE DEPARTMENT  IDENTIFY
PLANTER  PLANTER  PLANTER  PLANTER
I FIRST FLOOR PLAN 7 UNITS  Al3 SCALE: I/8" = I'-0"  NORTH

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PROJECT


Johnson Bend

433 West Johnson Street Madlson, Wisconsin 53703

DRAWING

FIRST FLOOR PLAN

DATA

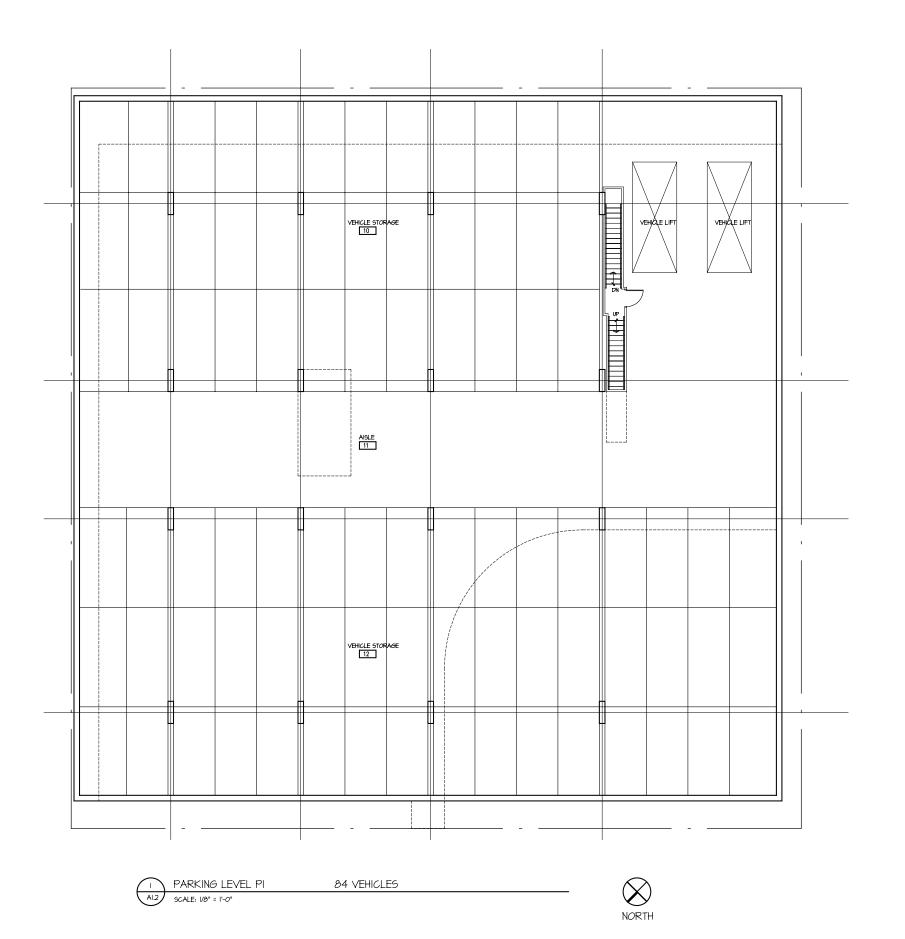





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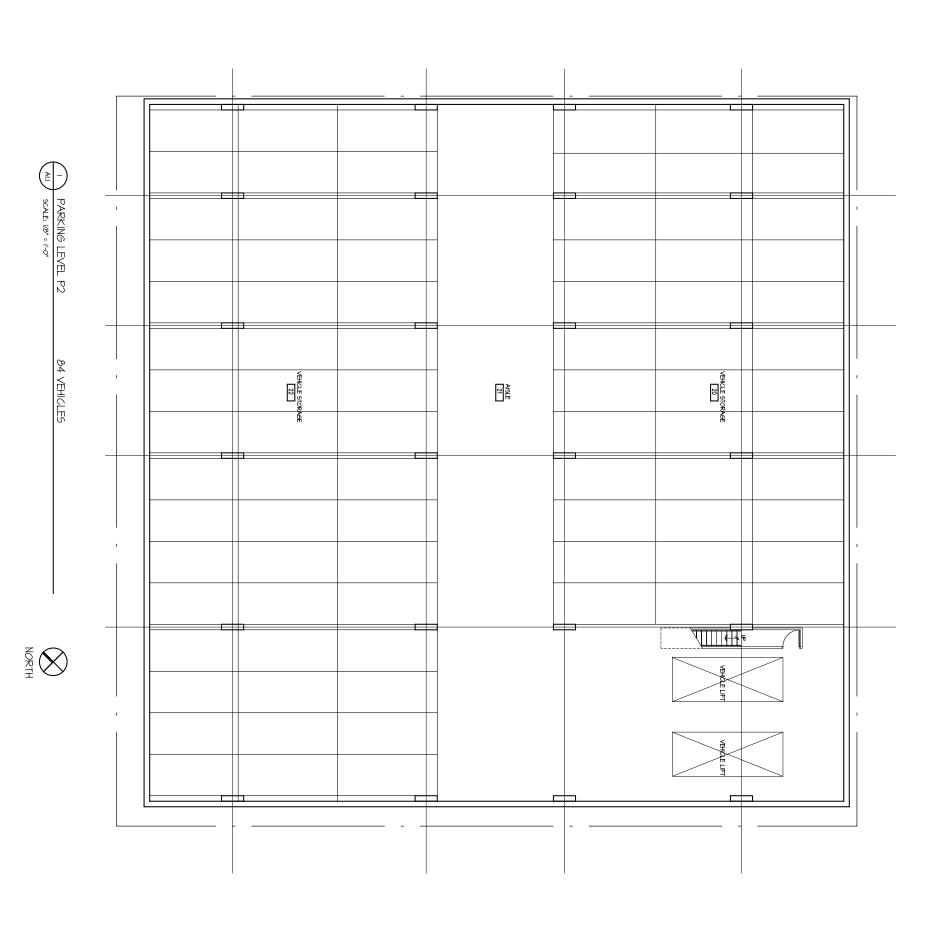
Johnson Bend

433 West Johnson Street Madison, Wisconsin 53703

DRAWING

PARKING LEVEL P1 PLAN

DATA






SUTTON

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Madison, Wisconsin 53703
PROJECT Johnson Bend

433 West Johnson Street Madison, Wisconsin 53703 DRAWING

PARKING LEVEL P2 PLAN

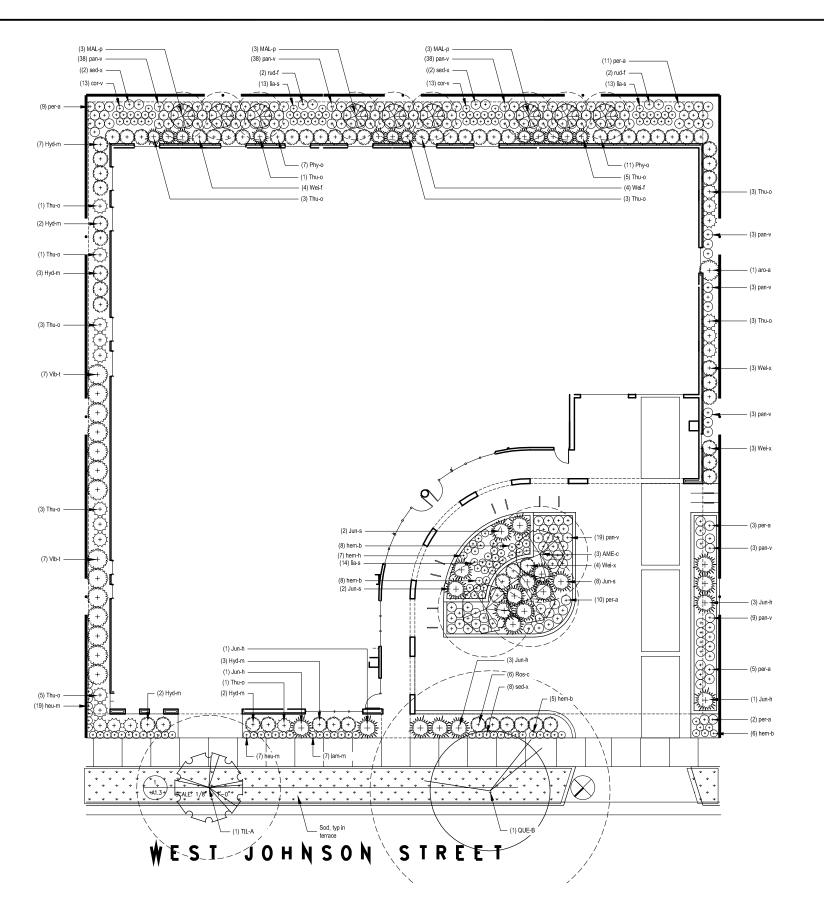




#### GENERAL LANDSCAPE & PLANTING NOTES

by plant spacing per schedule.

- 1. Plant material to be installed and maintained by a qualified and experienced landscape installer.
- All materials, plant locations and plant bed conditions are subject to the approval of the Landscape Architect and Owner at any time. Plants are to be freshly dug. Transporting of plants shall be done in a manner as to not destroy the natural shape, compromise the health, or alter the characteristics of plant materials.
- 3. Rootballs shall meet or exceed size standards as set forth in 'American Standards for Nursery Stock'. MAIN LEADERS OF ALL TREES SHALL REMAIN INTACT.
- Remove from the site any plant material that turns brown or defoliates within five (5) days after planting. Replace immediately with approved, specified material.

  4. Plant counts indicated on drawings are for Landscape Architect's use only. Contractor shall make own plant quantity takeoffs using drawings, and plant schedule requirements (i.e., spacing), unless otherwise directed by Landscape Architect. Contractor to verify bed measurements and install appropriate quantities as governed
- All plant beds shall receive 3" minimum of genuine shredded hardwood bark mulch (unless otherwise noted). Apply pre-emergent herbicide as directed by the manufacturer prior to installing mulch.
- 6. The Contractor shall install and/or amend topsoil in all proposed bed areas to meet ASTM D5268 standards. Landscaper shall verify depth and quality of topsoil prior to plant installation. A minimum of 4" of topsoil is required for seeded areas; 12" for plant beds. Topsoil sources shall include the reuse of surface soil stockpiled on site, clean of roots, plants, sod, stones, clay lumps, and other extraneous or foreign materials larger than 1". Supplement with imported topsoil from off-site sources when quantities are insufficient. Do not obtain supplemental topsoil from agricultural land, bogs, or marshes. Inorganic amendments, organic amendments, and fertilizers shall be used to amend topsoil as needed for long-term plant health.
- 7. Verify all utility locations in the field prior to beginning work. Repair all damaged utilities to satisfaction of the Owner and Operating Authority at no additional cost.
- 8. Install all plant material in accordance with all local codes and ordinances. Obtain any required permits necessary to complete work. All workmanship and materials shall be guaranteed by the Contractor for a period of one (1) calendar year after Final Acceptance.
- 9. Maintain all new lawn and plant material for a three (3) month period from date of Substantial Completion. Maintanenace shall include pruning, cultivating, watering, weeding, fertilizing, restoring plant saucers, spraying for disease and insects, and replacing tree wrappings. Recommended long-term maintenance procedures shall be provided to the Owner before expiration of this period.
- 10. Recondition soil and seed/re-reseed all areas disturbed by construction activities that are not to receive other surface treatment (i.e. pavement, planting bed, etc.). Seed with WiDOT 40 or equal.
- 11. All plant beds to receive steel edge (see Detail 8/L301) where bed is not bounded by a structure or pavement unless otherwise noted.
- 12. Scientific names of plants to take precendence over common names.
- 13. SOD: Provide Highland type, nursery-grown sod of dense growth, with a strong, fibrous root system, and shall be composed of at least seventy-five (75) percent Kentucky Bluegrass, mixed with fescue and perennial rye grasses, and free of pernicious weeds. Cut the sod at a length of approximately 2" (5.1 cm), and rake the sod free of debris.
- 14. Landscape boulders Weathered Waupon boulders available at Madison Block and Stone (contact: Tyler Anderson 608-249-5633 x224) or approved equal. Height of boulder indicated on plan refers to height above grade. Length and width shall be scaled according to plan.

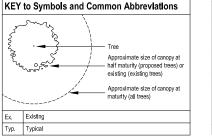

Total points required = Total Landscape Units (Total SF points = (17,673 SF / 300) x 5 = 295 points	of devel	oped are	a / 300	) x 5
	Ground Level		Roof	
TABULATION OF POINTS & CREDITS		Pts	Qty	Pts
Overstory deciduous trees (min 2.5" caliper) @ 35 pts ea.				П
Ornamental trees (1.5" caliper) @ 15 pts ea.	12	180		
Evergreen trees (min 3' height) @ 15 pts ea.				
Shrub, deciduous (min 18" ht or 3 gal cont) @ 2 pts ea	75	150	9	18
Shrub, evergreen (min 18" ht or 3 gal cont) @ 3 pts ea	53	169	13	39
Ornamental grasses (min 18" ht or 3 gal cont) @ 2 pts ea.				
Decorative fence @ 4 points / 10 linear feet				
Subtotals		499		
Total proposed landscape points achieved				5

rtments pranbesign ...

Approval Drawings for Johnson Bend Apartments 425 W Johnson Street, Madison, WI 53703 Les Orosz

wner: Les Orosz
University Avenue, N
association with: Sutton A

vision Date Description

Issued for:	Approval
Issue Date:	2014-02-18
Job No:	2014-045
Drawn by:	ASA

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These Drawings and Specifications, and all copies thereof are and shall remain it properly and copyright of the Landscape Architect. They shall be used only with respect to this project and are not to be used on any other project or work withou prior witten permission from the Landscape Architect.




Sheet Title

Ground Level Landscape Plan

Sheet No:



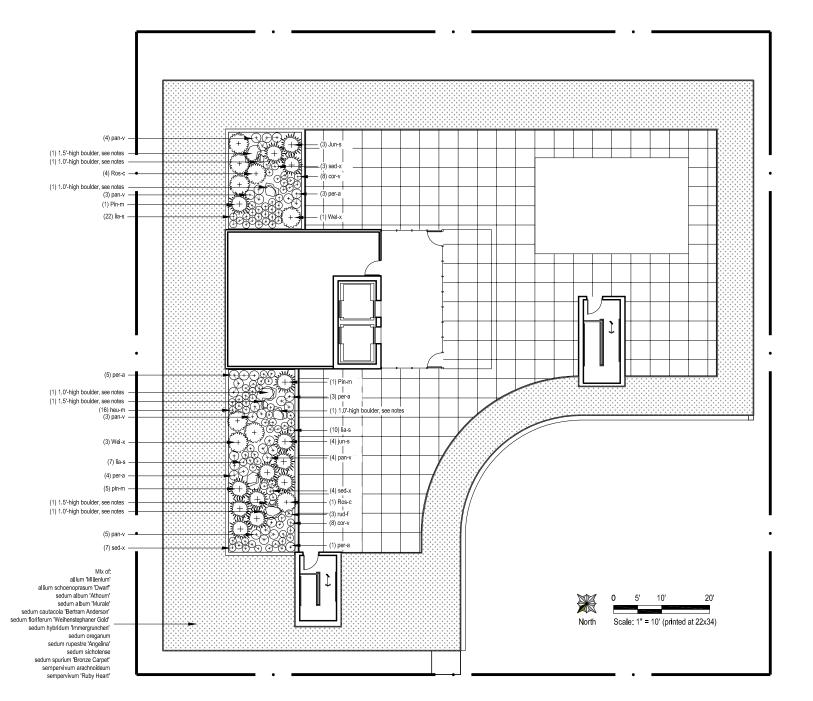

TREE PLANTING NOTES:

1. Mark the north side of the tree in the nursery and rotate tree to

face north at the site whenever possible.

Each tree must be planted such that the trunk flare is visible at the

top of the root ball. Trees where the trunk flare is not visible shall top of the root ball. Trees where the trunk flare is not visible shal be rejected. On on cover the trunk flare with soil.

If the root ball is wrapped in plastic or other non-biodegradable material, remove the entire wrap. If the root ball is wrapped in burlap, remove burlap and with sakels from tops of root balls and partially from sides, but do not remove from under root balls.

Wrap trees of 2" cal. or more w/trunk tape to first branch. DO NOT girdle tree.

Trunk flare, see Tree Planting Notes

- Slope & scarlfy sides of pit.

bottom of pit.

TREE PLANTING
Not to scale

3" shredded hardwood bark mulch, no dyes.
 Do not place mulch in contact with tree trunk.


- Width of pit to be two (2) times ball diameter


Water thoroughly after pit is half filled.


Set root ball on undisturbed soil cone at

ONLY in excavations that hold water longer


3" high topsoil saucer equal in diameter to root ball

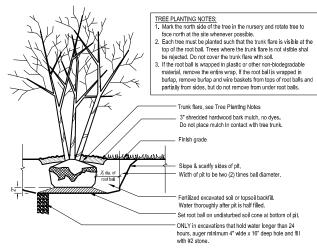


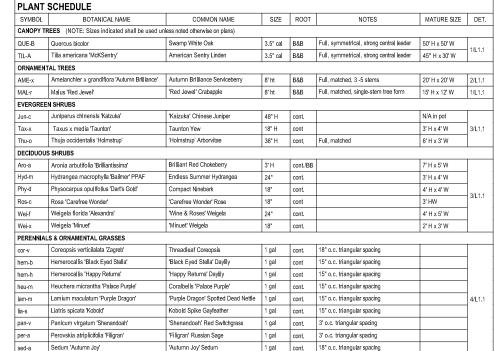

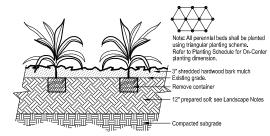

PERENNIAL PLANTING
Not to scale

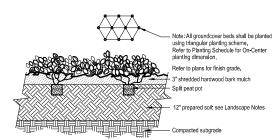

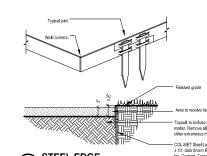

GROUNDCOVER PLANTING

Not to confe 6 STEEL EDGE
Not to scale

ndesign LLC - 480 Maynard Drive · Sun Prairie, WI 53590 608.318.1217 · Fax 608.318.1216 · www.plandesignIlc. prandesign Landiversion Passion

Johnson Bend Apartments 425 W Johnson Breit, Madison, WI 53703

Issued for: Approval Issue Date: 2014-02-18 Job No: 2014-045 Drawn by: ASA


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Sheet Title: Roof Landscape Plan

Sheet No: 2 of 2



3 SHRUB PLANTING

Not to scale

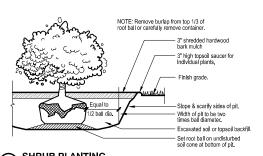than 24 hours, auger minimum 4" wide x 16" deep hole and fill with #2 stone. 2 MULTI-STEM TREE PLANTING
Not to scale











