
APPLICATION FOR
URBAN DESIGN COMMISSION
REVIEW AND APPROVAL

AGENDA ITEM#_	
Project #	
Legistar #	

	DATE SUBMITTED:	Action Requested Informational Presentation	
	UDC MEETING DATE:	Initial Approval and/or Recommendation Final Approval and/or Recommendation	
-	PROJECT ADDRESS: 4824 High Crossing Blvd/ 2: ALDERMANIC DISTRICT: 17	501 East Springs Drive	PL
	OWNER/DEVELOPER (Partners and/or Principals) Don Goben, DMG Holding Company LLC	ARCHITECT/DESIGNER/OR AGENT: Arlan Kay, AIA, Architecture Network Inc	LEASE
. ,	1415 Pflaum Rd	116 E Dayton St	H
T T	Madison, WI 53716	Madison, WI 53703	7
	CONTACT PERSON:  Address:  Amy Hasselman, AIA, Archi  116 E Dayton St  Madison, WI 53703  (608) 251-7515 x33  Fax:  (608) 251-7566  E-mail address: amy_hasselman@architecture		PRINT:
	well as a fee) School, Public Building or Space (Fee may be re	of a Retail, Hotel or Motel Building Exceeding 40,0  4 District (Fee required)	
	Street Graphics Variance* (Fee required) Other		

\*Public Hearing Required (Submission Deadline 3 Weeks in Advance of Meeting Date)


Where fees are required (as noted above) they apply with the first submittal for either initial or final approval of a project.

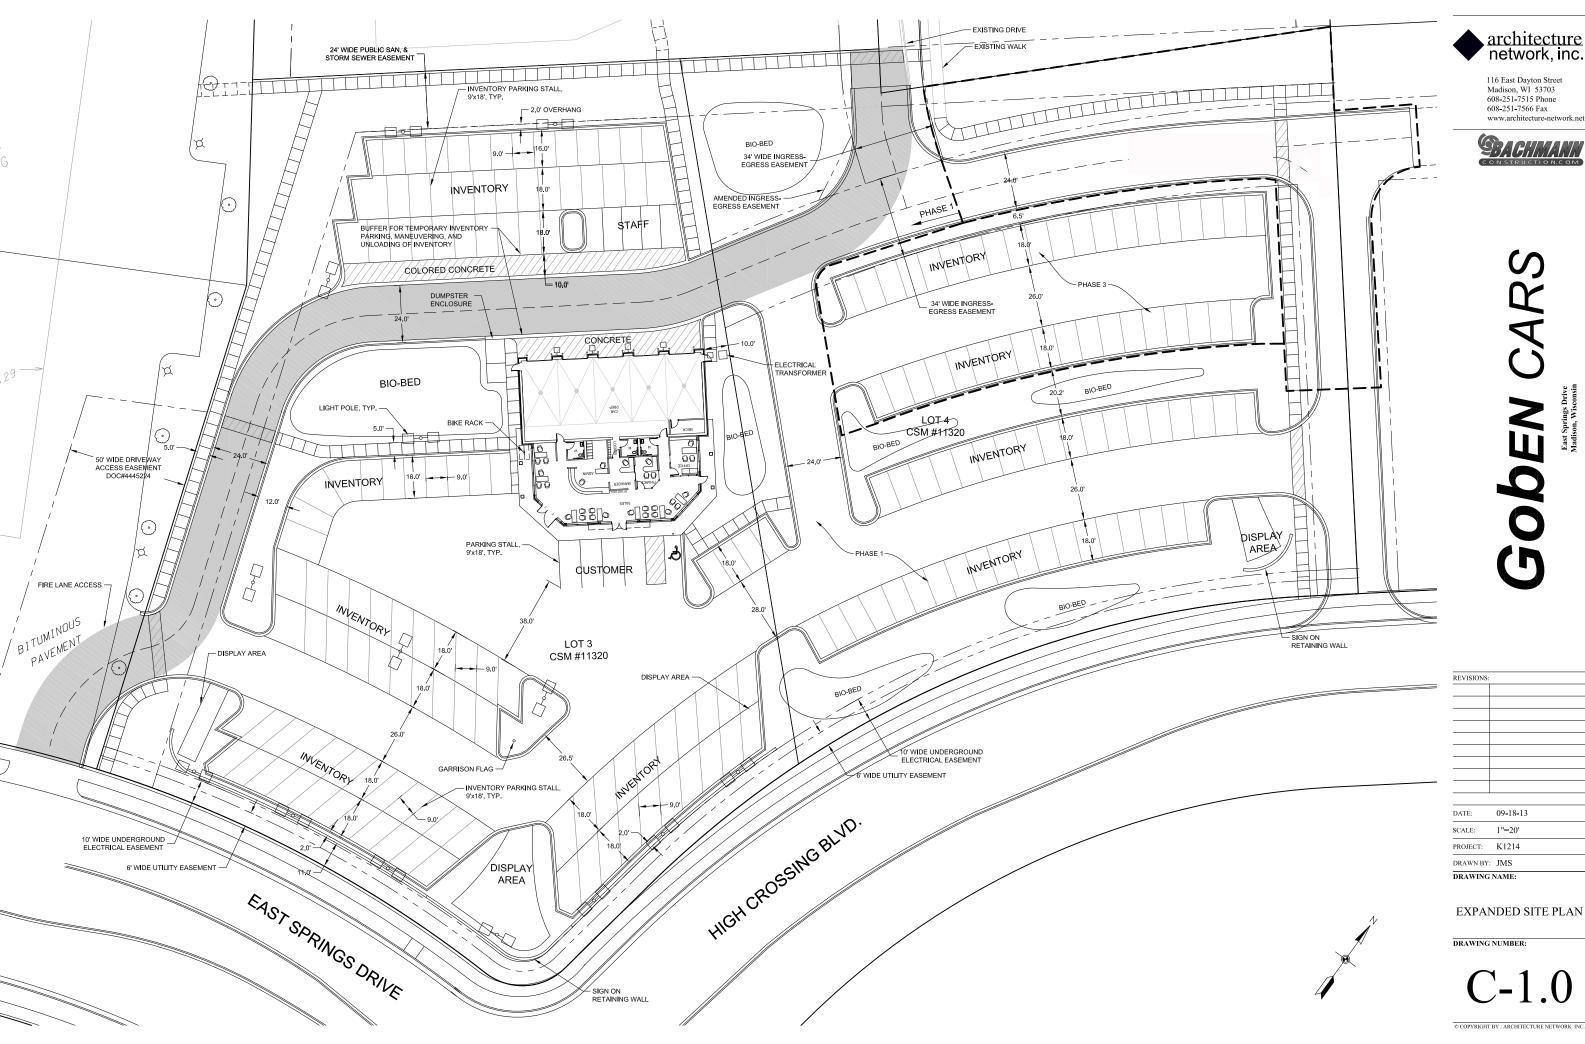

architecture network, inc.

608-251-7515 Phone 608-251-7566 Fax www.architecture-network.net



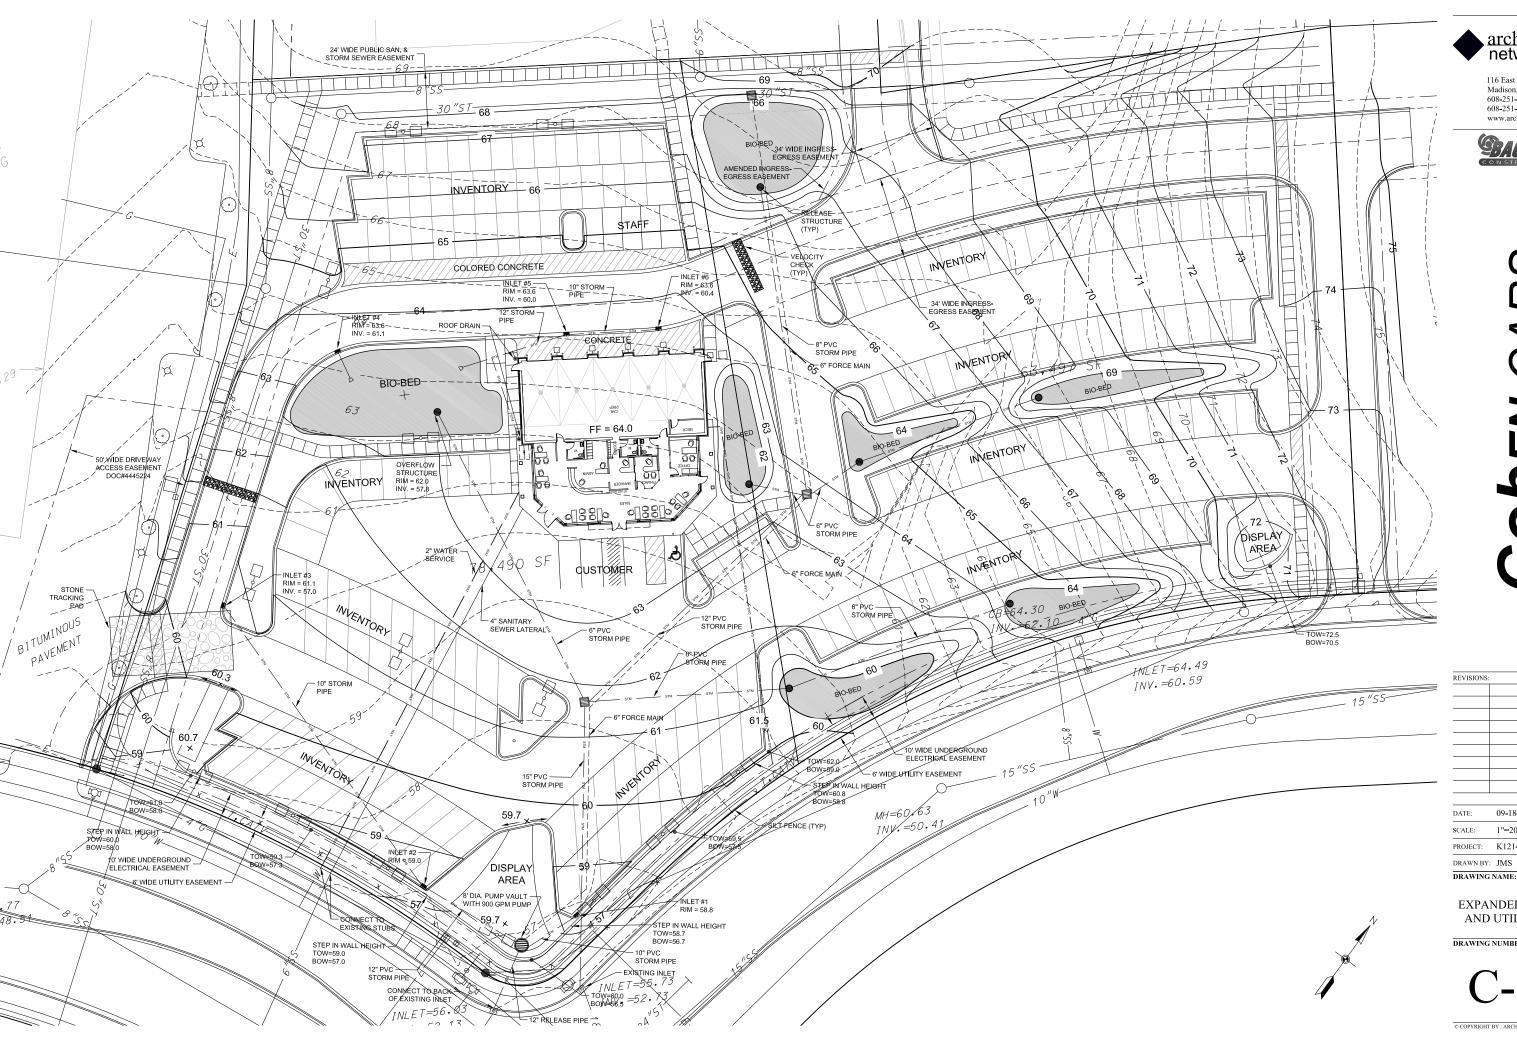

architecture network, inc.


116 East Dayton Street Madison, WI 53703 608-251-7515 Phone 608-251-7566 Fax www.architecture-network.net



09-18-13 1"=20" K1214

**EXPANDED GRADING** AND UTILITY PLAN

DRAWING NUMBER:

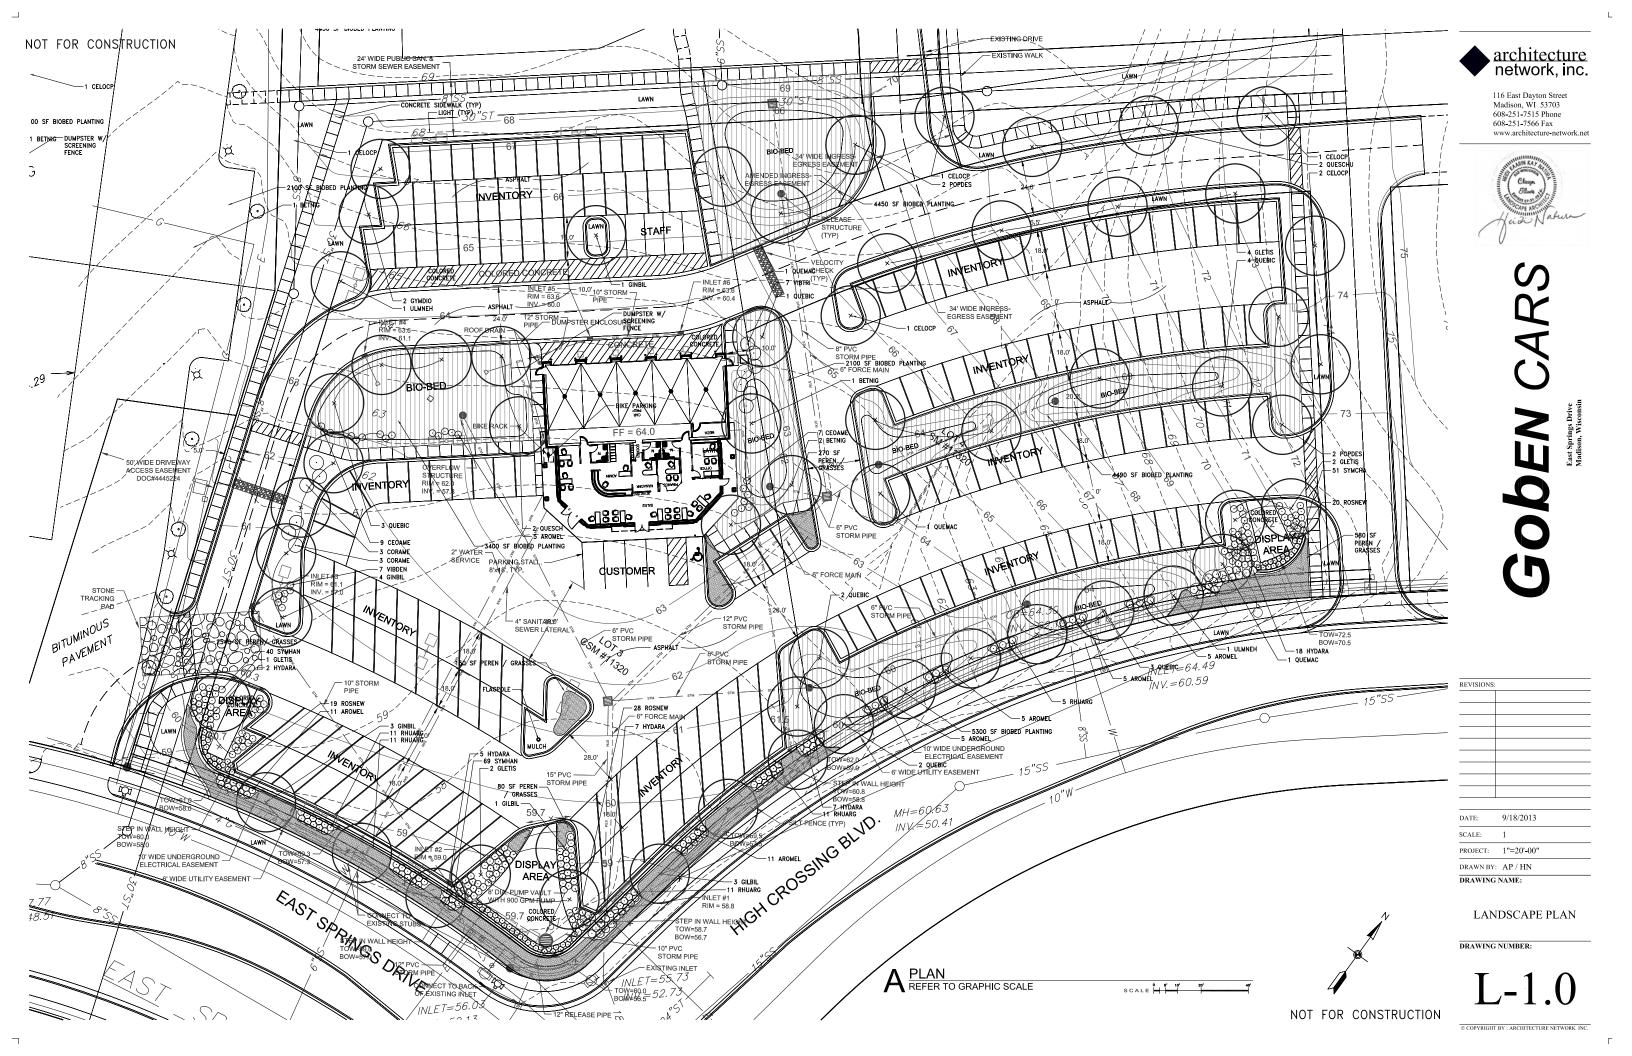

Quantity	Key	Scientific Name	Common Name	Size	Root	Spacing
58	TREES					
3	BETNIG	Betula nigra	River Birch	8' clump	B&B	Plan
6	CELOCP	Celtis occidentalis "Prairie Pride"	Prairie Pride Hackberry	2.5" cal.	B&B	Plan
9	GLETIS	Gleditsia triacanthos var. inermis 'Skyline'	Thornless Common Honeylocust	2.5" cal.	B&B	Plan
13	GINBIL	Ginkgo biloba	Ginkgo biloba	2.5" cal.	B&B	Plan
2	GYMDIO	Gymnocladus dioicus 'Expresso'	Express o Kentucky Coffeetree	2.5" cal.	B&B	Plan
4	POPDES	Populus deltoides 'Siouxland'	Souixland Poplar	2.5" cal.	B&B	Plan
12	QUEBIC	Quercus bicolor	Swamp White Oak Bur Oak	2.5" cal.	B&B B&B	Plan
7	QUESCH	Quercus macrocarpa Quercus X schuettii	Schuettii Oak	2.5" cal.	B&B B&B	Plan
2	ULMNEH	Ulmus x 'New Harizan'	Accolade Smoothleaf Elm	2.5 ° cal.	B&B	Plan
13	SMALL TREES	Olinus X New Plonzon	Accorate shoothear chi	2.5 Car.	DOLD	Fian
	AMEGRA	Amelanchier x grandiflora	Appl e Serviceberry	4' ht.	888	Plan
	CRACIN	Crataegus crus-galli var. inermis	Thornless Cockspur Hawthorn	4 ht.	B&B	Plan
6	CORAME	Corylus americana	American Hazelnut	5 gal.	Cont.	Plan
	VIBPRU	Viburnum prunifolium	Blackhaw Viburnum	4' ht.	B&B	Plan
7	VIBTRI	Viburnum trilobum	Highbush Cranberry	4' ht.	B&B	Plan
385	SHRUBS					
47	AROMEL	Arania melanocarpa	Black Chokeberry	5 gal.	Cont.	Plan
16	CEOAME	Ceonothus americanus	New Jersey Tea	5 gal.	Cont.	Plan
39	HYDARA	Hydrangea arborescens 'Annabelle'	Anna bell e Hydrangea	7 gal.	Cont.	Plan
	PHYOPU	Physocarpus opulifolius	Common Ninebark	5 gal.	Cont.	Plan
49	RHUARG	Rhus aromatica 'Gro-low'	Grow-low Sumac	5 gal.	Cont.	Plan
67	ROSNEW	Rose	Low Rose	5 gal.	Cont.	Plan
	SYRMPA	Syringa meyeri 'Palibin'	Palibin Lilac	5 gal.	Cont.	Plan
160	SYMCHA	Symphoricarpos x chenaultii 'Hancock'	Hancock Coralberry	2 gal	Cont.	Plan
1360	VIBDEN	Viburnum dentotum	Arrowwood Vi burnum	5 gal.	Cont.	Plan
62	PERENNIALS	Allium cernuum	Nodding Onion		Cont.	18"
	7 3000000			gal.		- Contraction in the Contraction
140	ANECAN	Anemone canadensis	Meadow Anemone	gal.	Cont.	18"
50	ASCTUB	Asclepias tuberosa	Butterflyweed	gal.	Cont.	18"
50	ASTAZU	Aster azureus	Sky Blue Aster	gal.	Cont.	18"
50	CORPAL	Coreopsis palmata	Prairie Coreopsis	gal.	Cont.	18"
80	ECHPUR	Echinacea purpurea	Purple Coneflower	gal.	Cont.	18"
30	EUPMGA	Eupatorium maculatum 'Gateway'	Spotted Joe Pye Weed	gal.	Cont.	18"
100	HEURIC	Heuchera richardsonii	Prairie Alum Root	gal.	Cont.	18"
80	LIAPYC	Liatris pychnostachya	Blazing Star	gal.	Cont.	18"
28	MISSGR	Miscanthus sinsensis 'Gracillimus'	Maiden Grass	gal.	Cont.	18"
50	PANVRO	Panicum virgatum 'Rotstahlbusch'	Red Switch Grass	gal.	Cont.	18"
50	PARINT	Parthenium integrifolium	Wild Quinine	gal.	Cont	18"
50	PENDHR	Penstemon diaitalis 'Husker Red'	Foxglove Beard Tongue	gal.	Cont.	18"
40	PETPUR	Petalostemum purpureum	Purple Prairie Clover	gal.	Cont.	18"
50	PHYVIR	Physostegia virginiana	Obedient Plant	gal.	Cont.	18"
50	RATPIN	Ratibida pinnata	Yellow Coneflower	gal.	Cont.	18"
	_					
100	RUDFGO	Rudbeckia fulgida 'Goldsturm'	GoldsturmBlack-eyed Susan	gal.	Cont.	18"
80	SCHSCO	Schizachyrium scoparius	Little Bluestern	gal.	Cont.	18"
120	SEDHER	Sedum 'Herbstfreude'	Autumn Joy Sedum	gal.	Cont.	18"
100	SPOHET	Sporobolus heterolepis	Prairie Dropseed	gal.	Cont.	18"
NOTES:	1. REFER TO SP	ECIFICATIONS				
	2. SEED ALL LAV	WN AREAS				
	ELDERO MEE EM					

Λ	PLANT	SCHED	ULE
н			

Quantity	Key	Scientific Name	Common Name	Size	Root	Spacing	Wetland
2,800	BIOBED PLA	ANTING MIX (4190 SF)					
196		Allium cernuum	Nodding Wild Onion	gal.	Cont.	15"	FAC+
140		Aster ericoides	Heath Aster	gal.	Cont.	15"	FACW+
224		Carex vulpinoidea	Fox Sedge	gal.	Cont.	15"	OBL
56		Eyringium yuccifolium	Rattlesnake Master	gal.	Cont.	15"	FAC+
140		Helenium autumnalis	Autumn Sneezeweed	gal.	Cont.	15"	FACW+
140	i i	Lobelia siphilitica	Great Blue Lobelia	gal.	Cont.	15"	FACW+
140		Monarda fistulosa	Wild Bergamot	gal.	Cont.	15"	FACU
140		Panicum virgatum	Switchgrass	gal.	Cont.	15"	FAC+
56		Penstemon digitalis	Foxglove	gal.	Cont.	15"	FAC-
252		Schizachyrium scoparius	Little Bluestem	gal.	Cont.	15"	FACU-
84		Silphium perfoliatum	Cup Plant	gal.	Cont.	15"	FACW
56		Silphium terebinthinaceum	Prairie Dock	gal.	Cont.	15"	FACU
140		Solidago rigida	Stiff Goldenrod	gal.	Cont.	15"	FACU-
252		Sorghastrum nutans	Indian Grass	gal.	Cont.	15"	FACU+
252		Spartina pectinata	Prairie Cordgrass	gal.	Cont.	15"	FACW+
140		Sporobolus heterolepis	Prairie Dropseed	gal.	Cont.	15"	FACU-
112		Vernonia fasciculata	Ironweed	gal.	Cont.	15"	FACW
140		Veronicastrum virginicum	Culver's Root	gal.	Cont.	15"	FAC
140		Zizea aurea	Golden Alexanders	gal.	Cont.	15"	FAC+
NOTES:	1. REFERT	O SPECIFICATIONS					
	2. PLANTIN	IGS MAY HAVE MULCH OR LAWN AREA 18"-2' W	IDE TO BUFFER ALONG VEHICLE USE AREAS				
		SPECIES AND SIZE SUBSTITUTIONS MAY BE MADE I				2	

B PLANT SCHEDULE: BIOBED

### LANDSCAPE CALCULATIONS PER ZONING CODE (28.142;4c) MINIMUM SIZE AT INSTALLATION PLANT TYPE OVERSTORY DECIDUOUS TREE 35 2 1/2" CAL ORNMAMENTALTREE EVERGREEN TREE 15 3FT TALL SHRUB, DECIDUOUS 2 18" OR 3G SHRUB, EVERGREEN 3 18" OR 3G ORNAMENTAL GRASSES ORNAMENTAL/DECORATIVE FENCING OR WALL TOTAL POINTS PROVIDED 4 PER 10 IN. FT. TOTAL SITE AREA (SF) 143,760 POINTS REQUIRED 2396

LANDSCAPE CALCULATIONS

architecture network, inc.

116 East Dayton Street Madison, WI 53703 608-251-7515 Phone 608-251-7566 Fax www.architecture-network.net



DRAWN BY:	
PROJECT:	
SCALE:	1
DATE:	9/18/2013

REVISIONS:


NOTE: THESE DRAWINGS ARE NOT FOR CONSTRUCTION. CONSTRUCTION DOCUMENTS WILL BE BASED ON SOILS TESTS AND FINAL ENGINEERING. LANDSCAPE PLAN SCHEDULES

DRAWING NUMBER:

NOT FOR CONSTRUCTION

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1.96 1.56 1.72 1.40 0.72 0.58 0.48 0.30 20.5 21.4 20.7 4.12 5.12 17.8 7.99 5.94 15.4 6.47 2.36 1.54 5.93 9.31 14.3 19.4 19.0 14.1 8.77 5.16 CONTOUR: 0.50 FC @ 4' AFG 0.14 0.17 / 0.22 0.35 1.01 0.90 14.2 16.1 23 7 21.3 1.61 2.09 3.57 5.23 27.1 18.5 17.6 16.2 13.3 23.8 23.6 18.0 16.6 15.3 (A.O. A.O. 1.48 2.66 4.44 9.43 14.0 7.87 5.16 4.15 3.48 3.27 2.81 3.22 5.69 8.41 3.22 21.4 19.4 CALCULATION SUMMARY GRID HEIGHT GROUP MAX/MIN AVE/MIN <+> MISC 0.00 2.66 4.95 At Grade 26.2 15.4 16.8 4.52 2.97 2.66 N/A 4.55 12.12 20.15 <\*> SECONDARY 26.06 <#> FRONT ROW 36.23 7.31 4.07 19.0 | 22.7 | 24.3 | 24.1 | 38.4 | 25.8 | 18.7 | 18.9 | 5.52 | 4.53 | 2.89 | 2.70 | 0.58 | 0.15 SITE LUMINAIRE SCHEDULE TYPE SYMBOL DESCRIPTION LUMENS | MOUNTING | LLI 15.0 24.1 31.0 31.7 38.2 38.5 18.8 12.9 6.75 4.80 2.32 1.94 1.34 0.19 McGraw-Edison Talon **6-6** 2) TLL-1000-MH-208-4F-FG-FF-HS (2) 1000 MH 0.75 10000 BASE .52 0.52 0.53 0.54 0.55 0.56 0.58 0.10 0.14 0.18 0.23 0.31 0.52 2.56 2.29 3.18 4.54 7.46 35 18.0 8.70 5.51 3.97 3.71 POLE ) POLE BASE McGraw-Edison Talon **1** 2) TLL-1000-MH-208-4F-FG-FF-HS (2) 1000 MH 10000 0.75 0.62 2.22 2.35 3.40 3.88 4.55 8.53 7.24 5.39 3.48 1.59 0.89 0.45 0.26 0.16 0.11 0.58 0.56 0.55 0.54 0.53 0.53 0.53 0.53 0.53 0B1 9 SITE PHOTOMETRIC PLANT McGraw-Edison Talon 0.2 **1** 10000 0.75 (2) 1000 MH (2) TLL-1000-MH-208-4F-FG-FF BASE 0.05 0.06 0.08 0.09 0.11 0.13 0.17 0.22 TRUE PROJECT McGraw-Edison Talon 10' AFG (1) TLM-150-MP-120-4F-FG-F-DW 1) 150 PSMH 14000 0.75 ONIORTHO.DONORTH8 0.59 0.10

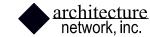

116 East Dayton Street Madison, WI 53703 608-251-7515 Phone 608-251-7566 Fax www.architecture-network.



9514 Union Valley Road Black Earth, Wisconsin 53515 Phone: 608-279-1717 Email: dhill.ies@tds.net

## JOBEN CARS

REVISIONS	S:	
REV-1	XX-XX-2013	
	1	
DATE:	08-09-2013	
SCALE:	-	

PROJECT: K1214

DRAWN BY: IES

DRAWING NAME:

SITE PHOTOMETRIC PLAN

DRAWING NUMBER:

E-0.1

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iving Habitats

Ecological Services Environmental Plannin Custom Artworks 6457 North Sayre Avent Chicago, Illinois 60631 p. 773-467-1634



# GOBEN CARS East Springs Drive Madison, Wisconsin

REVISIONS	<i>-</i>
5	03 JUNE 2013
4	17 MAY 2013
3	12 APRIL 2013
2	27 MARCH 2013
1	30 JANUARY 2013
DATE:	12/19/2012
SCALE:	NTS
PROJECT:	
DRAWN BY	Y: CM/AP

SITE RENDERINGS

DRAWING NUMBER:

DRAWING NAME:

A-3.4



## Living Habitats Landscape Architecture Ecological Services

Ecological Services Environmental Plannin Custom Artworks 6457 North Sayre Avena Chicago, Illinois 60631 p. 773-467-1634



## GOBEN CARS East Springs Drive Madison, Wisconsin

### 

SITE RENDERINGS

DRAWING NUMBER:

DRAWN BY: CM/AP

DRAWING NAME:

A-3.2







### Living Habit Landscape Archites

Endoscape Architectus Ecological Services Environmental Plannin Custom Artworks 6457 North Sayre Avens Chicago, Illinois 60631 p. 773-467-1634



## Goben CARS East Springs Drive

REVISIONS:	
5	03 JUNE 2013
4	17 MAY 2013
3	12 APRIL 2013
2	27 MARCH 2013
1	30 JANUARY 2013
DATE:	12/19/2012
SCALE:	NTS

SITE RENDERINGS

DRAWING NUMBER:

DRAWN BY: CM/AP

DRAWING NAME:

A-3.3





## GODEN CAR.

REVISIO	_
#1	1/30/2013
#2	3/27/2013

DATE: 27 MARCH 2013

SCALE: NTS

PROJECT: K1214

DRAWING NAME:

DRAWING NAI

SITE PLAN

COMMERCIAL

DRAWING NUMBER:

OP-1.2

GHT BY: ARCHITECTURE NETWORK INC.



The McGraw-Edison Talon is the most versatile, functionally designed, universally adaptable outdoor luminaire available. The Talon brings outstanding performance to walkways, parking lots, roadways, building areas, and any security lighting application. U.L. listed and CSA certified for wet locations. IP66 Rated.

## (E) McGRAW-EDISON®



Catalog #	Туре
Project	
Comments	Date
Prepared by	

### SPECIFICATION FEATURES

### Construction

One-piece heavy-wall, die-cast aluminum construction with integral reveal channels along top surface of housing. Internal cast-in wall separates optical and electrical chambers allowing components to operate cooler. One-piece die-cast aluminum door frame with integral cast-in gasket channel seals optical chamber to an IP66 rating. Stainless steel latches and hinges allow for toolless opening and removal of door frame.

### Electrical

Offered standard with ballast and related electrical componentry hard mounted to die-cast housing details for optimal heat transfer and operating efficiency. Optional galvanized steel swing-down power tray with integral handle. Electrical disconnects allow tray to be completely removed from the housing providing ample hand and tool room for attachment of fixture during installation.

### Optical

REFLECTOR: Choice of 14 high efficiency optical systems utilizing horizontal and vertical lamp orientations. Optional high efficiency segmented optical systems constructed of premium 95% reflective anodized aluminum sheet. Optical segments are rigidly mounted inside a thick gauge aluminum housing for superior protection. All segment faces are clean of rivet heads, tabs or other means of attachment which may cause streaking in the light distribution. Standard with mogulbase socket for HPS, MH and 250-400W MP. Standard with medium-base socket for 200W MP and below. All optical modules feature quick disconnect wiring plugs and are field rotatable in 90° increments.

### Mounting

Extruded 8" aluminum arm includes internal bolt guides allowing for easy positioning of fixture during installation to pole or wall surface. Standard single carton packaging of housing, square pole arm and round pole adapter for contractor friendly arrival of product on site.

### Finish

Housing and arm finished in a 5 stage premium TGIC polyester powder coat paint, 2.5 mil nominal thickness for superior protection against fade and wear. Standard colors include black, bronze, grey, white, dark platinum, and graphite metallic. RAL and custom color matches available. Consult the McGraw-Edison Architectural Colors brochure for the complete selection.




## **TALON MEDIUM**


70 - 400W **Pulse Start Metal Halide High Pressure Sodium** Metal Halide

> **ARCHITECTURAL** ARFA I LIMINAIRE



### DIMENSIONS ARM DRILLING

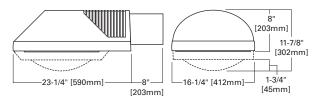

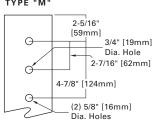


### WATTAGE TABLE


Lamp Type	Wattage
Pulse Start Metal Halide (MP)	70, 100, 150, 175, 200, 250, 320, 350, 400W
High Pressure Sodium (HPS)	70, 100, 150, 250, 400W
Metal Halide (MH)	175, 250, 400W

## **COOPER** Lighting www.cooperlighting.com

### TYPE "M"

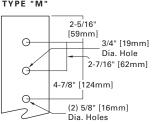

### WALL DRILLING

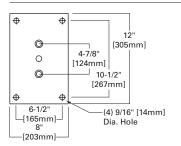

### **ENERGY DATA Hi-Reactance Ballast Input Watts**

70W HPS HPF (86 Watts) 70W MP HPF (94 Watts) 100W HPS HPF (115 Watts) 100W MP HPF (129 Watts) 150W HPS HPF (170 Watts) 150W MP HPF (185 Watts)

### **CWA Ballast Input Watts**

175W MP HPF (198 Watts) G 200W HPS HPF (240 Watts) 200W MP HPF (227 Watts) G 250W HPS HPF (295 Watts) 250W MP HPF (283 Watts) G 320W MP HPF (361 Watts) G 350W MP HPF (397 Watts) G 400W HPS HPF (457 Watts) 400W MP HPF (452 Watts) G

Effective Projected Area: (Sq. Ft.) Recessed Door w/o Arm: 0.79 Deep Door w/o Arm: 1.02 8" Arm: 0.43


### SHIPPING DATA

Approximate Net Weight: Recessed Door: 47 lbs. (21.79 kgs.) Deep Door: 52 lbs. (23.63 kgs.)



ADH082577 pc 2010-06-08 11:39:44

### ORDERING INFORMATION

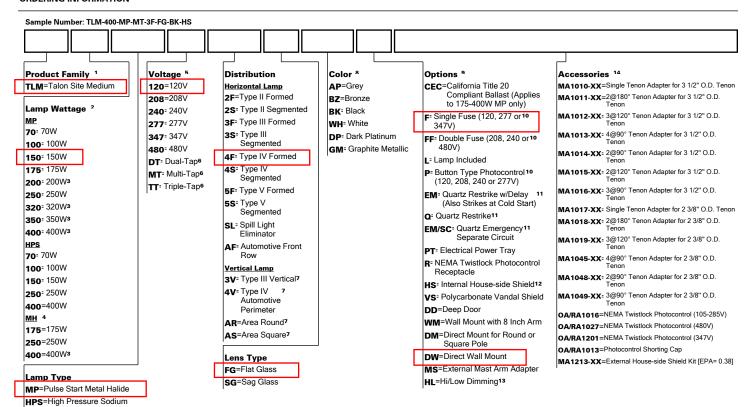

- Notes: 1 8" arm and round pole adapter included with fixture
  - 2 Standard with mogul-base socket for HPS, MH and 175 400W MP. Vertical optics offered with medium-base socket standard up to 200W MP.
  - 3 Requires reduced envelope lamp.
  - 175, 250 and 400W MH available for non-US markets only.
  - 5 Products also available in non-US voltages and 50Hz for international markets. Consult factory for availability and ordering information.
  - Dual-Tap ballast is 120/277V wired 277V. Multi-Tap ballast is 120/208/240/277V wired 277V. Triple-Tap ballast is 120/277/347V wired 347V.
  - 7 Vertical lamp optics ship standard with deep door. 250 400W not available with flat glass.
  - 8 Custom and RAL color matching available upon request. Consult Cooper Lighting Representative for further information
  - Add as suffix.

MH=Metal Halide4

- 10 Must specify voltage
- 11 Quartz options not available with SL and AF optics.
- House-side shield not available on 5S, 5F, AS, AR, and SL optics.
- 13 Requires vertical lamp orientation. Provides 24V low voltage leads used in dimming control.
- 14 Order separately, replace XX with color designation.

### DESCRIPTION

The McGraw-EdisonTalon is the most versatile, functionally designed, universally adaptable outdoor luminaire available. The Talon brings outstanding performance to walkways, parking lots, roadways, loading docks, building areas, and any security lighting application. U.L. listed and CSA certified for wet locations. IP65 Rated.





Catalog #	Туре
Project	
Comments	Date
Prepared by	

### SPECIFICATION FEATURES

### Construction

One-piece heavy-wall, die-cast aluminum construction with integral reveal channels along top surface of housing. Internal cast-in wall separates optical and electrical chambers allowing components to operate cooler. One-piece die-cast aluminum door frame with integral cast-in gasket channel seals optical chamber to an IP65 rating. Stainless steel latches and hinges allow for toolless opening and removal of door frame.

### Electrical

Electrical componentry mounted on a swing-down galvanized steel power tray with integral handle. Electrical disconnects allow tray to be completely removed from the housing providing ample hand and tool room for attachment of fixture during installation.

### Optical

REFLECTOR: Choice of 14 high efficiency optical systems utilizing horizontal and vertical lamp orientations. Optional high efficiency segmented optical systems constructed of premium 95% reflective anodized aluminum sheet. Optical segments are rigidly mounted inside a thick guage aluminum housing for superior protection. All segment faces are clean of rivet heads, tabs or other means of attachment which may cause streaking in the light distribution. Standard with mogulbase socket. All optical modules feature quick disconnect wiring plugs and are field rotatable in 90° increments.

### Mounting

Extruded 10 1/2" aluminum arm includes internal bolt guides allowing for easy positioning of fixture during installation to pole or wall surface. Standard single carton packaging of housing, square pole arm and round pole adapter for contractor friendly arrival of product on site.

### Finish

Housing and arm finished in a 5 stage premium TGIC polyester powder coat paint, 2.5 mil nominal thickness for superior protection against fade and wear. Standard colors include black, bronze, grey, white, dark platinum, and graphite metallic. RAL and custom color matches available. Consult the McGraw-Edison Architectural Colors brochure for the complete selection.




## **TLL** TALON LARGE

250 - 1000W Pulse Start Metal Halide High Pressure Sodium Metal Halide

ARCHITECTURAL


### DIMENSIONS

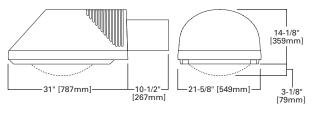


### WATTAGE TABLE

Lamp Type	Wattage
Pulse Start Metal Halide (MP)	250, 320, 350, 400, 450, 750, 875, 1000W
High Pressure Sodium (HPS)	250, 400, 750, 1000W
Metal Halide (MH)	250, 400, 1000W

### ARM DRILLING

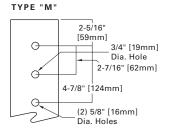

### WALL DRILLING

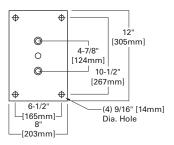



### ENERGY DATA

### **CWA Ballast Input Watts**

250W HPS HPF (295 Watts) © 250W MP HPF (283 Watts) © 320W MP HPF (361 Watts) © 350W MP HPF (397 Watts) © 400W HPS HPF (457 Watts) © 450W MP HPF (452 Watts) © 450W MP HPF (508 Watts) © 750W HPS HPF (840 Watts) 750W MP HPF (820 Watts) 1000W HPS HPF (1100 Watts) 1000W MP HPF (1070 Watts) 1000W MH HPF (1070 Watts) 1000W MH HPF (1070 Watts) 1000W MH HPF (1070 Watts)

### EPA

Effective Projected Area: (Sq. Ft.) 3.28 with 10.5" ARM

### SHIPPING DATA Approximate Net Weight: 400W 91 lbs. (41.36 kgs.) 1000W 98 lbs. (44.54 kgs.)










### ORDERING INFORMATION

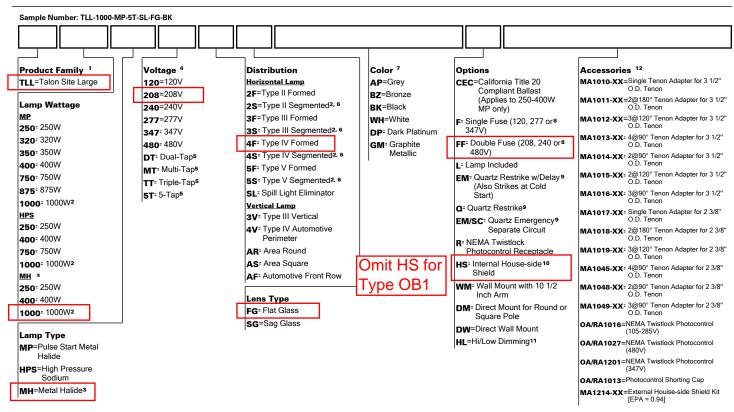

Notes: 1 10 1/2" arm and round pole adapter included with fixture. 2 Requires reduced envelope lamp. 3 250 and 400W are available for non-US markets only. 4 Products also available in non-US voltages and 50Hz for international markets. Consult factory for availability and ordering information. 5 Dual-Tap ballast is 120/277V wired 277V. Triple-Tap ballast is 120/208/240/277/480V wired 347V. 5-Tap ballast is 120/208/240/277/480V wired 480V. 6 Maximum wattage on segmented optical distributions is 400W. 7 Custom and RAL color matching available upon request. Consult Cooper Lighting Representative for further information. 8 Must specify voltage. 9 Quartz options not available with SL and AF optics. 10 House-side shield not available on 5S, 5F, AS, AR, and SL optics. 11 Requires vertical lamp orientation. Provides 24V low voltage leads used in dimming control. 12 Order separately, replace XX with color designation.