

CITY OF MADISON ZONING BOARD OF APPEALS

VARIANCE APPLICATION

\$300 Filing Fee

Ensure all information is typed or legibly printed using blue or black ink.

Address of Subject Property: 622 2632 HOWARD PLACE
Name of Owner: LAKE TOWNE APARTMENTS LLC - PERELLA ANDERSON
Address of Owner (if different than above): 22 LANGDON ST. SUITE 101
MADISOH, WI. 53703
Daytime Phone: <u>608-221-0077</u> Evening Phone: <u>608-219-7749</u>
Email Address: becky elaketowne.com
Name of Applicant (Owner's Representative): JLA ARCHITECTS - MARK M. SMITH
Address of Applicant: 218 CROSS ROADS DRIVE SUITE 7300
MADISON, WI 53718
Daytime Phone: 608-442-3867 Evening Phone: 608-345-3476
Email Address: msmithe jla-ap.com
Description of Requested Variance: REAR TARD SETBACK BECAUSE OF
UHIQUE SITE GEOMETET
(See reverse side for more instructions)
Amount Paid: \$300- FOR OFFICE USE ONLY Hearing Date: \$1/2 \(\sqrt{13} \)
Amount Paid: 195781 Hearing Date: $8/5999999999999999999999999999999999999$
Filing Date: 8/6/13 OV /W MWT Appeal Number: 082213-4
Received By: JEM GQ: NRUP 28A, CUP Parcel Number: 0709 - 1913 - 4 Code Section(s): 28.579 (1)
Zoning District: DRZ
Alder District:

Standards for Variance

The Zoning Board of Appeals shall not grant a variance unless it finds that the applicant has shown the following standards are met:

1. There are conditions unique to the property of the applicant that do not apply generally to other properties in the district.

SITE HAS ONE "FRONT" BOUNDARY ON HORTHEAST AND NO TRUE "REAR" LOT LINE. THIS CREATES AN INTERPRETED BEAK SETBACK THAT SEVERLY IMPACTS BUILDABLE AREA. -ALSO SITE HAS VERY IFFEGULAR GEOMETRY

2. The variance is not contrary to the spirit, purpose, and intent of the regulations in the zoning district and is not contrary to the public interest.

THE PROPOSED BUILDING MEETS ALL EEQUIPEMENTS FOR DR-Z ZONING EXCEPT THE PEAR TARD SETBACK AT THE EXTREME S.W. CORNER OF THE SITE.

3. For an area (setbacks, etc) variance, compliance with the strict letter of the ordinance would unreasonably prevent use of the property for a permitted purpose or would render compliance with the ordinance unnecessarily burdensome.

STRICT COMPLIANCE WOULD SEVERLY LIMIT THE BUILDABLE
FOOTPRINT OF THE SITE AND CAUSE A FURTHER
COMPROMISE OF "HORMAL" OF ALLEPTABLE DESIGN

4. The alleged difficulty or hardship is created by the terms of the ordinance rather than by a person who has a present interest in the property.

CUPPENT OWNER HAS BEEN A GOOD STEWARD OF THE PROPERTIES FOR YEARS, LAKE TOWNE BELIEVES IN HIGH QUALITY PROJECTS AND APPROPRIATE ABSTHETICS. THE

5. The proposed variance shall not create substantial detriment to adjacent property.

LITTLE OF HO CHANGE TO THE YIEWSHED AND USE OF THE

ADJACENT PEOPERTIES. FRONTS FACE FRONTS, SIDES FACE SIDES

E BACKS FACE BACKS. STRICT COMPLIANCE WOULD HOT LESSEN THE

IMPACT OF INCREASED HEIGHT VS. EXISTING

6. The proposed variance shall be compatible with the character of the immediate neighborhood.

AREA HAS CREAT VARIETY OF SCALE, PROXIMITY, SETEACK MATERIALS. PROPOSAL IS ARCHITECTURALLY RICHING MATERIAL, SCALE & DETAIL. USE AS APARTMENT HOUSING YS PREDOMINANT IN AREA.

Application Requirements

Please provide the following Information (Please note any boxes left uncheck below could result in a processing delay or the Board's denial of your application):

	J	Pre-application meeting with staff : Prior to submittal of this application, the applicant is strongly encouraged to discuss the proposed project and submittal material with Zoning staff. Incomplete applications could result in referral or denial by the Zoning Board of Appeals.
	d	Site plan, drawn to scale. A registered survey is recommended, but not required. Show the following on the site plan (Maximum size for all drawings is 11" x 17"): □ Lot lines
		 Existing and proposed structures, with dimensions and setback distances to all property lines Approximate location of structures on neighboring properties adjacent to variance Major landscape elements, fencing, retaining walls or other relevant site features Scale (1" = 20' or 1' = 30' preferred) North arrow
		Elevations from all relevant directions showing existing and proposed views, with notation showing the existing structure and proposed addition(s). (Maximum size for all drawings is 11" x 17")
		Interior floor plan of existing and proposed structure, when relevant to the variance request and required by Zoning Staff (Most additions and expansions will require floor plans). (Maximum size for all drawings is 11" x 17")
1. p		Front yard variance requests only. Show the building location (front setback) of adjacent properties on each side of the subject property to determine front setback average.
A.	.0	Lakefront setback variance requests only. Provide a survey prepared by a registered land surveyor showing existing setbacks of buildings on adjacent lots, per MGO 28.138.
4.4	.0	Variance requests specifically involving slope, grade, or trees. Approximate location and amount of slope, direction of drainage, location, species and size of trees.
	V	CHECK HERE. I acknowledge any statements implied as fact require supporting evidence.
	V	CHECK HERE. I have been given a copy of and have reviewed the standards that the Zoning Board of Appeals will use when reviewing applications for variances.
	Owr	ner's Signature: Lower M. Anderson Date: 8-6-13 (Do not write below this line/For Office Use Only)
	Γ	
	The I	DECISION Board, in accordance with its findings of fact, hereby determines that the requested variance for (is) (is not) in compliance with all of the standards for a variance.
	Furth	ner findings of fact are stated in the minutes of this public hearing.
	The	Zoning Board of Appeals: Approved Denied Conditionally Approved
	Zon	ing Board of Appeals Chair:
	Dat	e:


632 Howard Place August 5, 2013

The proposed project consists of the demolition of the current buildings at 622 and 632 Howard Place. We are proposing to combine both properties as 632 Howard Place. On the combined property w propose to construct a 33 unit / 47 resident apartment building.

The building will be primarily clad in brick / stone masonry and fiber cement panels. Appropriate levels of detail including balconies are included in the current design.

Mark M. Smith

JLA Architects

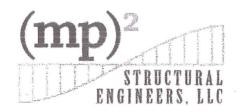

March 18, 2013

Ms. Rebecca Anderson Lake Towne Apartments, LLC 22 Langdon Street Madison, WI 53703

SUBJECT: 622 & 632 Howard Avenue Apartments

Structural Assessment

MP-Squared Project No: 1310034WI

INTRODUCTION

MP-Squared Structural Engineers, LLC (MP2) was retained by Ms. Rebecca Anderson of Lake Towne Apartments, LLC to observe and comment on the structural integrity of the framing at 622 & 632 Howard Avenue apartments in Madison, Wisconsin. MP2 made two visits to the properties; the first visit occurred on Monday, February 11 at approximately 2:30 pm; the second visit occurred on Friday, March 8 at approximately 4:00 pm. The purpose of this report is to summarize our observations.


OBSERVATIONS/ASSESSMENT

632 Howard Avenue:

632 Howard Avenue is a student housing apartment building. There are apartments on three levels above grade and one level below grade. Above grade framing is typically wood framed and the foundation, where exposed, appears to be cast-in-place concrete.

Nearly all the framing in the building is covered with wall/floor/ceiling sheathing; however, structural concerns are noticeable passively throughout the building. There are two "bump-outs" — one at the front of and one in the back of the building. Each bump-out appears to have once been an exterior, perhaps three season, porch that has been converted to livable space. There is a significant change in elevation between the main structure and the bump-out. Also, there appears to be differential movement between the bump-out and the main structure as seen by peeling paint at the intersection of the bump-out to the main building (see Photo 1); additionally, via conversations with the building

583 D'Onofrio Drive, Suite 201, Madison, WI 53719 Phone: 608-821-4770 Fax: 608-821-4780 www.mpsqrd.com

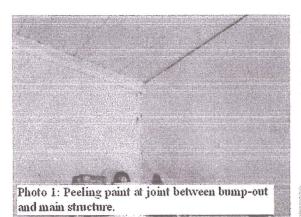


owner re caulking of exterior joint of the bump-out to the main structure, the caulking is replaced every one to two years because of visible separation (see Photo 2). The bump-out may not have a typical frost wall foundation which could be the cause of the relative movement.

There are "soft" spots felt throughout the building. These may be due to localized water damage, undersized framing, or a combination of the two; however, without removing the sheathing and exposing the wall studs and/or floor framing it is not possible to determine how pervasive the damage is. Water damage of some degree




between bump-out and main structure.

can be assumed in nearly all bathrooms and kitchens (see Photo 3).

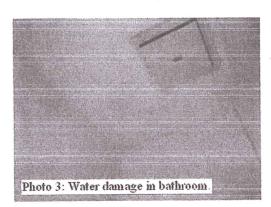


In the lower level some framing was exposed and dry rot was noted (see Photo 4). Again, without removing the sheathing and exposing the floor joists it is not possible to determine the extent of the rot.

The foundation appears to have section loss in one of the lower level apartments. Additionally, efflorescence and water staining was noted.

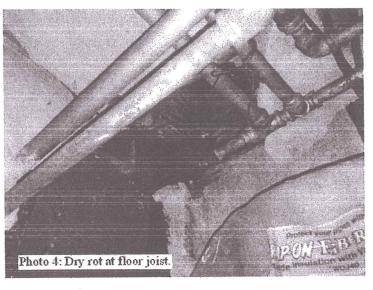

583 D'Onofrio Drive, Suite 201, Madison, WI 53719 Phone: 608-821-4770 Fax: 608-821-4780 www.mpsqrd.com

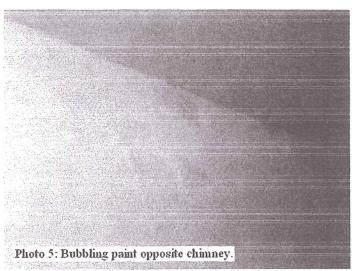


Paint in the stairwell opposite the chimney has bubbled (see Photo 5). Per the Owner the bubbling paint has been repaired numerous times and a new liner has been installed in the chimney. It is our understanding the bubbling continued after the liner was installed. This may not indicate a structural issue; however, it is concerning and may be indicative of high heat.

632's garage does not appear to have been originally designed


per typical structural engineering standards. The trusses have not been properly fastened to the top of the wall. Steel tie rods have been installed to prevent the walls from kicking out; however, the structure appears generally unstable and possibly in danger of imminent collapse. See Photo 6.

622 Howard Avenue:

622 Howard Avenue is a student housing apartment building. There are apartments on two levels above grade and one level below grade. Above grade framing is typically wood framed and the foundation, where exposed, appears to be constructed using a multi-wythe brick wall.

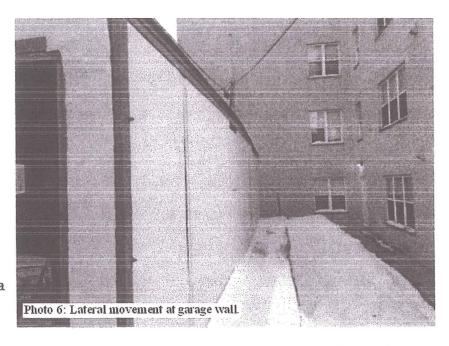

The condition of the framing at 622 is generally unremarkable. Buckling of the exterior front porch decking was noted, and appears to be from moisture and a rigid boundary condition. Moisture infiltration was noted in the attic – there is discoloration of the roof joists and roof decking, along with efflorescence on the chimney.

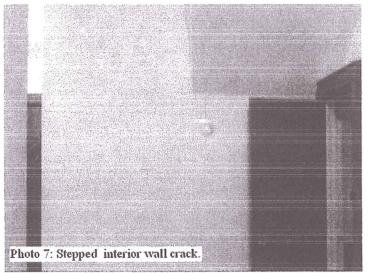



The most concerning structural behavior occurs approximately in-line with the ridge. The floor framing on the first and second floor significantly dips approximately 18'-0" from the front, exterior wall. On the second floor, there is a large, apparently active, stepped crack (see Photos 7-9). This is indicative of settlement. The exterior foundation and exterior wall framing show no signs of

distress. A possible origin may be due to the removal of an interior load bearing member, or perhaps continued settlement of an interior load bearing column/wall.

CONCLUSION

The structural issues in 632 Howard Avenue are pervasive. Load path and the extent of rot and water damage cannot be determined unless the sheathing is removed and the studs are

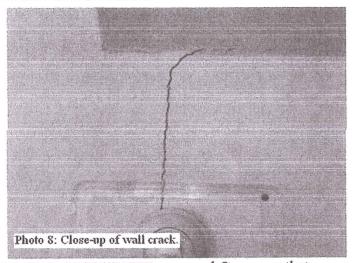

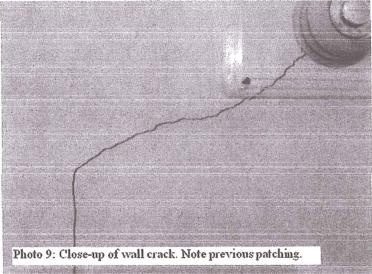

exposed. It appears that water has infiltrated the structure via different means. Continued exposure to moisture will cause decay and rot in any structure, especially wood framed buildings. Unfortunately, significant changes in strength and stiffness can take place before any rotting is detected. Visual clues appear mostly during the advanced stages of fungal attack, limiting the life of the structure.

583 D'Onofrio Drive, Suite 201, Madison, WI 53719 Phone: 608-821-4770 Fax: 608-821-4780 www.mpsqrd.com

The structural issues in 622 Howard Avenue appear less pervasive, but could be a larger life safety issue than what we are observing in 632. Tracking down the cause of the settlement will require a rigorous evaluation and exposure of the framing system. It may be necessary to retain to geotechnical engineer if the structural load path is found to be sufficient to transfer the loads to the foundation.

The garage at 632 Howard should be considered in danger of imminent collapse and should be repaired, shored, or demolished.

LIMITATIONS

Our observations were limited to a hands-reach assessment. The assessment conducted by MP2 was limited to observable conditions.


A rigorous structural analysis of the structure/s is beyond the scope of our contract and has not been performed. Typical connections and the structural adequacy of framing members have not been verified by rigorous structural analysis. The observations were limited to the items stated in the report.


Sincerely,

MP-SQUARED STRUCTURAL ENGINEERS, LLC

Melissa A. Peyton, P.E.

Structural Engineer / Principal

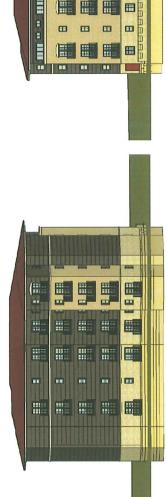


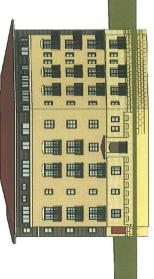

LAKE TOWNE APARTMENTS



SOUTH ELEVATION

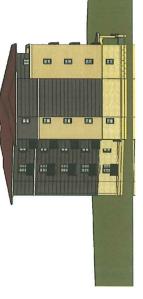


PROGRESS DOCUMENTS

They decorate settled progress and latest and myster in settled to change, includely additional death, they are affected to include the description of the settled and the settle settle death and the settle settle

632 HOWARD PLACE

EAST ELEVATION

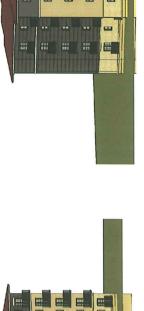

8

■ ■ ■

WEST ELEVATION


Design Elevations


A201


EAST ELEVATION 632 HOWARD PLACE

NORTH EAST ELEVATION 632 HOWARD PLACE



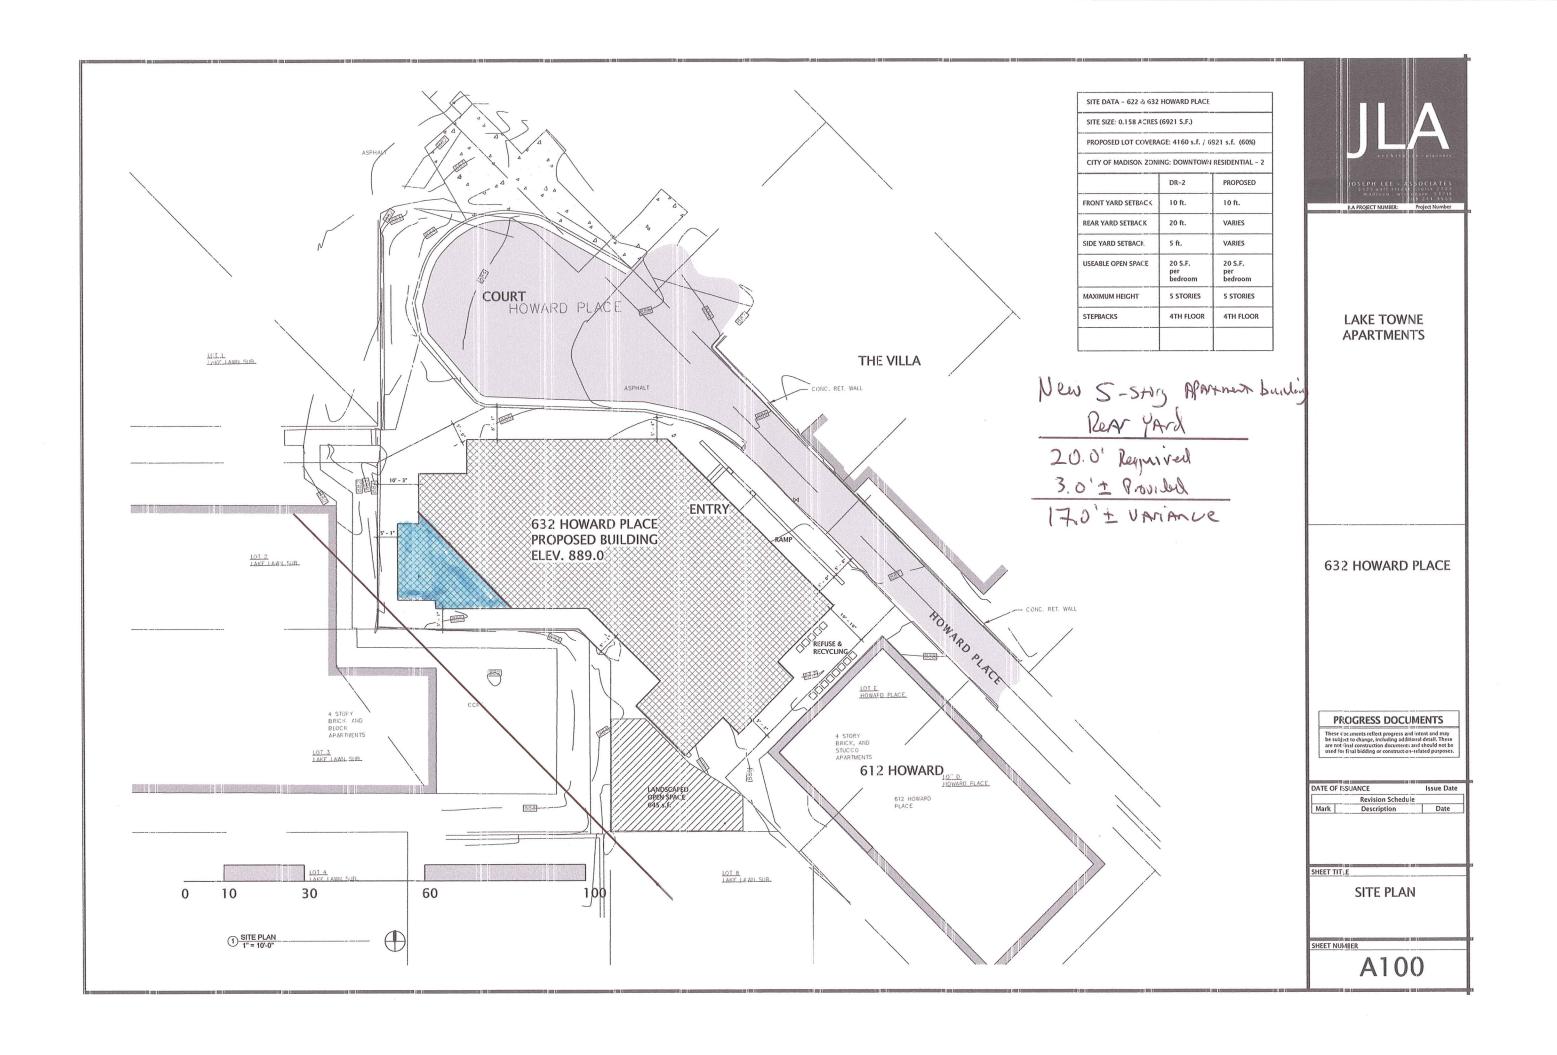

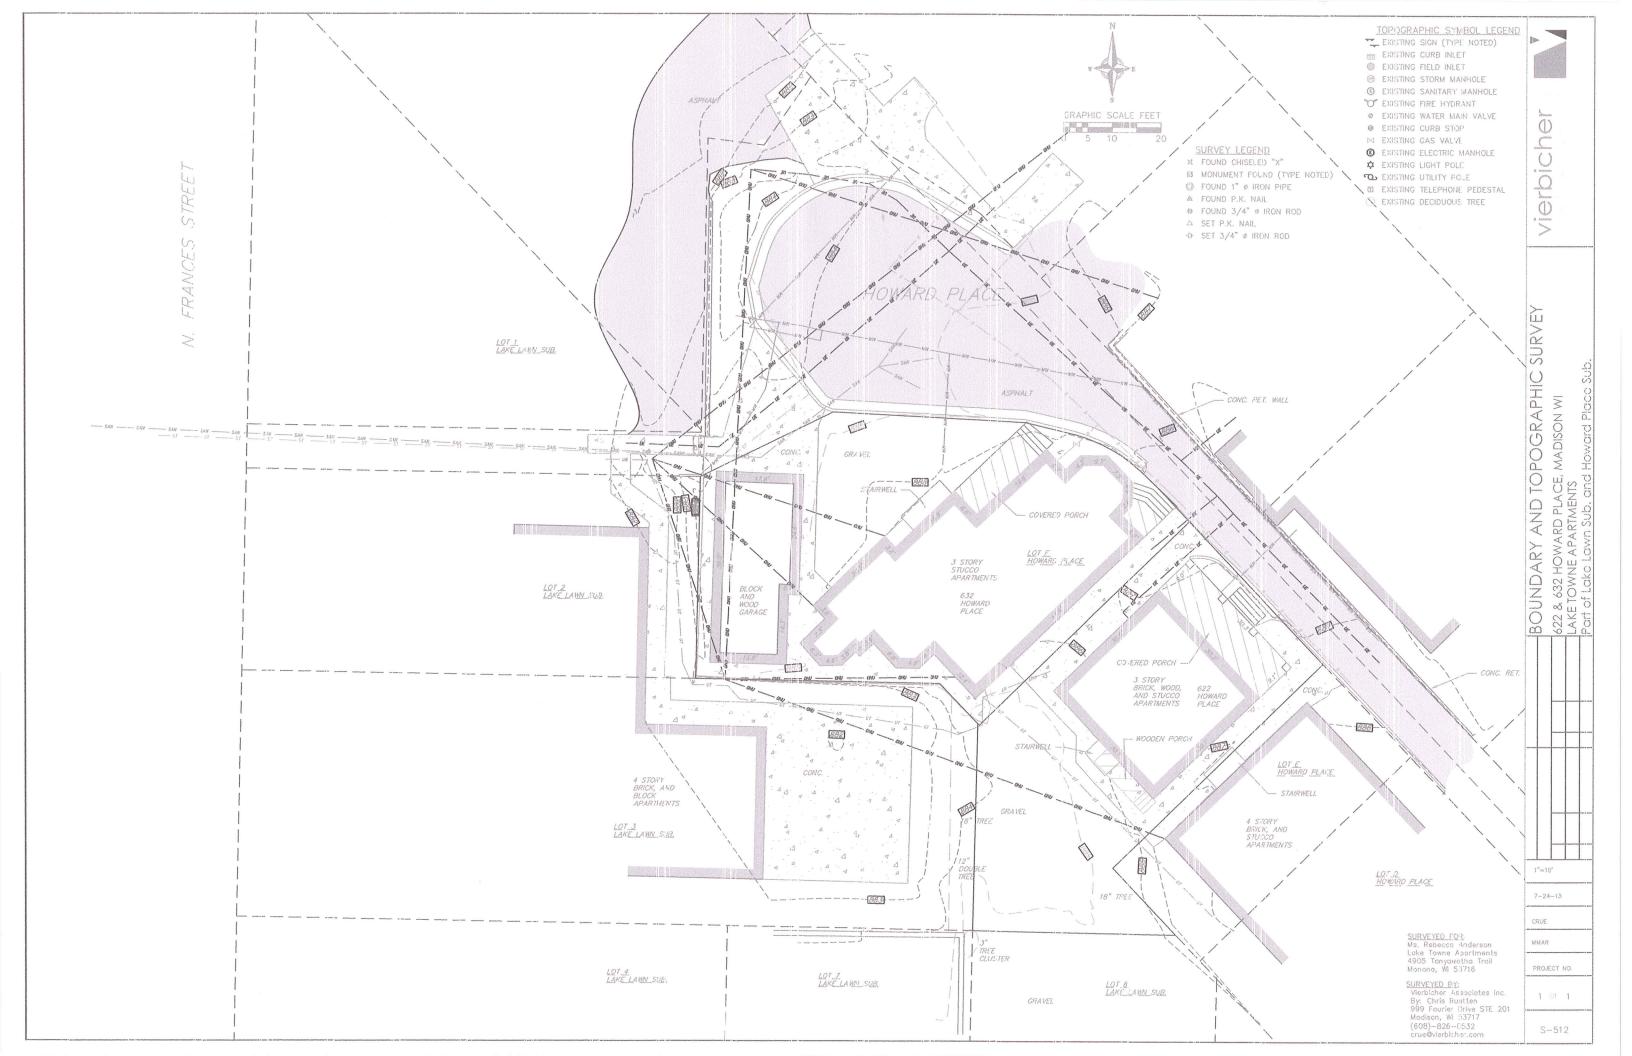

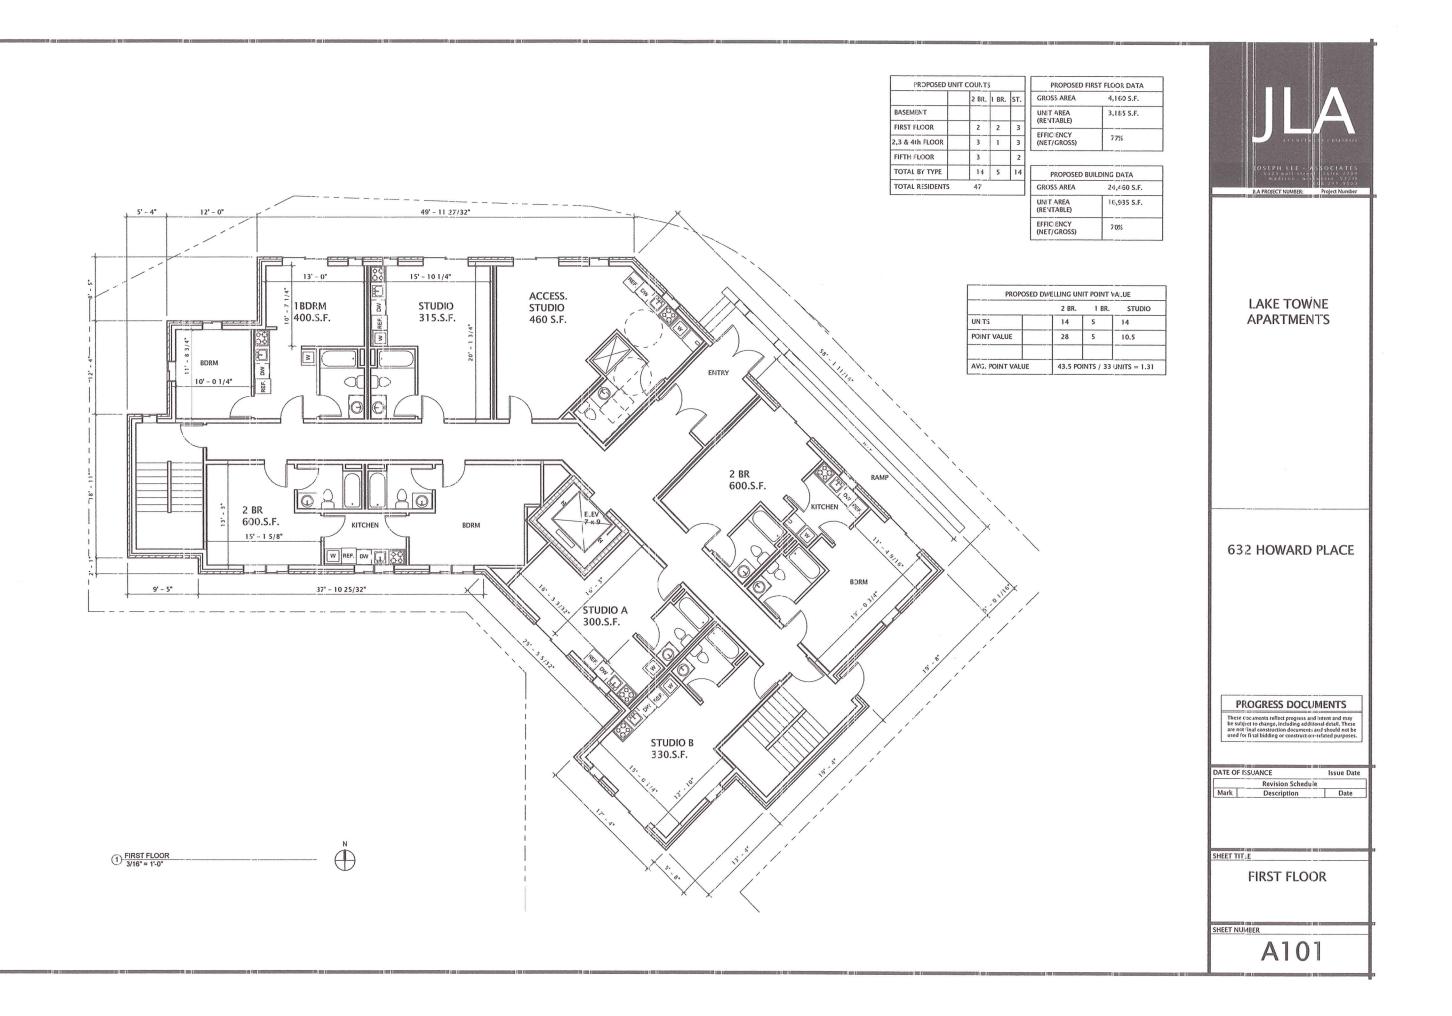

PROPOSED UN	IT COUNTS	5	
	2 BR.	I BR.	ST.
BASEMENT			
FIRST FLOOR	2	2	3
2,3 & 4th FLOOR	3	1	3
FIFTH FLOOR	3		2
TOTAL BY TYPE	14	5	14
TOTAL RESIDENTS	47		-

	PROPOSED 2ND,3RD &4TH FLOOR DATA			
г.	GROSS AREA	4,160 S.F.		
	UNIT AREA (RENTABLE)	3,325 S.F.		
3	EFFICIENCY (NET/GROSS)	80%		
7				

PROPOSED BU	JILDING DATA	
GROSS AREA	24,460 S.F.	
UNIT AREA (RENTABLE)	16,935 S.F.	
EFFICIENCY (NET/GROSS)	70%	



LAKE TOWNE **APARTMENTS** 632 HOWARD PLACE

PROGRESS DOCUMENTS

These cocuments reflect progress and intent and may be subject to change, including additional detail. These are not final construction documents and should not be used for final bidding or construct out-related purposes.

DATE OF ISSUANCE Revision Schedule


Mark Description Date

SHEET TITLE

2ND,3RD & 4TH FLOOR

SHEET NUMBER

A102

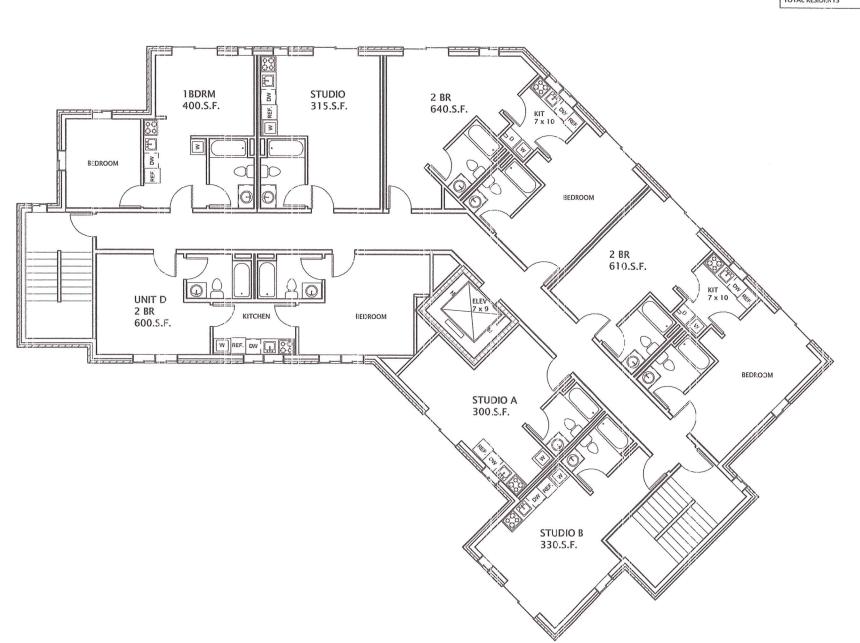

1 SECOND FLOOR 3/16" = 1'-0"

FROPOSED	UNIT C	OUNTS			
	3 BR.	2 BR.	I BR.	ST	
BASEMENT					
FIRST FLOOR		2	2	4	
2,3 & 4th FLOOR		3	1	3	
FIFTH FLOOR		3		2	
TOTAL BY TYPE		14	5	14	
TOTAL RESIDENT	S	47			

OSED	UNIT	COUNTS PROPOSED FIFTH FLOOR DATA			
	3 BR.	2 BR.	I BR.	ST.	GROSS AREA 3.760 S.F.
					UNIT AREA (RENTABLE) 2.915 S.F.
R		2	2	4	(NEIVIABLE)
OOR		3	1	3	(NET/GROSS) 79%
R		3		2	<u> </u>
YPF		14	5	14	PROPOSED BUILDING CATA

PROPOSED BU	JILDING DATA
GROSS AREA	24,460 S.F.
UNIT AREA (RENTABLE)	16.935 S.F.
EFFICIENCY (NET/GROSS)	70%



LAKE TOWNE **APARTMENTS**

632 HOWARD PLACE

PROGRESS DOCUMENTS

DATE OF ISSUANCE Revision Schedule

Mark Description Date

SHEET TITLE

5TH FLOOR

SHEET NUMBER

A103

