
APPLICATION FOR URBAN DESIGN COMMISSION REVIEW AND APPROVAL	AGENDA ITEM # Project # Legistar #
DATE SUBMITTED: September 12, 2012 UDC MEETING DATE: September 19, 2012	Action RequestedInformational PresentationXInitial Approval and/or RecommendationXFinal Approval and/or Recommendation
PROJECT ADDRESS: 309 West Johnson Strest ALDERMANIC DISTRICT: 4 OWNER/DEVELOPER (Partners and/or Principal Hovde Properties 122 West Washington Avenue, #101 Madison CONTACT PERSON: Steve Holzhauer Address: Eppstein Uhen Architect 222 West Washington A Phone: 442-6688 Fax:	ARCHITECT/DESIGNER/OR AGENT: Eppstein Uhen Architects 222 West Washington Avenue, #605 Madison
well as a fee) School, Public Building or Space (Fee may b	ling of a Retail, Hotel or Motel Building Exceeding 40,000 n C4 District (Fee required) ed)

Where fees are required (as noted above) they apply with the first submittal for either initial or final approval of a project.



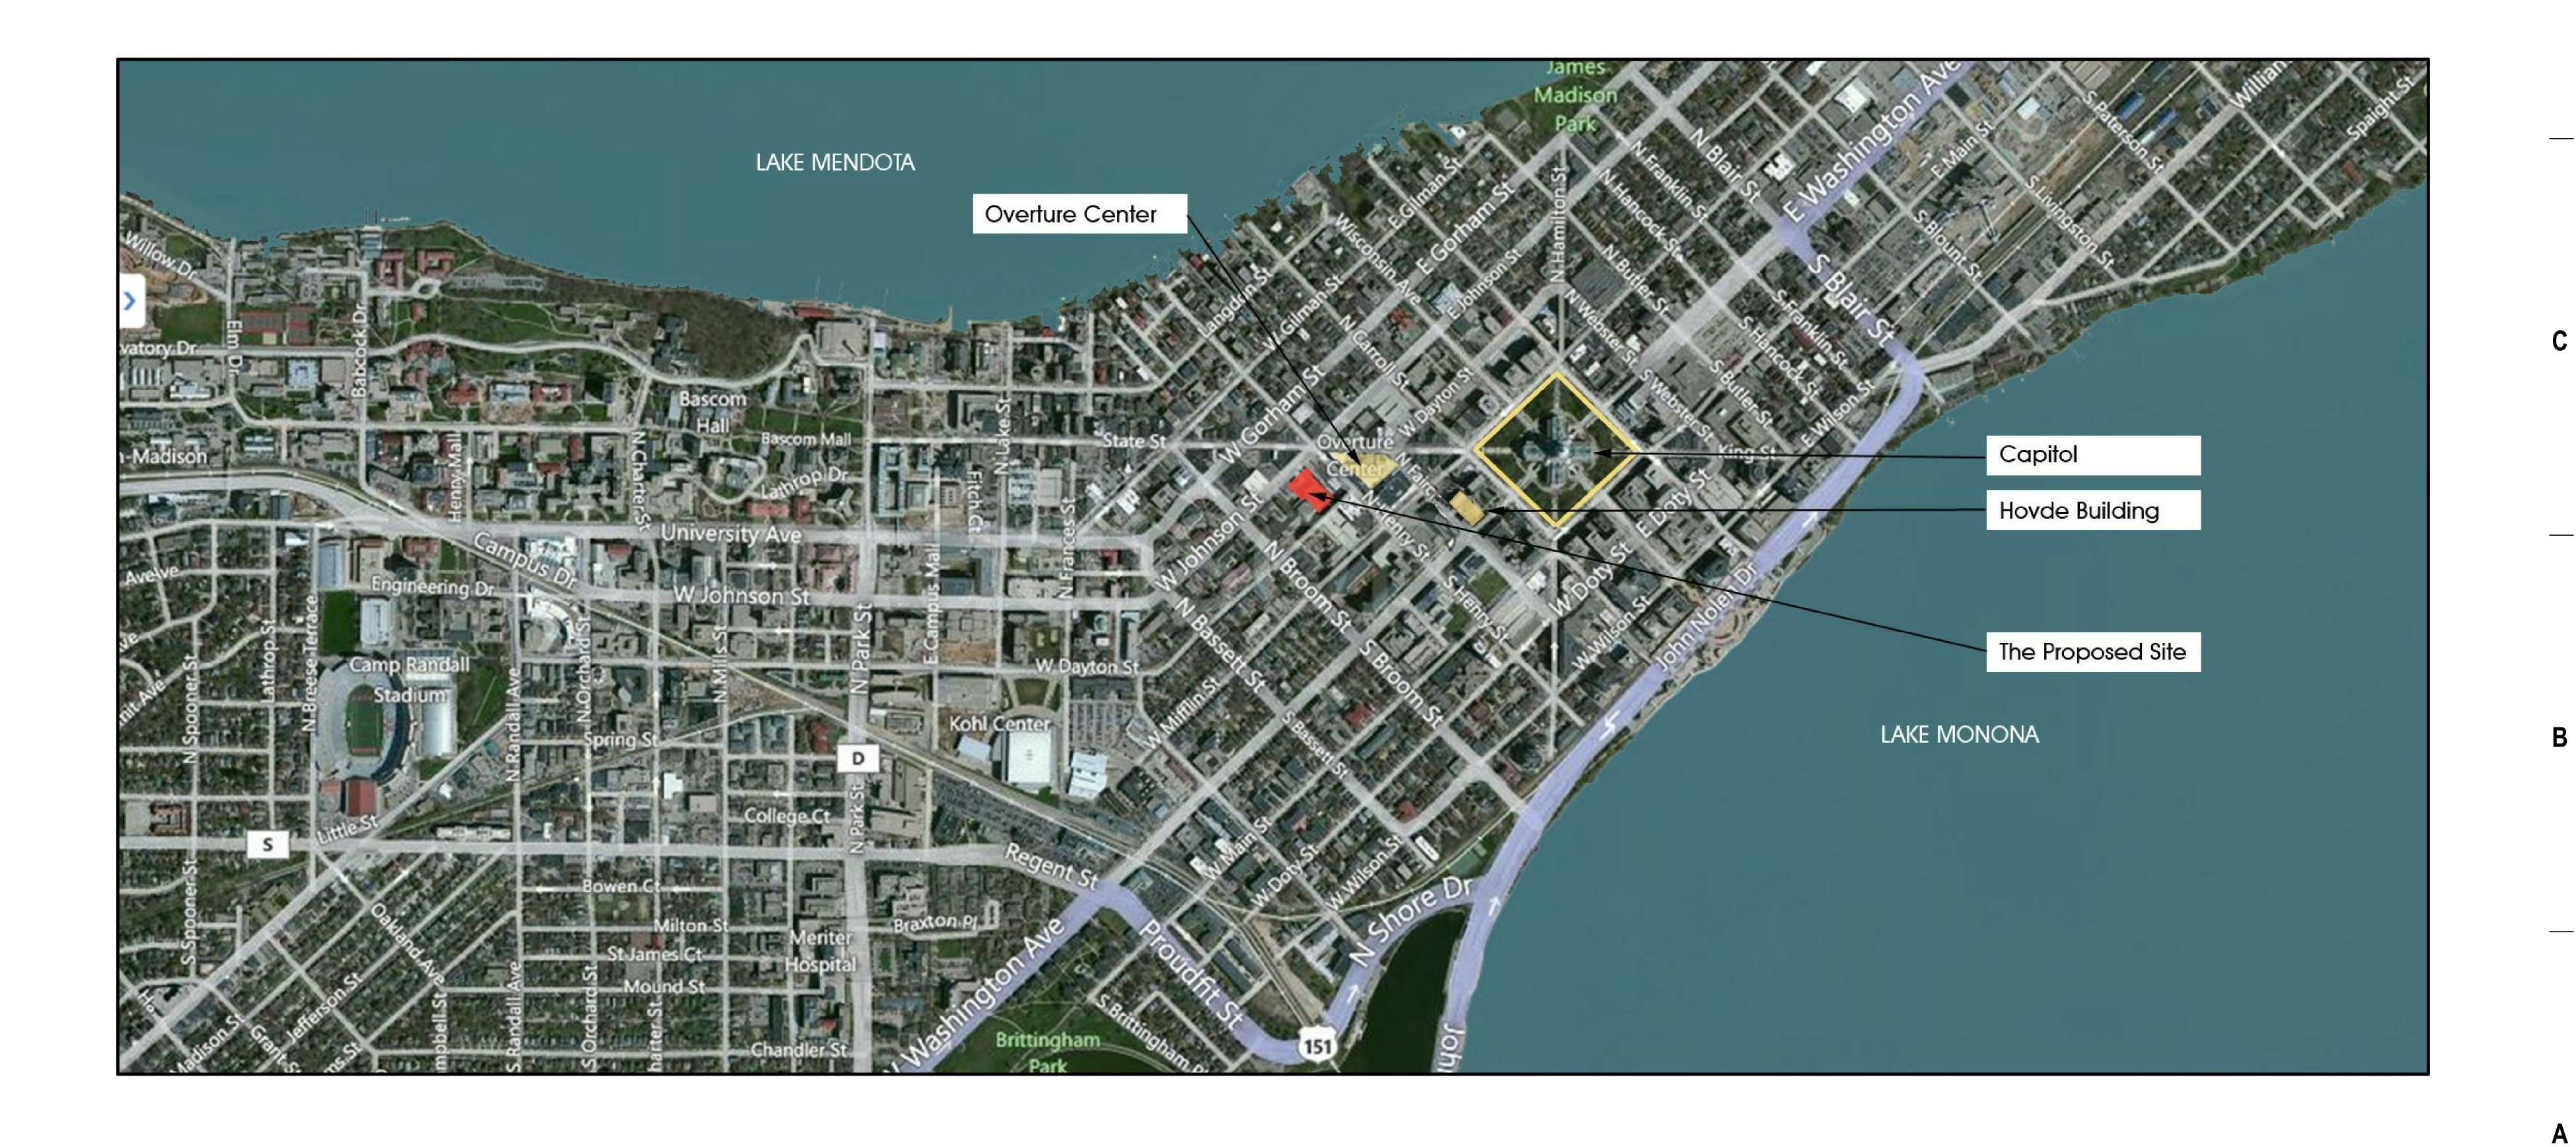

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madison

222 West Washington Ave, Suite 650 Madison, Wisconsin 53703 tel 608 442 5350 fax 608 442 6680

KEY PLAN

2

1

eppstein uhen : architects

ISSUANCE AND REVISIONS

URBAN DESIGN COMMISSION APPROVAL SET # DATE DESCRIPTION

PROGRESS DOCUMENTS

These documents reflect progress and intent and may be subject to change, including additional detail. These are not final construction documents and should not be used for final bidding or construction-related purposes.

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PROJECT INFORMATION



309 W. JOHNSON STREET MADISON, WI



DATE:

SHEET NAME:

SHEET INFORMATION

9/19/2012





HOVDEPROPERTIES

122 W. Washington Ave. • Madison, WI 53703-2718

TEL 608-255-5175 · FAX 608-255-6196

September 12, 2012

Urban Design Commission City of Madison 215 Martin Luther King Jr. Blvd

Re: Letter of Intent 305/309/325 W. Johnson Street Development. Madison, WI 53703

The following is submitted together with the plans, application and zoning text for staff, Urban Design, Plan Commission and Common Council consideration of approval.

Organizational Structure:

Owner: Hovde Properties, LLC 122 W. Washington Ave Madison, WI Architect: Eppstein Uhen Architects, 222 W Washington Ave Madison, WI Structural Engineer: Pierce Engineers, 10 W Mifflin St. Madison, WI Construction Manager: JH Findorff & Son, 300 S. Bedford St. Madison, WI Landscape Architect & Civil Engineer: Ken Saiki Design, 303 S Paterson St. Madison, WI Owner Representative: Huffman Facility Development, Inc., 16 N Carroll St. Madison, WI

Introduction:

By way of background, after Hovde Properties, LLC ("Hovde") initially proposed a mixed-use development on parcels of land located at 305 and 309 West Johnson Street, the City of Madison ("City") approached Hovde with the idea of incorporating the operations of the City's fire department with the development plans of Hovde. There were several meetings with City Staff and Hovde's development team to determine the most feasible program the site could support. The final resolution of these combined Hovde and City meetings is being submitted with this application. Both Hovde and the City continue to meet jointly on a regular basis to determine the final business terms and conditions of this joint development.

Hovde is proposing a mixed-used development consisting of a residential component, a parking structure, commercial offices and retail on parcels of land located at 305, 309 and 325 West Johnson Street (the "Project"). The Project will be subjected to the condominium form of ownership in accordance with Chapter 703 of the Wisconsin Statutes as more fully described below. Hovde has owned 309 W. Johnson Street since the 1980's and acquired 305 W. Johnson in May of 2012. As part of the Project, Hovde intends to acquire from the City the parcel that currently houses the City's fire administration building located at 325 W. Johnson Street. Upon completion of the Project, the City intends to purchase a condominium unit in the Project from Hovde to be used as new City fire administration offices.

The Project includes a request for a waiver from bulk standards described in Urban Design Zone 1 as more fully shown in the attached plans.

A one lot Certified Survey Map ("CSM") containing the Project site and the current Fire Station #1 Building is being generated with an anticipated submittal date of September 5th. The CSM will be recorded following the conveyance from the City to Hovde of (i) 325 West Johnson, (ii) an approximately 10 foot strip of land along the eastern boundary of the First Station #1 parcel, and (iii) a momentary transfer of the Fire Station #1 parcel. Following recordation of the one lot CSM, a two unit condominium will be created. One unit will be the Project site (the "Hovde Land Unit") and the second unit will be the Fire Station #1 parcel which will be immediately conveyed back to the City. A second condominium plat describing the Project will then be recorded vertically over the Hovde Land Unit.

W Mifflin Neighborhood/Business Districts/City Committees:

Hovde has met and worked with the W Mifflin district of Capital Neighborhoods and the Greater State Street Business Associations from the conceptual stage of the Project. Meetings with members of downtown stakeholders also included board members of the downtown business improvement district. Alderman Mike Verveer convened a larger neighborhood meeting on April 12, 2012 after which a neighborhood steering committee was formed that has met approximately 4 times. Members of the Hovde development team have made informational presentations to the Board of Estimates meeting on March 12, 2012, Urban Design Committee on May 16, 2012 and the Plan Commission on June 18, 2012.

Existing Conditions:

Three buildings presently occupy the proposed combined parcel.

- 305 West Johnson Street is an 18,700 SF two-story masonry building constructed in 1913, housing two commercial spaces and 6 apartment units. There are two commercial spaces with a total of the purposes of this project. Its demolition is proposed. There is an access easement on the W. Architectural Site Plan AS102.
- 309 West Johnson Street is a 34,000 SF two-story masonry building constructed in 1910. It is W. Dayton Street.
- 325 West Johnson Street is a 14,000 SF two-story steel framed building constructed in 1968. It is condition, the building cannot support the long-term needs of the fire department. Vertical expansion may be structurally feasible, however the cost of this construction combined with associated renovations of the building make it impractical. Its demolition is proposed.
- 316 West Dayton is a 26,000 SF three-story steel framed building constructed in 1968. It has been the home of Fire Station #1 since its construction. The building is in good physical condition and separate Public Works project.

5,726 square feet. The building is not fire sprinklered, accessible to the disabled nor expandable for Dayton side of the parcel sitting between 305 W. Johnson Street and 202 North Henry Street. See

primarily used for indoor parking with 43 stalls and includes two outdated commercial spaces that front on W. Johnson St. with a total square footage of 3,600 sf. The building is not fire sprinklered, accessible to the disabled nor easily converted from its currently structured parking. Its demolition is proposed. There is also a 51 car surface parking lot behind the building which is accessed off of

the current administrative headquarters for the Madison Fire Department. While in good physical

will continue to be used as a fire station. A full renovation of the building is proposed as part of a

Project Description:

The project will consolidate and improve existing properties that face both West Johnson and West Dayton Streets in the downtown district, resulting in a single 1.63 acre parcel. Outdated low-rise buildings and a surface parking lot will be replaced with approximately 255 residential dwelling units, approximately 49,000 square feet of commercial office space, (of which approximately 30,000 square feet will be sold as a condo to the City of Madison for its fire administration operation), approximately 11,000 square feet of ground floor retail and approximately 300 enclosed parking stalls. The gross area of the entire building will be approximately 463,000 square feet with 278,000 square feet comprising the market-rate apartments. The resulting increased density and proposed mixed uses will substantially increase the activity around the site with hundreds of people living and working in the development. Up to 100 commercial office tenants (including 60 fire department employees) will work on the second floor of the building when fully occupied. Public lobbies will connect commercial tenants and residents at both streets and ground floor retail will serve to activate the 300 block of West Johnson Street.

Included with the proposed demolition plan is the existing Fire Department administration building. Constructed over 40 years ago, it is no longer adequate for the functional support of the department's present and long-term needs. Space within the new building will be built to address the department's administration space needs beyond 2027. The Project will be connected to Fire Station #1, providing needed storage, firefighter support space and parking. A separate public building lobby for the fire department's offices will be built on Dayton Street. To maintain vehicle access to the north side of Fire Station #1, a shared access easement will be created along the west property line.

Legal Description:

Currently the Project is a compilation of lots and parcels with a metes and bounds description located at 305, 309 and 325 West Johnson Street. The final legal description for the Project will be created following the Certified Survey Map and 2-step condominium platting process more fully described below.

Site Development Data:

Density Analysis:

Lot Area: 70,874 sf Acres: 1.63 acres Dwelling Units: 255 Lot Area/D. U.: 278 sf Density (Units per Acre): 156.4 Includes the complete City of Madison Parcel The following further illustrates the project data:

Project Data - W. John	ison Street Dev	elopmen	ıt					9/12/2012
	Apartme	nts	(Commercia	I	Parki	ng	
floor	apartment GSF	# of units	retail GSF	office GSF	fire dept GSF	parking GSF	parking	Total GSF
lower level 2						46,237	117	46,237
lower level						47,891	113	47,891
ground floor (at Johnson)	2,669		11,059	1,036	2,863	28,878	65	46,505
mezzanine level	8,454				2,376	2,205	8	13,035
floor 2	981			18,149	24,201			43,331
floor 3	33,595	36						33,595
floor 4	33,593	36						33,593
floor 5	33,595	36						33,595
floor 6	33,593	36						33,593
floor 7	24,142	24						24,142
floor 8	20,072	18						20,072
floor 9	17,672	16						17,672
floor 10	17,672	16						17,672
floor 11	17,672	16						17,672
floor 12	17,672	15						17,672
floor 13	12,170	6						12,170
floor 14	4,683							4,683
floors 13 + 14 subtotal	16,853	6						
mechanical penthouse								-
totals	278,236	255	11,059	19,185	29,440	125,211	303	463,131
Total Parking							303	
office / retail							23	
fire department					1		25	
·					1			
commercial subtotal							48	
residential subtotal							255	
parking ratio per unit							1.00	

Approximate Dwelling Unit Mix and Estimated Prices:

Unit Data- W Johnson Project				
Туре	Ave Unit SF	# of Units	Ave Price	
Studios	586	20	\$873	
1 Bedroom	729	131	\$1,145	
1 Bedroom+Den	853	40	\$1,305	
Two Bedroom	1,105	49	\$1,635	
Two Bedroom+Der	1,410	15	\$1,974	
Total Units	255			

Loading:

There will one 10x35 off-street loading zone accessible from W. Johnson Street and one 10x35 off-street loading accessible from W. Dayton Street. There will also be an on-street passenger/loading zone on both W. Johnson and W. Dayton Streets as indicated on The Drawings.

Project Schedule:

August 15, 2012 - Land Use SubmittalSeptember 5, 2012 - Submit CSMSeptember 12, 2012 - Submit Design for UDC Initial ApprovalSeptember 26, 2012 - Submit Design for UDC Final ApprovalNovember 15, 2012 - Purchase and Sales Agreement ExecutedOctober 15, 2012 - Plan Commission Approval of PUDOctober 30, 2012 - Common Council Approval of PUDDecember 2012 - Site DemolitionJanuary 2013 - Construction StartJune 2014 - First Phase of Building CompletionOctober 2014 - Final Phase of Building Completion


Social & Economic Impact:

The social impacts are many. Providing a vehicle for an improved fire administration will increase public safety citywide. The Project also serves as a catalyst for the renovation of Fire Station #1 which will improve working conditions for downtown fire fighters. Having up to 350 additional residents in the center city will increase the demand for goods and services which will help retain and grow local business on and around State Street. As an infill development site, the increase in economic value to the land will result in higher assessments and tax revenues to the city and other taxing authorities. These funds can go to pay for teachers, firefighters and police.

Through the development process from concepts to construction to grand opening it is estimated that there will be 70 full time jobs created a year for three years. In addition, there are hundreds more jobs imbedded in the manufacture and delivery of the materials to the job site. When fully occupied the project will create 5 full time jobs in the operation and management of the building, 60 jobs with the fire department's administration operations and approximately 40 jobs in the office and retail components of the building.

TIF Application:

Provided the financial model identifies a gap in funds, the developer would seek tax incremental financing from the City of Madison.

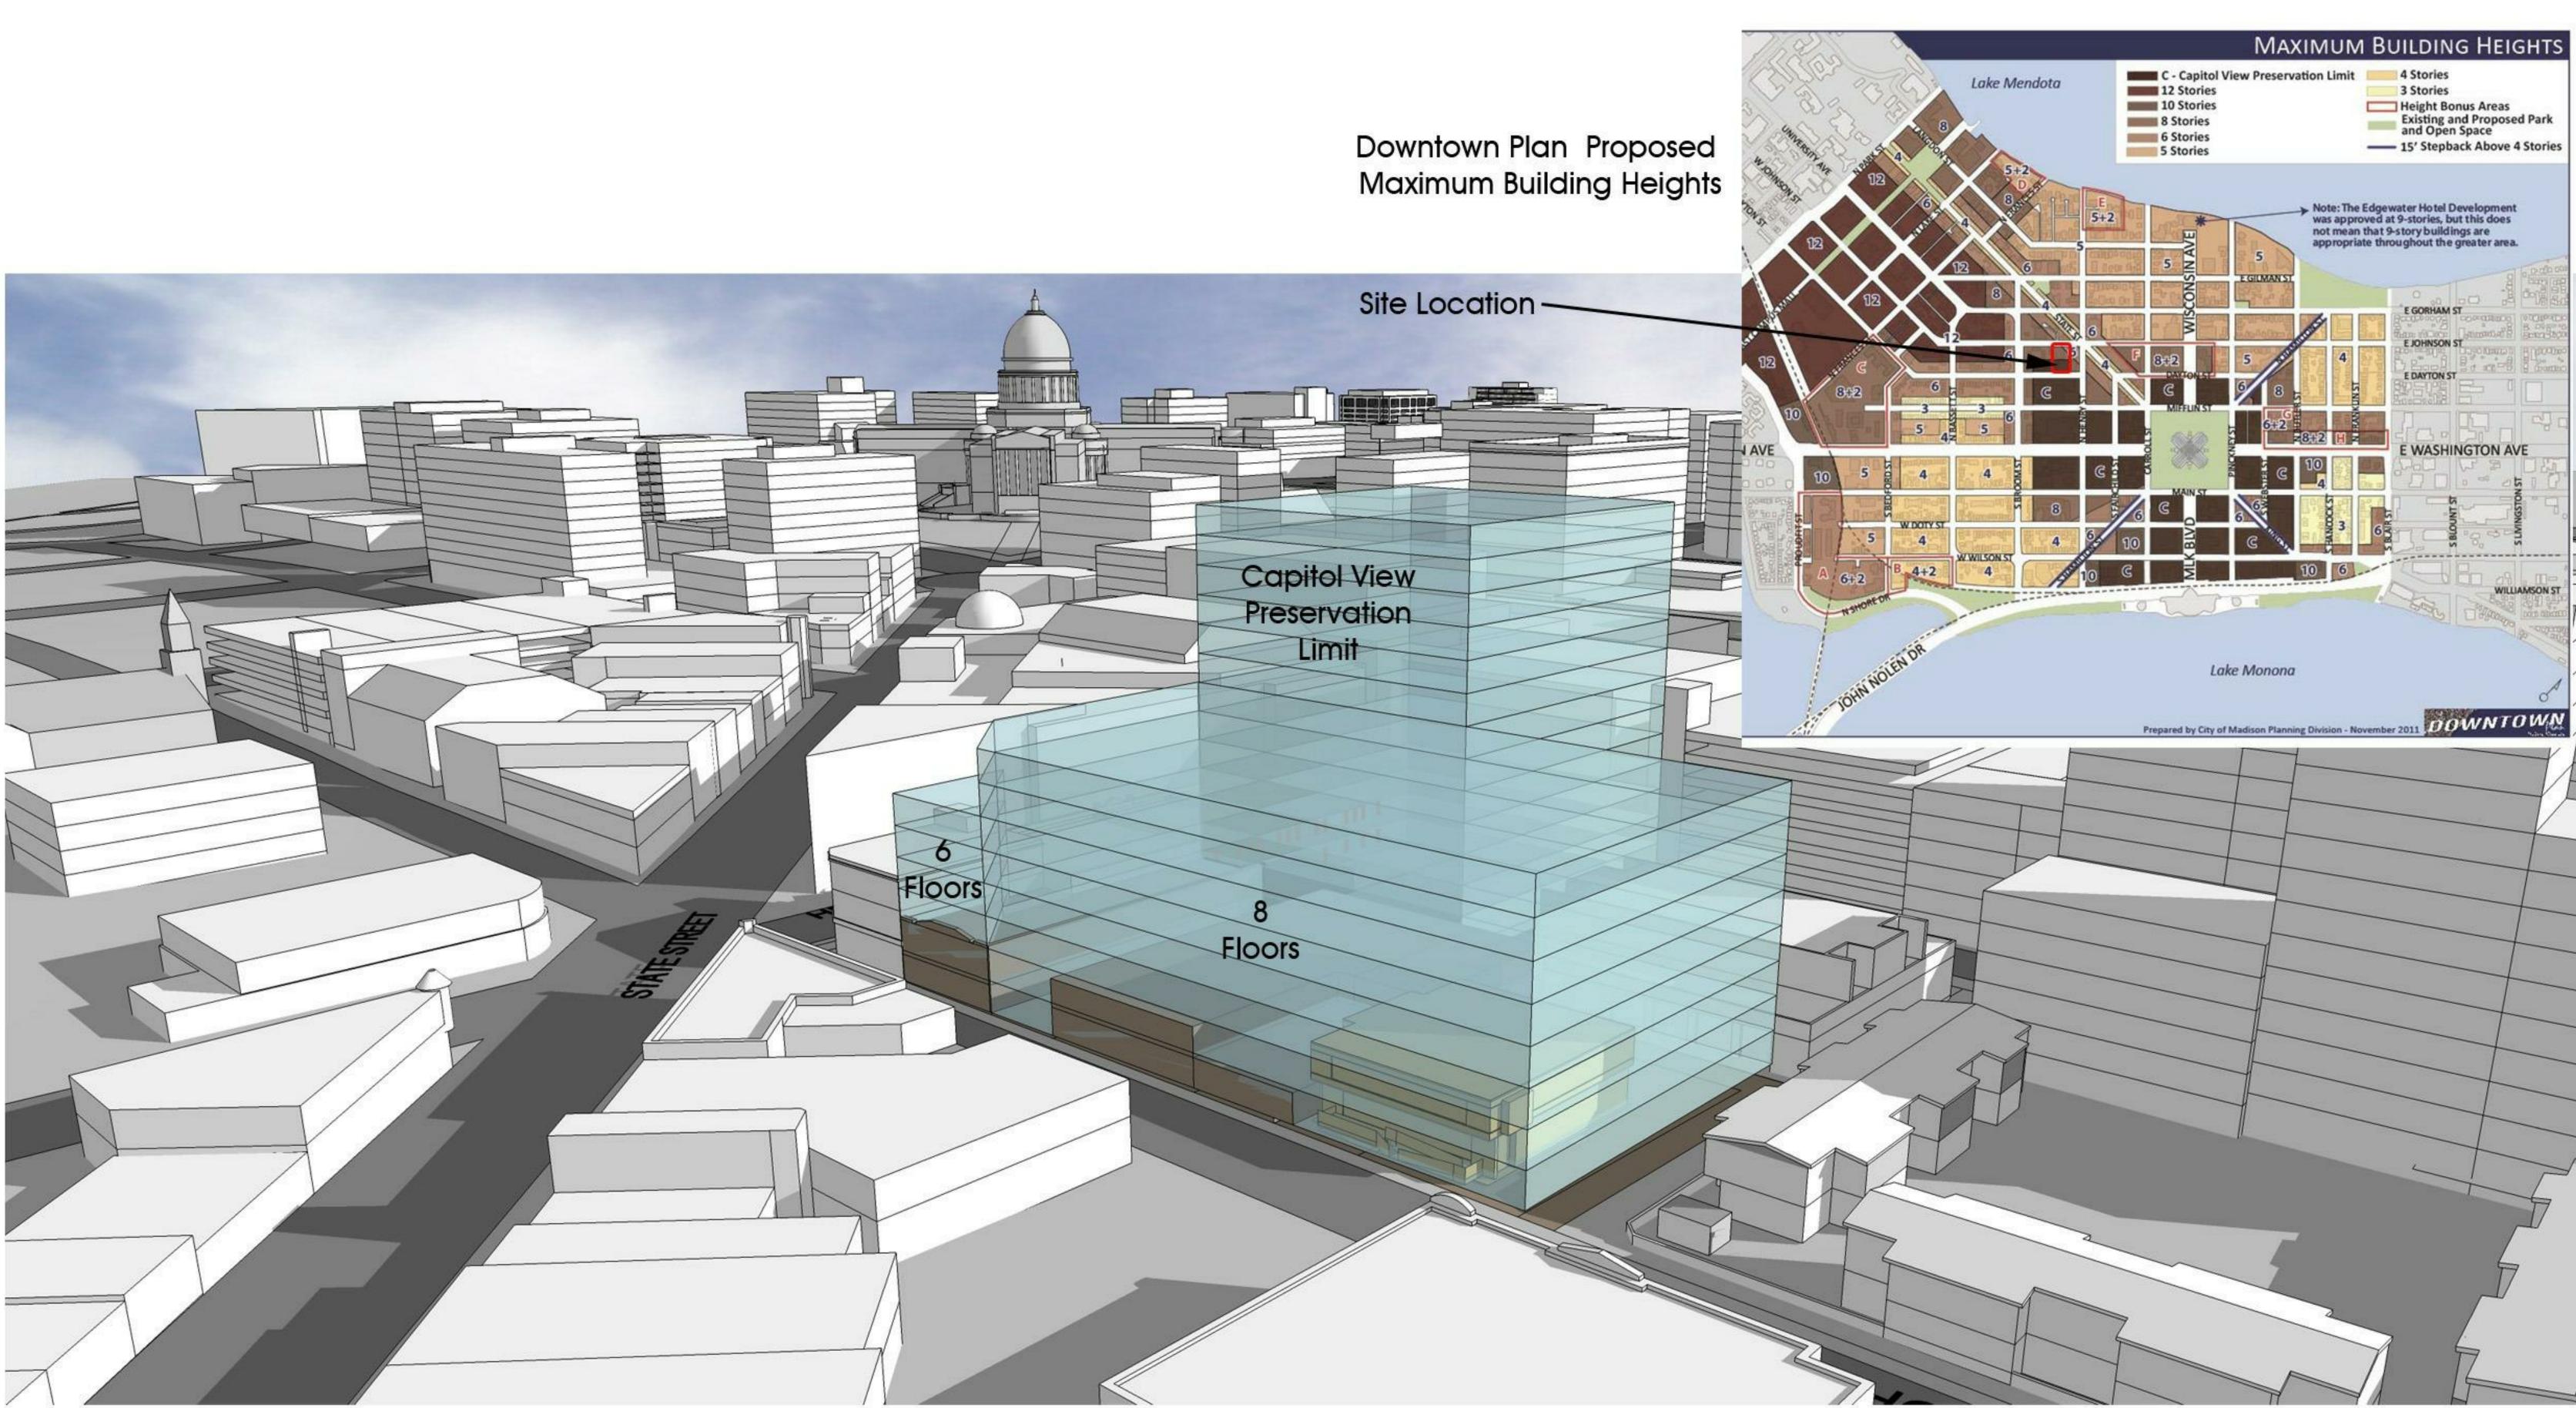



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KEY PLAN

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ISSUANCE AND REVISIONS

URBAN DESIGN COMMISSION APPROVAL SET # DATE DESCRIPTION

PROGRESS DOCUMENTS

These documents reflect progress and intent and may be subject to change, including additional detail. These are not final construction documents and should not be used for final bidding or construction-related purposes.

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PROJECT INFORMATION



309 W. JOHNSON STREET MADISON, WI

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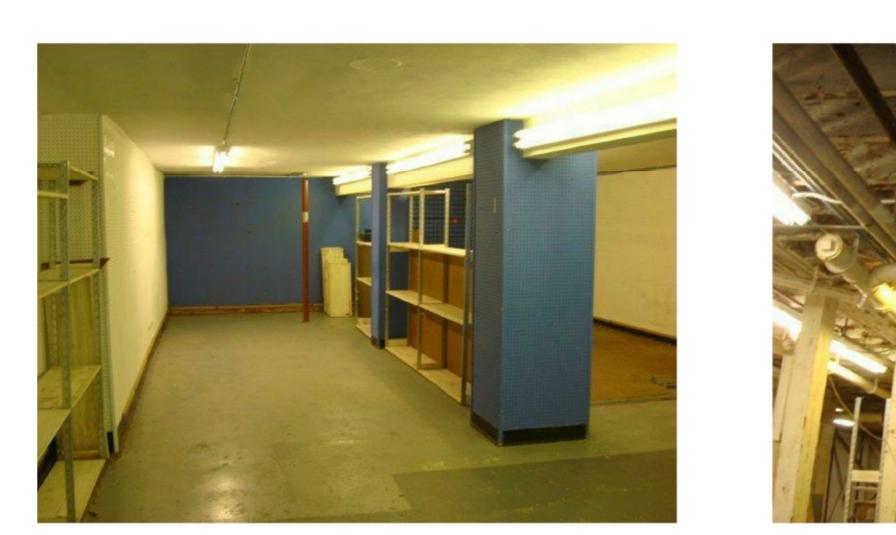
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305 W. JOHNSON STREET

3 INTERIORS OF EXISTING PROPERTIES TO BE DEMOLISHED





2 EXISTING STREETSCAPE AT WEST DAYTON STREET







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309 W. JOHNSON STREET



325 W. JOHNSON STREET

WEST DAYTON STREET

316



ISSUANCE AND REVISIONS

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216 N. Henry

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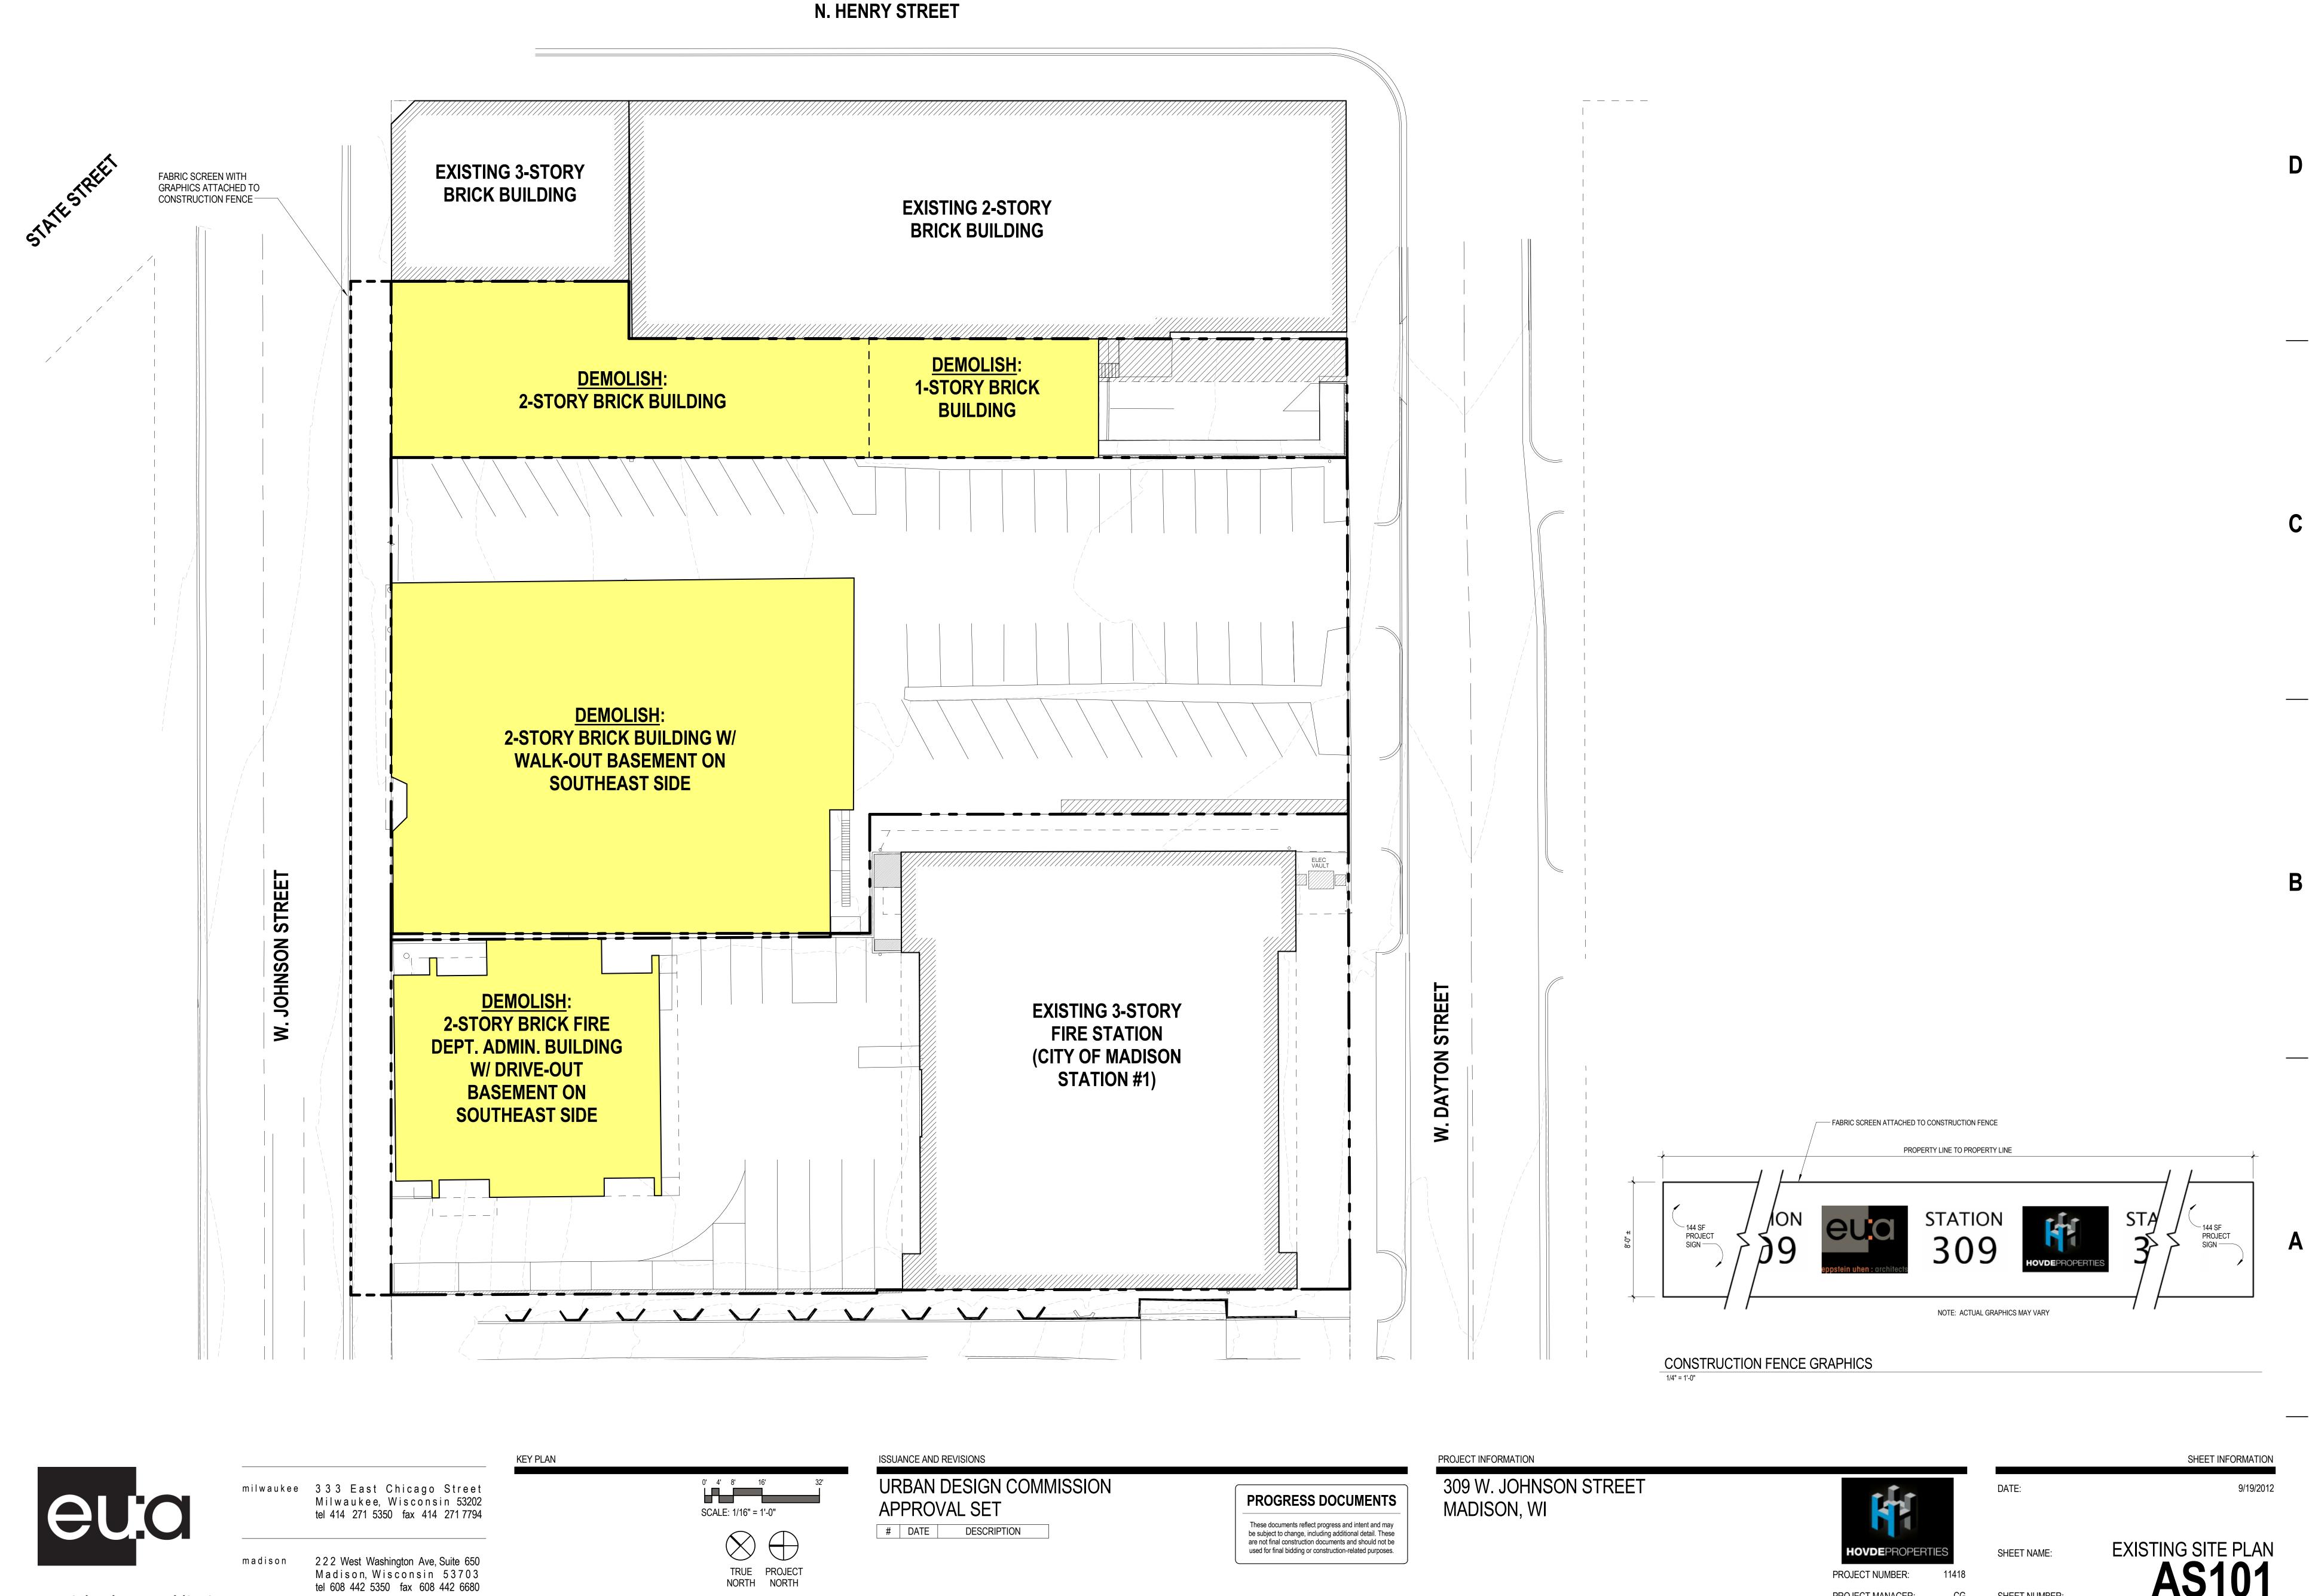


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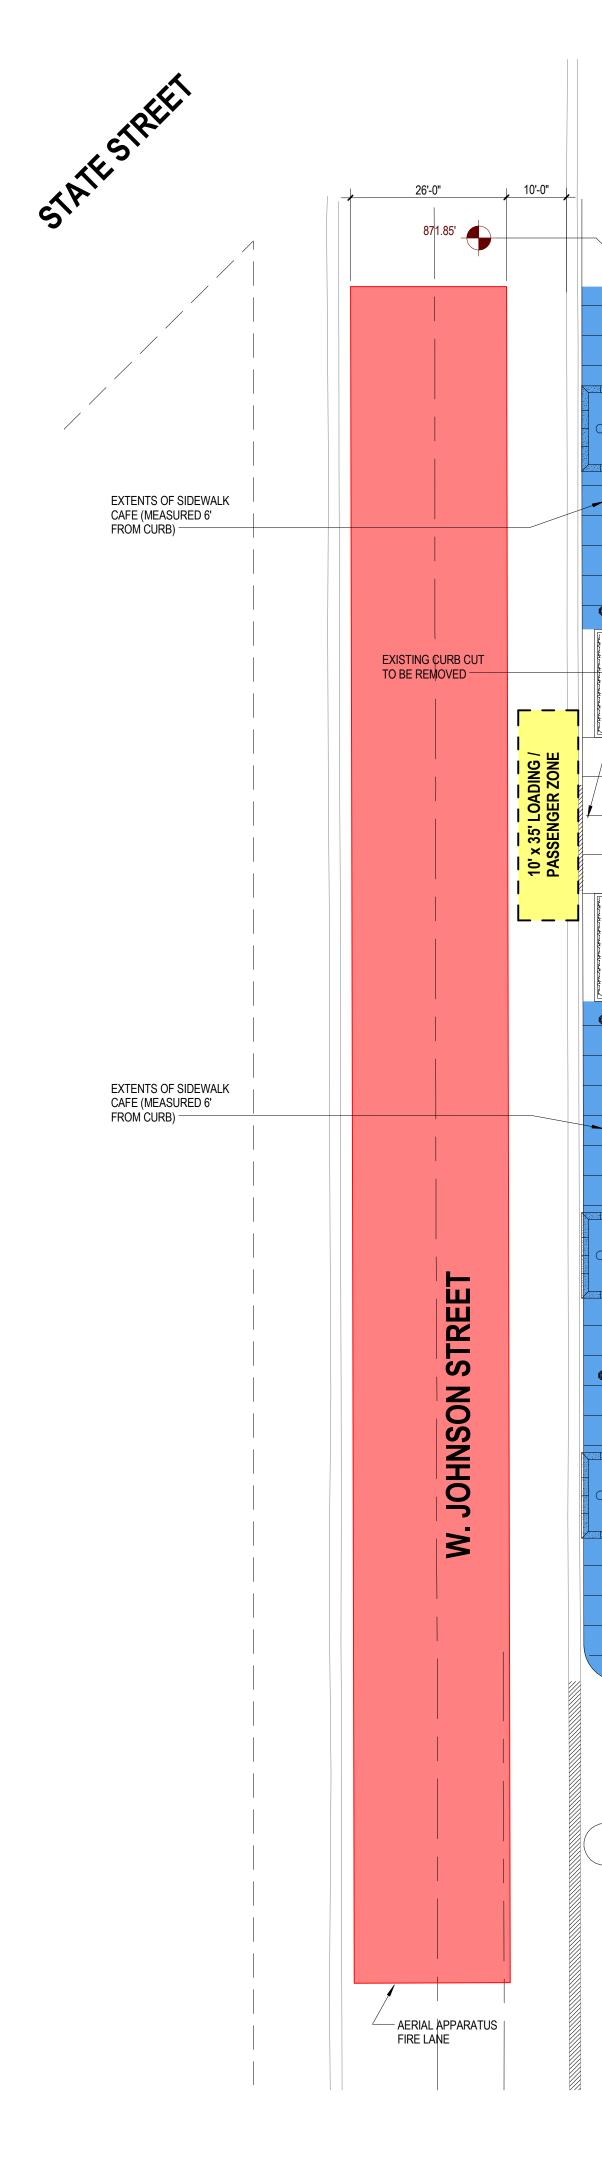




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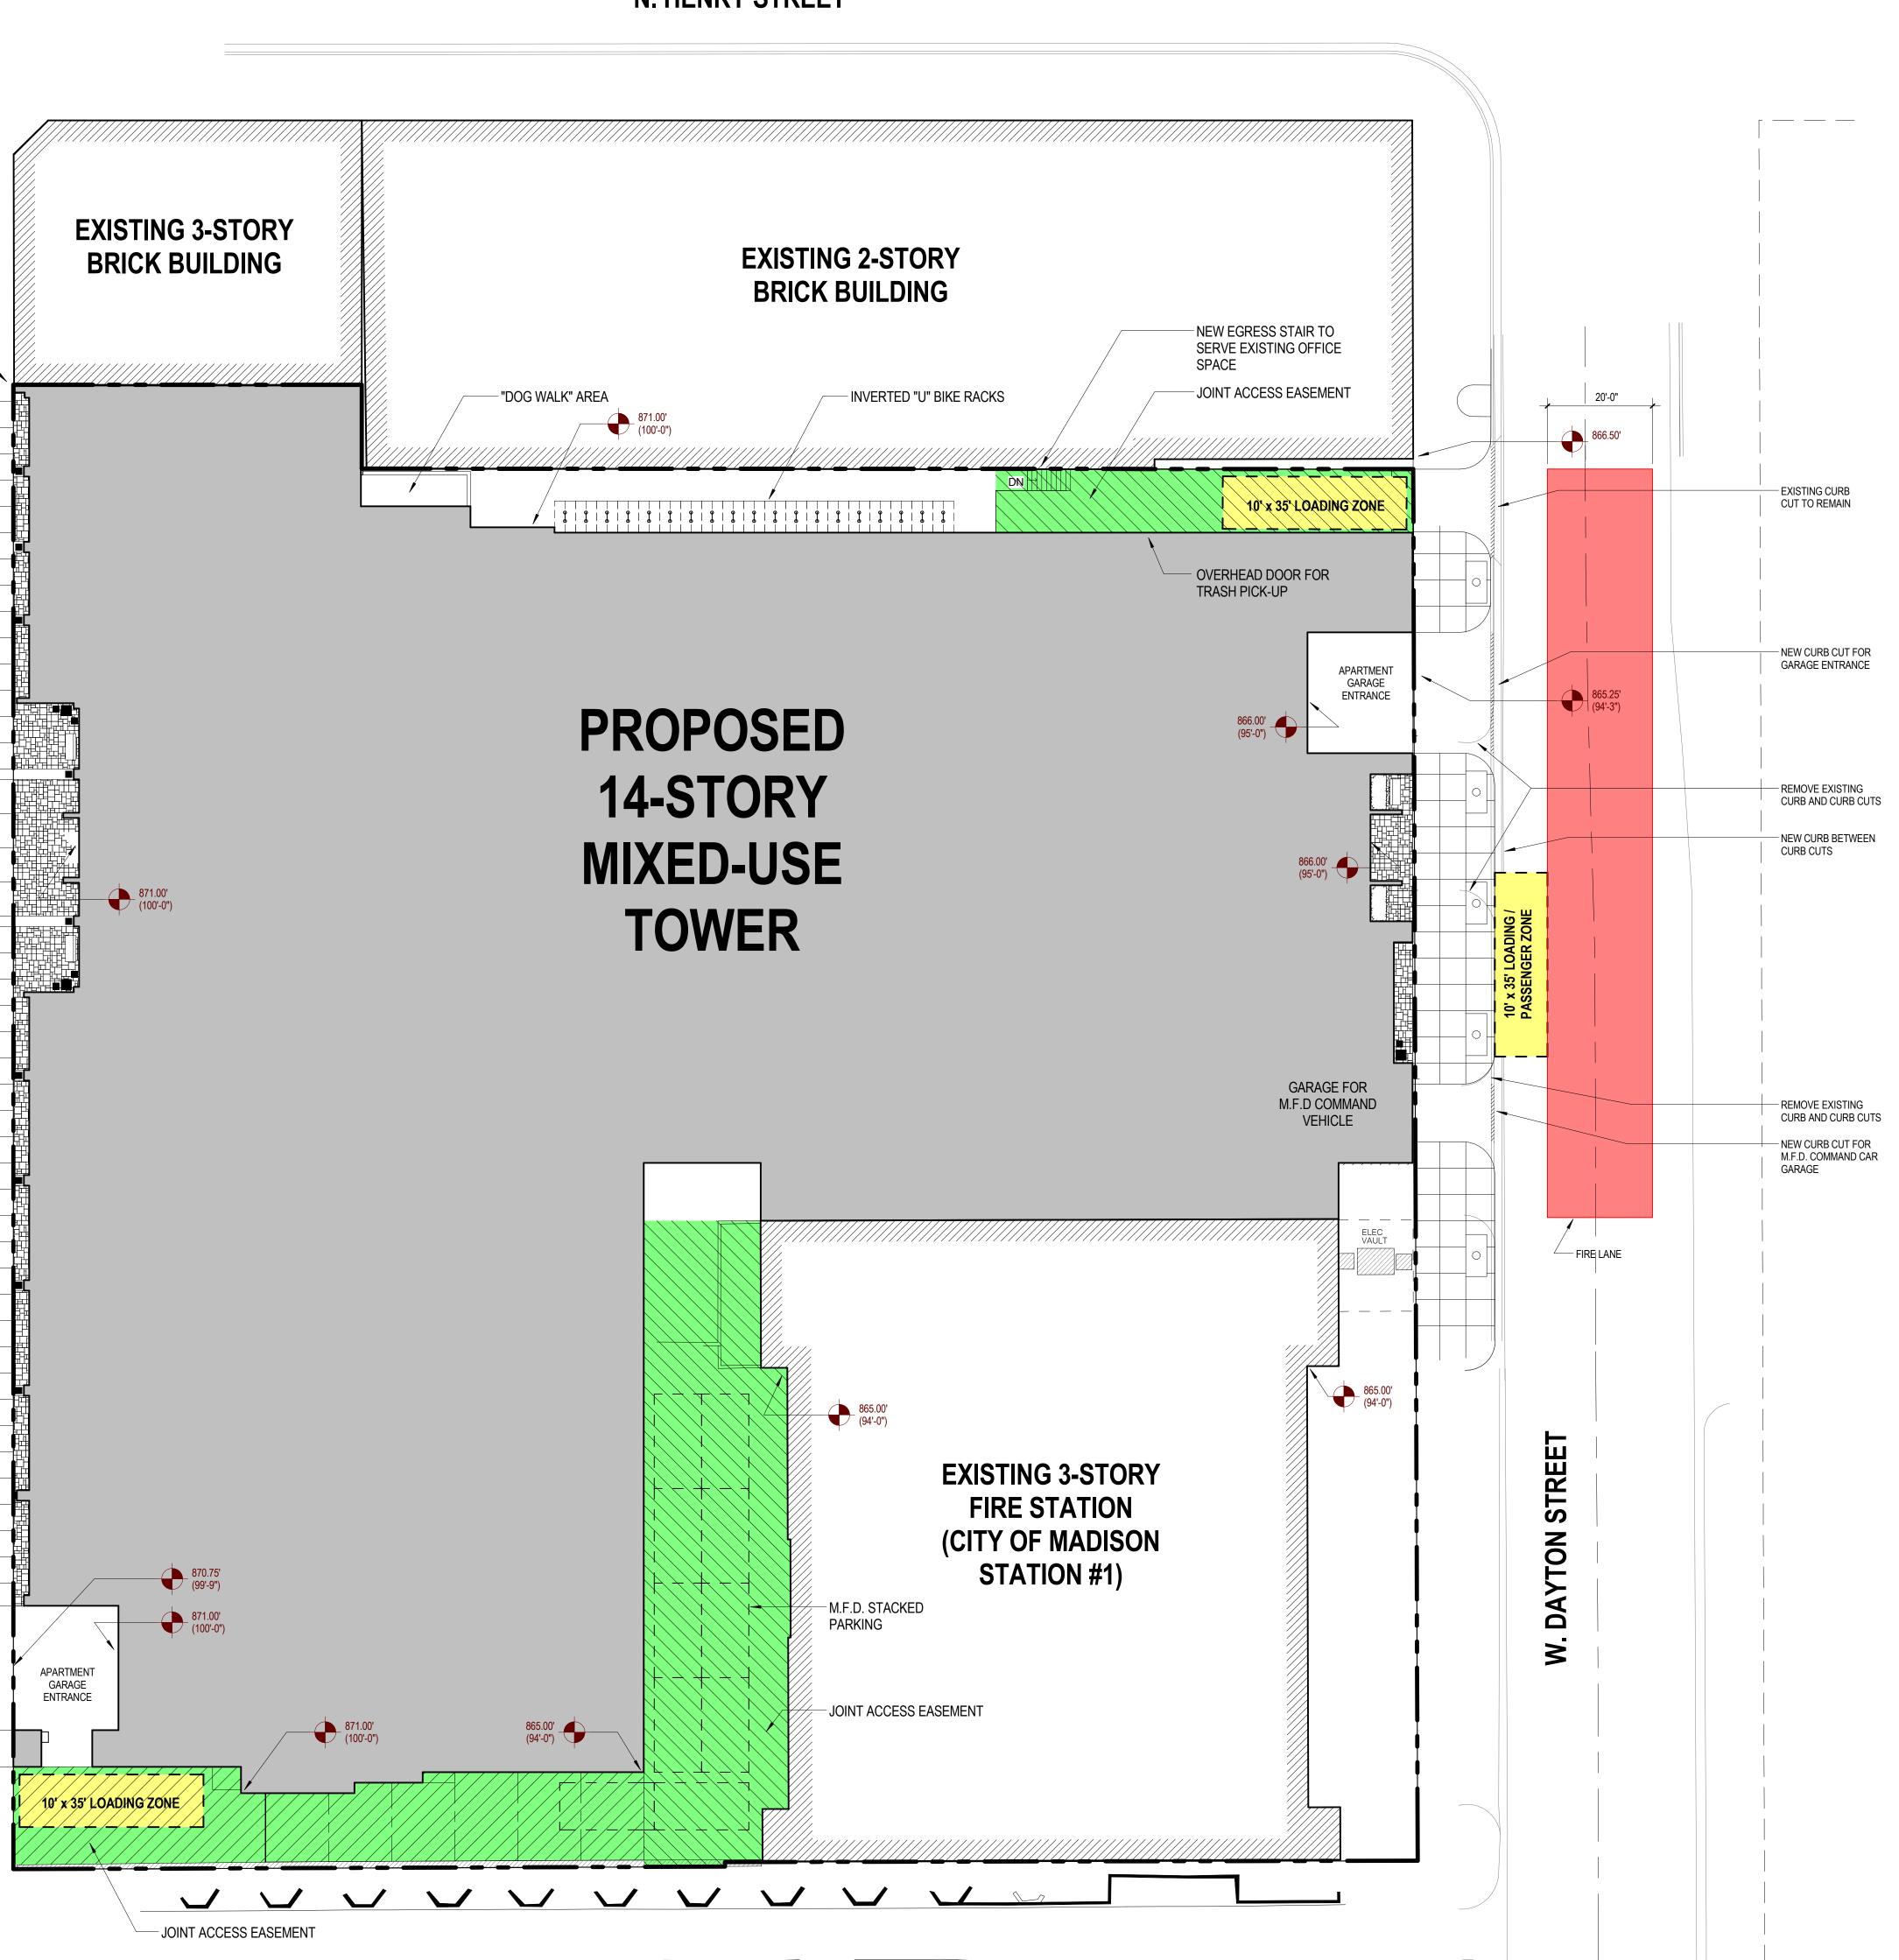
N. HENRY STREET

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0' 4' 8' 16' SCALE: 1/16" = 1'-0" \bigotimes \bigcirc TRUE PROJECT NORTH NORTH ISSUANCE AND REVISIONS

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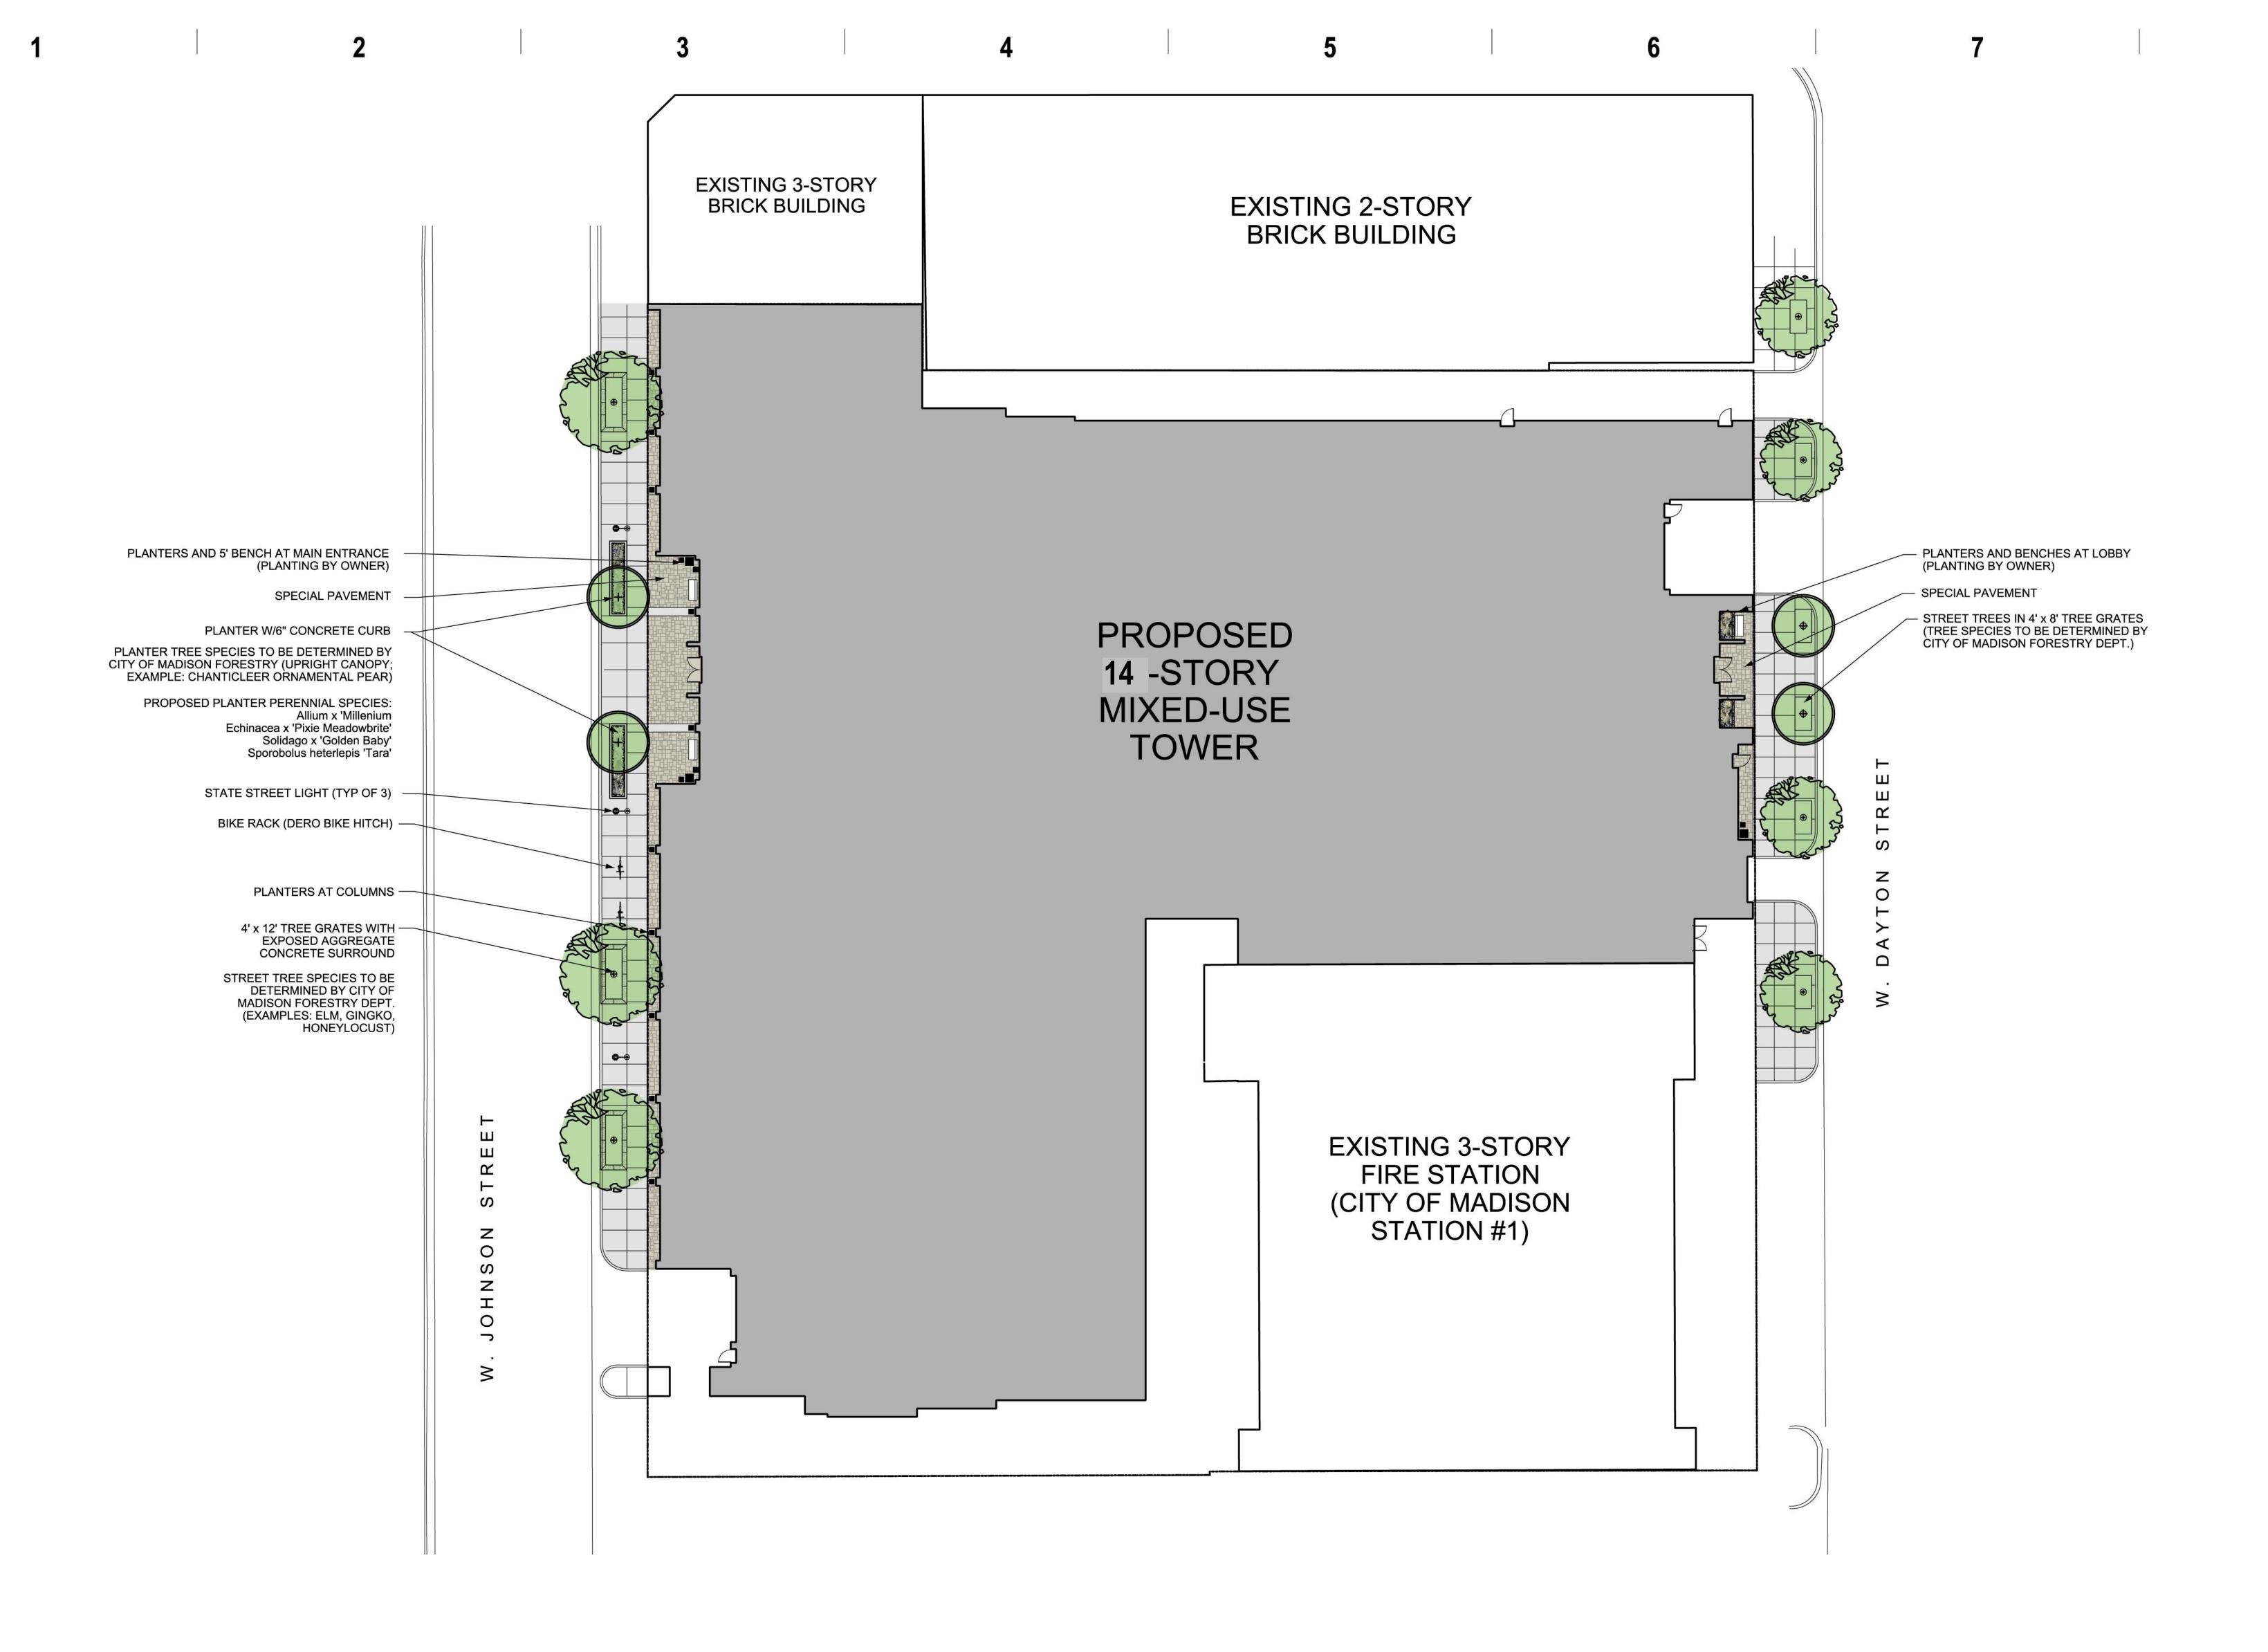
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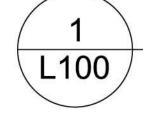
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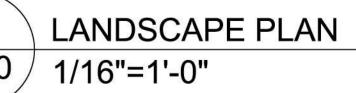
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TRUE PROJECT NORTH NORTH ISSUANCE AND REVISIONS

URBAN DESIGN COMMISSION APPROVAL SET # DATE DESCRIPTION

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309 W. JOHNSON STREET MADISON, WI



DATE:

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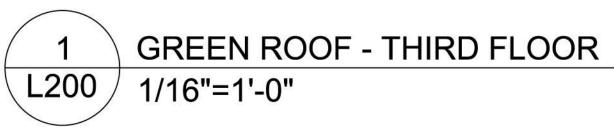
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9/19/2012







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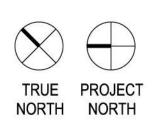
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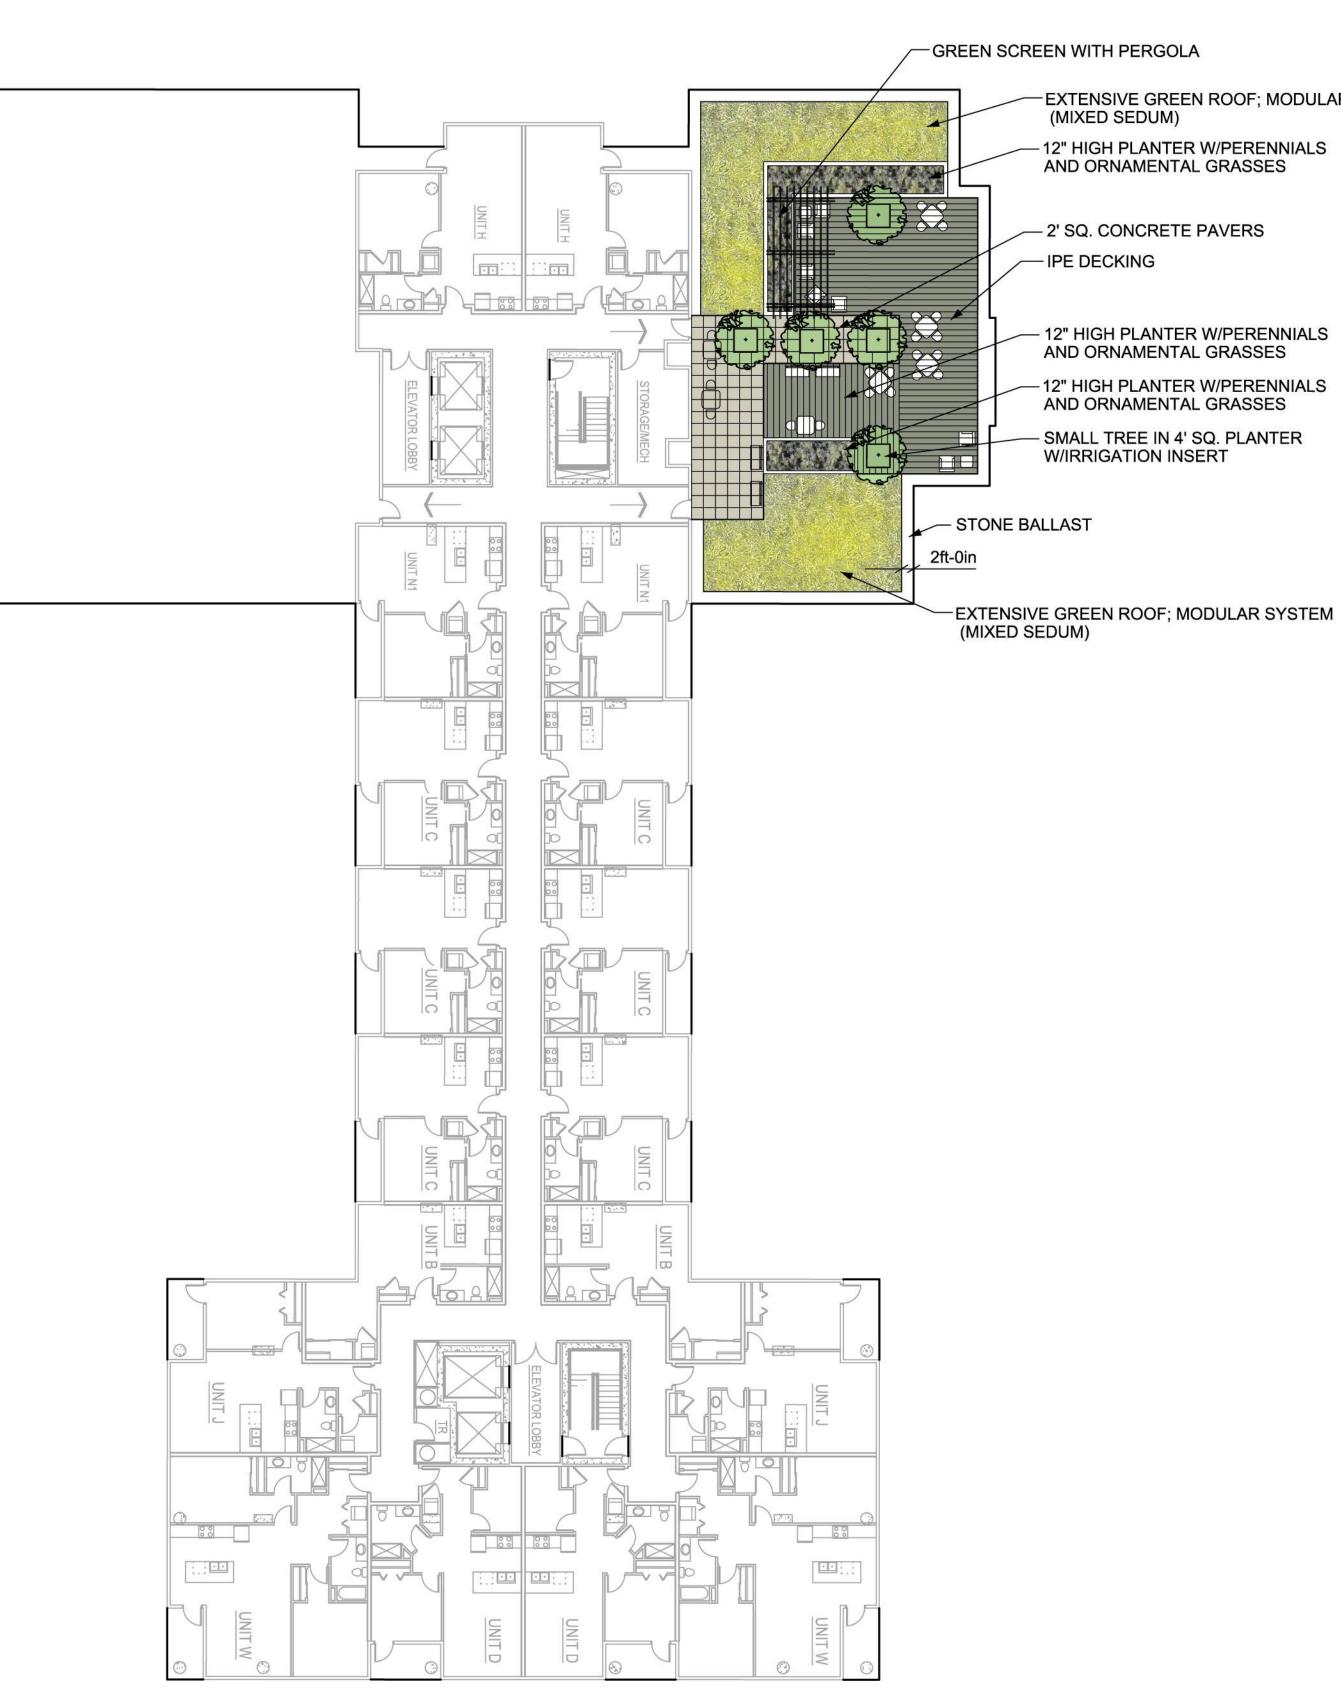
PROGRESS DOCUMENTS

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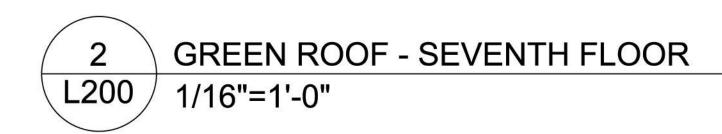
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PROJECT INFORMATION



309 W. JOHNSON STREET MADISON, WI



DATE:

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— EXTENSIVE GREEN ROOF; MODULAR SYSTEM (MIXED SEDUM)

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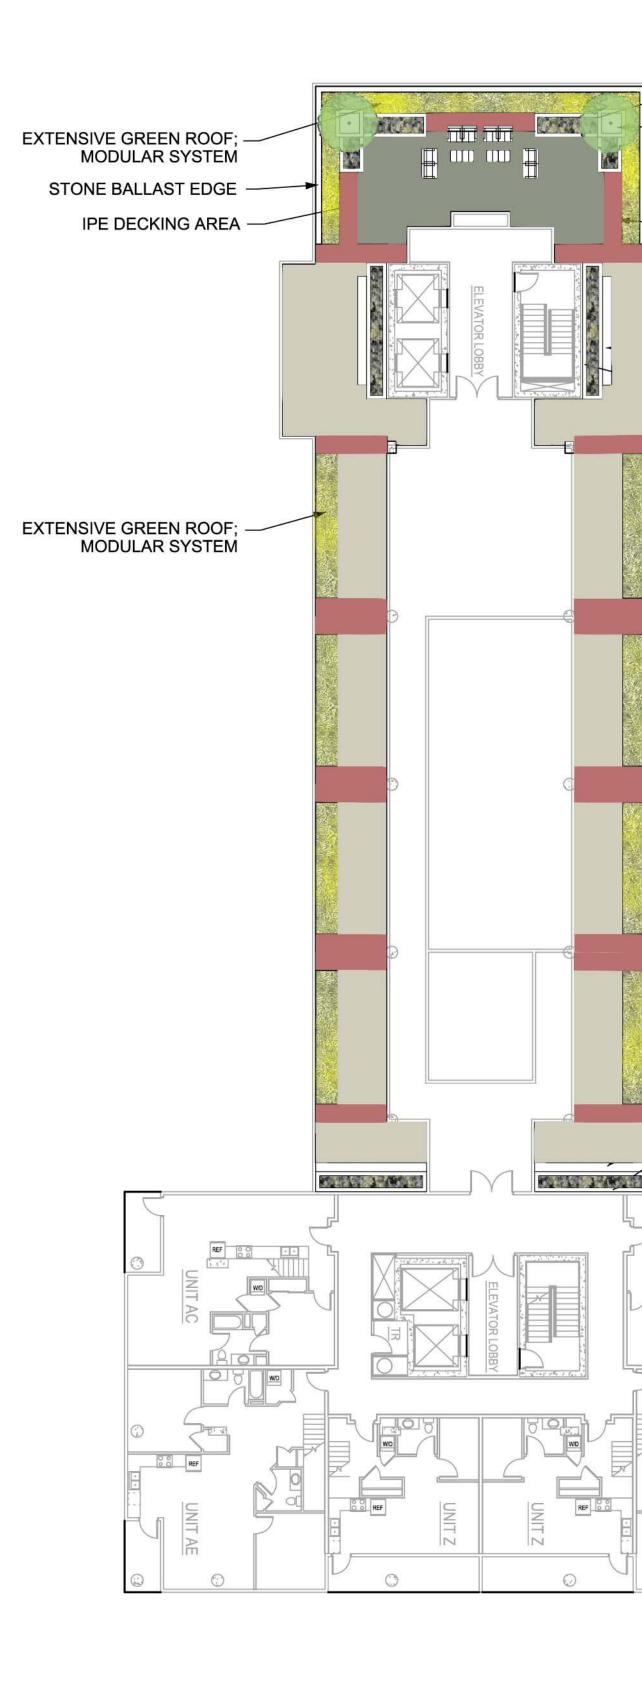
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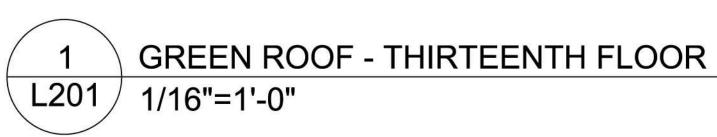


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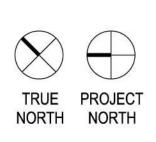
	inary Plant Palette				
Key	Botanical Name	Common Name	Quantity	Size	Comme
<u> </u>			Quantity	5126	Comme
	Trees				
	Malus sargentii 'Tina'	Tina Sargent Crabapple		5' Ht B&B	Multi-stemmed
	Minoc				
	Vines Akebia quinata	Fiveleaf Akbia		1 gal pot	
	Clematis maximowzsiana	Sweet Autumn Clematis		1 gal pot	
	Johnson St. Planter Perennials <i>Allium x</i> 'Millenium'	Millonium Ornomontal Onion		4 1/2" pot	
	<i>Echinacea x</i> 'Pixie Meadowbrite'	Millenium Ornamental Onion Pixie Meadowbrite Purple Coneflower		4 1/2 pot 4 1/2" pot	
	Solidago x 'Golden Baby'	Golden Baby Goldenrod		4 1/2" pot	
	Sporobolus heterolepis 'Tara'	Tara Dropseed		4 1/2" pot	
	Semi-Intensive Green Roof				
	Allium 'Summer Beauty'	Summer Beauty Ornamental Onion		4 1/2" pot	
	Aster sericeus Coreopsis verticillata 'Zagreb'	Silky Aster Zagreb Threadleaf Tickseed		4 1/2" pot 4 1/2" pot	<u> </u>
	Dianthus carthusianorum	Clusterhead Pink		4 1/2" pot 4 1/2" pot	
	Eragrostis spectabilis	Purple Love Grass		4 1/2" pot	
	Gaura lindeimeri 'Summer Breeze' Panicum virgatum 'Prairie Sky'	Summer Breeze Gaura Prairie Sky Switchgrass		4 1/2" pot 4 1/2" pot	
	Sedum x 'Purple Emperor'	Purple Emperor Sedum		4 1/2" pot	
	Sesleria autumnalis	Autumn Moor Grass		4 1/2" pot	
	Extensive Green Boof mix 4				
	Extensive Green Roof - mix 1 Sedum acre 'Aurea'		pre-grown g	reen roof	shade tolerant; 3
	Sedum ellacombeanum		modules		east side
	Sedum hybridum 'Immergrunchen'				
	Sedum floriferum 'Weihenstephaner Gold' Sedum pachyclados		-		
	Sedum sexangulare				
	Sedum spurium 'Album Superbum'		4		
	Sedumspurium 'Fuldaglut' Sedumspurium 'Green Mantle'		-		
	Sedumspurium 'John Creech'		1		
	Sedum ternatum Sedum tschernokolevii		_		
			-		
	Extensive Green Roof - mix 2				
	Sedum album 'Chloroticum' Sedum album 'Green Ice'		pre-grown g modules	reen roof	3rd floor west sid
	Sedum abum Green ice Sedum spectabile 'Star Dust'				predominantly gr white
	Sedum spurium 'Album Superbum'		1		
	Sedum spurium 'Green Mantle'		-		
	Extensive Green Roof - mix 3				
	Sedum album 'Chloroticum'		pre-grown g	reen roof	3rd floor west si
	Sedum spurium 'Dragon's Blood' Sedum spurium 'John Creech'		modules		predominantly p
	Sedum spurium 'Pink Jewel'		-		green
	Sedum spurium 'Roseum']		
	Sedum spurnium 'Royal Pink' Sedum spurnium 'Summer Glory'		-		
			_		
	Extensive Green Roof - mix 4				
	Sedum album 'Coral Carpet'		pre-grown g modules	reen root	3rd floor west si predominantly y
	Sedum floriferum 'Weihenstephaner Gold' Sedum hybidum 'Immergrunchen'				pink
	sedum reflexum		1		
	Sedum rupestre 'Angelina'		-		
	Sedum sexangulare Sedum spurium 'Dragon's Blood'		-		
	Sedum spurium 'Voodoo']		
	Extensive Green Roof - mix 5				
	Allium schoenoprasum 'Forescate'		pre-grown g	reen roof	7th floor; sun; m
	Sedum acre 'Aureum'		modules		with accent plan
	Sedum album 'Chloroticum' Sedum cauticola 'Sunset Cloud'		-		
	Sedum cauticola Sunset Cloud	 	-		
	Sedum spurium 'Dragon's Blood']		
	Sedum spurium 'Voodoo'		-		
	Extensive Green Roof - mix 6				
	Sedum acre 'Aureum'		pre-grown g	reen roof	13th floor; sun; r
	Sedum album 'Chloroticum'		modules		colors
	Sedum reflexum 'Moonshadow' Sedum reflexum 'Solar Spice'		-		
	Sedum rupestre 'Angelina'		1		
	Sedum spurium 'Sour Cherry'		7		1
	Sedum spurium 'Voodoo'		—		

ISSUANCE AND REVISIONS

URBAN DESIGN COMMISSION APPROVAL SET # DATE DESCRIPTION

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- 18" HIGH PLANTER

— 3' SQ. PAVERS, TYP.

2' SQ. PAVERS, TYP.

W/VINES

— 28" HIGH PLANTER W/INTEGRATED SEAT

NOTE: ALL RAISED PLANTERS WITH

IRRIGATION INSERTS

— 28" HIGH PLANTER W/INTEGRATED SEAT

REF

6' HIGH TRELLIS STRUCTURE W/VINES

– 6' HIGH TRELLIS STRUCTURE

TREE

- 28" HIGH PLANTER W/SMALL

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PROJECT INFORMATION

309 W. JOHNSON STREET MADISON, WI



DATE:

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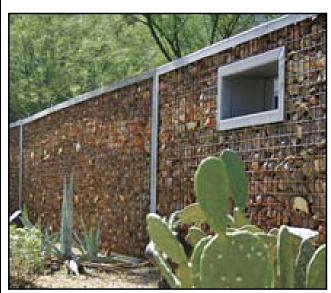
222 West Washington Ave, Suite 650 Madison, Wisconsin 53703 tel 608 442 5350 fax 608 442 6680 KEY PLAN

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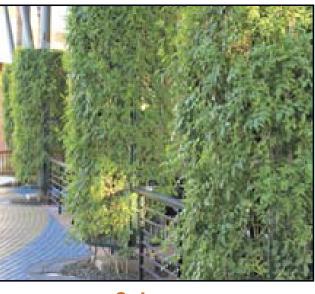




Mounted Trellis



Rock Wall Fencing



Columns



Trellis



Plant Wall




ISSUANCE AND REVISIONS

APPROVAL SET

DATE DESCRIPTION

URBAN DESIGN COMMISSION

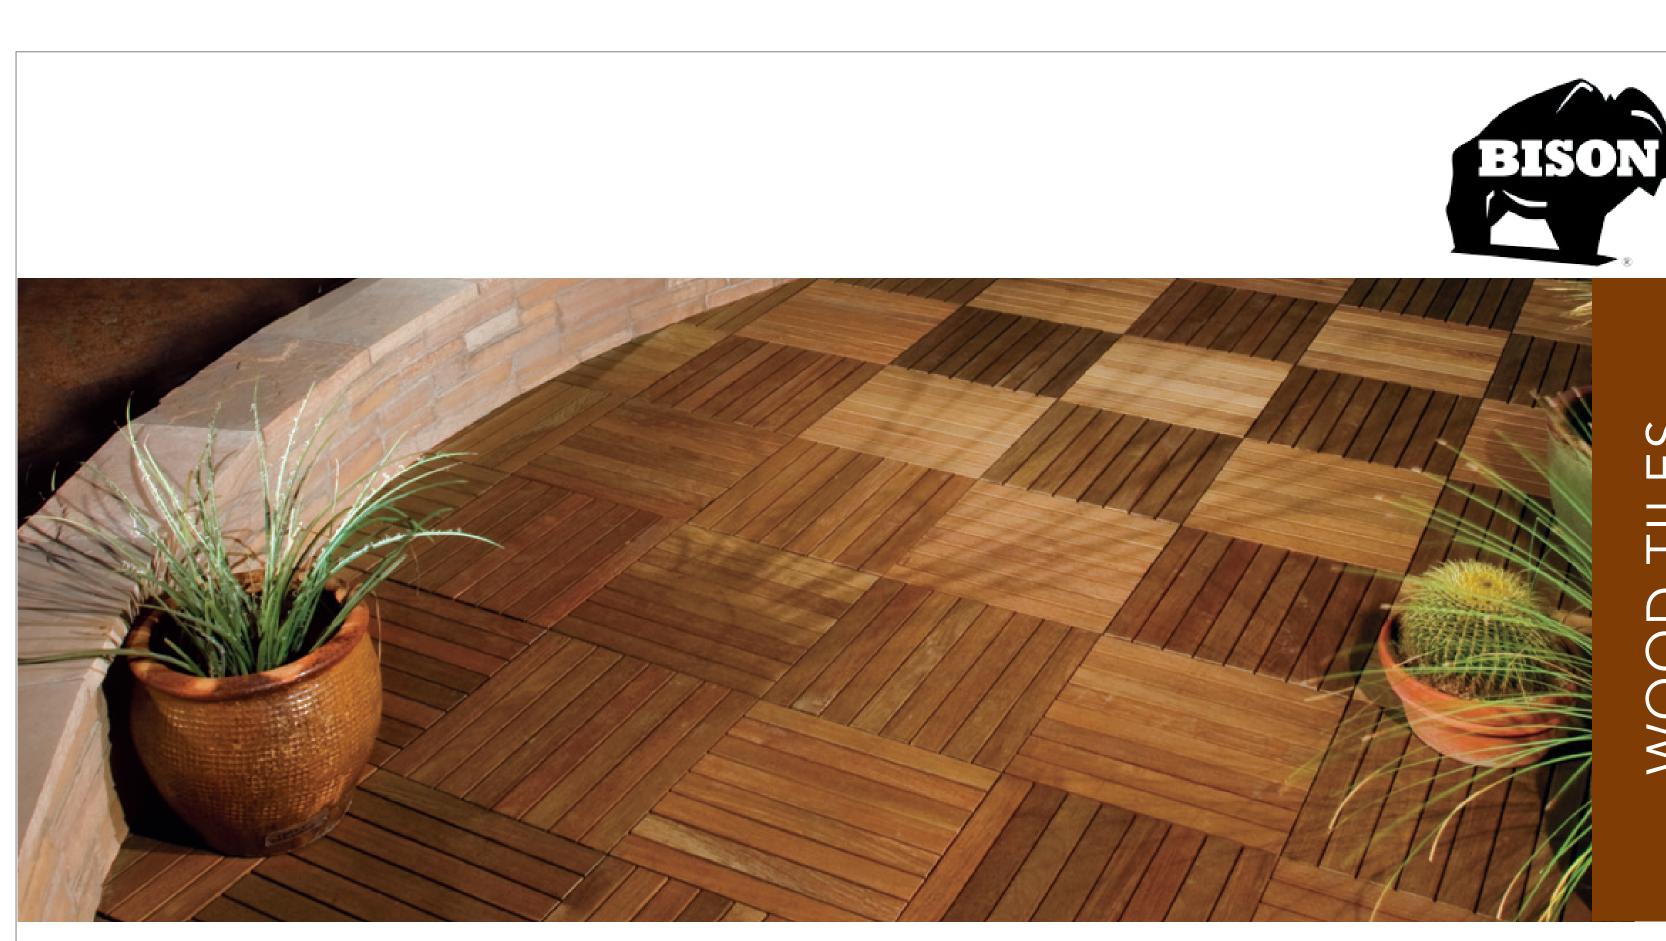

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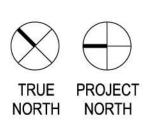
BEAUTY, LONGEVITY AND EXCEPTIONAL VALUE **BISON WOOD TILES**

Constructed from select Brazilian Hardwoods, Bison Wood Tiles are harvested in an environmentally responsible method designed to preserve and enhance the economic viability of rain forest hardwoods. Hardwood species include Ipê and Massaranduba



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4

- FSC® Certified options available
- Commercial grade and constructed with stainless steel screws
- Bison Wood Tiles are beautiful and weather to natural gray if left unfinished
- 100% natural wood and approximately three times harder than Red Oak
- Long Lasting and Low Maintenance


PROJECT INFORMATION 309 W. JOHNSON STREET MADISON, WI



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A·101 HENRY ADAMS ST. SUITE 380 SAN FRANCISCO, CA 94103 P·415.863.3406/800.426.6471 F·415.863.3530 W·WWW.IAPSF.COM E·INFO@IAPSF.COM




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222 West Washington Ave, Suite 650 Madison, Wisconsin 53703 tel 608 442 5350 fax 608 442 6680 **KEY PLAN**

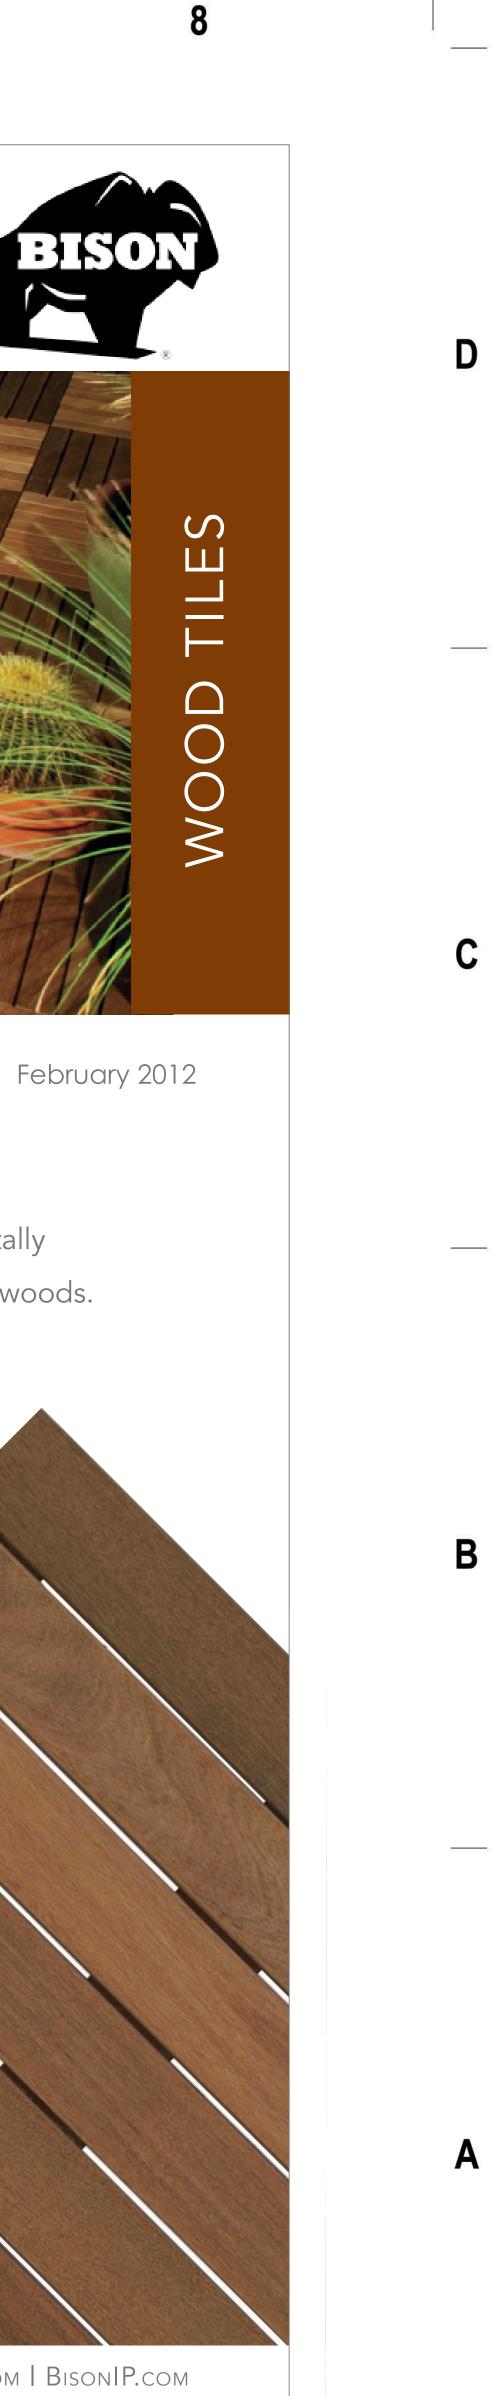

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Clean, elegant, and distinctively modern

The Metro Collection was born out of a desire to do something that would work with current architecture, but wouldn't feel cold and featureless. We gave each size a seductive curve, then a simple reveal to emphasize the shape. Whether in FRP fiberglass, metal infused, or GFRC Concrete, you'll find that Metro works in most urban settings.

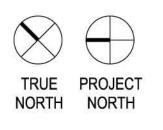



For more information about the Metro Collection, visit tournesolsiteworks.com/product-metro collection.html



Metro Collection

6

Lightweight FRP fiberglass and GFRC are designed to be durable despite low weight even for heavy-traffic locations

Coordinates with our self-watering container irrigation products

Metallic FRP finishes will naturally weather over time, like metal containers

Round, square and rectangular sizes from 18" to 60", with customization available

Matching ash, trash available



tournesolsiteworks.com




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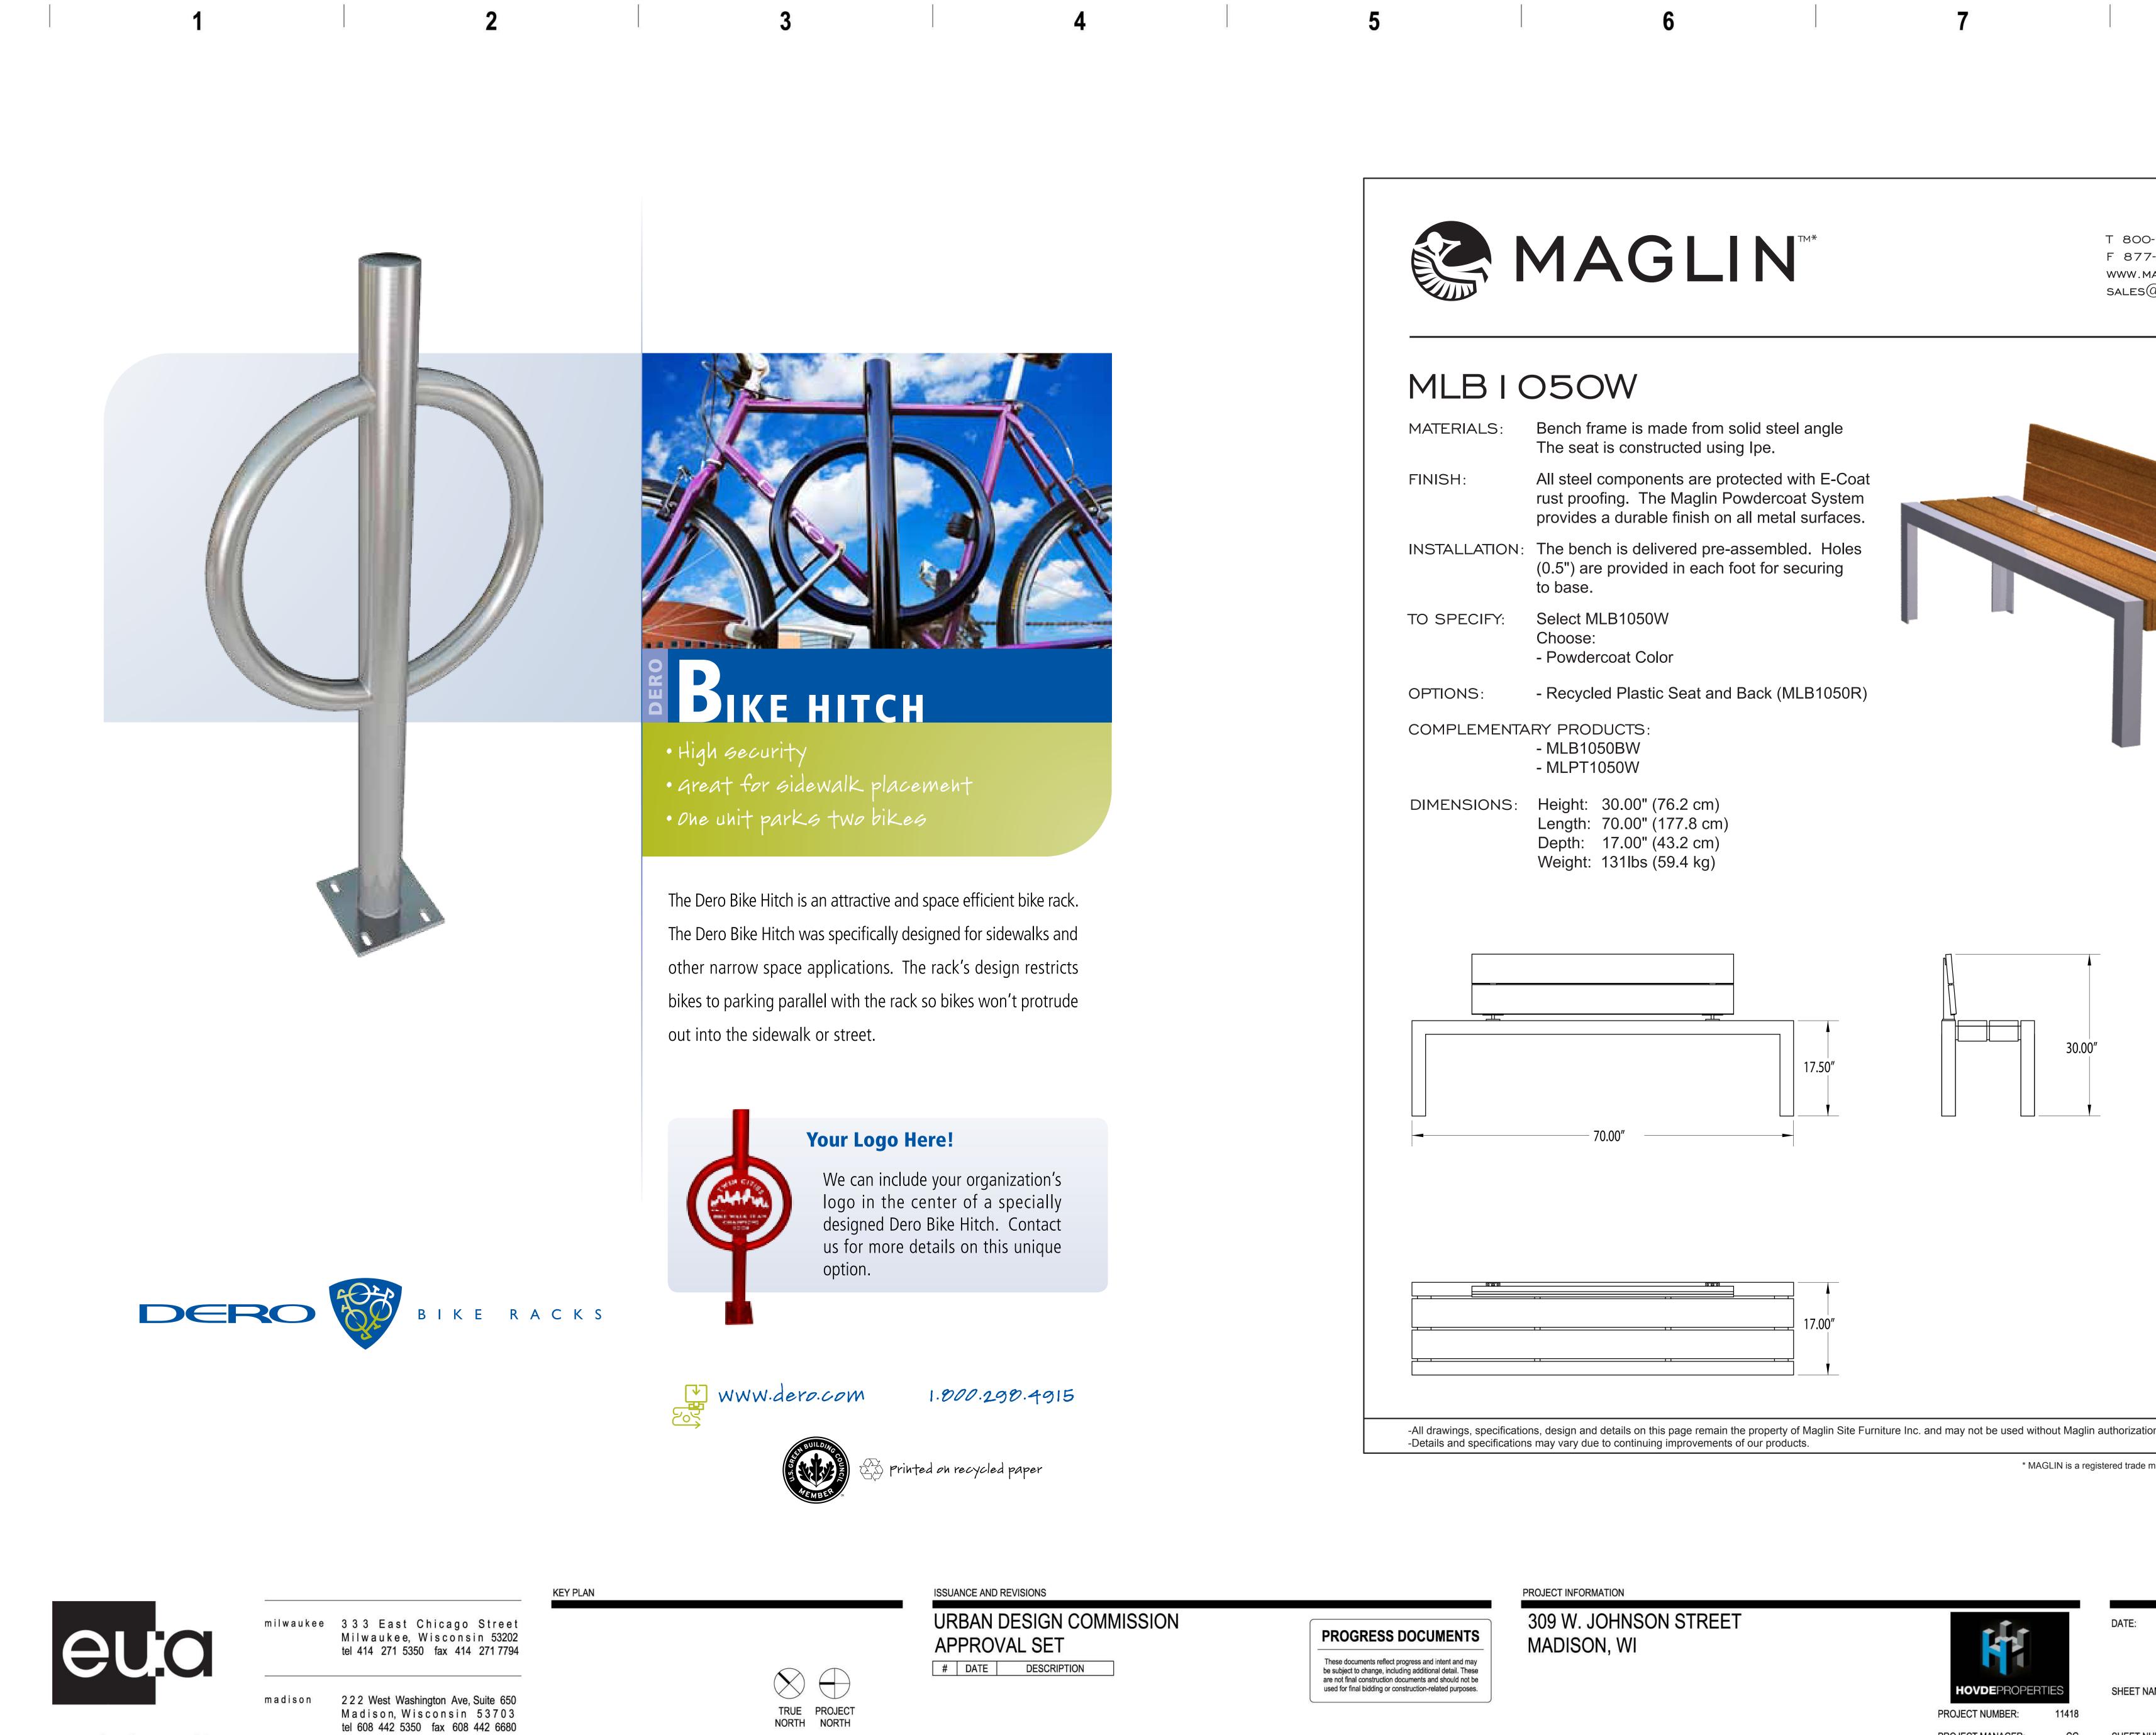
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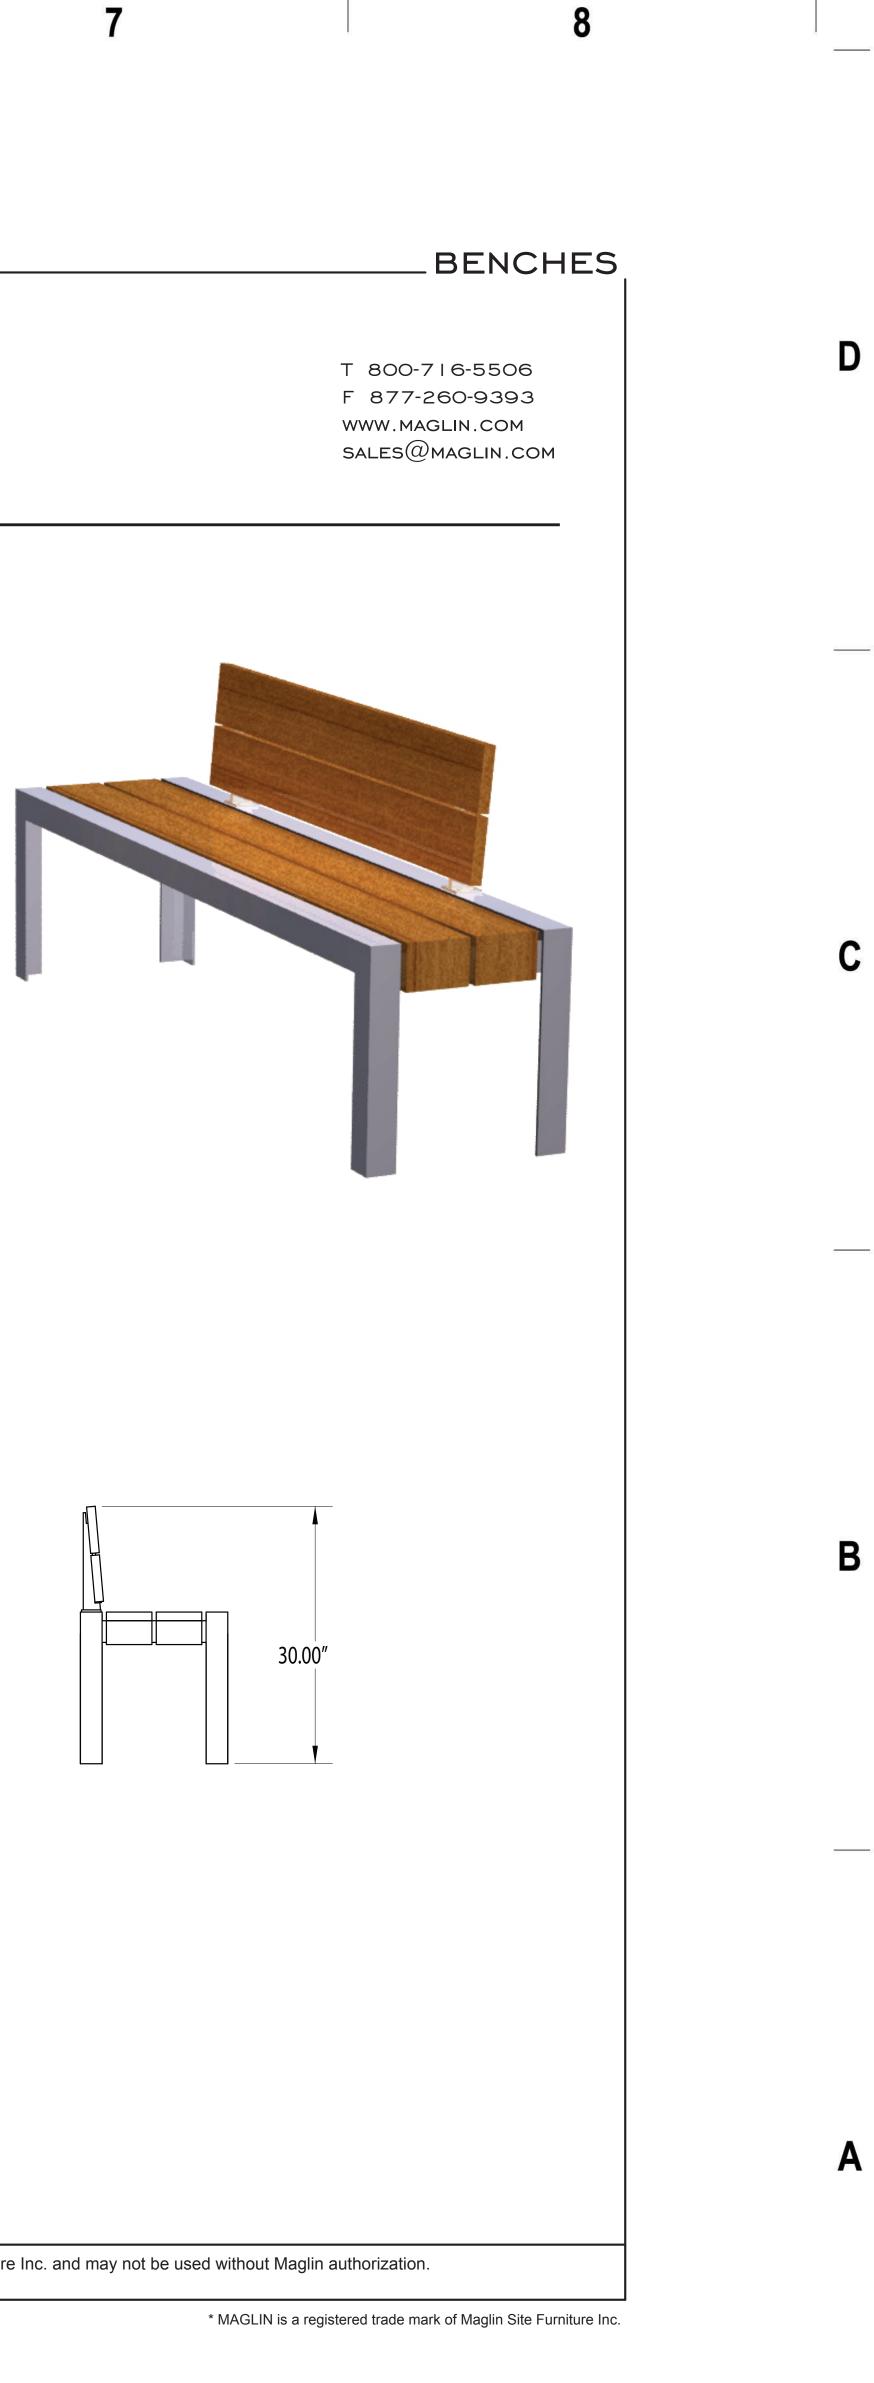



MAGLIN^{™*}


MLB I O50W

TERIALS:	Bench frame is made from solid steel angle The seat is constructed using lpe.
ISH:	All steel components are protected with E-Coat rust proofing. The Maglin Powdercoat System provides a durable finish on all metal surfaces.
TALLATION:	The bench is delivered pre-assembled. Holes (0.5") are provided in each foot for securing to base.
SPECIFY:	Select MLB1050W Choose: - Powdercoat Color
TIONS:	- Recycled Plastic Seat and Back (MLB1050R)
MPLEMENTA	RY PRODUCTS: - MLB1050BW

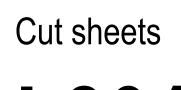
	- MLPT1	050W	
ENSIONS:	•	30.00" (76.2 cm)	
	Length:	70.00" (177.8 cm)
	Depth:	17.00" (43.2 cm)	
	Weight:	131lbs (59.4 kg)	



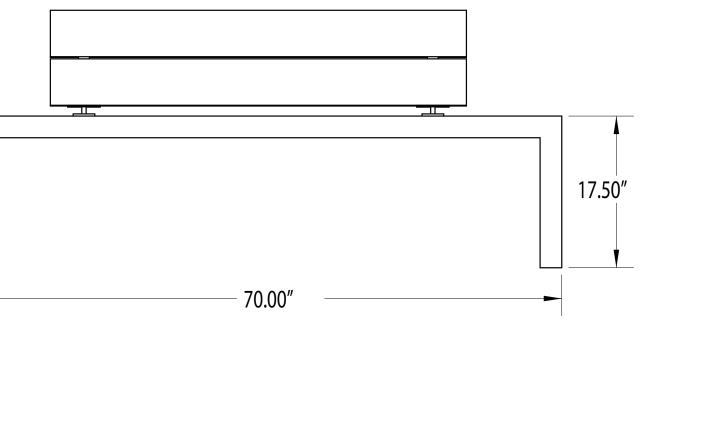

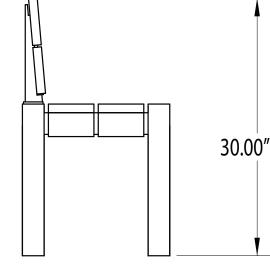

-All drawings, specifications, design and details on this page remain the property of Maglin Site Furniture Inc. and may not be used without Maglin authorization. -Details and specifications may vary due to continuing improvements of our products.

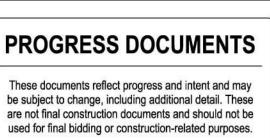

PROJECT INFORMATION 309 W. JOHNSON STREET MADISON, WI



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SHEET NUMBER:

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View From Johnson Street



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KEY PLAN

View From Johnson Street

ISSUANCE AND REVISIONS

URBAN DESIGN COMMISSION APPROVAL SET # DATE DESCRIPTION

PROGRESS DOCUMENTS


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View From State Street

PROJECT INFORMATION



309 W. JOHNSON STREET MADISON, WI

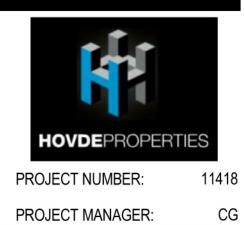

DATE:

SHEET NAME:

SHEET NUMBER:

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9/19/2012

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LOOKING SOUTH ON JOHNSON



LOOKING WEST ON DAYTON



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LOOKING EAST ON JOHNSON

AERIAL LOOKING SOUTH

ISSUANCE AND REVISIONS

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LOOKING NORTH ON DAYTON

AERIAL LOOKING EAST

PROJECT INFORMATION



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PERSPECTIVES



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9/19/2012

AERIAL LOOKING NORTH

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PROJECT NUMBER: 11418 PROJECT MANAGER:

HOVDEPROPERTIES

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DATE:

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eu:a

milwaukee 3:3:3 East Chicago Street Milwaukee, Wisconsin 53202 tel 414:271:5350 fax 414:2717794

madison 2:2.2 West Washington Ave, Suite 650 Madison, Wisconsin 5:3703 tel 608 442 5350 fax 608 442 6680

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AERIAL LOOKING SOUTH

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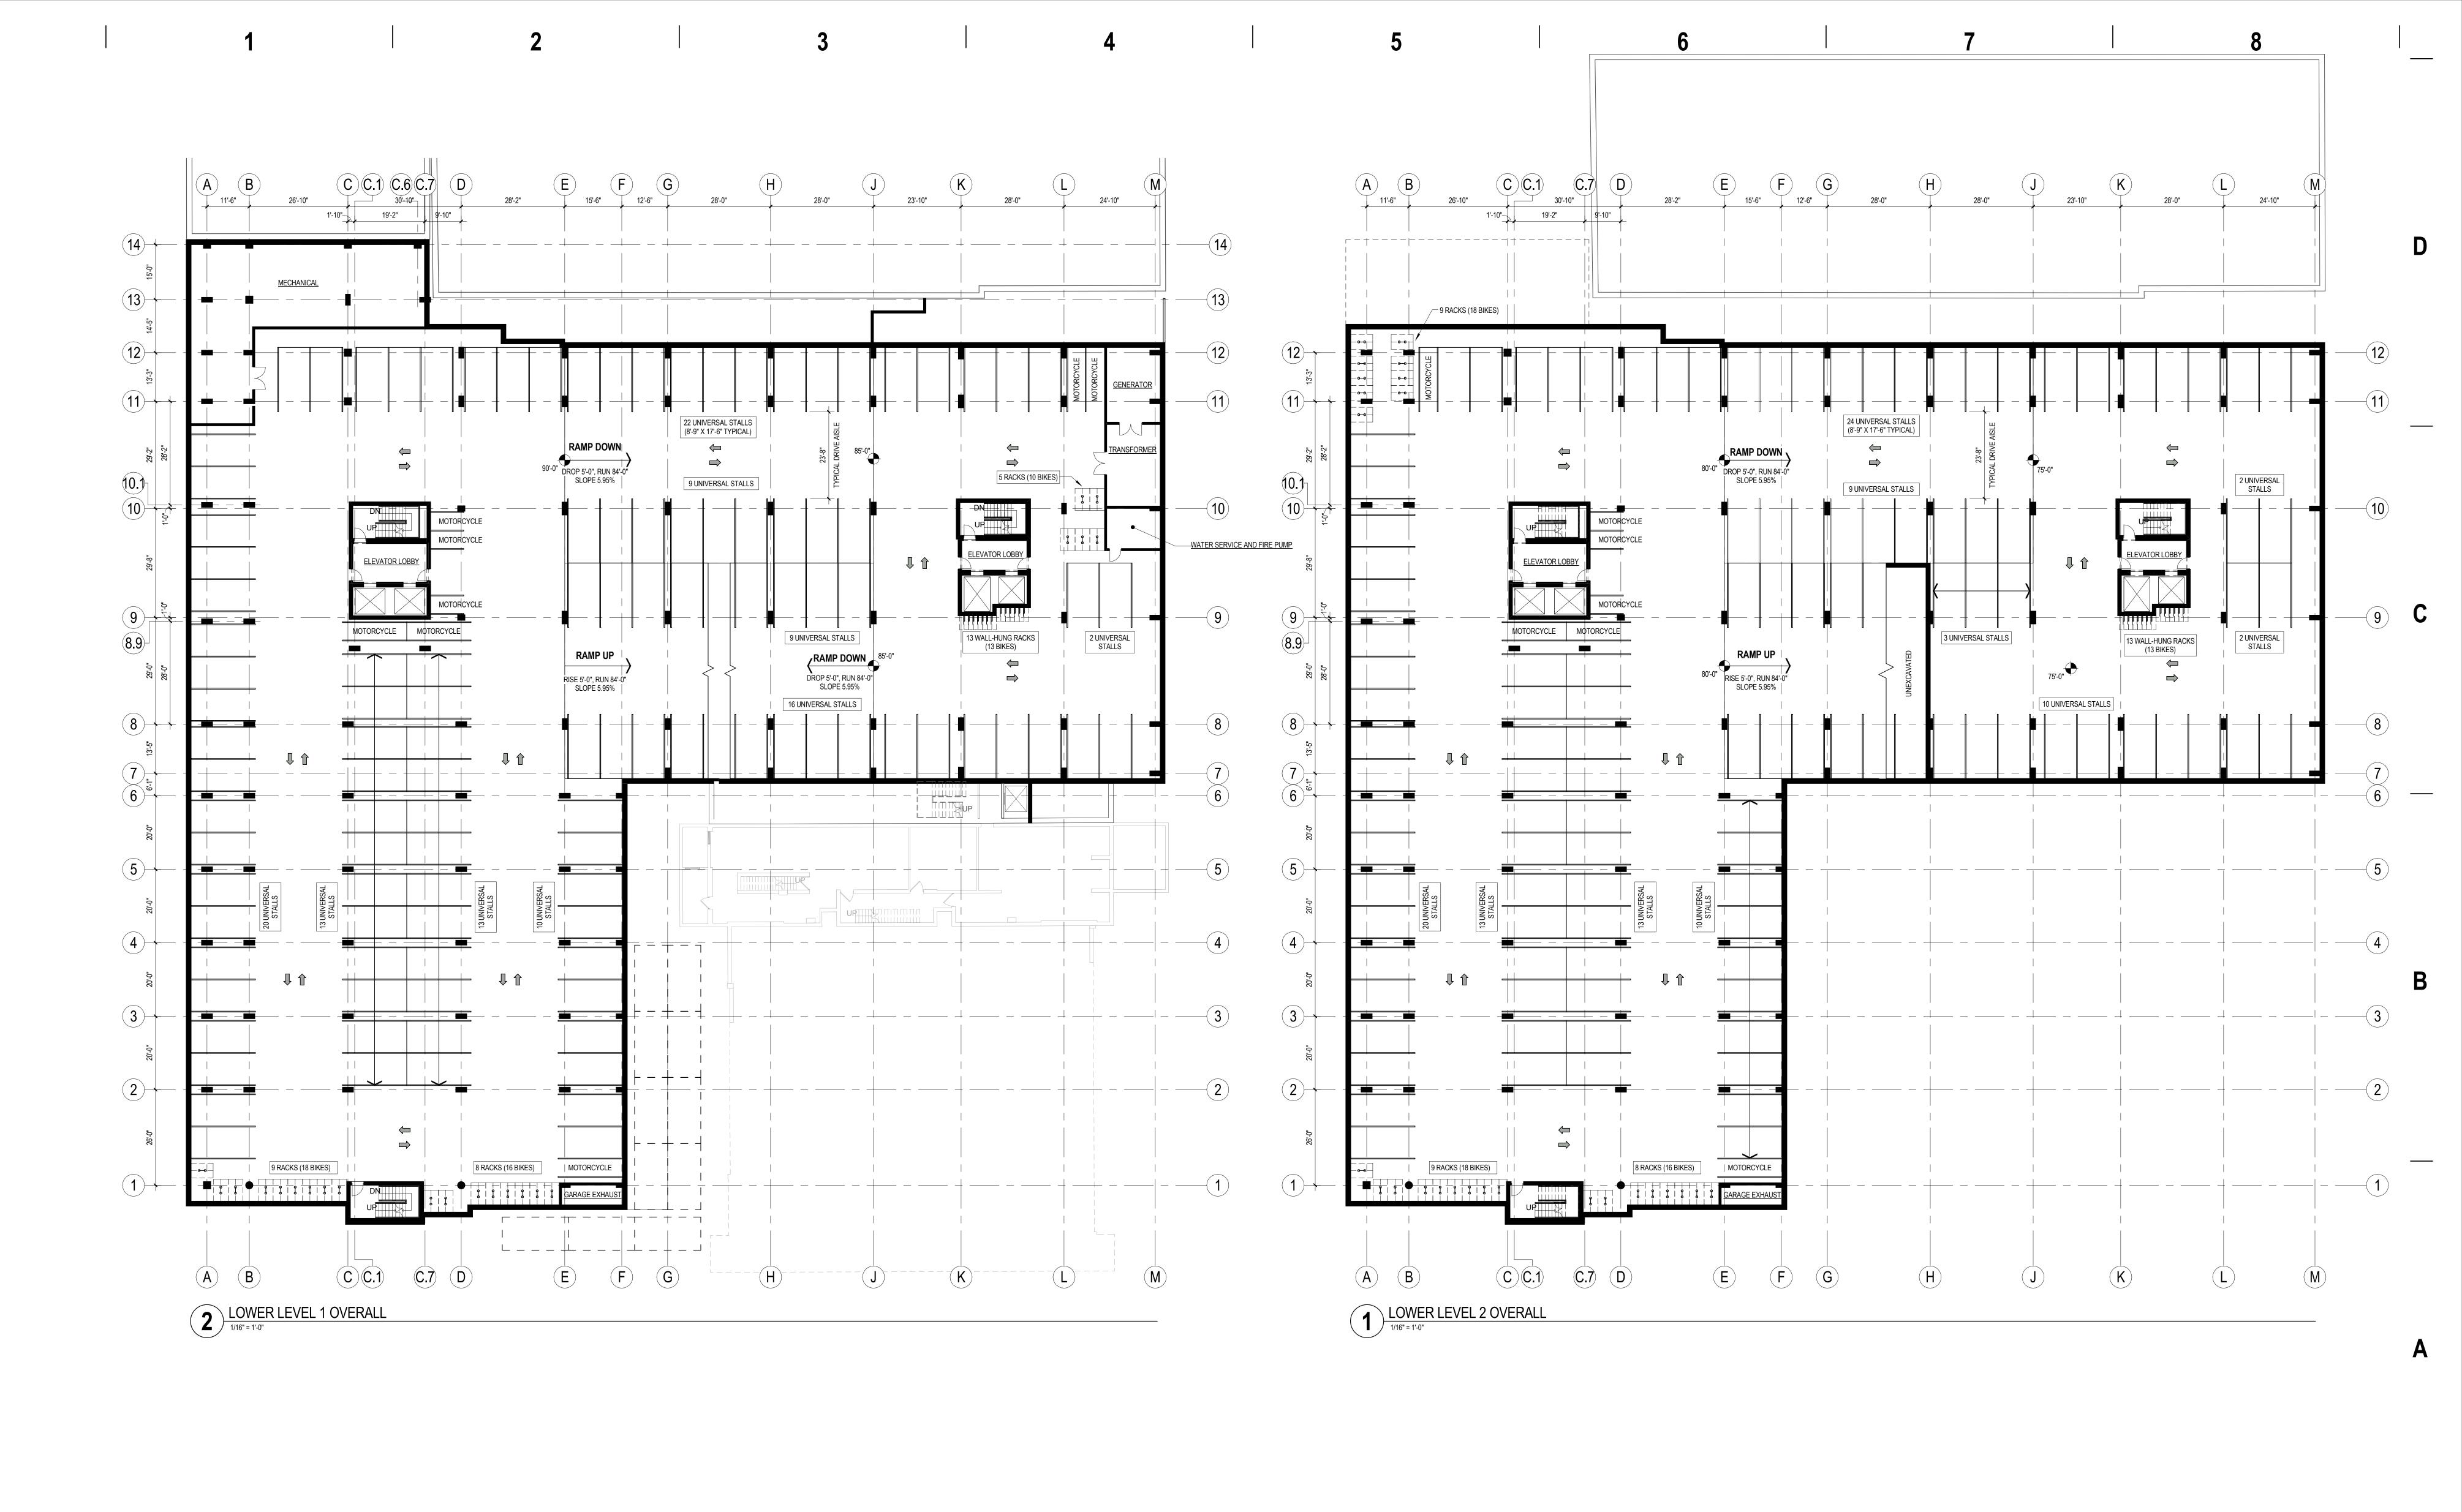
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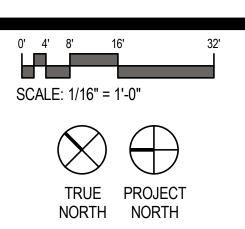
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MADISON, WI




DATE:

SHEET NAME:

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	PARKING - NON-MFD	VEHICLE	ES
Level	Stall Type	Count	Comments
LOWER LEVEL 2	UNIVERSAL	121	
LOWER LEVEL 1	UNIVERSAL	113	
GROUND FLOOR	ACCESSIBLE	4	
GROUND FLOOR	ACCESSIBLE - VAN	3	
GROUND FLOOR	UNIVERSAL	30	
GROUND FLOOR	UNIVERSAL	4	
Grand total		275	
	PARKING - MFD VE	HICLES	
Level	Stall Type	Count	Comments
GROUND FLOOR	STACKED	11	BEHIND STATION #1

Level	Stall Type	Count	Comments	
GROUND FLOOR	STACKED	11	BEHIND STATION #1	
GROUND FLOOR	UNIVERSAL	4		
MEZZANINE LEVEL	STACKED	12		
MEZZANINE LEVEL	UNIVERSAL	21		
Grand total		48		
PARKING - MOPEDS & MOTORCYCLES				
LEVEL	STALL TYPE	COUNT	Comments	

STALL TYPE	COUNT	Comments			
MOTORCYCLE	7				
MOTORCYCLE	8				
-	· · · · ·				
MOPED	27				
MOTORCYCLE	3				
•	45				
	STALL TYPE MOTORCYCLE MOTORCYCLE MOPED	STALL TYPECOUNTMOTORCYCLE7MOTORCYCLE8MOPED27MOTORCYCLE3			

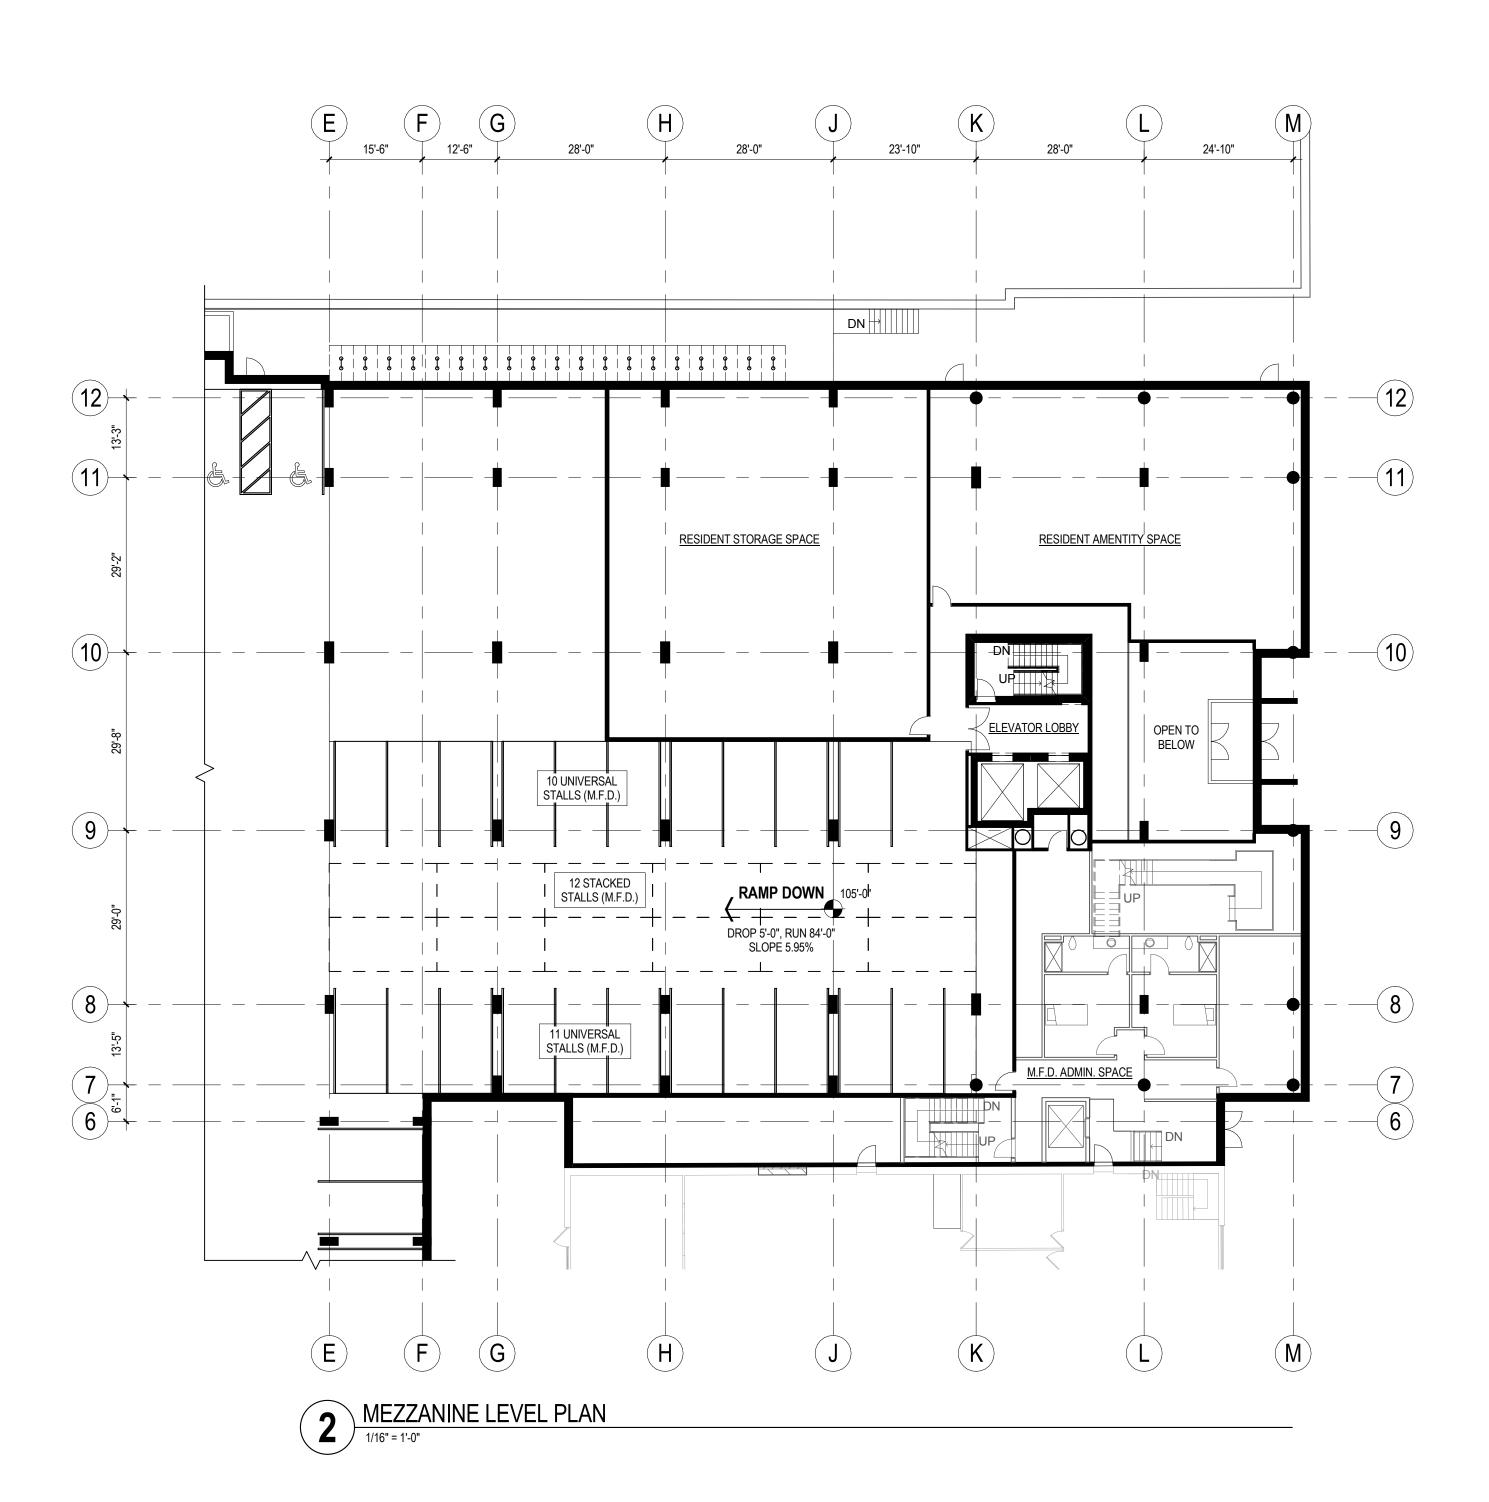KEY PLAN




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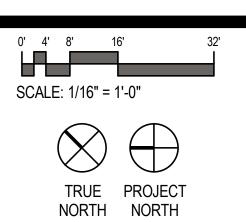
	PARKING - BICYCLES		
LEVEL	RACK TYPE	NUMBER OF RACKS	TOTAL BIKES
LOWER LEVEL 2	DOUBLE BIKE - FLOOR MOUNT	26	52
LOWER LEVEL 2	SINGLE BIKE - WALL MOUNT	13	13
LOWER LEVEL 1	DOUBLE BIKE - FLOOR MOUNT	22	44
LOWER LEVEL 1	SINGLE BIKE - WALL MOUNT	13	13
GROUND FLOOR	DOUBLE BIKE - FLOOR MOUNT	19	38
Grand total		93	160



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ISSUANCE AND REVISIONS



APPROVAL SET # DATE DESCRIPTION
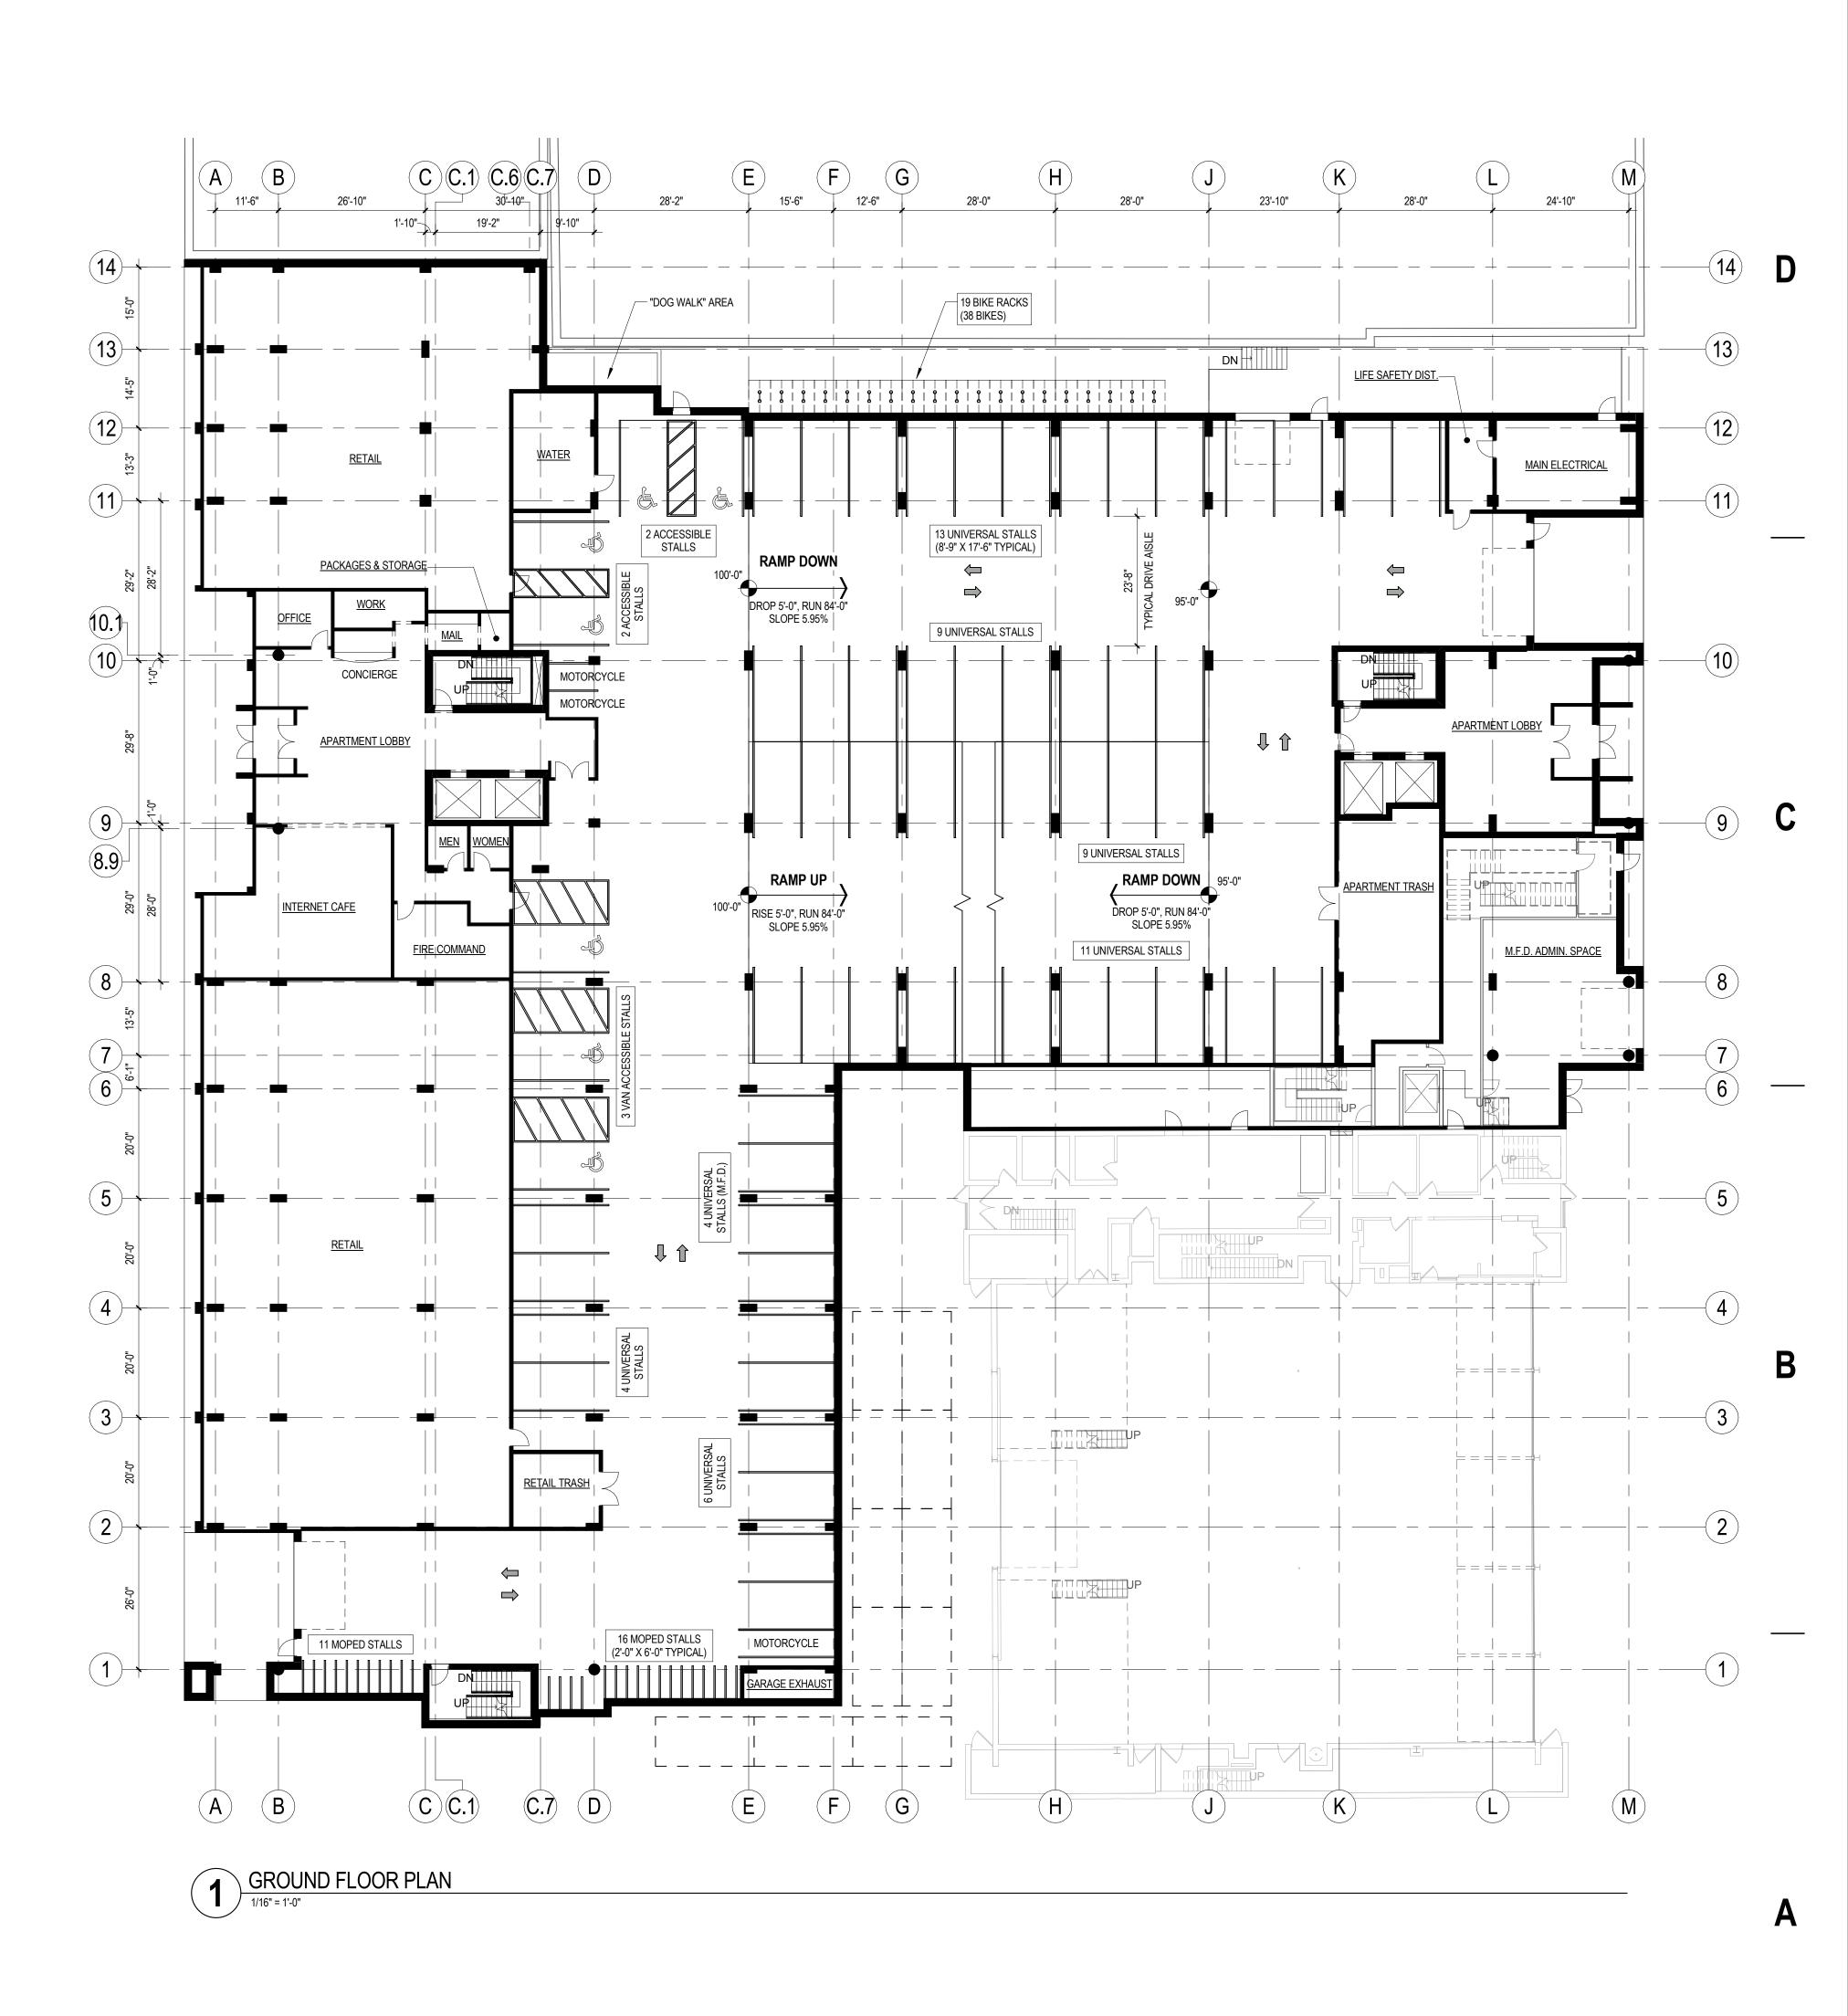
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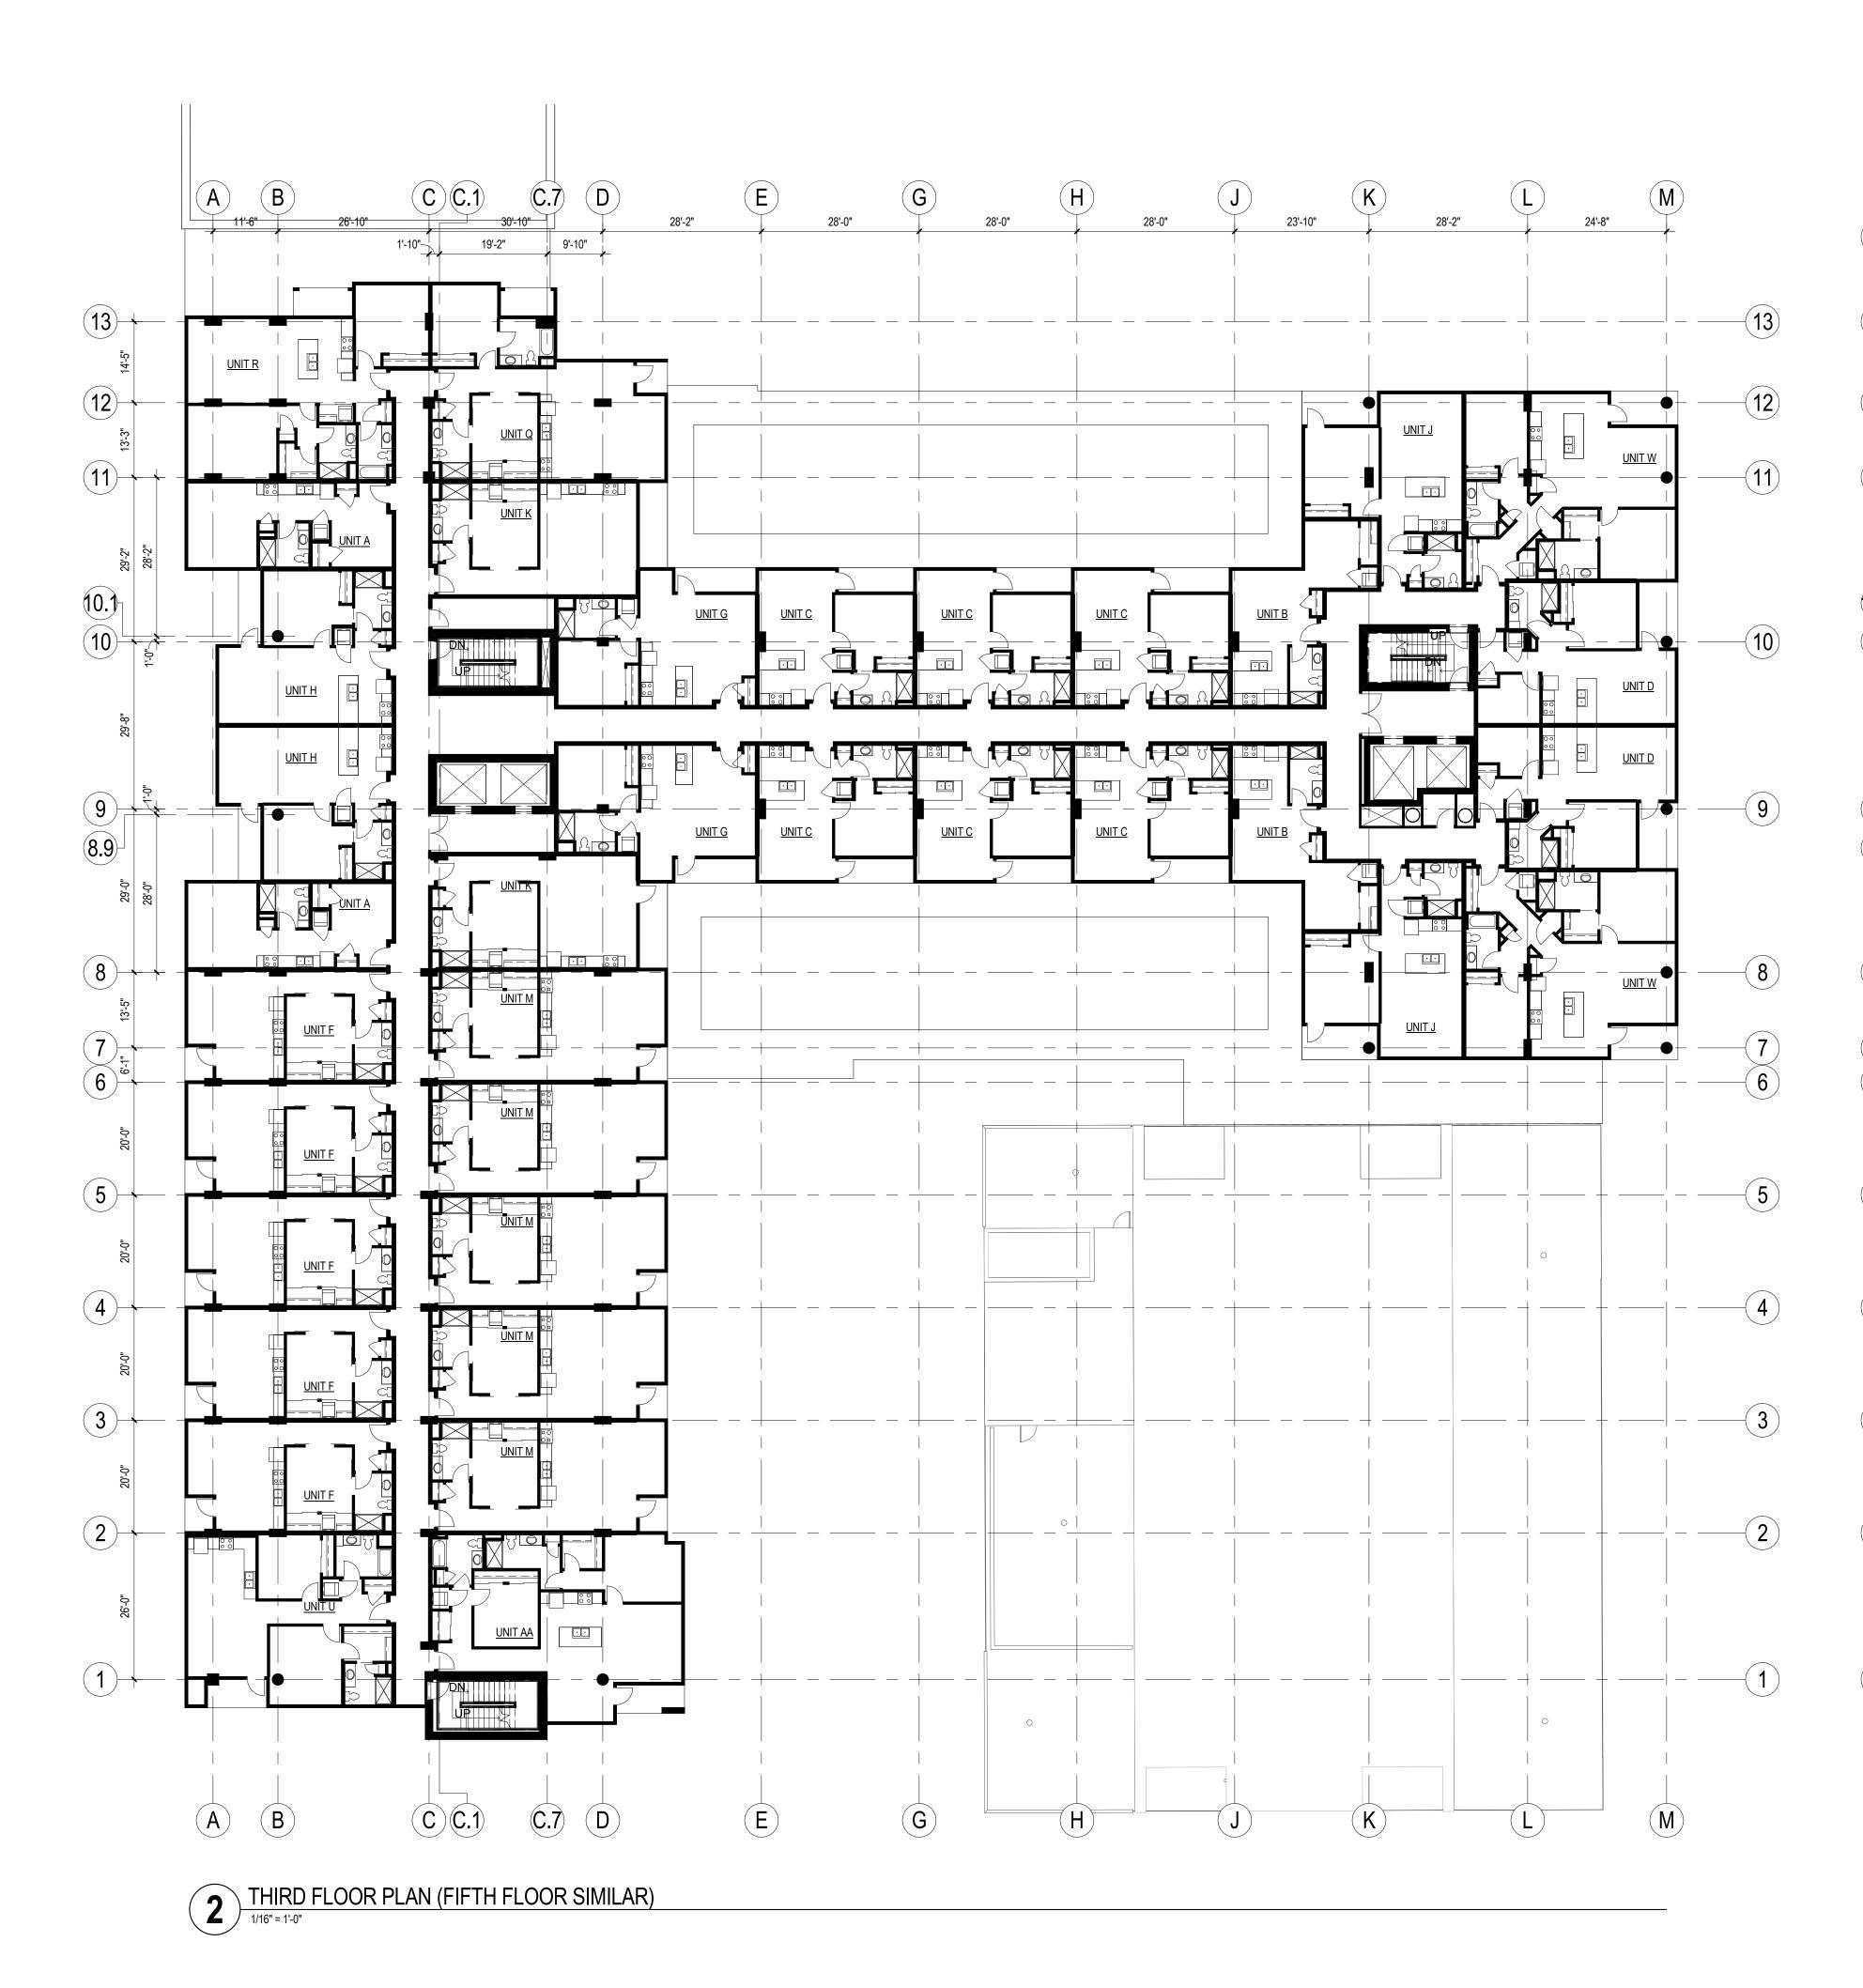
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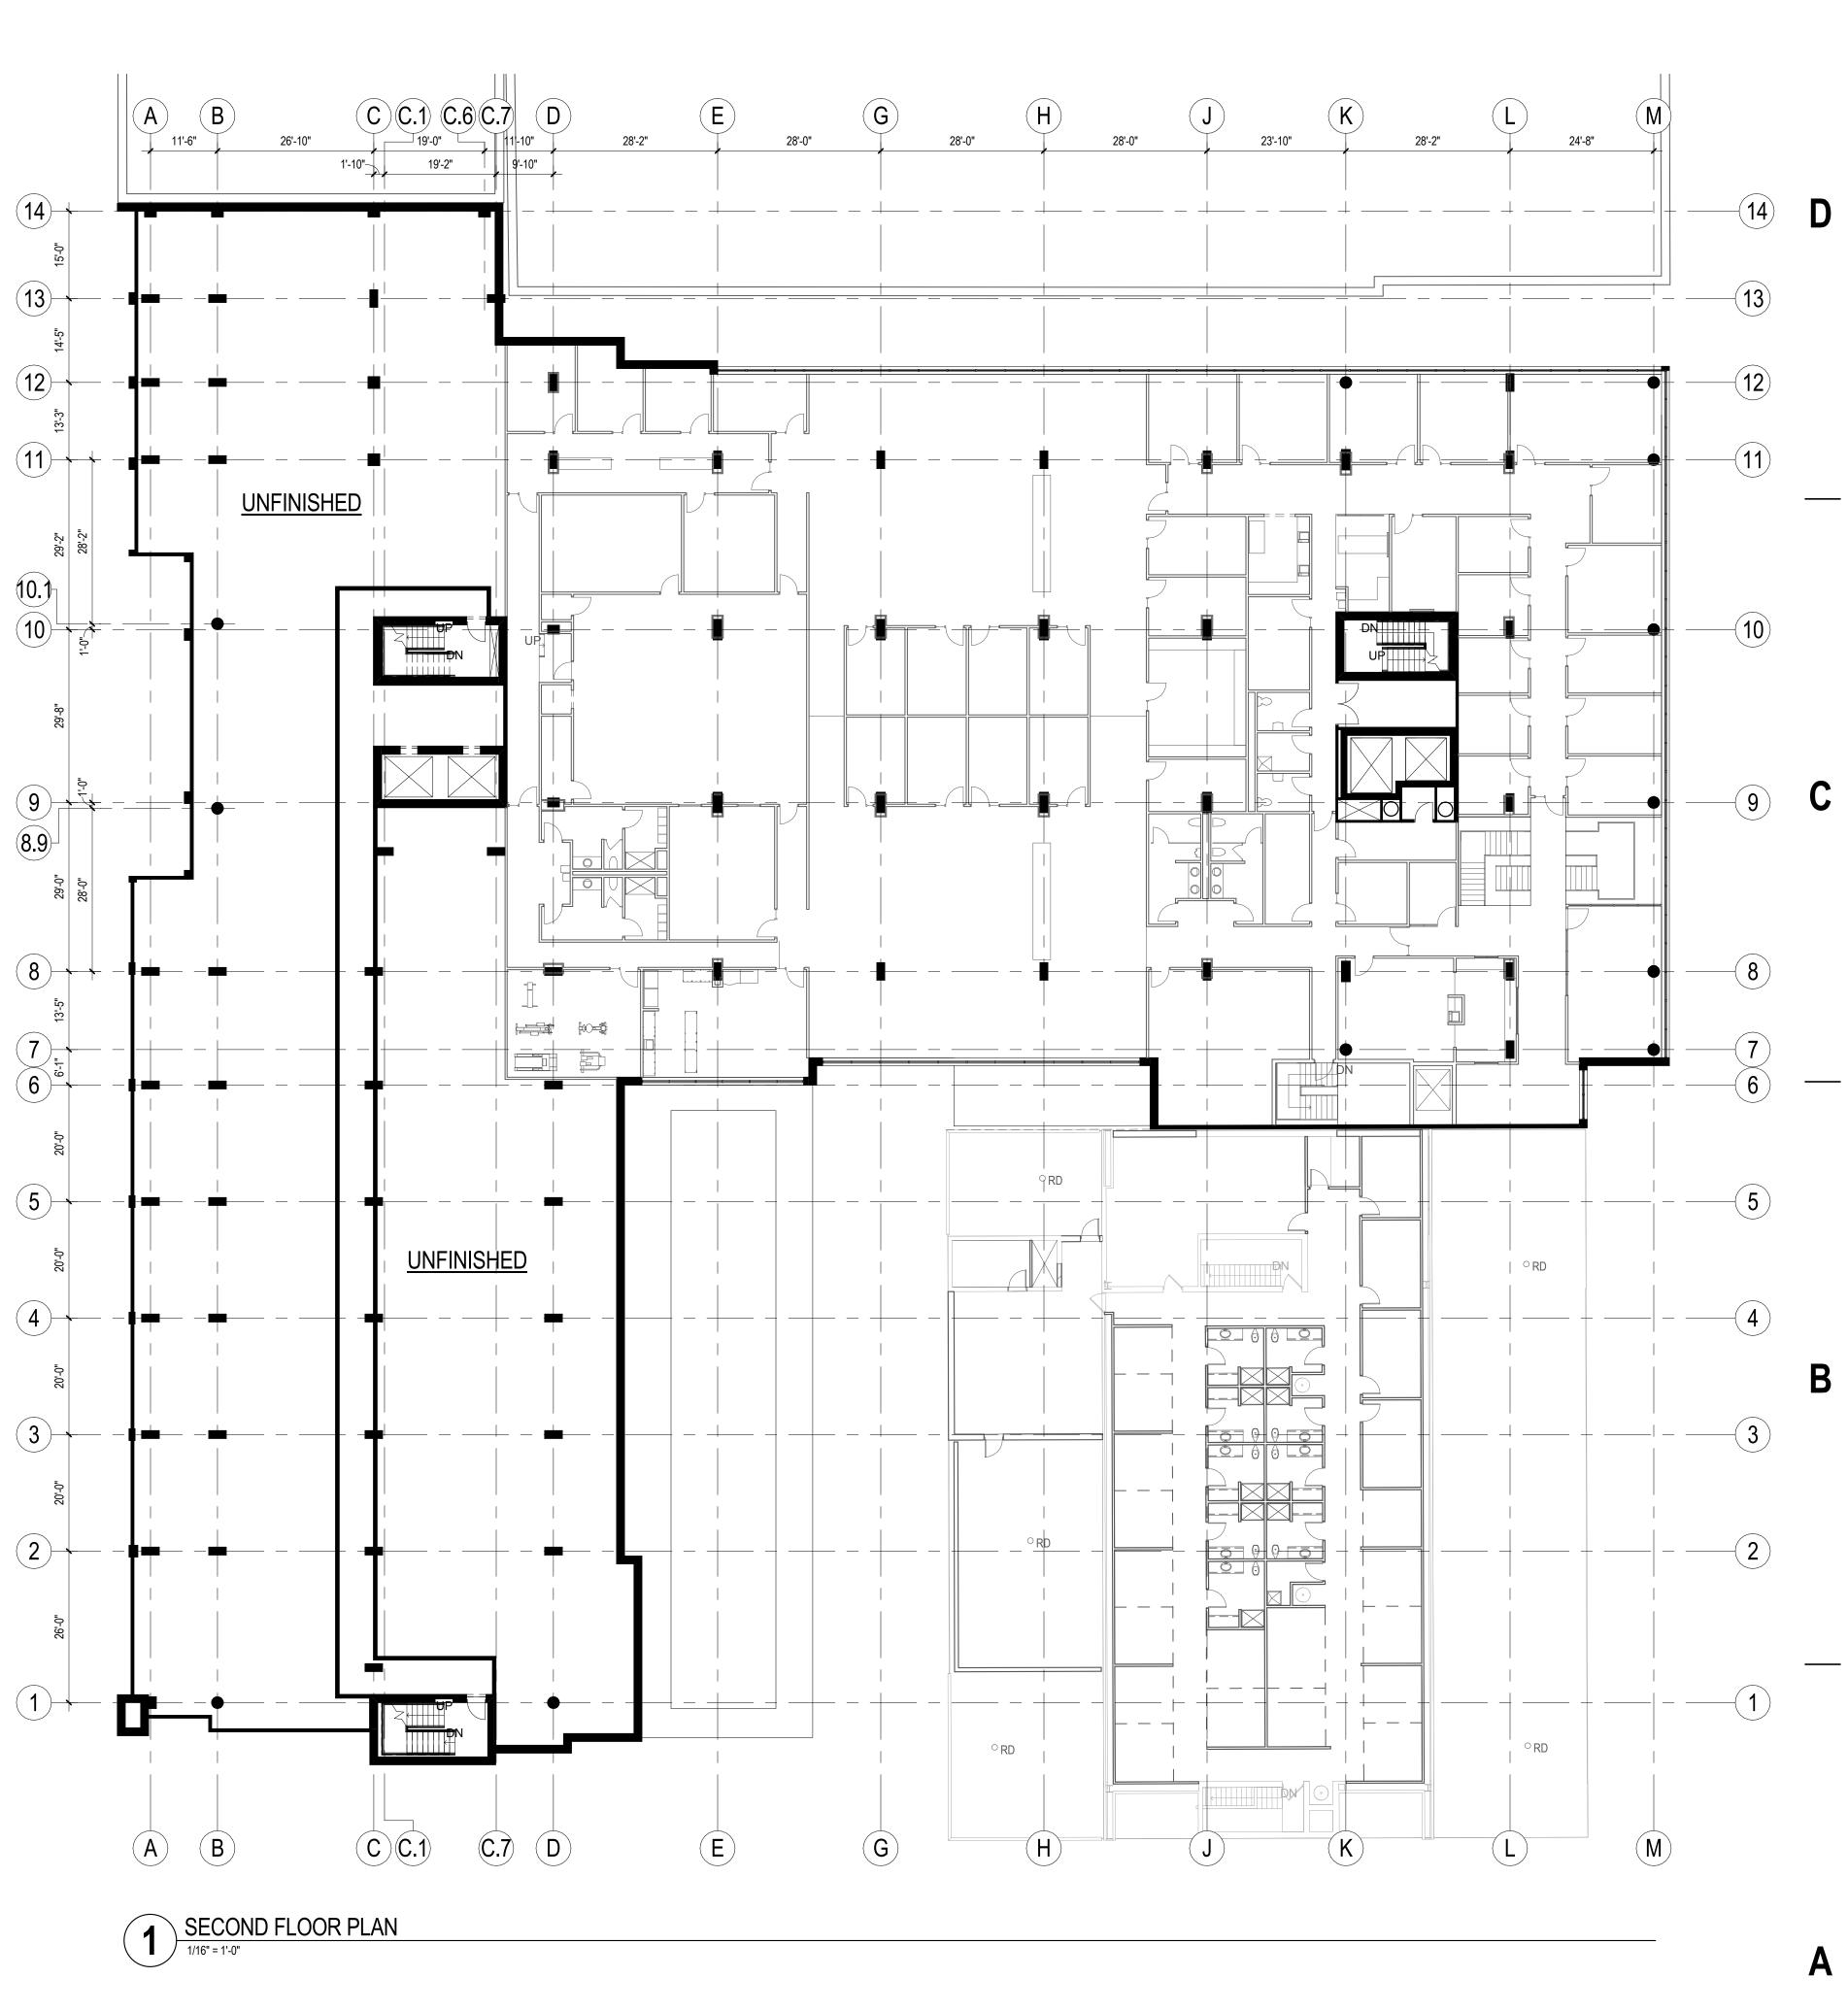
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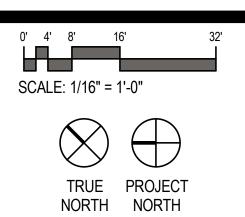
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ISSUANCE AND REVISIONS



APPROVAL SET # DATE DESCRIPTION

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PROGRESS DOCUMENTS

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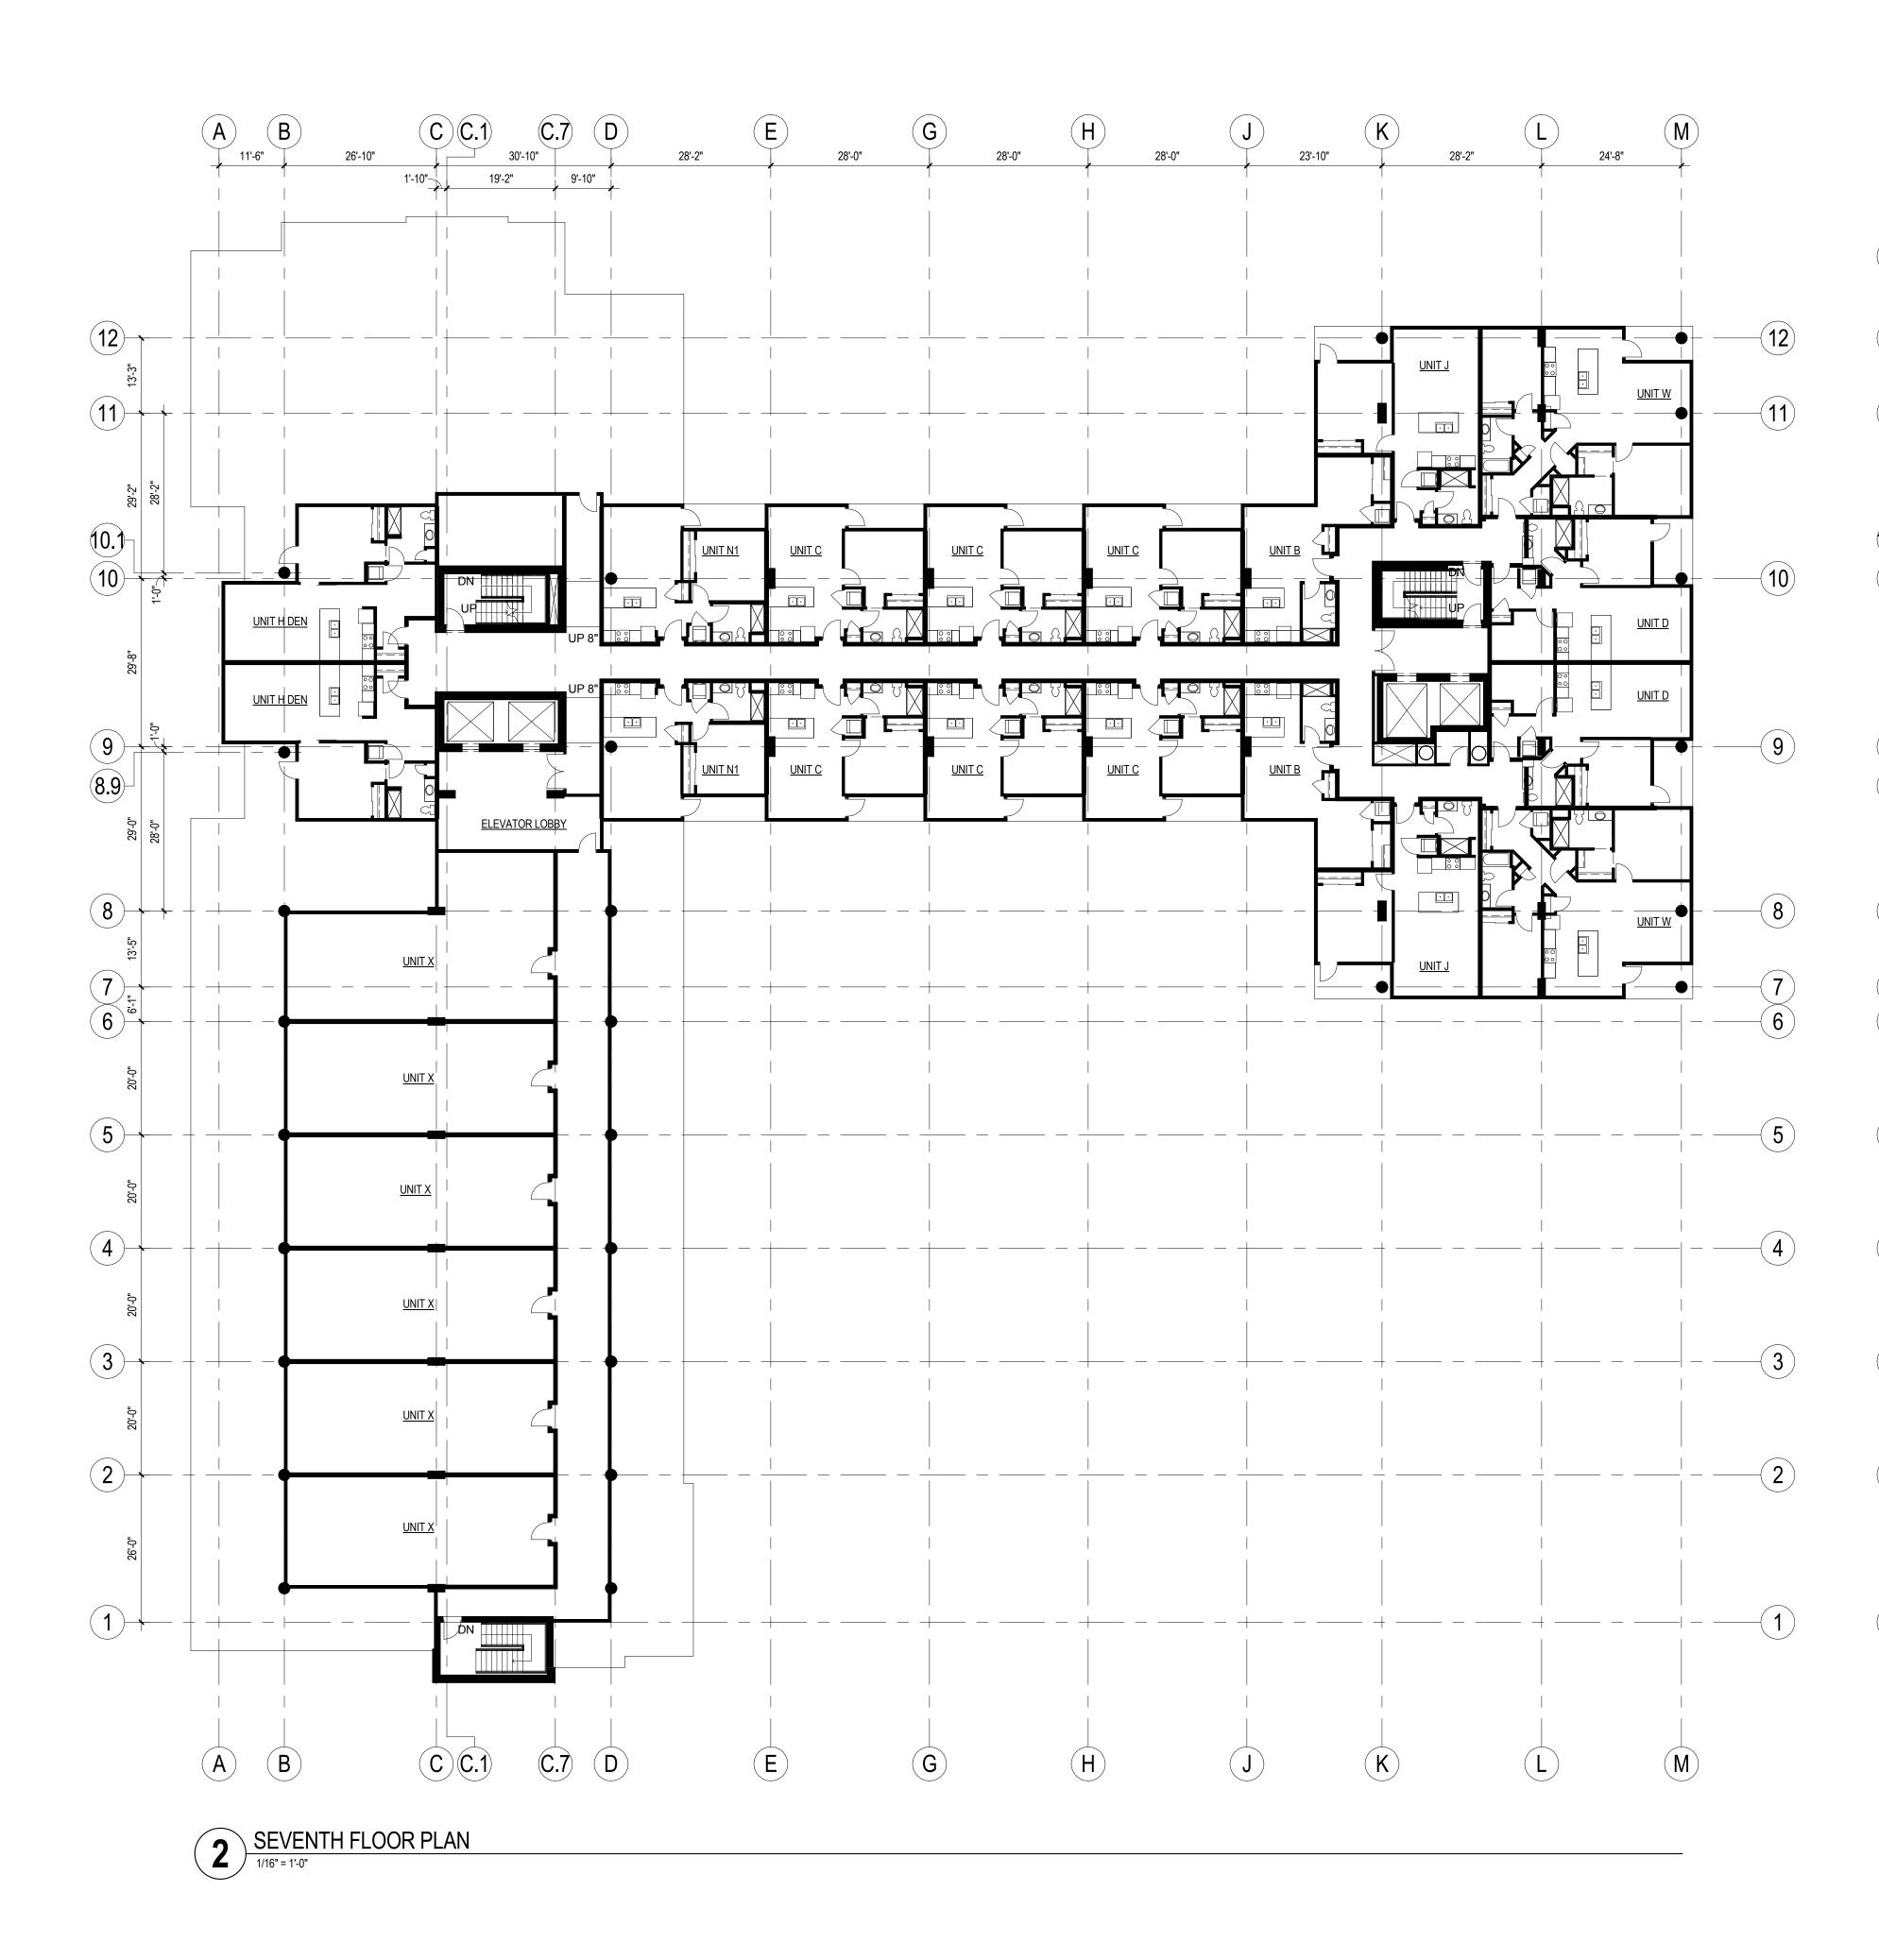
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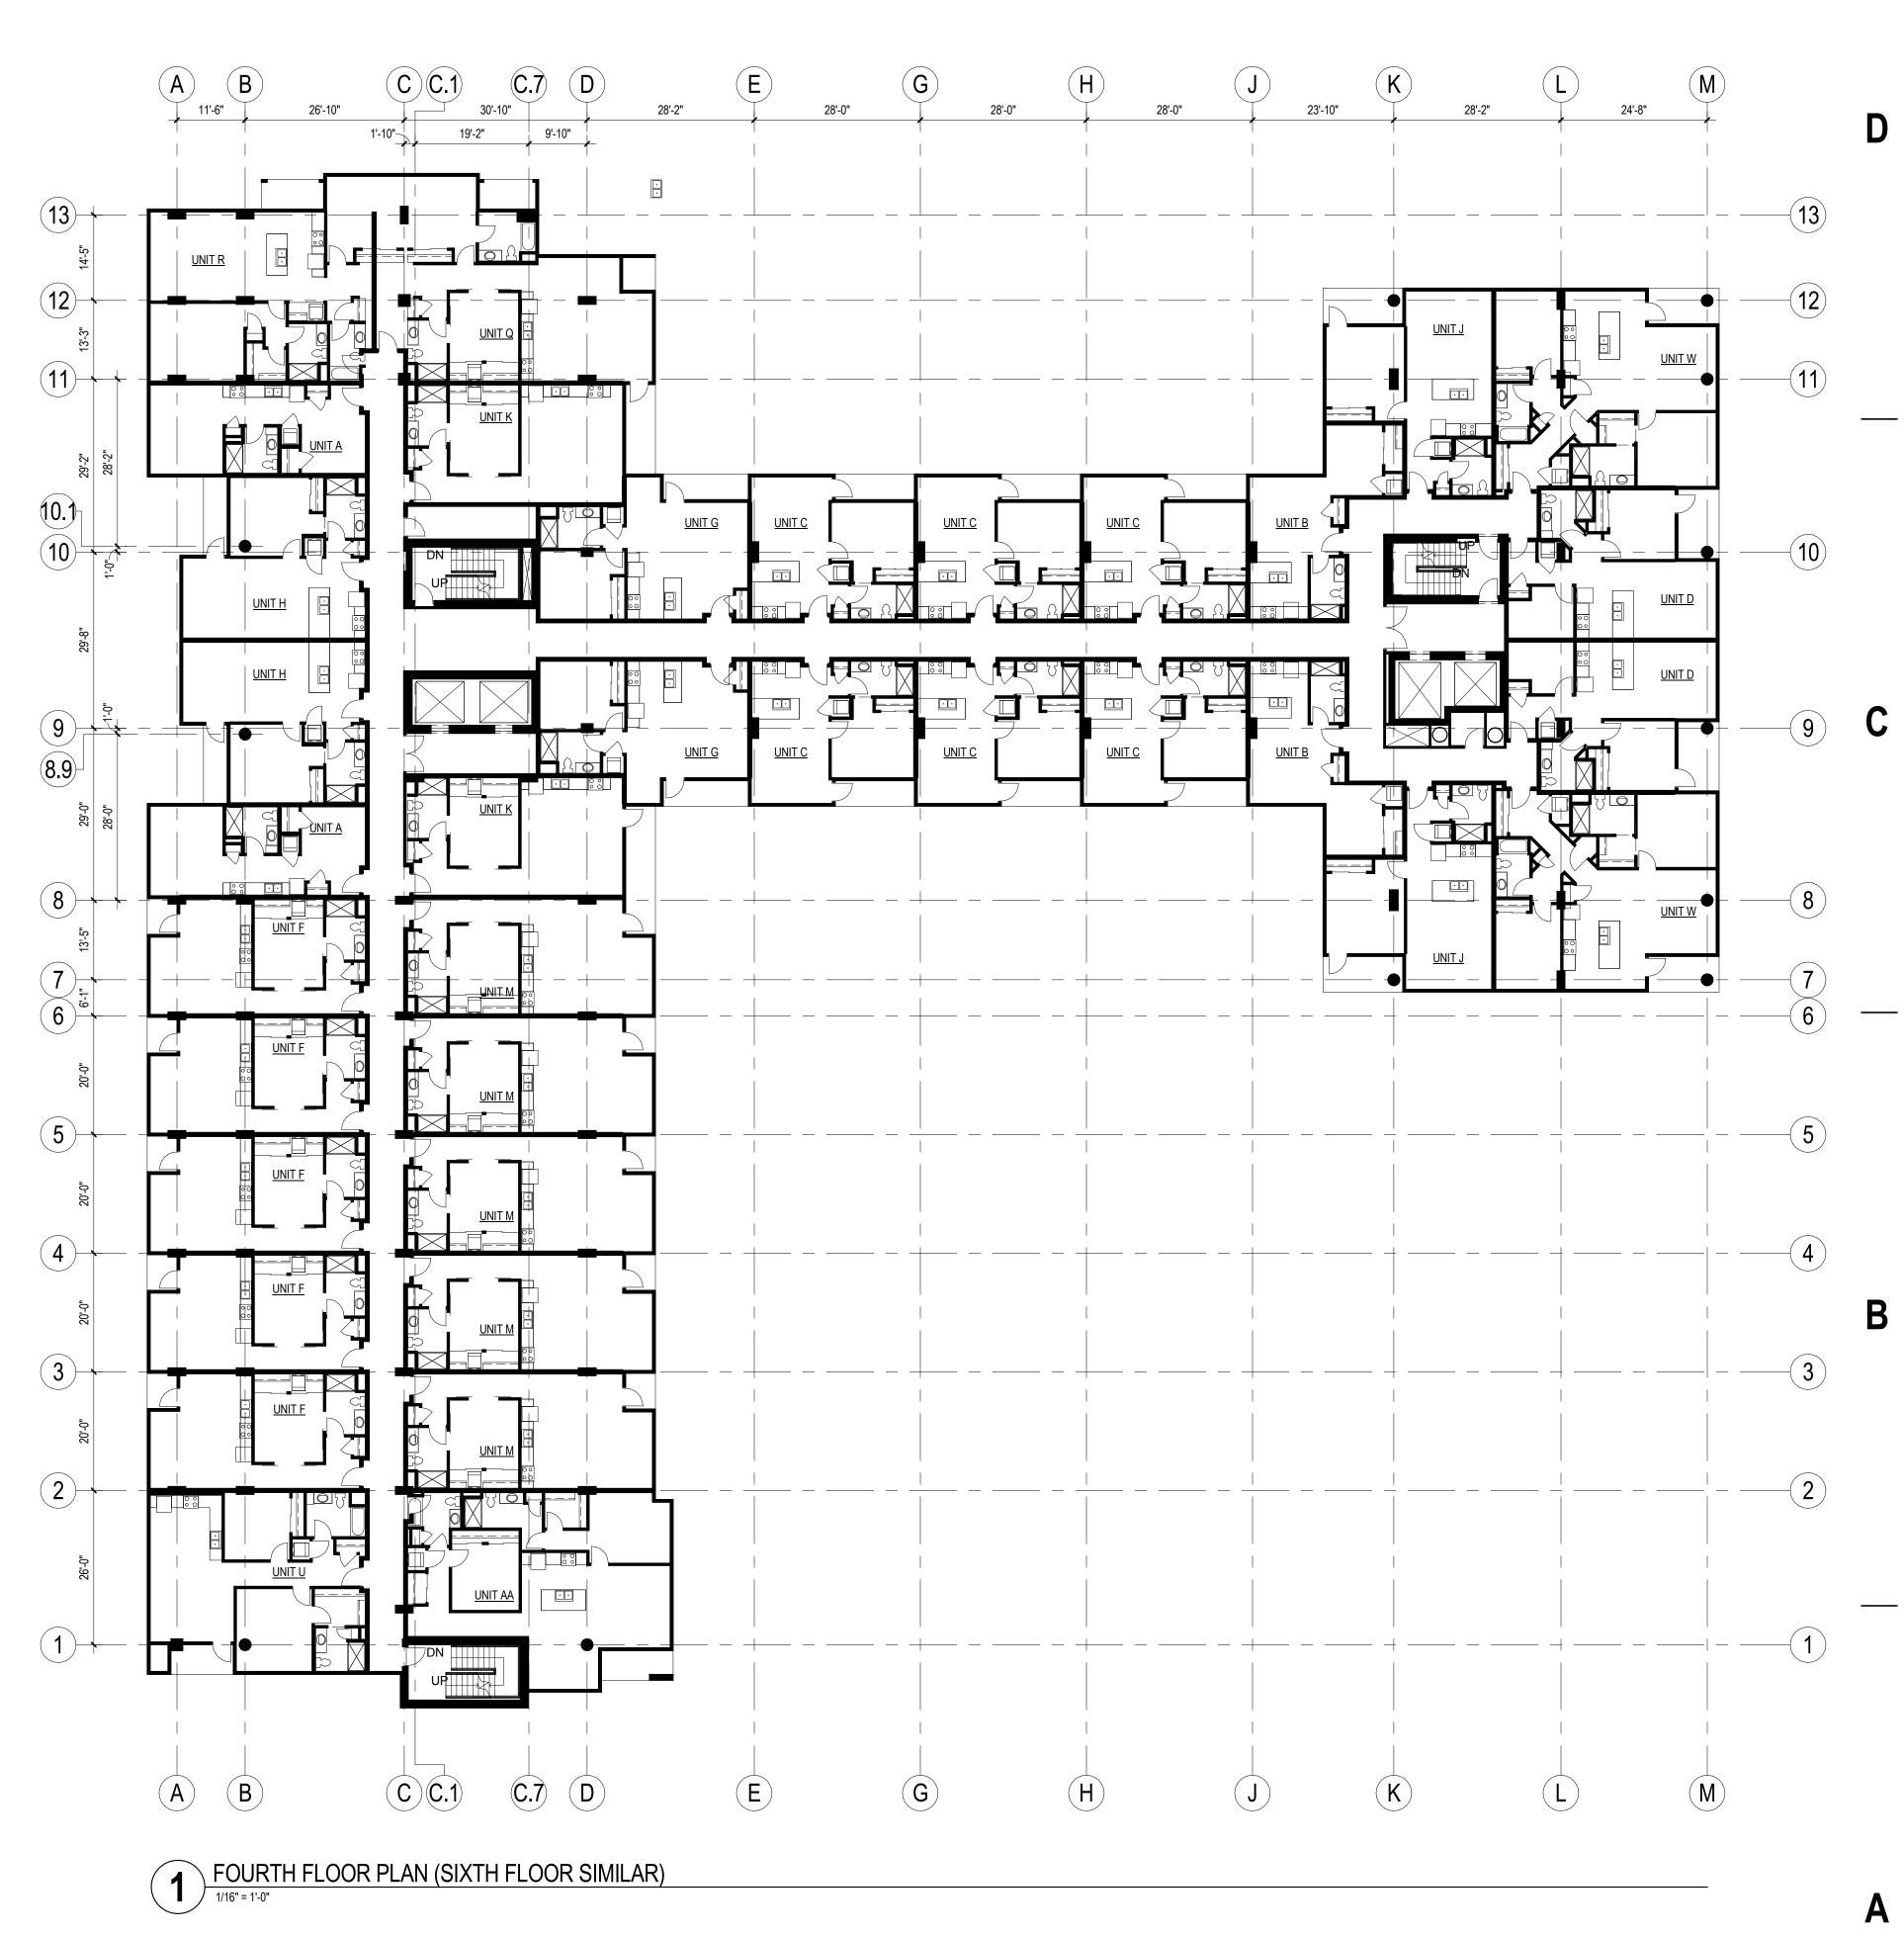
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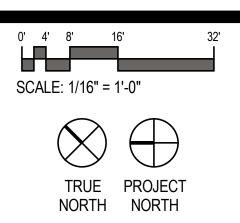
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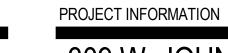
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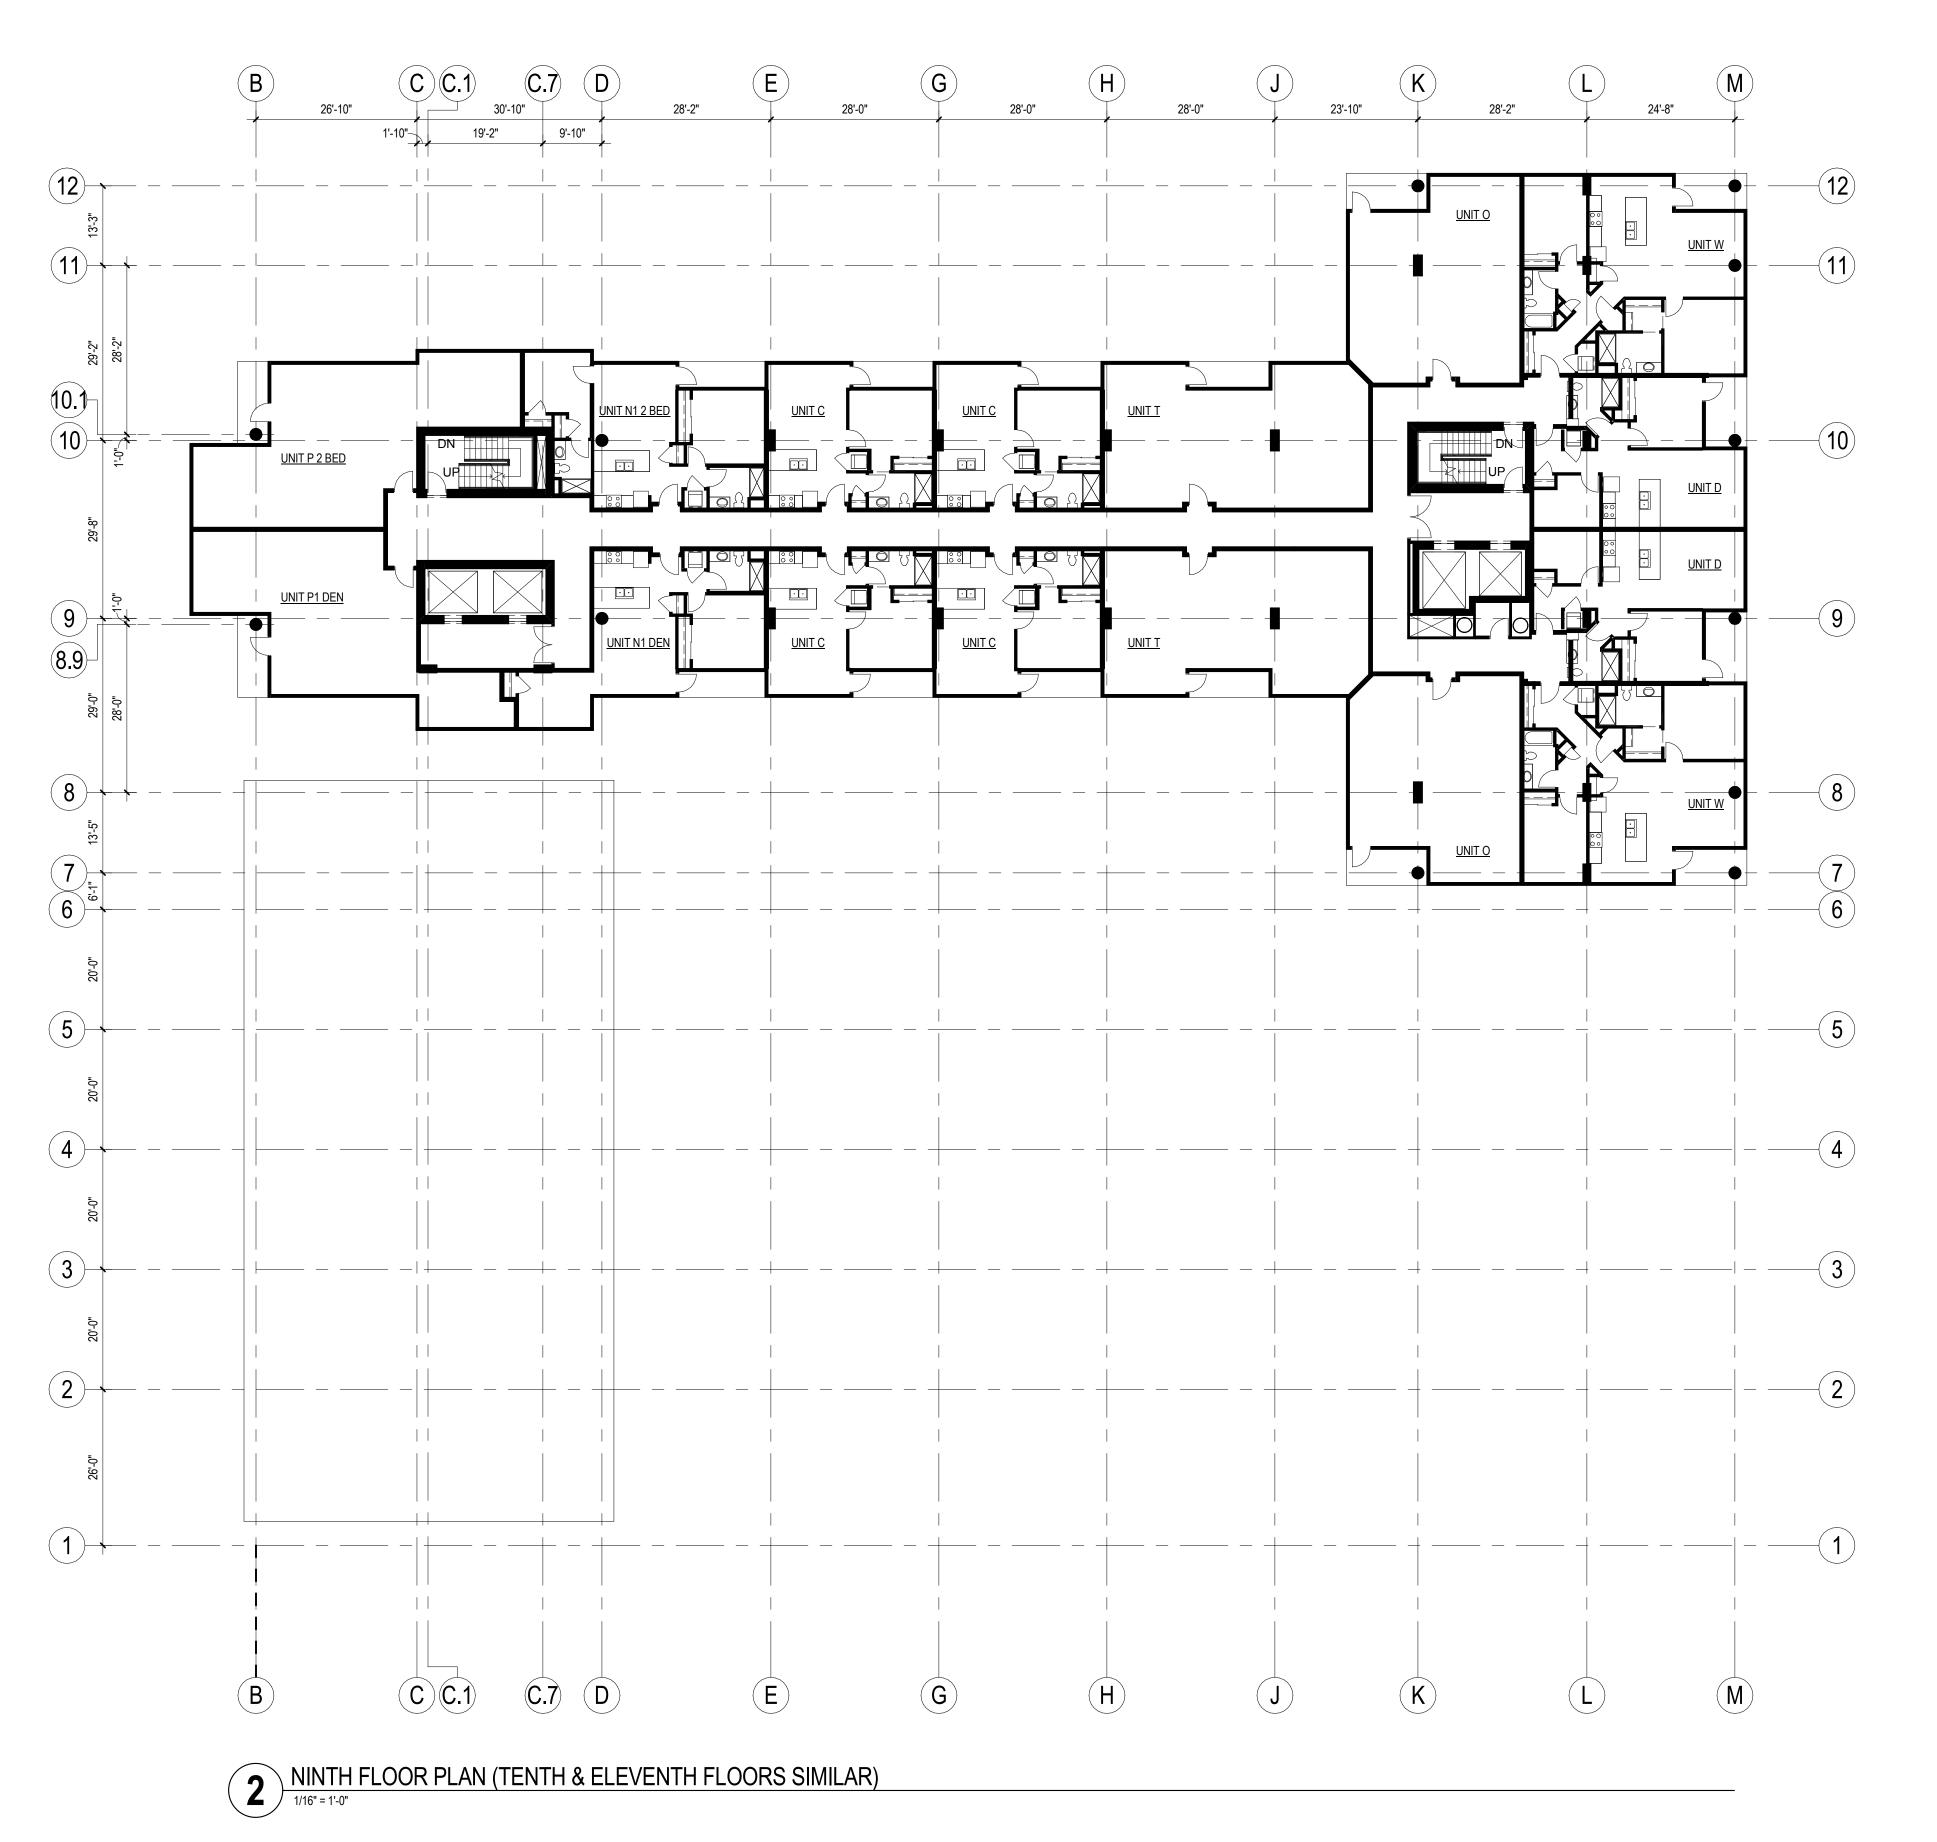
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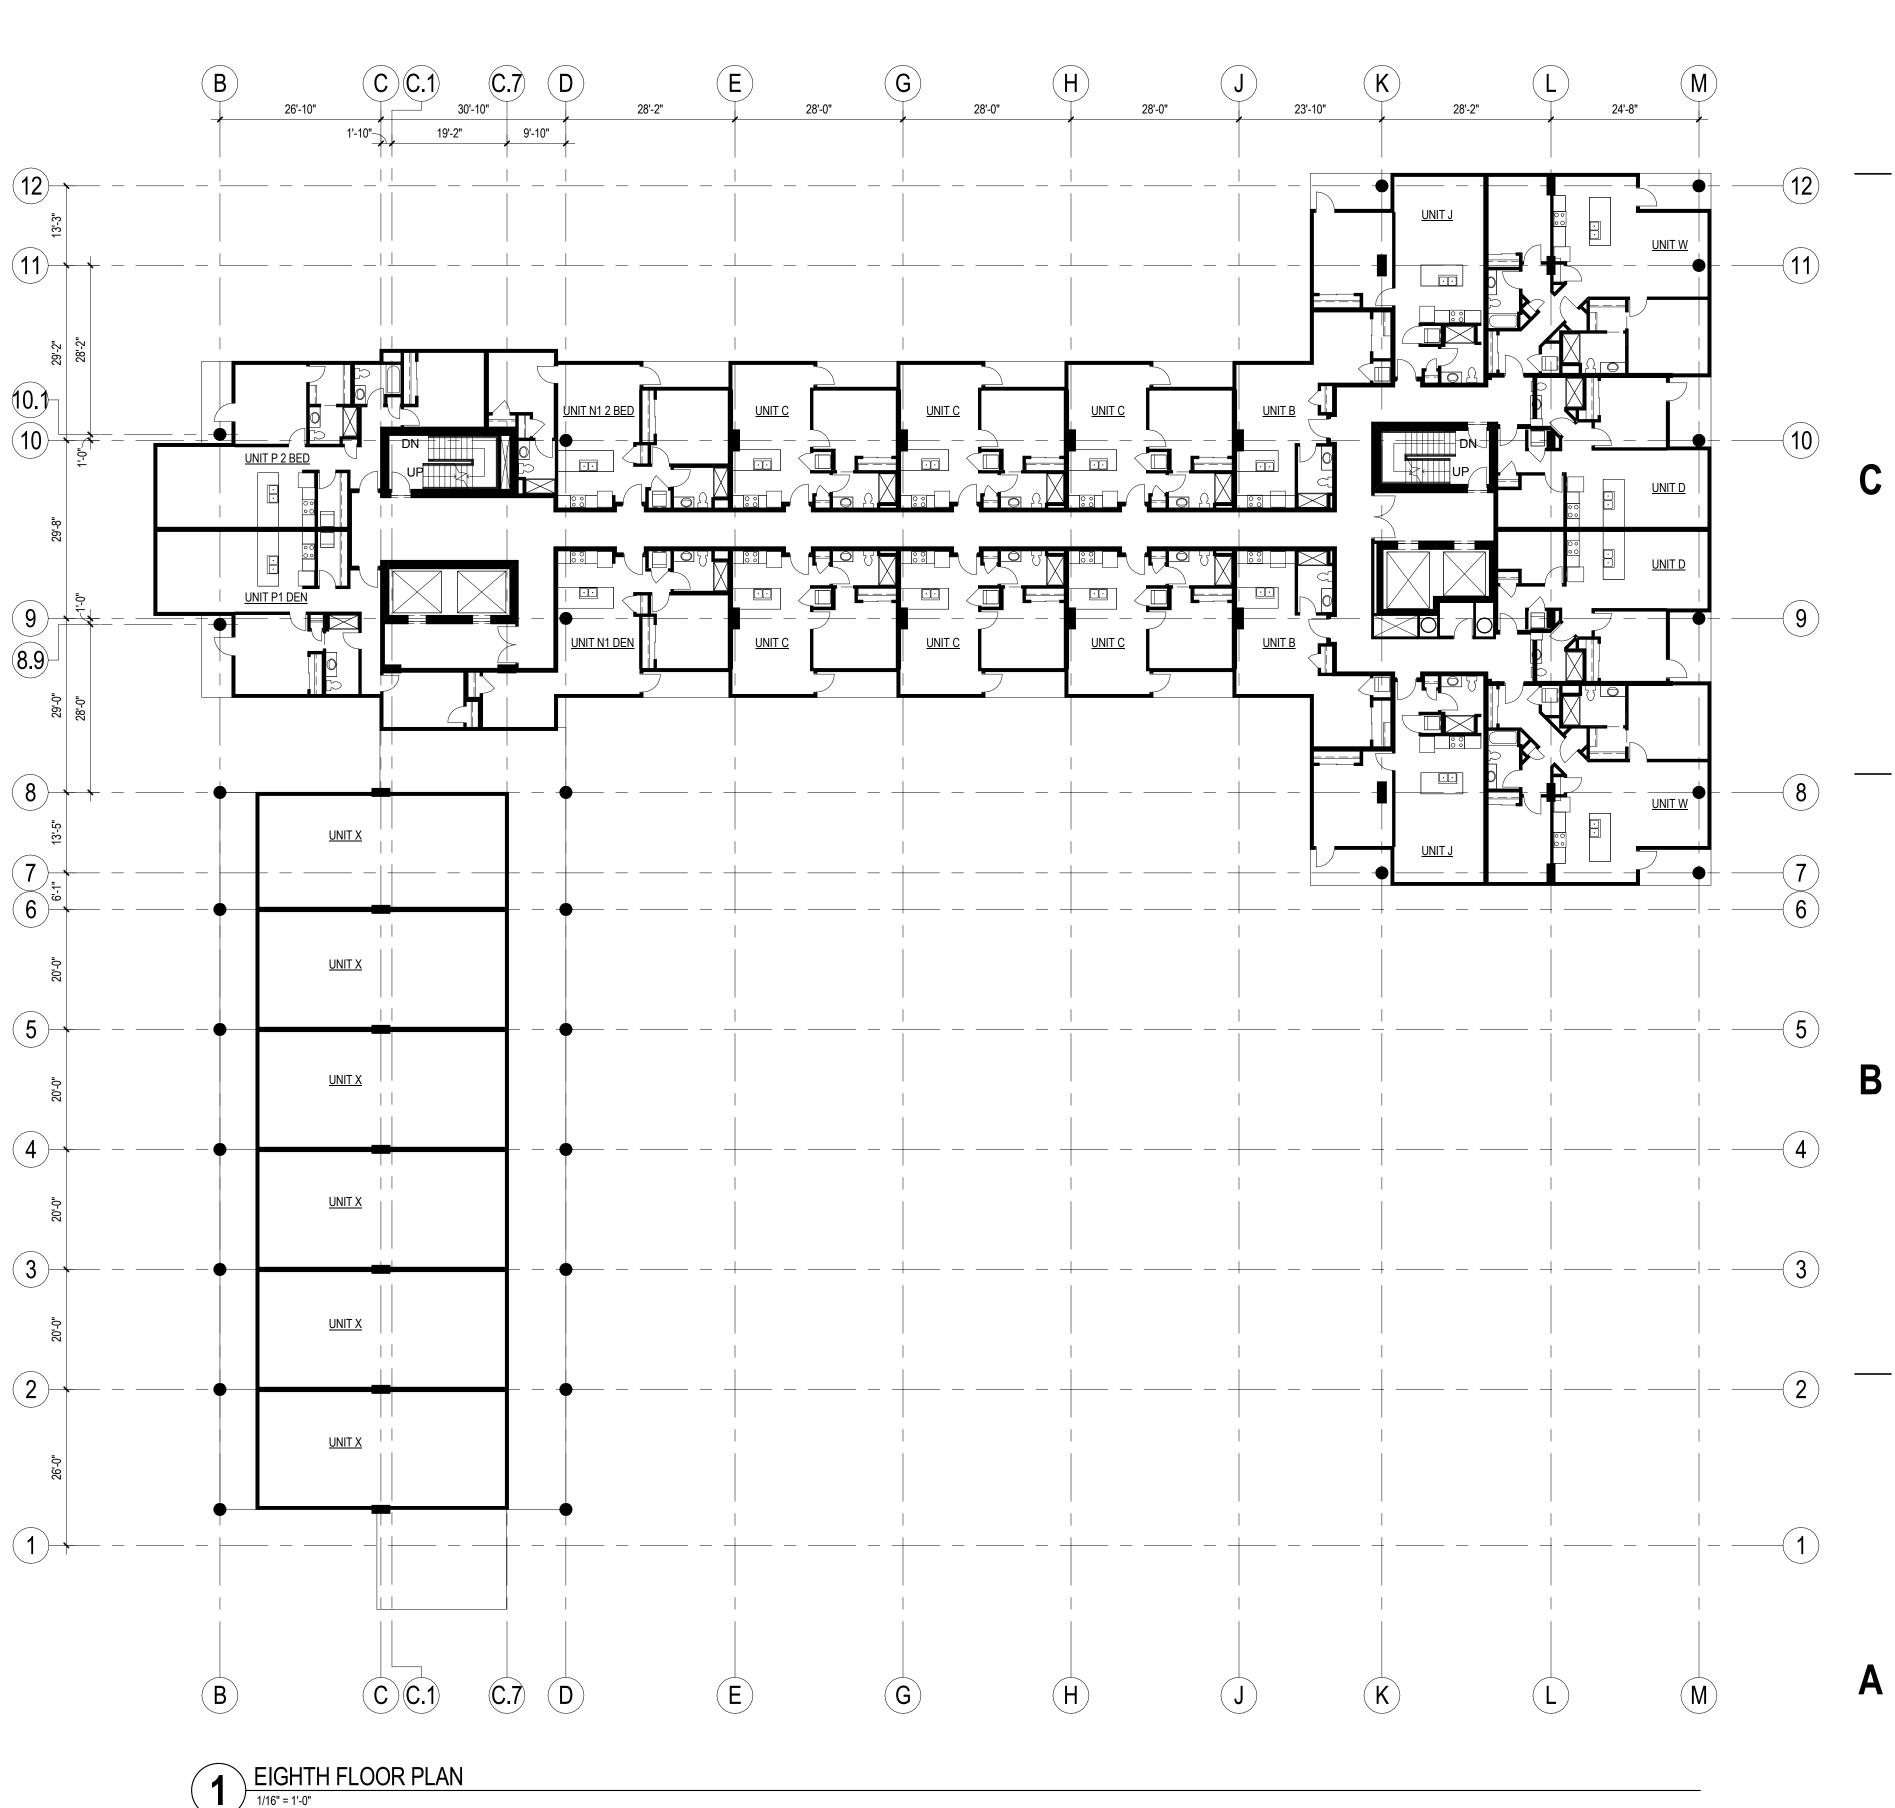


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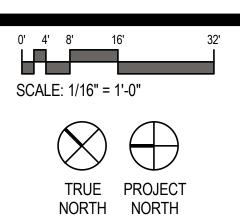
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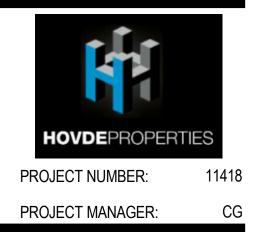
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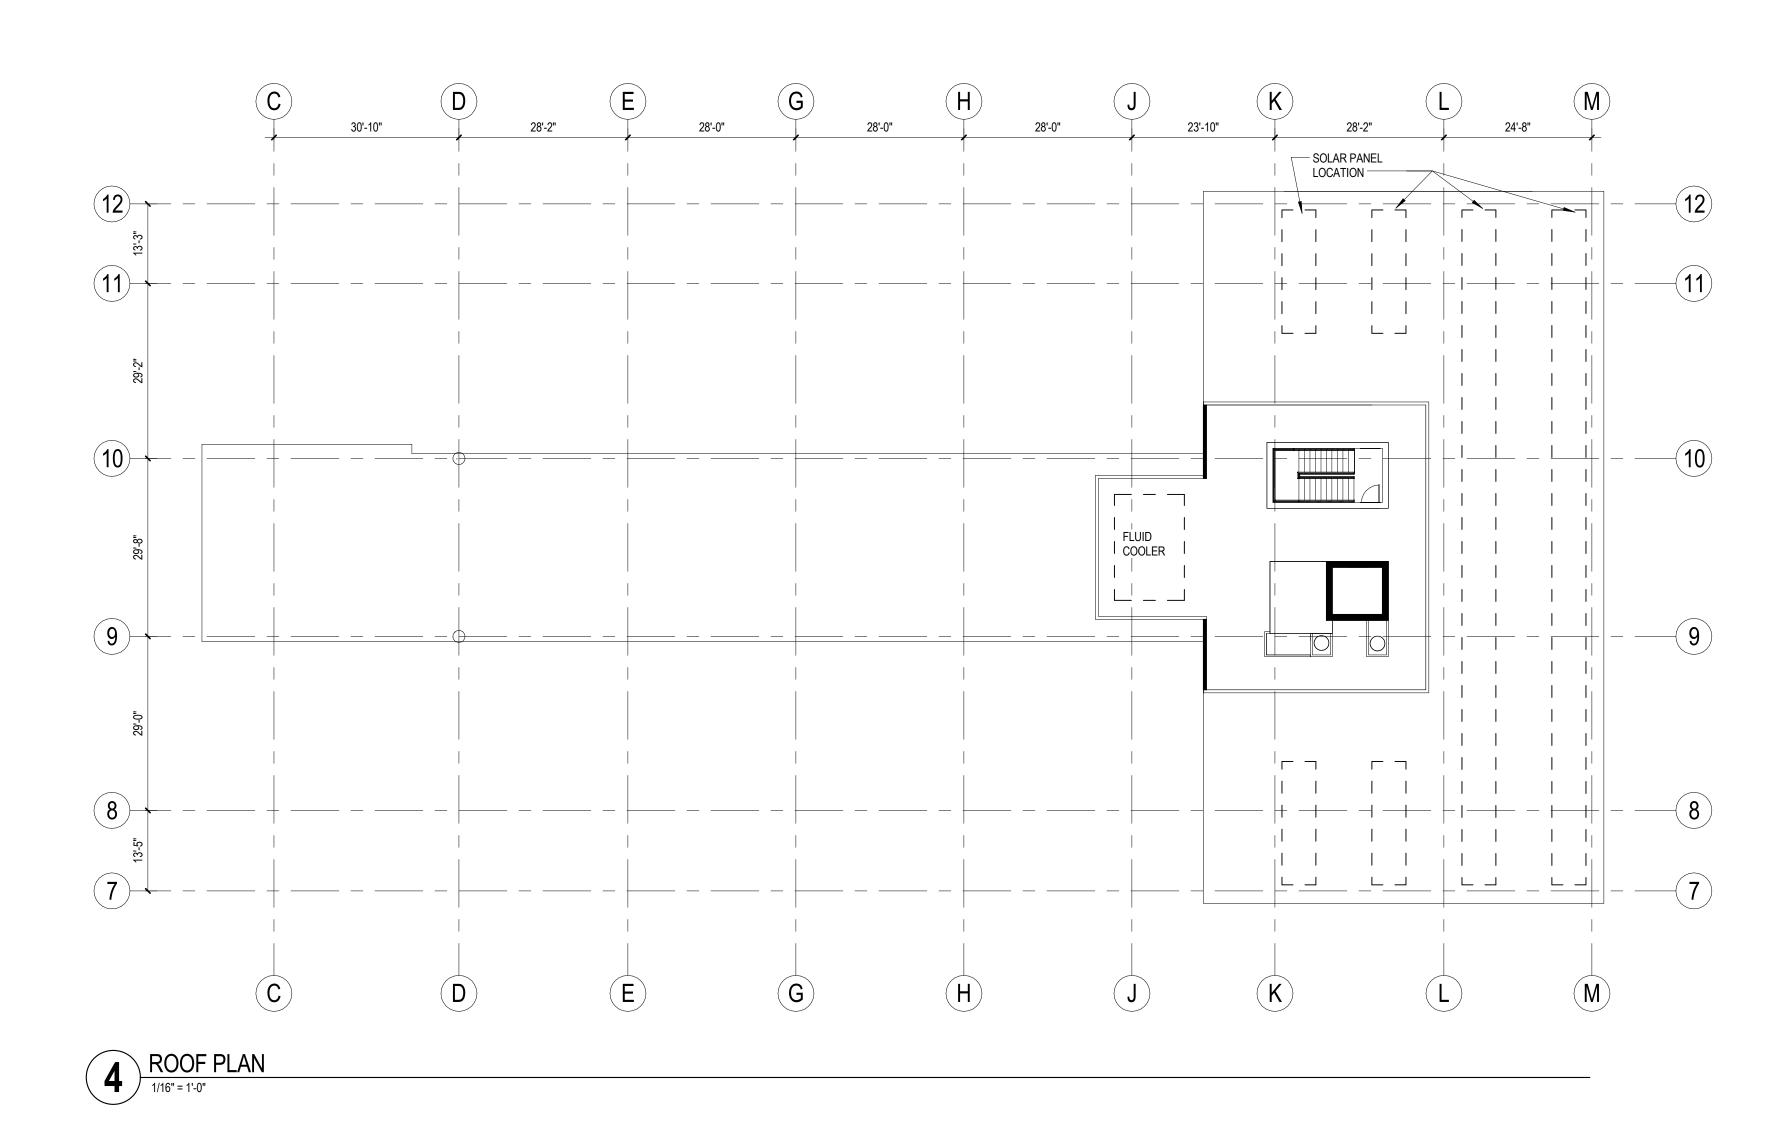
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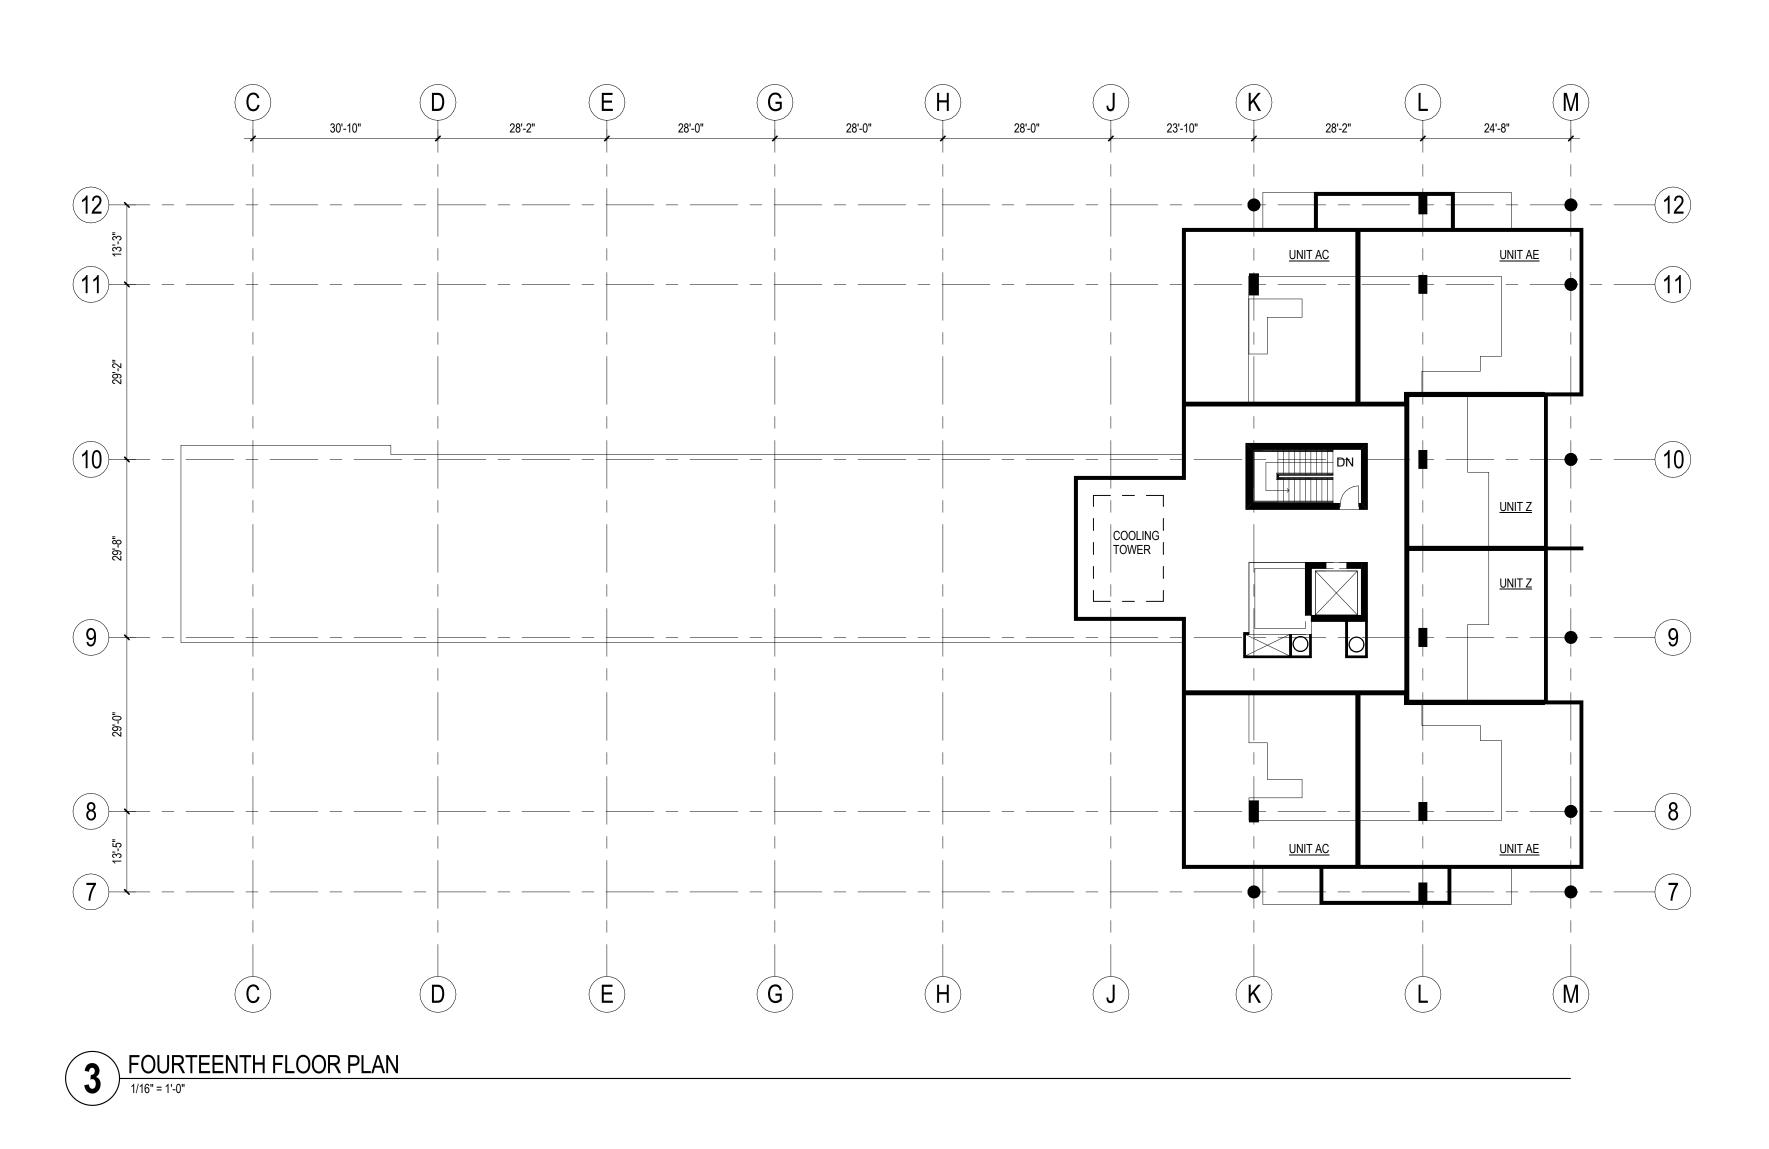
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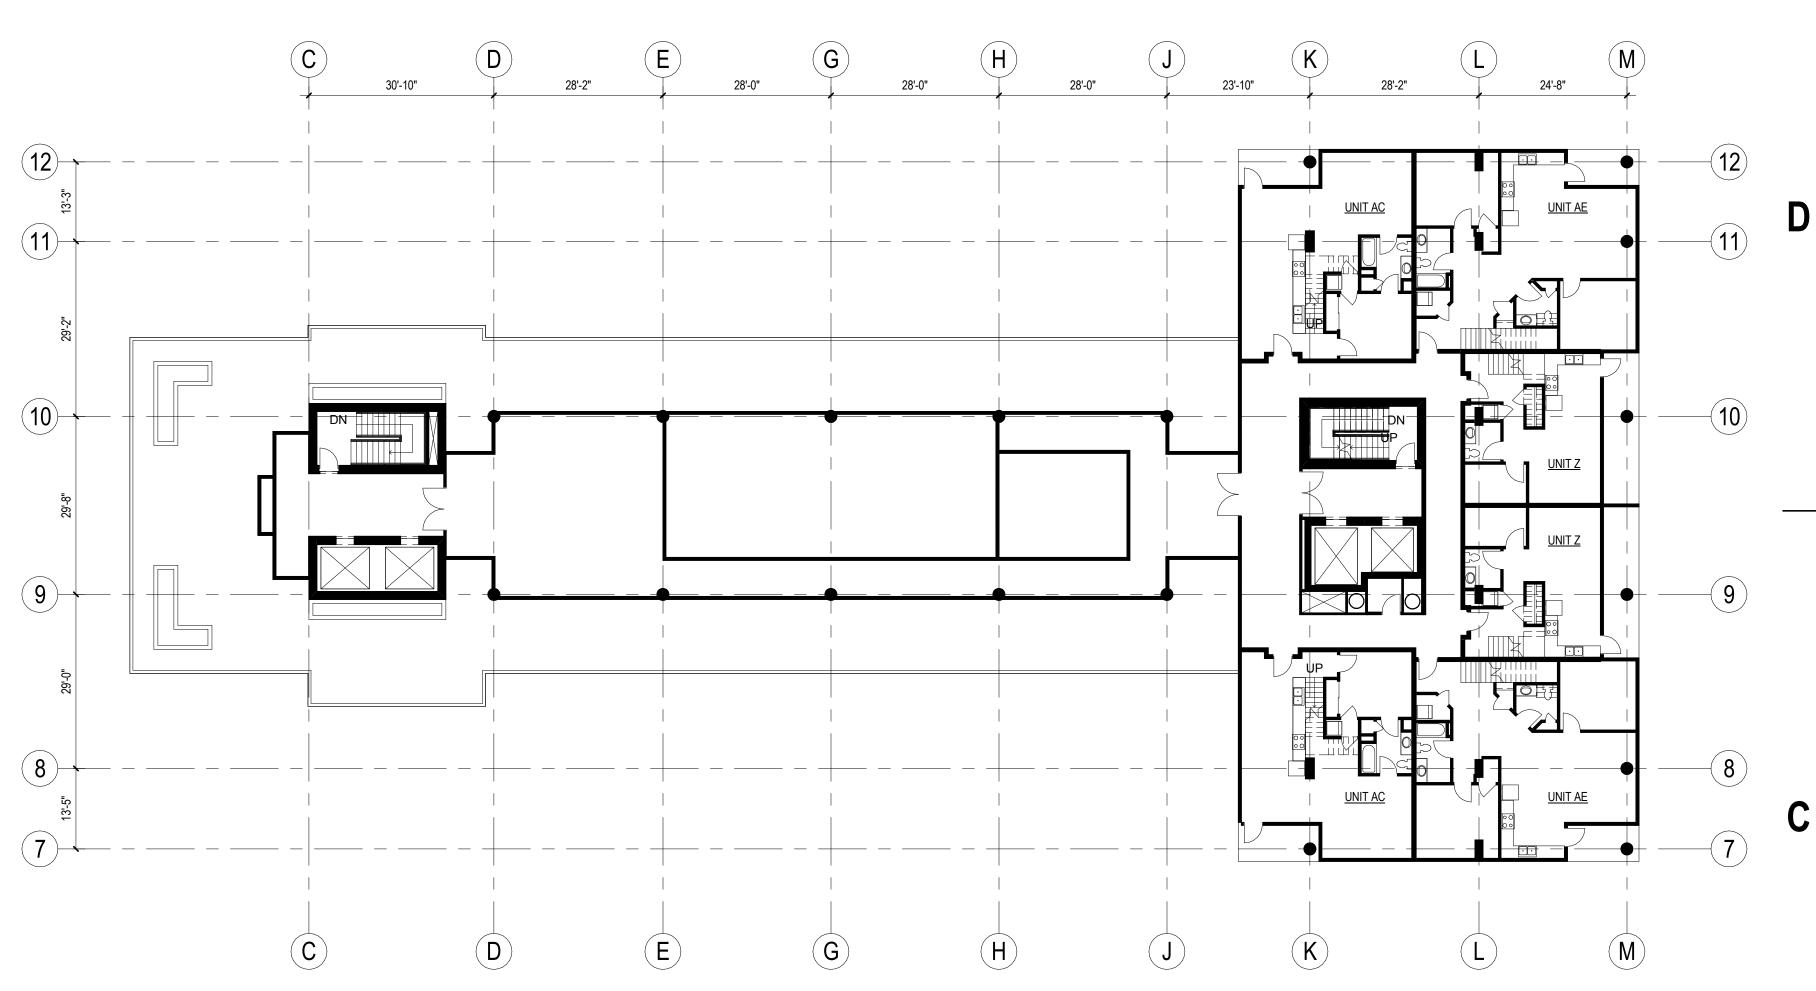


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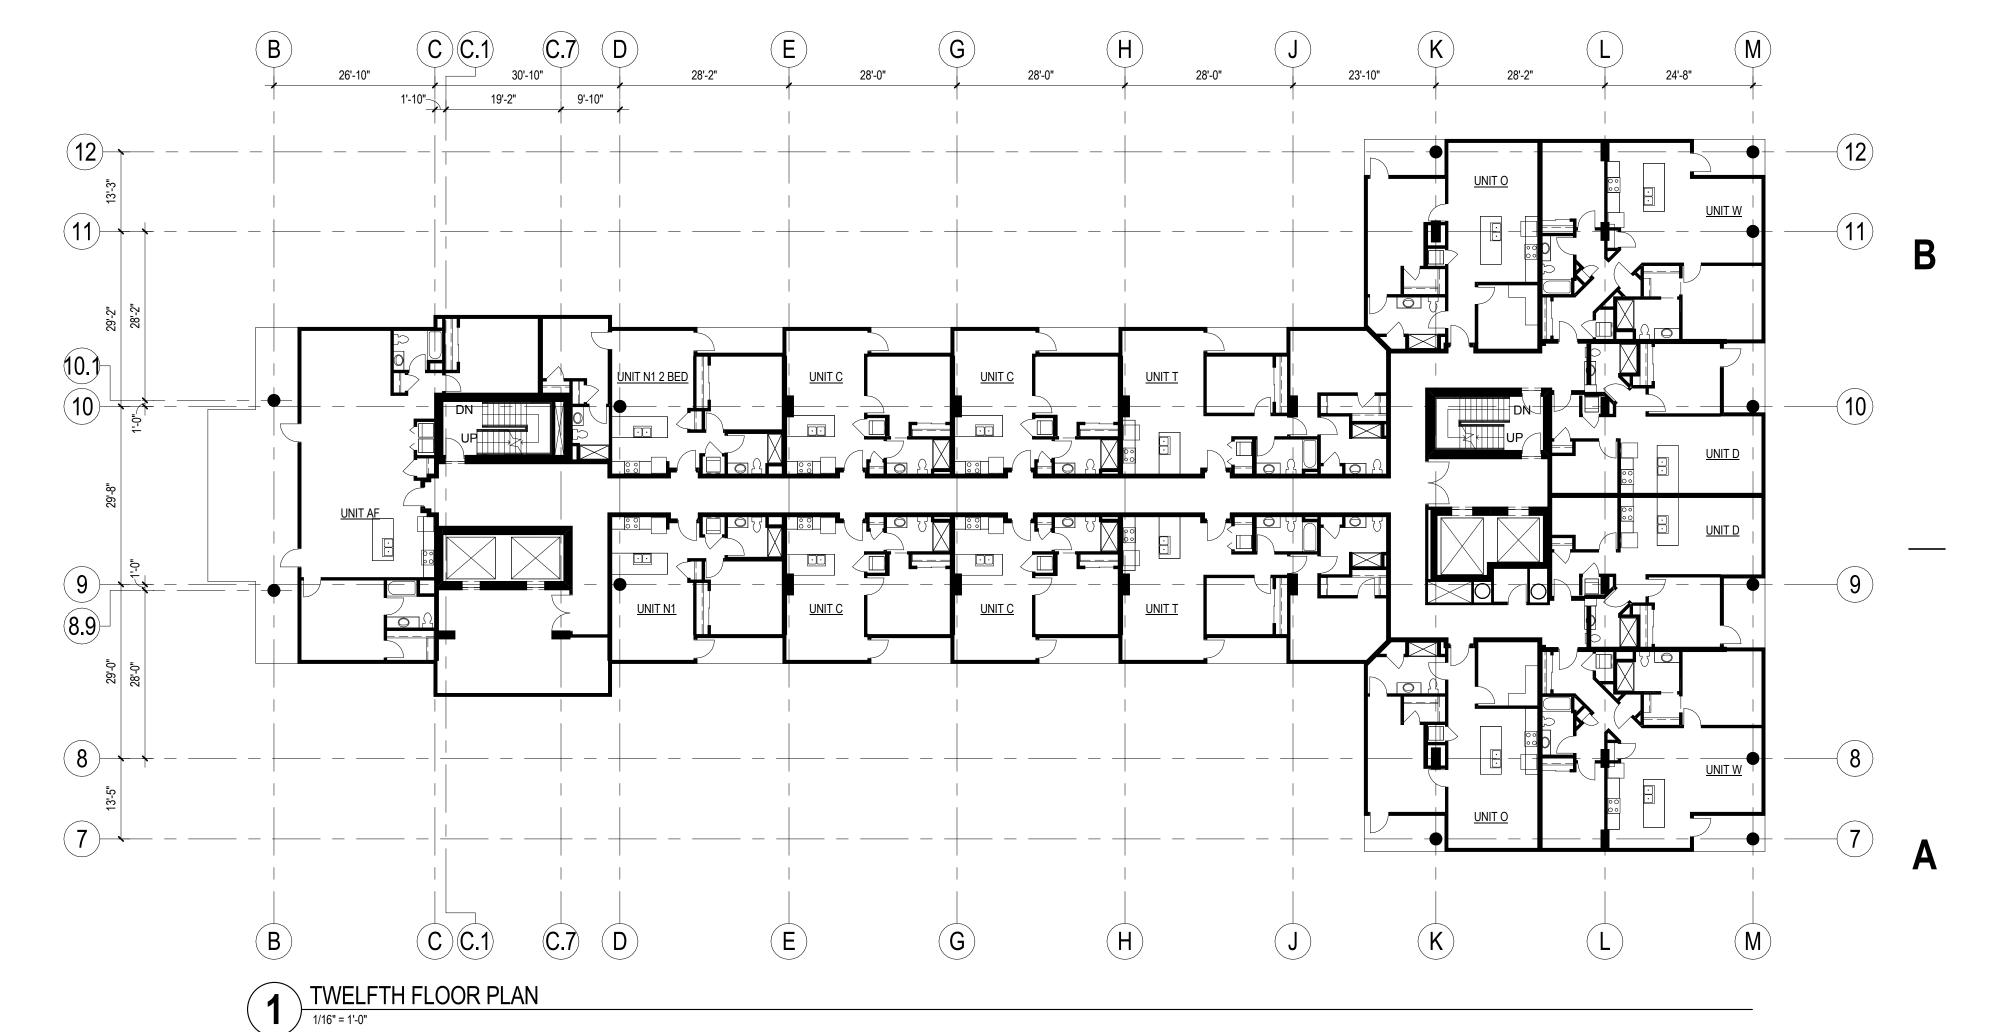
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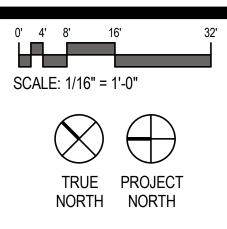
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2 THIRTEENTH FLOOR PLAN 1/16" = 1'-0"

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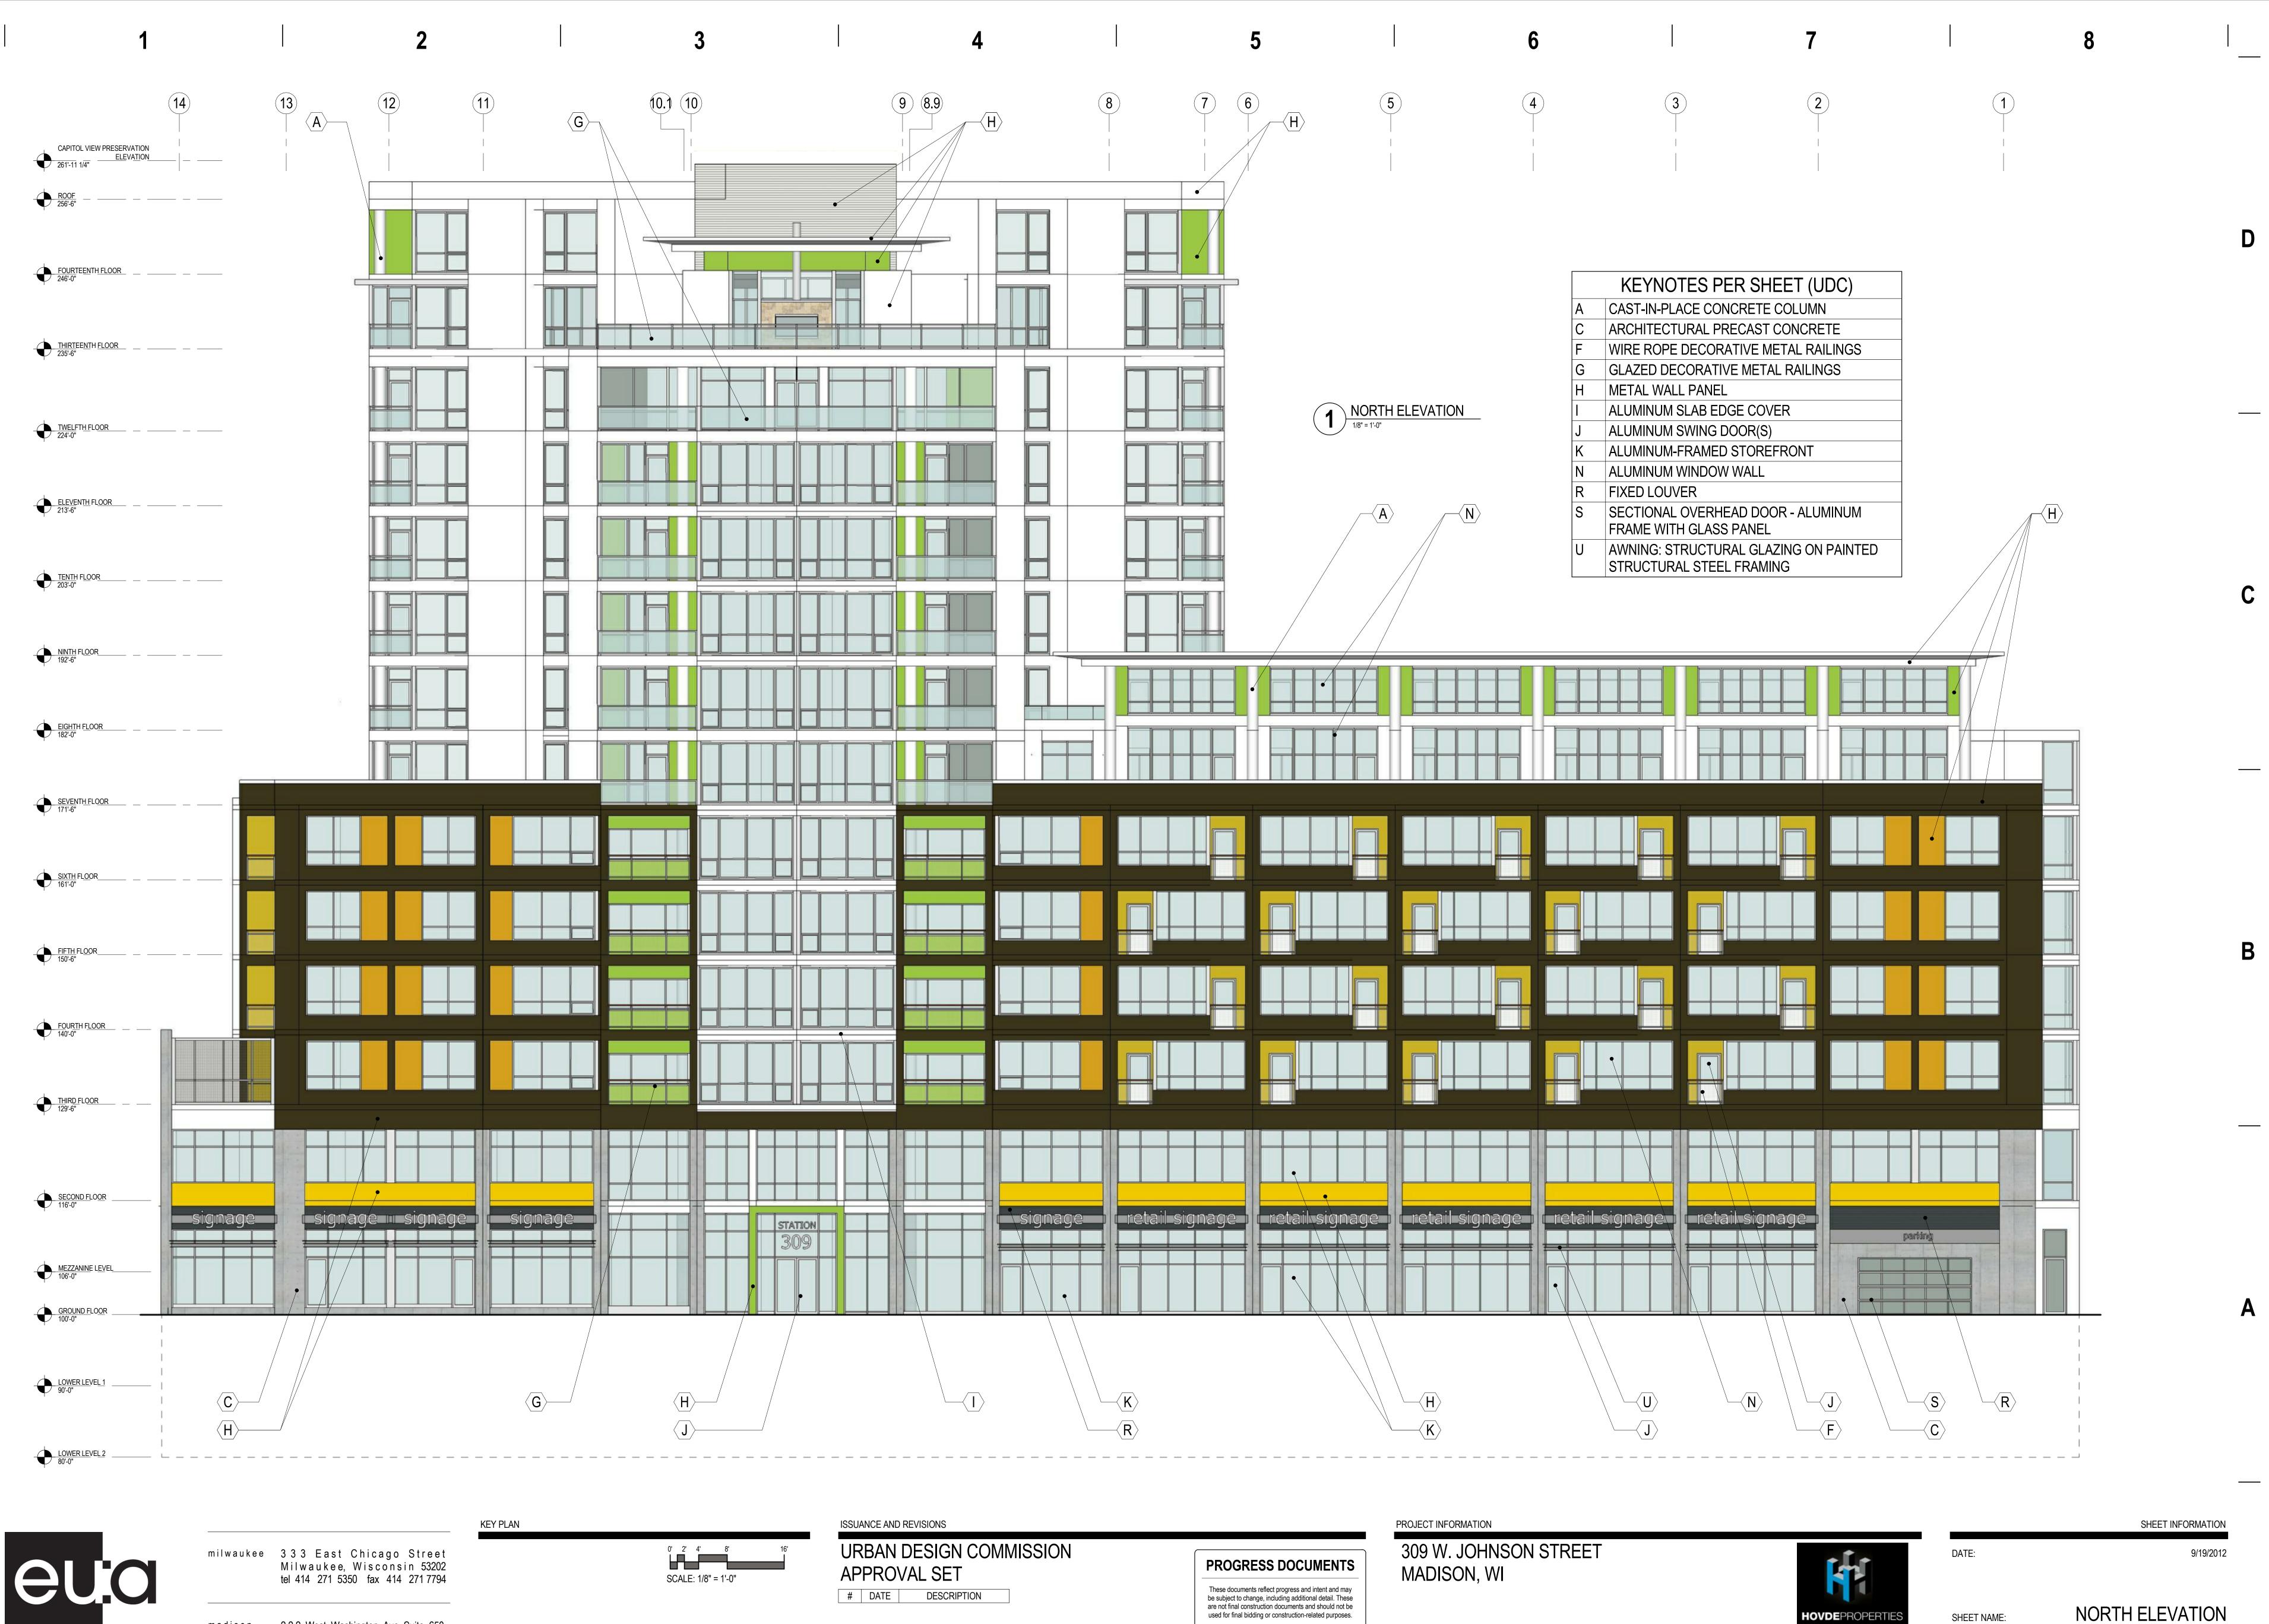


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0' 2' 4' 8 SCALE: 1/8" = 1'-0" ISSUANCE AND REVISIONS



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PROJECT INFORMATION

309 W. JOHNSON STREET MADISON, WI



DATE:

SHEET NAME:

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APITOL VIEW PRESERVATION <u>ELEVATION</u> 261'-11 1/4"	
<u>ROOF</u>	П
FOURTEENTH FLOOR 246'-0"	
THIRTEENTH FLOOR 235'-6"	
TWELFTH FLOOR 224'-0"	
EL <u>EV</u> ENTH FLOOR 213'-6"	
	С
NINTH FLOOR 192'-6"	
EIGHTH FLOOR 182'-0"	
SEVENTH FLOOR 171'-6"	
SIXTH FLOOR	
FIF <u>TH FLOOR</u> 150'-6"	В
FOURTH FLOOR 140'-0"	
TH <u>IRD FLOOR</u> 129'-6"	
SECOND FLOOR 116'-0"	
MEZZANINE LEVEL 106'-0"	
GROUND FLOOR 100'-0"	Α
$-\overline{Q} \xrightarrow{LOWER LEVEL 1}{90'-0"} \xrightarrow{P}$	
LOW <u>ER LEVEL 2</u> 80'-0"	
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WEST ELEVATI	ON

WEST ELEVATION © Eppstein Uhen Architects, Inc.





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0' 2' 4' 8 SCALE: 1/8" = 1'-0"

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DATE:

SHEET NAME:

CAPITOL VIEW PRESERVATION <u>ELEVATION</u> 261'-11 1/4"	
	_
F <u>OURTEENTH FLOOR</u>	D
T <u>HIRTEEN</u> TH <u>FLOOR</u> 235'-6"	
<u>TWELFTH_FLOOR</u>	
<u>ELEVENTH FLOOR</u> 213'-6"	
<u>TENTH FLOOR</u>	С
<u>NINTH FLOOR</u> 192'-6"	
<u>EIGHTH FLOOR</u>	
<u>SEVENTH FLOOR</u>	
<u>SIXTH FLOOR</u> 161'-0"	
	В
<u>FOUR</u> TH <u>FLOOR</u> 140'-0"	
<u>THIRD_FLOOR</u>	
<u>SECOND FLOOR</u> 116'-0"	
<u>MEZZANINE LEVEL</u> 106'-0"	
<u>GROUND FLOOR</u>	Α
LOWER LEVEL 1	
<u>LOWER LEVEL 2</u> 80'-0"	
SHEET INFORMATION	

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9/19/2012






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LOWER LEVEL 2 80'-0"

0' 2' 4' 8' SCALE: 1/8" = 1'-0" ISSUANCE AND REVISIONS

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PROGRESS DOCUMENTS

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	KEYNOTES P
Α	CAST-IN-PLACE C
G	GLAZED DECORA
Н	METAL WALL PAN
	ALUMINUM SLAB
J	ALUMINUM SWING
Ν	ALUMINUM WIND

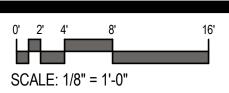PROJECT INFORMATION



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DATE:

SHEET NAME:

SHEET NUMBER:

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PER SHEET (UDC) CONCRETE COLUMN ATIVE METAL RAILINGS NEL BEDGE COVER NG DOOR(S) DOW WALL

D

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PARTIAL NORTH ELEVATION A205



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KEY PLAN

<u>MEZZANINE LEVEL</u> 106'-0" GROUND FLOOR LOWER LEVEL 2 _____



NINTH FLOOR 192'-6"

EIGHTH FLOOR 182'-0"

FIFTH FLOOR 150'-6"

FOURTH FLOOR 140'-0"

THIRD FLOOR 129'-6"

<u>ELEVENTH</u> FL<u>O</u>OR 213'-6"

<u>THIRTEENTH FLOOR</u> 235'-6"

<u>FOURTEENTH FLOOR</u> 246'-0"


<u>ROOF</u> _____


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ISSUANCE AND REVISIONS

URBAN DESIGN COMMISSION APPROVAL SET # DATE DESCRIPTION

PROGRESS DOCUMENTS

These documents reflect progress and intent and may be subject to change, including additional detail. These are not final construction documents and should not be used for final bidding or construction-related purposes.

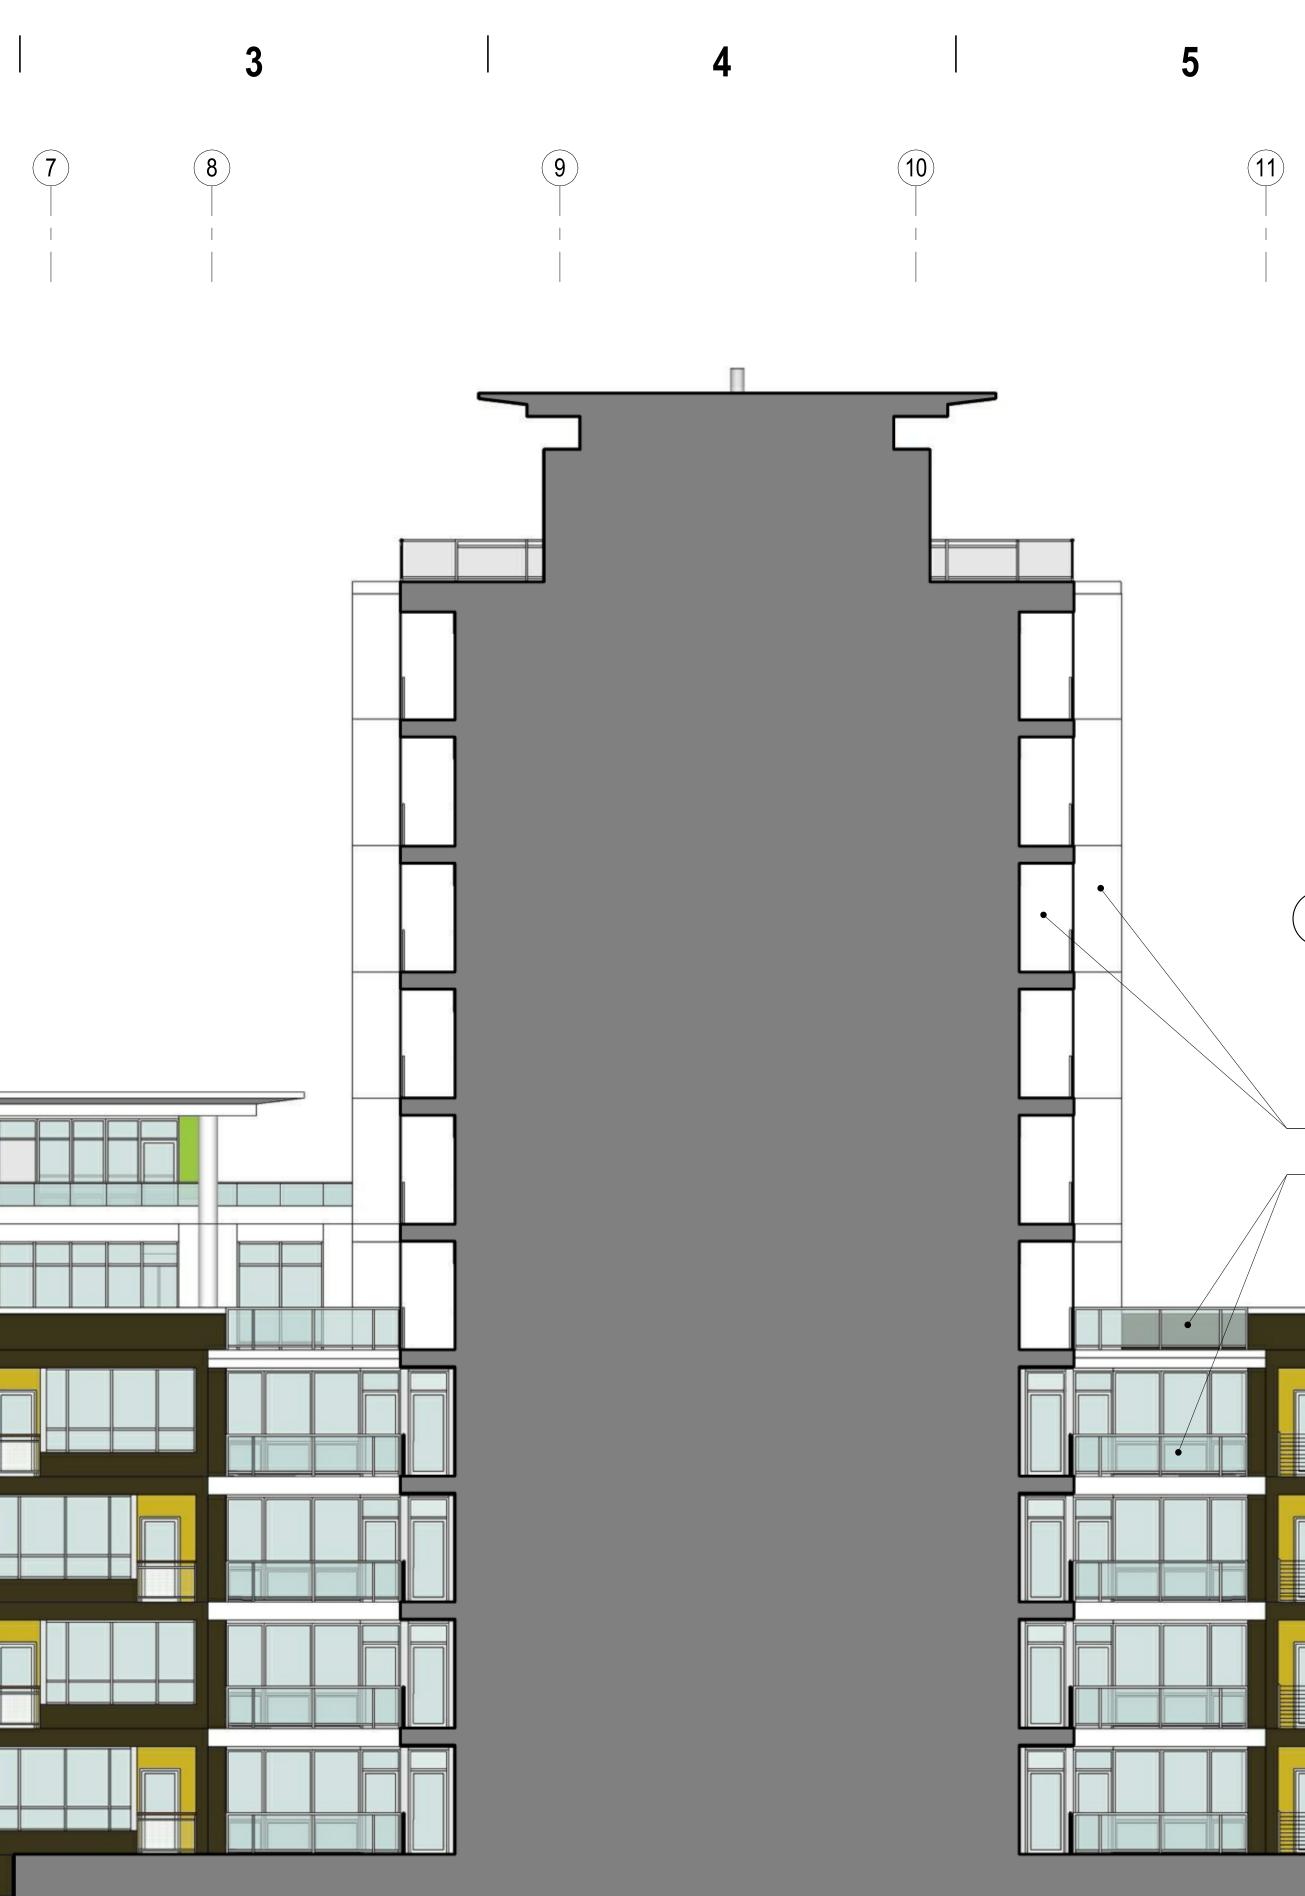	KEYNOTES P
В	CAST-IN-PLACE C
F	WIRE ROPE DECC
G	GLAZED DECORA
Н	METAL WALL PAN
J	ALUMINUM SWING
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1 PARTIAL SOUTH ELEVATION
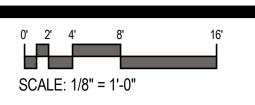
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309 W. JOHNSON STREET MADISON, WI



DATE:

SHEET NAME:

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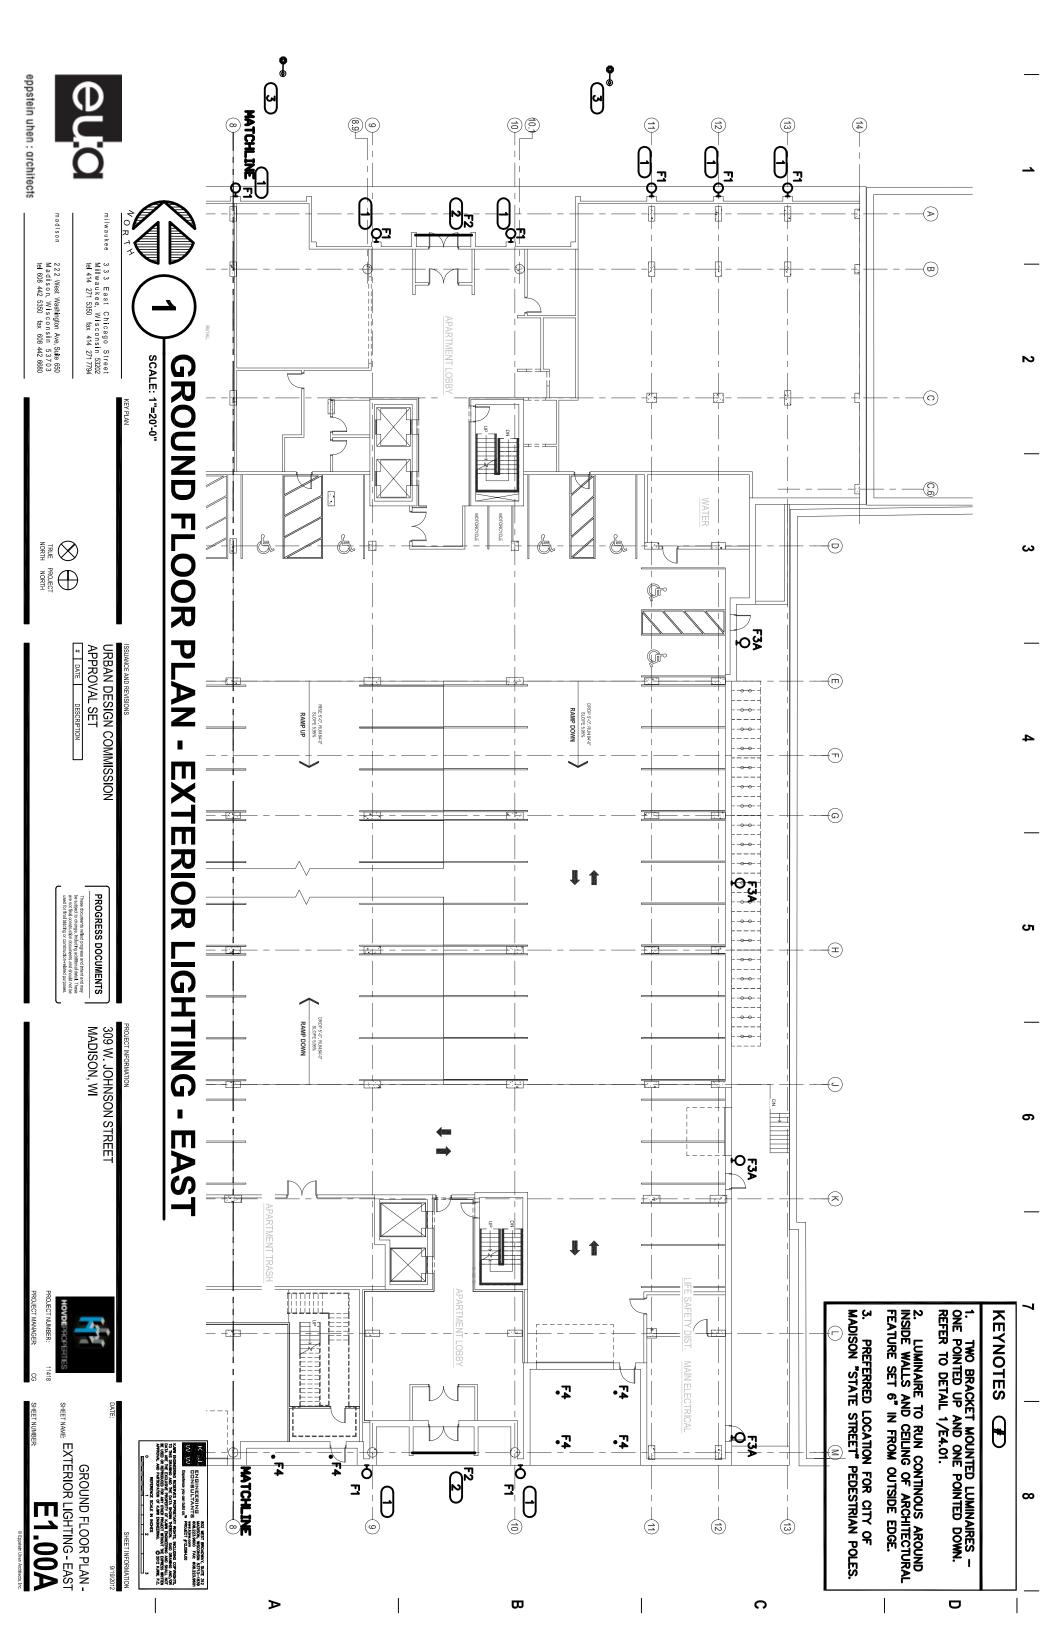
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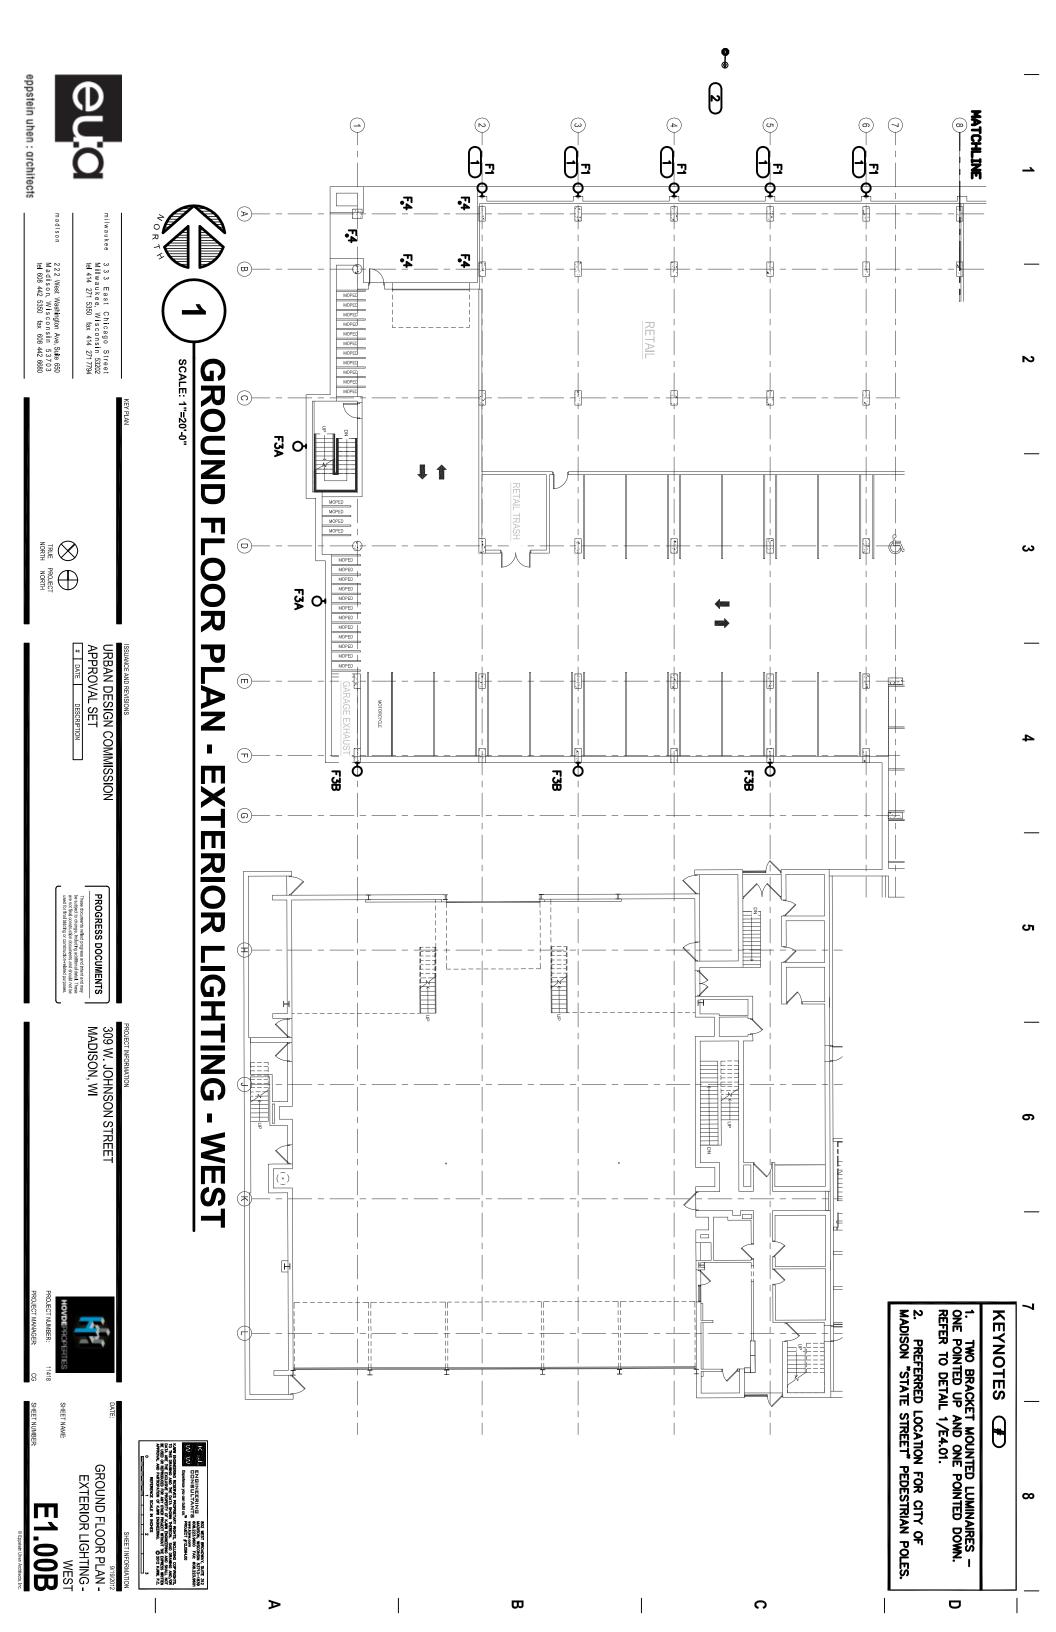
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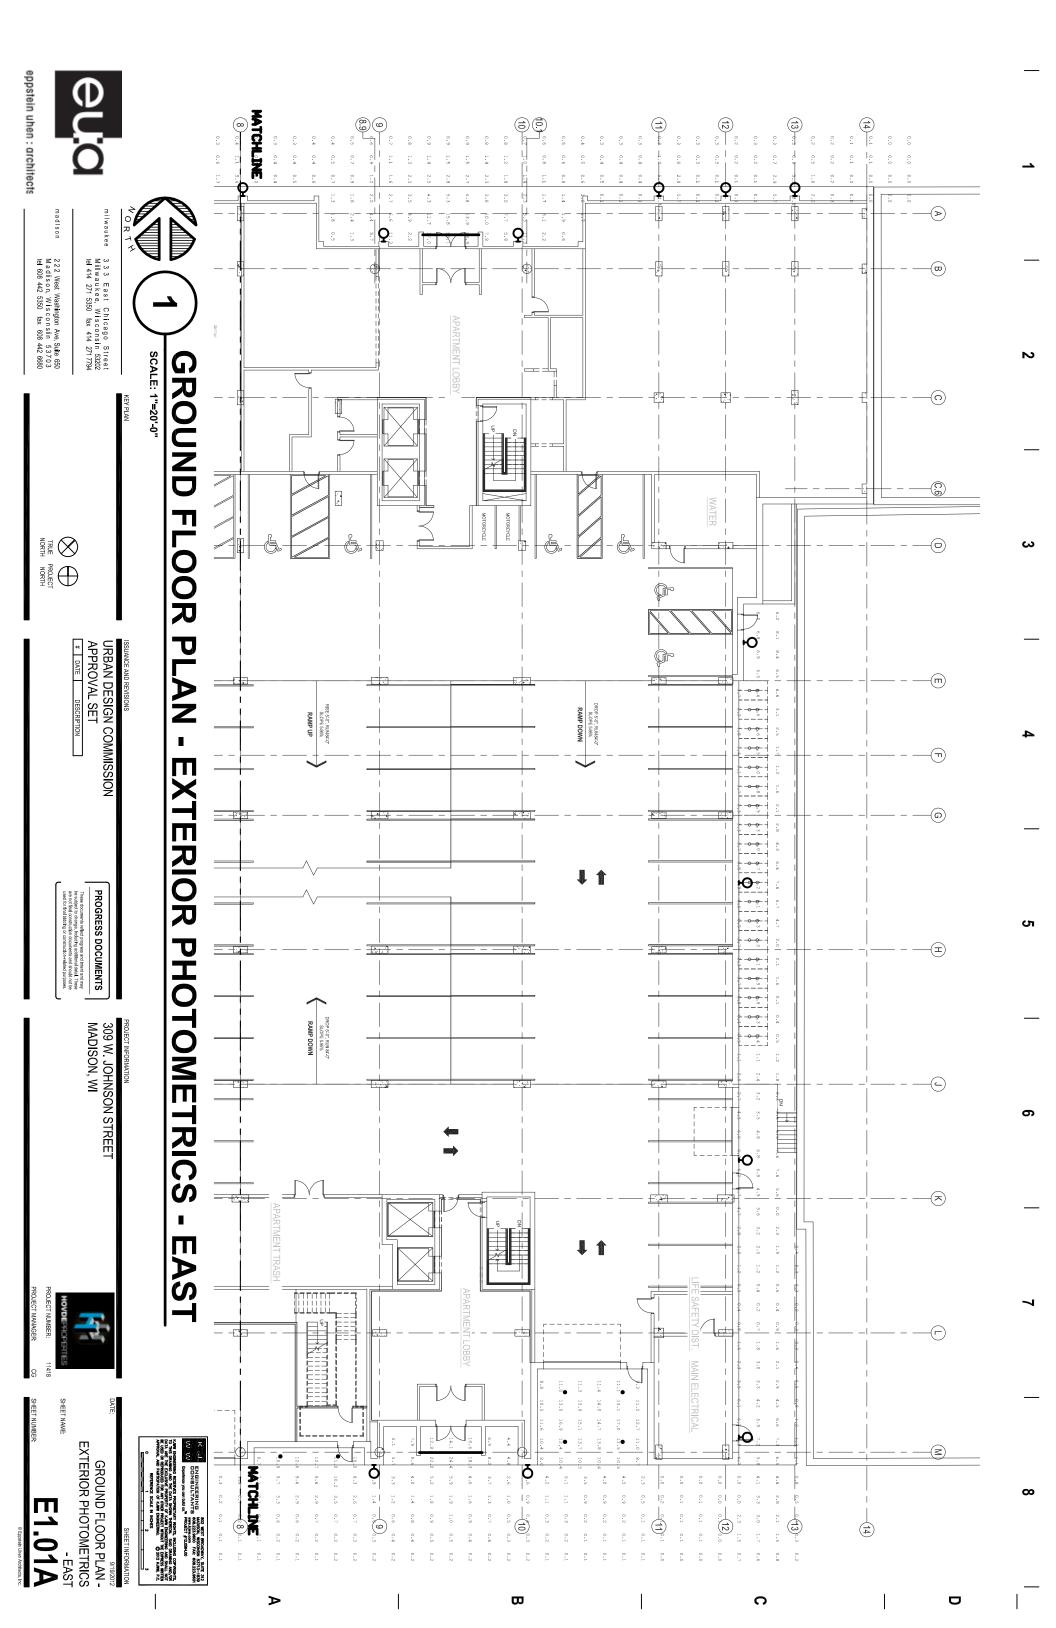
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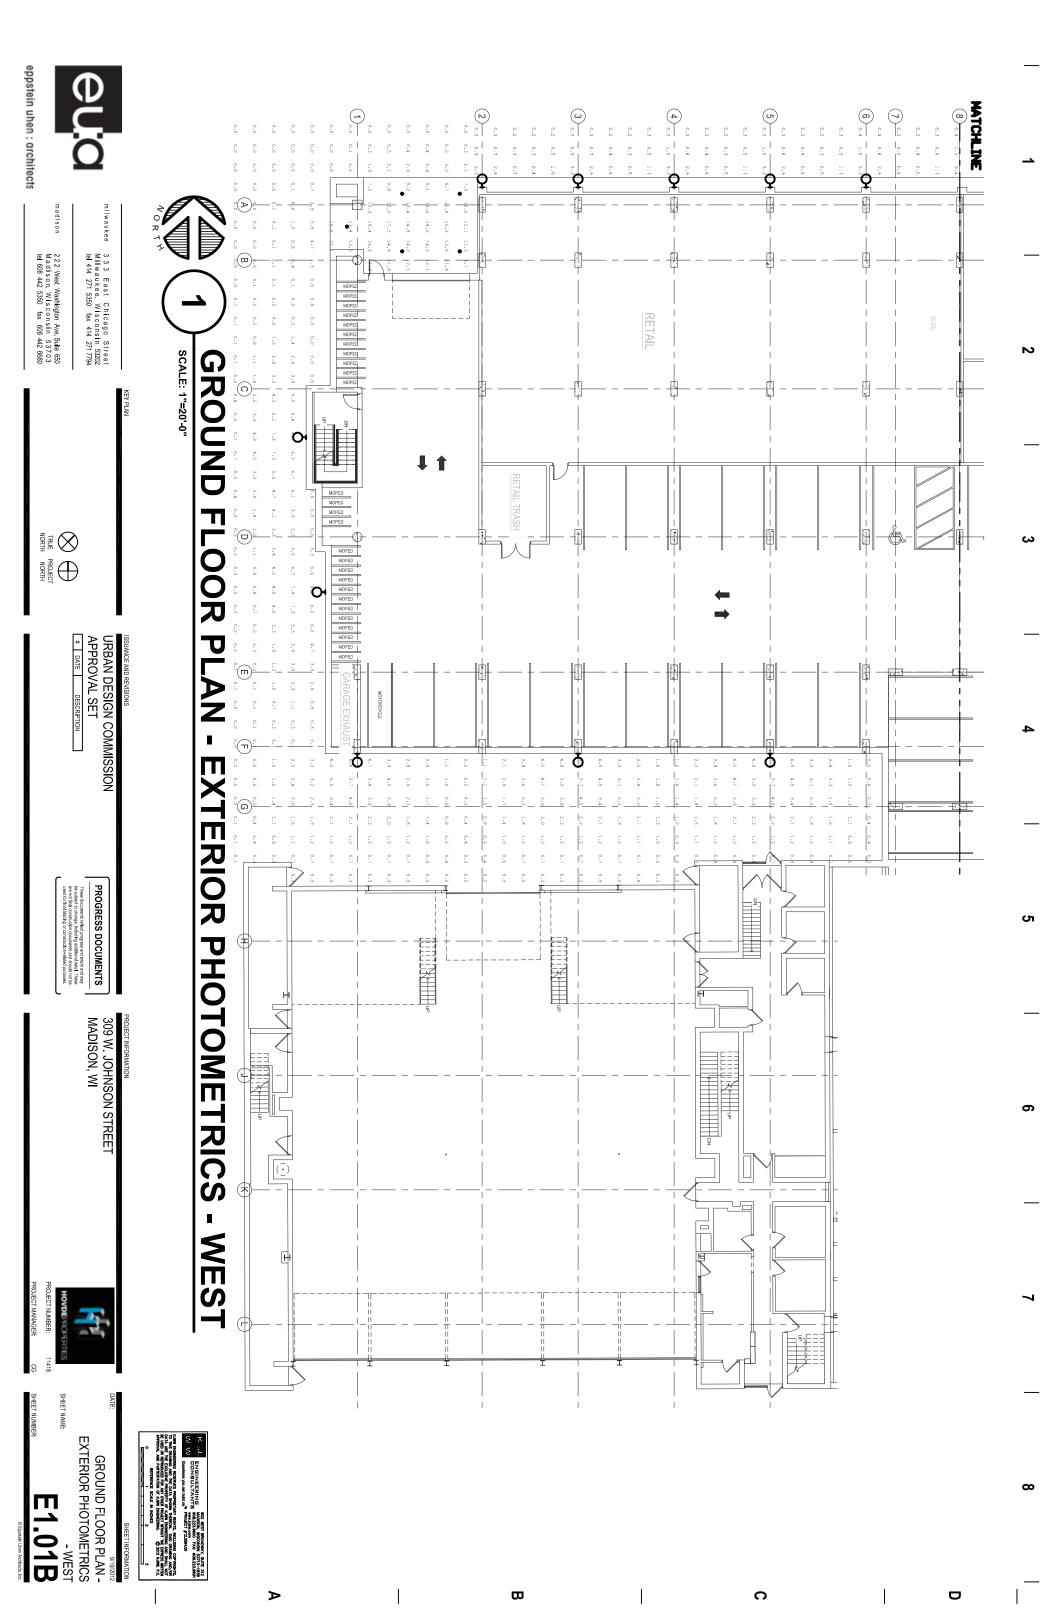
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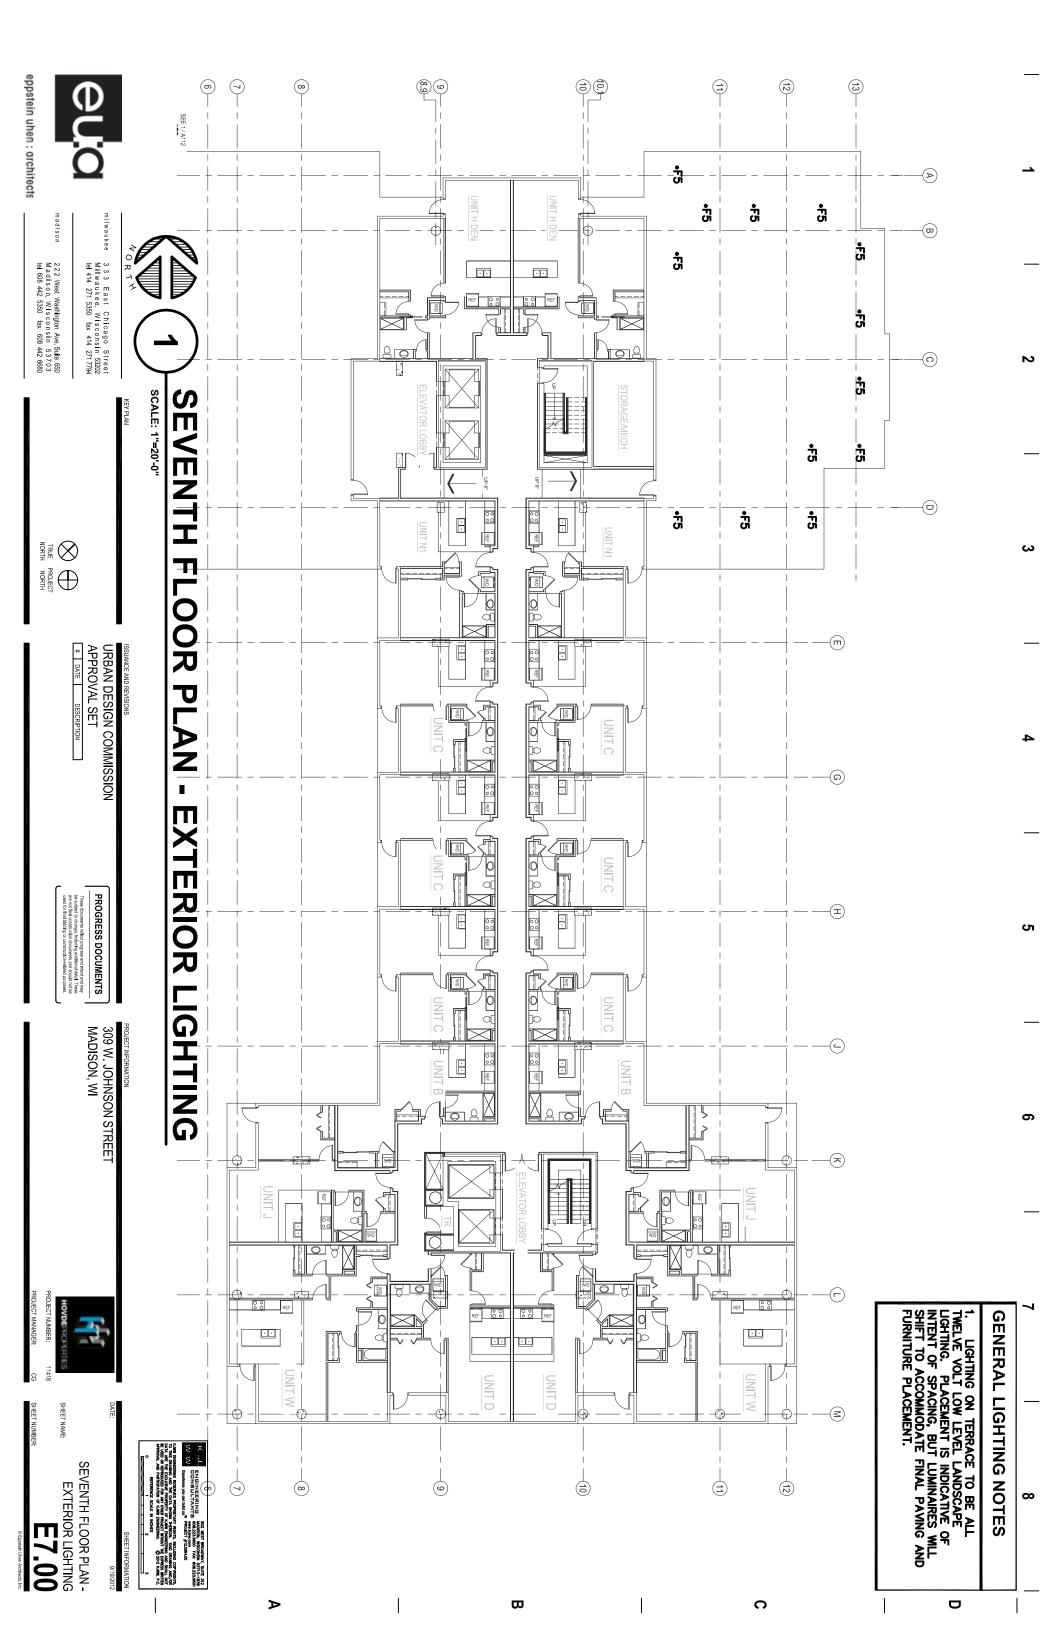
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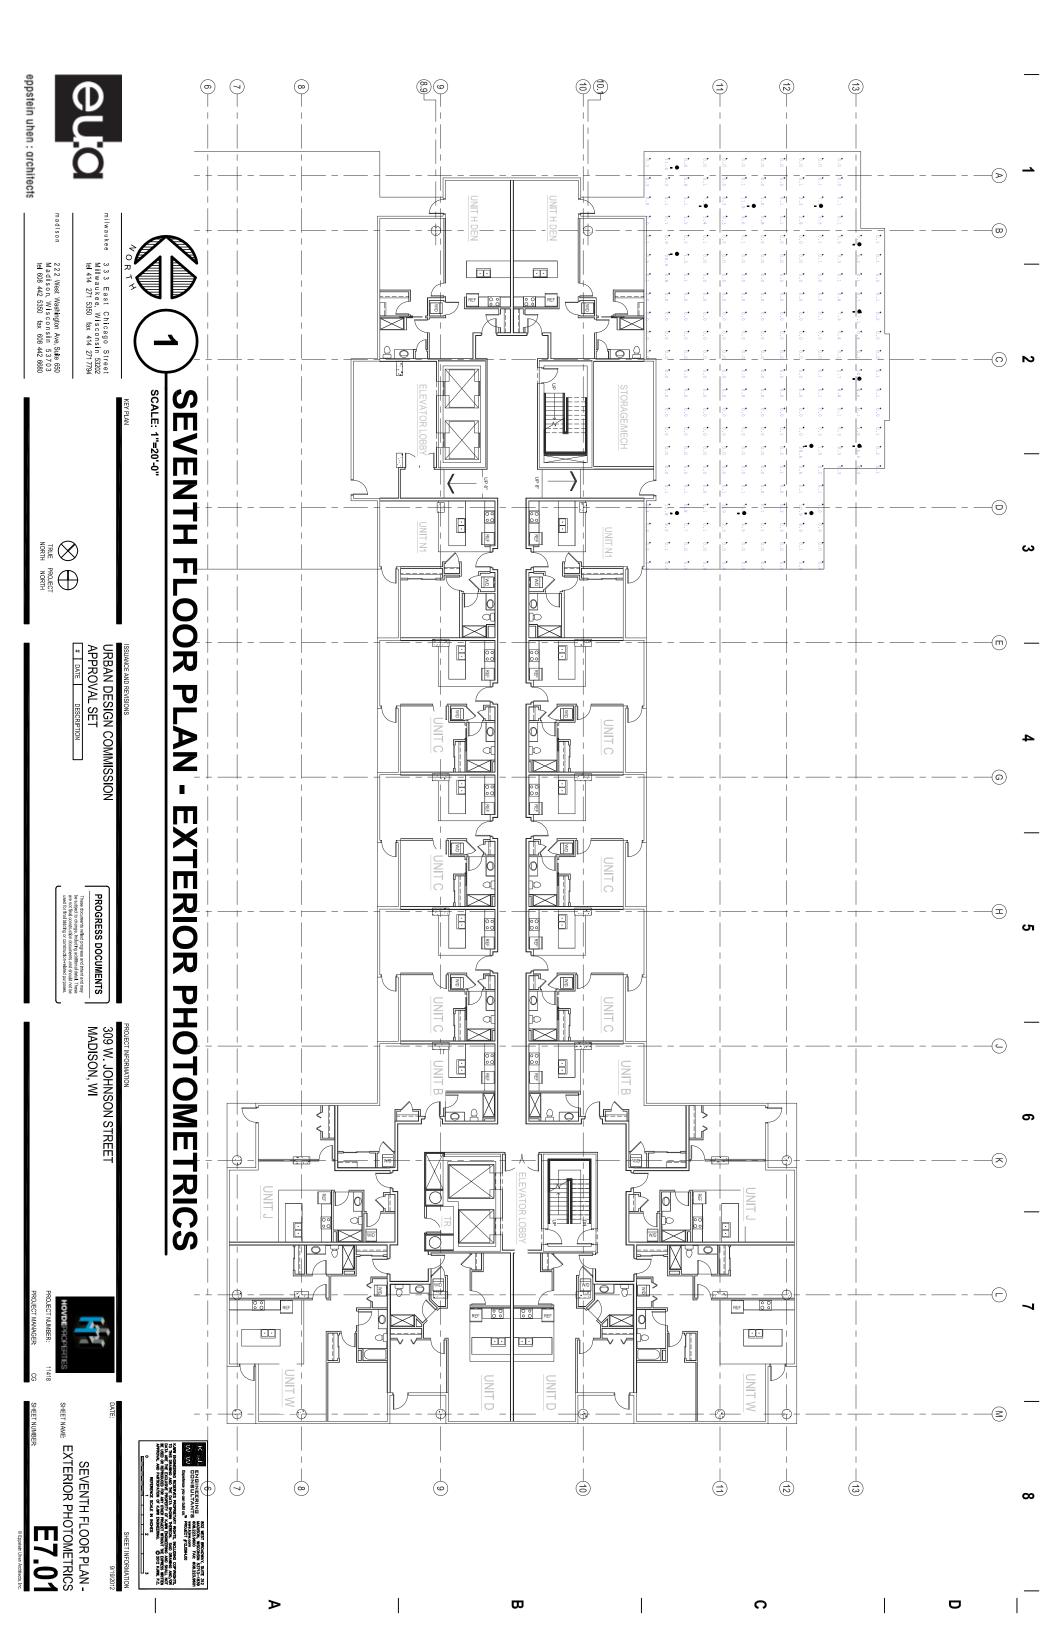














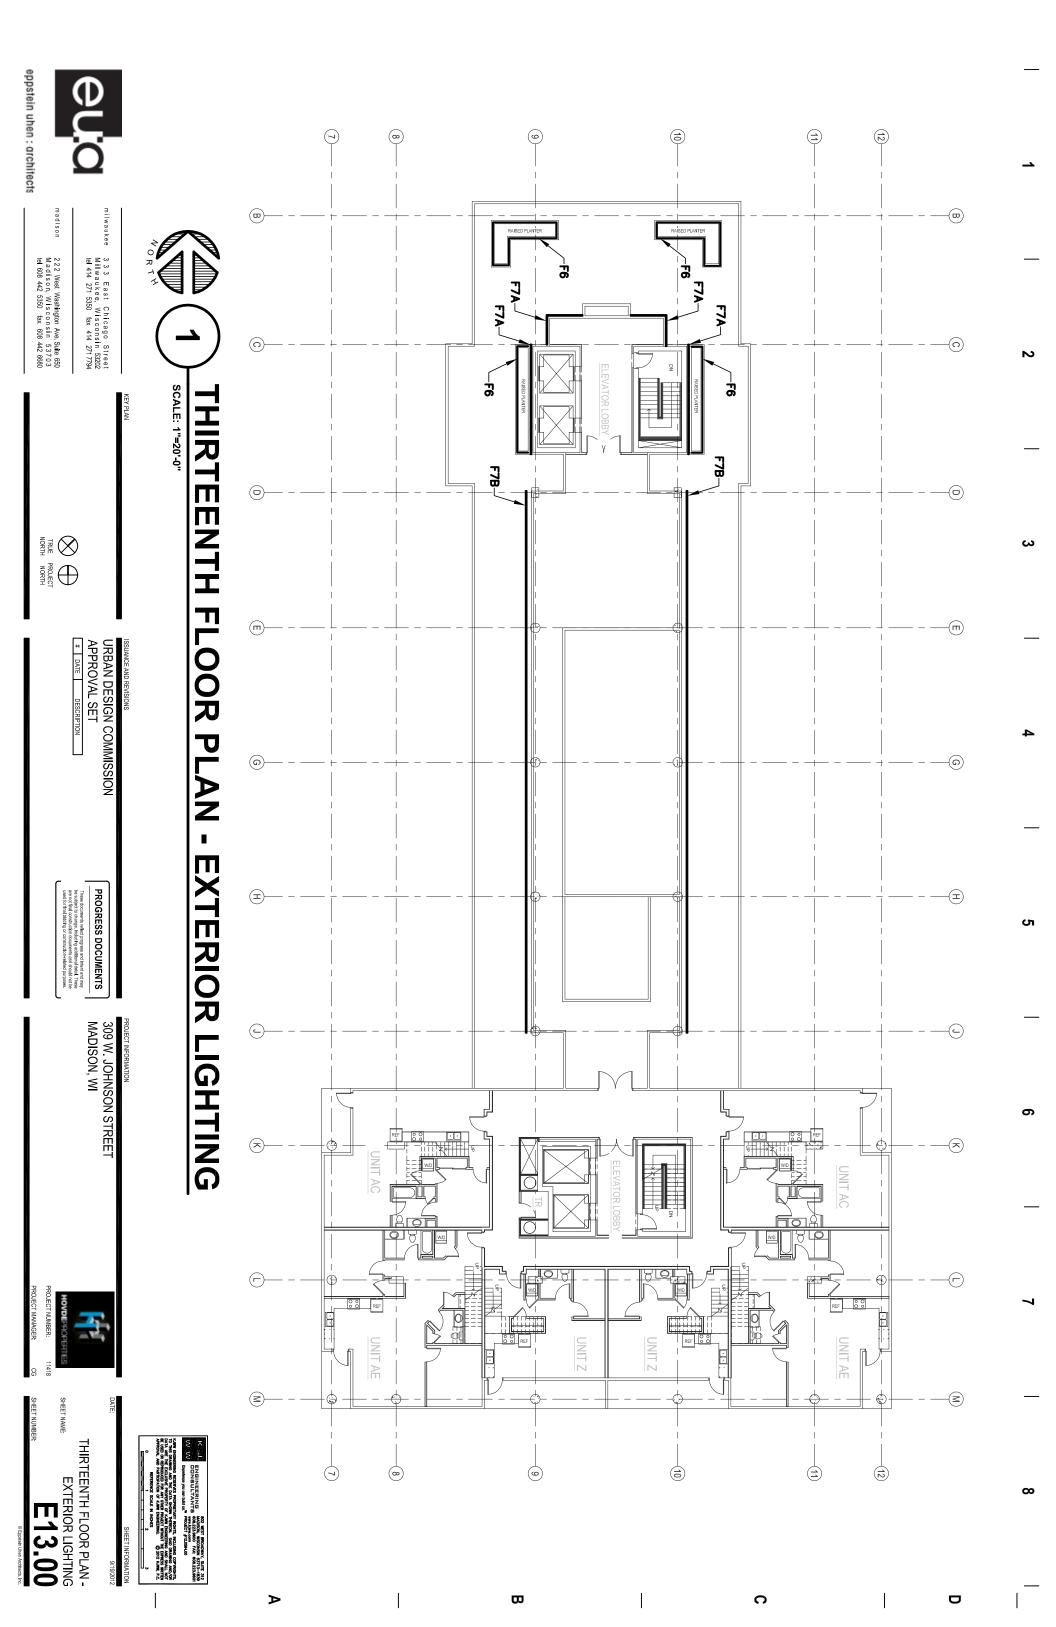

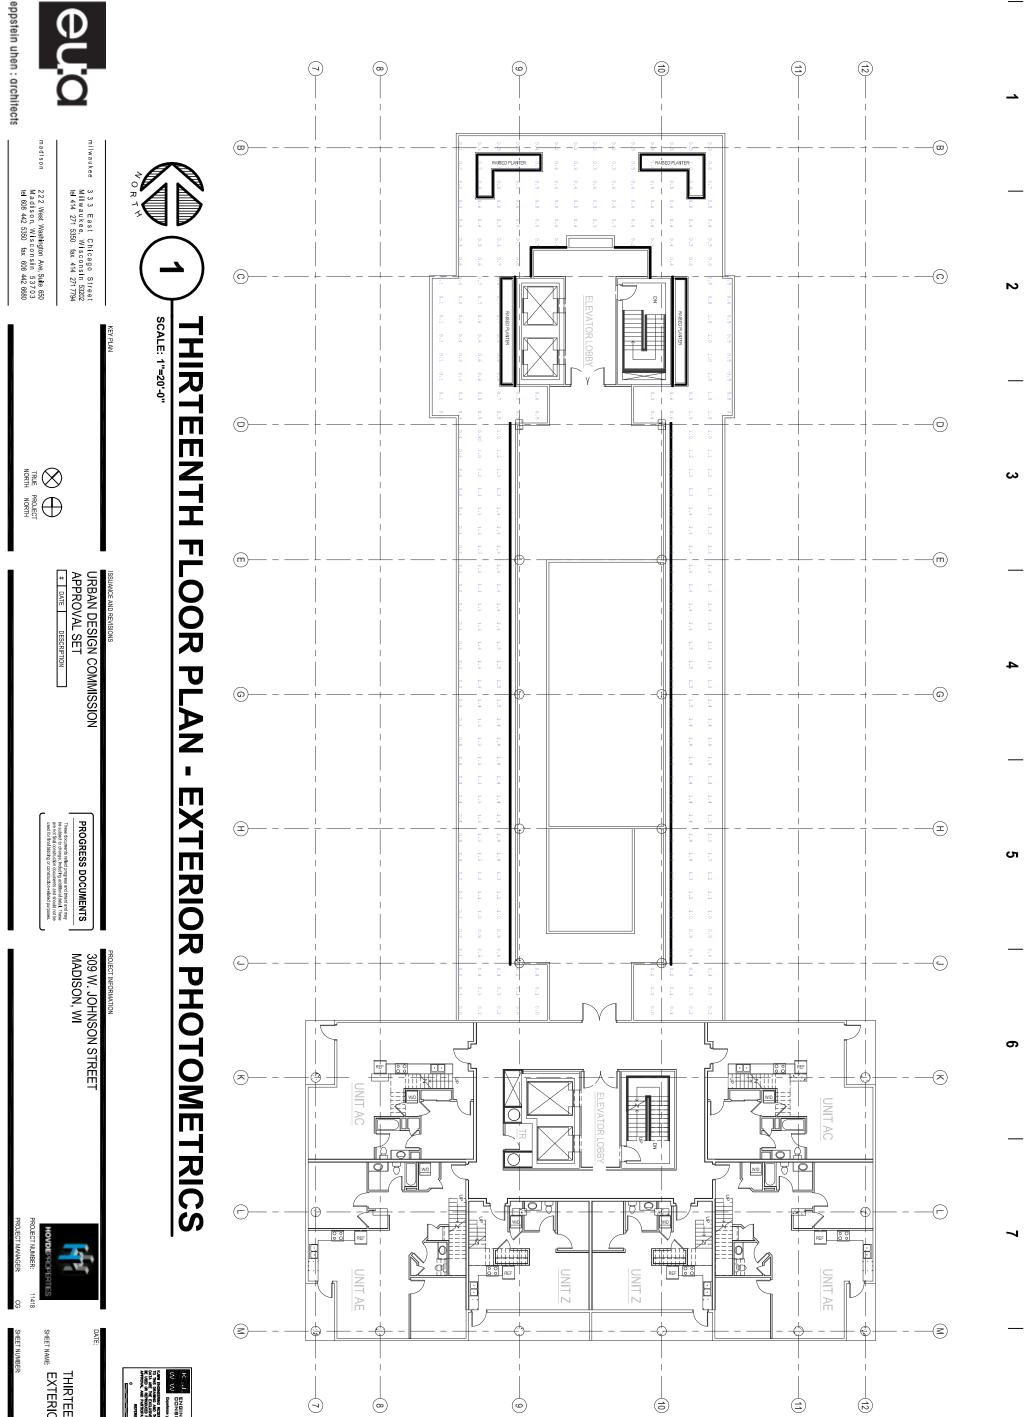

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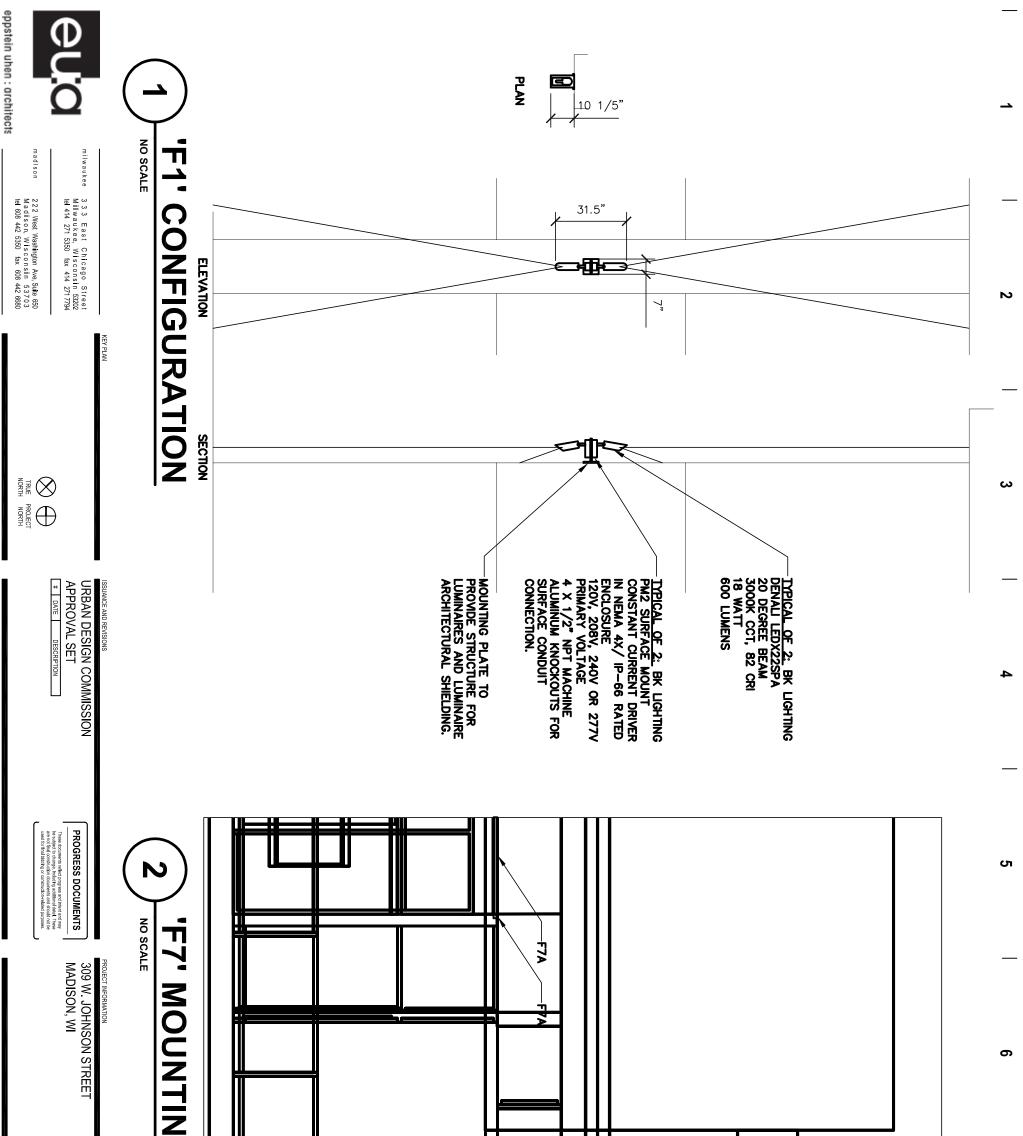
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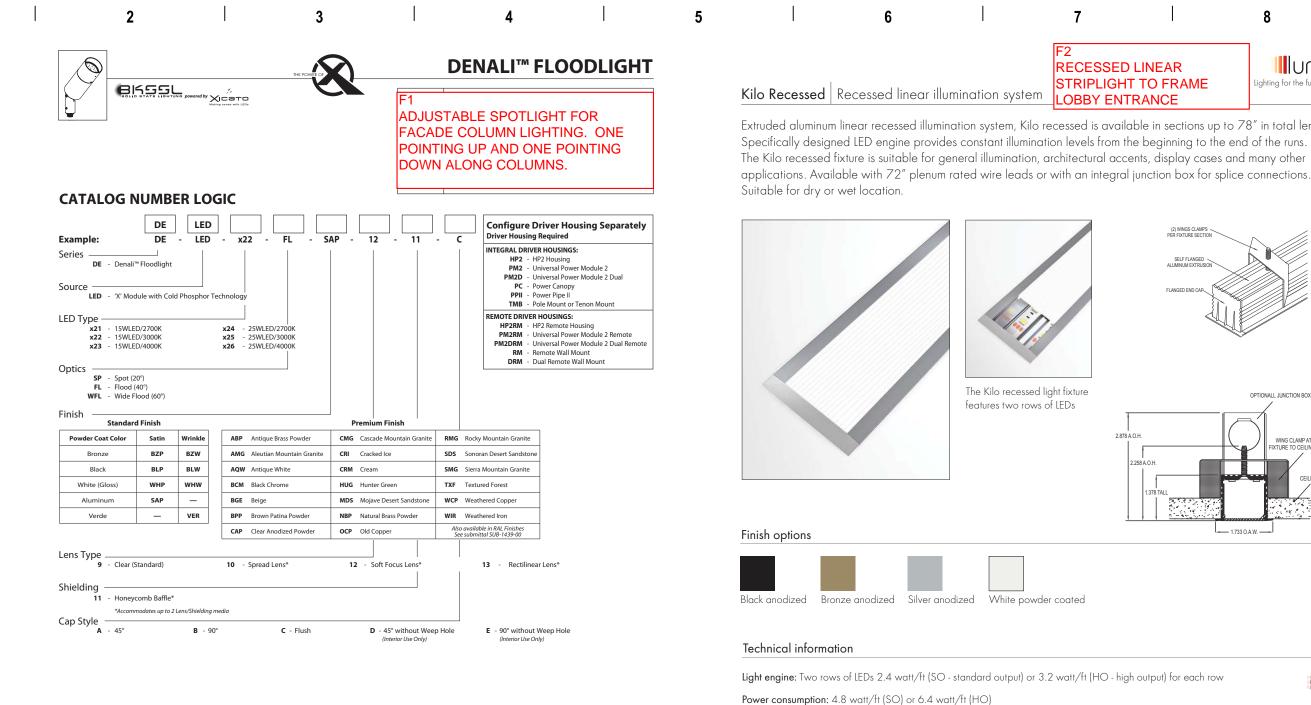
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© Eppstein Uten Architects, Inc.			SHEET NAME: STREET	AND SECTION W.JOHNSON	EXTERIOR ELEVATIONS	DATE: 9/19/2012	SHEET INFORMATION

GH NORTH COLUMN

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PROJECT NUMBER: 11418 PROJECT MANAGER: CG	IG LOCATIONS				
DATE: SHEET NAME: DE: SHEET NUMBER:	•				-
DETAILS - LIGHTING	EQUINTERING ENGINEERING ENGINEERI		 	_	_



LM79 DA	ТА				L70 DATA	OPTICAL	DATA
BK No.	ССТ (Тур.)	CRI (Ra. Typ.)	Color Consistency	Input Watts (Typ.)	Minimum Rated Life (hr 70% of initial lumens (L		e Angle
x21	2700K	>80	±40K	15	50,000	Spot	20°
x22	3000K	>80	±50K	15	50,000	Flood	40°
x23	4000K	>80	±70K	15	50,000	Wide Floo	d 60°
x24	2700K	>80	±40K	25	50,000		
x25	3000K	>80	±50K	25	50,000		
x26	4000K	>80	±70K	25	50,000		
B-I		GHT	ING	40429 Brickyard Drive • M 559.438.5800 • F www.bklighting.com •	AX 559.438.5900	SUBMITTAL DATE 3-12-12	DRAWING NUMBER SUB001113

B-K LIGHTING

KEY PLAN

THIS DOCUMENT CONTAINS PROPRIETARY INFORMATION OF B-K LIGHTING, INC. AND ITS RECEIPT OR POSSESSION DOES NOT CONVEY ANY RIGHTS TO REPRODUCE, DISCLOSE ITS CONTENTS, OR TO MANUFACTURE, USE OR SELL ANYTHING IT MAY DESCRIBE. REPRODUCTION, DISCLOSURE OR USE WITHOUT SPECIFIC WRITTEN AUTHORIZATION OF B-K LIGHTING, INC. IS STRICTLY FORBIDDEN.

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TRUE PROJECT NORTH NORTH

www.bklighting.com • info@bklighting.com

SUANCE AND REVISIONS

URBAN DESIGN COMMISSION APPROVAL SET # DATE DESCRIPTION

PROJECT INFORMATION

CRI: 70+ Standard, 82+ High

Operating Voltage: 24 VDC

Max run length: 20 feet (SO), 15 feet (HO)

309 W. JOHNSON STREET MADISON, WI



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madison 222 West Washington Ave, Suite 650 Madison, Wisconsin 53703 tel 608 442 5350 fax 608 442 6680

milwaukee 333 East Chicago Street Milwaukee, Wisconsin 53202

tel 414 271 5350 fax 414 271 7794


PROGRESS DOCUMENTS

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REVO.O

RECESSED LINEAR STRIPLIGHT TO FRAME LOBBY ENTRANCE

Extruded aluminum linear recessed illumination system, Kilo recessed is available in sections up to 78" in total length.

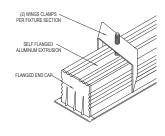

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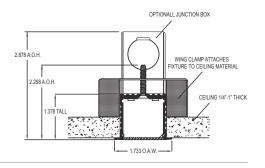
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Lighting for the future, today.




Made in USA

Color temperature: 2700K, 2900K, and 4000K. Others available upon request.

Light output for 2900K High CRI LEDs with clear lens: 354 lumens/foot (SO), 504 lumens/foot (HO) The light output is reduced by 30% when the frosted lens is used.

Dimming: Low voltage magnetic dimmers. (See Luminii website for list of compatible dimmers) Luminii PSD series power supply required.



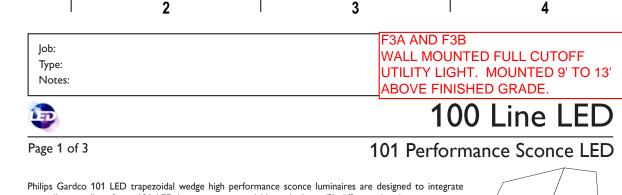

naturally to wall surfaces. 101 LED luminaires are available with three (3) different distribution patterns, providing full cutoff performance (in the normal downlight position) and featuring LED arrays. Luminaires provide performance excellence and advanced Philips Gardco LED thermal management technology. High performance Class 1 LED systems offer potential energy savings of 50 % or more compared to HID systems. 101 LED luminaires are also available with Automatic Profile Dimming, increasing savings by an additional 33%.



PREFIX		DISTRIBUTION		LED WATTAGE		LED SELECTION		VOLTAGE		FINISH		OPTIONS
				-							Η	
Enter the order code in	to the	e appropriate box above.	No	te: Philips Gardco reserves	s th	e right to refuse a config	urati	on. Not all combinations	and	configurations are valid.	ſ	

Refer to notes below for exclusions and limitations. For questions or concerns, please consult the factory.

PREFIX

DISTRIBUTION

Type II Wide Throw Optic, featuring Maximized Lateral Throw

- 101L Trapezoidal Wedge LED - Constant Wattage / Full Light Output 2 **101L-DCC** Trapezoidal Wedge LED - Dual Arrays with Dual Circuit Control 101L-DIM Trapezoidal Wedge LED - 0 - 10V Dimming (Control system by others.) 4 **101L-APD** Trapezoidal Wedge LED with Automatic Profile Dimming
 - 3 Type III Preferred Wide Throw Optic, featuring Improved Forward Throw Type IV Maximized Forward Throw Optic

See page 3 for more detailed luminaire configuration information

LED WATTAGE AND LUMEN VALUES

Ordering	Average System	LED Current	LED	Luminair	e Initial Absolute	Lumens ^{2,3}	Basis of Lumen Data
Code	Watts ¹	(mA)	Selection	TYPE 2	TYPE 3	TYPE 4	Photometric tests performed in compliance with IESNA LM-79.
35LA	35	350	NW	2,883	2,974	2,821	
55LA	55	530	NW	3,948	4,158	3,904	

. Wattage may vary by +/- 8% due to LED manufacturer forward volt specification and ambient temperature. Wattage shown is average for 120V through 277V input. Actual wattage may vary by an additional +/- 10% due to actual input voltage. 2. Tests are in process for luminaires with the DL option , CW and WW luminaires. CW values may be approximated by applying a 1.08 multiplier to NW values shown.

Contact Gardeo.applications@phillips.com if any approximate estimates are required for design purposes. 3. LED arrays feature LEDs that provide from 100 to 130 lumens per watt when operated at 350 mA. Lumen values based on tests performed in compliance with IESNA LM-79.

LED S	ELECTION	VOLTA	VOLTAGE					
CW NW	Cool White - 5700°K - 75 CRI Neutral White - 4000°K - 75 CRI	UNIV	120V through 277V, 50hz or 60hz					
ww	Warm White - 3000°K - 75 CRI							
1611 Clov (800) 227-	is Barker Road, San Marcos,TX 78666 -0758 (512) 753-1000 FAX:(512) 753-7855 sitelighting.com		PHILIPS					

161 (800) 227-0758 (512) 753-1000 FAX: (512) 753-7855 sitelighting.com © 2012 Koninklijke Philips Electronics N.V. All Rights Reserved.

Philips Gardco reserves the right to change materials or modify the design of its product without notification as part of the company's continuing product improvement program. G200-028/0212



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milwaukee 333 East Chicago Street Milwaukee, Wisconsin 53202

tel 414 271 5350 fax 414 271 7794



URBAN DESIGN COMMISSION APPROVAL SET # DATE DESCRIPTION

GARDCO

Project Name: - Fixture Type: - Model No: - Lamp Info:

APPLICATION

Small aperture medium distribution downlight is suitable for commercial, retail and institutional applications that require an energy saving, long life LED lamp source, high lumen output and excellent color rendering characteristics.

PRODUCT DATA

REFLECTOR: The parabolic reflector redirects spill light from the lamp, and eliminates high angle glare. A one half-inch overlap flange is standard. Supplied standard with Specular Clear Alzak, other reflector finishes are available in order to provide maximum flexibility to the designer

HOUSING: Heavy gauge galvanized steel housing provides a secure mounting platform for the electrical components and protects the optical assembly. Standard plaster flange allows one inch ceiling thickness with custom depth available. LED module is accessible from below.

MOUNTING: Universal Mounting brackets adjust vertically 5.5" and accepts C-channel or rigid bars (see optional accessories).

ELECTRICAL: 2000 lumen = 120 to 277 VAC, 50-60 Hz.; 2800 lumen = 120 or 277 VAC, 50-60 Hz.

JUNCTION BOX: Heavy gauge galvanized junction box pre-wired with grounding pigtail. Easy access covers. Multiple conduit knockouts listed for through branch circuit wiring. LED MODULE & DRIVER: LED Module and Driver are manufactured by Philips Lighting. Remote phosphor technology insures color consistency from fixture to fixture. HEAT MANAGEMENT: Engineered heat sink 1100 - 2000 models feature patented Synjet module that circulates air for optimum heat management of the LED engine.

DIMMING: Standard product is compatible with 0-10 volt dimming controls.

LIGHT OUTPUT (Im)	COLOR TEMP. (K)	SYSTEM WATTS
2000	2700	33.4
2000	3000	33.4
2000	3500	32.9
2000	4000	31.4
2800	2700	51.4
2800	3000	51.4
2800	3500	50.4
2800	4000	49.4

CRI = 80. Specifications based on GEN 3 Fortimo LED DLM2000 by Philips Lighting after 100 hours.

• Expected lamp life to be 50,000 hours with 70% lumen maintenance when ambient temperatures do not exceed 45°C. Lower ambient temperatures yield longer lamp life.

@. Intertek Under Covered Ceiling

Catalog #: 6VLED Example: 6VLED200	04K		
Fixture Series	Lumens	Color	Input/Voltage
6VLED	2000	4K (4000K) 35K (3500K)	120/277V Standard
OVLED	2800*	3K (3000K) 27K (2700K)	E1 120V E2 277V
	* Input voltag	ge must be specifie	d.

Hanger Bars (set of 2)	
□ 101782 = #520 Caddy Bars	□ 9152 = 52" C-Channe
□ 9127 = 27" C-Channel	27BH = 27" Solid Bar
For Optional Reflector Finishes & Decorativ	e elements, consult special

Fixture Type: Project[.]

PATHWAY

the Lighting Source

PROJECT INFORMATION


309 W. JOHNSON STREET MADISON, WI

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PROGRESS DOCUMENTS


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Optional Accessories



PROJECT MANAGER:

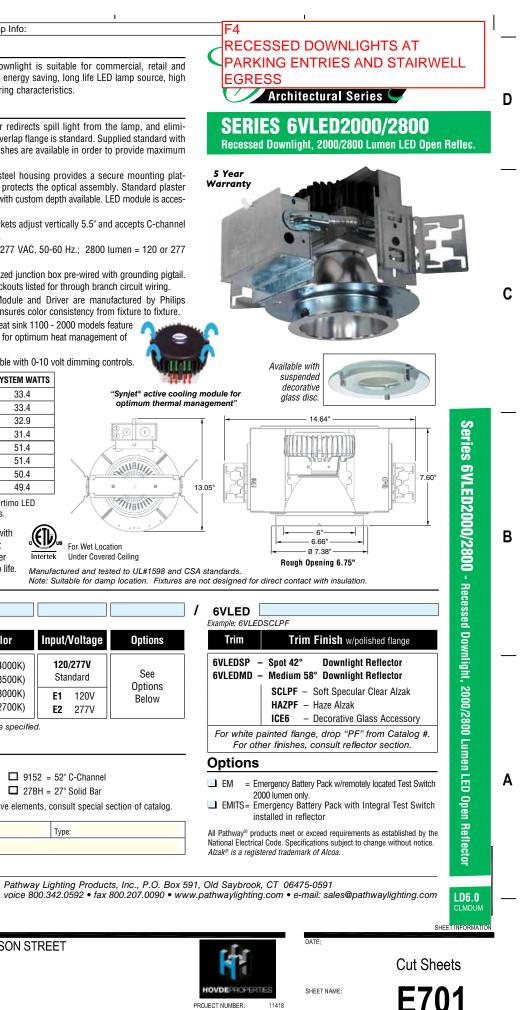SHEET NUMBER:

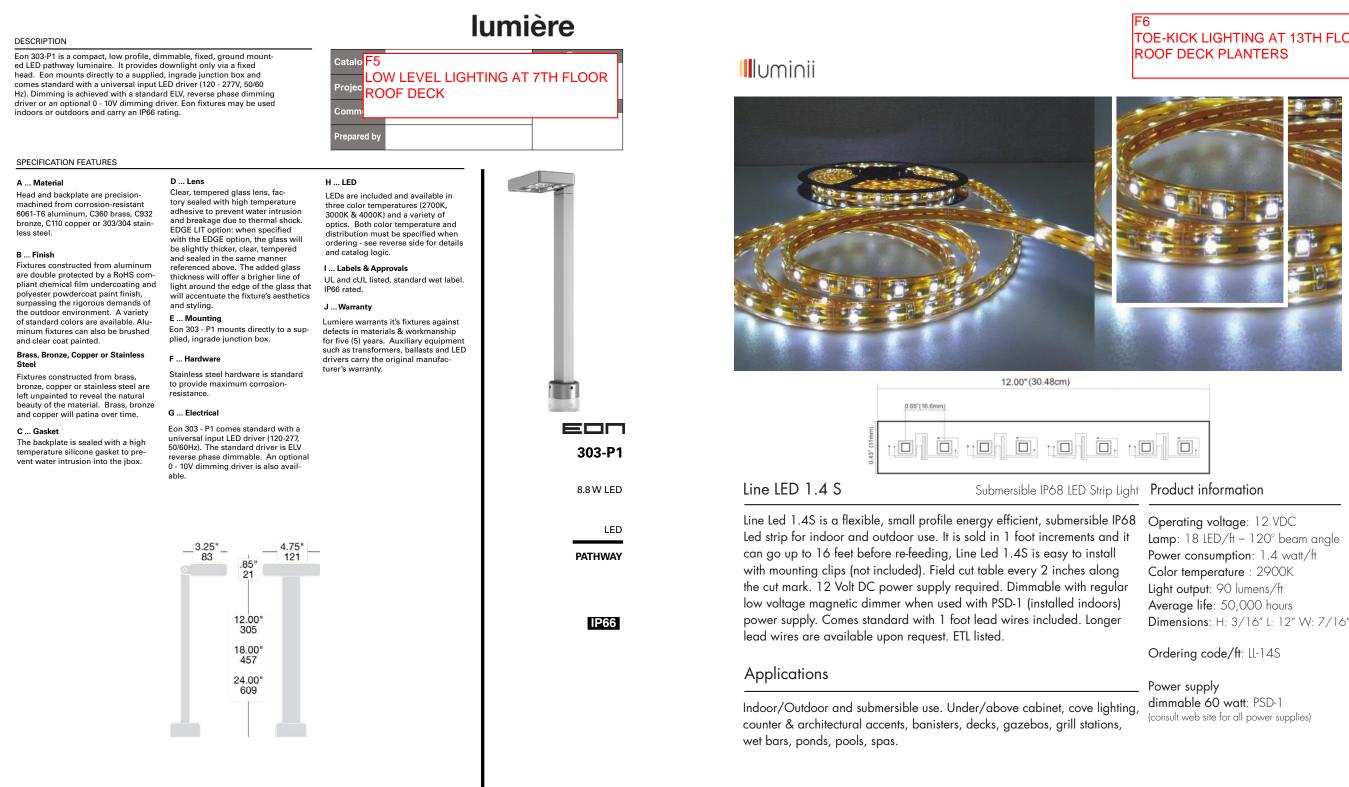

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ROJECT INFORMATIO

309 W. JOHNSON STREET MADISON, WI

madison 222 West Washington Ave, Suite 650 Madison, Wisconsin 53703 tel 608 442 5350 fax 608 442 6680

milwaukee 333 East Chicago Street Milwaukee, Wisconsin 53202

tel 414 271 5350 fax 414 271 7794

COOPER Lighting

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Specification and Dimensions subject to change without notice



JANCE AND REVISION

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PROGRESS DOCUMENTS

TOE-KICK LIGHTING AT 13TH FLOOR


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Line LED Wet Linear LED strip for wet locations - 12V

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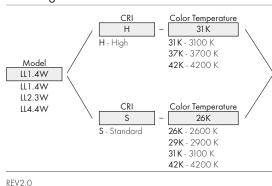


Technical specifications

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Models	LL1.4W	LL2.3W	LL4.4W
LEDs/ft	18	30	18
Average power consumption	1.4 watt/ft	2.3 watt/ft	4.4 watt/ft
Light output for 2900K	102 lum/ft	179 lum/ft	315 lum/ft
Amperage load at maximum run	2.6 A	3.0 A	4.0 A
Ordering increment	2.00″	1.25″	2.00″
Maximum run length	35 ft	27 ft	20 ft
Dimensions	0.40" W 0.11" H	0.32" W 0.11" H	0.48" W 0.11" H

Ordering code

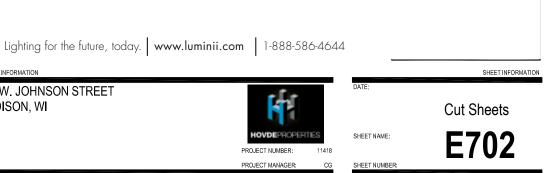



milwaukee 3.3.3 East Chicago Street Milwaukee, Wisconsin 53202 tel 414 271 5350 fax 414 2717794

222 West Washington Ave, Suite 650 Madison, Wisconsin 53703 tel 608 442 5350 fax 608 442 6680 madison

KEY PLAN



SUANCE AND REVISIONS

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PROJECT INFORMATION 309 W. JOHNSON STREET

MADISON, WI

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Iuminii Lighting for the future, today.

INDIRECT LIGHTING

AT 13TH FLOOR

ROOF DECK

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Line LED Wet is a small profile, energy efficient LED strip for wet locations. Available in the standard of 70 CRI as well as high of 80-85 CRI, the line LED has superior light output, a durable but flexible circuit board and it is very easy to install.

7

Due to the sealing bond needed to guarantee the wet-rating, exact lengths are required to order the line LED wet. Extending and turning corners in the field require custom production.

Avoid direct sunlight and UV ray exposure. UV protection required. If the line LED is enclosed in the Luminii provided extrusions (page 2) no extra UV protection is required other than the provided lense.

Applications: Indoor / outdoor use for under / above cabinet, cove lighting, counter accent, architectural accents, under banisters, display and book cases, decks, gazebos, barbeque stations and wet bars.

Operating voltage



12 VDC Operating temperature -40°F to 140°F (-40°C to 60°C) Beam Angle 120° Average life 30.000 hours Dimmable Low voltage magnetic dimmers. PSD series power supply required. Mounting

3M self-adhesive tape. Mounting to an aluminum profile or the HST aluminum heat sink tape is required to reach the rated 30,000 hours average life. (LL1.4 excluded)

Approvals ETL Class II wet listed

* Please note: LED color temperature availability dependent on CRI of choice



