APPLICATION FOR URBAN DESIGN COMMIS REVIEW AND APPROVAL	AGENDA ITEM # SSION Project # Legistar #
DATE SUBMITTED: $\frac{8/1/1}{1000000000000000000000000000000000$	Action Requested Informational Presentation Initial Approval and/or Recommendation Y Final Approval and/or Recommendation
ALDERMANIC DISTRICT: OWNER/DEVELOPER (Partners a 	and/or Principals) ARCHITECT/DESIGNER/OR AGENT: <u>JOHN W. GUTTON</u> <u>IO4 KILLA STREET</u> <u>IO3 MADISOH WI 53703</u> <u>A W. GUTTON</u> <u>KILLA STREET</u> <u>A GDP</u> ton Plan (GDP) tion Plan (SIP) pment (PCD) t Plan (GDP) tion Plan (SIP) pment (PCD) t Plan (SIP) pment (PCD) t Plan (GDP) tion Plan (SIP) pment (PCD) t Plan (SIP) pment (PCD) t Remodeling in an Urban Design District * (A public hearing is required as
(See Section B for:) New Construction or Exterior (See Section C for:) R.P.S.M. Parking Variance (I (See Section D for:) Comprehensive Design Revie Street Graphics Variance* (F Other	ew* (Fee required)
Where fees are required (as noted ab a project.	ove) they apply with the first submittal for either initial or final approval of

ZONING TEXT PUD(GDP-SIP) Aspen Court 211 South Bedford Street Madison, WI 53703

Legal Description: Lots 1, 2, and the southwest ½ of lot 3, block 30, Original Plat of the City of Madison, located in the SW ¼ of the NE ¼, Section 23, T7N, R9E, City of Madison, Dane County, Wisconsin.

A. Statement of Purpose: This zoning district is established for the development of 58 apartments with 62 total bedrooms, and 70 underground parking stalls.

- B. Permitted Uses:
 - 1. Residential uses as allowed in the R-6 zoning district.
 - 2. Uses accessory to permitted uses listed above.
- C. Lot Area: 22,011 square feet.
- D. Floor Area Ratio:
 - 1. Maximum floor area ratio permitted is 3.0.
 - 2. Maximum building height shall be four (4) stories or as shown on the approved SIP.
- E. Yard Requirements: Yard areas will be provided as shown on the approved SIP.
- F. Landscaping: The landscaping will be provided as shown on the approved SIP.

I. Signage: Signage will be allowed as per Chapter 31 of the Madison General Ordinances, as compared to the R-6 district, or as approved by Urban Design.

J. Family Definition: The family definition for this PUD-SIP shall coincide with the definition given in Chapter 28.03(2) of the Madison General Ordinances for the R-6 Zoning District.

K. Alterations and Revisions: No alteration or revision of this Planned Unit Development shall be permitted unless approved by the City Plan Commission; how ever, the Zoning Administrator may issue permits for minor alterations or additions which are approved by the Director of Planning and Development and the alderperson of the district and are compatible with the concept by the city Plan Commission. Legal Description for Aspen Court 211 South Bedford Street

Lots 1, 2, and the southwest ½ of Lot 3, Block 30, Original Plat of the City of Madison, located in the NW ¼ of the SE ¼, and the SW ¼ of the NE ¼, Section 23, T7N, R9E, City of Madison, Dane County, Wisconsin.

LETTER OF INTENT May 23, 2012

Revised July 31, 2012

PUD-GDP/SIP Submission - Aspen Court

211 South Bedford Street

Proposed by

Les Orosz Orosz Properties 505 University Avenue Madison, WI 53703

(608) 256-7368

Prepared by

Sutton Architecture	KEE Arch	nitecture	Quam Engineering
Plandesign			
104 King Street Albright	Doug Kozel	Ryan Quam	Andy
Madison, WI 53703			

(608) 469-2528

STATEMENT OF RATIONALE (MARKET)

This submittal is to redevelop lots 1, 2, and the SE half of lot 3 in block 30. We have identified the goals of the neighborhood plan as well as the downtown plan that will be release shortly. We have also worked with the neighborhood to identify a scale and density that works for them as well as the owner. This location has great access to all areas of the city, including by bus and bicycle paths.

This area has seen major interest for high end apartments. Young professionals continue to look in this neighborhood for desirable housing. Madison's unique isthmus limits the amount of land that is available for development, making the demand even greater. Also the increase in student housing closer to campus has helped to enhance the desire for market rate apartments east of West Washington Avenue.

FEASABILITY

This site has great access and is adjacent to several newer developments. Some are condominiums that will benefit from developing upscale rental in place of tired student residential housing stock. Even though there are more apartments being proposed, it appears the market needs more units. The major user is coming from Epic, which continues to expand and hire more employees. We do not see this trend changing. Also, a large sector in the housing market is looking to rent better apartments rather than buy. With several interesting projects in the same area, it generates stronger interest from this group.

PROJECT DESCRIPTION

Parking will be underground, providing 70 parking spots, with two HDC- accessible. There will also be bicycle, moped, and motorcycle parking in a dedicated area of the underground parking structure. There will be a total of 58 apartments. The mix will be 50 one bedroom that vary from 440 to 840 square feet, 4 one bedroom plus den with 795 square feet, and 4 two bedroom units with 1,165 square feet. We will also have a work out area on the first floor.

POTENTIAL IMPACTS (AMENITIES)

This site has tremendous visibility, but is currently underwhelming in use and architecture. The proposed development provides a great opportunity to continue to improve the quality of housing in this location. Even though this is not considered a large development, we are providing amenities that will help the neighborhood. This includes a loading facility, sufficient underground parking, additional landscaping, and bike racks for tenants and the general public.

Our site is on the city bus route for easy access anywhere in the city. Also, we are connected to city bike paths. These are great transportation amenities for the tenants. We are also near the square, city parks, Lake Monona, and major vehicular arteries.

NEIGHBORHOOD CONTEXT (DENSITY)

We have worked closely with the neighborhood to develop the program and architecture. We are also following the neighborhood plan as well as the soon-to-be release downtown plan. We have paid particular attention to breaking up the massing and creating individual entrances for the first floor apartments.

This location in the Bassett neighborhood was identified as a transition area that could handle higher density for multi-family housing.

OPEN SPACE

Our open space will consist of one large side lot area of 1,430 square feet, one large terrace garden area of 3,550 square feet and one small courtyard of 500 square feet. All but three apartments will have decks or terraces. They will vary from 60 to 110 square feet, for an additional 3,564 square feet. The total open space will be 9,044 square feet.

PARKING AND ACCESS

We will have 70 parking stalls on two levels of underground parking. Two of these stalls will be HDCP-accessible. There will also be a 10' by 35' service bay stall. Both driveways will be from Bedford Street, which we feel is the street which has heavier traffic use.

MANAGEMENT

The facility will be managed by the owners management company located at 505 University Avenue. They have daily office hours from 8:00 a.m. to 5:00 p.m.. After hours, they have an emergency number the residents can call.

BIKE PARKING

We will have racks for 12 bikes for public use and 90 for residential use. The residential storage will be in the underground parking area. We will modify bike stalls to moped stalls as needed.

CURRENT ZONING

The existing zoning is R-6. The following is a comparison with what would be required by the current zoning and what we are actually providing.

	actual lot	required
Lot Area:	21,780 s.f.	26,700 s.f.
Floor Area Ratio:	3.0	2.0
Footprint:	55% lot coverage	40%
Yard Requirement:	5' front 11' side 5' street side 5' rear	10' front 5' side 10' street side 5' rear
Useable Open Space:	9,044 s.f.	4,340 s.f.
Off Street Parking:	71	58
Bike stalls:	90	62
Off Street Loading:	1	1
Height:	4 story	4 story

PROJECT SCHEDULE

August, 2012:	Demolition.
September, 2012:	Excavation and start of construction.
June, 2013:	Completion.

PROJECT TEAM

Owner:	Les Orosz
Architect:	Sutton Architecture and Douglas Kozel AIA
Civil:	Quam Engineering
Structural:	GKS Engineering
Landscape:	Andy Albright

GENERAL DESIGN STANDARDS

Architectural Design

The massing of the building will be minimized by major setbacks as will as utilizing bumpouts that will only extend three stories. The entire underground parking structure will have a masonry veneer wherever it extends above grade from a minimum of two feet to a maximum of five feet. The bumpouts will have a brick veneer. The main body of the structure will have a 5" exposed lap cement board siding. The two major setbacks (street courtyard entrance and main entry) will have a horizontal cortin metal shingle with concealed fasteners.

Utilities

All utility service within the proposed development will be provided underground. All utilities are accessed on the site and will not require excavation into the street. Existing utility poles will be eliminated whenever possible. See utility plan.

Storm Drainage

All storm water for the structures will drain toward West Doty Street. We will tie into the storm pipe on West Doty Street and have a sediment catch basin on site. We will also utilize rain barrels to catch the first flush from the roof drainage for site landscape watering.

Site Lighting

The design of all site lighting will be coordinated to complement the site design and architectural character of the building.

All fixtures will be positioned with care taken to direct light away from windows and street traffic. Most lighting will not be seen, using can fixtures at all entrances and down lights on the decks. We will provide recessed wall lights at the base of the masonry wall to light just the immediate sidewalk for additional safety and welcoming aesthetics. We will also use steel channel shapes with LED down lights for accents along the private sidewalk into the garden terrace entrance. LED's will be used as much as possible.

Signs

The building will be identified with the project name on the face of the masonry as well as the building number.

Service Area

Trash collection is in a trash room accessible to all residential tenants on the first parking level, near the garage entry. The trash area will handle all recycling material as well.

Landscaping


The landscaping plan provides durable plantings at the perimeter of the building with increased color identifying the entrance areas. We will maintain all terrace trees. The main terrace garden will have large planters with small ornamental trees and smaller plantings with a maintenance path though it. We will have additional landscape features such as an arbor and lighted bollards constructed out of steel shapes to match the building architecture.

Walkways

All walkways will be constructed of concrete to match existing sidewalks. The existing sidewalk will be replaced along the entire lot. We are also proposing individual access to the first floor units from the sidewalk. These access points will be marked as private.

Parking Areas

We will have 70 parking stalls for the 58 unit. The stalls will be "one size fits all", 8'-9" by 17'-0", with 23'-0" drive aisles. Two underground stall will be HDCP accessible and near the elevator. We will have a dedicated area for bikes capable of handling 90 bicycles. We will convert bike stalls to mopeds as needed, as well as car stalls.

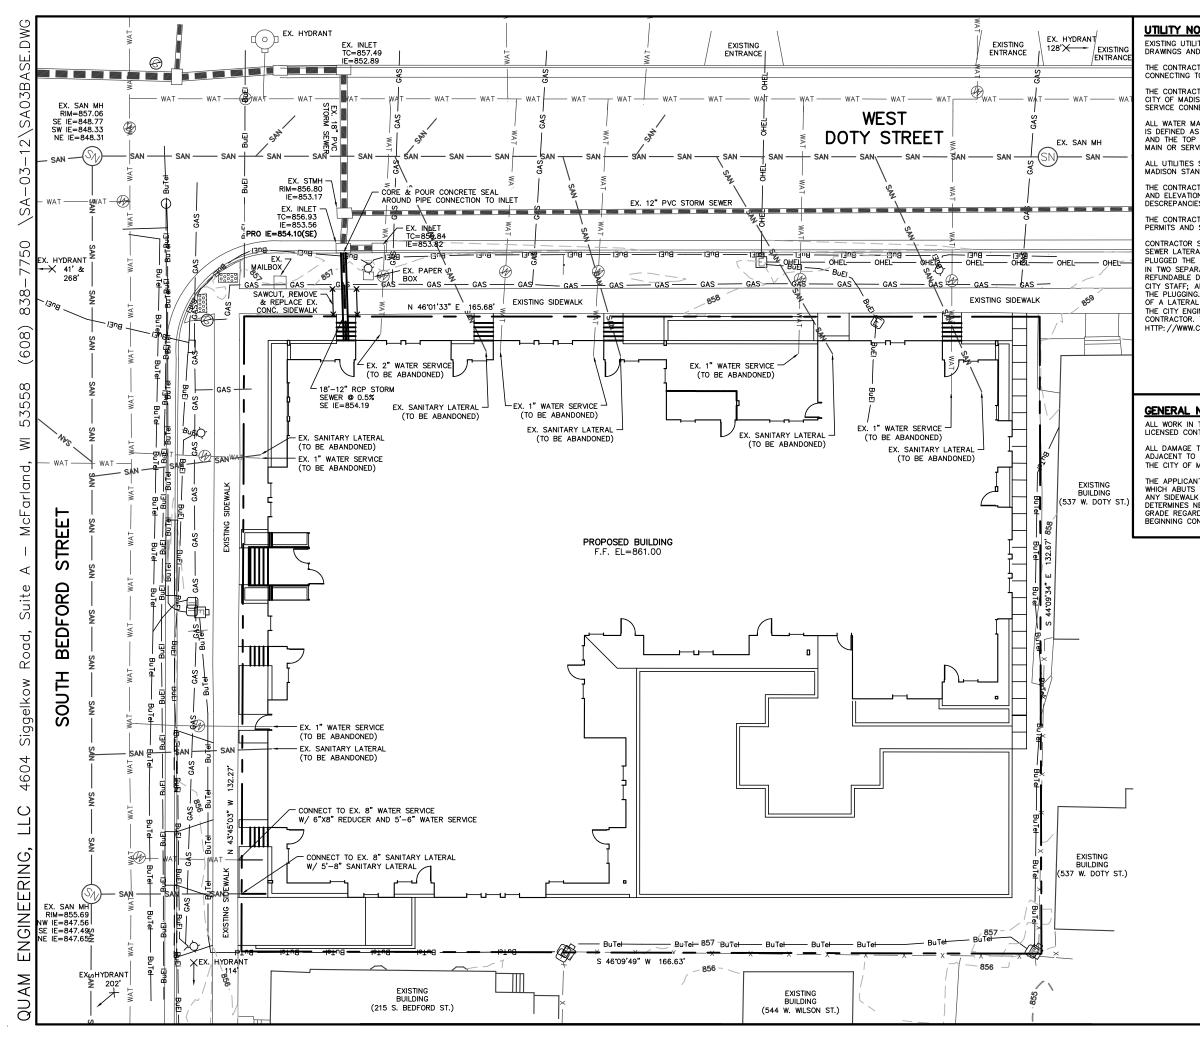

OTES:	SUTTON
TIES SHOWN WERE OBTAINED FROM CITY OF MADISON RECORD ID MARKED UTILITIES.	ARCHITECTURE
CTOR SHALL CONTACT CITY OF MADISON UTILITIES PRIOR TO TO EXISTING SANITARY SEWER AND WATER MAIN.	104 King Street Miedicon, Wi 80703 Tol. 666-687-666 Pint 606-687-6764
CTOR SHALL SUBMIT THE APPLICATION FOR SERVICE TO THE SON WATER UTILITY TO OBTAIN THE PERMIT FOR THE WATER NECTIONS.	
IAIN SHALL BE BURIED TO A DEPTH OF 6.5 FEET. THE DEPTH S THE DISTANCE BETWEEN THE FINISHED GRADE ELEVATION > OF WATER VICE.	
SHALL BE CONSTRUCTED IN ACCORDANCE TO CITY OF NDARD SPECIFICATIONS.	
CTOR SHALL VERIFY ALL UTILITY LOCATIONS, SIZES, MATERIALS, DNS PRIOR TO THE START OF CONSTRUCTION. ANY ES SHALL BE REPORTED TO ENGINEER.	
TOR SHALL OBTAIN ALL NECESSARY SEWER CONNECTION SEWER PLUGGING PERMITS PRIOR TO ANY UTILITY WORK.	
SHALL OBTAIN A PERMIT TO PLUG THE EXISTING SANITARY (AL THAT IS TO BE ABANDONED. FOR THE LATERAL TO BE CONTRACTOR SHALL DEPOSIT \$1,000 WITH THE CITY ENGINEER RATE CHECKS IN THE FOLLOWING AMOUNTS: (1). \$100 NON DEPOSIT FOR THE COST OF INSPECTION OF THE PLUGGING BY AND (2). \$900 FOR THE COST OF CITY CREWS TO PERFORM G. IF THE CONTRACTOR ELECTS TO COMPLETE THE PLUGGING L SITE AND THE PLUGGING IS INSPECTED AND APPROVED BY SINEER, THE \$900 FOR THE SHALL BE RETURNED TO THE THIS PERMIT APPLICATION IS AVAILABLE ONLINE AT CITYOFMADISON.COM/ENGINEERING/PERMITS.CFM	
NOTES:	
THE PUBLIC RIGHT-OF-WAY SHALL BE PERFORMED BY A CITY VIRACTOR.	- 「 ¹⁴⁵ 53 53 53 558
TO THE PAVEMENT ON SOUTH BEDFORD AND WEST DOTY, D THE DEVELOPMENT SHALL BE RESTORED IN ACCORDANCE WITH MADISON'S PAVEMENT PATCHING CRITERIA.	G, LL (1 Consultants . Wisconsin : 838-7752
NT SHALL REPLACE ALL SIDEWALK AND CURB AND GUTTER THE PROPERTY WHICH IS DAMAGED BY THE CONSTRUCTION OR	ERINC bite Design ing.com McFarland. Fax (608)
K AND CURB AND GUTTER WHICH THE CITY ENGINEER VEEDS TO BE REPLACED BECAUSE IT IS NOT AT A DESIRABLE RDLESS OF WHETHER THE CONDITION EXISTED PRIOR TO INSTRUCTION.	VGINEEF commercial Site mengineering. Suite A - Mer 338-7750; Fax
	QUAM ENGINEERIN Residential and Commercial Site Deside www.quamengineering.com 4604 Siggelkow Road, Suite A - McFarlan Phone (608) 838–7750; Fax (608)
TO OBTAIN LOCATION OF PARTICIPANTS' UNDERGROUND FACILITES BEFORE YOU DIG IN WISCONSIN CALL DIGGERS HOTLINE 1-800-242-8511 TOLL FREE TDD(FOR THE HEARING IMPAIRED)(800)542-2289 WIS. STATUTE 182.0175 (1974) REQUIRES MIN. OF 3 WORK DAYS NOTCE BEFORE YOU EXCAVATE	OWNER Les Orosz (608) 347-5432 University Avenue Madison, Wisconsin PROJECT Aspen Court
	Apartments 211 South Bedford Street Madison, Wisconsin 53703 DRAWING UTLITY PLAN
	DATA Project + 201212 Date 052122 Drewn by RD.Q.

ZONING MAP

Aspen Court 211 South Bedford Street

OWNER Les Orosz

505 University Avenue Madison, WI 53703

SITE DATA

BUILDING SIZE CONSTRUCTION TYPE BUILDING HEIGHT NUMBER OF STORIES NUMBER OF LEVELS OCCUPANCY TYPE LOT SIZE PARKING BIKE PARKING LOADING FACILITY ZONING

49,475 SQUARE FEET 5B 44'-4" 4 6 R2 22,011 SQUARE FEET 70 98 PUD

(608)256-7368

INDEX

- TI.I TITLE SHEET
- CI.I SURVEY
- CI.2 SITE PLAN
- CI.3 GRADING & EROSION CONTROL PLAN
- CI.4 UTILITY PLAN
- LI.I LANDSCAPE PLAN
- LI.2 EXTERIOR DECK PLAN

AI.I PARKING LEVEL B FLOOR PLAN

- AI.2 PARKING LEVEL A FLOOR PLAN
- AI.3 FIRST FLOOR PLAN
- AI.4 SECOND FLOOR PLAN (3RD SIMILAR)
- AI.5 FOURTH FLOOR PLAN
- AI.6 ROOF PLAN
- A2.1 SW AND NW ELEVATIONS
- A2.2 SE AND NE ELEVATIONS
- A2.3 SE AND NE SECTION/ELEVATIONS
- A3.1 WALL SECTIONS
- A3.2 WALL SECTIONS
- A3.3 WALL SECTIONS & DETAILS

DRAWING

TITLE SHEET LOCATION/ZONING MAP

SUTTON

ARCHITECTURE

I. 608-469-2528 Fax 608-255-1764

DESIGN CONSULTANT

CIVIL ENGINEERING

DOUGLAS KOZEL AIA KEE ARCHITECTURE

RYAN QUAM

QUAM ENGINEERING


LANDSCAPE

ANDY ALBRIGHT PLANDESIGN


104 King Street Madison, WI 53703

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Date:	07.31.12
Drawn by:	jws

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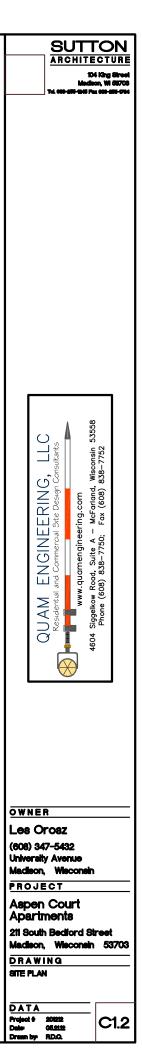


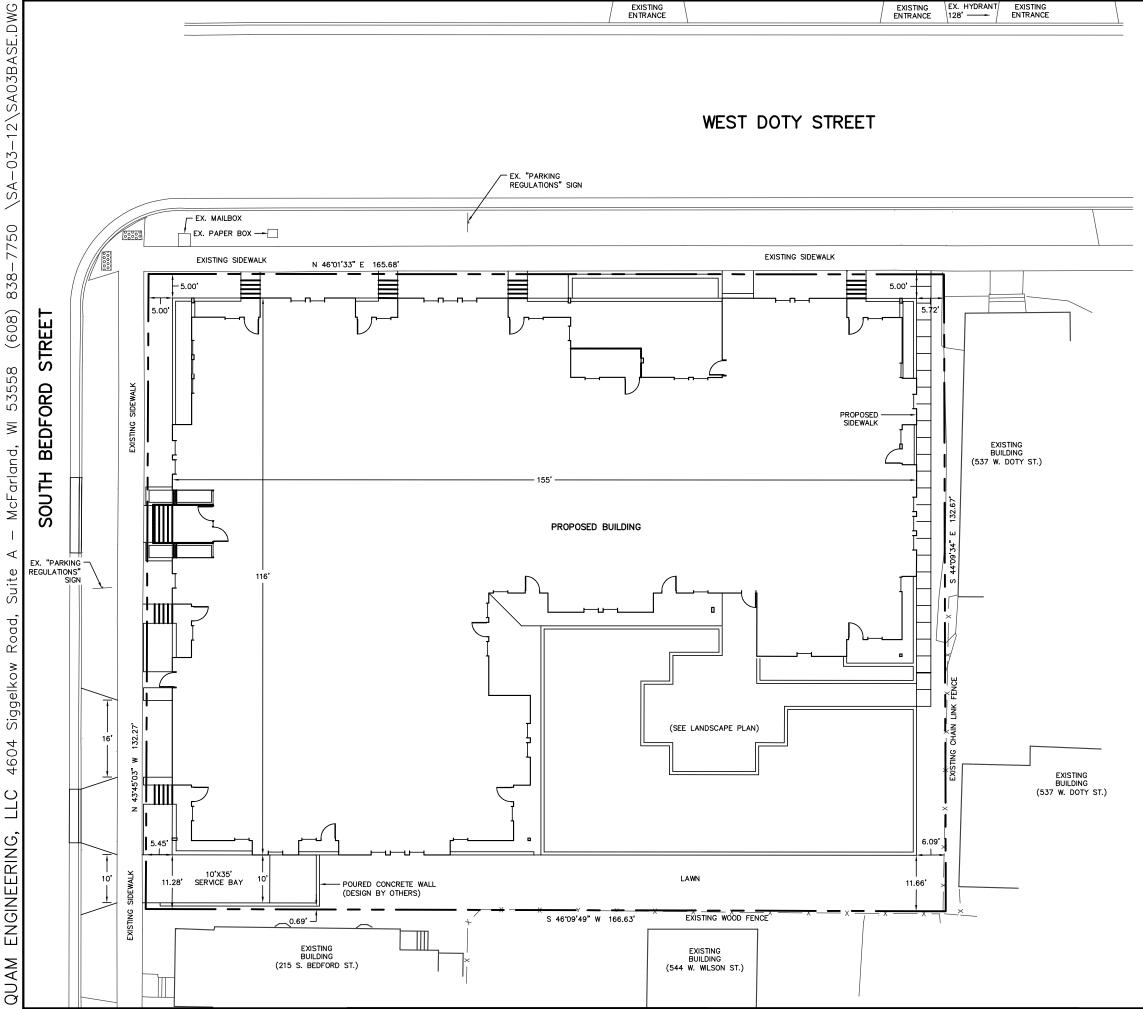
\SA-03-12\SA03BASE.DWG 838-7750 (608) 53558 \ge McFarland, \triangleleft Suite Road, Siggelkow 4604 LLC ENGINEERING,

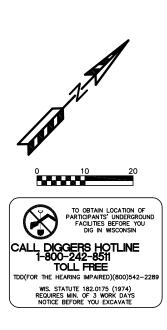



DUMPSTER NOTE
THERE WILL BE NO DUMPSTER POSITION ON
THE SITE AND THE GARBAGE REMOVAL WILL
BE MANAGED WITHIN THE BUILDING.


PARKING LOT	PLAN SITE INFO	RMATION BLOCK	
Site Address <u>211 SOUTH BEDFORD STREET</u> Site acreage (total) <u>0.50 ACRES</u>			
Number of building stories (above grade) <u>FOUR</u> Building height <u>44-4</u> DILHR type of construction (new structures or additions) <u>5B</u> Total square footage of building <u>12,597</u>			
Use of property <u>APARIMENTS</u> Gross square feet of office <u>N/A</u> Gross square feet of reali orea <u>N/A</u> Number of employees in worehouse <u>N/A</u> Number of employees in production <u>N/A</u> Copacity of restaurant/place of assembly <u>N/A</u>			
Number of bicycle stalls shown (SEE PARKING PLAN)			
Number of Parking stalls: (SEE PARKING PLAN)			
		SHOWN	
	Small Car	0	
	Large Car	0	
	Accessible	0	
	Total	0	
Number of trees shown (See Landscape Plan)			




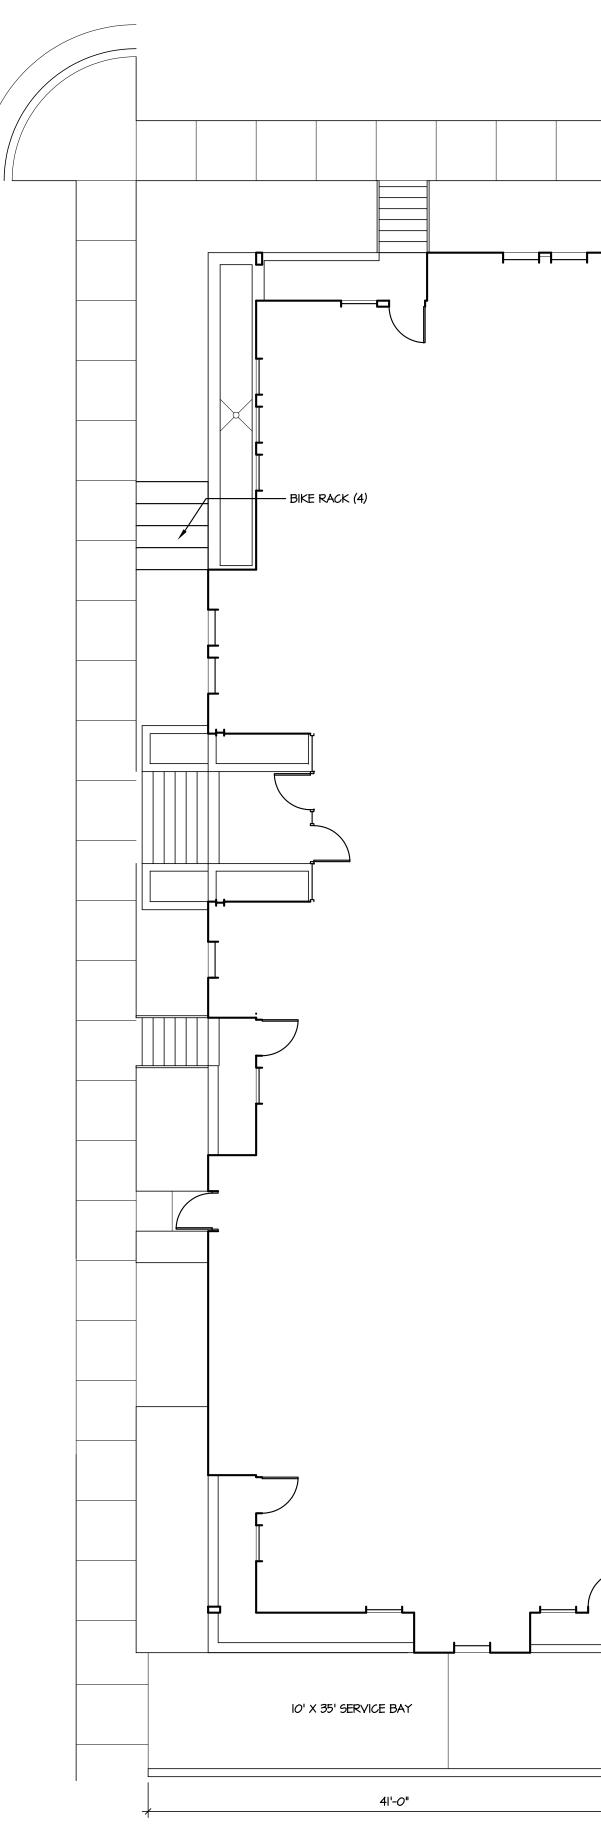


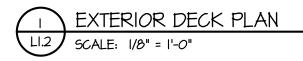


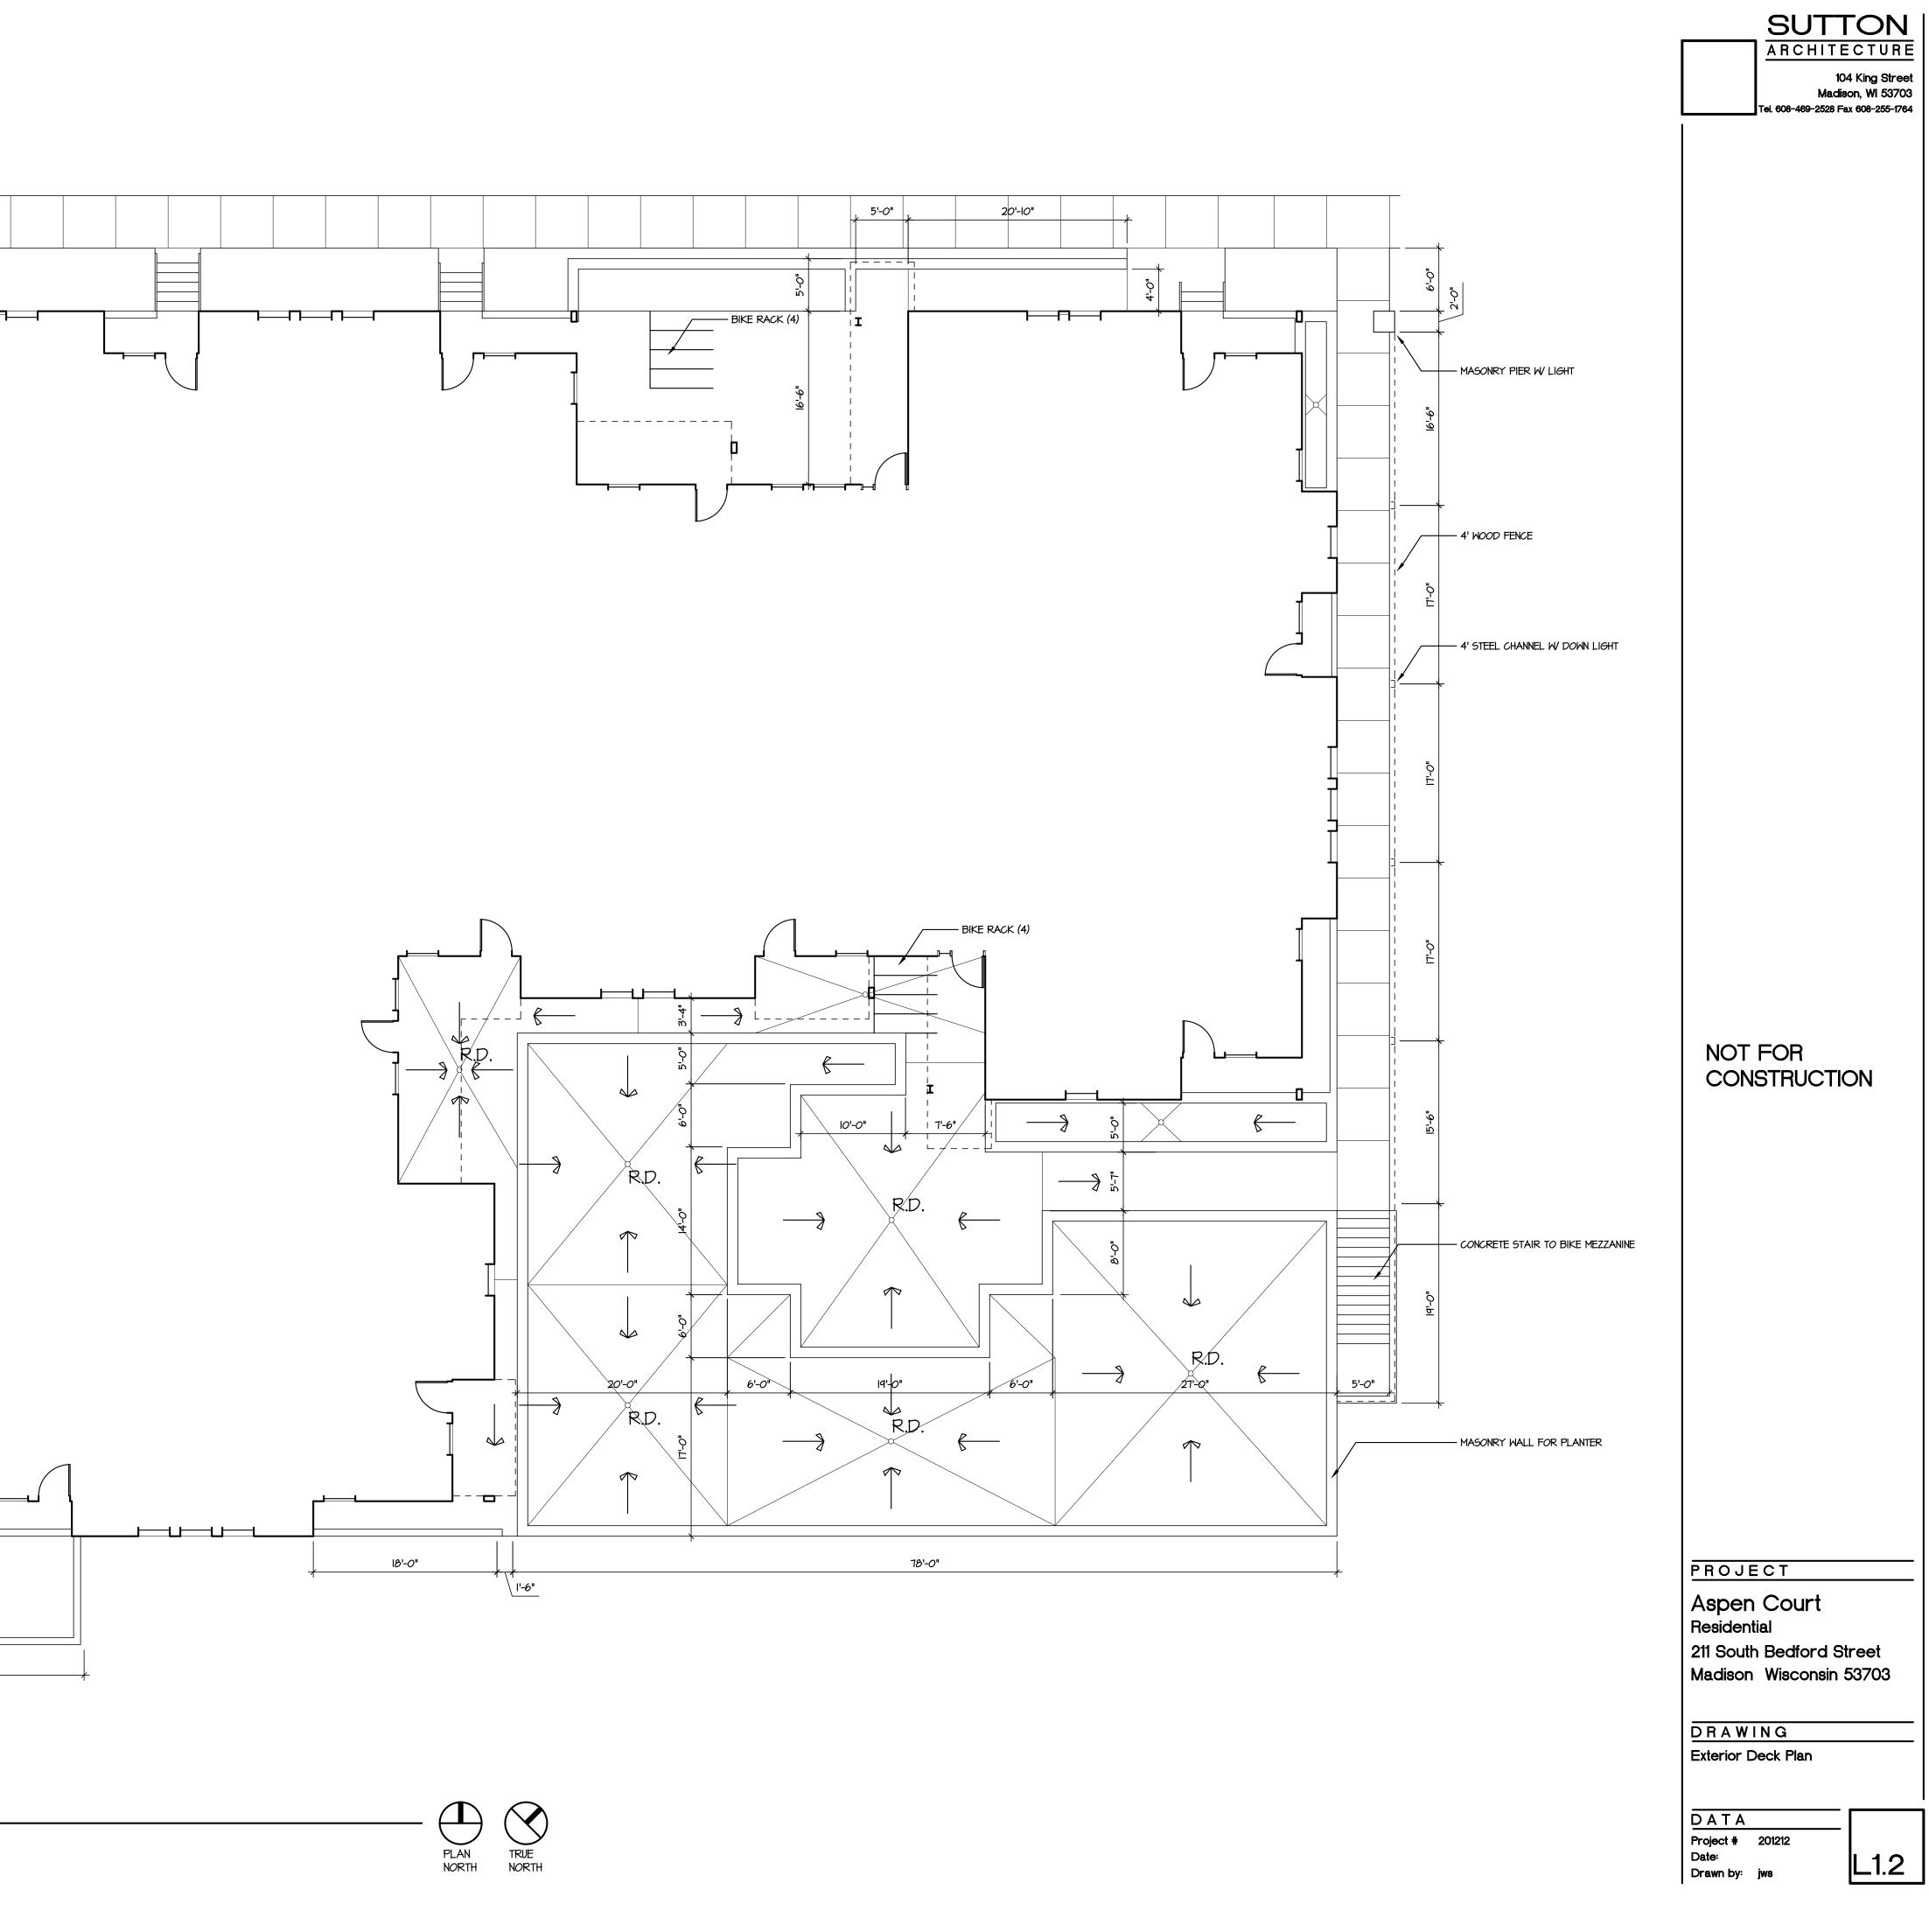

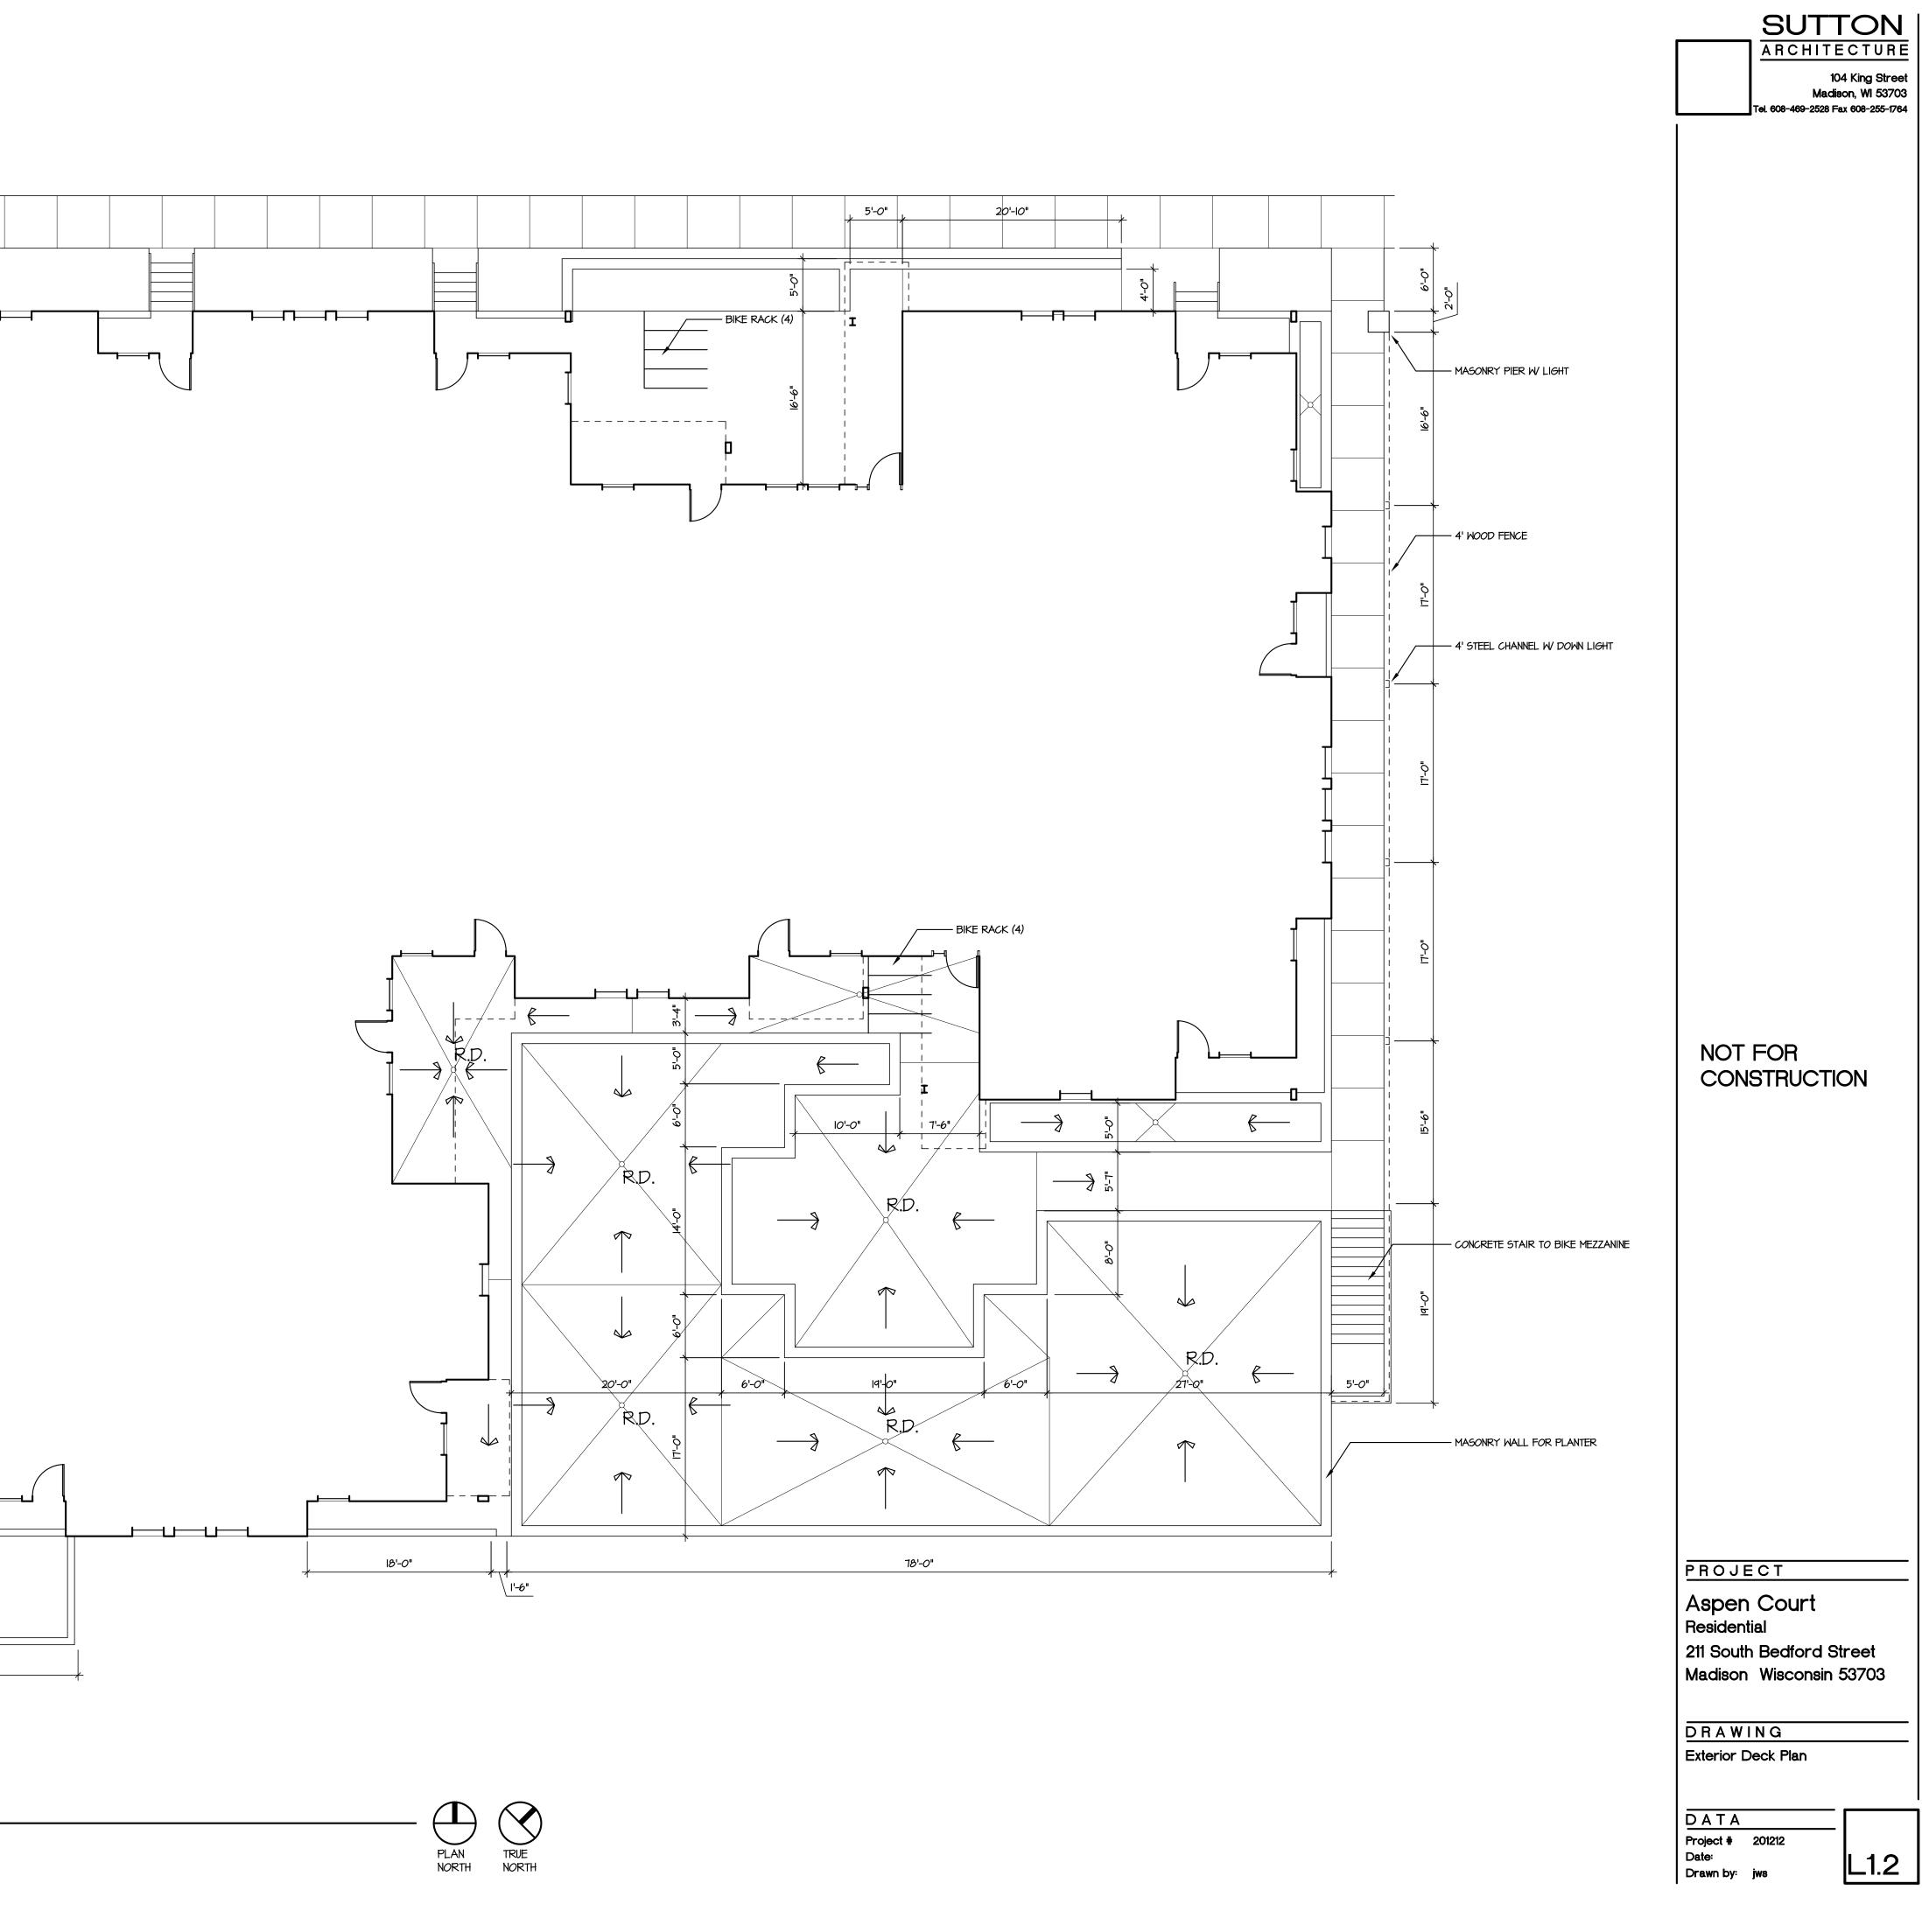


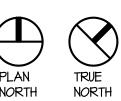


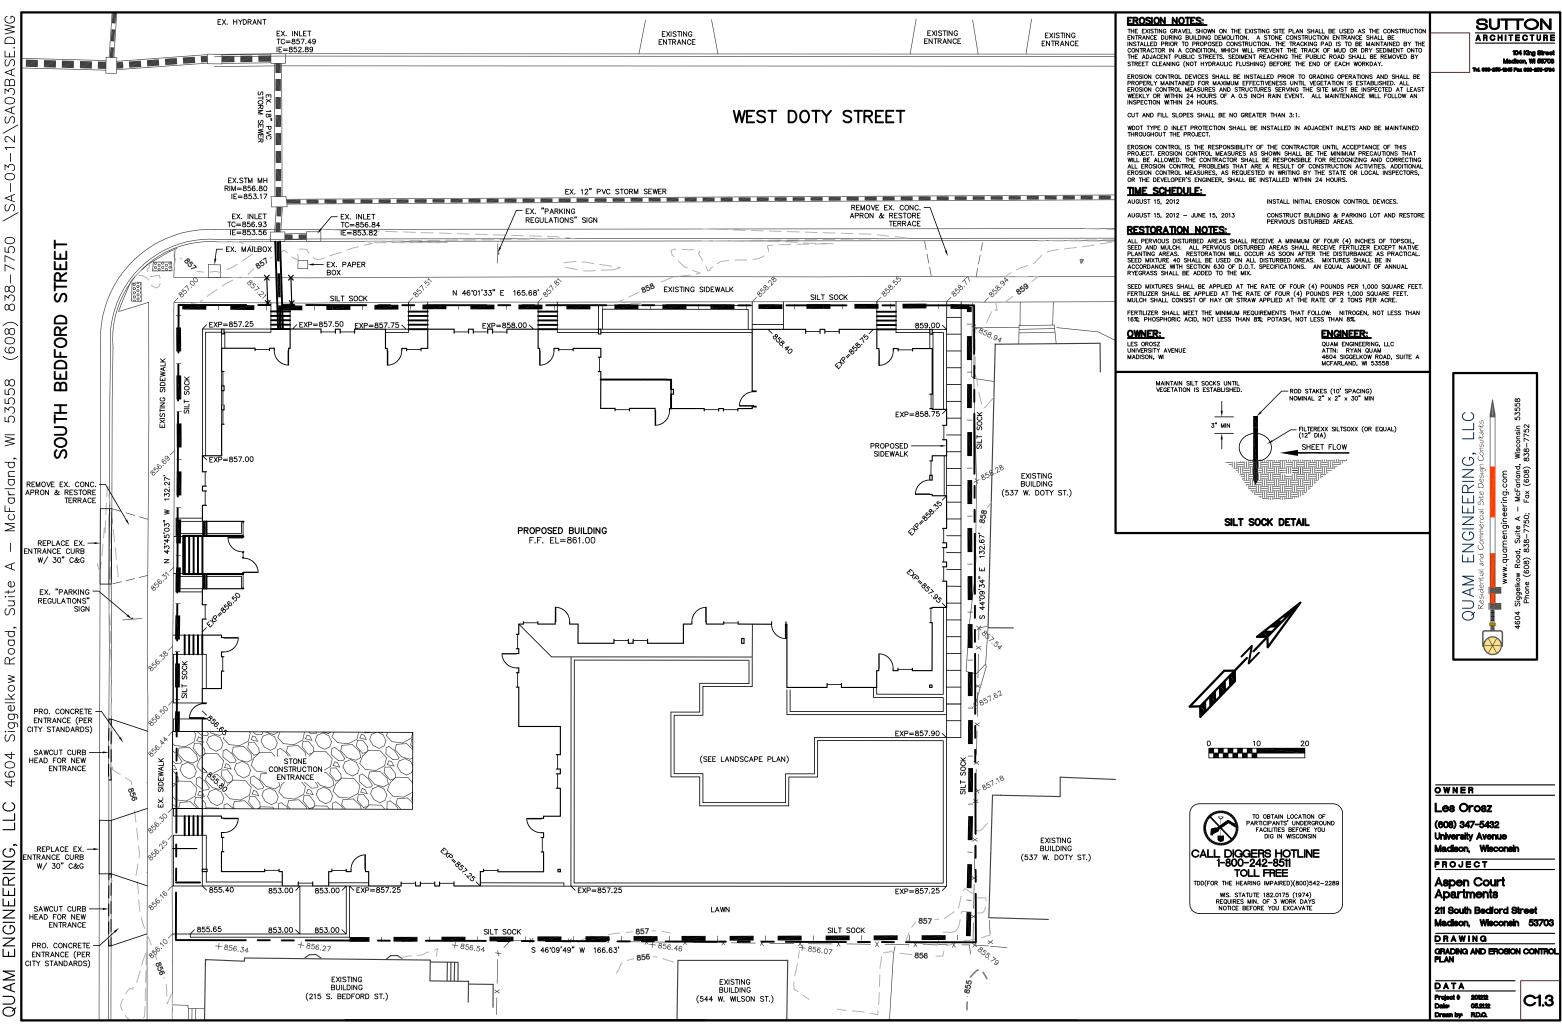


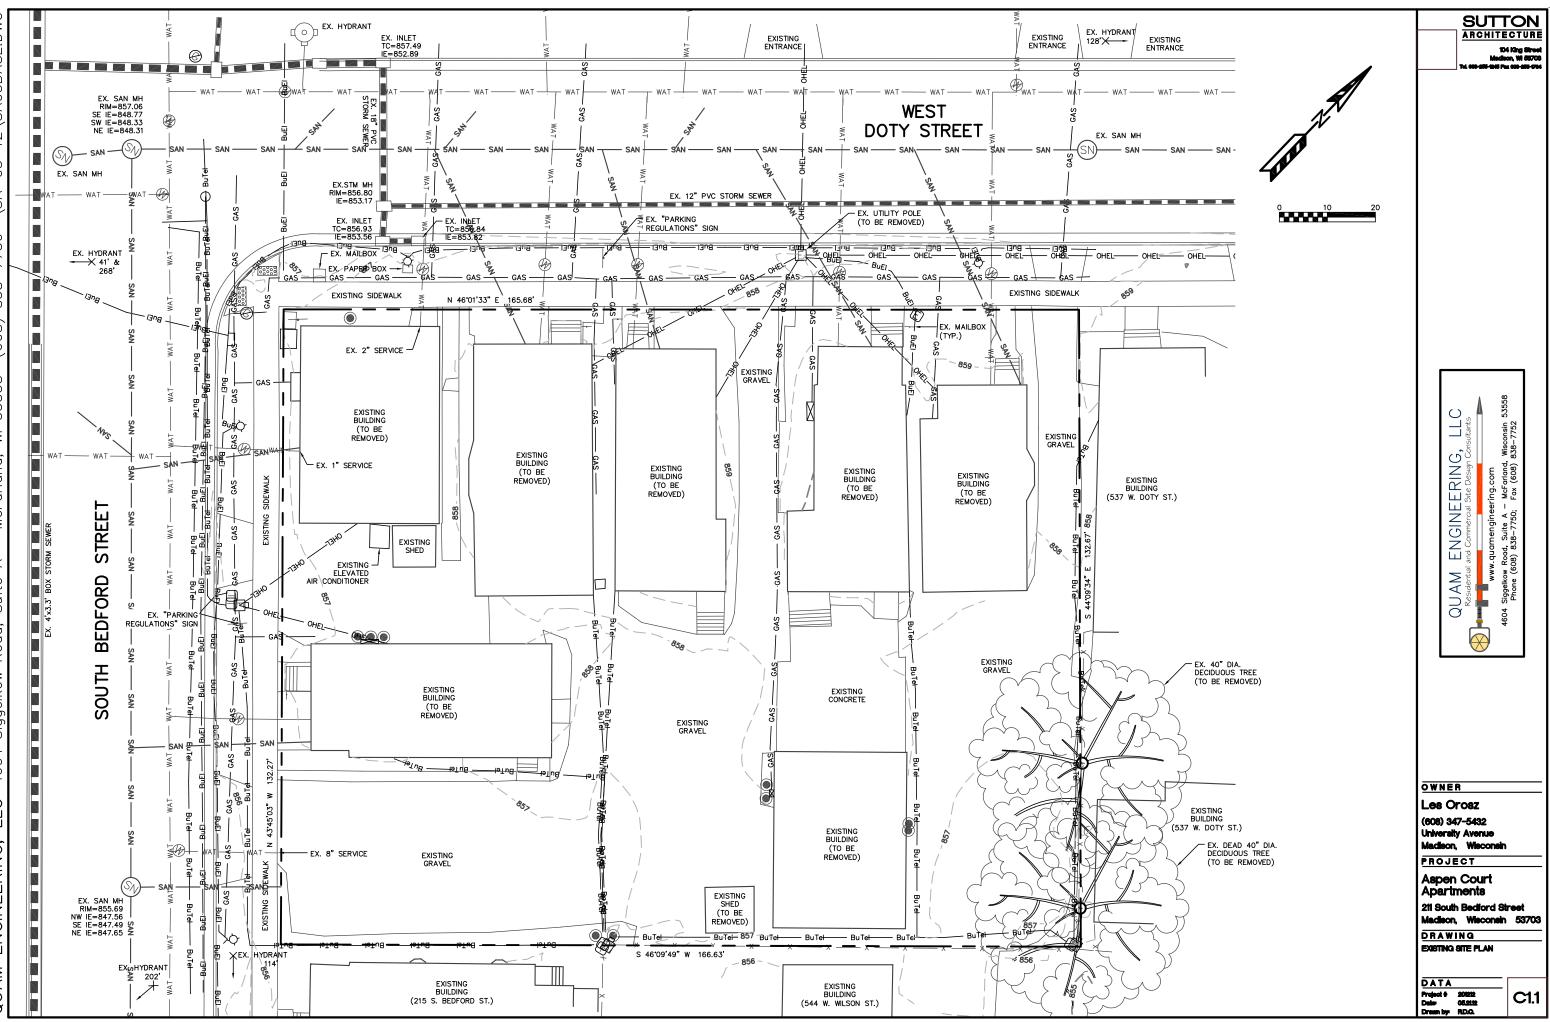


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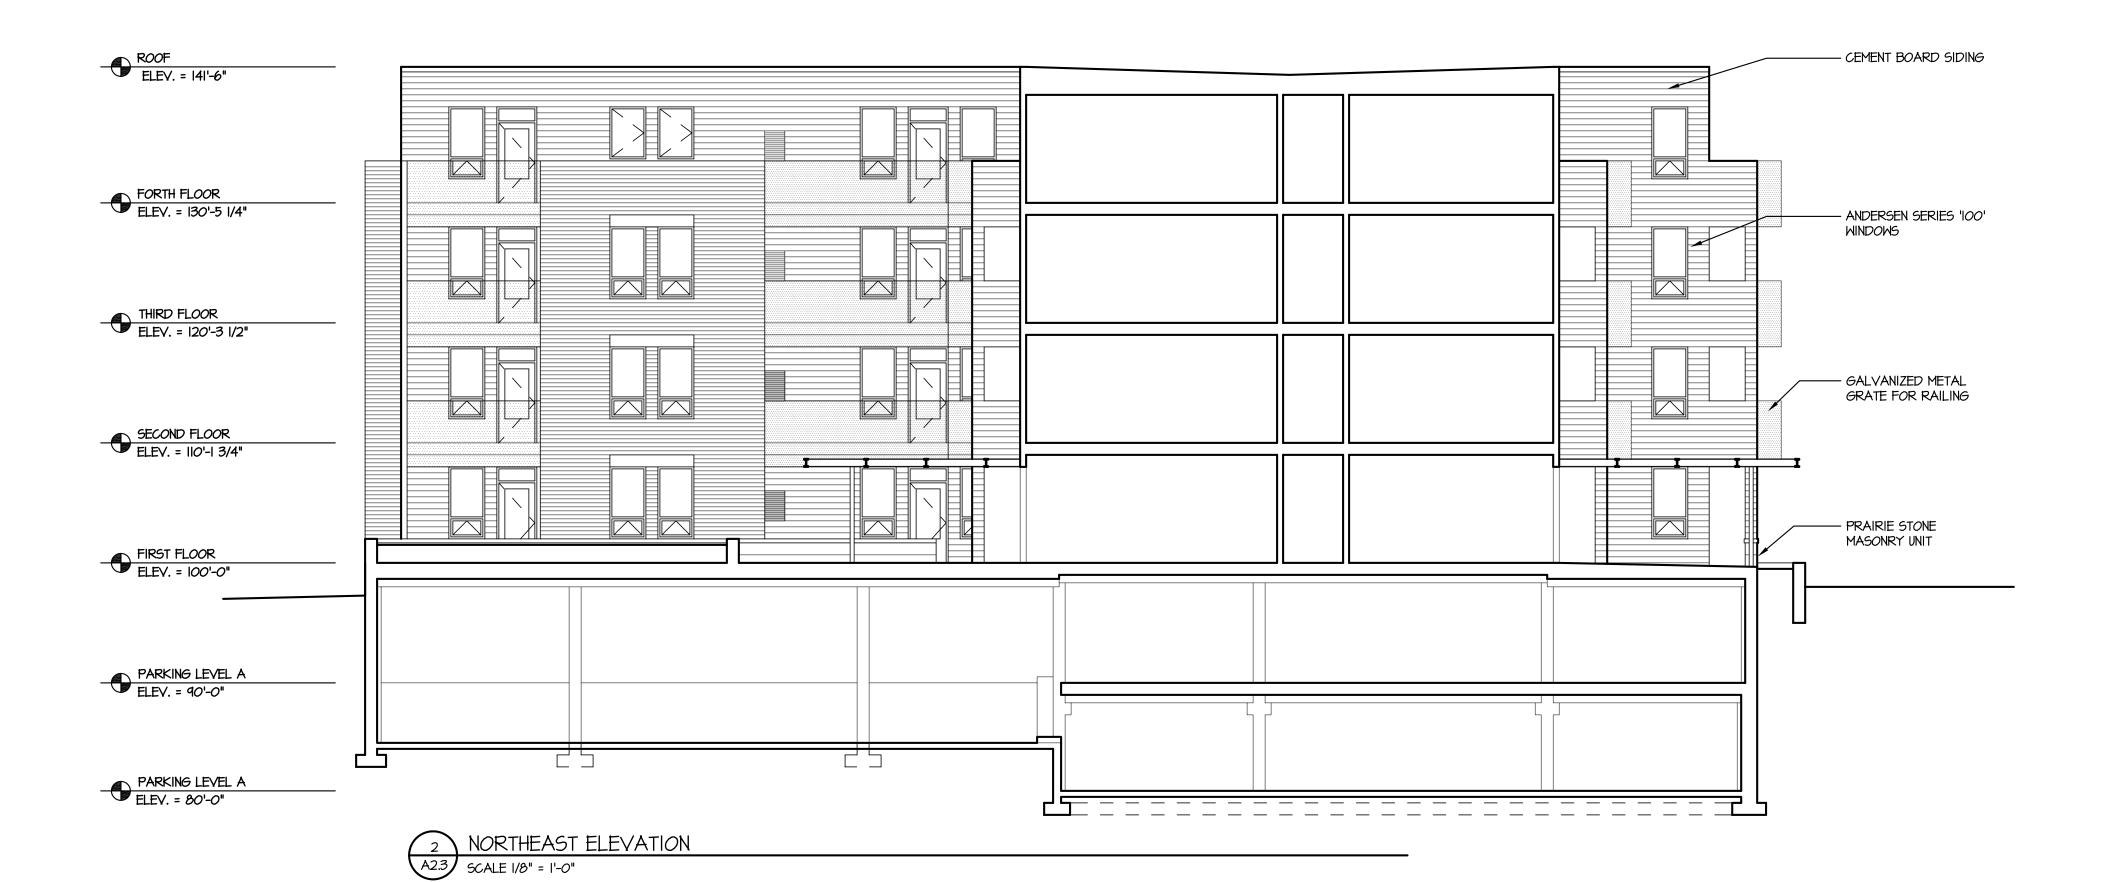


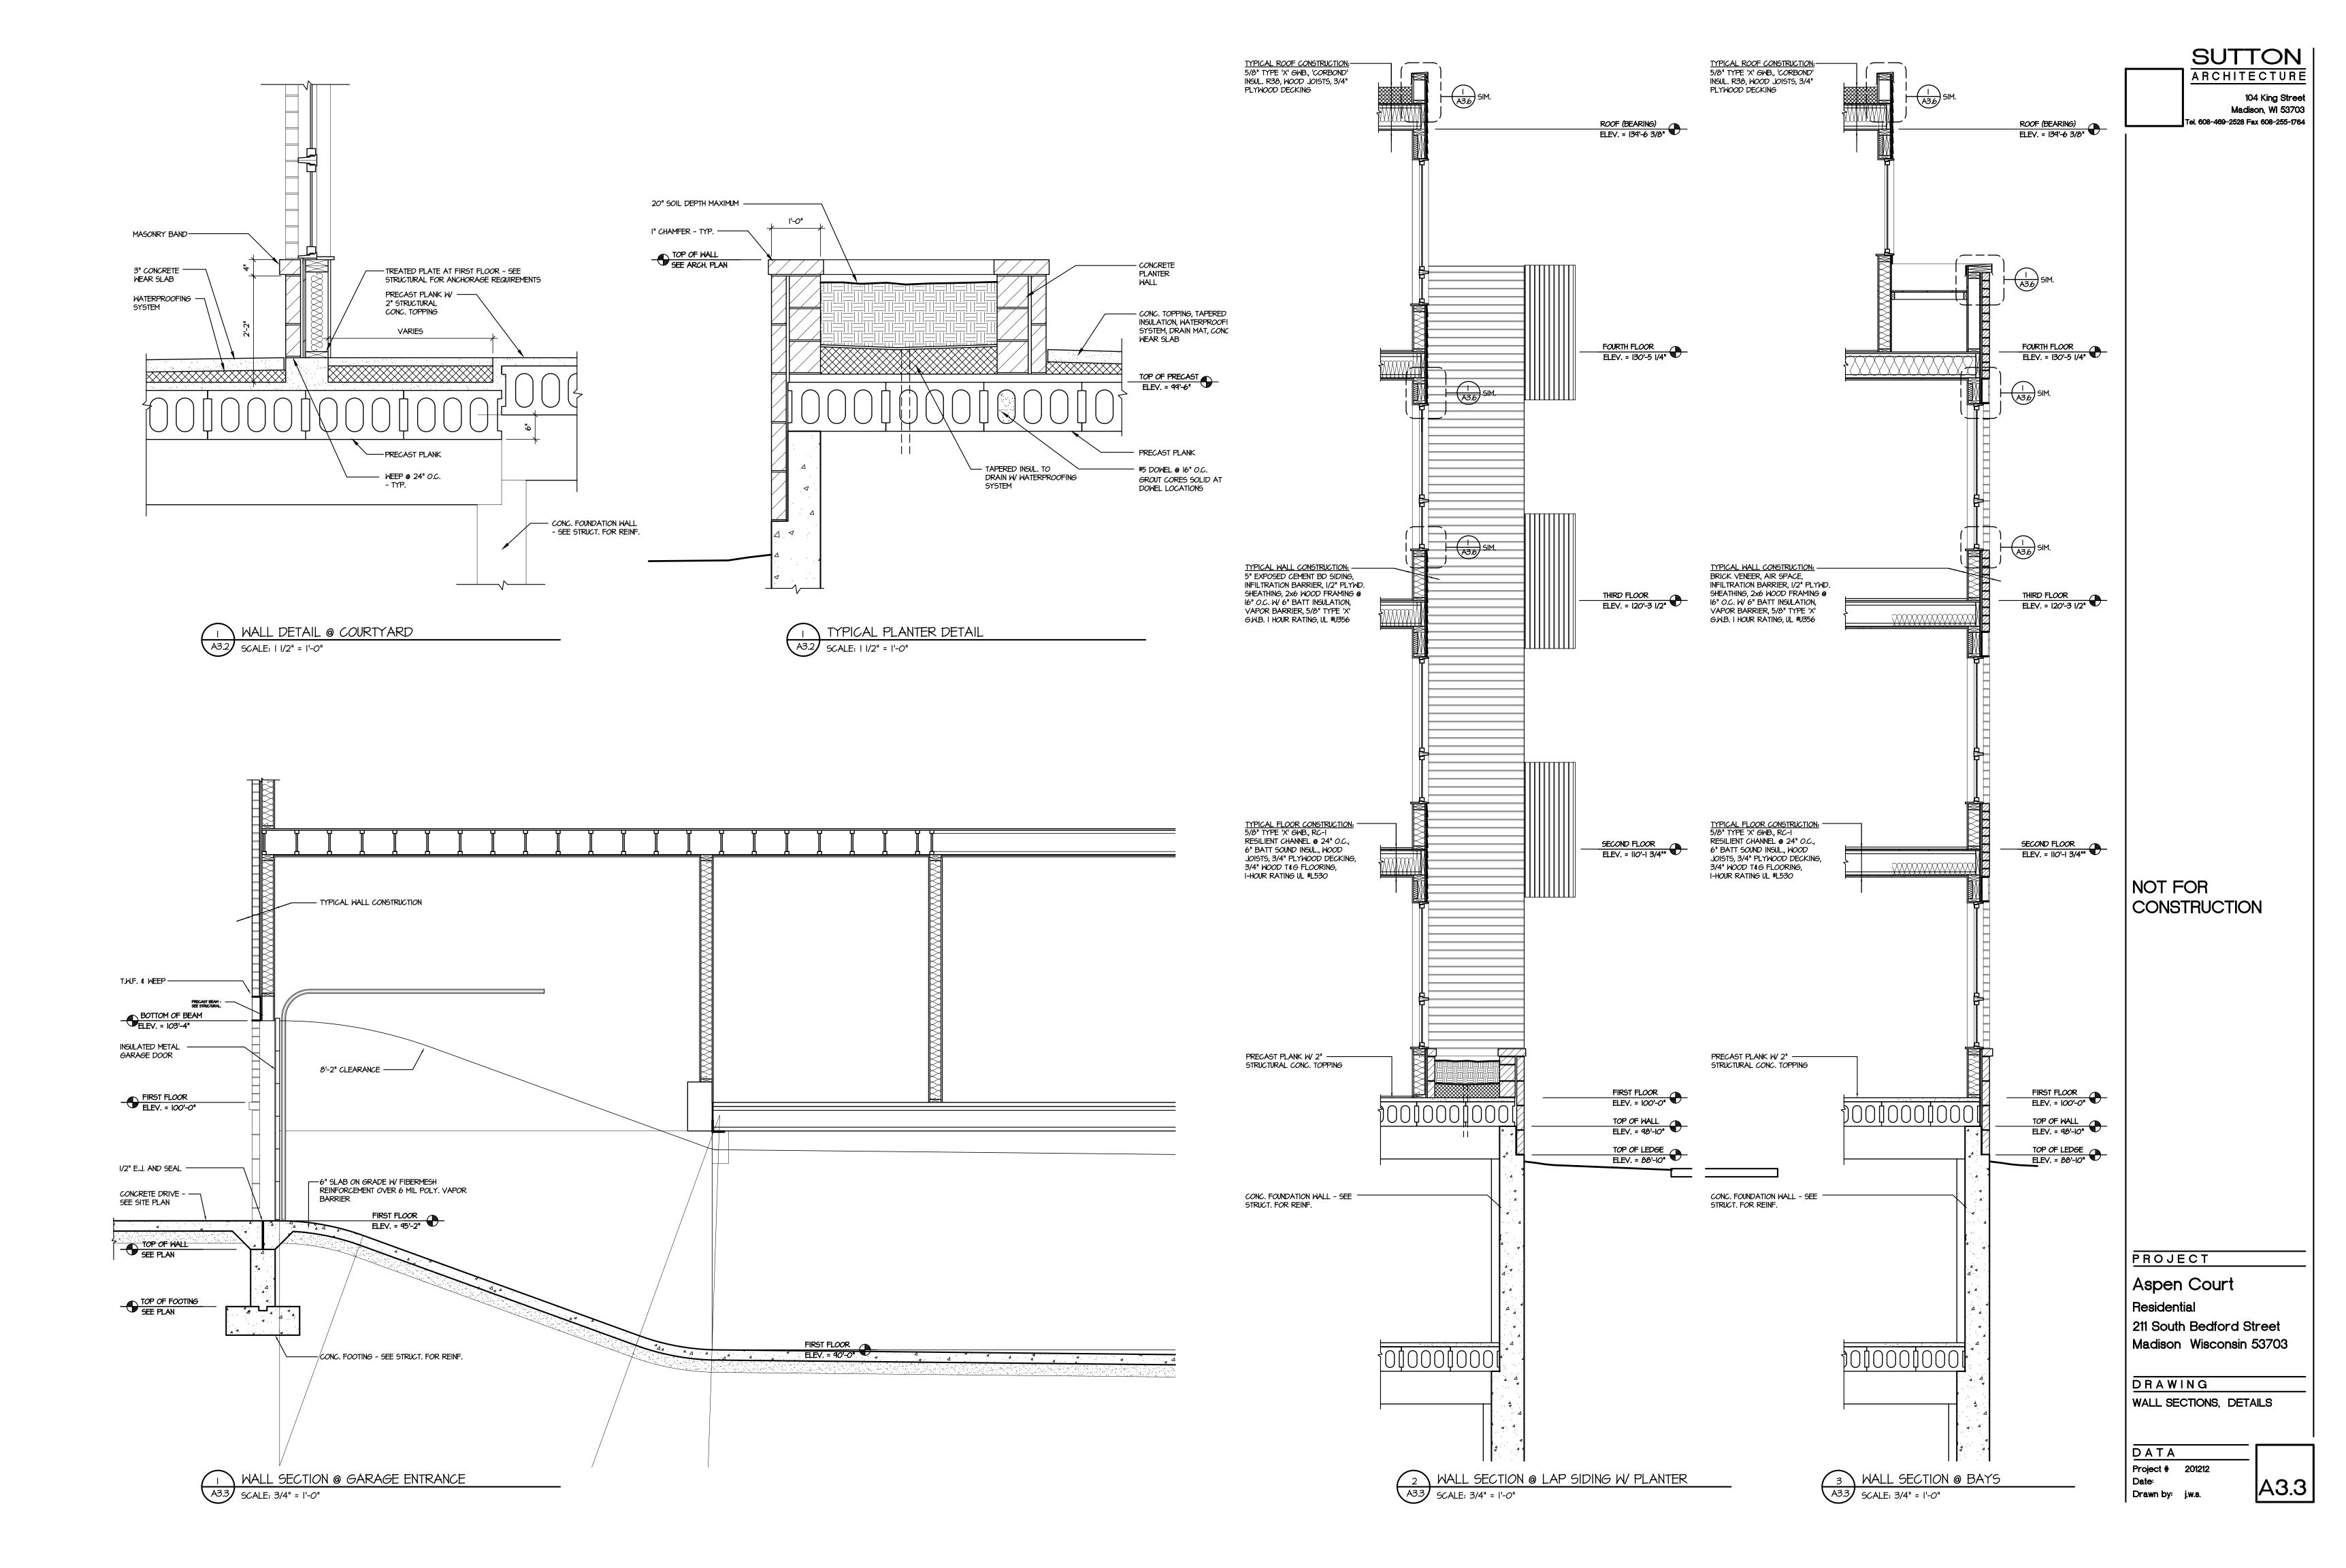

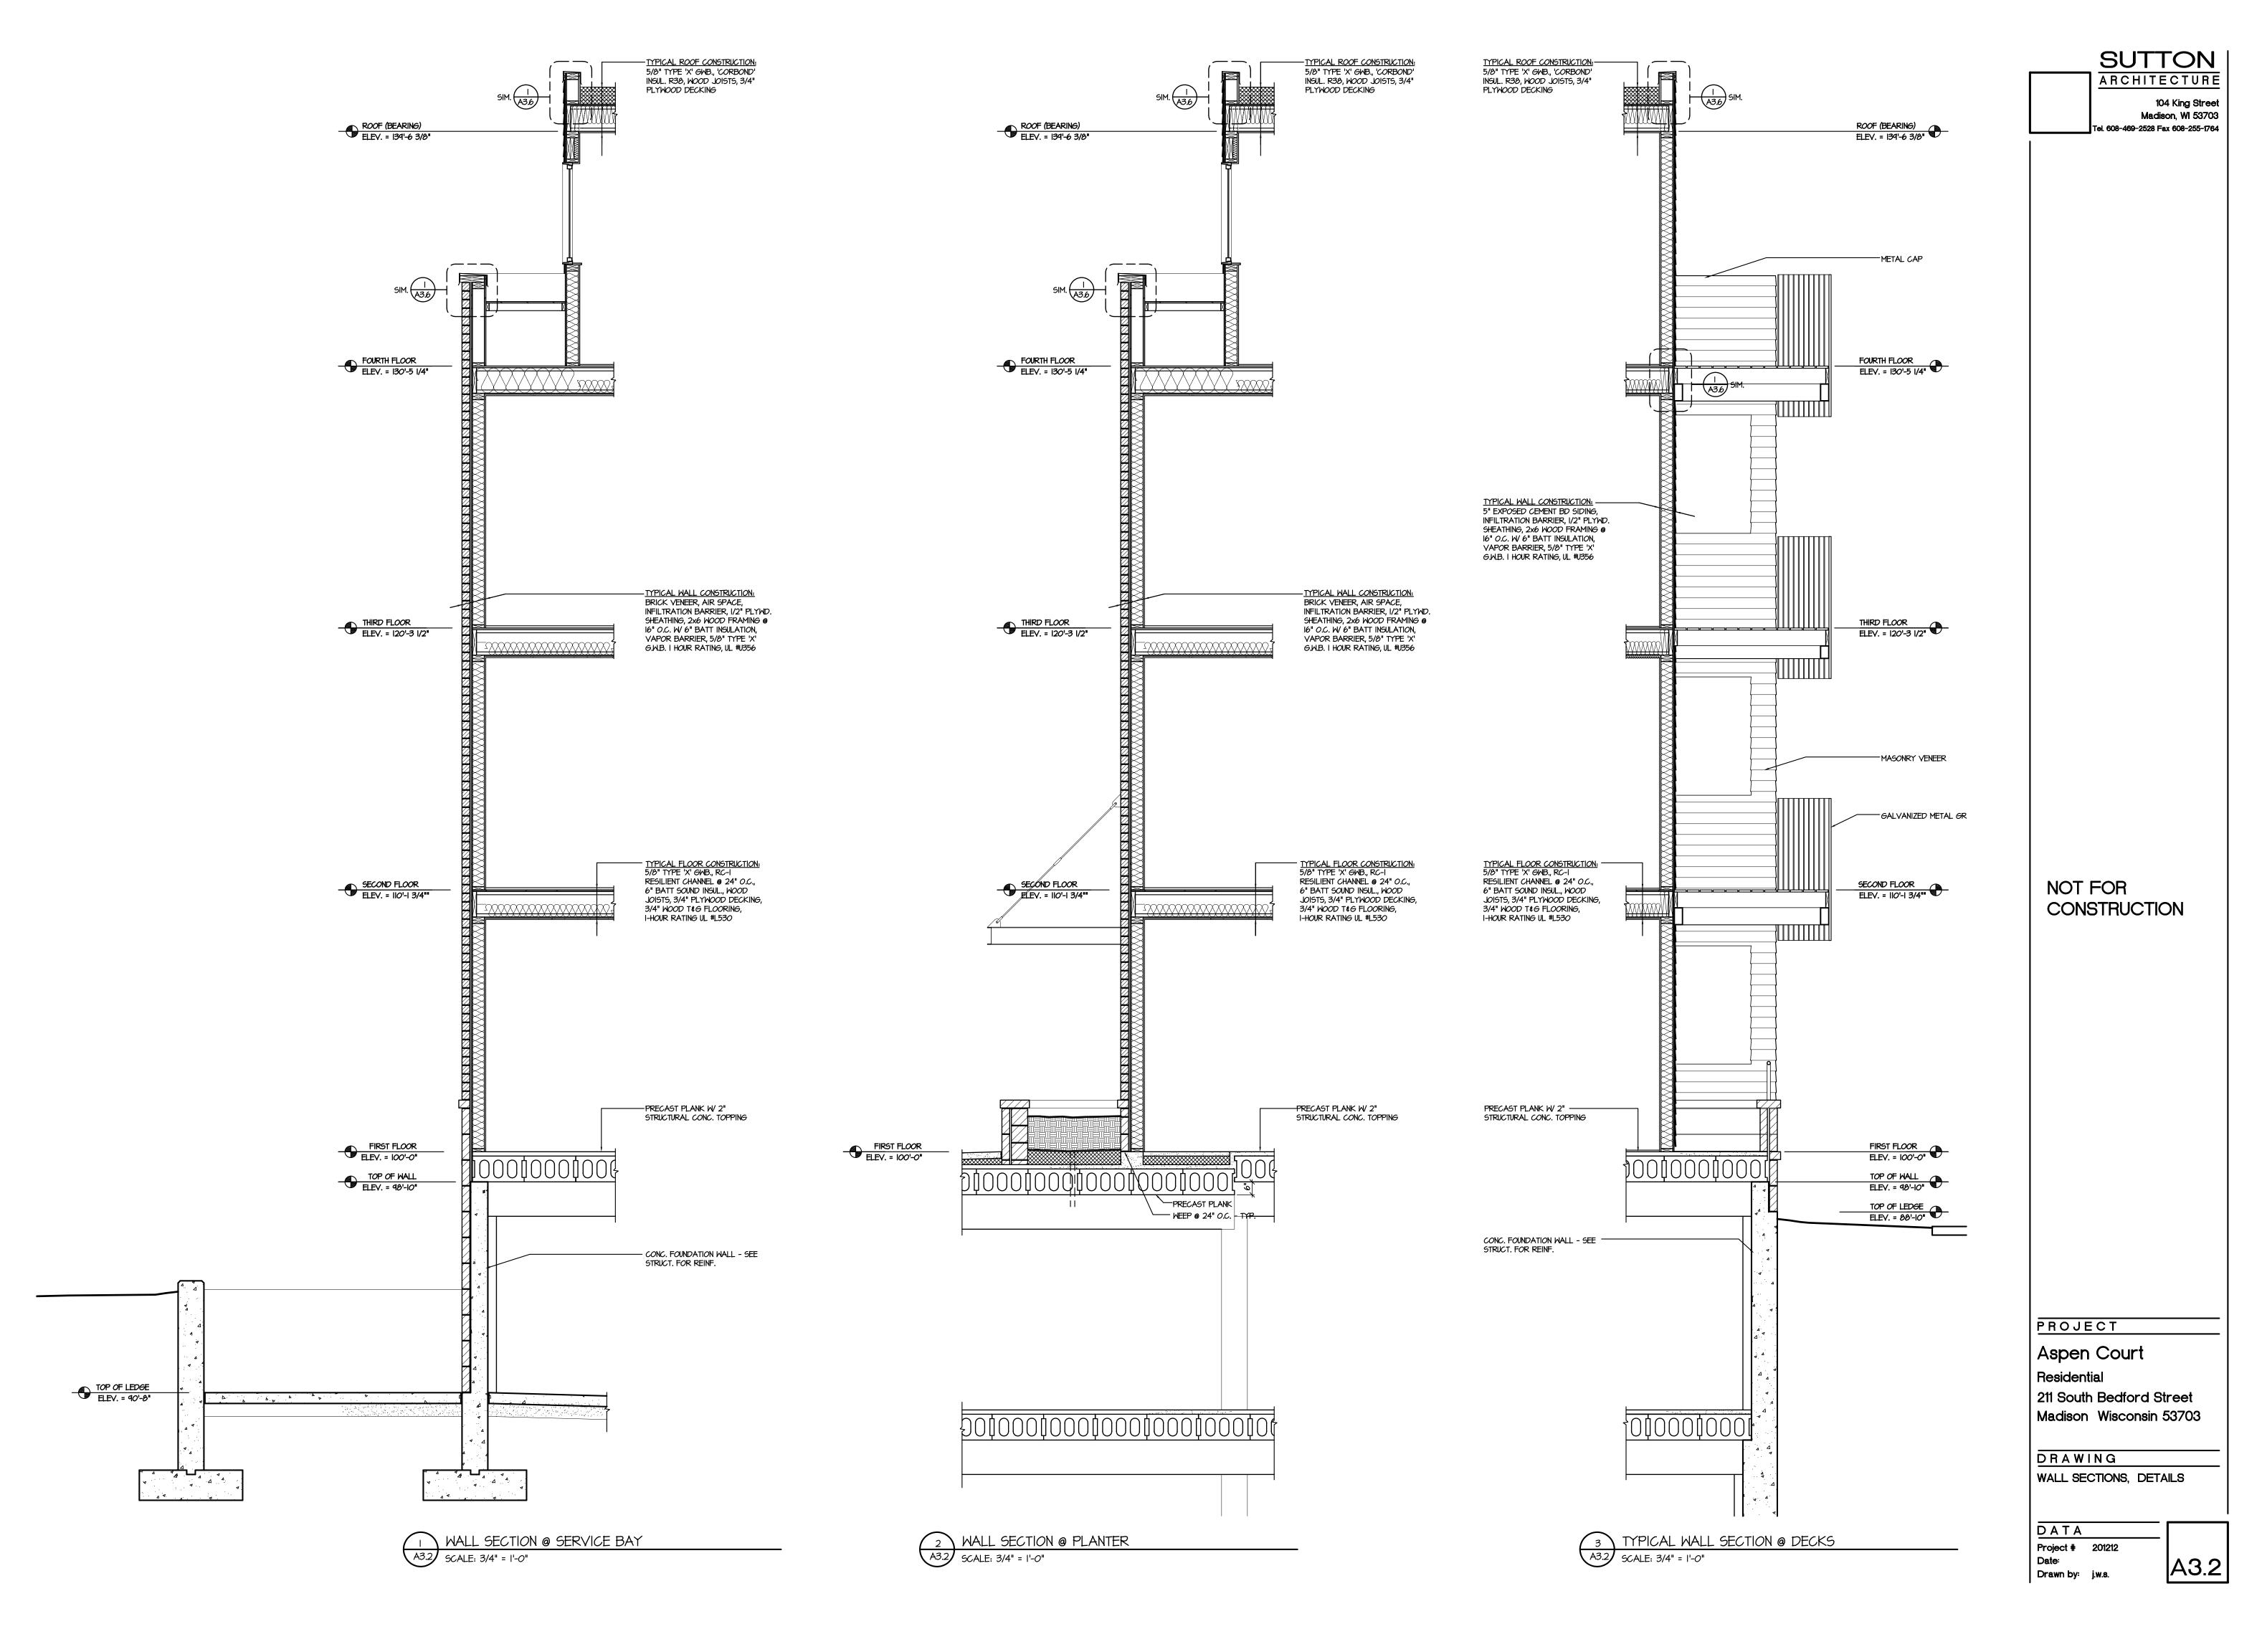

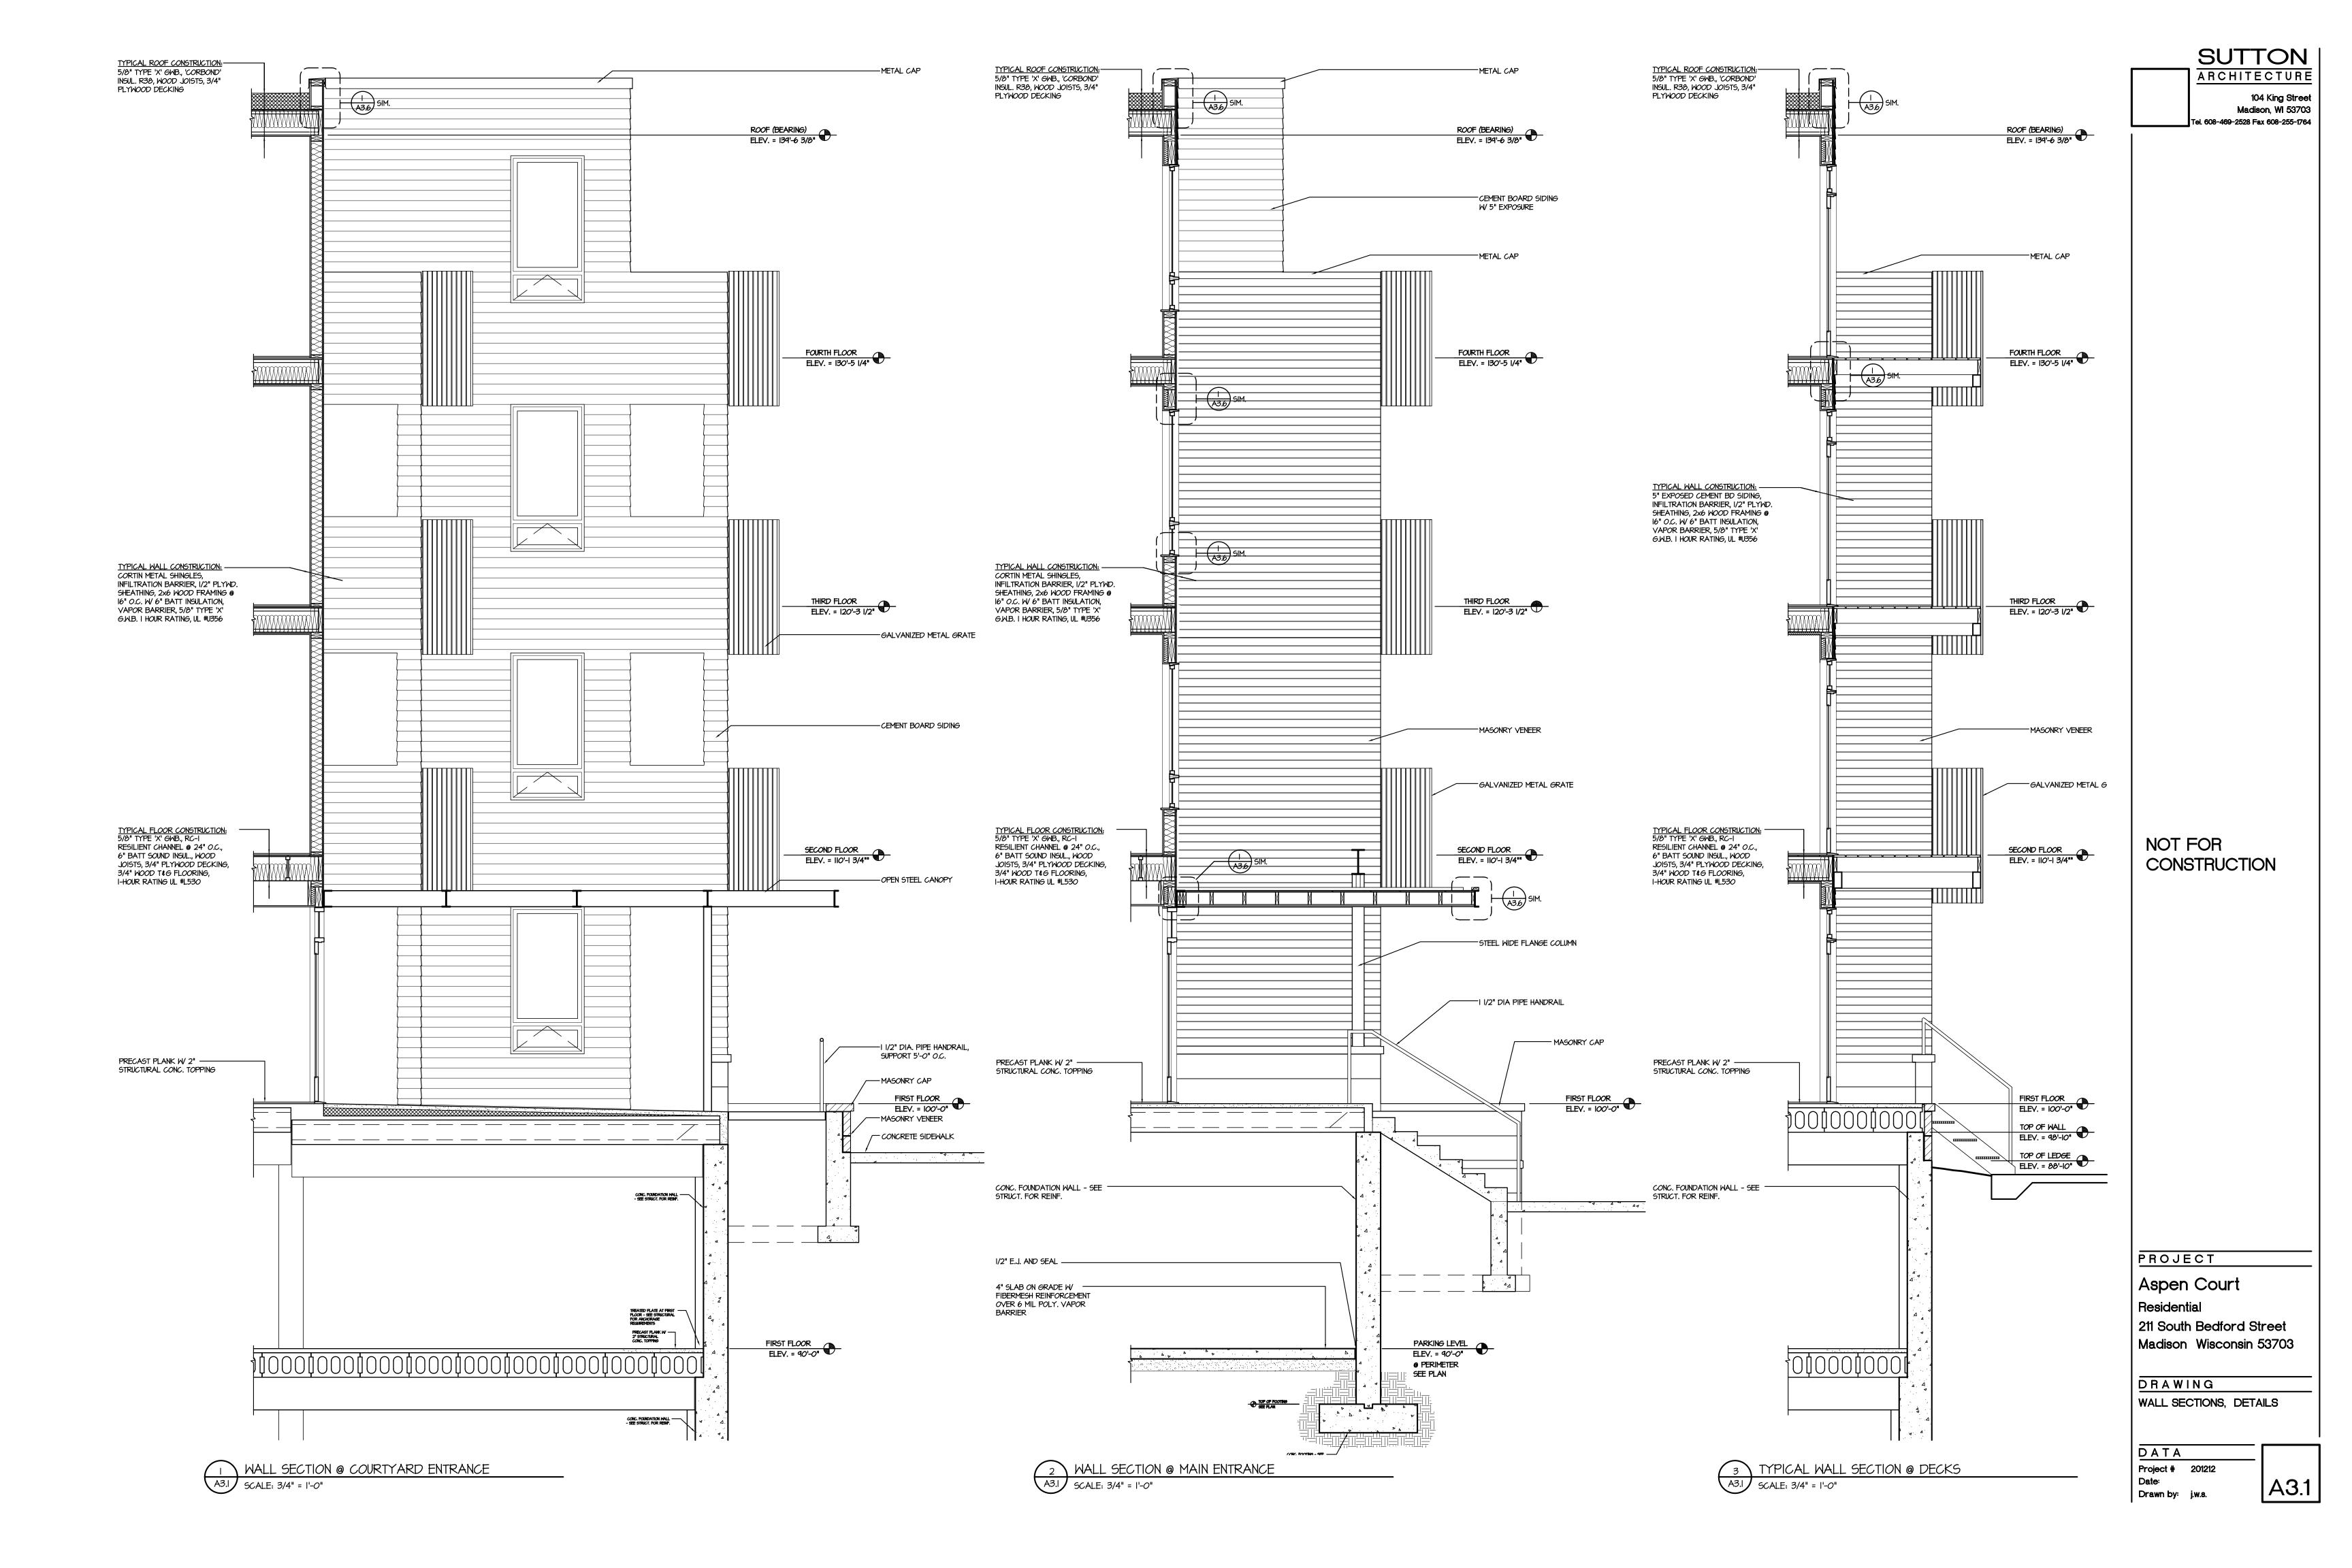

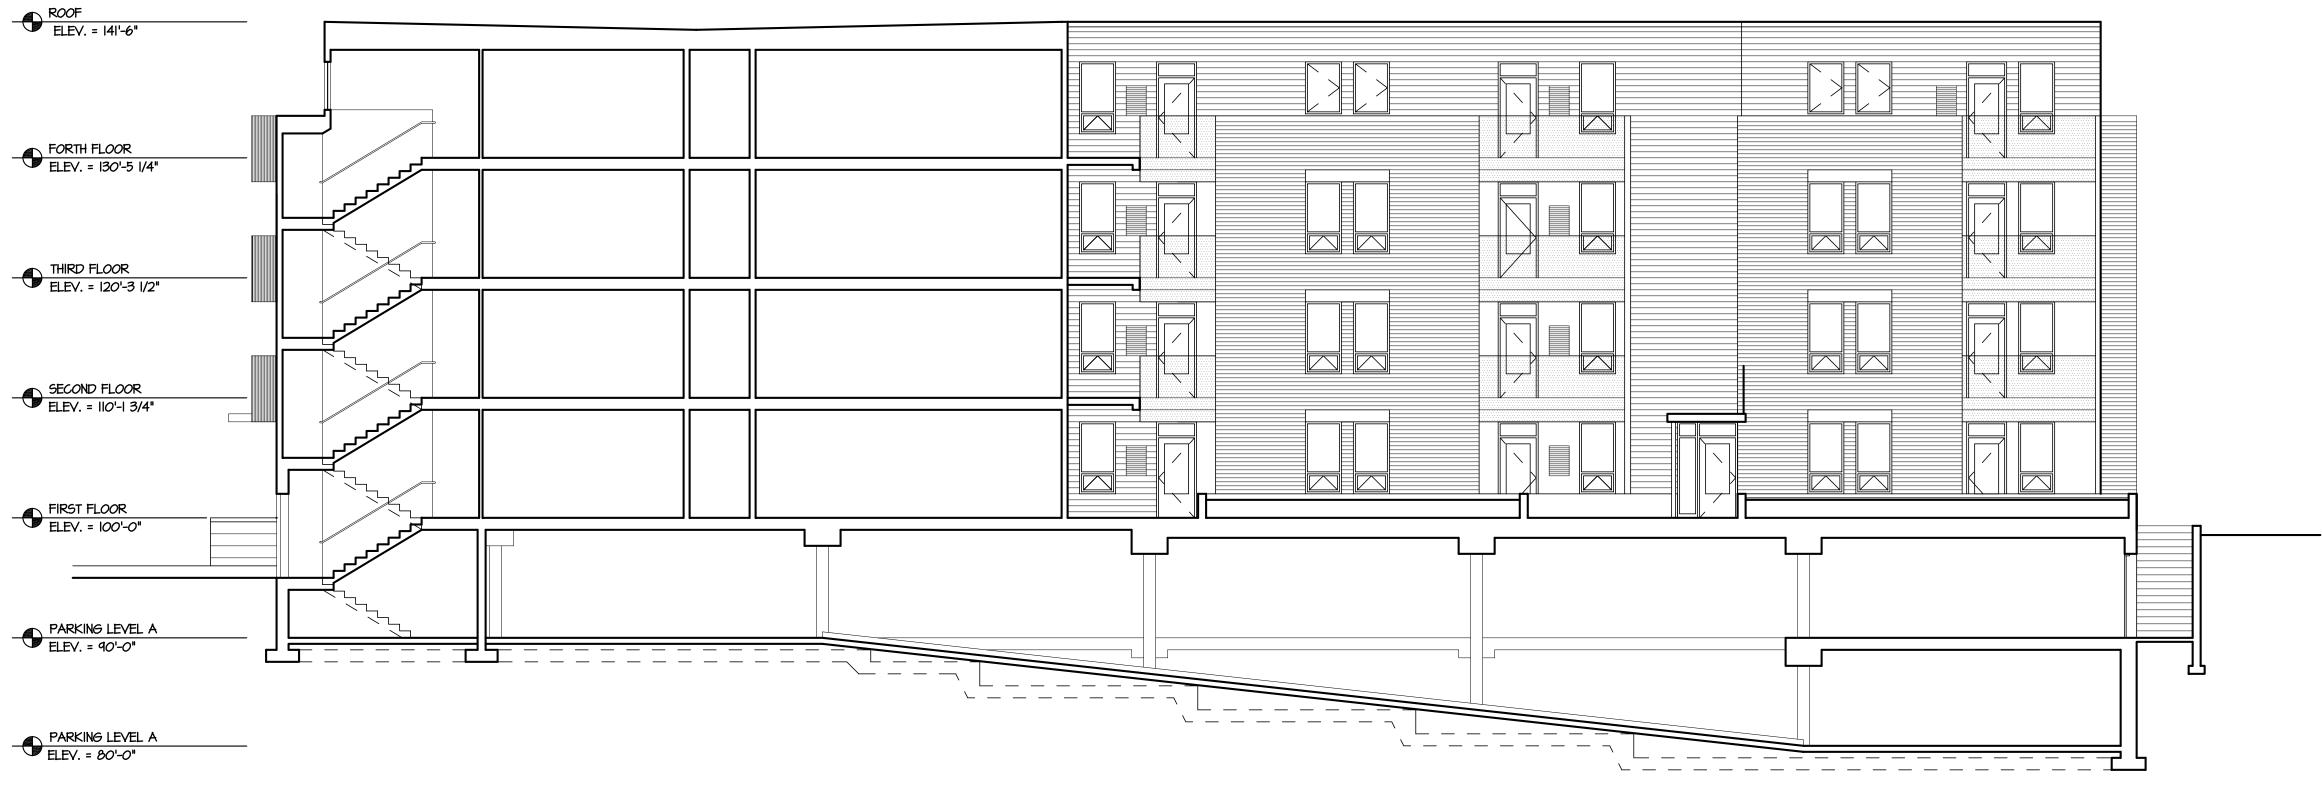SOUTHEAST ELEVATION A2.3 SCALE 1/8" = 1'-0"



NOT FOR CONSTRUCTION

SUTTON

ARCHITECTURE

Tel. 608-469-2528 Fax 608-255-1764

104 King Street Madison, WI 53703

OWNER

Les Orosz (608) 347-5432 University Avenue Madison, Wisconsin

PROJECT

Aspen Court Apartments

211 South Bedford Street Madison, Wisconsin 53703


DRAWING BUILDING SECTION/ELEVATIONS

DATA	
Project #	201212
Date:	
Drawn by:	j.w.8.

A2.3



I SOUTHEAST ELEVATION A2.2 SCALE 1/8" = 1'-0"

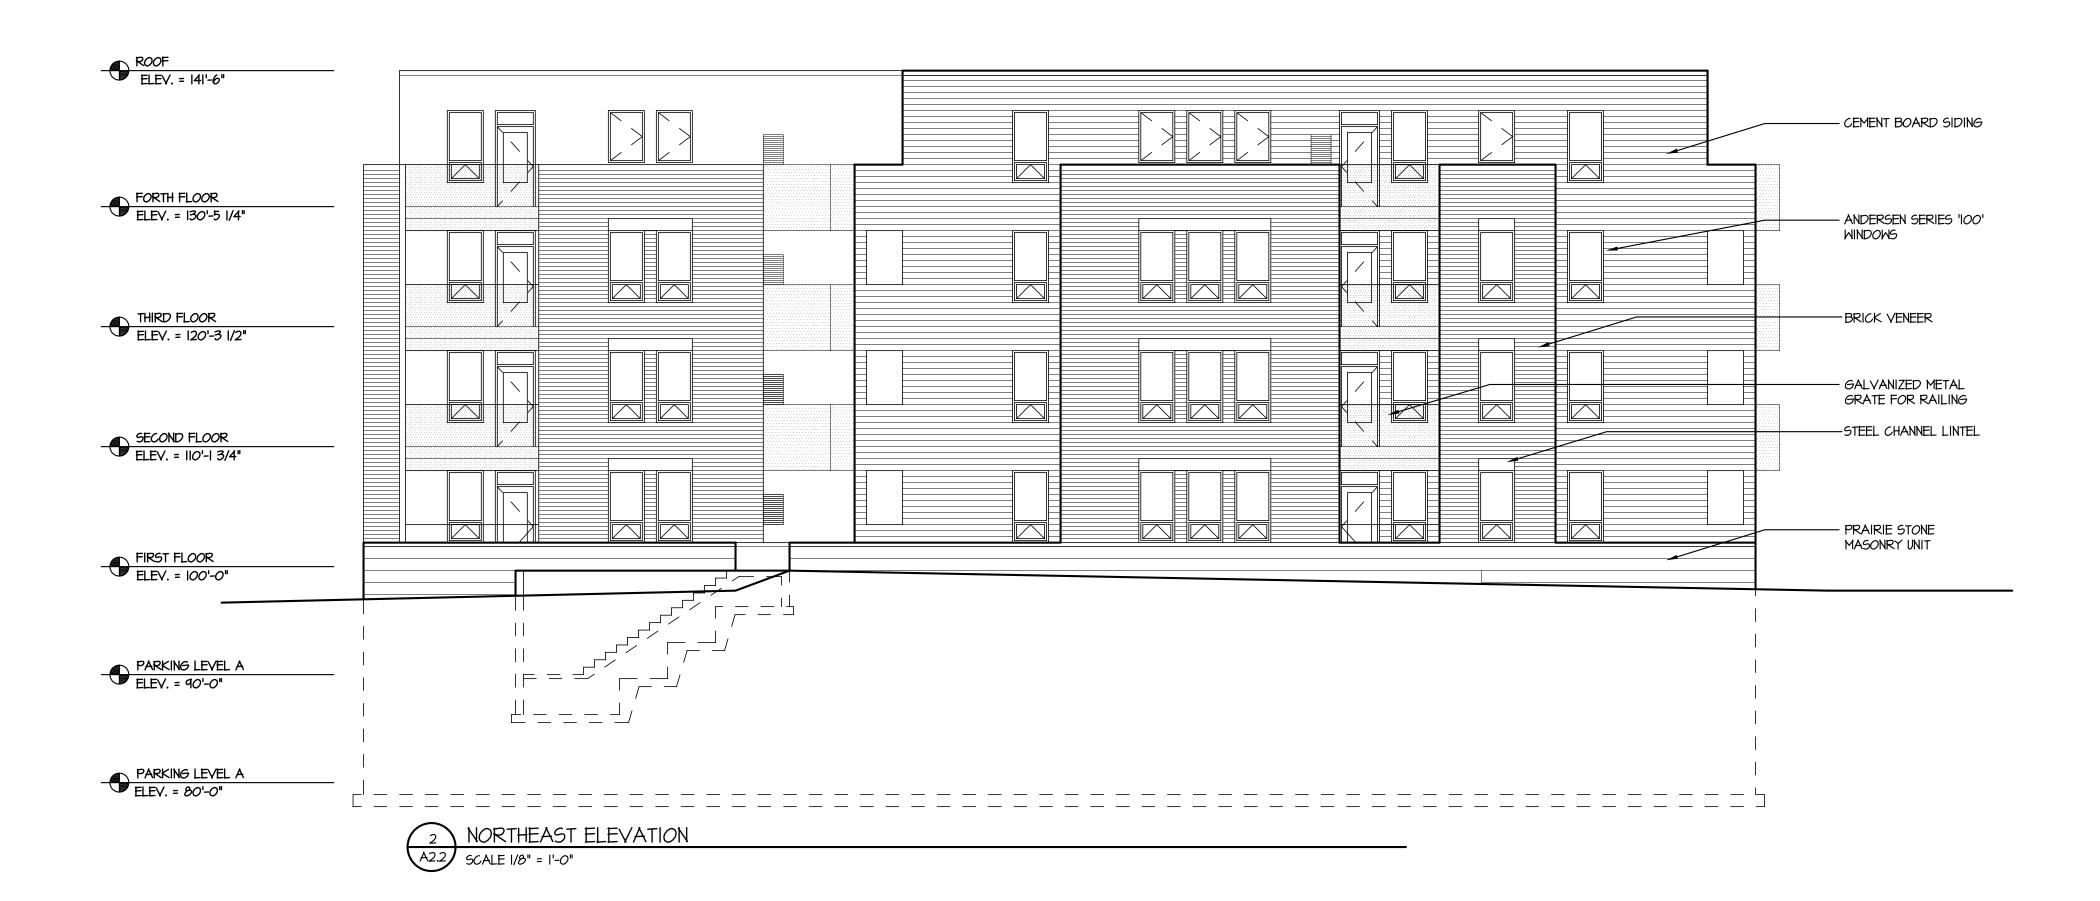

NOT FOR CONSTRUCTION

SUTTON

ARCHITECTURE

Tel. 608-469-2528 Fax 608-255-1764

104 King Street Madison, WI 53703

OWNER

Les Orosz (608) 347-5432 University Avenue Madison, Wisconsin

PROJECT

Aspen Court Apartments

211 South Bedford Street Madison, Wisconsin 53703


DRAWING BUILDING ELEVATIONS


DATA Project # 201212 Date Drawn by: j.w.s.

A2.2






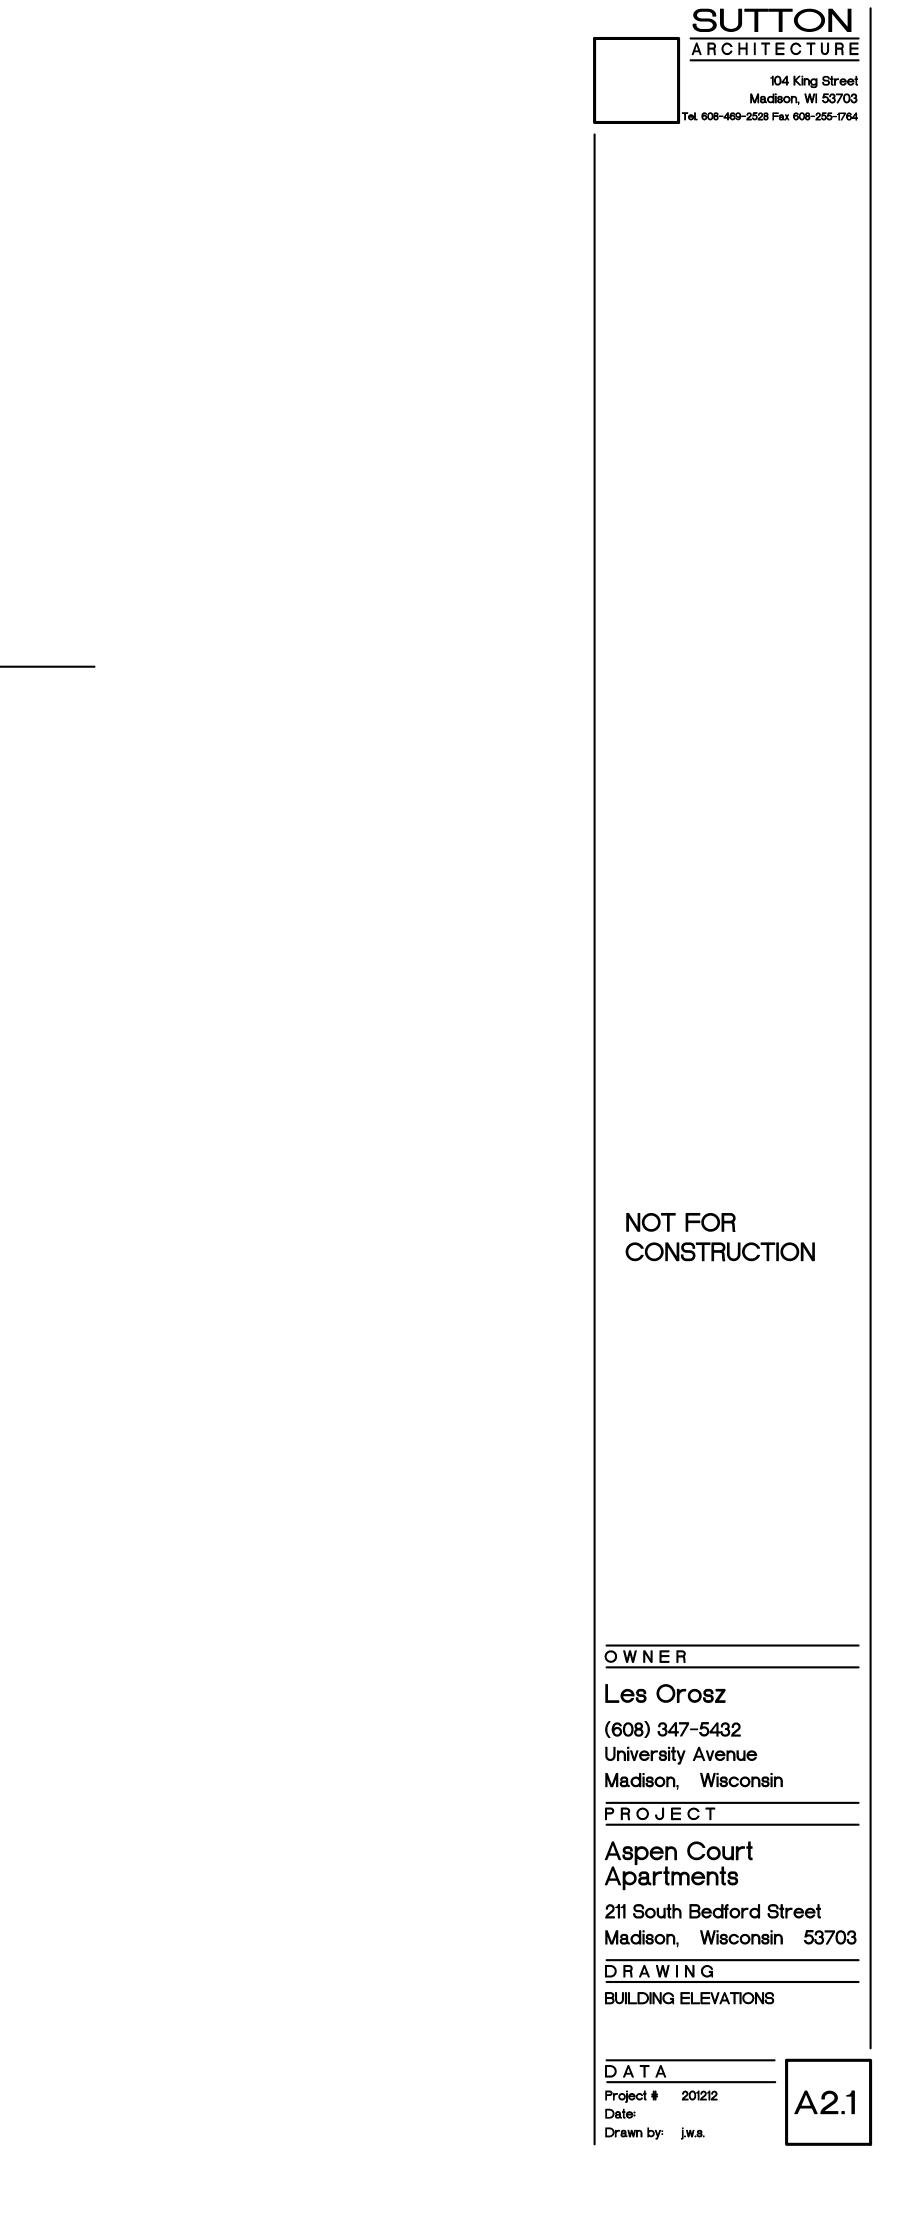


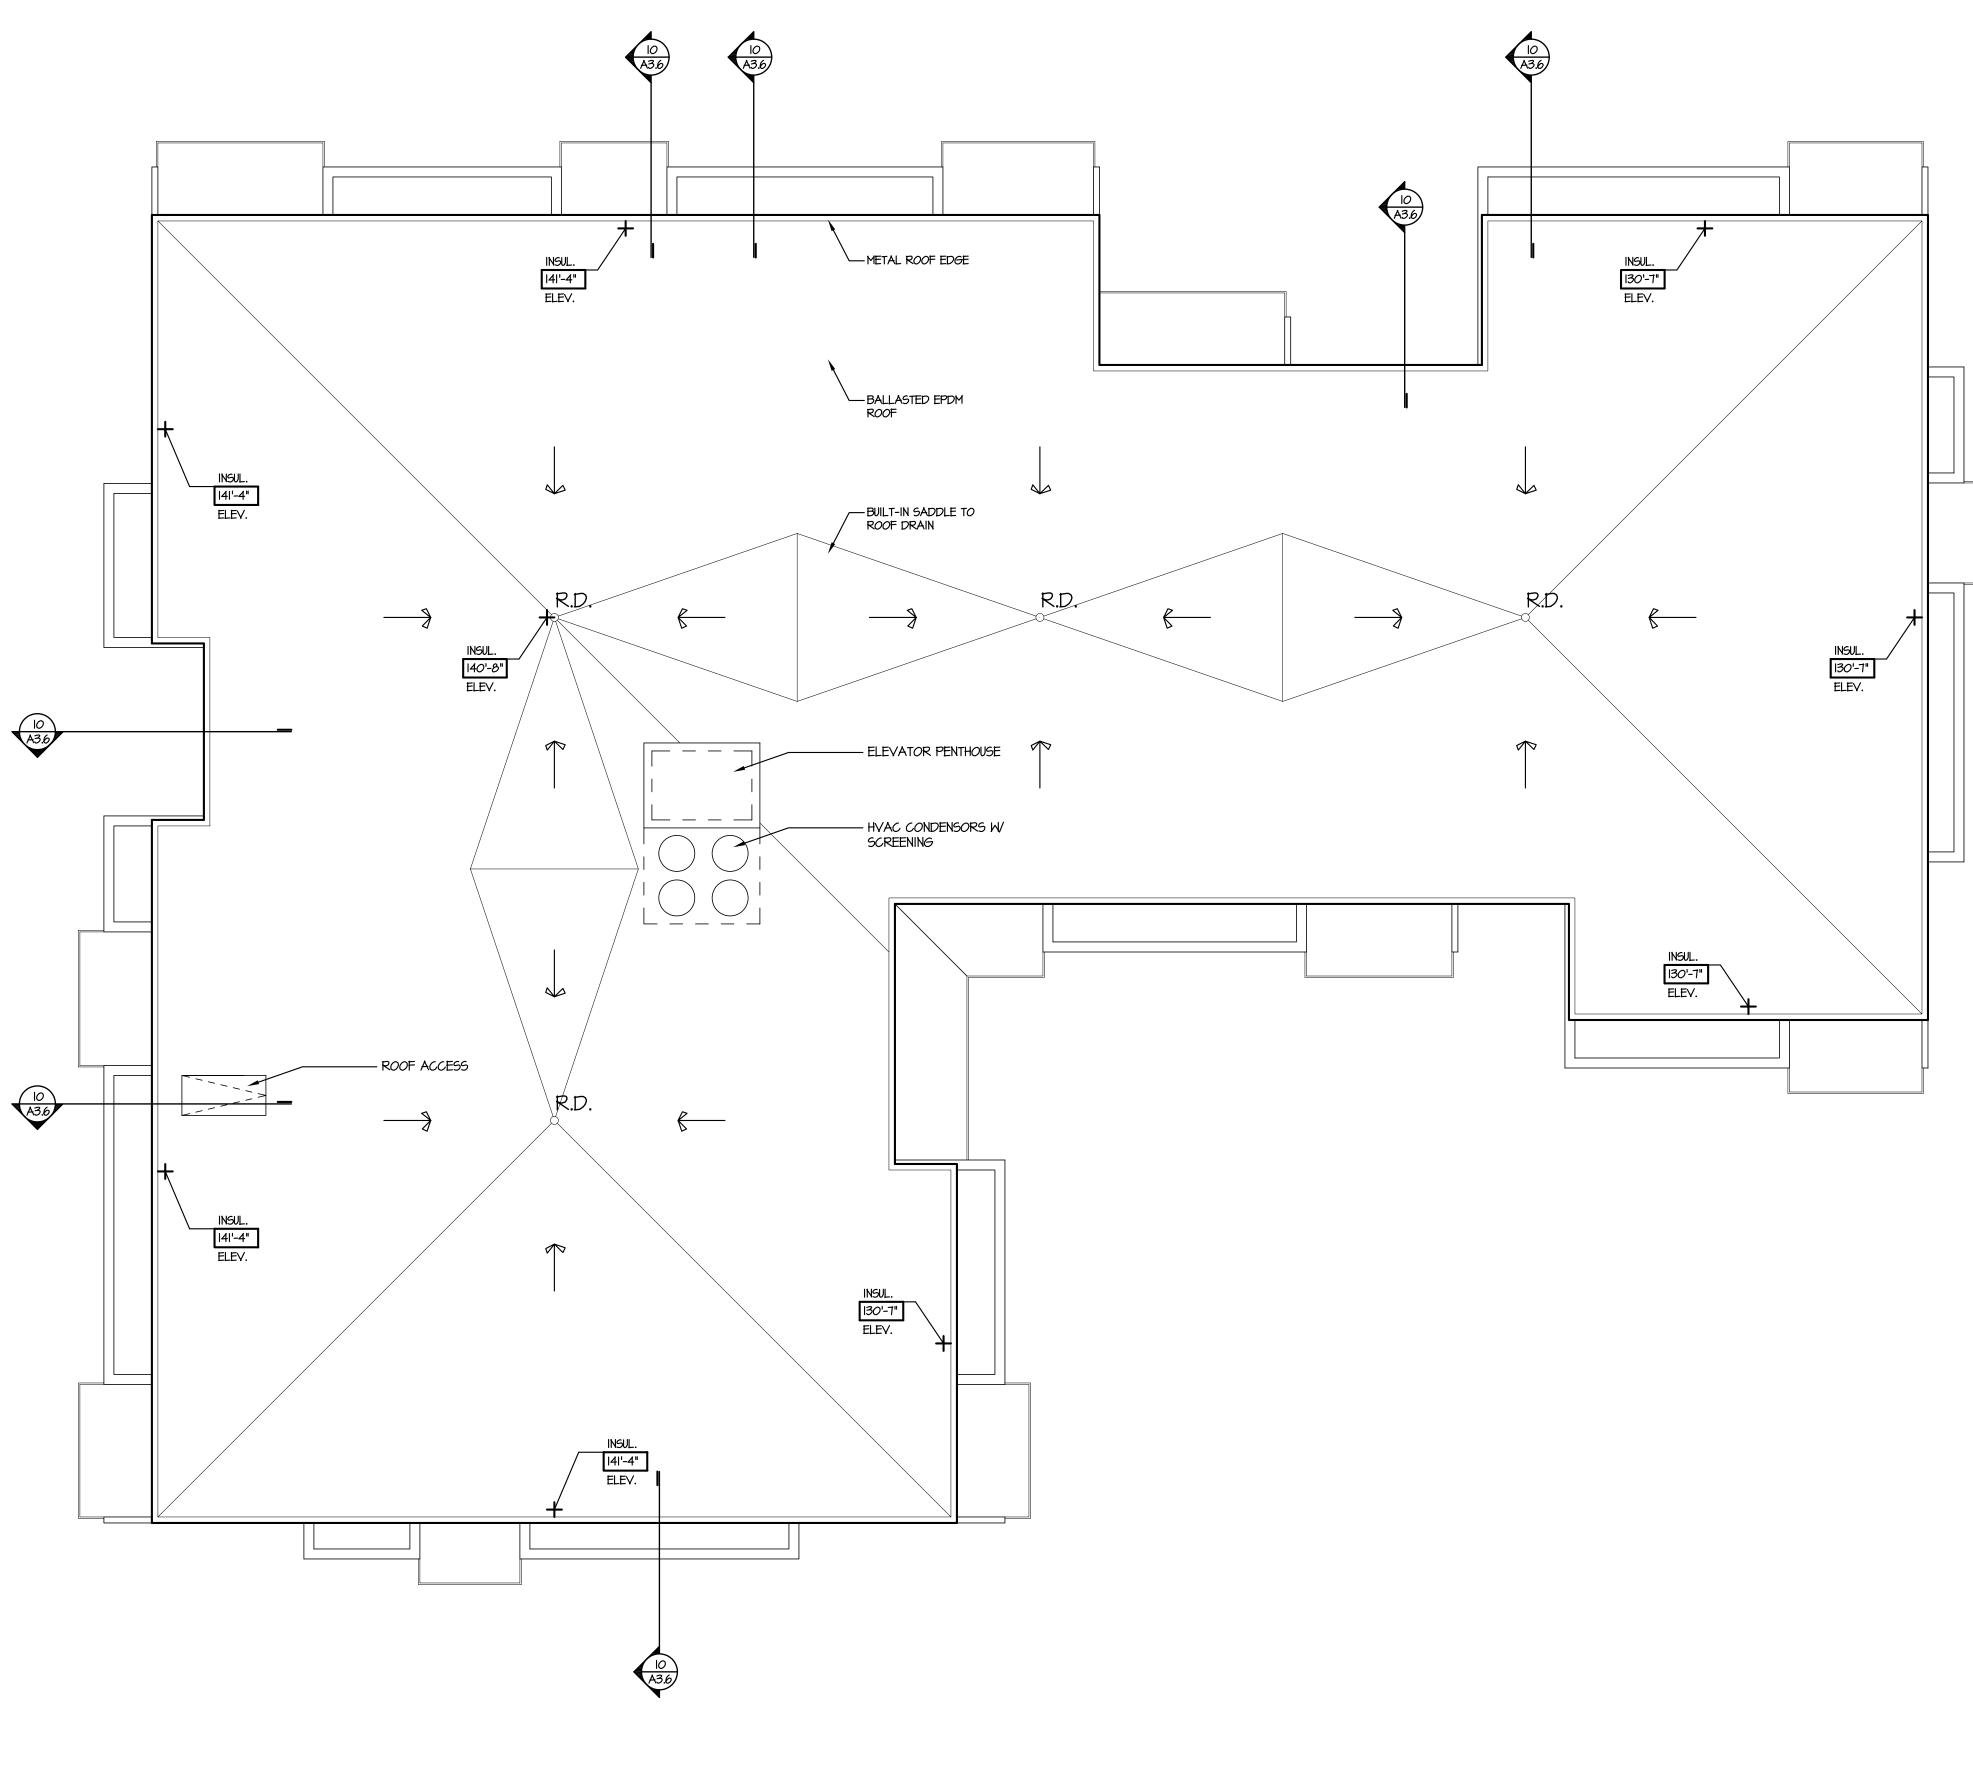







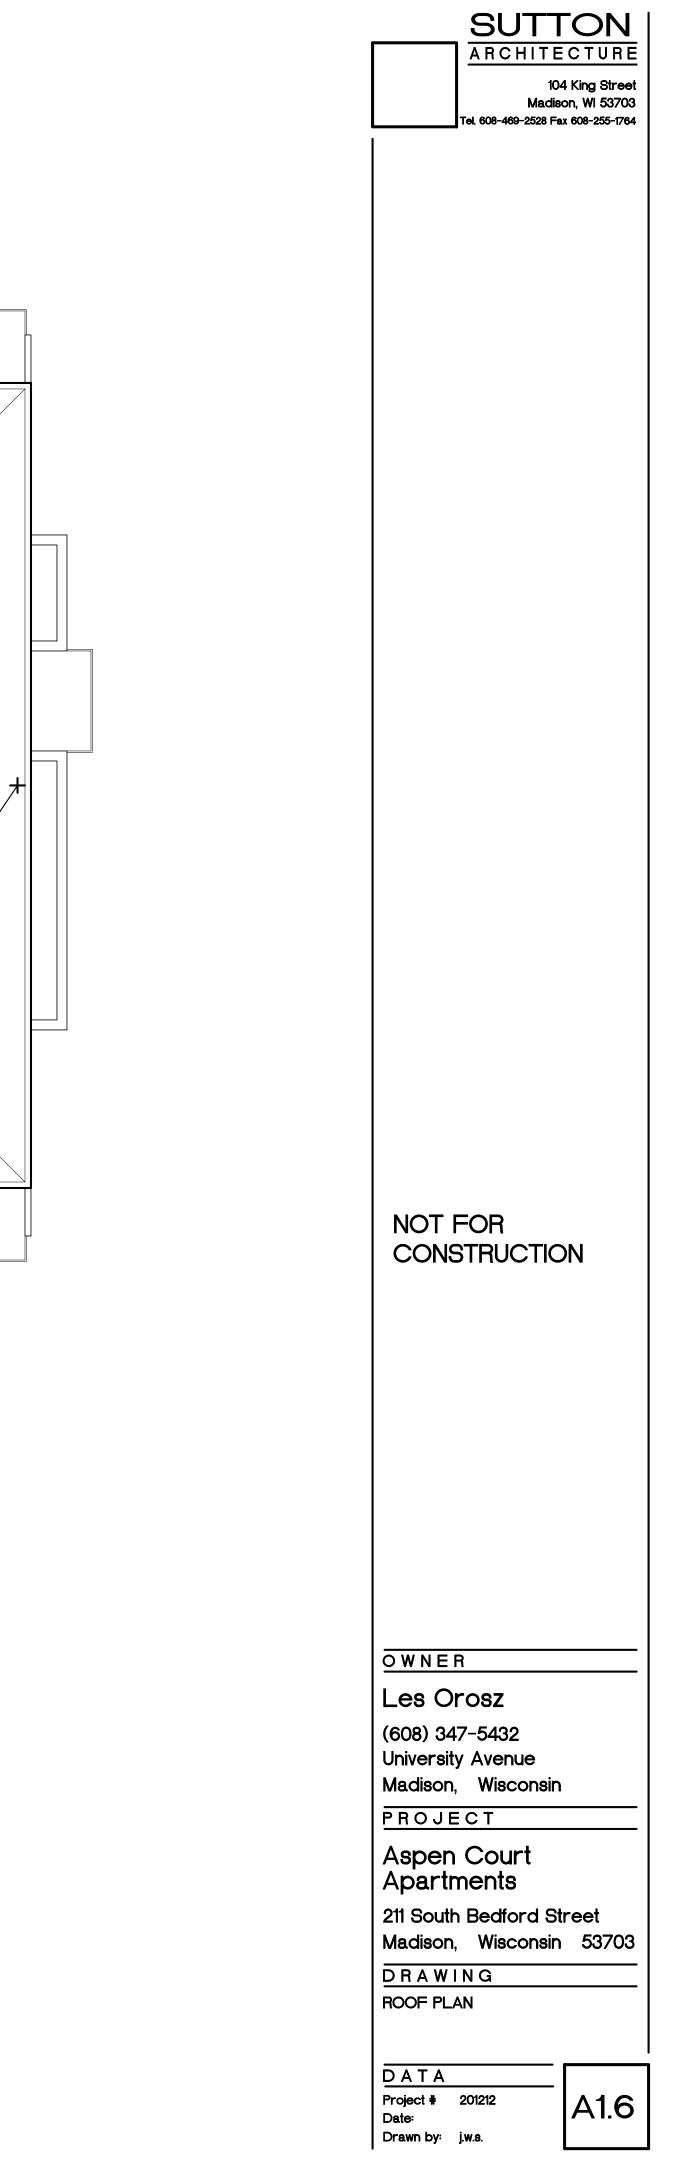

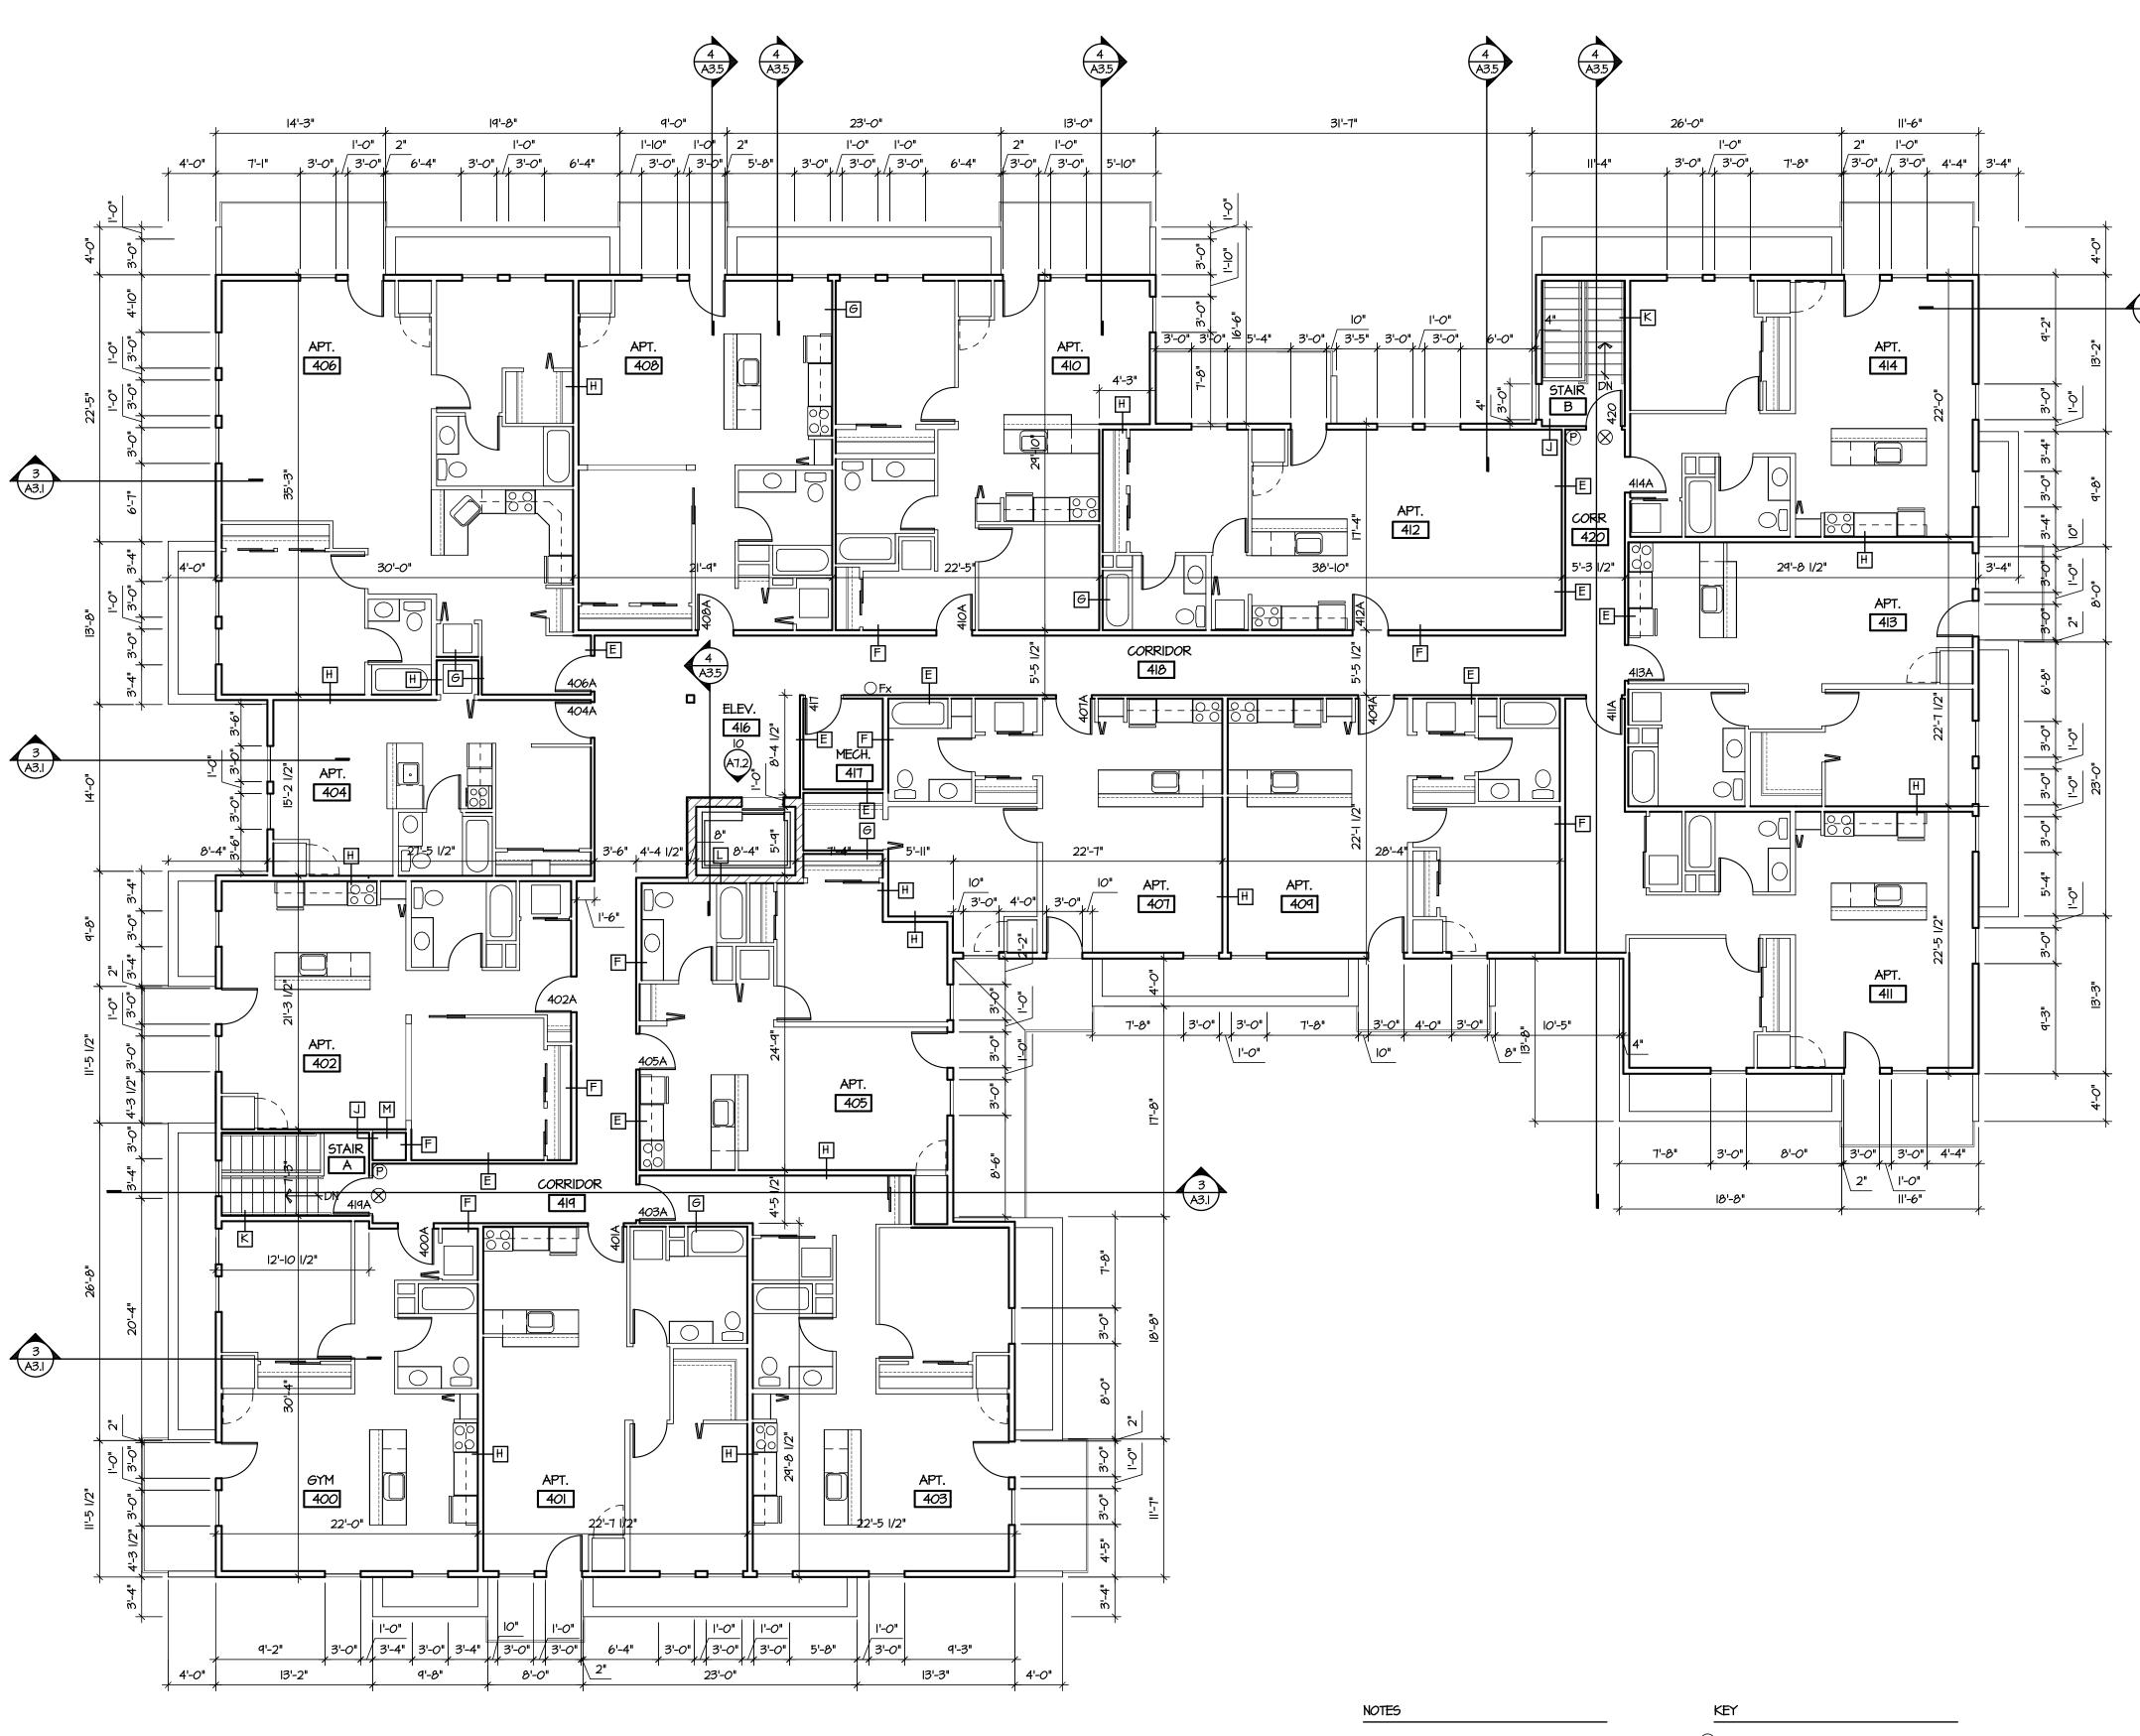

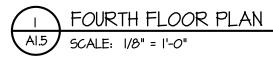

- I. ALL DIMENSIONS ARE TO FACE OF STUDS, CONCRETE, OR MASONRY.
- 2. SEE SHEET A4.I FOR PARTITION TYPES \$ ROOM FINISH SCHEDULES.
- 3. SEE SHEET CI.2 FOR CONTINUATION OF SITE FEATURES.
- 4. SEE SHEET AT.I FOR INTERIOR ELEVATIONS.
- (W) CLASS I STANDPIPES A PARTITION TYPES

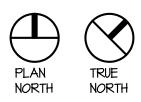

	SUTTON ARCHITECTURE
	104 King Street Madison, WI 53703 Tel. 608-469-2528 Fax 608-255-1764
3	
A3.3	
	NOT FOR CONSTRUCTION
	PROJECT Aspen Court
	Residential 211 South Bedford Street
	Madison Wisconsin 53703
	DRAWING Fourth Floor Plan
	DATA Project # 201212 Date: Drawn by: jws A1.5


(5) SMOKE DETECTORS W BATTERY BACK-UP

(E) EMERGENCY LIGHTING W BATTERY BACK-UP

EXIT LIGHTS W BATTERY BACK-UP


⊖Fx FIRE EXTINGUISHER


P FIRE ALARM PULL STATION

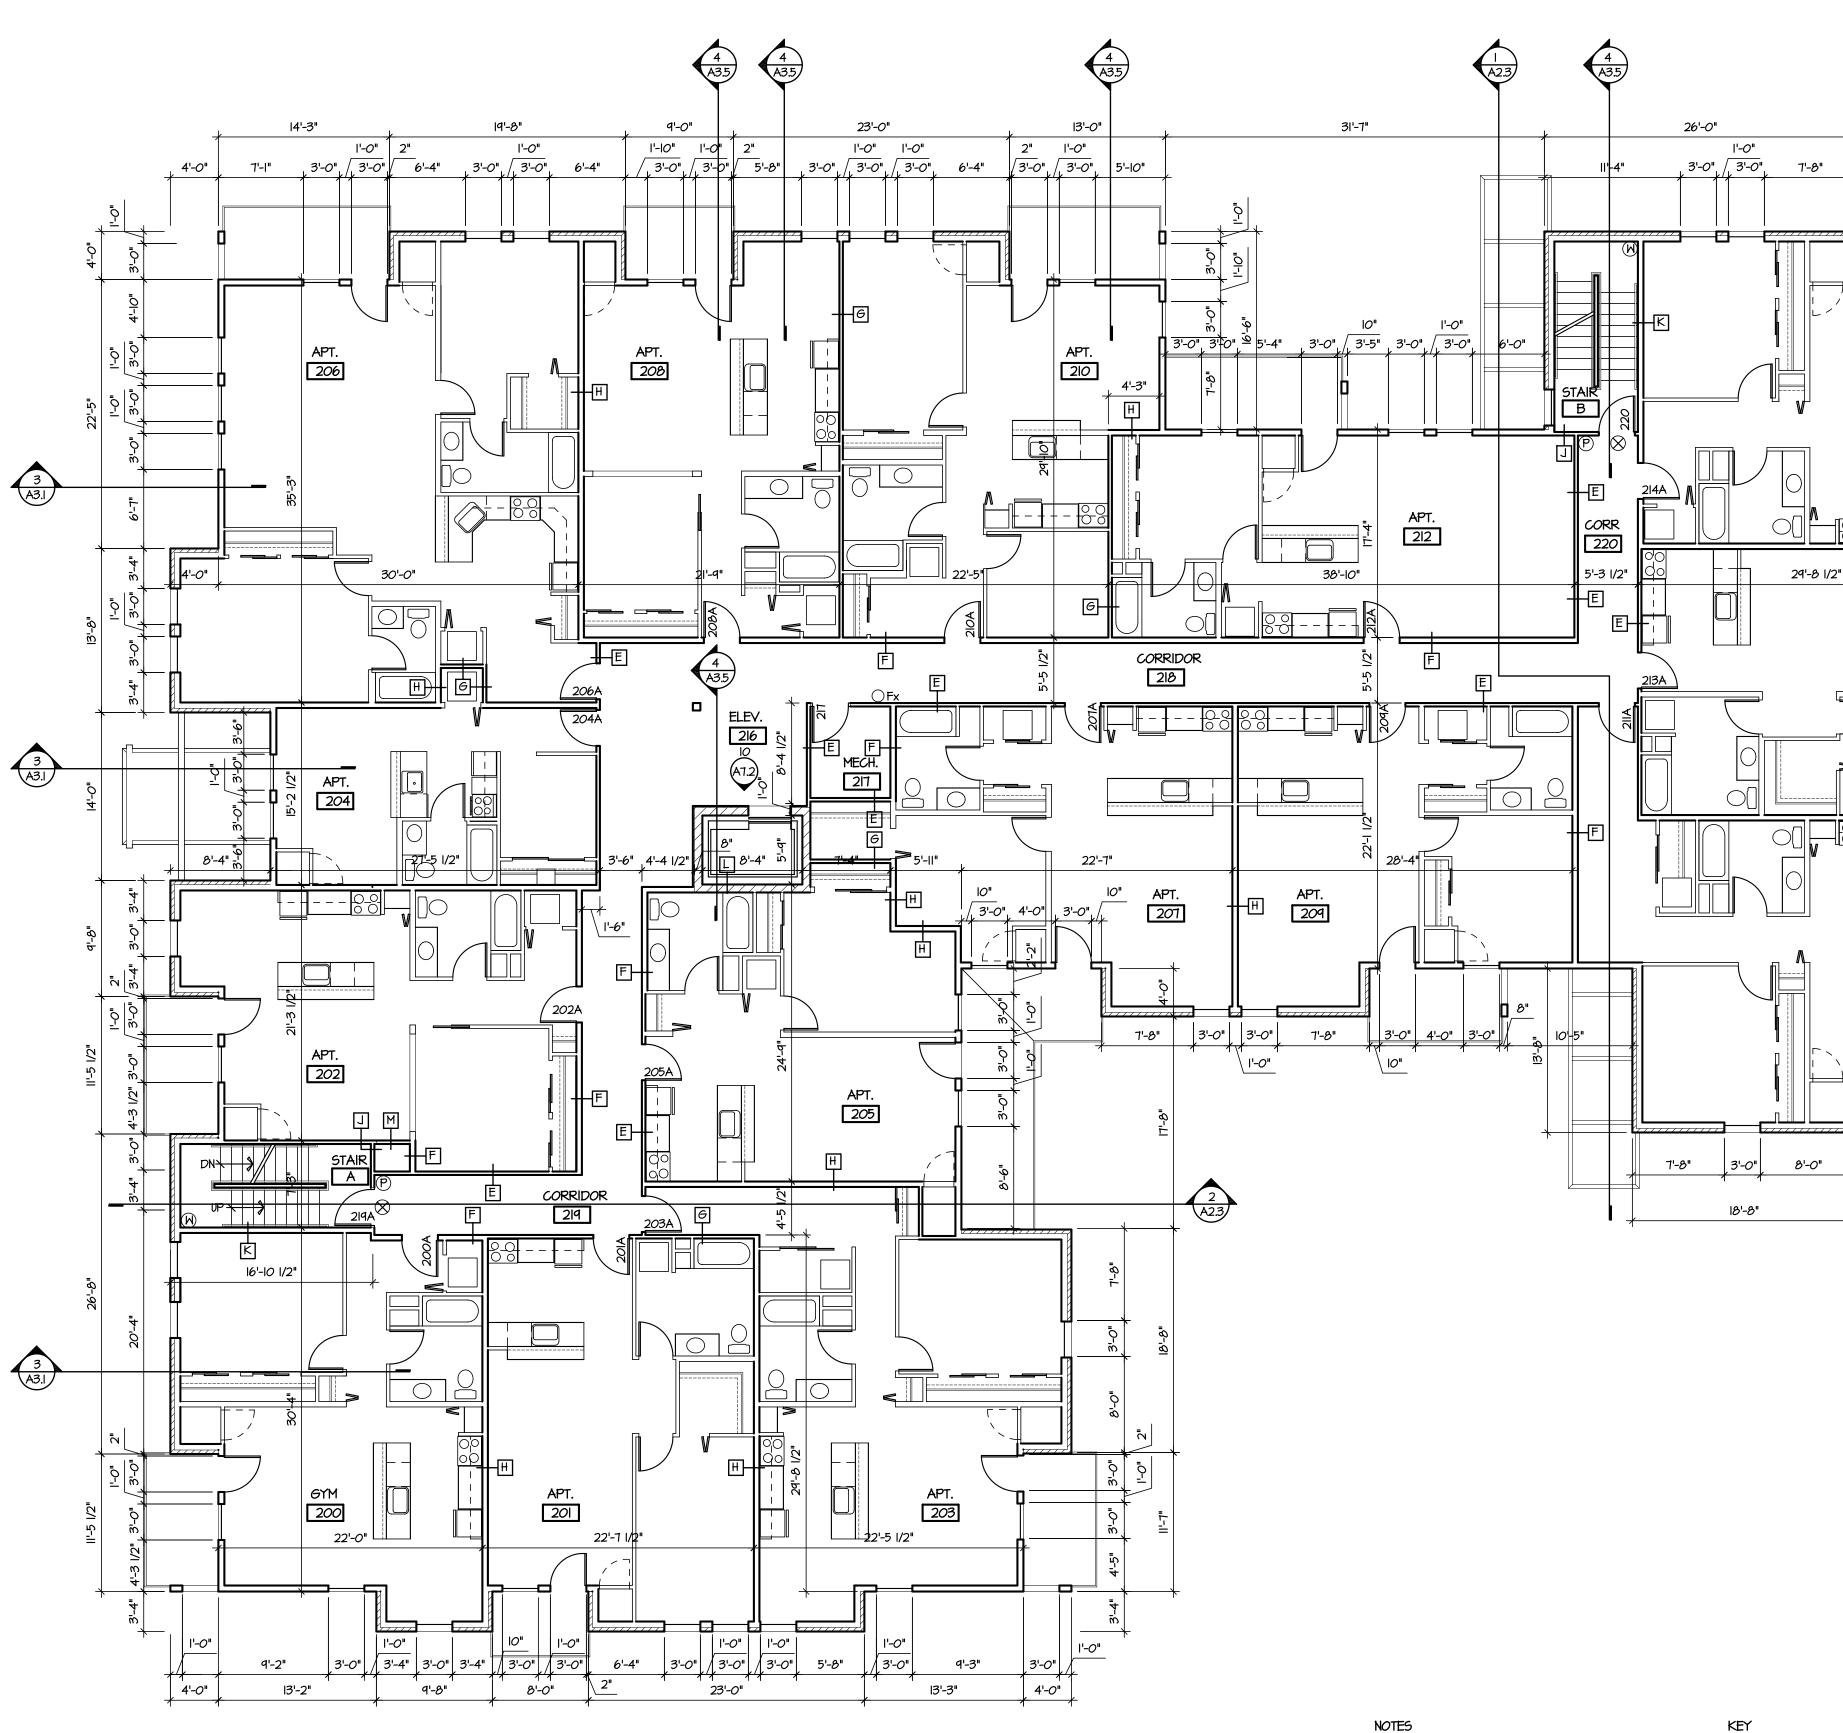




- NOTES
- I. ALL DIMENSIONS ARE TO FACE OF STUDS, CONCRETE, OR MASONRY.
- 2. SEE SHEET A4.I FOR PARTITION TYPES & ROOM FINISH SCHEDULES.
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- 4. SEE SHEET AT.I FOR INTERIOR ELEVATIONS.
- EXIT LIGHTS W BATTERY BACK-UP ⊖Fx FIRE EXTINGUISHER P FIRE ALARM PULL STATION (W) CLASS I STANDPIPES
- A PARTITION TYPES

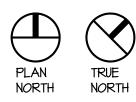


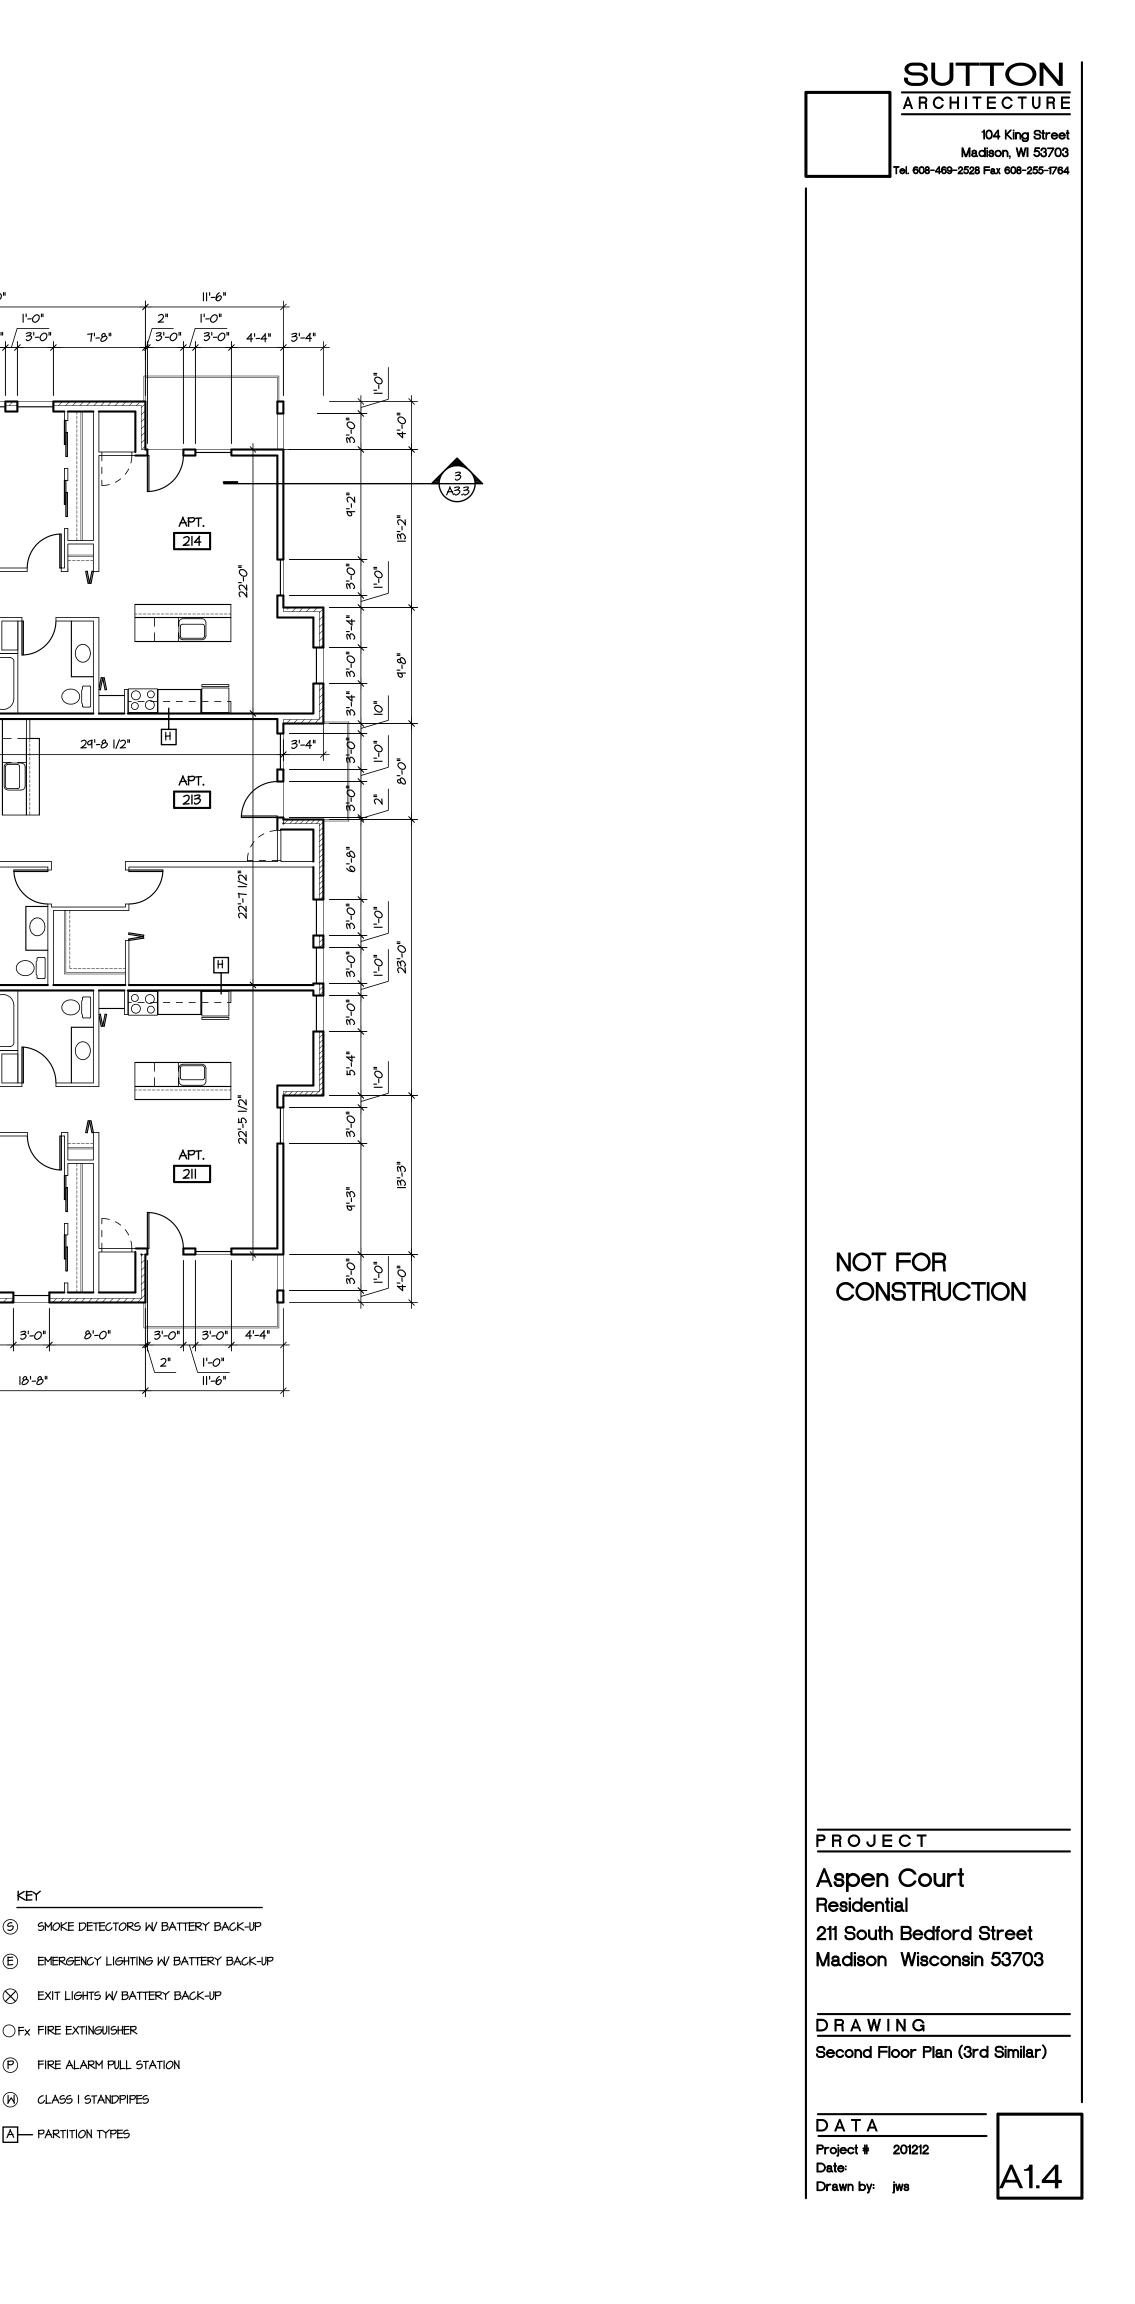


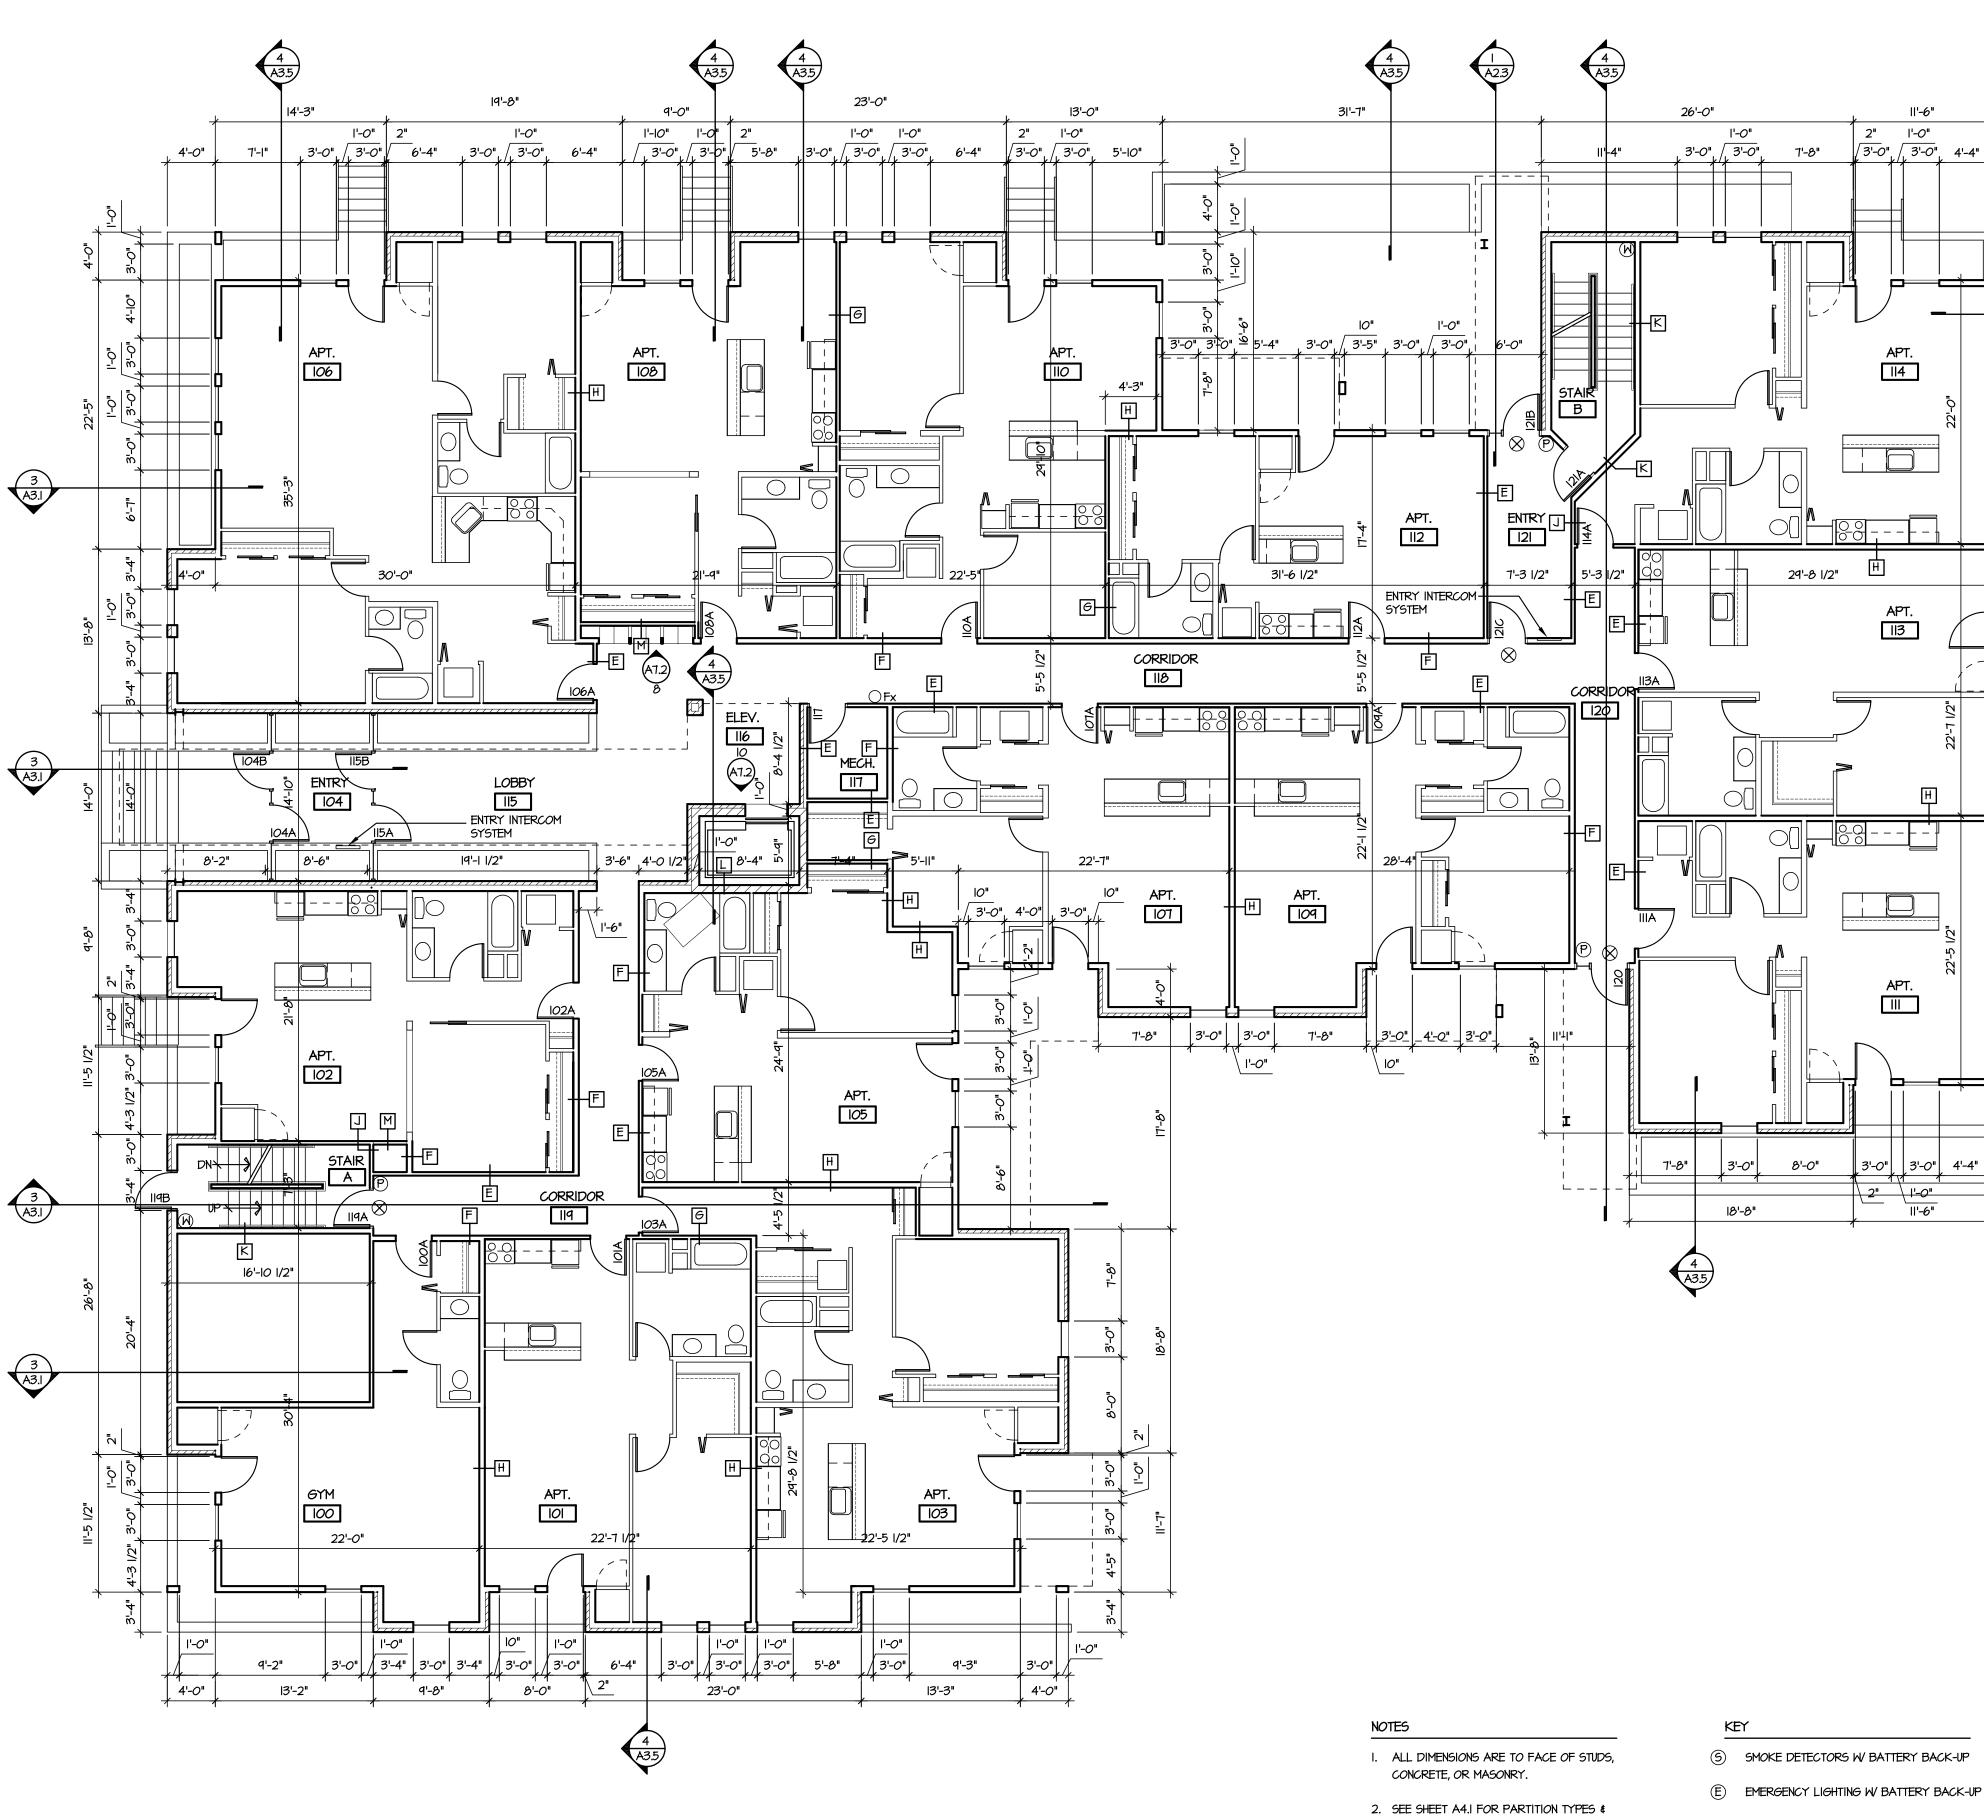



- ROOM FINISH SCHEDULES.
- 3. SEE SHEET CI.2 FOR CONTINUATION OF SITE FEATURES.
- 4. SEE SHEET AT.I FOR INTERIOR ELEVATIONS.
- (W) CLASS I STANDPIPES A PARTITION TYPES

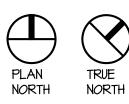

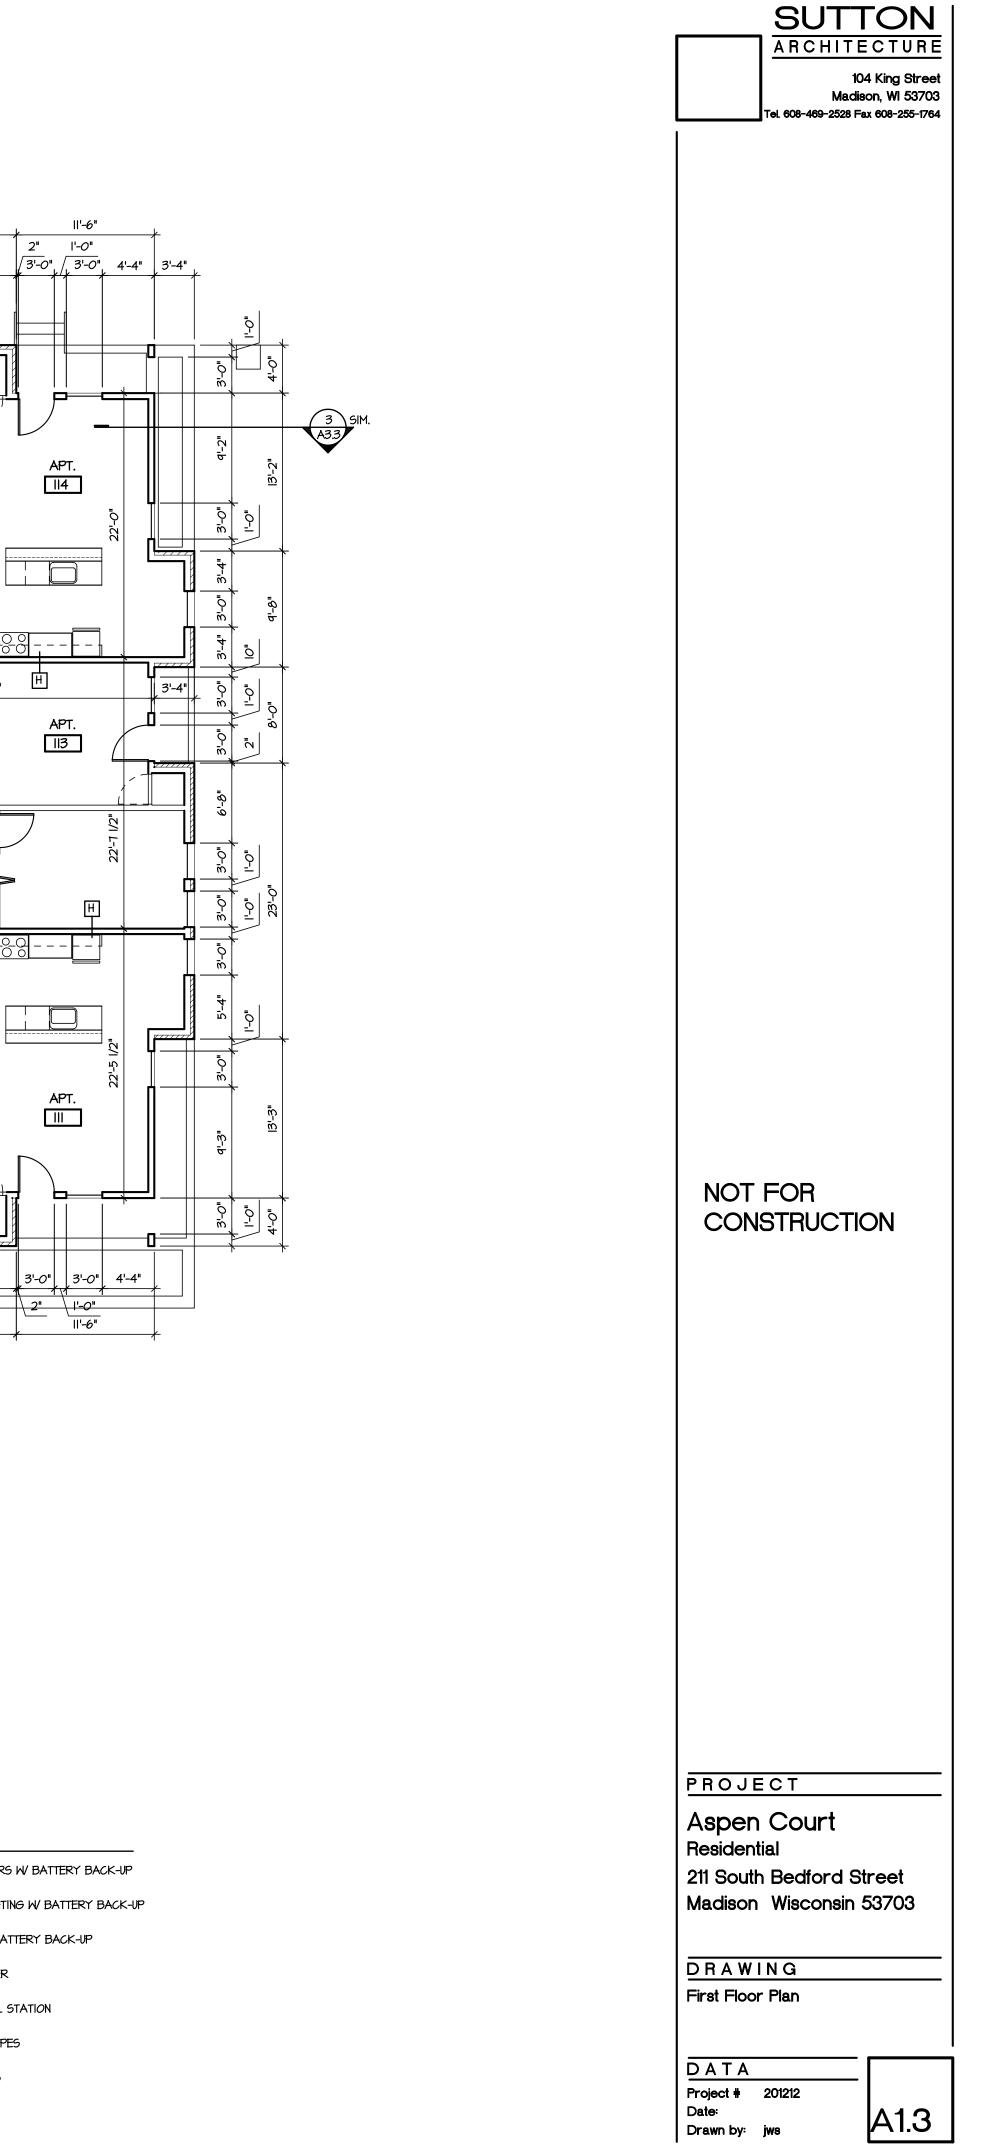

(5) SMOKE DETECTORS W BATTERY BACK-UP

APT.

||4


APT. II3

Apt.

EXIT LIGHTS W BATTERY BACK-UP


 \bigcirc Fx FIRE EXTINGUISHER

P FIRE ALARM PULL STATION

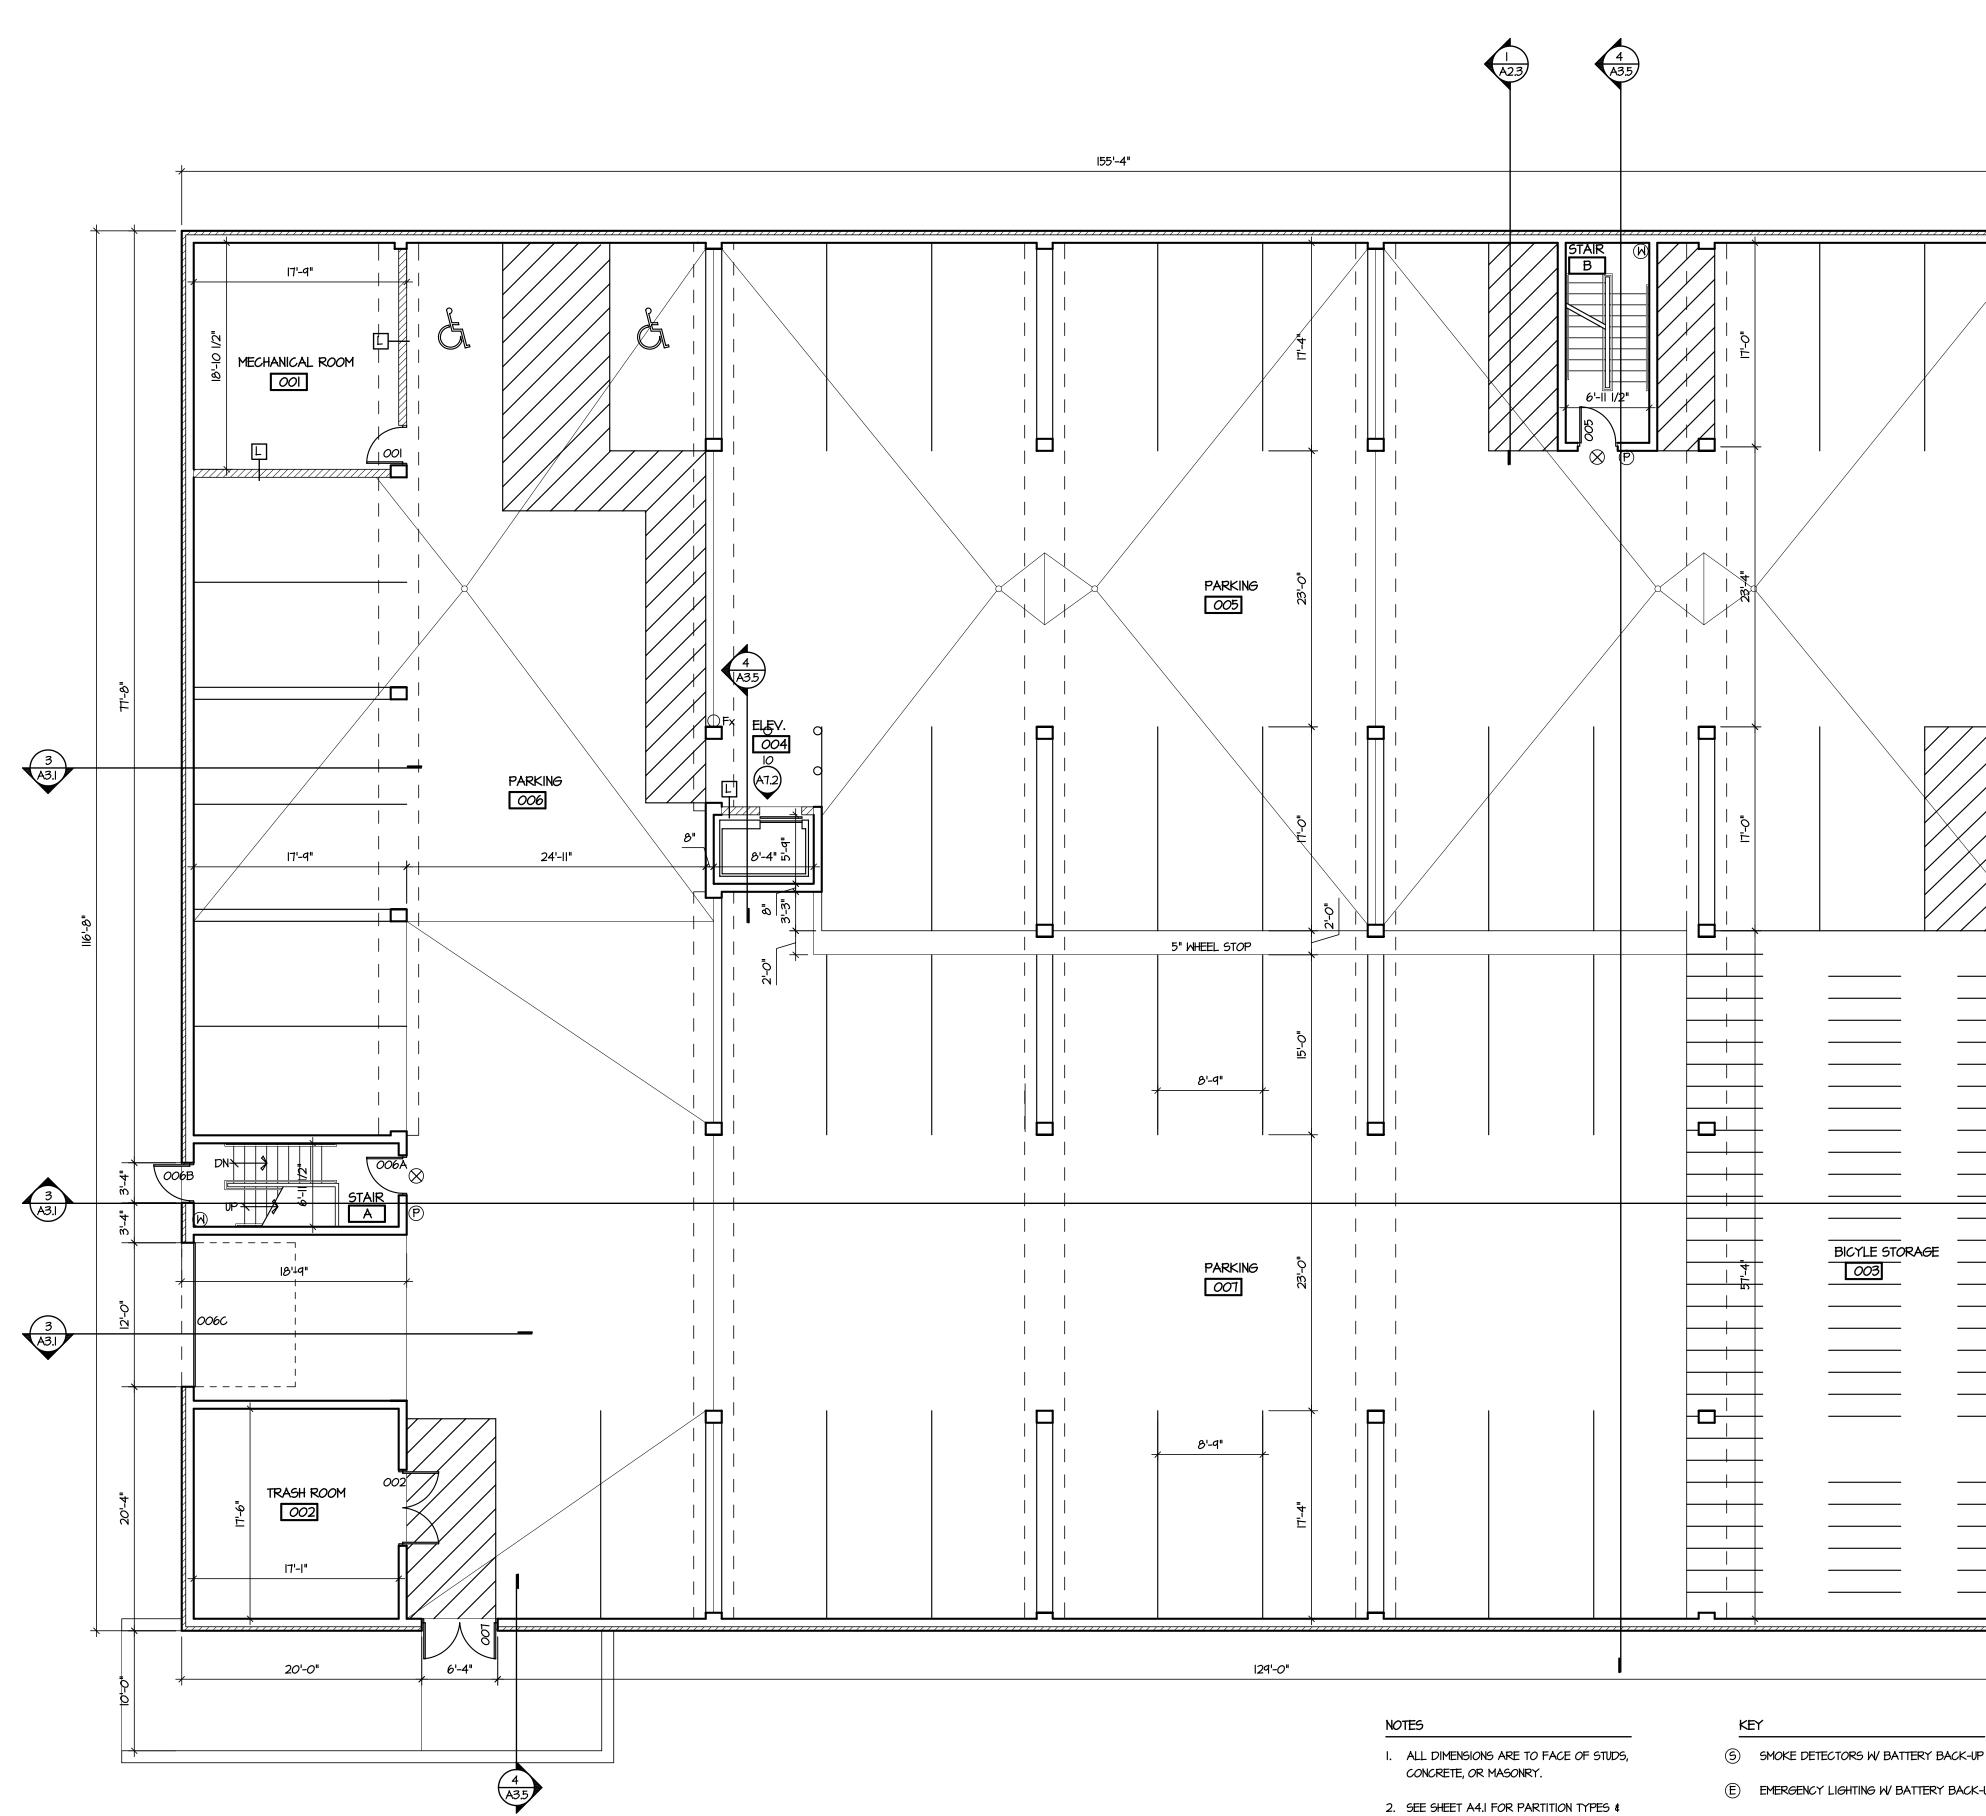


- 2. SEE SHEET A4.1 FOR PARTITION TYPES \$ ROOM FINISH SCHEDULES.
- 3. SEE SHEET CI.2 FOR CONTINUATION OF SITE FEATURES.
- 4. SEE SHEET AT.I FOR INTERIOR ELEVATIONS.

- 🛞 EXIT LIGHTS W BATTERY BACK-UP ⊖Fx FIRE EXTINGUISHER
- (P) FIRE ALARM PULL STATION
- (W) CLASS I STANDPIPES
- A PARTITION TYPES

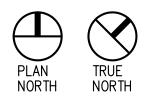


	A R C H I T E C T U R E 104 King Street Madison, WI 53703 Tel. 608-469-2528 Fax 608-255-1764
	NOT FOR CONSTRUCTION
ሪK-ሆP BACK-ሆP	PROJECT Aspen Court Residential 211 South Bedford Street Madison Wisconsin 53703 DRAWING Parking Level A DATA
	Project # 200201 Date: Drawn by: jws

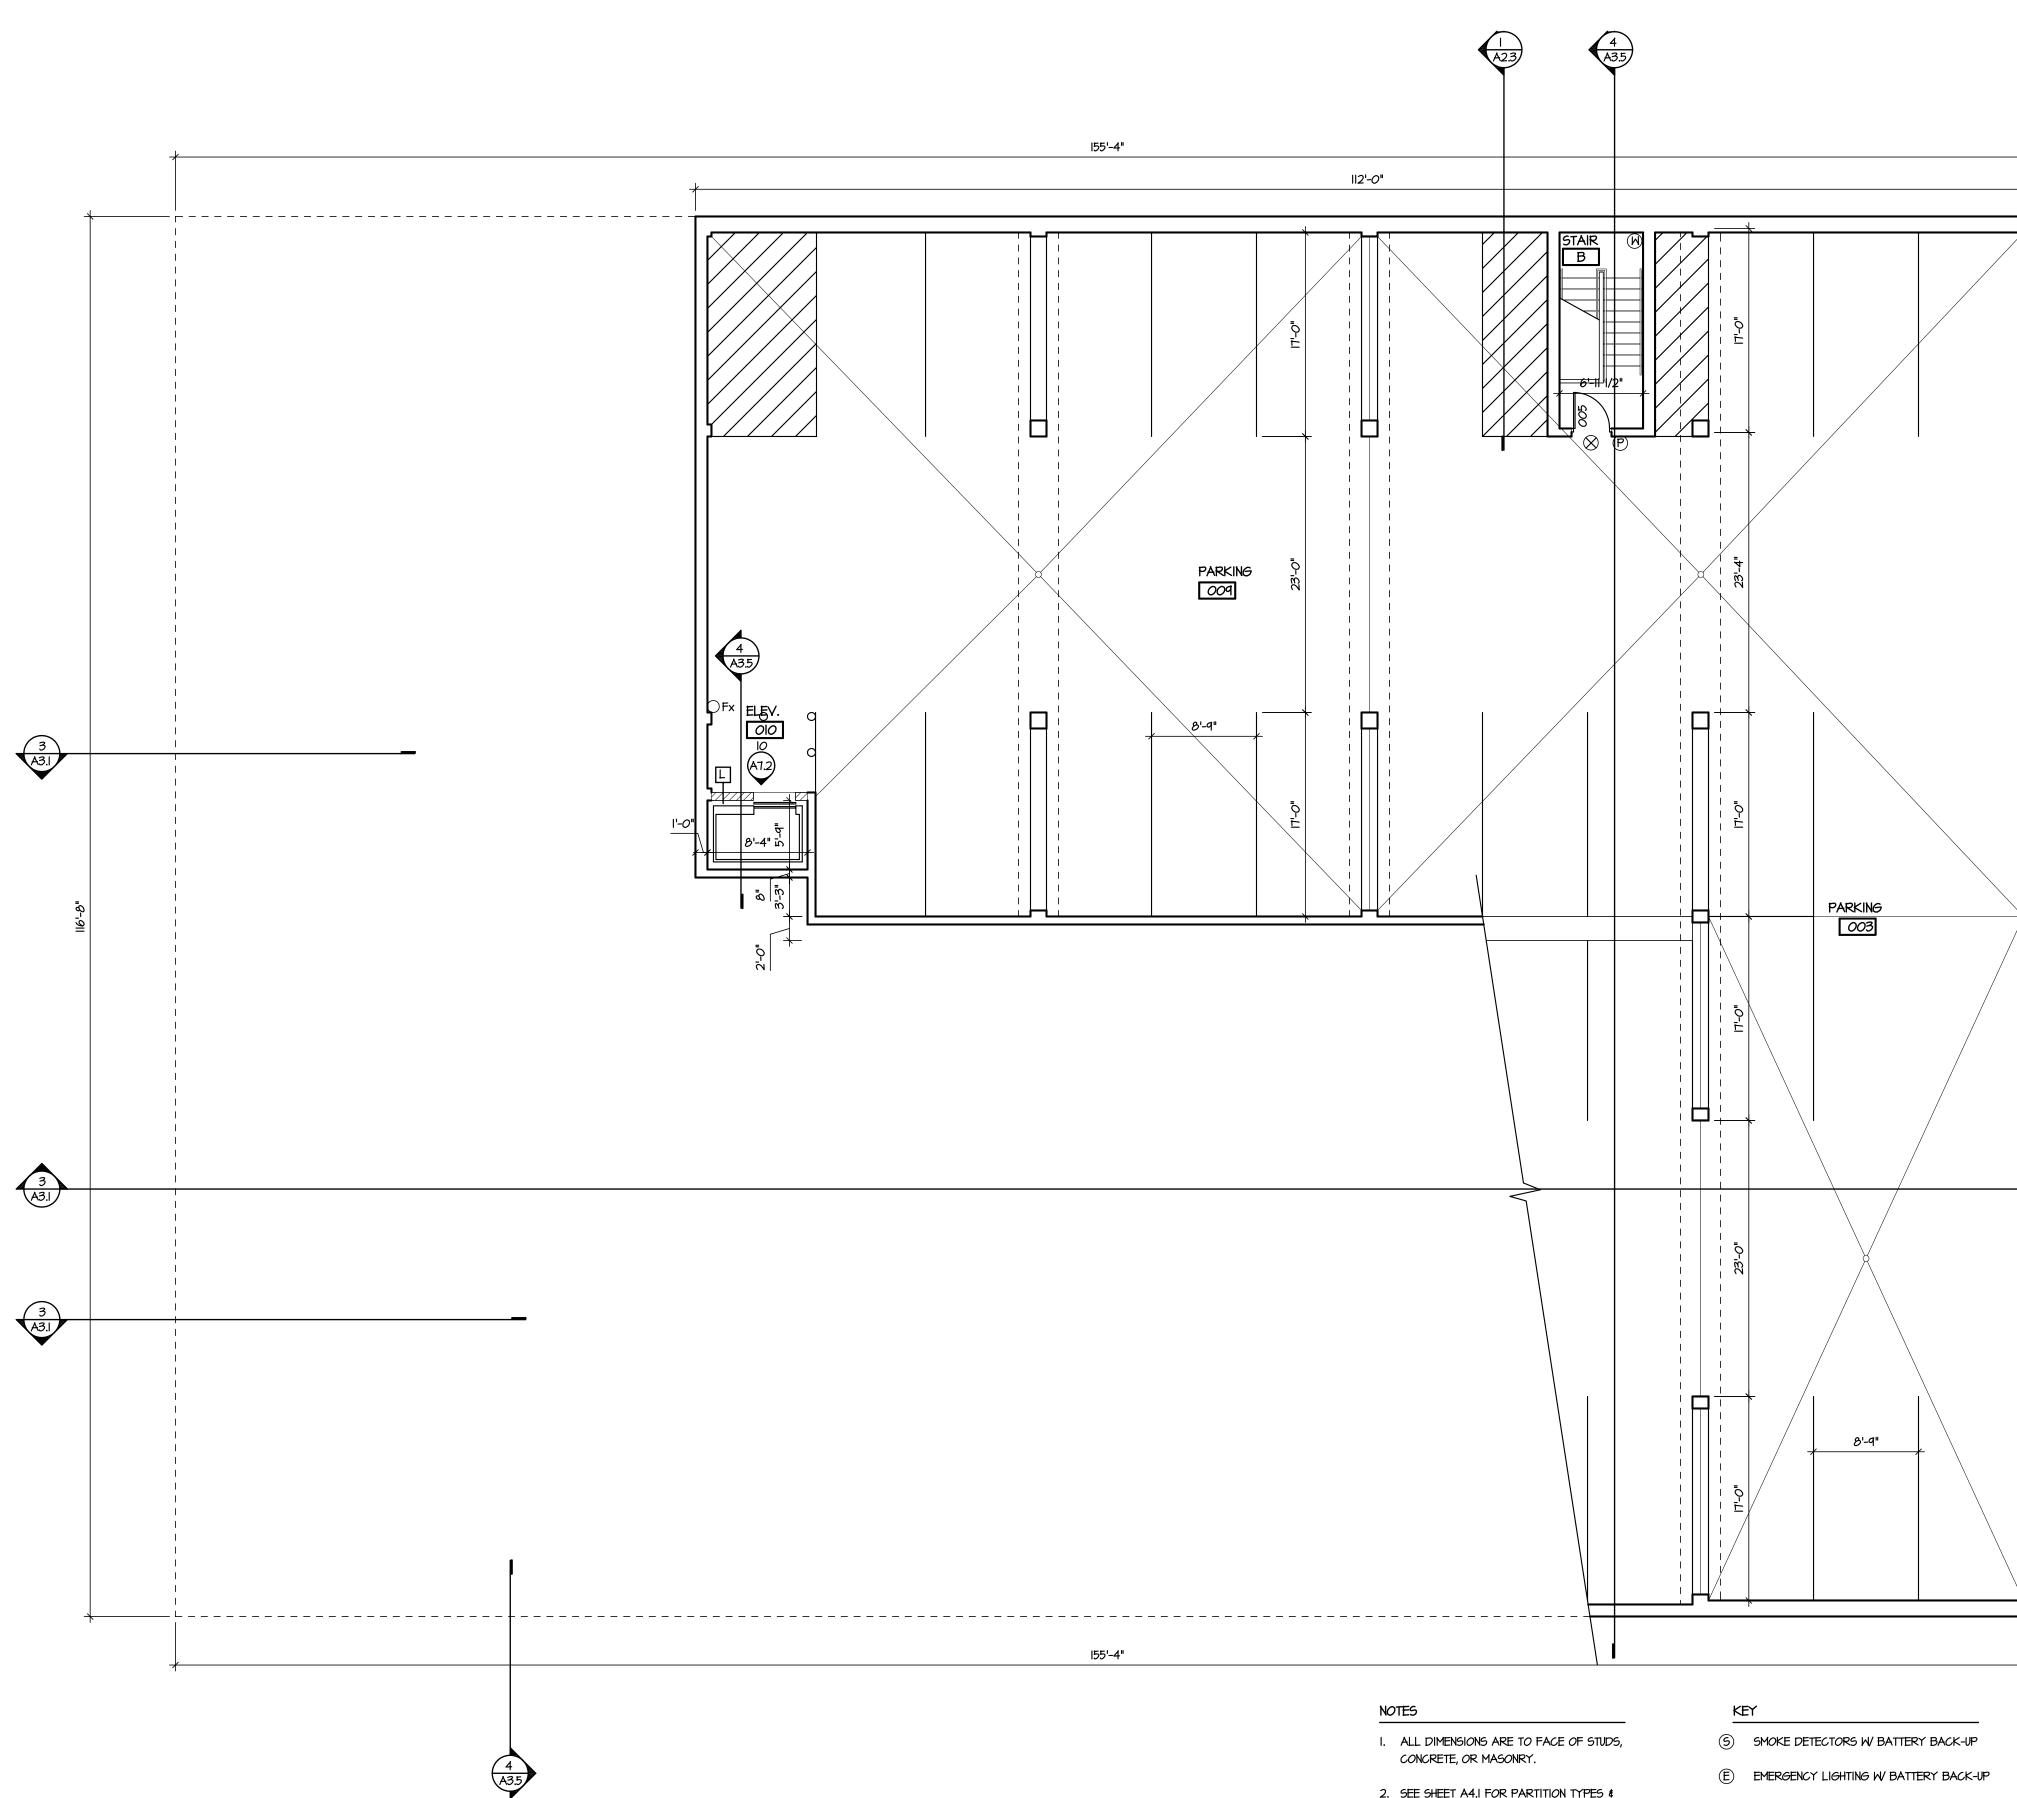


I GARAGE PARKING LEVEL AI.I SCALE: 1/8" = 1'-0"

- 2. SEE SHEET A4.I FOR PARTITION TYPES & ROOM FINISH SCHEDULES.
- 3. SEE SHEET CI.2 FOR CONTINUATION OF SITE FEATURES.
- 4. SEE SHEET A7.1 FOR INTERIOR ELEVATIONS.

- EXIT LIGHTS W BATTERY BACK-UP
- ⊖Fx FIRE EXTINGUISHER
- P FIRE ALARM PULL STATION
- (W) CLASS I STANDPIPES
- A PARTITION TYPES

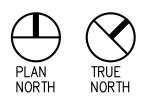


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PROJECT Aspen Court
Residential 211 South Bedford Street Madison Wisconsin 53703
DRAWING Parking Level B DATA
Project # 200201 Date: Drawn by: jws A1.1

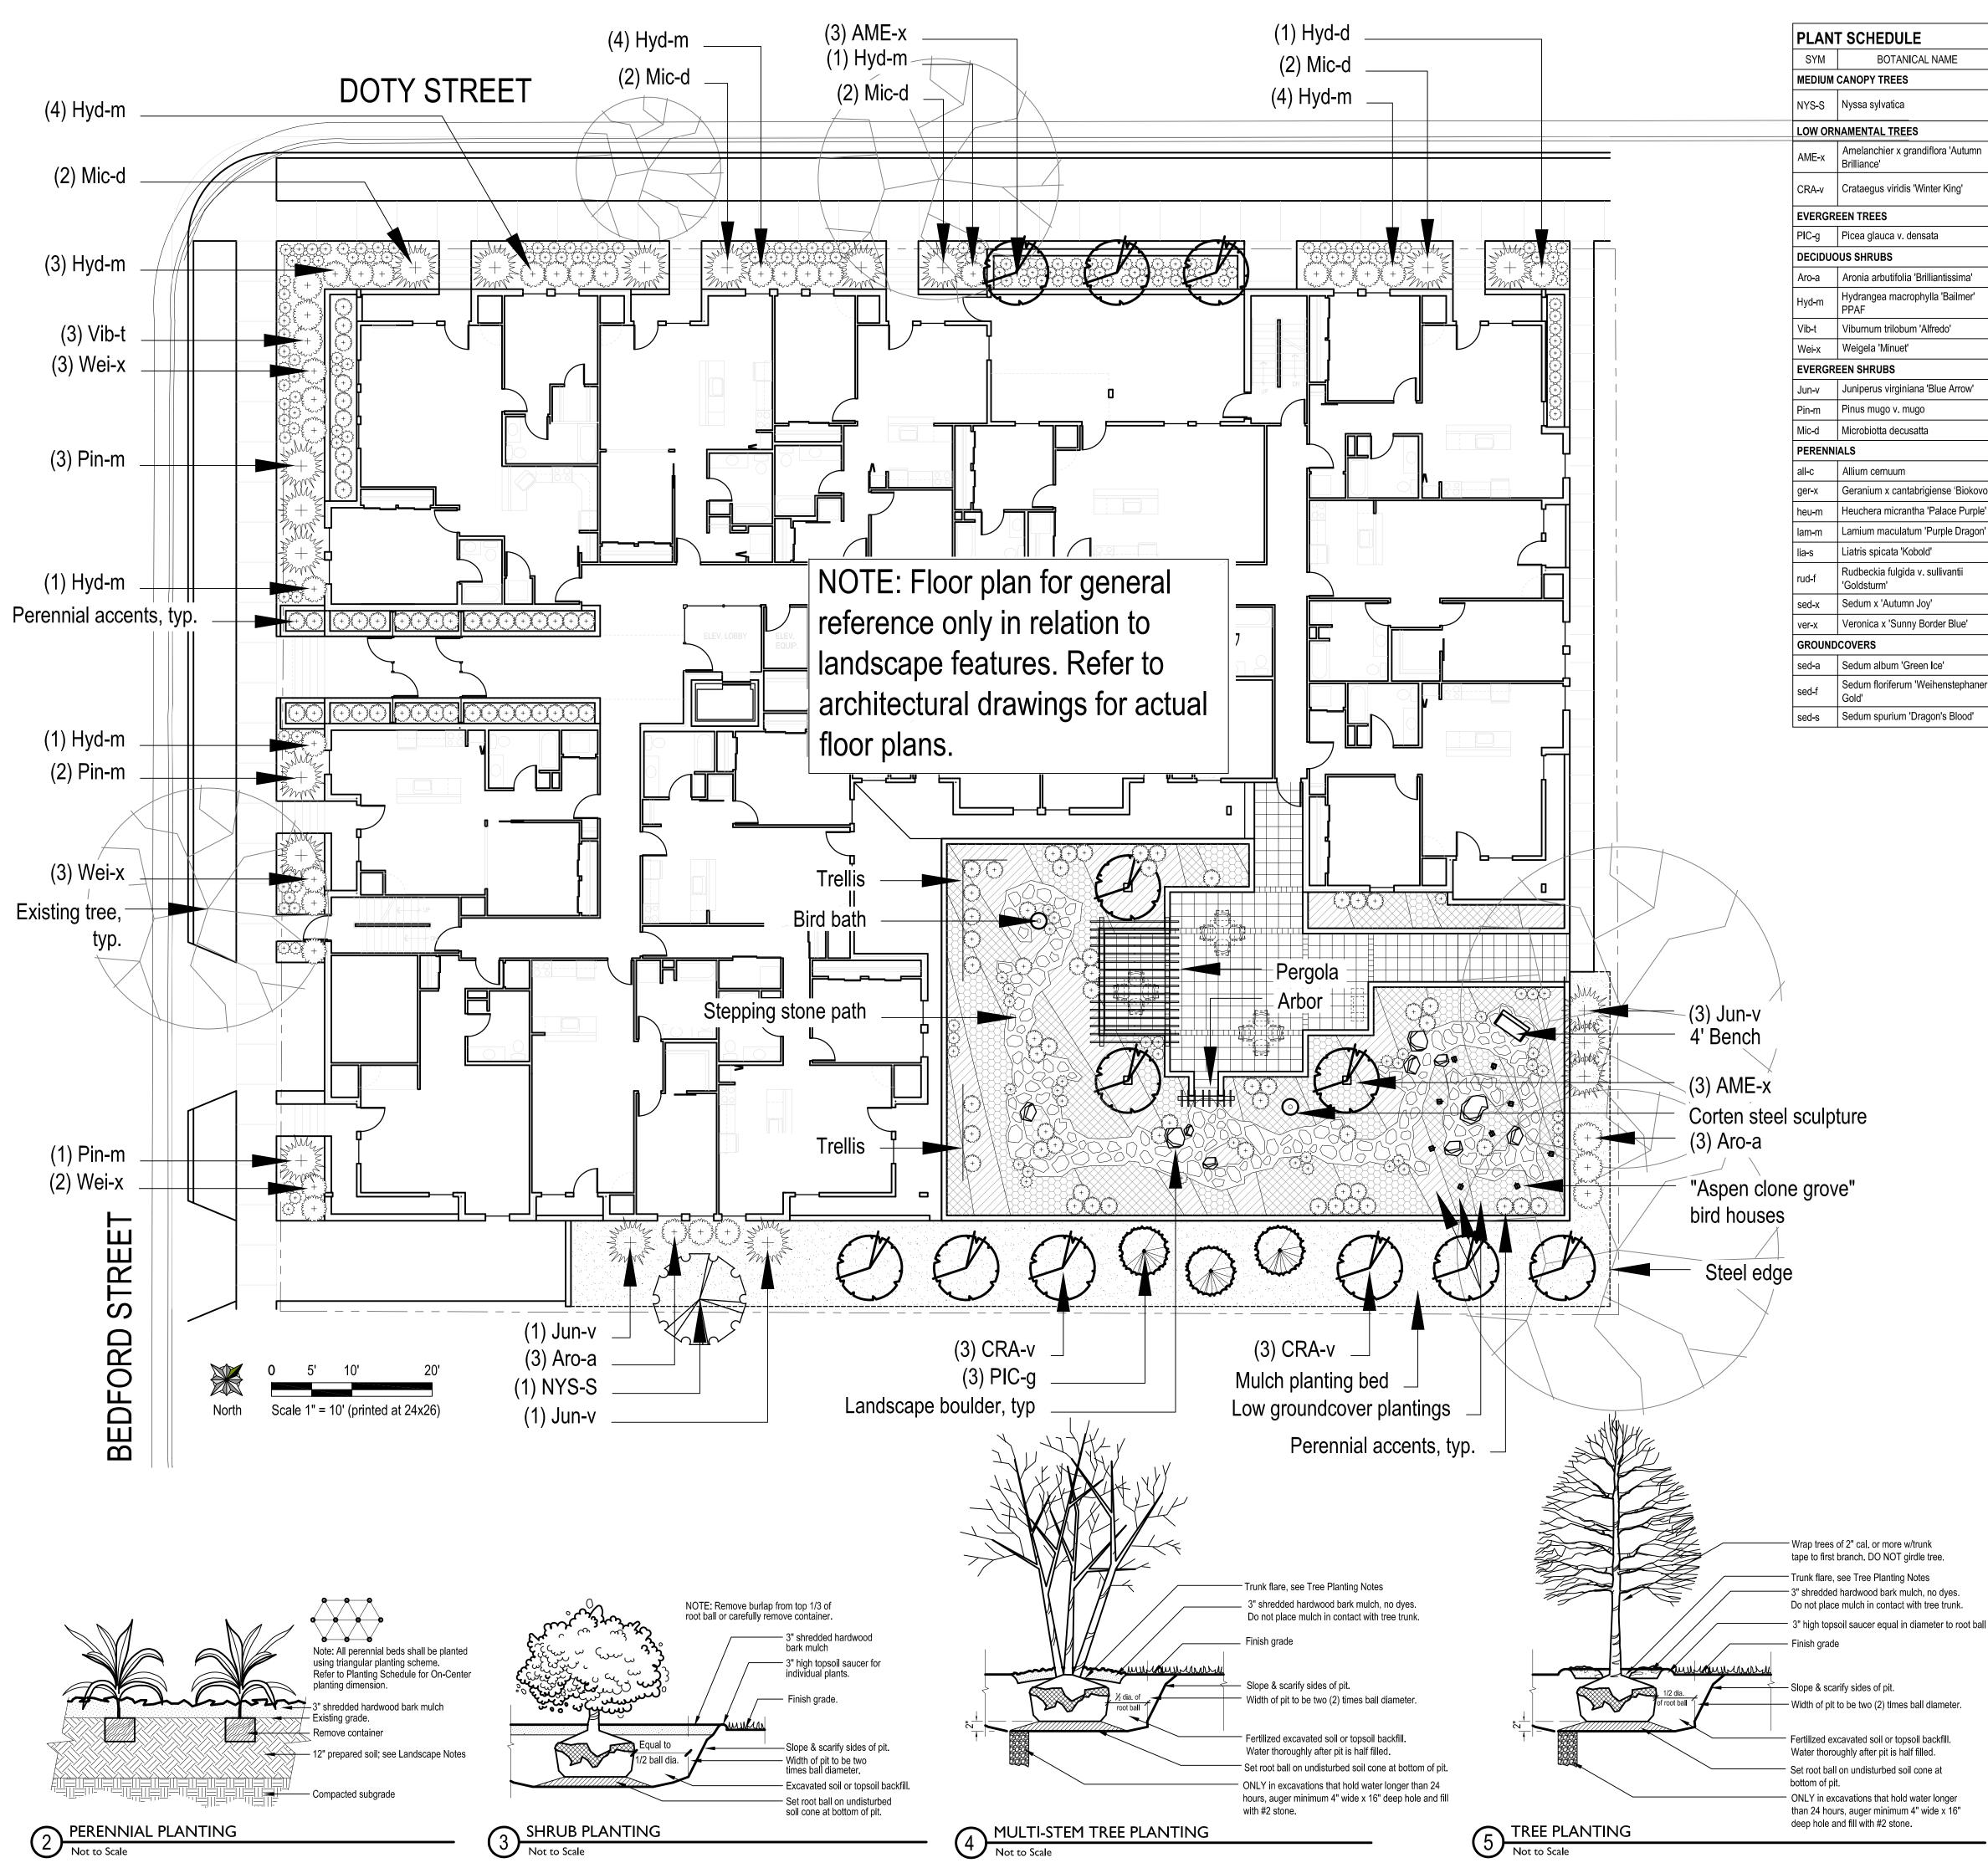



1E	COMMON NAME	SIZE	ROOT	NOTES	MATURE SIZE	DETAI	
	Black Tupelo	1.5" cal	B&B	Full, symmetrical, strong central leader	30'-50' H x 20'-30' W	5/L1.1	
			-	-		-	
'Autumn	Autumn Brilliance Serviceberry	8' ht	B&B	Full, matched, 3-5 stems	15'-25' H x 15'-25' W	4/L1.1	
ing'	Winter King Hawthorn	8' ht	B&B	Full, matched, single-stemmed	25'-35' H x 25'-35' W	5/L1.1	
	Black Hills Spruce	5' ht	B&B	Symmetrical	20'-40' H x 10'-15' W	6/L1.1	
ssima'	Brilliant Red Chokeberry	24"	cont.		6' H x 3' W		
ailmer'	Endless Summer Hydrangea	24"	cont.		3' H x 4' W	3/L1.1	
1	Compact American Cranberry	36"	cont.		5' H x 5' W		
	'Minuet' Weigela	18"	cont.		2' H x 3' W		
	•			•			
Arrow'	Blue Arrow Juniper	4'	cont.		10'-12' H x 3'-4' W		
	Mugho Pine	18"	cont.		3'-5' H x 3'-4' W	- 3/L1.1	
	Russian Cypress	12"	cont.		12"-18" H x 4'-5' W		
	Nodding Onion	1/2 gal	cont.				
e 'Biokovo'	'Biokovo' Cranesbill	1/2 gal	cont.				
e Purple'	Coralbells 'Palace Purple'	1/2 gal	cont.			2/L1.1	
e Dragon'	'Purple Dragon' Spotted Dead Nettle	1/2 gal.	cont.				
	Kobold Spike Gayfeather	1/2 gal	cont.				
antii	Goldsturm Orange Coneflower	1/2 gal	cont.				
	Autumn Joy Sedum	1/2 gal	cont.				
Blue'	'Sunny Border Blue' Speedwell	1/2 gal	cont.				
	'Green Ice' Stonecrop		plug	white flowers Jun - Jul	1"-2" H x 10" W	2/L1.1	
stephaner	'Weihenstephaner Gold' Stonecrop		plug	yellow flowers Jun - Jul	3"H x 10" W		
Blood'	'Dragon's Blood' Stonecrop		plug	red flowers Jun - Aug	3"-4" H x 10" W		

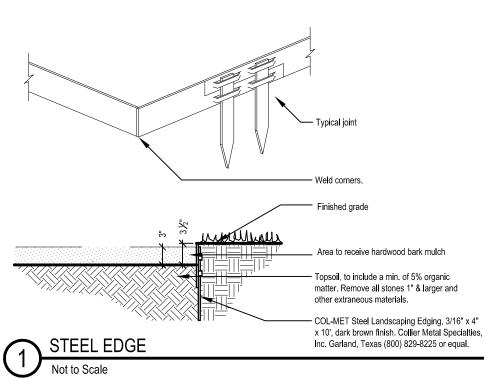


TREE PLANTING NOTES (ALL TREES)

- . Mark the north side of the tree in the nursery and rotate tree to face north at the site whenever
- possible. . Each tree must be planted such that the trunk flare is visible at the top of the root ball. Trees where the trunk flare is not visible shal be rejected. Do not cover the trunk flare with soil.
- 3. If the root ball is wrapped in plastic or other non-biodegradable material, remove the entire wrap. If the root ball is wrapped in burlap, remove burlap and wire baskets from tops of root balls and partially from sides, but do not remove from under root balls.

EVERGREEN TREE PLANTING NOTES:

. This detail used for evergreens 6' or less in size; other evergreens staked in standard fashion. 2. Do not prune evergreens except under direction of Landscape Architect.

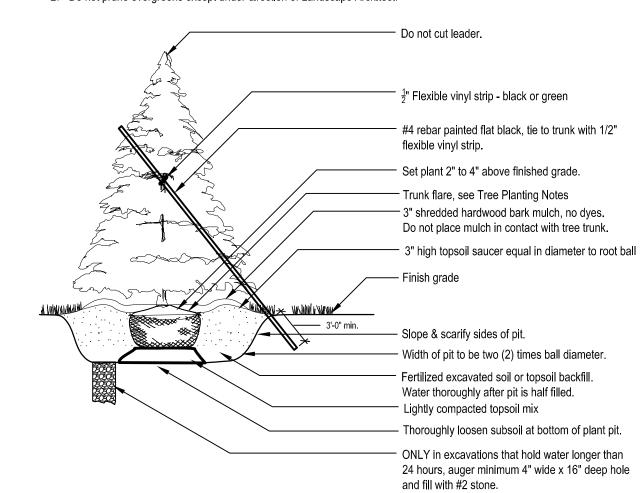

CONSULTANT PLANDESIgn Plandesign LLC • 480 Maynard Drive • Sun Prairie, Wi 53590 Tel 608.318.1217 • Fax 608.318.1216 • www.plandesignilc.com © 2012 Plandesign LLC. All rights reserved. These Drawings and Specifications, and all copies thereof are and shall remain the property and copyright of the Landscape Architect. They shall be used only with respect to this Project and are not to be used on any other Project or Work without prior written permission from the Landscape Architect. Plandesign LLC Job No: 2012-.31 Plandesign LLC File: 2012-031 Aspen Court\Dwg\2012-031-L-Series-1-PlanSubmittal.dwg Drawn by: ASA OWNER Les Orosz (608) 347-5432 University Avenue Madison, Wisconsin PROJECT

SUTTON

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ARCHITECTURE

el. 608-255-1245 Fax 608-255-1764

Aspen Court Apartments

211 South Bedford Street Madison, Wisconsin 53703

DRAWING LANDSCAPE PLAN

DATA Project # 201111 Date: 2012.05.23 Drawn by:

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6 EVERGREEN TREE PLANTING Not to Scale