
# APPLICATION FOR URBAN DESIGN COMMISSION REVIEW AND APPROVAL

AGENDA ITEM #_	
Project #	

DATE SUBMITTED  UDC MEETING DA	D: August 25, 2010 TE: September 1, 2010	Action Requested Informational Presentation Initial Approval and/or Recommendation X Final Approval and/or Recommendation				
		<u></u>				
PROJECT ADDRES	S: 4620 Frey Street (formerly 709 N	. Segoe Road)				
ALDERMANIC DIS	TRICT: District #11, Chris Schmidt					
OWNER/DEVELOP	ER (Partners and/or Principals)	ARCHITECT/DESIGNER/OR AGENT:				
Stone House Devel	lopment, Inc.	Knothe & Bruce Architects, LLC				
321 E. Main Street	<u>:                                      </u>	7601 University Avenue, Suite 201				
Madison, WI 5370	3	Middleton, Wisconsin 53562				
CONTACT PERSON:	J. Randy Bruce/Knothe & Bruce Arch	tects, LLC				
Address: _	7601 University Avenue, Suite 201					
-	Middleton, Wisconsin 53562					
Phone:	608-836-3690					
Fax:	608-836-6934					
E-mail address	: rbruce@knothebruce.com					
General Do X Specific In Planned Commun General Do Specific In Planned Resident New Construction required as well a School, Public B New Construction 50,000 Sq.Ft Planned Commen (See Section B for:)	uilding or Space (Fee may be required) on or Addition to or Remodeling of a Ret	ail, Hotel, or Motel Building Exceeding				
New Constructio	on or Exterior Remodeling in C4 District	(Fee required)				
(See Section C for:)  R.P.S.M. Parking	g Variance (Fee required)					
_	Design Review* (Fee required) Variance* (Fee Required)					
<pre> Other *Public Hearing Requirements</pre>	red (Submission Deadline 3 Weeks in A	dvance of Meeting Date)				

# **Locator Map**

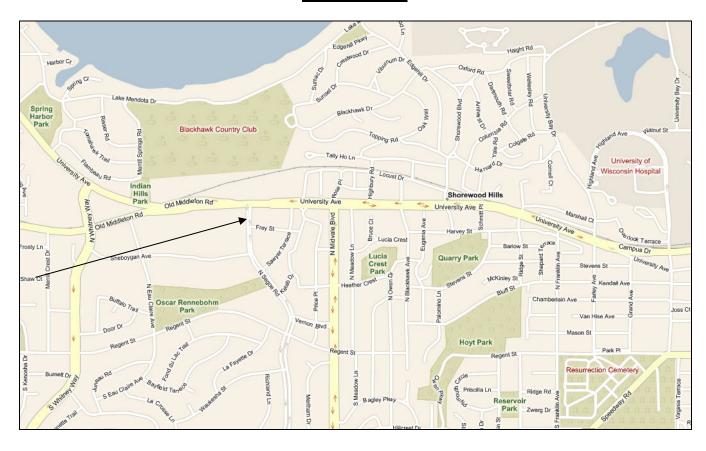



August 25, 2010

Mr. Brad Murphy
Director of Planning
Department of Planning & Development
City of Madison
215 Martin Luther King Jr. Blvd
PO Box 2985
Madison, Wisconsin 53701

Re: Letter of Intent

Amended PUD-GDP-SIP

4620 Frey Street (formerly 709 N. Segoe Road)

Madison, WI

Dear Mr. Murphy:

The following is submitted together with the plans, application and zoning text for staff, Plan Commission and Common Council consideration of approval.

# Organizational structure:

Owner: Stone House Development, Inc.

321 East Main Street Madison, WI 53703 608-251-6000 608-251-6077 fax Contact: Rich Arnesen

rarnesen@stonehousedevelopment.com

Engineer: Vierbicher Associates, Inc

999 Fourier Drive , Suite 201

Madison, Wisconsin 53717

(608) 826-0532

Contact: Dave Glusick dglu@vierbicher.com

Architect:

Knothe & Bruce Architects, LLC 7601 University Avenue, Ste 201

Middleton, WI 53562

608-836-3690 608-836-6934 fax Contact: Randy Bruce rbruce@knothebruce.com

Landscape Design: Ken Saiki Design 303 S. Paterson St.

Suite 1

Madison, WI 53703 (608) 251-3600 Contact: Mike Sturm msturm@ksd-la.com Letter of Intent – PUD-GDP-SIP 4620 Frey Street (formerly 709 N. Segoe Road) August 25, 2010 Page 2 of 3

### Introduction:

The proposed site is located on the east side of North Segoe Road on the remaining parcel of land adjacent to the recently approved Target. Other surrounding uses include Weston Place Condominiums to the south along Frey Road: the Pyare Square building and McDonalds to the north along University Avenue and the State office buildings to the west and North. The development team has been meeting with the alderperson and the neighbors while putting together this development proposal.

The apartments will be developed using WHEDA's Section 42 tax credit housing program. WHEDA recently announced that this project was successful in obtaining the tax-credit allocation. While the apartments will be affordably priced, they will also provide a high-quality living environment and the amenities that are consistent with the neighborhood.

The current Target lot, which will be created by a soon to be recorded CSM, will be further subdivided to create the subject parcel. That subdivision will be approved concurrently with this proposed PUD-SIP.

### **Project Description:**

The project consists of two linked 4-story apartment buildings with 96 units. The buildings step down the sloped site and are four stories in height with a flat roof. The high-quality exterior materials will be a combination of masonry, fiber-cement board siding and metal panels. The exterior materials were chosen to be compatible with the adjacent Westin Place and Target buildings while maintaining a modern residential aesthetic. The street-side elevations of the buildings are well detailed and landscaped, and are punctuated with individual entries to the dwelling units. Many of the first floor units are townhomes with entry porches along Frey Street and N. Segoe Road.

The buildings are placed close to the site perimeter to enhance the public streetscapes. Pedestrian access is planned throughout the site connecting the buildings and users to the perimeter streets and surrounding retail and office uses. Vehicular access is accommodated from Frey Street with access to both the parking areas. Parking is largely accommodated below the buildings with a two level underground parking garage. Convenient bicycle parking is provided in the courtyard area, entrances and basement parking. The trash collection will be accommodated from the University Avenue entry through a cross-access easement with Target.

The exterior open space of the development, while somewhat limited, is well designed and provides attractive areas for the residents and guests. A ground level plaza opens onto the landscaped lawns and provides an area for informal social gatherings. A generous Commons Room is provided on the upper floor which opens onto a roof terrace for additional usable open space. The Commons and roof deck will afford the opportunity to have a multitude of planned functions for the residents as well as extensive views to the north and east. In addition to the common open spaces, the overwhelming majority of the apartments will have a porch or balcony for private open space.

The new construction will be environmentally conscious and meet the standards of Wisconsin Green Built Homes.

Letter of Intent – PUD-GDP-SIP 4620 Frey Street (formerly 709 N. Segoe Road) August 25, 2010 Page 3 of 3

# Site Development Data:

**Dwelling Unit Mix:** 

One-Bedroom44Two-Bedroom42Three-Bedroom Townhomes10Total Dwelling Units96

Densities:

Lot Area 58,909 or 1.35 Acres

Lot Area / D.U. 613.6 SF/unit Density 71 units/acre

Building Height: Four Stories

Vehicle Parking:

Underground 120 stalls Surface 20 stalls

Total 140 stalls or 1.45 stalls/unit

Bicycle Parking:

Underground 59 stalls Surface- standard 2'x6' 28 stalls

Total 87 stalls (50 + .5(46)=73 required)

# Project Schedule:

It is anticipated that the new construction phase will start in the fall of 2010 and be completed in summer 2011.

### Social & Economic Impacts:

This development will have a positive social and economic impact. The development will substantially increase the City tax base with minimal, if any, increased costs to the City. The development will enhance the Hilldale area and provide new workforce housing while promoting pedestrian, bicycle and mass-transit circulation.

Thank you for your time in reviewing our proposal.

Very Truly Yours,

J. Randy Bruce, AIA Managing Member

# EXHIBIT A DESCRIPTION


A parcel of land being part of Lot 2, Certified Survey Map Number 12930, as recorded in Volume 82 of Certified Survey Maps, on Pages 160-180, as Document Number 4667665, Dane County Registry, also located in the NE ¼ of the NW ¼ and the NW ¼ of the NE ¼, all in Section 20, Township 07 North, Range 09 East, in the City of Madison, Dane County, Wisconsin, more fully described as follows:

Commencing at the Northeast corner of said Lot 2, said point also lying on the southerly rightof-way line of University Avenue; thence along the boundary line of said Lot 2 for the next thirteen (13) courses; 1-thence South 00 degrees 28 minutes 48 seconds East, 226.39 feet to a point of non-tangential curvature; 2-thence Southeasterly along a curve to the right, having a radius of 9.00 feet and a chord bearing South 09 degrees 42 minutes 37seconds East, 7.83 feet; 3-thence South 16 degrees 05 minutes 17 seconds West, 156.52 feet; 4- thence North 80 degrees 14 minutes 35 seconds West, 107.38 feet; 5-thence North 82 degrees 01 minute 33 seconds West, 246.77 feet to a point of non-tangential curvature; 6-thence Northwesterly along the arc of a curve to the left which has a radius of 2865.00 feet and a chord bearing North 85 degrees 05 minutes 22 seconds West, 303.04 feet to the point of beginning; 7-thence continuing Northwesterly along the arc of a curve to the left which has a radius of 2865.00 feet and a chord which bears North 88 degrees 11 minutes 28 seconds West, 7.01 feet; 8-thence North 83 degrees 23 minutes 34 seconds West, 80.93 feet to a point of non-tangential curvature; 9-thence Northwesterly along the arc of a curve to the left which has a radius of 2873.00 feet and a chord which bears South 89 degrees 10 minutes 56 seconds West, 95.10 feet to a point of reverse curve; 10-thence Northwesterly along the arc of a curve to the right which has a radius of 15.00 feet and a chord which bears North 46 degrees 55 minutes 14 seconds West, 21.16 feet to the Easterly right-of-way line of North Segoe Road; 11-thence along said Easterly right-of-way line, North 02 degrees 04 minutes 30 seconds West, 260.70 feet to a point of curve; 12-thence Northeasterly along the arc of a curve to the right which has a radius of 15.00 feet and a chord which bears North 43 degrees 43 minutes 20.5 seconds East, 21.51 feet to the aforementioned southerly right-of-way line of University Avenue; 13-thence along said Southerly right-of-way line, North 89 degrees 31 minutes 11 seconds East, 190.75 feet; thence South 00 degrees 20 minutes 17 seconds East, 300.31 feet to the point of beginning. Said description contains 58,909 square feet or 1.35 acres.

# Beta Catalog Number:



Notes:

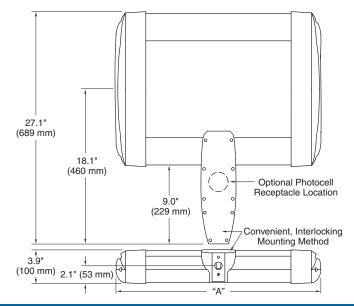

Product	Housing			Initial Delivered	LED		Color	Factory-Installed Options
Family	Indicator	<b>Optics</b>	Mounting	Lumens (00's)	Performance	Voltage	<b>Options</b>	If choosing more than one option, please type in manually on the lines provided above.
BLD	ARE	$T3^1$	$\mathbf{D}\mathbf{A}^3$	017	LED-B	UL	SV	EM–Emergency <sup>4</sup>
		$3B^2$		034		(120–277V	BZ	F–Fuse
				051		Universal) UH	BK WH	HL-Hi/Low (175/350/525, dual circuit input) <sup>5-8</sup>
				068 085		(347–480V	w п PB	P-Photocell <sup>6</sup>
				102		Universal)	1 D	R-NEMA Photocell Receptacle
				119		12		TL-2-Level (175/525 w/ integrated sensor control) <sup>5,7</sup>
				136		27		TL1-2-Level (350/700 w/ integrated sensor control) <sup>5,7</sup>
				153		34		TL2-2-Level (0/350 w/ integrated sensor control) <sup>7,9,10</sup>
				170				TL3-2-Level (0/525 w/ integrated sensor control) <sup>5,7</sup>
				187				TL4-2-Level (0/700 w/ integrated sensor control) <sup>5,7</sup>
				204				35K–3500k Color Temperature <sup>11</sup>
								43K–4300k Color Temperature <sup>11</sup>
Footnotes	5							525–525mA Drive Current <sup>12</sup>

- 1-IESNA Type III distribution
- 2-IESNA Type III distribution with backlight control
- 3-Direct mounting arm

Output Mult	ipliers
Color Temperature	Lumen Multiplier
6000K (Standard)	1.00
4300K	0.80
3500K	0.75
Ambient	Lumen

Ambient Temperature (°C)	Lumen Multiplier
-20	1.11
10	1.04
25	1.00
40	0.96

Drive Current	Lumen Multiplier	Power Multiplier	L <sub>70</sub> Life* (hours)
175mA	0.6	0.5	> 150,000
350mA (Standard)	1.0	1.0	> 150,000
525mA	1.3	1.5	70,000

\* Based on fixture operating at 15° C. Refer to LED Ambient spec sheet.

- 4-Emergency mode delivers 1 light bar 350mA lumen output, consult LED Emergency Spec Sheet for further details
- 5-Available for 1-6 light bar fixtures
- 6-Must specify voltage other than UL or UH
- 7-Refer to multi level spec sheet for more information
- 8-Sensor not included

- - 9-May be ordered with 525mA drive current
  - 10-Available for 1-12 light bar fixtures
  - 11-Color temperature per fixture
  - 12-Driver operates at 525mA instead of the standard 350mA providing a higher lumen output and a shorter life

LED Performance Generation B Specs*							
Light Bars	Initial Delivered Lumens – Type III Optic	Initial Delivered Lumens – Type III Optic w/ Backlight Shield	System Watts 120-277V	System Watts 347-480V	Dim. "A"/in.		
1	1,750 (017)	1,160 (017)	28	30	11.75		
2	3,500 (034)	2,320 (034)	55	59	11.75		
3	5,250 (051)	3,480 (051)	79	84	13.75		
4	7,000 (068)	4,640 (068)	104	109	15.75		
5	8,750 (085)	5,800 (085)	128	133	17.75		
6	10,500 (102)	6,960 (102)	153	156	19.75		
7	12,250 (119)	8,120 (119)	183	194	21.75		
8	14,000 (136)	9,280 (136)	207	218	23.75		
9	15,750 (153)	10,440 (153)	232	242	25.75		
10	17,500 (170)	11,600 (170)	257	266	27.75		
11	19,250 (187)	12,760 (187)	281	290	29.75		
12	21,000 (204)	13,920 (204)	306	313	31.75		
* Basea	l on 6000k color tempe	rature fixture operatin	g at 350mA	and 25C An	ıbient.		



Beta LED 1200 92nd Street

Sturtevant, WI 53177

800-236-6800

www.BetaLED.com

#### **General Description**

Slim, low profile design minimizes wind load requirements. Fixture sides are rugged cast aluminum with integral, weather-tight LED driver compartments and high performance aluminum heatsinks. Convenient, interlocking mounting method. Mounting housing is rugged die cast aluminum and mounts to 3 – 6" square or round pole. Fixture is secured by two (2) 5/16-18 UNC bolts spaced on 2" centers. Includes leaf/debris guard. Five year limited warranty on fixture.

#### **Electrical**

Modular design accommodates varied lighting output from high brightness, white, 6000K (+/- 500k per full fixture), minimum 75 CRI, long life LED sources. 120-277V 50/60 Hz, Class 1 LED drivers are standard. 347-480V 50/60 Hz driver is optional. LED drivers have power factor >90% and THD <20% of full load. Integral weather-tight electrical box with terminal strip for easy power hook-up.

### **Finish**

Exclusive Colorfast DeltaGuard® finish features an E-Coat epoxy primer with an ultra-durable silver powder topcoat, providing excellent resistance to corrosion, ultraviolet degradation and abrasion. Bronze, black, white and platinum bronze powder topcoats are also available. The finish is covered by our 10 year limited warranty.

#### Labels

UL listed in the U.S. and Canada for wet locations and enclosure classified IP66 per IEC 529. Fixture also available with CE listing, RoHS compliant.


#### Patent

US Pat. D576,330; EC000693924; AU314711; AU314710; NZ408891; NZ408892; MX25801, CA Pat. Pend. German 20 2007 013 623.4. US and international patents pending. Design patents/regs. granted and pending.


### Field-Installed Accessories




Bird Spikes XA-BRDSPK No Photo Available NEMA Kit w/ Cover XA-NEMA1

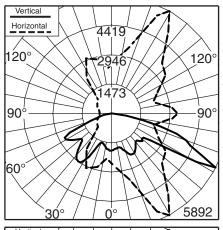


Independent Testing Laboratories certified test. Report No. ITL61147. Candlepower distribution curve of 6 light bar Type III LED luminaire with 10,500 initial delivered lumens operating at 350mA.

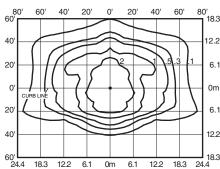

Isofootcandle plot of 6 light
bar Type III LED luminaire
at 20' A.F.G. Luminaire with
10,500 initial delivered
lumens operating at 350mA.
Initial FC at grade.

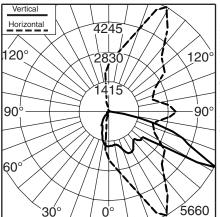

Independent Testing Laboratories certified test. Report No. ITL61148. Candlepower distribution curve of 6 light bar Type III LED luminaire with backlight control and 6,960 initial delivered lumens operating at 350mA.

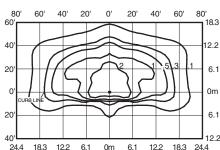

Isofootcandle plot of 6 light bar Type III LED luminaire with backlight control at 20' A.F.G. Luminaire with 6,960 initial delivered lumens operating at 350mA. Initial FC at grade.

LED Area Light EPA Calculations

	LIGHT BARS										
	2	3	4	5	6	7	8	9	10	11	12
Fixed Arm Mount											
1 fixture	0.60	0.60	0.60	0.60	0.60	0.60	0.60	0.60	0.61	0.65	0.69
2 fixtures (180°)	1.20	1.20	1.20	1.20	1.20	1.20	1.20	1.20	1.21	1.29	1.38
2 fixtures (90°)	0.87	0.92	0.96	1.00	1.04	1.08	1.12	n/a	n/a	n/a	n/a
3 fixtures (90°)	1.47	1.51	1.55	1.60	1.64	1.68	1.72	n/a	n/a	n/a	n/a
4 fixtures (90°)	1.75	1.83	1.91	2.00	2.08	2.16	2.24	n/a	n/a	n/a	n/a



Beta LED • 1200 92nd Street • Sturtevant, WI 53177 • 800-236-6800 • www.Beta LED.com

# UNIVERSITY AVENUE

KNOTHE SBRUCE ARCHITECTS

7601 University Avenue Suite 201 Middleton, Wisconsin 53562 608-836-3690 Fax 836-6934

Consultant

Notes

- I. A SIDE WALK WITH A PITCH GREATER THAN 1:20 IS A RAMP. THE MAXIMUM PITCH OF ANY RAMP OR WALK SHALL BE 1:12. RAMPS OVERCOMING MORE THAN 6" CHANGE IN ELEVATION TO HAVE HANDRAILS ON BOTH SIDES.
- 2. ALL DRIVEWAYS, CURB ADJACENT TO DRIVEWAYS, AND SIDEWALK CONSTRUCTION WITHIN THE PUBLIC RIGHT-OF-WAY, SHALL BE COMPLETED IN ACCORDANCE WITH CITY OF MADISON STANDARD SPECIFICATIONS FOR PUBLIC WORKS CONSTRUCTION BY A CONTRACTOR CURRENTLY LICENSED BY THE CITY.
- 3. ALL NEW DRIVES TO BE CONSTRUCTED WITH CLASS III APPROACHES IN ACCORDANCE WITH MADISON GENERAL ORDINANCE SECTION 10.08(4)
- 4. ALL TRASH AND RECYCLING TO BE COLLECTED IN TRASH ROOMS IN THE BUILDING BASEMENTS.
- 5. SEE SITE GRADING AND UTILITY PLANS FOR ADDITIONAL INFORMATION.
- ALL WORK IN THE RIGHT OF WAY SHALL BE PERFORMED BY A CITY OF MADISON LICENSED CONTRACTOR.
- 7. BIKE STALLS TO BE IN ACCORDANCE TO MADISON GENERAL ORDINANCE 28.II, (SEE SUBSECTIONS (3)(e) AND (3)(h)2d.)
- ALL CITY SIDEWALK, CURB, AND GUTTER WHICH IS DAMAGED DURING CONSTRUCTION OR THAT THE CITY ENGINEER DETERMINES TO BE NECESSARY SHALL BE REPLACED.
- ANY DAMAGE TO STREET PAVEMENT WILL REQUIRE RESTORATION IN ACCORDANCE WITH THE CITY'S PATCHING CRITERIA.
- IO. SIGNAGE APPROVALS ARE NOT GRANTED BY THE PLAN COMMISSION. SIGNAGE MUST BE APPROVED BY THE URBAN DESIGN COMMISSION OR STAFF. SIGN PERMITS MUST BE ISSUED BY THE ZONING SECTION OF THE DEPARTMENT OF PLANNING AND COMMUNITY AND ECONOMIC DEVELOPMENT PRIOR TO SIGN INSTALLATIONS.

Neighborhood Meeting - May 1, 2010 Informational UDC Submittal - May 26, 2010

Plan Com. Submittal - June 23, 2010

Final UDC Sign Submittal - August 11, 2010 Final UDC Submittal - August 25, 2010

Revisions

# PROPOSED TARGET

SITE DEVELOPMENT STATISTICS

LOT AREA 58,909 S.F./I.35 ACRES

DWELLING UNITS 96 D.U.

LOT AREA/ D.U. 613.6 S.F./D.U.

DENSITY 71 UNITS/ACRE

BUILDING HEIGHT 4 STORY

GROSS FLOOR AREA 109,970 S.F. (excluding underground parking)
FLOOR AREA RATIO 1.86

 UNIT MIX
 ONE BEDROOM
 44

 TWO BEDROOM
 42

 THREE BEDROOM T.H.
 10

 TOTAL
 96

SHEET INDEX:

C-2.I

C-4.2

A-1.3

A-2.2

SITE PLAN

SITE LIGHTING PLAN

SITE UTILITY PLAN

PLANT SCHEDULE & DETAILS

PLANTING PLAN

ELEVATIONS

ELEVATIONS

ELEVATIONS

SITE GRADING & EROSION CONTROL PLAN

BASEMENT & GROUND FLOOR PLANS

FIRST & SECOND FLOOR PLAN

THIRD & FOURTH FLOOR PLAN

VEHICLE PARKING
UNDERGROUND
SURFACE
TOTAL

120 (INCL. 3 ACCESSIBLE)

20 (INCL. 2 VAN ACCESSIBLE)

140 (INCL. 5 ACCESSIBLE)

BIKE PARKING
UNDERGROUND
SURFACE
TOTAL

FREY STREET

<u>28</u> 87 (50 + .5(46)=73 REQUIRED) Hilldale Place

4620 Frey Street

(formerly 709 N. Segoe Road)

Drawing Title

Site Plan

Dunion No.

Project No.

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Drawing No.

C-1.1



-NEW CLASS III DRIVEWAY APPROACH

IN ACCORDANCE WITH MADISON

\_VAN ACCESSIBLE PARKING SIGN

----STOP SIGN @ 7' HIGH

GENERAL ORD. SECTION 10.08(4)

←4 BIKE STALLS

TRASH/RECYCING

-10'x35' LOADING ZONE -"NO PARKING, LOADING

ZONE ONLY" SIGN

SCREEN WALL

-SHEET A-2.2

SEE ELEVATION ON

-10'x35' LOADING ZONE

ROOF DECK

UNDERGROUND

PARKING

Ą

20'

6 ENTRANCE

UNDERGROUND PARKING

ENTRANCE

SIGN LOCATION—

SIGN

LOCATION-

ROA

SEGOE

12.5

-6 BIKE STALLS

RETAINING /LANDSCAPING WALLS

\_ 6 BIKE + STALLS

39 UNIT BUILDING

78 UNDERGROUND VEHICLE STALLS

( 4 STORIES)

CONCRETYE BUS STOP PAD -

ACCESSIBLE ROUTE (TYP.) \_

3 BIKE STALLS (2'X6' TYP)

2' VEHICLE OVERHANG

PLAZA

CONCRETE WALKS (TYP.)

57 UNIT BUILDING

42 UNDERGROUND VEHICLE STALLS

( 4 STORIES)

VAN ACCESSIBLE PARKING SIGN



SEGOE ROAD

# UNIVERSITY

	5.	
39 UNIT BUILDING	A	
57 UNIT BUILDING	B	
	Site Lighting Plan	

LUMIN	AIRE SC	HEDULE	
Symbol	Label	Description	Lamp
	А	RECTANGULAR SECURITY / DEEP SHIELDED	50 WATT HPS
	В	FOUR LIGHT BAR GEN B TYPE IV AREA LIGHT WITH BACKLIGHT SHIELD	LED-B



Consultant


Revisions


Neighborhood Meeting - May 1, 2010 Informational UDC Submittal - May 26, 2010 Plan Com Submittal - June 23, 2010 Final UDC Submittal - August 25, 2010

Project Title
Hilldale Place


4620 Frey Street (formerly 709 N. Segoe Road) Drawing Title
Site Lighting Plan


Project No. Drawing No. 1007

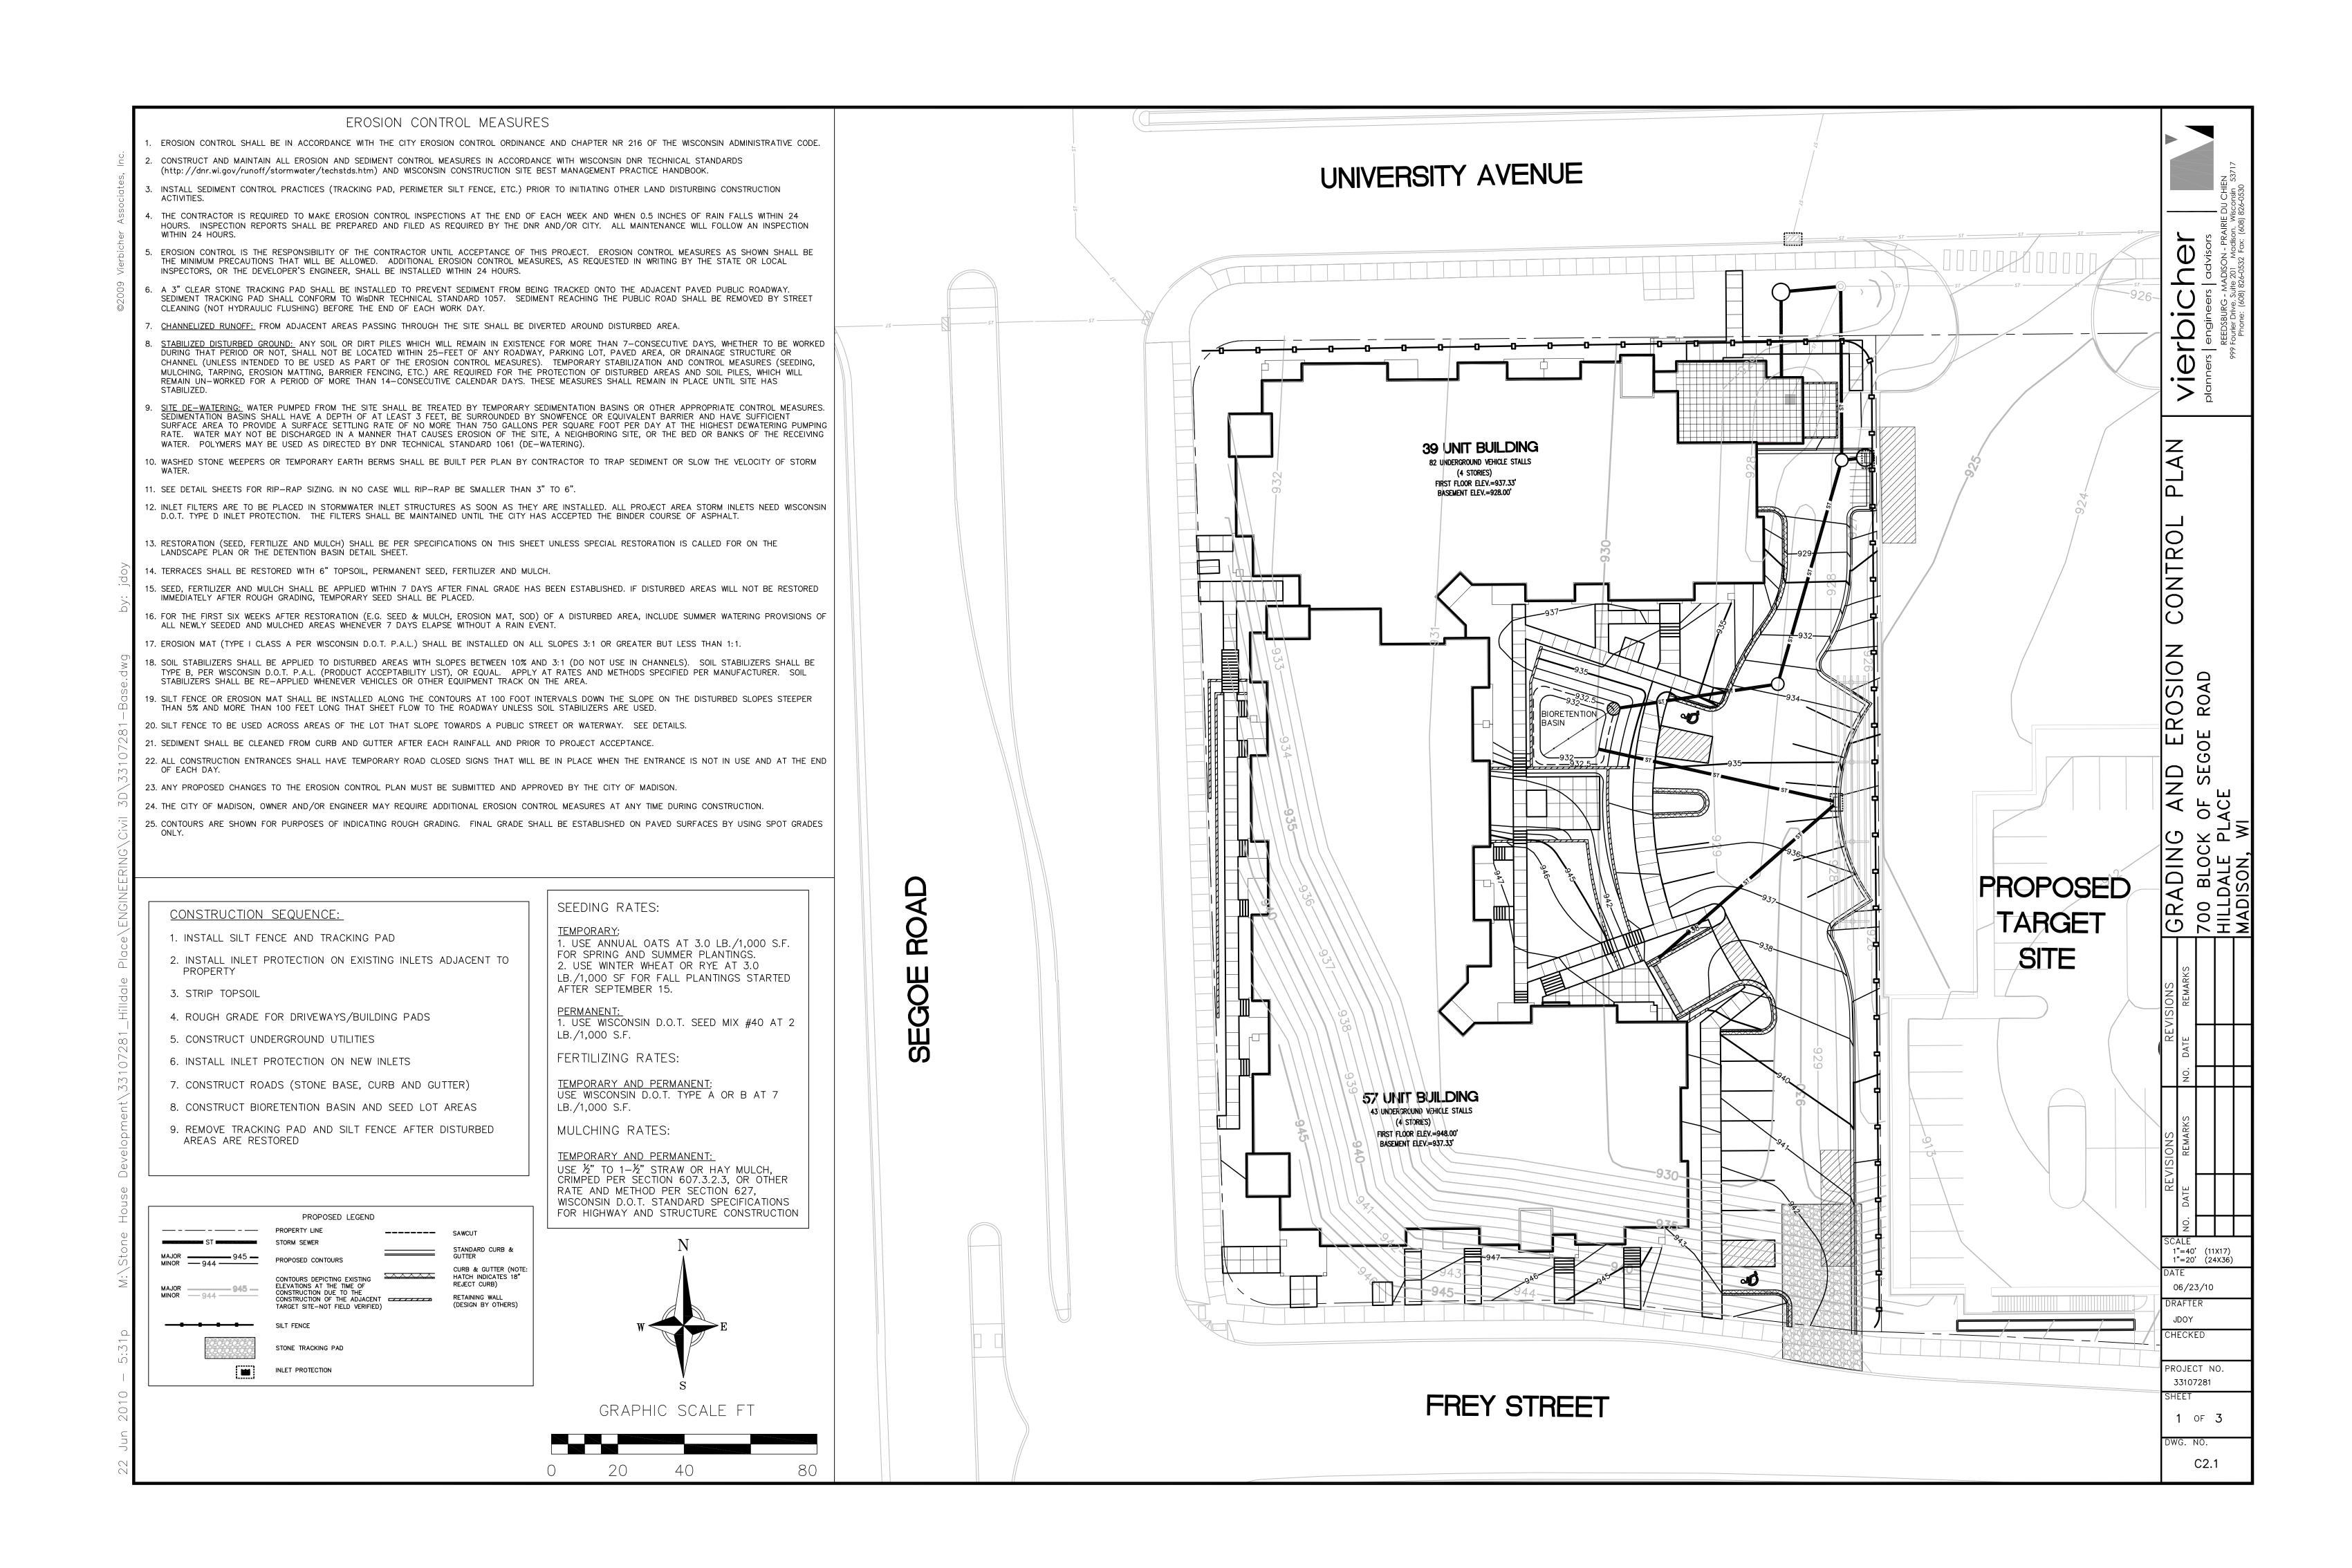


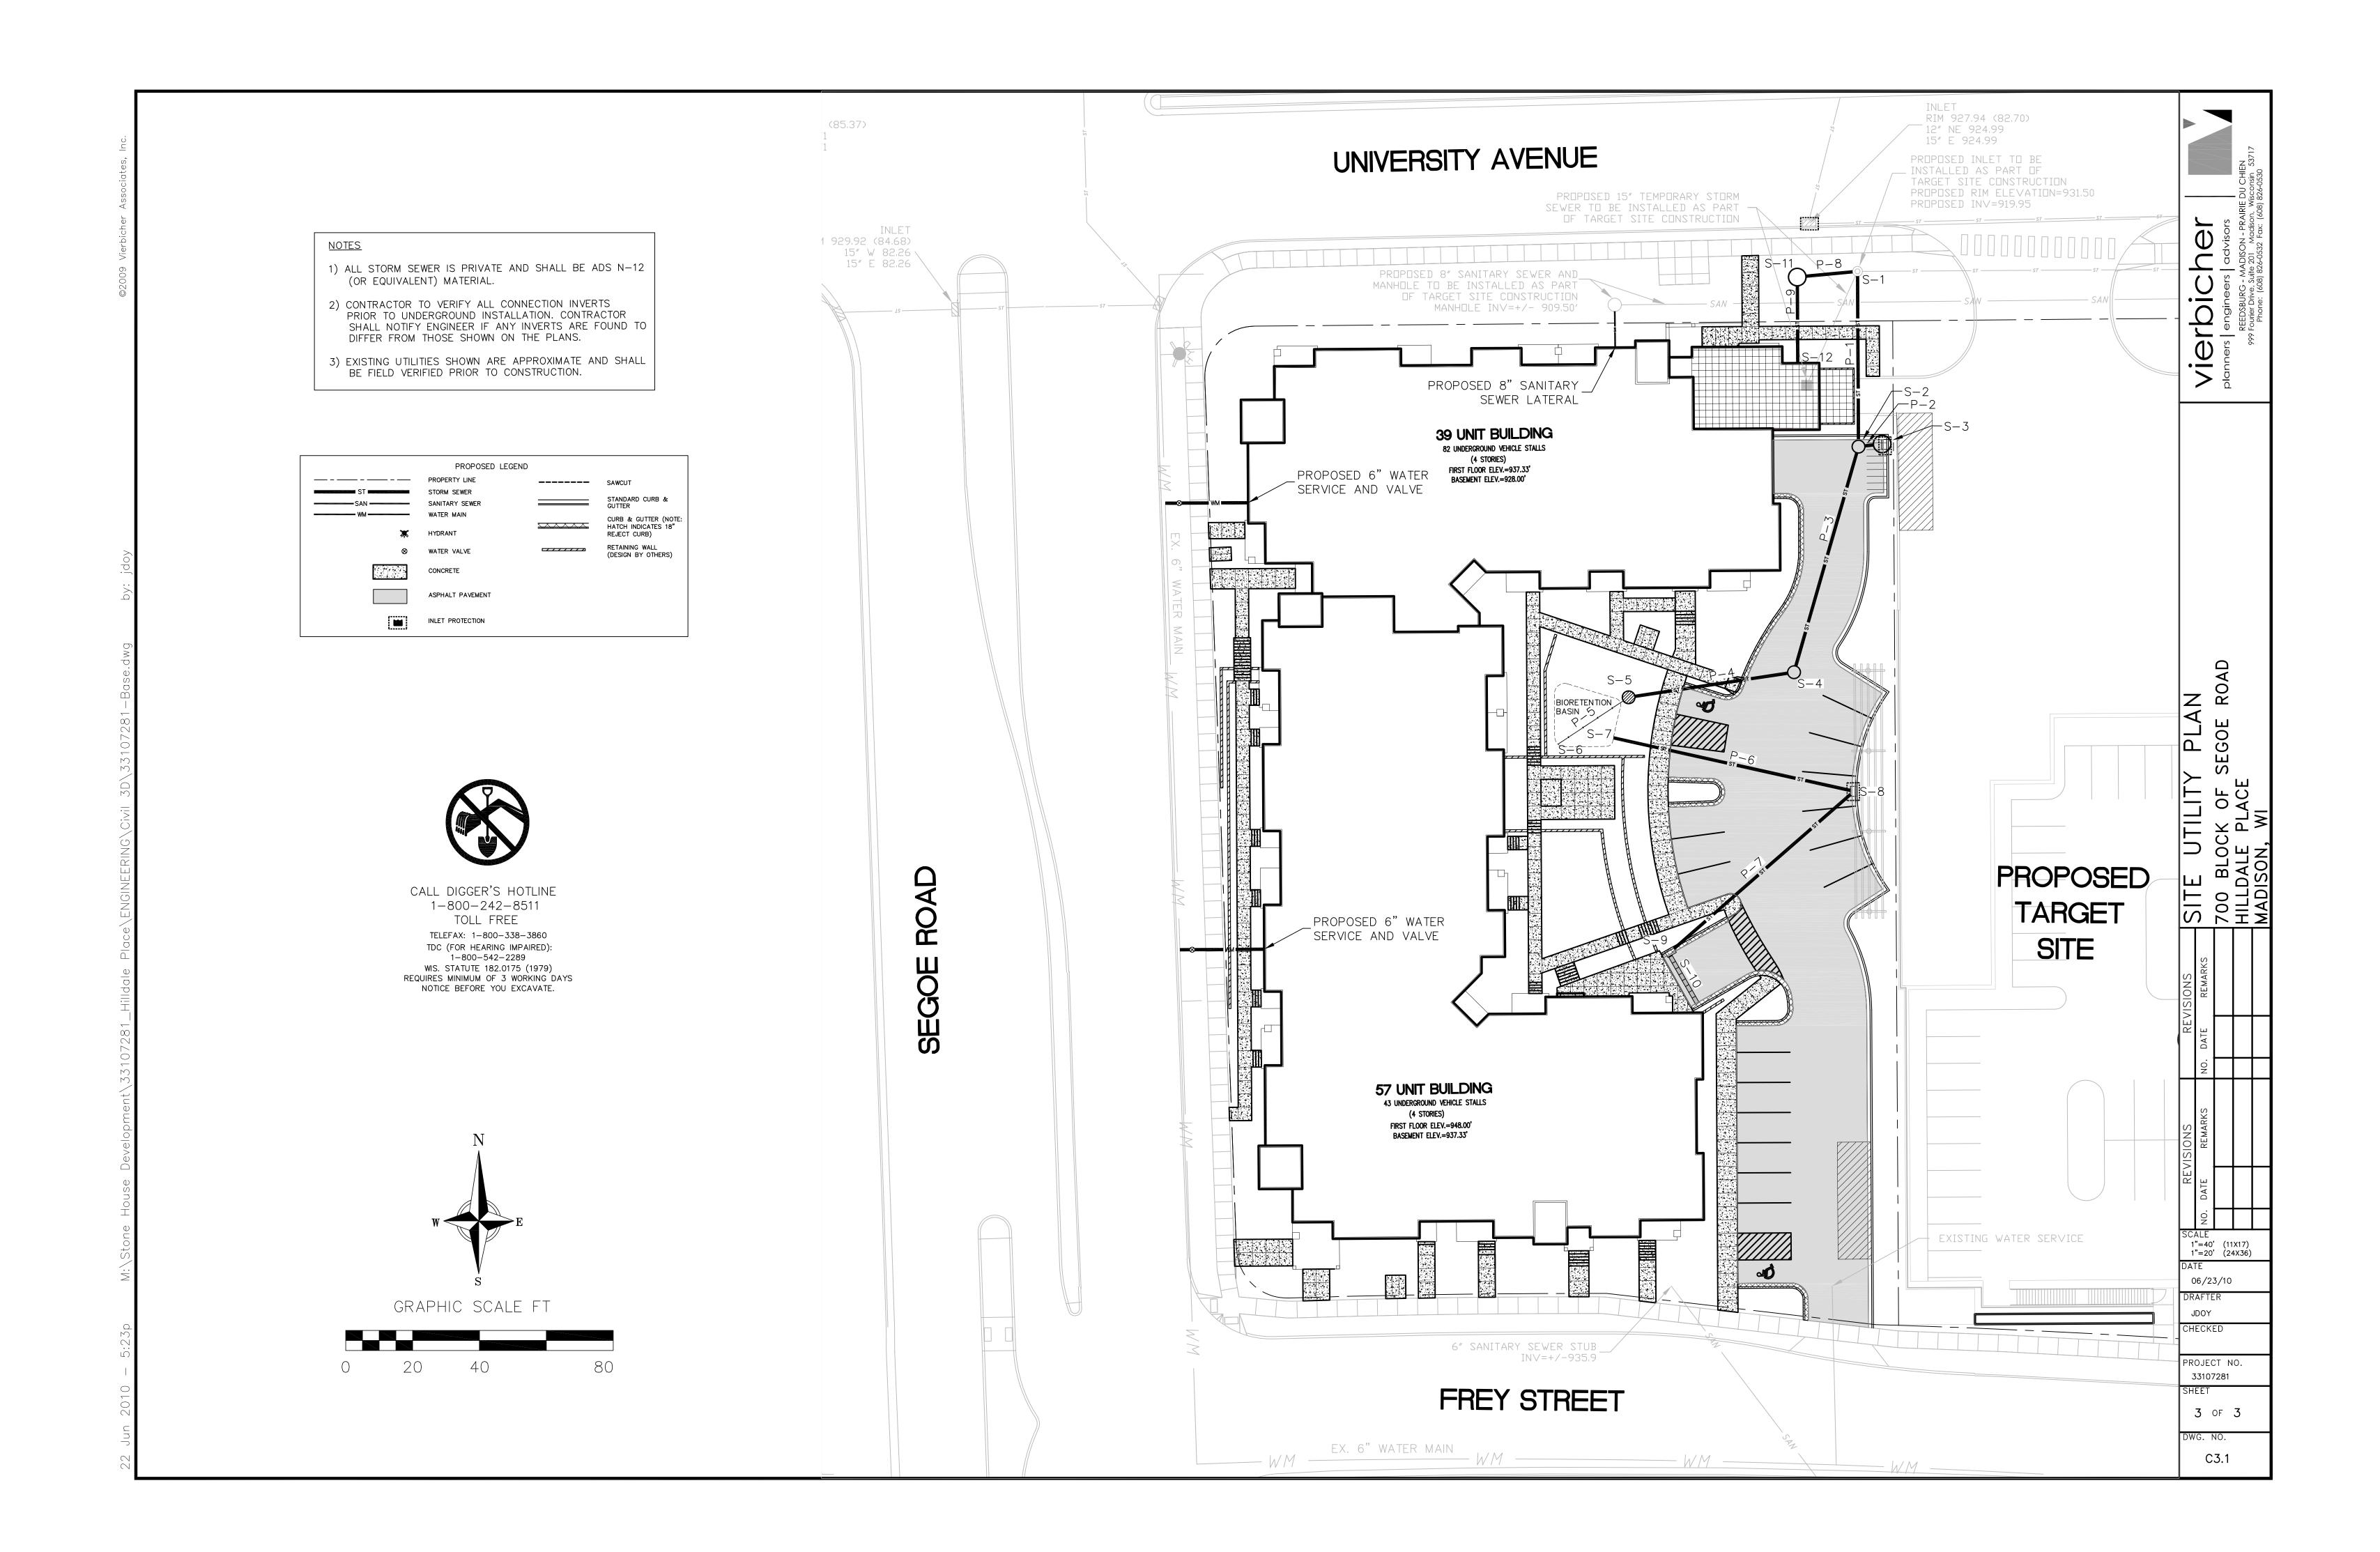


# UNIVERSITY AVENUE

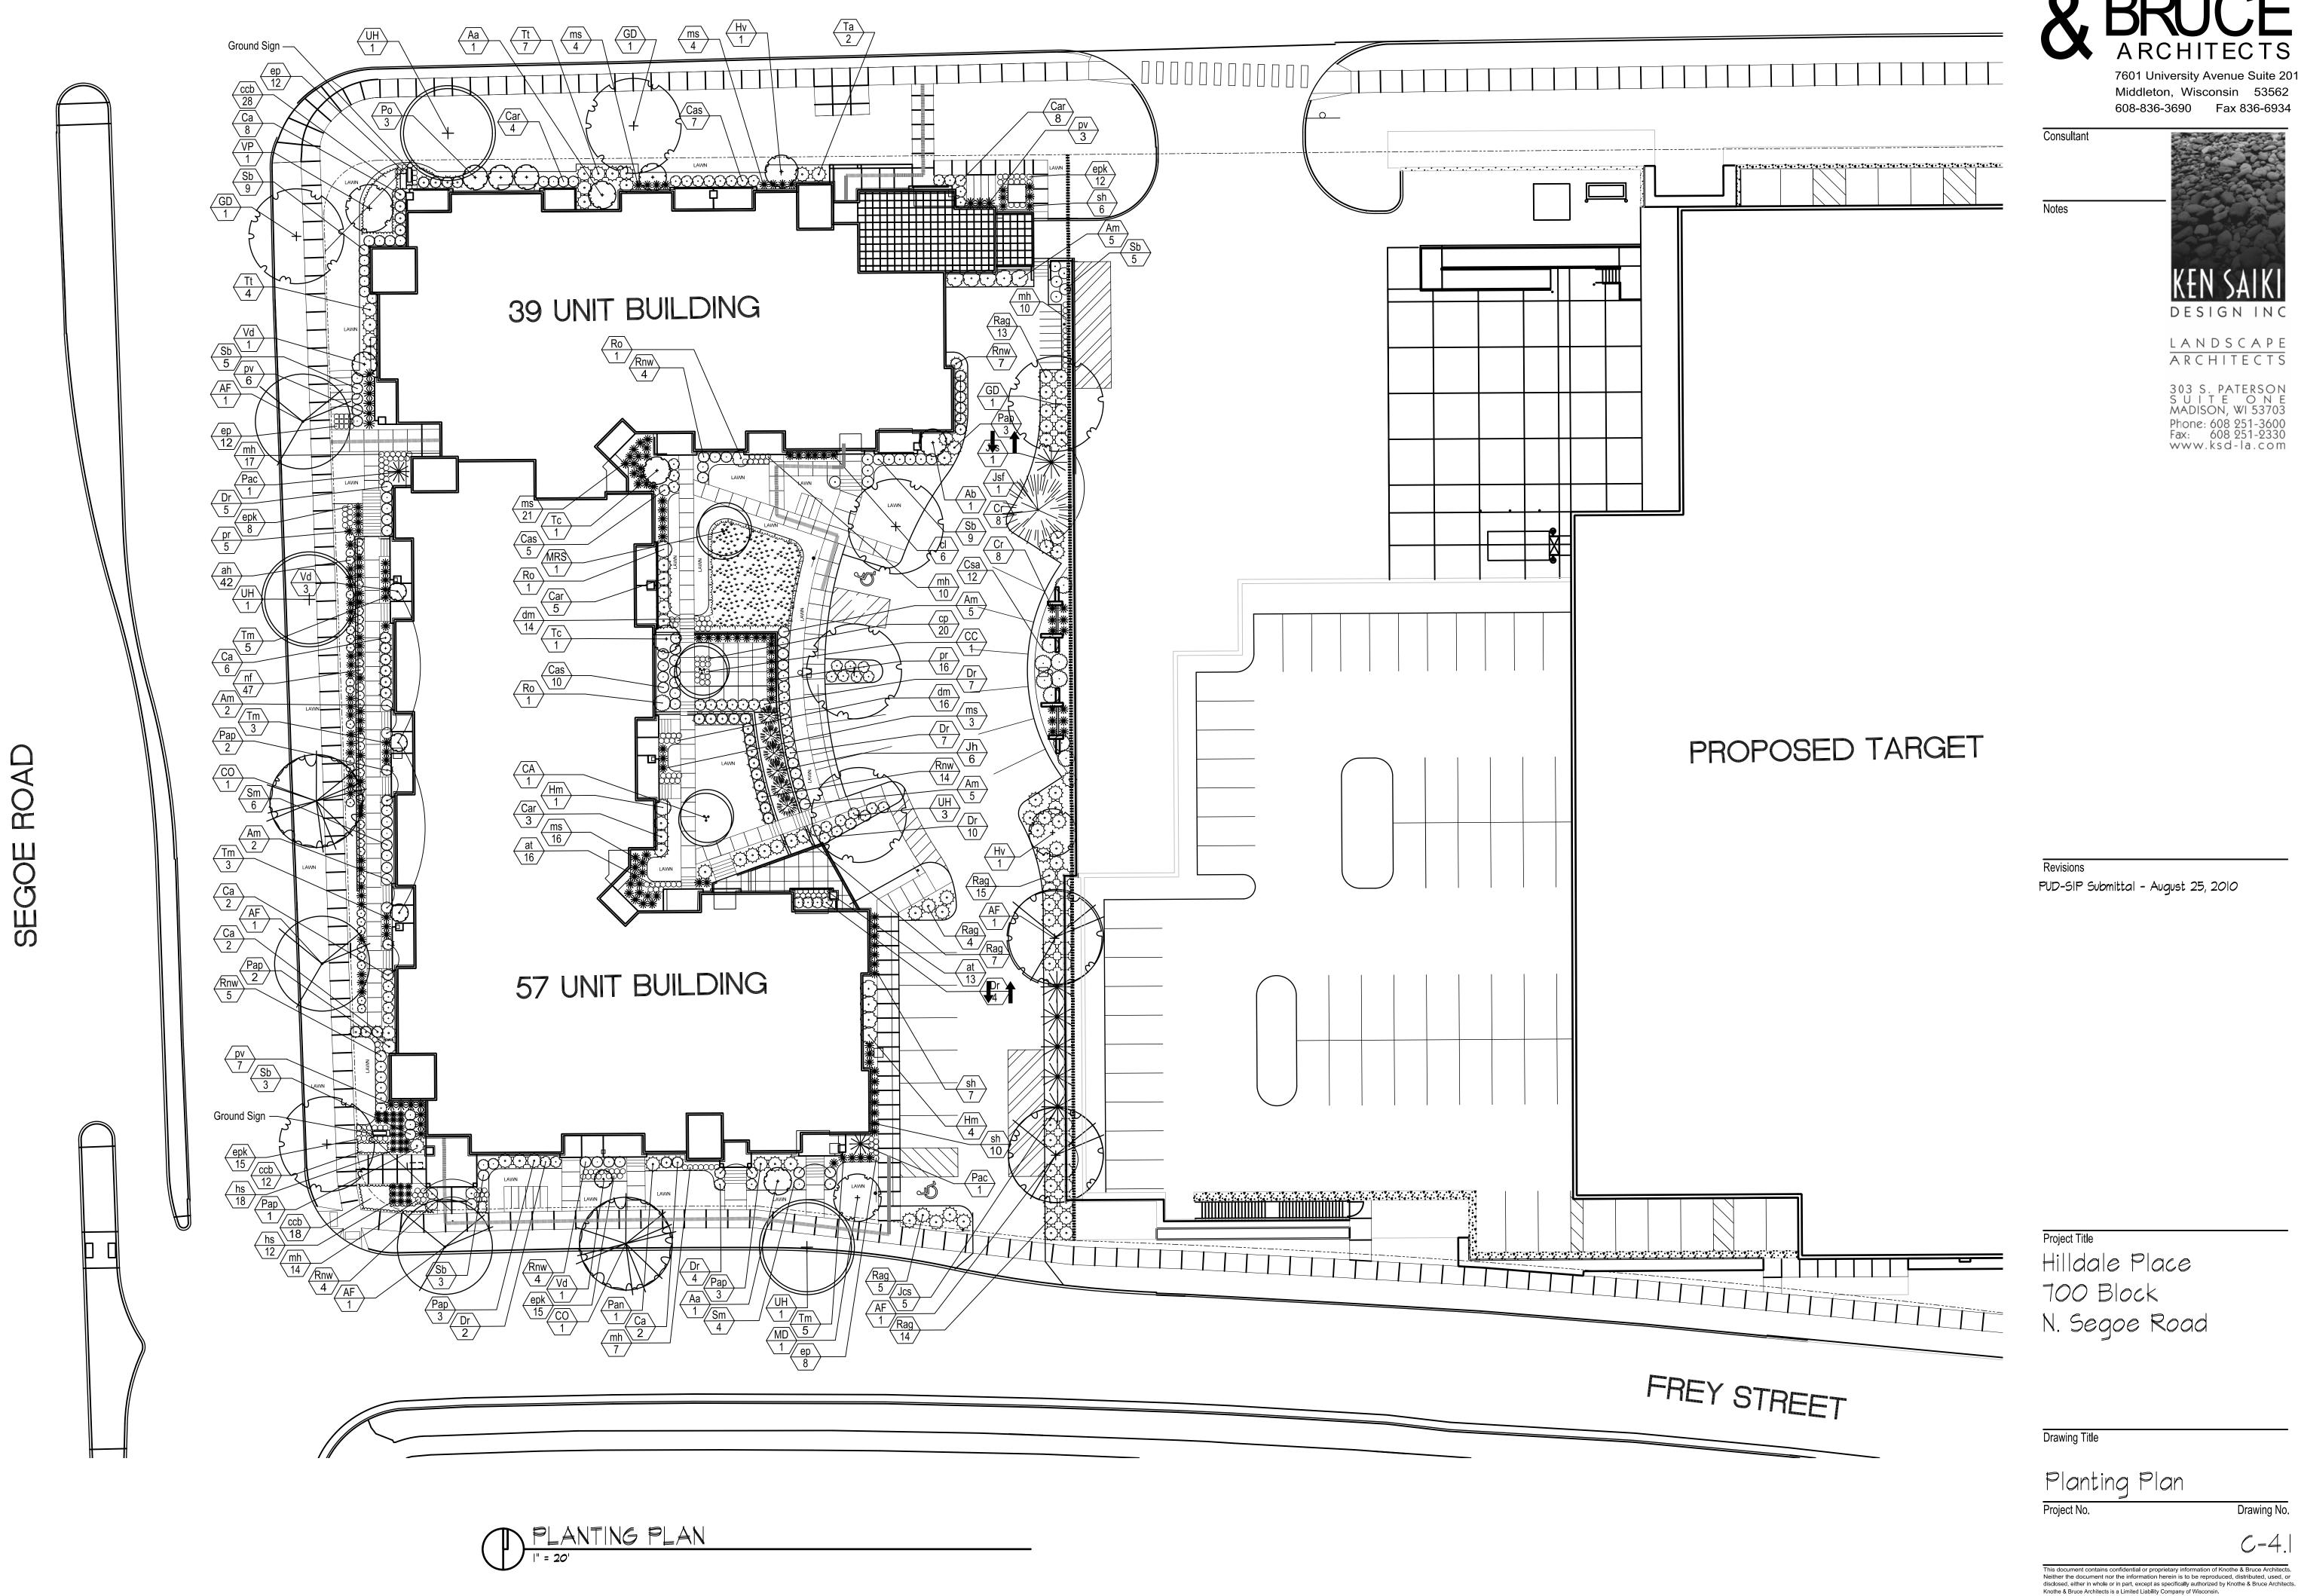


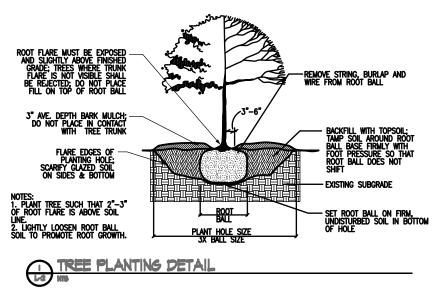

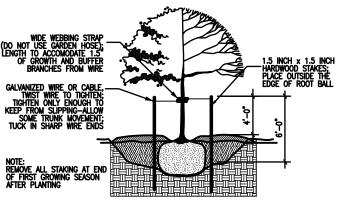

TREE STAKING DETAIL

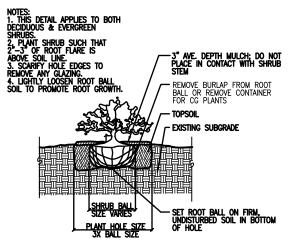

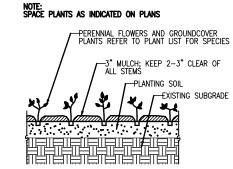



L A N D S C A P E A R C H I T E C T S

303 S. PATERSON S. U. I. T. E. O. N. E. MADISON, WI 53703 Phone: 608 251-3600 Fax: 608 251-2330 www.ksd-la.com

SHRUB PLANTING DETAIL
123 1879

PERENNIAL PLANTING DETAIL
122 1879

COMPACTED OR UNDISTURBED SOIL AT PERIMETER OF PLANT BED
NOTE: DO NOT FILL SHOVEL CUT EDGE WITH MULCH  ANGLE TO TOP OF PLANT BED
SHOVEL-CUT EDGE

City of Madison - Landscape Worksheet					
Number of Parking Stalls					
Total Sq. Footage of Storage Area					
Number of Canopy Shade Trees					
Required - 2" - 2 1/2" cal.					
No. of Landscape Points Required					
Points for Loading Area Required					
Number of Points Required					1
				Credits	
Element	Point		Points		
	Value	Quantity	Achieved	Quantity	Poir
Canopy Tree: 2" - 21/2"	35	4	140		
Deciduous Shrub	2	49	98		
Evergreen Shrub	3	6	18		
Decorative Wall or Fence	5		0		
(per 10 L.F.)					
Earth Berm (per 10 L.F.)					
Avg. Height 30"	5		0		
Avg. Height 15"	2		0		
Evergreen Trees	15	1	15		
3' height minimum					
Canopy Tree or Small Tree	15	1	15		
1 1/2" - 2" Caliper					
(i.e., Crab, Hawthorn)					
-		Sub-Totals	286		
				Total Points	2


	PLANT	SCHEDULE	AND	DETAILS	
1	NTS				_

	ed Plant List  Botanical Name	Common Name	Quantity	Size	Snor	Comments
еу	Botanical Name	Common Name	Quantity	3126	Spec	Comments
	Daniduana Trans					
_	Deciduous Trees	0: 0: 14		0" 1	DAD	
F	Acer x freemanii 'Sienna'	Sienna Glen Maple	5	3" cal.	B&B	
0	Celtis occidentalis 'Windy City'	Windy City Hackberry	2	3" cal.	B&B	
D	Gymnocladus dioica 'Espresso'	Espresso Kentucky Coffeetree	2	2.5" cal.	B&B	
Н	Ulmus 'Homestead'	Homestead Elm	6	2.5" cal.	B&B	
	Ornamental Trees					
A	Cornus alternifolia	Pagoda Dogwood	1	6' ht.		Multi-stem; min. 3 leaders
С	Carpinus caroliniana	Muscle Wood	1	6' ht.		Multi-stem; min. 3 leaders
D	Malus x. David	David Crabaplle	2	5' ht		Multi-stem; min. 3 leaders
RS	Magnolia sella 'Royal Star'	Royal Star Magnolia	1	6'	B&B	
>	Viburnum prunifolium	Blackhaw Viburnum	1	6' ht.	B&B	Multi-stem; min. 3 leaders
	Deciduous Shrubs/Vines					
а	Amelanchier alnofolia 'Regent'	Regent Serviceberry	7	#5	cont.	
b	Aronia arbutifolia 'Brilliantissima'	Red Chokeberry	1	#5	cont.	
n	Aronia melanocarpa 'Morton'	Iroquois Beauty Black Chokeberry	19	2' ht.	cont.	
а	Ceanothus americanus	New Jersey Tea	24	#1	cont.	
ar	Cletrha alnifolia' Ruby Spice'	Rubey Spice Clethra	21	#2	cont.	
ıs	Clethra alnifolia ' Sixteen Candles'	Sixteen Candles Clethra	22	#2	cont.	
r	Campsis Radicans	Common Trumpet Vine	8	#2	cont	
a	Cornus serciea 'Allemans compact'	Allemans Compact Dogwood	17	#2	cont.	
r	Diervilla rivularis 'Morton'	Summer Stars Diervilla	39	18" ht.	cont.	
n	Hydrangea macro 'All Summer Beauty'	All summer Beauty Hydrangea	11	#3	cont	
/	Hamamelis virginiana	Common Witchazel	2	5' ht.	B&B	
0	Physocarpus opulifolius 'Seward'	Summer Wine Eastern Ninebark	3	2' ht.	cont.	
w	Rosa ' Nearly Wild'	Nearly Wild Rose	26	#2	cont	
b	Spirea betulifolia 'Tor'	Birchleaf Spirea	33	#2	cont.	
	Syringa meyeri 'Palibin'		4		_	
n	Viburnum dentatum 'Christom'	Dwarf Korean Lilac	4	#5	cont.	
d	Viburium dentatum Crinstom	Blue Muffin Viburnum	4	3' ht.	cont.	
	Evergreen Shrubs					
s	Juniperus chinensis 'Sea Green'	Sea Green Juniper	5	#5	cont.	
h	Juniperus horizontalis 'Pulmosa Compacta'	Andorra Compact Juniper	6	#5	cont.	
			1			
sf	Juniperus scopulorum 'Fairview'	Fairview Juniper		5' ht.	B&B	
IC	Picea clauca 'Conica'	Dwarf Alberta Spruce	2	#5	cont.	
ın	Picea abies 'Nidiformis'	Bird's Nest Spruce	1	#5	cont.	
		Compact Norway Spruce	14	#3	cont.	
	Picea abies ' Pumila'					
0	Rhododendron 'PJM'	PJM Rhododendron	2	#5	cont.	
D	Rhododendron 'PJM' Taxus cuspidata'Dwarf Bright Gold'	PJM Rhododendron Dwarf Bright Gold Yew	2	#5	cont.	
D	Rhododendron 'PJM' Taxus cuspidata'Dwarf Bright Gold' Thuja occidentalis 'Mr. Bowling Ball'	PJM Rhododendron				
o C n	Rhododendron 'PJM' Taxus cuspidata'Dwarf Bright Gold'	PJM Rhododendron Dwarf Bright Gold Yew	2	#5	cont.	
o C n	Rhododendron 'PJM' Taxus cuspidata' Dvarf Bright Gold' Thuja occidentalis 'Mr. Bowling Ball' Taxus x media 'Tauntonii'	PJM Rhododendron Dwarf Bright Gold Yew Mr. Bowling Ball Arborvitae	2 16	#5 18" ht.	cont.	
o C n	Rhododendron 'PJM' Taxus cuspidata'Dwarf Bright Gold' Thuja occidentalis 'Mr. Bowling Ball' Taxus x media 'Tauntonii'  Perennials/Grasses/Groundcovers	PJM Rhododendron Dwarf Bright Gold Yew Mr. Bowling Ball Arborvitae Taunton Yew	2 16 19	#5 18" ht. 2' ht.	cont. cont. cont.	
o c m t	Rhododendron 'PJM' Taxus cuspidata'Dwarf Bright Gold' Thuja occidentalis 'Mr. Bowling Ball' Taxus x media 'Tauntonii'  Perennials/Grasses/Groundcovers Achillea hybrida-Dwarf Gold	PJM Rhododendron Dwarf Bright Gold Yew Mr. Bowling Ball Arborvitae Taunton Yew  Dwarf Gold Yarrow	2 16	#5 18" ht.	cont.	
n t	Rhododendron 'PJM' Taxus cuspidata'Dwarf Bright Gold' Thuja occidentalis 'Mr. Bowling Ball' Taxus x media 'Tauntonii'  Perennials/Grasses/Groundcovers	PJM Rhododendron Dwarf Bright Gold Yew Mr. Bowling Ball Arborvitae Taunton Yew	2 16 19	#5 18" ht. 2' ht.	cont. cont. cont.	
n t	Rhododendron 'PJM' Taxus cuspidata'Dwarf Bright Gold' Thuja occidentalis 'Mr. Bowling Ball' Taxus x media 'Tauntonii'  Perennials/Grasses/Groundcovers Achillea hybrida-Dwarf Gold	PJM Rhododendron Dwarf Bright Gold Yew Mr. Bowling Ball Arborvitae Taunton Yew  Dwarf Gold Yarrow	2 16 19	#5 18" ht. 2' ht.	cont. cont. cont.	
n t	Rhododendron 'PJM' Taxus cuspidata'Dvarf Bright Gold' Thuja occidentalis 'Mr. Bowling Ball' Taxus x media 'Tauntonii'  Perennials/Grasses/Groundcovers Achillea hybrida-Dvarf Gold Astilbechinensis taquetti'Purpurkerze'	PJM Rhododendron Dwarf Bright Gold Yew Mr. Bowling Ball Arborvitae Taunton Yew  Dwarf Gold Yarrow Purple Candles Astibe Blue Chips Campanula	2 16 19 36 29	#5 18" ht. 2' ht. 1 qt. 1 qt. 1 qt.	cont. cont. cont. cont. cont. cont.	
n t t	Rhododendron 'PJM' Taxus cuspidata'Dwarf Bright Gold' Thuja occidentalis 'Mr. Bowling Ball' Taxus x media 'Tauntonii'  Perennials/Grasses/Groundcovers Achillea hybrida-Dwarf Gold Astilbechinensis taquetti'Purpurkerze' Campanula carpatica Blue Chips' Chasmanthium latifolium	PJM Rhododendron Dwarf Bright Gold Yew Mr. Bowling Ball Arborvitae Taunton Yew  Dwarf Gold Yarrow Purple Candles Astilbe Blue Chips Campanula Northern Sea Oats	2 16 19 36 29 58 6	#5 18" ht. 2' ht.  1 qt. 1 qt. 1 qt. 1 qt. 1 qt.	cont.	
n t t b	Rhododendron 'PJM' Taxus cuspidata'Dvarf Bright Gold' Thuja occidentalis 'Mr. Bowling Ball' Taxus x media 'Tauntonii'  Perennials/Grasses/Groundcovers Achillea hybrida-Dvarf Gold Astilbechinensis taquetti'Purpurkerze' Campanula carpatica Blue Chips' Chasmanthium latifolium Carex pensylvanica	PJM Rhododendron Dwarf Bright Gold Yew Mr. Bowling Ball Arborvitae Taunton Yew  Dwarf Gold Yarrow Purple Candles Astilbe Blue Chips Campanula Northern Sea Oats Pennsylvania Sedge	2 16 19 36 29 58 6 20	#5 18" ht. 2' ht.  1 qt.	cont.	
h t b I	Rhododendron 'PJM' Taxus cuspidata' Dvarf Bright Gold' Thuja occidentalis 'Mr. Bowling Ball' Taxus x media 'Tauntonii'  Perennials/Grasses/Groundcovers Achillea hybrida-Dvarf Gold Astilibechinensis taquetti' Purpurkerze' Campanula carpatica Blue Chips' Chasmanthium latifolium Carex pensylvanica Digitalis mertonensis	PJM Rhododendron Dwarf Bright Gold Yew Mr. Bowling Ball Arborvitae Taunton Yew  Dwarf Gold Yarrow Purple Candles Astilbe Blue Chips Campanula Northem Sea Oats Pennsylvania Sedge Perennial Foxglove	2 16 19 36 29 58 6 20 30	#5 18" ht. 2' ht.  1 qt.	cont.	
h t b I	Rhododendron 'PJM' Taxus cuspidata' Dvarf Bright Gold' Thuja occidentalis 'Mr. Bowling Ball' Taxus x media 'Tauntonii'  Perennials/Grasses/Groundcovers Achillea hybrida-Dvarf Gold Astilbechinensis taquetti'Purpurkerze' Campanula carpatica Blue Chips' Chasmanthium latifolium Carex pensylvanica Digitalis mertonensis Echinacea pupurea 'Magnus'	PJM Rhododendron Dwarf Bright Gold Yew Mr. Bowling Ball Arborvitae Taunton Yew  Dwarf Gold Yarrow Purple Candles Astilbe Blue Chips Campanula Northern Sea Oats Pennsylvania Sedge Perennial Foxglove Magnus Purple Coneflower	2 16 19 36 29 58 6 20 30 32	#5 18" ht. 2' ht.  1 qt.	cont.	
m t t t t b b	Rhododendron 'PJM' Taxus cuspidata'Dvarf Bright Gold' Thuja occidentalis 'Mr. Bowling Ball' Taxus x media 'Tauntonii'  Perennials/Grasses/Groundcovers Achillea hybrida-Dvarf Gold Astilbechinensis taquetti'Purpurkerze' Campanula carpatica Blue Chips' Chasmanthium latifolium Carex pensylvanica Digitalis mertonensis Echinacea purpurea 'Magnus' Echinacea purpurea 'Kim's Mophead'	PJM Rhododendron Dwarf Bright Gold Yew Mr. Bowling Ball Arborvitae Taunton Yew  Dwarf Gold Yarrow Purple Candles Astilbe Blue Chips Campanula Northern Sea Oats Pennsylvania Sedge Perennial Foxglove Magnus Purple Coneflower Mophead Coneflower	2 16 19 36 29 58 6 20 30 32 36	#5 18" ht. 2' ht.  1 qt.	cont.	
h t b l l o	Rhododendron 'PJM' Taxus cuspidata'Dvarf Bright Gold' Thuja occidentalis 'Mr. Bowling Ball' Taxus x media 'Tauntonii'  Perennials/Grasses/Groundcovers Achillea hybrida-Dvarf Gold Astilbechinensis taquetti'Purpurkerze' Campanula carpatica Blue Chips' Chasmanthium latifolium Carex pensylvanica Digitalis mertonensis Echinacea purpurea 'Magnus' Echinacea purpurea 'Kim's Mophead' Helictotrichon sempervirens 'Saphirsprudel'	PJM Rhododendron Dwarf Bright Gold Yew Mr. Bowling Ball Arborvitae Taunton Yew  Dwarf Gold Yarrow Purple Candles Astilbe Blue Chips Campanula Northern Sea Oats Pennsylvania Sedge Perennial Foxglove Magnus Purple Coneflower Mophead Coneflower Blue Oat Grass	2 16 19 36 29 58 6 20 30 32 36 30	#5 18" ht. 2' ht.  1 qt.	cont.	
h t t b l l o n o o k k s s	Rhododendron 'PJM' Taxus cuspidata' Dvarf Bright Gold' Thuja occidentalis 'Mr. Bowling Ball' Taxus x media 'Tauntonii'  Perennials/Grasses/Groundcovers Achillea hybrida-Dvarf Gold Astilbechinensis taquetti' Purpurkerze' Campanula carpatica Blue Chips' Chasmanthium latifolium Carex pensylvanica Digitalis mertonensis Echinacea purpurea 'Magnus' Echinacea purpurea 'Kim's Mophead' Helictotrichon sempervirens 'Saphirsprudel' Monarda hybrid 'Jacob Kline'	PJM Rhododendron Dwarf Bright Gold Yew Mr. Bowling Ball Arborvitae Taunton Yew  Dwarf Gold Yarrow Purple Candles Astilbe Blue Chips Campanula Northem Sea Oats Pennsylvania Sedge Perennial Foxglove Magnus Purple Coneflower Mophead Coneflower Blue Oat Grass Jacob Kline Monarda	2 16 19 36 29 58 6 20 30 32 36 36 30 53	#5 18" ht. 2' ht.  1 qt.	cont.	
h t b l l o o o k k s s	Rhododendron 'PJM' Taxus cuspidata' Dvarf Bright Gold' Thuja occidentalis 'Mr. Bowling Ball' Taxus x media 'Tauntonii'  Perennials/Grasses/Groundcovers Achillea hybrida-Dvarf Gold Astilbechinensis taquetti'Purpurkerze' Campanula carpatica Blue Chips' Chasmanthium latifolium Carex pensylvanica Digitalis mertonensis Echinacea purpurea 'Magnus' Echinacea purpurea 'Kim's Mophead' Helictotrichon sempervirens 'Saphirsprudel' Monarda hybrid 'Jacob Kline' Matteuccia struthiopteris	PJM Rhododendron Dwarf Bright Gold Yew Mr. Bowling Ball Arborvitae Taunton Yew  Dwarf Gold Yarrow Purple Candles Astilbe Blue Chips Campanula Northern Sea Oats Pennsylvania Sedge Perennial Foxglove Magnus Purple Coneflower Mophead Coneflower Blue Oat Grass Jacob Kline Monarda Ostrich Fern	2 16 19 36 29 58 6 20 30 32 36 30 32 48	#5 18" ht. 2' ht.  1 qt.	cont.	
h t t b l l o o m	Rhododendron 'PJM' Taxus cuspidata'Dvarf Bright Gold' Thuja occidentalis 'Mr. Bowling Ball' Taxus x media 'Tauntonii'  Perennials/Grasses/Groundcovers Achillea hybrida-Dvarf Gold Astilbechinensis taquetti'Purpurkerze' Campanula carpatica Blue Chips' Chasmanthium latifolium Carex pensylvanica Digitalis mertonensis Echinacea purpurea 'Magnus' Echinacea purpurea 'Kim's Mophead' Helictotrichon sempervirens 'Saphirsprudel' Monarda hybrid 'Jacob Kline' Matteuccia struthiopteris Nepata faassenii 'Walkers Low'	PJM Rhododendron Dwarf Bright Gold Yew Mr. Bowling Ball Arborvitae Taunton Yew  Dwarf Gold Yarrow Purple Candles Astilbe Blue Chips Campanula Northern Sea Oats Pennsylvania Sedge Perennial Foxglove Magnus Purple Coneflower Mophead Coneflower Blue Oat Grass Jacob Kline Monarda Ostrich Fern Walkers Low Catmint	2 16 19 36 29 58 6 20 30 32 36 30 53 48 33	#5 18" ht. 2' ht.  1 qt.	cont.	
h t t t t t t t t t t t t t t t t t t t	Rhododendron 'PJM' Taxus cuspidata'Dvarf Bright Gold' Thuja occidentalis 'Mr. Bowling Ball' Taxus x media 'Tauntonii'  Perennials/Grasses/Groundcovers Achillea hybrida-Dvarf Gold Astilbechinensis taquetti'Purpurkerze' Campanula carpatica Blue Chips' Chasmanthium latifolium Carex pensylvanica Digitalis mertonensis Echinacea purpurea 'Magnus' Echinacea purpurea 'Mism's Mophead' Helictotrichon sempervirens 'Saphirsprudel' Monarda hybrid 'Jacob Kline' Matteuccia struthiopteris Nepata faassenii 'Walkers Low' Panicum virgatum 'Rotstrahlbush'	PJM Rhododendron Dwarf Bright Gold Yew Mr. Bowling Ball Arborvitae Taunton Yew  Dwarf Gold Yarrow Purple Candles Astilbe Blue Chips Campanula Northern Sea Oats Pennsylvania Sedge Perennial Foxglove Magnus Purple Coneflower Mophead Coneflower Blue Oat Grass Jacob Kline Monarda Ostrich Fern Walkers Low Catmint Red Switch Grass	2 16 19 36 29 58 6 20 30 32 36 30 53 48 33 21	#5 18" ht. 2' ht.  1 qt.	cont.	
h t t bb l l book s h f r r v v	Rhododendron 'PJM' Taxus cuspidata' Dvarf Bright Gold' Thuja occidentalis 'Mr. Bowling Ball' Taxus x media 'Tauntonii'  Perennials/Grasses/Groundcovers Achillea hybrida-Dvarf Gold Astilbechinensis taquetti'Purpurkerze' Campanula carpatica Blue Chips' Chasmanthium latifolium Carex pensylvanica Digitalis mertonensis Echinacea purpurea 'Magnus' Echinacea purpurea 'Kim's Mophead' Helictotrichon sempervirens 'Saphirsprudel' Monarda hybrid 'Jacob Kline' Matteuccia struthiopteris Nepata fiasssenii 'Walkers Low Panicum virgatum 'Rostsrahlbush' Panicum virgatum 'Northwind'	PJM Rhododendron Dwarf Bright Gold Yew Mr. Bowling Ball Arborvitae Taunton Yew  Dwarf Gold Yarrow Purple Candles Astilbe Blue Chips Campanula Northem Sea Oats Pennsylvania Sedge Perennial Foxglove Magnus Purple Coneflower Mophead Coneflower Blue Oat Grass Jacob Kline Monarda Ostrich Fern Walkers Low Catmint Red Switch Grass Northwind Switch Grass	2 16 19 36 29 58 6 20 30 32 36 30 53 48 33 21	#5 18" ht. 2' ht.  1 qt.	cont.	
h t t b l D m b k s f f	Rhododendron 'PJM' Taxus cuspidata'Dvarf Bright Gold' Thuja occidentalis 'Mr. Bowling Ball' Taxus x media 'Tauntonii'  Perennials/Grasses/Groundcovers Achillea hybrida-Dvarf Gold Astilbechinensis taquetti'Purpurkerze' Campanula carpatica Blue Chips' Chasmanthium latifolium Carex pensylvanica Digitalis mertonensis Echinacea purpurea 'Magnus' Echinacea purpurea 'Mism's Mophead' Helictotrichon sempervirens 'Saphirsprudel' Monarda hybrid 'Jacob Kline' Matteuccia struthiopteris Nepata faassenii 'Walkers Low' Panicum virgatum 'Rotstrahlbush'	PJM Rhododendron Dwarf Bright Gold Yew Mr. Bowling Ball Arborvitae Taunton Yew  Dwarf Gold Yarrow Purple Candles Astilbe Blue Chips Campanula Northern Sea Oats Pennsylvania Sedge Perennial Foxglove Magnus Purple Coneflower Mophead Coneflower Blue Oat Grass Jacob Kline Monarda Ostrich Fern Walkers Low Catmint Red Switch Grass	2 16 19 36 29 58 6 20 30 32 36 30 53 48 33 21	#5 18" ht. 2' ht.  1 qt.	cont.	
h t t b l l D n n D o o o o	Rhododendron 'PJM' Taxus cuspidata'Dvarf Bright Gold' Thuja occidentalis 'Mr. Bowling Ball' Taxus x media 'Tauntonii'  Perennials/Grasses/Groundcovers Achillea hybrida-Dvarf Gold Astilbechinensis taquetti'Purpurkerze' Campanula carpatica Blue Chips' Chasmanthium latifolium Carex pensylvanica Digitalis mertonensis Echinacea purpurea 'Magnus' Echinacea purpurea 'Kim's Mophead' Helictotrichon sempervirens 'Saphirsprudel' Monarda hybrid 'Jacob Kline' Matteuccia struthiopteris Nepata faassenii 'Walkers Low Panicum virgatum 'Rotstrahlbush' Panicum virgatum 'Rotstrahlbush' Sporobolus heterolepis	PJM Rhododendron Dwarf Bright Gold Yew Mr. Bowling Ball Arborvitae Taunton Yew  Dwarf Gold Yarrow Purple Candles Astilbe Blue Chips Campanula Northem Sea Oats Pennsylvania Sedge Perennial Foxglove Magnus Purple Coneflower Mophead Coneflower Blue Oat Grass Jacob Kline Monarda Ostrich Fern Walkers Low Catmint Red Switch Grass Northwind Switch Grass	2 16 19 36 29 58 6 20 30 32 36 30 53 48 33 21	#5 18" ht. 2' ht.  1 qt.	cont.	
h t t b l l D n n D o o o o	Rhododendron 'PJM' Taxus cuspidata' Dvarf Bright Gold' Thuja occidentalis 'Mr. Bowling Ball' Taxus x media 'Tauntonii'  Perennials/Grasses/Groundcovers Achillea hybrida-Dvarf Gold Astilbechinensis taquetti'Purpurkerze' Campanula carpatica Blue Chips' Chasmanihium latifolium Carex pensylvanica Digitalis mertonensis Echinacea purpurea 'Magnus' Echinacea purpurea 'Misses Wophead' Helictotrichon sempervirens 'Saphirsprudel' Monarda hybrid 'Jacob Kline' Matteuccia struthiopteris Nepata faassenii 'Walkers Low' Panicum virgatum 'Rotstrahlbush' Panicum virgatum 'Rotstrahlbush' Panicum virgatum 'Northwind' Sporobolus heterolepis	PJM Rhododendron Dwarf Bright Gold Yew Mr. Bowling Ball Arborvitae Taunton Yew  Dwarf Gold Yarrow Purple Candles Astilbe Blue Chips Campanula Northern Sea Oats Pennsylvania Sedge Perennial Foxglove Magnus Purple Coneflower Mophead Coneflower Blue Oat Grass Jacob Kline Monarda Ostrich Fern Walkers Low Catmint Red Switch Grass Northwind Switch Grass Prairie Dropseed	2 16 19 36 29 58 6 20 30 32 36 30 53 48 33 21 13	#5 18" ht. 2' ht.  1 qt.	cont.	
h t t b l l D n n D o o o o	Rhododendron 'PJM' Taxus cuspidata' Dvarf Bright Gold' Thuja occidentalis 'Mr. Bowling Ball' Taxus x media 'Tauntonii'  Perennials/Grasses/Groundcovers Achillea hybrida-Dvarf Gold Astilbechinensis taquetti' Purpurkerze' Campanula carpatica Blue Chips' Chasmanthium latifolium Carex pensylvanica Digitalis mertonensis Echinacea purpurea 'Magnus' Echinacea purpurea 'Kim's Mophead' Helictotrichon sempervirens 'Saphirsprudel' Monarda hybrid 'Jacob Kline' Matteuccia struthiopteris Nepata faassenii 'Walkers Low Panicum virgatum 'Rostsrahlbush' Panicum virgatum 'Northwind' Sporobolus heterolepis  Bioretention Mix Carex vulpinoidea	PJM Rhododendron Dwarf Bright Gold Yew Mr. Bowling Ball Arborvitae Taunton Yew  Dwarf Gold Yarrow Purple Candles Astilbe Blue Chips Campanula Northem Sea Oats Pennsylvania Sedge Perennial Foxglove Magnus Purple Coneflower Mophead Coneflower Blue Oat Grass Jacob Kline Monarda Ostrich Fern Walkers Low Catmint Red Switch Grass Northwind Switch Grass Prairie Dropseed  Fox sedge	2 16 19 36 29 58 6 20 30 32 36 30 53 48 33 21 13	#5 18" ht. 2' ht.  1 qt.	cont.	
appoor	Rhododendron 'PJM' Taxus cuspidata' Dvarf Bright Gold' Thuja occidentalis 'Mr. Bowling Ball' Taxus x media 'Tauntonii'  Perennials/Grasses/Groundcovers Achillea hybrida-Dvarf Gold Astilbechinensis taquetti'Purpurkerze' Campanula carpatica Blue Chips' Chasmanihium latifolium Carex pensylvanica Digitalis mertonensis Echinacea purpurea 'Magnus' Echinacea purpurea 'Misses Wophead' Helictotrichon sempervirens 'Saphirsprudel' Monarda hybrid 'Jacob Kline' Matteuccia struthiopteris Nepata faassenii 'Walkers Low' Panicum virgatum 'Rotstrahlbush' Panicum virgatum 'Rotstrahlbush' Panicum virgatum 'Northwind' Sporobolus heterolepis	PJM Rhododendron Dwarf Bright Gold Yew Mr. Bowling Ball Arborvitae Taunton Yew  Dwarf Gold Yarrow Purple Candles Astilbe Blue Chips Campanula Northern Sea Oats Pennsylvania Sedge Perennial Foxglove Magnus Purple Coneflower Mophead Coneflower Blue Oat Grass Jacob Kline Monarda Ostrich Fern Walkers Low Catmint Red Switch Grass Northwind Switch Grass Prairie Dropseed	2 16 19 36 29 58 6 20 30 32 36 30 53 48 33 21 13	#5 18" ht. 2' ht.  1 qt.	cont.	Include equal quantities of each species and arrange randomly throughout the planting area. Plant 1'-0" O.C.


PUD-SIP Submittal - August 25, 2010

Hilldale Place 700 Block N. Segoe Road

Drawing Title
Plant Schedule and Details

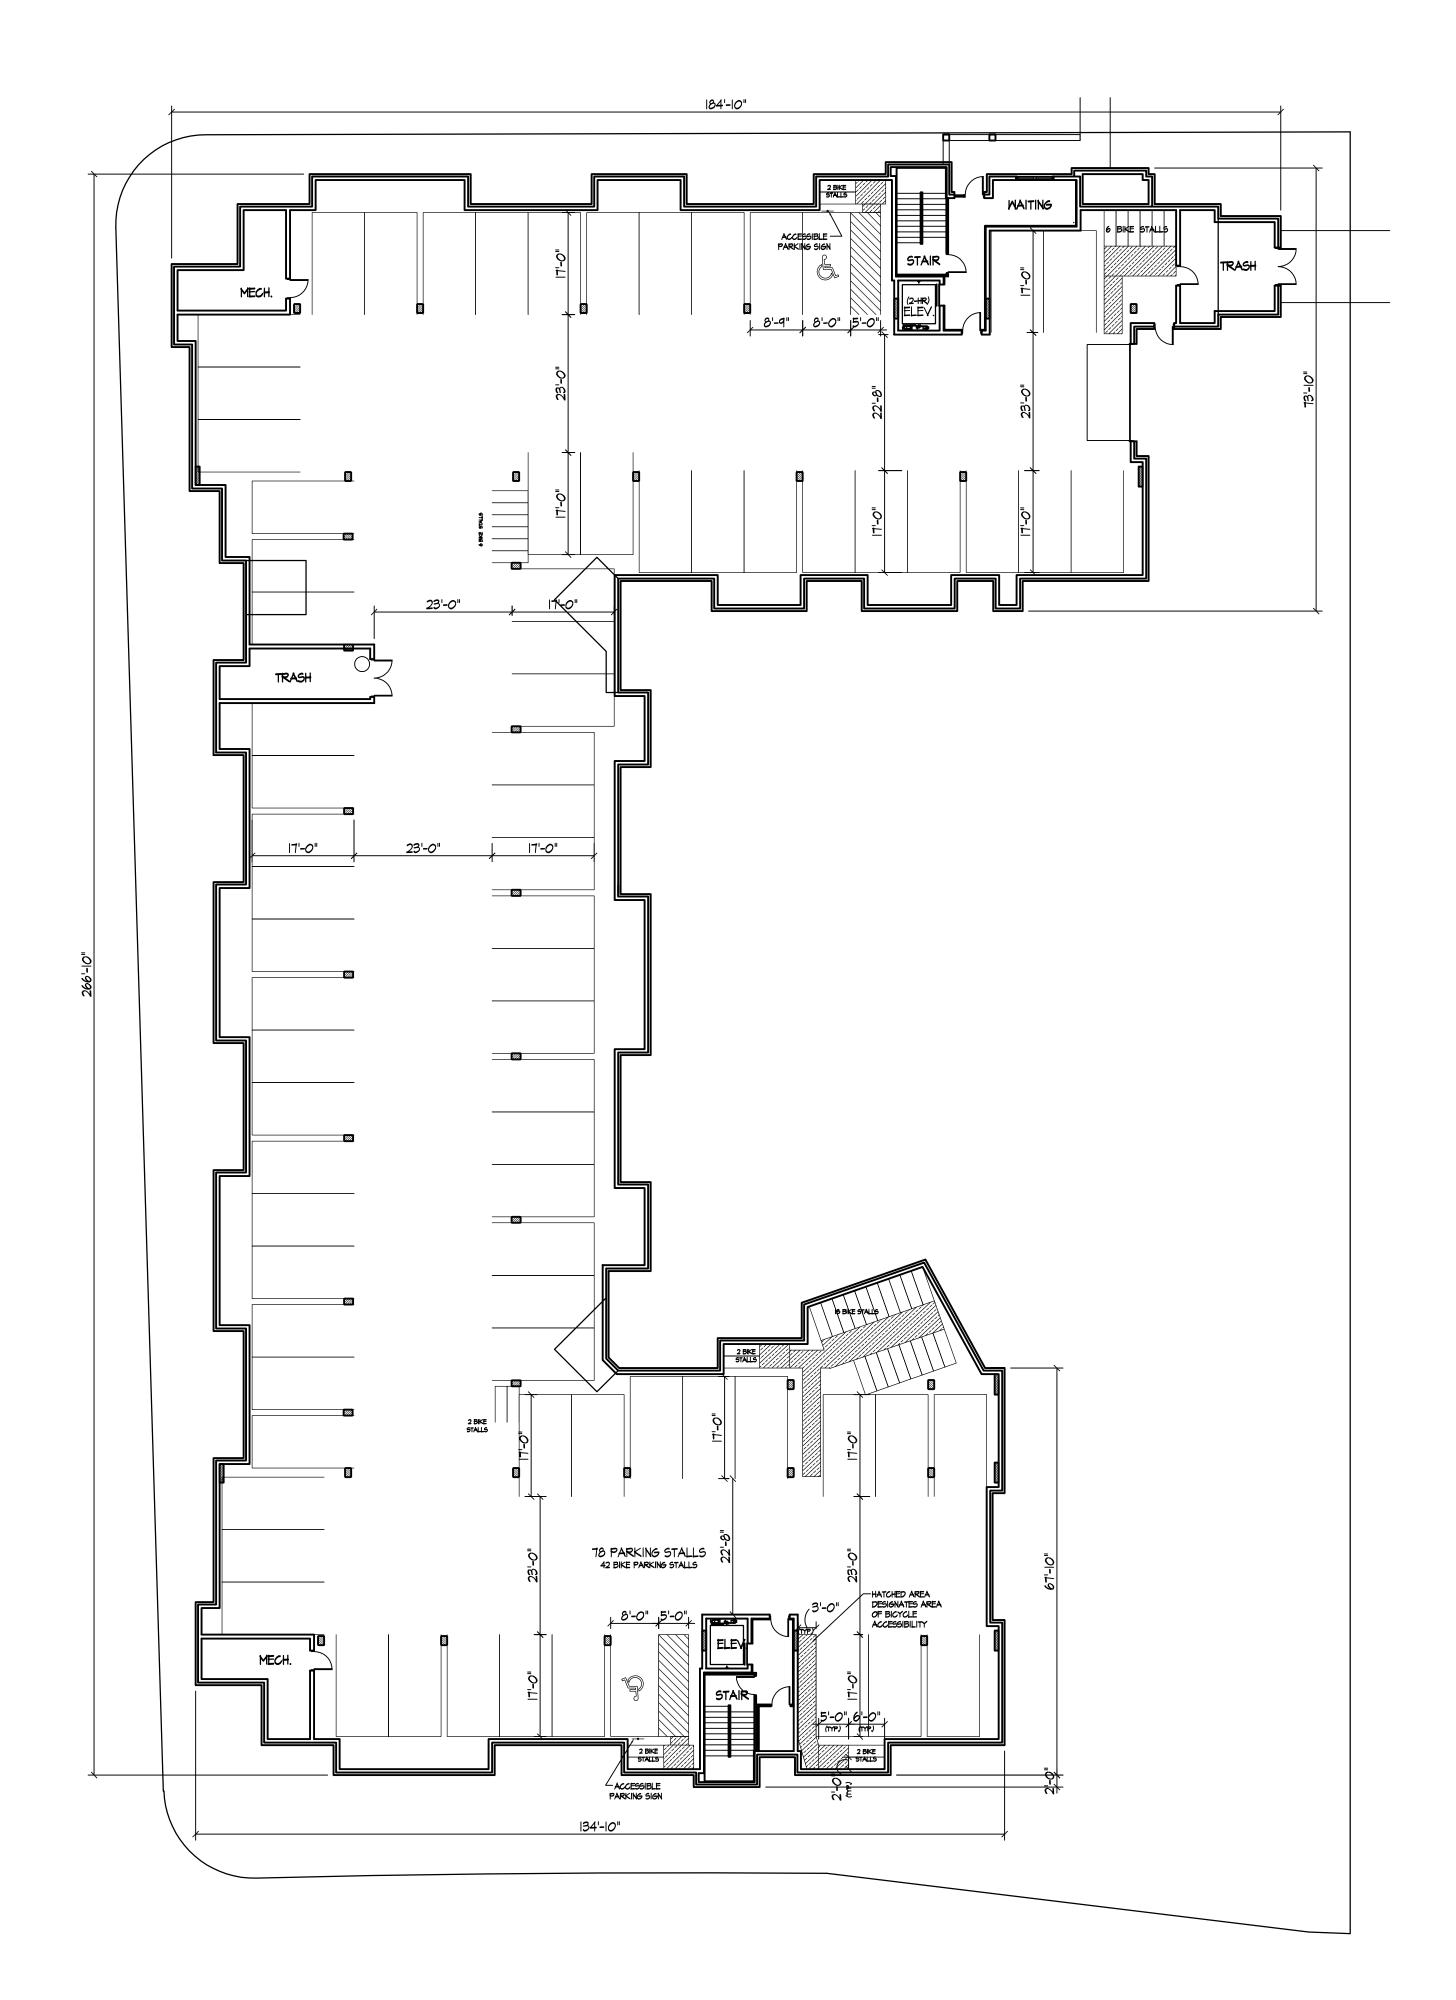



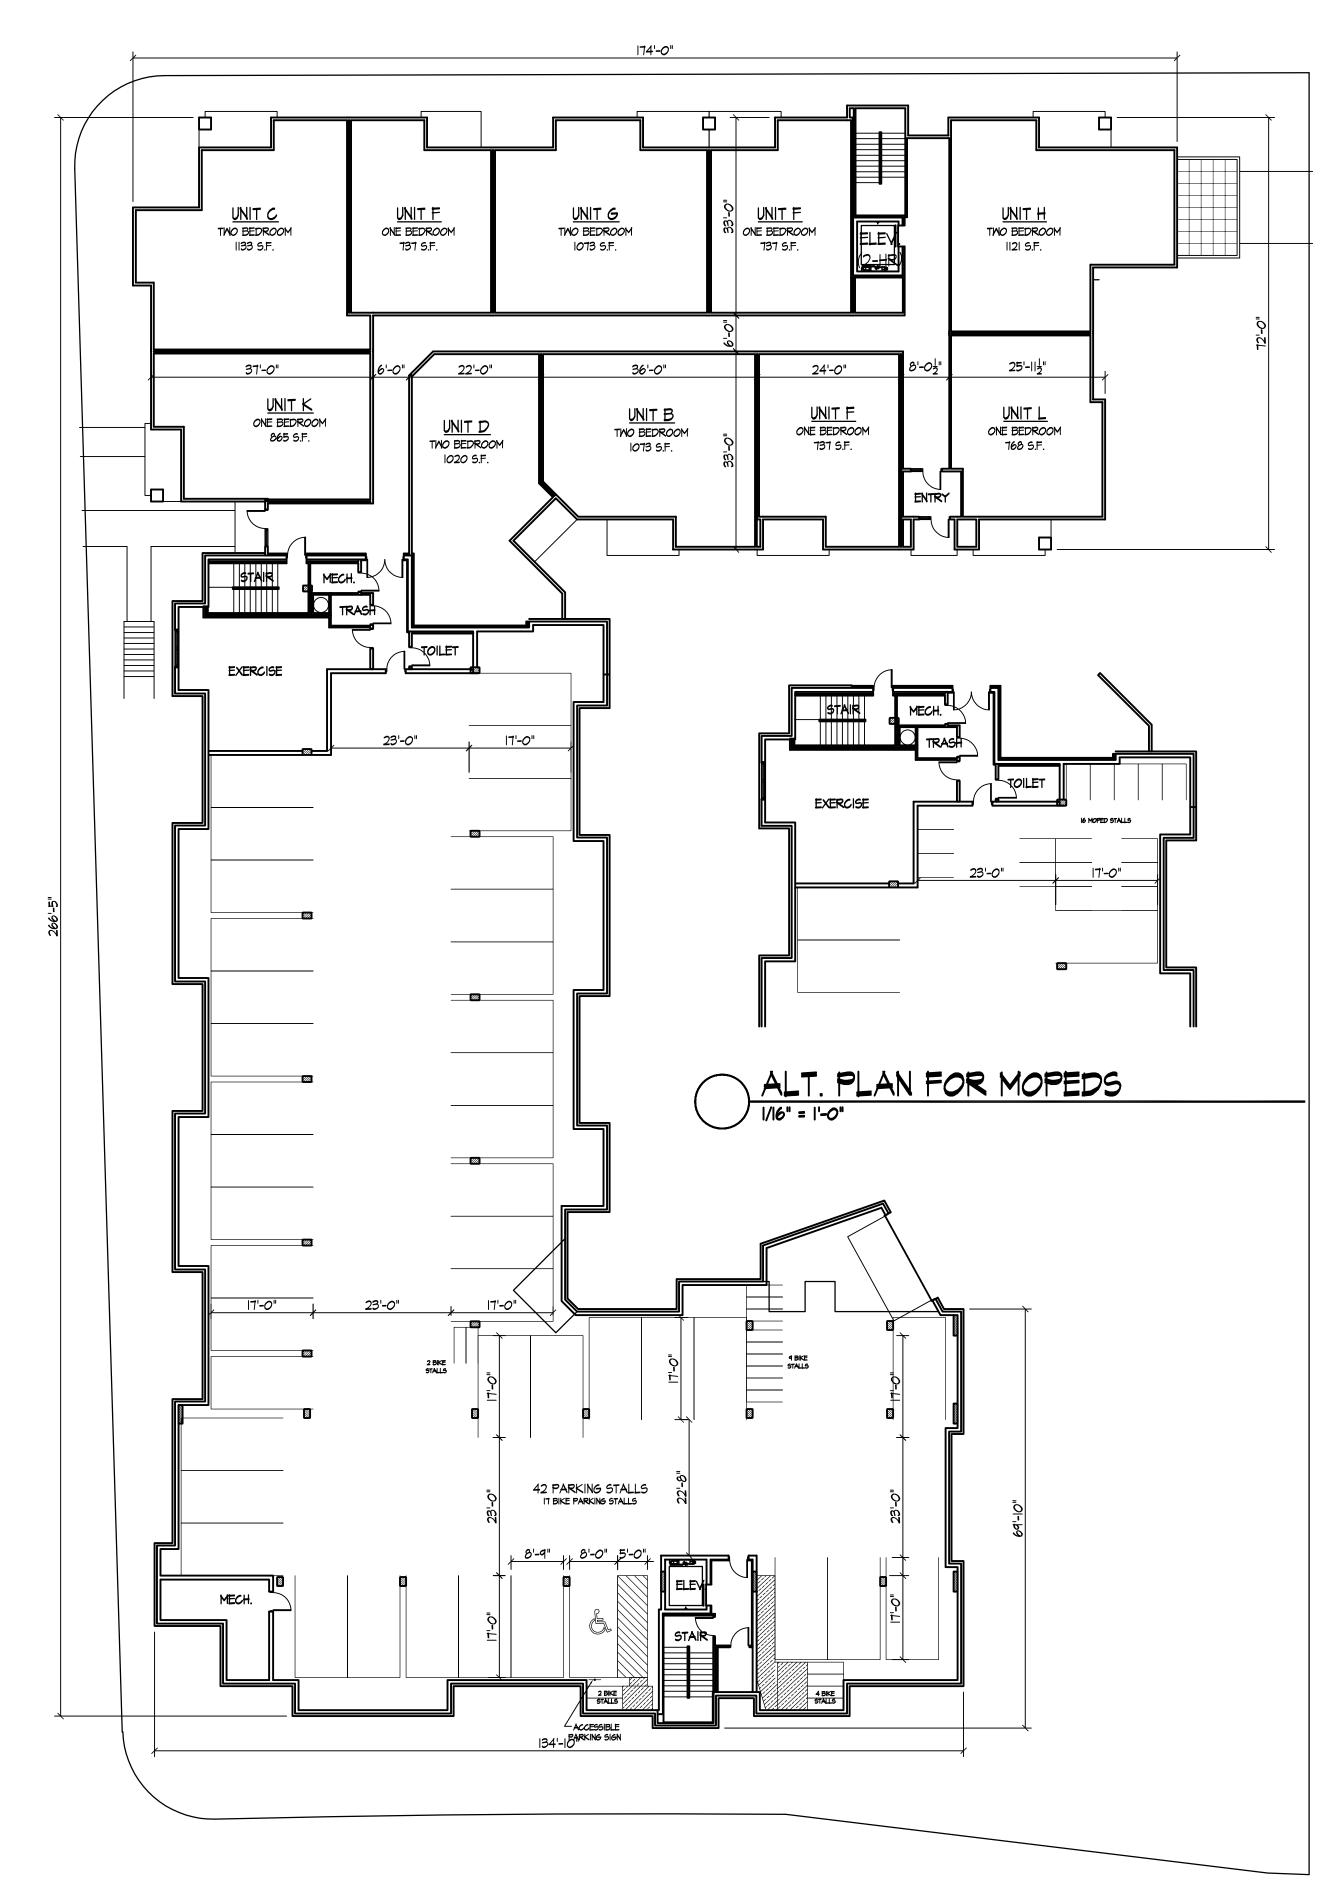

GROUND FLOOR PLAN 12,170 S.F. (EXCLUDES PARKING)

7601 University Avenue Suite 201 Middleton, Wisconsin 53562 608-836-3690 Fax 836-6934

Consultant

Date

Revisions

Issued - April 23,2010 Informational UDC Submittal - May 26, 2010 Plan Com Submittal - June 23, 2010 Final UDC Submittal - August 25, 2010

Project Title

Hilldale Place

4620 Frey Street (formerly 709 N. Segoe Road)

Drawing Title


Basement & Ground

Floor plans Project No.


1007

Drawing No.

A-I.I

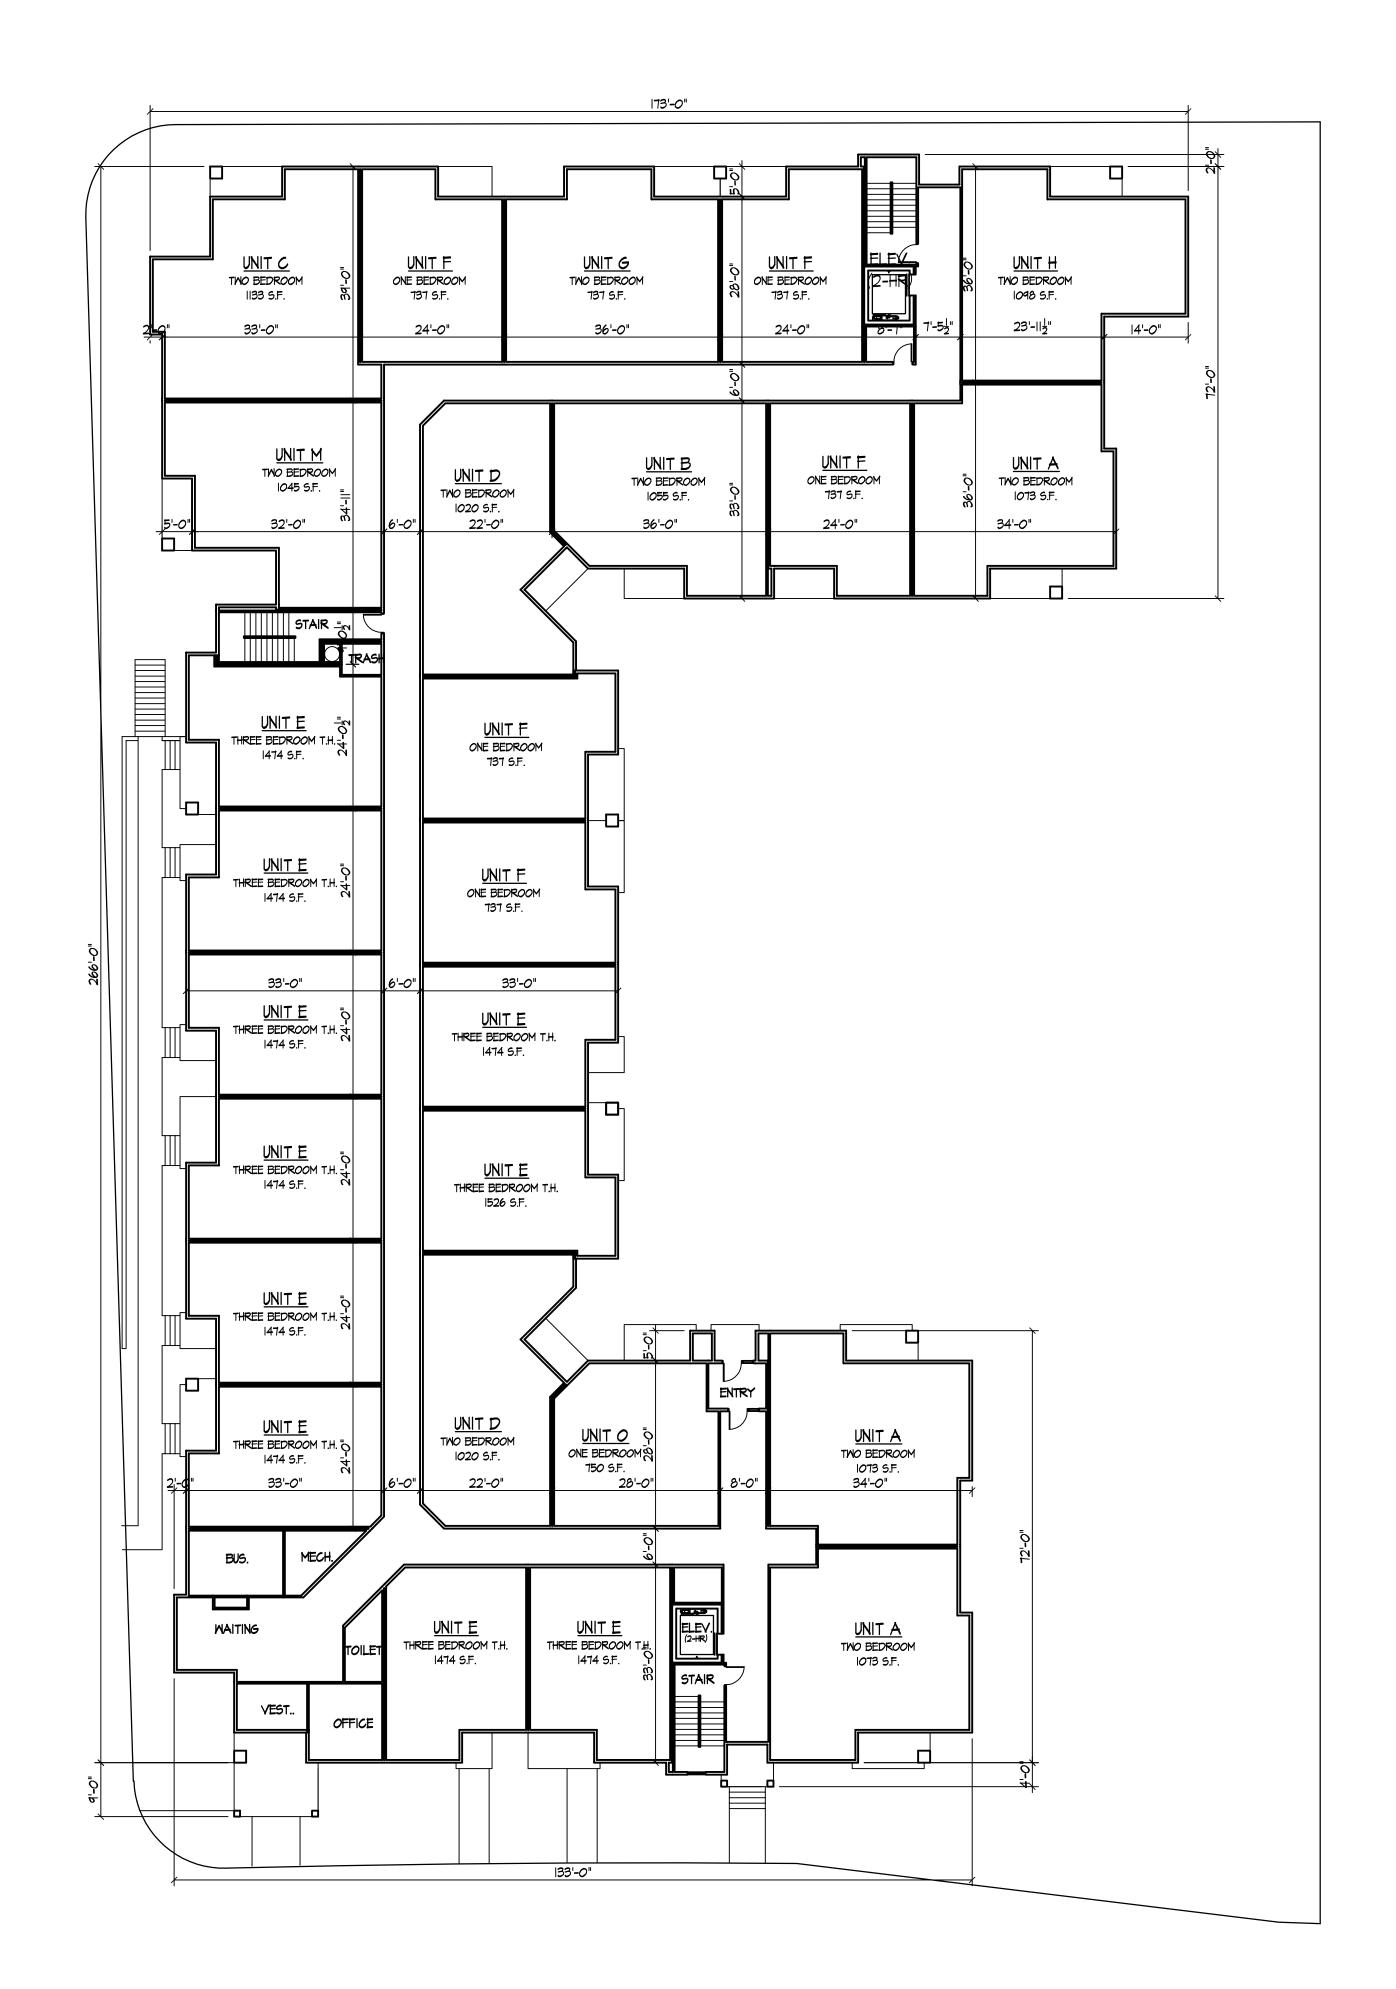



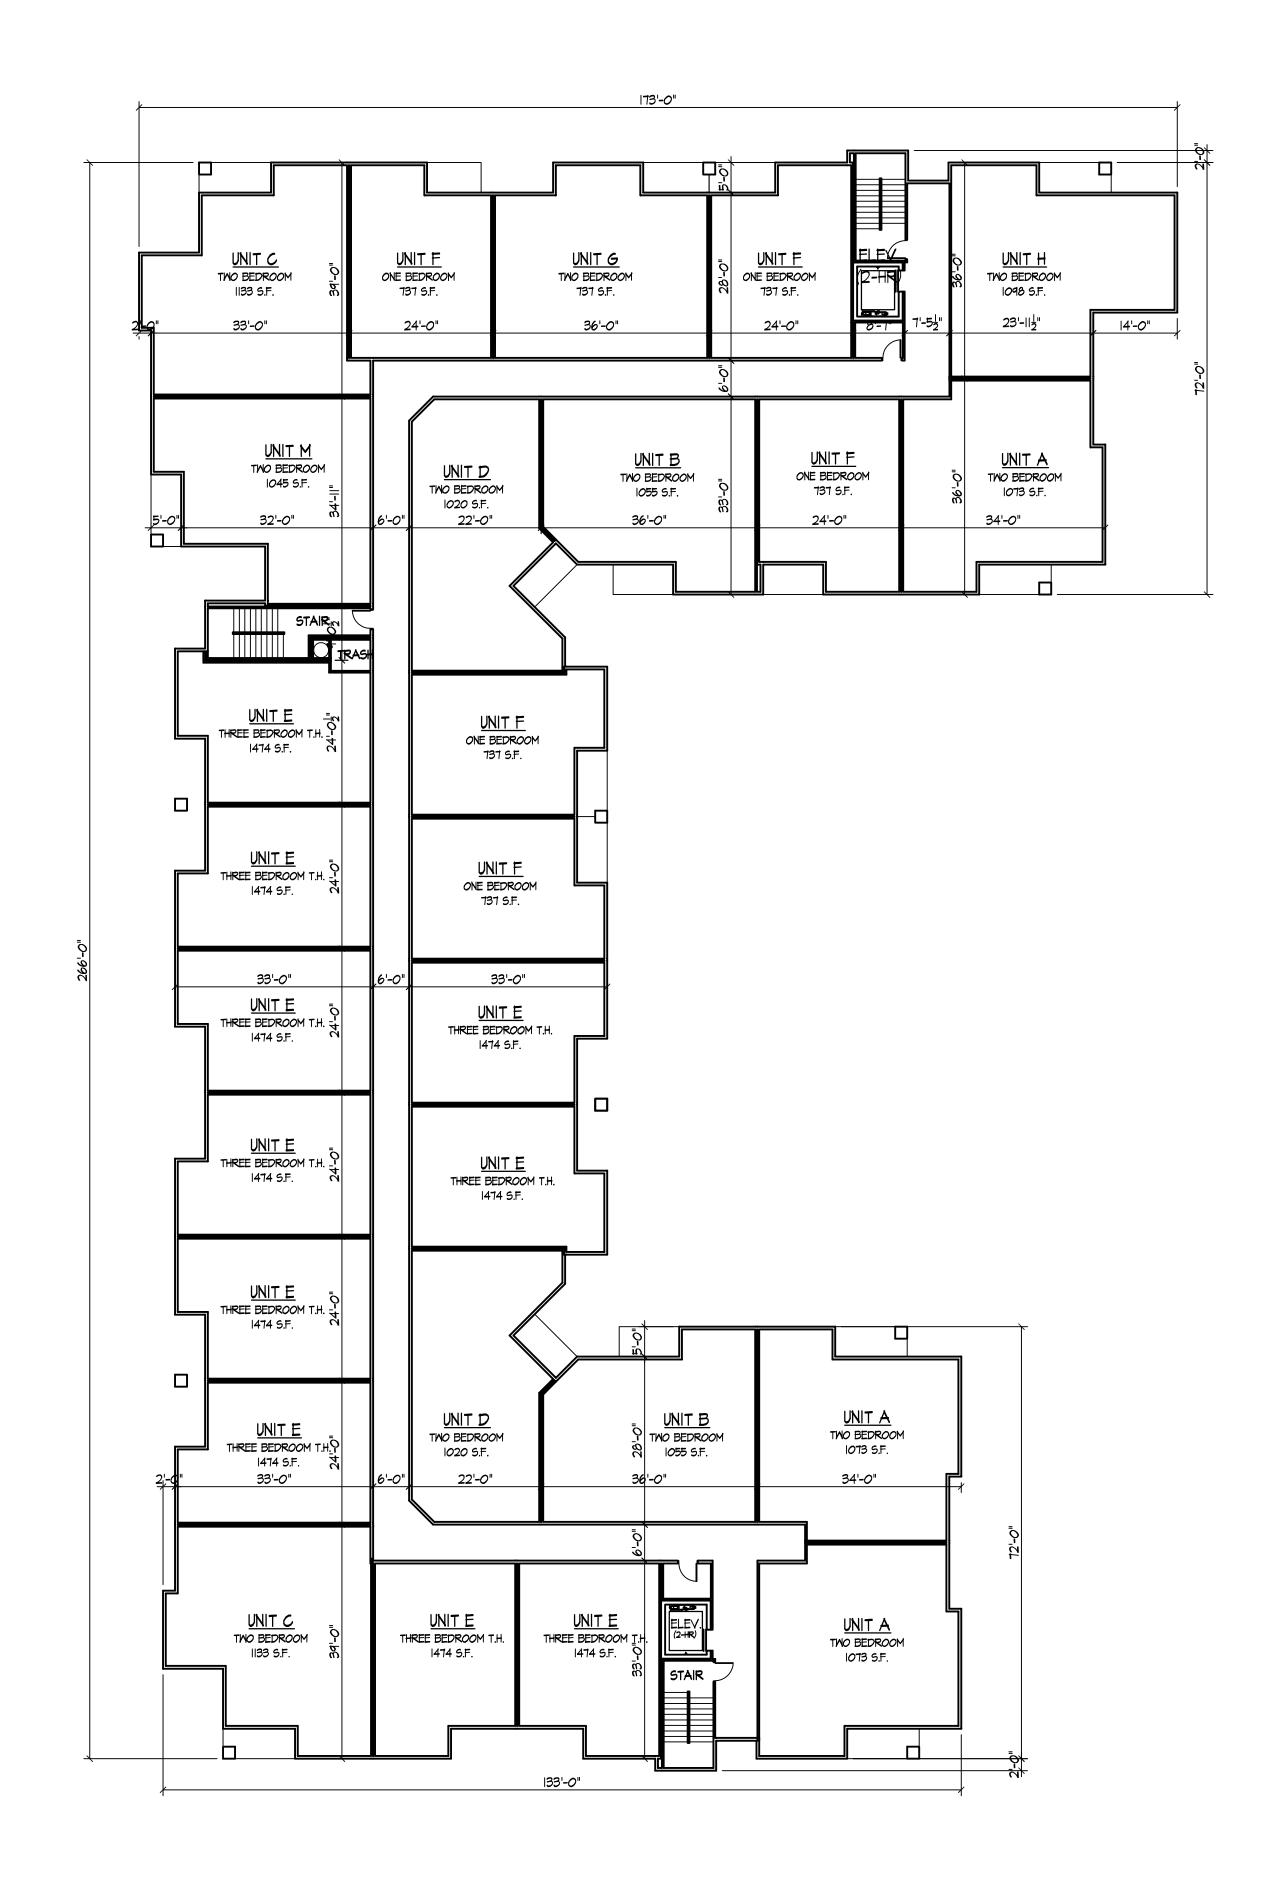

SECOND FLOOR PLAN

1/16" = 1'-0"

27,420 S.F.

KNOTHE SUITE ARCHITECTS
7601 University Avenue Suite 201

Middleton, Wisconsin 53562 608-836-3690 Fax 836-6934

Consultant

.

Revisions Issued - April 23,2010 Informational UDC Submittal - May 26, 2010 Plan Com Submittal - June 23, 2010

Final UDC Submittal - August 25, 2010

Project Title
Hilldale Place

4620 Frey Street (formerly 709 N. Segoe Road)


Drawing Title First & Second Floor

Plans
Project No.


1007

Drawing No.

A-1.2

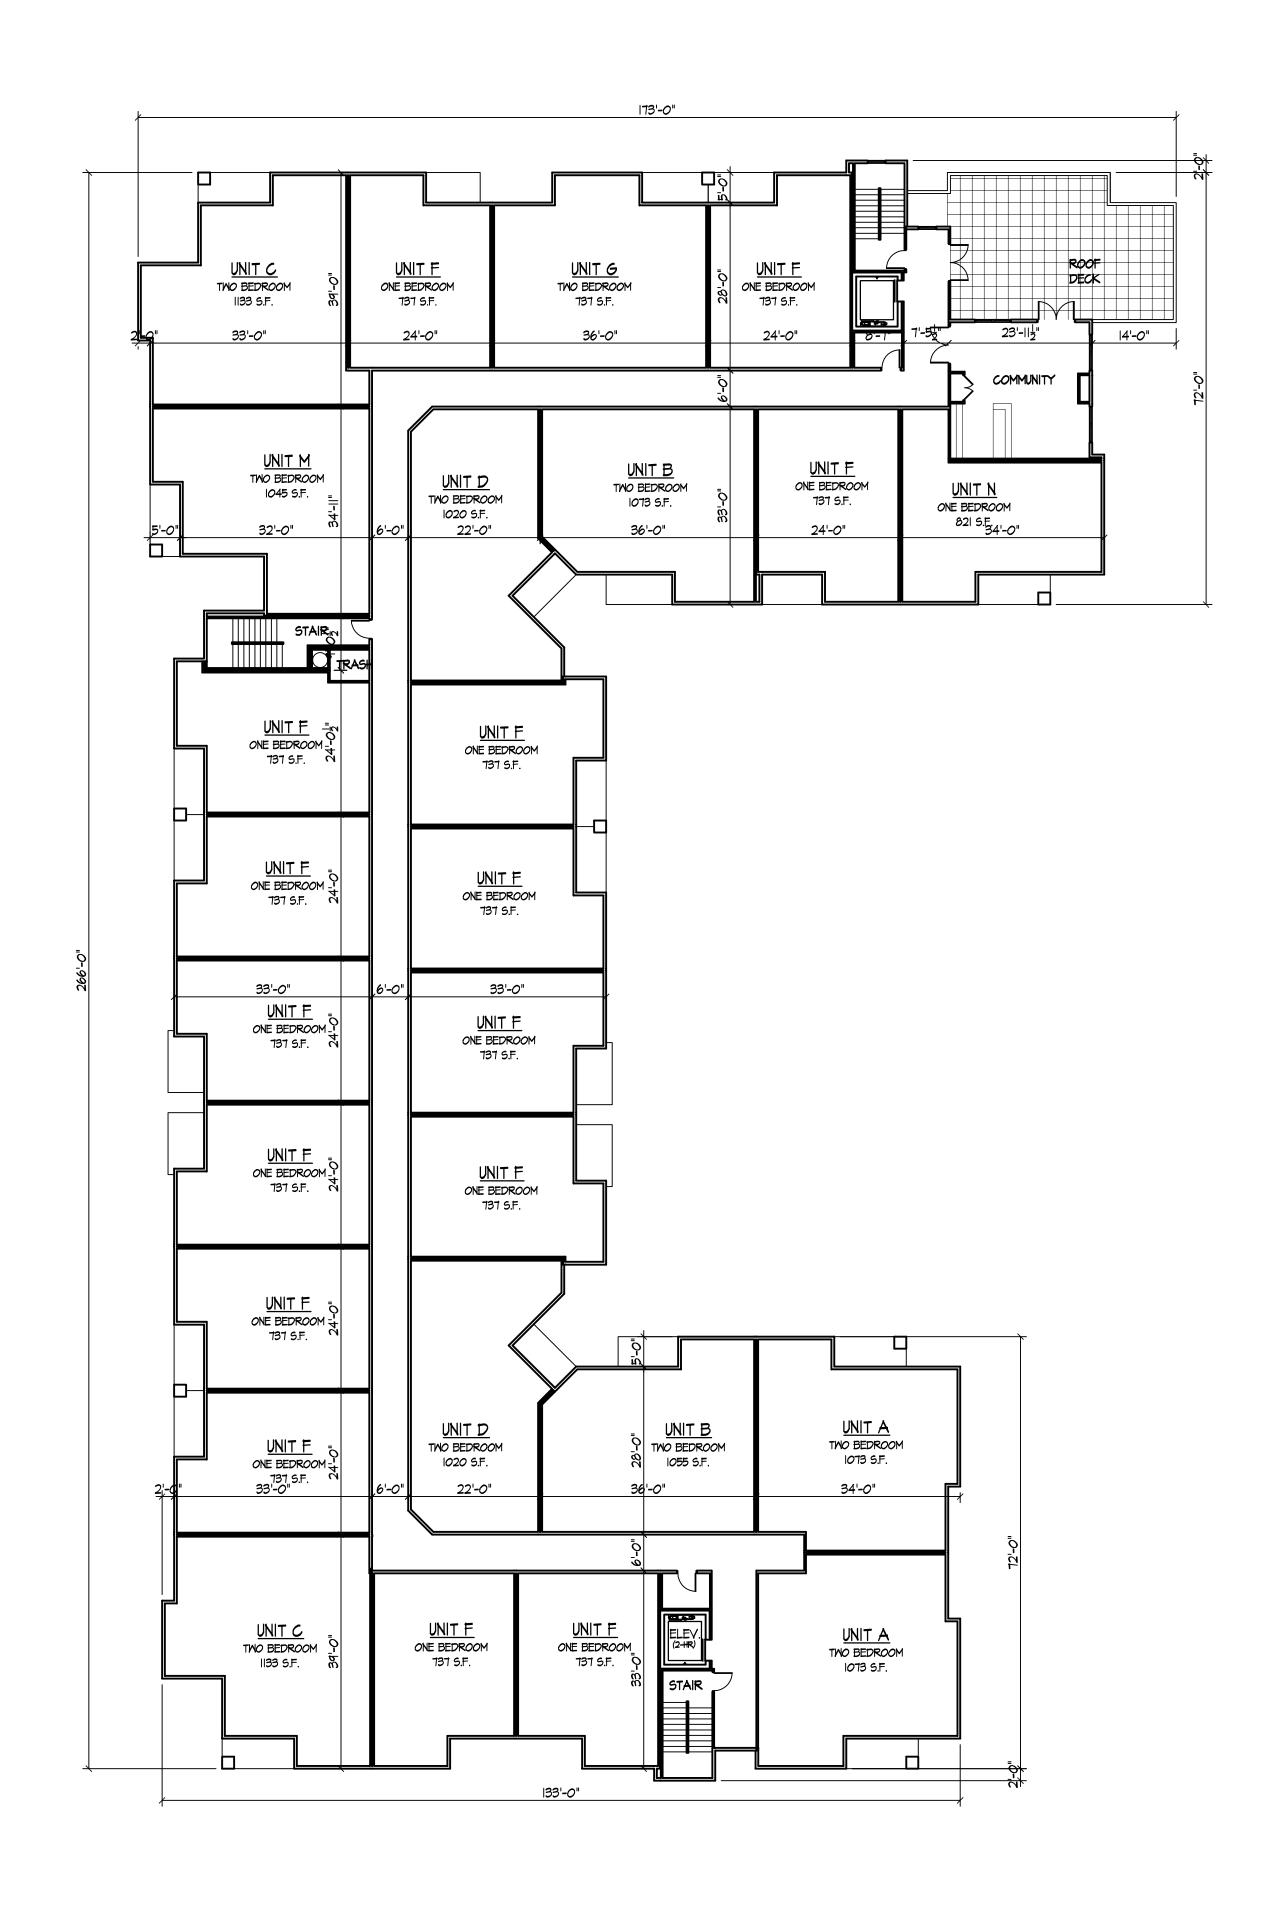



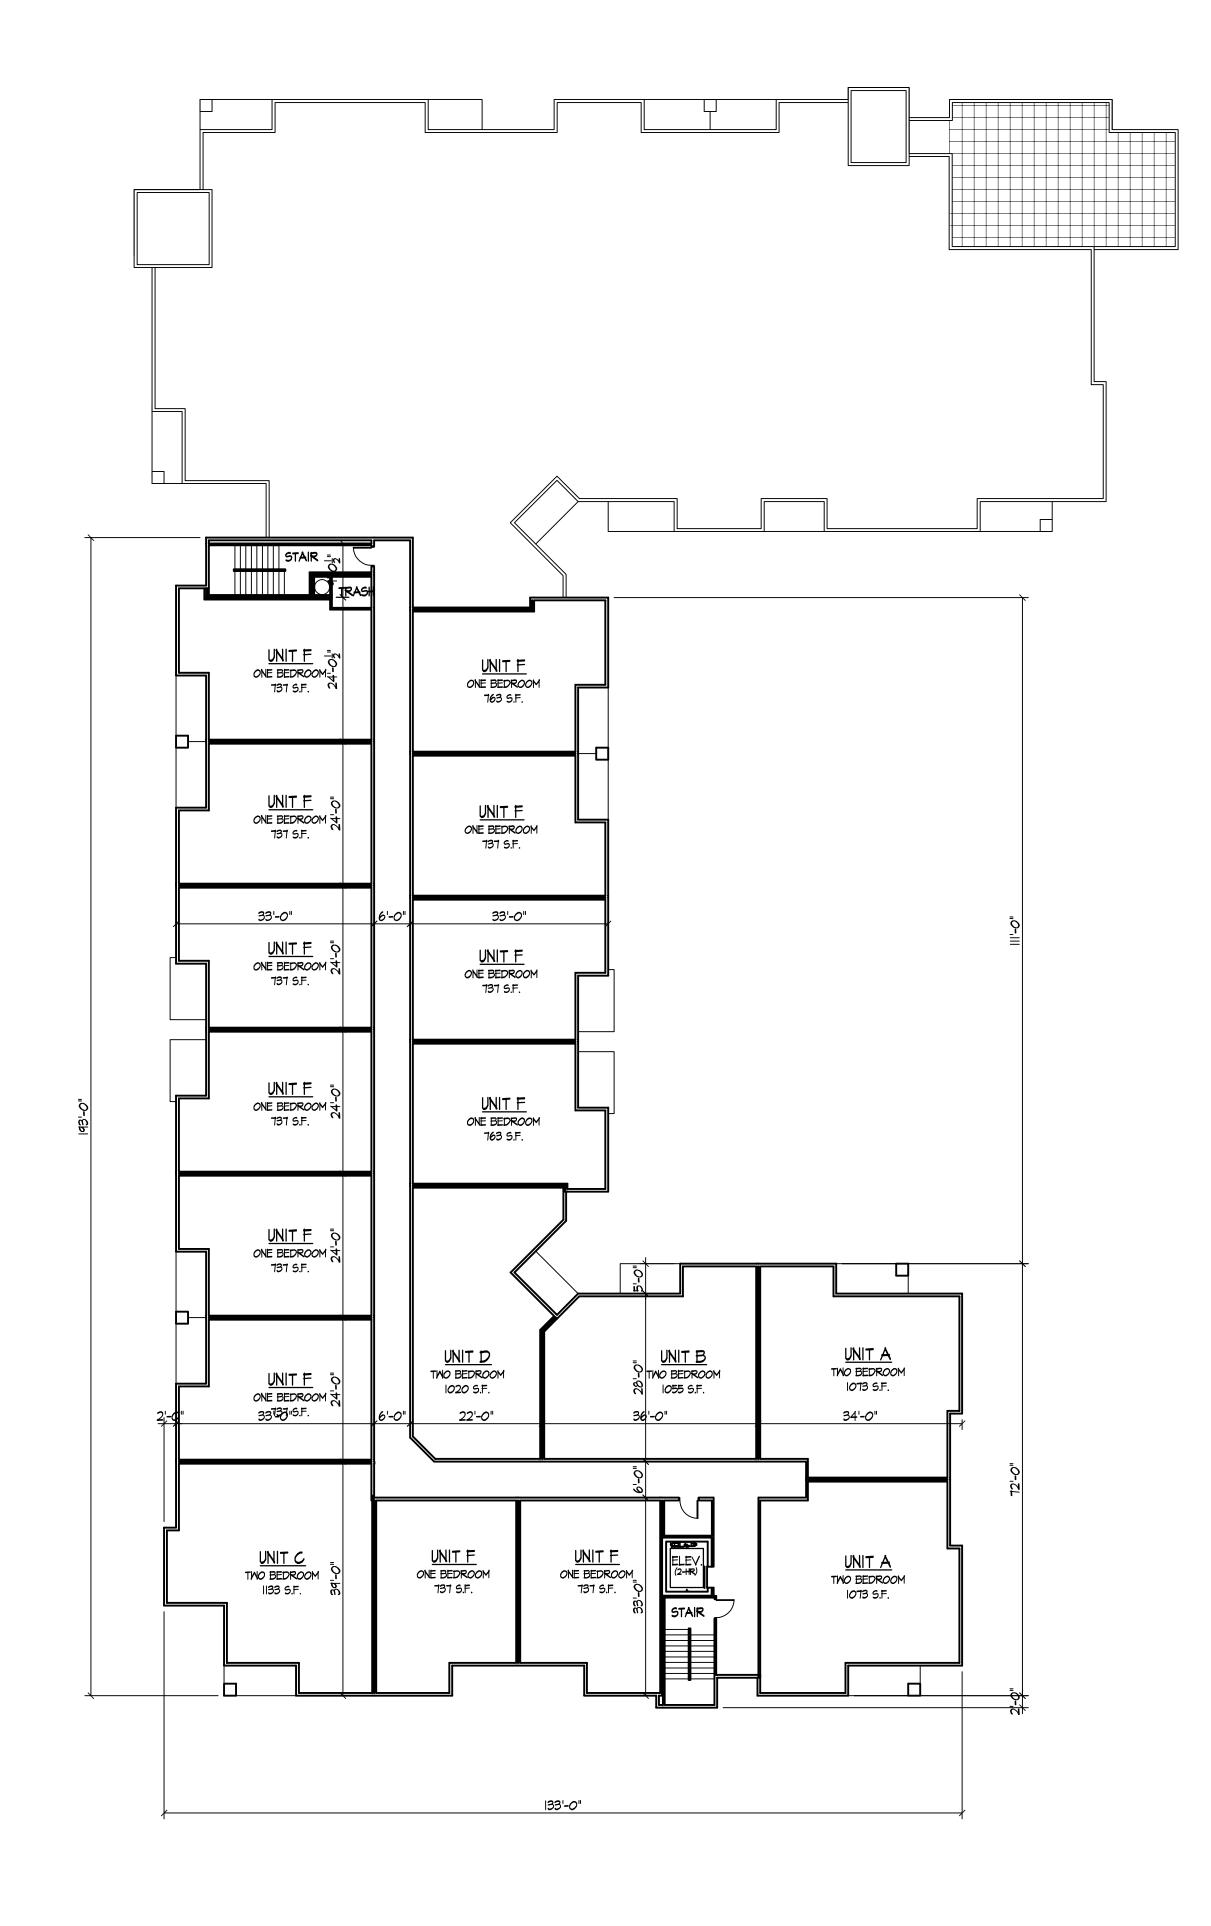





7601 University Avenue Suite 201 Middleton, Wisconsin 53562 608-836-3690 Fax 836-6934

Consultant

Notes Date

Revisions Issued - April 23,2010 Informational UDC Submittal - May 26, 2010 Plan Com Submittal - June 23, 2010

Plan Com Submittal - June 23, 2010 Final UDC Submittal - August 25, 2010

Project Title

Hilldale Place

4620 Frey Street (formerly 709 N. Segoe Road)

Drawing Title
Third & Fourth Floor

Plans Project No.

1007

Drawing No.

A-1.3





SOUTH ELEVATION ALONG FREY STREET

NORTH ELEVATION INSIDE COURTYARD

3/32" = 11-0"



WEST ELEVATION ALONG SEGOE ROAD

KNOTHE
SBRUCE
ARCHITECTS

7601 University Avenue Suite 201
Middleton, Wisconsin 53562
608-836-3690 Fax 836-6934

Consultant

No

Revisions

Issued - April 23,2010 Informational UDC Submittal - May 26, 2010 Plan Com Submittal - June 23, 2010 Initial UDC Submittal - July 21, 2010 Final UDC Submittal - August 25, 2010

Project Title

Hilldale Place

4620 Frey Street (formerly 709 N. Segoe Road)

Drawing Title **Elevations** 

Project No.

1007

A-2.

Drawing No.



608-836-3690 Fax 836-6934



NORTH ELEVATION ALONG UNIVERSITY AVENUE

NORTH ELEVATION INSIDE COURTYARD



Revisions

Issued - April 23,2010 Informational UDC Submittal - May 26, 2010 Plan Com Submittal - June 23, 2010 Initial UDC Submittal - July 21, 2010 Final UDC Submittal - August 25, 2010

Project Title Hilldale Place

EAST ELEVATION 3/32" = 1'-0"

SCREENING WALL ELEVATION


4620 Frey Street (formerly 709 N. Segoe Road) Drawing Title

Elevations

Project No.

1007 A-2.2

Drawing No.

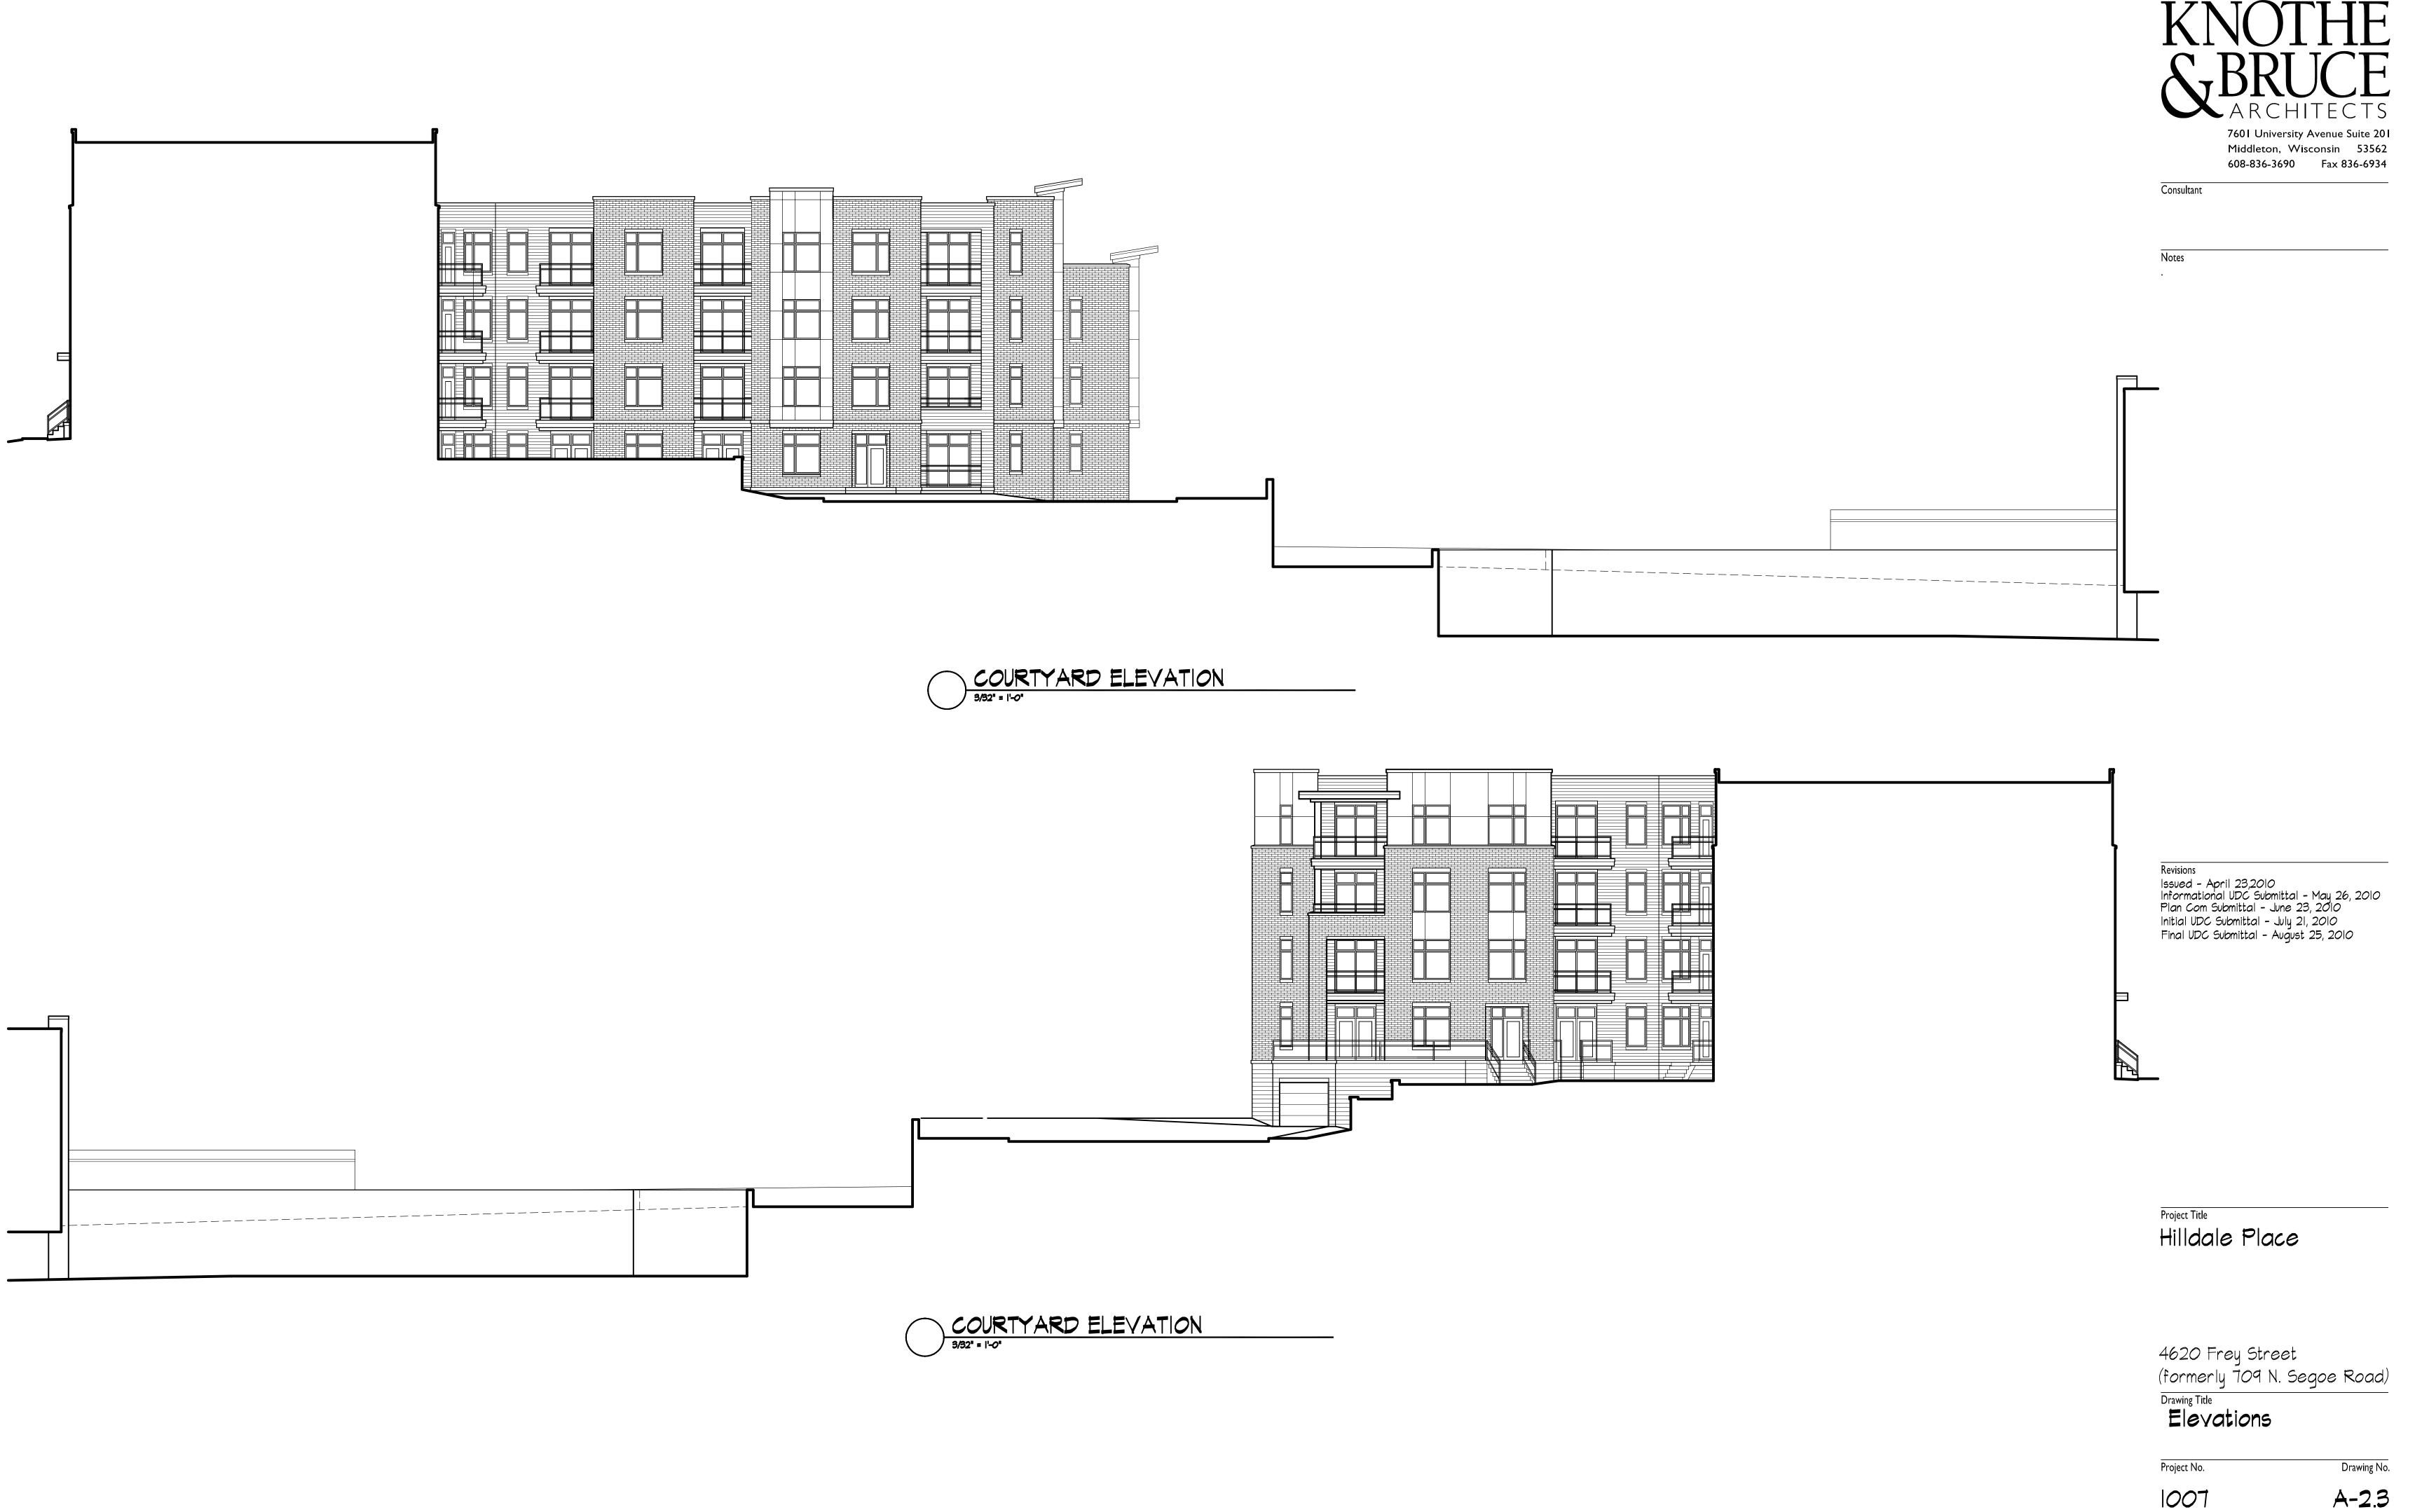




# **Up/Down Cutoff & Deep Shielded**


## E5 Series Up/Down Cutoff

The optics provide controlled uplight and downlight with side cutoff. The E5 Series optics are also available for vertical mounting; add suffix "R" to catalog number.

**NOTE:** 50-watt MH with suffix "G" is supplied with a glass insert to allow operation in the wall-mounted position.

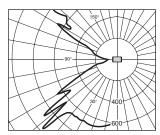


Candlepower Distribution Curve of 50W HPS E5 Up/Down Cutoff Light.

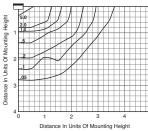


Isofootcandle plot of one 50W HPS E5 Up/Down Cutoff Light at 10' (3.0 m) mounting height (plan view).

# E8 Series Deep Shielded


Front brightness shielding without sacrificing wide light distribution. The E8 works ideally over entrances.

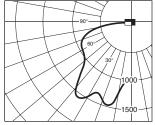

Candlepower Distribution Curve of 70W HPS E8 Deep Shielded Light.

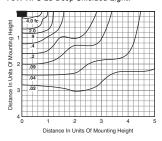

Isofootcandle plot of one 70W HPS E8 Deep Shielded Light at 15' (4.6 m) mounting height (plan view).

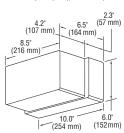

For 50, 70 and 100W HPS with quad-volt or tri-volt, and all MH fixtures, the housing depth is 3" (76 mm), and the overall fixture depth is 7.2" (183 mm).

Description	Lamp Type	Number	Position	
Up/Down Cutoff	50W MH	E5405-MG	Wall	
	35W HPS	E5503-1	Any	
	50W HPS	E5505-1	Any	
Deep Shielded	50W MH	E8405-M	Wall Down	light only
	70W MH	E8407-M	Wall Down	light only
	35W HPS	E8503-1	Any	
	50W HPS	E8505-1	Any	
	70W HPS	E8507-1	Wall Down	light only
	100W HPS	E8510-1	Wall Down	light only
NOTE: Suffix "G" in	dicates glass inse	rt is supplied.		
Options: (Factory-	installed)		Change	Add After
Description			Suffix To	Suffix
277V ballast (35-50V	/ HPS only)		2	
347V ballast (50W HP	S only)		6	
Quad-volt ballast (70	-100W HPS only)		М	
Tri-volt ballast (50 &	70W MH only)		T	
Tri-volt ballast (70 &	100W HPS only)		T	
Photocell (120V, 277V,	208V, 240V or 347\	/)	1, 2, 3, 4 or 6	Р
Bronze Color Shroud	<u> </u>			BS
Gold Color Shroud (i	not available on 100\	W HPS)		GS
High Power Factor be	allast			Н
Tamperproof Lens Fa	steners			J
Vertical Mounting (Es	Series only)			R
NOTE: Not available	when both hpf ar	nd photocell su	pplied	
Polycarbonate Lens				V
Accessories: (Fiel	d-installed)			
Description		Ca	talog Numb	er
Surface Mounting Bo	X		ESB-7	
Pole Mounting Brack	et		PAS-7	
Tamperproof Screwd	river		TPS-1	

**Order Information** 

Mounting

Catalog

Wattage/

# E5 Series Mounting Multipliers

Height	Multiplier
7' (2.1 m)	2.04
8' (2.4 m)	1.56
9' (2.7 m)	1.23
10' (3.0 m)	1.00
12' (3.7 m)	0.69
15' (4.6 m)	0.44
20' (6.1 m)	0.25

The E5 Series photometric data was developed in testing Ruud fixtures with clear, 50W HPS 4,000 lumen medium base lamps. Footcandle readings for other wattages and lamp types may be obtained by multiplying the chart values by the following:

Lamp/Wattages	Multiplier
50W MH	0.85
35W HPS	0.56

#### **E8 Series Mounting Multipliers**

Height	Multiplier
8' (2.4 m)	3.52
10' (3.0 m)	2.25
12' (3.7 m)	1.56
15' (4.6 m)	1.00
20' (6.1 m)	0.56
25' (7.6 m)	0.36

The E Series photometric data in this section was developed in testing Ruud fixtures with clear, 70W HPS 6,400 lumen medium base lamps. Footcandle readings for other wattages and lamp types may be obtained by multiplying the chart values by the following:

Lamp/Wattages	Multiplier
50W MH	0.53
70W MH	0.86
35W HPS	0.35
50W HPS	0.63
100W HPS	1.48

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