

Letter of Intent Brown Lofts Apartments

Steve Brown Apartments, Owner 1815 University Avenue Madison, Wisconsin 53705

March 4, 2008

Project Description:

The Brown Lofts Apartments is a 64-unit residential apartment community located on the near-west side of Madison. The project consists of a 4-story building whose design features a mix of apartment sizes from One-bedroom units to Two-bedroom multistory units with underground parking. Please refer to the attached drawings for detailed unit count. The existing 3 ½ story "Princeton House" building – a 102-unit, 200+ person capacity residence hall, which is out of character with the neighborhood to the south, will be demolished upon city approval. The density of the proposed project is consistent with the City of Madison Comprehensive Plan which calls for High Density Residential (HDR) on this site. The site lies within the University Heights Historic District and follows the district guidelines. Site amenities include: access to public transportation, close proximity to the University of Wisconsin campus, private balconies, and ample parking.

Owner:

Steve Brown Apartments 120 West Gorham Street Madison, WI 53703 (608) 255-7100 Steve Brown Owner

Architect:

Brownhouse 202 West Gorham Street Madison, WI 53703 (608) 663-5100 Patrick McGowan
Principal / Director of Architecture

Landscape Architect: Joe Hanauer
Landscape Architecture, LLC Landscape Architect

3390 Cty. Tk. P Mount Horeb, WI 53572

(608) 798-1840

Site Engineer and Surveyor: Michelle Burse Burse Survey & Engineering Inc. Peter Fortlage

1400 East Washington Avenue Madison, WI 53703 (608) 250-9263

Site Information:

The project presented is proposed as a PUD (GDP/SIP). The site has vehicular access off Princeton Avenue and pedestrian/bike access from both Princeton Avenue and University Avenue. The main entrance to the building is on University Avenue. Landscaping will be principally located along the street facades and on roof terraces on the south side of the building. The lot is 25,520 square feet in size (per city records), approximately 0.586 acres.

Construction Schedule:

July 5, 2008 Begin Construction
August 20, 2009 Construction Completion

Building Use and Square Footage:

This traditionally designed 64-unit apartment building is a 4-story building featuring multistory units and underground parking. The exterior facade will feature a rusticated stone veneer base on the first floor with full brick veneer above. A painted, built-up synthetic material cornice will top off the building. Special design elements include: arched openings, quoins on the building's corners, horizontal limestone and precast concrete banding, aluminum casement windows, and decorative metal fencing. The exterior materials, landscaping, signage, and site lighting will compliment adjacent properties in this neighborhood.

The apartment units vary in size from One-bedroom apartments to spacious Two-bedroom multistory units. Amenities will include heated underground parking, laundry/vending areas and private outdoor balconies.

The following is the gross square footage of the proposed building:

Parking Level P2	16,477 sf.
Parking Level P1	23,923 sf.
First Floor	20,050 sf.
Second Floor	18,508 sf.
Third Floor	18,508 sf.
Fourth Floor	18,508 sf.
Total Building Area:	115,974 sf.

Bedrooms per Dwelling Unit:

Please refer to Site Plan (C200) for additional information.

Parking Requirements:

Please refer to Site Plan (C200) for additional information.

Mail Drop-off and Pick-up:

Resident mailboxes are located inside of the Main entrance Lobby on the First floor of the building.

Hours of Operation:

The building will be occupied 24 hours a day / 365 days of the year.

Potential Number of School Age Children Generated by Project:

The project is estimated to generate less than ten (10) school age children.

Maintenance:

Trash removal will be contracted privately and collected at the drive entry to the parking level of the building. Steve Brown Apartments will provide snow removal and landscape maintenance for the entire property.

Demolition Recycling and Reuse Plan:


Recycling and reuse plan to be approved by the City's Recycling coordinator prior to the issuance of the demolition permit.

Legal Description:

The lands subject to this Planned Unit Development District shall include those described below:

All of Lots 3, 4, 5 and 6, Block 3, University Heights, as recorded in Volume 1 of Plats, on Page 17, as document number 197136, Dane County Registry, located in the Northeast Quarter of the Northwest Quarter of Section 22, Township 07 North, Range 09 East, City of Madison, Dane County, Wisconsin.

Containing 25,520 sq. ft. = 0.586 Acres.

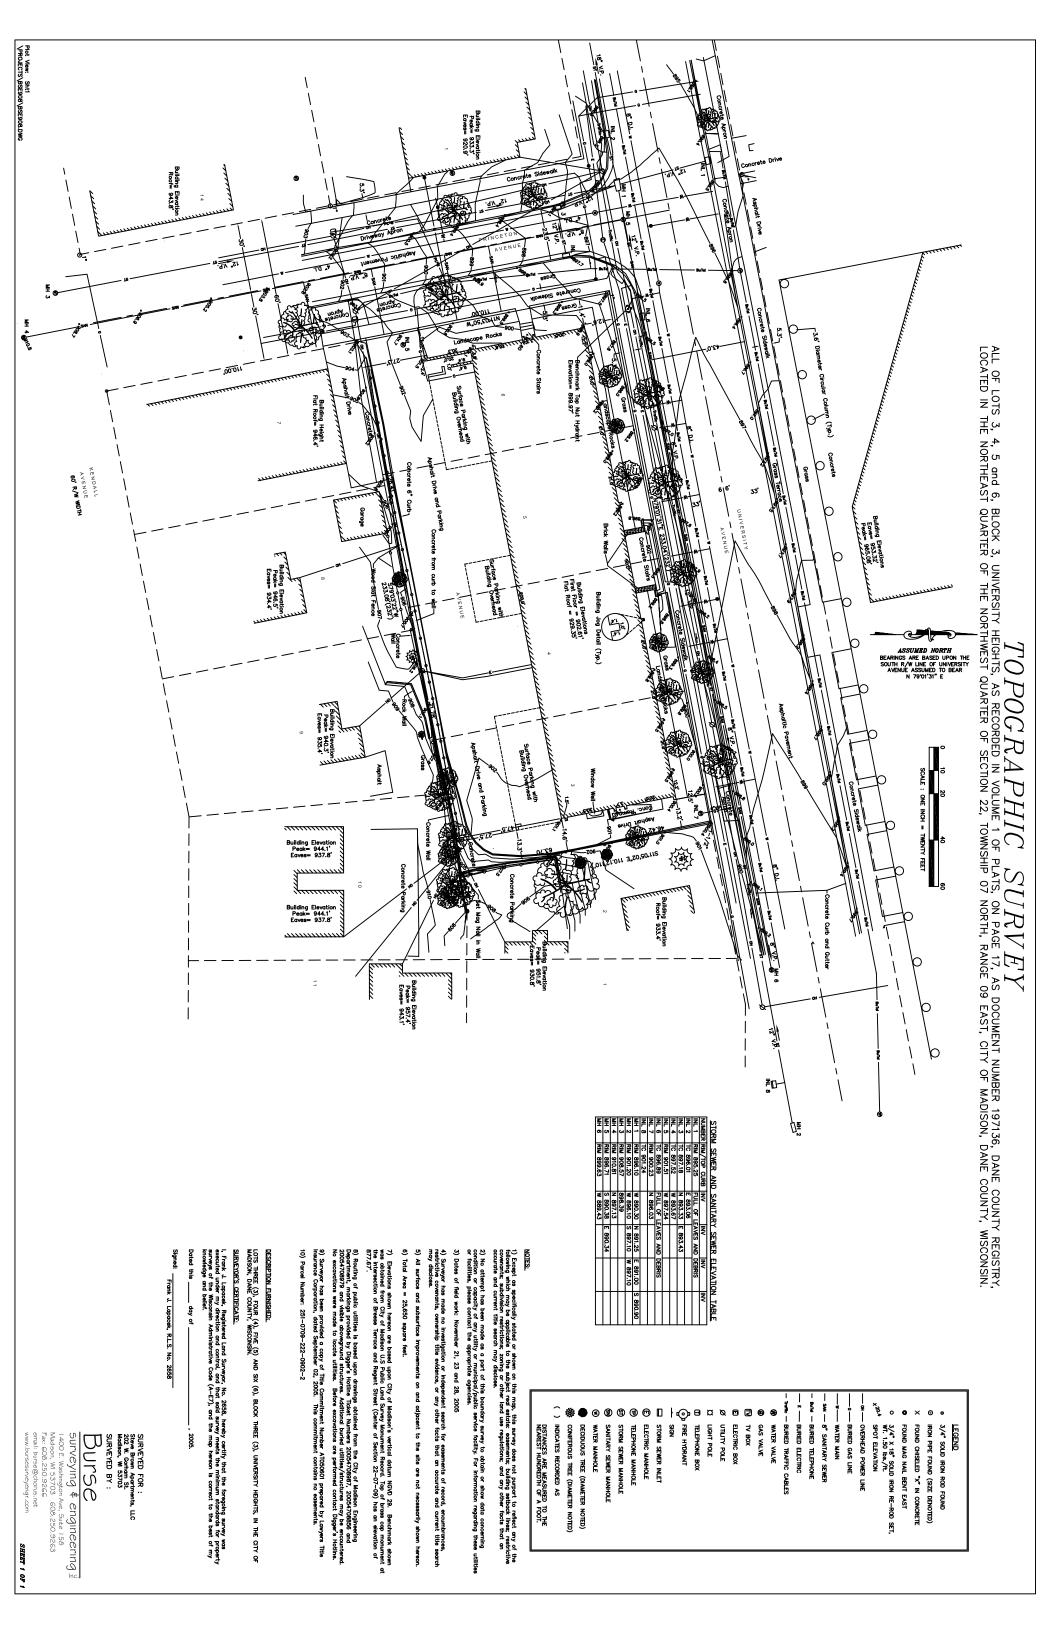

ABBREVIATIONS ACOUSTICAL CEILING TILE ABOVE FINISHED FLOOR AESTHETIC JOINT

GENERAL NOTES

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O.F.C.I.

15. GYPSUM BOARD SHEATHING FOR WALLS, CEILINGS AND OTHER MISCELLANEOUS CONSTRUCTION IS 5/8" THICK, U.N.O. ON THE DRAWINGS OR IN THE SPECIFICATIONS 13. INSTALL MISCELLANEOUS WOOD BLOCKING AS INDICATED ON THE DRAWINGS OF AS REQUIRED FOR THE PROPER INSTALLATION OF CABINETRY, PKTURES, APPLIANCES, EQUIPMENT, GRAB BARS, TOILET ACCESSORES, BASE TRIM, DOOR CABINES, MISCELLANEOUS TRIMS AND OTHER MISCELLANEOUS TRIMS.

14. PRODUCT SPECIFICATIONS FOR THIS PROJECT ARE USITED IN THE PRODUCT USIT, DOOR SCHEDULE, PLUMBING FIXTURE & TOILET ACCESSORES SOHEDULE, LICHT FIXTURE & ELECTRICAL FIXTURE SCHEDULE AND IN THE APPLIANCE

REQUIRED SUBMITTALS

DOOR AND DOOR HARDWARE SHOP DRAWINGS AND PRODUCT DATA.
WALL AND FLOOR TILE SHOP DRAWINGS AND PRODUCT DATA.
LIGHTING PLAN AND PRODUCT DATA FOR ALL LIGHT FIXTURES, EXIT LIGHTS,
MERGENCY, LIGHTS, SWITCHES AND MISCELLANEOUS FIXTURES, EQUIPMENT AND CABINETRY, CASEWORK, COUNTERTOP & CABINET HARDWARE SHOP DRAWINGS

C LAMINATE

5. POWER PLAN AND PRODUCT DATA FOR ALL COMPONENTS OF THE POWER
DISTRIBUTION SYSTEM INCLUDING OUTLETS, PANELS, SUB-PANELS AND ALL
MISCELLAMEOUS EQUIPMENT AND ACCESSORIES.

6. HYAC PLAN AND PRODUCT DATA FOR ALL COMPONENTS OF THE HYAC SYSTEM
INCLUDING HEATING AND AIR CONDITIONING UNITS, MAKE-UP AIR UNITS, DUCTING,
CONTROLS, GRILLES AND ALL MISCELLANEOUS EQUIPMENT AND ACCESSORIES.

PROJECT LOCATION

SITE LOCATION


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STANLARO
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URINAL
VERTICAL
VERTICAL
VERTICAL
VINTA, COMPOSTION TILE
WATERCLOSET
WATERPROOF
WEIGHT
WIDE / WIDTH
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WOODT
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NLESS NOTED OTHERWISE

I. ALL CONTRACTORS SHALL, AT THE TIME OF BIDDING OR PRICING, CONFIRM WITH ALL OF THEIR SUBCONTRACTORS, VENDORS, AND SUPPLIERS THE AVAILABILITY OF MATERIALS AND PRODUCTS SPECIFIED FOR THIS PROJECT. THE GENERAL SOUTRACTOR SHALL REPORT TO BROWNHOUSE ANY MATERIALS OR PRODUCTS THAT ARE NOT AVAILABLE OR WILL CAUSE DELAY IN THE CONSTRUCTION SCHEDULE. THE CONTRACTOR WILL REPORT THIS INFORMATION TO BROWNHOUSE 1) DRAWING TITLE



RIOR TO SIGNING OF THE CONTRACT FOR CONSTRUCTION SO ACCEPTABLE SUBSTITUTIONS CAN BE FOUND OR APPROVED BY BROWNHOUSE.

ALL CONTRACTOR PROPOSED SUBSTITUTIONS SHALL BE SUBMITTED TO ROWNHOUSE WITH THE CONTRACTOR'S BID OR PRICING PACKAGE.

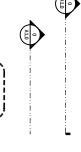SEE THE <u>REQUIRED SUBMITTALS</u> LIST FOR A LIST OF INFORMATION THAT MUST BE IBMITTED TO BROWNHOUSE PRIOR TO ORDERMS, FARRICATION AND STEAL STEAL AMERICAN, AND DESIGNBUILD MECHANICAL, ELECTRICAL, PLUMBING, FIRE PROTECTION AND DESIGNBUILD MECHANICAL, ELECTRICAL, PLUMBING, FIRE PROTECTION AND







OWNER:

MADISON, WISCONSIN 53705

1815 UNIVERSITY AVENUE

IMENTS



ESIGNBUILD MECHANICAL, ELECTRICAL, PLUMBING, FIRE PROTECTION AND HER DESIGNBUILD CONTRACTORS SHALL PROVIDE ALL NECESSARY CULATIONS AND SUBMITTALS TO OBTAIN PERMITS FOR THEIR WORK. LL CONTRACTORS TO ABIDE BY ALL APPLICABLE BUILDING, HVAC, ELECTRICAL MBING AND LIFE SAFETY CODES.

K SHALL COMPLY WITH THE ACCESSIBILITY REQUIREMENTS OF CESSIBILITY IN THE WISCONSIN ENROLLED COMMERCIAL BUILDING NSI A117, AS REFERENCED BY THE WISCONSIN ENROLLED

R DESIGNBUILD CONTRACTORS ARE RESPONSIBLE FOR THE PROPER DESIGN
NISTALLATION OF THEIR SYSTEMS. PENETRATIONS THROUGH FIRE RATED
MBLIES SHALL COMPLY WITH THE REQUIREMENTS OF CHAPTER 7. FIRE
TRACE FRATED CONSTRUCTION IN THE WISCONSIN ENROLLED COMMERCIAL













8. ALL CONTROL SHALL FIELD VERIFY DIMENSIONS AND FIELD CONDITIONS
PRIOR TO COMMENCIMENT OF THEIR WORK.
9. DIMENSIONS, DIMENSIONS REFER TO PACE OF CONCRETE WALLS, FACE OF
MASONRY WALLS, FACE OF STUDS AT EXTERIOR WALLS IN NEW CONSTRUCTION,
FACE OF FINISH AT EXISTING CONDITIONS, FACE OF STUDS AT NEW MITEROR
WALLS OR PARTITIONS OR CENTERLINES OF DEMISSION WALLS BETWEEN REPERATE
TENANTS OR RESIDENTIAL UNITS. CLEAR DIMENSIONS REFER TO UNDOSSTRUCTED
DIMENSIONS THAT MUST BE MAINTAINED, CLEAR DIMENSIONS REFER TO THE NETALLATION
OF EQUIPMENT, FURNISHING, FIXTURES, PITC...
10. FRAMING: ALL FRAMINGIS METAL STUD FRAMING, EXCEPT MISCELLANEOUS
BLOCKING FOR CABINET'S, RITYLURES, APPLIANCES, GRAB BARS, ETC. ALL
MISCELLANEOUS WOOD BLOCKING SHALL BE DIMENSIONAL LUMBER OR PLYWOOD
OF SUFFICIENT STRENGTH TO PROVIDE PROPER ANCHORAGE OR CARRY REQUIRED
OF SUFFICIENT STRENGTH TO PROVIDE PROPER ANCHORAGE OR CARRY REQUIRED






















NTERIOR WALL/PARTITION FRAMING IS 3 5/8" COLD FORMED, 25 GAUGE METAL

ERIOR WALL FRAMING IS 6" COLD FORMED, 16 GAUGE METAL STUDS @ 16"



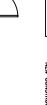







INDOW TYPE

REVISION NUMBER

ARCHITECTURAL KEYNOTE

NEW CONSTRUCTION

 \boxtimes

 \bowtie

 \bowtie

|X|

EXIT SIGN

SYMBOLS

BUILDING SECTION DRAWING TITLE

DETAIL REFERENCE

ELEVATION REFERENCE

MADISON, WI 53703 PH: (608) 255-7100

STEVE BROWN - OWNER STEVE BROWN APARTMENTS

120 W. GORHAM STREET

CODE SUMMARY:

CONSTRUCTION TYPE:

HEIGHT: PROJECT AREA: OCCUPANCY:

R-2 / S-2

4 STORIES

SEE SHEET C200

SECOND FLOOR FIRST FLOOR

OCCUPANT LOAD: FOURTH FLOOR THIRD FLOOR X (S-2)

X (R-2) **FULLY SPRINKLERED** (NFPA 13)

FIRE PROTECTION:

DRAWING INDEX:

TOPOGRAPHIC SURVEY T100 - TITLE SHEET

C200 - SITE PLAN

U/D-1 - UTILITY PLAN G-1 - GRADING/EROSION CONTROL PLAN

L100 - LANDSCAPE PLAN

A201 - PARKING LEVEL P1 A200 - PARKING LEVEL P2

A202 - FIRST FLOOR PLAN

A203 - SECOND FLOOR PLAN A204 - THIRD FLOOR PLAN

A205 - FOURTH FLOOR PLAN


A301 - EXTERIOR ELEVATIONS A300 - EXTERIOR ELEVATIONS

RAWING INDEX (CONT.):


PRELIMINARY - NOT FOR CONSTRUCTION

SHEET

BROWN LOFTS 1815 UNIVERSITY AVE. MADISON, WI 53705

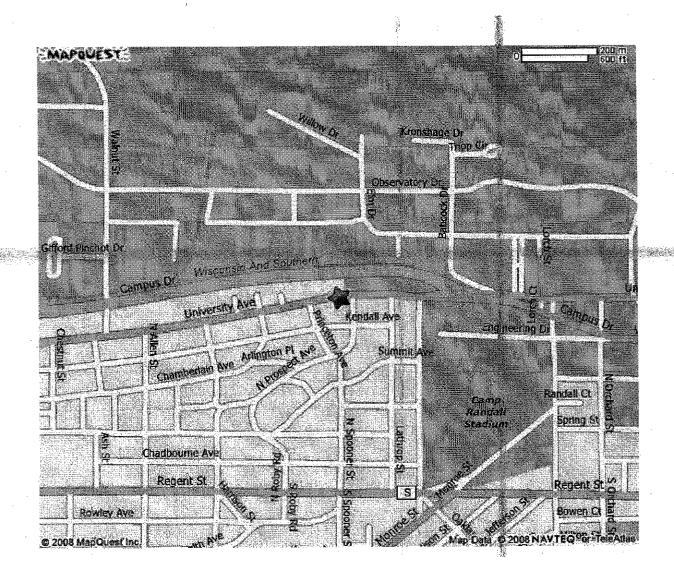



SITE LOCATION
1815 UNIVERSITY AVENUE

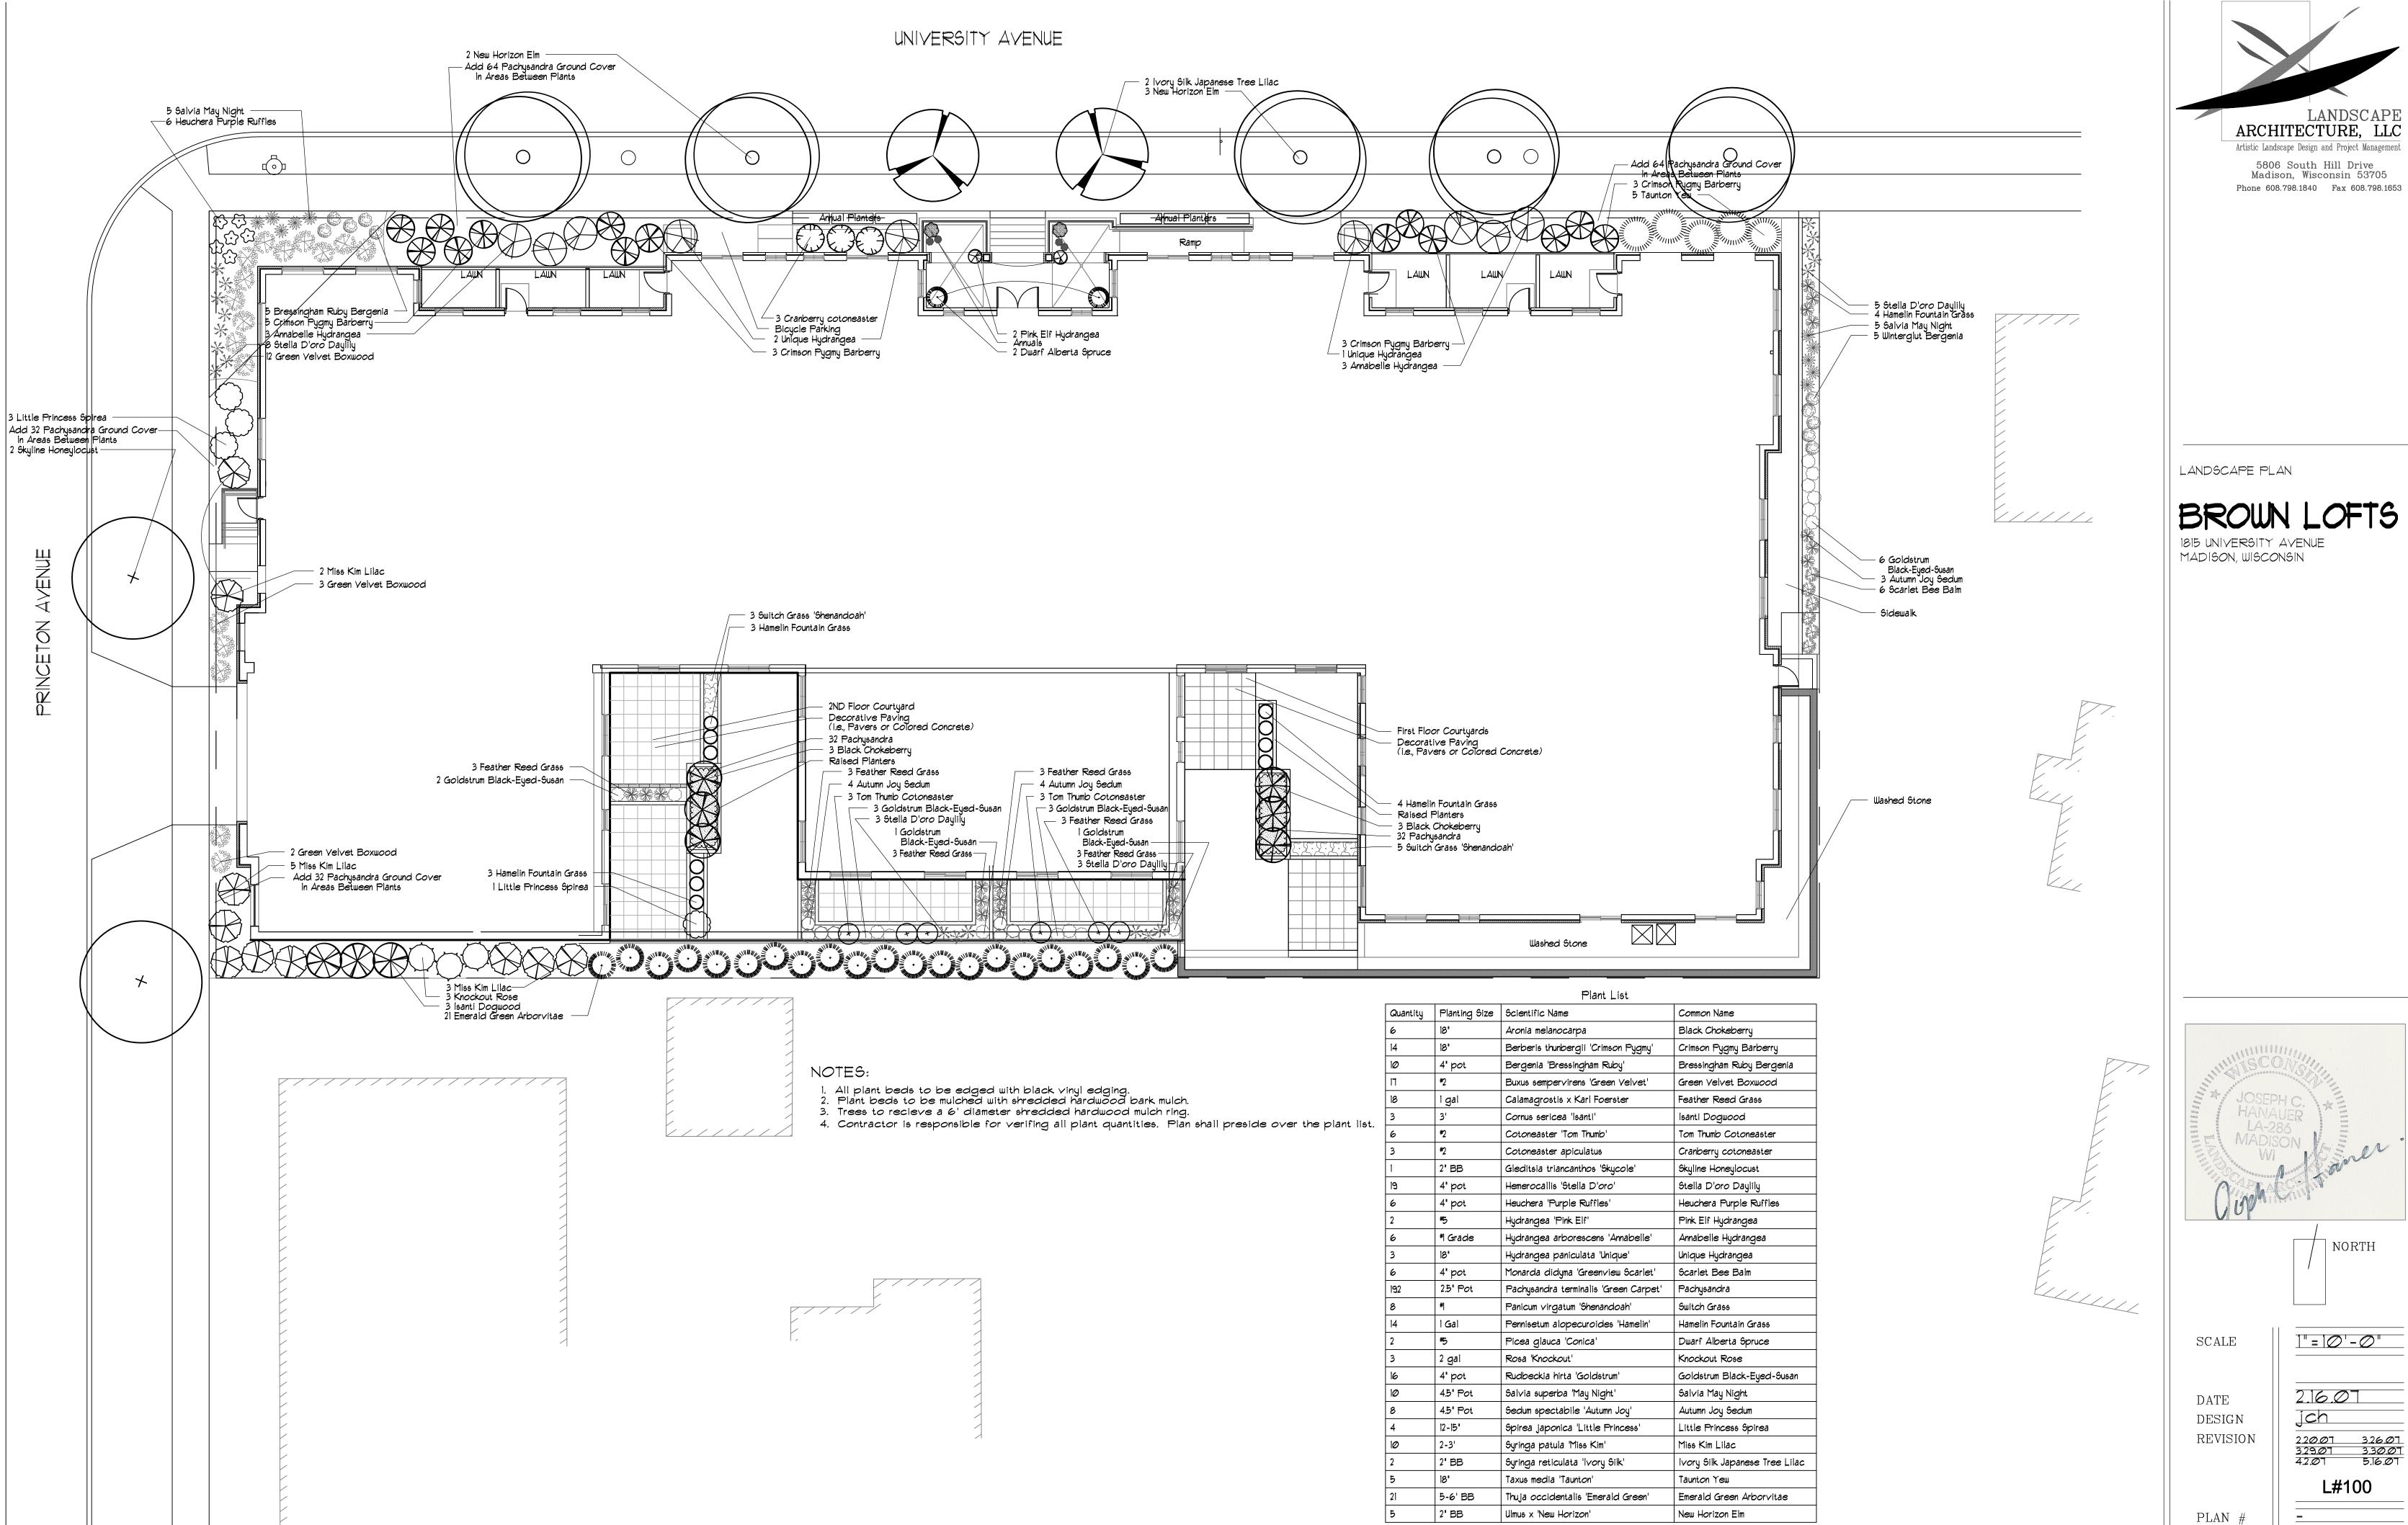

LANDSCAPE ARCHITECTURE, LLC Artistic Landscape Design and Project Management



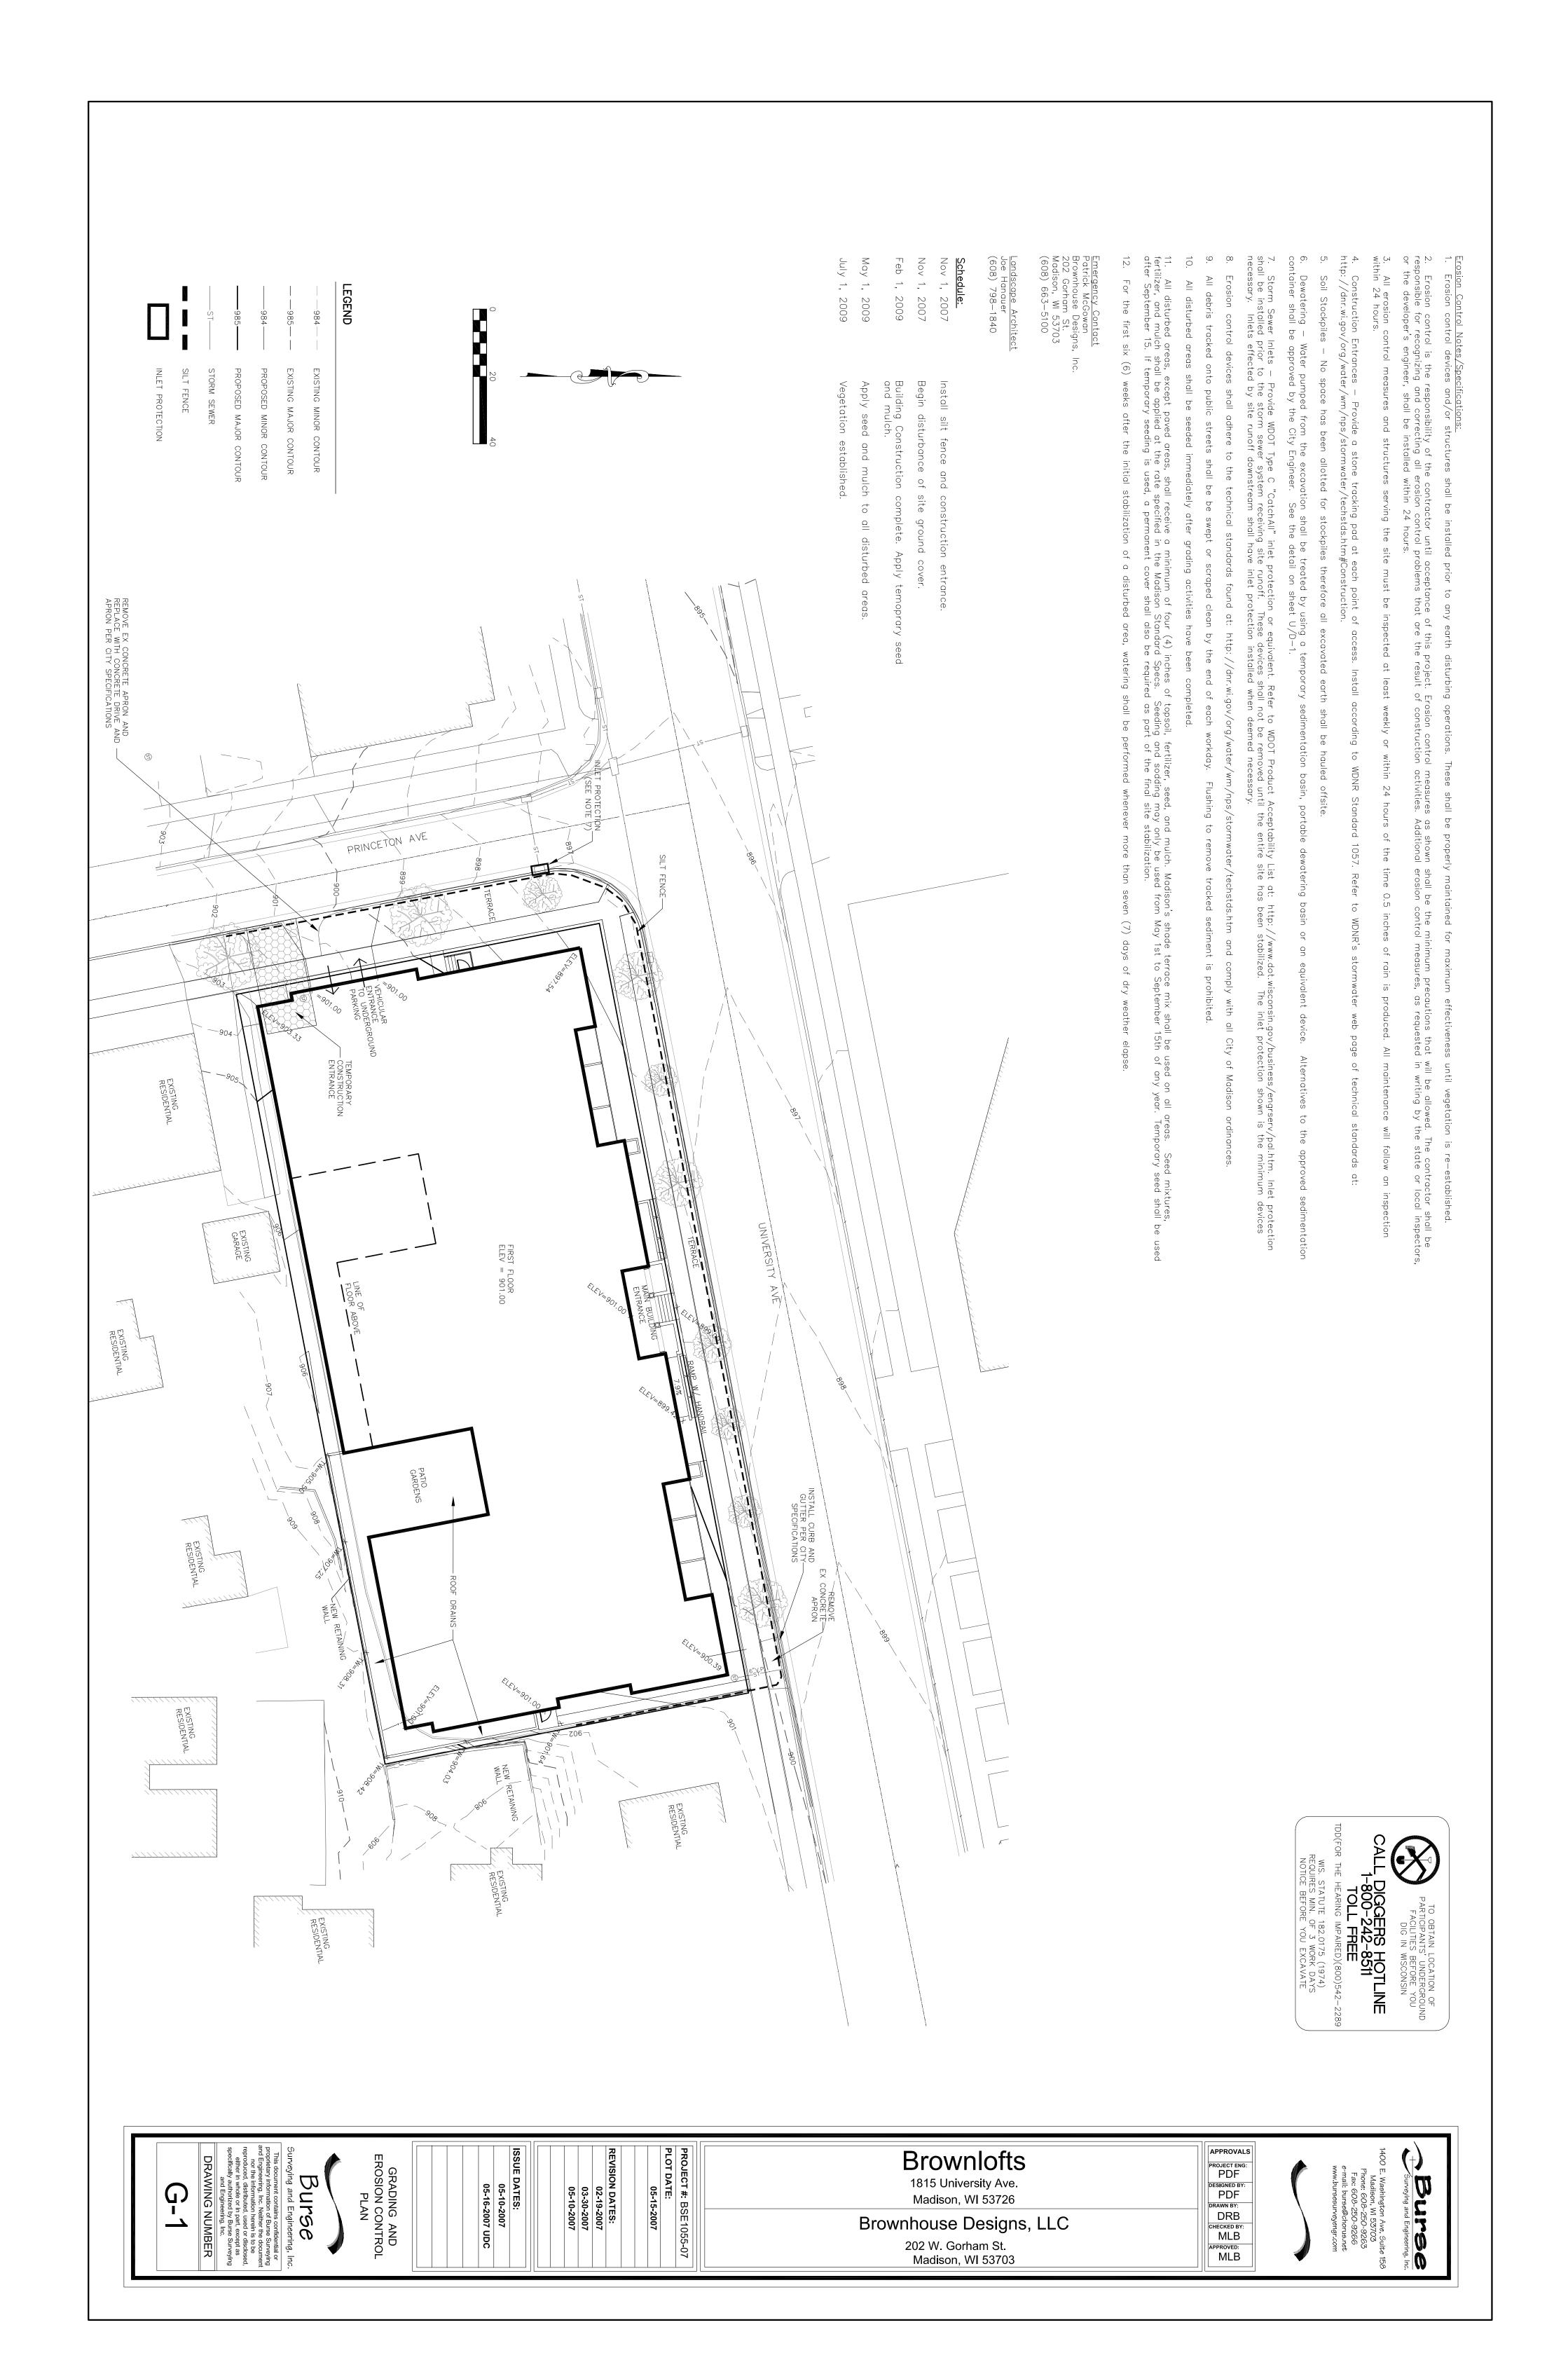

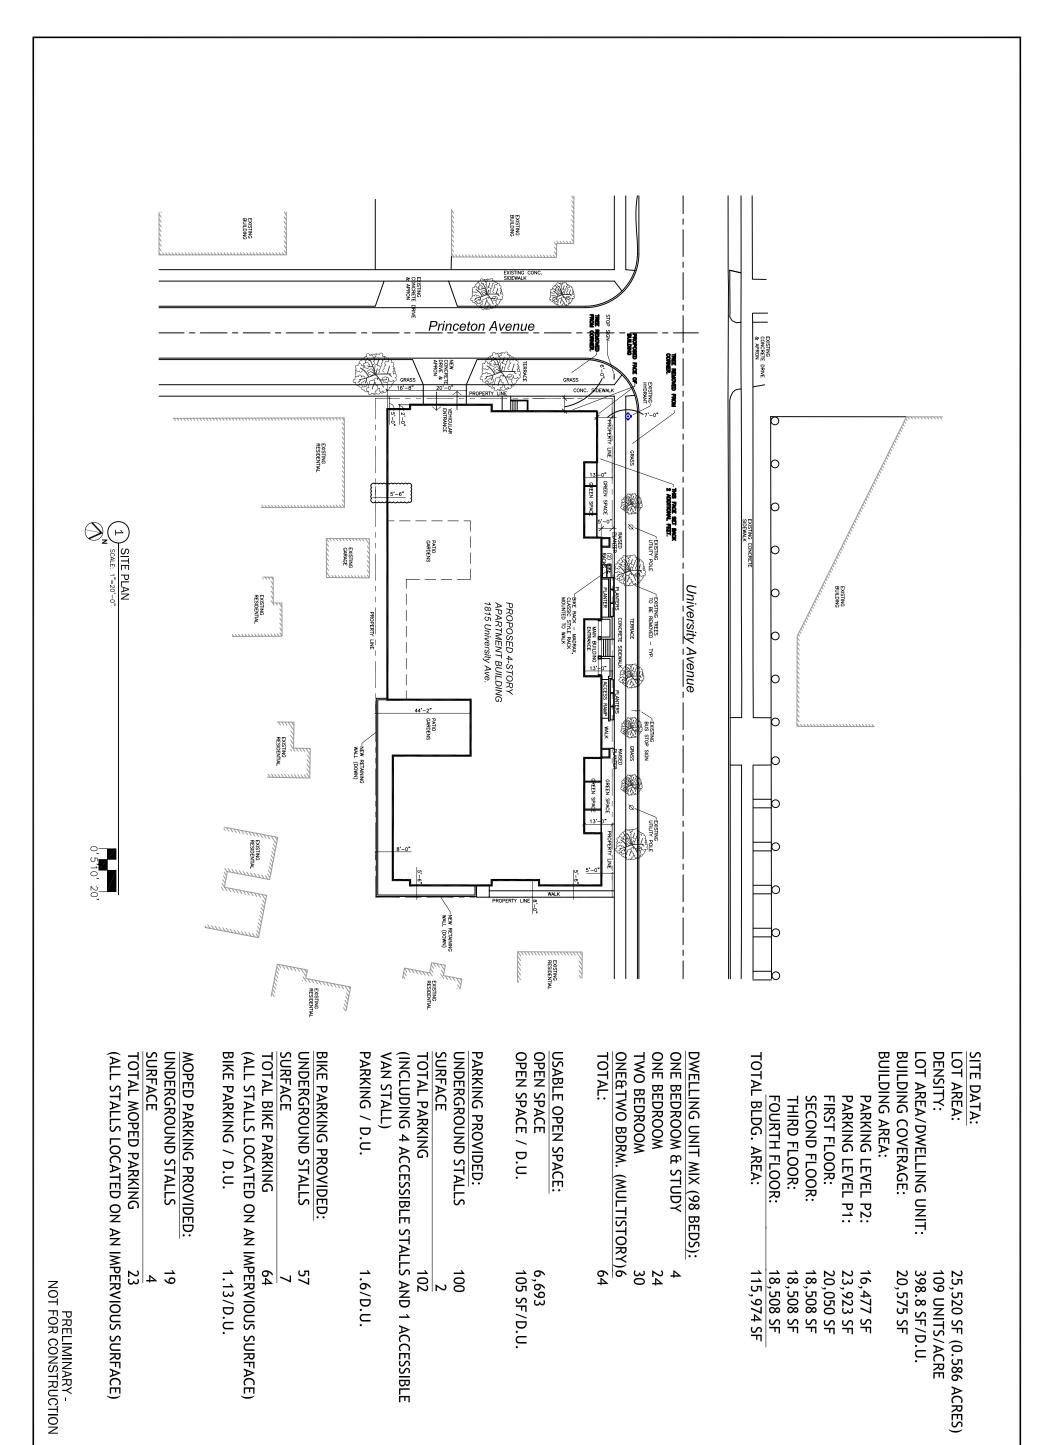

C200

SITE PLAN

BROWN LOFTS
1815 UNIVERSITY AVE.
MADISON, WI 53705



BROWN LOFTS
1815 UNIVERSITY AVE.

DWG STATUS DATE:
PC SUBMITTAL 2/21/07
UDC SUBMITTAL 3/14/07
UDC SUBMITTAL 4/4/07
UDC SUBMITTAL 5/16/07
REVISION/NO. DATE:

- FIRST FLOOR ELEV: 901'-0"

PARKING_LEVEL_1 ELEV: 891'-0"


PRELIMINARY — NOT FOR CONSTRUC


ARCH. LIGHT FIXTURE—TYP.


EAST ELEVATION

SCALE: 1/8"=1'-0"

EXTERIOR ELEVATIONS

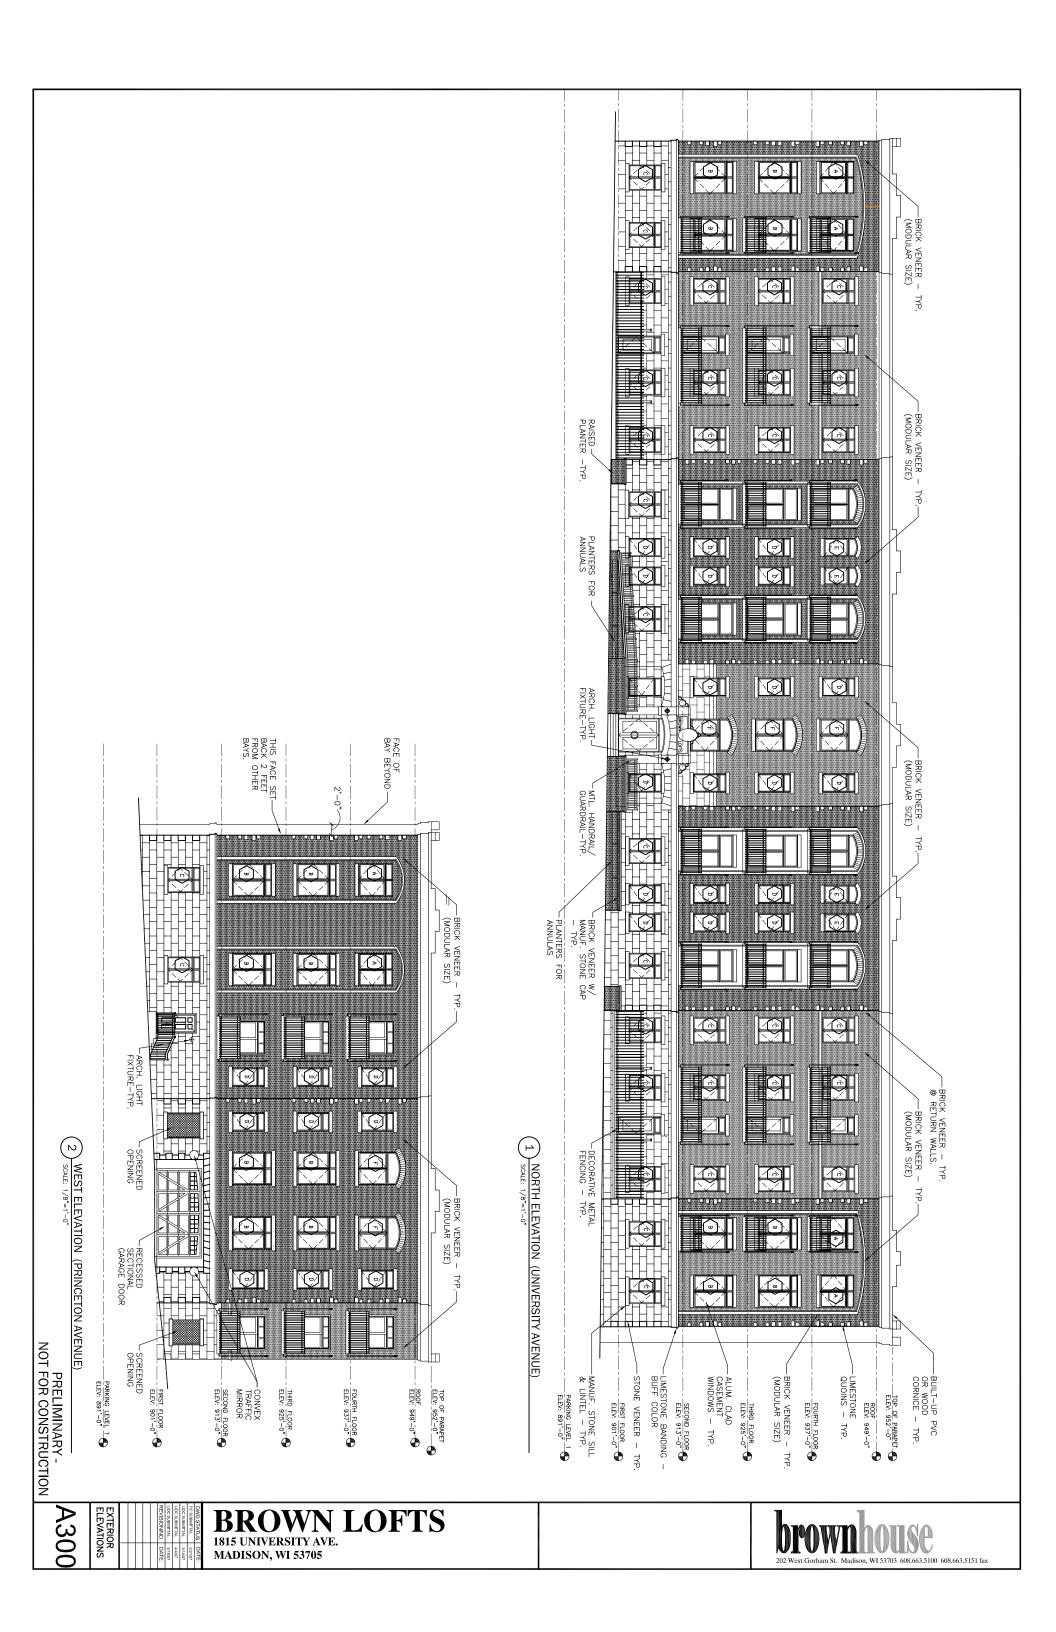


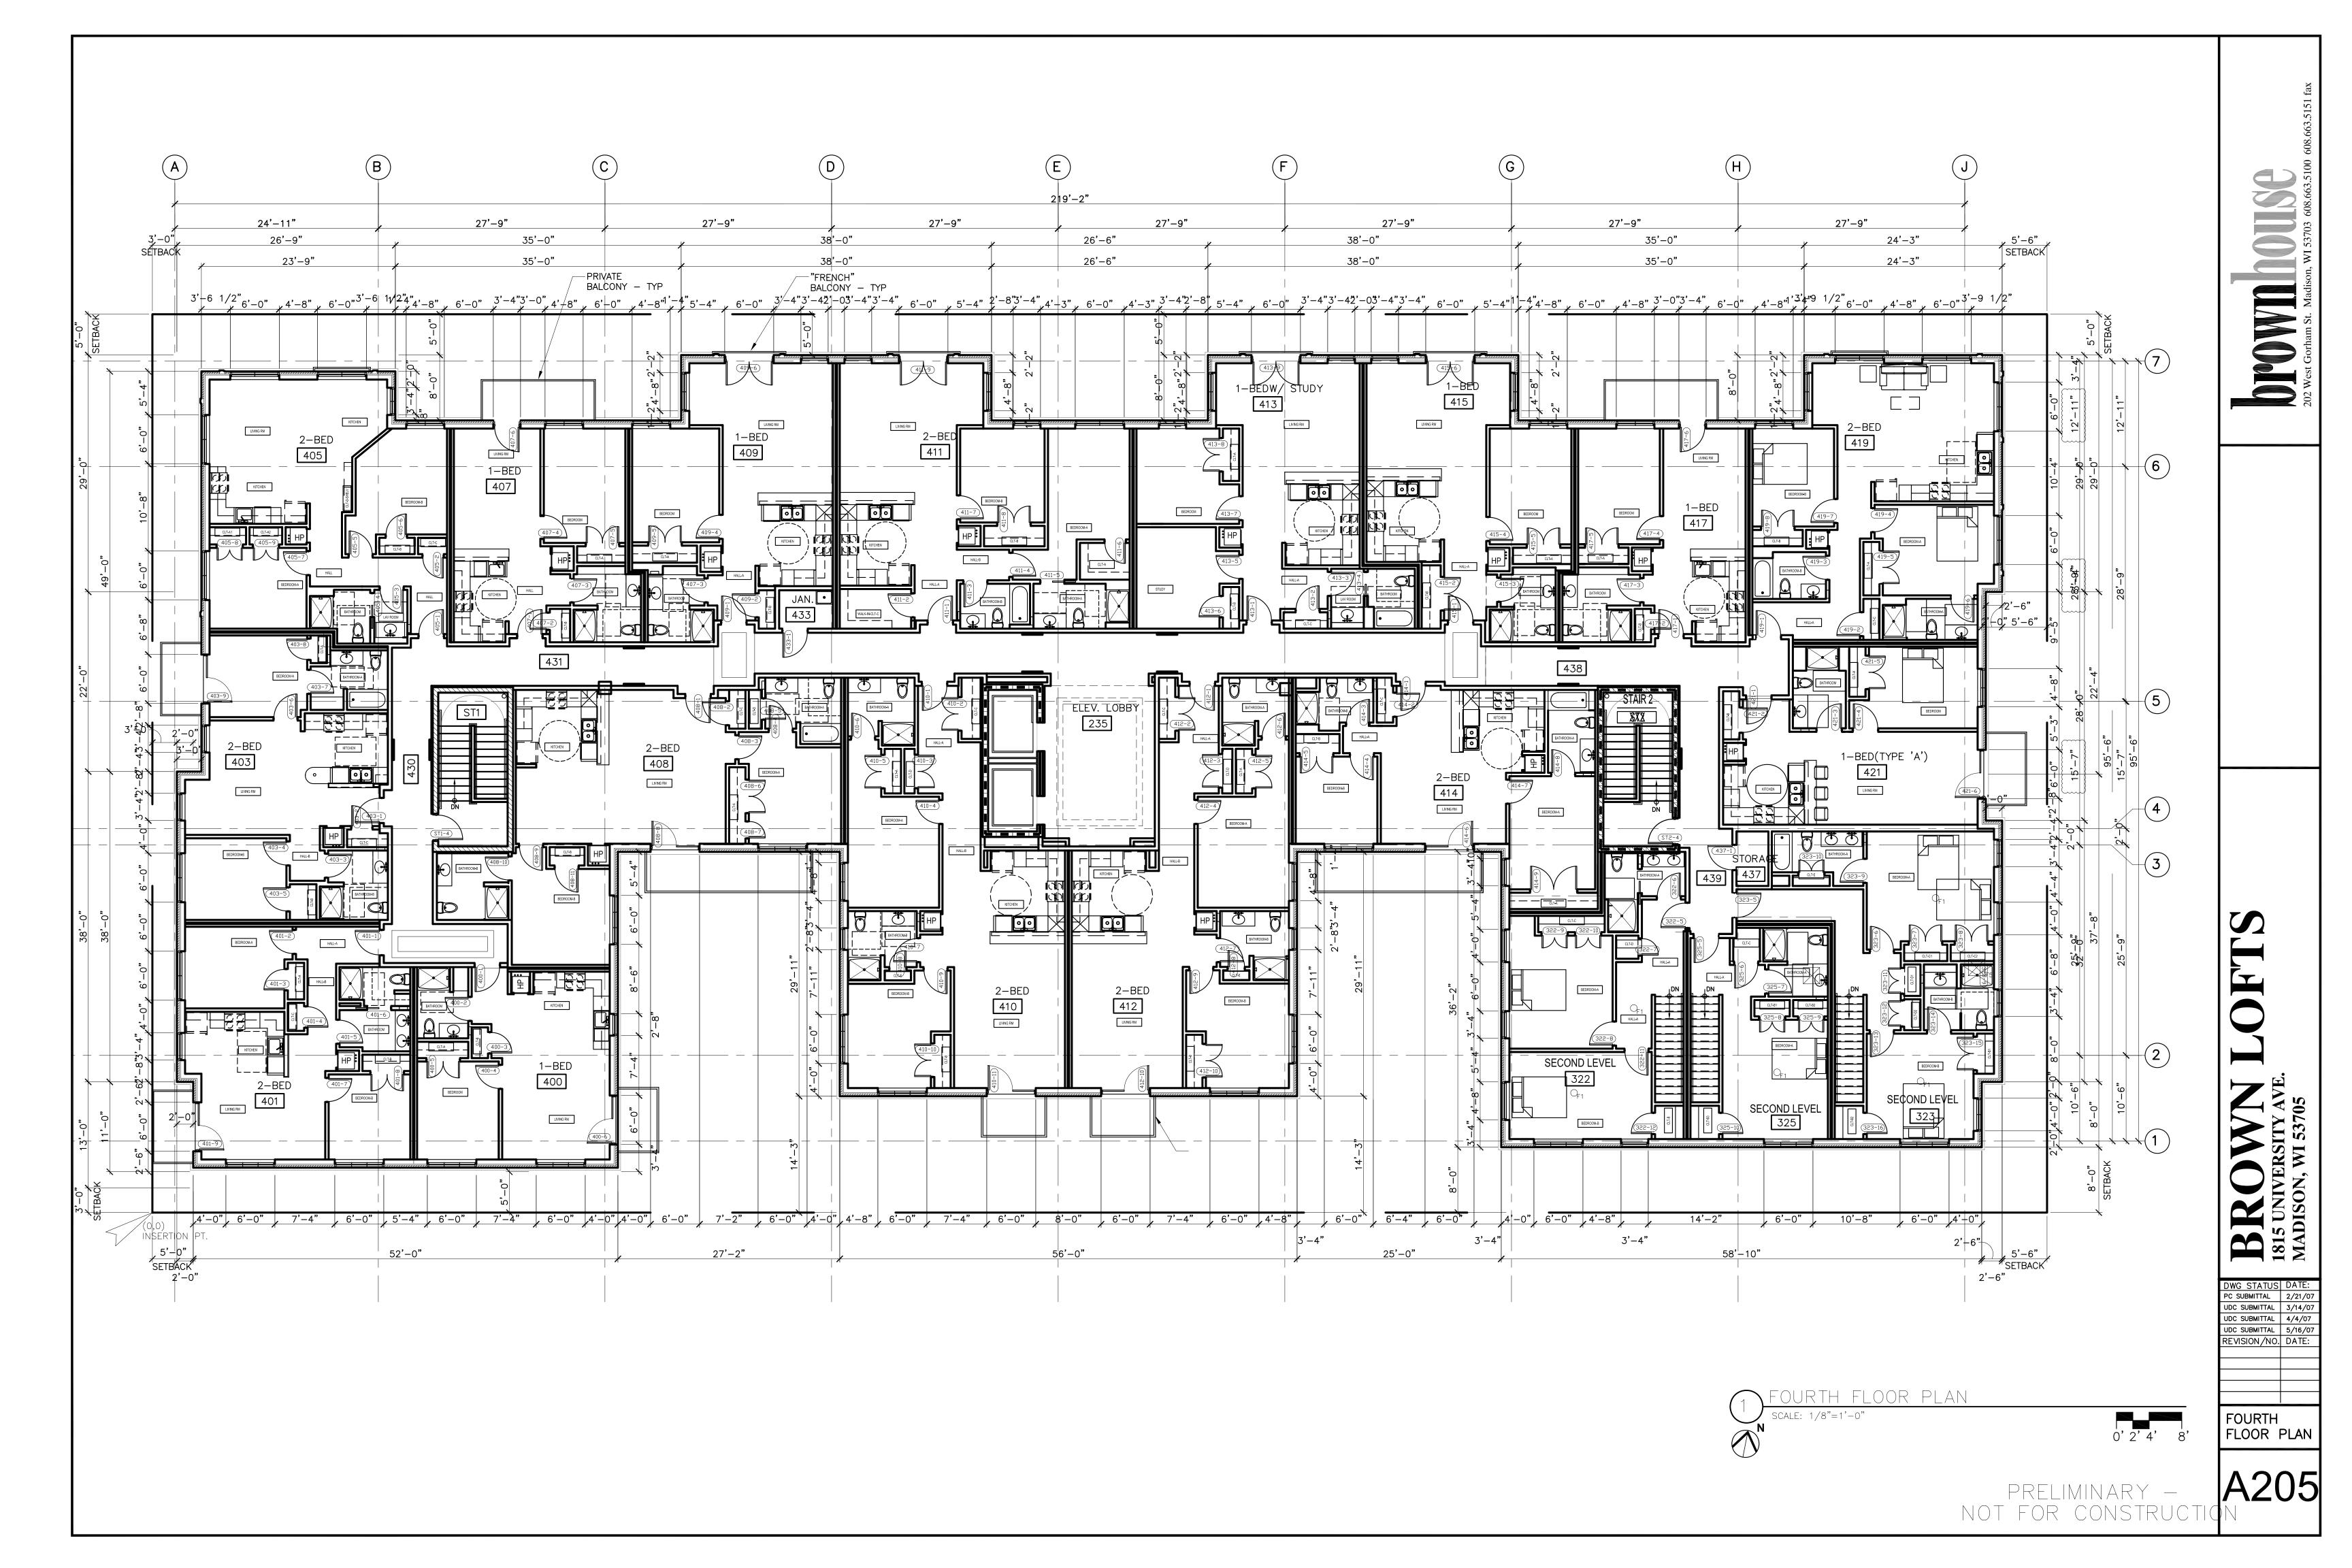

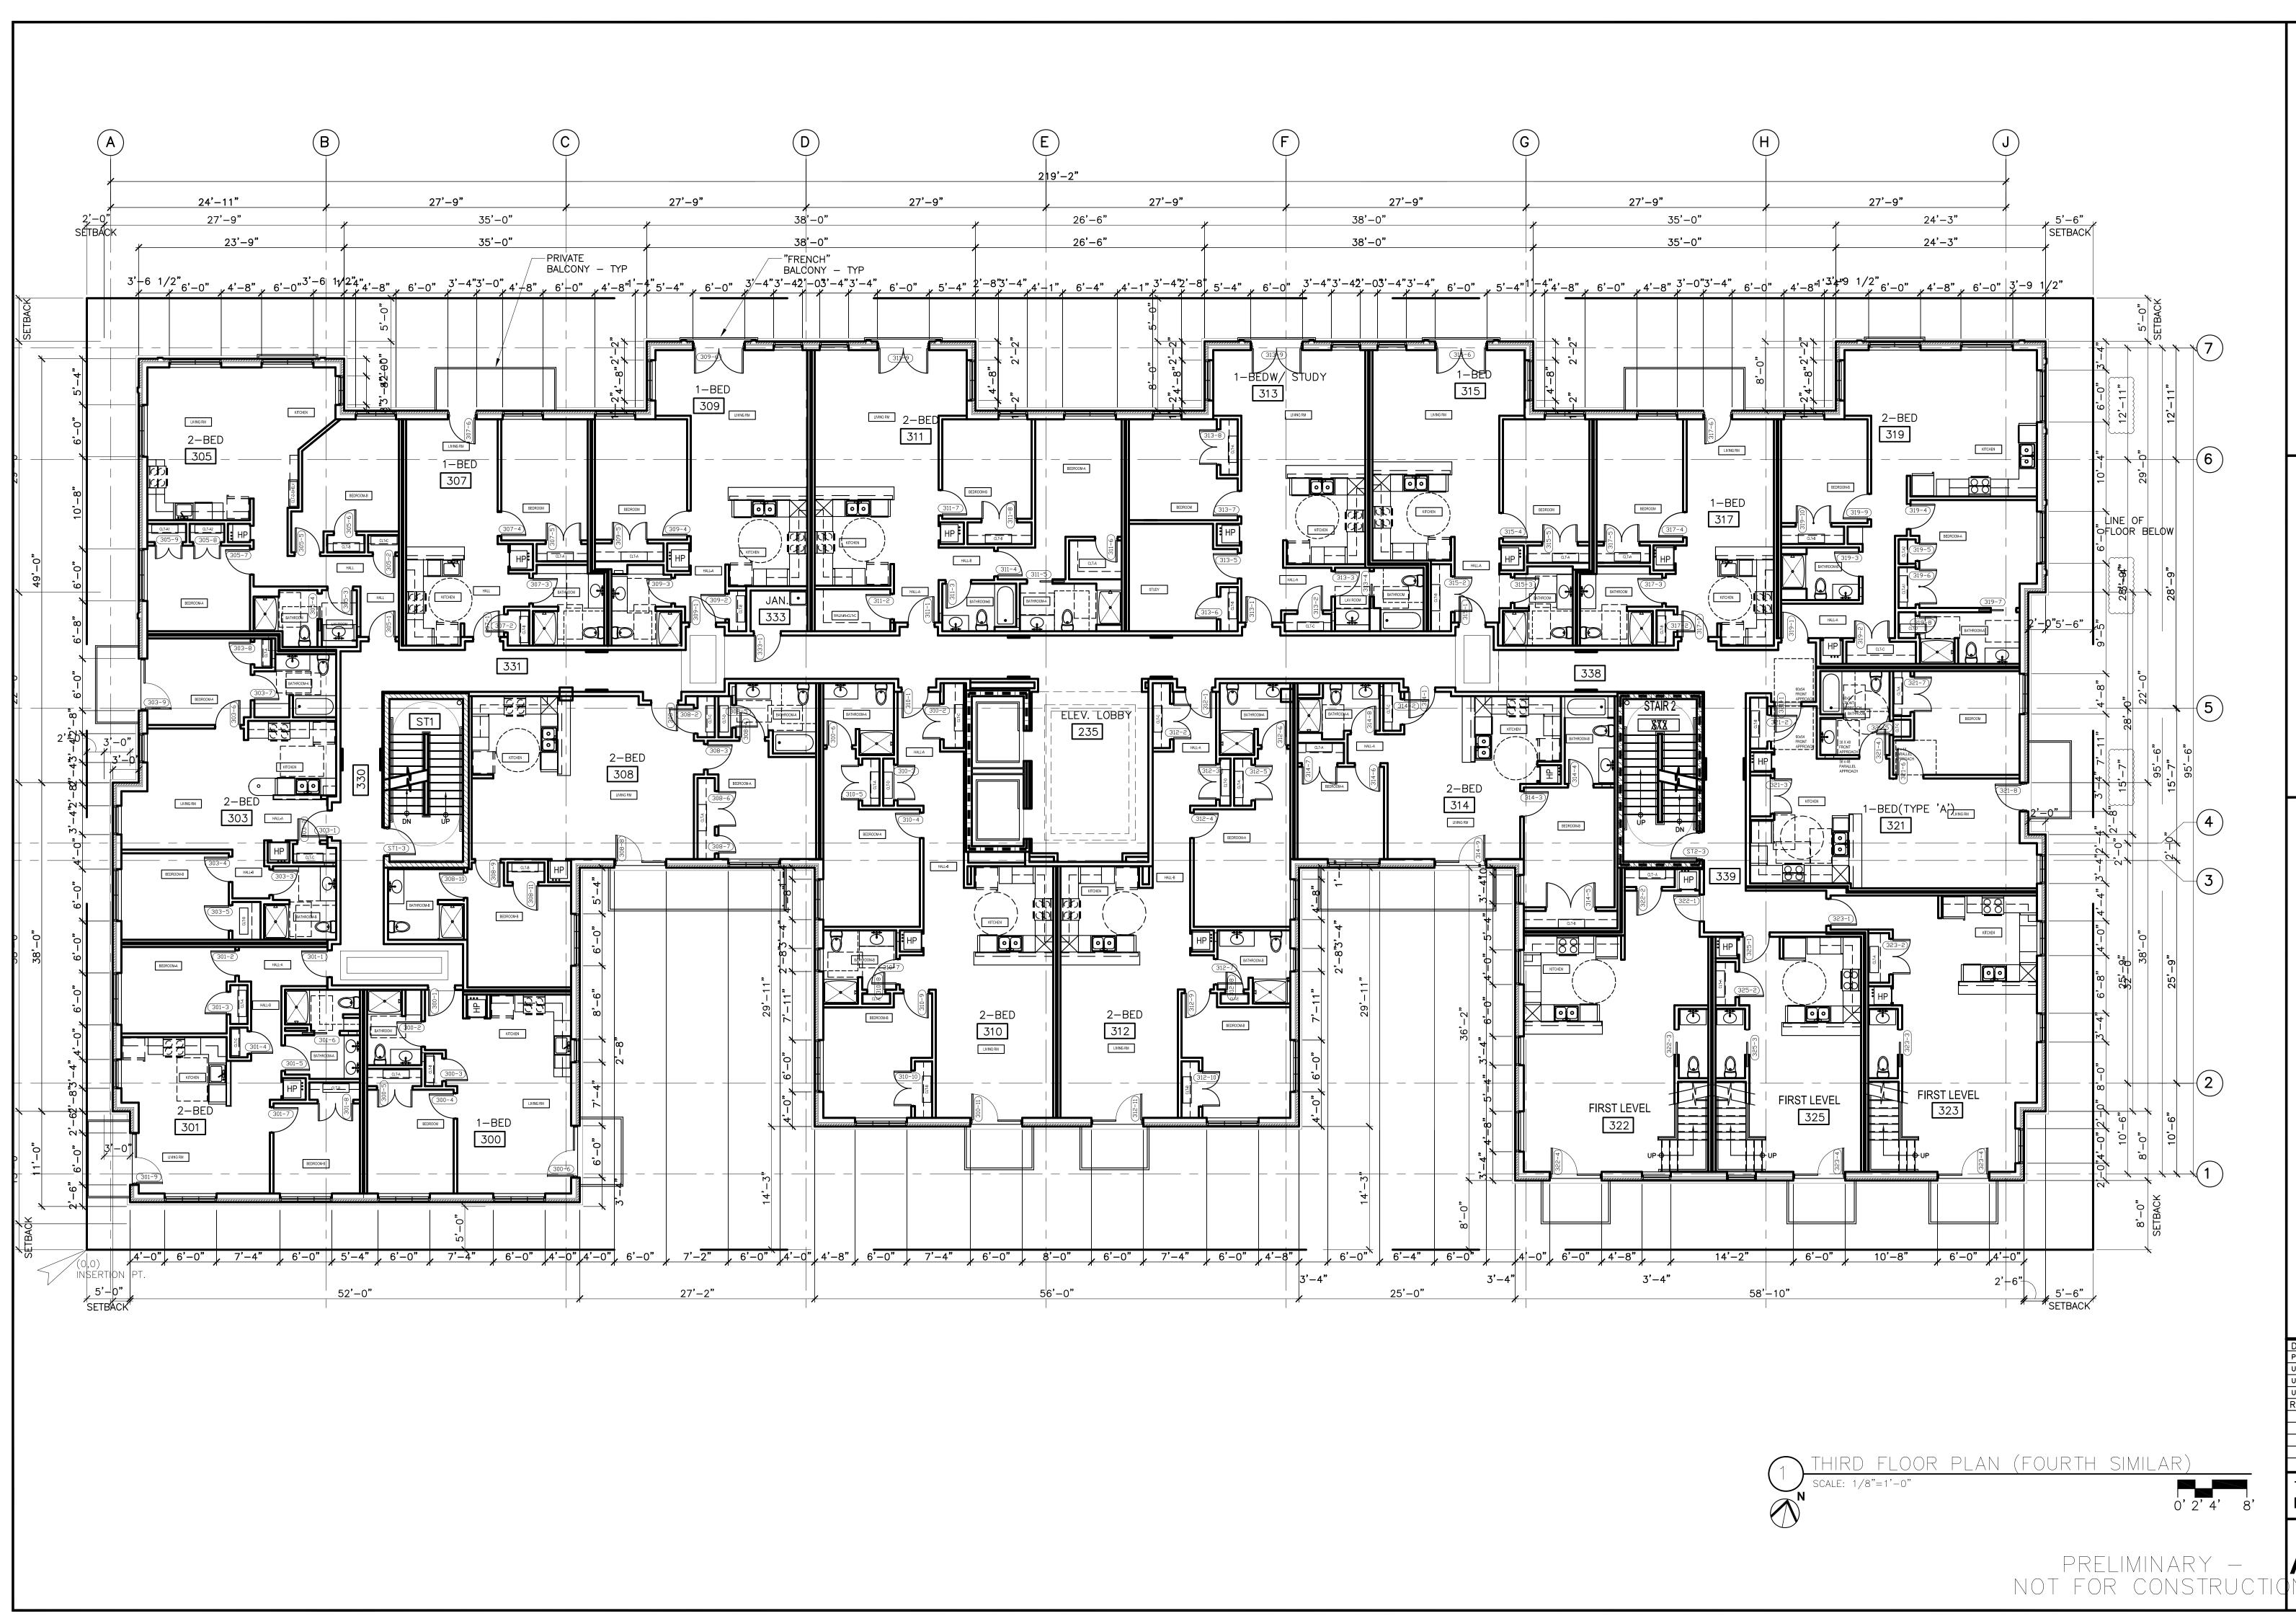

UDC SUBMITTAL 3/14/07 REVISION/NO. DATE:

THIRD FLOOR PLAN

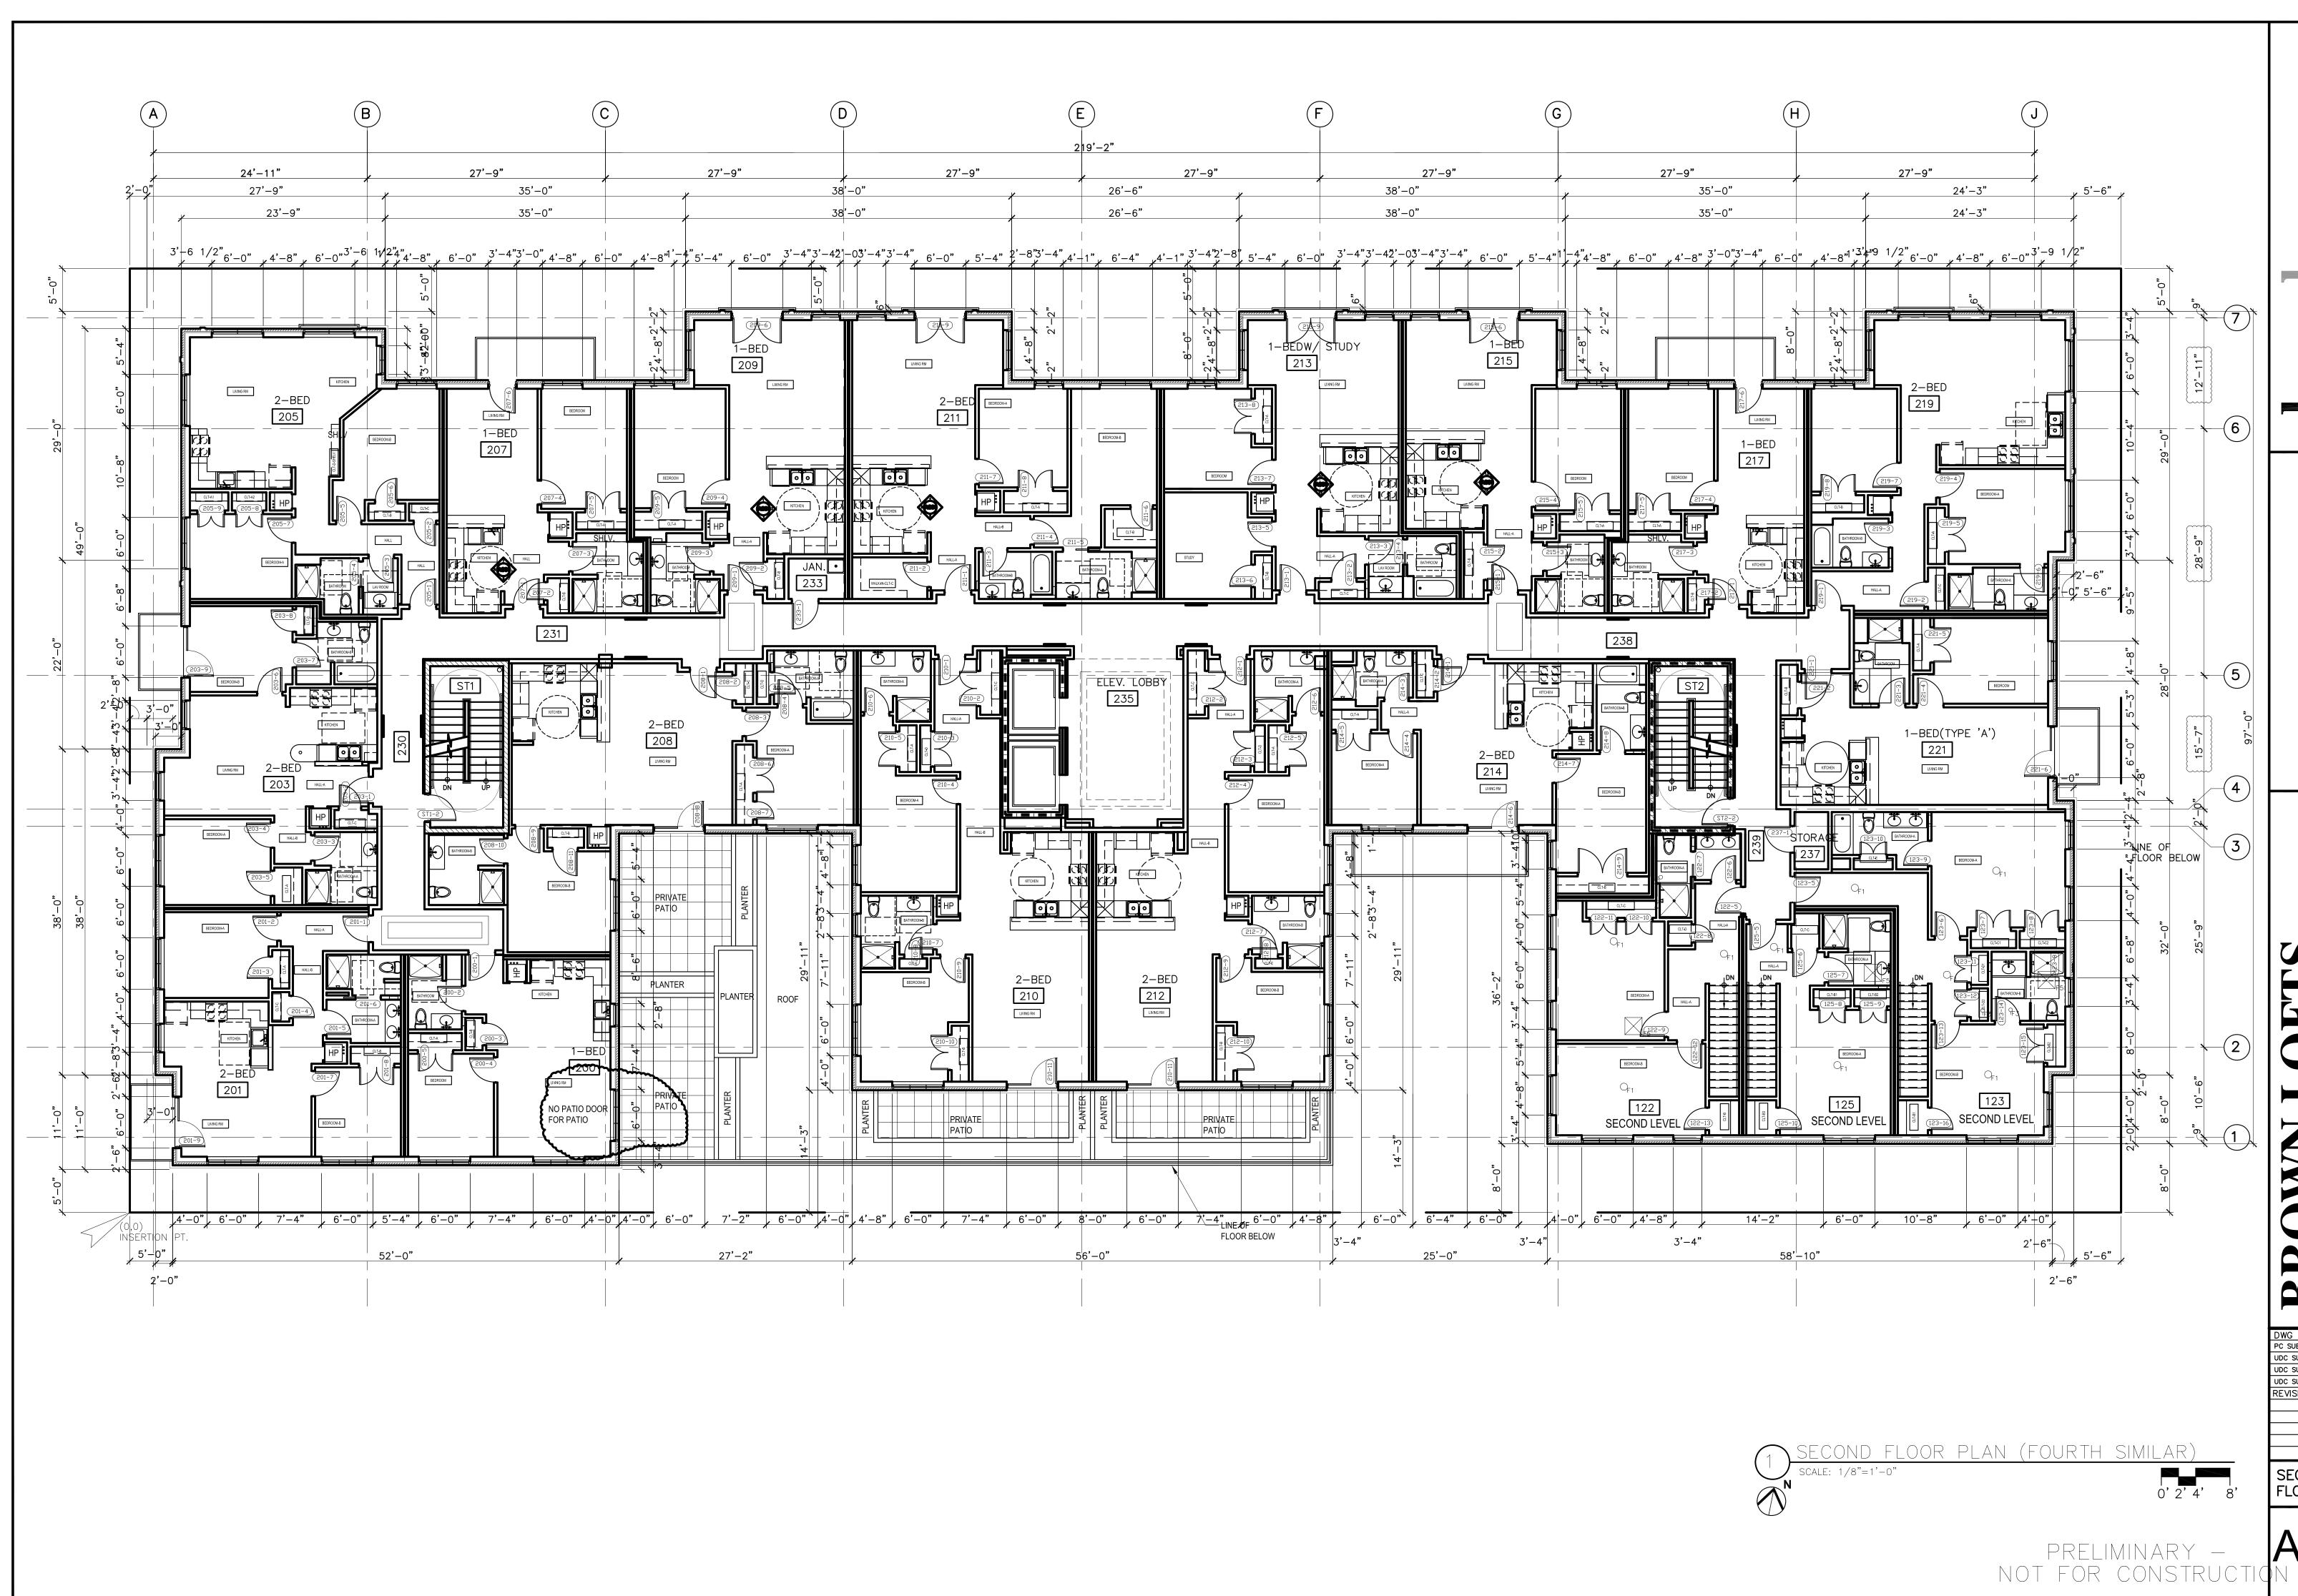



202 West Gorham St. Madison, WI 53703 608.663.5100

BROWN LOFTS
1815 UNIVERSITY AVE.
MADISON WI 53705

DWG STATUS DATE:
PC SUBMITTAL 2/21/07
UDC SUBMITTAL 3/14/07
UDC SUBMITTAL 4/4/07
UDC SUBMITTAL 5/16/07
REVISION/NO. DATE:


SECOND FLOOR PLAN

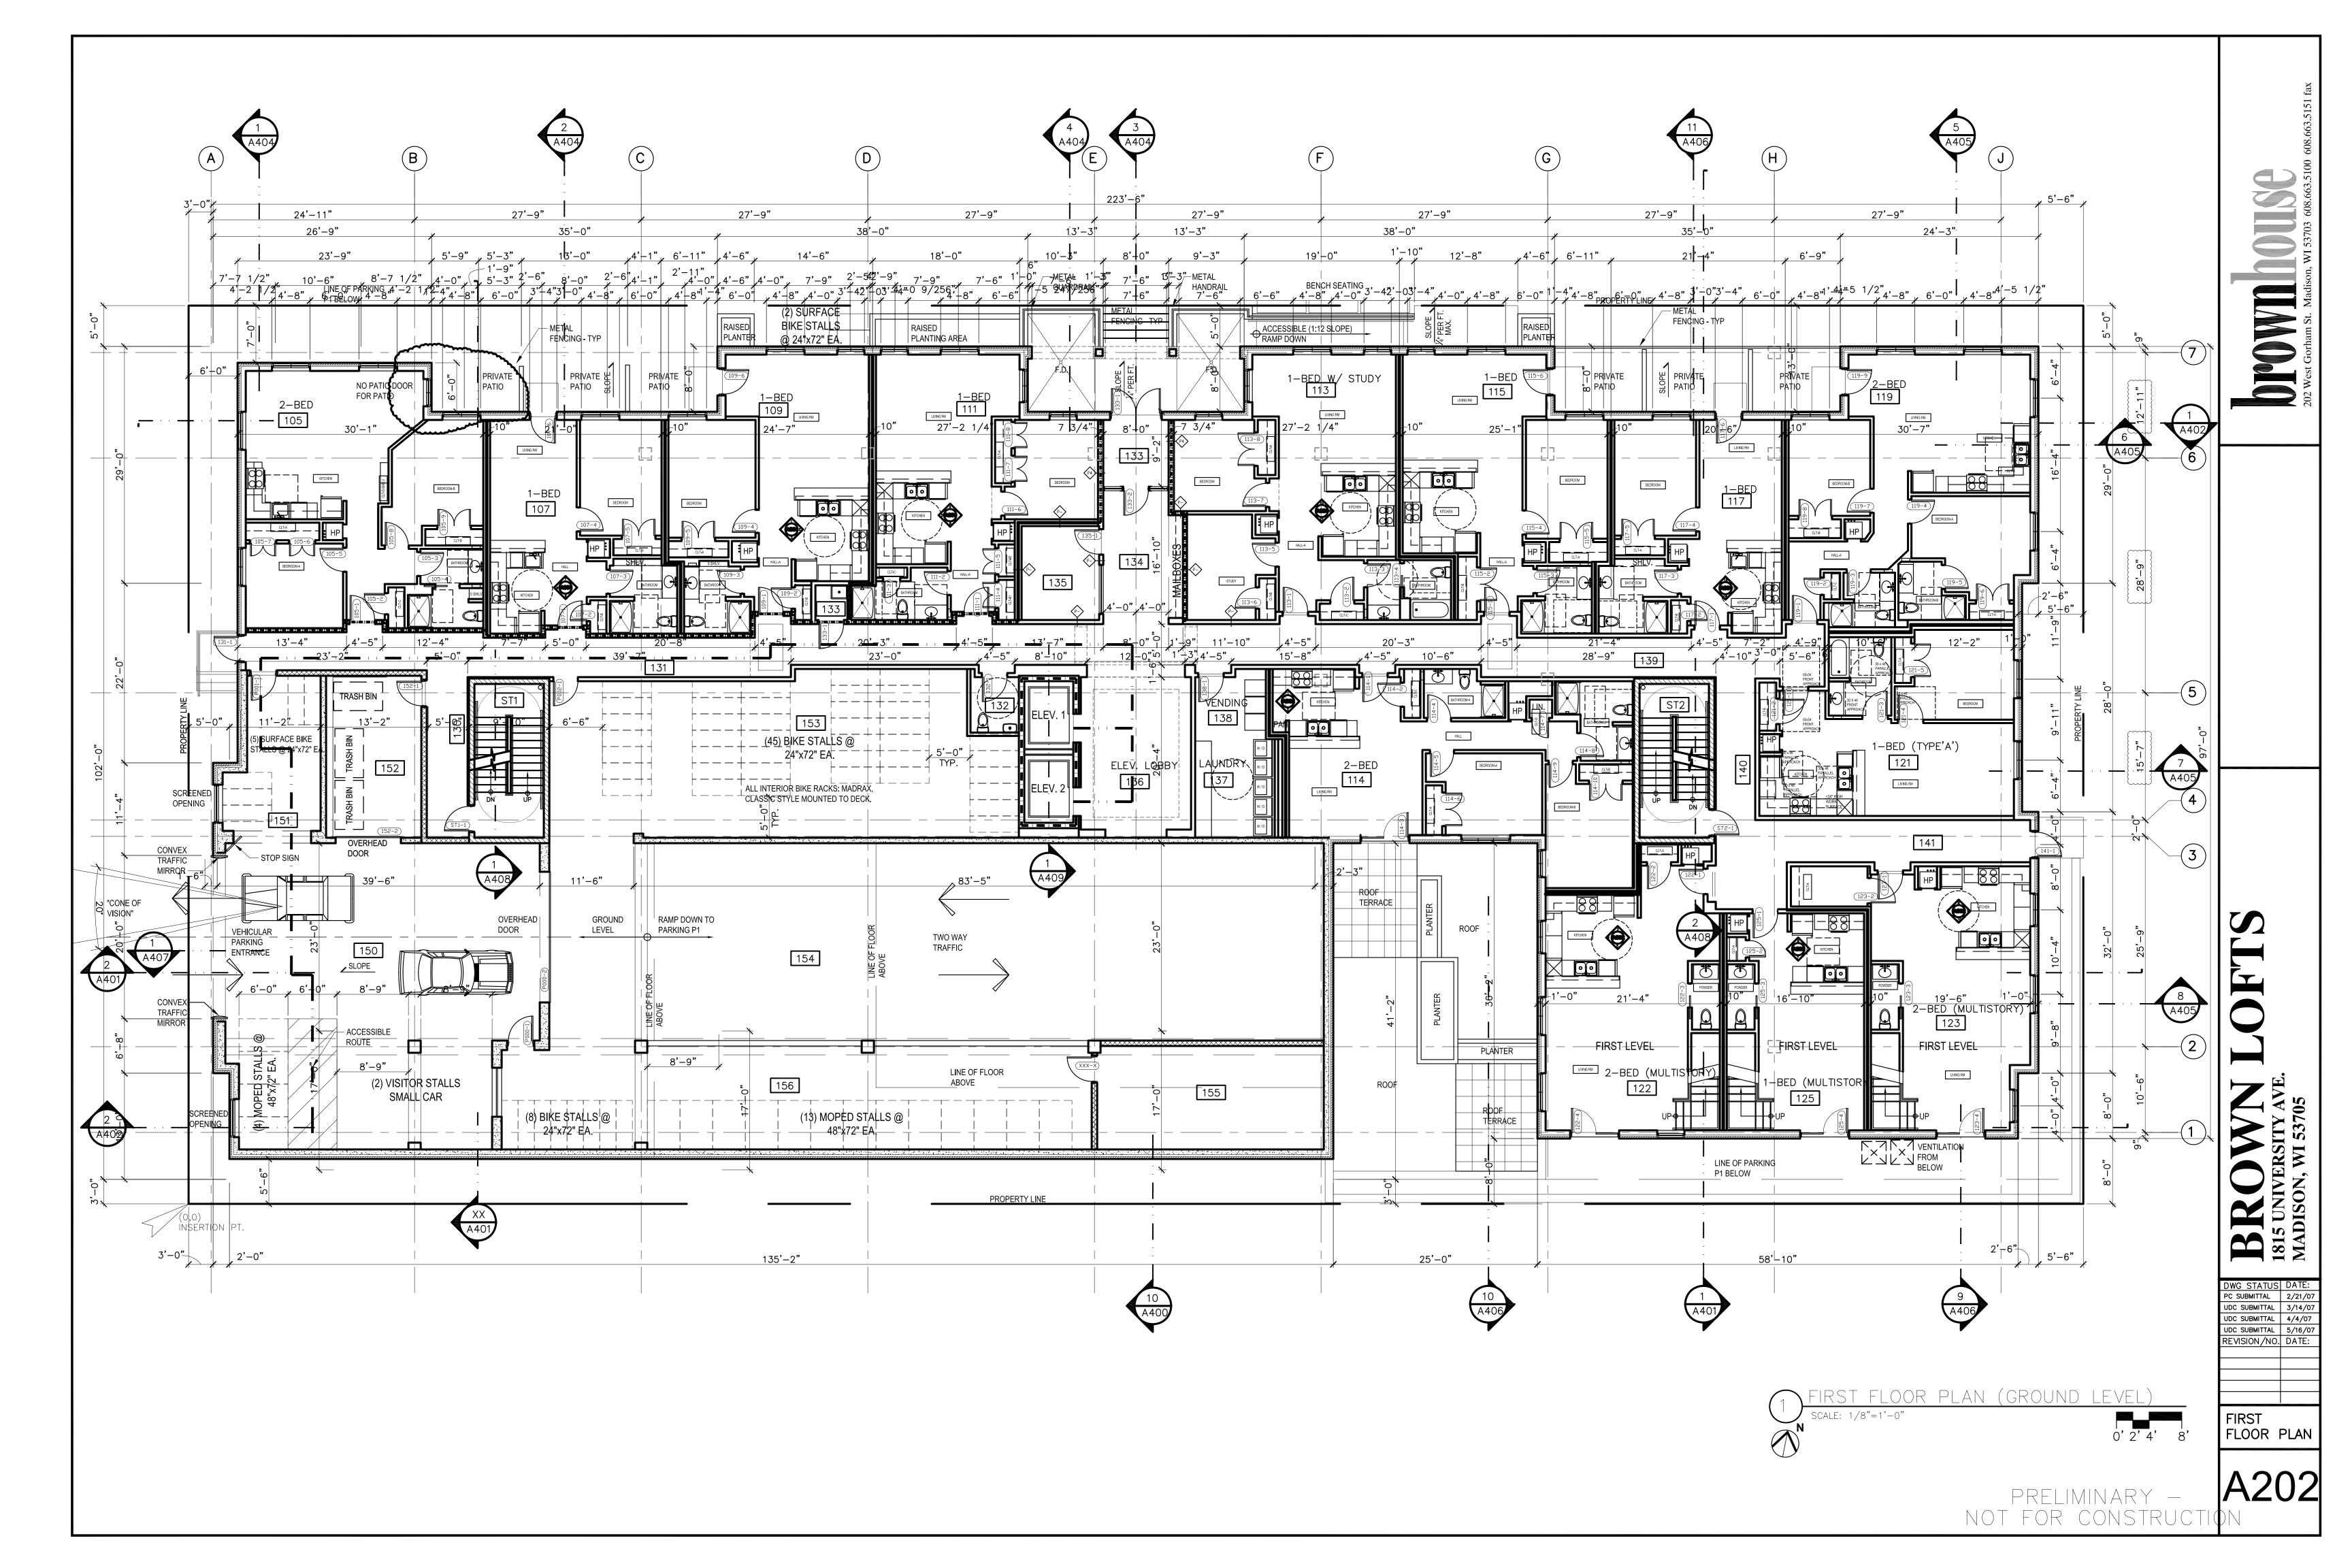

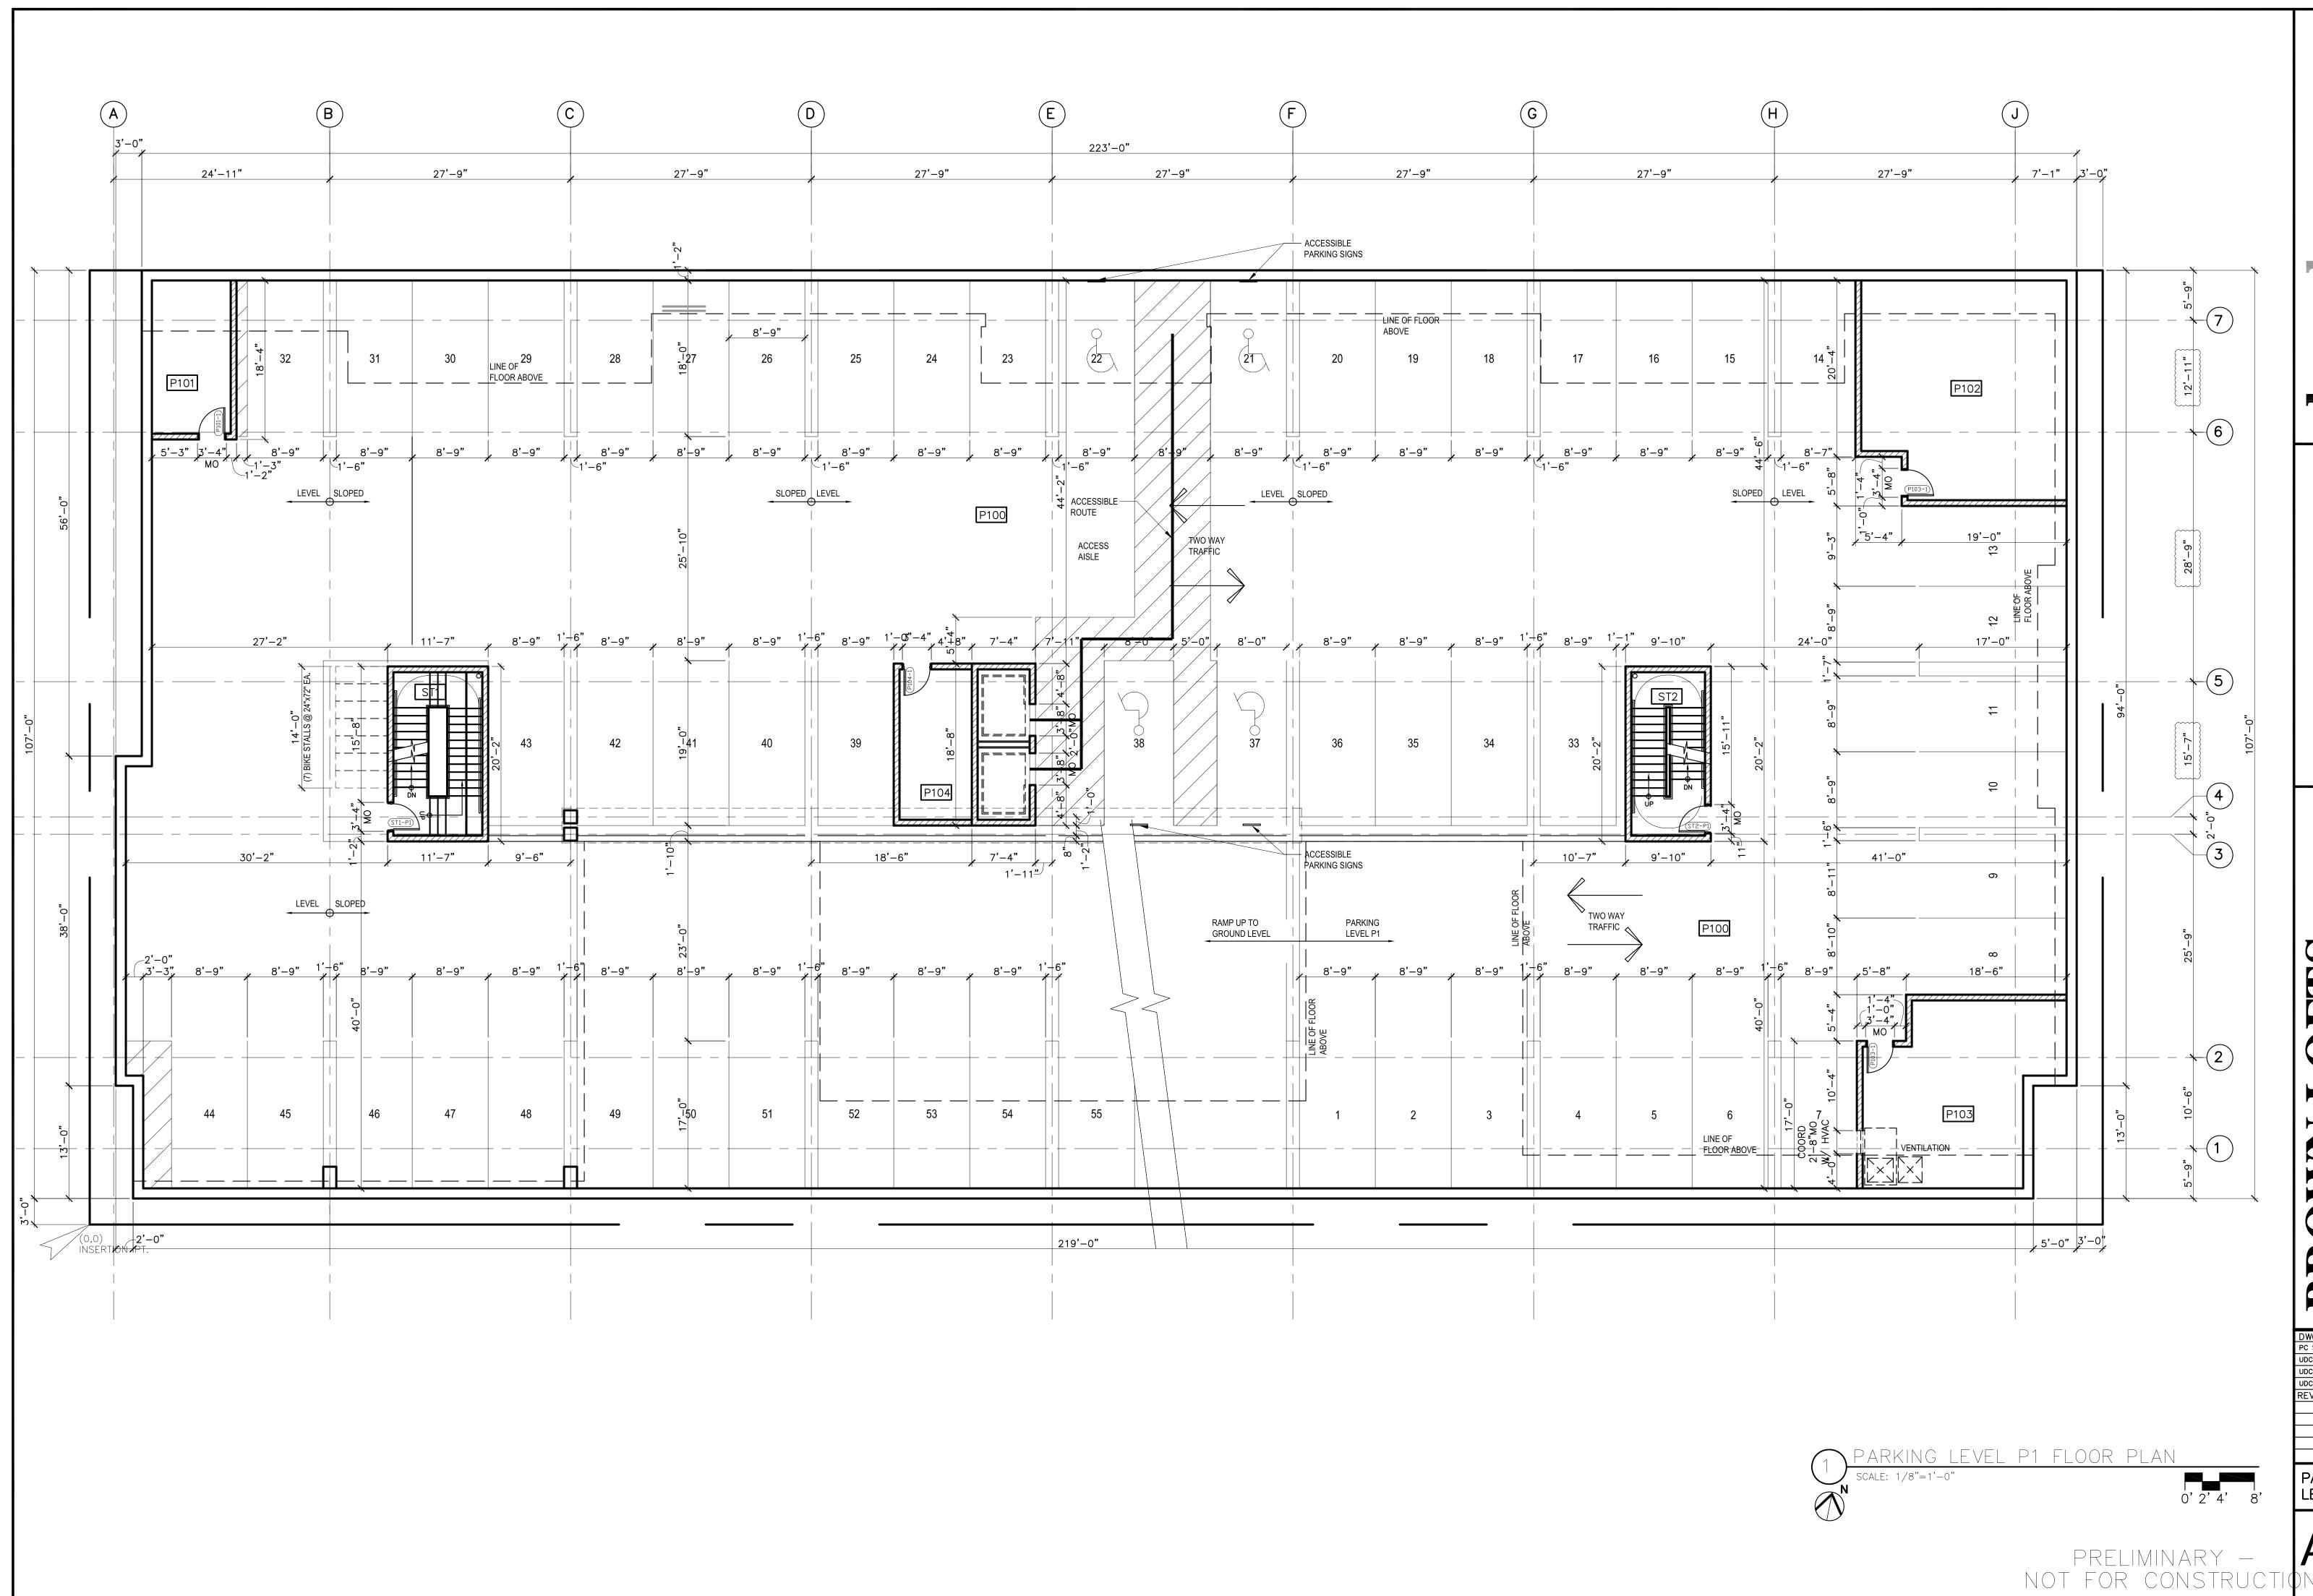

UDC SUBMITTAL 3/14/07 UDC SUBMITTAL 4/4/07 UDC SUBMITTAL 5/16/07
REVISION/NO. DATE:

PARKING LEVEL P1

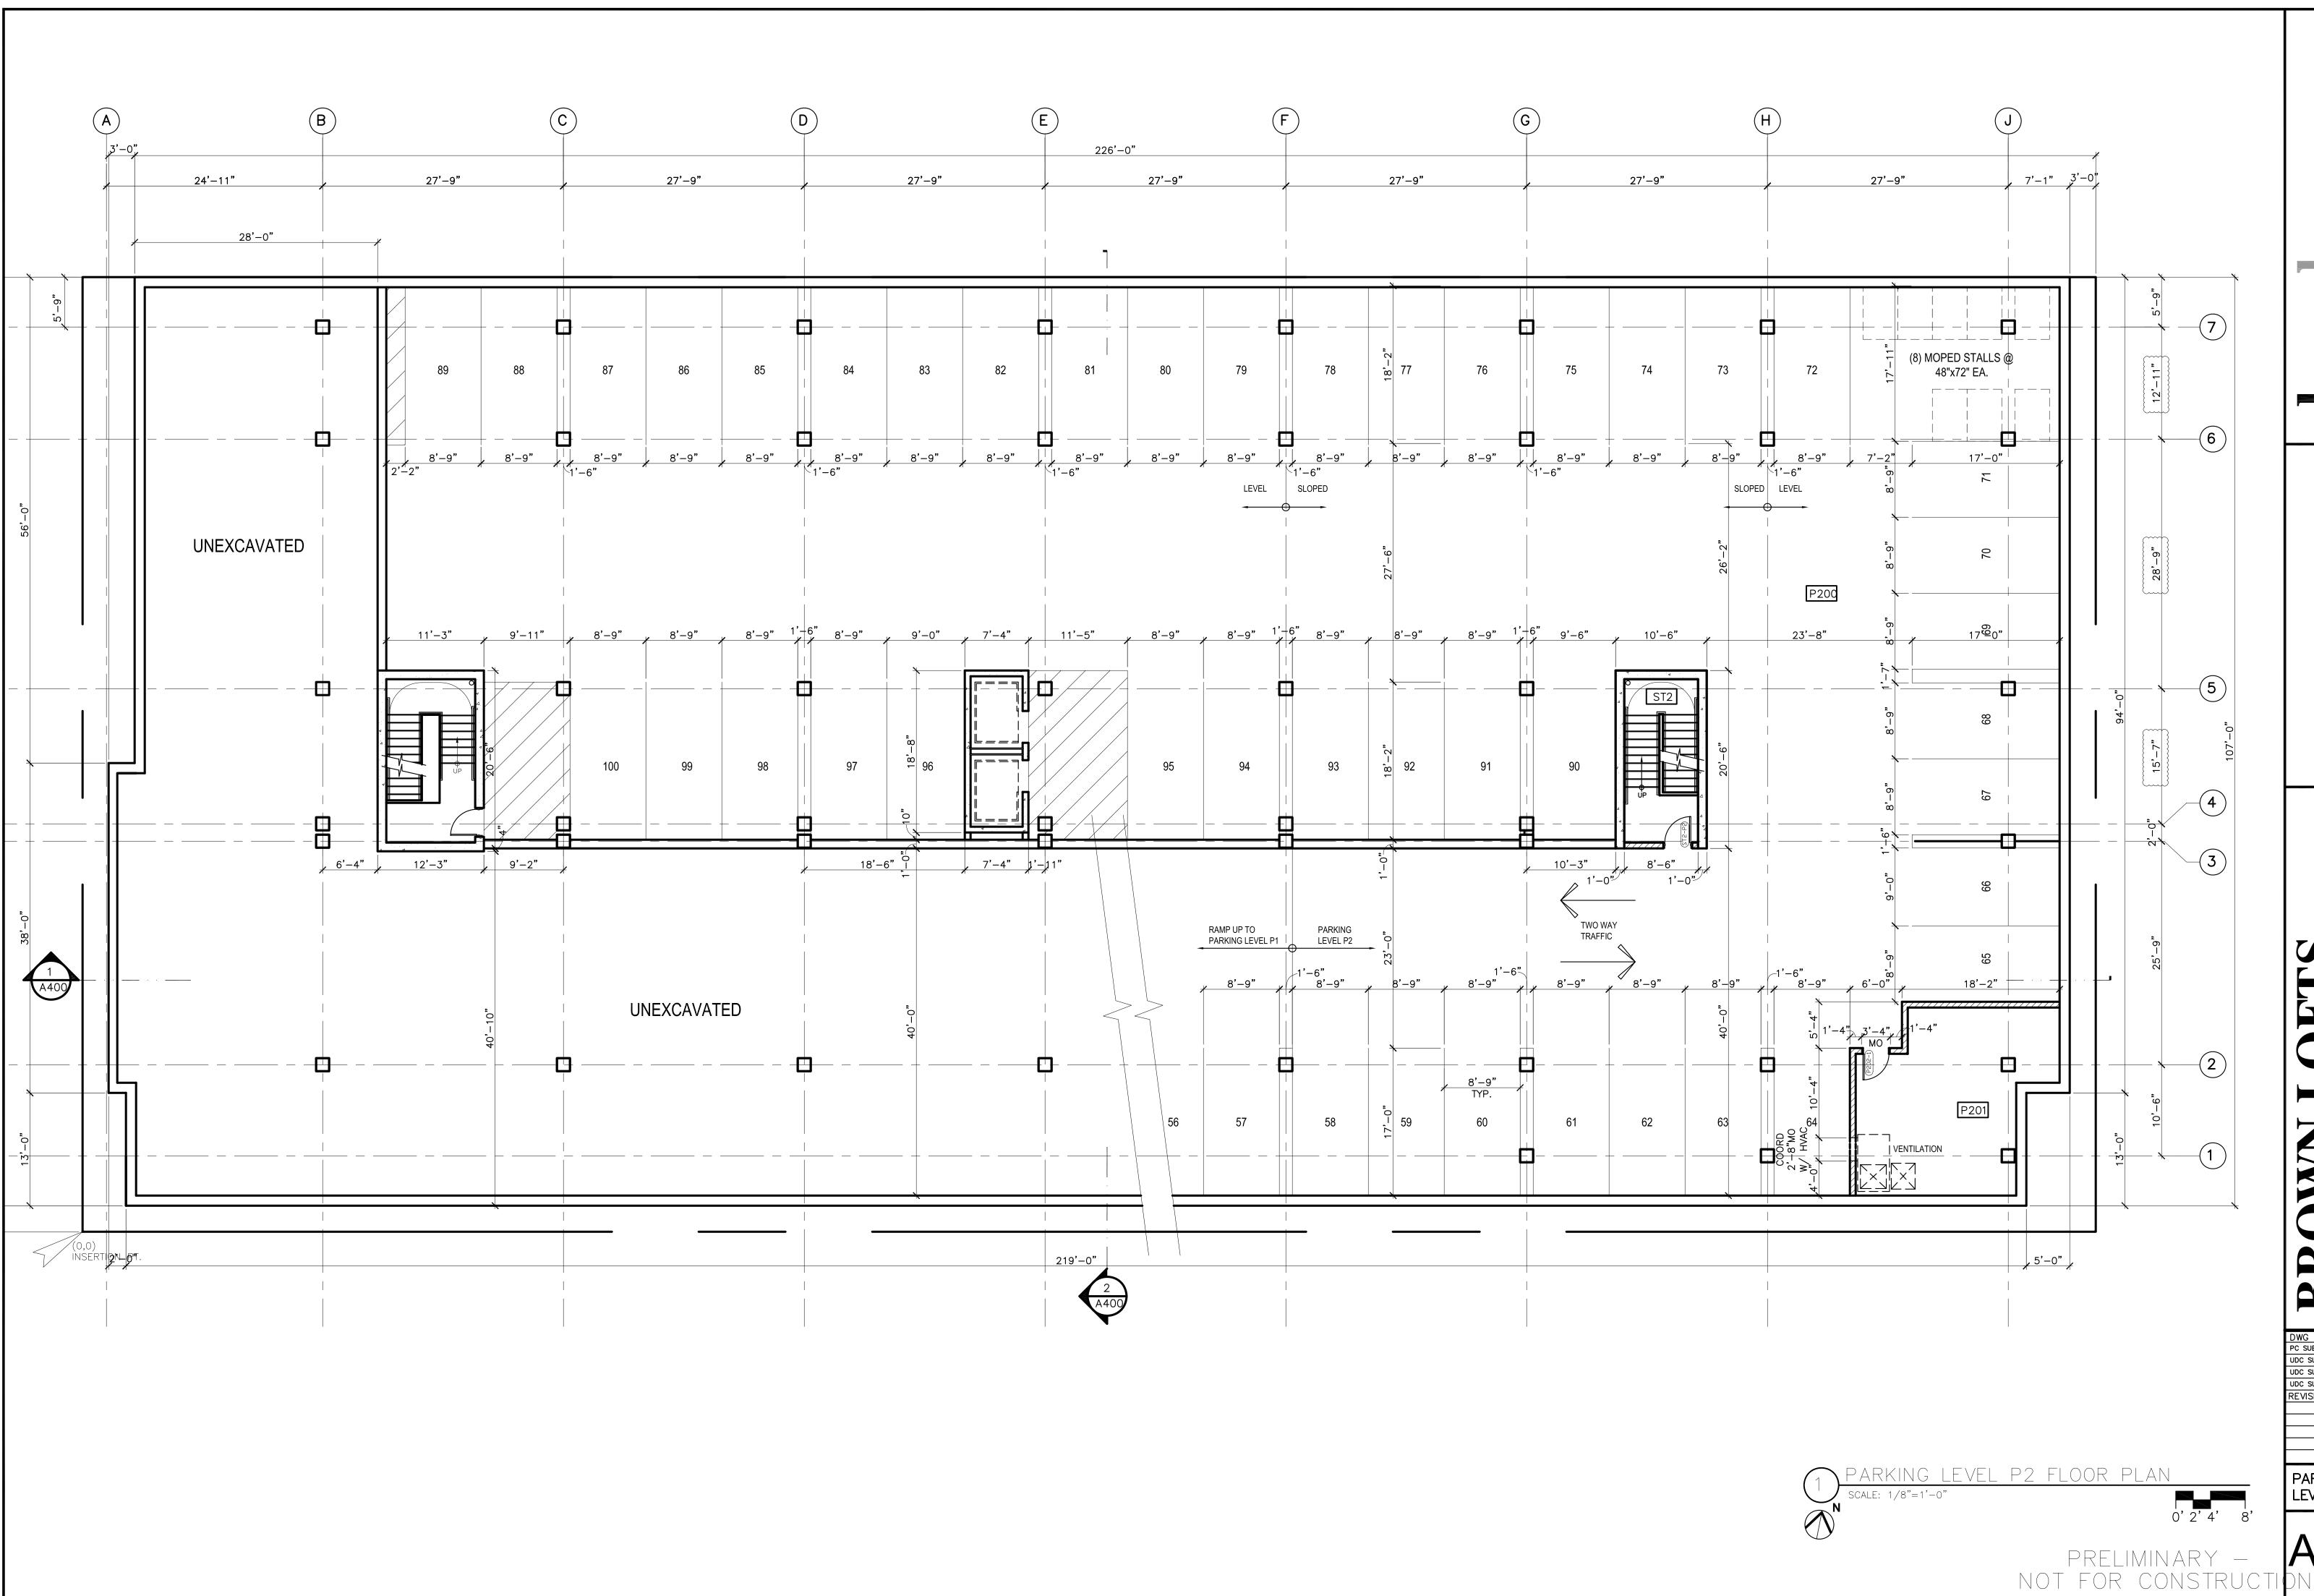

202 West Gorham St. Madison, WI 53703 608.663.5100 608.66

BROWN LOFTS
1815 UNIVERSITY AVE.

DWG STATUS DATE:
PC SUBMITTAL 2/21/07
UDC SUBMITTAL 3/14/07
UDC SUBMITTAL 4/4/07
UDC SUBMITTAL 5/16/07
REVISION/NO. DATE:

PARKING LEVEL P2



Zoning Text Brown Lofts Apartments

Steve Brown Apartments, Owner 1815 University Avenue Madison, WI 53705

March 4, 2008

Legal Description:

The lands subject to this Planned Unit Development District shall include those described below:

All of Lots 3, 4, 5 and 6, Block 3, University Heights, as recorded in Volume 1 of Plats, on Page 17, as document number 197136, Dane County Registry, located in the Northeast Quarter of the Northwest Quarter of Section 22, Township 07 North, Range 09 East, City of Madison, Dane County, Wisconsin.

Containing 25,520 sq. ft. = 0.586 acres.

A. Statement of Purpose:

This PUD (GDP/SIP) zoning district is being established to allow for the construction of a 64-unit multifamily housing project consistent with the density, style and massing of the adjacent residential neighborhood. The current zoning of the site is HIS-UH OR.

B. Permitted Uses:

- 1. Those that are stated as permitted uses in the proposed PUD district.
- 2. Uses accessory to permitted uses in the proposed PUD district.

C. Lot Area:

25,520 square feet = 0.586 acres

D. Floor Area Ratio:

- 1. Maximum Floor Area Ratio permitted is 3.2.
- 2. Maximum building height shall be 4 stories (Proposed height: 56 feet top of parapet)

E. Yard Requirements:

Yard areas will be provided as shown on approved plans.

Front yard = 5'-0" ft. and 13'-0" ft. Rear yard = 5'-6" and 8'-0" ft. Side yard = 2'-0" ft. and 5'-0" ft.

F. Landscaping:

Site landscaping will be provided as shown on approved plans.

G. Accessory Off-Street Parking & Loading:

Accessory off-street parking and loading shall be provided based on PUD (GDP/SIP) zoning as shown on the approved plans.

H. Lighting:

Site lighting will be provided as shown on approved plans.

I. Signage:

Signage will be provided as approved on the recorded plans.

J. Family Definition:

The family definition for this PUD (GDP/SIP) shall coincide with the definition given in Chapter 28.03(2) of the Madison General Ordinances for the HIS-UH OR (R-5) zoning district.

K. Alterations and Revisions:

No alteration or revision of this Planned Unit Development shall be permitted unless approved by the City Plan Commission, however, the Zoning Administrator may issue permits for minor alterations or additions which are approved by the Director of Planning and Development and the district Alderperson and are compatible with the concept stated in the underlying General Development Plan approved by the City Plan Commission.

