### APPLICATION FOR URBAN DESIGN COMMISSION REVIEW AND APPROVAL

| AGENDA ITEM #_   |  |
|------------------|--|
| <b>Project #</b> |  |

| DATE SUBMITTE  | D: January 23, 2007  ATE: January 30, 2007  | Action Requested Informational Presentation Initial Approval and/or Recommendation X Final Approval and/or Recommendation |
|--|---|---|
| PROJECT ADDRE  | SS: 101-109 N. Franklin Street  |   |
| ALDERMANIC DI  | STRICT: #2 - Brenda Konkel  | -   |
| OWNER/DEVELO   | PER (Partners and/or Principals)  | ARCHITECT/DESIGNER/OR AGENT:  |
| Renaissance Prop   | erty Group, LLC   | Knothe & Bruce Architects, LLC  |
| One Sherman Ter  | race, Suite 102   | 7601 University Avenue, Suite 201   |
| Madison, WI 537  | 04  | Middleton, Wisconsin 53562  |
| CONTACT PERSON   | : J. Randy Bruce/Knothe & Bruce Arch  | nitects, LLC  |
| Address:   | 7601 University Avenue, Suite 201   |   |
|  | Middleton, Wisconsin 53562  |   |
| Phone:   | _608-836-3690   |   |
| Fax:   | _608-836-6934   |   |
| E-mail addres  | ss: rbruce@knothebruce.com  |   |
| General I x Specific I Planned Comm General I Specific I Planned Reside New Constructi required as well School, Public I | evelopment (PUD) Development Plan (GDP) Implementation Plan (SIP) unity Development (PCD) Development Plan (GDP) Implementation Plan (SIP) Intial Development (PRD) on or Exterior Remodeling in an Urban I as a fee) Building or Space (Fee may be required) on or Addition to or Remodeling of a Re |   |
| (See Section B for:)  New Construction   | on or Exterior Remodeling in C4 Distric   | et (Fee required)   |
| (See Section C for:) R.P.S.M. Parkin   | ng Variance (Fee required)  |   |
|  | Design Review* (Fee required) Variance* (Fee Required)  |   |
| Other*Public Hearing Requ  | uired (Submission Deadline 3 Weeks in A   | Advance of Meeting Date)  |

December 17, 2007

Revised: January 23, 2008

Mr. Brad Murphy
Director of Planning
Department of Planning & Development
City of Madison
215 Martin Luther King Jr. Blvd
PO Box 2985
Madison, Wisconsin 53701

Re: The Conklin House Relocation

Letter of Intent Rezoning to PUD- SIP

101-109 N. Franklin Street

Madison, WI

Dear Mr. Murphy:

The following is submitted together with the plans, application and zoning text for staff, Plan Commission and Common Council consideration of approval of a rezoning request to PUD-SIP.

#### **Organizational structure:**

Project: The Conklin House Relocation Engineer: Calkins Engineering

101–109 N. Franklin Street 5010 Voges Road

Madison, WI 53718 (608) 838-0444 (608) 838-0445 fax

Owner: Renaissance Property Group, LLC (608) 838-0445 fax
One Sherman Terrace, Ste 102 Contact: Dave Glus

One Sherman Terrace, Ste 102 Contact: Dave Glusick
Madison, WI 53704 dglusick@calkinsengineering.com

608-301-0000 608-301-0001 fax

Relocation Ten Twenty Two, LLC

Contact: Michael Matty Architect: Knothe & Bruce Architects, LLC

mmatty@renpropgroup.com 7601 University Avenue, Ste 201

Middleton, WI 53562

608-836-3690 608-836-6934 fax Contact: Randy Bruce

Developer:c/o Bill White at Michael Best & Contact: Randy Bruce Friedrich, LLP rbruce@knothebruce.com

One South Pinckney Street, Ste 700

Madison, WI 53703

wfwhite@michaelbest.com

608-257-3501 Landscape Ken Saiki Design

608-283-2275 fax Design: 303 S. Paterson Street, Ste 1
Contact: Bill White Madison, WI 53703

Madison, WI 53703 (608) 251-3600 Contact: Ken Saiki ksaiki@ksd-la.com Letter of Intent –PUD-SIP The Conklin House Relocation 101-109 N. Franklin Street December 18, 2007 Page 2 of 3

#### Introduction:

This project proposes the renovation and infill development of three lots on the northeast corner of North Franklin and East Mifflin Street. The three properties have recently been purchased by Renaissance Property Group and suffer from an extended period of deferred maintenance.

The 13,171 square foot site is currently zoned R-5 and occupied by three residential structures, two garages and backyard parking for 17 cars. This proposal envisions the removal of the garages and backyard parking and the relocation of the Conklin House to a forth lot created within the other three lots. The Conklin House is a turn of the century Queen Ann that was extensively remodeled by the firm of Claude & Stark and is currently located at 309 North Mills Street. The current site of the Conklin House is the subject of a development proposal for a higher-density student housing project that is now under consideration by the Plan Commission.

#### **Project Description:**

The three existing residential structures that face North Franklin Street were constructed between 1879 and 1918 and represent an eclectic and interesting mix of architecture from the period. The Conklin House will face East Mifflin Street with a raised porch and steps creating an inviting street presence. A new curb cut on Mifflin Street will provide access to a small 3 stall parking area. New and repaired concrete walks will provide pedestrian access to the backyard while a new wood ramp will provide handicap access to the Conklin House. The front, side and back yards are appropriately landscaped to facilitate outdoor recreation.

### **Project Schedule and Management:**

It is anticipated that the relocation will occur in March, 2008 with the renovation of the structures to occur shortly after. Project completion, including landscaping, is scheduled for Summer of 2009. Trash will be collected in private household receptacles and brought to curb by tenants. Snow removal, landscape maintenance, and building maintenance will be provided by the owner.

#### Social & Economic Impacts:

The development will provide a new in-fill location for The Conklin House, a turn of the century Queen Ann by Claude & Stark Architects. It will also allow for the renovation and improvement of three existing residential structures while reducing backyard parking and increasing green space. The development will modestly increase housing in the central city and promote pedestrian and bicycle circulation while reducing vehicular traffic.

### **Site Development Data:**

| Densities:           | <u>Existing</u>   | Required per R-5 | <u>Proposed</u> |
|----------------------|-------------------|------------------|-----------------|
| Lot area             | 13,171 SF or .302 | acres            | same            |
| Lot area / D.U.      | 2195 SF/unit      |                  | 1317 SF/unit    |
| Density (units/acre) | .0503             |                  | .0302           |
| Usable open space    | 0 SF              | 4,480 SF         | 2212 SF         |
| • •                  | 0% of site        | 34% of site      | 17% of site     |
| Parking Ratios:      | Existing          | Required per R-5 | <u>Proposed</u> |
| Automobile parking   | 17 stalls or      | 16 stalls        | 2 stalls or     |
|                      | 2.83 stalls/unit  | 1.6 stalls/unit  | 0.2 stalls/unit |

Letter of Intent –PUD-SIP The Conklin House Relocation 101-109 N. Franklin Street December 18, 2007 Page 3 of 4

| Bicycle parking   | 5 stal                      | ls                  | 10 stalls   | 10 stalls     |
|---|-----------------------------|---------------------|---|---------------|
| Dwelling Unit Mix (Total Site): One-Bedroom Two-Bedroom + Den Three-Bedroom Three-Bedroom + Den Five-Bedroom Six-Bedroom Total Dwelling Units | 1<br>4<br><u>1</u><br>6 (20 | Existing  Bedrooms) | Prop<br>1<br>4<br>1<br>2<br>1<br>1<br>10 (25 Bedr | ooms)         |
| <u>Dwelling Unit Mix – Existing (By</u>   | Building):<br>101           | <u>103-105</u>      | <u>107-109</u>                                    | Conklin House |
| One-Bedroom Two-Bedroom + Den Two-Bedroom + Den Three-Bedroom + Den Five-Bedroom Six-Bedroom  | 1                           | 2                   | 1   |               |
| Total Dwelling Units<br>Total Bedrooms  | 1<br>3                      | 3<br>12             | 2<br>5  | -             |
| Dwelling Unit Mix – Proposed (E   |                             |                     | <u>107-109</u>                                    | Conklin House |
| Two-Bedroom<br>Two-Bedroom + Den  |                             | 2                   | 1   | 1<br>1        |
| Three-Bedroom   | 1                           |                     | 1   | ı             |
| Three-Bedroom + Den<br>Five-Bedroom<br>Six-Bedroom  |                             | 1                   |   | 1             |
| Total Dwelling Units Total Bedrooms   | 1 3                         | 3<br>9              | 2<br>5  | 4<br>8        |
| Conklin House Gross Area (app<br>Basement 19<br>First Floor 20<br>Second Floor 20<br>Third Floor 11   |                             | j                   | J   | J             |


Thank you for your time in reviewing our proposal.

Very Truly Yours,




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No

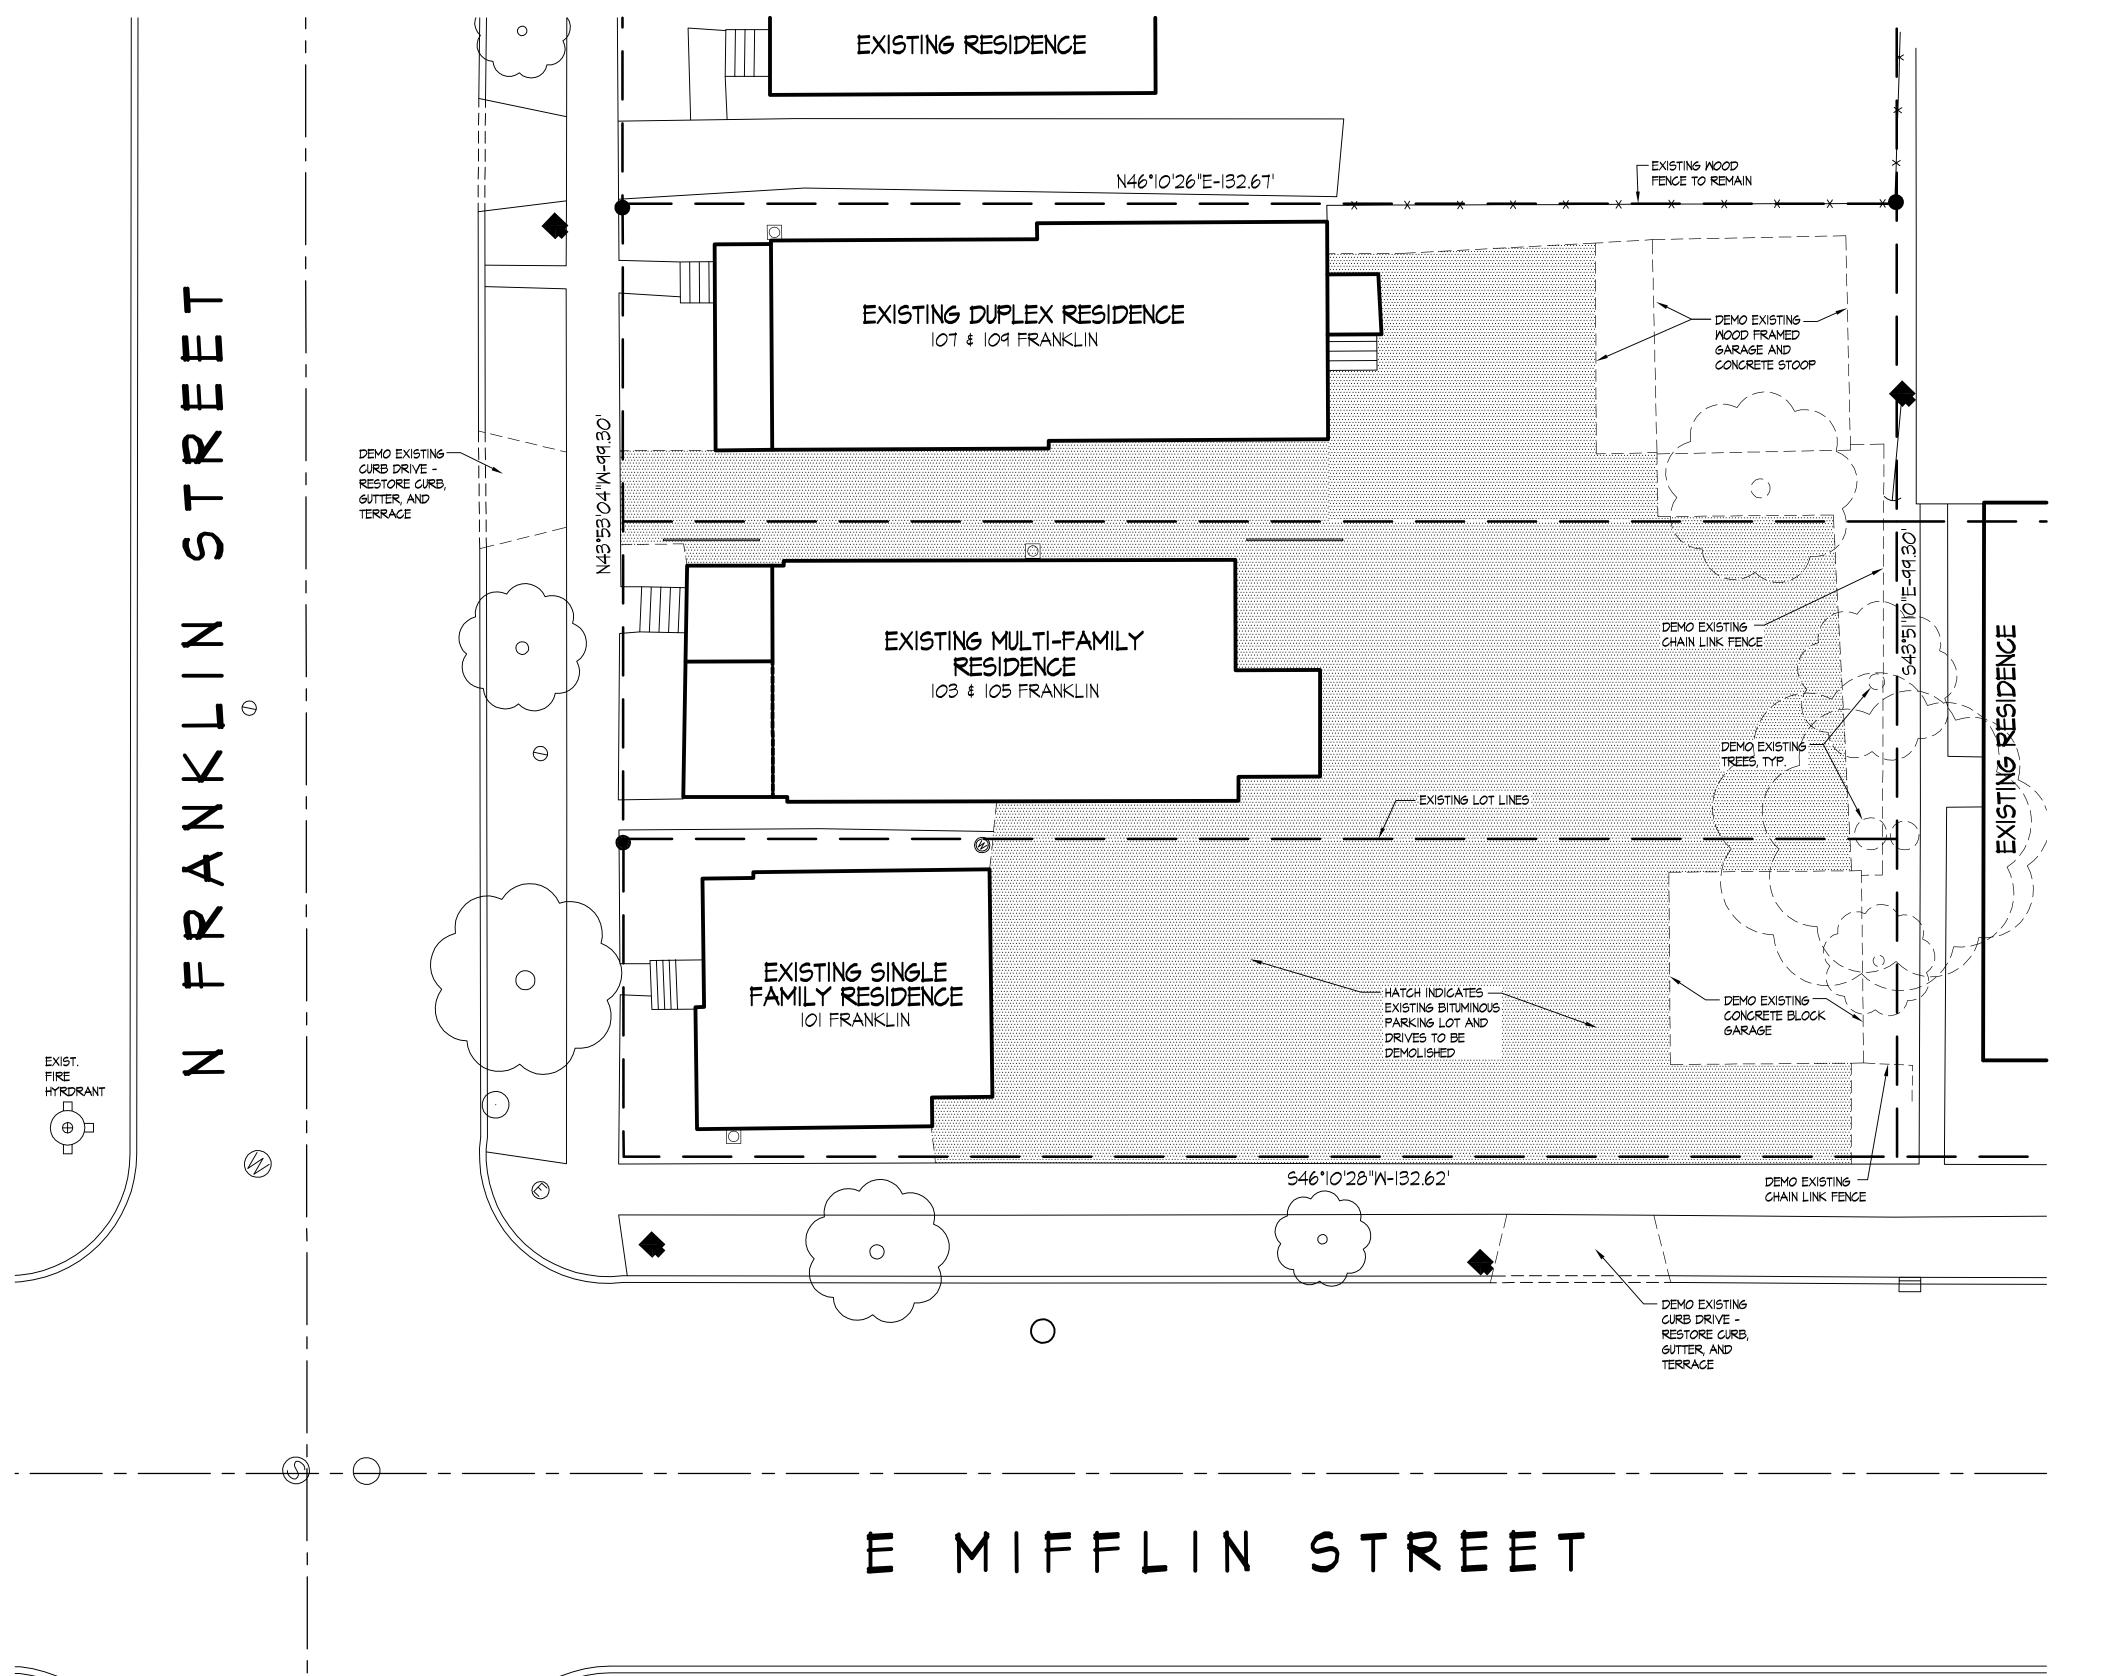

DEMOLITION SITE PLAN

Revisions PUD Submittal - December 17, 2007 Final UDC Submittal - January 2, 2008

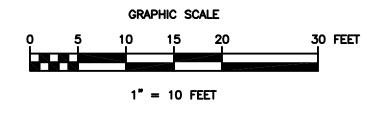

Project Title

Conklin House Relocation

OI - 109 N. Franklin St.

Drawing Title


Demolition Site Plan

Project No. Drawing No. C-1.0

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Existing Required per R-5
13,171 SF or .302 acres
2195 SF/unit
.0502
0 SF 4,480 SF
0% of site 34% of site Proposed same 1317 SF/unit .0302 2212 SF 17% of site Required per R-5 16 stalls 1.6 stalls/unit 10 stalls Proposed 10 (25 Beds) 107/109

Six-Bedroom Total Dwelling Units Total Bedrooms Conklin House Gross Area (approx.):
Basement 1971 SF
First Floor 2000 SF
Second Floor 2000 SF
Third Floor 1150 SF
Total Area 7121 SF

One-Bedroom Two-Bedroom + Den Two-Bedroom + Den Three-Bedroom + Den Five-Bedroom

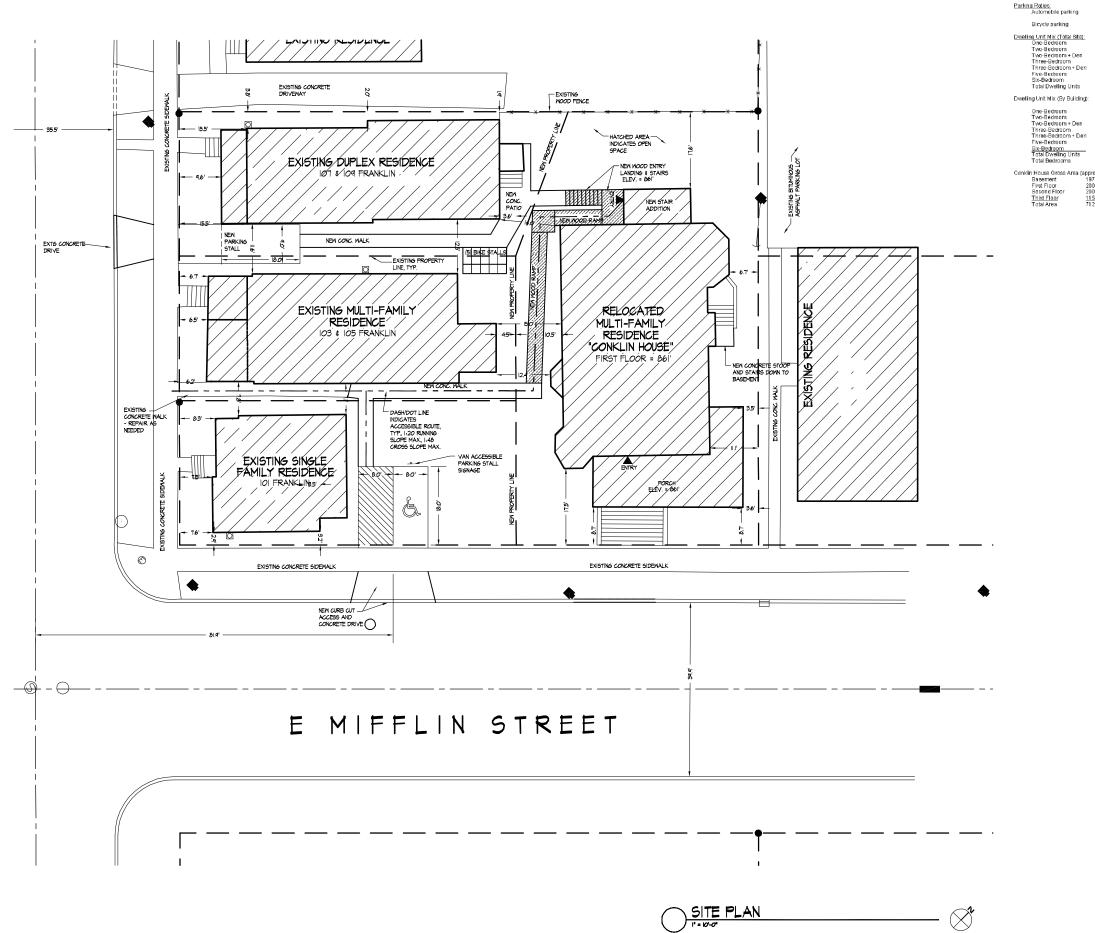Site Development Data: Densities: Lot area Lot area / D.U. Density (units/acre) Usable open space

Existing

6 (20 Beds)

0/2

7601 University Avenue Suite 201 Middleton, Wisconsin 53562 608-836-3690 Fax 836-6934

Consultant

I. ALL WALKWAY STAIRS TO HAVE PAINTED RAILINGS EACH SIDE.


2. ALL DRIVEWAYS, CURB ADJACENT TO DRIVEWAYS, AND SIDEMALK CONSTRUCTION WITHIN THE RUBLIC RIGHT-OF-WAY SHALL BE COMPLETED IN ACCORDANCE WITH CITY OF MADISON SPECIFICATIONS.

3. ALL TRASH TO BE COLLECTED IN PRIVATE HOUSELHOLD RECEPTICLES TO BE BROUGHT TO CURB.

5. I.48 MAXIMIM SLOPE IN ANY DIRECTION AT ACCESSIBLE PARKING STALL AND ACCESS AISLE I.20 MAXIMIM SLOPE IN ANY DIRECTION AT TYPICAL PARKING STALLS.

6. SEE GRADING, UTILITY, EROSION CONTROL, AND LANDSCAPING PLANS FOR ADDITIONAL INFORMATION.

Revisions PUD Submittal - December 17, 2007 Initial UDC Submittal - January 2, 2008 Final UDC Submittal - January 23, 2008

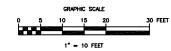

Project Title


Conklin House Relocation


101 - 109 N. Franklin St. Drawing Tide **Site Plan** 

Drawing No.

C-1.1

0622-H

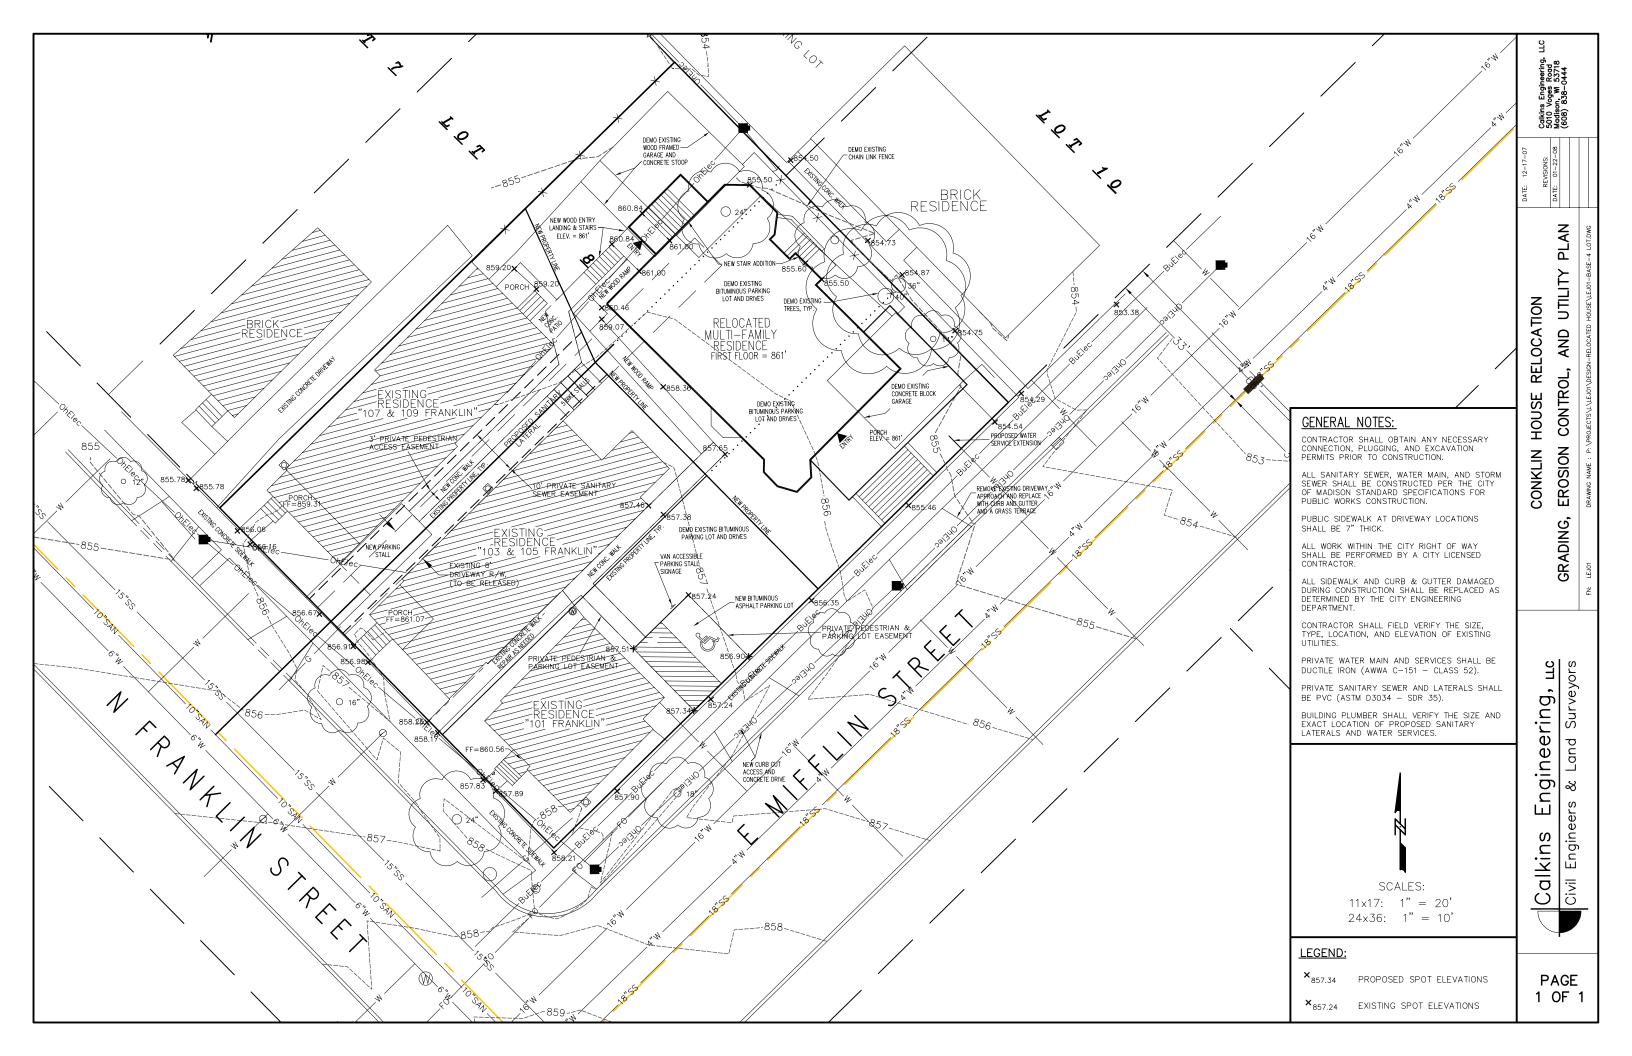

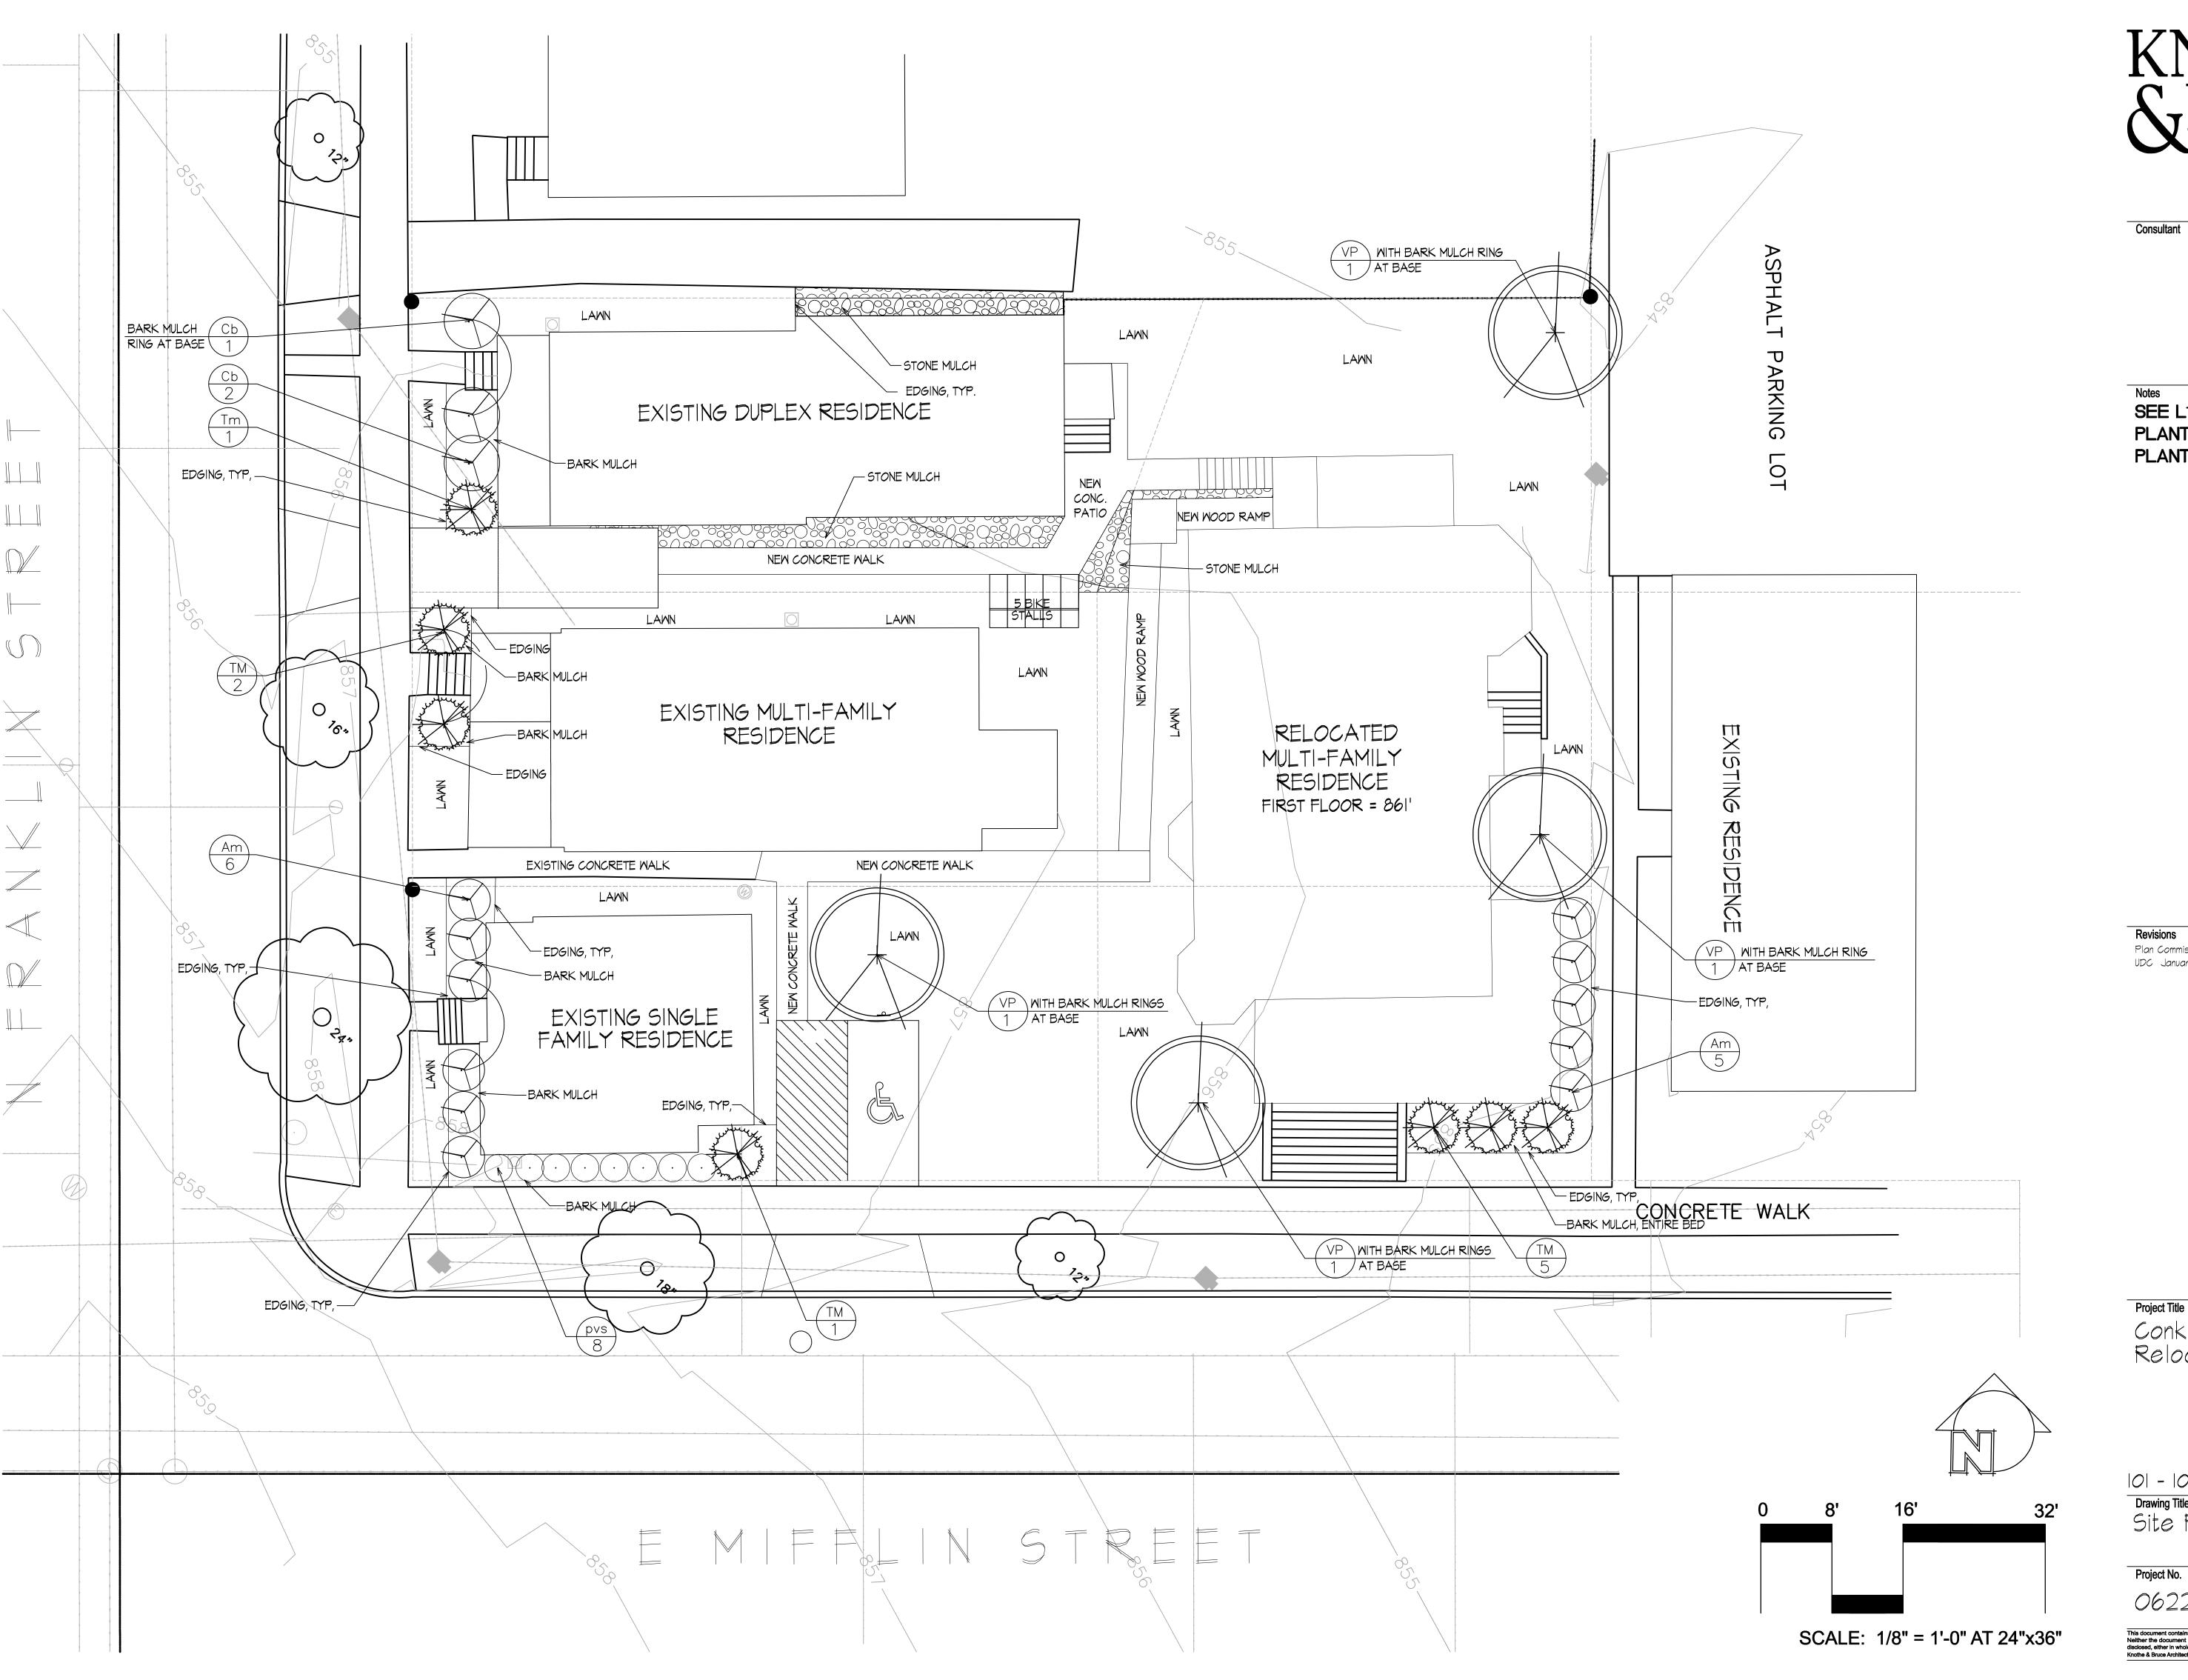

Middleton, Wisconsin 53562 608-836-3690 Fax 836-6934

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LANDSCAPE ARCHITECTS

SEE L1.2 FOR DETAILS, PLANT SCHEDULE, AND PLANTING NOTES


Plan Commission December 17, 2007 UDC January 23, 2008


Project Title

Conklin House Relocation

101 - 109 N. Franklin St. Drawing Title
Site Planting Plan


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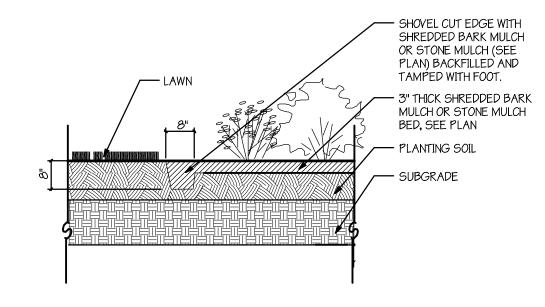


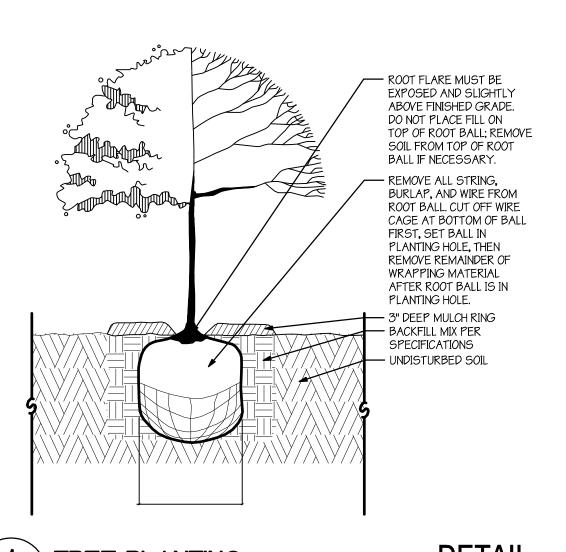


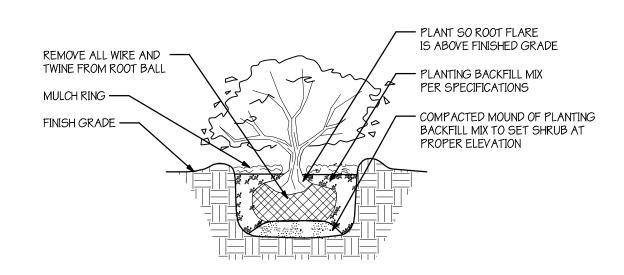**DETAIL** 

**NOT TO SCALE** 



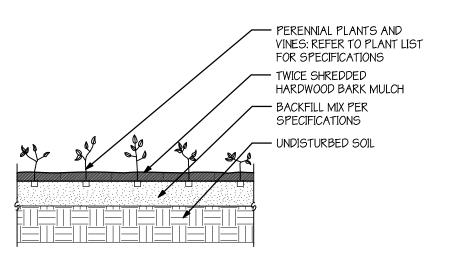

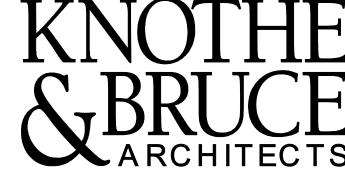

7611 Elmwood Avenue Suite 102 Middleton, Wisconsin 53562 608-836-3690 Fax 836-6934

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LANDSCAPE ARCHITECTS

| 1 \  | TREE PLANTING | DETAIL      |
|------|---------------|-------------|
| L1.2 |               | NOT TO SCAL |

| 2   | SHRUB PLANTING |
|-----|----------------|
| 112 |                |

| 3    | PERENNIAL PLANTING | DETAIL       |
|------|--------------------|--------------|
| L1.2 |                    | NOT TO SCALE |

| 4             | SHOVEL CUT EDGE | DETAIL       |
|---------------|-----------------|--------------|
| <b>L1.2</b> / |                 | NOT TO SCALE |

## PLANT SCHEDULE

| Key | Botanical Name                    | Common Name                | Qty. | Size          | Comments                        |
|-----|-----------------------------------|----------------------------|------|---------------|---------------------------------|
|     |                                   |                            |      |               |                                 |
|     | Deciduous Trees                   |                            |      |               |                                 |
| VP  | Viburnum prunifolium              | Blackhaw Viburnum          | 4    | 2.5" Cal./BB  | Tree Form; match specimens      |
|     |                                   |                            |      |               |                                 |
|     | Evergreen Trees                   |                            |      |               |                                 |
| TM  | Taxus x media 'Hicksii'           | Hick's Yew                 | 7    | 48" Ht./Cont. | Well-developed plants           |
|     | Deciduous Shrubs                  |                            |      |               |                                 |
| Am  | Aronia melanocarpa 'Autumn Magic' | Autumn Magic Aronia        | 11   | 36" Ht./Cont. | Match specimens                 |
| Cb  | Cornus baileyi                    | Bailey Red Twigged Dogwood | 3    | 36" Ht./Cont. | Well-developed plants           |
|     | Grasses                           |                            |      |               |                                 |
| pvs | Panicum virgatum 'Shennendoah'    | Shennendoah Switchgrass    | 8    | 1 Gal. Cont.  | space per plan; match specimens |

Plan Commission December 17, 2007 UDC January 23, 2008

## PLANTING NOTES

- 1. If existing soil conditions are unsuitable for planting, seeding, or sodding, topsoil is to be applied. Topsoil shall be clean salvaged or imported material capable of passing the 1" sieve and meeting the requirements of Section 625.2(1) of the Standard Specifications for Highway Construction. The material shall be free of rocks, gravel, wood, debris, and of noxious weeds and their seeds.
- 2. Remove all rocks, debris, and litter from the site and all planting/seeding/sodding areas. Till or disc the subsoil to a depth of 2"-4" to allow aeration. Provide a minimum of 4" of topsoil in areas where existing soil conditions are unsuitable for sodding and seeding.
- 3. Do not apply topsoil to saturated or frozen subgrades.
- 4. Provide organic soil amendments and lime as recommended by soil analysis. If topsoil has been determined acceptable by a soil test, no ammendments are needed. Uniformly apply any organic soil ammendments and incorporate into the top 4"-6" of soil by tilling or discing.
- 5. Provide suitable amended soil for all planters on site.

### **PLANTS**

1. All plant material shall conform to the American Standards of Nursery Stock. 2. All plant material shall be true to the species and variety/hybrid/cultivar specified, and nursery-grown in accordance with good horticultural practices, and under climatic conditions similar to those of the site location. Nursery-dug material shall be freshly dug and properly prepared for planting. Contact Landscape Architet, in writing, to request any plant material substitutions due to availibility issues.

### PLANTS CONT...

- 3. Trees and shrubs shall have superior form, compactness, and symmetry. Damaged trees and shrubs, by weather, insects, fungus, knots, abraisions, or cut limbs or leaders and trees with multiple leaders, unless specified otherwise, will be
- 4. Trees and shrubs shall have healthy, well-developed root systems, free from physical damage.
- 5. Plants shall conform to the measurements specified within the contract documents.
- 6. During transportation, no plant shall be bound with rope or wire in a manner that damages trunks or breaks branches. Plants are not to be dragged, lifted, or pulled by the trunk, branches or foliage. Plants are not to be thrown off of a
- 7. Prior to installation, plants must be protected from sun and drying winds, kept in shaded areas, and kept well-watered. Install all plants within three days of delivery to site.
- 8. All plants shall be guaranteed to be in healthy and flourishing condition during the growing season. The guarantee does not cover damage from vandalism, animals, freezing rain, or winds over 60 mph. During any time of the guarantee period, the Contractor shall remove or replace, without cost to the owner, all plants not in a healthy and flourishing condition as determined by the Landscape Architect.
- 9. All plant material shall be guaranteed for one (1) year from time of installation. Only one replacement per plant shall need to be made.

### PLANTS CONT...

- 10. Organic Mulch is to be shredded bark, free of material detrimental to healthy plant growth. Shredded bark mulch shall be 1/8" nominal thickness, with at least 50% having an area of not less than 1 sq. inch, and no piece having an area of more than 4 sq. inches.
- 11. Stake all planting and notify Digger's Hotline (1-800-242-8511) to verity location of all underground utilities prior to excavation.
- 12. The planting pit for containerized and balled and burlapped plants shall be at least 2.5 to 3 times the diameter of the soil ball. The soil beyond the edges is to be loosened. The soil at the base of the pit is to remain undisturbed.
- 13. The depth of the planting pit shall correspond to the distance from the bottom of the soil ball to the root flare, or slightly less.
- 14. Plant material set too low will need to be re-set by the contractor pending the Landscape Architect's instructions. Pits shall be backfilled with excavated soil so long as it is not muddy or frozen.
- 15. Root balled plants shall have rope/string, wire, and burlap or other wrapping material cut away and removed completely from the root ball and hole after the plant has been set in the hole.
- 16. No soil is to cover the top of the root flare. All plants shall be mulched with a 3" layer of specfied mulch immediatly after planting. Mulch is to pulled back no less than 3" and no more than 6" from trunks.
- 17. Thoroughly water plants immediately after planting and before mulching. 18. Remove all twine and lables and prune any dead or broken branches after planting.

### PLANTS CONT...

19. Maintenance for plant material shall be 30 days. Plants shall be watered, staked, pruned, dead-headed, and planting beds shall be weeded during this time period.

### **ACCESSORIES**

- 1. Shovel cut edge shall be used to separate bark mulch planting areas from lawn areas. See detail, this sheet.
- 2. Stone mulch shall be 1-1/2" washed decorative mulch i.e. "American Heritage" blend or other similar. Install stone mulch over filter fabric layer.

Relocation

Conklin House


101 - 109 N. Franklin St.


Plant Scheudle / Details

Project No.


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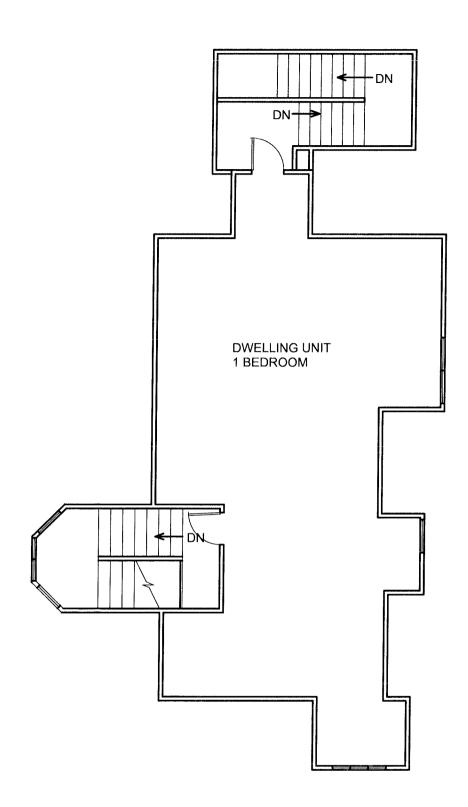
isclosed, either in whole or in part, except as specifically authorized by Knothe & Bruce Architect



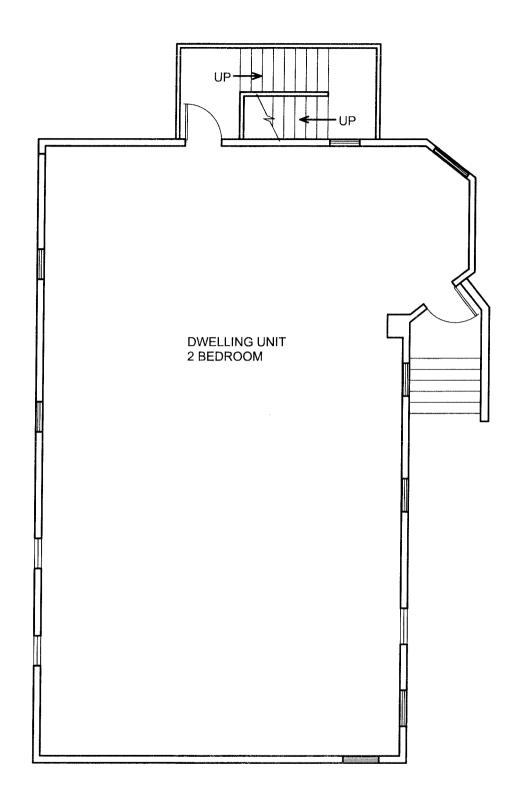

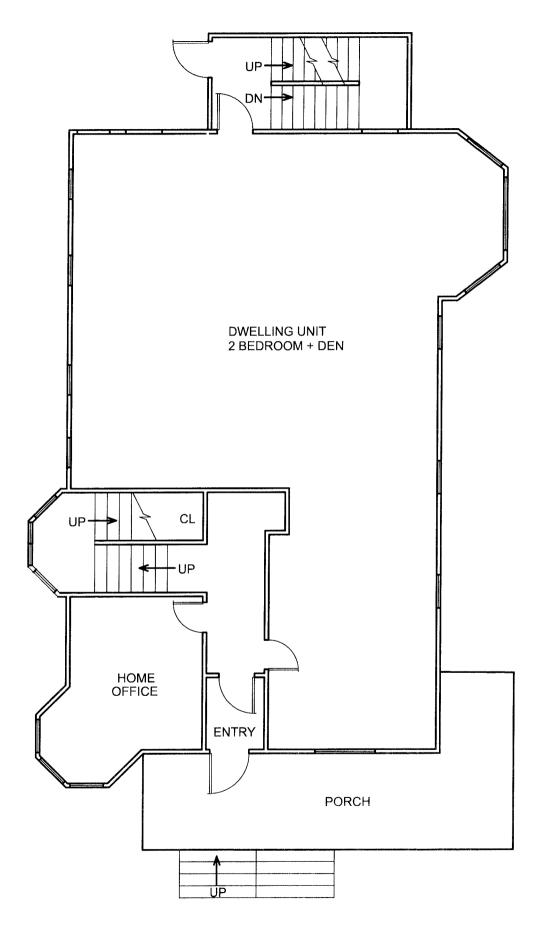CONKLIN HOUSE - FIRST FLOOR PLAN 1/8"=1'-0"



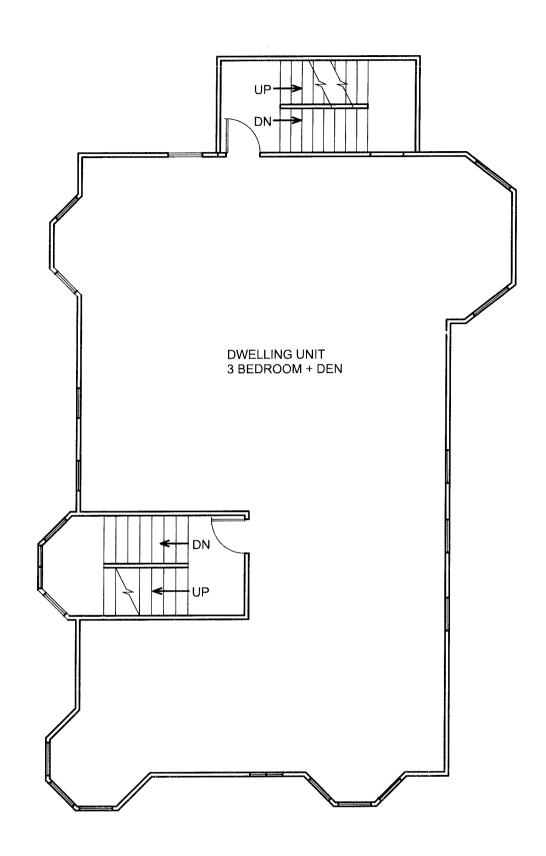



Existing N. Franklin St. Site
Elevation along E. Mifflin Street



Conklin House at N. Franklin St. Site
Elevation along E. Mifflin Street

Photo Elevations
The Conklin House Relocation
101-109 N. Franklin Street
January 2, 2008
Page 1 of 5

### 101 N. Franklin St.

Single Family Residence (3) Bedrooms Total



Southwest and Southeast Elevations (Front)



Northeast Elevation (Back)



Close-up of Back Corner.

- Install new asphalt shingle roof and gutters.
- 2. Install new windows throughout.
- 3. Prepare and paint all wood siding.
- 4. Repair and paint front and back stairs and railings.
- Replace existing vertical wood siding at back corner with horizontal wood siding to match rest of exterior.
- 6. Install new landscaping per landscaping plan.
- 7. Remove or replace wood shutters.


Photo Elevations
The Conklin House Relocation
101-109 N. Franklin Street
January 2, 2008
Page 2 of 5

#### 103 & 105 N. Franklin St.

- (3) Unit Multi-Family
- (9) Bedrooms Total



Northwest and Southwest Elevations (Front)

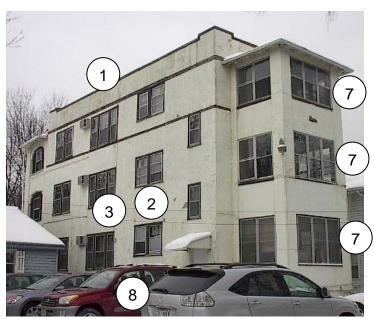

Northeast and Southeast Elevations (Back)

- 1. Replace flat roof and parapet with new low-slope hipped roof, to match existing roofs over front and back porch elements.
- 2. Repair and paint stucco finish.
- 3. Install new windows throughout.
- 4. Remove infill areas around front bedrooms to restore open porches.
- Front porches to receive new stairs, railings, decking, and ceilings.
- 6. Shore up foundation and modify structure at front porches as required to bring porches back to plumb.
- Remove windows at enclosed back porches and restore open screened porches. Refurbish interior finishes including flooring. Replace or add scuppers as necessary.
- 8. Install new landscaping per landscaping plan.

Photo Elevations
The Conklin House Relocation
101-109 N. Franklin Street
January 2, 2008

Page 3 of 5

### 107 & 109 N. Franklin St.

- (2) Unit Duplex
- (5) Bedrooms Total



Southwest Elevation (Front)



Northeast and Southeast Elevations (Back)

- 1. Inspect windows. Repair or replace as required.
- 2. Repair damaged areas of vinyl siding.
- 3. Front and back porches to receive new stairs, railings, decking, and ceilings.
- 4. Shore up foundation and modify structure at back porch.
- 5. Install new landscaping per landscaping plan.

Photo Elevations
The Conklin House Relocation
101-109 N. Franklin Street
January 2, 2008
Page 4 of 5

### Site Features to be Removed



Wood-framed garage on 107/109 N. Franklin Lot to be dismantled and stored off-site for future use.



Masonry garage on 101 N. Franklin Lot to be demolished.



Chain-link fence and trees along property line to be removed – far view.



Chain-link fence and trees along property line to be removed – close-up view.

Photo Elevations The Conklin House Relocation 101-109 N. Franklin Street January 2, 2008 Page 5 of 5

### **Conklin House**

- (4) Unit Multi-Family
- (8) Bedrooms Total



Front Elevation



Front and Side Elevations


Left Side of Back Elevation

- 1. Relocate existing building and front porch to new site. Pour new foundation to accept existing structure and reuse sandstone base. Existing foundation windows to remain. Additional windows and window wells may be added as required to accommodate basement unit.
- 2. Remove back addition and exterior stairs. Replace with new enclosed stair to provide secondary means of egress for each dwelling unit.
- 3. Front porch to receive new wood stairs and railings.
- 4. Install new windows throughout.
- 5. Install new landscaping per landscaping plan.



Right Side of Back Elevation



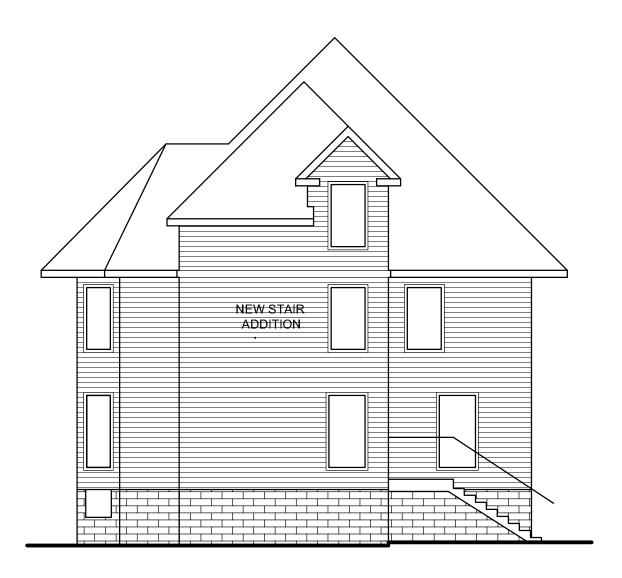

# CONKLIN HOUSE - BACK ELEVATION 1/8"=1'-0"