APPLICATION FOR URBAN DESIGN COMMISSION REVIEW AND APPROVAL


AGENDA	ITEM#	
Project # _		


DATE SUBMITTED: February 28, 2007	Action Requested Informational Presentation Initial Approval and/or Recommendation		
UDC MEETING DATE: March 7, 2007	Initial Approval and/or Recommendation X Final Approval and/or Recommendation		
PROJECT ADDRESS: 301 S. Ingersoll			
ALDERMANIC DISTRICT: Judy Olson #6			
OWNER/DEVELOPER (Partners and/or Principals)	ARCHITECT/DESIGNER/OR AGENT:		
301 S. Ingersoll, LLC/ Rich Arnesen	Knothe & Bruce Architects, LLC		
321 E. Main Street	7601 University Avenue, Suite 201		
Madison, WI 53701	Middleton, Wisconsin 53562		
CONTACT PERSON: J. Randy Bruce/Knothe & Bruce Archi	tects, LLC		
Address:7601 University Avenue, Suite 201			
Middleton, Wisconsin 53562			
Phone: <u>608-836-3690</u>			
Fax:608-836-6934			
E-mail address: <u>rbruce@knothebruce.com</u>			
TYPE OF PROJECT: (See Section A For:) X Planned Unit Development (PUD) — General Development Plan (GDP) X Specific Implementation Plan (SIP) — Planned Community Development (PCD) — General Development Plan (GDP) — Specific Implementation Plan (SIP) — Planned Residential Development (PRD) — New Construction or Exterior Remodeling in an Urban Design District* (A public hearing is required as well as a fee) — School, Public Building or Space (Fee may be required) — New Construction or Addition to or Remodeling of a Retail, Hotel, or Motel Building Exceeding 50,000 Sq.Ft. — Planned Commercial Site			
(See Section B for:) New Construction or Exterior Remodeling in C4 District	(Fee required)		
(See Section C for:) R.P.S.M. Parking Variance (Fee required)			
(See Section D for:) — Comprehensive Design Review* (Fee required) — Street Graphics Variance* (Fee Required)			
Other *Public Hearing Required (Submission Deadline 3 Weeks in Advanced Company)	dvance of Meeting Date)		



Site Locator Map

301 S. Ingersoll Street

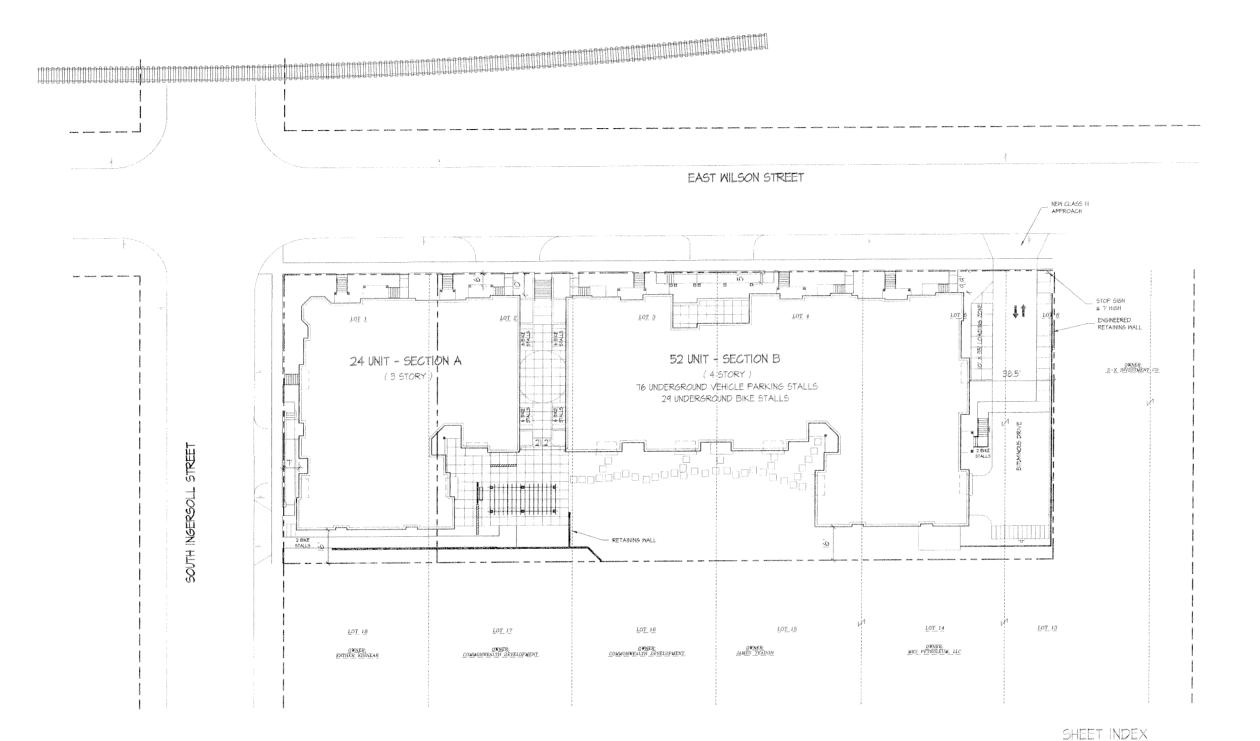

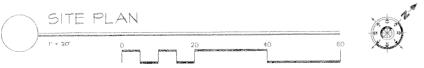



C-2.1 SITE GRADING PLAN C-4.1 LANDSCAPE PLAN

A-1.3 THIRD FLOOR PLAN

A-1.4 FOURTH FLOOR PLAN

A-2.1 ELEVATIONS

C-I.I SITE PLAN

A-22 ELEVATIONS

A-2.3 ELEVATIONS

7601 University Avenue, Ste. 201 Middleton, Wisconsin 53562 608-836-3690 Fax 836-6934

1. MAXIMM SLOPE AT ALL HANDIGAP ACCESSIBLE WALKS 1:20. MAXIMM SLOPE AT HANDICAP RAMPS 1:12. RAMPS OVERCOMING MORE THAN 6" CHANGE IN ELEVATION TO HAVE HANDRAILS ON BOTH SIDES

2. ALL DRIVEWAYS, CIRB ADJACENT TO DRIVEWAYS, AND SIDEWALK CONSTRUCTION WITHIN THE FIBLIC IGNET-OF-WAY, SHALL BE COMPLETED IN ACCORDANCE WITH CITY OF MADISCN STANDARD SPECIFICATIONS FOR FIBLE MORKS CONSTRUCTION BY A CONTRACTOR CURRENTLY LICENSED BY THE

3 ALL NEW DRIVES TO BE CONSTRUCTED WITH CLASS III APPROACHES IN ACCORDANCE WITH MADISON GENERAL ORDINANCE SECTION 10.08(4)

ALL TRASH TO BE COLLECTED IN UNDERGROUND PARKING GARAGES. RECYCLING AREAS TO BE PROVIDED IN TRASH ROOM.

5. SEE GRADING AND UTILITY PLANS FOR ADDITIONAL INFORMATION.

6. COMM 62.0500(II)-REQUIRED FIRE LANES SHALL BE PROVIDED PRIOR TO THE PLACEMENT OF COMBUSTIBLE MATERIALS AT THE BUILDING SITE, OR THE CONSTRUCTION OF ANY PORTION OF A BUILDING ABOVE THE FOOTING AND FOUNDATION.

T, BIKE STALLS TO BE IN ACCORDANCE TO MADISON GENERAL ORDINANCE 28.11, FOR THE TYPES OF RACKS ESPECIALLY SEE SUBSECTIONS (9)(e) AND (9)(h)2d., 1(M) BIKE RACK TO BE USED.

Plan Commission Submittal - September 20, 2006 Progress Printing - January 26, 2007 February 12, 2007 Final VDC Submittal - February 28, 2007




Project Title 30| S. Ingersoll St.


Site Plan

Project No.

0555

Drawing No. C-1.

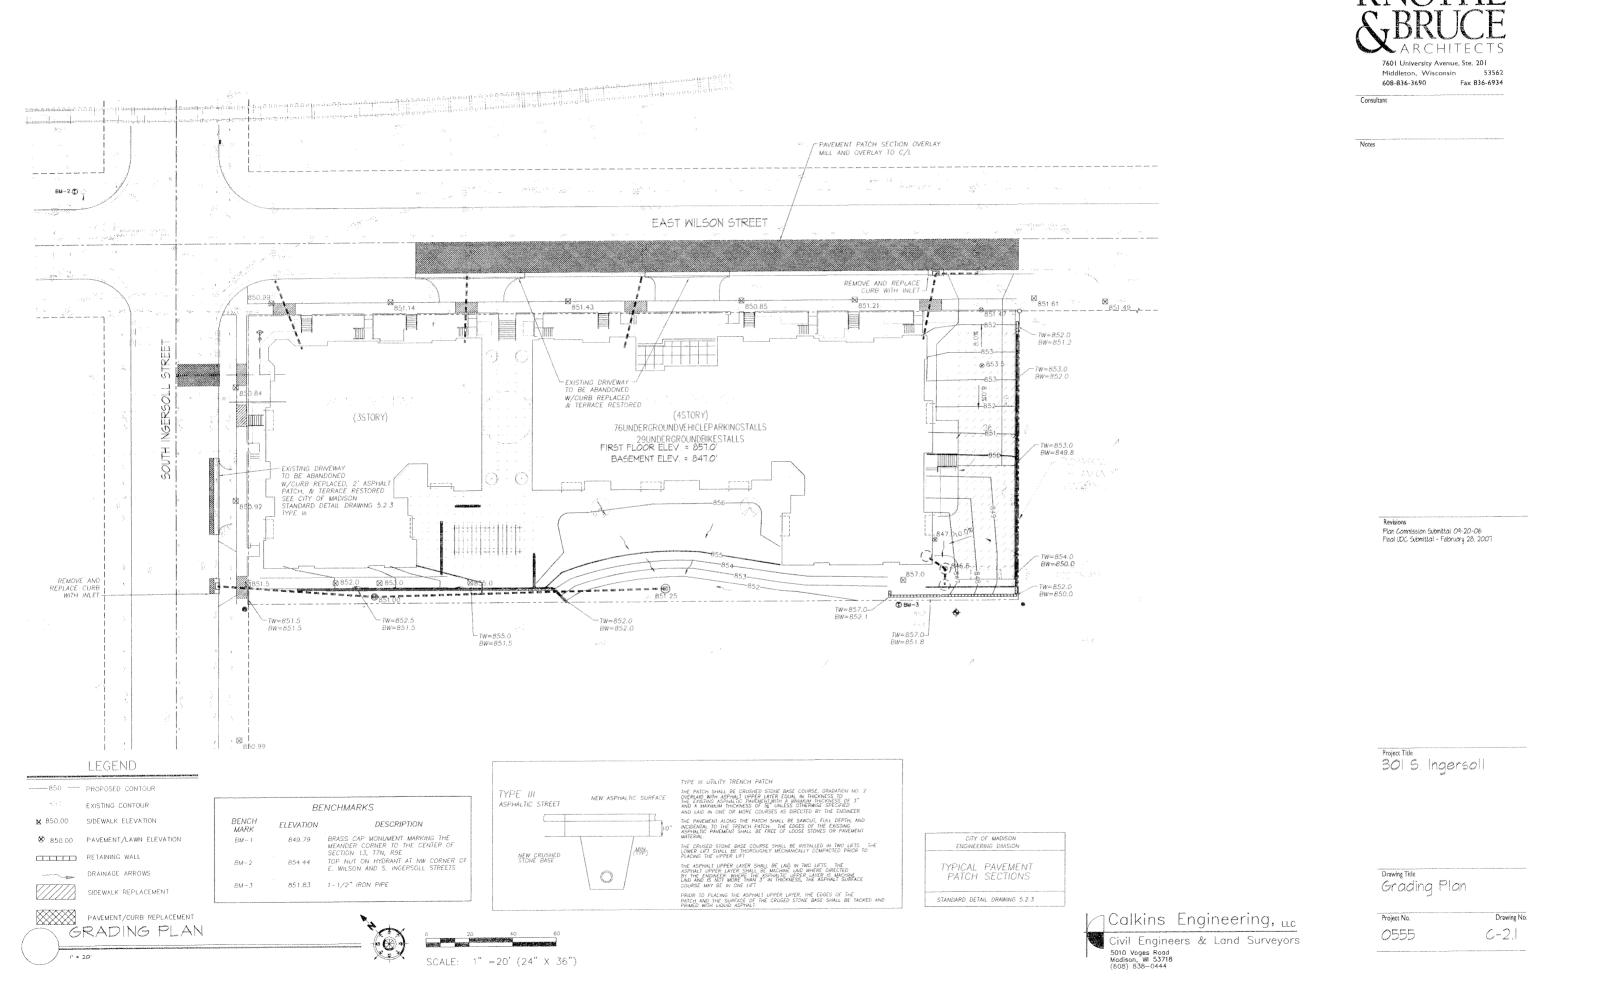

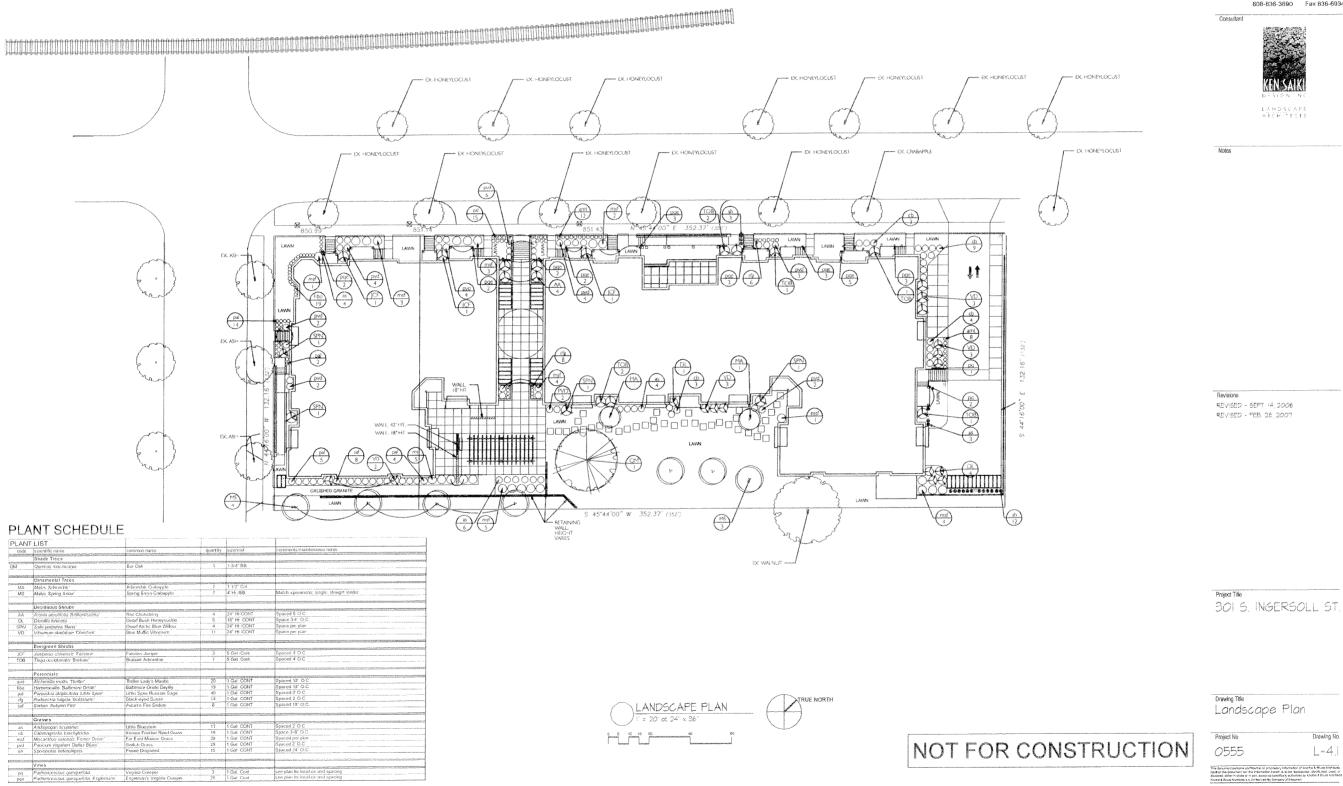


7601 University Ave Suite 201 Middleton, Wisconsin 53562 608-836-3690 Fax 836-6934



Middleton, Wisconsin 53562 608-836-3690 Fax 836-6934

Notes
1. 20 BIKE PARKING STALLS IN EACH BASEMENT. PROVIDE
BIKE RACK SECRELLY PASTERED TO IVALL OR FLOOR. AN
ADDITIONAL O SURPLACE STALLS FOR EACH BUILDING ON SITE
FOR SH STALLS TOTAL.

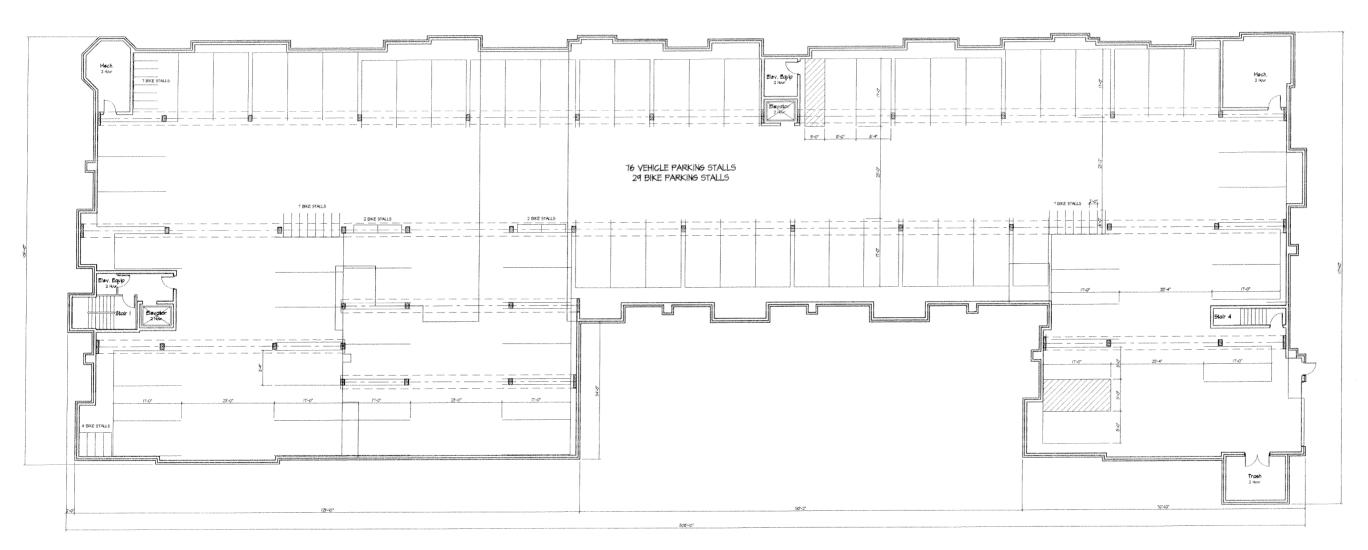

Issued for review - July 5, 2006 Plan Camnission Submittal - September 20, 2006

Project Title 301 S. Ingersoll St.

BASEMENT PLAN

Crawing Title
Basement Plan

Project No 0555

Drawing No

A-1.0



Consultant

25



Drawing Title First Floor Plan

0555

Project No. Drawing No

A-1.1

ns discussest continue mobiles (som a proposition order order order order order). Expressible movement for the información south of this be reproduced and before liberal Claracions or a station of gament or order or open fragy in the continue in the case of the continue of the continue



Notes



SECOND FLOOR PLAN
8/82" = 1'-0" 29266 SF



Orawing Title
Second Floor Plan

Project No.

Drawing No.

0555 A-I.2





THIRD FLOOR PLAN



25286 SF

301 S. Ingersoll St.

Drawing Tale
Third Floor Plan

Project No.

0555 A-1.3

Drawing No



FOURTH FLOOR PLAN





Middleton, Wisconsin 53562 608-836-3690 Fax 836-6934

Revisions Issued for review - July 5, 2006 Plan Commission Submittal - September 20, 2006

Project Title 301 S. Ingersoll St.

Drawing Tate
Fourth Floor Plan

Project No 0555

Drawing No

A-1.4



7601 University Avenue Suite 201 Middleton, Wisconsin 53562 608-836-3690 Fax 836-6934

Consultant

Notes

TYPICAL MATERIALS



Elevation Along East Wilson Street
3/82" = 1'-0"

Revisions

Issued - September 4, 2006 Plac Commission Submittel - September 20, 2006 Progress Phinting - January 26, 2001 Final UDG Submittel - February 28, 2001



Elevation Along Ingersoll
3/32" = 1'-0"

Project Title

301 S. Ingersoll St.

E. Wison, Madison Drawing Title Exterior Elevations

Project No.

Drawing No.

A2.

0555

This document consoles confidential or proprietary information of Knothe & Bruce Arthfile Nebbur the document nor the information benefit to be reproducted, distributed, used disclosed, edder to whole or to part, energy as specifically authorised by Knothe & Bruce Arthfile

Middleton, Wisconsin 53562 608-836-3690 Fax 836-6934

Consultant

ROOKWOOD TERRA COTTA ROOKWOOD TERRA COTTA (SMOROS) TENNA 00 ... (5N2803) RENWCK GOLDEN OAK ROOKWOOD TERRA COTTA ROOKWOOD AMBER RENAICK GOLDEN OAK RENWICK GOLDEN OAK ROOKWOOD AMBER (SN2803) - ROOKWOOD AMBER (SW2824) (SW2824) (SW28/7) (SM2824) (5x12817) DOWNING EARTH (SM2820) DOWNING EARTH (5/12820) DOWNING
EARTH ROYCROFT PEWTER
(SW2820) (SW2846) ROYCROFT PEWTER (SW2848) Fild: find tion 000 É ШШ 0 0 0 The state of the s

Rear Elevation

Revisions

Issued - September 4, 2006 Plan Cormission Submittal - September 20, 2006 Progress Printing - January 26, 2001 Final IDC Submittal - February 28, 2001



Side Elevation
3/32" = 1'-0"

301 S. Ingersoll St.

Project Tide

E Wilson, Modison Drawing Title Exterior Elevations


Project No. Drawing No.

0555 A-2.2

hi document compalis confidential or proprintary information of Knothe & Bruse Architectus eliders the document not the information herain is to be reproduced, distributed, stad, or solved elides in whole or maint, enters as sendically entherhold by Knothe & Once Architectus.



3/32" = 1'-0"

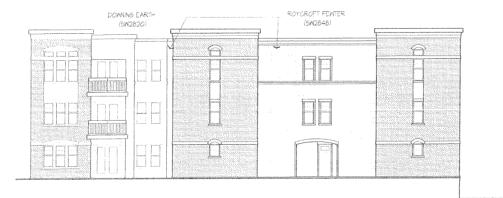



7601 University Avenue Suite 201 Middleton, Wisconsin 53562 608-836-3690 Fax 836-6934

Consultant

Revisions Issued - February 22, 2007 Final UDC Submittal - February 28, 2007

Project Tide

301 S. Ingersoll St.

E. Wilson, Madison Drawing Title Exterior Elevations

Project No.

Drawing No. A-2.3

September 20, 2006

Revised: February 26, 2007

Mr. Brad Murphy **Director of Planning** Department of Planning & Development City of Madison 215 Martin Luther King Jr. Blvd PO Box 2985 Madison, Wisconsin 53701

Re: Letter of Intent

> M-1 to PUD-GDP-SIP 301 S. Ingersoll Street

Madison, WI

Dear Mr. Murphy:

The following is submitted together with the plans, application and zoning text for staff, Plan Commission and Common Council consideration of approval.

Organizational structure:

Owner: 301 S. Ingersoll, LLC

P. O. Box 1547

Madison, WI 53701-1547

608-251-6000 608-251-6077 fax Contact: Rich Arnesen, Stone House Dev.

Engineer: Calkins Engineering

5010 Voges Road Madison, WI 53718

(608) 838-0444 (608) 838-0445 fax Contact: Dave Glusick Architect:

Knothe & Bruce Architects, LLC

7601 University Avenue, Ste 201 Middleton, WI 53562

608-836-3690 608-836-6934 fax Contact: Randy Bruce rbruce@knothebruce.com

Landscape

Ken Saiki Design Design: 303 S. Paterson St.

Suite 1

Madison, WI 53703 (608) 251-3600 Contact: Ken Saiki

Letter of Intent – PUD-GDP-SIP 301 S. Ingersoll Street September 20, 2006 Revised: February 26, 2007 Page 2 of 4

Introduction:

The proposed site is located on the southeast corner of Ingersoll and East Wilson Streets. It is currently occupied by the Badger Cab office and garage operation. The adjacent properties are a RB's Pasta to the east and residential uses to the south and west. An Amoco gas station also borders the site on the southeast corner of the site. Plans for the future Central Park include the site to the north across Wilson Street, currently a rail corridor.

This project proposes the redevelopment of this underutilized site for a 76-unit apartment development with under-building parking. The developers will be requesting Federal Housing Tax-Credits and specially structured WHEDA financing to provide highly needed affordable housing opportunities for the Marquette neighborhood. The proposed development is consistent with the East Rail Corridor Plan and the Williamson Street Build Plan. The developers have been working with the alderperson and the neighborhood group to realize the suggestions in these plan documents and to create a redevelopment with an active residential streetscape that respects the neighborhood context.

East Rail Corridor Plan:

The East Rail Corridor Plan generally recommends higher density development with employment to the north of the rail corridor and housing to the south. It specifically recommends housing for this site with a conservation district transition area for the corner of Ingersoll and East Wilson. The plan also states that the new housing be affordable and include a mix of ownership and rental housing. This proposal meets these guidelines by increasing the housing density of the corridor, providing affordable housing options and respecting the existing neighborhood scale.

Williamson Street Build Plan:

The Williamson Street Build Plan outlines the design guidelines for new construction within the plan limits. The site is located within Zone II of the plan which recommends residential use with a maximum three story height and a 1 story bonus for the inclusion of affordable housing. It also identifies several specific design principles and criteria including:

- Define the street edges
- Mend the gaps in the neighborhood fabric
- Integrate, connect and enclose public spaces
- Support a pedestrian / bike-friendly environment
- Open space should be visually connected to the rear yards
- A 16 foot rear yard setback with structured parking
- 70 square feet of open space per bedroom
- Off-street parking for a minimum of .75 stalls/dwelling unit

This redevelopment proposal meets the design standards set out in the East Rail Corridor and Williamson Street Build Plans. Several meetings with neighborhood representatives have been held and general support has been given to the project by the neighborhood board. A larger neighborhood meeting will be held in the near future to provide additional exchange with neighbors.

Letter of Intent – PUD-GDP-SIP 301 S. Ingersoll Street September 20, 2006 Revised: February 26, 2007 Page 3 of 4

Project Description:

The site plan was designed to create an urban, pedestrian-oriented streetscape. The two buildings in the development form both a street edge and a rear courtyard. The larger 52 unit four story building houses the community areas of the development and is located on the east end of the site. To provide a better transition to the residential neighbors, the building on the corner of Ingersoll and East Wilson is of a smaller scale with three stories and 24 units. The courtyard is linked to the future Central Park and has both hardscape areas for intensive use and landscaped green space for recreation, plantings and storm water management. The lower two floors of the buildings on the East Wilson Street façade will be two-story, 3-bedroom townhomes with individual entry porches.

The buildings are well articulated to maintain a residential scale and rhythm. Flat roofs are used to minimize the apparent building heights. The exterior materials are masonry in combination with composite wood siding. The siding will have varied deep colors for a striking façade and the masonry detailing will add to the substantial appearance.

Vehicular access to the underground parking garage is accommodated on the east end of the site. Visitor parking will be accommodated on-street. Currently, unrestricted parking is available on the north side of Wilson. The developer, with the neighborhood support, is requesting that the Wilson Street parking be posted as 2 hour parking to better accommodate the neighborhood and development needs. Adequate bicycle parking is provided in the parking garage and in the courtyard area on the site.

Site Development Data:

_			• •		
1 111/0	llina	I In	14	N /I i v ·	
Dwel	IIII ICI	UH	ш	IVIIX.	

Studios	7
One-Bedroom	23
One-Bedroom + Den	2
Two-Bedroom	34
Three-Bedroom Townhomes	<u>10</u>

Total dwelling Units 76

Densities:

Lot Area 41,464 SF or 1.06 acres

Lot Area / D.U. 611 SF/unit
Density 72 units/acre

Building Height: 3 and 4 Stories

Floor Area Ratio:

Total Floor Area (excluding parking) 84,240 SF

Floor Area Ratio 2.0

Vehicular Parking Standards (R-6)

Studios (7 X .50 /unit) 3.5 spaces
One Bedrooms (25 X 1.25 /unit) 31.25 spaces
Two Bedrooms (34 X 1.50 /unit) 51 spaces

Letter of Intent – PUD-GDP-SIP 301 S. Ingersoll Street September 20, 2006 Revised: February 26, 2007 Page 4 of 4

Three Bedrooms (10 X 1.75/unit) 17.5 spaces
Total Required Parking 103 spaces

Bicycle parking

Units 1-50 (1 space/unit) 50 spaces
Units 50 - 76 (.5 space/unit) 13 spaces
Total Required Parking 63 spaces

Provided Vehicular Parking Ratio:

Automobile parking (underground)

Bicycle parking (underground)

29 stalls or .4 stalls/unit

Bicycle parking (surface)

39 stalls or .5 stalls/unit

Loading;

Off-street loading will be provided for this project in the drive lane at the east end of the site.

Project Schedule:

It is anticipated that construction will start in the spring of 2006 and be completed in spring of 2008.

Social & Economic Impacts:

This development will have a positive social and economic impact. The development will substantially increase the city tax base on an infill site with minimal, if any, increased costs to the City. The redevelopment achieves the goals of Madison's adopted development plans and provides new affordable housing in the central city while promoting pedestrian, bicycle and mass-transit circulation.

Thank you for your time in reviewing our proposal.

Very Truly Yours,

J. Randy Bruce, AIA Managing Member

301 S. Ingersoll Street Demolition of Existing Buildings/Structures September 20, 2006







Project # 0555

Color Selections

301 S. Ingersoll Street Stonehouse Development

Presented at Final UDC Meeting: March 7, 2007

<u>Material</u>	Brand	Colors
52 Unit Building		
Trim	Sherwin Williams	Downing Sand (SW2822)
Siding	Sherwin Williams	Aurora Brown (SW2837)
Siding	Sherwin Williams	Renwick Golden Oak (SW2824)
Siding	Sherwin Williams	Rookwood Terra Cotta (SW2803)
Siding	Sherwin Williams	Rookwood Amber (SW2817)
Brick	Interpace Industries,Inc	Vera Cruz –King
Base Masonry Units	Arriscraft International	Pecan (Rocked)
Window heads, sills, banding	Arriscraft International	Pecan (Smooth)
Windows	to be determined	tan
Aluminum Railing	T.B.D.	Dark Bronze

24 Unit Building

Trim	Sherwin Williams	Natural Choice (SW7011)
Siding	Sherwin Williams	Roycroft Pewter (SW2848)
Siding	Sherwin Williams	Downing Earth (SW2820)
Brick	Interpace Industries,Inc	Cordova –King
Window heads, sills, bands	Arriscraft International	Pecan -smooth
Shingles	Owens Corning Oakridge Pro 40	Colonial Slate
Windows	to be determined	white
Aluminum Railing	T.B.D.	Dark Bronze

Zoning Text

PUD-SIP

301 S. Ingersoll Street September 20, 2006 Revised: January 02, 2007

Legal Description: The lands subject to this Planned Unit Development District shall include the lands described in Exhibit A.

- A. **Statement of Purpose:** This zoning district is established to allow for the construction of a residential development with 76 dwelling units.
- B. **Permitted Uses:** Following are permitted uses within this P.U.D.
 - 1. Multifamily residential uses as allowed in the R-6 zoning district.
 - 2. Accessory uses including but not limited to:
 - a. Accessory uses directly associated with those permitted uses including parking for residents and guests.
 - b. Temporary buildings for storage of building materials and equipment for construction purposes when on the same lot as a principle use for a period not to exceed the duration of such construction.
- C. *Lot Area*: As shown on the approved plans.
- D. *Height Regulations*: As shown on the approved plans.
- E. *Yard Regulations*: As shown on the approved plans.
- F. **Landscaping**: Site Landscaping will be provided as shown on the approved plans.
- G. *Usable Open Space Requirements*: Usable open space will be provided as shown on the approved plans.
- H. **Parking & Loading**: Off-street parking shall be provided as shown on the approved plans.
- I. *Family Definition*: The family definition shall coincide with the definition given in M.G.O. 28.03 for the R-6 zoning district.
- J. *Signage*: Signage will be allowed as per the R-6 zoning district as approved by the Urban Design Commission.
- K. *Alterations and Revisions:* No alteration or revision of this Planned Unit Development shall be permitted unless approved by the City Planning Commission, however, the Zoning Administrator may issue permits for minor alterations or additions which are approved by the Architectural Review Committee, Director Of Planning and Development and the alderperson of the district and are compatible with the concept approved by the City Planning Commission.