
APPLICATION FOR URBAN DESIGN COMMISSION REVIEW AND APPROVAL


AGENDA	ITEM	#_		
Project #_			-	

DATE SUBMITTED: October 12, 2005 UDC MEETING DATE: October 19, 2005	Action Requested Informational Presentation Initial Approval and/or Recommendation X Final Approval and/or Recommendation
ODE MEETING DATE.	The state of the s
PROJECT ADDRESS: 1433 Monroe Street	
ALDERMANIC DISTRICT: 5 (Robbie Webb	er)
OWNER/DEVELOPER (Partners and/or Principals) UW Credit Union	ARCHITECT/DESIGNER/OR AGENT: PLANNING Design Build, Inc.
3500 University Avenue	901 Deming Way, Suite 102
Madison, WI 53705	Madison, WI 53717
CONTACT PERSON: Lisa Aumann Address: PLANNING Design Bui 901 Deming Way, Sui Phone: 608-836-8055	te 102, Madison, WI 53717
Fax: 608-836-5818	- SAME SED
E-mail address: laumann@planningdes TYPE OF PROJECT: (See Section A for:)	ignbuild.com RECEIVED OCT 2005 OCT 400 Madison City of Madison Planning Unit
Planned Unit Development (PUD) General Development Plan (GDP)	Pianima
Specific Implementation Plan (SIP)	662321290
Planned Community Development (PCD)	
General Development Plan (GDP) Specific Implementation Plan (SIP)	
Planned Residential Development (PRD)	
New Construction or Exterior Remodeling in an	Urban Design District * (A public hearing is required as
well as a fee) School, Public Building or Space (Fee may be re	equired)
New Construction or Addition to or Remodeling	g of a Retail, Hotel or Motel Building Exceeding 50,000
Sq. Ft.	
Planned Commercial Site X Deferral from Plan Commission	- Recommendation Needed
(See Section B for:)	
New Construction or Exterior Remodeling in C4	1 District (Fee required)
(See Section C for:) R.P.S.M. Parking Variance (Fee required)	
(See Section D for:) Comprehensive Design Review* (Fee required) Street Graphics Variance* (Fee required)	
Other	•
	1- '- Advance of Marking Data'
*Public Hearing Required (Submission Deadline 3 Wee	
February 24, 2005 b. C:\Documents and Settings\bigch\Local Settings\Temp\ud	tcrevicwapprovalFeb05.doc

: 608-836-8055	ANTE 162
608-836-5818	a Marco
laddress: <u>laumann@planningd</u> esignbuild.co	
DJECT:	OCT 2005 City of Madison
for:)	CITY OF WIND UM
	Planin
	(COC 1792)
	- 6585Fe
d Community Development (PCD)	
d Residential Development (PRD)	strict * (A public hearing is required
	strict. (A public hearing is required
'enstruction or Addition to or Remodeling of a Retail Hote'	or Motel Building Exceeding 50,000
	1 of Moter Banang Encountry
	lation Needed
	action weeded.
	uired)
c for:)	
M. Parking Variance (Fee required)	
) F ₂)	
Graphics variance (rec required)	26
ng Required (Submission Deadline 3 Weeks in Advance of	Meeting Date)
p-C:\Documents and Settings\bigch\Local Settings\Temp\udcreviewapprovalFeb05.do	oc
	address: laumann@planningdesignbuild.co DIECT: for:) d Unit Development (PUD) General Development Plan (GDP) Specific Implementation Plan (SIP) d Community Development (PCD) General Development Plan (GDP) Specific Implementation Plan (SIP) d Residential Development (PRD) onstruction or Exterior Remodeling in an Urban Design Dia a fee) , Public Building or Space (Fee may be required) onstruction or Addition to or Remodeling of a Retail, Hotel d Commercial Site cral from Plan Commission – Recommend for:) onstruction or Exterior Remodeling in C4 District (Fee required) for:) M. Parking Variance (Fee required) for:) ethensive Design Review* (Fee required) Graphics Variance* (Fee required)

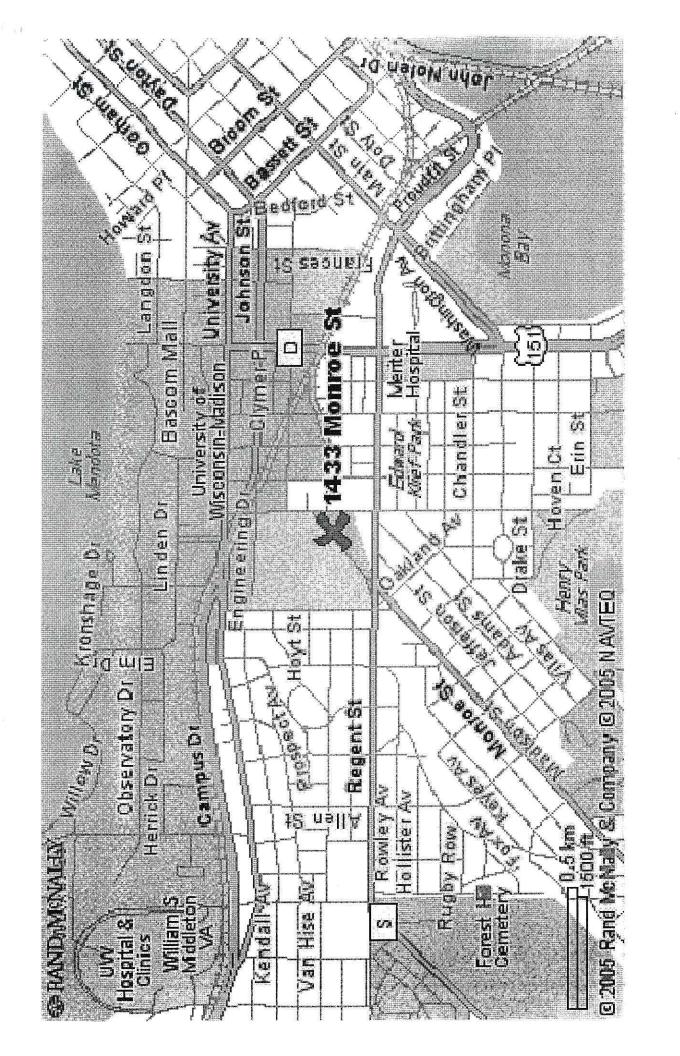

SITE LOCATION MAP OFANIANADA August 1 Computed to the state of the

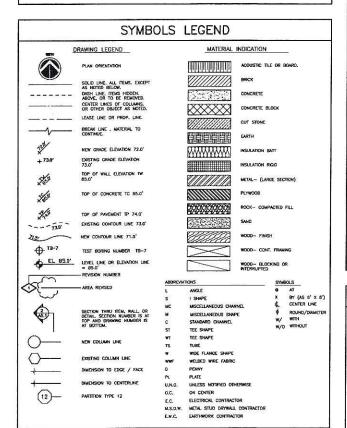


DESIGN—BUILDER PLANNING DESIGN BUILD, INC. 901 DEMING WAY, SUITE 102 MADISON, WISCONSIN 53717 PHONE: (608) 836–8055 FAX : (608) 836–5818

PROJECT DIRECTORY

CIVIL CONSULTANT TEAM ENGINEERING 240 MAIN STEET LOGANVILLE, WI 53943 PHONE: (608) 727-2146 FAX: (608) 727-2148 LANDSCAPING CONSULTANT
THE BRUCE COMPANY
2830 W. BETLINE HWY
MIDDLETON, WI 53562-0330
PHONE: (608) 836-7041
FAX : (608) 831-6266

UW CREDIT UNION MONROE STEET BRANCH

BUILDING CODE Project: 20040190 UWCU - Monroe Street Branch (602.5) Type VB - Any material permitted by code (304.1) Business Group B 2. Occupancy Type: 3. Allowable Height & Area (Table 503) Type VB = 40' maximum 4. Actual Height and Area: 1 story (16'-0") 3,774 GSF 5. Fire Resistive Ratings: (Tables 601 and 602) Type VB: Struct Framing: Bearing Walls: Non-Bearing Exterior Walls: Non-Bearing Interior Walls: <10' dist, = 1 hr, >10' dist, = 0 hr Any code permitted material 0 hr Floor Construction Roof Construction 6. Means of Egress (Table 1003.2.2.2) Floor area/ occupant Total = 3,774 GSF/100 GSF/Occ = 38 Occupants (1003.3.1.1) Egress door size 32" clear min. 48" max. (1004.2.1) 2 exits required (Table 1004.2.4) 200' Maximum travel distance (1004.2.5) Common path of travel 75' (1004.3.2.2) Minimum corridor width = 36" if >50 occupants (1004.3.2.3) A Use dead end max. 20' (Table1004.2.1) 2 exits 9. Drinking Fountain (Table 2902.1) One required. Drinking water provided at Coffee Station. 11. Fire Extinguishers: Per International Fire Code 12. Interior Finishes (Table 803.4) Sprinklered: Class C: Rooms & Enclosed spaces

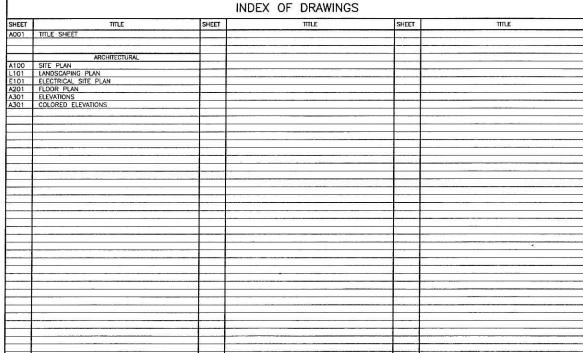


PLANNING DESIGN BUILD TEAM PLANNING Design Build, Inc. 901 Deming Way, Suita 10 Madison, WI 53717 **6**08.836.8055 **(3** 608.836.5818 planningdesignbuild.com STR Ш MONROE B Street UW Credit Union 3500 University Ave. Madison, WI 53744-4963 UNION 1433 Morr Madison, V CREDIT ≥ REVISION DATES: ISSUE DATES: This drawing shall be used for fabrication, erection and/or installation. Check all project addenda and construction bulletins for modifications. PROJECT #: 20040190

> PLOT DATE: 10/12/2005 SHEET NUMBER

> > A001


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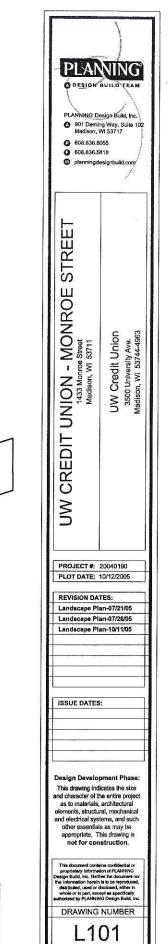
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PLANNING O DESIGN BUILD TEAM PLANNING Design Build, Inc. 901 Deming Way, Suite 107
 Madison, WI 53717 608.836,8055 608.836.5818 planningdesignbuild.com STREET UNION - MONROE 1433 Monroe Street Madison, WI 53711 CREDIT M REVISION DATES: ISSUE DATES: This drawing shall be used for fabrication, erection and/or installation. Check all project addenda and construction bulletins for modifications. PROJECT#: 20040190 PLOT DATE: 10/12/2005 SHEET NUMBER A100

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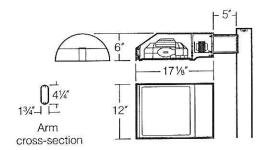


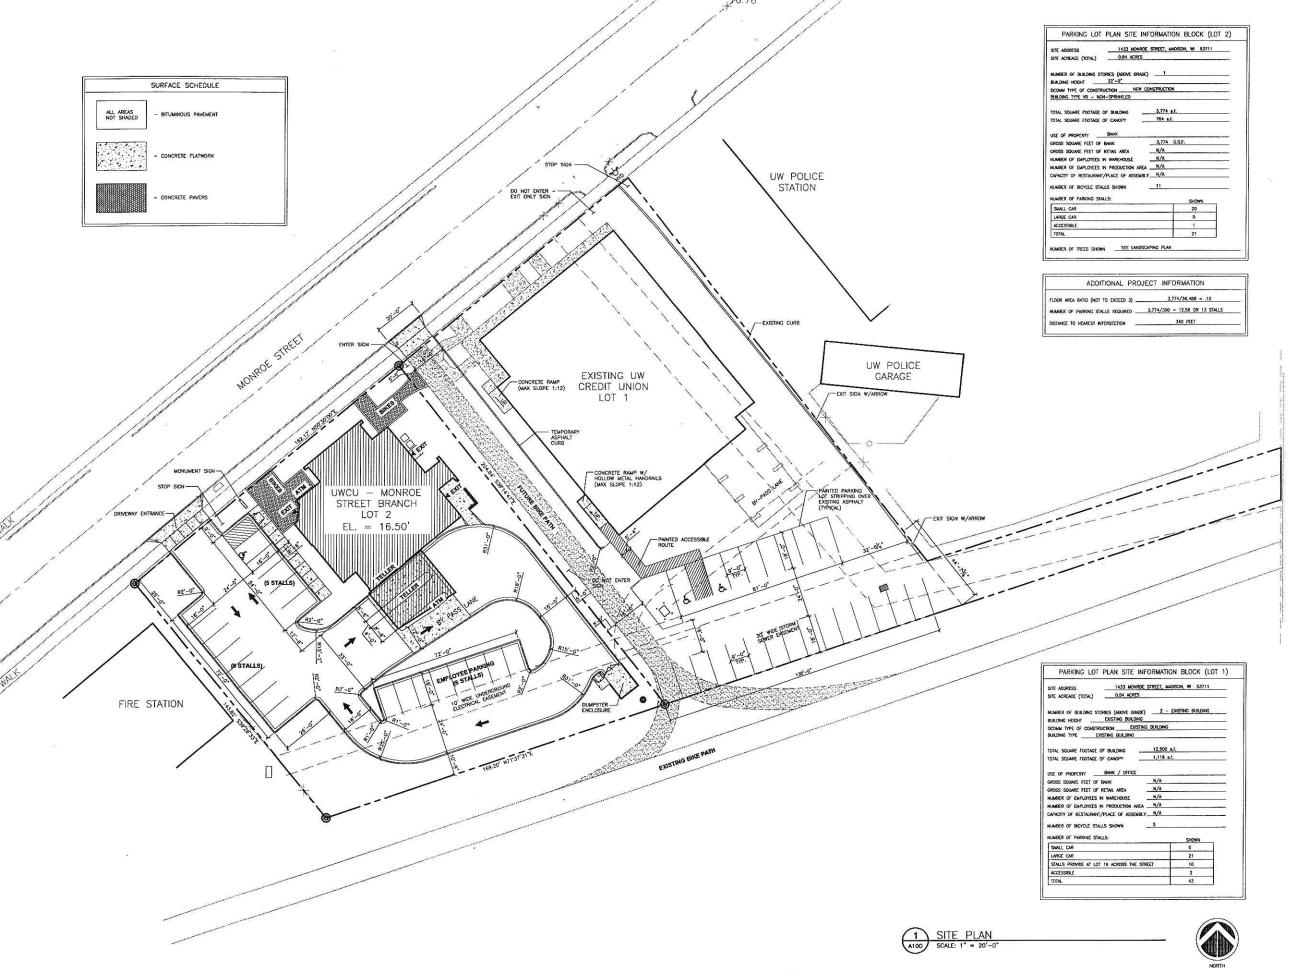The Archetype® revision 3/17/03 • sar.pdf

Type: Sobre Catalog number:						Approvals:
	1	Ĩ	1	ſ	1	
Mtg.	Fixture	Electrical Module See page 2	Finish	Options See pages 3-4	Optional Vertical Slipfitter Mount	
Sele	ct pole fro	10. 1952	og. If pol	e is provided by others indicate O.D. for arm fitting.	See page 5	Date: Page: 1 of 5

Specifications

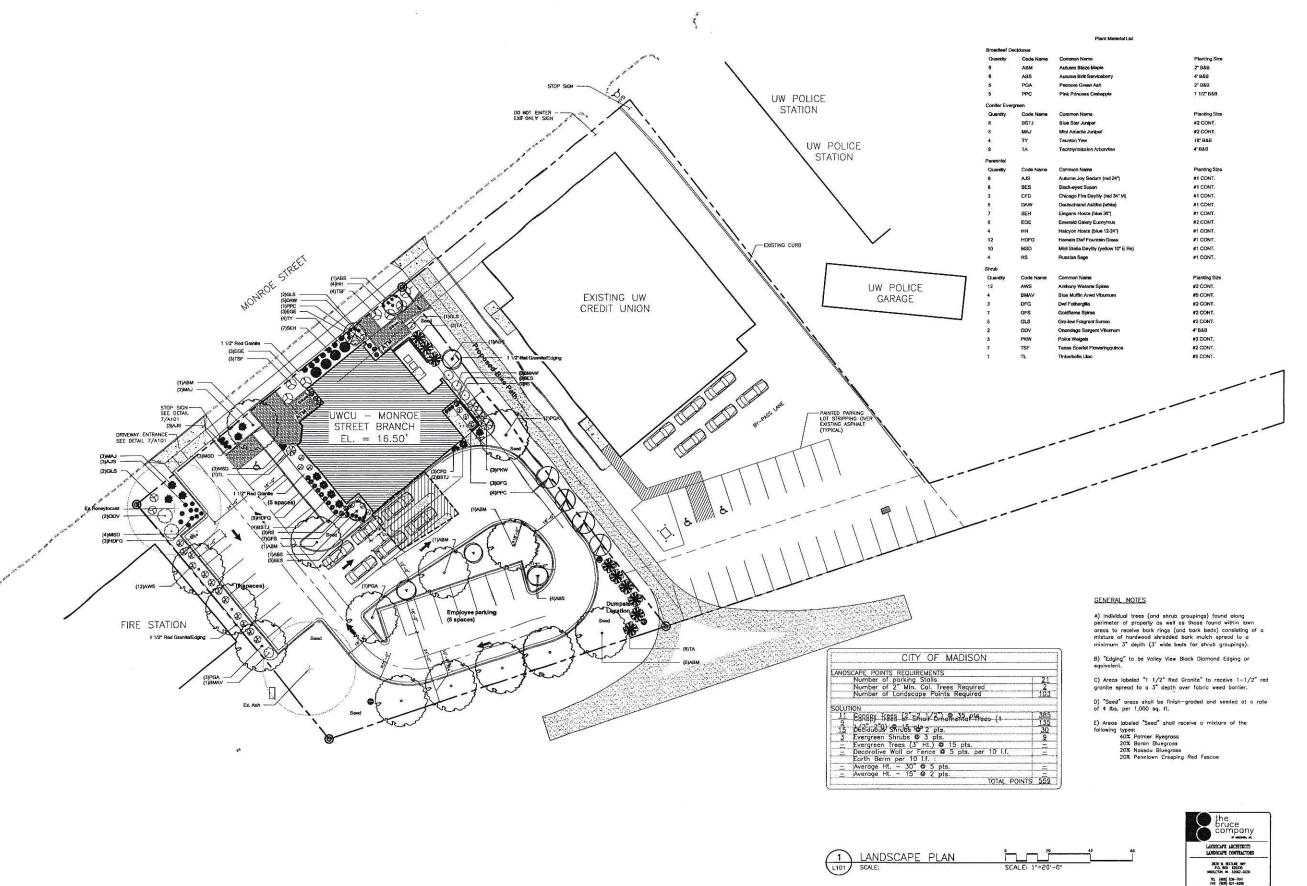70 to 175 watt Medium Base Lamps Maximum Fixture weight (150HPS) = 25 lb



Housing: One piece low copper (less than .6%) die-cast aluminum alloy with integral cooling ribs over the optical chamber and electrical compartment. Solid barrier wall separates optical and electrical compartments. Double-thick wall with gussets on the support-arm mounting end. The fixture's housing forms a half cylinder with 58° front face plane providing a recess to allow a flush single-latch detail. All hardware is stainless steel or electro-zinc plated steel.

Lens Frame: One piece low copper (less than .6%) die-cast aluminum alloy lens frame with 1" minimum depth around the gasket flange. Integral hinges with stainless steel pins provide no-tool mounting and removal from housing. Single die-cast aluminum cam-latch provides positive locking and sealing of the optical chamber by a one piece extruded and vulcanized silicone gasket. Clear 3/16" thick tempered glass lens retained by eight steel clips with full silicone gasketing around the perimeter.

Reflector Module: Specular Alzak® optical segments are rigidly mounted within a die-cast aluminum enclosure that attaches to the housing as a one-piece module. Reflector module is field rotatable in 90° increments. MH and HPS sockets are porcelain 4KV pulse rated medium base. All reflector modules are factory prewired with quick-disconnect plug and include silicone seal at the penetration of the internal barrier wall in the luminaire housing.

Electrical Module: All electrical components are UL and CSA recognized, mounted on a single plate and factory prewired with quick-disconnect plugs. Electrical module attaches to housing with no-tool hinges and latches, accessible by opening the lens frame only. All ballasts are high power factor rated -20°F. starting.

Support Arm: One piece extruded aluminum with internal bolt guides and fully radiussed top and bottom. Luminaire-to-pole attachment is by internal draw bolts, and includes a pole reinforcing plate with wire strain relief. Arm is circular cut for specified round pole.

Optional Wall Mounting: Fixture mounts to 3" or 4" Junction Boxes by a cast aluminum adapter plate with fixture mounting bolts.

NOTE: Junction Box in wall must provide adequate fixture support. See NEC sections 370-13, 17 and 410-14, 16. Quick-disconnect plug and wiring are provided to allow field connections prior to fixture

Finish: Super TGIC thermoset polyester powder coat paint, 2.5 mil nominal thickness, applied over a chromate conversion coating; 2500 hour salt spray test endurance rating. Standard colors are Black, Dark Bronze, Light Gray, Platinum Silver, or White. Custom colors are available and subject to additional charges, minimum quantities and longer lead times. Consult representative.

Certification: UL Listed to U.S. and Canadian safety standards for wet locations. Fixture manufacturer shall employ a quality program that is certified to meet the ISO 9001:2000 standard.

CAUTION: Fixtures must be grounded in accordance with local codes or the National Electrical Code. Failure to do so may result in serious



	personal injury.	Thay Toolie III ou
Hubbell Lighting, Inc.		
1003 KIM LIGHTING INC. • P.O. BOX 60080, CITY OF INDUSTR	RY, CA 91716-0080 • TEL: 626/968-5666 • FAX: 626/369-2695	5600503



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	У	۲	C	
	-0	000		

Job:

Page: 2 of 5



Standard Features

Mounting	Plan View:					A A		Wall Mount
3SY configuration is available for round poles only.				L				
	EPA:	0.7	1.4	1.2	1.9	1.9	2.5	
	Cat. No.: 🔰	(1SA	□2SB	☐ 2SL	□3ST	☐3SY	☐4SC	□ 1W
Fixture Cat. No. designates fixture and light distribution. See the Kim Site/Roadway	Flat Lens	The state of the s				(,	(i)	$\left[\times\right]$
Optical Systems Catalog for detailed information on reflector design and	Light Distribu	ution:	Type II		Type III	Tyr Forwar	oe IV d Throw	Type V Square
application.			Full Cutoff		Full Cutoff		Cutoff	Full Cutof
1 1	Cat. No.:		□ SAR2	!	X \$AR3		SAR4	☐SAR5
Electrical Module HPS = High Pressure Sodium MH = Metal Halide	Cat. Nos. for		al Modules a PS120 PS208 PS240 PS277 PS347		IPS120 IPS208 IPS240 IPS277 IPS347	150HPS1 150HPS2 150HPS2 150HPS2	208 240 277	
	Lamp	ED-17,	. Clear	ED-17,	Clear	ED-17, Clea	ır	
	Socket	Mediu	m Base	Mediur	n Base	Medium Bas	se	
	ANSI Ballast Type	S-62		S-54		S-55		
Lamp Lamp Line Watts Type Volts 150 HPS 120	Type	70N 70N 70N 70N 70N	IH208 IH240 IH277	100M	ЛН208 ЛН240 ЛН277	150MH12 150MH20 150MH24 150MH27	08	175MH120 175MH208 175MH240 175MH277 175MH347
	Lamp	ED-17,	Clear	ED-17,	Clear	ED-17, Clea	r El	D-17, Clear
	Socket	Mediu	m Base	Mediur	n Base	Medium Bas	se M	ledium Base
	ANSI Ballast Type	M-98		M-90		M-102	Ν	i-5 <i>7</i>
Finish Super TGIC powder coat paint over a chromate conversion coating.	Cat. No.:	ors subje	Dark Bronz DB-P ect to addition c. Custom c	□ LG onal char	ges, minimu		□WH-P	Custom Color CC-P ded lead times

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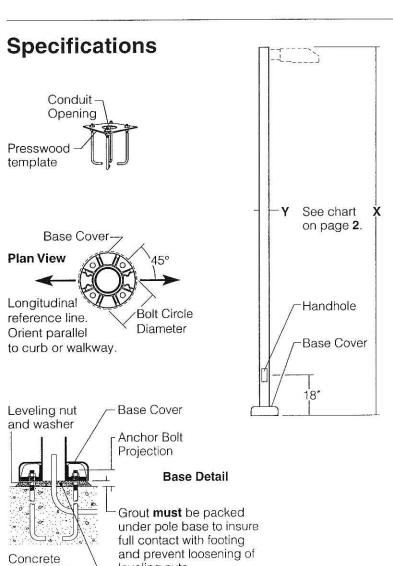


SAR, SET fixtures only

Round Aluminum Non-Tapered Pole

revision 8/1/99 • prasar.pdf

Type: Job: Catalog number:					Approvals:
	1	1	1	1	
Pole Cat. No.	Mounting	Pole Finish	Optional Hinged Base	Optional Duplex Receptacle	
L See p	page 2		Se	ee page 3	Date: Page: 1 of 4



leveling nuts.

Provide a channel through

the grout for drainage from the pole interior.

footing to be designed by

others.

Pole Construction: Seamless round extruded aluminum tube of alloy 6063-T6, welded at top and bottom of aluminum base casting of alloy 356.

Base Cover: Base has a two piece cast aluminum full cover of 319 alloy, secured by stainless steel screws.

Pole Cap: A flush-sided cast aluminum pole cap is provided.

Handhole: 18" up from base, with a gasketed cover and ground lug. Poles with a 3%" O.D. include a handhole reinforcement casting welded in place.

Anchor Bolts: Four galvanized anchor bolts provided, complete with eight nuts, eight flat washers, and a presswood template.

Strength: Poles will withstand wind loads as listed in chart (see page **2**) when luminaires are mounted per fixture installation instructions.

Finish: Super TGIC thermoset polyester powder coat paint applied over a chromate conversion coating. Standard colors are Black (**BL-P**), Dark Bronze (**DB-P**), Light Gray (**LG-P**), Platinum Silver (**PS-P**), and White (**WH-P**). Custom colors are available.

CAUTION: Do not install poles without luminaires or strength guarantee is voided. Any unauthorized accessories secured to pole shall void strength guarantee.

Maintenance: A regularly scheduled maintenance program must be established to insure the protective paint coating is intact, corrosion or structural damage has not occurred, and anchor bolt nuts are tight. Failure to do so could lead to eventual pole collapse and serious personal injury.

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SAR, SET fixtures only

Round Aluminum Non-Tapered Pole revision 8/1/99 • prasar.pdf

Type: Job:											Date Page	: e: 2 of 4
Standard	Fe	eatu	res	x Drag Fa Highway	l allowable pole actor) are derive and Transporta tion based on I	ed from the tion Officia	: AASHTO ıls). Respor	standa nsibility	ırd (Ame Ties witl	rican A h the sp	nich is Fix ssociatior pecifier fo	ture Area of State or correc
Pole Catalog No.				•				Allow	able Po	le EPA		
Pole				olt Anchor	Azaban	Base	Conduit	S	nd Map teady Vind		– Gusting Wind Equivale	
Catalog Number	X	Υ	14 OF 0	cle Bolt ia. Projectio	Anchor n Bolts	Cover Size	Opening	170/91	80 /104	90/117	100 /130	110/14
	10'	33/8" x	100,000,000	" 31/8"	³ / ₄ " x 15" + 3"	9½" dia.	21/2" dia.	5.6	3.9	2.8	1.7	1.3
☐ PRA10-34125**	10′ 12′	3% X		378 7″ 31⁄8″	$\frac{3}{4}$ x 15" + 3"	9½" dia.	2½" dia.	7.4	5.3	3.8	2.7	1.9
☐ PRA12-34188**	14'	33/8" X		7″ 31/8″	$\frac{3}{4}$ x 15" + 3"	9½" dia.	21/2" dia.	5.8	3.9	2.7	1.7	0.8
☐ PRA14-34188**	14'	4" x .			$\frac{3}{4}$ x 15" + 3"	11%" dia.	3" dia.	8.9	6.2	4.4	3.2	2.5
☐ PRA14-4188**	16′	4 x . 4" x .		/2 3/4 /2" 3/4"	³ / ₄ " x 30" + 4"	11% dia. 11%" dia.	3" dia.	6.9	4.6	3.1	2.1	1.6
☐ PRA16-4188 ★PRA20-4188				/2 3/4 /2" 31/4"	³ / ₄ " × 30" + 4"	11% dia. 11%" dia.	3" dia.	4.0	2.3	1.1	<u></u>	
	19.5' 19.5'			/2 3/4 /2" 31/4"	3/4" x 30" + 4"	11% dia.	3" dia.	7.6	5.1	3.7	2.8	2.2
**Optional hinged Mounting Arrang *Allowable pole jobsite wind comust be equal to than fixture moun	eme EPA condi	nts for tions reater	Moun	Plan Viev		□ SB	L		□ ST	•	SY	□sc
man mare moun			-	ixture and								
			SAR SET	ixture and	0.7 1.0	1.4 2.0	1.2 1.5		1.9 2.4		1.9 2.2	2.5 2.7
Finish Super TGIC powder coat paint over a chromate conversion coating.		Color: Cat. N Color: Cat. N	lo.: XBI *Cus			Light Gray □ LG-P		latinum] PS-P	Silver	White □ WH	-P	
			* Cust	om colors su	ubject to addition	onal charge color desci	es, minimu ription:	m quar	ntities an	d exten	ded lead	times.

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SAR, SET fixtures only

Round Aluminum Non-Tapered Pole revision 8/1/99 • prasar.pdf

Type: Job:		The second secon	Page: 3 of 4
Optional Featu	res		
Optional Hinged Base Cat. No.	Optional hinged base available for SA and SB mount poles up to 14 feet only. The use of hinged bases requires some pre-planning so poles hinge in the right direction, as dictated by the surrounding environment.	Hinging Directions	$X1$ \uparrow \rightarrow $Y2$ \downarrow SA mount $X2$ $X1$ \uparrow \rightarrow $Y2$ \downarrow SB mount $X2$
Optional Duplex Receptacle Cat. No.	Mounted opposite the handhole, at 22½" from base of internally welded and sealed with a gasketed self-closing Duplex Receptacle (DR) rated 15A, 125V Duplex Receptacle with Ground Fault Circuit Interru	cover and lockin	g bracket.

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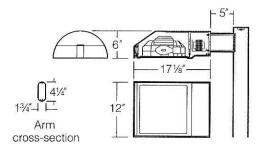


The Archetype[®] revision 3/17/03 • sar.pdf

	oe: o: talog i	2 number:				Approvals:
	1	Ĩ	1	I	T	
Mtg.	Fixture	Electrical Module	Finish	Options	Optional	
		- See page 2		See pages 3-4	Vertical Slipfitter Mount See page 5	Date:
Selec	t pole fro	m Kim Pole Catal	og. If pol	e is provided by others indicate O.D. for arm fitting.		Page: 1 of 5

Specifications

70 to 175 watt Medium Base Lamps Maximum Fixture weight (150HPS) = 25 lb



Housing: One piece low copper (less than .6%) die-cast aluminum alloy with integral cooling ribs over the optical chamber and electrical compartment. Solid barrier wall separates optical and electrical compartments. Double-thick wall with gussets on the support-arm mounting end. The fixture's housing forms a half cylinder with 58° front face plane providing a recess to allow a flush single-latch detail. All hardware is stainless steel or electro-zinc plated steel.

Lens Frame: One piece low copper (less than .6%) die-cast aluminum alloy lens frame with 1" minimum depth around the gasket flange. Integral hinges with stainless steel pins provide no-tool mounting and removal from housing. Single die-cast aluminum cam-latch provides positive locking and sealing of the optical chamber by a one piece extruded and vulcanized silicone gasket. Clear ¾6" thick tempered glass lens retained by eight steel clips with full silicone gasketing around the perimeter.

Reflector Module: Specular Alzak® optical segments are rigidly mounted within a die-cast aluminum enclosure that attaches to the housing as a one-piece module. Reflector module is field rotatable in 90° increments. MH and HPS sockets are porcelain 4KV pulse rated medium base. All reflector modules are factory prewired with quick-disconnect plug and include silicone seal at the penetration of the internal barrier wall in the luminaire housing.

Electrical Module: All electrical components are UL and CSA recognized, mounted on a single plate and factory prewired with quick-disconnect plugs. Electrical module attaches to housing with no-tool hinges and latches, accessible by opening the lens frame only. All ballasts are high power factor rated -20°F. starting.

Support Arm: One piece extruded aluminum with internal bolt guides and fully radiussed top and bottom. Luminaire-to-pole attachment is by internal draw bolts, and includes a pole reinforcing plate with wire strain relief. Arm is circular cut for specified round pole.

Optional Wall Mounting: Fixture mounts to 3" or 4' Junction Boxes by a cast aluminum adapter plate with fixture mounting bolts.

NOTE: Junction Box in wall must provide adequate fixture support. See NEC sections 370-13, 17 and 410-14, 16. Quick-disconnect plug and wiring are provided to allow field connections prior to fixture mounting.

Finish: Super TGIC thermoset polyester powder coat paint, 2.5 mil nominal thickness, applied over a chromate conversion coating; 2500 hour salt spray test endurance rating. Standard colors are Black, Dark Bronze, Light Gray, Platinum Silver, or White. Custom colors are available and subject to additional charges, minimum quantities and longer lead times. Consult representative.

Certification: UL Listed to U.S. and Canadian safety standards for wet locations. Fixture manufacturer shall employ a quality program that is certified to meet the ISO 9001:2000 standard.

CAUTION: Fixtures must be grounded in accordance with local codes or the National Electrical Code. Failure to do so may result in serious personal injury.



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Type:

Job:

Page: 2 of 5



Standard Features

Mounting 3SY configuration is available for round poles only.	Plan View:	-		Ţ,				Wall Mount
	EPA:	0.7	1.4	1.2	1.9	1.9	2.5	
	Cat. No.:]1SA	X 2SB	☐ 2SL	☐ 3ST	☐3SY	☐ 4SC	□ 1W
Fixture Cat. No. designates fixture and light distribution. See the Kim Site/Roadway Optical Systems Catalog for detailed information on reflector design and application.	Flat Lens Light Distrib Cat. No.:	ution:	Type I Full Cut	off	Type III Full Cutoff	Forward Full (e IV d Throw Cutoff AR4	Type V Square Full Cutoff
	Control of the Contro	Programmes	W-13-11		1 10/110	/ <		- 18.54.435
Electrical Module HPS = High Pressure Sodium MH = Metal Halide Lamp Lamp Line Watts Type Volts 150 HPS 120	Cat. Nos. for Lamp Socket ANSI Ballasi Type	70h	HPS120 HPS208 HPS240 HPS277 HPS347 7, Clear Jum Base	☐ 100 ☐ 100 ☐ 100 ☐ 100 ☐ 100 ☐ ED-17, Mediu: S-54	HPS208 HPS240 HPS277 HPS347 Clear m Base	150HPS1 150HPS2 150HPS2 150HPS3 150HPS3 ED-17, Clea Medium Bas S-55	208 440 277 447 ree	175MH120 175MH208
		701	VIH240 VIH277 VIH347	5 100	MH240 MH277 MH347	☐ 150MH24 ☐ 150MH27 ☐ 150MH34	7 🛚	175MH240 175MH277 175MH347
	Lamp		7, Clear	ED-17		ED-17, Clea		D-17, Clear
	Socket		um Base		m Base	Medium Bas	are a later to	edium Base
	ANSI Ballasi Type		S. S	M-90		M-102	M	-57
Finish Super TGIC powder coat paint over a chromate conversion coating.	Color: B Cat. No.:	lack (BL-P lors sub	Dark Bron DB-P ject to addi ive. Custom	TLO	G-P □P	ım quantities	□WH-P	Custom Color ¹ CC-P ded lead times.



SAR, SET fixtures only

Round Aluminum Non-Tapered Pole

revision 8/1/99 • prasar.pdf

Type: Job: Catalog number:		9			Approvals:
	1	I	1	1	
Pole Cat. No.	Mounting	Pole Finish	Optional Hinged Base	Optional Duplex Receptacle	
See	page 2 ————		Se	e page 3	Date: Page: 1 of 4

Specifications Conduit -Opening Presswood template See chart on page 2. Base Cover-Plan View Longitudinal Handhole reference line. Diameter Orient parallel -Base Cover to curb or walkway. -Base Cover Leveling nut and washer Anchor Bolt Projection **Base Detail** Grout **must** be packed under pole base to insure full contact with footing

and prevent loosening of

Provide a channel through

the grout for drainage from the pole interior.

leveling nuts.

Concrete

others.

footing to be designed by

Pole Construction: Seamless round extruded aluminum tube of alloy 6063-T6, welded at top and bottom of aluminum base casting of alloy 356.

Base Cover: Base has a two piece cast aluminum full cover of 319 alloy, secured by stainless steel screws.

Pole Cap: A flush-sided cast aluminum pole cap is provided.

Handhole: 18" up from base, with a gasketed cover and ground lug. Poles with a 3%" O.D. include a handhole reinforcement casting welded in place.

Anchor Bolts: Four galvanized anchor bolts provided, complete with eight nuts, eight flat washers, and a presswood template.

Strength: Poles will withstand wind loads as listed in chart (see page **2**) when luminaires are mounted per fixture installation instructions.

Finish: Super TGIC thermoset polyester powder coat paint applied over a chromate conversion coating. Standard colors are Black (**BL-P**), Dark Bronze (**DB-P**), Light Gray (**LG-P**), Platinum Silver (**PS-P**), and White (**WH-P**). Custom colors are available.

CAUTION: Do not install poles without luminaires or strength guarantee is voided. Any unauthorized accessories secured to pole shall void strength guarantee.

Maintenance: A regularly scheduled maintenance program must be established to insure the protective paint coating is intact, corrosion or structural damage has not occurred, and anchor bolt nuts are tight. Failure to do so could lead to eventual pole collapse and serious personal injury.

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5604199213

SAR, SET fixtures only

Round Aluminum Non-Tapered Pole

Type:											Date:	!
Job:			terior.		7.5						Page	: 2 of 4
Standard	Fe	ature	S	x Drag Fad Highway a	allowable pole ctor) are derive and Transporta tion based on I	ed from the tion Officia	AASHTO ls). Respor	standa sibility	rd (Ame lies witl	rican As n the sp	ssociation ecifier for	of State r correct
Pole Catalog No.								Allow	able Po	le EPA		
Pole Catalog	X	Y	Bolt Circle	Anchor Bolt	Anchor	Base Cover	Conduit	St	id Map - eady Vind		- Gusting Wind Equivaler	
Number	5.Ns	1.5%		Projection	8 1105-300-70	Size	Opening	70 /91	80 /104	90 /117	100 /130	110 /143
☐ PRA10-34125**	10′	3¾" x .125	7″	31/8"	³ / ₄ " × 15" + 3"	91/2" dia.	21/2" dia.	5.6	3.9	2.8	1.7	1.3
☐ PRA12-34188**	12'	3%" x .188	7"	31/8"	$\frac{3}{4}$ " × 15" + 3"	9½" dia.	21/2" dia.	7.4	5.3	3.8	2.7	1.9
☐ PRA14-34188**	14'	3¾″ x .188	7"	31/8"	$\frac{3}{4}$ " × 15" + 3"	91/2" dia.	21/2" dia.	5.8	3.9	2.7	1.7	0.8
PRA14-4188**	14'	4" x .188	81/2"	31/4"	$\frac{3}{4}$ " x 15" + 3"	11 1/8" dia.	3" dia.	8.9	6.2	4.4	3.2	2.5
PRA16-4188	16'	4" x .188	81/2"	31/4"	$\frac{3}{4}$ " $\times 30$ " $+ 4$ "	11%" dia.	3" dia.	6.9	4.6	3.1	2.1	1.6
EPRA20-4188	19.5′	4" x .188	81/2"	31/4"	$\frac{3}{4}$ " x 30" + 4"	11%" dia.	3" dia.	4.0	2.3	1.1		-
PRA20-5188	19.5	5" x .188	81/2"	31/4"	$\frac{3}{4}$ " x 30" + 4"	11%" dia.	3" dia.	7.6	5.1	3.7	2.8	2.2

Mounting Arrangements *Allowable pole EPA for jobsite wind conditions must be equal to or greater than fixture mount EPA.	Plan Views:	-		↓	—		
	Mounting:	SA	X SB	□ SL	□ST	□ SY	□sc
	Kim Fixture and EPA: SAR SET	0.7 1.0	1.4 2.0	1.2 1.5	1.9 2.4	1.9 2.2	2.5 2.7
Finish Super TGIC powder coat paint over a chromate conversion coating.	Color: Black Cat. No.: BL-P Color: *Custom Color: Cat. No.: CC-P * Custom colors subject Consult representative.	to additio	nal charges,		Platinum S PS-P	□W	′Н-Р

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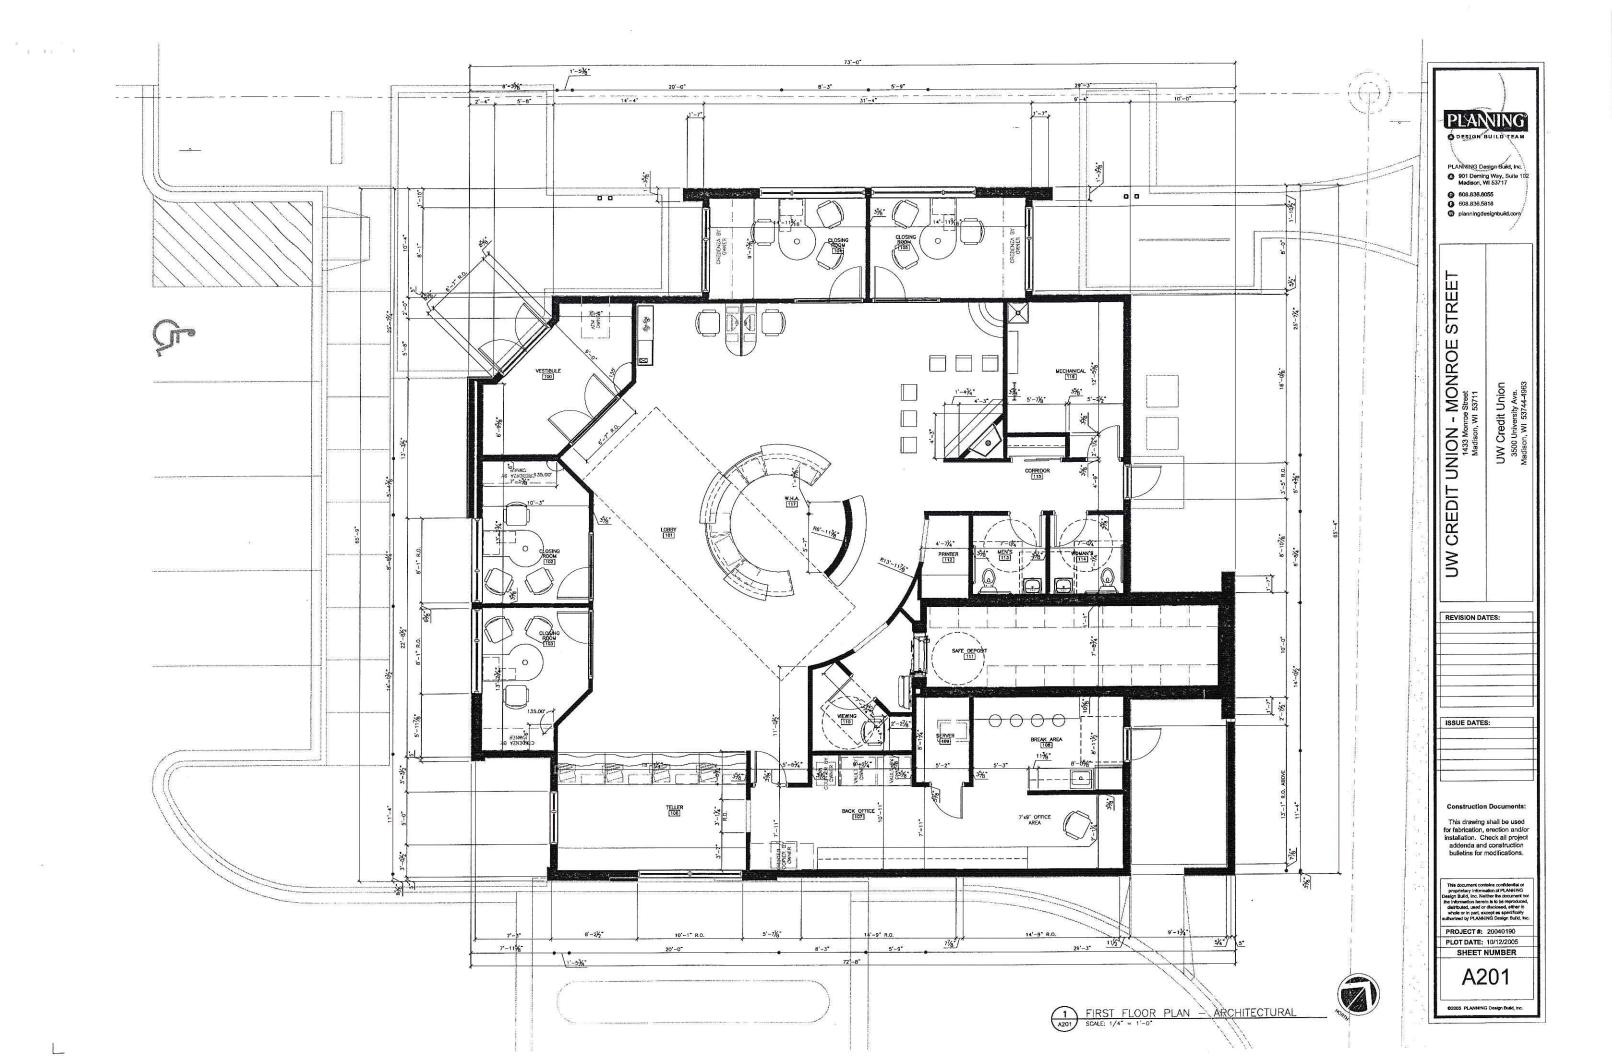



SAR, SET fixtures only


Round Aluminum Non-Tapered Pole revision 8/1/99 • prasar.pdf

Type: Job:			Date: Page: 3 of 4
Optional Featu	res		
Optional Hinged Base Cat. No.	Optional hinged base available for SA and SB mount poles up to 14 feet only. The use of hinged bases requires some pre-planning so poles hinge in the right direction, as dictated by the surrounding environment.	Hinging Directions	X1 \uparrow \rightarrow Y2 \downarrow SA mount X2 X1 \uparrow \rightarrow Y2 \downarrow SB mount X2
Optional Duplex Receptacle Cat. No. DR DR-GFI No Option	Mounted opposite the handhole, at 22½" from base of internally welded and sealed with a gasketed self-closing Duplex Receptacle (DR) rated 15A, 125V Duplex Receptacle with Ground Fault Circuit Interru	cover and locking	g bracket.


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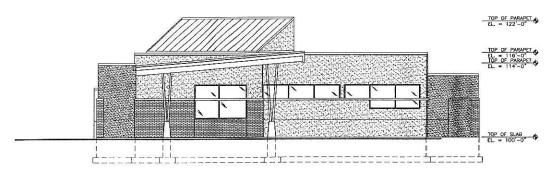
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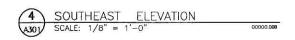
NORTHWEST ELEVATION


SCALE: 1/8" = 1'-0" 00000.000

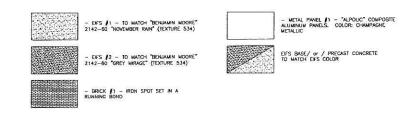

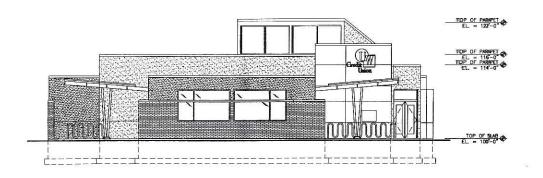




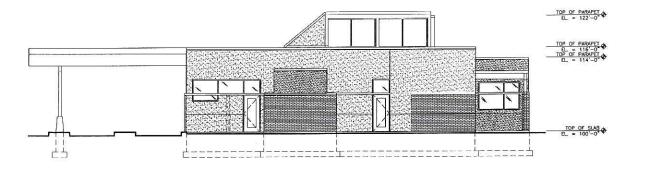


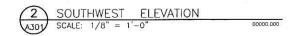


PLANVING" O DESIGN BUILD TEAM PLANNING Design Build, Inc. 901 Deming Way, Suite 102 Madison, WI 53717 608.836.8055 608.836.5818 STREET UNION - MONROE 1433 Monroe Street Madison, WI 33711 UW Credit Union 3500 University Ave. Madison, WI 53744-4963 CREDIT (M REVISION DATES: ISSUE DATES: Schematic Design Phase: This drawing indicates the scale and relationship of the project components. This drawing is not for construction. PROJECT#: 20040190 PLOT DATE: 10/12/2005 SHEET NUMBER A301


Application made for LEED-NC 2.1

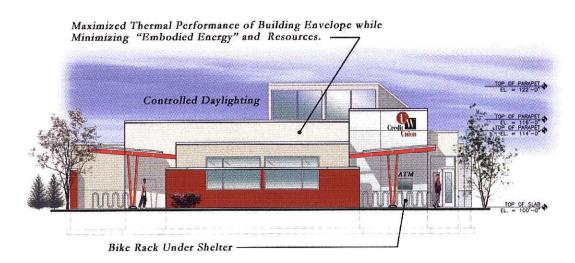

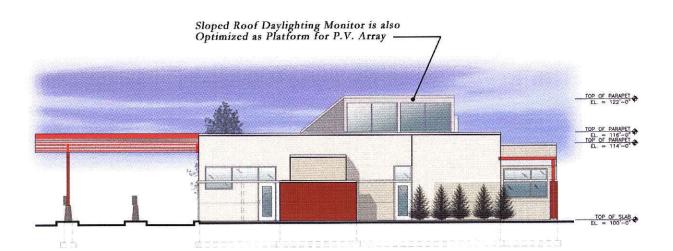

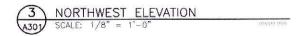




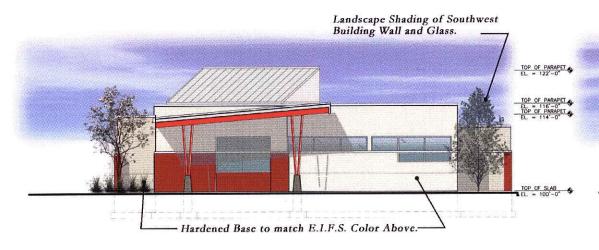





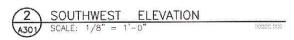



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SHEET NUMBER A301

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