
MCKEE ROAD MIXED USE DEVELOPMENT

6701 MCKEE ROAD MADISON, WISCONSIN 53719



CITY OF MADISON LAND USE AND URBAN DESIGN COMMISSION SUBMITTAL

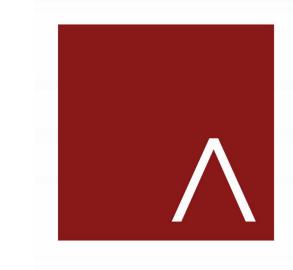





OCTOBER 18, 2024

JLA PROJECT NUMBER:

W22-0201

McKEE ROAD MIXED-USE DEVELOPMENT BUILDING A1

October 7, 2024



	UNIT NAME		STUDIO		1 BEDI	ROOM	2 BEDROOMS	AL S	AL MS	ERCIAL IREA ABLE	TAL FA	SS .F.)	ζ	ð .	ច	8 S	<u>ত</u>	_
		A1	A2	А3	B1	B2	D1	ρĦ	000	MER ARI SAB	ARE SAB	A (S	Ë	RKIN A (S	VERED	RKIN	RKIN	ĕI
	BEDROOMS	1	1	1	1	1	2	[E]	(C) T	OM. NET	E NET ESI	(3) G AREA	EFFICI	PA!	PAF	SUR	A	≥
	AREA (S.F.)	558	559	584	718	680	1,249		- 8	ŭ	~	~ ∢	1 11	⋖	1		2) :	
R	3RD	2	1	4	9	2	4	22	26	=	16,829	19,460	86.5%					
0	2ND	2	1	4	9	2	4	22	26	-	16,829	19,460	86.5%			9	RETAIL	RATIO
0	1ST	2	0	3	9	2	0	16	16	and the same of th	10,690	19,460	54.9%			19	7.6	PER 1K SF
FL	LL			:						2,500	-	24,628	10.2%	21,350	54	18	PER UNIT	PER BR
	TOTALS	6	2	11	27	6	8	60	68	2,500	44,348	83,008	53.4%	21,350	54	18	1.20	1.06
		10.0%	3.3%	18.3%	45.0%	10.0%	13.3%											

739 Average N.S.F. per unit 973 Average G.S.F per unit 395 Average S.F. per space

McKEE ROAD MIXED-USE DEVELOPMENT BUILDING A2

31.7%


55.0%

49.2%

13.3%

18.5%

October 7, 2024

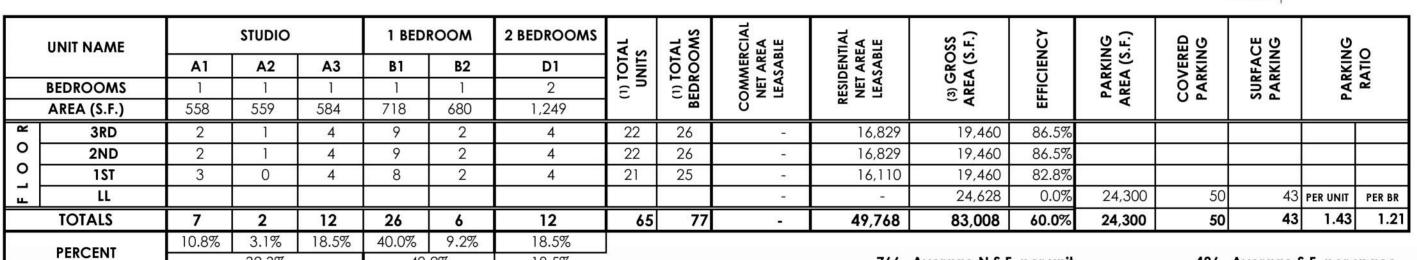


766 Average N.S.F. per unit 898 Average G.S.F per unit 486 Average S.F. per space

NOTES

1 TOTAL UNIT & BEDROOM COUNT ASSUMES IDENTICAL FOOTPRINT FROM FLOORS 2 & 3.

- 2 TABLE ABOVE ASSUMES 3,500 S.F. (+/-) OF COMMON AMENITY SPACE ON 1st FLOOR. ADDITIONAL COMMON AMENTIY SPACE WOULD REDUCE NET LEASABLE S.F. OF THE BUILDING.
- **3** GROSS AREA DOES NOT INCLUDE PARKING AREAS.
- 4 1st FLOOR IN EACH BUILDING CONTAINS THE MAIN ENTRY LOBBY AT MID-LEVEL.
- 5 PARKING AREAS INCLUDE THE STAIRS & ELEVATOR.
- 6 LOWER LEVEL GROSS SQUARE FOOTAGE IS DIVIDED EQUALLY BETWEEN BUILDINGS A1 & A2.

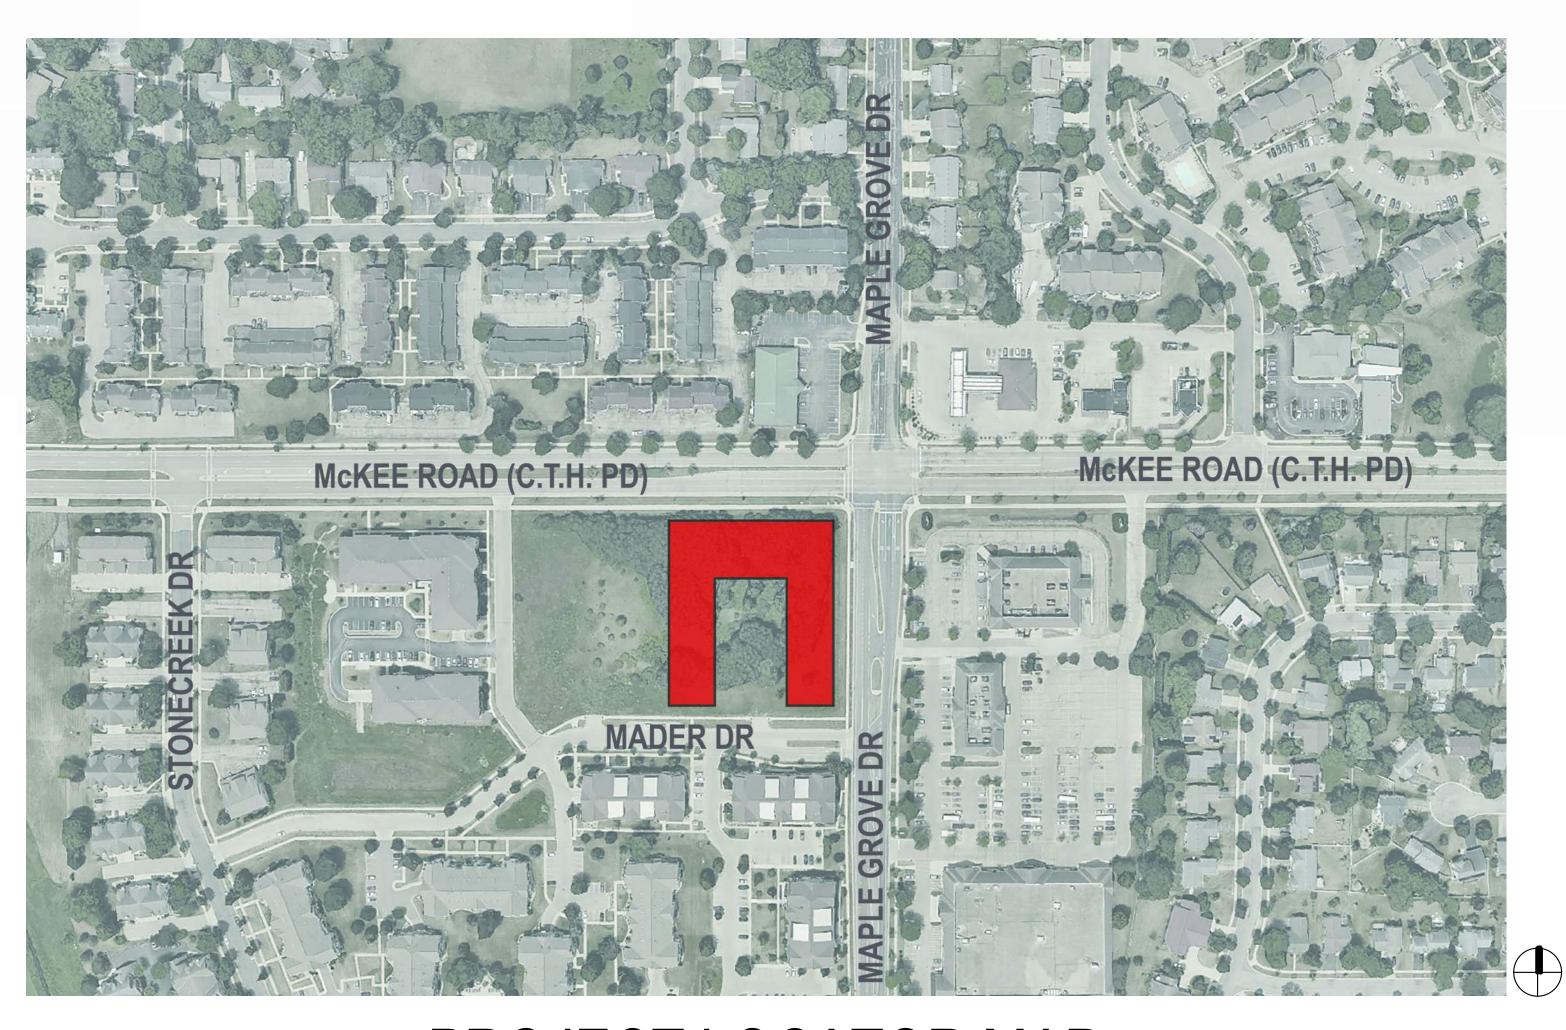

PROJECT LOCATOR MAP

SHEET NUMBER	SHEET NAME
1000	COVER
J001	INDEX SHEET
C100	SITE LAYOUT PLAN
C200	SITE GRADING PLAN
C300	SITE UTILITY PLAN
C400	CONSTRUCTION DETAILS
C500	FIRE ACCESS PLAN
.100	LANDSCAPE PLAN
J010	EXISTING SITE CONTEXT PHOTOS
J011	EXISTING SITE CONTEXT PHOTOS
JSP-100	MASTER SITE PLAN
J100	LOWER LEVEL PLAN
J101	FIRST FLOOR PLAN
J102	TYPICAL FLOOR PLAN
J103	ROOF PLAN
J200	EXTERIOR ELEVATIONS
J201	EXTERIOR ELEVATIONS
J202	EXTERIOR ELEVATIONS
J210	EXTERIOR ELEVATIONS- BIRDGLASS
J211	EXTERIOR ELEVATIONS- BIRDGLASS
J212	EXTERIOR ELEVATIONS- BIRDGLASS
J213	BIRDGLASS CALCULATIONS
J220	EXTERIOR MATERIALS & BUILDING DETAILS
J230	EXTERIOR RENDERINGS
J231	EXTERIOR RENDERINGS
J232	EXTERIOR RENDERINGS
J233	EXTERIOR RENDERINGS
J234	EXTERIOR RENDERINGS
J235	EXTERIOR RENDERINGS
J236	EXTERIOR RENDERINGS
J300	BUILDING SECTIONS
J400	SITE PHOTOMETRICS



LAVES EY Company

MCKEE ROAD MIXED USE DEVELOPMENT

CITY OF MADISON LAND USE AND URBAN DESIGN COMMISSION SUBMITTAL

PROGRESS DOCUMENTS


These documents reflect progress and intent and may be subject to change, including additional detail. These are not final construction documents and should not be used for final bidding or construction-related purposes.

DATE OF I	ISSUANCE	00	CTOBER 18, 2024
	REVISION SCHED	ULE	
Mark	Description		Date

SHEET TIT

INDEX SHEET

SHEET NUMBER

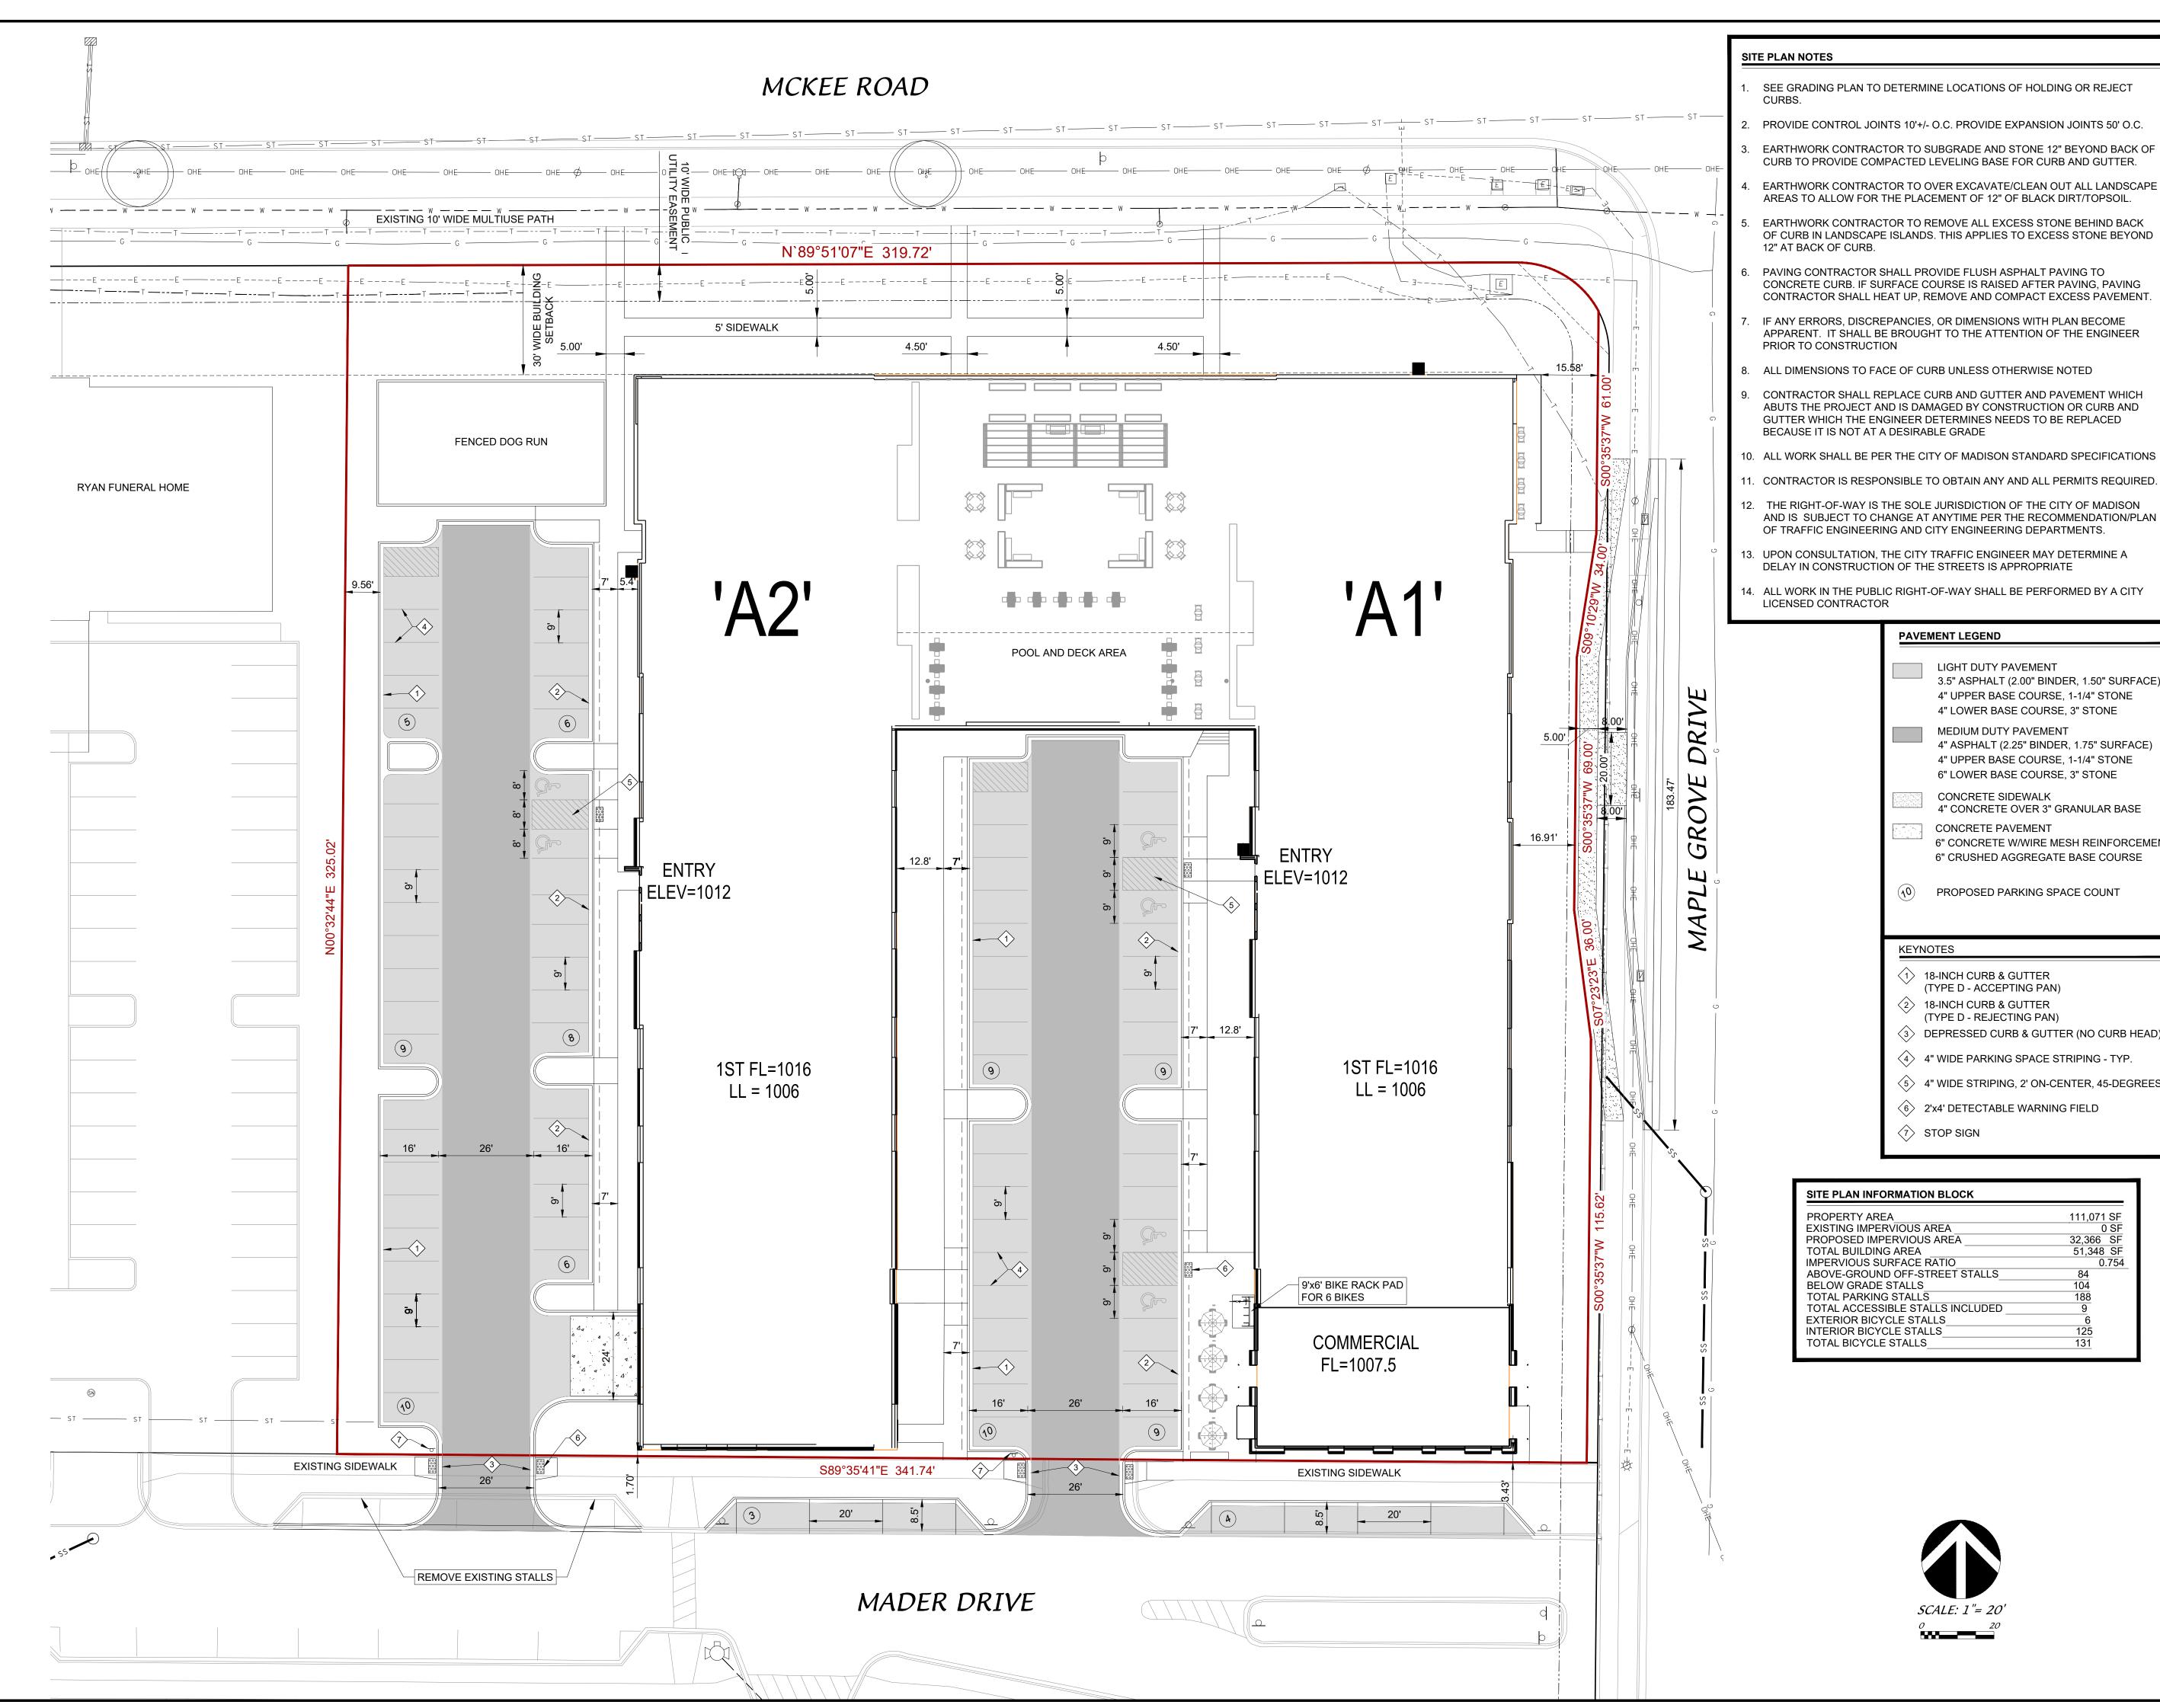

- SEE GRADING PLAN TO DETERMINE LOCATIONS OF HOLDING OR REJECT
- 2. PROVIDE CONTROL JOINTS 10'+/- O.C. PROVIDE EXPANSION JOINTS 50' O.C.
- EARTHWORK CONTRACTOR TO SUBGRADE AND STONE 12" BEYOND BACK OF CURB TO PROVIDE COMPACTED LEVELING BASE FOR CURB AND GUTTER.
- EARTHWORK CONTRACTOR TO OVER EXCAVATE/CLEAN OUT ALL LANDSCAPE AREAS TO ALLOW FOR THE PLACEMENT OF 12" OF BLACK DIRT/TOPSOIL.
- EARTHWORK CONTRACTOR TO REMOVE ALL EXCESS STONE BEHIND BACK OF CURB IN LANDSCAPE ISLANDS. THIS APPLIES TO EXCESS STONE BEYOND 12" AT BACK OF CURB.
- PAVING CONTRACTOR SHALL PROVIDE FLUSH ASPHALT PAVING TO CONCRETE CURB. IF SURFACE COURSE IS RAISED AFTER PAVING, PAVING CONTRACTOR SHALL HEAT UP, REMOVE AND COMPACT EXCESS PAVEMENT.
- IF ANY ERRORS, DISCREPANCIES, OR DIMENSIONS WITH PLAN BECOME APPARENT. IT SHALL BE BROUGHT TO THE ATTENTION OF THE ENGINEER
- ALL DIMENSIONS TO FACE OF CURB UNLESS OTHERWISE NOTED
- CONTRACTOR SHALL REPLACE CURB AND GUTTER AND PAVEMENT WHICH ABUTS THE PROJECT AND IS DAMAGED BY CONSTRUCTION OR CURB AND GUTTER WHICH THE ENGINEER DETERMINES NEEDS TO BE REPLACED BECAUSE IT IS NOT AT A DESIRABLE GRADE
- ALL WORK SHALL BE PER THE CITY OF MADISON STANDARD SPECIFICATIONS
- 12. THE RIGHT-OF-WAY IS THE SOLE JURISDICTION OF THE CITY OF MADISON AND IS SUBJECT TO CHANGE AT ANYTIME PER THE RECOMMENDATION/PLAN
- 13. UPON CONSULTATION, THE CITY TRAFFIC ENGINEER MAY DETERMINE A DELAY IN CONSTRUCTION OF THE STREETS IS APPROPRIATE
- ALL WORK IN THE PUBLIC RIGHT-OF-WAY SHALL BE PERFORMED BY A CITY LICENSED CONTRACTOR

PAVEMENT LEGEND LIGHT DUTY PAVEMENT 3.5" ASPHALT (2.00" BINDER, 1.50" SURFACE) 4" UPPER BASE COURSE, 1-1/4" STONE 4" LOWER BASE COURSE, 3" STONE MEDIUM DUTY PAVEMENT 4" ASPHALT (2.25" BINDER, 1.75" SURFACE) 4" UPPER BASE COURSE, 1-1/4" STONE 6" LOWER BASE COURSE, 3" STONE

- CONCRETE SIDEWALK 4" CONCRETE OVER 3" GRANULAR BASE CONCRETE PAVEMENT
- 6" CONCRETE W/WIRE MESH REINFORCEMENT 6" CRUSHED AGGREGATE BASE COURSE
- PROPOSED PARKING SPACE COUNT

KEYNOTES

- 18-INCH CURB & GUTTER (TYPE D ACCEPTING PAN)
- 2 18-INCH CURB & GUTTER
- (TYPE D REJECTING PAN)
- 3 DEPRESSED CURB & GUTTER (NO CURB HEAD)
- 4 4" WIDE PARKING SPACE STRIPING TYP.
- 5 4" WIDE STRIPING, 2' ON-CENTER, 45-DEGREES
- 6 2'x4' DETECTABLE WARNING FIELD
- ⟨¬⟩ STOP SIGN

SITE PLAN INFORMATION BLOCK	
PROPERTY AREA	111,071 SF
EXISTING IMPERVIOUS AREA	0 SF
PROPOSED IMPERVIOUS AREA	32,366 SF
TOTAL BUILDING AREA	51,348 SF
IMPERVIOUS SURFACE RATIO	0.754
ABOVE-GROUND OFF-STREET STALLS	84
BELOW GRADE STALLS	104
TOTAL PARKING STALLS	<u> 188</u>
TOTAL ACCESSIBLE STALLS INCLUDED	9
EXTERIOR BICYCLE STALLS	6
INTERIOR BICYCLE STALLS	125
■ TOTAL BICYCLE STALLS	131

SCALE: 1"= 20'



MADISON : MILWAUKEE jla-ap.com

JLA PROJECT NUMBER:



W22-0201



MCKEE ROAD MIXED USE DEVELOPMENT

CITY OF MADISON LAND USE AND URBAN DESIGN COMMISSION SUBMITTAL

PROGRESS DOCUMENTS


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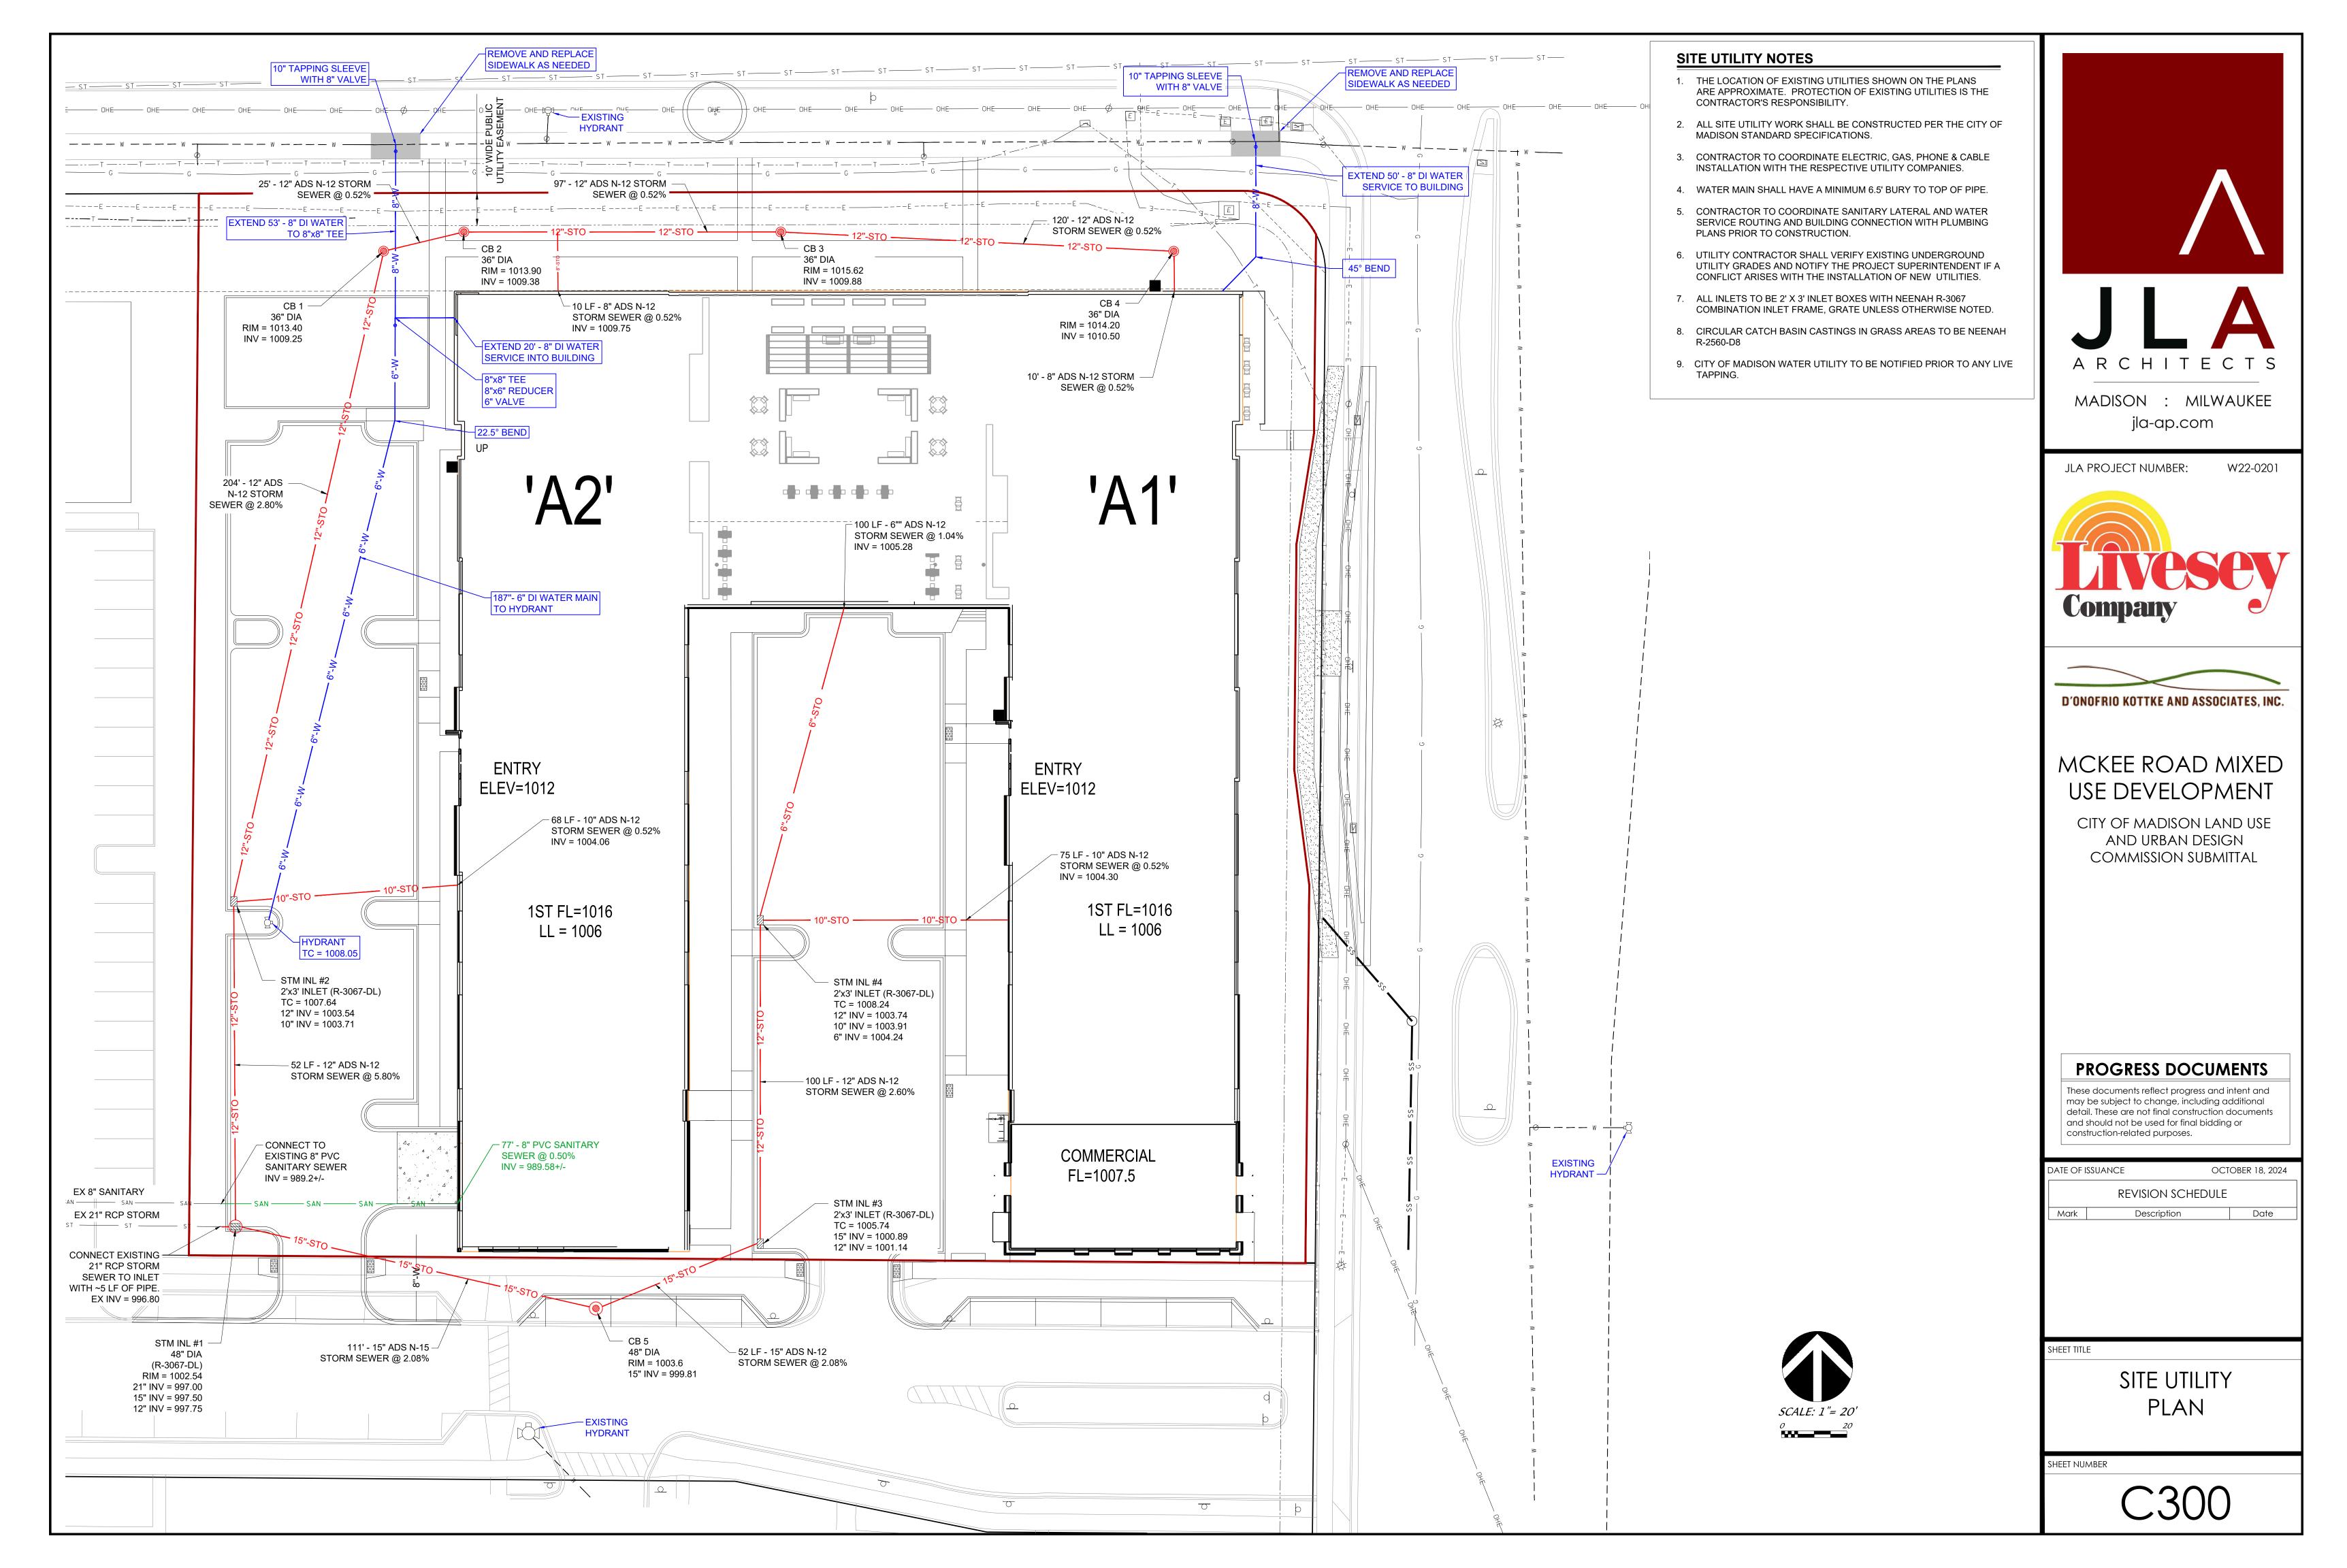
DATE OF I	ssuance oct	OBER 18, 2024
	REVISION SCHEDULE	
Mark	Description	Date


SITE LAYOUT PLAN

Sheet number

C100



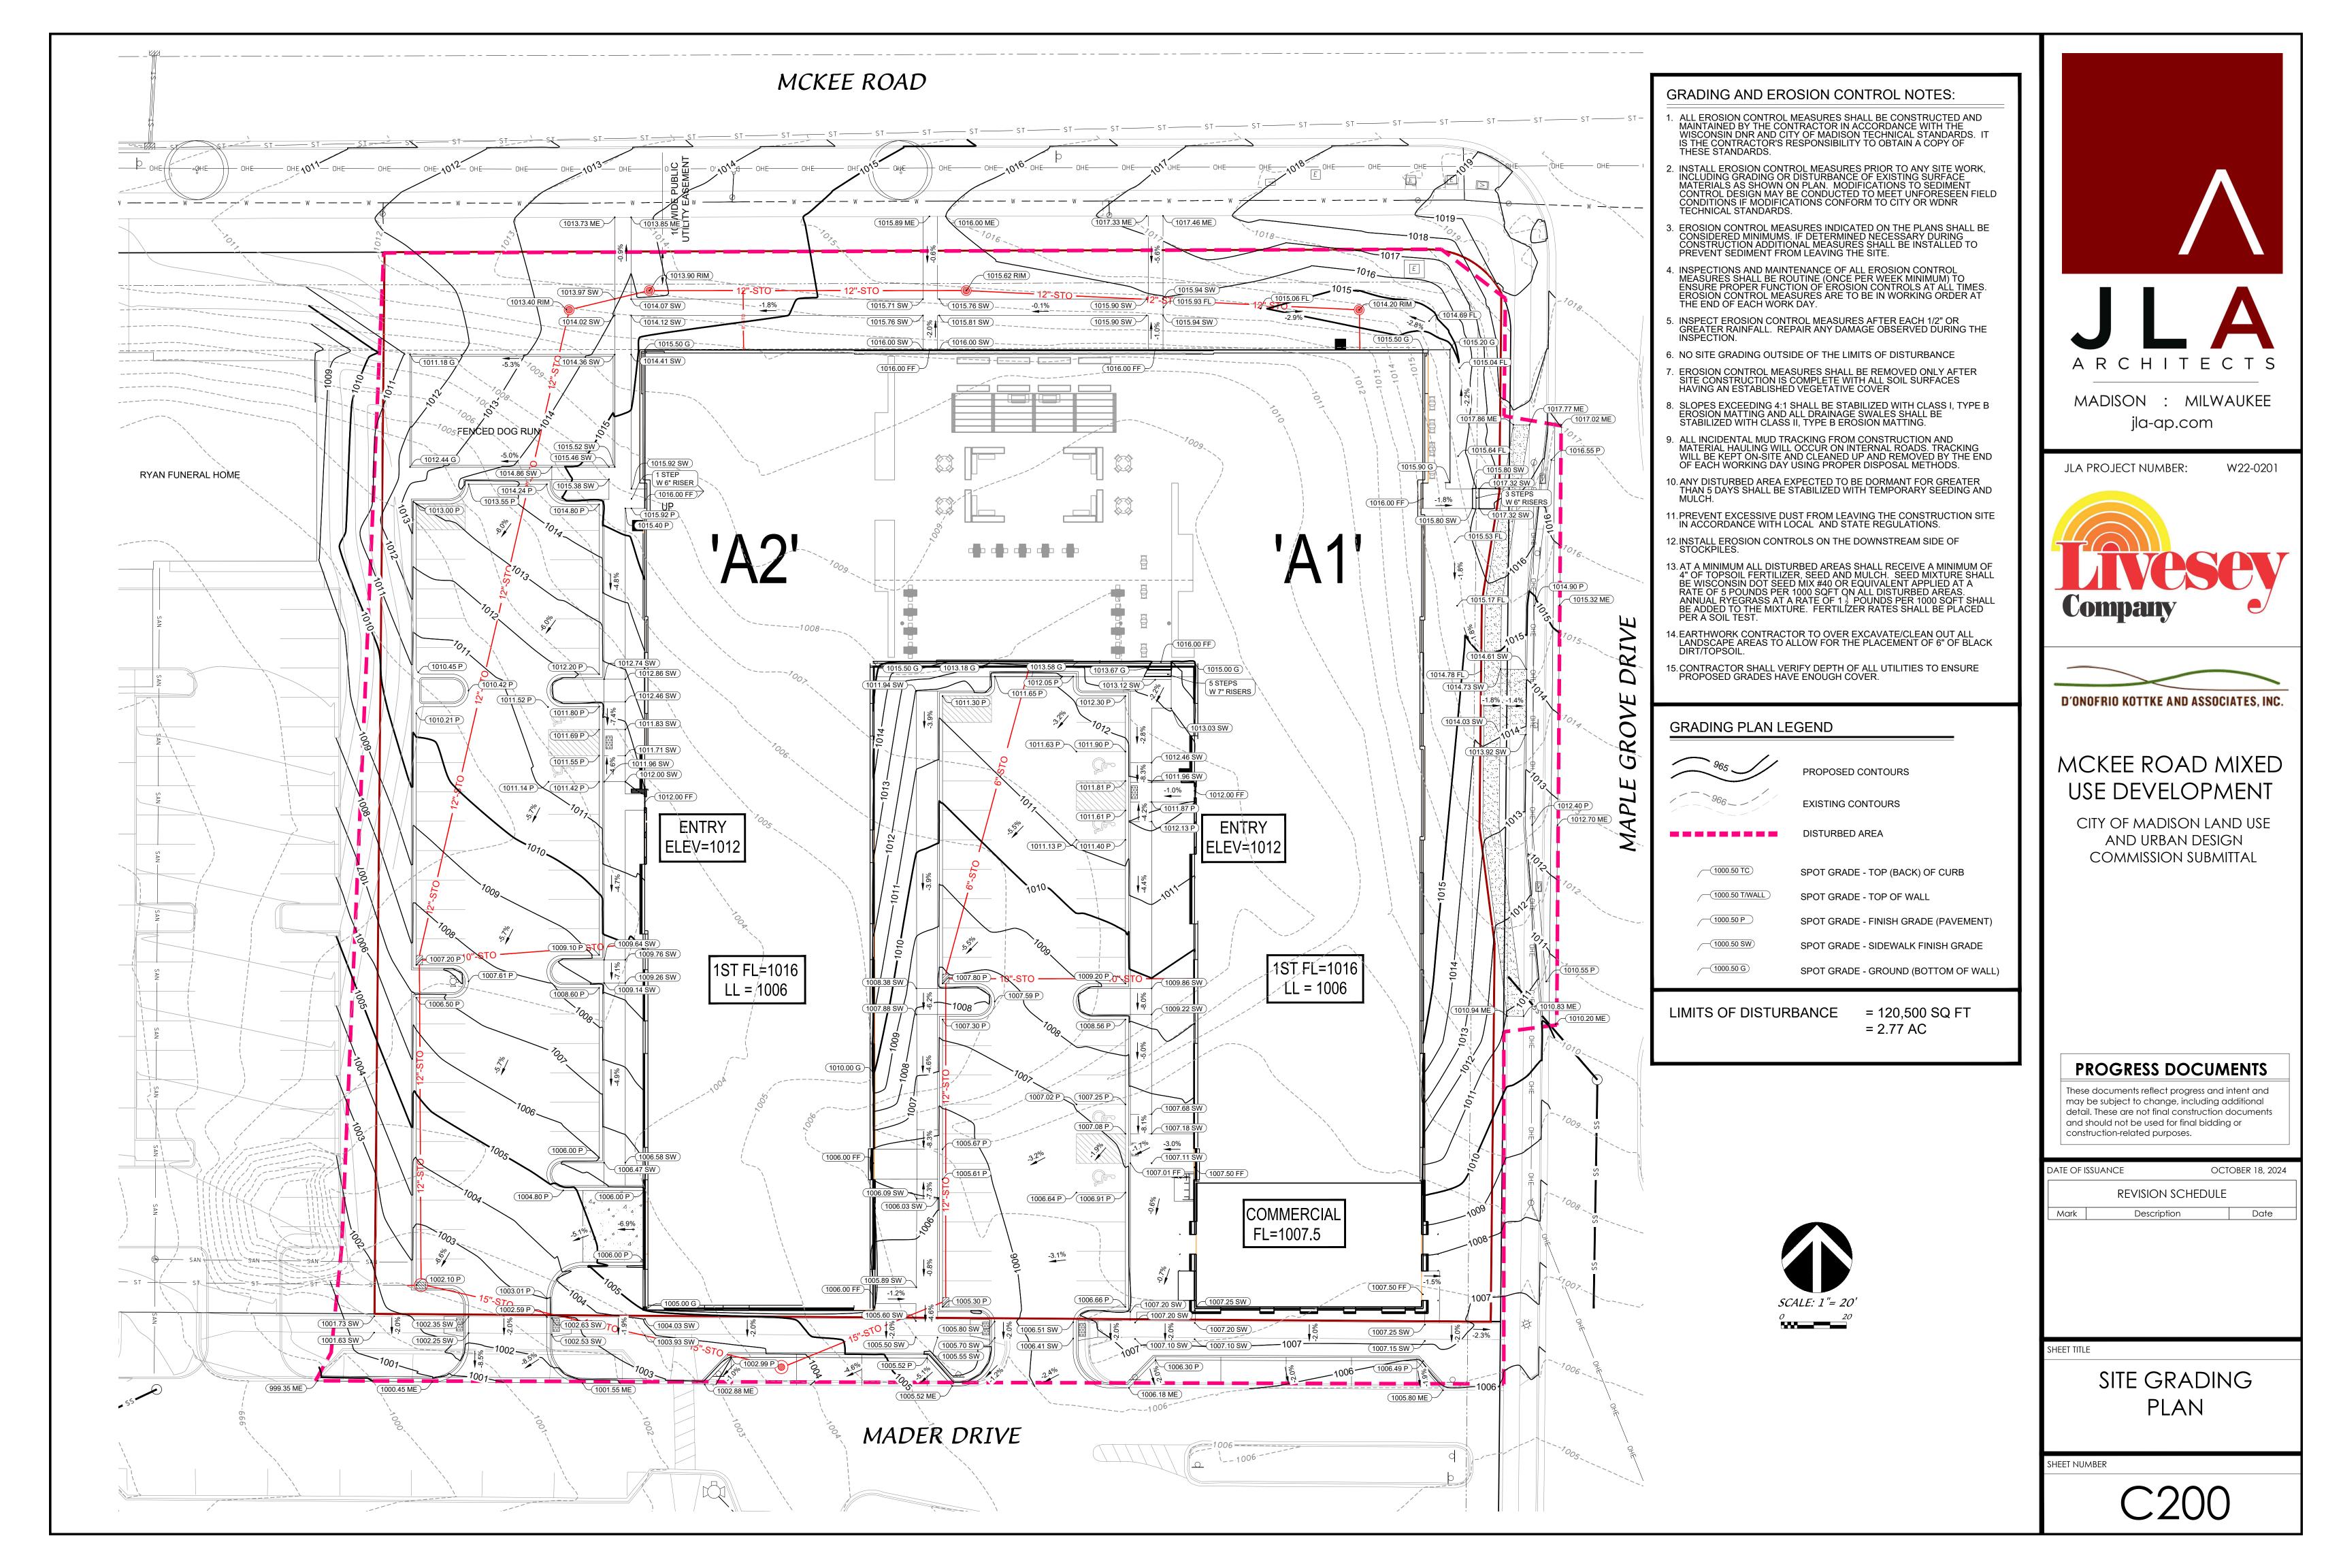

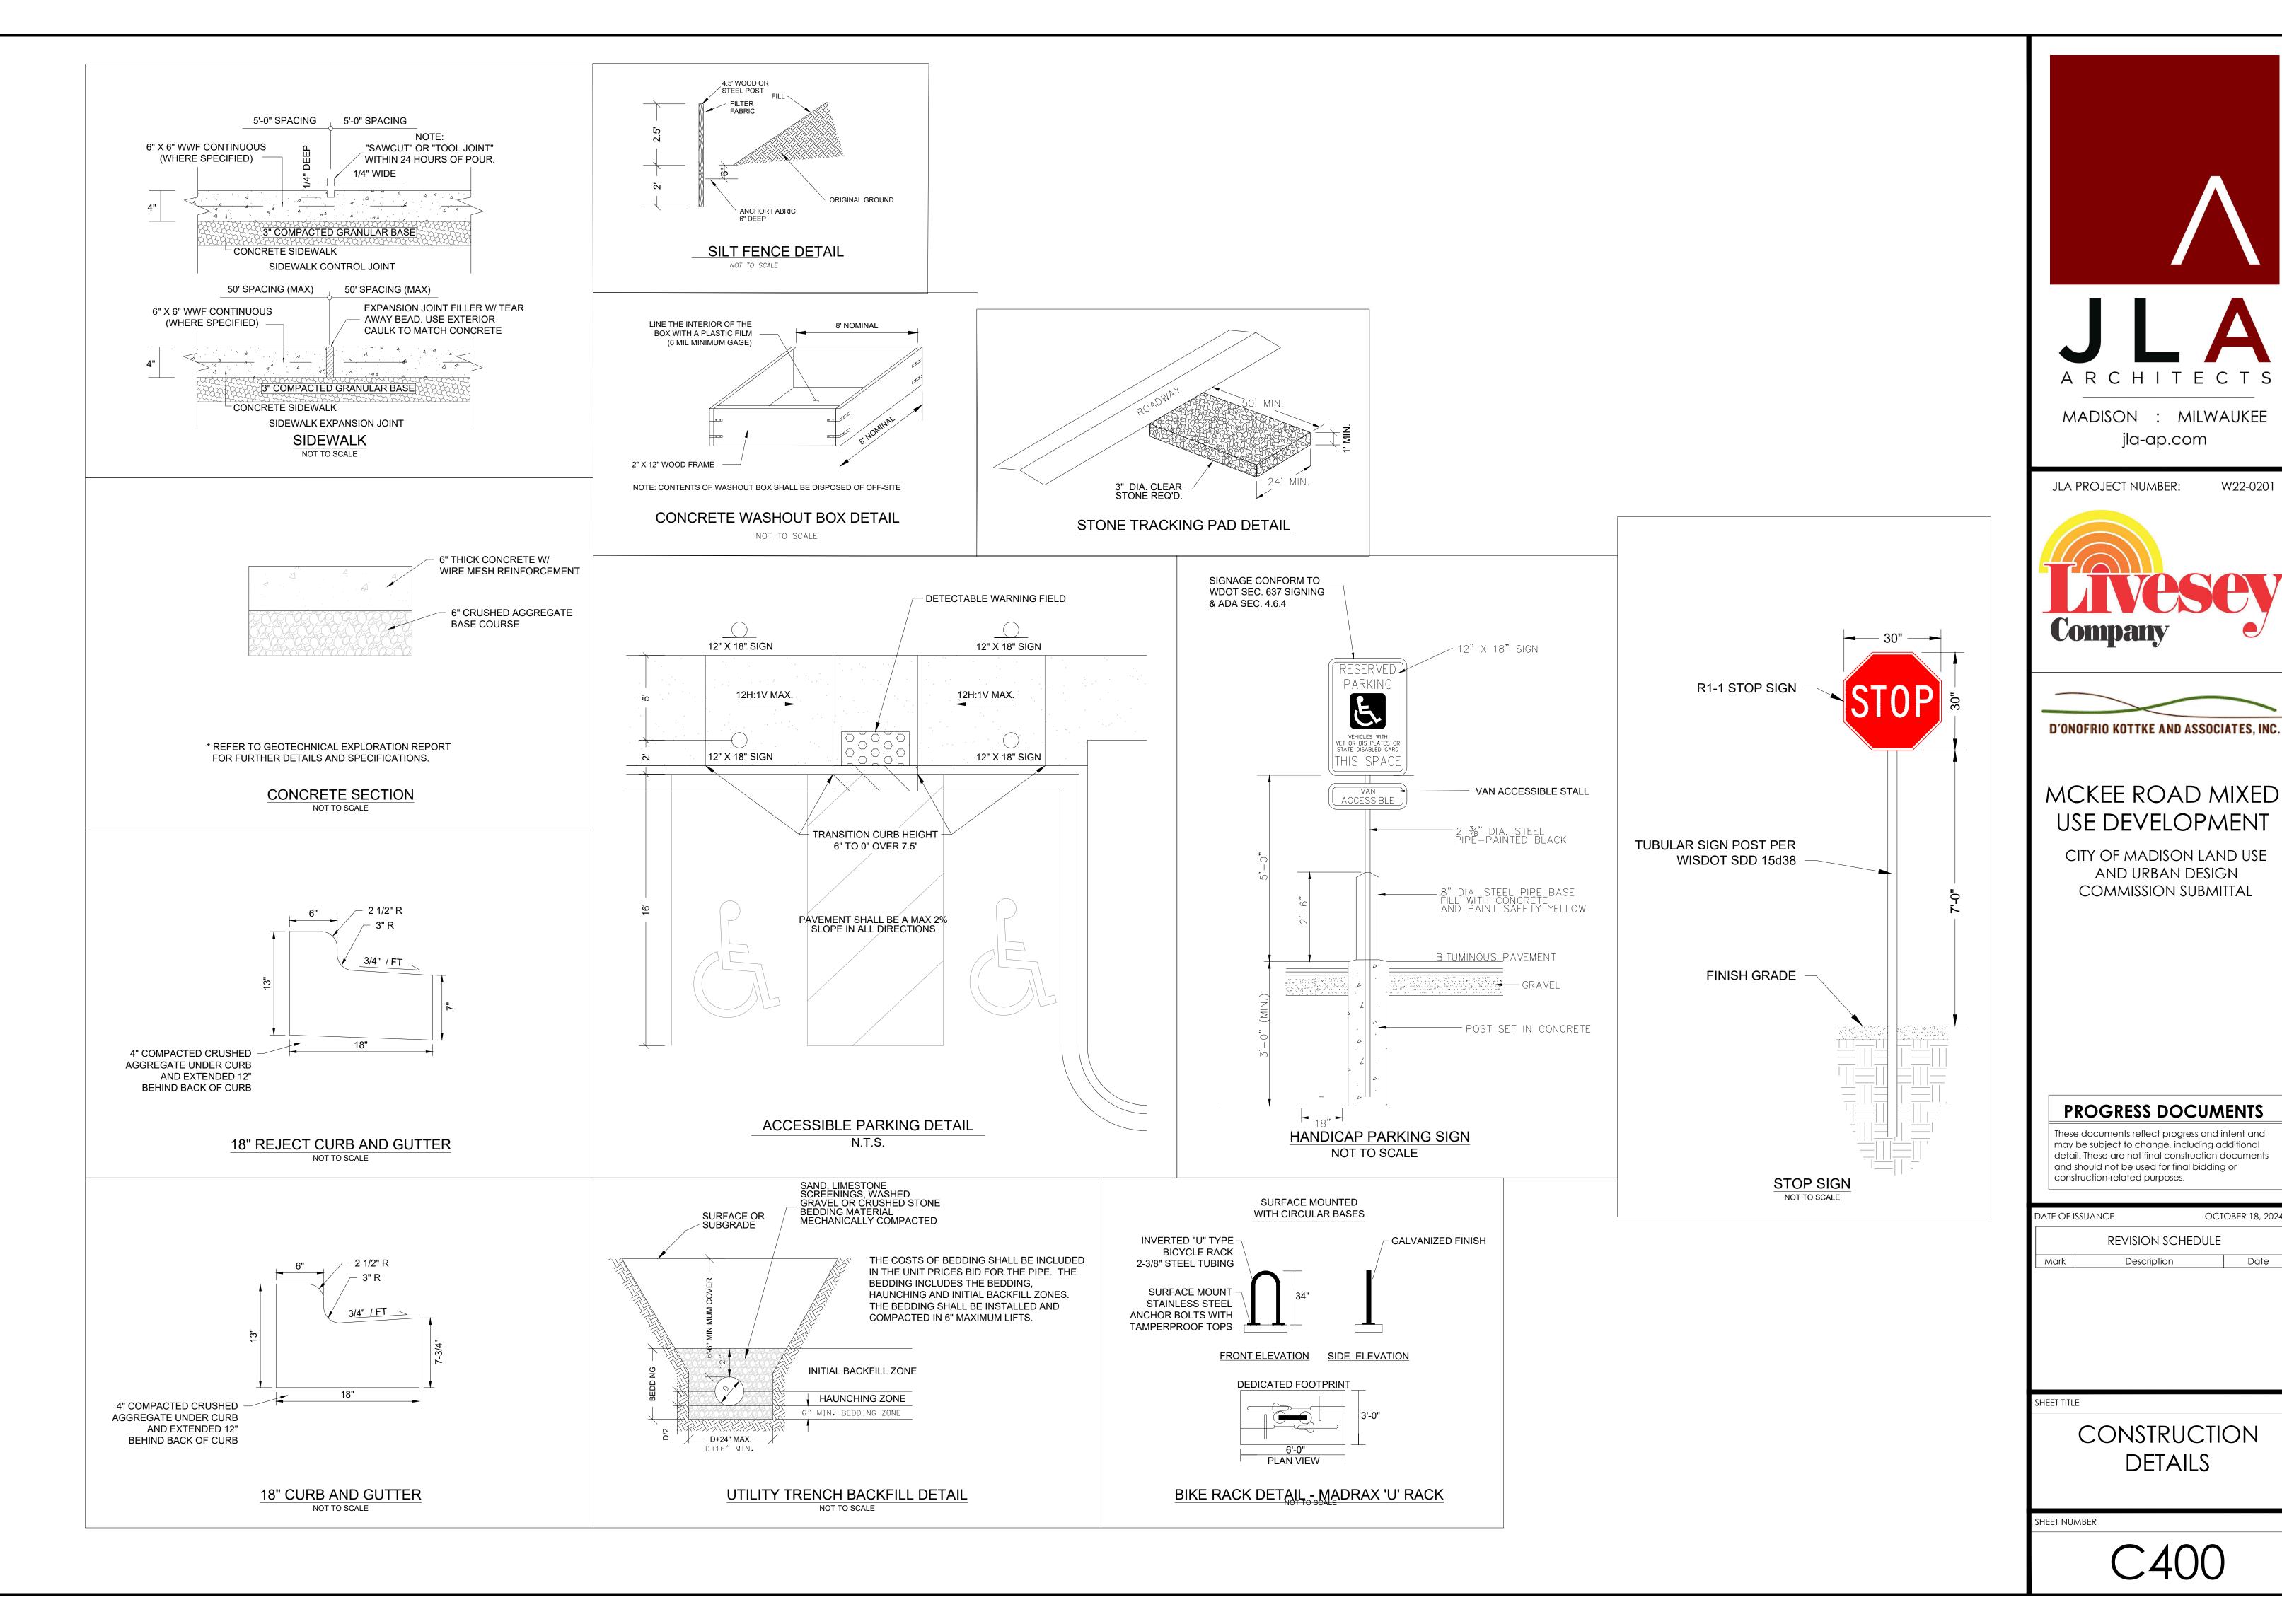

MADISON : MILWAUKEE

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CITY OF MADISON LAND USE

AND URBAN DESIGN COMMISSION SUBMITTAL

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detail. These are not final construction documents

REVISION SCHEDULE

CONSTRUCTION


DETAILS


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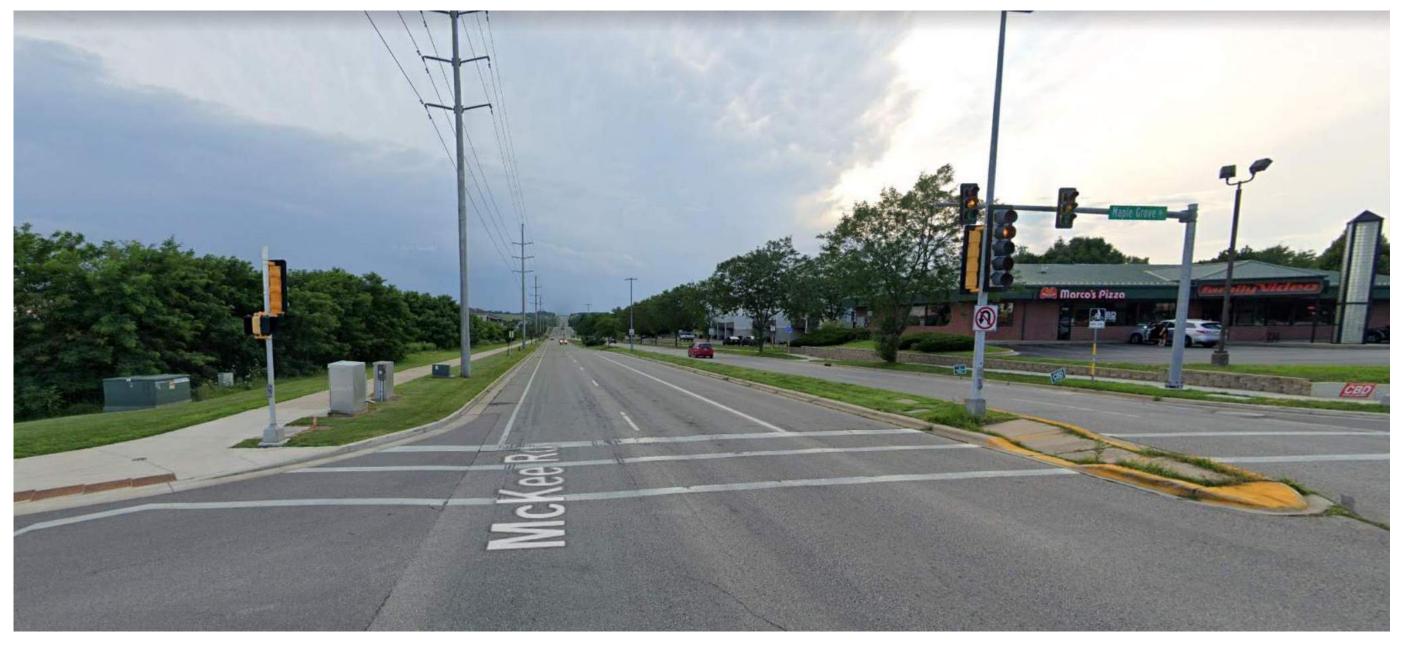
OCTOBER 18, 2024

Date

W22-0201



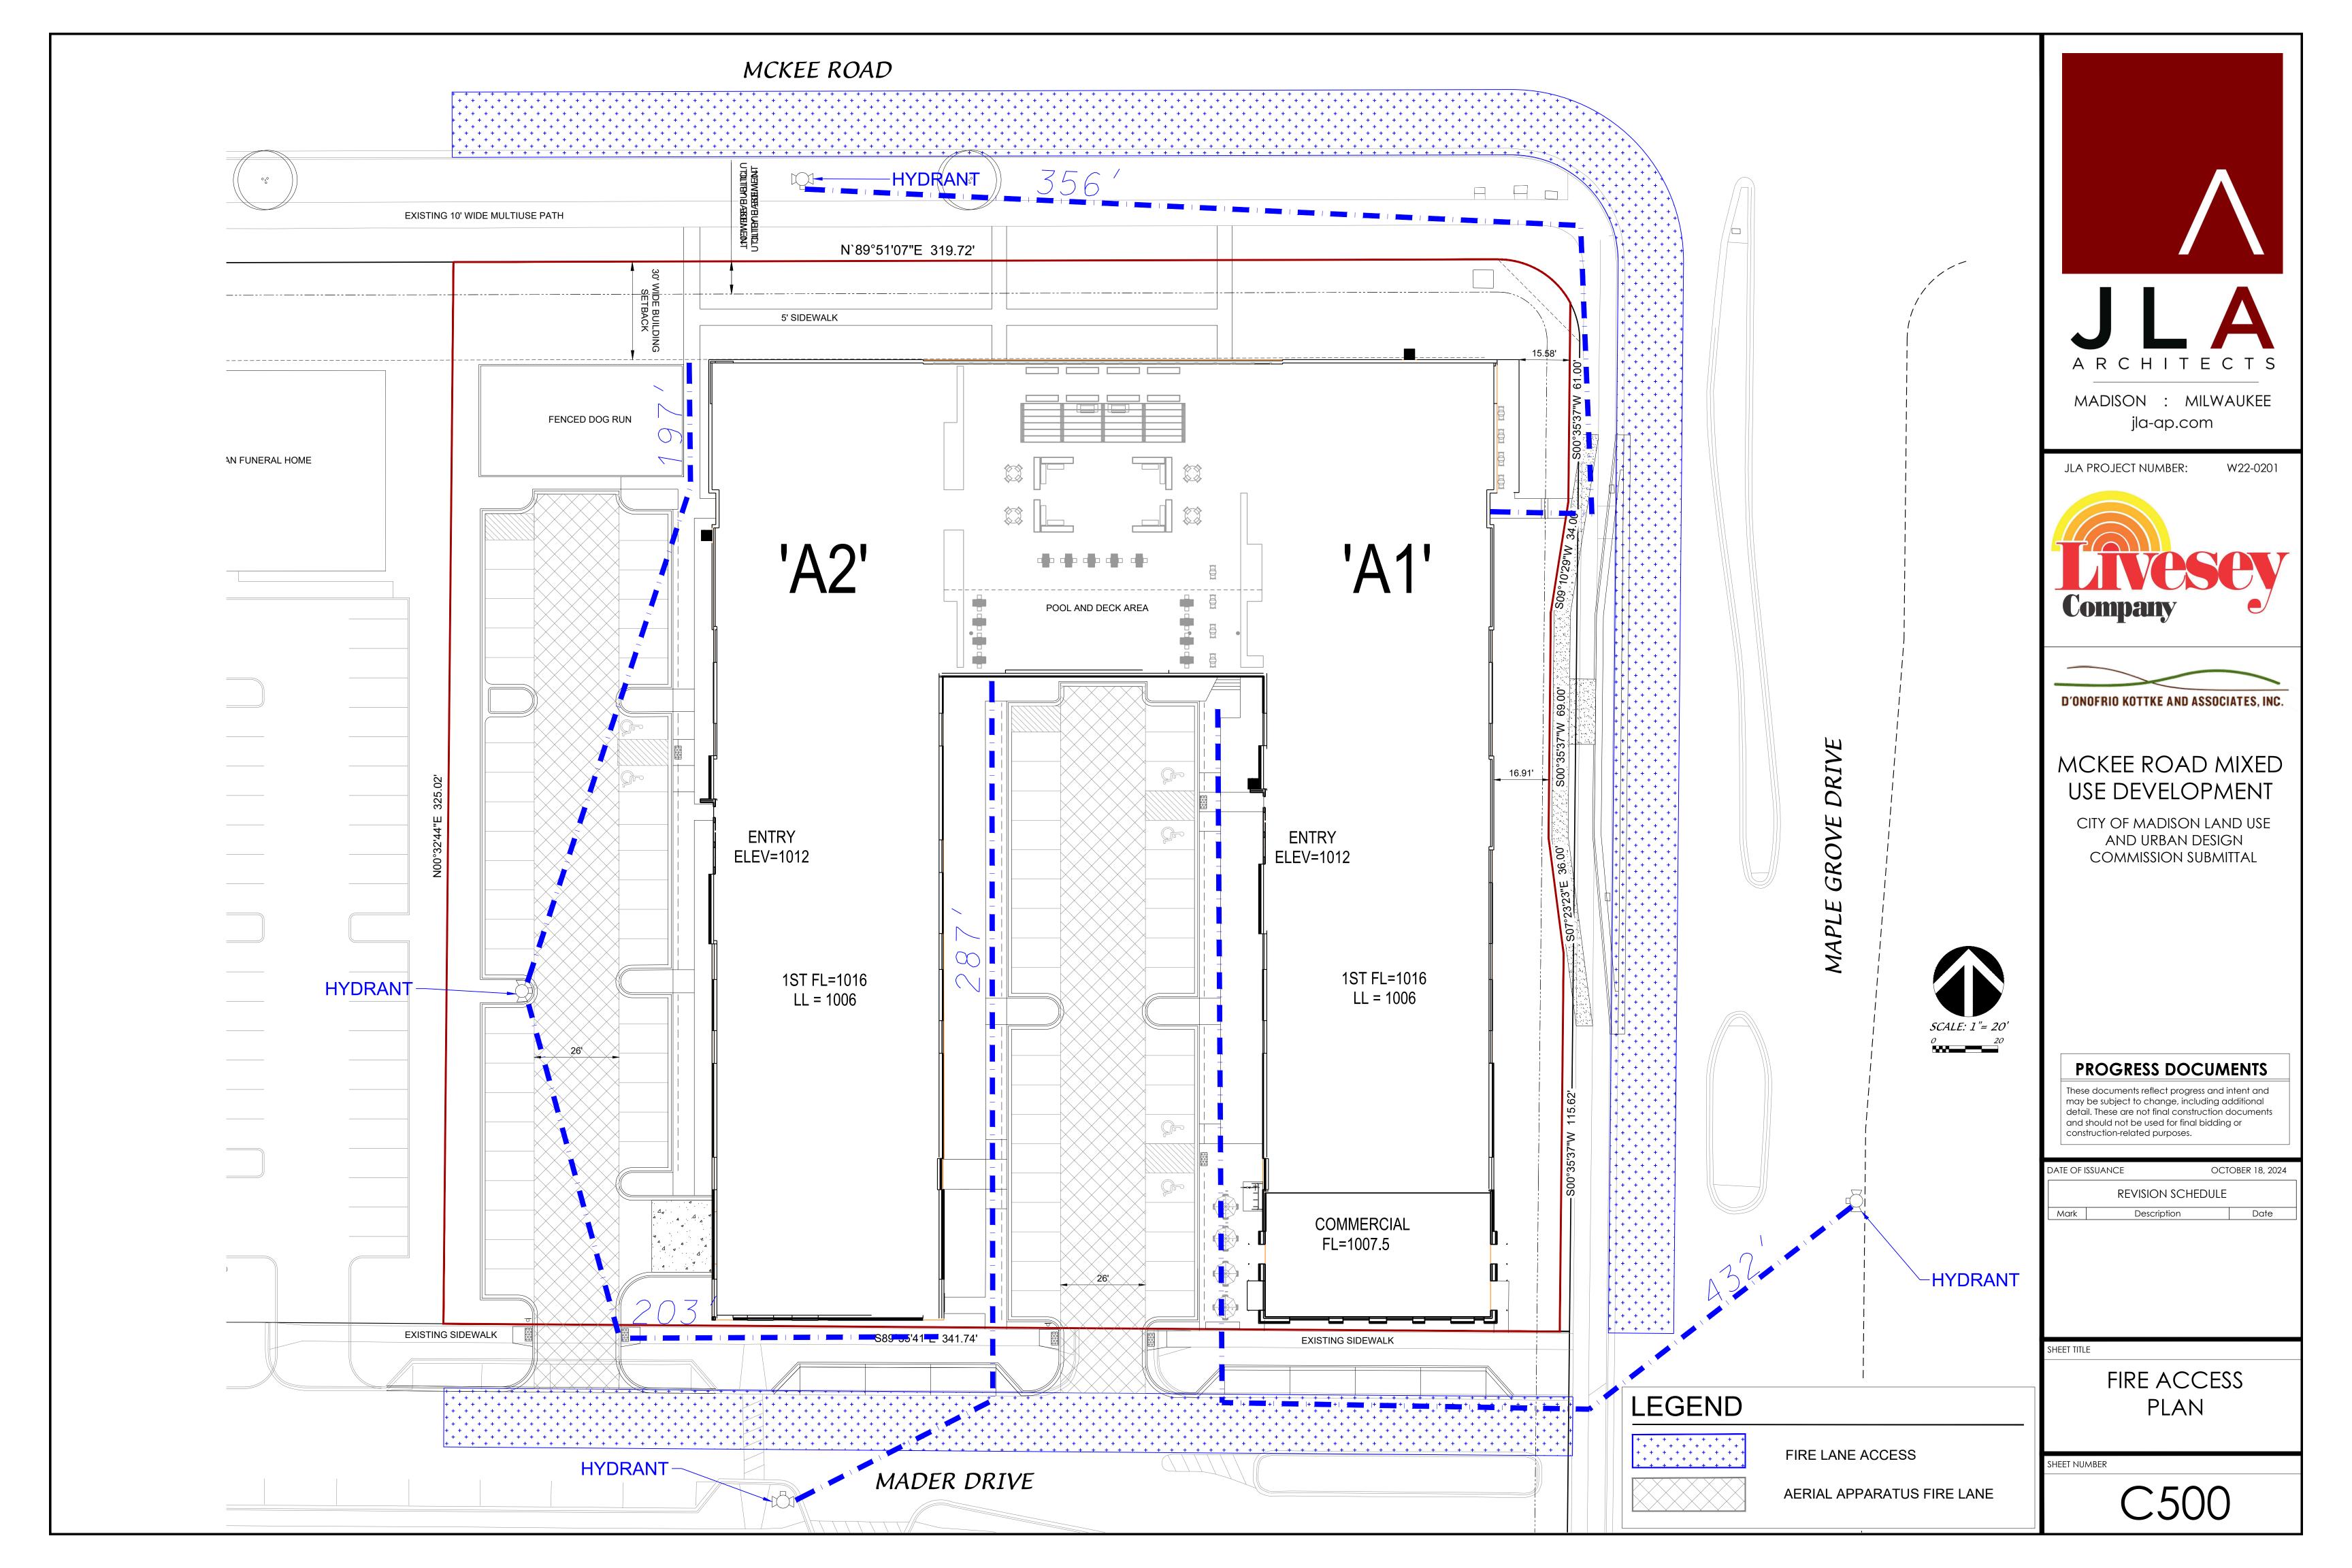


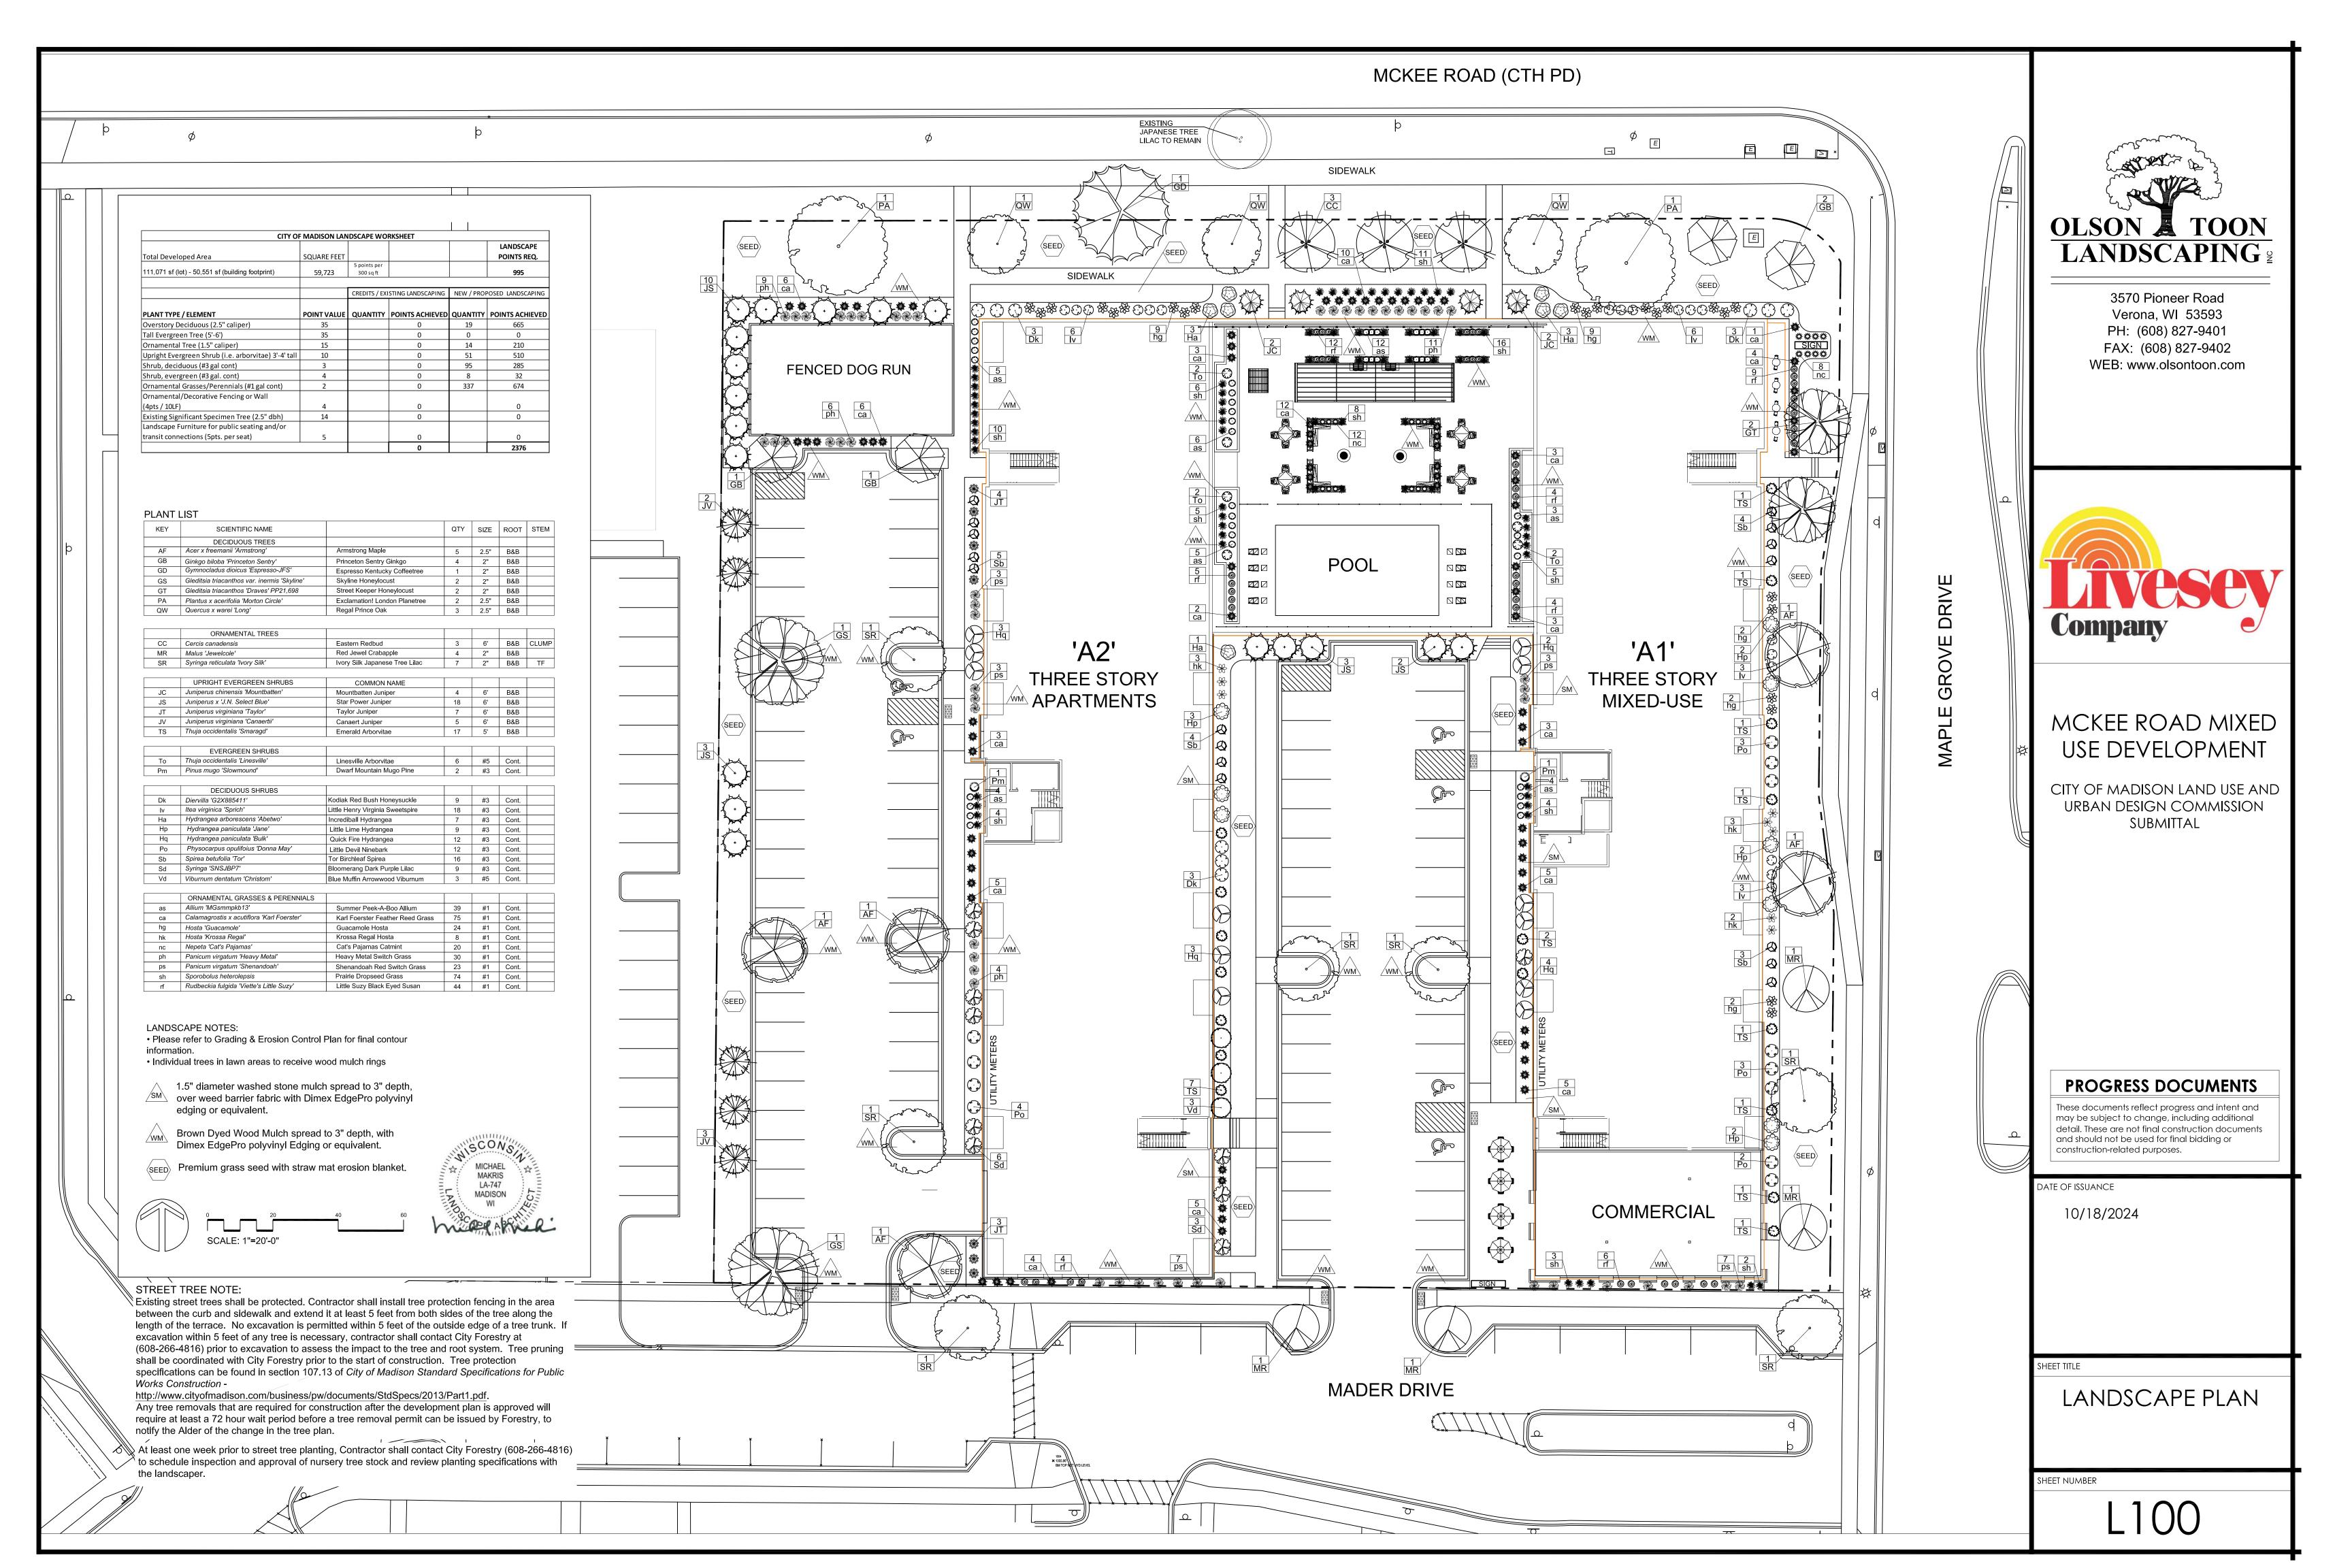

NORTHEAST CORNER - McKEE RD (LOOKING WEST)



NORTHEAST CORNER - McKEE RD & MAPLE GROVE DR (OPPOSITE CORNER)

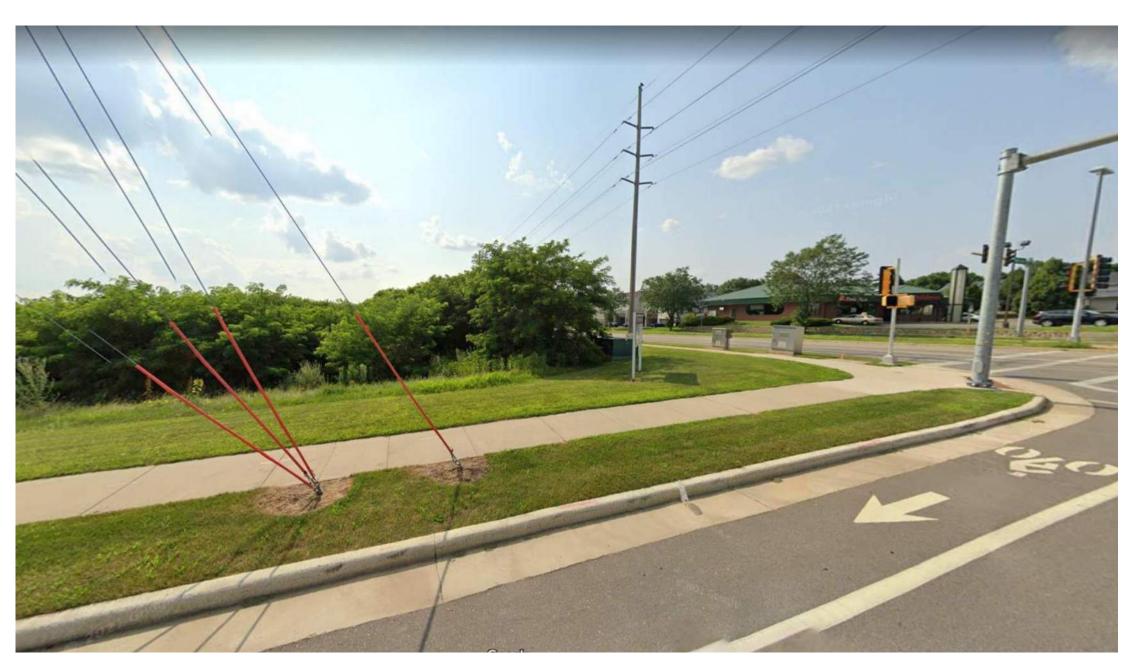

NORTHEAST CORNER - MAPLE GROVE DR (LOOKING WEST)



NORTHEAST CORNER - McKEE RD & MAPLE GROVE DR (SITE CORNER)



JLA PROJECT NUMBER: W22-0201



MCKEE ROAD MIXED
USE DEVELOPMENT

CITY OF MADISON LAND USE AND URBAN DESIGN COMMISSION SUBMITTAL

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DATE OF ISSUANCE OCTOBER 18, 2024

REVISION SCHEDULE

Mark Description

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EXISTING SITE CONTEXT PHOTOS


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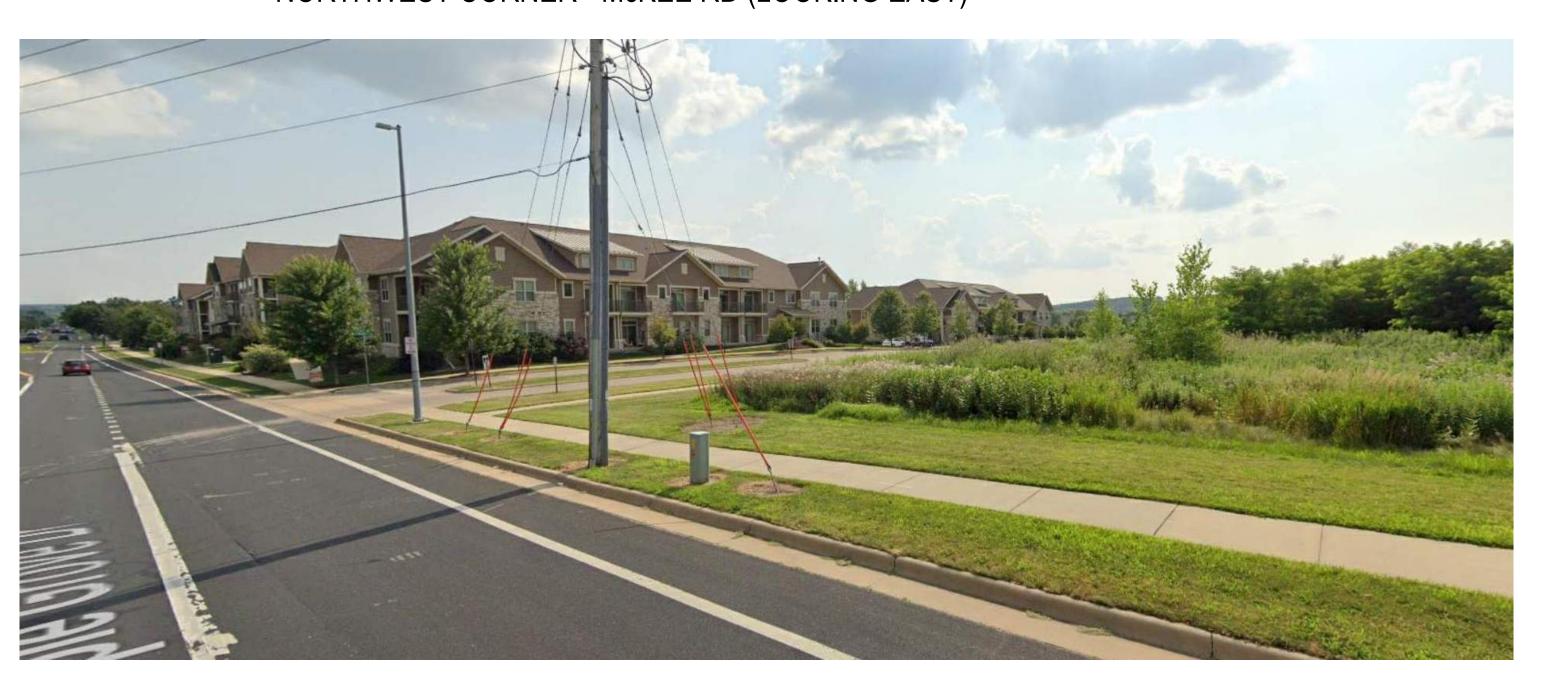
NORTHWEST CORNER - McKEE RD (LOOKING SOUTHEAST)



NORTHWEST CORNER - McKEE RD (LOOKING SOUTHWEST)



NORTHWEST CORNER - McKEE RD (LOOKING EAST)

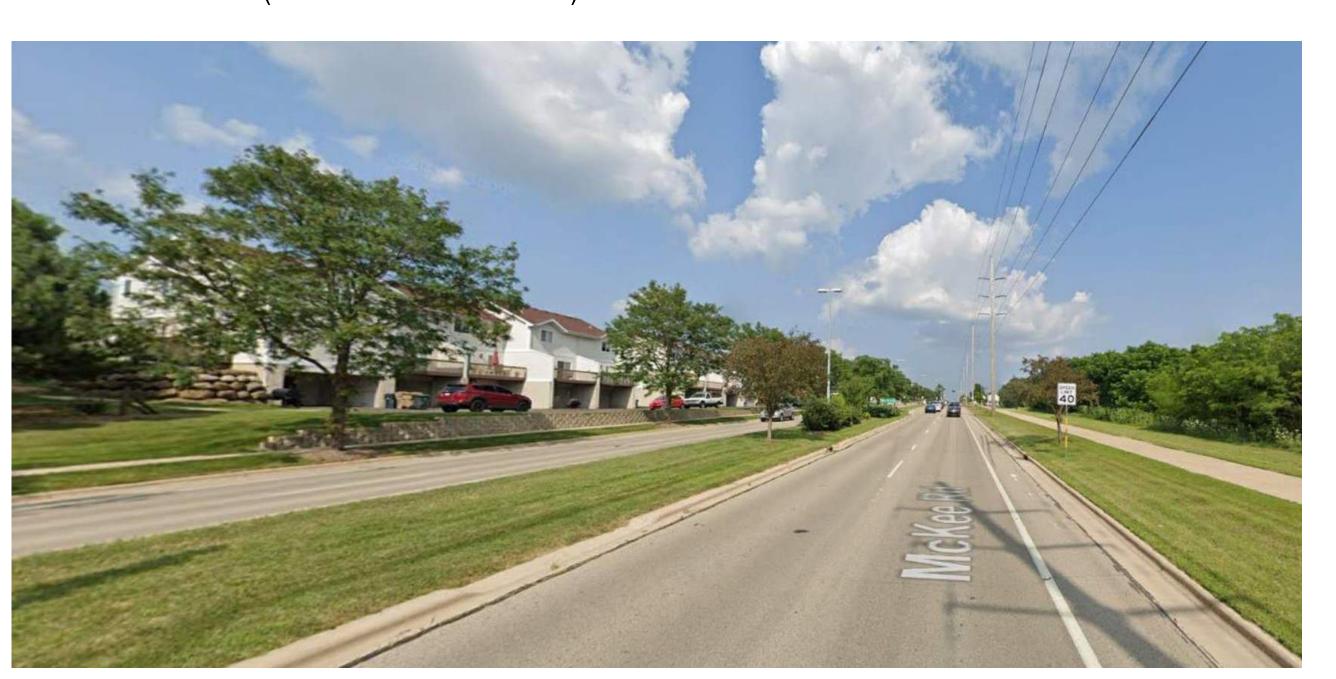

SOUTHEAST CORNER - MAPLE GROVE DR (LOOKING TOWARDS MARDER DR)



jid dpiediii



MCKEE ROAD MIXED USE DEVELOPMENT

CITY OF MADISON LAND USE AND URBAN DESIGN COMMISSION SUBMITTAL

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REVISION SCHEDULE

Mark Description Date

SHEET TIT

EXISTING SITE CONTEXT PHOTOS

SHEET NUMBER





JLA PROJECT NUMBER: W22-0201



MCKEE ROAD MIXED USE DEVELOPMENT

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DATE OF ISSUANCE OCTOBER 18, 2024

REVISION SCHEDULE

Mark Description Date

SHEET

SCALE: 1" = 30'-0"


MASTER SITE PLAN

Sheet number

USP-100

1 ARCHITECTURAL SITE PLAN

SCALE: 1" = 30'-0"

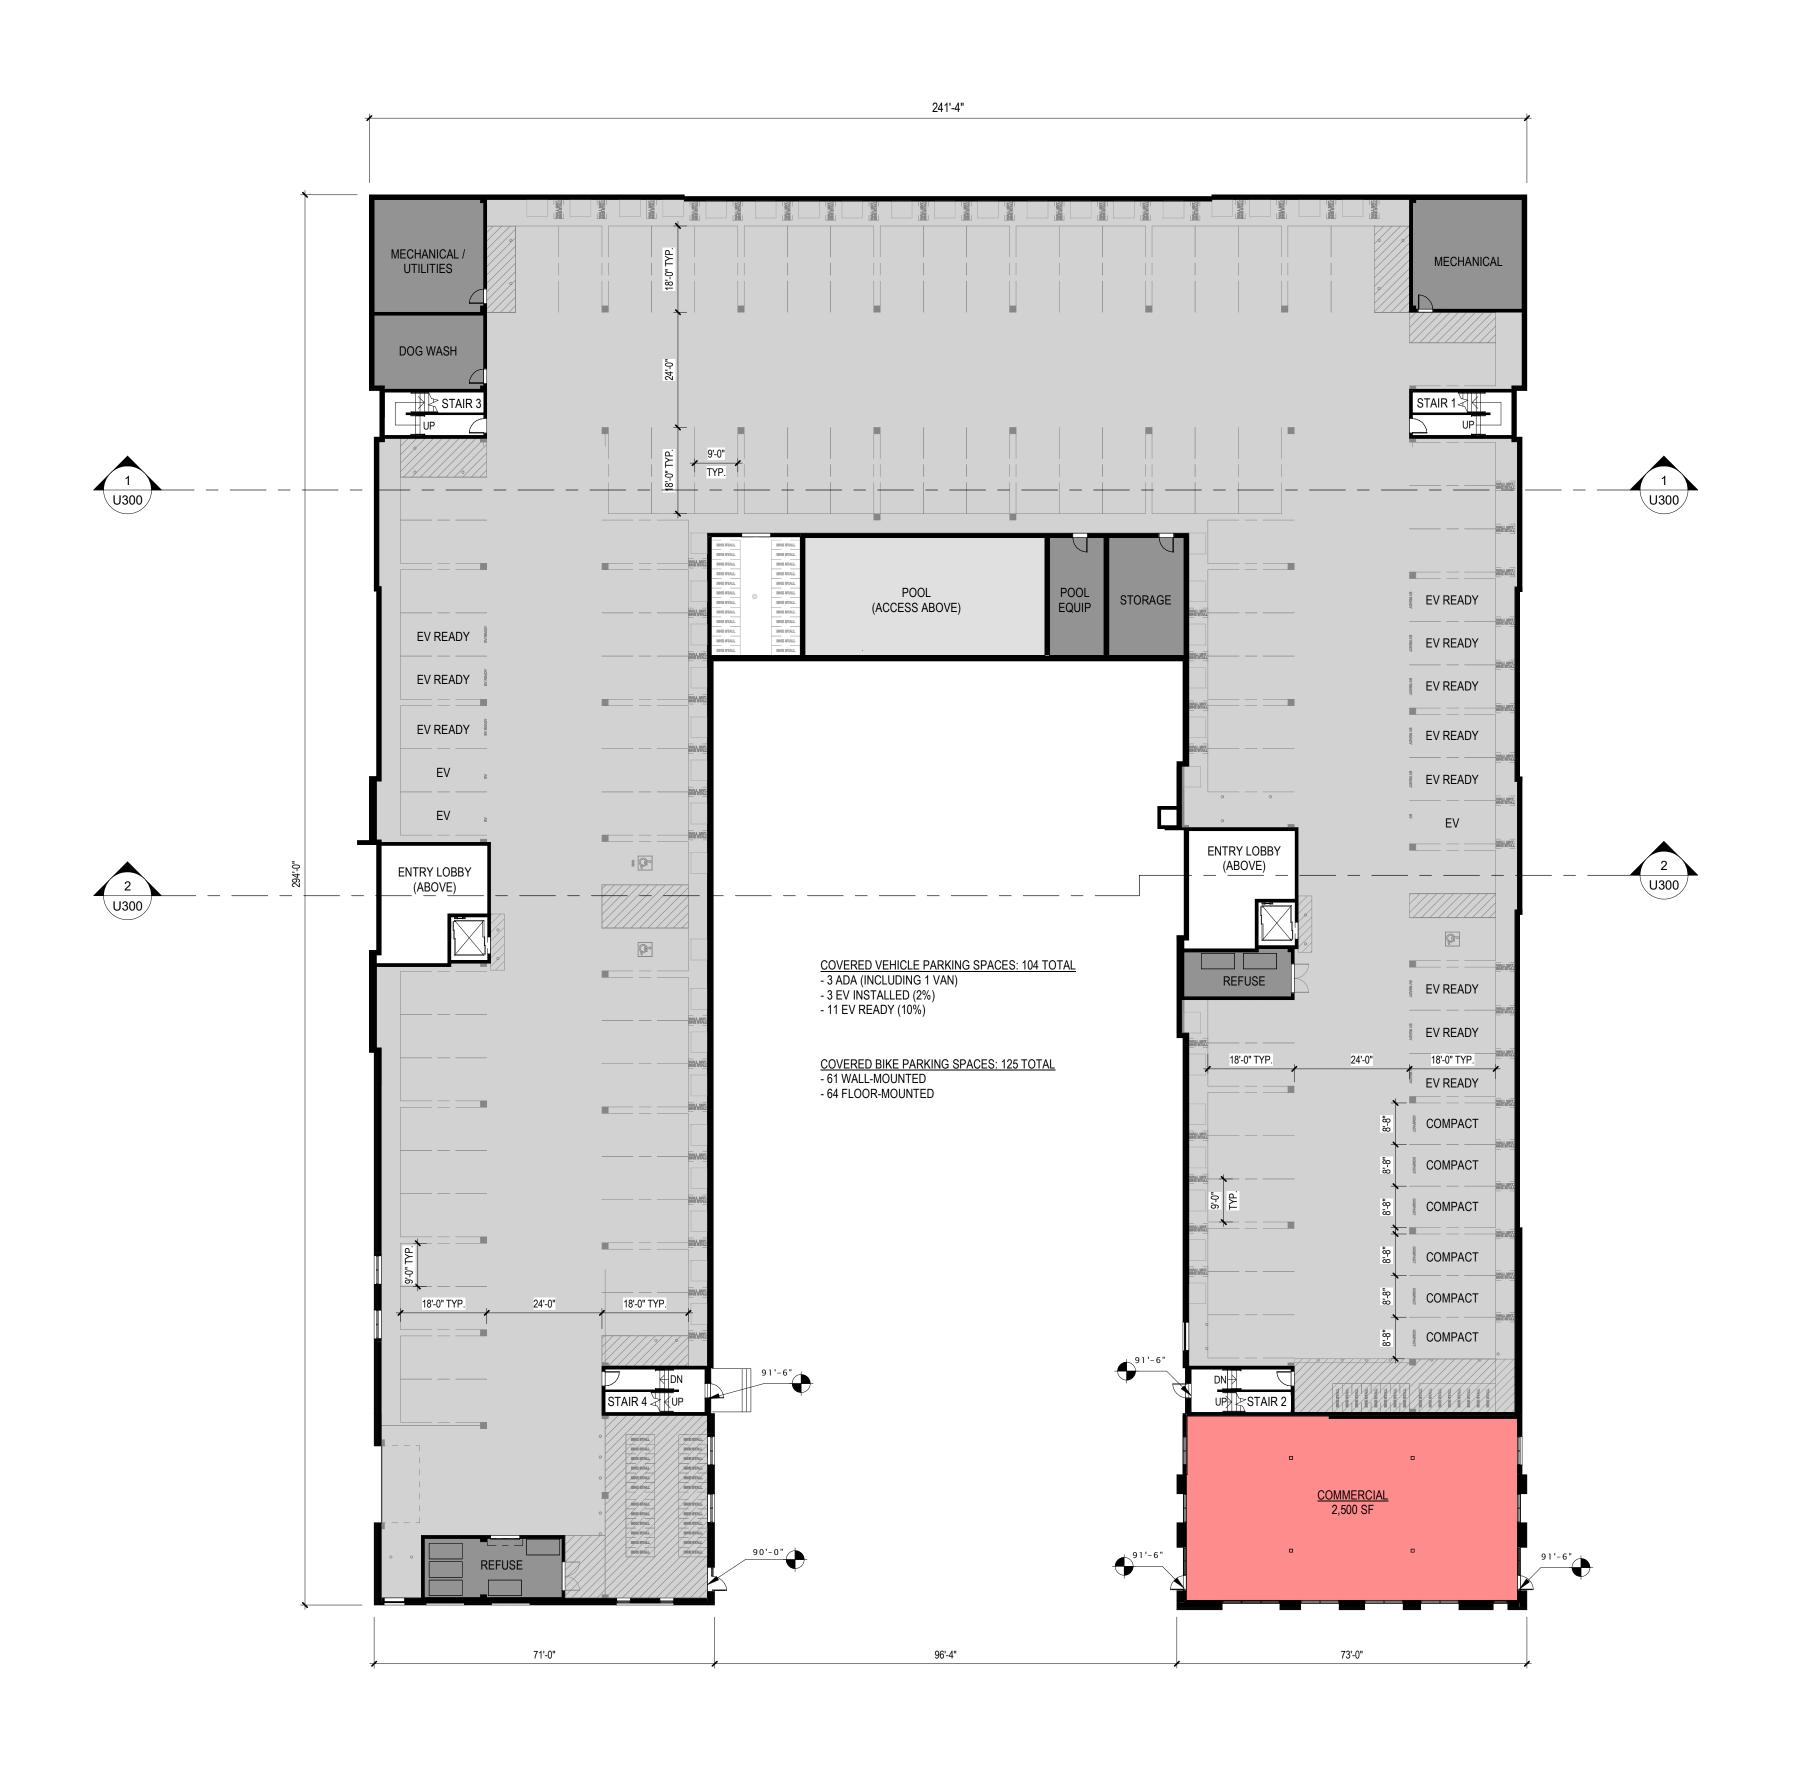



JLA PROJECT NUMBER: W22-0201



MCKEE ROAD MIXED USE DEVELOPMENT

CITY OF MADISON LAND USE AND URBAN DESIGN COMMISSION SUBMITTAL

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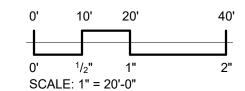
LOWER LEVEL PLAN

SHEET NUMBER

U100

1 LOWER LEVEL PLAN

SCALE: 1" = 20'-0"





FIRST FLOOR PLAN

SCALE: 1" = 20'-0"



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W22-0201

JLA PROJECT NUMBER:



MCKEE ROAD MIXED USE DEVELOPMENT

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REVISION SCHEDULE


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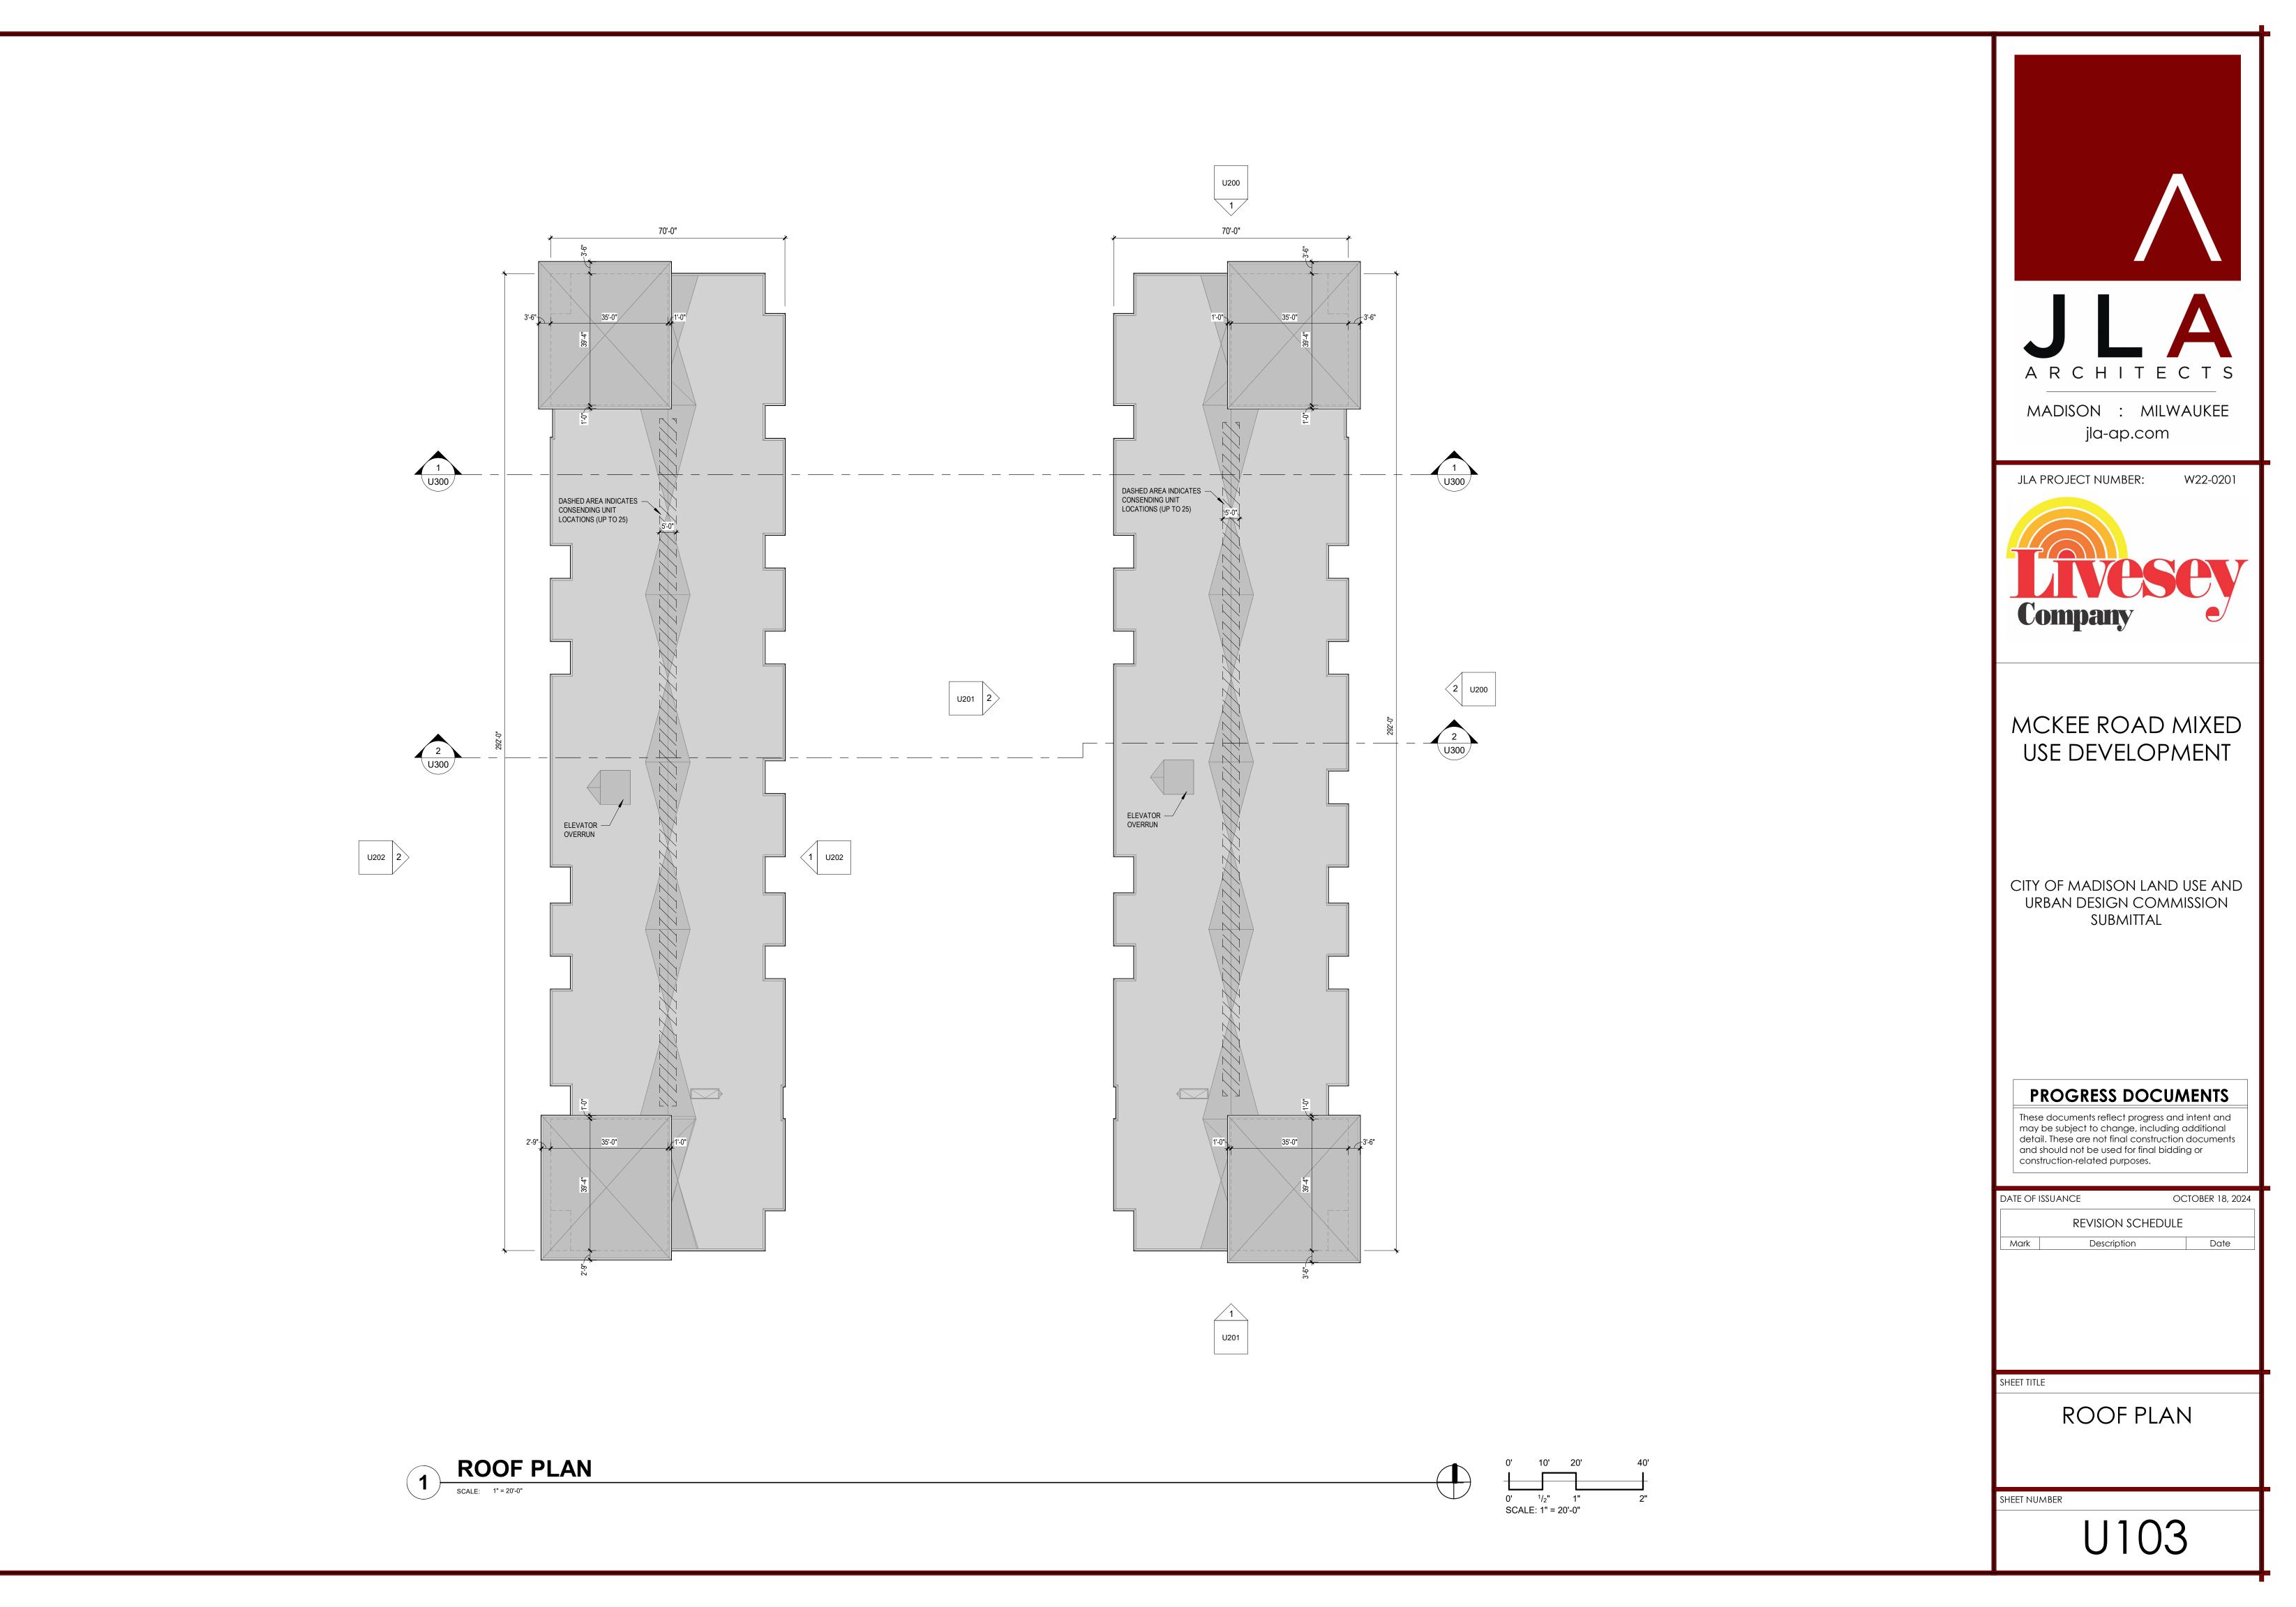
SHEET TITLE

SCALE: 1" = 20'-0"

FIRST FLOOR PLAN

SHEET NUMBER




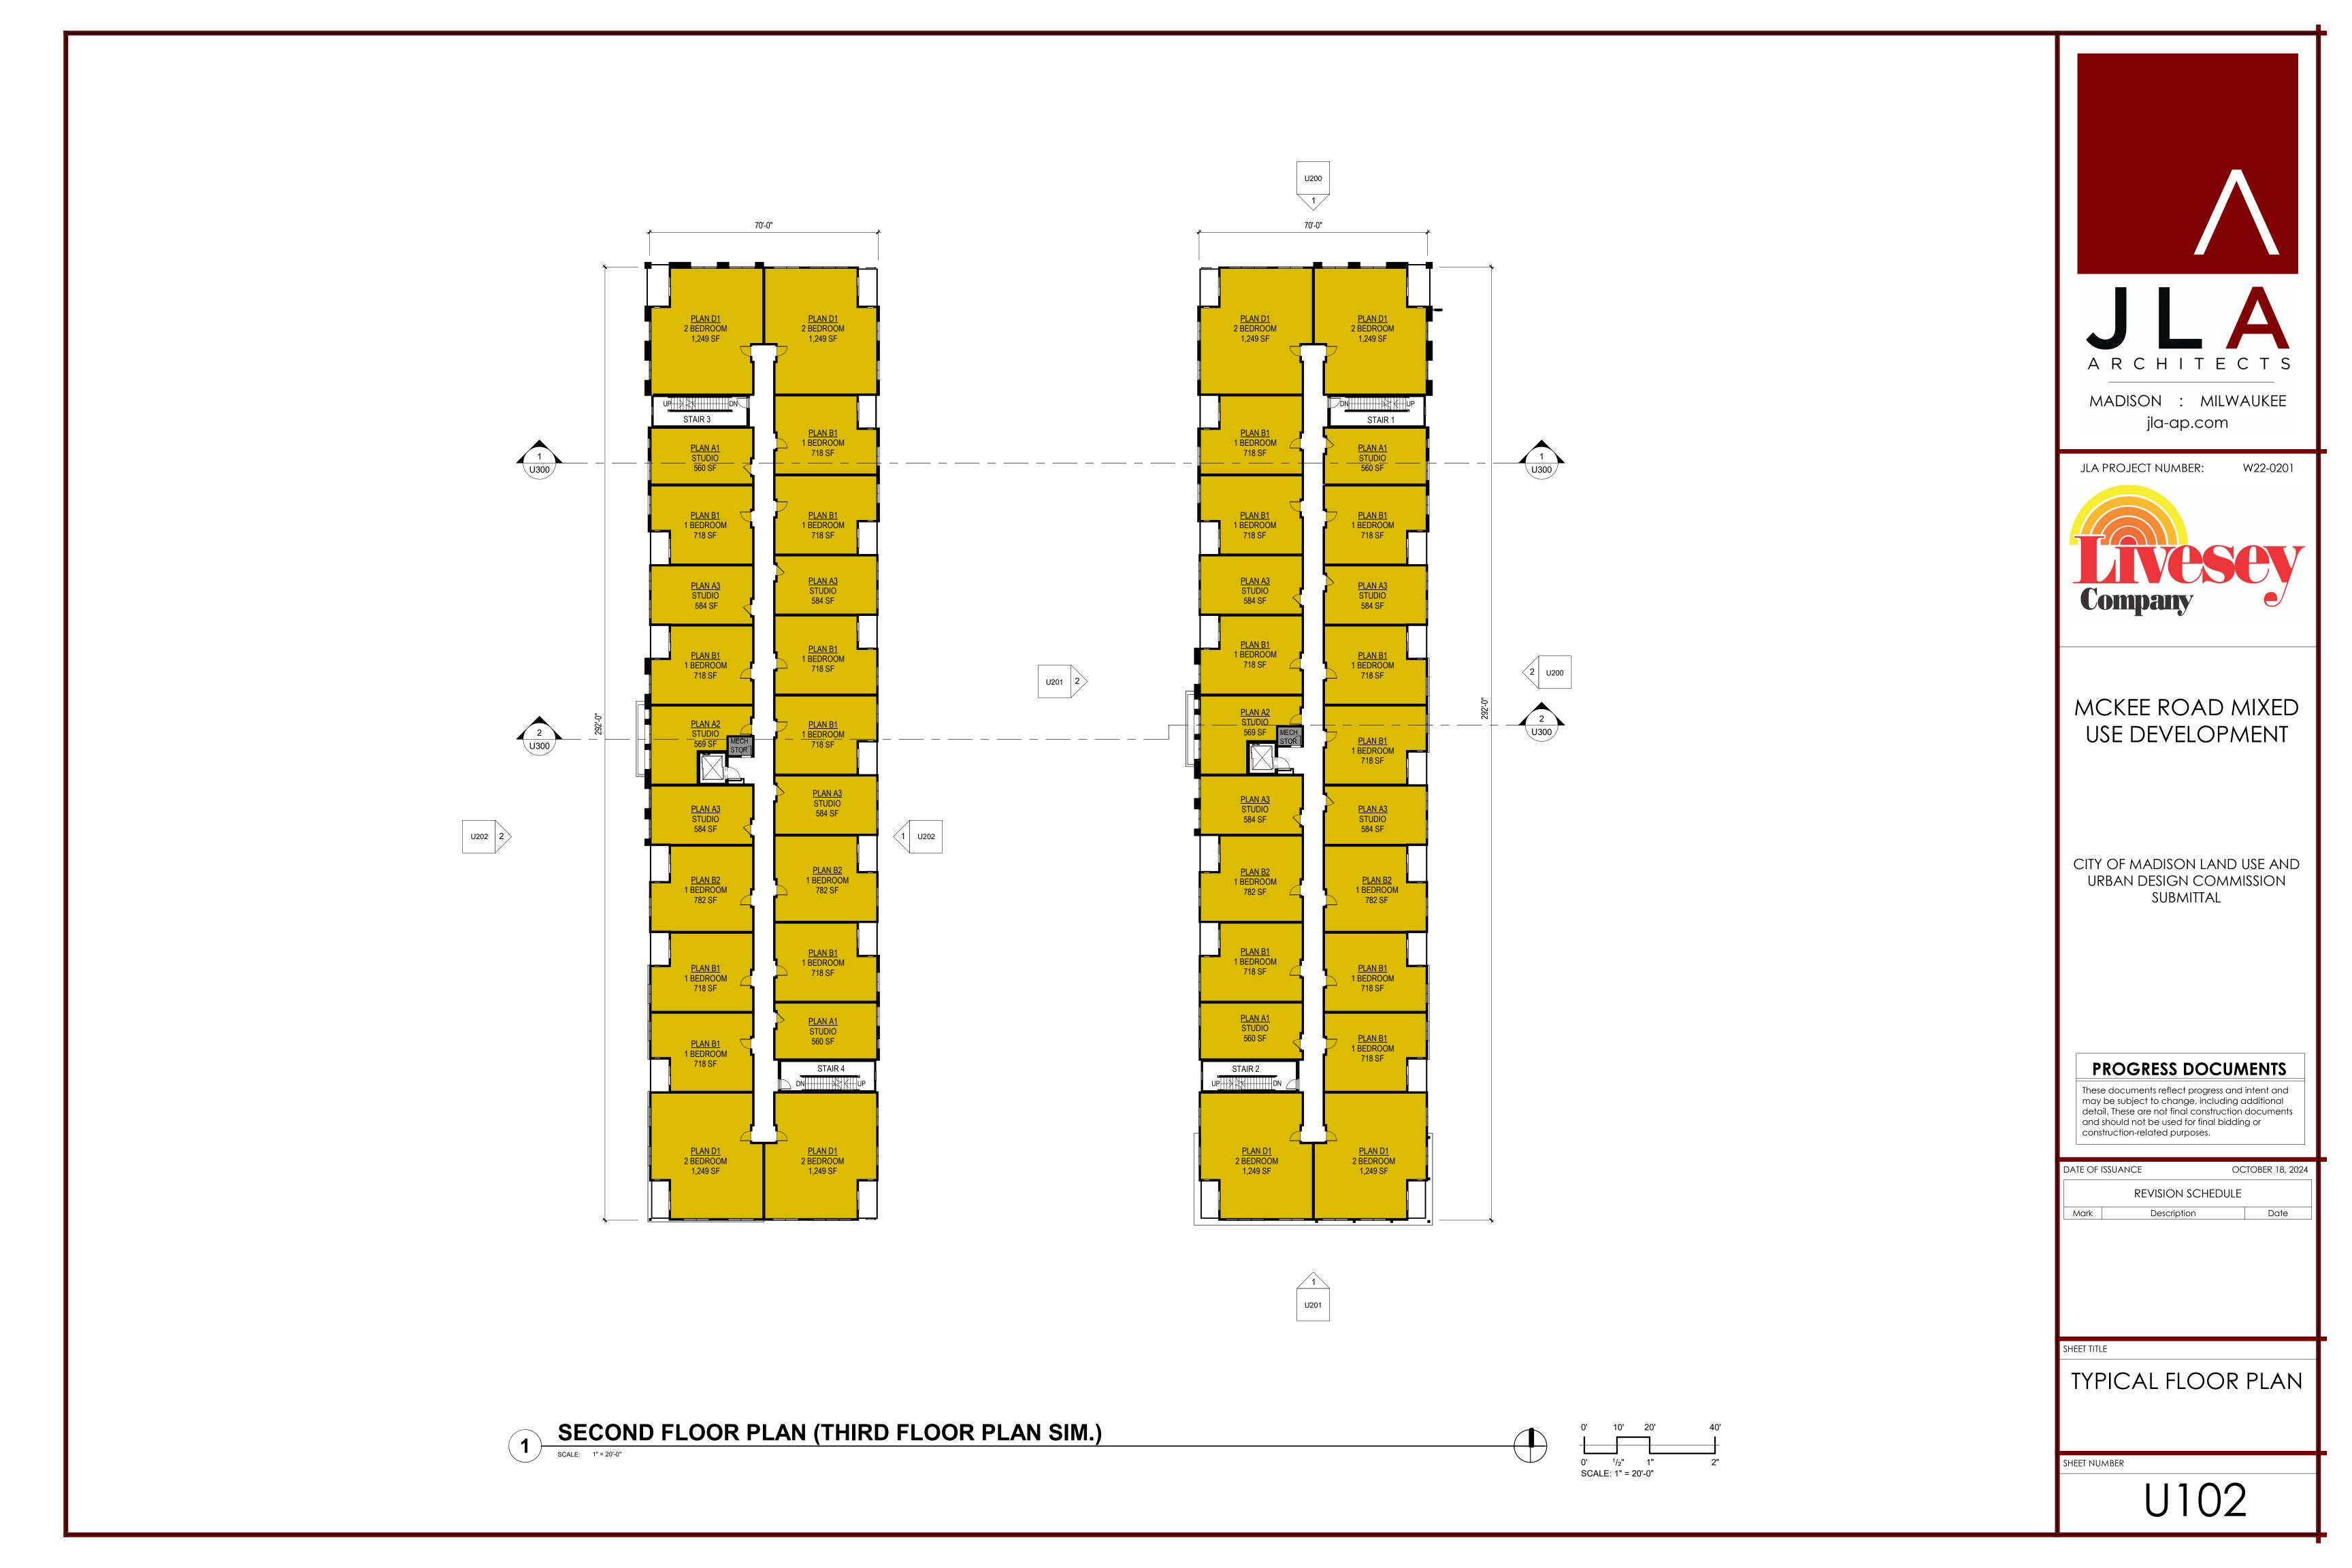







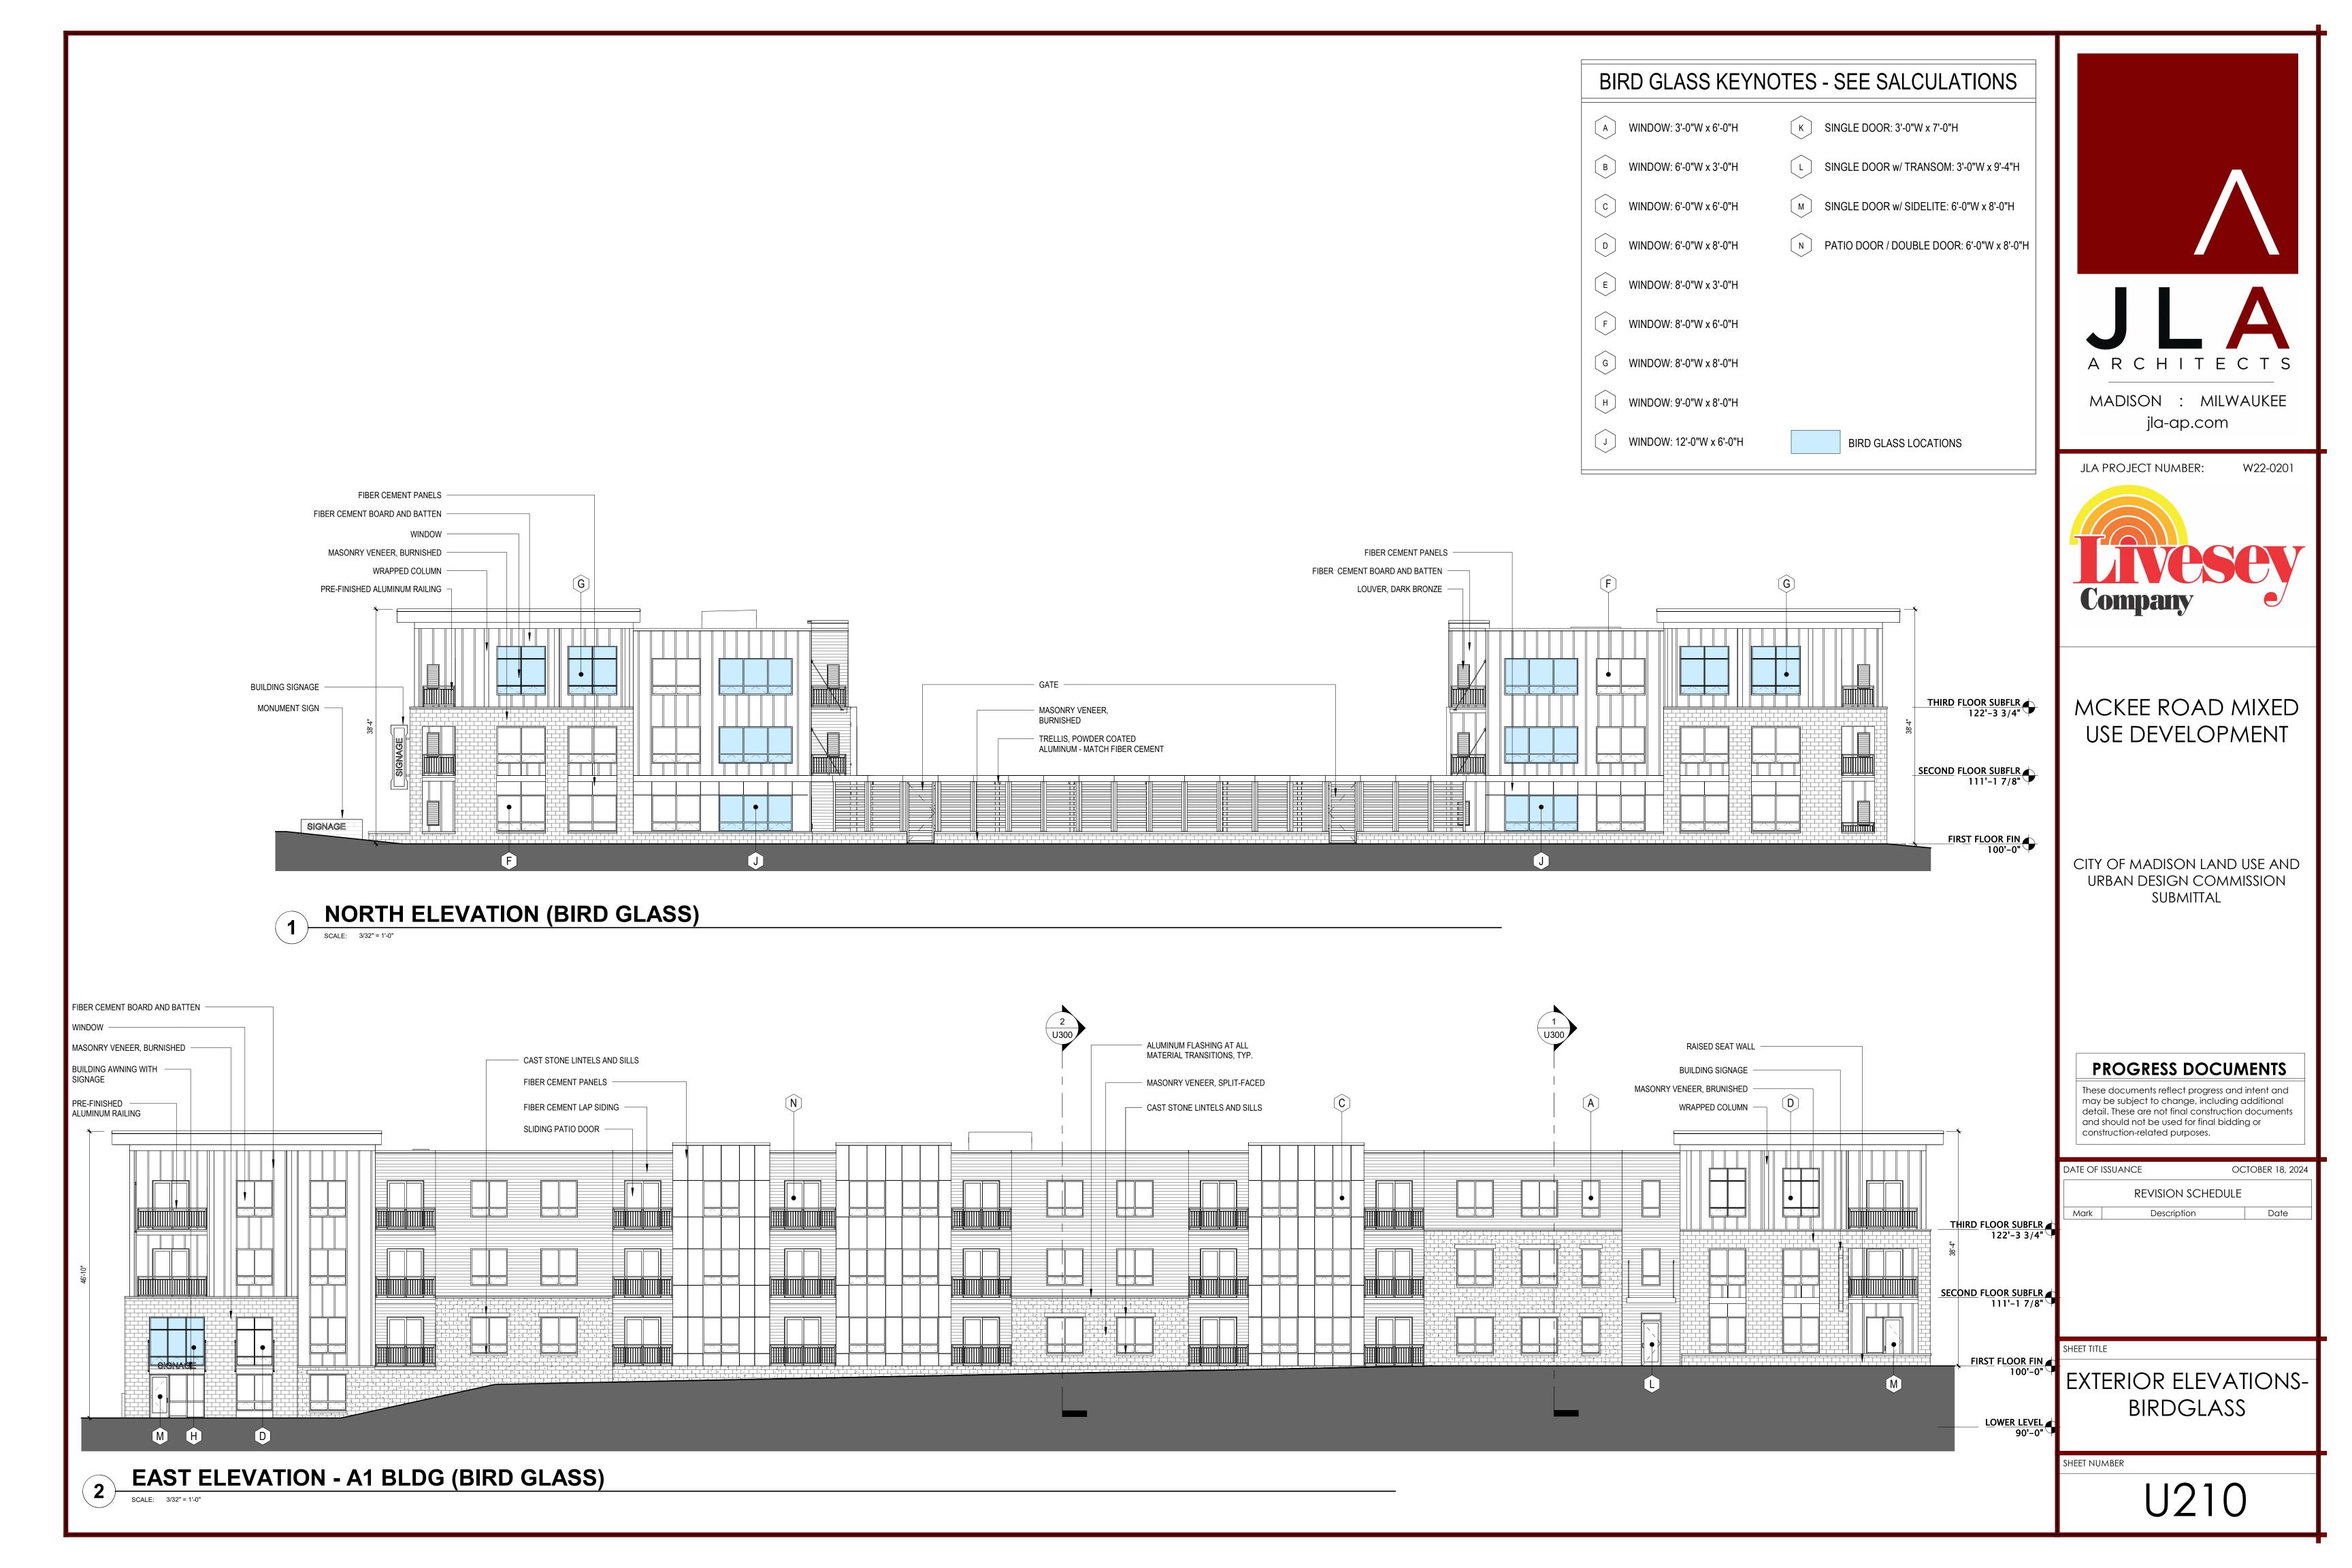


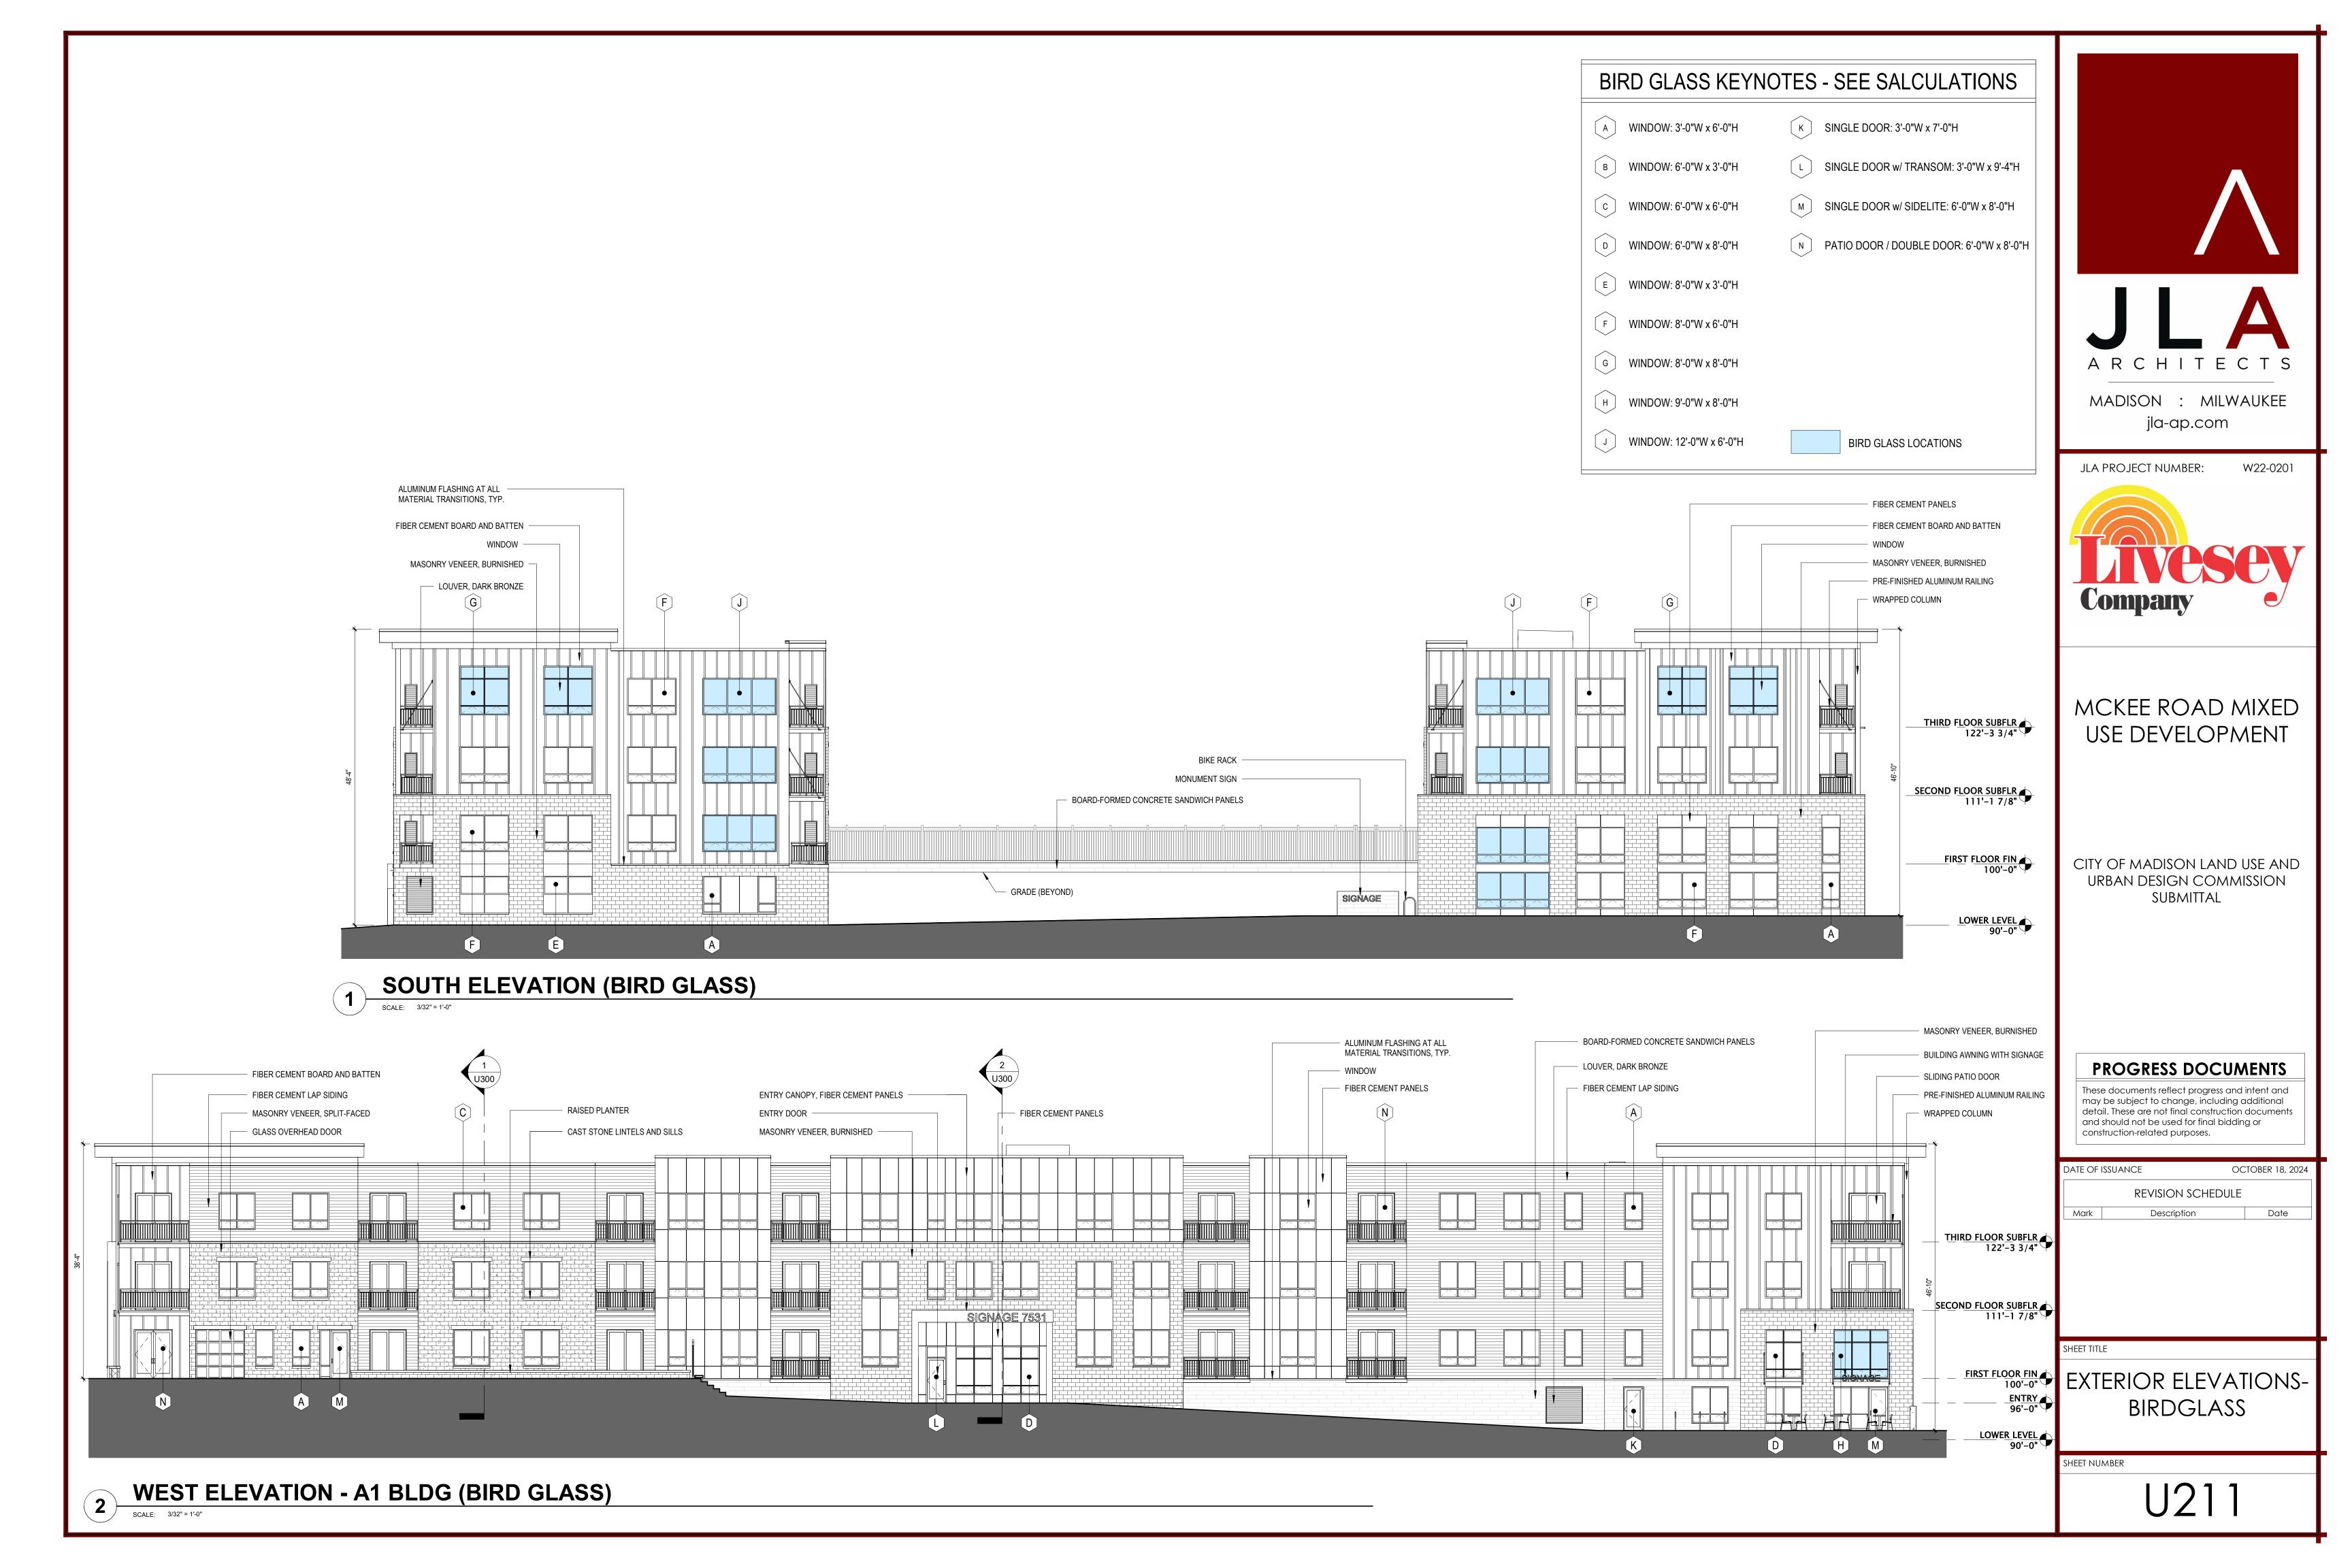





Figure 1 - Window Mullion Graphic

SPANDRELL (OPAQUE) GLASS MUST HAVE A REFLECTIVITY OF 14% OR

✓ LESS IN ORDER TO NOT BE COUNTED IN GLASS AREA CALCULATIONS

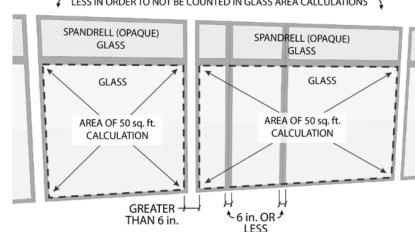

BIRD- SAFE GLASS WINDOW MULLION GRAPHIC

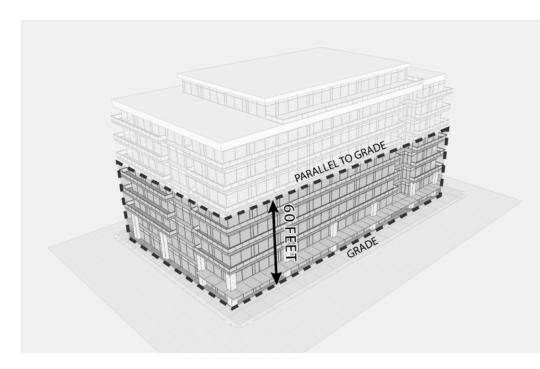

BIRD- SAFE GLASS 60-FOOT GRAPHIC

28.129 BIRD-SAFE REQUIREMENTS:

(1) Statement of Purpose: The Bird-Safe Glass Requirements in this section are intended to reduce the heightened risk for bird collisions with glass on specified building designs and configurations.

(2) Applicability: Subsection (4) applies to all exterior construction and development activity, including the expansion of existing buildings and structures, as specified therein.

(3) Measuring Glass Area: Under this Ordinance, glass area shalle be measured as one (1) continuous panel of glass or other transparent material, or a set of two (2) or more such panels divided by mullions of six (6) inches in width or narrower. Panels surrounded on all sides by solid walls or mullions wider than six (6) inches shall be considered individual windows. Spandrel or opaque reflectivity of 14% or less shall not be included in the calculation of glass area. See Revised Figure 1.

(4) Bird-Safe Glass Treatment Requirements: Glass areas on the following buildings or structures shall be treated to reduce the risk of bird collision by incorporating a pattern of visual markers that are either; a) dots or other isolated shapes that are 1/4" in diameter or larger and spaced at not more than a two-inch (2") by two-inch (2") pattern; or b) lines that are 1/8" in width or greater and spaced no more than 2" apart; low reflective opaque materials; building-integrated structures like non-glass double-skin facades, metal screens, fixed solar shading, exterior insect screens, and other features that cover the glass surface; or other similar mitigation treatments approved by the Zoning Administrator.

(a) Buildings or structures over 10,000 square feet: For any building or structure over 10,000 square feet in size (floor area of above-grade stories), bird-safe glass treatment is required as follows:

1. For building facades where the first sixty (60) feet (See REVISED Figure 2) from grade are comprised of greater than or equal to fifty percent (50%) glass:

a. At least eighty-five percent (85%) of the glass must be treated; and

b. All glass within fifteen (15) feet of a building corner must be treated when see through or fly through conditions exist. See Figure 3.

2. For building facades where the first sixty (60) feet from grade are comprised of less than fifty percent (50%) glass;

a. At least eighty-five percent (85%) of the glass on glass areas fifty (50) square feet or over must be treated; and b. Of all glass areas over fifty (50) square feet, any glass within fifteen (15) feet of a building corner must be treated.

3. All glass railings must be treated.

4. All glass on enclosed building connections shall be treated up to sixty (60) feet above grade.

(b) Sky-bridges: For buildings and structures of any size, all glass on above-ground bridges must be treated.

(c) At grade glass: For buildings and structures of any size, all at grade glass features such as sound walls or glass screens must be treated.

(5) This Ordinance shall become effective October 1, 2020.

McKee Avenue Mixed-Use
BIRD GLASS CALCULATIONS

10/7/2024

Building A1

*50+ SQ FT AND REQUIRE A BIRD GLAZING SAFETY SYSTEM ON A MIN. OF 85% OF THE GLAZING

					WALL DESIGNATION							
					NORTH E	LEVATION	SOUTH E	LEVATION	EAST EL	EVATION	WEST EL	.EVATION
WINDOW/ DOOR DESIGNATION	WIDTH	HEIGHT	# OF PANES	AREA	GLZ AREA	# WINDOW	GLZ AREA	# WINDOW	GLZ AREA	# WINDOW	GLZ AREA	# WINDOW
A: WINDOW - 3'-0"x 6'-0"	3.0	6.0	2	18.0	0.0	0	36.0	2	162.0	9	180.0	10
B: WINDOW - 6'-0"x 3'-0"	6.0	3.0	2	18.0	0.0	O	0.0	0	0.0	0	0.0	0
C: WINDOW - 6'-0" x 6'-0"	6.0	6.0	4	36.0	0.0	O	0.0	0	1620.0	45	1620.0	45
D: WINDOW - 6'-0" x 8'-0"	6.0	8.0	6	48.0	0.0	C	0.0	0	144.0	3	144.0	3
E: WINDOW - 8'-0" x 3'-0"	8.0	3.0	2	24.0	0.0	C	0.0	0	0.0	0	0.0	0
F: WINDOW - 8'-0" x 6'-0"	8.0	6.0	4	48.0	336.0	7	480.0	10	0.0	0	0.0	0
G: WINDOW - 8'-0" x 8'-0"	8.0	8.0	6	64.0	128.0	2	128.0	2	0.0	0	0.0	0
H: WINDOW - 9'-0" x 8'-0"	9.0	8.0	9	72.0	0.0	0	0.0	0	72.0	1	72.0	1
J: WINDOW - 12'-0" x 6'-0"	12.0	6.0	6	72.0	216.0	3	288.0	4	0.0	0	0.0	0
K: DOOR - 3'-0" x 7'-0"	3.0	7.0	1	21.0	0.0	0	0.0	0	21.0	1	21.0	1
L: DOOR & TRANSOM: 3'-0" x 9'-4"	3.0	9.3	2	27.9	0.0	0	0.0	0	27.9	1	27.9	1
M: DOOR & SIDELITE: 6'-0" x 8'-0"	6.0	8.0	2	48.0	0.0	O	0.0	0	96.0	2	96.0	2
N: PATIO DOOR: 6'-0" x 8'-0"	6.0	8.0	2	48.0	0.0	0	0.0	0	960.0	20	960.0	20
					680.0	TOTAL GLZ	932.0	TOTAL GLZ	3,102.9	TOTAL GLZ	3,120.9	TOTAL GLZ
					2,045	WALL AREA	2,834	WALL AREA	11,592	WALL AREA	11,087	WALL AREA
					33.25%	% GLAZING	32.89%	% GLAZING	26.77%	% GLAZING	28.15%	% GLAZING

*50+ SQ FT AND REQUIRE A BIRD GLAZING SAFETY SYSTEM ON A MIN. OF 85% OF THE GLAZING

25.99% % GLAZING

26.22% % GLAZING

25.62% % GLAZING

Building A2

					WALL DESIGNATION									
					NORTH E	LEVATION	SOUTH E	LEVATION	EAST EL	EVATION .	WEST EL	EVATION		
WINDOW/ DOOR DESIGNATION	WIDTH	HEIGHT	# OF PANES	AREA	GLZ AREA	# WINDOW	GLZ AREA	# WINDOW	GLZ AREA	# WINDOW	GLZ AREA	# WINDOW		
A: WINDOW - 3'-0"x 6'-0"	3.0	6.0	2	18.0	0.0	0	36.0	2	108.0	6	126.0	7		
B: WINDOW - 6'-0"x 3'-0"	6.0	3.0	2	18.0	0.0	0	0.0	0	36.0	2	36.0	2		
C: WINDOW - 6'-0" x 6'-0"	6.0	6.0	4	36.0	0.0	0	0.0	0	1620.0	45	1512.0	42		
D: WINDOW - 6'-0" x 8'-0"	6.0	8.0	6	48.0	0.0	0	0.0	0	0.0	0	288.0	6		
E: WINDOW - 8'-0" x 3'-0"	8.0	3.0	2	24.0	0.0	0	0.0	0	0.0	0	0.0	(
F: WINDOW - 8'-0" x 6'-0"	8.0	6.0	4	48.0	336.0	7	336.0	7	0.0	0	0.0	C		
G: WINDOW - 8'-0" x 8'-0"	8.0	8.0	6	64.0	128.0	2	128.0	2	0.0	0	0.0	C		
H: WINDOW - 9'-0" x 8'-0"	9.0	8.0	9	72.0	0.0	0	0.0	0	0.0	0	0.0	C		
J: WINDOW - 12'-0" x 6'-0"	12.0	6.0	6	72.0	216.0	3	216.0	3	0.0	0	0.0	C		
K: DOOR - 3'-0" x 7'-0"	3.0	7.0	1	21.0	0.0	0	0.0	0	21.0	1	21.0	1		
L: DOOR & TRANSOM: 3'-0" x 9'-4"	3.0	9.3	2	27.9	0.0	0	0.0	0	0.0	0	27.9	1		
M: DOOR & SIDELITE: 6'-0" x 8'-0"	6.0	8.0	2	48.0	0.0	0	0.0	0	96.0	2	0.0	(
N: PATIO DOOR: 6'-0" x 8'-0"	6.0	8.0	2	48.0	0.0	0	0.0	0	1104.0	23	1008.0	21		
					680.0	TOTAL GLZ	716.0	TOTAL GLZ	2,985.0	TOTAL GLZ	3,018.9	TOTAL GLZ		
					2,045	WALL AREA	2,755	WALL AREA	11,384	WALL AREA	11,785	WALL AREA		

33.25% % GLAZING



jla-ap.com

W22-0201

JLA PROJECT NUMBER:



MCKEE ROAD MIXED USE DEVELOPMENT

CITY OF MADISON LAND USE AND URBAN DESIGN COMMISSION SUBMITTAL

PROGRESS DOCUMENTS

These documents reflect progress and intent and may be subject to change, including additional detail. These are not final construction documents and should not be used for final bidding or construction-related purposes.

DATE OF I	SSUANCE	OCTOBER 18, 2024
	revision sched	ULE
Mark	Description	Date

SHEET TITLE

BIRDGLASS CALCULATIONS

SHEET NUMBER



DARK BRONZE FINISH: WINDOWS, LOUVERS, COPING, RAILINGS, PICKET FENCES




FIBER CEMENT LAP SIDING: AGED PEWTER



METALIC BRONZE: FIBER CEMENT CLADDING AND ARCHITECTURAL SCREEN POWDER COAT



CMU: BURNISHED CREAM COLOR

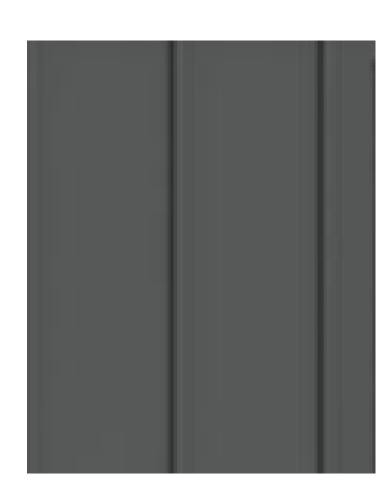

FIBER CEMENT PANEL:

IRON GRAY


FIBER CEMENT BOARD AND BATTEN: **IRON GRAY**




CMU: SPLITFACE CREAM COLOR




BOARD FORMED CONCRETE

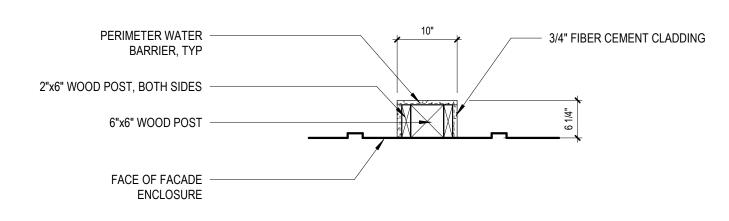


PLAN DETAIL: CLAD PILASTER

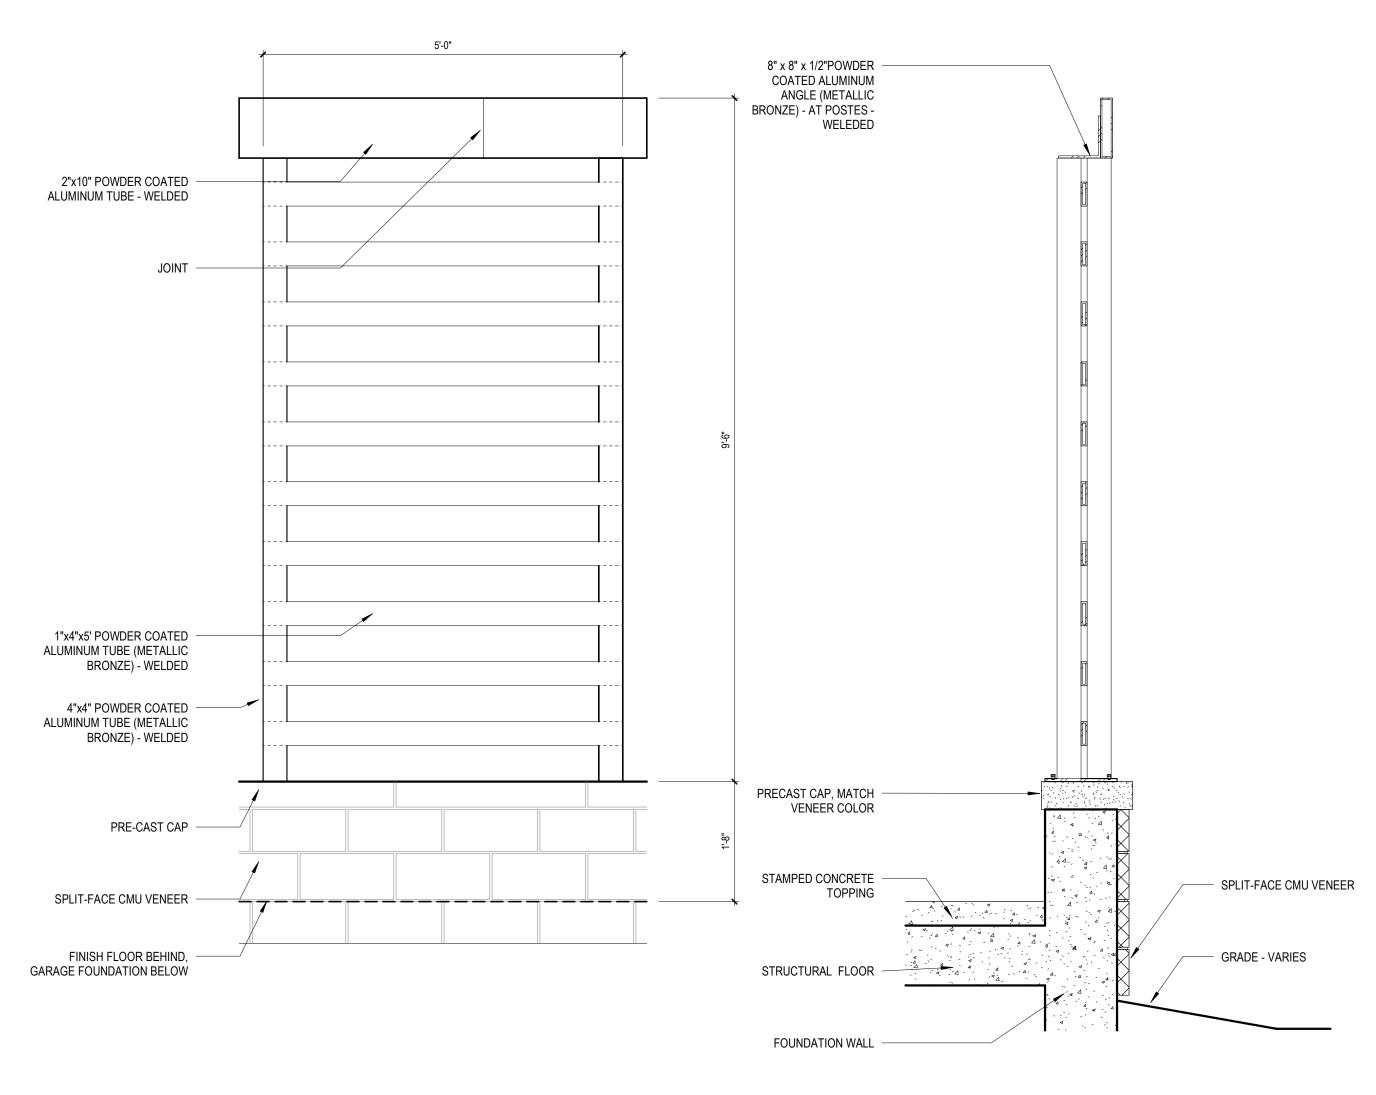

ENLARGED ELEVATION: ARCHITECTURAL SCREEN PANEL

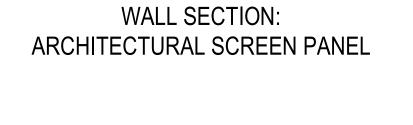

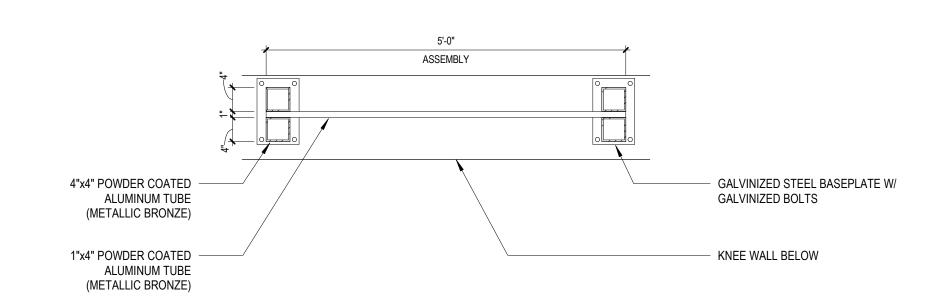

ENLARGED PLAN: ARCHITECTURAL SCREEN PANEL



JLA PROJECT NUMBER: W22-0201

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MCKEE ROAD MIXED USE DEVELOPMENT

CITY OF MADISON LAND USE AND URBAN DESIGN COMMISSION SUBMITTAL

PROGRESS DOCUMENTS

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	REVISION SCHE	DULE	
Mark	Description		Date

EXTERIOR MATERIALS & BUILDING DETAILS

SHEET NUMBER



PRECAST CONCRETE: LINTEL, SILL, WALL CAPS



PERSPECTIVE RENDERING: CORNER OF McKEE ROAD AND MAPLE GROVE DR.



JLA PROJECT NUMBER: W22-0201



MCKEE ROAD MIXED
USE DEVELOPMENT

CITY OF MADISON LAND USE AND URBAN DESIGN COMMISSION SUBMITTAL

PROGRESS DOCUMENTS

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DATE OF	ISSUANCE OC	CTOBER 18, 2024
	REVISION SCHEDULE	
Mark	Description	Date

SHEET

EXTERIOR RENDERINGS

Sheet Number



PERSPECTIVE RENDERING: McKEE ROAD - CORNER OF BUILDING A2



W22-0201

JLA PROJECT NUMBER:



MCKEE ROAD MIXED
USE DEVELOPMENT

CITY OF MADISON LAND USE AND URBAN DESIGN COMMISSION SUBMITTAL

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DATE OF	SSUANCE OC	CTOBER 18, 2024
	REVISION SCHEDULE	
Mark	Description	Date

SHEET

EXTERIOR RENDERINGS

SHEET NUMBER



PERSPECTIVE RENDERING: TERRACE AND POOL DECK FROM BACLONY



JLA PROJECT NUMBER: W22-0



MCKEE ROAD MIXED
USE DEVELOPMENT

CITY OF MADISON LAND USE AND URBAN DESIGN COMMISSION SUBMITTAL

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DATE OF ISSUANCE OCTOBER 18, 2024

REVISION SCHEDULE

Mark Description Date

SHEET

EXTERIOR RENDERINGS

SHEET NUMBER



PERSPECTIVE RENDERING: CORNER OF MAPLE GROVE DR. AND MADER DR. COMMERICAL FACADE



JLA PROJECT NUMBER: W22-0201



MCKEE ROAD MIXED
USE DEVELOPMENT

CITY OF MADISON LAND USE AND URBAN DESIGN COMMISSION SUBMITTAL

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REVISION SCHEDULE

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SHEET

EXTERIOR RENDERINGS

SHEET NUMBER



PERSPECTIVE RENDERING: INTERNAL PARKING LOT AND COMMERCIAL FACADE



JLA PROJECT NUMBER: W22-0201



MCKEE ROAD MIXED
USE DEVELOPMENT

CITY OF MADISON LAND USE AND URBAN DESIGN COMMISSION SUBMITTAL

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REVISION SCHEDULE

Mark Description Date

SHEET

EXTERIOR RENDERINGS

SHEET NUMBER



PERSPECTIVE RENDERING: MAIN RESIDENTIAL ENTRY



JLA PROJECT NUMBER: W22-0201



MCKEE ROAD MIXED
USE DEVELOPMENT

CITY OF MADISON LAND USE AND URBAN DESIGN COMMISSION SUBMITTAL

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REVISION SCHEDULE

Mark Description Date

SHEET TITLE

EXTERIOR RENDERINGS

SHEET NUMBER



RENDERING: PARTIAL ELEVATION OF PATIO AMENITY AND RESIDENTIAL STAIR ACCESS



JLA PROJECT NUMBER: W22-0201



MCKEE ROAD MIXED
USE DEVELOPMENT

CITY OF MADISON LAND USE AND URBAN DESIGN COMMISSION SUBMITTAL

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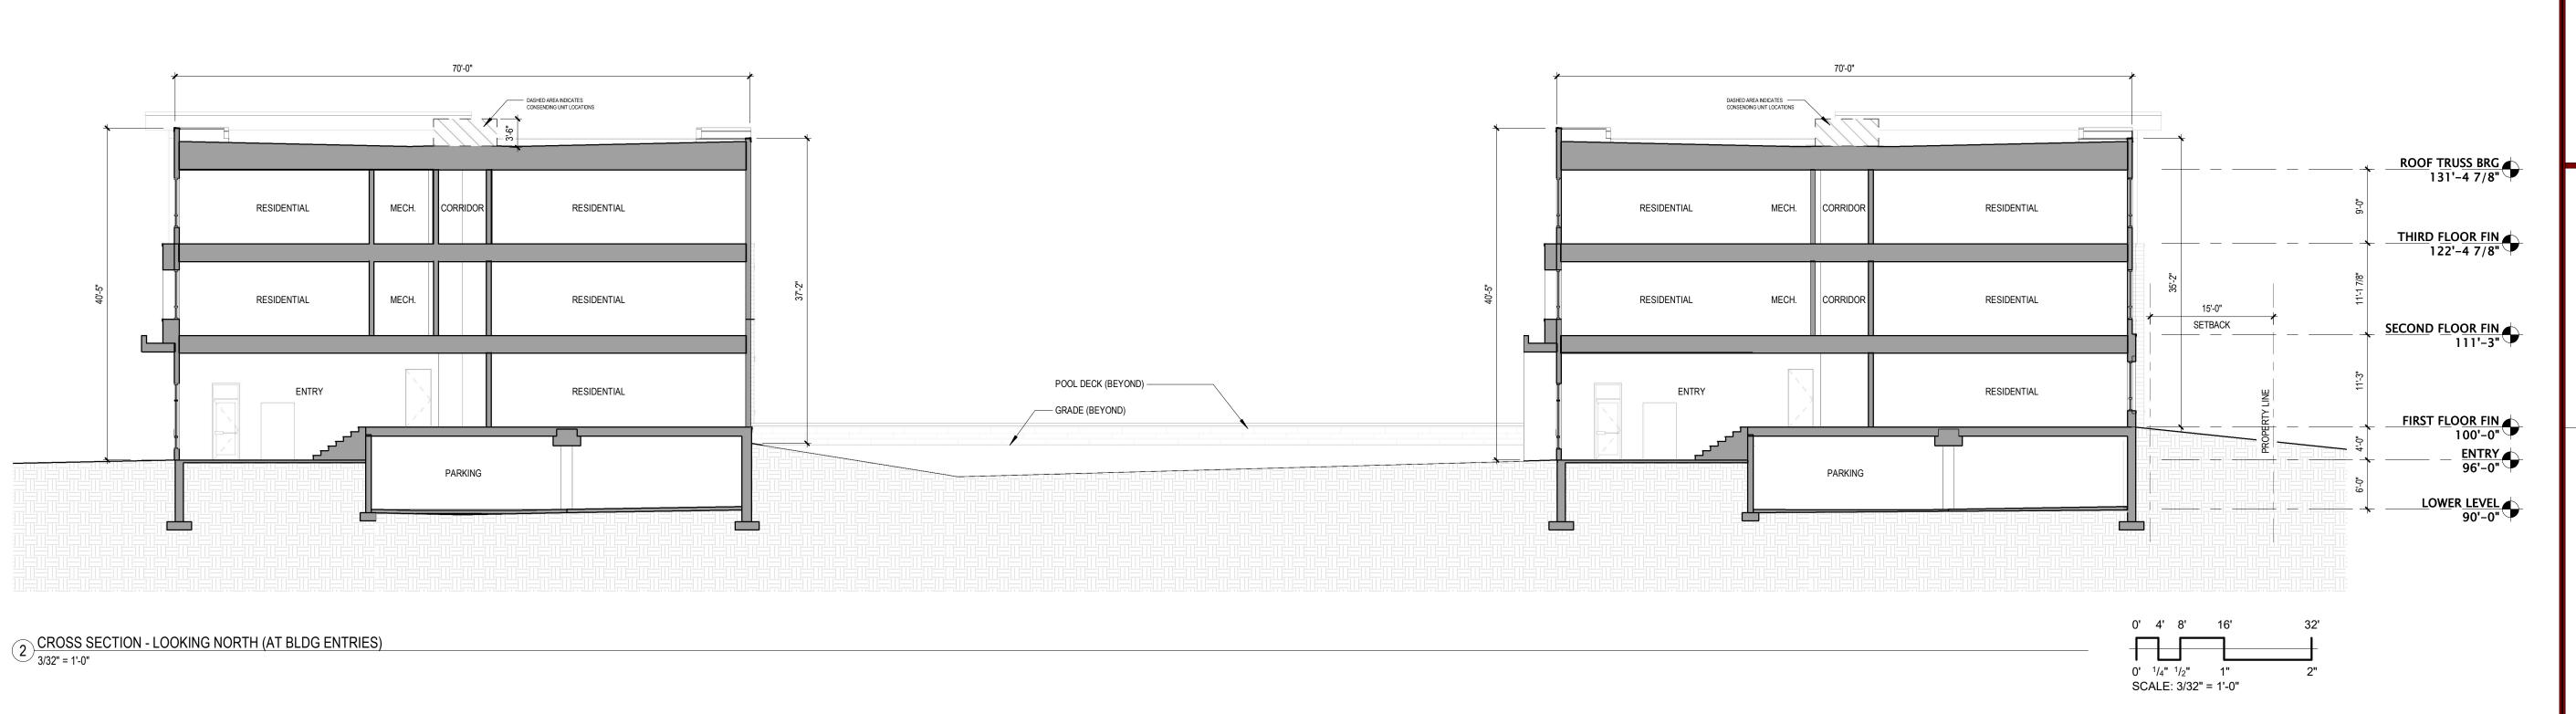
REVISION SCHEDULE


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EXTERIOR RENDERINGS

SHEET NUMBER





MADISON : MILWAUKEE
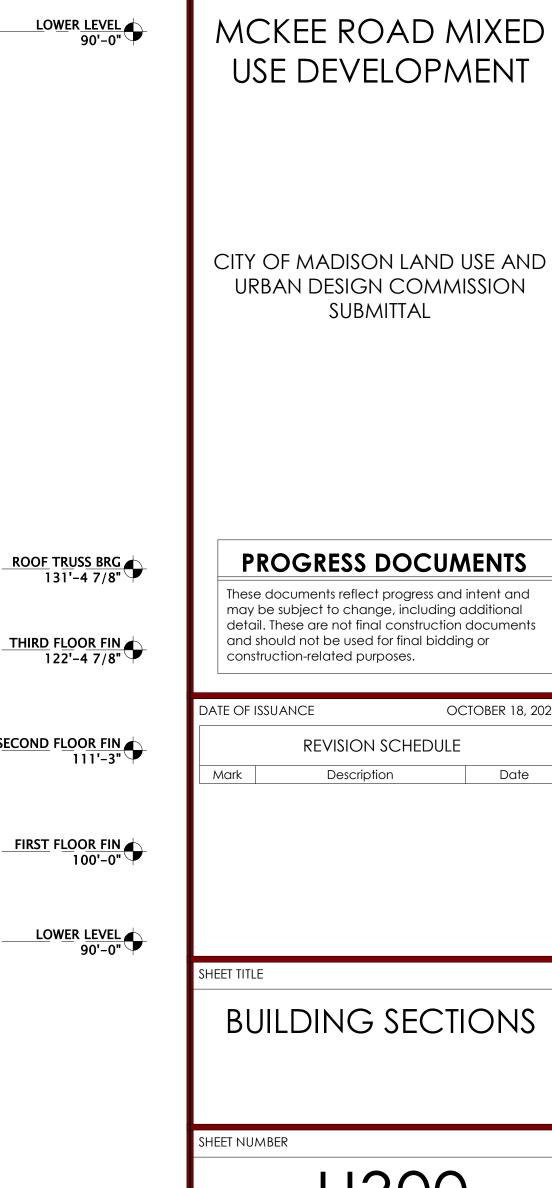
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SUBMITTAL

Description

U300


OCTOBER 18, 2024

Date

JLA PROJECT NUMBER:

Company

W22-0201

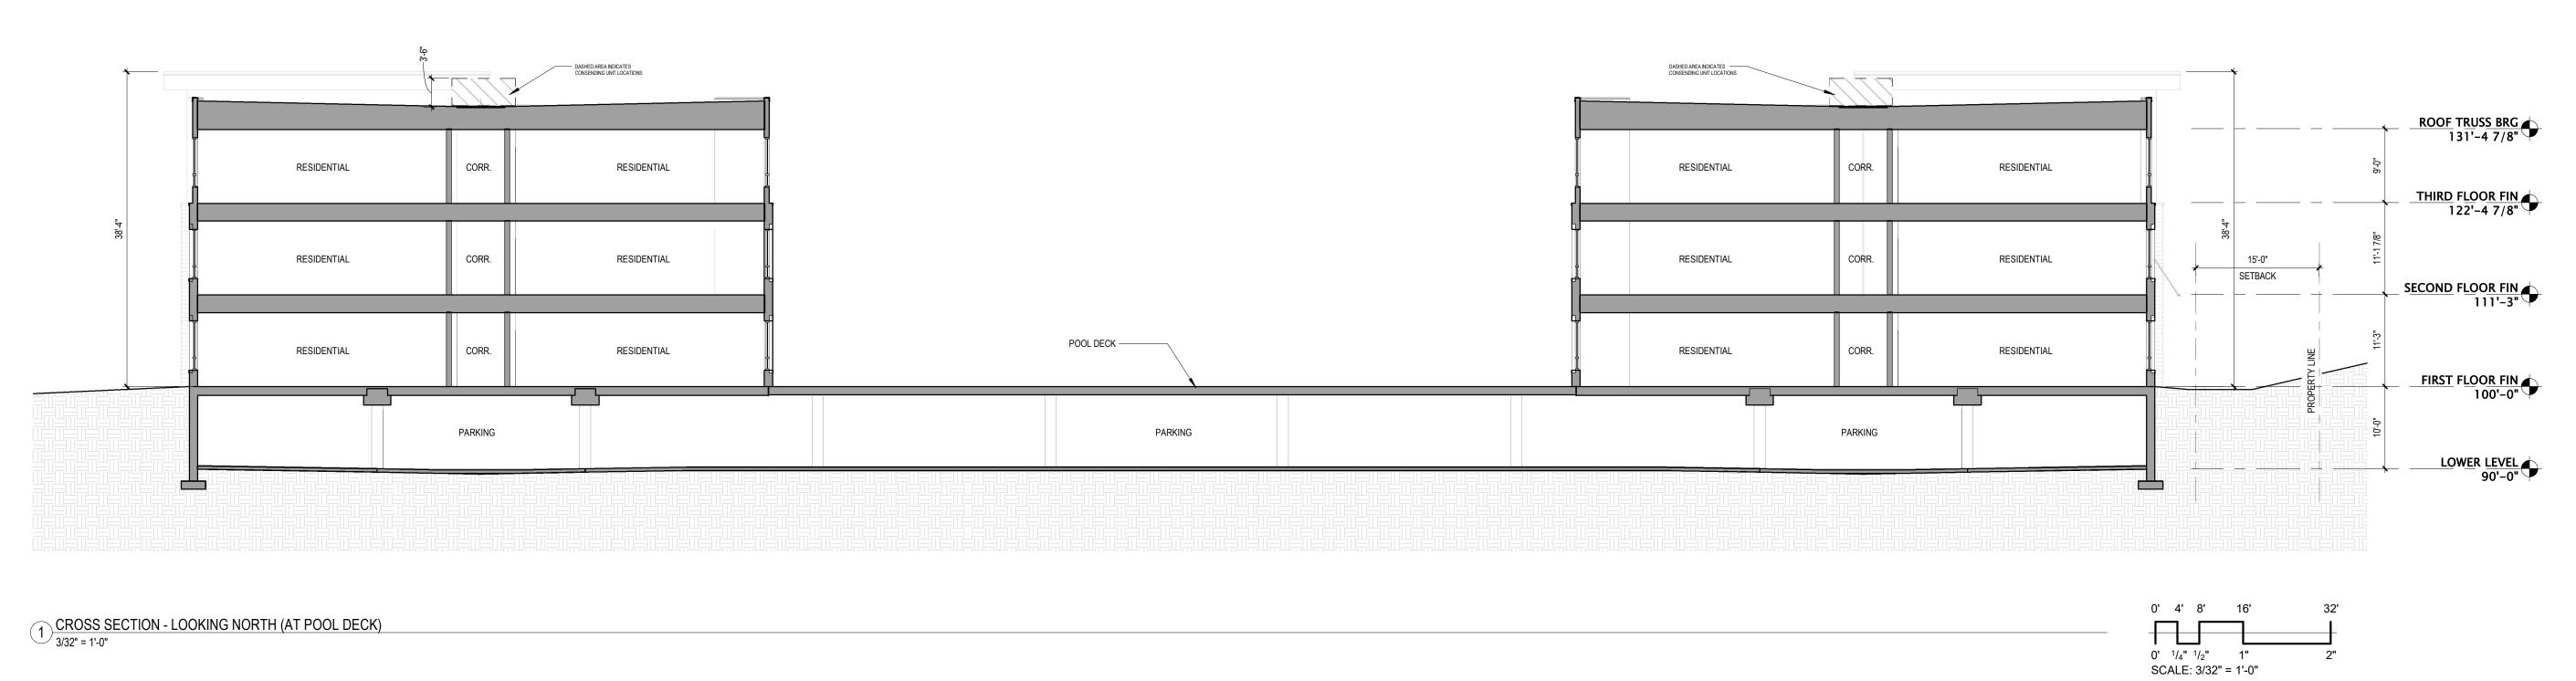


NOTES:

- Customers are responsible for confirming mounting heights, fixture suspension types/lengths, color temperature, CRI, linear fixture lengths, pole lengths, and bollard heights/lengths prior to ordering.
- Mounting height (MH) is measured from the bottom of the fixture to the floor.
- This Lighting layout assumes the following unless values are specified and must be confirmed by the customer prior to ordering.
- •• Room reflectance of 80, 50, 20 for standard ceilings and 50, 50, 20 for exposed ceilings
- Wall sconces are mounted at 7' for calculation purposes. Customer must confirm desired mounting height before rough in.

Description	Symbol	Avg	Max	Min	Max/Min	Avg/Min
Dog Run_At Grade	+	2.16 fc	4.16 fc	0.57 fc	7.3:1	3.8:1
Lot 1 East Sidewalk_At Grade	+	2.36 fc	6.27 fc	1.00 fc	6.3:1	2.4:1
Lot 2 East Sidewalk_At Grade	+	1.90 fc	3.43 fc	0.64 fc	5.4:1	3.0:1
Lot 2 West Sidewalk_At Grade	+	1.91 fc	3.85 fc	0.67 fc	5.7:1	2.9:1
NE Patio_At Grade	+	2.17 fc	5.46 fc	0.61 fc	9.0:1	3.6:1
North Sidewalk_At Grade	+	1.64 fc	3.72 fc	0.62 fc	6.0:1	2.6:1
Parking Lot 1_At Grade	+	1.70 fc	4.55 fc	0.48 fc	9.5:1	3.5:1
Parking Lot 2_At Grade	+	1.74 fc	3.53 fc	0.84 fc	4.2:1	2.1:1
Typical Under Canopy At Grade	T +	9.36 fc	13.86 fc	6.29 fc	2.2:1	1.5:1

Grade			'	0.0110	0.0110	0.0010	14//	
Schedule								
Label	QTY	Manufacturer	Catalog			Lamp Output	LLF	Input Power
D1	21	Lithonia Lighting	LDN4 ALO2 (1000LM) SWW1 AR LSS 80CRI			1353	0.9	12.57
OA3	3	Lithonia Lighting	RSX1 LED P2 XXK R3 MVOLT XXXX + 20FT SSS POLE (ASSUMES 3FT BASE)			E 9843	0.95	72.95
ОАЗН	2	Lithonia Lighting	RSX1 LED P2 XXK R POLE (ASSUMES 3F		XXX + 20FT SSS	6909	0.95	72.95
OA4	1	Lithonia Lighting	RSX1 LED P2 XXK R (ASSUMES 3FT BAS		+ 20FT SSS POL	E 9972	0.95	72.95
OA4H	1	Lithonia Lighting	RSX1 LED P2 XXK R4 HS MVOLT XXXX + 20FT SSS POLE (ASSUMES 3FT BASE)			6554	0.95	72.95
OA5	1	Lithonia Lighting	RSX1 LED P2 XXK R5 MVOLT XXXX + 10FT SSS POLE (ASSUMES 3FT BASE)			LE 10106	0.95	72.95
OB1	21	FC Lighting	FCB6C-4WN03-UNV-40-XXK-3L-XXX-LD			331	1	10.72
OS1	4	BROWNLEE LIGHTING INC	7070-08-PL-U07-WD-XXK			881	0.95	6.8702
OW1	10	Lithonia Lighting	WPX1 LED P2 XXK N	IVOLT XXXX		2913	0.95	24.42

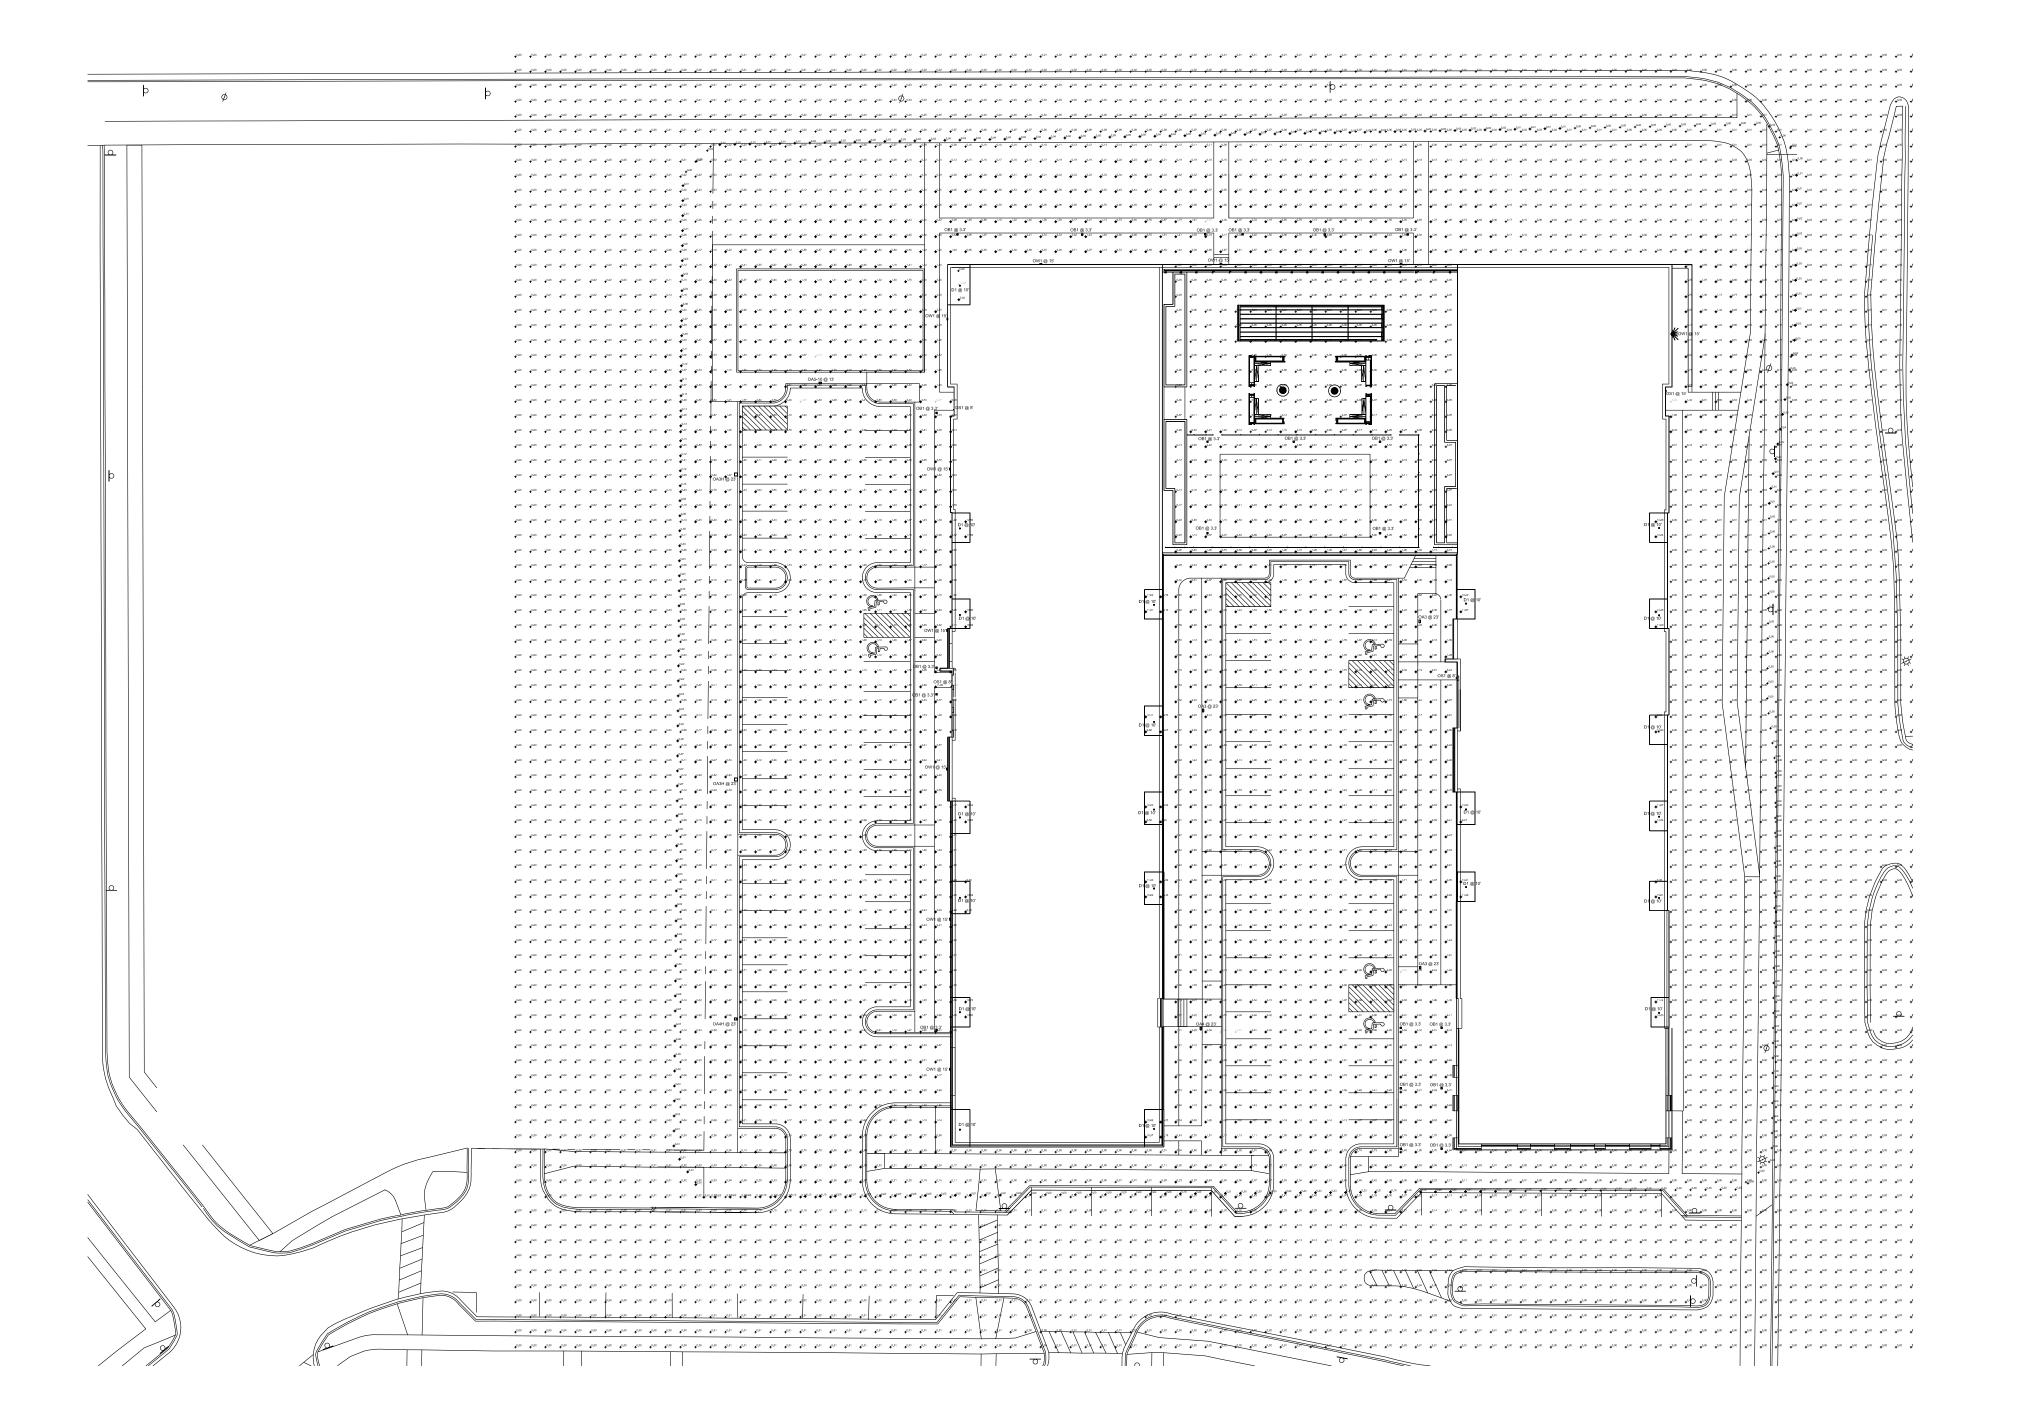

J. L. A. A. A. R. C. H. I. T. E. C. T. S.

JLA PROJECT NUMBER: W22-02

ila-ap.com

MADISON : MILWAUKEE



MCKEE ROAD MIXED USE DEVELOPMENT

CITY OF MADISON LAND USE AND URBAN DESIGN COMMISSION SUBMITTAL

PROGRESS DOCUMENTS

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REVISION SCHEDULE

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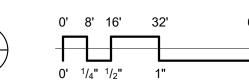
SHEET T

SITE PHOTOMETRICS

SHEET NUMBER

U400

SITE PHOTOMETRICS PLAN



SCALE: 1/32" = 1'-0"



CITY OF MADISON LANDSCAPE WORKSHEET

Section 28.142 Madison General Ordinance

Project Location /	/ Address 6701 McKee Rd./	6702 Mader Dr.	
Name of Project	McKee Rd Mixed Use Develo	pment	
Owner / Contact	Livesey Company		
Contact Phone _	608-833-2929	Contact Email	jake@liveseyco.com
**	. .	ots greater than ten thou ed by a registered lands	usand (10,000) square feet in size cape architect. **
Applicability			
buildings, structu their accessory st	ares and parking lots, except the	ne construction of detach	nent activity, including the expansion of existing ned single-family and two-family dwellings and to compliance with this section unless all of the be brought up to compliance:
(a) The a	rea of site disturbance is less t	han ten percent (10%) of	The entire development site during any ten-(10)
year j	period.		
(b) Gross	floor area is only increased by	ten percent (10%) during	any ten-(10) year period.
(c) No de	emolition of a principal building	g is involved.	
(d) Any d	displaced landscaping elements	must be replaced on the s	site and shown on a revised landscaping plan.
landscape points (a) For a	depending on the size of the lot	and Zoning District. In (b) and (c) below, five	g lot. There are three methods for calculating (5) landscape points shall be provided for each
Т	Cotal square footage of develop	ed area <u>59,723</u>	_
Т	Cotal landscape points required	995	_
	For the first five (5) developed a	•	at five (5) points per three hundred (300) square er one hundred (100) square feet for all additional
Т	Cotal square footage of develop	ed area	_
F	Five (5) acres = $217,800 \text{ square}$	feet	
F	First five (5) developed acres =	3,630 points	
R	Remainder of developed area		_
Т	Cotal landscape points required		_
	the Industrial – Limited (IL) ne hundred (100) square feet of		al (IG) districts, one (1) point shall be provided
Т	Cotal square footage of develop	ed area	_
т	Cotal landscape points required		

Tabulation of Points and Credits

Use the table to indicate the quantity and points for all existing and proposed landscape elements.

Dissa Trans / Elana and	Minimum Size at	Ditak	Credits/ Existing Landscaping		New/ Proposed Landscaping	
Plant Type/ Element	Installation	Points	Quantity	Points Achieved	Quantity	
Overstory deciduous tree	2½ inch caliper measured diameter at breast height (dbh)	35			19	665
Tall evergreen tree (i.e. pine, spruce)	5-6 feet tall	35			0	0
Ornamental tree	1 1/2 inch caliper	15			14	210
Upright evergreen shrub (i.e. arborvitae)	3-4 feet tall	10			51	510
Shrub, deciduous	#3 gallon container size, Min. 12"-24"	3			95	285
Shrub, evergreen	#3 gallon container size, Min. 12"-24"	4			8	32
Ornamental grasses/ perennials	#1 gallon container size, Min. 8"-18"	2			337	674
Ornamental/ decorative fencing or wall	n/a	4 per 10 lineal ft.				
Existing significant specimen tree	Minimum size: 2 ½ inch caliper dbh. *Trees must be within developed area and cannot comprise more than 30% of total required points.	14 per caliper inch dbh. Maximum points per tree: 200				
Landscape furniture for public seating and/or transit connections	* Furniture must be within developed area, publically accessible, and cannot comprise more than 5% of total required points.	5 points per "seat"				
Sub Totals						2376

Total Number of Points Provided	2376	
Total Number of Points Provided		

^{*} As determined by ANSI, ANLA- American standards for nursery stock. For each size, minimum plant sizes shall conform to the specifications as stated in the current American Standard for Nursery Stock.

Landscaping shall be distributed throughout the property along street frontages, within parking lot interiors, as foundation plantings, or as general site landscaping. The total number of landscape points provided shall be distributed on the property as follows.

Total Developed Area

Required landscaped areas shall be calculated based upon the total developed area of the property. Developed area is defined as that area within a single contiguous boundary which is made up of structures, parking, driveways and docking/loading facilities, but excluding the area of any building footprint at grade, land designated for open space uses such as athletic fields, and undeveloped land area on the same zoning lot.

Development Frontage Landscaping

Landscaping and/or ornamental fencing shall be provided between buildings or parking areas and the adjacent street(s), except where buildings are placed at the sidewalk. Landscape material shall include a mix of plant materials.

Interior Parking Lot Landscaping

The purpose of interior parking lot landscaping is to improve the appearance of parking lots, provide shade, and improve stormwater infiltration. **All parking lots with twenty (20) or more parking spaces** shall be landscaped in accordance with the interior parking lot standards.

Foundation Plantings


Foundation plantings shall be installed along building facades, except where building facades directly abut the sidewalk, plaza, or other hardscape features. Foundation plantings shall consist primarily of shrubs, perennials, and native grasses.

Screening Along District Boundaries

Screening shall be provided along side and rear property boundaries between commercial, mixed use or industrial districts and residential districts.

Screening of Other Site Elements

The following site elements shall be screened in compatibility with the design elements, materials and colors used elsewhere on the site: refuse disposal areas, outdoor storage areas, loading areas, and mechanical equipment.

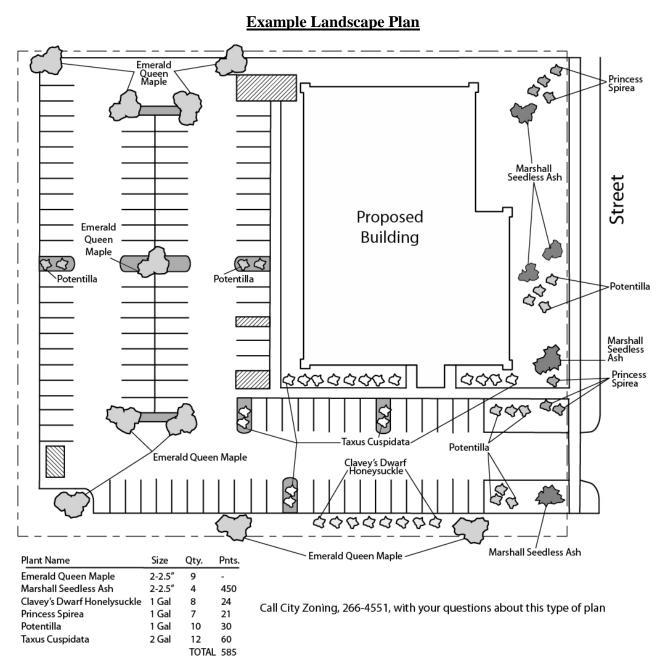

LANDSCAPE PLAN AND LANDSCAPE WORKSHEET INSTRUCTIONS

Refer to Zoning Code Section 28.142 LANDSCAPING AND SCREENING REQUIREMENTS for the complete requirements for preparing and submitting a Landscape Plan and Landscape Worksheet.

Applicability.

The following standards apply to all exterior construction and development activity, including the expansion of existing buildings, structures and parking lots, except the construction of detached single-family and two-family dwellings and their accessory structures. The entire development site must be brought up to compliance with this section unless all of the following conditions apply, in which case only the affected areas need to be brought up to compliance:

- (a) The area of site disturbance is less than ten percent (10%) of the entire development site during any ten-(10) year period.
- (b) Gross floor area is only increased by ten percent (10%) during any ten-(10) year period.
- (c) No demolition of a principal building is involved.
- (d) Any displaced landscaping elements must be replaced on the site and shown on a revised landscaping plan.

Landscape Plan and Design Standards.

Landscape plans shall be submitted as a component of a site plan, where required, or as a component of applications for other actions, including zoning permits, where applicable. Landscape plans for zoning lots greater than ten thousand (10,000) square feet in size must be prepared by a registered landscape architect.

- (a) Elements of the landscape plan shall include the following:
 - 1. Plant list including common and Latin names, size and root condition (i.e. container or ball & burlap).
 - 2. Site amenities, including bike racks, benches, trash receptacles, etc.
 - 3. Storage areas including trash and loading.
 - 4. Lighting (landscape, pedestrian or parking area).
 - 5. Irrigation.
 - 6. Hard surface materials.
 - 7. Labeling of mulching, edging and curbing.
 - 8. Areas of seeding or sodding.
 - 9. Areas to remain undisturbed and limits of land disturbance.
 - 10. Plants shall be depicted at their size at sixty percent (60%) of growth.
 - 11. Existing trees eight (8) inches or more in diameter.
 - 12. Site grading plan, including stormwater management, if applicable.
- (b) Plant Selection. Plant materials provided in conformance with the provisions of this section shall be nursery quality and tolerant of individual site microclimates.
- (c) Mulch shall consist of shredded bark, chipped wood or other organic material installed at a minimum depth of two (2) inches.

Landscape Calculations and Distribution.

Required landscaped areas shall be calculated based upon the total developed area of the property. Developed area, for the purpose of this requirement, is defined as that area within a single contiguous boundary which is made up of structures, parking driveways and docking/loading facilities, but **excluding** the area of any building footprint at grade, land designated for open space uses such as athletic fields, and undeveloped land area on the same zoning lot.

- (a) Landscaping shall be distributed throughout the property along street frontages, within parking lot interiors, and as foundation plantings, or as general site landscaping.
- (b) Planting beds or planted areas must have at least seventy-five percent (75%) vegetative cover.
- (c) Canopy tree diversity requirements for new trees:
 - 1. If the development site has fewer than 5 canopy trees, no tree diversity is required.
 - 2. If the development site has between 5 and 50 canopy trees, no single species may comprise more than 33% of trees.
 - 3. If the development site has more than 50 canopy trees, no single species may comprise more than 20% of trees.

Development Frontage Landscaping.

Landscaping and/or ornamental fencing shall be provided between buildings or parking areas and the adjacent street(s), except where buildings are placed at the sidewalk. Landscape material shall include a mix of plant material meeting the following minimum requirements:

10/2013 4

- (a) One (1) overstory deciduous tree and five (5) shrubs shall be planted for each thirty (30) lineal feet of lot frontage. Two (2) ornamental trees or two (2) evergreen trees may be used in place of one (1) overstory deciduous tree.
- (b) In cases where building facades directly abut the sidewalk, required frontage landscaping shall be deducted from the required point total.
- (c) In cases where development frontage landscaping cannot be provided due to site constraints, the zoning administrator may waive the requirement or substitute alternative screening methods for the required landscaping.
- (d) Fencing shall be a minimum of three (3) feet in height, and shall be constructed of metal, masonry, stone or equivalent material. Chain link or temporary fencing is prohibited.

Interior Parking Lot Landscaping.

The purpose of interior parking lot landscaping is to improve the appearance of parking lots, provide shade, and improve stormwater infiltration. All parking lots with twenty (20) or more parking spaces shall be landscaped in accordance with the following interior parking lot standards.

- (a) For new development on sites previously undeveloped or where all improvements have been removed, a minimum of eight percent (8%) of the asphalt or concrete area of the parking lot shall be devoted to interior planting islands, peninsulas, or landscaped strips. For changes to a developed site, a minimum of five percent (5%) of the asphalt or concrete area shall be interior planting islands, peninsulas, or landscaped strips. A planting island shall be located at least every twelve (12) contiguous stalls with no break or alternatively, landscaped strips at least seven (7) feet wide between parking bays.
- (b) The primary plant materials shall be shade trees with at least one (1) deciduous canopy tree for every one hundred sixty (160) square feet of required landscaped area. Two (2) ornamental deciduous trees may be substituted for one (1) canopy tree, but ornamental trees shall constitute no more than twenty-five percent (25%) of the required trees. No light poles shall be located within the area of sixty percent (60%) of mature growth from the center of any tree.
- (c) Islands may be curbed or may be designed as uncurbed bio-retention areas as part of an approved low impact stormwater management design approved by the Director of Public Works. The ability to maintain these areas over time must be demonstrated. (See Chapter 37, Madison General Ordinances, Erosion and Stormwater Runoff Control.)

Foundation Plantings.

Foundation plantings shall be installed along building facades, except where building facades directly abut the sidewalk, plaza, or other hardscape features. Foundation plantings shall consist primarily of shrubs, perennials, and native grasses. The Zoning Administrator may modify this requirement for development existing prior to the effective date of this ordinance, as long as improvements achieve an equivalent or greater level of landscaping for the site.

Screening Along District Boundaries.

Screening shall be provided along side and rear property boundaries between commercial, mixed use or industrial districts and residential districts. Screening shall consist of a solid wall, solid fence, or hedge with year-round foliage, between six (6) and eight (8) feet in height, except that within the front yard setback area, screening shall not exceed four (4) feet in height. Height of screening shall be measured from natural or approved grade. Berms and retaining walls shall not be used to increase grade relative to screening height.

Screening of Other Site Elements.

The following site elements shall be screened in compatibility with the design elements, materials and colors used elsewhere on the site, as follows:

- (a) <u>Refuse Disposal Areas.</u> All developments, except single family and two family developments, shall provide a refuse disposal area. Such area shall be screened on four (4) sides (including a gate for access) by a solid, commercial-grade wood fence, wall, or equivalent material with a minimum height of six (6) feet and not greater than seven (7) feet.
- (b) <u>Outdoor Storage Areas.</u> Outdoor storage areas shall be screened from abutting residential uses with a by a building wall or solid, commercial-grade wood fence, wall, year-round hedge, or equivalent material, with a minimum height of six (6) feet and not greater than seven (7) feet. Screening along district boundaries, where present, may provide all or part of the required screening.
- (c) <u>Loading Areas.</u> Loading areas shall be screened from abutting residential uses and from street view to the extent feasible by a building wall or solid, commercial-grade wood fence, or equivalent material, with a minimum height of six (6) feet and not greater than seven (7) feet. Screening along district boundaries, where present, may provide all or part of the required screening.
- (d) <u>Mechanical Equipment.</u> All rooftop and ground level mechanical equipment and utilities shall be fully screened from view from any street or residential district, as viewed from six (6) feet above ground level. Screening may consist of a building wall or fence and/or landscaping as approved by the Zoning Administrator.

Maintenance.

The owner of the premises is responsible for the watering, maintenance, repair and replacement of all landscaping, fences, and other landscape architectural features on the site. All planting beds shall be kept weed free. Plant material that has died shall be replaced no later than the upcoming June 1.