# 14,595 SF POST FRAME BUILDING SIMPLY HOMES PROPERTIES

2917 DAIRY DR.
MADISON, WI
SEPTEMBER 23, 2024



## PROPOSED COMPLETED ELEVATION

C6.0 EROS

C6.I-C6.2 CONS

ARCHITECTURAL 
A-00I FIRST

A-100 FIRST

A-400 EXTER

STRUCTURAL 
MECHANICAL - DESIGN

FIRST

MECHANICAL - DESIGN

PLUMBING - DESIGN

ELECTRICAL - DESIGN

ELECTRICAL - DESIGN

ELECTRICAL - DESIGN

ELECTRICAL - DESIGN

ON S

ARCHITECTURAL 
A-00I FIRST

A-400 EXTER

STRUCTURAL 
MECHANICAL - DESIGN

ELECTRICAL - DESIGN

ELECTRICAL - DESIGN

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		INDEV OF DRAWINGS	IOOA
		INDEX OF DRAWINGS	
	SHEET NO.	DESCRIPTION	\( \times \times \times \)
	GENERAL -		
	GI.O	TITLE SHEET	XXXX
	CIVIL -		
	CI.O	EXISTING PLAN	XXXX
	C2.0	PROPOSED SITE PLAN	7000
	C3.0	UTILITY PLAN	<b>\$</b>
	C4.0	GRADING PLAN	
	C5.0	EROSION CONTROL PLAN	550
	C6.0	EROSION CONTROL DETAILS	FEC
	C6.I-C6.2	CONSTRUCTION DETAILS	
	ARCHITECTURAL -	FIRST FLOOR ARCHITECTURAL CORE	(FE)
	A-001	FIRST FLOOR ARCHITECTURAL CODE	
	A-100	FIRST FLOOR PLAN	
	A-400	EXTERIOR ELEVATIONS	FE+V
	STRUCTURAL -	DEGICN BUILT	
	MECHANICAL - PLUMBING -	DESIGN BUILT DESIGN BUILT	
	ELECTRICAL -	DESIGN BUILT	F
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INDEX OF DRAWINGS

<u>DISCIPLINE:</u> C - CIVIL

L - LANDSCAPE A - ARCHITECTURE

K - FOOD SERVICE DISCIPLINE MODIFIER

SHEET NUMBER WITHIN SERIES

SHEET NUMBERINGSTANDARDS

REFER TO A/E/C CAD STANDARD FOR

M - MECHANICAL E - ELECTRICAL P - PLUMBING S - STRUCTURAL

NUMBERING SYSTEM:

XXIOO

SUBMITTAL TYPE
PRIMARY OCCUPANCY TYPE
SECONDARY OCCUPANCY TYPE
OCCUPANCY SEPARATIONS


NEW CONSTRUCTION
STORAGE BUILDING (S-I)
BUSINESS (B)
N/A



PROJECT LOCATION

LOCATION PLAN

DANE COUNTY, WI

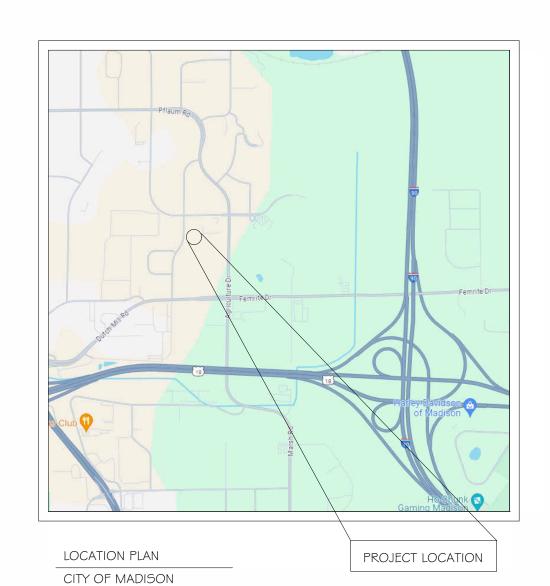

PROJECT AREA

FLOOR LEVELS

CONSTRUCTION CLASS

SPRINKLER PROTECTION

BUILDING DESIGN CRITERIA

CODE COMPLIANCE PER 2018 WISCONSIN
COMMERCIAL BUILDING CODE (WCBC) (2015 IBC - CODES)
ENERGY COMPLIANCE PER IECC 2015

- BUILDING ENVELOPE REQUIREMENTS:
BUILDING ROOF (U=0.027) SPS 363.0402
BLDG WALL (U=0.051) SPS 363.0402
FENESTRATIONS MTL FRAME W/ THERMAL BREAK (U=0.38)
DOORS, SWINGING (U=0.37)
DOORS, NON SWINGING (U=0.31)

- PROVIDED THERMAL ENVELOPE:

WOOD FRAMED WALL

CAVITY F.G. INSULATION R21 (U=0.048)

ROOF

BLOWN IN F.G. INSULATION R=50

- OCCUPANCY TYPE

IBC 508.3 SEPARATED OCCUPANCIES

SI - MODERATE HAZARD STORAGE = 8,475 SF

- CONSTRUCTION CLASSIFICATION - VB POST FRAME BUILDING

B - BUSINESS GROUP = 6,120 SF

- BUILDING ALLOWABLE AREA - IBC 506.2 = 9,000 SF NON SPRINKLED - IBC 506.3 FRONTAGE INCREASE = 6,750 SF  $I_F = (F/P-0.25)W/30$   $I_F = (520/520-0.25)30/30 = 0.75 * 9000 = 6,750 SF$ 

- TOTAL ALLOWED = 9,000 SF + 6,750 SF = 15,750 SF

- OCCUPANT LOAD

IBC 508.3 SEPARATED OCCUPANCIES

BUSINESS (B) 6,120 SF / 500 = 12 OCCUPANTS

STORAGE (SI) = 8,475 SF / 500 = 16

TOTAL = 28 OCCUPANTS

ABBREVIATIONS

MFG. = MANUFACTU EOP = EDGE OF PAVEMENTBOC = BACK OF CURBDIM. = DIMENSION EOSW = EDGE OF SIDEWALK SPF = SPRUCE PINE TOF = TOP OF FOOTINGDF = DOUGLAS FIR FFE = FIRST FLOOR ELEVATION SP = SOUTHERN PINTOW = TOP OF WALLCONC. = CONCRETESFE = SECOND FLOOR ELEVATION WWF = WIRE WELDED ELEV. = ELEVATIONOC = ON CENTERRO = ROUGH OPENINGEW = EACH WAYEF = EACH FACEBM = BENCHMARKSQ. FT. = SQUARE FEETWH = WATER HEATERDIA. = DIAMETERDW = DISHWASHERTYP. = TYPICALREF. = REFRIGERATORHM = HOLLOW METALFRZ. = FREEZERFTG. = FOOTINGSS = STAINLESS STEEL PC = PRECASTALUM. = ALUMINUMIBC = INTERNATIONAL BUILDING CODE OHD = OVERHEAD DOORT/O = TOP OFWD = WOODMTL. = METALGALV. = GALVANIZEDHSS = HOLLOW STEEL STRUCTURE BRG. = BEARINGSTL. = STEEL OH = OVERHANGOFOI - OWNER FURNISHED OWNER INSTALLED

- CABINET TYPE FIRE EXTINGUISHER - CYLINDER TYPE FIRE EXTINGUISHER **\$ VALVE CABINET** PULL STATION FIRE HORN DOOR HOLD DEVICE EXIT LIGHT EXHAUST FAN EMERGENCY LIGHT RESCUE ASSISTANCE INTERCOM RESCUE ASSISTANCE DIRECTIONAL SIGN RESCUE ASSISTANCE BOULDER WALL DRINKING FOUNTAINS SIGN LOCATION REVISION / ADDENDUM DESIGNATION

ALL DIMENSIONS ARE STUD TO STUD

UNLESS OTHERWISE NOTED.

ARCHITECTURAL LEGEND

ANNOTATION CALLOUTS/DRAWING SYMBOLS

INTERIOR ELEVATION

- ELEVATION NUMBER

- EXTERIOR ELEVATION

SHEET NUMBER

ENLARGEMENT, DETAIL

- SHEET NUMBER

NORTH ARROW w/ TRUE NORTH

\_\_\_\_\_ REVISION TAG

**ROOM TAG** 

SPOT ELEVATION

LEVEL NAME

SHEET KEYNOTE

DOOR TAG

WINDOW TAG

WALL TAG

**ROOM TAG** 

**UNIT TAG** 

SMOKE TAG

FIRE EXTINGUISHER

INDICATION

IOI


FILE NAME: E:\Projects\2024\0824-28 Lindsay Hagens Warehouse\Revit\PostFrame-20249-20.rvt

PROJECT NO: 0824-28
PLOT DATE: 8/26/24
PLOT BY: SSR
PLOT SCALE: As indicated

PRELIMINARY NOT FOR CONSTRUCTION



SHEET # CI.O CUP SUBMITTAL I 9/23/24

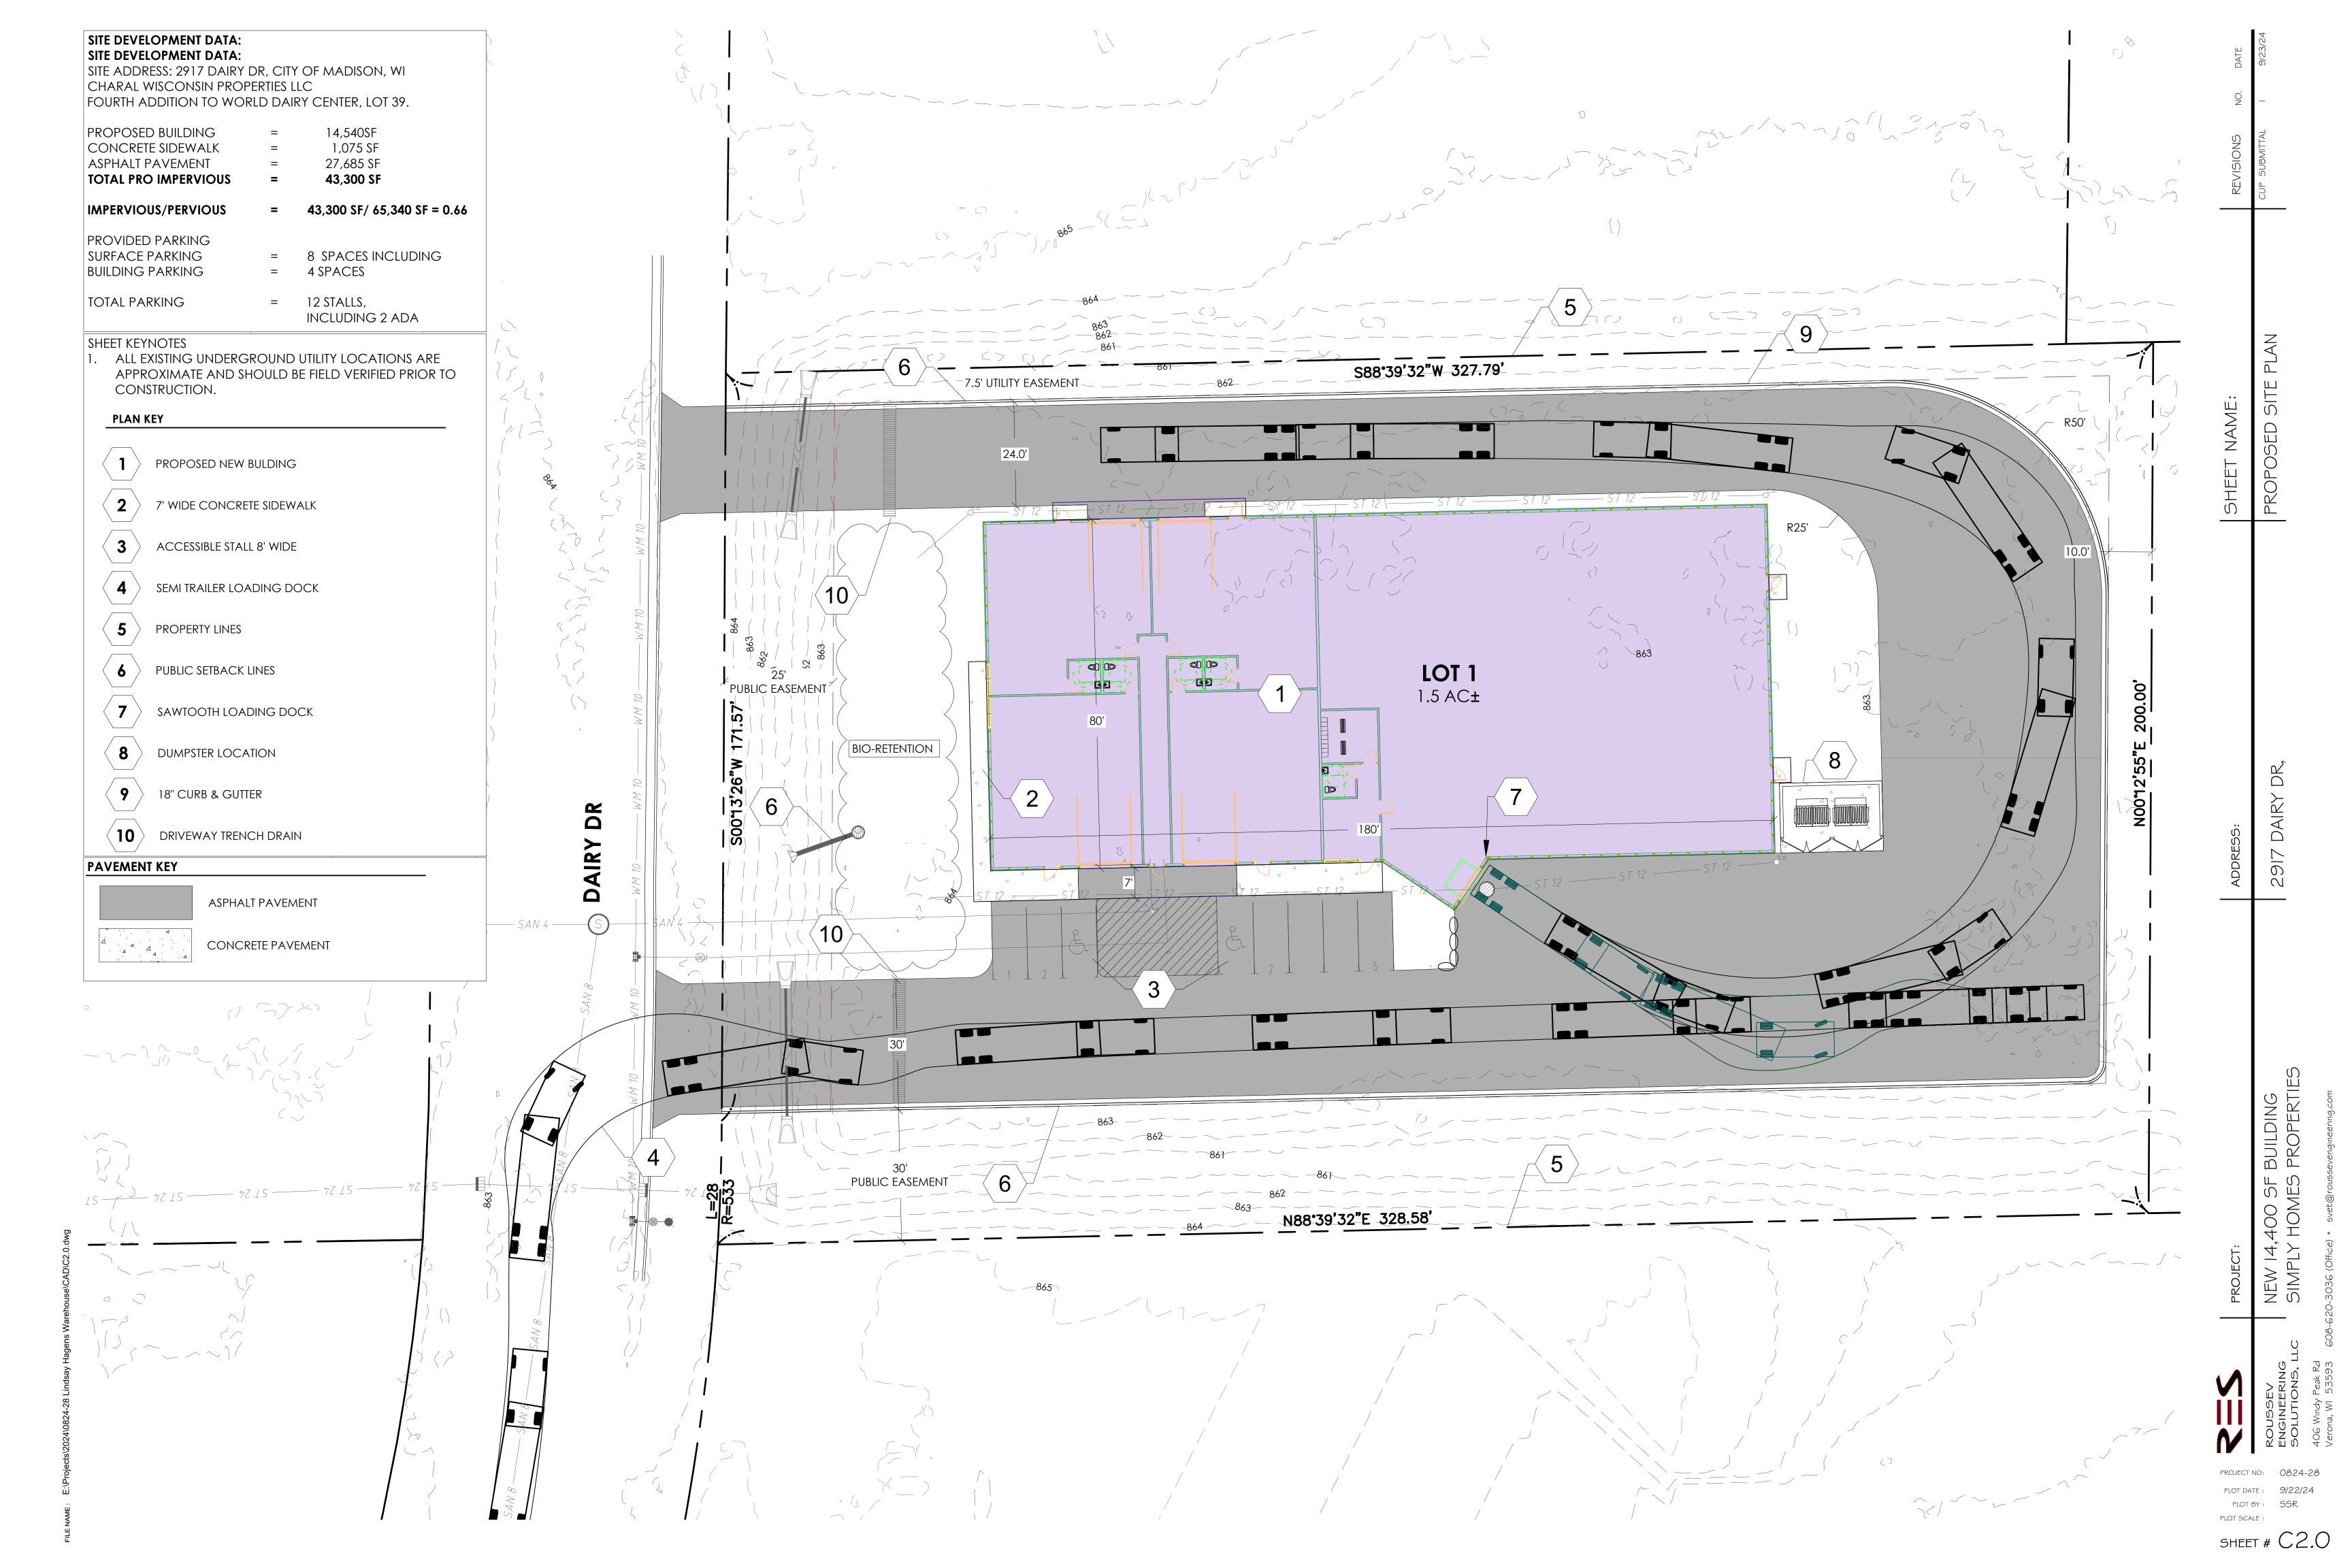

CONSTRUCTION.

2. ALL EXISTING UTILITIES SHOWN ON THE PLAN ARE APPROXIMATE

AND SHALL BE FIELD VERIFIED PRIOR CONSTRUCTION

3. ALL SITE UTILITY WORK SHALL BE DONE IN ACCORDANCE WITH CITY OF MADISON STANDARD SPECIFICATIONS FOR PUBLIC

WORKS CONSTRUCTION, LATEST ADDITION.

4. PRIOR TO CONSTRUCTION, CONTRACTOR SHALL OBTAIN A STREET OPENING PERMIT FOR ANY WORK TO BE DONE WITHIN THE RIGHT-OF-WAY.

5. CONTRACTOR SHALL OBTAIN ALL NECESSARY PLUGGING/CONNECTION PERMITS FROM THE CITY PRIOR TO ANY UTILITY WORK. CONTRACTOR TO NOTIFY THE DEPARTMENT OF PUBLIC WORKS A MINIMUM OF 48 HOURS BEFORE CONNECTING TO PUBLIC UTILITIES.

6. RESTORATION OF PAVEMENT, CURB & GUTTER, AND SIDEWALK WITHIN THE STREET RIGHT OF WAY IS CONSIDERED INCIDENTAL AND SHALL BE INCLUDED IN THE COST OF THE UNDERGROUND IMPROVEMENTS.

CONTRACTOR SHALL CONFIRM CONNECTION ELEVATION
GRADES OF ALL PIPES PRIOR TO BEGINNING CONSTRUCTION.

8. CONTRACTOR SHALL SUBMIT SHOP DRAWINGS TO THE CITY UTILITIES DIRECTOR FOR THE PROPOSED WATER IMPROVEMENTS WITHIN THE RIGHT-OF-WAY PRIOR TO CONSTRUCTION.

 NEW WATER MAIN PIPE AND FITTINGS SHALL BE CLASS 52 D.I. (8-INCH Ø).

10. WATER FITTINGS AND VALVES SHALL BE AS FOLLOWS:

10.1. VALVES SHALL BE RESILIENT-SEATED GATE VALVES,
MECHANICAL JOINT CONFORMING TO ANSI/AWWA C509
OR ANSI/AWWA C515. VALVES SHALL HAVE NON-RISING
STEM, WITH 2 INCH OPERATING NUT OPENING
COUNTER-CLOCKWISE. THE VALVE WEDGE SHALL BE DUCTILE
IRON FULLY ENCAPSULATED WITH EPDM RUBBER, SHALL BE
SYMMETRICAL AND SEAL EQUALLY WELL WITH FLOW IN
EITHER DIRECTION. VALVE BOXES SHALL BE CAST IRON AND
SHALL INCLUDE A GATE VALVE ADAPTOR MANUFACTURED
BY ADAPTOR INC.

10.2. HYDRANTS AFC WATEROUS PACER BREAKAWAY MODEL WB-67 OR APPROVED EQUAL. HYDRANT MARKERS RODON HYDRAFINDER. RODONCORP.COM OR SIMILAR.

10.3. AMERICAN NATIONAL STANDARD FOR DUCTILE IRON AND GRAY IRON FITTINGS, 3-INCH THROUGH 48-INCH, FOR WATER (ANSI/AWWA C110/A21.10 - LATEST REVISION) OR AMERICAN NATIONAL STANDARD FOR DUCTILE IRON COMPACT FITTINGS, 3-INCH THROUGH 64-INCH FOR WATER (ANSI/AWWA C153/A21.53-11 - LATEST REVISION).

10.4. MECHANICAL JOINT FITTING REQUIREMENTS:
CLASS 250 MECHANICAL JOINT PIPE FITTINGS.
CEMENT LINED. ALL BELLS. ENTIRE FITTING TARRED.
ESTABLISH CONDUCTIVITY ACROSS FITTINGS IN ACCORDANCE WITH SECTION 702.3.1.
FURNISHED WITH ALL NECESSARY ACCESSORIES (RUBBER

FURNISHED WITH ALL NECESSARY ACCESSORIES (RUBBER GASKETS, FLANGES, BOLTS, ETC.).

10.5. MECHANICAL JOINT RESTRAINTS:

EBAA IRON INC. - MEGALUG® SERIES 1100.

STAR PIPE PRODUCTS – STARGRIP® SERIES 3000.

10.6. WATER SERVICE SHALL BE TYPE "K" COPPER, 2" Ø

CONFORMING TO ASTM B-88 FROM CORPORATION STOP TO

CURB STOP.

4-INCH DIAMETER AND LARGER LATERALS: CLASS 52 DUCTILE IRON IN ACCORDANCE WITH SECTION 702.3.1 – DUCTILE IRON PIPE

10.7. CORPORATION STOPS:

MUELLER B-25000N, AWWA INLET, COPPER FLARE OUTLET BALL CORPORATION VALVE OR A.Y. MCDONALD 74701BL-X (X DENOTES SIZE), BALL STYLE FLARE CORP, LESS NUT OR FORD FB1000-X-C16198-Y-NL, BALLCORP AWWA TO CTS QUICK JOINT 45-DEG ANGLE, -ANWT-

10.8. CURB STOPS: ¾-INCH TO 2-INCH DIAMETER, QUARTER-TURN, BALL VALVE CURB STOPS

A.Y. MCDONALD 76100 (SIZE), Q CTS FLARED,

A.Y. MCDONALD 76100Q (SIZE), Q CTS COMPRESSION

MULLER H15209N 2-INCH, COMPRESSION JOINTS, BOTH SIDES

COPPER


10.9. CURB STOP BOXES: MULLER H10386 FOR 2-INCH, ARCH PATTERN, 7 TO 8 FOOT EXTENSION, SLIP TYPE EXTENSION, UPPER SECTION BEING 1 ¼ INCHES IN DIAMETER, PROVIDED W/ 5-FOOT ROUND STATIONARY RODS AND GUIDE RINGS, BRASS PENTAGON HEAD PLUG-TYPE LIDS.

11. ANY PERSON WHO INSTALLS A NONCONDUCTIVE WATER OR SEWER LATERALS MUST ALSO INSTALL A LOCATION WIRE OR OTHER EQUALLY EFFECTIVE MEANS FOR MARKING THE LOCATION OF THE LATERAL. METHOD SHALL BE APPROVED BY THE CITY.

12. CONTRACTOR TO COORDINATE NEW, RELOCATED AND/OR ABANDONED GAS, ELECTRIC, TELEPHONE, AND CABLE WITH APPROPRIATE UTILITY COMPANIES.

13. ALL WATER MAIN PIPE AND FITTINGS SHALL BE INSTALLED TO A MIN. DEPTH OF COVER OF 6.0'. AFTER RE-GRADING, EXISTING WATER MAIN PIPE WHICH DOES NOT MEET THIS REQUIREMENT SHALL BE INSULATED.


14. SANITARY SEWER SERVICES SHALL BE 6" Ø SDR-35.
15. BUILDING PLUMBER SHALL VERIFY SIZE, SLOPE, AND EXACT LOCATION OF PROPOSED SANITARY LATERALS AND WATER SERVICES PRIOR TO INSTALLATION.

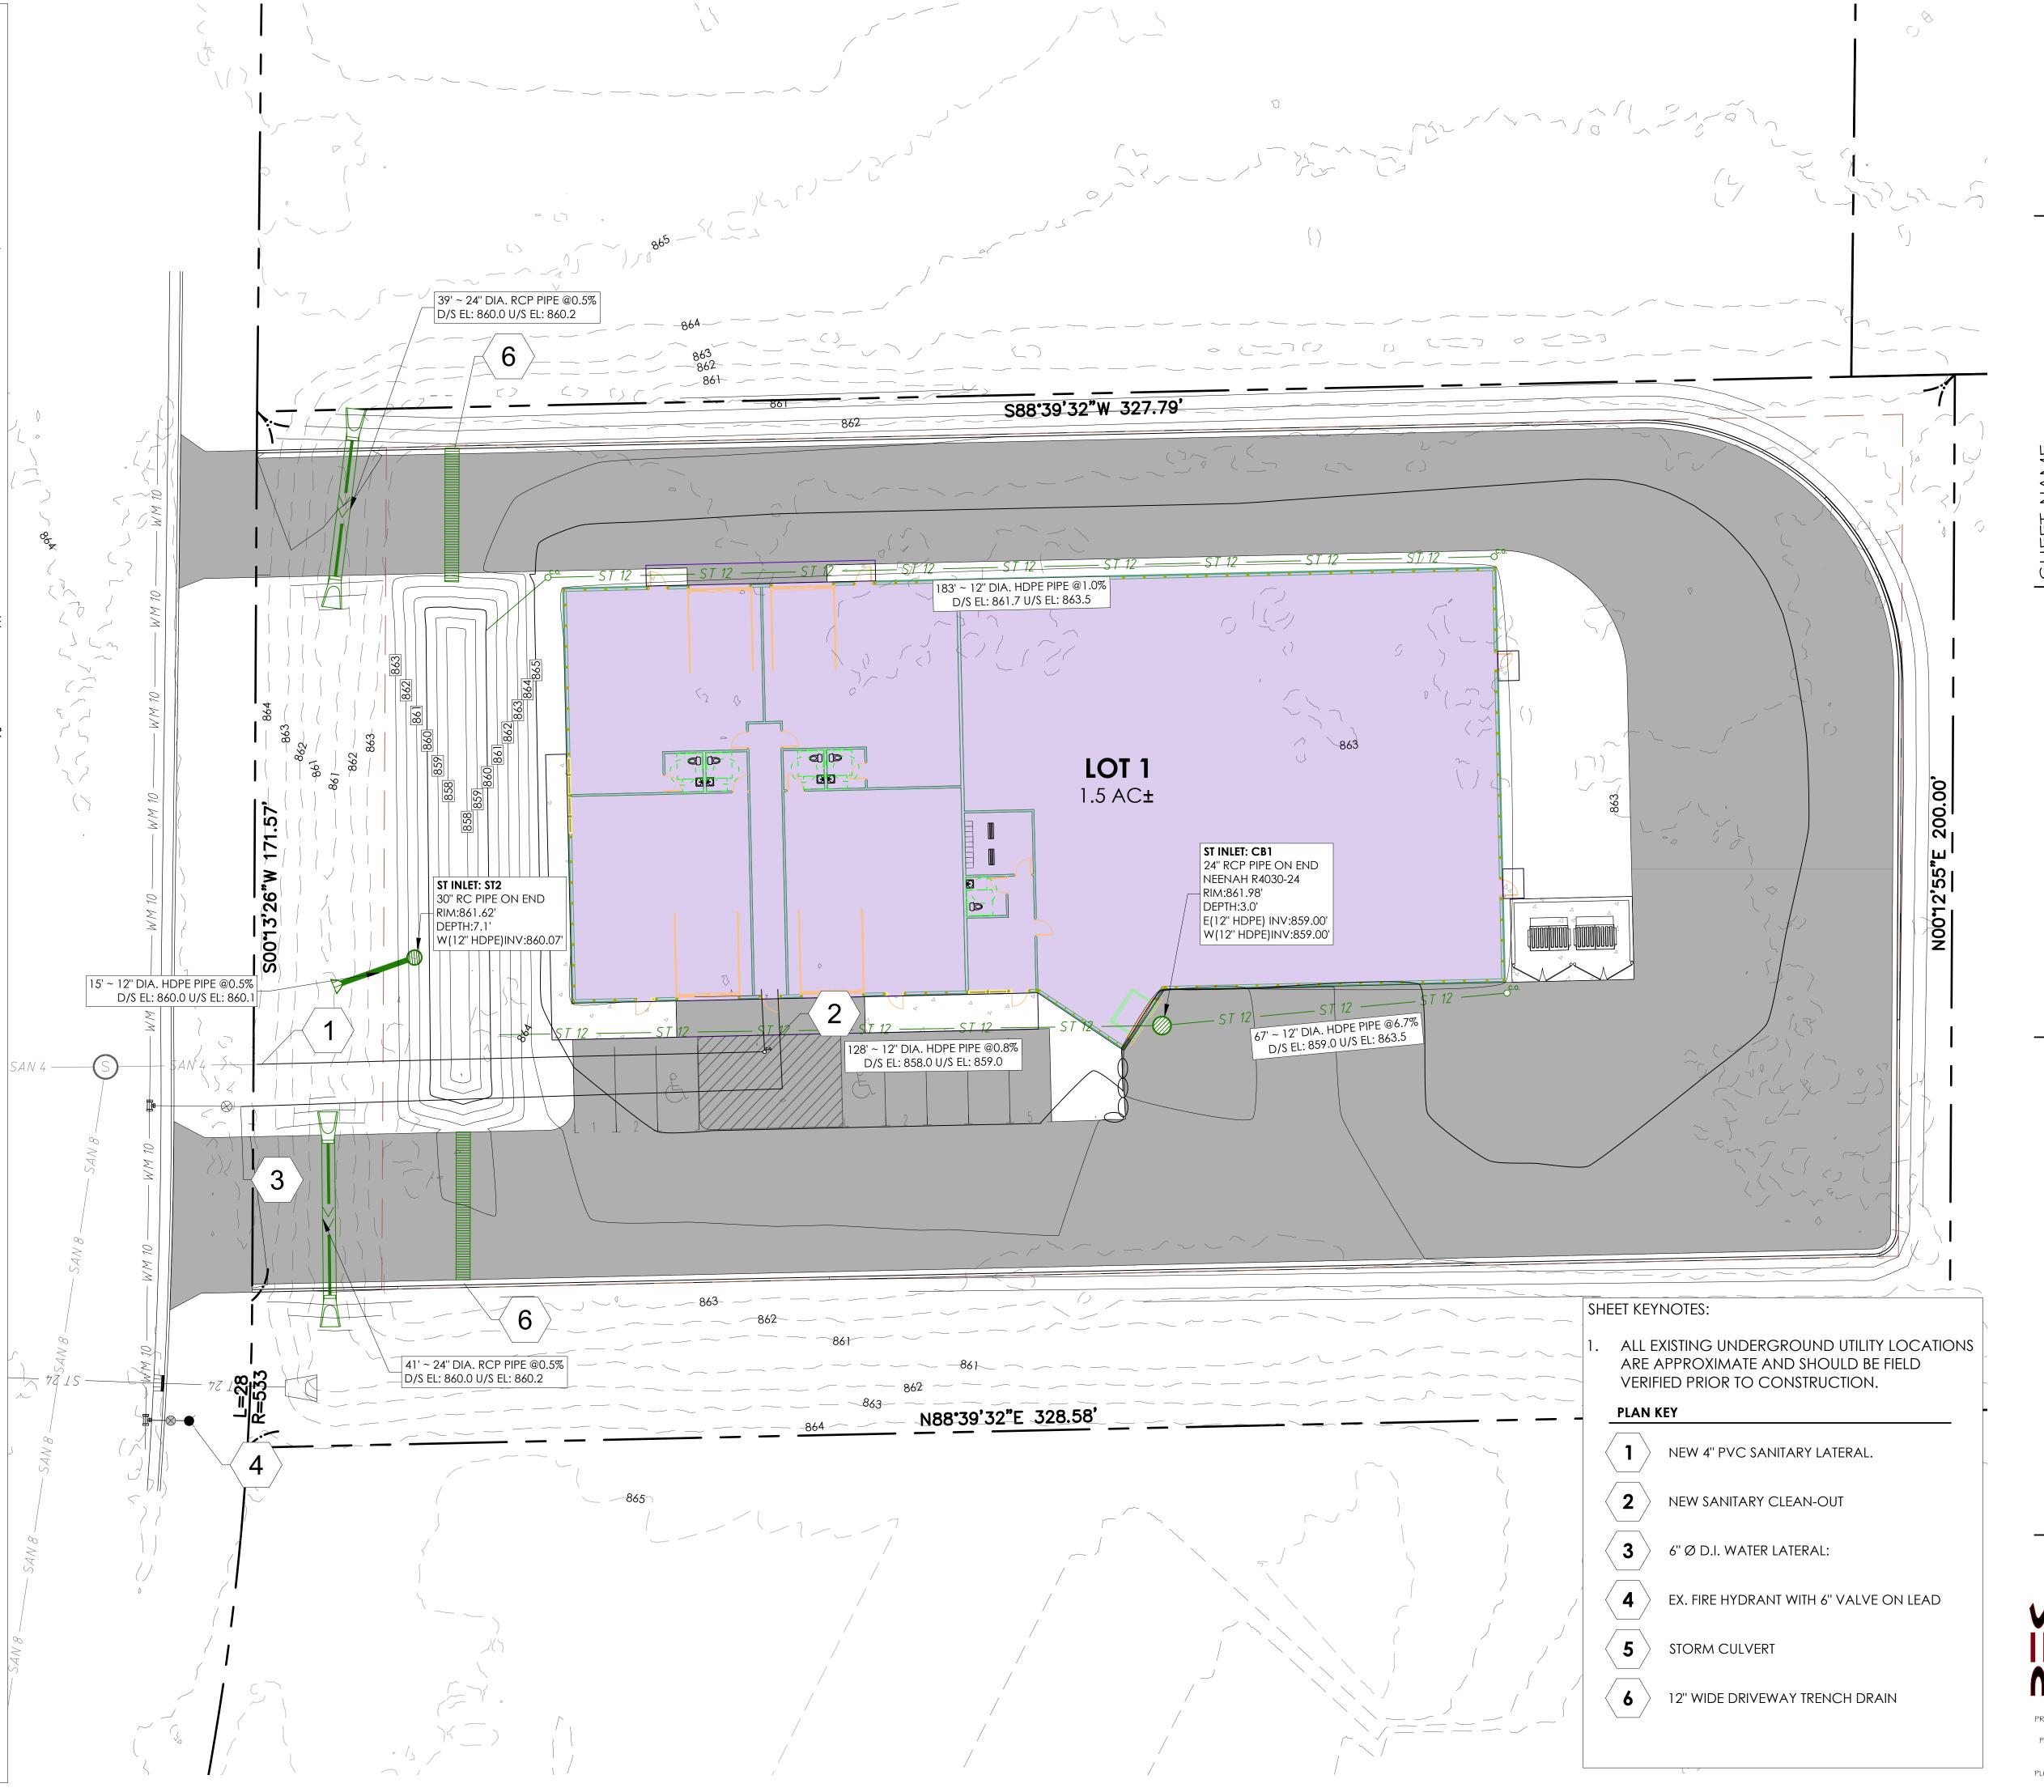

FILE NAME: E:\Projects\2

SHEET # C3.0

BUILDING PROPERTII

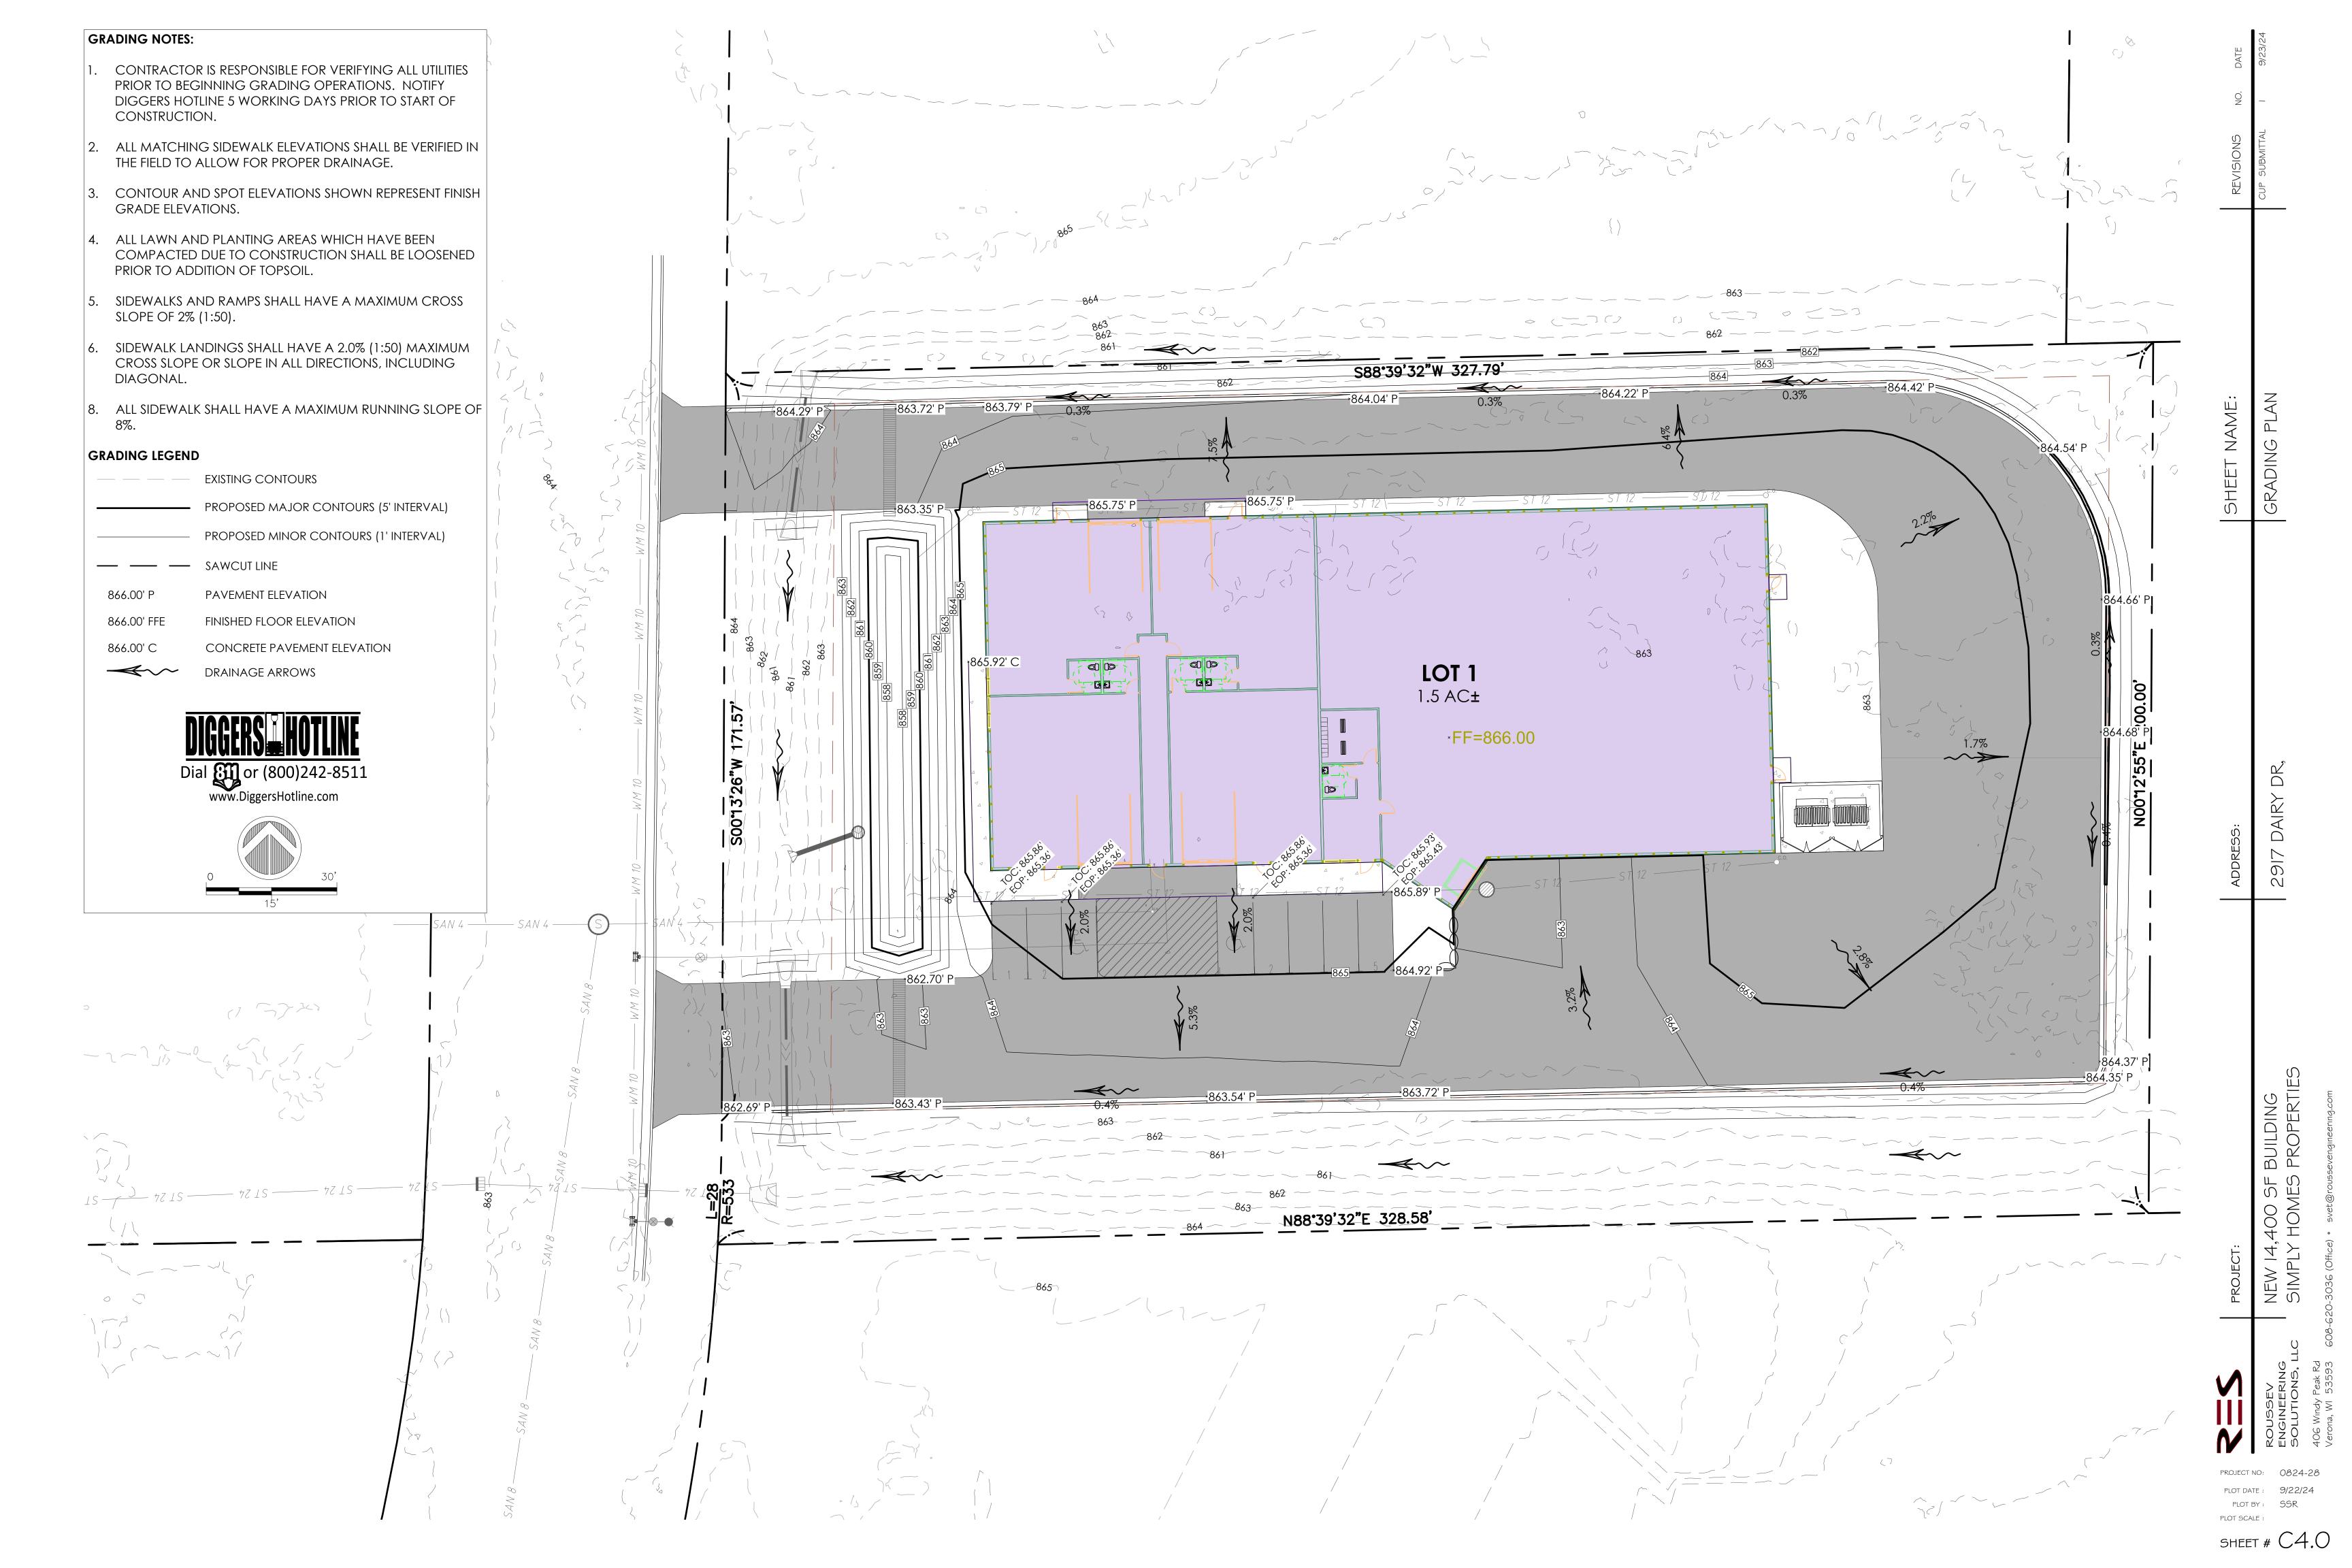


# **EROSION CONTROL NOTES:**

- 1. THE CONTRACTOR SHALL IMPLEMENT AND MAINTAIN EROSION CONTROL DEVICES FROM THE START OF LAND DISTURBING CONSTRUCTION ACTIVITIES UNTIL FINAL STABILIZATION OF THE CONSTRUCTION SITE.
- 2. ALL EROSION CONTROL MEASURES SHALL BE INSTALLED IN ACCORDANCE WITH CITY EROSION CONTROL AND STORMWATER ORDINANCE AND THE APPROPRIATE WISCONSIN DNR CONSTRUCTION SITE EROSION AND SEDIMENT CONTROL TECHNICAL STANDARDS. THE CITY RESERVES THE RIGHT TO REQUIRE ADDITIONAL EROSION CONTROL MEASURES AS CONDITIONS WARRANT.
- 3. CLEANING RIGHT-OF-WAY SURFACES SHALL BE THOROUGHLY CLEANED BEFORE THE END OF EACH WORKING DAY WITHOUT HYDRAULIC FLUSHING.
- 4. RESTORATION RESTORATION SHALL BE COMPLETED AS NOTED IN THE CONSTRUCTION SCHEDULE UNLESS OTHERWISE AUTHORIZED BY THE CITY.
- 5. INSPECTION THE CONTRACTOR SHALL INSPECT EROSION AND SEDIMENT CONTROL PRACTICES WEEKLY, AND WITHIN 24 HOURS FOLLOWING A RAINFALL OF 0.5 INCHES OR GREATER. DOCUMENTATION OF EACH INSPECTION SHALL INCLUDE THE TIME, DATE AND LOCATION OF INSPECTION, THE PHASE OF LAND DISTURBANCE AT THE CONSTRUCTION SITE, PERSON CONDUCTING THE INSPECTION, ASSESSMENT OF CONTROL PRACTICES, AND A DESCRIPTION OF ANY EROSION OR SEDIMENT CONTROL MEASURE INSTALLATION.
- 6. STONE TRACKING PAD. BEFORE BEGINNING CONSTRUCTION, CONTRACTOR SHALL INSTALL A STONE TRACKING PAD AT EACH POINT WHERE VEHICLES ENTERS/EXITS THE CONSTRUCTION SITE. STONE TRACKING PADS SHOULD BE AT LEAST 24 FEET WIDE AND 50 FEET LONG, AND CONSTRUCTED OF 3-6 INCH WASHED STONE WITH A DEPTH OF AT LEAST 12 INCHES. ON SITES WITH CLAY SOILS, TONE TRACKING PADS MUST BE UNDERLAIN WITH A GEOTEXTILE LINER TO PREVENT THE STONE FROM SINKING INTO THE SOIL.
- 7. INLET PROTECTION. ALL INLETS SUBJECT TO DRAINAGE SHALL BE PROTECTED WITH TYPE D INLET PROTECTION OR APPROVED EQUAL. ANY DEPOSITS OF DIRT, MUD, ROCK, DEBRIS, OR OTHER MATERIAL ENTERING THE STORM SEWER SYSTEM SHALL BE PROMPTLY AND THOROUGHLY CLEANED OUT.
- 8. EROSION MAT. AREAS OR EMBANKMENTS HAVING SLOPES GREATER THAN OR EQUAL TO 4H:1V SHALL BE STABILIZED WITH WISCONSIN DOT CLASS 1, URBAN, TYPE B, EROSION MAT.
- 9. TEMPORARY EROSION CONTROL. ALL TEMPORARY EROSION AND SEDIMENT CONTROL MEASURES SHALL BE REMOVED WITHIN 30 DAYS AFTER FINAL SITE STABILIZATION IS ACHIEVED OR AFTER THE TEMPORARY MEASURES ARE NO LONGER NEEDED.
- 10. STABILIZATION. STABILIZE AREAS OF FINAL GRADING WITHIN 7 DAYS OF REACHING FINAL GRADE.
- 11. TOPSOIL. A MINIMUM OF 4 INCHES OF TOPSOIL MUST BE APPLIED TO ALL AREAS TO BE SEEDED OR SODDED.
- 12. SEEDING. SEED MIXTURE SHALL BE APPLIED AT A RATE OF 2 LBS PER 1,000 SF OF AREA OR AS NOTED ON THE LANDSCAPE PLAN.
- 13. STOCKPILES. IMMEDIATELY STABILIZE STOCKPILES AND SURROUND STOCKPILES AS NEEDED WITH SILT FENCE OR OTHER PERIMETER CONTROL IF STOCKPILES WILL REMAIN INACTIVE FOR 7 DAYS OR LONGER.
- 14. EXISTING SITE HAS A REGIONAL STORM WATER FACILITY THAT PROVIDES COMPLIANCE WITH NR 151 REQUIREMENTS.



TRACKING PAD

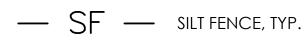

INLET PROTECTION, TYP.



CLASS II RIP-RAP @ STORM SEWER OUTLET, TYP.





EROSION MAT



TEMPORARY DITCH CHECK, TYP.



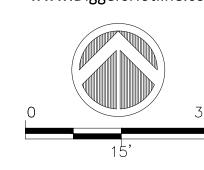

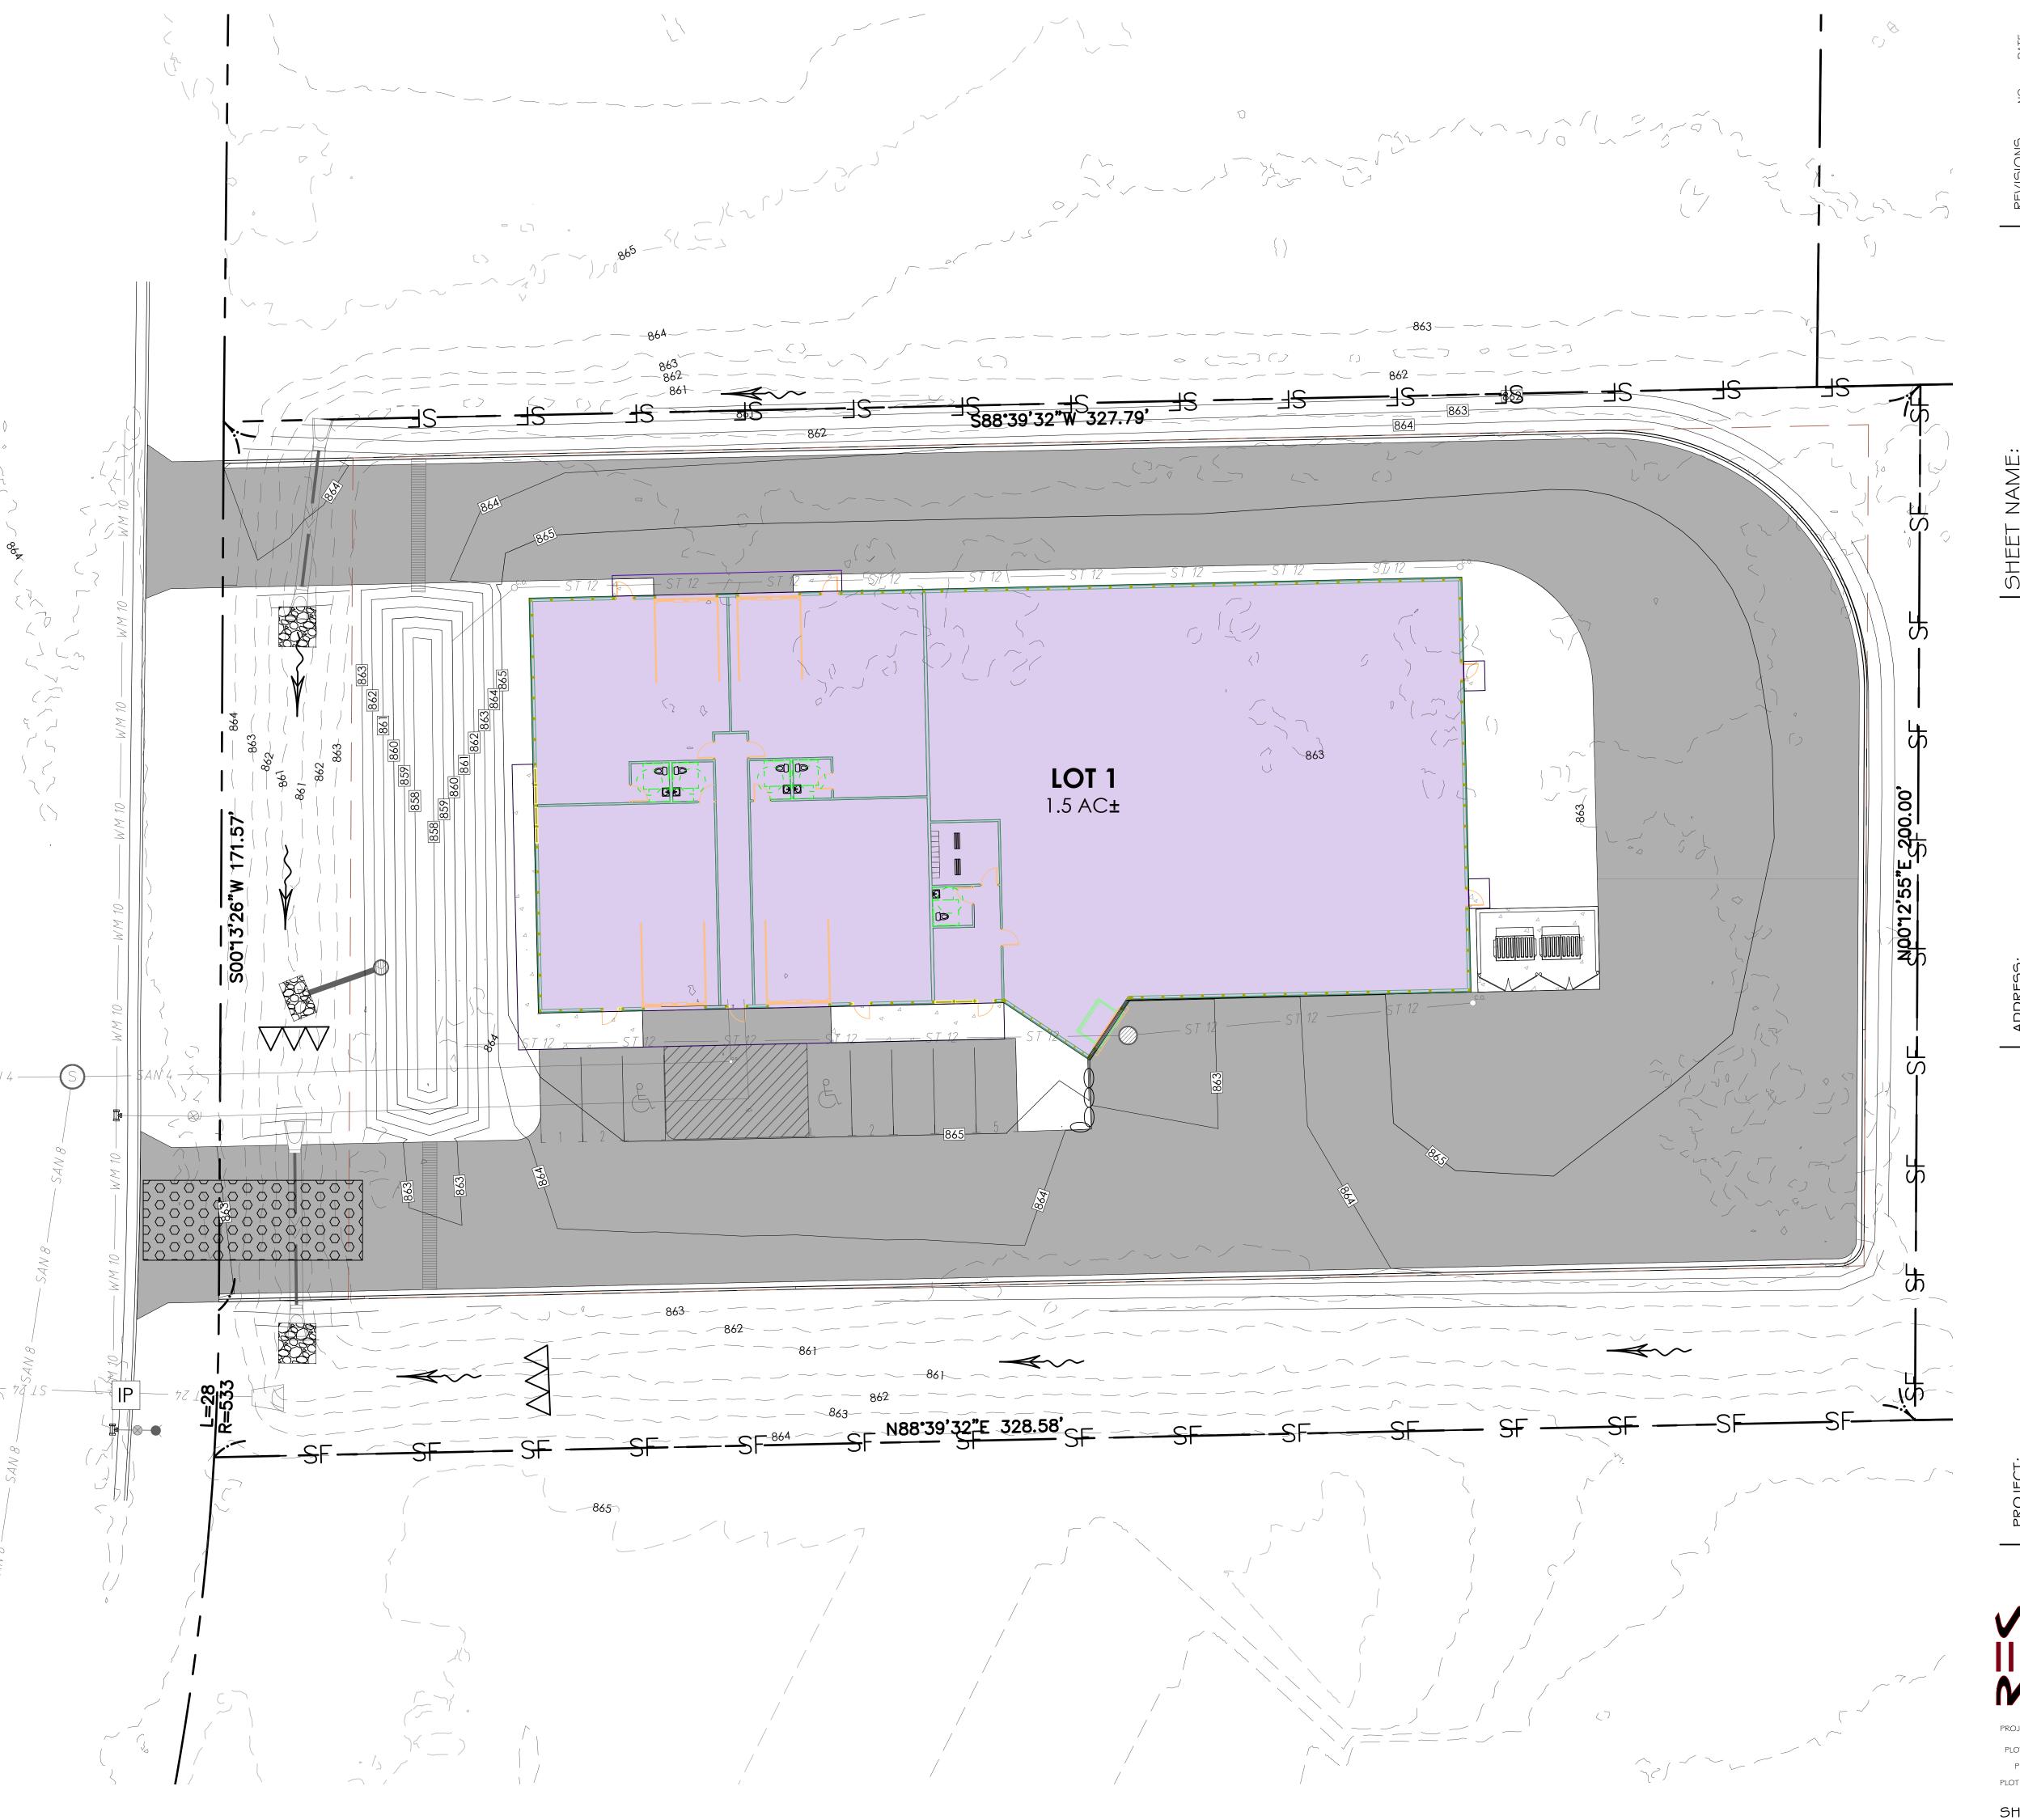

# **PLANT LIST**

KEY	QUAN	SIZE	COMMON NAME	Botanical Name F	ROOT
CH EP KCT SWO T	(7) 1 2 1 2	2 ½" 2 ½" 2 ½" 2 ½" 2 ½"	Canopy Trees Common Hackberry Exclamation Planetree Kentucky Coffeetree Swamp White Oak Tamarack	Celtis Occidentalis Platanus Acerifolia Gymnocladus Dioicus Quercus Bicolor Larix Laricina	BB BB BB BB BB
RBC	(1) 1	10'	Ornamental Trees River Birch Clump	Betula Nigra	ВВ
EA WBJ	(9) 4 5	5' 5'	Evergreen Shrubs Emerald Arborvitae Wichita Blue Juniper	Thuja Occidentalis Juniperus Scopulorum	BB BB
BC DBH GDP LDN MKL RTD YTD	(48) 12 15 4 3 2 9 3	24" 24" 18" 18" 36" 24" 24"	Deciduous Shrubs Black Chokeberry Dwarf Bush Honeysuckle Gold Drop Potentilla Little Devil Ninebark Miss Kim Lilac Red Twig dogwood Yellow Twig dogwood	Aronia Melanocarpa Diervilla Lonicera Potentilla Fruticosa Physocarpus Opulifolius Syringa Pubescence 'Miss Kir Cornus Sericea Cornus Lutea	Pot Pot Pot Pot M' Pot Pot Pot
LBS LH	(44) 24 20	1 G 1 G	Perennials Little Bluestem Grass Loyalist Hosta	Schizachyrium Scoparium Hosta 'Loyalist'	Con Con

## NOTES:

- 1) Disturbed lawn areas to receive a minimum of 4" of topsoil, premium bluegrass seed mix, starter fertilizer, and straw mulch.
- 2) Proposed bio-retention area to receive a minimum of a minimum of 4:of topsoil, short grass turf seed mix with cover crop (supplied by Agrecol, or equal) and installed per manufacturer's
- Disturbed lawn areas in public and utility easements to be repaired with a minimum of 4: of topsoil, turf seed to match existing turf, starter fertilize and straw mulch.
- 4) Lawn and turf areas in swales and on slopes more than 3:1 shall be mulched with straw mat. 5) Designated planting beds to be mulched with shredded hardwood bark mulch spread to a depth
- 6) Individual trees and shrub groupings in lawn areas to receive shredded hardwood bark mulch plant rings (4' diameter) spread to a depth of 3".
- 7) Designated planting beds to be separated from lawn and turf areas with 5" shovel cut edge.

## LANDSCAPE WORKSHEET 2917 Dairy Drive, Madison, WI

# **Landscape Points Required**


Developed Area = Landscape Points: 28,760 SF/300 x 5 =	28,760 SF <b>479 points</b>
Total Landscape Points Required	479 points
Landscape Points Supplied	
Existing canopy trees $-0 @ 35 =$ Proposed canopy trees $-7 @ 35 =$ Existing evergreen trees $-0 @ 35 =$ Proposed evergreen trees $-0 @ 35 =$ Existing ornamental trees $-0 @ 35 =$ Existing ornamental trees $-0 @ 15 =$ Proposed ornamental trees $-1 @ 15 =$ Existing upright evergreen shrubs $-0 @ 10 =$ Proposed upright evergreen shrubs $-9 @ 10 =$ Existing deciduous shrubs $-0 @ 3 =$ Proposed deciduous shrubs $-48 @ 3 =$ Existing evergreen shrubs $-0 @ 4 =$ Proposed evergreen shrubs $-0 @ 4 =$ Existing perennials & grasses $0 @ 2 =$ Proposed perennials & grasses $0 @ 2 =$	0 points 245 points 0 points 0 points 0 points 15 points 0 points 90 points 144 points 144 points 0 points 0 points
Total landscape points supplied =	582 points

<u>Lot Frontage Landscape Required</u> (Section 28.142(5) Development Frontage Landscaping)

"One (1) over-story deciduous tree and five (5) shrubs shall be planted for each thirty (30) lineal feet of lot frontage. Two (2) ornamental trees or two (2) evergreen trees may be used in place of one (1) over-story deciduous tree."

Dairy Drive =	200 LF
Over story trees required $200^{\circ}/30^{\circ} = 6.6$	<u>7 trees</u>
Shrubs required $(200^{\circ}/30^{\circ}) \times 5 = 33,3$	<u>34 shrubs</u>


Over story trees supplied	<u>6 trees</u>
Ornamental/Evergreen trees supplied	2 trees
Shrubs supplied	35 shrubs

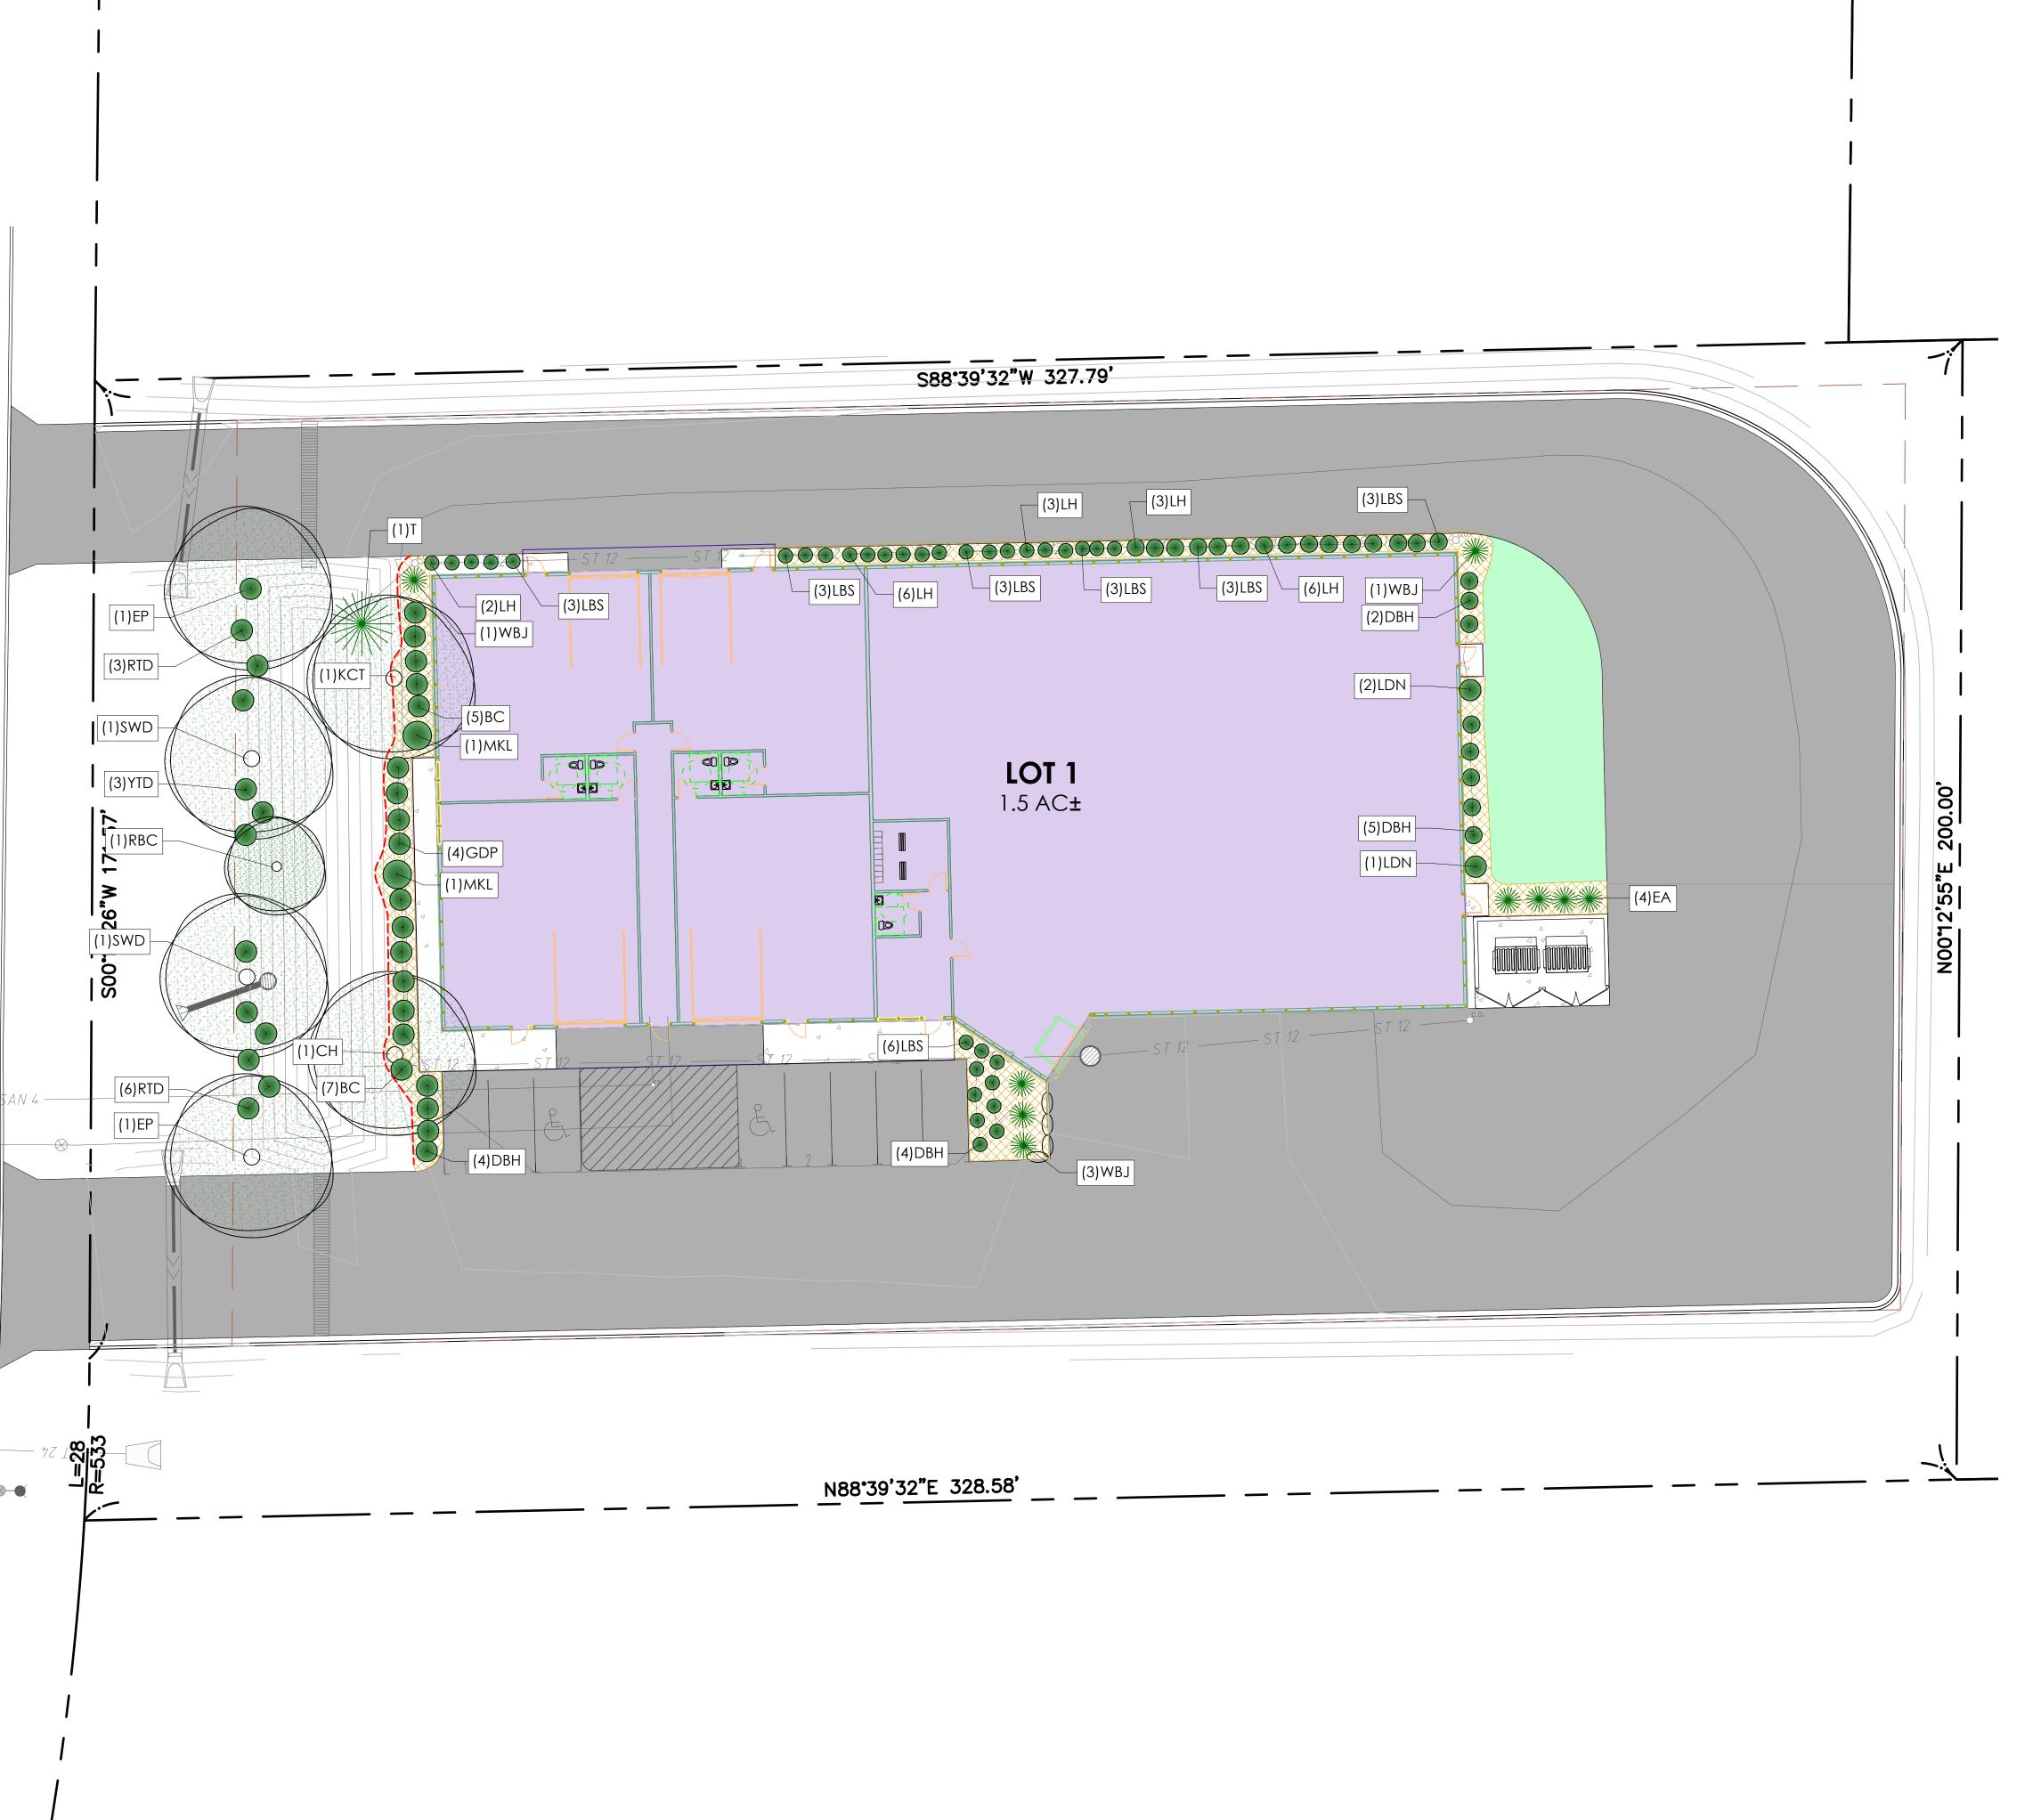


PLOT BY: SSR PLOT SCALE :

SHEET # LI.O

WHEN REMOVING OR MAINTAINING INLET PROTECTION, ANY TRAPPED MATERIAL THAT FALLS INTO THE INLET SHALL BE IMMEDIATELY REMOVED BY THE CONTRACTOR

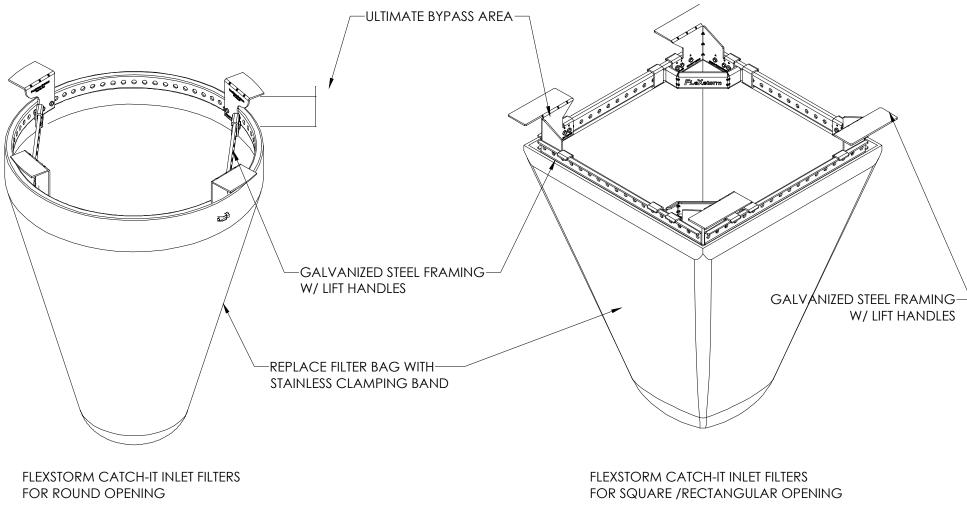

# **6-INLET PROTECTION**

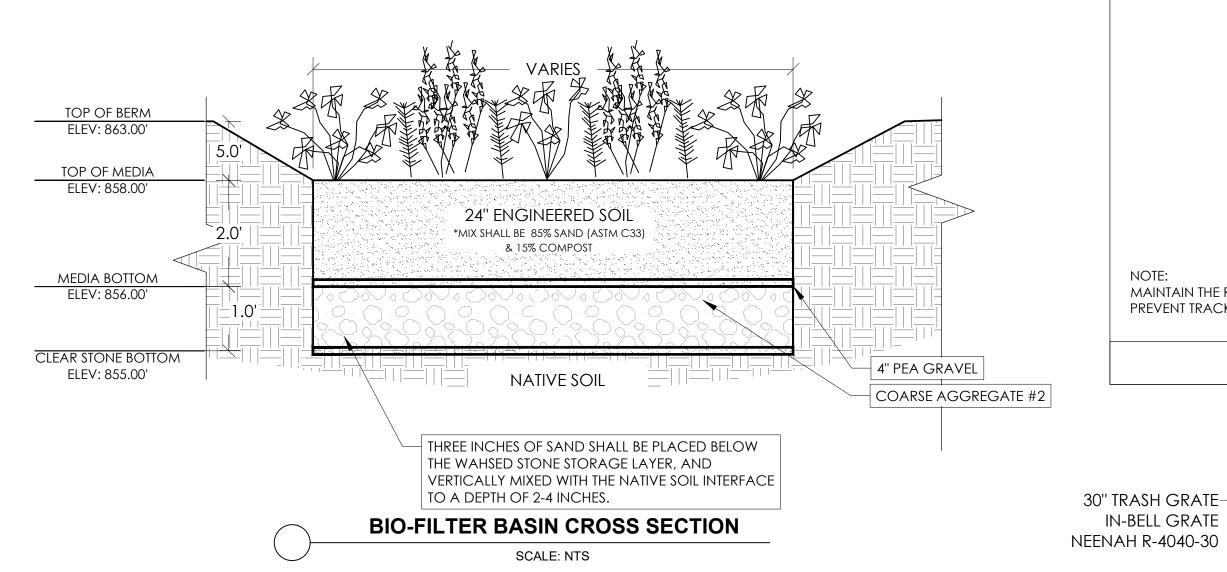

## **BIORETENTION BASIN NOTES:**

- RUNOFF SHALL NOT BE ALLOWED IN THE BASIN UNTIL AFTER THE TRIBUTARY AREA IS STABILIZED.
- 2. CONSTRUCTION OF THE BASIN SHOULD ONLY OCCUR DURING SUITABLE SITE CONDITIONS IF CONSTRUCTION OF THE BASIN OCCURS DURING SATURATED SOIL CONDITIONS, THE SOIL IN THE DEVICE COULD BE UNNECESSARILY COMPACTED.
- 3. MATERIALS USED FOR THE ENGINEERED SOIL SHALL COMPLY WITH WISCONSIN DNR TECHNICAL STANDARD 1004.
- 4. PLACED SAND SHALL MEET ONE OF THE FOLLOWING REQUIREMENTS:
- USDA COARSE SAND (.02 -.04 INCHES). ASTM C33 FINE AGGREGATE CONCRETE SAND. WISCONSIN STANDARDS AND SPECS FOR HIGHWAY AND STRUCTURE CONSTRUCTION. SECTION 501.2.5 FINE AGGREGATE CONCRETE SAND. SAND SHALL BE WASHED AND DRAINED TO REMOVE CLAY AND SILT PARTICLES PRIOR MIXING. STONE STORAGE SHALL MEET COARSE AGGREGATE #2, WISCONSIN STANDARDS AND SPECS FOR HIGHWAY AND STRUCTURE CONSTRUCTION. SECTION 501.2.5. 2003.
- 5. COMPACTION OF THE SOILS USED FOR THE BIORETENTION DEVICE MUST BE AVOIDED HEAVY EQUIPMENT SHOULD NOT BE USED IN THE CONSTRUCTION OF THE BASIN.
- 6. LIVE PLANT PLUGS GROWN TO AT LEAST 1.25" x 1.25" x 2.25" IN POTS SHALL BE PLANTED AT 1' ON CENTER THROUGHOUT THE PLANTING AREA.
- 7. USE RAINWATER RENEWAL (#RNR) BY AGRECOL NATIVE SEED MIX FOR BOTTOM OF BIO-RETENTION BASIN IN ADDITION TO PLUG PLANTINGS. SEED AT 8 PLS LBS/ACRE OR 94 SEEDS PER SF.
- 8. PLANTS SHALL BE NATIVE PLANTS AS SPECIFIED BY AGRECOL OR OTHER APPROVED NURSERY.
- 9. INSTALL CLASS II TYPE A BIO-DEGRADABLE EROSION MAT IN BASIN BOTTOM, TYP.
  - **5-BIO-FILTER BASIN** 4-BIO-FILTER OUTLET

TRENCH SHALL BE A MINIMUM OF 4" WIDE BY 6" DEEP TO BURY AND ANCHOR THE GEOTEXTILE FABRIC, FOLD MATERIAL TO FIT TRENCH AND BACKFILL AND COMPACT TRENCH WITH EXCAVATED SOIL.

(2) HORIZONTAL BRACE WITH 2" X 4" WOODEN FRAME OR EQUIVALENT AT TOP OF POST AS DIRECTED BY THE ENGINEER.

(3) WOOD POST SHALL BE A MINIMUM SIZE OF 1 1/8" X 1 1/8" OF OAK OR HICKORY.

MAINTAIN THE ROCK ENTRANCE TO

IN-BELL GRATE

6" ORIFICE WITH-TRASH PROTECTION

@860.1'

TOP MEDIA 858.00'

12" HDPE


INV: 860.1'

GROUT OR PRE-

CAST BOTTOM

30" RCP PIPE ON END-


PREVENT TRACKING ONTO PAVEMENT

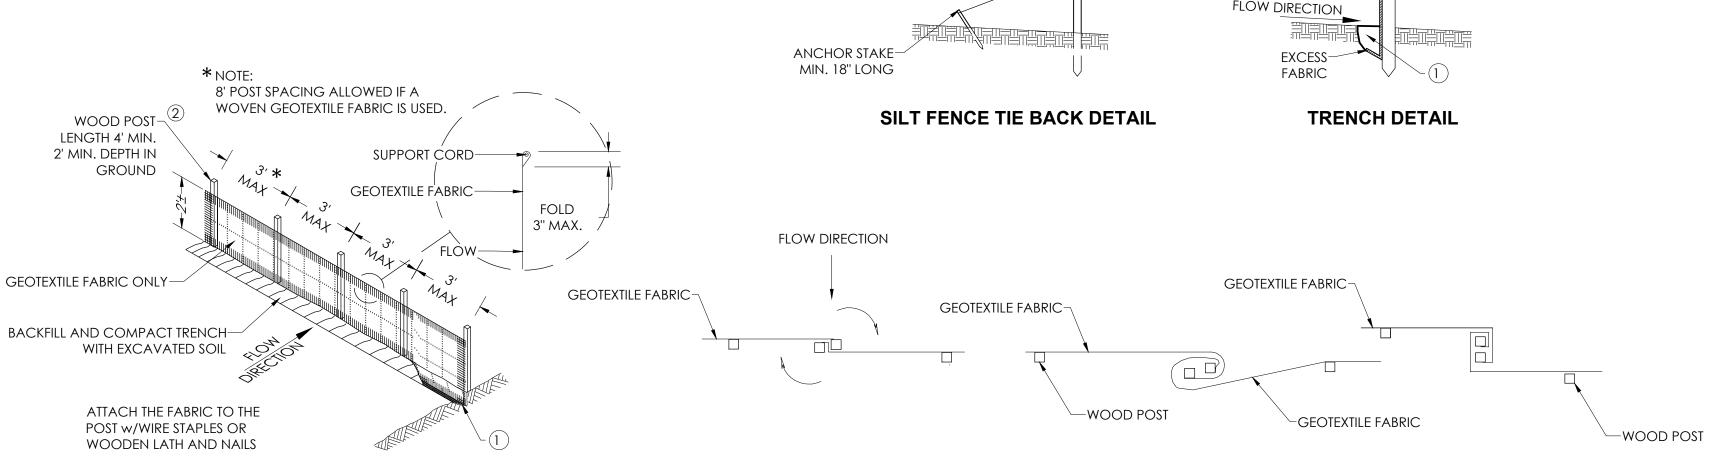

TIE BACK BETWEEN-

FENCE POST

AND ANCHOR

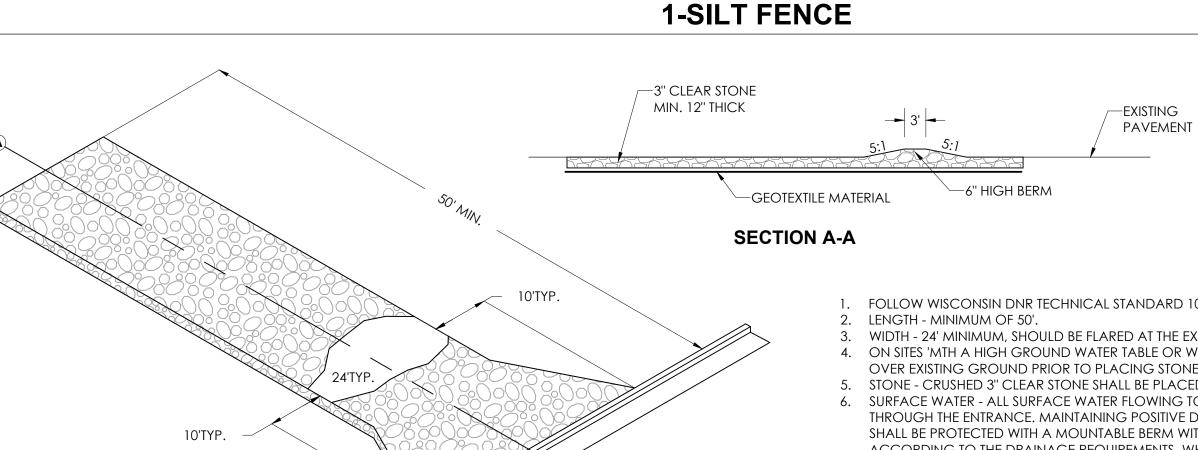

861.60'

854.50'

- WIDTH 24' MINIMUM, SHOULD BE FLARED AT THE EXISTING ROAD TO PROVIDE A TURNING RADIUS. ON SITES 'MTH A HIGH GROUND WATER TABLE OR WHERE SATURATED CONDITIONS EXIST, GEOTEXTILE FABRIC SHALL BE PLACED


**JOINING LENGTHS OF SILT FENCE** 

GEOTEXTILE FABRIC-

-WOOD

- STONE CRUSHED 3" CLEAR STONE SHALL BE PLACED AT LEAST 12" DEEP OVER THE ENTIRE LENGTH AND WIDTH OF ENTRANCE SURFACE WATER - ALL SURFACE WATER FLOWING TO OR DIVERTED TOWARDS CONSTRUCTION ENTRANCES SHALL BE PIPED THROUGH THE ENTRANCE. MAINTAINING POSITIVE DRAINAGE. PIPE INSTALLED THROUGH THE STABILIZED CONSTRUCTION ENTRANCE SHALL BE PROTECTED WITH A MOUNTABLE BERM WITH 5:1 SLOPES AND MINIMUM OF 6" STONE OVER THE PIPE. PIPE SHALL BE SIZED ACCORDING TO THE DRAINAGE REQUIREMENTS. WHEN THE ENTRANCE IS LOCATED AT A HIGH SPOT AND HAS NO DRAINAGE TO CONVEY A PIPE SHALL NOT BE NECESSARY. THE MINIMUM PIPE DIAMETER SHALL BE 6". CONTRACTOR SHALL BE RESPONSIBLE FOR
- THE MAINTENANCE OF SAID PIPE. LOCATION - A STABILIZED CONSTRUCTION ENTRANCE SHALL BE LOCATED WHERE CONSTRUCTION TRAFFIC ENTERS AND/OR LEAVES THE CONSTRUCTION SITE. VEHICLES LEAVING THE SITE MUST TRAVEL OVER THE ENTIRE LENGTH OF THE TRACKING PAD.

# 2-TRACKING PAD

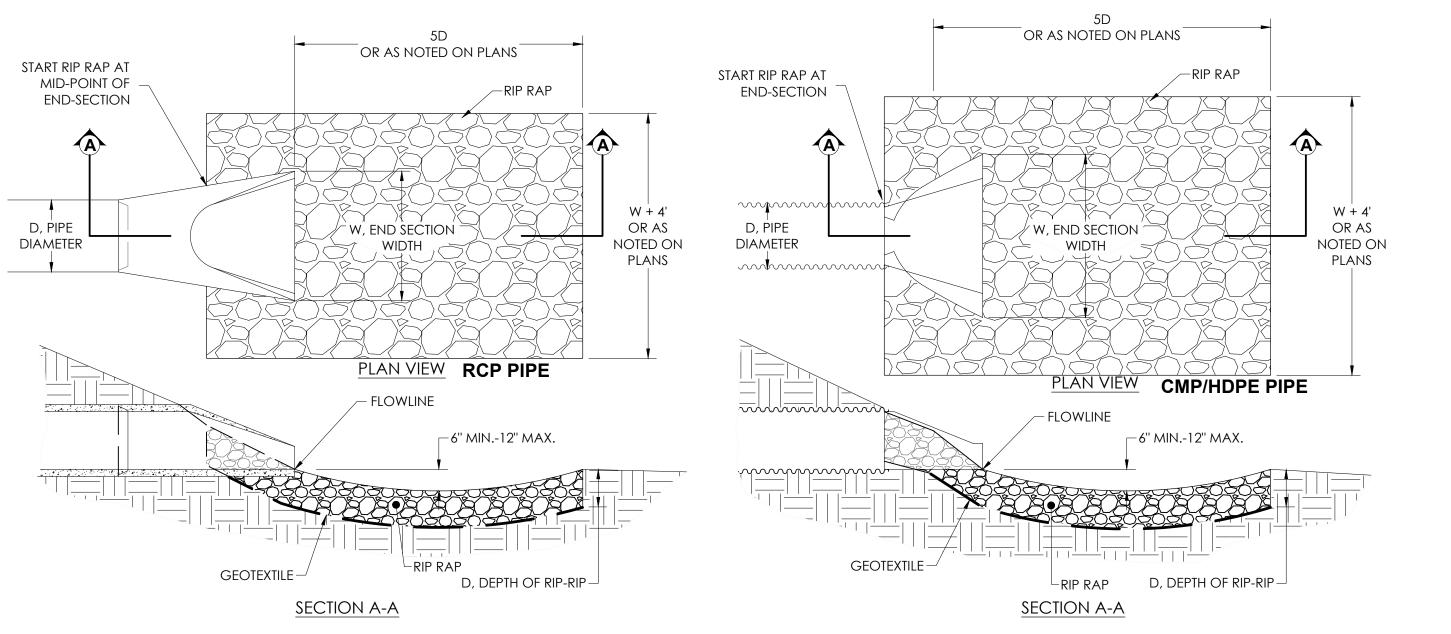


**3-RIP RAP AT PIPE DISCHARGE** 

PLOT BY: SSR

SHEET # C6.0

BUILDING PROPERTIE


PLOT SCALE

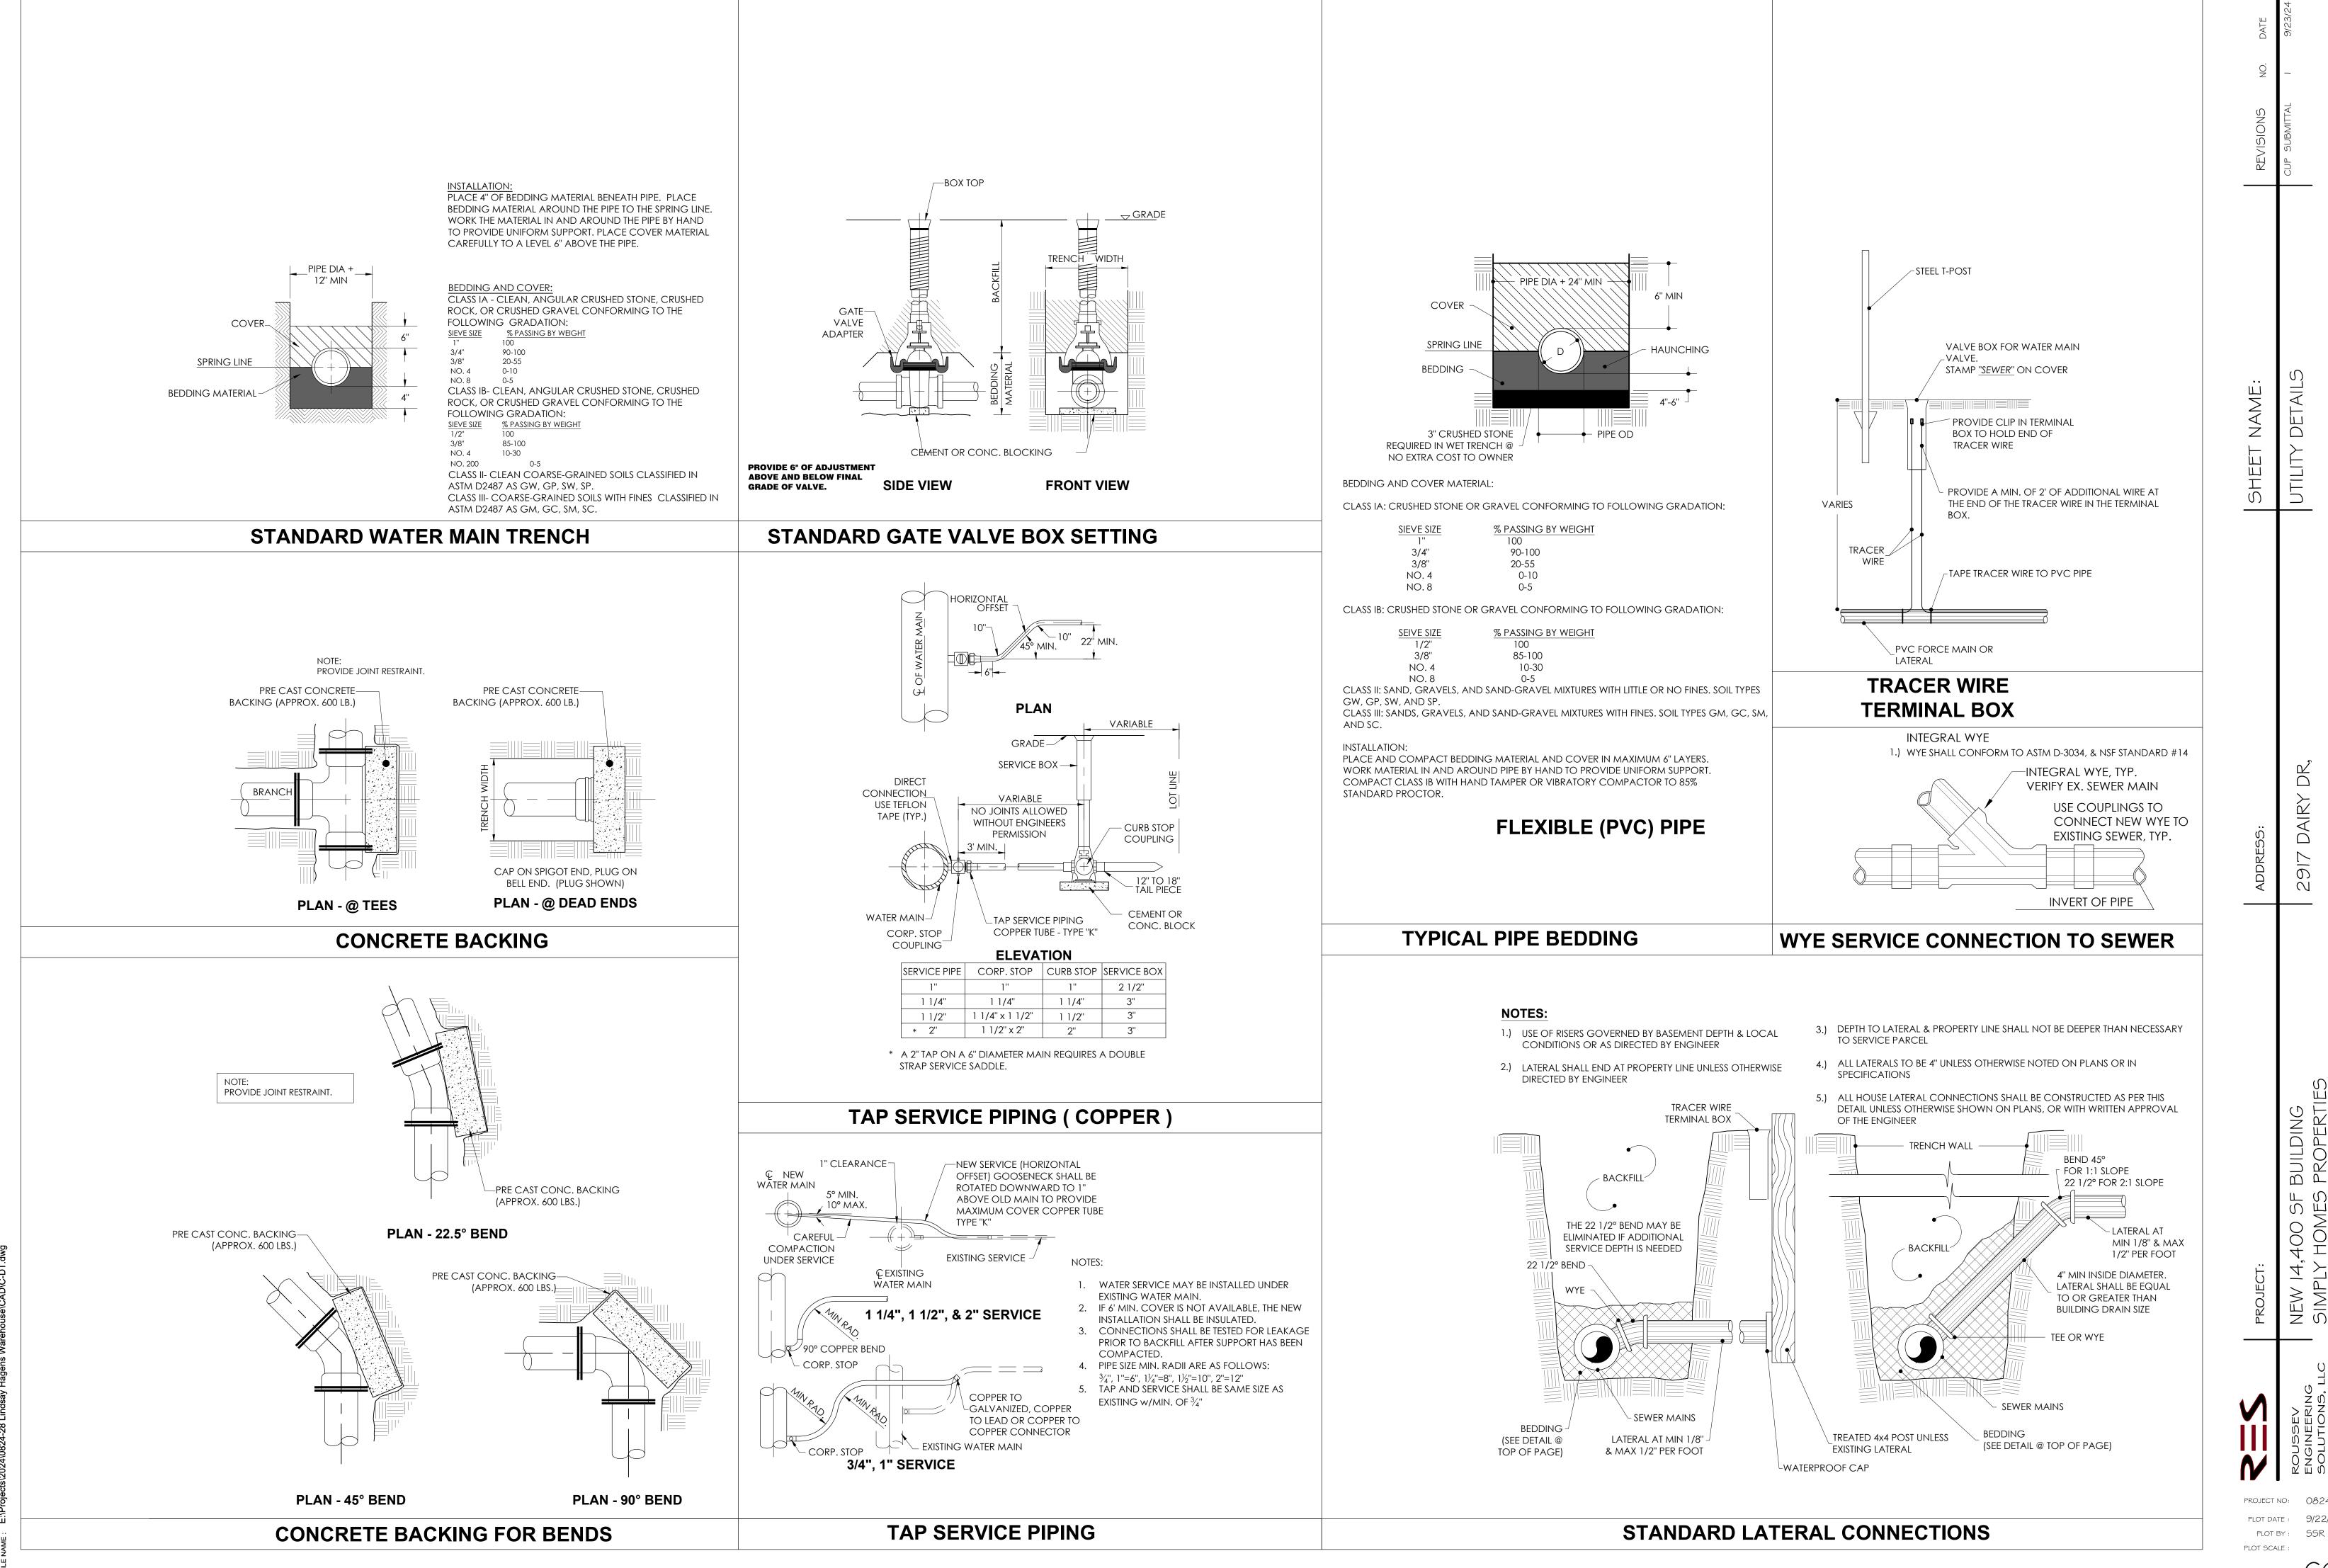

SHEET # C6.1

BUILDING

400 SF HOMES

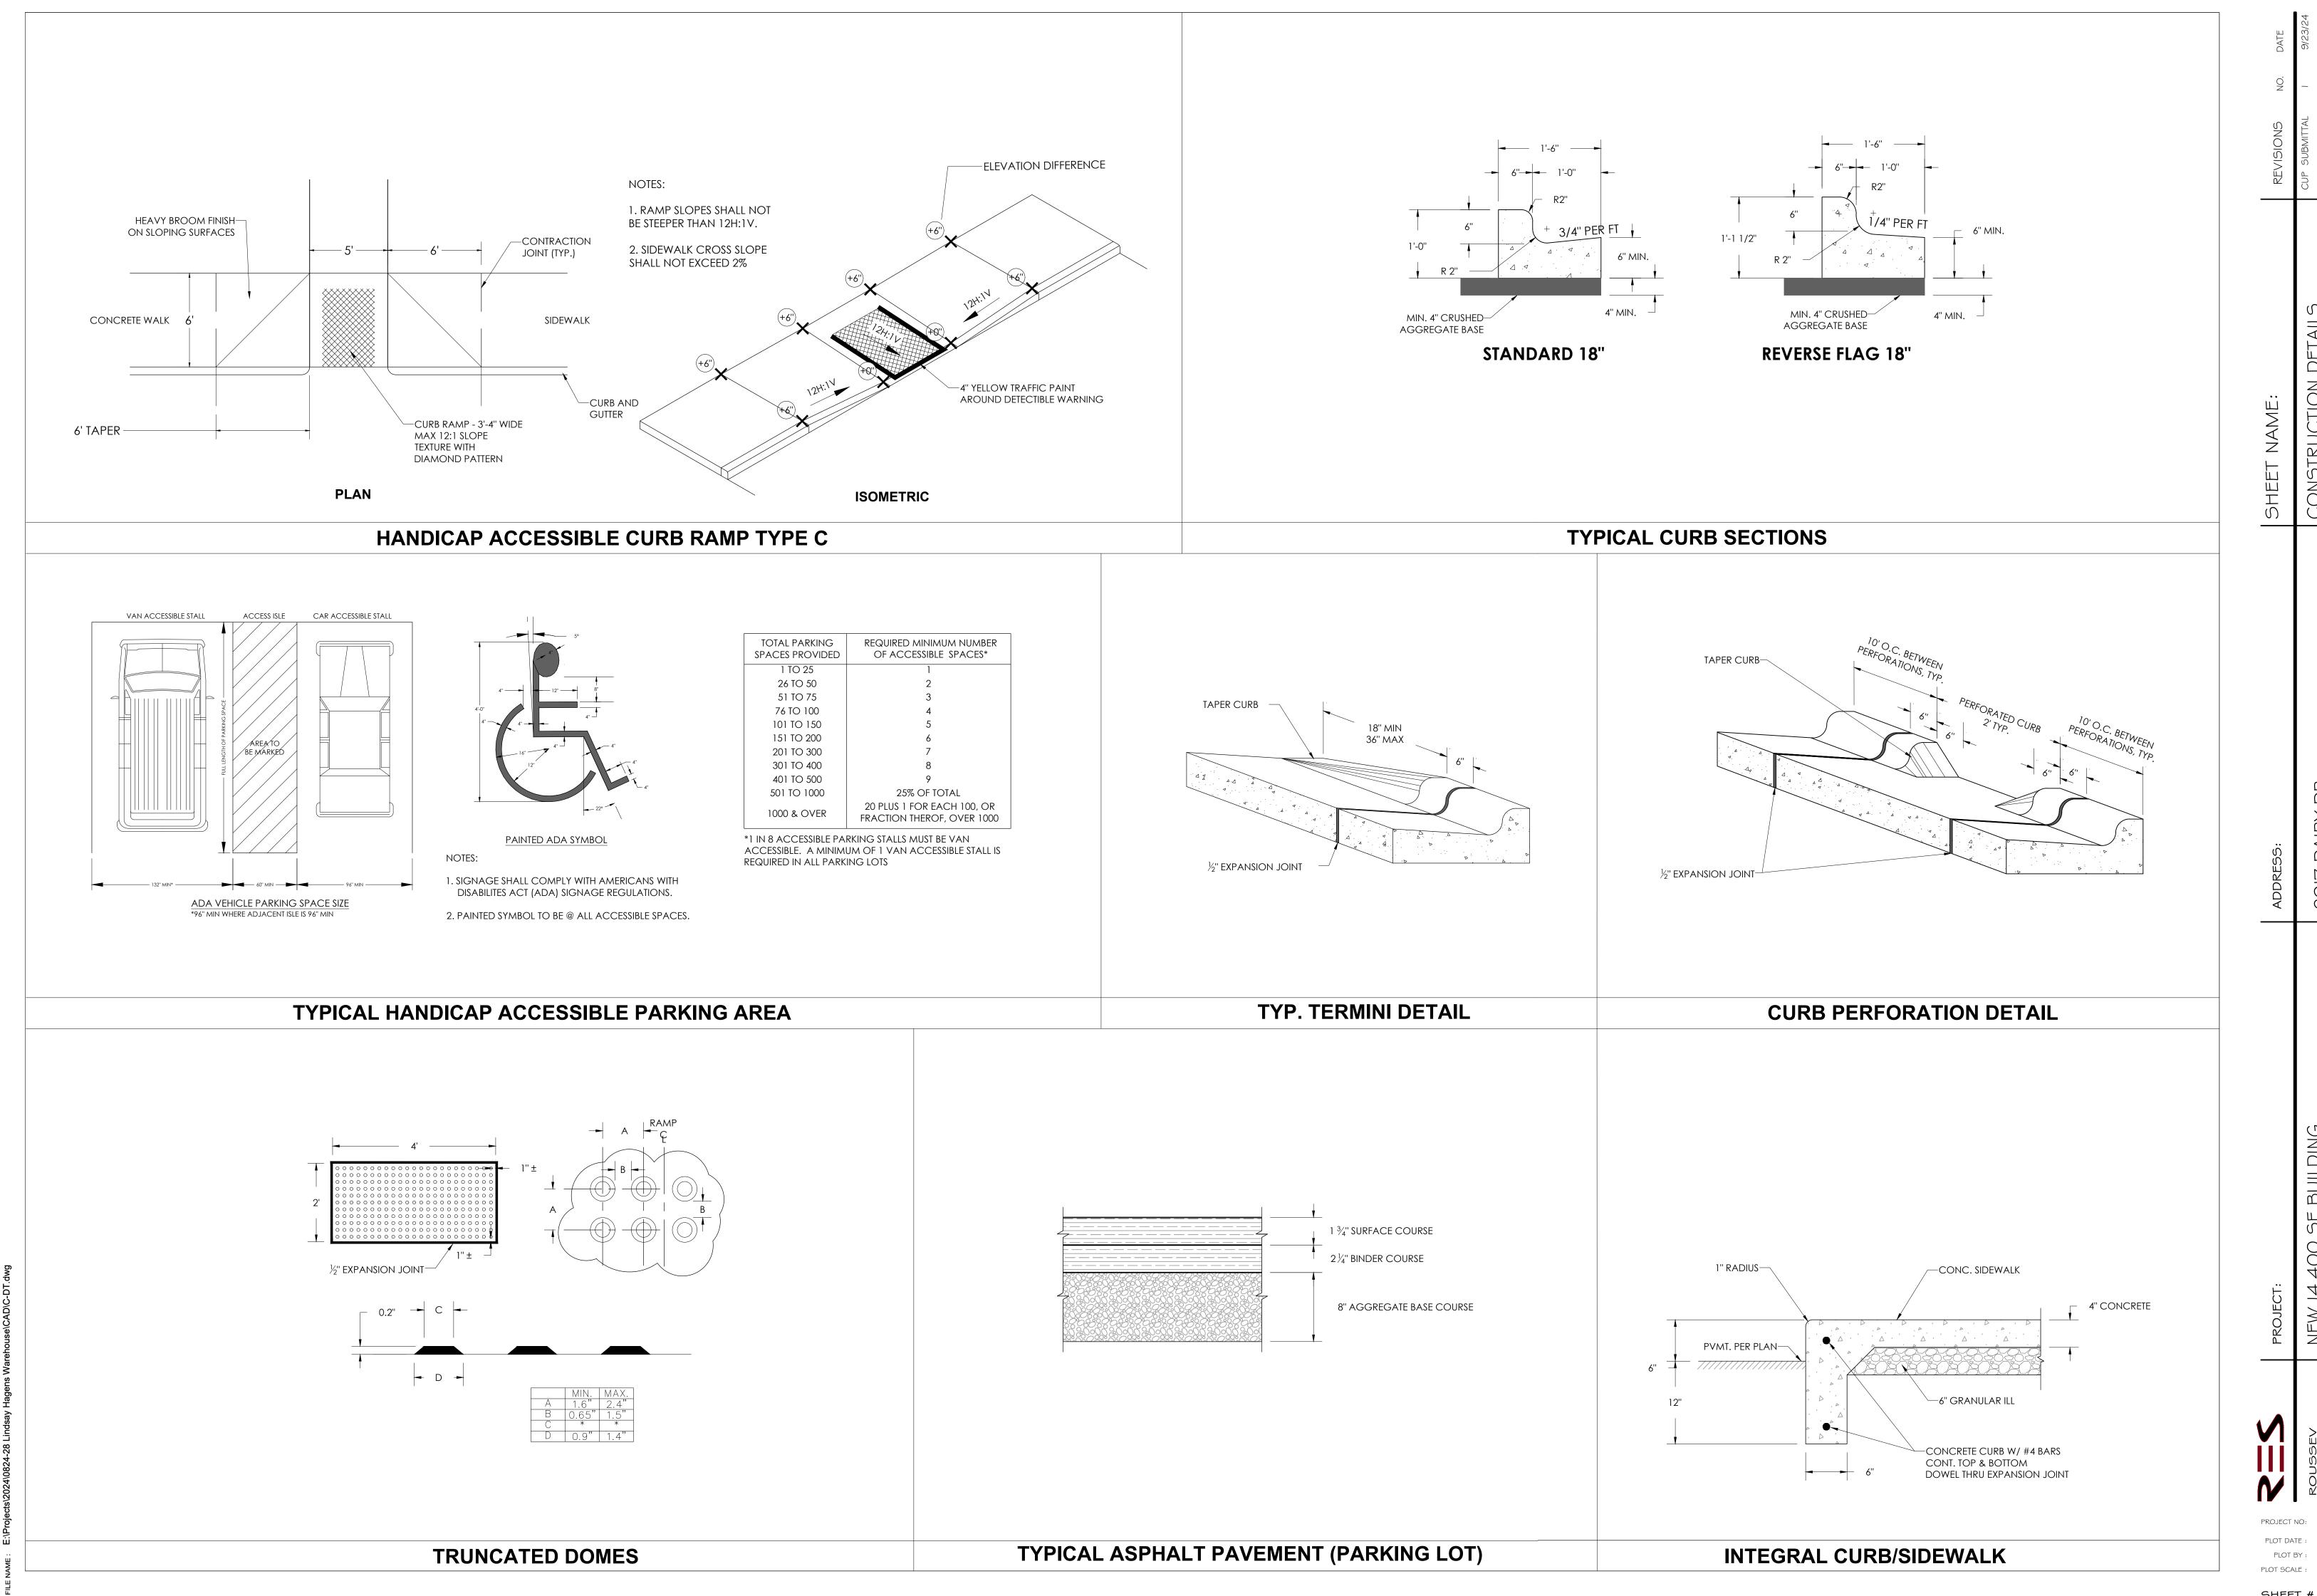

SHEET # C6.2

BUILDING CODE REVIEW			
REFERENCED CODES BUILDING CLASSIFICATION	INTERNATIONAL BUILDING CODE (IBC) - 2015  MAJOR OCCUPANCY: IBC 508.4 SEPARATED OCCUPANIES  MODERATE HAZARD STORAGE (SI) = 8,475 SF  BUSINESS OCCUPANCY (B) = 6,120 SF		
CONSTRUCTION TYPE	VB		
FIRE PROTECTION SYSTEMS	(NOT REQUIRED, OWNER IS CONSIDERING INSTALLING COMPLETE NFPA 13)		
BUILDING HEIGHT AND AREA LIMITATIONS	I STORY		
ALLOWABLE AREA	- IBC 506.2 (SI \$ B) NS = 9,000 SF		
FRONTAGE INCREASE	- IBC 506.3 = (520'/520'-0.25)*30/30 = 75% = OR 75%*9,000 = 6,750 SF		
TOTAL ALLOWABLE AREA	= 9,000 SF + 6,750 = 15,750 SF		
GROSS BUILDING AREA	= 14,595 SF		
BUILDING FIRE AREA	- IBC 903: STORAGE (SI) MAX. ALLOWED FIRE ARE A= 12,000 SF > 8,475 SF		

			ROOM OCC	JUFANCY		
ROOM NO	NAME	AREA	FUNCTION OF SPACE	OCCUPANT LOAD FACTOR	OCCUPANT LOAD	COMMENTS
	WAREHOUSE	7782 SF	STORAGE	500	16	
2	SPACE	1340 SF	BUSINESS	500	3	
3	SPACE	1299 SF	BUSINESS	500	3	
4	SPACE	1343 SF	BUSINESS	500	3	
5	SPACE	1297 SF	BUSINESS	500	3	
6	OFFICE	225 SF	BUSINESS	500	0	
7	ADA TLT	59 SF	BUSINESS	500	0	
8	ADA TLT	55 SF	BUSINESS	500	0	
9	CORRIDOR	324 SF	BUSINESS	500	1	
10	ADA TLT	60 SF	BUSINESS	500	0	
П	ADA TLT	55 SF	BUSINESS	500	0	
12	ADA TLT	57 SF	BUSINESS	500	0	
13	LOCKER RM	156 SF	BUSINESS	500	0	

### MEANS OF EGRESS - CHAPTER IO

OCCUPANT LOAD	28 OCCUPANTS
IBC 1005.3.2 (I): EGRESS WIDTH - 0.15 " PER OCCUPANT	28 X O.15" = 4.20"
EGRESS OPENINGS	(8) MAN DOOR @ 36"
TOTAL EXISTING EGRESS WIDTH	288" : OK

IBC 1017 EXIT TRAVEL DISTANCE

- EXIT ACCESS TRAVEL DISTANCE: MAX ALLOWED PER TABLE 1017.2 = 200' - 0" FOR BLDG W/O SPRINKLER SYSTEM FOR B \$ 5-I OCCUPANCY < 200' - 0"

## PLUMBING FIXTURES FOR CURRENT CONSTRUCTION

SECTION 2902 - MINIMUM PLUMBING FACILITIES

PLUMBING FIXTURE CALCULATIONS:

B/ MALE B / FEMALE
WATER CLOSETS I PER 25 I PER 25
LAVATORIES I PER 100 I PER 100

SI/ MALE SI / FEMALE
WATER CLOSETS I PER 100 I PER 100
LAVATORIES I PER 100 I PER 100


TOTAL MEN'S = 6\* 0.04 + 6\*0.01 = 0.3 (IREQUIRED), 2.5 PROVIDEDTOTAL WOMEN'S = 6\* 0.04 + 6\*0.01 = 0.3 (IREQUIRED), 2.5 PROVIDEDTOTAL LAVATORIES = 28\*0.01 = 0.28 (IREQUIRED), 5 PROVIDEDTOTAL DRINKING FOUNTAINS = 12/100 (B) + 16/1000 (SI) = (IREQUIRED), I PROVIDEDTOTAL SERVICE SINKS = IREQUIRED, I PROVIDED

EXIT LIGHT

FE FIRE EXTINGUISH FEC FIRE EXTINGUISHER

-CYLINDER TYPE -CABINET TYPE


FEC FIRE EXTINGUISHER -CABINET TYPE

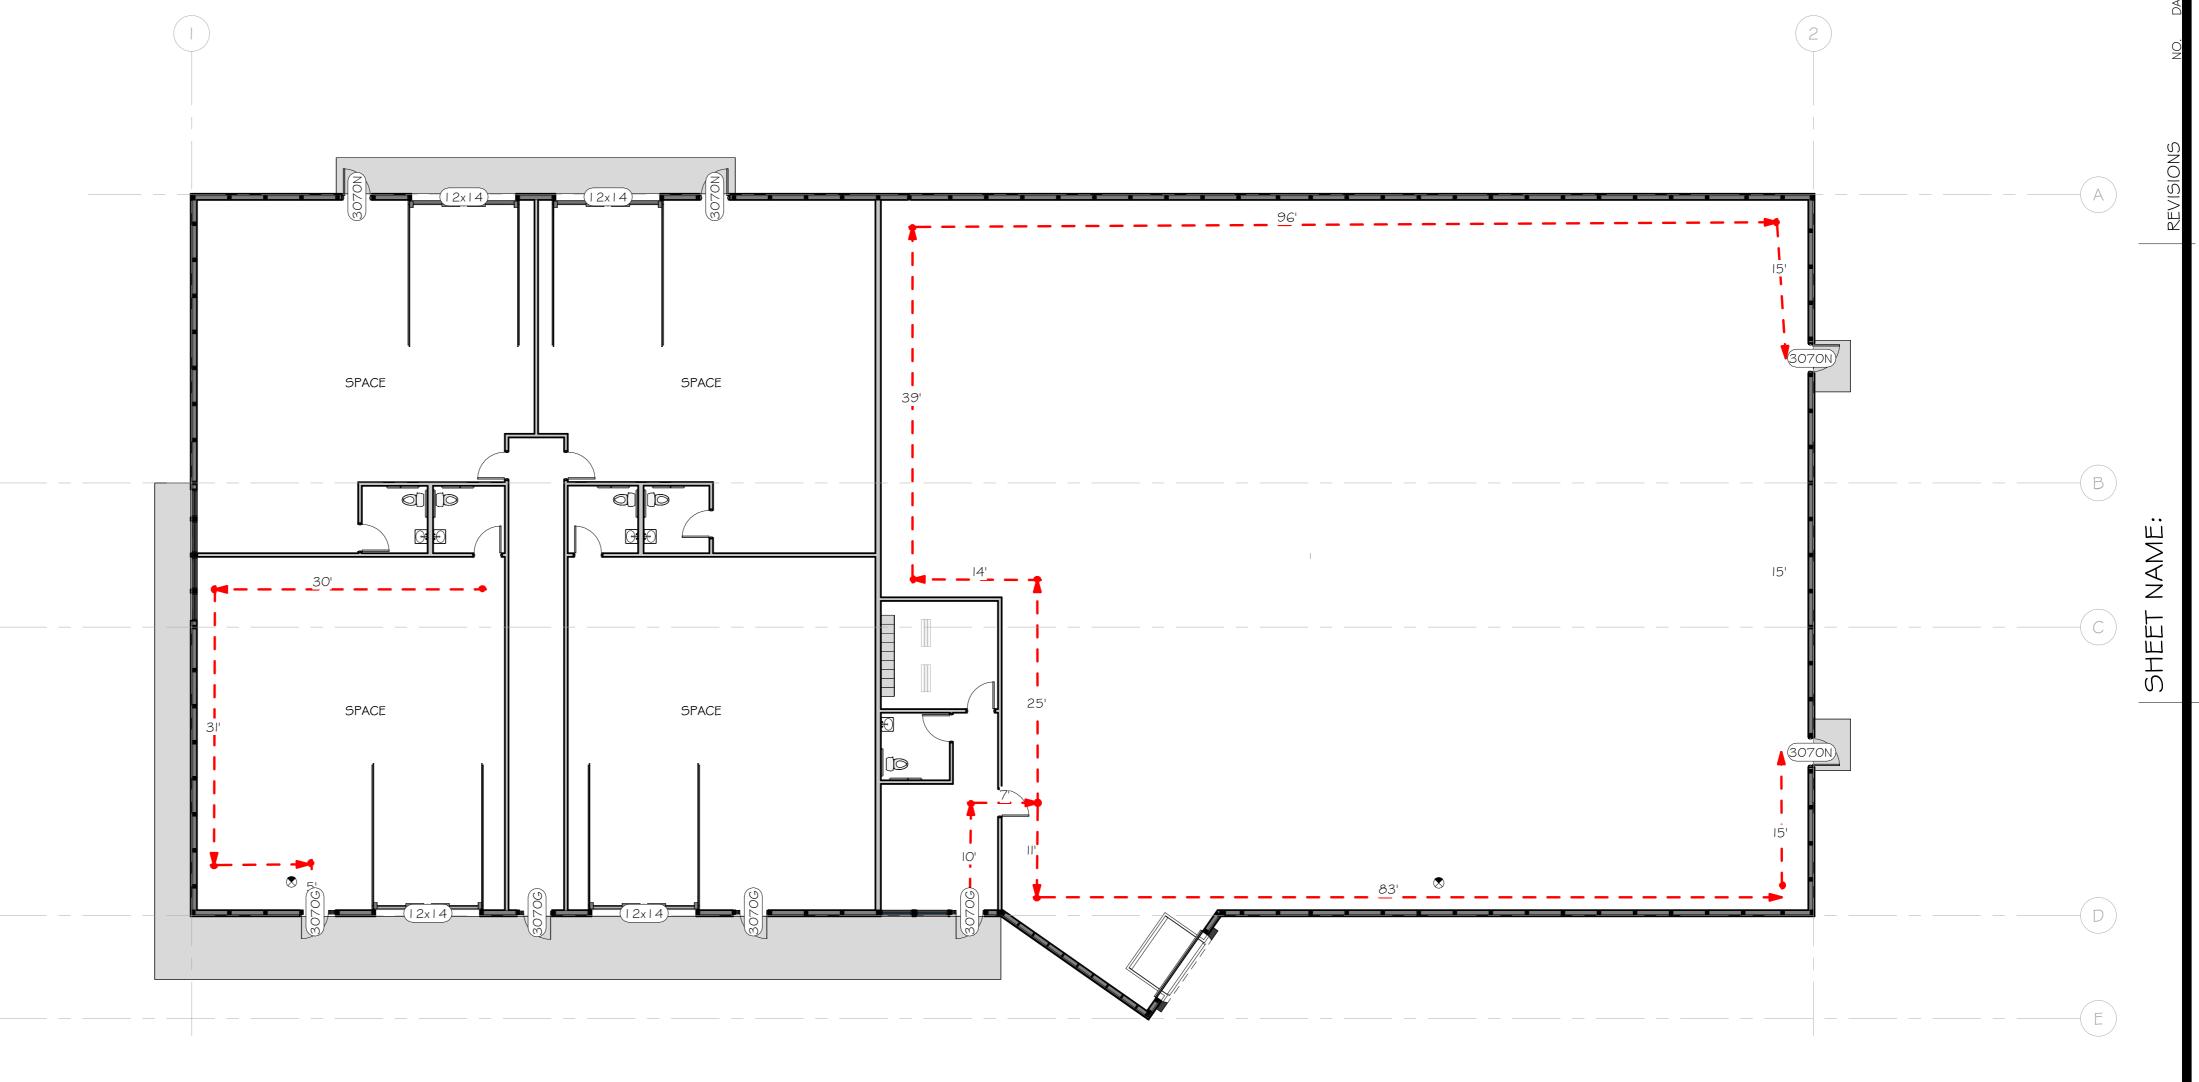

2 LIFE SAFETY & EGRESS PLANS

SCALE: 3/64" = 1'-0" on 12" x 18"

3/32" = 1'-0" on 24" x 36"

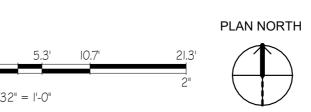

ADDRESS: 2917 DAIRY [

JILDING

O SF POST-FRAME BUIL Y HOMES PROPERTIES


PROJECI:
14,400 SF PC
SIMPLY HOME

ROUSSEV ENGINEERING SOLUTIONS, LLC

PROJECT NO: 0824-28
PLOT DATE: 8/26/24
PLOT BY: SSR
PLOT SCALE: As indicated

SHEET # A = 0

PRELIMINARY NOT FOR CONSTRUCTION

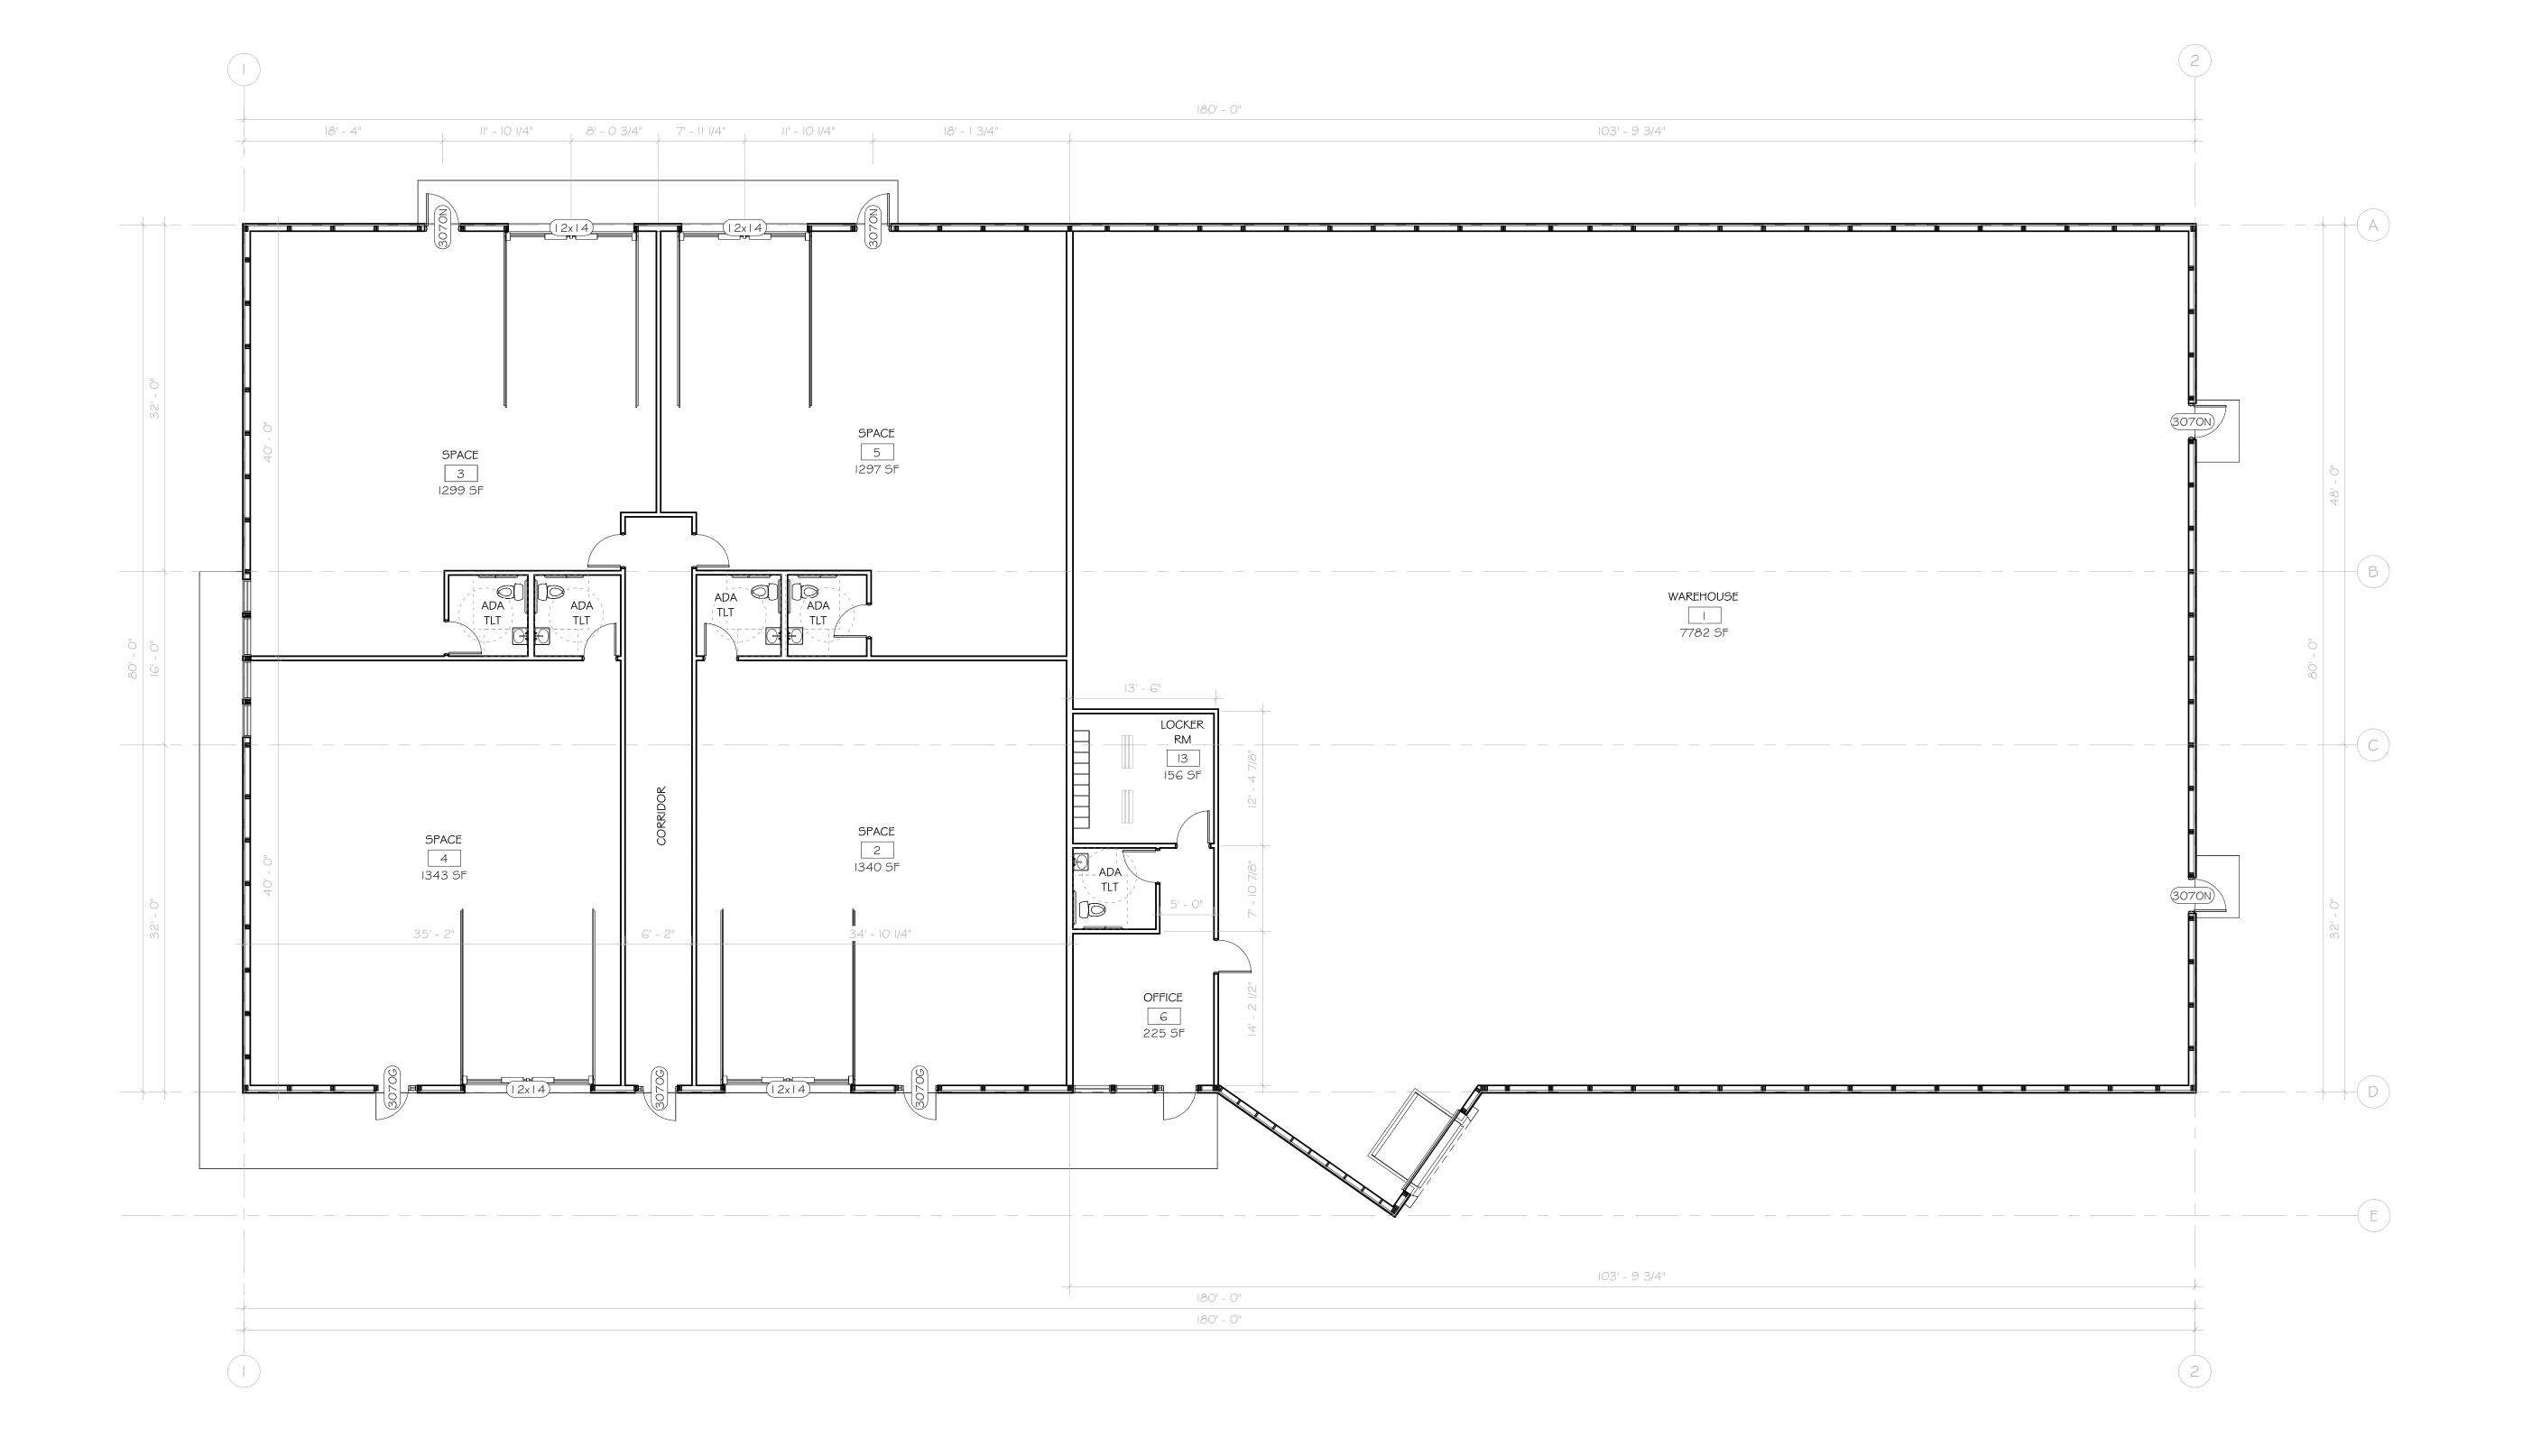



FIRST FLOOR PLAN

SCALE: I/I6" = I'-0" on I2" x I8"

I/8" = I'-0" on 24" x 36"

PLAN NORTH

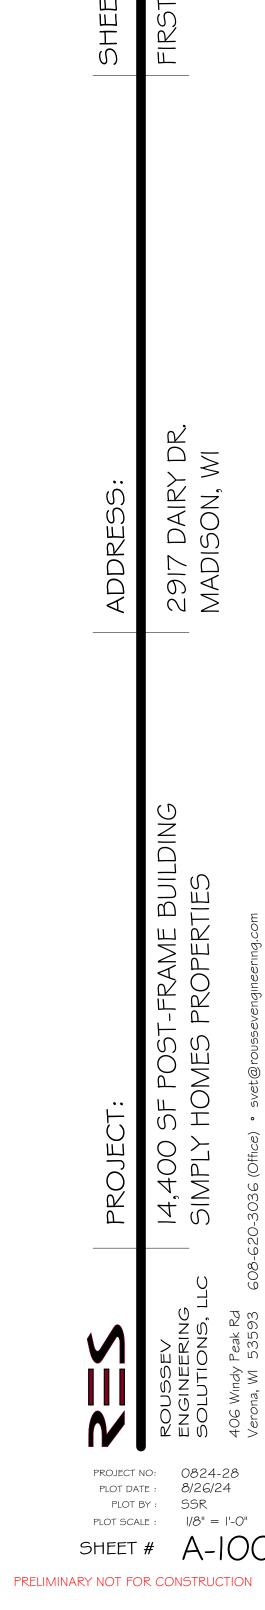

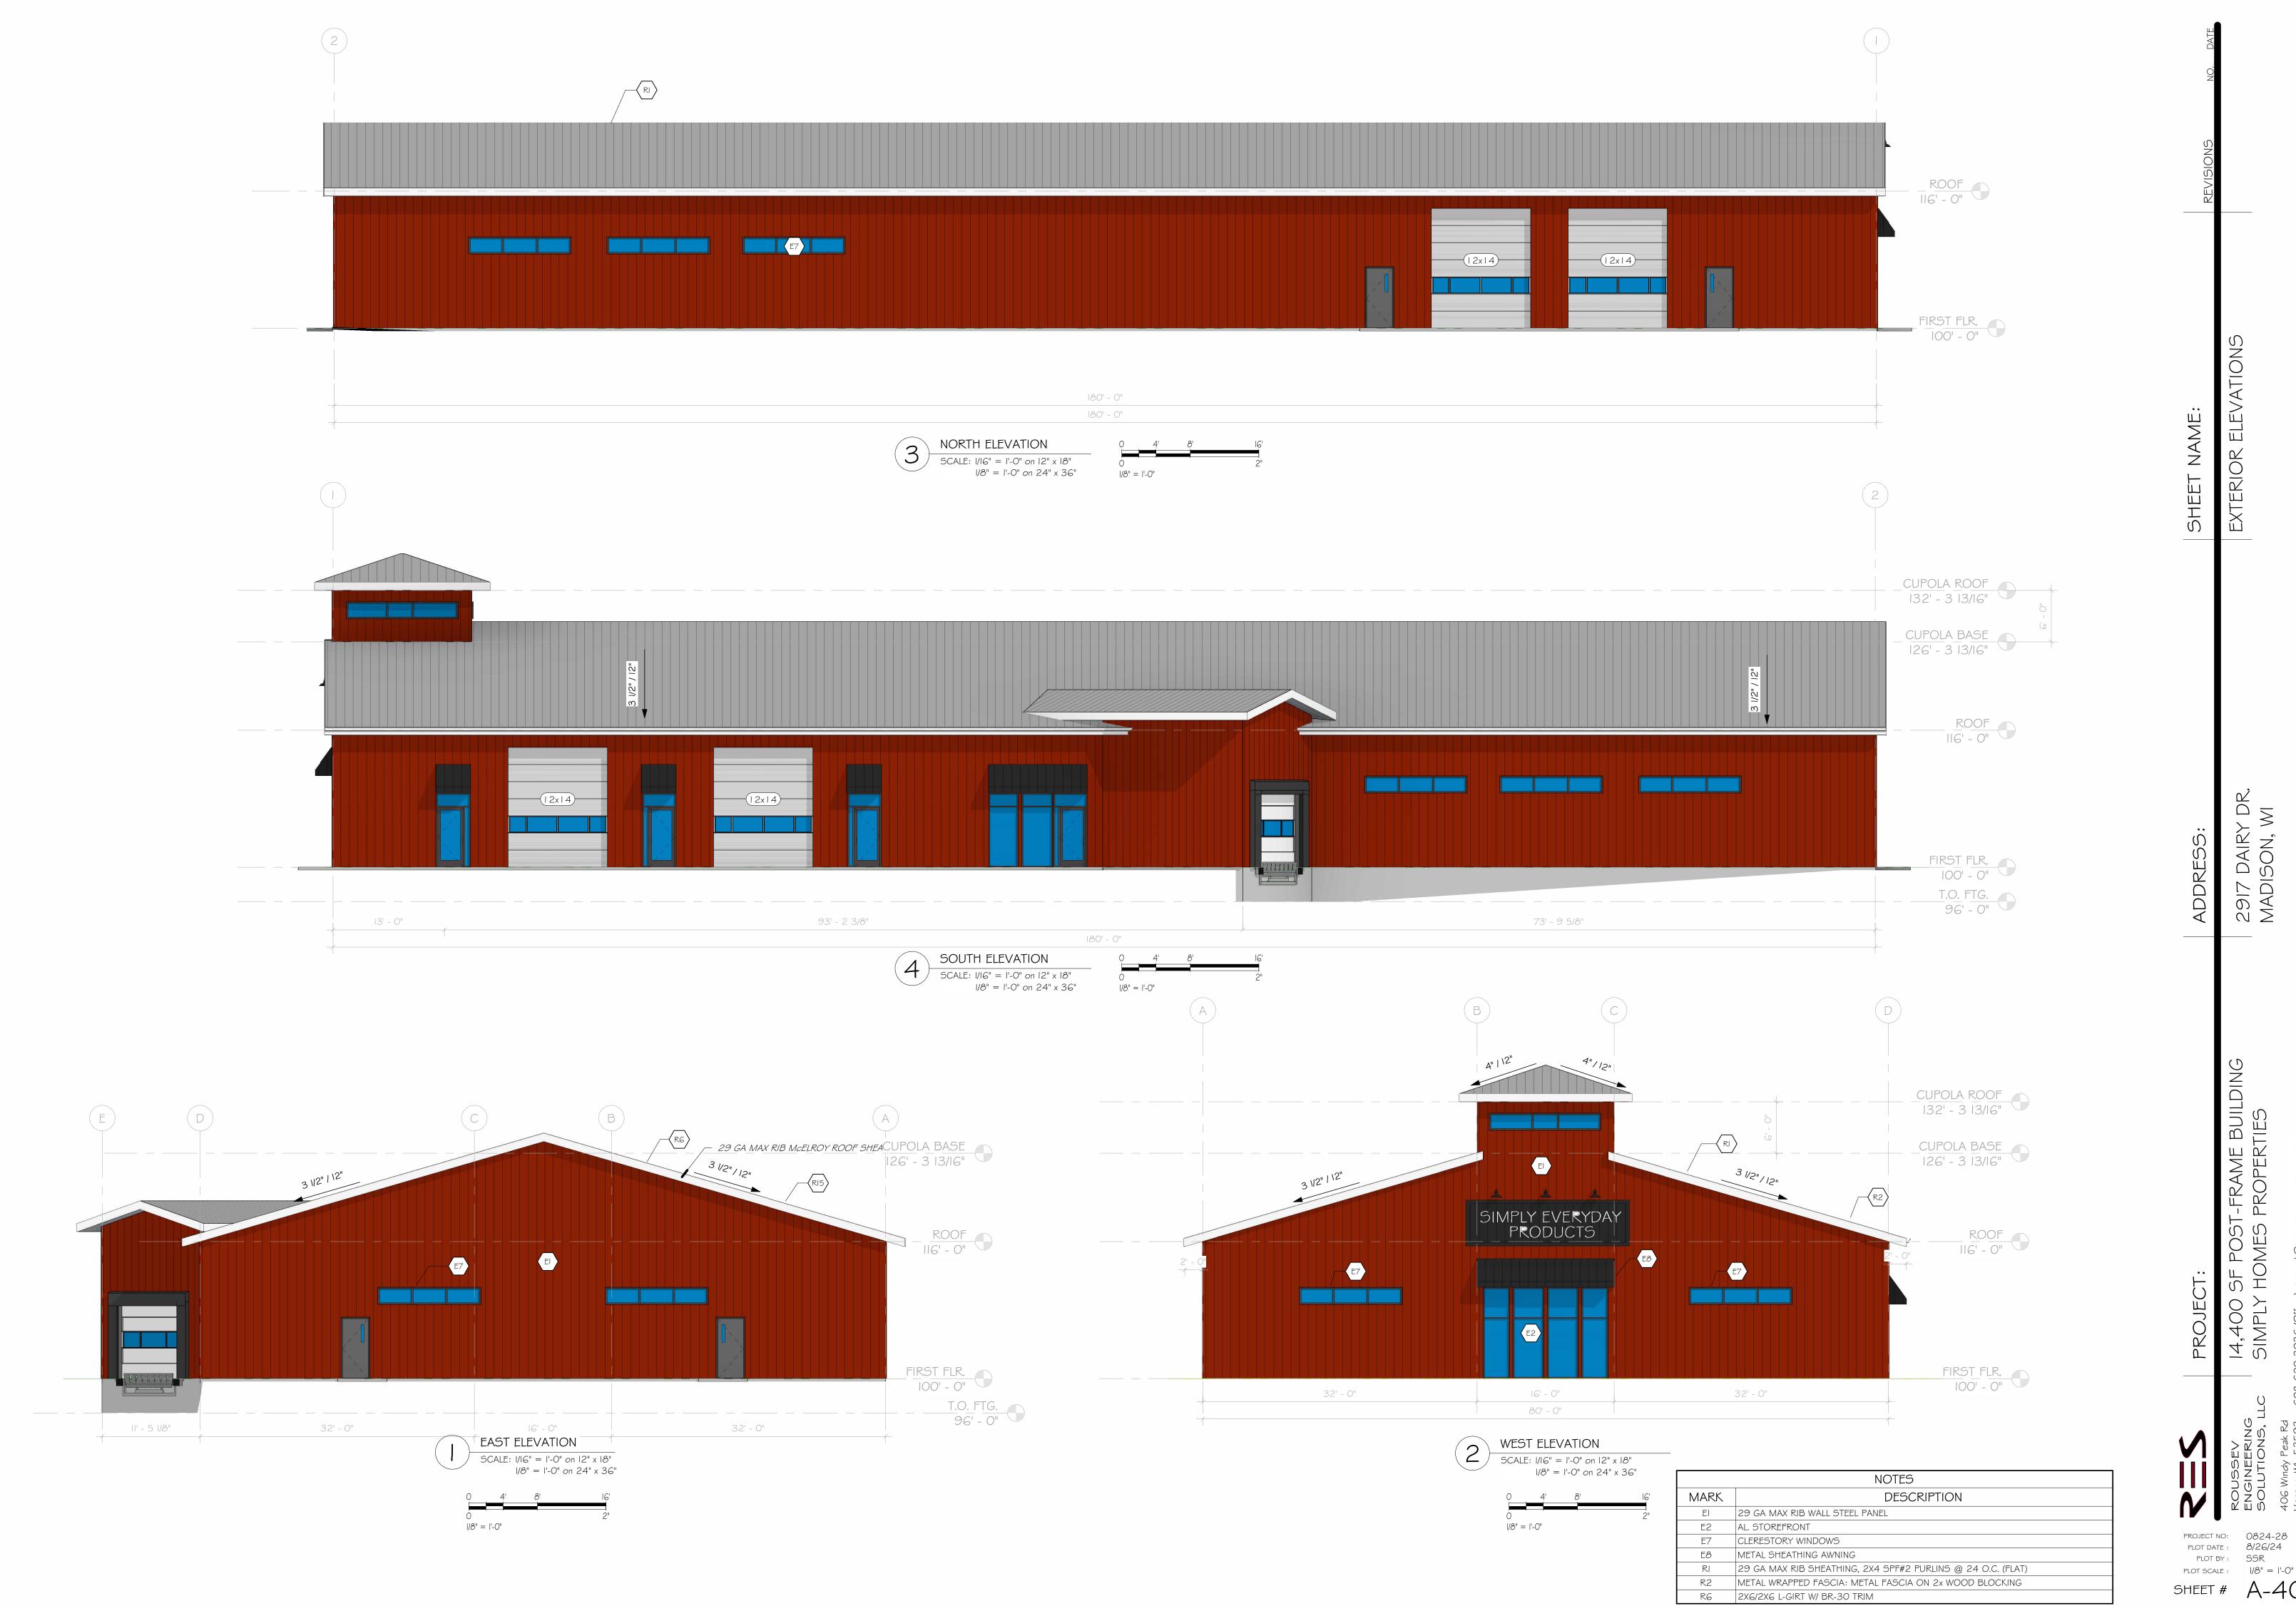

PLOT SCALE: 1/8" = 1'-0"PRELIMINARY NOT FOR CONSTRUCTION