



# TIGERS CHILDREN'S HOME - REMODEL

# 1902 S. STOUGHTON RD. | MADISON, WI 53716

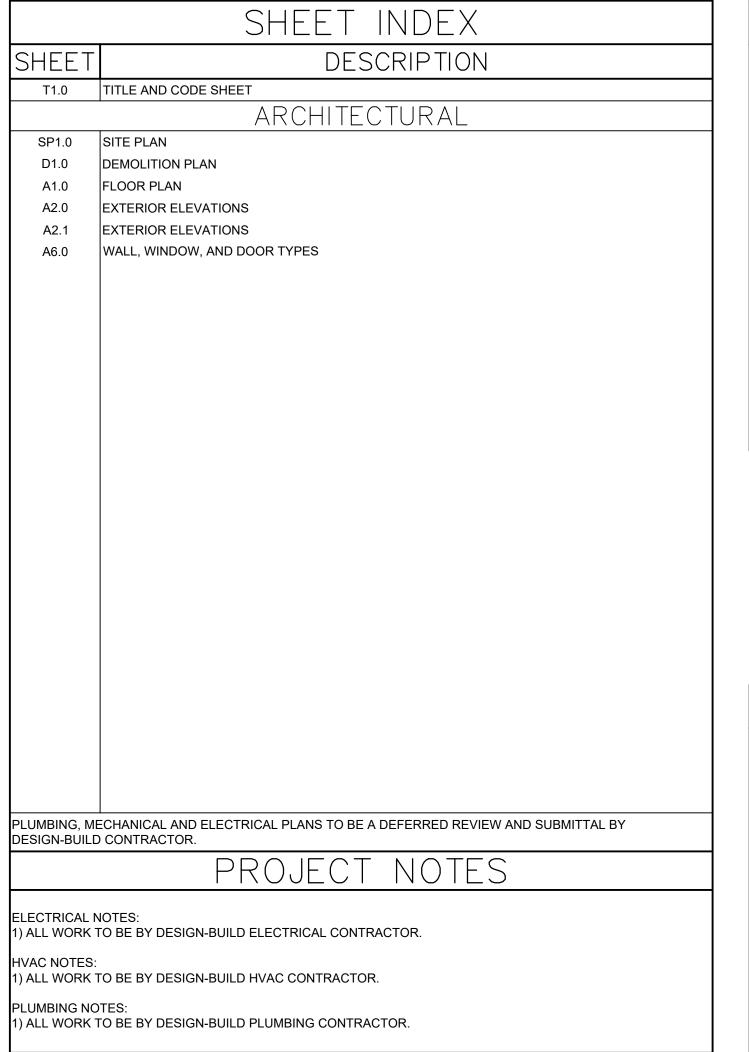

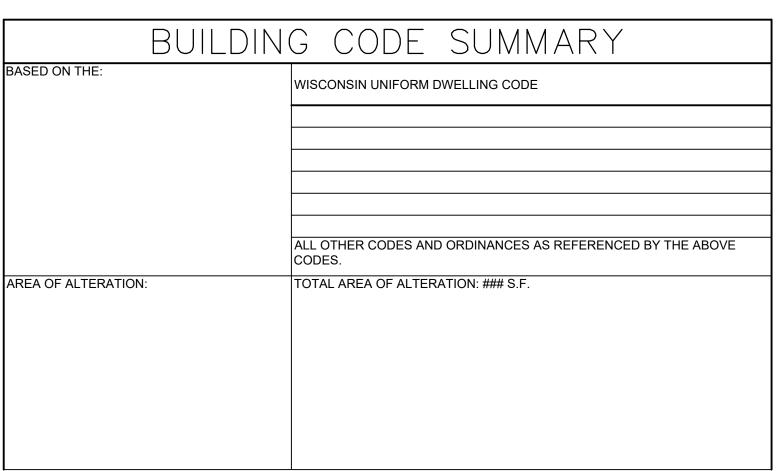

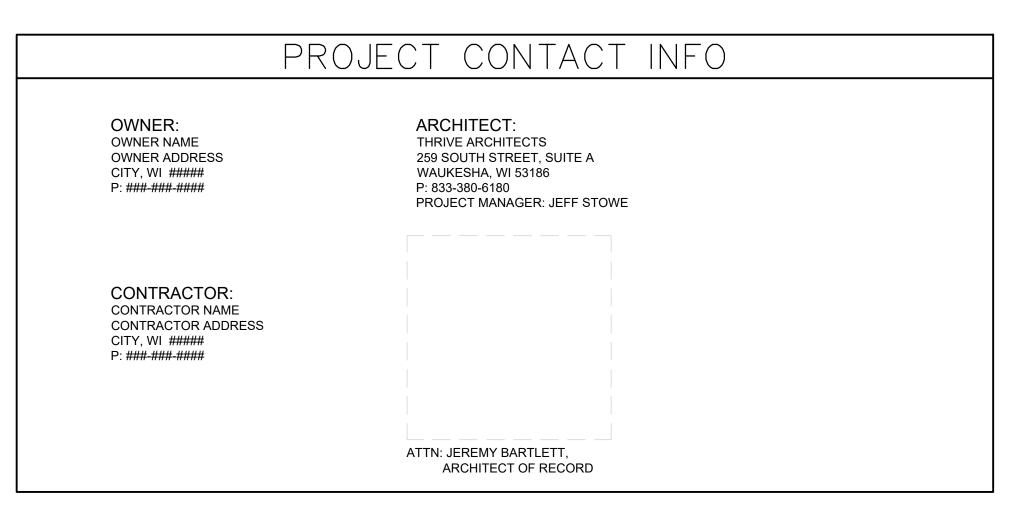

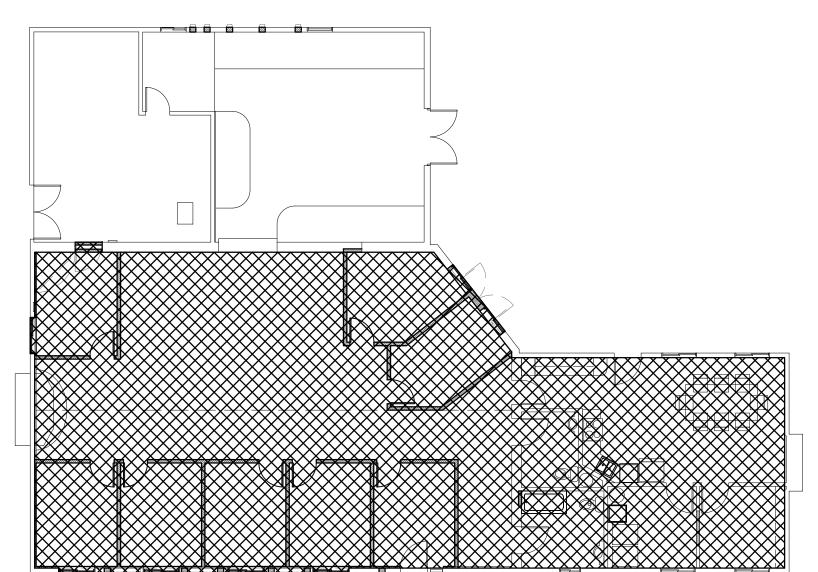

AREA OF WORK

FIRST FLOOR KEY PLAN SCALE: N.T.S.







No. Date Description 08.23.2024 Plan Commission

Drawn by

JAJ

Revisions —

Checked by

JMS

259 South Street, Suite A WAUKESHA, WI 53186

 $\blacksquare$ Project Info. -24026 -

Tigers Children's

p: 833-380-6180

Home

Remodel

Madison, WI

**—**Sheet Title <del>——</del>

1902 S Stoughton Rd

Sheet No. -

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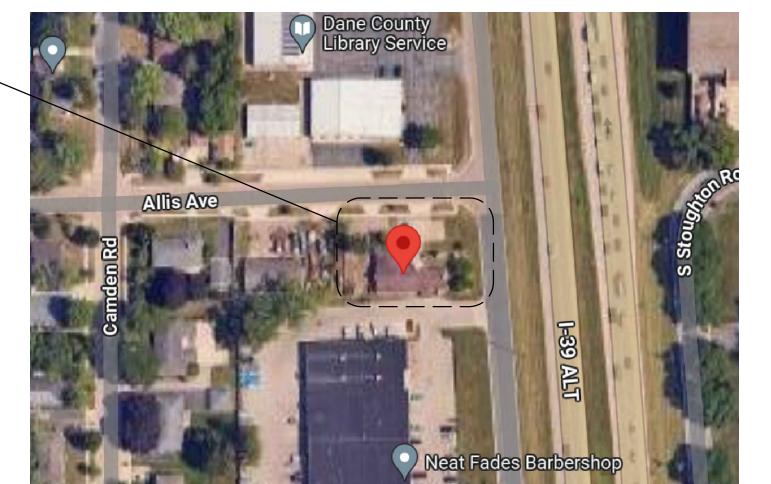
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# GENERAL NOTES

- CONSTRUCTION IS TO BE IN COMPLIANCE WITH ALL GOVERNING CODES, ORDINANCES & STANDARDS. THE CONTRACTOR(S) SHALL BE RESPONSIBLE FOR INITIATING, MAINTAINING, & SUPERVISING ALL SAFETY PRECAUTIONS & PROGRAMS IN CONNECTION WITH THE PERFORMANCE OF THIS PROJECT. ARCHITECT/DESIGNER SHALL NOT BE RESPONSIBLE FOR ANY COST, SCHEDULE OR CONSTRUCTION ISSUES ARISING
- DUE GC/OWNERS FAILURE TO DISTRIBUTE ALL DOCS. SUBCONTRACTORS & SUPPLIERS SHOULD ENDEAVOR TO REVIEW A COMPLETE SET OF DOCS BEFORE BIDDING, FABRICATING & INSTALL. GC, SUBCONTRACTORS, MATERIAL SUPPLIERS, OWNER, ETC. MUST NOTIFY ARCHITECT OF ANY ERRORS, OMISSIONS, O
- DEFECTS IN THE CONSTRUCTION DOCUMENTS PRIOR TO BIDDING, FABRICATING OR INSTALLING WORK. SITE DIMENSIONS ARE TO BE FIELD VERIFIED AND ADJUSTED ACCORDINGLY. THE ARCHITECT/DESIGNER SHALL BE NOTIFIED OF ANY VARIANCES BEFORE CONTRACTOR BEGINS OR PROCEEDS WORK. MECH, ELEC, PLUMB & FIRE PROTECTION ARE TO BE DESIGN BUILT, COMPLYING WITH ALL GOVERNING CODES,
- & STANDARDS, WHICH WILL BE THE FULL RESPONSIBILITY OF THE CONTRACTOR; THE ARCHITECT ALL MECH, ELEC, PLUMB & FIRE PROTECTION SYSTEMS/EQUIP. SHALL BE MAINTAINED ACCORDING TO MANUFACTURER'S STANDARDS. BLDG. OWNER SHALL ASSUME FULL RESPONSIBILITY FOR MAINTANANCE/OPPERATION
- THE INSTALLATION AND EXECUTION OF ALL MATERIALS SHALL BE IN ACCORDANCE WITH THE MANUFACTURER'S STANDARDS AND SPECIFICATIONS. ALL MEANS & METHODS OF CONSTRUCTION TO BE THE SOLE RESPONSIBILITY OF
- PORTABLE FIRE EXTINGUISHERS SHALL BE PROVIDED IN OCCUPANCIES AND LOCATIONS AS REQUIRED BY THE INTERNATIONAL FIRE CODE. INSTALLATION LOCATIONS SHALL HAVE A MAXIMUM TRAVEL DISTANCE OF 75' TO ANY EXTINGUISHER. EXTINGUISHERS SHALL BE LOCATED IN CONSPICUOUS LOCATIONS WERE THEY WILL BE READILY ACCESSIBLE AND IMMEDIATELY AVAILABLE FOR USE, TYPICALLY ALONG PATHS OF TRAVEL. EXTINGUISHERS SHALL NOT BE OBSTRUCTED FROM VIEW, IF VISUAL OBSTRUCTION CAN NOT BE AVOIDED ANOTHER MEANS SHALL BE PROVIDED TO INDICATE THE EXTINGUISHER LOCATIONS. EXTINGUISHERS NOT EXCEEDING 40" SHALL BE INSTALLED SO THAT ITS TOP IS NOT MORE THAT 5'-0" ABOVE THE FLOOR, EXTINGUISHERS EXCEEDING 40" SHALL BE INSTALLED SO THAT ITS TOP IS NOT MORE THAN 3'-6" ABOVE THE FLOOR. THE CLEARANCE BETWEEN THE FLOOR AND BOTTOM OF HAND HELD UNITS SHALL NOT BE LESS THAN 4". VERIFY EXTINGUISHER LOCATIONS W/ LOCAL FIRE DEPT. & OWNER PRIOR TO INSTALLATION.
- ALL CONCRETE FLAT WORK MUST BE WET CURED PER ACI REQUIREMENTS AND/OR CURED USING A CURING COMPOUND. REFER TO STRUCTURAL NOTES FOR CURING COMPOUND SPECS. CONTRACTOR IS RESPONSIBLE FOR APPLYING CURING COMPOUNDS PER THE MANUFACTURER'S REQUIREMENTS.

### TYPICAL ABBREVIATIONS

ABV: Above	B/O: By Others	DW: Dishwasher	FTG: Footing	LB: Pound	NO, #: Number	REFR: Ref	TEMP: Tempered
ACOUS: Acoustical	BO: Bottom Of	DIV: Division	FND: Foundation	LAM: Laminate(d)	. "	REG: Register	TK: Tight Knot
ADDL: Additional	BR: Bedroom	DR: Door	FRM: Fram(d), (ing)	LAV: Lavatory	O: Non-Operable Window	RE: Reinforced	T&G: Tongue and Groove
ADH: Adhesive		DH: Double Hung	FBO: Furnished by Others	LH: Left Hand	Section	REQ'D: Required	T/O: Top of
ADJ: Adjustable	CAB: Cabinet	DS: Downspout	FUR: Furred	L: Length	OBS: Obscure	RA: Return Air	TOC: Top of Concrete
AFF: Above Finish Floor	CALC: Calculation	DRWR: Drawer		LOA: Length Overall	OC: On Center	REV: Revision	TOW: Top of Wall
AGG: Aggregate	CD: Cabinet Door	DT: Drain Tile	GA: Gage, Gauge	LT: Light	OP: Opaque	R: Riser	TB: Towel Bar
AHJ: Authority Having	CG: Corner Guard	DWG: Drawing	GAL: Gallon	LF: Lineal Feet	OPG: Opening	RD: Rod	T: Tread
Jurisdiction	CIP: Cast-In-Place	D: Nail Size	GL: Glass, Glazing	LL: Live Load	OSB: Orientated Strand Board	R&S: Rod and Shelf	TS: Tubular Steel
A/C: Air Conditioning	(Concrete)		GI: Galvanized Iron	LVL: Laminated Veneer	OD: Outside Diameter	RFG: Roofing	TYP: Typical
ALT: Alternate	CL: Centerline	EW: Each Way	GLBK: Glass Block	Lumber		RM: Room	
ALUM: Aluminum	CO: Clean Out	E: East	GLB: Glue Laminated Beam	LVR: Louver	PMT: Paint(ed)	RO: Rough Opening	UL: Underwriters Laborator
ANC: Anchor, Anchorage	CONTR: Contract (or)	EL: Elevation	GT: Grout		PBD: Particle Board		UNF: Unfinished
AB: Anchor Bolt	COORD: Coordinate	ELEV: Elevation	GRD: Grade, Grading	MFR: Manufacturer	PRT: partition	SCH: Schedule	UNO: Unless Noted Otherwi
ANOD: Anodized	CRPT: Carpet	EQ: Equal	GWB: Gypsum Wall Board	MO: Masonry Opening	PVMT: Pavement	SCN: Screen	
APX: Approximate	CIP: cast-in-place	EQP: Equipment	• •	MAX: Maximum	PERF: Perforate(d)	SECT: Section	VB: Vapor Barrier
APT: Apartment	CLK: Caulking	EXCV: Excavate	HWD: Hardware	MAS: Masonry	PLAS: Plaster	SGD: Sliding Glass Door	VAR: Varnish
ARCH: Architect	CAS: Casement	EXH: Exhaust	HDR: Header	MECH: Mechanic(al)	PLAM: Plastic Laminate	SHTH: Sheathing	VIF: Verify In Field
(architectural)	CB: Catch Basin	EXIST: Existing	HTG: Heating	MC: Medicine Cabinet	PLT: Plate	SHT: Sheet	VRN: Veneer
ASPH: Asphalt	CLG: Ceiling	EXT: Exterior	HVAC: Heating,	MED: Medium	PLYWD: Plywood	SH: Shelf, Shelving	VERT: Vertical
AUTO: Automatic	CT: Ceramic Tile		Ventilation—Air Conditioning	MDF: Medium Density	PCC: Precast Concrete	SIM: Similar	VG: Vertical Grain
AVE: Avenue	CIR: Circle	FOC: Face of Concrete	HT: Height	Fiberboard	PCF: Pounds Per Cubic Foot	SKL: Skylight	VIN: Vinyl Sheet
AVR: Average	CLR: Clear	FOF: Face of Finish	HC: Hollow Core	MDO: Medium Density Overlay	PLF: Pounds Per Linear Foot	S: South	
AWN: Awning	COL: Column	FOM: Face of Masonry	HOR: Horizontal	MBR: Member	PSF: Pounds Per Square	SLB: Slab	WL: Wall
•	CONC: Concrete	FOS: Face of Studs	HB: Hose Bib	MMB: Membrane	Foot	SLD: Slider(ing)	WC: Water Closet
BSMT: Basement	CMU: Concrete Masonry	FOW: Face of Wall		MTL: Metal	PSI: Pounds Per Square Inch	SPEC: Specification	WH: Water Heater
BM: Beam	Unit	FBD: Fiberboard	IN: Inch	MWK: Millwork	PBF: Prefabricated	SQ: Square	WP: Water Proofing
BVL: Beveled	CONST: CONSTruction	FCB: Fiber Cement Board	INCL: Include	MIN: Minimum	PRF: Preformed	STD: Standard	WR: Weather Resistant
BITUM: Bituminous	CONT: Continuous	FGL: Fiberglass	ID: Inside Diameter	MIR: Mirror	PT: Pressure Treated	STV: Stove	WRB: Weather Resistive
BLK: Block	CJT: Control Joint	FIN: Finish	INS: Insulate	MISC: Miscellaneous	PL: Property Line	STL: Steel	Barrier
BLKG: Blocking	CORR: Corrugated	FFE: Finished Floor Elevation	INT: Interior	MOD: Module	PH: Toilet Paper Hanger	STR: Structural	WWF: Welded Wire Fabric
BLW: Below	CUFT: Cubic Foot	FA: Fire Alarm	INV: Invert	MLD: Moulding	, ,	SA: Supply Air	WWM: Welded Wire Mesh
BLDV: Boulevard	CUYD: Cubic Yard	FE: Fire Extinguisher		MLB: Micro Laminate Beam	QTY: Quantity	SC: Solid Core	W: West
BTW: Between		FPL: Fireplace	JNT: Joint		QT: Quarry Tile	SW: Shear Wall	WIN: Window
BD: Board	DP: Dampproofing	FLSH: Flashing	JST: Joist	NOM: Nominal	•	SS: Stainless Steel	W/O: Without
BOT: Bottom	DTL: Detail	FLR: Floor		N: North	RAD: Radius	SYS: System	W/: With
BLDG: Building	DIA: Diameter	FLOR: Fluorescent	KD: Kiln Dried	NIC: Not in Contract	REF: Reference		WD: Wood
BUR: Built Up Roofing	DIM: Dimension	FT: Foot, Feet	KIT: Kitchen	NTS: Not To Scale	RFL: Reflect(ed),(ive),(or)	TEL: Telephone	



**VICINITY MAP** SCALE: N.T.S.





ALLIS AVE. EXIST. CURB CUT TO REMAIN EXIST. CURB CUT TO REMAIN PROPERTY LINE 120.93' EXIST. CONCRETE EXIST. ASPHALT EXIST. FENCE TO REMAIN EXIST. STOOP EXISTING BUILDING 3,731 S.F. EXIST. FENCE TO REMAIN EXIST. STOOP EXIST. FENCE TO REMAIN PROPERTY LINE 138.88'

THR VE ARCH TECTS

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Tigers Children's Home

Remodel

1902 S Stoughton Rd Madison, WI

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	JAJ	JMS

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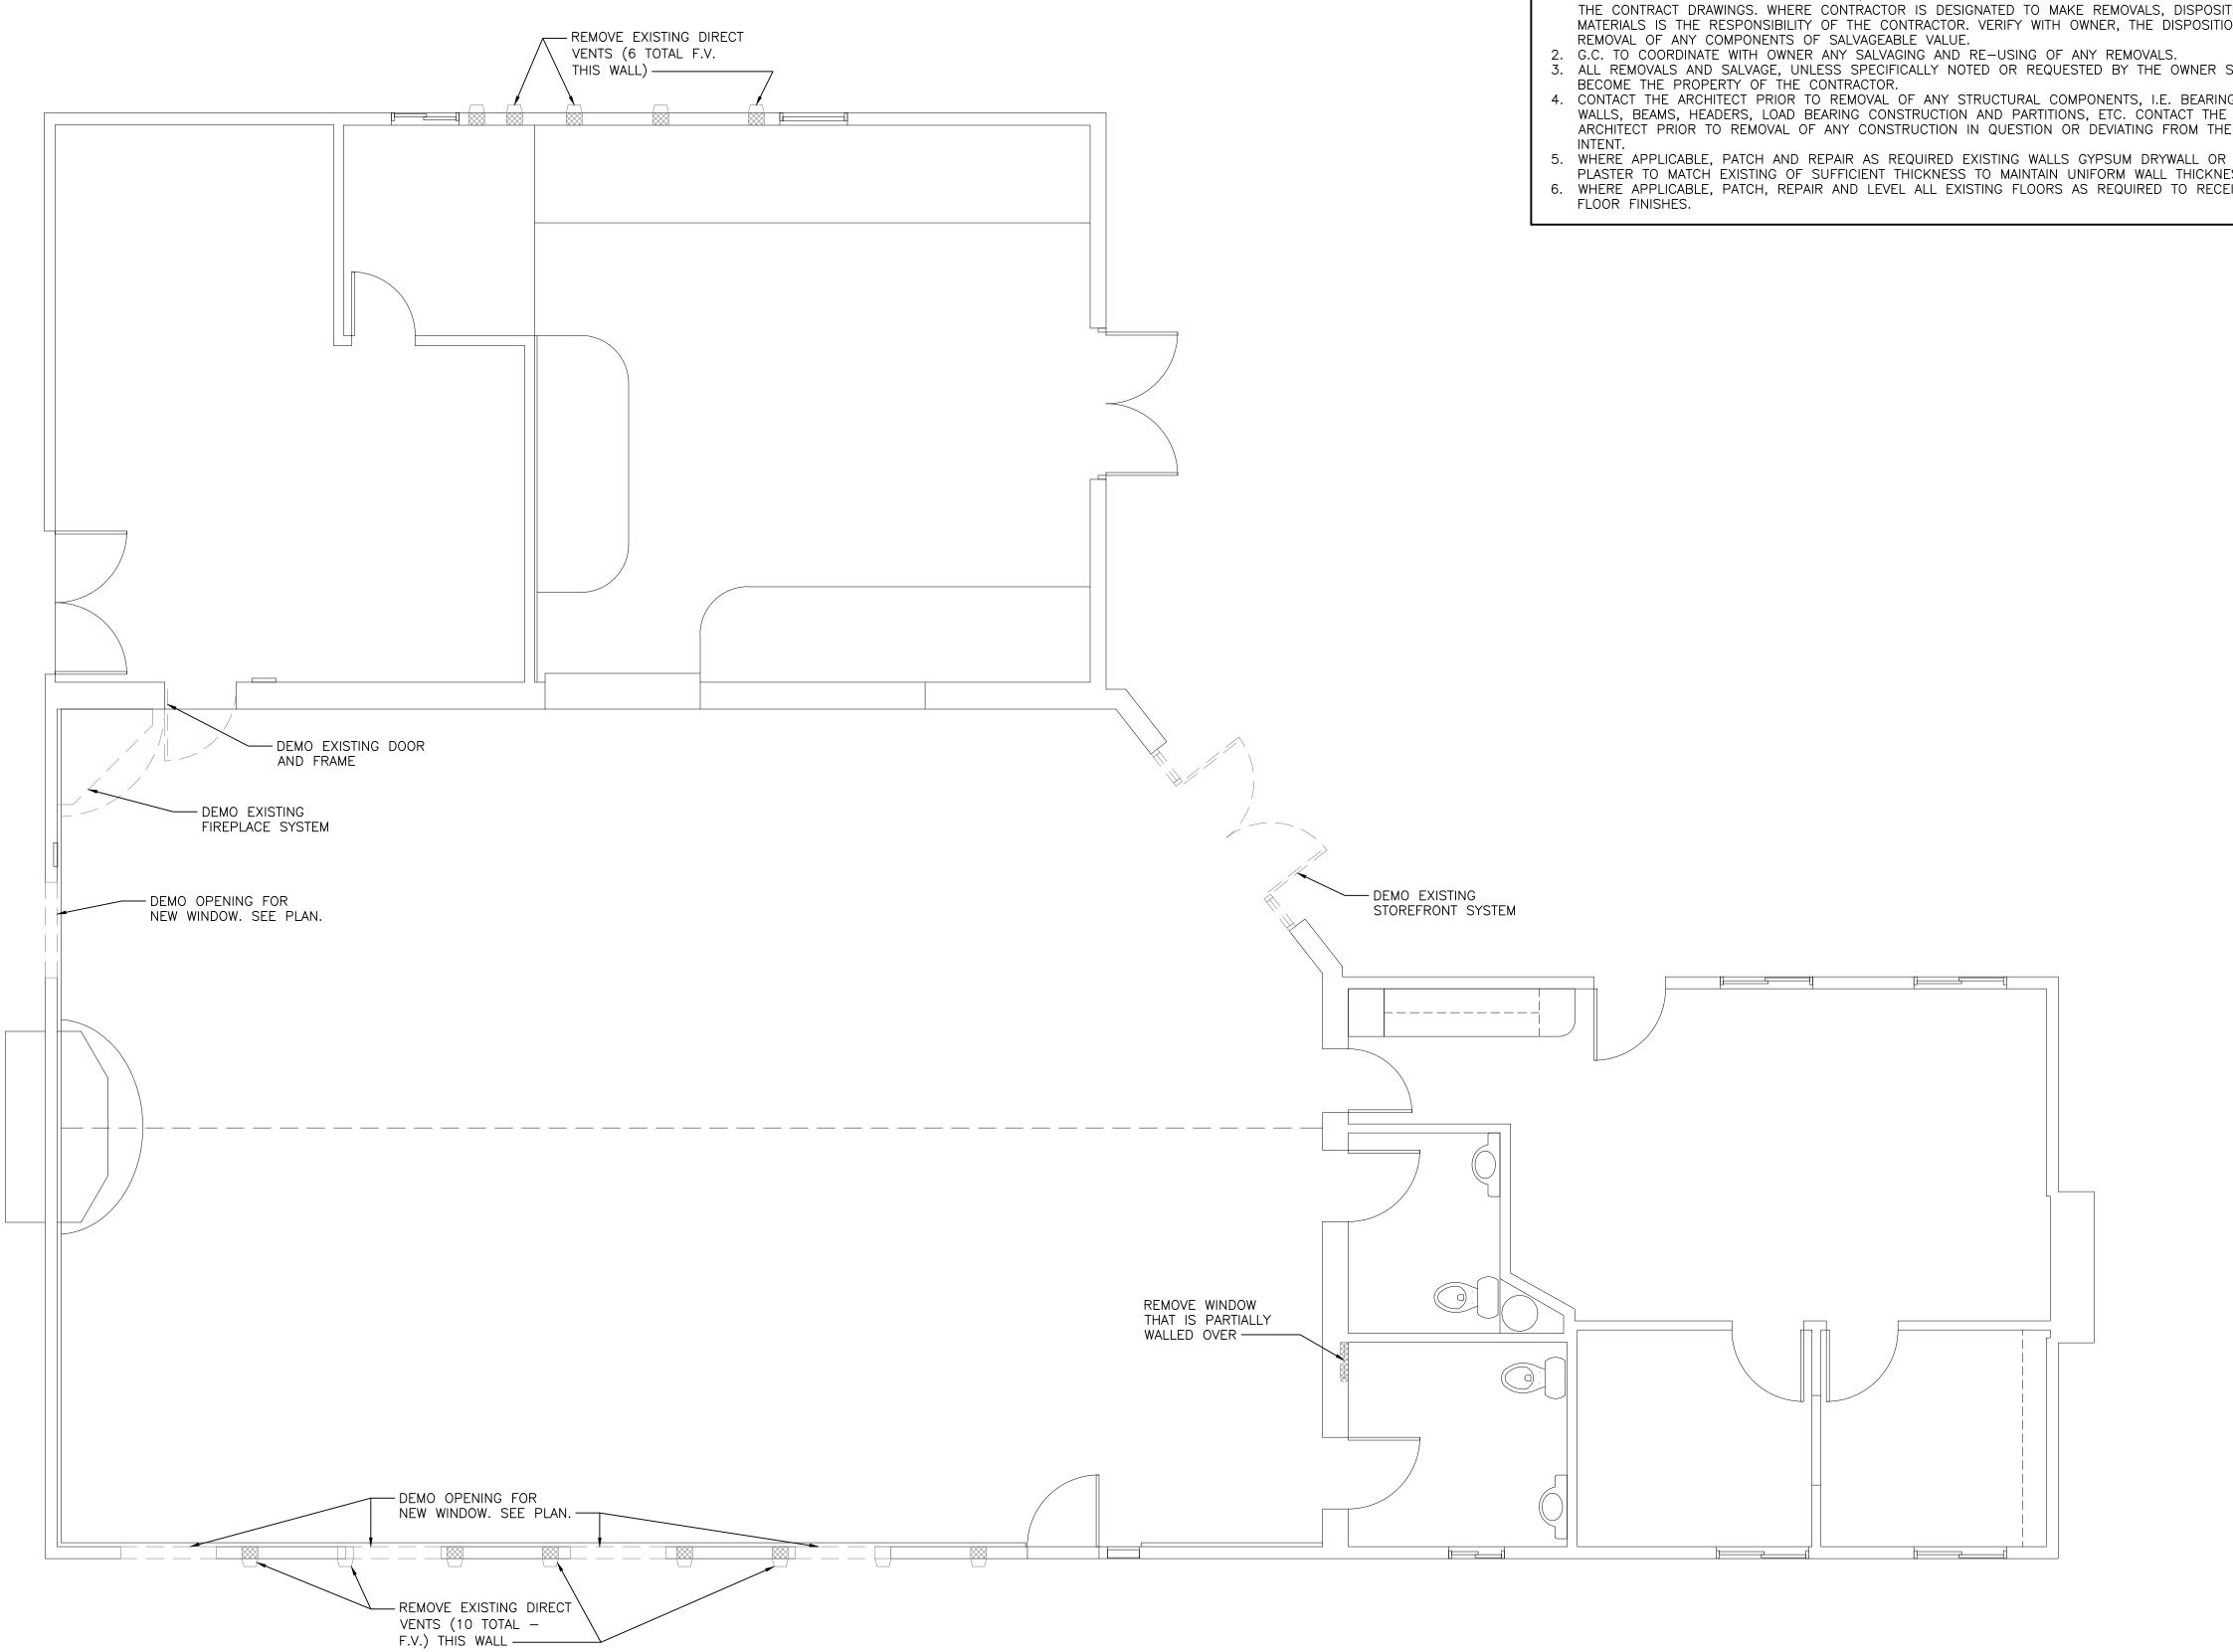
08.23.2024 Plan Commission

Sheet No. –

SP1.0

SITE PLAN

SCALE: 1"=10'-0" (22x34)





- REMOVE ALL EXISTING CONSTRUCTIONS AND FINISHES NECESSARY FOR THE COMPLETION OF THE WORK AS DEPICTED ON THE DRAWINGS. INCLUDING BUT NOT LIMITED TO, ITEMS SHOWN ON THE PLANS WITH DASHED LINES. NECESSARY DISCONNECTS AND ALTERATIONS TO EXISTING MECHANICAL, PLUMBING AND ELECTRICAL SYSTEMS SHALL BE INCLUDED AND VERIFIED WITH ARCHITECT IF NOT SPECIFIED ON DRAWINGS. PATCH AS REQUIRED ALL CONSTRUCTIONS TO REMAIN IN ACCORDANCE WITH THE CONTRACT DRAWINGS. WHERE CONTRACTOR IS DESIGNATED TO MAKE REMOVALS, DISPOSITION OF MATERIALS IS THE RESPONSIBILITY OF THE CONTRACTOR. VERIFY WITH OWNER, THE DISPOSITION AND
- 2. G.C. TO COORDINATE WITH OWNER ANY SALVAGING AND RE-USING OF ANY REMOVALS.
- 3. ALL REMOVALS AND SALVAGE, UNLESS SPECIFICALLY NOTED OR REQUESTED BY THE OWNER SHALL
- 4. CONTACT THE ARCHITECT PRIOR TO REMOVAL OF ANY STRUCTURAL COMPONENTS, I.E. BEARING WALLS, BEAMS, HEADERS, LOAD BEARING CONSTRUCTION AND PARTITIONS, ETC. CONTACT THE ARCHITECT PRIOR TO REMOVAL OF ANY CONSTRUCTION IN QUESTION OR DEVIATING FROM THE DESIGN
- PLASTER TO MATCH EXISTING OF SUFFICIENT THICKNESS TO MAINTAIN UNIFORM WALL THICKNESS.
- 6. WHERE APPLICABLE, PATCH, REPAIR AND LEVEL ALL EXISTING FLOORS AS REQUIRED TO RECEIVE NEW

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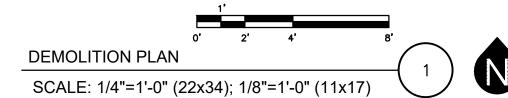
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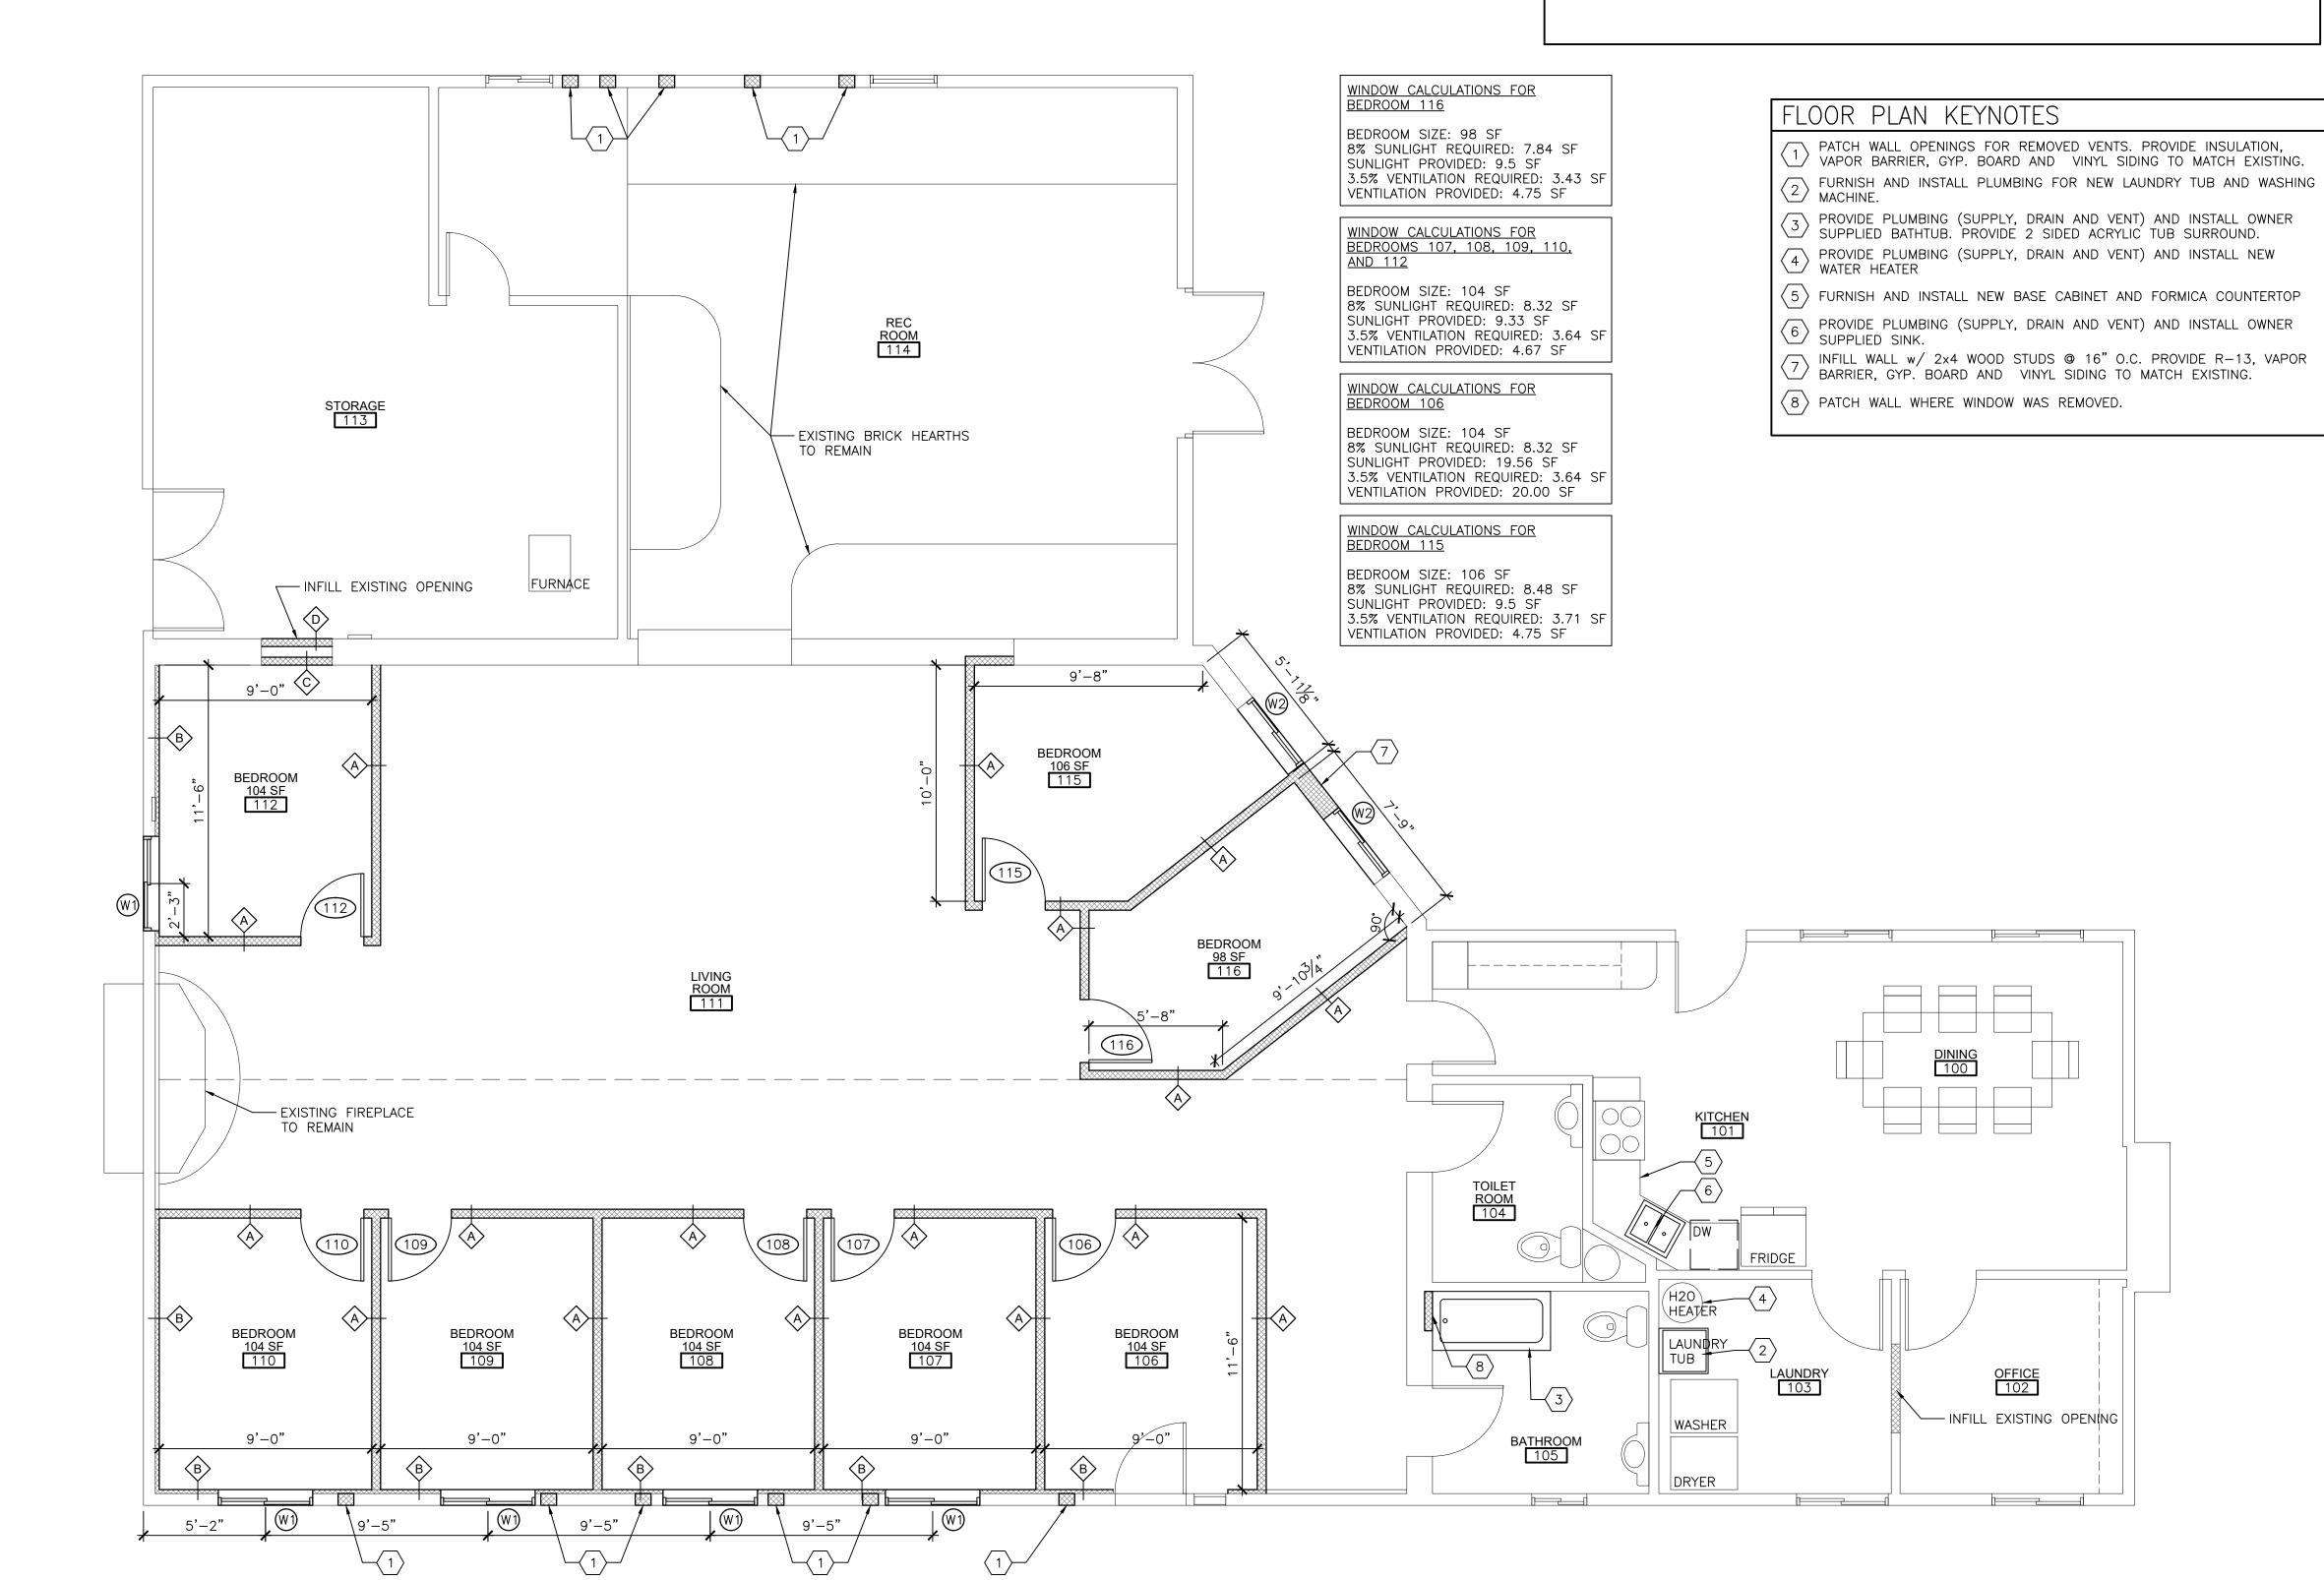
Description 08.23.2024 Plan Commission

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### GENERAL NOTES

- 1. SEE SHEET A6.0 FOR WALL TYPES. ALL WALLS ARE TYPE A UNLESS OTHERWISE NOTED.
- 2. G.C. TO COORDINATE WITH OWNER ALL ELECTRICAL OUTLET NEEDS/LOCATIONS.
- 3. G.C. TO COORDINATE WITH OWNER ALL FINISHES.
  4. PROVIDE MOISTURE RESISTANT DRYWALL AT ALL WET AREAS, INCLUDING BUT NOT LIMITED TO TOILET ROOMS, KITCHENS, AND JANITOR CLOSETS.





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Sheet Title ————

-LOOR PLAN

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08.23.2024 Plan Commission

**\_**Sheet No. **\_** 

A1.0

FLOOR PLAN

SCALE: 1/4"=1'-0" (22x34); 1/8"=1'-0" (11x17)



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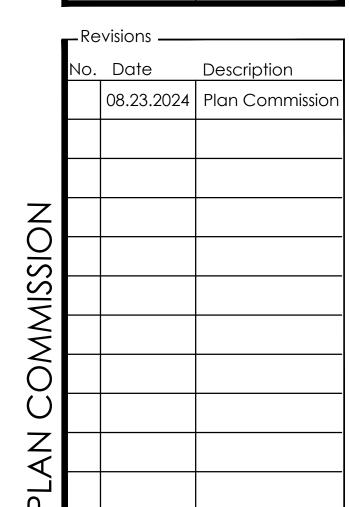
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Remodel


1902 S Stoughton Rd Madison, WI

EXTERIOR ELEVATIONS

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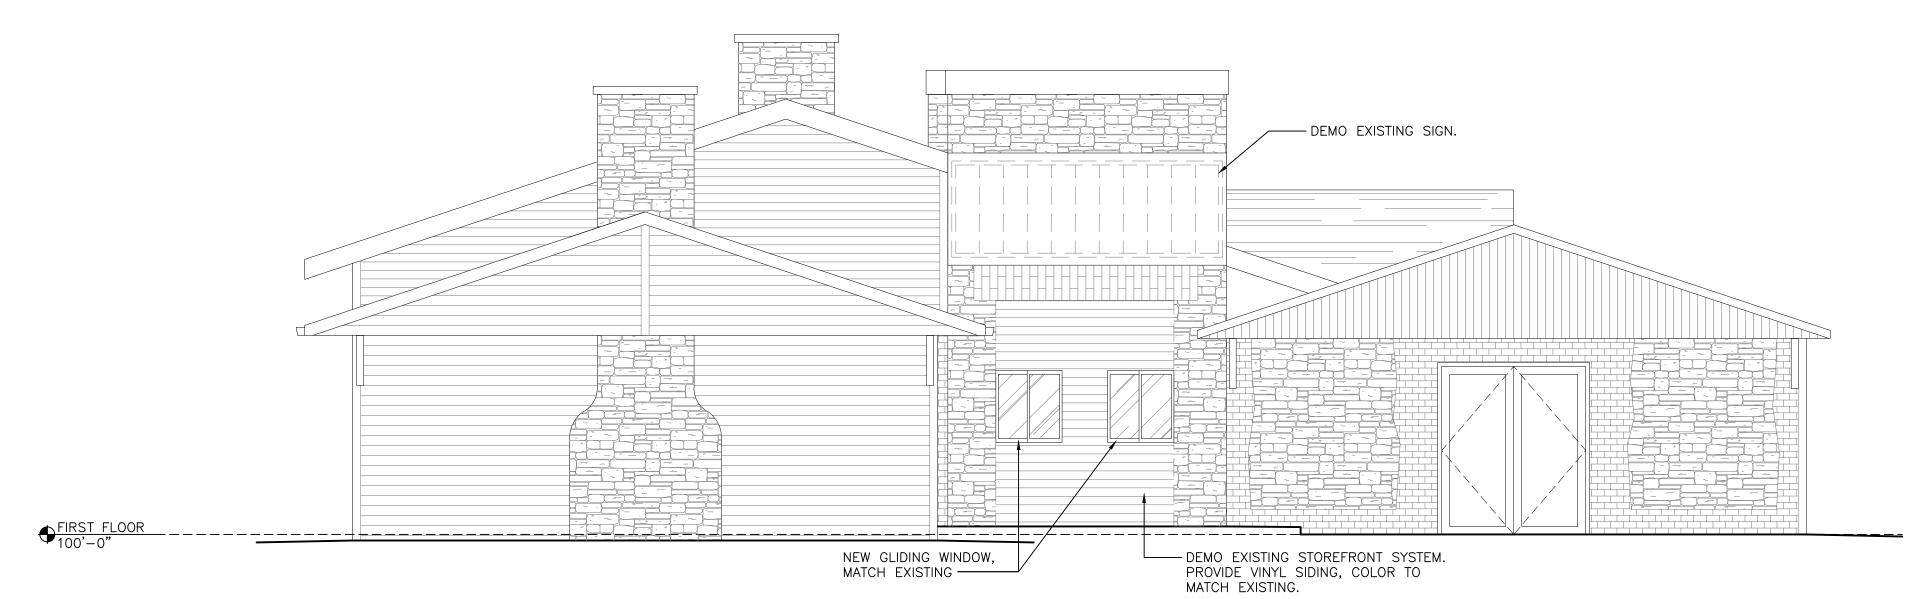


NORTH EXTERIOR ELEVATION

SCALE: 1/4"=1'-0" (22x34); 1/8"=1'-0" (11x17)

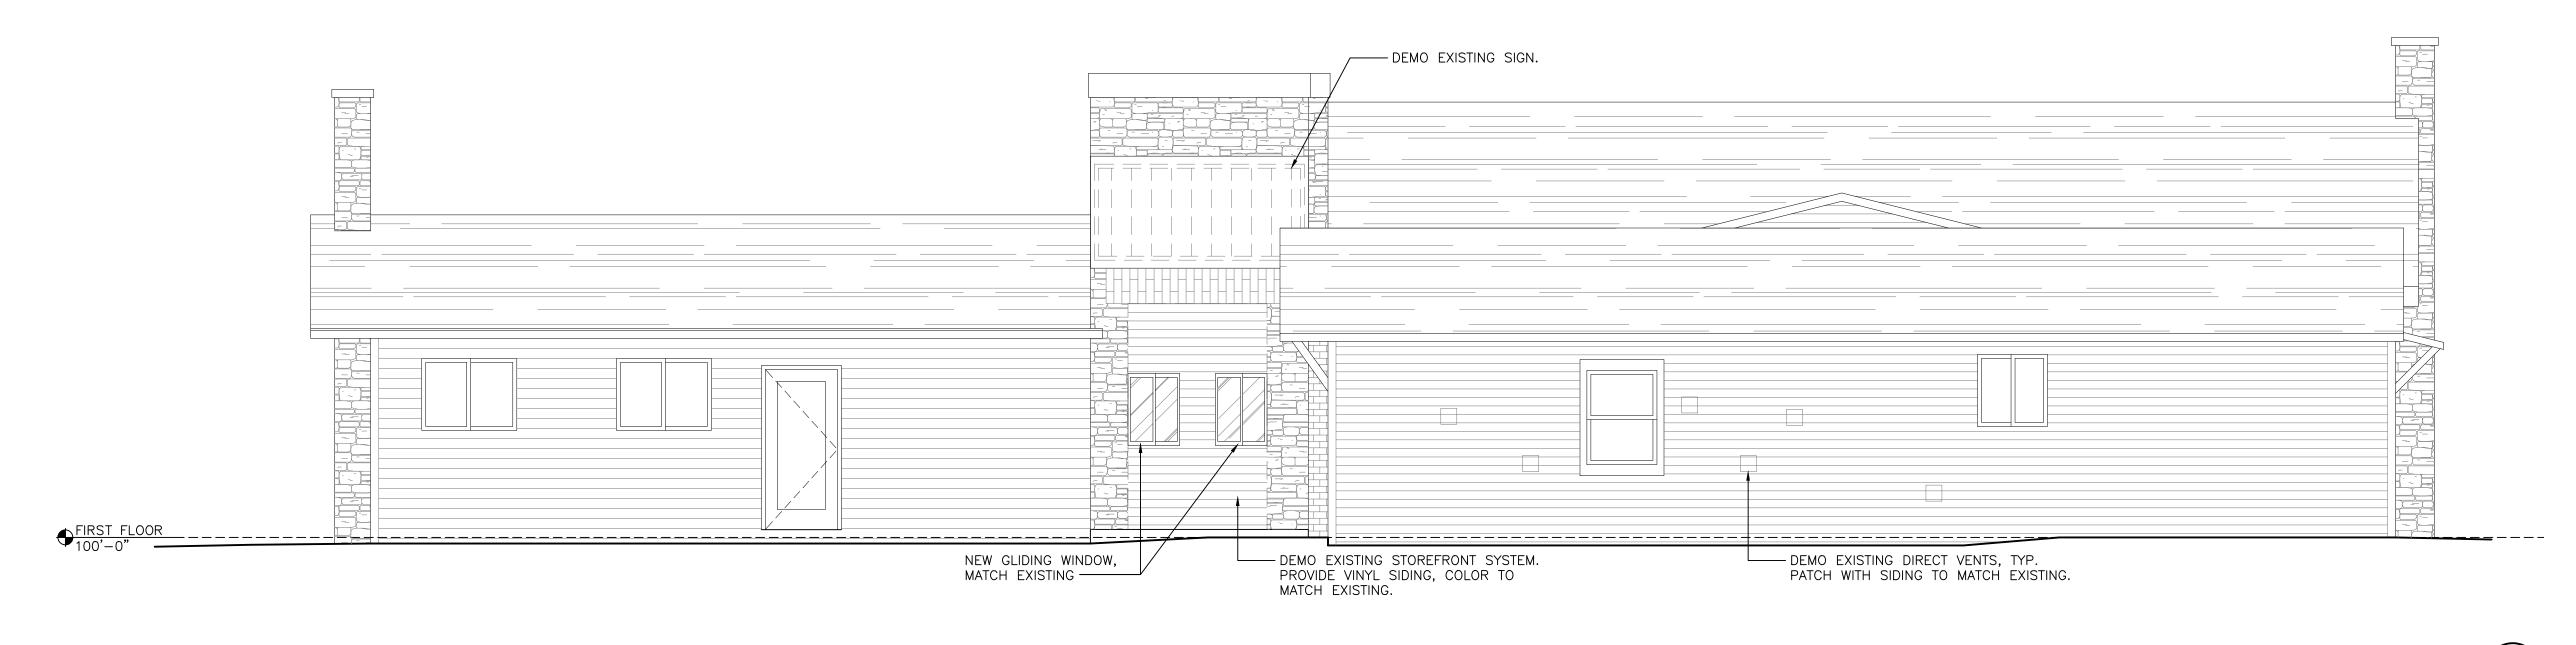EAST EXTERIOR ELEVATION

SCALE: 1/4"=1'-0" (22x34); 1/8"=1'-0" (11x17)





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EXTERIOR ELEVATIONS

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No. Date Description


08.23.2024 Plan Commission

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WEST EXTERIOR ELEVATION

SCALE: 1/4"=1'-0" (22x34); 1/8"=1'-0" (11x17)

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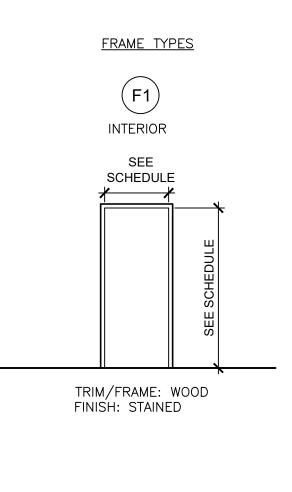


SOUTH EXTERIOR ELEVATION

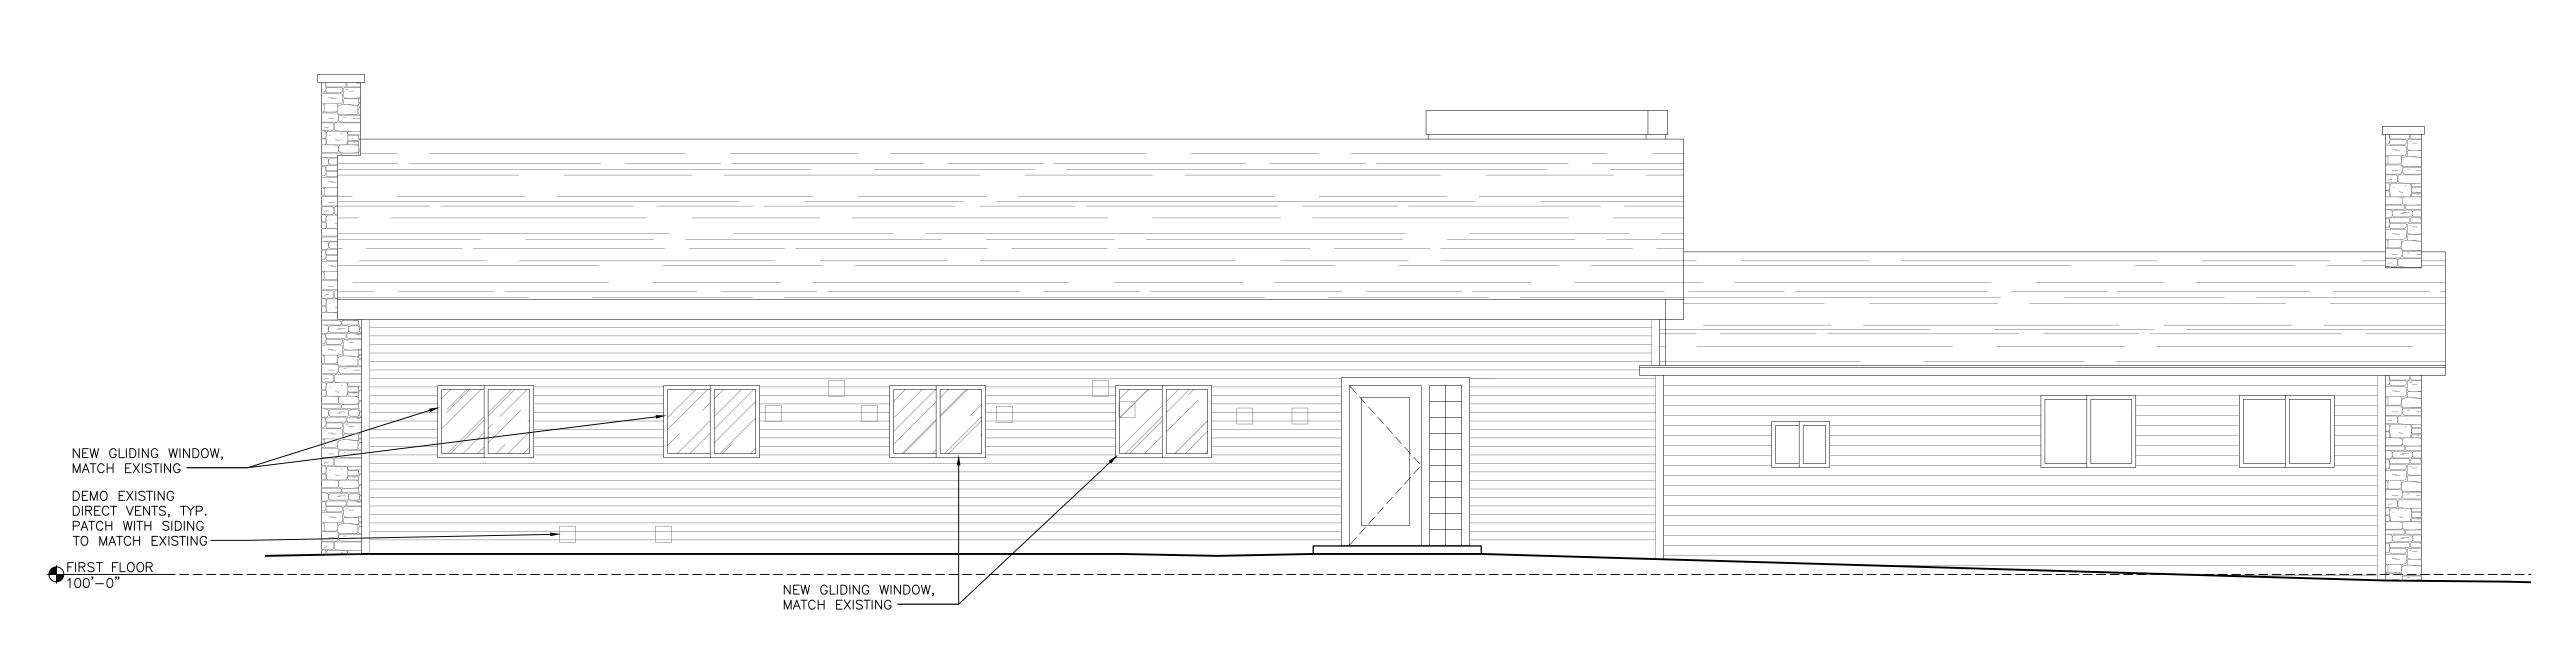SCALE: 1/4"=1'-0" (22x34); 1/8"=1'-0" (11x17)

NEW GLIDING WINDOW, MATCH EXISTING ————


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DOOR TYPES




INTERIOR





MATERIAL: STAIN GRADE WOOD PANEL: FLUSH, HOLLOW CORE FINISH: STAIN GLAZING: NONE HARDWARE: SEE DOOR SCHEDULE NOTES

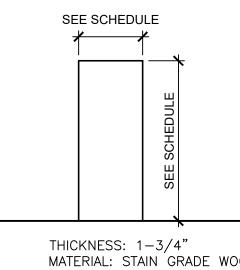	DOOR SCHEDULE							
DOOR NUMBER	ROOM NAME	OF PANELS		ZE L	DOOR TYPE	FRAME TYPE	FIRE RATING	RKS
DOOF	ROOM	NO. O	WIDTH	HEIGHT	РООР	FRAM	FIRE	REMARKS
106	BEDROOM	1	2'-8"	6'-8"	D1	F1		
107	BEDROOM	1	2'-8"	6'-8"	D1	F1		
108	BEDROOM	1	2'-8"	6'-8"	D1	F1		
109	BEDROOM	1	2'-8"	6'-8"	D1	F1		
110	BEDROOM	1	2'-8"	6'-8"	D1	F1		
112	BEDROOM	1	2'-8"	6'-8"	D1	F1		
115	BEDROOM	1	2'-8"	6'-8"	D1	F1		
116	BEDROOM	1	2'-8"	6'-8"	D1	F1		

- DOOR HARDWARE IS NOT SPECIFIED; HARDWARE COORDINATION MEETING WITH OWNER, DOOR SUPPLIER AND G.C. IS REQUIRED. G.C. TO SUPPLY ALL DOOR HARDWARE REQUIRED BY CODE.
- DOOR HARDWARE SHALL COMPLY WITH ICC/ANSI A117.1 SEC 404.2.6 HANDLES, PULLS, LATCHES, LOCKS, AND OTHER OPERABLE PARTS ON ACCESSIBLE DOORS SHALL HAVE A SHAPE THAT IS EASY TO GRASP WITH ONE HAND AND DOES NOT REQUIRE TIGHT GRASPING, PINCHING OR TWISTING OF THE WRIST. THE HARDWARE SHALL BE PLACED AT LEAST 34 INCHES, BUT NOT MORE THAN 48 INCHES ABOVE THE FLOOR SURFACE.

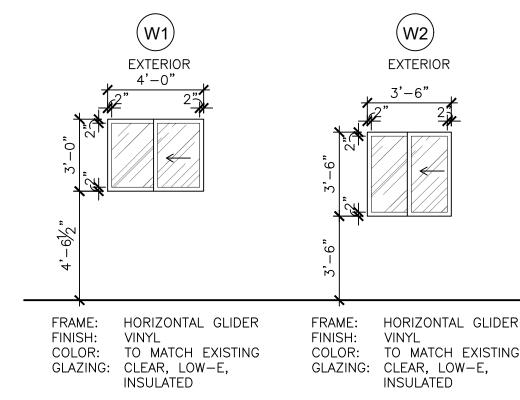


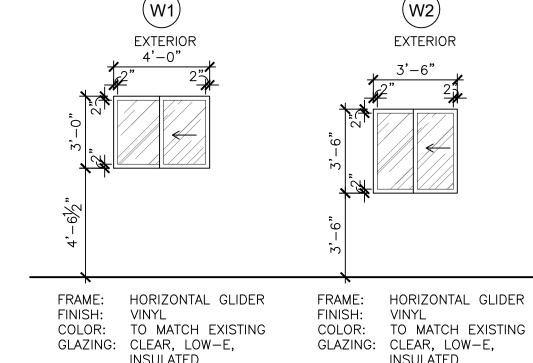

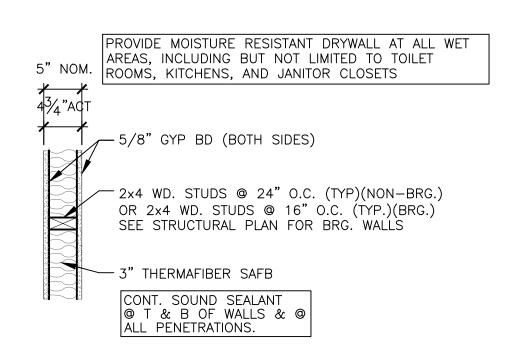


EXTEND WALLS TO STRUCTURE ABOVE

WALL TYPE A SCALE: N.T.S.

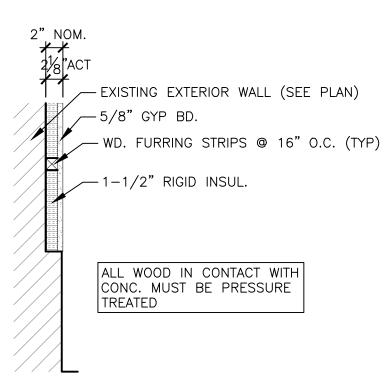


EXTEND WALLS TO CEILING ABOVE

WALL TYPE B SCALE: N.T.S.

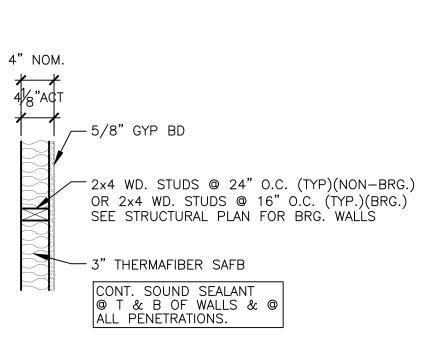

WALL TYPE C

SCALE: N.T.S.

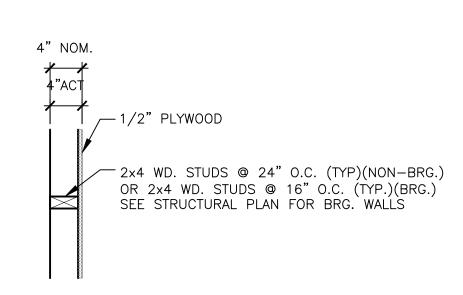

WALL TYPE D SCALE: N.T.S.



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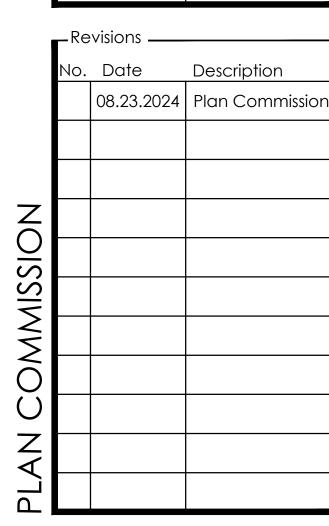
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2024-08-

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