# **URBAN DESIGN COMMISSION APPLICATION**



City of Madison Planning Division Madison Municipal Building, Suite 017 215 Martin Luther King, Jr. Blvd. P.O. Box 2985 Madison, WI 53701-2985 (608) 266-4635



FOR OFFICE USE ONLY:	
Date Received	☐ Initial Submittal
Paid	■ Revised Submittal

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	desi proje subr	red meeting date ect requires bot mittals, a comp	e and the th UDC <u>ar</u> lleted <u>Lan</u>	action nd Lan	tion, including the requested. If your and Use application and re also required to	access the Si necesite acceder a Yog tias ntaub nt	d an interpreter, translator, materials in alternate formats or other accommodations to se forms, please call the Planning Division at (608) 266-4635.  a interprete, traductor, materiales en diferentes formatos, u otro tipo de ayuda para estos formularios, por favor llame al (608) 266-4635.  koj xav tau ib tug neeg txhais lus, tus neeg txhais ntawv, los sis xav tau cov awv ua lwm hom ntawv los sis lwm cov kev pab kom paub txog cov lus qhia hu rau Koog Npaj (Planning Division) (608) 266-4635.
1.	Proj	ect Information	n				
	Add	ress (list all addr	esses on th	he proj	ect site): Madison Yards E	Block 4 47	716 Sheboygan Ave Madison WI, 53715
		: Madison Yards			, <u></u>		
2.	App	<b>lication Type</b> (d	check all t		oply) and Requested D	ate	
	UDC	meeting date re	equested	Augu	ust 14, 2024		
		New developm	ent			or previ	ously-approved development
		Informational			Initial Approval	V	Final Approval
3.	Proj	ect Type					
	V	Project in an Url	ban Design	n Distri	ct	Sigr	nage
					strict (DC), Urban		Comprehensive Design Review (CDR)
					d-Use Center District (MXC) nent Center District (SEC)		Modifications of Height, Area, and Setback
		Campus Instituti			, or Employment Campus		Sign Exceptions as noted in <u>Sec. 31.043(3)</u> , MGO
	<b>F</b>	District (EC)	(DD			Oth	ner
	V	Planned Develop  General De		-	(GDP)		Please specify
		Specific Im	-				
		Planned Multi-U	Jse Site or	Reside	ential Building Complex		
_	_						
4.			-	-	wner Information		
		licant name	David Em			_	mpany Madison Yards Lodging Associates, LLC
		et address			, Suite 400		//State/Zip Madison, WI 53705
	Tele	phone	608-833-4	4100		_ Em	ail emerich@raymondteam.com
	Proj	ect contact pers	son Ethar	n Skeels	s, AIA	_ Cor	mpany Kahler Slater
	Stre	et address	790 N. Wa	ater St,	Suite 1700		//State/Zip Milwaukee, WI 53202
	Tele	phone	414-290-3	3778		_ Em	ail eskeels@kahlerslater.com
	Pro	perty owner (if	not applic	ant) _	Madison Yards Block 6, LLC		
	Stre	et address	241 N. Bro	oadway	,, Suite 400	_ City	//State/Zip Milwaukee, WI 53202
	Tele	phone	414-453-0	0110		_ Em	ail mtheder@summitsmith.com

# **URBAN DESIGN COMMISSION APPROVAL PROCESS**



#### Introduction

The City of Madison's Urban Design Commission (UDC) has been created to:

- Encourage and promote high quality in the design of new buildings, developments, remodeling, and additions so as to maintain and improve the established standards of property values within the City.
- Foster civic pride in the beauty and nobler assets of the City, and in all other ways possible assure a functionally efficient
  and visually attractive City in the future.

# **Types of Approvals**

There are three types of requests considered by the UDC:

- Informational Presentation. A request for an Informational Presentation to the UDC may be requested prior to seeking any
  approvals to obtain early feedback and direction before undertaking detailed design efforts. Applicants should provide
  details on the context of the site, design concept, site and building plans, and other relevant information to help the UDC
  understand the proposal and provide feedback. (Does not apply to CDR's or Signage Modification requests)
- <u>Initial Approval</u>. Applicants may, at their discretion, request Initial Approval of a proposal by presenting preliminary design information. As part of their review, the Commission will provide feedback on the design information that should be addressed at Final Approval stage.
- <u>Final Approval</u>. Applicants may request Final Approval of a proposal by presenting all final project details. Recommendations or concerns expressed by the UDC in the Initial Approval must be addressed at this time.

#### **Presentations to the Commission**

The Urban Design Commission meets virtually via Zoom, typically on the second and fourth Wednesdays of each month at 4:30 p.m. Applicant presentations are strongly encouraged, although not required. Prior to the meeting, each individual speaker is required to complete an online registration form to speak at the meeting. A link to complete the online registration will be provided by staff prior to the meeting. Please note that individual presentations will be limited to a **maximum of three (3) minutes**. The pooling of time may be utilized to provide one speaker more time to present, however the additional time will be based on the number of registrants from the applicant team, i.e. two (2) applicant registrants = six (6) minutes for one (1) speaker.

Primarily, the UDC is interested in the appearance and design quality of projects. Emphasis should be given to the site plan, landscape plan, lighting plan, building elevations, exterior building materials, color scheme, and graphics. Please note that presentation slides, in a PDF file format, are required to be submitted **the Friday before** the UDC meeting.

# **URBAN DESIGN DEVELOPMENT PLANS CHECKLIST**



The items listed below are minimum application requirements for the type of approval indicated. Please note that the UDC and/or staff may require additional information in order to have a complete understanding of the project.

1. Informa	itional Presentation						
	Locator Map	١		Requ	uirements	for	All Plan Sheets
	Letter of Intent (If the project is within			1.	Title bloc	k	
	an Urban Design District, a summary of how the development proposal addresses			2.	Sheet nu	mb	er
	the district criteria is required)		Providing additional	3.	North arı	ow	1
	Contextual site information, including	Ţ	information beyond these minimums may generate			th١	written and graphic
	photographs and layout of adjacent		a greater level of feedback		Date		
	buildings/structures Site Plan		from the Commission.	6.	Fully dim at 1"= 40		sioned plans, scaled r larger
_	Two-dimensional (2D) images of						be legible, including
_	proposed buildings or structures.				full-sized   l s (if require		dscape and lighting
2. Initial A <sub>l</sub>	pproval						
	Locator Map				)	1	
	Letter of Intent (If the project is within a Undevelopment proposal addresses the district			y of ]	how the		Providing additional
	Contextual site information, including photograp	ohs	and layout of adjacent buildin	gs/stru	uctures		information
	Site Plan showing location of existing and p bike parking, and existing trees over 18" diar			es, bik	ke lanes,		beyond these minimums may
	Landscape Plan and Plant List (must be legibl	'e)					generate a greater level of
	Building Elevations in <u>both</u> black & white and and color callouts	col	or for all building sides, inclu	ıding	material		feedback from the Commission.
	PD text and Letter of Intent (if applicable)						
3. Final Ap	proval						
-	· equirements of the Initial Approval (see above	), p	lus:				
	Grading Plan						
	Lighting Plan, including fixture cut sheets and	d ph	notometrics plan (must be le	gible)	)		
	Utility/HVAC equipment location and screeni	ng	details (with a rooftop plan	f roof	- mounted	)	
	Site Plan showing site amenities, fencing, tras	sh,	bike parking, etc. (if applica	ole)			
	PD text and Letter of Intent (if applicable)						
	Samples of the exterior building materials						
	Proposed sign areas and types (if applicable)						
4. Signage	Approval (Comprehensive Design Review (CL	OR),	Sign Modifications, and Sig	ın Exc	eptions (p	er 🖢	Sec. 31.043(3))
	Locator Map						
	Letter of Intent (a summary of <u>how</u> the proposed s	sign	age is consistent with the CDR c	r Signa	age Modific	atic	ons criteria is required)
	Contextual site information, including photo project site	ogra	phs of existing signage bot	h on	site and v	vith	nin proximity to the
	Site Plan showing the location of existing sign driveways, and right-of-ways	nag	e and proposed signage, din	nensic	ned signa	ge :	setbacks, sidewalks,
	Proposed signage graphics (fully dimensioned	d, s	caled drawings, including m	ateria	ls and cold	ors,	and night view)
	Perspective renderings (emphasis on pedestr	ian	/automobile scale viewshed	s)			
	Illustration of the proposed signage that mee	ets (	<u>Ch. 31, MGO</u> compared to w	hat is	being req	ues	sted
	Graphic of the proposed signage as it relates	to	what the <u>Ch. 31, MGO</u> woul	d peri	mit		

# 5. Required Submittal Materials

# ✓ Application Form

 A completed application form is required for <u>each</u> UDC appearance. For projects also requiring Plan Commission approval, applicants must also have submitted an accepted application for Plan Commission consideration prior to obtaining any formal action (Initial or Final Approval) from the UDC.

#### ☑ Letter of Intent

- If the project is within an Urban Design District, a summary of how the development proposal addresses the district criteria is required.
- For signage applications, a summary of how the proposed signage is consistent with the applicable Comprehensive Design Review (CDR) or Signage Modification review criteria is required.
- Development Plans (Refer to checklist on Page 4 for plan details)
- Filing Fee (Refer to Section 7 (below) for a list of application fees by request type)

## **☑** Electronic Submittal

- Complete electronic submittals <u>must</u> be received prior to the application deadline before an application will be scheduled
  for a UDC meeting. Late materials will not be accepted. All plans must be legible and scalable when reduced. Individual
  PDF files of each item submitted should be submitted via email to <u>UDCapplications@cityofmadison.com</u>. The email
  must include the project address, project name, and applicant name.
- Email Size Limits. Note that an individual email cannot exceed 20MB and it is the responsibility of the applicant to present files
  in a manner that can be accepted. Applicants who are unable to provide the materials electronically should contact the Planning
  Division at (608) 266-4635 for assistance.

# Notification to the District Alder

Please provide an email to the District Alder notifying them that you are filing this UDC application. Please send this as
early in the process as possible and provide a copy of that email with the submitted application.

### 6. Applicant Declarations

1.	Prior to submitting this application, the This application was discussed with Je	applicant is required to discuss the proposed project wi sica Vaughn	ith Urban Design Commission staff. on Various dates April-July 2024
2.	The applicant attests that all required r is not provided by the application deconsideration.	naterials are included in this submittal and understan idline, the application will not be placed on an Urba	ds that if any required information an Design Commission agenda for
Nam	e of applicant David Emerich	Relationship to propert	ty Under Contract
Auth	orizing signature of property owner	M Dones Emer Pictt 1	Date

# 7. Application Filing Fees

Fee payments are due by the submittal date. Payments received after the submittal deadline may result in the submittal being scheduled for the next application review cycle. Fees may be paid in-person, via US Mail, or City drop box. If mailed, please mail to: City of Madison Building Inspection, P.O. Box 2984, Madison, WI 53701-2984. The City's drop box is located outside the Municipal Building at 215 Martin Luther King, Jr. Blvd. on the E Doty Street side of the building. Please make checks payable to City Treasurer, and include a completed application form or cover letter indicating the project location and applicant information with all checks mailed or submitted via the City's drop box.

Please consult the schedule below for the appropriate fee for your request:

	Urban Design Districts: \$350 (per §33.24(6) MGO).
	Minor Alteration in the Downtown Core District (DC) or Urban Mixed-Use District (UMX): \$150 (per §33.24(6)(b) MGO)
	Comprehensive Design Review: \$500 (per §31.041(3)(d)(1)(a) MGO)
	Minor Alteration to a Comprehensive Sign Plan: \$100 (per §31.041(3)(d)(1)(c) MGO)
П	All other sign requests to the Urban Design Commis.

- □ All other sign requests to the Urban Design Commission, including, but not limited to: appeals from the decisions of the Zoning Administrator, requests for Sign Modifications (of height, area, and setback), and additional sign code approvals: \$300 (per §31.041(3)(d)(2) MGO)
- A filing fee is not required for the following project applications if part of the combined application process involving both Urban Design Commission and Plan Commission:
- Project in the Downtown Core District (DC), Urban Mixed-Use
   District (UMX), or Mixed-Use Center District (MXC)
- Project in the Suburban Employment Center District (SEC), Campus Institutional District (CI), or Employment Campus District (EC)
- Planned Development (PD): General Development Plan (GDP) and/or Specific Implementation Plan (SIP)
- Planned Multi-Use Site or Residential Building Complex

# MADISON YARDS BLOCK 6, LLC

July 9, 2024

City of Madison Planning Division 215 Martin Luther King, Jr. Blvd, Suite 017 Madison, WI 53701

RE: Madison Yards at Hill Farms, Block 4 PD-SIP Submittal Approval

Dear City of Madison Planning Division:

This letter provides approval (on behalf of Madison Yards Block 6, LLC) for Madison Yards Lodging Associates, LLC c/o Raymond Management Company, Inc. to submit applications to the City of Madison for zoning changes and otherwise for the Madison Yards at Hill Farms, Block 4 PD-SIP project. The project site is located at 4716 Sheboygan Avenue, Lot 4, Madison Yards at Hill Farms. Previous applications for this project were submitted by HKS Holdings, LLC (and/or MKE Acquisitions, LLC). Madison Yards Lodging Associates, LLC will act as developer of the parcel moving forward.

Please feel free to contact either of the individuals signing this letter below with any questions.

Sincerely,

Mark Theder

**Authorized Representative** 

Madison Yards Block 6, LLC c/o Summit Smith Development 731 N. Jackson St, Suite 505

Milwaukee, WI 53202 Office: 414.453.0110 Cell: 414.379.0761

E-Mail: mtheder@summitsmith.com Website: www.summitsmith.com

31305485.2

Joe Klein, Manager MKE Acquisitions, LLC 172 N. Broadway Second Floor Milwaukee, WI 53202 kleinjos@gmail.com

# Lisa Steinhauer

**From:** Lisa Steinhauer

**Sent:** Thursday, July 11, 2024 11:25 AM district11@cityofmadison.com

**Cc:** Dave Emerich

**Subject:** Madison Yards Hotel

**Attachments:** 24-0710\_MY BLK 4 - Update.pdf

#### Hi Alder Tishler,

Thank you for your time on the phone this morning. As mentioned, we hope to receive final SIP approval for our hotel development from the UDC at the upcoming August 14, 2024 meeting. Attached are the DRAFT plans for review at the meeting. We are still making a few tweaks prior to submittal, including showing an electric charging stall in the employee parking lot, as discussed.

This hotel includes 145 keys within 5 stories. The design is similar to previous versions you've seen but is revised to address prior UDC comments.

I look forward to meeting with you on Monday 7/15 at 2:30pm. If you enter the SpringHill Suites parking structure using the eastern entrance (at the bottom of Frey St hill), there are parking spaces available at the entrance to the hotel lobby. I will meet you in the lobby along with my colleague, Dave Emerich, for a tour.

Thank you,

#### **Lisa Steinhauer**

Real Estate Coordinator Raymond Management Company | 4601 Frey St. Suite 400 Madison, WI 53705 Direct: (608) 692-8353



#### https://www.raymondteam.com

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# Kahler Slater

Milwaukee Madison Richmond Chicago Singapore

July 15, 2024

City of Madison Planning Division 215 Martin Luther King, Jr. Blvd, Suite 017 Madison, WI 53701 790 N Water Street, Suite 1700 Milwaukee, WI 53202 P 414,272,2000

RE: Letter of Intent - Madison Yards at Hill Farms, Block 4 PD-SIP Land Use - UDC Final

This letter, together with plans, application and supplemental materials, constitutes our Land Use Application for Major Amendment to an Approved Planned Development – Specific Implementation Plan (PD-SIP) for the proposed Madison Yards at Hill Farms, Block 4 project.

Project Location:

The project site is located at 4716 Sheboygan Ave., Lot 4 Madison Yards at Hill Farms. The site is 1.08 acres.

Legal Description:

Lot 4, Madison Yards at Hill Farms, recorded in Volume 61-018B of Plats on page 99, as Document No. 5524360, located in the Northeast Quarter of the Northwest Quarter of Section 20, Township 07 North, Range 09 East, City of Madison, Dane County, Wisconsin, more particularly described as follows:

Beginning at the Southeast Comer of Lot 4, aforesaid; thence South 82 degrees 57 minutes 14 seconds West along the South line of Lot 4, aforesaid, a distance of 211.50 feet; thence North 84 degrees 03 minutes 12 seconds West along the South line of Lot 4, aforesaid, 30.71 feet to the West line of Lot 4, aforesaid; thence North 03 degrees 25 minutes 28 seconds West along said line, 196.36 feet to the North line of Lot 4, aforesaid; thence North 86 degrees 34 minutes 32 seconds East along said line, 241.38 feet to the East line of Lot 4, aforesaid; thence South 03 degrees 25 minutes 28 seconds East along said line, 188.00 feet to the Point of Beginning.

Said lot contains 47,117 square feet or 1.082 acres.

Project Team:

Owner/Developer: Madison Yards Lodging Associates, LLC.

Master Planner/Civil Engineer/Landscape Architect: JSD Professional Services, Inc.

Architect: Kahler Slater, Inc.

#### **Project Description**

The project is a portion of the larger multi-block development known as Madison Yards at Hill Farms. Block 4 is situated along the north side Sheboygan Ave. west of Segoe Rd. In Madison, Wl. The project consists of a 145 guestroom Hotel and associate guest amenities.

The hotel building of +/- 102,250 GSF The building occupies the northeast portion of the block with its primary entrance on Hill Farms Pl. A second public entry is located to the south on Sheboygan Ave. the majority of parking is provided on the adjacent Block 1 in the parking structure to the east and is accessed by an internal access drive from Segoe or Gardener. Employee parking is located on a surface parking lot located on the southwest portion of the block and is screened from the right of way. The loading and refuse areas are located to the south and west of the building access from the internal access drive. The primary façade materials for the Hotel are comprised of painted aluminum framed glazing systems with insulated glass, masonry, profiled painted single skin metal panels and painted fiber cement panels.

**Existing Land Use** 

Former Wisconsin DOT Office Building Parking - Vacant

Zoning Request

The Madison Yards Planned Development General Development Plan (GDP) was approved and recorded in April 2019. The development team is seeking approval of the Madison Yards at Hill Farms Block 4 Specific Implementation Plan (SIP)

# Zoning/ Project Data:

Block 4 is part of the Planned Development District – General Development Plan, Madison Yards at Hill Farms Redevelopment, 4802 Sheboygan Ave.

Block 4	Allowable/ required	Proposed
Site Area	1.08 Ac	1.08 Ac
Min/Max Bldg Area	30,000/160,000 GSF	102,250
Office	Max 0 GSF	0 GSF
Retail	Max 15,000 GSF	0 GSF
Hotel	225 Rooms	145 Rooms
Building Stories (min/max)	2 / 8 Stories	5 Stories
Building Height (min/max)	20 / 95 ft	64 ft
Setbacks		
Sheboygan	Min 8'	Min 9'6"
	Max 30'	Max 18'6"
Gardener	Min 5'	Min 5'4"
	Max 15'	Max 12'0"
Hill Farms Place	Min 5'	Min 5'4"
••••	Max15'	Max 8'0"
Iron Street	Max 15'	1'4" - 9'6"

Parking for hotel spaces is a minimum of .75 space per unit and a maximum of 1.5 spaces per unit. Additional parking above the maximum may be shared with another use.

The proposed Block 4 development will be provided with a minimum of 96 stalls in the parking structure located on the adjacent block 1 parking structure through a shared parking agreement. 12 surface stalls will be provided for employee parking only.

Loading and trash areas will be provided central to the block screened from Sheboygan Ave and accessed from the Iron Street, A single 10x50' loading bay will be provided.

# Streets, Easements, Utilities and Fire Access.

Streets within the Madison Yards development are privately held and maintained. Utility easements are in place for existing utility lines and future easements will be finalized and recorded once final plans are approved. Public access easements are in place as required in the final GDP approval.

Fire access for the site was discussed with Bill Sullivan of the Madison Fire Department, including fire lanes, aerial apparatus lanes, and street tree spacing. The approved GDP included a fire access plan for the project.

#### TOD Overlay.

The building is designed with a dual entry configuration with public entries on both Sheboygan Avenue and Hill Farms Place. These entries are connected continuously with guest amenity and lobby space including the guest courtyard amenity. The building façade and courtyard accent screen wall along Sheboygan Ave are located completely within the TOD required 20' maximum setback and comprise 50% of the Sheboygan street frontage compared to the TOD minimum of 30%. Surface parking is located to

the side of the Sheboygan façade activated by the public entry and screened with a significant landscape buffer.

# Urban District Design Standards.

The majority of parking serving the hotel is located in the adjacent Block 1 parking structure within the Madison Yards development. This parking is supplemented by a small employee only surface lot located along Iron Street to the west. The surface lot is setback 14'-18' feet from the property line and located behind significant landscape screening used to create an attractive corner and pedestrian experience.

A primary building entry is located prominently along Sheboygan Ave with another located along Hill Farms Place. The Sheboygan Ave Entry features a canopy, wood toned accent material and glazing clearly identifying it as a public entry to the Hotel.

The building massing creates significant setback depth and modulation between materials through the strategic planning of the differing guestroom types with in the body of the building. Special attention is paid to the corners of the building to create a strong street presence and layering of materials as the building turns the corners. Material changes also are set off by varying parapet heights further delineating the articulation visually.

The building features a 14' first floor height measured from Hill Farms Place to the finished floor of the second level. Guestrooms front Gardner feature significant vegetation between the guestroom windows and the sidewalk. The building's exterior material palette consists of brick, filled and polished burnished masonry, textured metal panel, fiber cement panel and wood toned accents. All materials are of high quality and locations are consistent with table 28E-1 of the Madison Zoning code.

## Urban Design District 6 Standards.

The public Right-of-way along Sheboygan Ave will feature a public entry to the building and be landscaped appropriately for the use and layout of the site. Off street surface parking is located as far to the west of the public entry as possible and will be landscaped and screened by a mix of plant material. The building design is comprised of high-quality low maintenance materials that have been selected to complement the recently completed adjacent buildings and neighborhood character. Roof top mechanical equipment will feature integrated screening where not shielded from view by parapets. The facades of the building are broken in their height materiality and articulation. Lighting is used to highlight areas of activity at the public entries and guest courtyards. Adequate and appropriate lighting will be provided at the parking, loading and public circulation areas and will complement the remainder of the Madison Yards development and neighborhood. The landscape design will be designed as a comprehensive whole with the adjacent Madison Yards block 6 areas and recently completed projects. All utilities serving the building will be located below grade. Ground mounted utility equipment will be fully screened from view from all public and private streets adjacent to the Hotel parcel.

#### **UDC Informational Comments**

The project was discussed at the July 26, 2023 Urban Design Commission as an informational presentation. While the feedback was generally positive, items for further exploration and explanation were discussed. First, the number of exterior materials and their apparent lack of contrast. While the design team believes the contrast concern was a result of the digital images special care has been taken to achieve the Hotel flag brand standard exterior color palette utilizing the high quality materials required by the City of Madison urban design standards and goals of the overall Madison Yards development. Soldier courses have been add to window heads at areas of brick facade to provide more texture and detail while maintaining the simplicity of the massing. The physical samples will also better demonstrate the contrast between the brick and fiber cement color. Similarly the dark burnished block is used as a durable base course material on the building and around high traffic areas of the dock and back of house but is intended to be of similar color value to the profiled metal panel to reduce the visual contrast between them so they create a single reading on the exterior as they are utilized to accent the same

massing elements of the building's composition. Following the informational presentation the design team added an accent wall at the corner of Sheboygan and Iron Streets to extend the reading of the Sheboygan façade along the street edge creating a building façade like element between the street and the surface parking area to further satisfy the TOD and UDD 6 requirements. This element was not well received during the following presentation and has since been removed. A substantial line of planting has been added to the east side of the parking area to create separation to the green space, while a seat wall was suggested the site grading created a condition not conducive to a level hardscape element. This landscape has been revised to accommodate snow removal with a focus on landscaping the corners of the east portion of the parking area. Seat wall with accent lighting were added to the north of the green and near the south entry. This element has since been moved to courtyard proper. The Landscape design takes special care to provide a variety of plant materials to create interest on all sides of the building. Lastly, the loading area has been reduced to a single bay allowing for better site circulation and screening of the back of house site areas.

UDC Initial Comments (Staff report Letter dated October 30, 2023)
The project team has addressed following comments received via Staff Report dated October 30, 2023.

- 3. The UDC finds that the VTAC units as described/designed are acceptable.
  - The project team notes acceptance and will proceed with the VTAC ventilation as shown.
- 4. The UDC finds that the proposed surface parking lot as designed and screened is appropriate.
  - The project team notes acceptance and will proceed with the parking and landscape screening as shown.
- 5. The screen wall shall be at lower in height and the materiality needs to be modified to be more open/permeable. The wall shall be designed with materials consistent with the building materials, including burnished block and faux wood fins. The wall location shall align with the building in plan view and datum.
  - The project team proposes the removal of the screen wall to create the desired open permeable presence requested. Any required retainage will be thru the use of limited natural boulder outcropping style retainage.
- 6. The sun-loving, prairie style plants on the north side of the building shall be replaced with a more shade tolerant selection.
  - The project team has updated the planting plan to address the comment.
- 7. On the west elevation, northwest corner, the sea green juniper, should be replaced with something more vertical.
  - The project team has updated the planting plan to address the comment.
- 8. Tree plantings located at the screen wall and between the loading area and the public lawn shall be at least a 2.5-inch caliper.
  - The project team has updated the planting plan to address the comment.
- 9. Provide details on material transitions between the metal panel and fiber cement. Consideration should be given to incorporating treatments that provide more relief between the fiber cement and metal panel, including providing a wide trim piece around the window surround to break-up the transition.
  - The project team has designed a trim between the window opening and the fiber cement siding to provide a shadow line between the materials.
- 10. Lighting shall be revised to be consistent with MGO Section 29.36.
  - The Site Lighting and Photometric has been revised to address the comment.

- 11. Revise the west elevation to corporate design details or material textures that break-up/minimize the blank expanses on the elevation.
  - The project team has updated the design incorporating additional guestroom window openings to area of brick at the west elevation.

# Traffic Impact Analysis

A traffic impact analysis (TIA) from Kimley Horn and a TDM Plan has been previously submitted for the Madison Yards project.

## Exterior Signage

All signage depicted in this submittal is for illustrative purposes only. The project team will follow the UDC signage review process as the design develops. Signage will be allowed per Chapter 31 of the Madison General Ordinances and will be provided with each SIP.

# Anticipated Schedule

Construction of Project is scheduled for a spring of 2025 construction start with completion in 2026.

Sincerely

Dave Emerich

Raymond Management Company


# BLOCK 4 HOTEL


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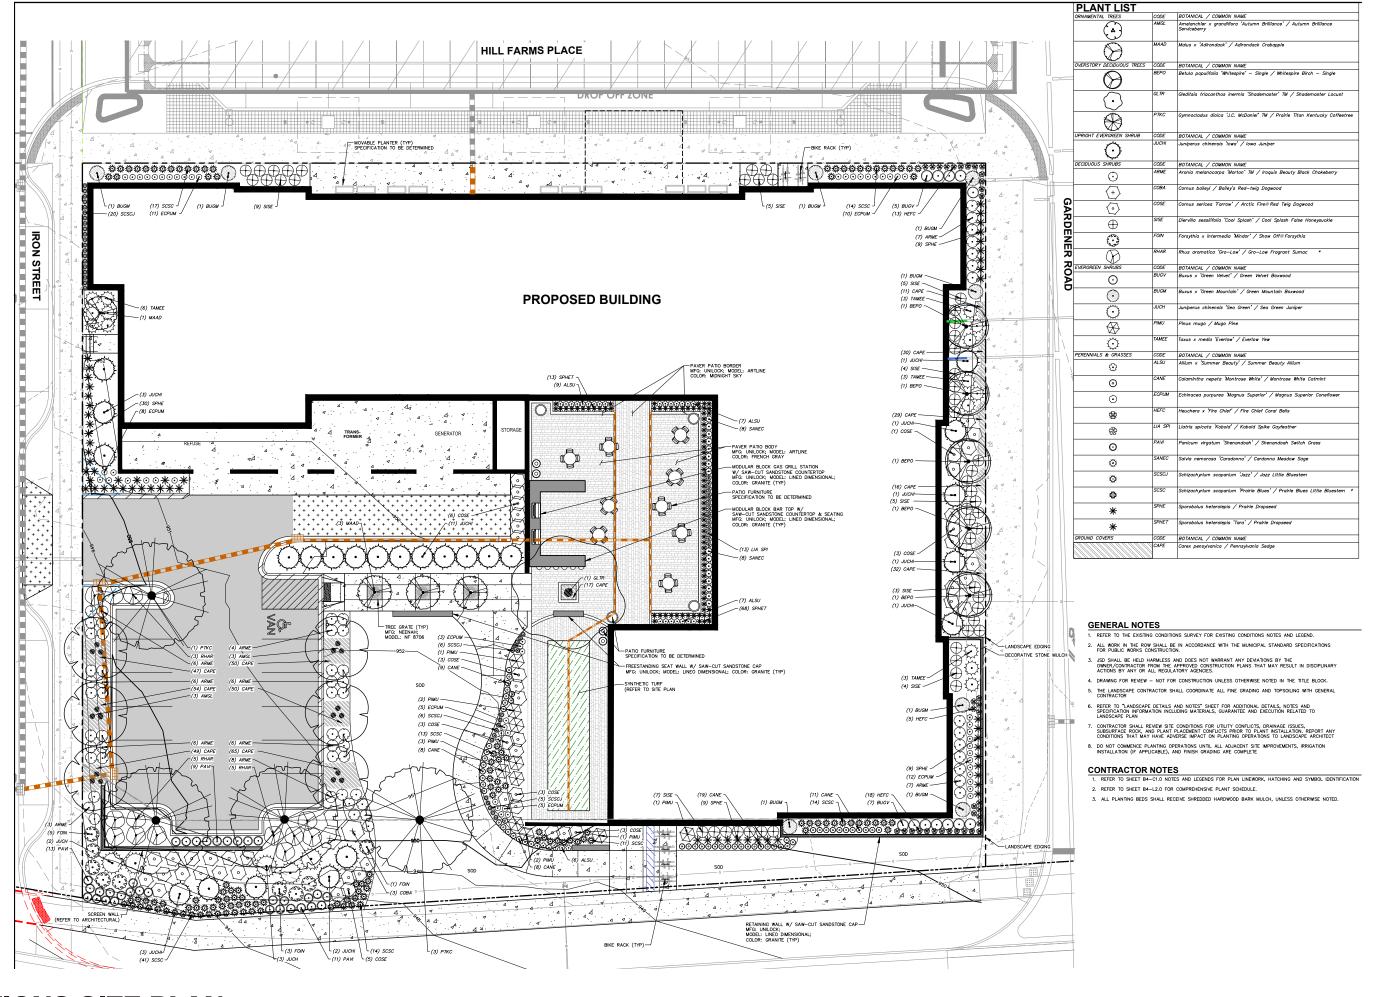
HOTEL DESIGN CONCEPT


JULY 2024

Kahler Slater



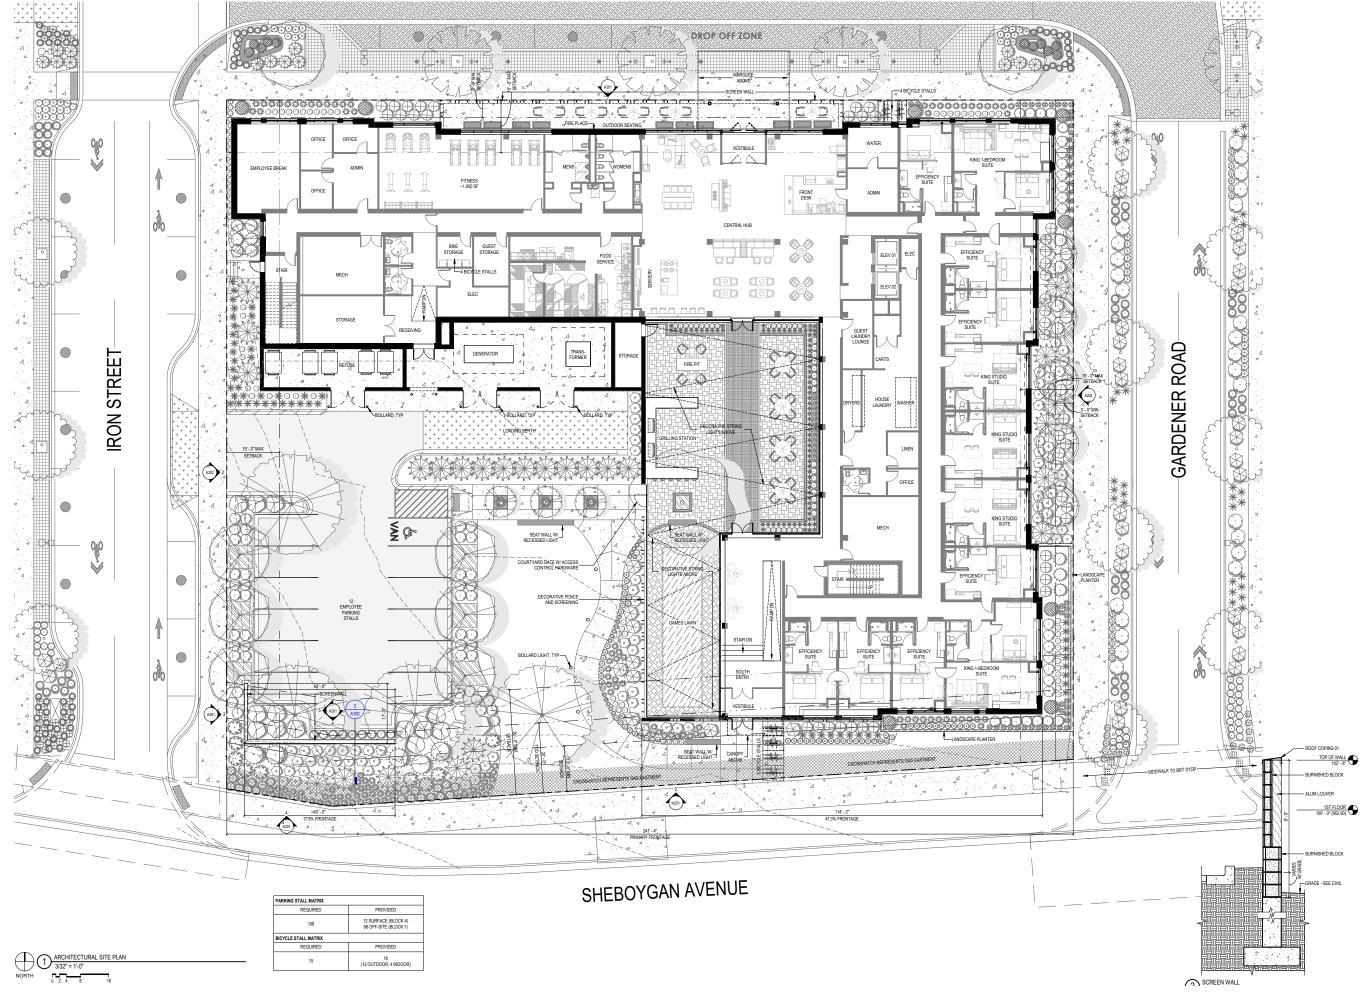

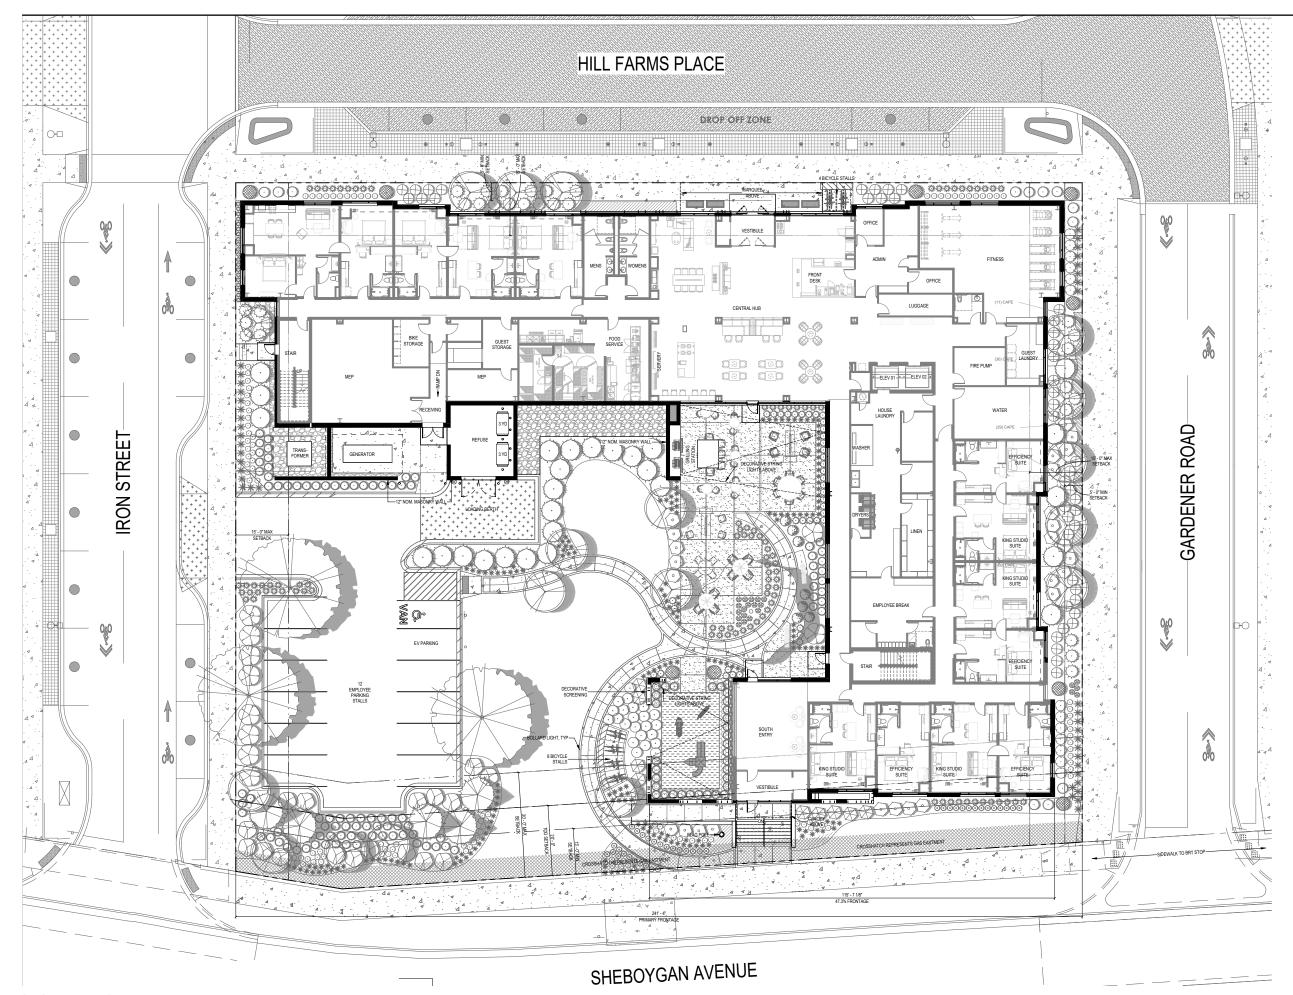

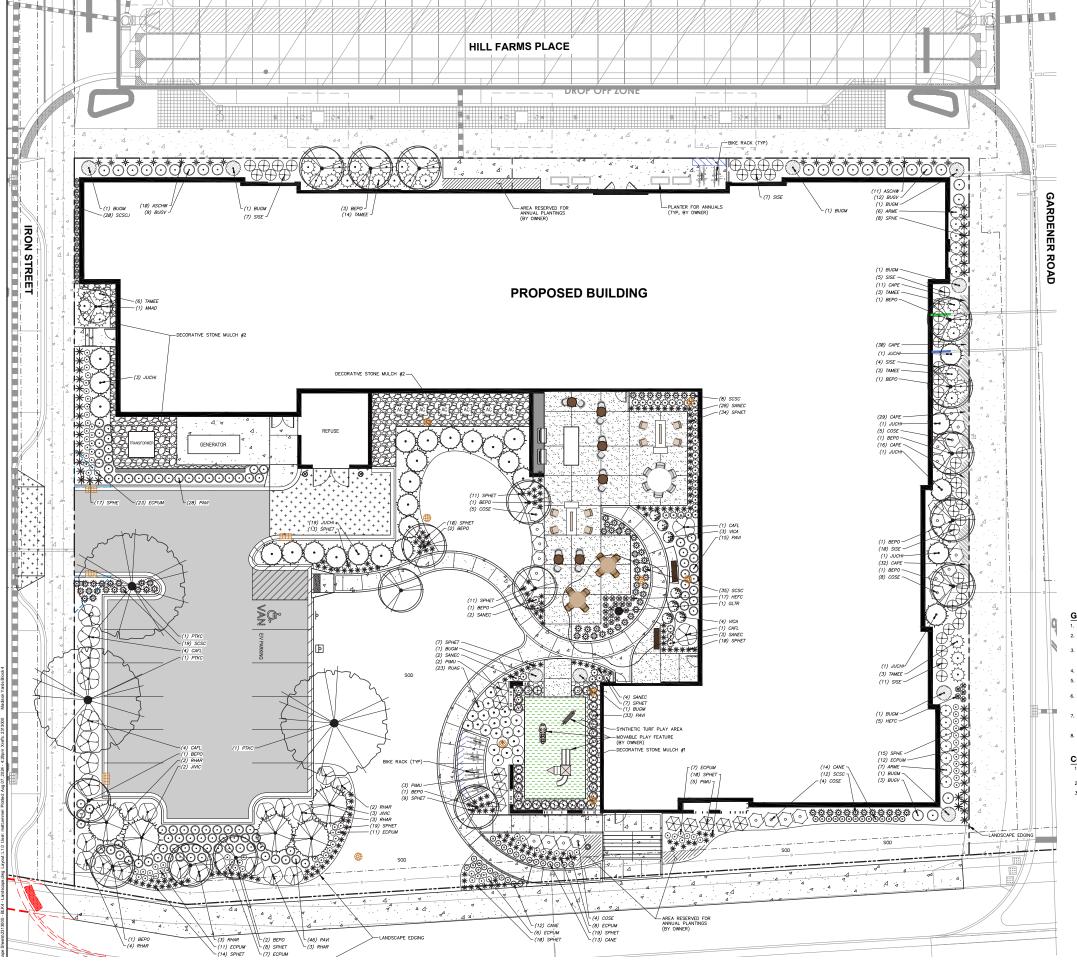


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		•
ORNAMEI	VTAL TRE	ES
	MAAD	Malus x 'Adirondack' / Adirondack Crabapple
OVERSTO	RY DECIL	DUOUS TREES
$\bigcirc$	BEP0	Betula populifolia 'Whitespire' — Single / Whitespire Birch — Single
$\bigcirc$	GLTR	Gleditsia triacanthos inermis 'Shademaster' TM / Shademaster Locust
	РТКС	Gymnocladus dioica 'J.C. McDaniel' TM / Prairie Titan Kentucky Coffeet
UPRIGHT	EVERGR	EEN SHRUB
0	JUCHI	Juniperus chinensis 'lowa' / lowa Juniper
0	JIVIC	Juniperus virginiana 'Canaertii' / Canaerti Eastern Redcedar
DECIDUO	US SHRL	JRS
0	ARME	Aronia melanocarpa 'Morton' TM / Iroquis Beauty Black Chokeberry
$\otimes$	CAFL	Calycanthus floridus 'SMNCAF' / Simply Scentsational® Sweetshrub
(0)	COSE	Cornus sericea 'Farrow' / Arctic Fire® Red Twig Dogwood
$\bigcirc$	SISE	Diervilla sessilifolia 'Cool Splash' / Cool Splash False Honeysuckle
(b)	RHAR	Rhus aromatica 'Gro-Low' / Gro-Low Fragrant Sumac *
<b>()</b>	VICA	Viburnum carlesii 'SMVCB' TM / Spice Baby Koreanspice Viburnum
FVFRGRF	EN SHRU	JRS
$\odot$	BUGV	Buxus x 'Green Velvet' / Green Velvet Boxwood
Ŏ	BUGM	Buxus x 'Green Mountain' / Green Mountain Boxwood
(X)	PIMU	Pinus mugo / Mugo Pine
∜	TAMEE	Taxus x media 'Everlow' / Everlow Yew
PERENNI	4LS & G	PRASSES
*	ASCHW	Astilbe chinensis 'Vision in White' / Vision in White Chinese Astilbe
(0)	CANE	Calamintha nepeta 'Montrose White' / Montrose White Catmint
(0)	1	1
8	ECPUM	Echinacea purpurea 'Magnus Superior' / Magnus Superior Coneflower
Õ	ECPUM HEFC	Echinacea purpurea 'Magnus Superior' / Magnus Superior Coneflower  Heuchera x 'Fire Chief' / Fire Chief Coral Bells
$\sim$	+	
Õ	HEFC	Heuchera x 'Fire Chief' / Fire Chief Coral Bells
000000000000000000000000000000000000000	HEFC PAVI	Heuchera x 'Fire Chief' / Fire Chief Coral Bells Panicum virgatum 'Shenandoah' / Shenandoah Switch Grass
000000000000000000000000000000000000000	HEFC PAVI RUAG	Heuchera x 'Fire Chief' / Fire Chief Coral Bella Fanicum virgatum 'Shenandoah' / Shenandoah Switch Grass Rudbeckia x 'American Gold Rush' / American Gold Rush Coneflower
0	HEFC PAVI RUAG SANEC	Heuchera x 'Fire Chief' / Fire Chief Coral Bells Fanicum virgatum 'Shenandoah' / Shenandoah Switch Grass Rudbeckia x 'American Gold Rush' / American Gold Rush Coneflower Salvia nemorosa 'Caradonna' / Cardonna Meadow Sage
	HEFC PAVI RUAG SANEC SCSCJ	Heuchera x 'Fire Chief' / Fire Chief Coral Bells  Panicum virgatum 'Shenandoah' / Shenandoah Switch Grass  Rudbeckia x 'American Gold Rush' / American Gold Rush Coneflower  Salvia nemorosa 'Caradonna' / Cardonna Meadow Sage  Schizachyrium scoparium 'Jazz' / Jazz Little Bluestem
	HEFC PAVI RUAG SANEC SCSCJ SCSC	Heuchera x 'Fire Chief' / Fire Chief Coral Bells  Panicum virgatum 'Shenandooh' / Shenandooh Switch Grass  Rudbeckia x 'American Gold Rush' / American Gold Rush Coneflower  Solvia nemorosa 'Caradonno' / Cardonna Meadow Saye  Schizachyrium scoparium 'Vazz' / Jazz Little Bluestem  Schizachyrium scoparium 'Prairie Blues' / Prairie Blues Little Bluestem

#### ENERAL NOTES


- REFER TO THE EXISTING CONDITIONS SURVEY FOR EXISTING CONDITIONS NOTES AND LEGEND.
- ALL WORK IN THE ROW SHALL BE IN ACCORDANCE WITH THE MUNICIPAL STANDARD SPECIFICATIONS FOR PUBLIC WORKS CONSTRUCTION.
- OWNER/CONTRACTOR FROM THE APPROVED CONSTRUCTION PLANS THAT MAY RESULT IN DISCIPLINARY ACTIONS BY ANY OR ALL REGULATORY AGENCIES.
- 4. DRAWING FOR REVIEW NOT FOR CONSTRUCTION UNLESS OTHERWISE NOTED IN THE TITLE BLOCK.
- REFER TO "LANDSCAPE DETAILS AND NOTES" SHEET FOR ADDITIONAL DETAILS, NOTES AND
- LANDSCAPE PLAN
- SUBSURFACE ROCK, AND PLANT PLACEMENT CONFLICTS PRIOR TO PLANT INSTALLATION. REPORT ANY CONDITIONS THAT MAY HAVE ADVERSE IMPACT ON PLANTING OPERATIONS TO LANDSCAPE ARCHITECT
- DO NOT COMMENCE PLANTING OPERATIONS UNTIL ALL ADJACENT SITE IMPROVEMENTS, IRRIGATION INSTALLATION (IF APPLICABLE), AND FINISH GRADING ARE COMPLETE


#### CONTRACTOR NOTES


- REFER TO SHEET B4—C1.0 NOTES AND LEGENDS FOR PLAN LINEWORK, HATCHING AND SYMBOL IDENTIFICATION
- 2. REFER TO SHEET B4-L2.0 FOR COMPREHENSIVE PLANT SCHEDULE.
- 3. ALL PLANTING BEDS SHALL RECEIVE SHREDDED HARDWOOD BARK MULCH, UNLESS OTHERWISE NOTED.

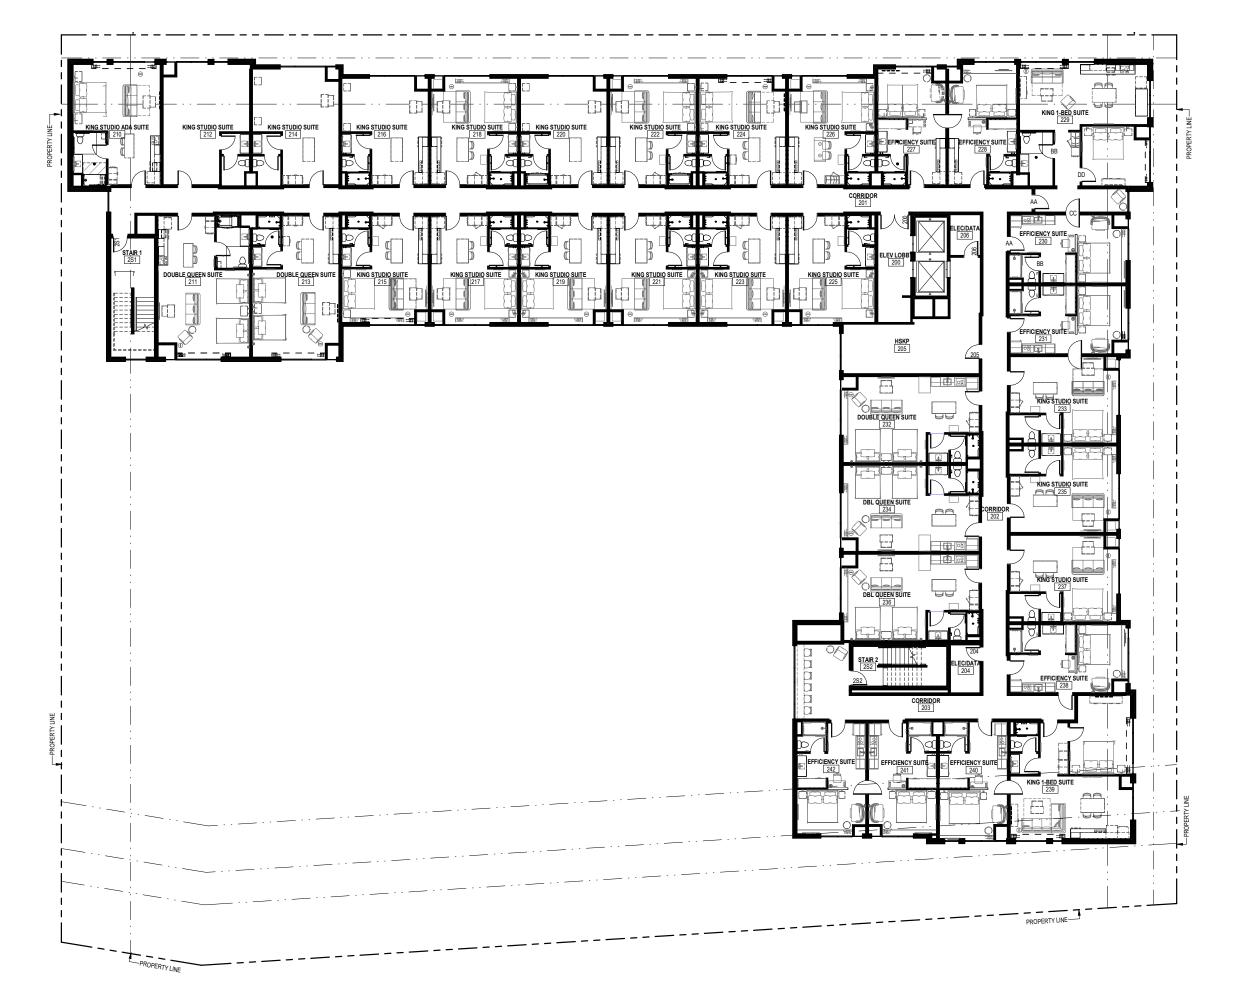

1ST FLOOR MIX		
EFFICIENCY SUITES		7
KING STUDIO SUITES		3
DLB QUEEN STUDIO SUITES		0
KING 1-BEDROOM SUITES		2
TOTAL		12
2ND FLOOR MIX		_
EFFICIENCY SUITES		8
KING STUDIO SUITES		18
DLB QUEEN STUDIO SUITES		5
KING 1-BEDROOM SUITES		2
TOTAL		33
3RD FLOOR MIX		
EFFICIENCY SUITES		8
KING STUDIO SUITES		18
DLB QUEEN STUDIO SUITES		5
KING 1-BEDROOM SUITES		2
TOTAL		33
4TH FLOOR MIX		_
EFFICIENCY SUITES		8
KING STUDIO SUITES		18
DLB QUEEN STUDIO SUITES		5
KING 1-BEDROOM SUITES		2
TOTAL		33
5TH FLOOR MIX		
EFFICIENCY SUITES		8
KING STUDIO SUITES		18
DLB QUEEN STUDIO SUITES		5
KING 1-BEDROOM SUITES		2
TOTAL		33
TOTAL KEY COU	NT	
EFFICIENCY SUITES	39 KEYS	
KING STUDIO SUITES	75 KEYS	
DLB QUEEN STUDIO SUITES	20 KEYS	
KING 1-BEDROOM SUITES	10 KEYS	
TOTAL	144 KEYS	

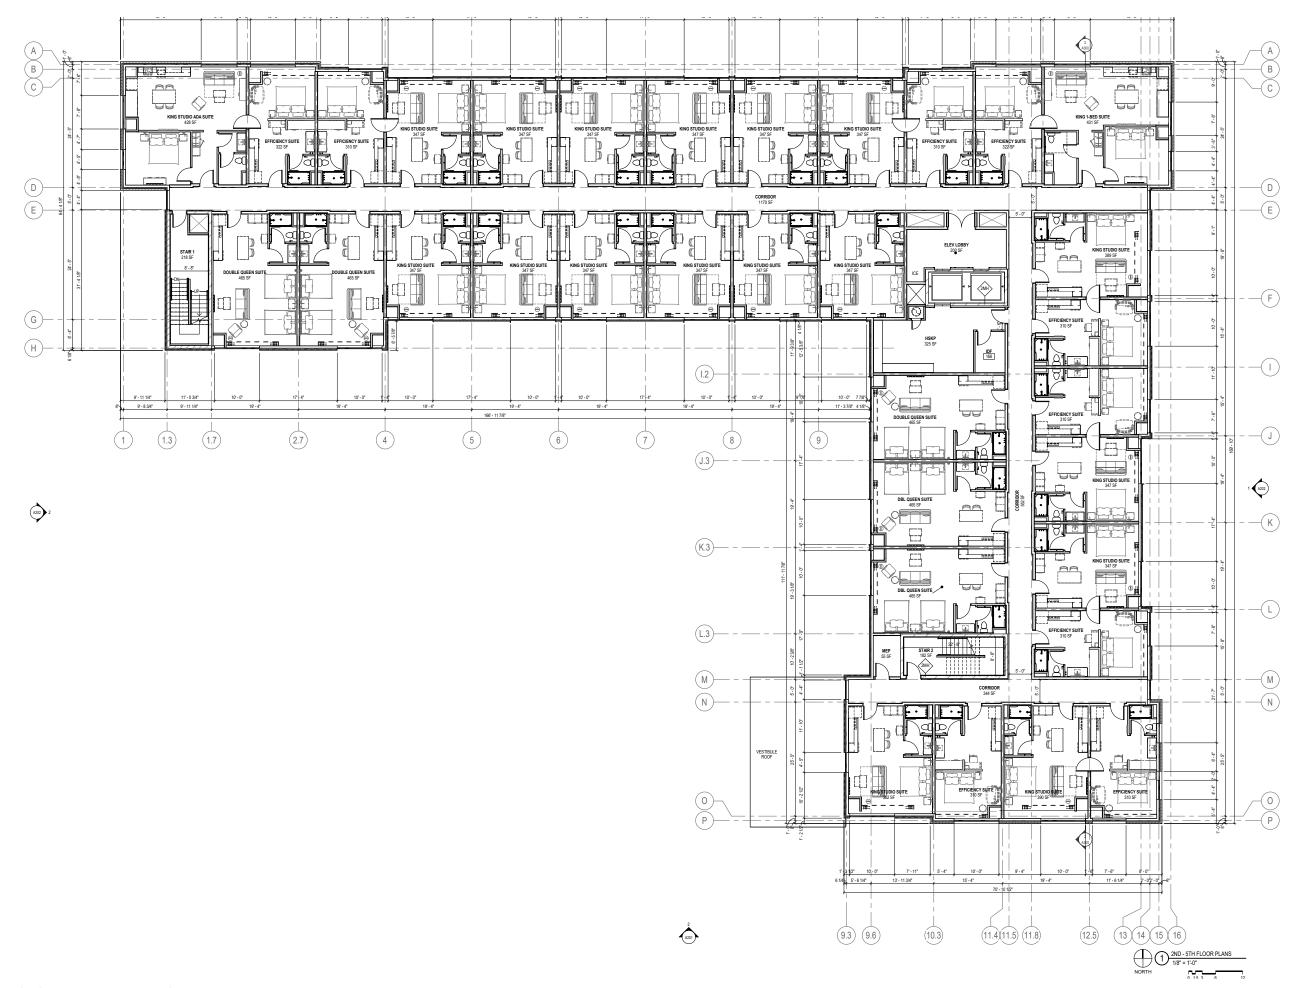

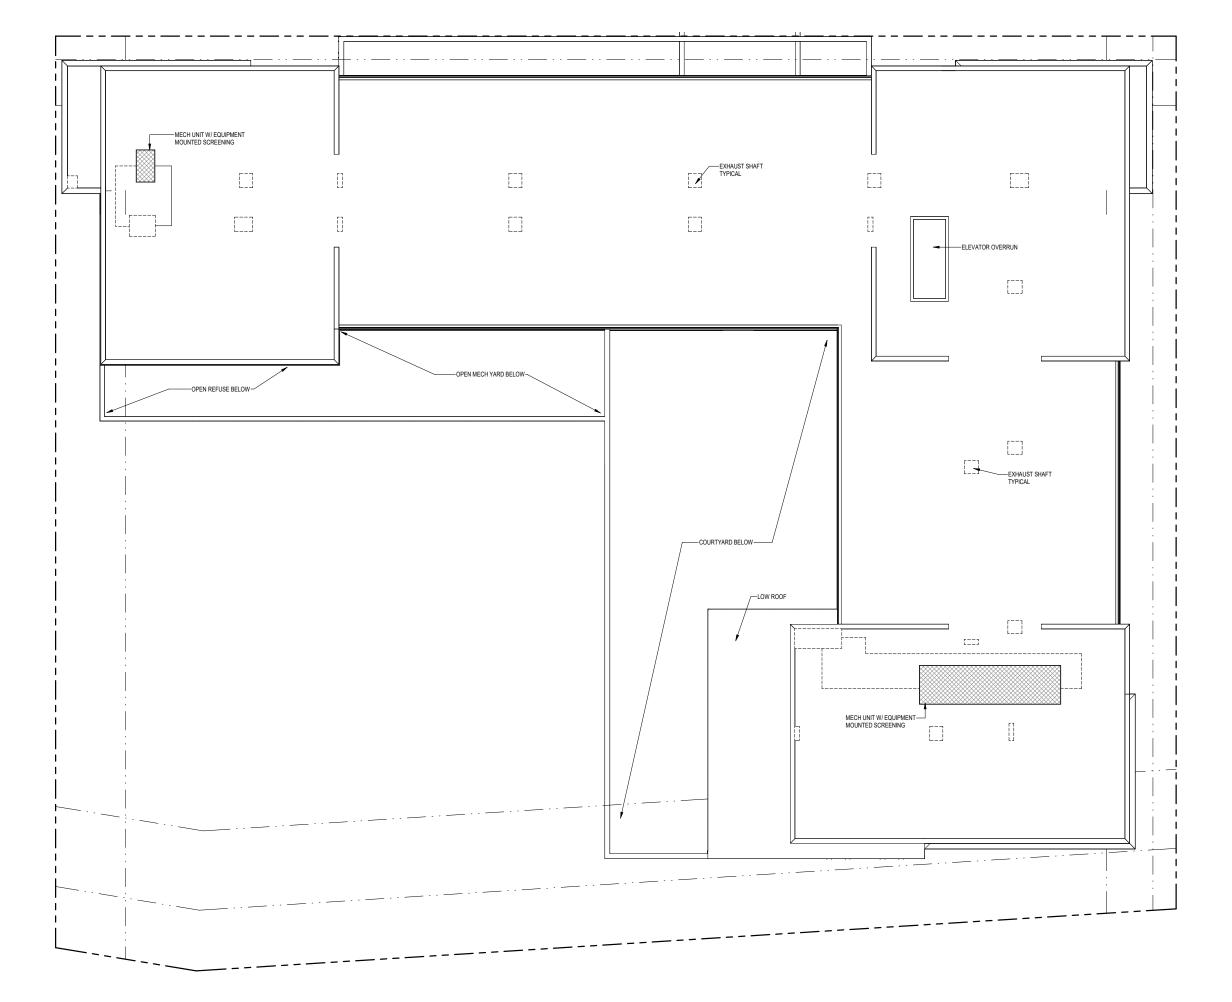

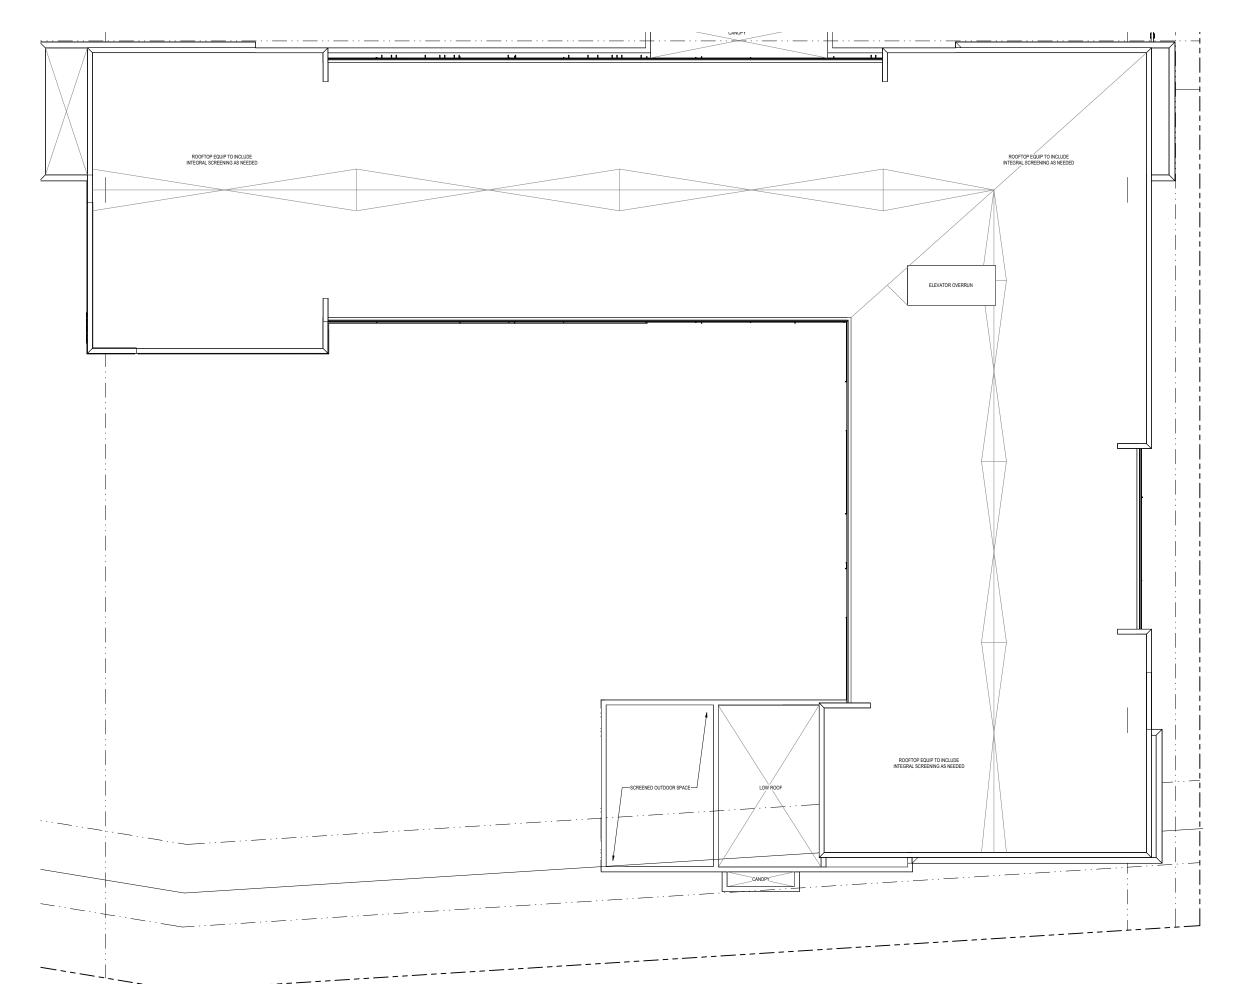









**MODULAR BRICK - LIGHT GRAY** 

**TEXTURED METAL PANEL** 

FIBER CEMENT BOARD - TAN

**WOOD LOOK ACCENT:** 











**MODULAR BRICK - LIGHT GRAY** 

TEXTURED METAL PANEL

FIBER CEMENT BOARD - TAN

**WOOD LOOK ACCENT:** 












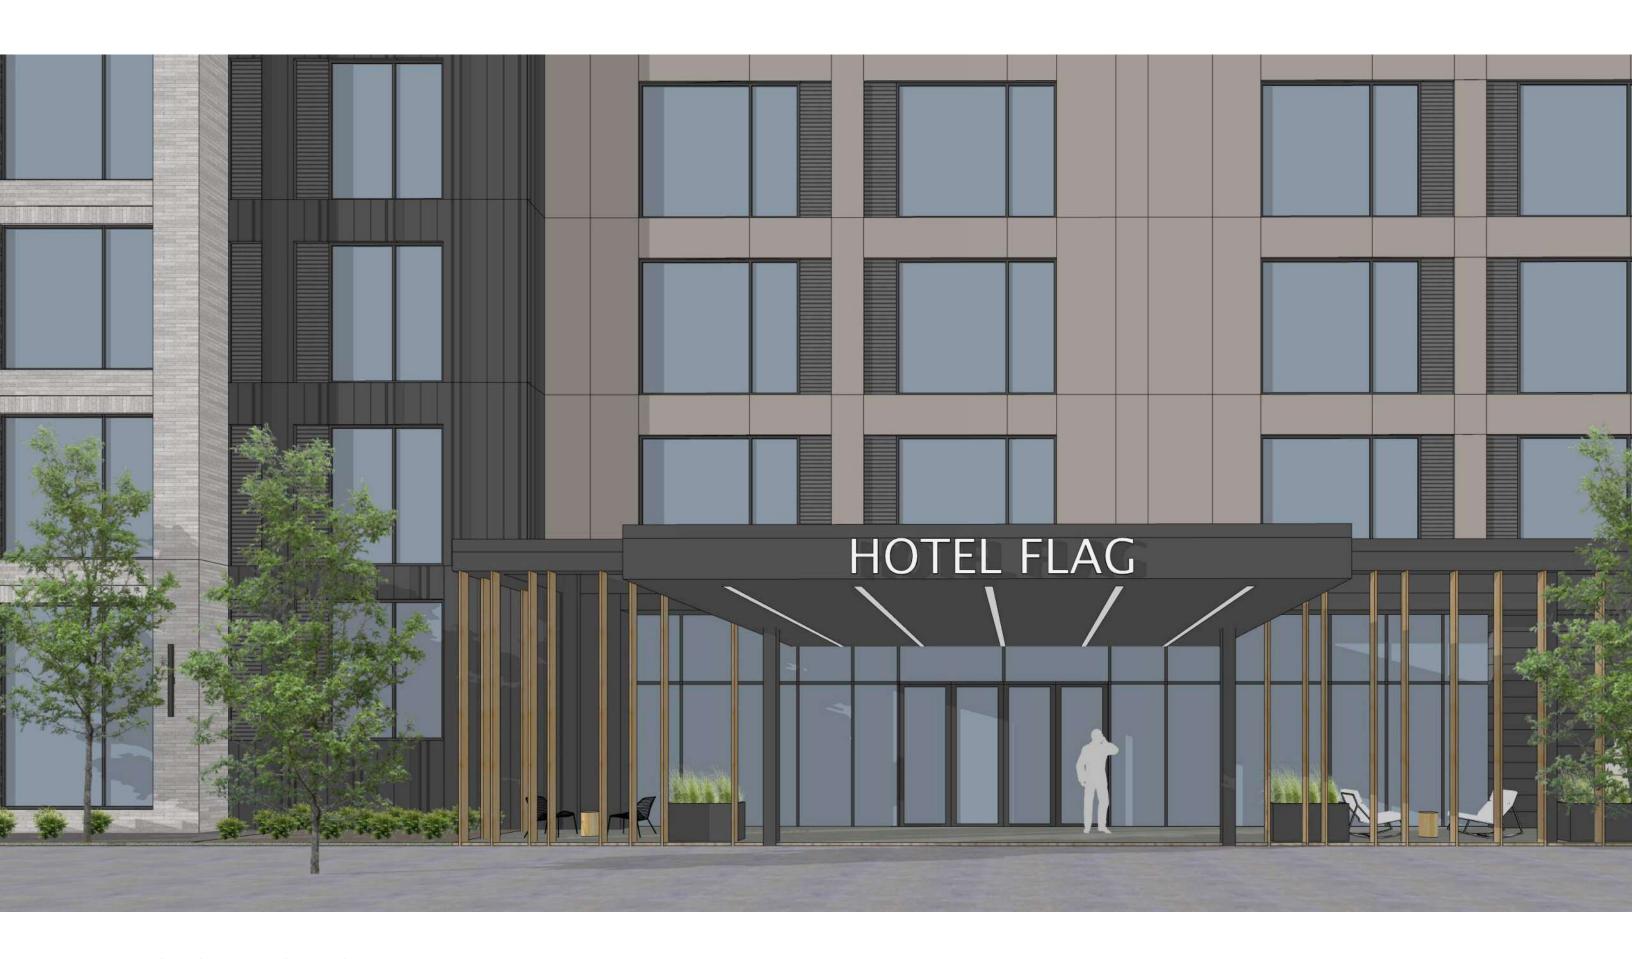
































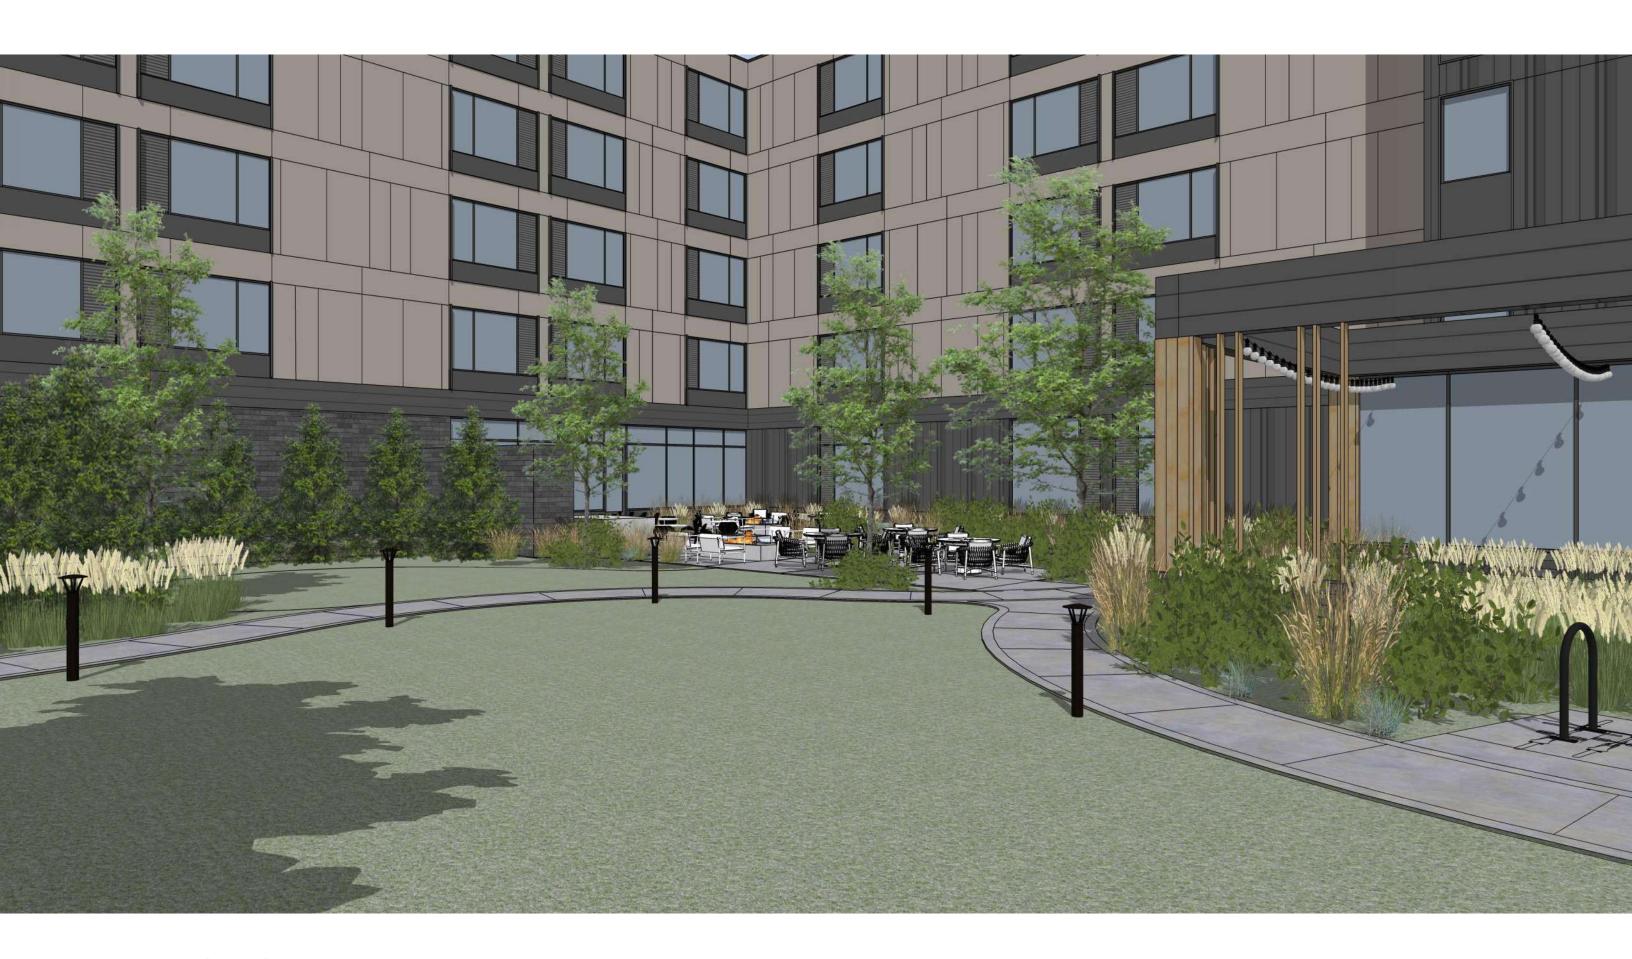















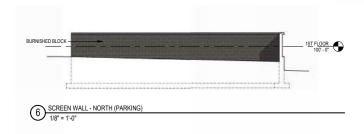

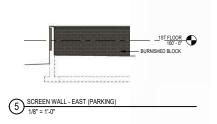

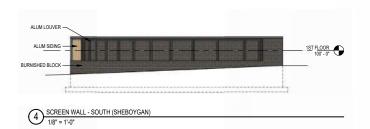

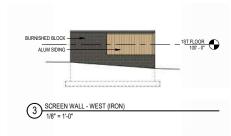







1) EAST ELEVATION
1/8" = 1'-0"












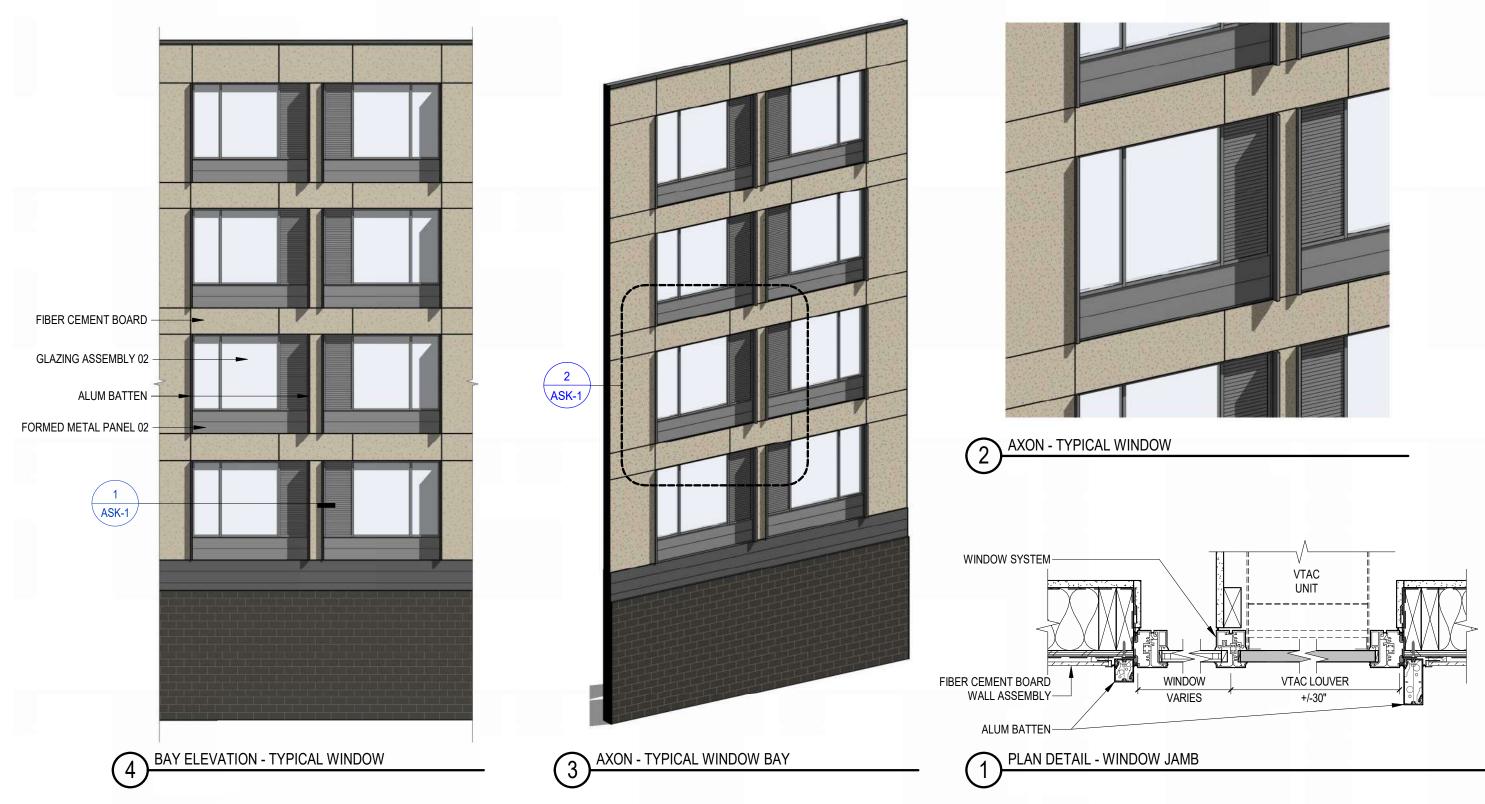

SIP SUBMITTAL

# MADISON YARDS: BLOCK 4 HOTEL

**BLOCK 4 AT MADISON YARDS** 

KAHLER SLATER PROJECT: 222093.00

JULY 15, 2024

GENERAL SHEET INDEX

SHEET NUMBER SHEET NAME
G000 COVER SHEET

CIVIL SHEET INDEX

SHEET NUMBER SHEET NAME

B4-C1.0 BLOCK 4 - NOTES & LEGEND

B4-C2.0 BLOCK 4 - OVERALL SITE PLAN

B4-C2.1 BLOCK 4 - SITE PLAN - ANNOTATED

B4-C2.2 BLOCK 4 - SITE PLAN - DIMENSIONED

B4-C3.0 BLOCK 4 - GRADING & EROSION CONTROL PLAN

B4-C4.0 BLOCK 4 - UTILITY PLAN

B4-C5.0 BLOCK 4 - DETAILS

SHEET NUMBER SHEET INDEX

SHEET NUMBER SHEET NAME

B4-L1.0 BLOCK 4 LANDSCAPE PLAN

B4-L2.0 BLOCK 4 LANDSCAPE DETAILS & NOTES

ARCHITECTURAL SHEET INDEX

SHEET NUMBER SHEET NAME
A111 1ST FLOOR PLAN
A112 2ND - 5TH FLOOR PLANS
A201 EXTERIOR ELEVATIONS
A202 EXTERIOR ELEVATIONS

NOT FOR CONSTRUCTION



Revisio

SIP SUBMITTAL

SCOPE DOCUMENTS

JULY 15, 2024

MADISON YARDS: BLOCK 4 HOTEL

BLOCK 4 AT MADISON YARDS

Project No. 222093.00

Sheet Title

**COVER SHEET** 

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Sheet No.

G000

125 South Clark Street, Suite 675-2, Chicago, Illinois 60603 Telephone 312.789.4516

**GENERAL NOTES** 

1. REFER TO THE EXISTING CONDITIONS SURVEY FOR EXISTING CONDITIONS NOTES AND LEGENDS.

- 2. ALL WORK IN THE ROW AND/OR PUBLIC EASEMENTS SHALL BE IN ACCORDANCE WITH THE STANDARD SPECIFICATIONS FOR SEWER & WATER CONSTRUCTION IN WISCONSIN AND MUNICIPAL REQUIREMENTS.
- 3. EXISTING GRADE SPOT ELEVATIONS SHOWN FOR INFORMATIONAL PURPOSES. DURING CONSTRUCTION MATCH EXISTING GRADES AT CONSTRUCTION LIMITS.
- 4. NO SITE GRADING OUTSIDE OR DOWNSLOPE OF PROPOSED SILT FENCE LOCATION. NO LAND DISTURBANCE BEYOND PROPERTY LINES.
- 5. JSD SHALL BE HELD HARMLESS AND DOES NOT WARRANT ANY DEVIATIONS BY THE OWNER/CONTRACTOR FROM THE APPROVED CONSTRUCTION PLANS THAT MAY RESULT IN DISCIPLINARY ACTIONS BY ANY OR ALL REGULATORY AGENCIES.

#### **PAVING NOTES**

- 1.1. ALL PAVING SHALL CONFORM TO "STATE OF WISCONSIN STANDARD SPECIFICATIONS FOR HIGHWAY & STRUCTURE CONSTRUCTION, LATEST EDITION, APPLICABLE CITY OF MADISON ORDINANCES AND THE GEOTECHNICAL REPORT PREPARED BY CGC INC. DATED FEBRUARY 27, 2018 (REPORT
- 1.2. ALL PAVING DIMENSIONS ARE TO FACE OF CURB UNLESS SPECIFIED OTHERWISE.
- 1.3. SURFACE PREPARATION NOTIFY ENGINEER/OWNER OF UNSATISFACTORY CONDITIONS. DO NOT BEGIN PAVING WORK UNTIL DEFICIENT SUBBÁSE AREAS HAVE BEEN CORRECTED AND ARE READY
- 1.4. ANY REQUIRED REPLACEMENT OF PUBLIC CURB AND GUTTER SHALL MATCH EXISTING AND MEET MUNICIPALITY REQUIREMENTS.

#### 2. ASPHALTIC CONCRETE PAVING SPECIFICATIONS

- 2.1. CODES AND STANDARDS THE PLACING, CONSTRUCTION AND COMPOSITION OF THE ASPHALTIC BASE COURSE AND ASPHALTIC CONCRETE SURFACE COURSE SHALL BE IN ACCORDANCE WITH THE REQUIREMENTS OF SECTIONS 450, 455, 460 AND 465 OF THE STATE OF WISCONSIN STANDARD SPECIFICATIONS FOR HIGHWAY AND STRUCTURE CONSTRUCTION, CURRENT EDITION. HEREAFTER, THIS PUBLICATION WILL BE REFERRED TO AS STATE HIGHWAY SPECIFICATIONS.
- 2.2. WEATHER LIMITATIONS APPLY TACK COATS WHEN AMBIENT TEMPERATURE IS ABOVE 50° F (10° C) AND WHEN TEMPERATURE HAS NOT BEEN BELOW 35° F (1° C) FOR 12 HOURS IMMEDIATELY PRIOR TO APPLICATION. DO NOT APPLY WHEN BASE IS WET OR CONTAINS EXCESS OF MOISTURE CONSTRUCT ASPHALTIC CONCRETE SURFACE COURSE WHEN ATMOSPHERIC TEMPERATURE IS ABOVE 40° F (4° C) AND WHEN BASE IS DRY AND WHEN WEATHER IS NOT RAINY. BASE COURSE MAY BE PLACED WHEN AIR TEMPERATURE IS ABOVE 30° F  $(-1^{\circ} C)$ .
- 2.3. GRADE CONTROL ESTABLISH AND MAINTAIN REQUIRED LINES AND ELEVATIONS FOR EACH
- 2.4. CRUSHED AGGREGATE BASE COURSE THE TOP LAYER OF BASE COURSE SHALL CONFORM TO SECTIONS 301 AND 305, STATE HIGHWAY SPECIFICATIONS.
- 2.5. BINDER COURSE AGGREGATE THE AGGREGATE FOR THE BINDER COURSE SHALL CONFORM T SECTIONS 460 AND 315, STATE HIGHWAY SPECIFICATIONS.
- 2.6. SURFACE COURSE AGGREGATE THE AGGREGATE FOR THE SURFACE COURSE SHALL CONFORM
- TO SECTIONS 460 AND 465, STATE HIGHWAY SPECIFICATIONS. 2.7. ASPHALTIC MATERIALS - THE ASPHALTIC MATERIALS SHALL CONFORM TO SECTION 455 AND 460, STATE HIGHWAY SPECIFICATIONS.
- 3. CONCRETE PAVING SPECIFICATIONS 3.1. CONCRETE PAVING SHALL BE IN ACCORDANCE WITH THE REQUIREMENTS OF SECTIONS 415 AND
- 3.2. CONCRETE PAVEMENT SHALL BE REINFORCED WITH NOVOMESH 950 (OR EQUAL) FIBER
- REINFORCEMENT AT A RATE OF 5 LBS/CUBIC YARD. 3.3. CURING COMPOUNDS SHALL CONFORM TO SECTION 415 OF THE STATE HIGHWAY SPECIFICATIONS.
- 3.4. CONTRACTOR SHALL PROVIDE CONTROL JOINTS AND CONSTRUCTION JOINTS OF ONE-QUARTER CONCRETE THICKNESS AT AN EQUAL RATIO OF LENGTH TO WIDTH WHEREVER POSSIBLE WITH A MAXIMUM LENGTH BETWEEN JOINTS OF 8' ON CENTER.
- 3.5. CONTRACTOR SHALL PROVIDE EXPANSION JOINTS IN SIDEWALKS AT A MAXIMUM 24' ON CENTER. 3.6. EXTERIOR CONCRETE SURFACES SHALL BE BROOM FINISHED.
- 3.7. ALL CONCRETE SURFACES TO BE SEALED WITH TYPE TK-26UV CONCRETE SEALANT.

#### 4. PAVEMENT MARKING SPECIFICATIONS

416 OF THE STATE HIGHWAY SPECIFICATIONS.

- 4.1. USE 4" WIDE, HIGH VISIBILITY YELLOW LATEX PAINT FOR STALL LINES.
- 4.2. MARK AND STRIPE ADA PARKING SPACES APPROPRIATELY.
- 4.3. ALL PAVEMENT MARKINGS INCLUDING: STOP BARS, CROSSWALKS, DIRECTIONAL ARROWS, PARKING STALL LINES, ADA STALL MARKINGS, NO PARKING ZONES, DROP-OFF/PICK-UP ZONES SHALL BE
- 4.4. 2' x 4' TRUNCATED DOME WARNING DETECTION FIELD SHALL BE PLACED AT ALL ADA RAMPS.

#### CONSTRUCTION SEQUENCING

PAINTED WITH LATEX PAINT PER SPECIFICATIONS.

- INSTALL PERIMETER SILT FENCE, INLET PROTECTION AND TEMPORARY CONSTRUCTION ENTRANCE.
- 2. STRIP AND STOCKPILE TOPSOIL, INSTALL SILT SOCK AROUND PERIMETER OF STOCKPILE.
- 3. CONDUCT ROUGH GRADING EFFORTS.

COVER IS ESTABLISHED.

- 4. INSTALL UTILITY PIPING AND STRUCTURES, IMMEDIATELY INSTALL INLET PROTECTION. COMPLETE FINAL GRADING, INSTALLATION OF GRAVEL BASE COURSES, PLACEMENT OF CURBS,
- 6. PLACE TOPSOIL AND IMMEDIATELY STABILIZE DISTURBED AREAS WITH EROSION CONTROL MEASURES
- AS INDICATED ON PLANS. EROSION CONTROLS SHALL NOT BE REMOVED UNTIL SITE IS FULLY STABILIZED OR 70% VEGETATIVE
- CONTRACTOR MAY MODIFY SEQUENCING AFTER ITEM NO. 1 AS NEEDED TO COMPLETE CONSTRUCTION IF EROSION CONTROLS ARE MAINTAINED IN ACCORDANCE WITH THE CONSTRUCTION SITE EROSION CONTROL REQUIREMENTS.

#### **EROSION CONTROL NOTES**

- 1. CONTRACTOR IS RESPONSIBLE TO NOTIFY ENGINEER OF RECORD AND OFFICIALS OF ANY CHANGES TO THE EROSION CONTROL AND STORMWATER MANAGEMENT PLANS. ENGINEER OF RECORD AND APPROPRIATE CITY OF MADISON OFFICIALS MUST APPROVE ANY CHANGES PRIOR TO DEVIATION FROM THE APPROVED PLANS.
- 2. ALL EROSION CONTROL MEASURES SHALL BE CONSTRUCTED AND MAINTAINED BY THE CONTRACTOR IN ACCORDANCE WITH THE WISCONSIN DEPARTMENT OF NATURAL RESOURCES (WDNR) TECHNICAL STANDARDS (REFERRED TO AS BMP'S) AND CITY OF MADISON ORDINANCE. IT IS THE CONTRACTOR'S RESPONSIBILITY TO OBTAIN A COPY OF THESE STANDARDS. CONTRACTOR SHALL BE RESPONSIBLE FOR ANY ADDITIONAL EROSION CONTROL MEASURES WHICH MAY BE NECESSARY TO MEET UNFORESEEN FIELD CONDITIONS.
- 5. INSTALL PERIMETER EROSION CONTROL MEASURES (SUCH AS CONSTRUCTION ENTRANCES, SILT FENCE AND EXISTING INLET PROTECTION) PRIOR TO ANY SITE WORK, INCLUDING GRADING OR DISTURBANCE OF EXISTING SURFACE COVER, AS SHOWN ON PLAN. MODIFICATIONS TO THE APPROVED EROSION CONTROL DESIGN IN ORDER TO MEET UNFORESEEN FIELD CONDITIONS IS ALLOWED IF MODIFICATIONS CONFORM TO BMP'S. ALL DESIGN MODIFICATIONS MUST BE APPROVED BY THE CITY OF MADISON PRIOR TO DEVIATION OF THE APPROVED PLAN.
- 4. ADDITIONAL EROSION CONTROL MEASURES, AS REQUESTED BY STATE INSPECTORS, LOCAL INSPECTORS, COUNTY INSPECTORS AND/OR ENGINEER OF RECORD SHALL BE INSTALLED WITHIN 24 HOURS OF
- 5. INSPECTIONS AND MAINTENANCE OF ALL EROSION CONTROL MEASURES SHALL BE ROUTINE (ONCE PER WEEK MINIMUM) TO ENSURE PROPER FUNCTION OF EROSION CONTROLS AT ALL TIMES. EROSION CONTROL MEASURES ARE TO BE IN WORKING ORDER AT THE END OF EACH WORK DAY.
- . ALL EROSION AND SEDIMENT CONTROL ITEMS SHALL BE INSPECTED WITHIN 24 HOURS OF ALL RAIN EVENTS EXCEEDING 0.5 INCHES. ANY DAMAGED EROSION CONTROL MEASURES SHALL BE REPAIRED OR REPLACED IMMEDIATELY UPON INSPECTION.
- . CONSTRUCTION ENTRANCES SHALL BE INSTALLED AT ALL LOCATIONS OF VEHICLE INGRESS/EGRESS POINTS. ADDITIONAL LOCATIONS OTHER THAN AS SHOWN ON THE PLANS MUST BE PRIOR APPROVED BY THE MUNICIPALITY. CONSTRUCTION ENTRANCES SHALL BE 50' LONG AND NO LESS THAN 12" THICK BY USE OF 3" CLEAR STONE. CONSTRUCTION ENTRANCES SHALL BE MAINTAINED BY THE CONTRACTOR IN A CONDITION WHICH WILL PREVENT THE TRACKING OF MUD OR DRY SEDIMENT ONTO ADJACENT PUBLIC STREETS AFTER EACH WORKING DAY OR MORE FREQUENTLY AS REQUIRED.
- 8. PAVED SURFACES ADJACENT TO CONSTRUCTION SITE VEHICLE ACCESS SHALL BE SWEPT AND/OR SCRAPED TO REMOVE ACCUMULATED SOIL, DIRT AND/OR DUST AFTER THE END OF EACH WORK DAY AND AS REQUESTED BY THE CITY OF MADISON.
- 9. INLET PROTECTION SHALL BE IMMEDIATELY FITTED AT THE INLET OF ALL INSTALLED STORM SEWER AND SILT FENCE SHALL BE IMMEDIATELY FITTED AT ALL INSTALLED CULVERT INLETS TO PREVENT SEDIMENT DEPOSITION WITHIN STORM SEWER SYSTEMS. 10. INSTALL EROSION CONTROLS ON THE DOWNSTREAM SIDE OF STOCKPILES. IF STOCKPILE REMAINS
- UNDISTURBED FOR MORE THAN SEVEN (7) DAYS, TEMPORARY SEEDING AND STABILIZATION IN ACCORDANCE WITH BEST MANAGEMENT PRACTICES IS REQUIRED. IF DISTURBANCE OCCURS BETWEEN NOVEMBER 15TH AND MAY 15TH, THE MULCHING SHALL BE PERFORMED BY HYDRO-MULCHING WITH A 11. DITCH CHECKS AND APPLICABLE EROSION NETTING/MATTING SHALL BE INSTALLED IMMEDIATELY AFTER
- COMPLETION OF GRADING EFFORTS WITHIN DITCHES/SWALES TO PREVENT SOIL TRANSPORTATION. 12. EROSION CONTROL FOR UTILITY CONSTRUCTION (STORM SEWER, SANITARY SEWER, WATER MAIN, ETC.): A. PLACE EXCAVATED TRENCH MATERIAL ON THE HIGH SIDE OF THE TRENCH. BACKFILL, COMPACT, AND STABILIZE THE TRENCH IMMEDIATELY AFTER PIPE CONSTRUCTION. DISCHARGE TRENCH WATER INTO A SEDIMENTATION BASIN OR FILTERING TANK IN ACCORDANCE WITH THE DEWATERING TECHNICAL STANDARD NO. 1061 PRIOR TO RELEASE INTO THE STORM

SEWER, RECEIVING STREAM, OR DRAINAGE DITCH.

- 13. ALL SLOPES 4:1 OR GREATER SHALL BE STABILIZED WITH CLASS I, TYPE B EROSION MATTING OR APPLICATION OF A WISCONSIN DEPARTMENT OF TRANSPORTATION (WisDOT) APPROVED POLYMER SOIL STABILIZATION TREATMENT OR A COMBINATION THEREOF, AS REQUIRED WITHIN 7 DAYS OF REACHING FINAL GRADE AND/OR AS SOON AS CONDITIONS ALLOW. DRAINAGE SWALES SHALL BE STABILIZED WITH CLASS II, TYPE B EROSION MATTING. EROSION MATTING AND/OR NETTING USED ONSITE SHALL BE INSTALLED IN ACCORDANCE WITH MANUFACTURER'S GUIDELINES AND WDNR TECHNICAL STANDARDS
- 14. CONTRACTOR SHALL TAKE ALL NECESSARY STEPS TO CONTROL DUST ARISING FROM CONSTRUCTION OPERATIONS. REFER TO WDNR TECHNICAL STANDARD 1068.
- 15. EROSION CONTROL MEASURES SHALL NOT BE REMOVED UNTIL ALL LAND DISTURBING CONSTRUCTION ACTIVITY AT THE SITE HAS BEEN COMPLETED AND THAT A UNIFORM PERENNIAL VEGETATIVE COVER HAS BEEN ESTABLISHED WITH A DENSITY OF AT LEAST 70% FOR UNPAYED AREAS AND AREAS NOT COVERED BY PERMANENT STRUCTURES OR THAT EMPLOY EQUIVALENT PERMANENT STABILIZATION
- 16. CONTRACTOR/OWNER SHALL FILE A NOTICE OF TERMINATION UPON COMPLETION OF THE PROJECT IN ACCORDANCE WITH WDNR REQUIREMENTS AND/OR PROPERTY SALE IN ACCORDANCE WITH WDNR REQUIREMENTS.
- STABILIZATION MEASURES SHALL BE INITIATED AS SOON AS PRACTICABLE IN PORTIONS OF THE SITE WHERE CONSTRUCTION ACTIVITIES HAVE TEMPORARILY OR PERMANENTLY CEASED. NO MORE THAN SEVEN (7) DAYS SHALL PASS AFTER THE CONSTRUCTION ACTIVITY IN THAT PORTION OF THE SITE HAS CEASED UNLESS:
- THE INITIATION STABILIZATION MEASURES BY THE SEVENTH (7) DAY AFTER CONSTRUCTION ACTIVITY HAS CEASED IS PRECLUDED BY SNOW COVER. IN THAT EVENT, STABILIZATION SHALL BE INITIATED AS SOON AS PRACTICABLE. CONSTRUCTION ACTIVITY WILL RESUME ON A PORTION OF THE SITE WITHIN FOURTEEN (14)
- DAYS FROM WHEN ACTIVITY CEASED, (I.E. THE TOTAL TIME PERIOD THAT THE CONSTRUCTION ACTIVITY IS TEMPORARILY CEASED IS LESS THAN FOURTEEN (14) DAYS. IN THAT EVENT, STABILIZATION MEASURES DO NOT HAVE TO BE INITIATED ON THAT PORTION OF THE SITE BY THE SEVENTH (7) DAY AFTER CONSTRUCTION ACTIVITY HAS TEMPORARILY CEASED. STABILIZATION MEASURES SHALL BE DETERMINED BASED ON SITE CONDITIONS AT THE TIME OF CONSTRUCTION ACTIVITY HAS CEASED, INCLUDING BUT NOT LIMITED TO WEATHER
- CONDITIONS AND LENGTH OF TIME MEASURE MUST BE EFFECTIVE. THE FOLLOWING ARE ACCEPTABLE STABILIZATION MEASURES: PERMANENT SEEDING; IN ACCORDANCE WITH APPROVED CONSTRUCTION SPECIFICATION TEMPORARY SEEDING; MAY CONSIST OF SPRING OATS(100LBS/ACRE) AND/OR WHEAT
  - OR CEREAL RYE (150LB/ACRE) HYDRO-MULCHING WITH A TACKIFIER GEOTEXTILE EROSION MATTING

#### GRADING AND SEEDING NOTES

SODDING

17. STABILIZATION PRACTICES:

- I. ALL PROPOSED GRADES SHOWN ARE FINISHED GRADES. CONTRACTOR SHALL VERIFY ALL GRADES, MAKE SURE ALL AREAS DRAIN PROPERLY AND SHALL REPORT ANY DISCREPANCIES TO THE ENGINEER PRIOR TO CONSTRUCTION.
- CONTRACTOR SHALL ASSUME SOLE RESPONSIBILITY FOR COMPUTATIONS OF ALL GRADING QUANTITIES WHILE JSD PROFESSIONAL SERVICES, INC. ATTEMPTS TO PROVIDE A COST EFFECTIVE APPROACH TO BALANCE EARTHWORK, GRADING DESIGN IS BASED ON MANY FACTORS, INCLUDING SAFETY AESTHETICS, AND COMMON ENGINEERING STANDARDS OF CARE. THEREFORE, NO GUARANTEE CAN BE MADE FOR A BALANCED SITE.
- 3. PARKING LOT AND DRIVEWAY ELEVATIONS ARE PAVEMENT GRADES, NOT TOP OF CURB GRADES, UNLESS OTHERWISE NOTED.
- 4. ANY WORK WITHIN RIGHT-OF-WAY SHALL BE PROPERLY PERMITTED AND COORDINATED WITH THE APPROPRIATE OFFICIALS PRIOR TO COMMENCEMENT OF ANY CONSTRUCTION ACTIVITIES. ALL GRADING WITHIN RIGHT-OF-WAY IS SUBJECT TO APPROVAL BY SAID OFFICIALS.
- 5. CONTRACTOR SHALL PROVIDE NOTICE TO THE MUNICIPALITY IN ADVANCE OF ANY SOIL DISTURBING ACTIVITIES, IN ACCORDANCE WITH MUNICIPAL REQUIREMENTS.
- 6. ALL DISTURBED AREAS SHALL BE SODDED AND/OR SEEDED AND MULCHED IMMEDIATELY FOLLOWING GRADING ACTIVITIES. SOD/SEED MIX TO BE IN ACCORDANCE WITH LANDSCAPE PLAN.
- FACILITIES JUST PRIOR TO SODDING AND/OR SEEDING AND MULCHING TO PROMOTE INFILTRATION. 8. CONTRACTOR SHALL WATER ALL NEWLY SODDED/SEEDED AREAS DURING THE SUMMER MONTHS

7. CONTRACTOR SHALL CHISEL-PLOW OR DEEP TILL WITH DOUBLE TINES ALL STORMWATER MANAGEMENT

- WHENEVER THERE IS A 7 DAY LAPSE WITH NO SIGNIFICANT RAINFALL. 9. CONTRACTOR TO DEEP TILL ALL COMPACTED PERVIOUS SURFACES PRIOR TO SODDING AND/OR
- 10. ALL SLOPES 20% OR GREATER SHALL BE TEMPORARY SEEDED, MULCHED, OR OTHER MEANS OF COVER PLACED ON THEM WITHIN 2 WEEKS OF DISTURBANCE.
- 11. ALL EXPOSED SOIL AREAS THAT WILL NOT BE BROUGHT TO FINAL GRADE OR ON WHICH LAND DISTURBING ACTIVITIES WILL NOT BE PERFORMED FOR A PERIOD GREATER THAN 30 DAYS AND REQUIRE VEGETATIVE COVER FOR LESS THAN 1 YEAR, REQUIRE TEMPORARY SEEDING FOR EROSION CONTROL. SEEDING FOR EROSION CONTROL SHALL BE IN ACCORDANCE WITH WDNR TECHNICAL STANDARD 1059 AND CITY OF MADISON ORDINANCE.

#### **UTILITY NOTES**

- ALL EXISTING UTILITIES ARE SHOWN FOR INFORMATIONAL PURPOSES ONLY AND ARE NOT GUARANTEED TO BE ACCURATE OR ALL INCLUSIVE. THE CONTRACTOR IS RESPONSIBLE FOR MAKING HIS OWN DETERMINATION AS TO THE TYPE AND LOCATIONS OF UNDERGROUND UTILITIES AS MAY BE NECESSARY TO AVOID DAMAGE THERETO. CONTRACTOR/OWNER SHALL CALL "DIGGER'S HOTLINE" PRIOR TO ANY CONSTRUCTION.
- PRIOR TO CONSTRUCTION, THE PRIME CONTRACTOR IS RESPONSIBLE FOR: EXAMINING ALL SITE CONDITIONS RELATIVE TO THE CONDITIONS INDICATED ON THE ENGINEERING DRAWINGS. ANY DISCREPANCIES ARE TO BE REPORTED TO THE ENGINEER AND RESOLVED PRIOR TO THE START OF CONSTRUCTION. OBTAINING ALL PERMITS INCLUDING PERMIT COSTS, TAP FEES, METER DEPOSITS, BONDS, AND ALL OTHER FEES REQUIRED FOR PROPOSED WORK TO OBTAIN OCCUPANCY.
- VERIFYING ALL ELEVATIONS, LOCATIONS AND SIZES OF SANITARY, WATER AND STORM LATERALS AND CHECK ALL UTILITY CROSSINGS FOR CONFLICTS. NOTIFY ENGINEER OF DISCREPANCY. NO WORK SHALL BE PERFORMED UNTIL THE DISCREPANCY IS RESOLVED. NOTIFYING ALL UTILITIES PRIOR TO INSTALLATION OF ANY UNDERGROUND IMPROVEMENTS NOTIFYING THE DESIGN ENGINEER AND MUNICIPALITY 48 HOURS PRIOR TO THE START OF

COORDINATING ALL CONSTRUCTION WITH OTHER CONTRACTORS INVOLVED WITH CONSTRUCTION

OF THE PROPOSED DEVELOPMENT AND FOR REPORTING ANY ERRORS OR DISCREPANCIES

BETWEEN THESE PLANS AND PLANS PREPARED BY OTHERS. 3. ALL UTILITY WORK SHALL BE DONE IN ACCORDANCE WITH THE STANDARD SPECIFICATIONS FOR SEWER AND WATER CONSTRUCTION IN WISCONSIN - AND ALL STATE AND LOCAL CODES AND SPECIFICATIONS. IT IS THE CONTRACTORS RESPONSIBILITY TO DETERMINE WHICH SPECIFICATIONS AND CODES APPLY,

CONSTRUCTION TO ARRANGE FOR APPROPRIATE CONSTRUCTION OBSERVATION.

- SPECIFICATIONS SHALL COMPLY WITH THE CITY OF MADISON SPECIAL PROVISIONS.
- LENGTHS OF ALL UTILITIES ARE TO CENTER OF STRUCTURES OR FITTINGS AND MAY VARY SLIGHTLY FROM PLAN. LENGTHS SHALL BE VERIFIED IN THE FIELD DURING CONSTRUCTION.

OVER NIGHT AS REQUIRED IN CONSTRUCTION SITES WHERE THE POTENTIAL FOR PEDESTRIAN INJURY

AND TO COORDINATE ALL CONSTRUCTION ACTIVITIES WITH THE APPROPRIATE LOCAL AND STATE

- 6. CONTRACTOR IS RESPONSIBLE FOR SITE SAFETY DURING THE CONSTRUCTION OF IMPROVEMENTS. CONTRACTOR SHALL INSTALL A PEDESTRIAN FENCE AROUND ALL EXCAVATIONS TO BE LEFT OPEN
- CONTRACTOR SHALL ADJUST AND/OR RECONSTRUCT ALL UTILITY COVERS (SUCH AS MANHOLE COVERS, VALVE BOX COVERS, ETC.) TO MATCH THE FINISHED GRADES OF THE AREAS EFFECTED BY THE
- THE PRIME CONTRACTOR IS RESPONSIBLE FOR COORDINATING ALL CONSTRUCTION WITH OTHER CONTRACTORS INVOLVED WITH CONSTRUCTION OF THE PROPOSED DEVELOPMENT AND FOR REPORTING ANY ERRORS OR DISCREPANCIES BETWEEN THESE PLANS AND PLANS PREPARED BY OTHERS. 10. ANY SANITARY SEWER, SANITARY SEWER SERVICES, WATER MAIN, WATER SERVICES, STORM SEWER,

OR OTHER UTILITIES, WHICH ARE DAMAGED BY THE CONTRACTORS, SHALL BE REPAIRED TO THE

11. THE CONTRACTOR IS RESPONSIBLE FOR PROVIDING THE ENGINEER WITH AS-BUILT CONDITIONS OF THE DESIGNATED IMPROVEMENTS IN ORDER THAT THE APPROPRIATE DRAWINGS CAN BE PREPARED, IF REQUIRED. ANY CHANGES TO THE DRAWINGS OR ADDITIONAL ITEMS MUST BE REPORTED TO THE ENGINEER AS WORK PROGRESSES.

#### 12. STORM SEWER SPECIFICATIONS -

OWNER'S SATISFACTION AT THE CONTRACTOR'S EXPENSE.

PIPE - REINFORCED CONCRETE PIPE (RCP) SHALL MEET THE REQUIREMENTS OF ASTM CLASS III (MINIMUM) C-76 WITH RUBBER GASKET JOINTS CONFORMING TO ASTM C-443. HIGH DENSITY DUAL-WALL POLYETHYLENE CORRUGATED PIPE SHALL BE AS MANUFACTURED BY ADS OR EQUAL WITH WATER TIGHT JOINTS, AND SHALL MEET THE REQUIREMENTS OF AASHTO DESIGNATION M-294 TYPE

- INLETS INLETS SHALL BE CONSTRUCTED IN ACCORDANCE WITH FILE. NO. 28 OF THE "STANDARD SPECIFICATIONS", OR APPROVED EQUAL WITH A 1'-8" X 2'-6" MAXIMUM OPENING. CURB FRAME & GRATE SHALL BE NEENAH R-3067 WITH TYPE R GRATE, OR EQUAL. BACKFILL AND BEDDING - STORM SEWER SHALL BE CONSTRUCTED WITH GRAVEL BACKFILL AND CLASS "B" BEDDING IN ALL PAVED AREAS AND TO A POINT 5 FEET BEYOND THE EDGE OF PAVEMENT. TRENCHES RUNNING PARALLEL TO AND LESS THAN 5 FEET FROM THE EDGE OF PAVEMENT SHALL ALSO REQUIRE GRAVEL BACKFILL. LANDSCAPED AREAS MAY BE BACKFILLED WITH EXCAVATED MATERIAL IN CONFORMANCE WITH SECTION 8.43.5 OF THE "STANDARD SPECIFICATIONS".
- MANHOLE FRAMES AND COVERS MANHOLE FRAMES AND COVERS SHALL BE AS SHOWN ON SHEET
- FIELD TILE CONNECTION ALL FIELD TILE ENCOUNTERED DURING CONSTRUCTION SHALL BE INCLUDED IN THE UNIT PRICE(S) FOR STORM SEWER. TILE LINES CROSSED BY THE TRENCH SHALL BE REPLACED WITH THE SAME MATERIAL AS THE STORM SEWER.
- 13. WATER MAIN SPECIFICATIONS -PIPE - DUCTILE IRON PIPE SHALL BE CLASS 52 CONFORMING TO AWWA C151 AND CHAPTER 8.18.0 OF THE "STANDARD SPECIFICATIONS". POLYVINYL CHLORIDE (PVC) PIPE SHALL MEET THE REQUIREMENTS OF AWWA STANDARD C-900, CLASS 150, DR-18, WITH CAST IRON O.D. AND INTEGRAL
- ELASTOMERIC BELL AND SPIGOT JOINTS. NON-METALLIC WATER MAINS SHALL BE INSTALLED WITH BLUE INSULATION TRACER WIRE AND CONFORM WITH SPS 382.30(11)(h). VALVES AND VALVE BOXES - GATE VALVES SHALL BE AWWA GATE VALVES MEETING THE REQUIREMENTS OF AWWA C-500 AND CHAPTER 8.27.0 OF THE "STANDARD SPECIFICATIONS". GATE VALVES AND VALVE BOXES SHALL CONFORM TO LOCAL PLUMBING ORDINANCES.
- HYDRANTS HYDRANTS SHALL CONFORM TO THE SPECIFICATIONS OF THE CITY OF MADISON. THE DISTANCE FROM THE GROUND LINE TO THE CENTERLINE OF THE LOWEST NOZZLE AND THE LOWEST CONNECTION OF THE FIRE DEPARTMENT SHALL BE NO LESS THAN 18-INCHES AND NO GREATER THAN 23-INCHES (SEE DETAIL).
- BEDDING AND COVER MATERIAL PIPE BEDDING AND COVER MATERIAL SHALL BE SAND, CRUSHED STONE CHIPS OR CRUSHED STONE SCREENINGS CONFORMING TO CHAPTER 8.43.2 OF THE "STANDARD SPECIFICATIONS"
- BACKFILL BACKFILL MATERIAL AND INSTALLATION SHALL BE IN ACCORDANCE WITH CHAPTER 2.6.0 OF THE "STANDARD SPECIFICATIONS". GRAVEL BACKFILL IS REQUIRED IN ALL PAVED AREAS AND TO A POINT 5 FEET BEYOND THE EDGE OF PAVEMENT. TRENCHES RUNNING PARALLEL TO AND LESS THAN 5 FEET FROM THE EDGE OF PAVEMENT SHALL ALSO REQUIRE GRAVEL BACKFILL. LANDSCAPED AREAS MAY BE BACKFILLED WITH EXCAVATED MATERIAL IN CONFORMANCE WITH SECTION 8.43.5 OF THE
- "STANDARD SPECIFICATIONS". 14. SANITARY SEWER SPECIFICATIONS -
- PIPE SANITARY SEWER PIPE MATERIAL SHALL BE POLYVINYL CHLORIDE (PVC) MEETING REQUIREMENTS OF ASTM D 3034, SDR-35, WITH INTEGRAL BELL TYPE FLEXIBLE ELASTOMERIC JOINTS, MEETING THE REQUIREMENTS OF ASTM D-3212.
- BEDDING AND COVER MATERIAL BEDDING AND COVER MATERIAL SHALL CONFORM TO THE APPROPRIATE SECTIONS OF THE "STANDARD SPECIFICATION" WITH THE FOLLOWING MODIFICATION: "COVER MATERIAL SHALL BE THE SAME AS USED FOR BEDDING AND SHALL CONFORM TO SECTION 8.43.2 (A). BEDDING AND COVER MATERIAL SHALL BE PLACED IN A MINIMUM OF THREE SEPARATE LIFTS, OR AS REQUIRED TO INSURE ADEQUATE COMPACTING OF THESE MATERIALS, WITH ONE LIFT OF BEDDING MATERIAL ENDING AT OR NEAR THE SPRINGLINE OF THE PIPE. THE CONTRACTOR SHALL TAKE CARE TO COMPLETELY WORK BEDDING MATERIAL UNDER THE HAUNCH OF THE PIPE TO PROVIDE ADEQUATE SIDE SUPPORT."
- "STANDARD SPECIFICATIONS." GRAVEL BACKFILL IS REQUIRED IN ALL PAVED AREAS AND TO A POINT 5 FEET BEYOND THE EDGE OF PAVEMENT. TRENCHES RUNNING PARALLEL TO AND LESS THAN 5 FEET FROM THE EDGE OF PAVEMENT SHALL ALSO REQUIRE GRAVEL BACKFILL. LANDSCAPED AREAS MAY BE BACKFILLED WITH EXCAVATED MATERIAL IN CONFORMANCE WITH SECTION 8.43.5 OF THE "STANDARD

BACKFILL - BACKFILL MATERIAL AND INSTALLATION SHALL BE IN ACCORDANCE CHAPTER 2.6.0 OF THE

- MANHOLES MANHOLES SHALL BE CONSTRUCTED IN ACCORDANCE WITH FILE NOS. 12, 13 AND 15 OF THE "STANDARD SPECIFICATIONS" AND ALL SPECIAL PROVISIONS OF THE CITY OF MADISON. MANHOLE FRAMES AND COVERS - MANHOLE FRAMES AND COVERS SHALL BE AS SHOWN ON SHEET
- 15. WATERMAIN AND SANITARY SEWER SHALL BE INSULATED WHEREVER THE DEPTH OF COVER IS LESS THAN 6 FEET. INSULATION AND INSTALLATION OF INSULATION SHALL BE CONFORMING WITH CHAPTER 4.17.0 "INSULATION" OF THE STANDARD SPECIFICATIONS FOR SEWER AND WATER CONSTRUCTION IN WISCONSIN 6TH EDITION UPDATED WITH ITS LATEST ADDENDUM (TYP.).

#### CITY FORESTRY NOTES

- 1. ALL PROPOSED STREET TREE REMOVALS WITHIN THE RIGHT OF WAY SHALL BE REVIEWED BY CITY FORESTRY BEFORE THE PLAN COMMISSION MEETING. STREET TREE REMOVALS REQUIRE APPROVAL AND A TREE REMOVAL PERMIT ISSUED BY CITY FORESTRY. ANY STREET TREE REMOVALS REQUESTED AFTER THE DEVELOPMENT PLAN IS APPROVED BY THE PLAN COMMISSION OR THE BOARD OF PUBLIC WORKS AND CITY FORESTRY WILL REQUIRE A MINIMUM OF A 72-HOUR REVIEW PERIOD WHICH SHALL INCLUDE THE NOTIFICATION OF THE ALDERPERSON WITHIN WHO'S DISTRICT IS AFFECTED BY THE STREET TREE REMOVAL(S) PRIOR TO A TREE REMOVAL PERMIT BEING ISSUED.
- 2. AS DEFINED BY THE SECTION 107.13 OF CITY OF MADISON STANDARD SPECIFICATIONS FOR PUBLIC WORKS CONSTRUCTION: NO EXCAVATION IS PERMITTED WITHIN 5 FEET OF THE TRUNK OF THE STREET TREE OR WHEN CUTTING ROOTS OVER 3 INCHES IN DIAMETER. IF EXCAVATION IS NECESSARY, THE CONTRACTOR SHALL CONTACT MADISON CITY FORESTRY (266-4816) PRIOR TO EXCAVATION. CITY OF MADISON FORESTRY PERSONNEL SHALL ASSESS THE IMPACT TO THE TREE AND TO ITS ROOT SYSTEM PRIOR TO WORK COMMENCING. TREE PROTECTION SPECIFICATIONS CAN BE FOUND ON THE FOLLOWING WEBSITE: HTTPS: //WWW.CITYOFMADISON.COM/BUSINESS/PW/SPECS.CFM
- 3. CONTRACTOR SHALL TAKE PRECAUTIONS DURING CONSTRUCTION TO NOT DISFIGURE, SCAR, OR IMPAIR THE HEALTH OF ANY STREET TREE. CONTRACTOR SHALL OPERATE EQUIPMENT IN A MANNER AS TO NOT DAMAGE THE BRANCHES OF THE STREET TREE(S). THIS MAY REQUIRE USING SMALLER EQUIPMENT AND LOADING AND UNLOADING MATERIALS IN A DESIGNATED SPACE AWAY FROM TREES ON THE CONSTRUCTION SITE. ANY DAMAGE OR INJURY TO EXISTING STREET TREES (EITHER ABOVE OR BELOW GROUND) SHALL BE REPORTED IMMEDIATELY TO CITY FORESTRY AT 266-4816. PENALTIES AND REMEDIATION SHALL BE
- 4. SECTION 107.13(G) OF CITY OF MADISON STANDARD SPECIFICATIONS FOR PUBLIC WORKS CONSTRUCTION ADDRESSES SOIL COMPACTION NEAR STREET TREES AND SHALL BE FOLLOWED. BY CONTRACTOR. THE STORAGE OF PARKED VEHICLES, CONSTRUCTION EQUIPMENT, BUILDING MATERIALS, REFUSE, EXCAVATED SPOILS OR DUMPING OF POISONOUS MATERIALS ON OR AROUND TREES AND ROOTS WITHIN FIVE (5) FEET OF THE TREE OR WITHIN THE PROTECTION ZONE IS PROHIBITED.
- 5. ON THIS PROJECT, STREET TREE PROTECTION ZONE FENCING IS REQUIRED. THE FENCING SHALL BE ERECTED BEFORE THE DEMOLITION, GRADING OR CONSTRUCTION BEGINS. THE FENCE SHALL INCLUDE THE ENTIRE WIDTH OF TERRACE AND, EXTEND AT LEAST 5 FEET ON BOTH SIDES OF THE OUTSIDE EDGE OF THE TREE TRUNK. DO NOT REMOVE THE FENCING TO ALLOW FOR DELIVERIES OR EQUIPMENT ACCESS THROUGH THE TREE PROTECTION ZONE.
- TWO WEEKS PRIOR TO THE START OF CONSTRUCTION FOR THIS PROJECT. ALL PRUNING SHALL FOLLOW THE AMERICAN NATIONAL STANDARDS INSTITUTE (ANSI) A300 — PART 1 STANDARDS FOR PRUNING. 7. ADDITIONAL STREET TREES ARE NEEDED FOR THIS PROJECT. TREE PLANTING SPECIFICATIONS CAN BE FOUND IN SECTION 209 OF CITY OF MADISON STANDARD SPECIFICATIONS FOR PUBLIC WORKS CONSTRUCTION (WEBSITE: <a href="https://www.cityofmadison.com/business/pw/specs.cfm">https://www.cityofmadison.com/business/pw/specs.cfm</a>) — ALL STREET TREE PLANTING LOCATIONS AND TREE SPECIES WITHIN THE RIGHT OF WAY SHALL BE DETERMINED BY

5. STREET TREE PRUNING SHALL BE COORDINATED WITH MADISON FORESTRY AT A MINIMUM OF

PROJECT BOUNDARIES. 8. AT LEAST ONE WEEK PRIOR TO STREET TREE PLANTING, CONTRACTOR SHALL CONTACT CITY FORESTRY AT (608) 266-4816 TO SCHEDULE INSPECTION AND APPROVAL OF NURSERY TREE

CITY FORESTRY. A LANDSCAPE PLAN AND STREET TREE PLANTING PLAN SHALL BE SUBMITTED IN PDF

FORMAT TO CITY FORESTRY FOR APPROVAL OF PLANTING LOCATIONS WITHIN THE RIGHT OF WAY AND

TREE SPECIES. ALL AVAILABLE STREET TREE PLANTING LOCATIONS SHALL BE PLANTED WITHIN THE

#### STOCK AND REVIEW PLANTING SPECIFICATIONS WITH THE LANDSCAPER. CITY TRAFFIC ENGINEERING NOTES

THE RIGHT-OF-WAY IS THE SOLE JURISDICTION OF THE CITY OF MADISON AND IS SUBJECT TO CHANGE AT ANY TIME PER THE RECOMMENDED PLAN BY TRAFFIC ENGINEERING AND CITY ENGINEERING DEPARTMENT

#### PROPERTY LINE

— · — · — · — · — EASEMENT LINE BUILDING OUTLINE ---- BUILDING OVERHANG — BUILDING SETBACK LINE — — PAVEMENT SETBACK LINE

EDGE OF PAVEMENT STANDARD CURB AND GUTTER REJECT CURB AND GUTTER ASPHALT PAVEMENT

CONCRETE PAVEMENT HEAVY DUTY CONCRETE PAVEMENT ——959——— PROPOSED 1 FOOT CONTOUR

————960———— PROPOSED 5 FOOT CONTOUR — — ·959· — — EXISTING 1 FOOT CONTOUR DRAINAGE DIRECTION

— — — GRADE BREAK STORMWATER MANAGEMENT AREA RETAINING WALL O-□ □-O-□ < LIGHT POLE (REFER TO PHOTOMETRIC PLAN)

BIKE RACK

SAWCUT EXISTING PAVEMENT S SANITARY SEWER D STORM SEWER ———————— SILT LOG

CONSTRUCTION ENTRANCE

FRAMED INLET PROTECTION


ADA PARKING SIGN


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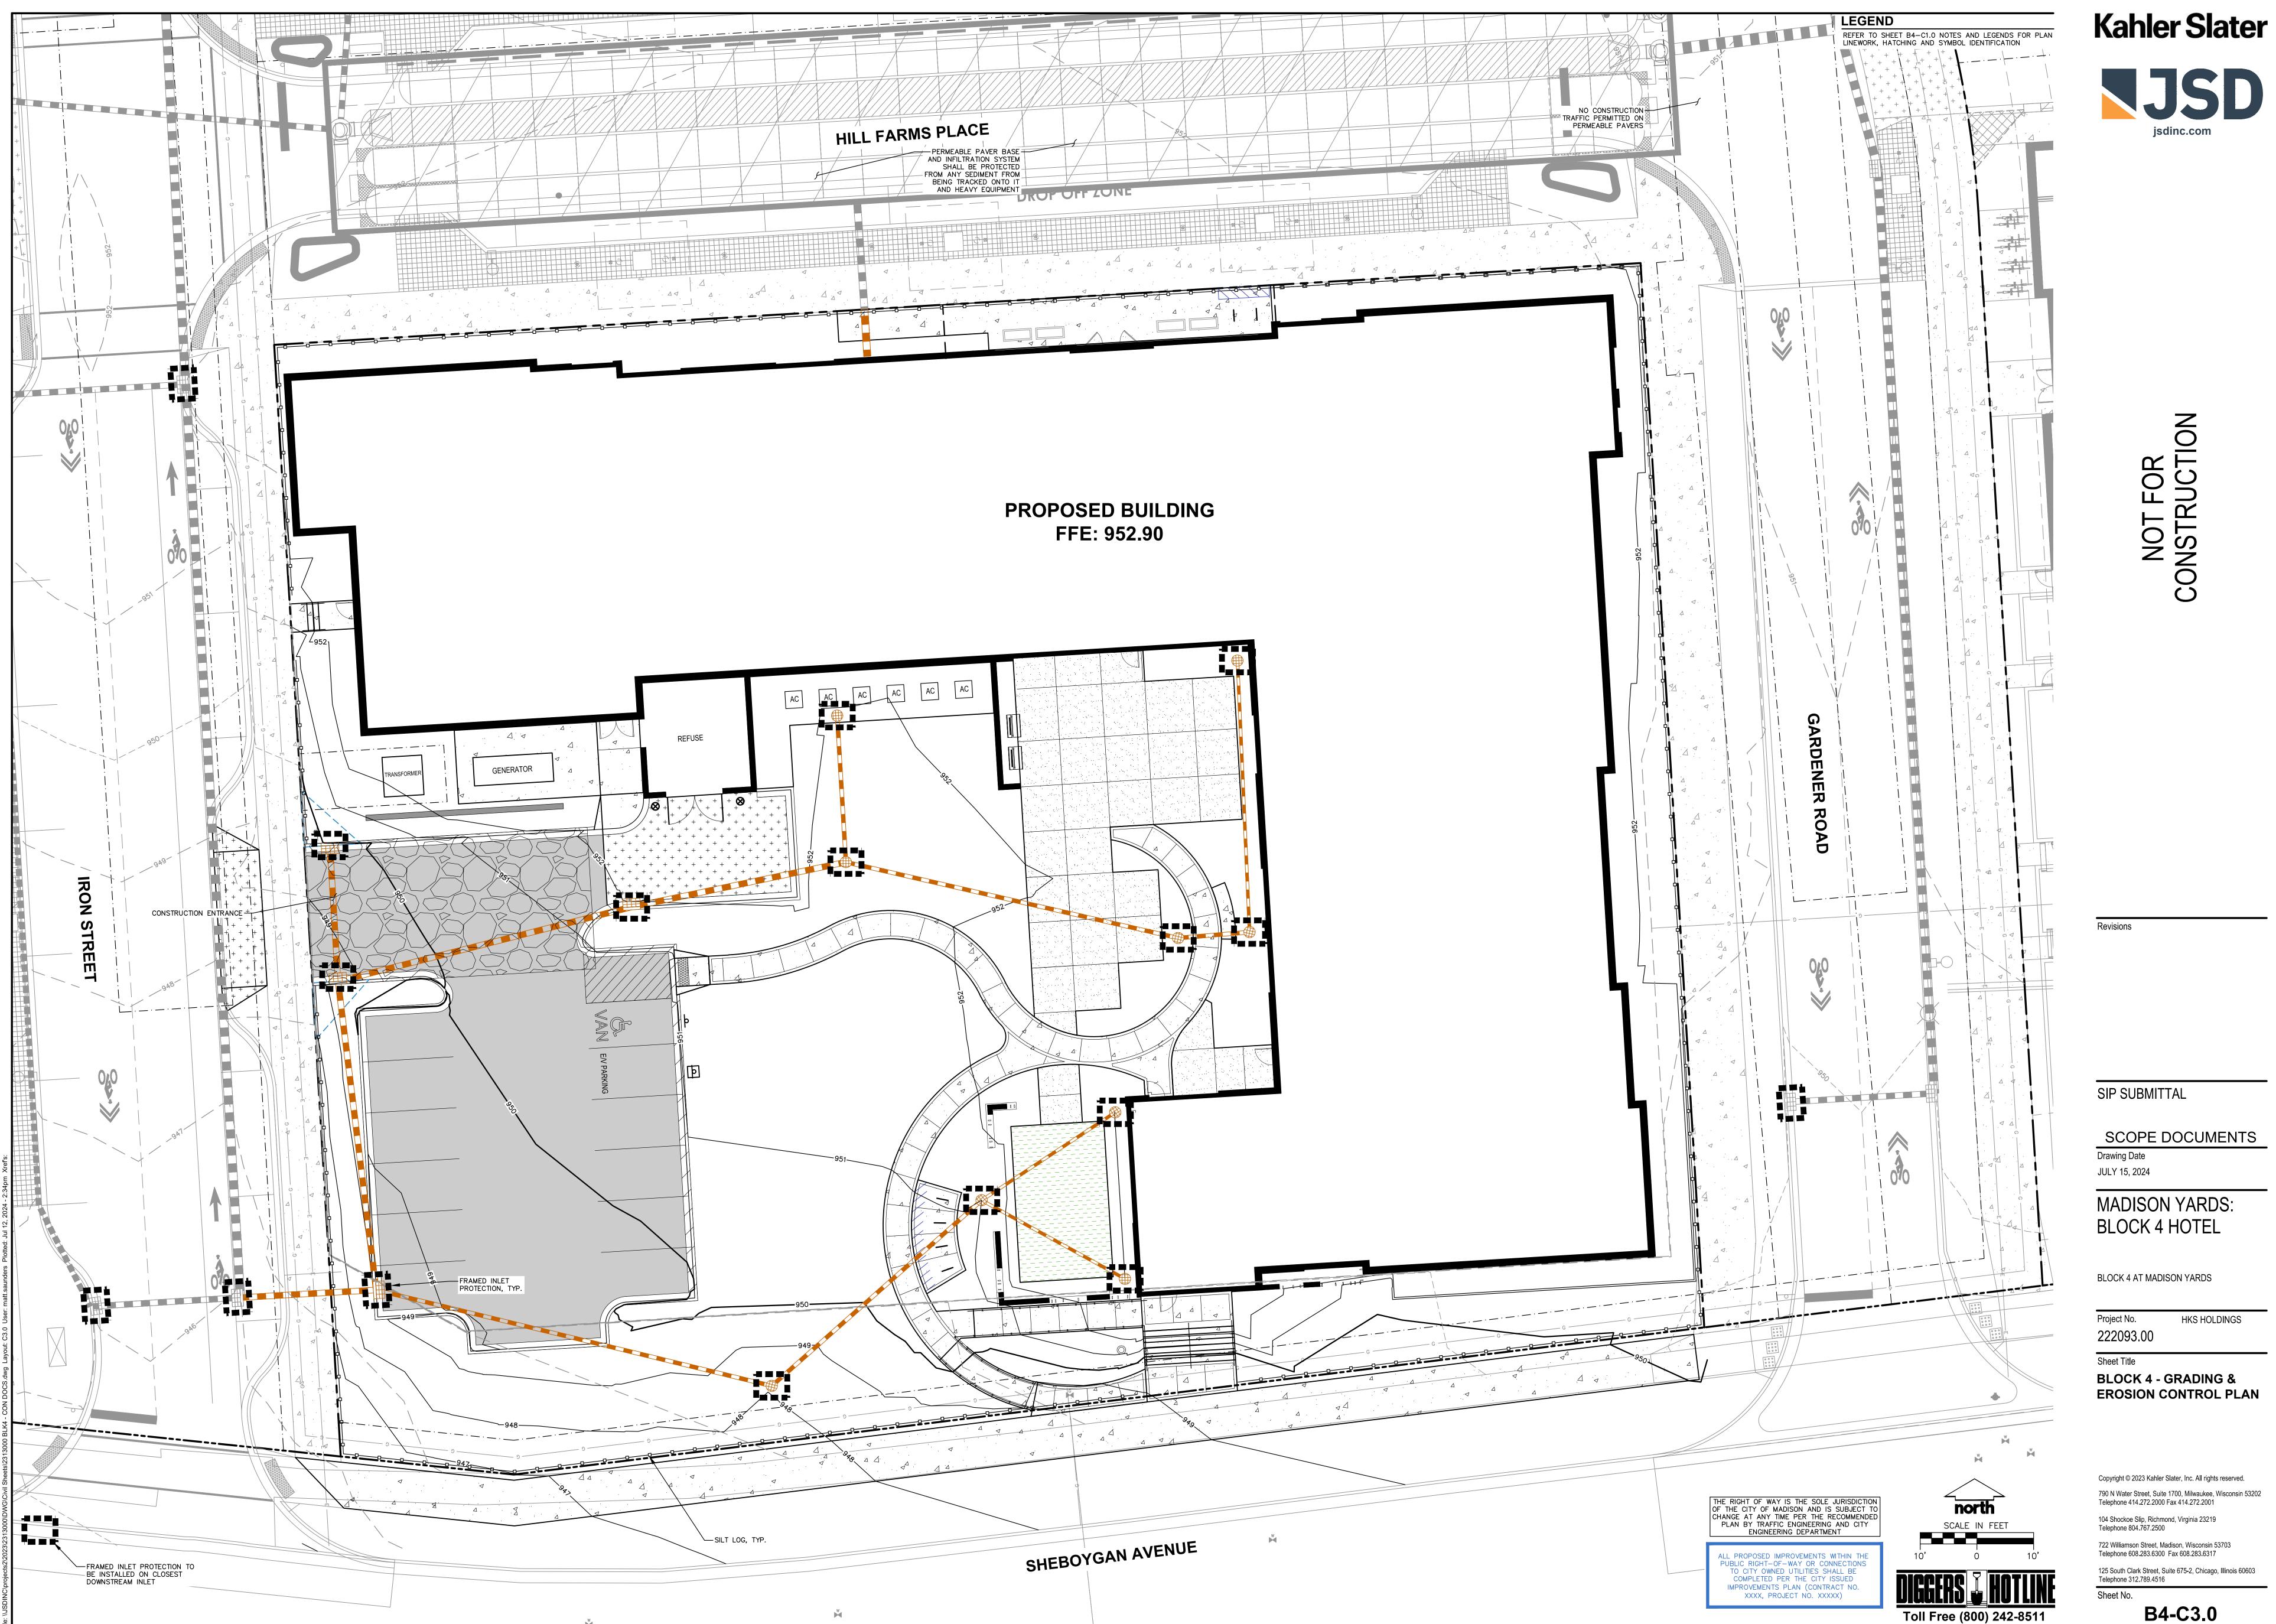
SPOT ELEVATION EP - EDGE OF PAVEMENT G - FINISH GRADE FC — FDGF OF CONCRETE BOC - BACK OF CURB MATCH - MATCH EXISTING GRADE HP - HIGH POINT SW — SIDEWALK


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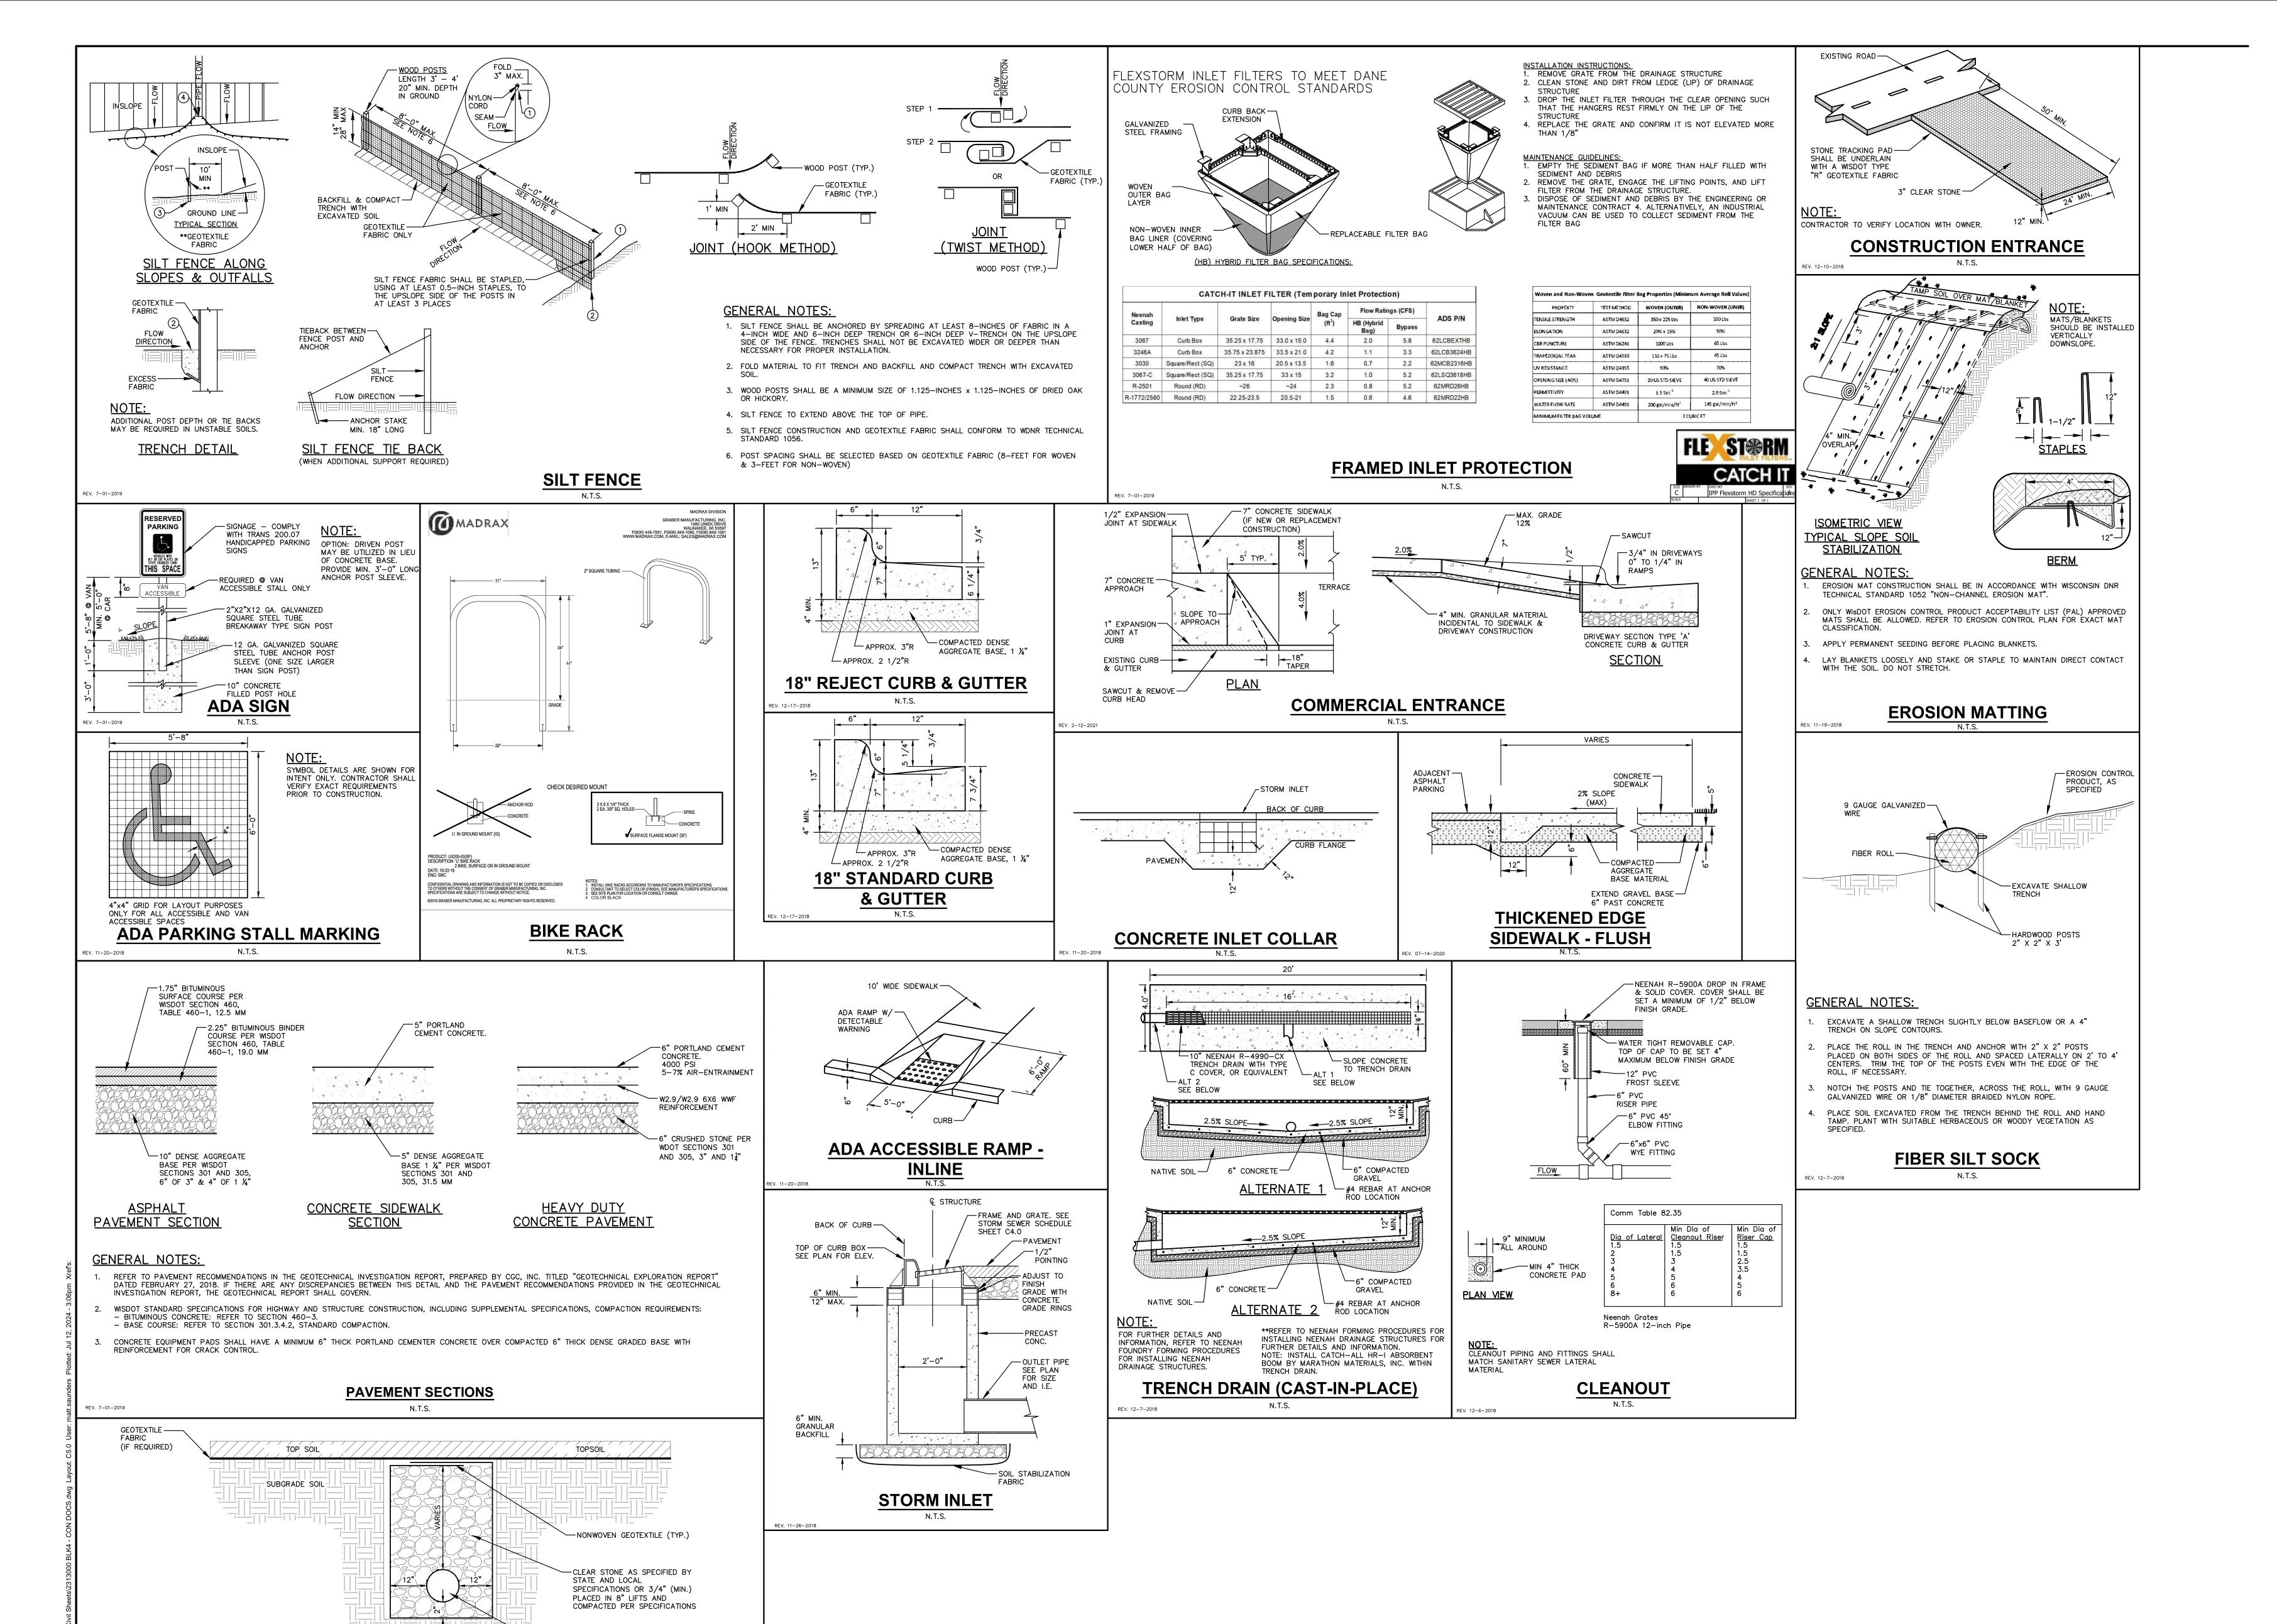
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- PERFORATED CORRUGATED

POLYETHYLENE PIPE PER

LENGTH AND SLOPE.

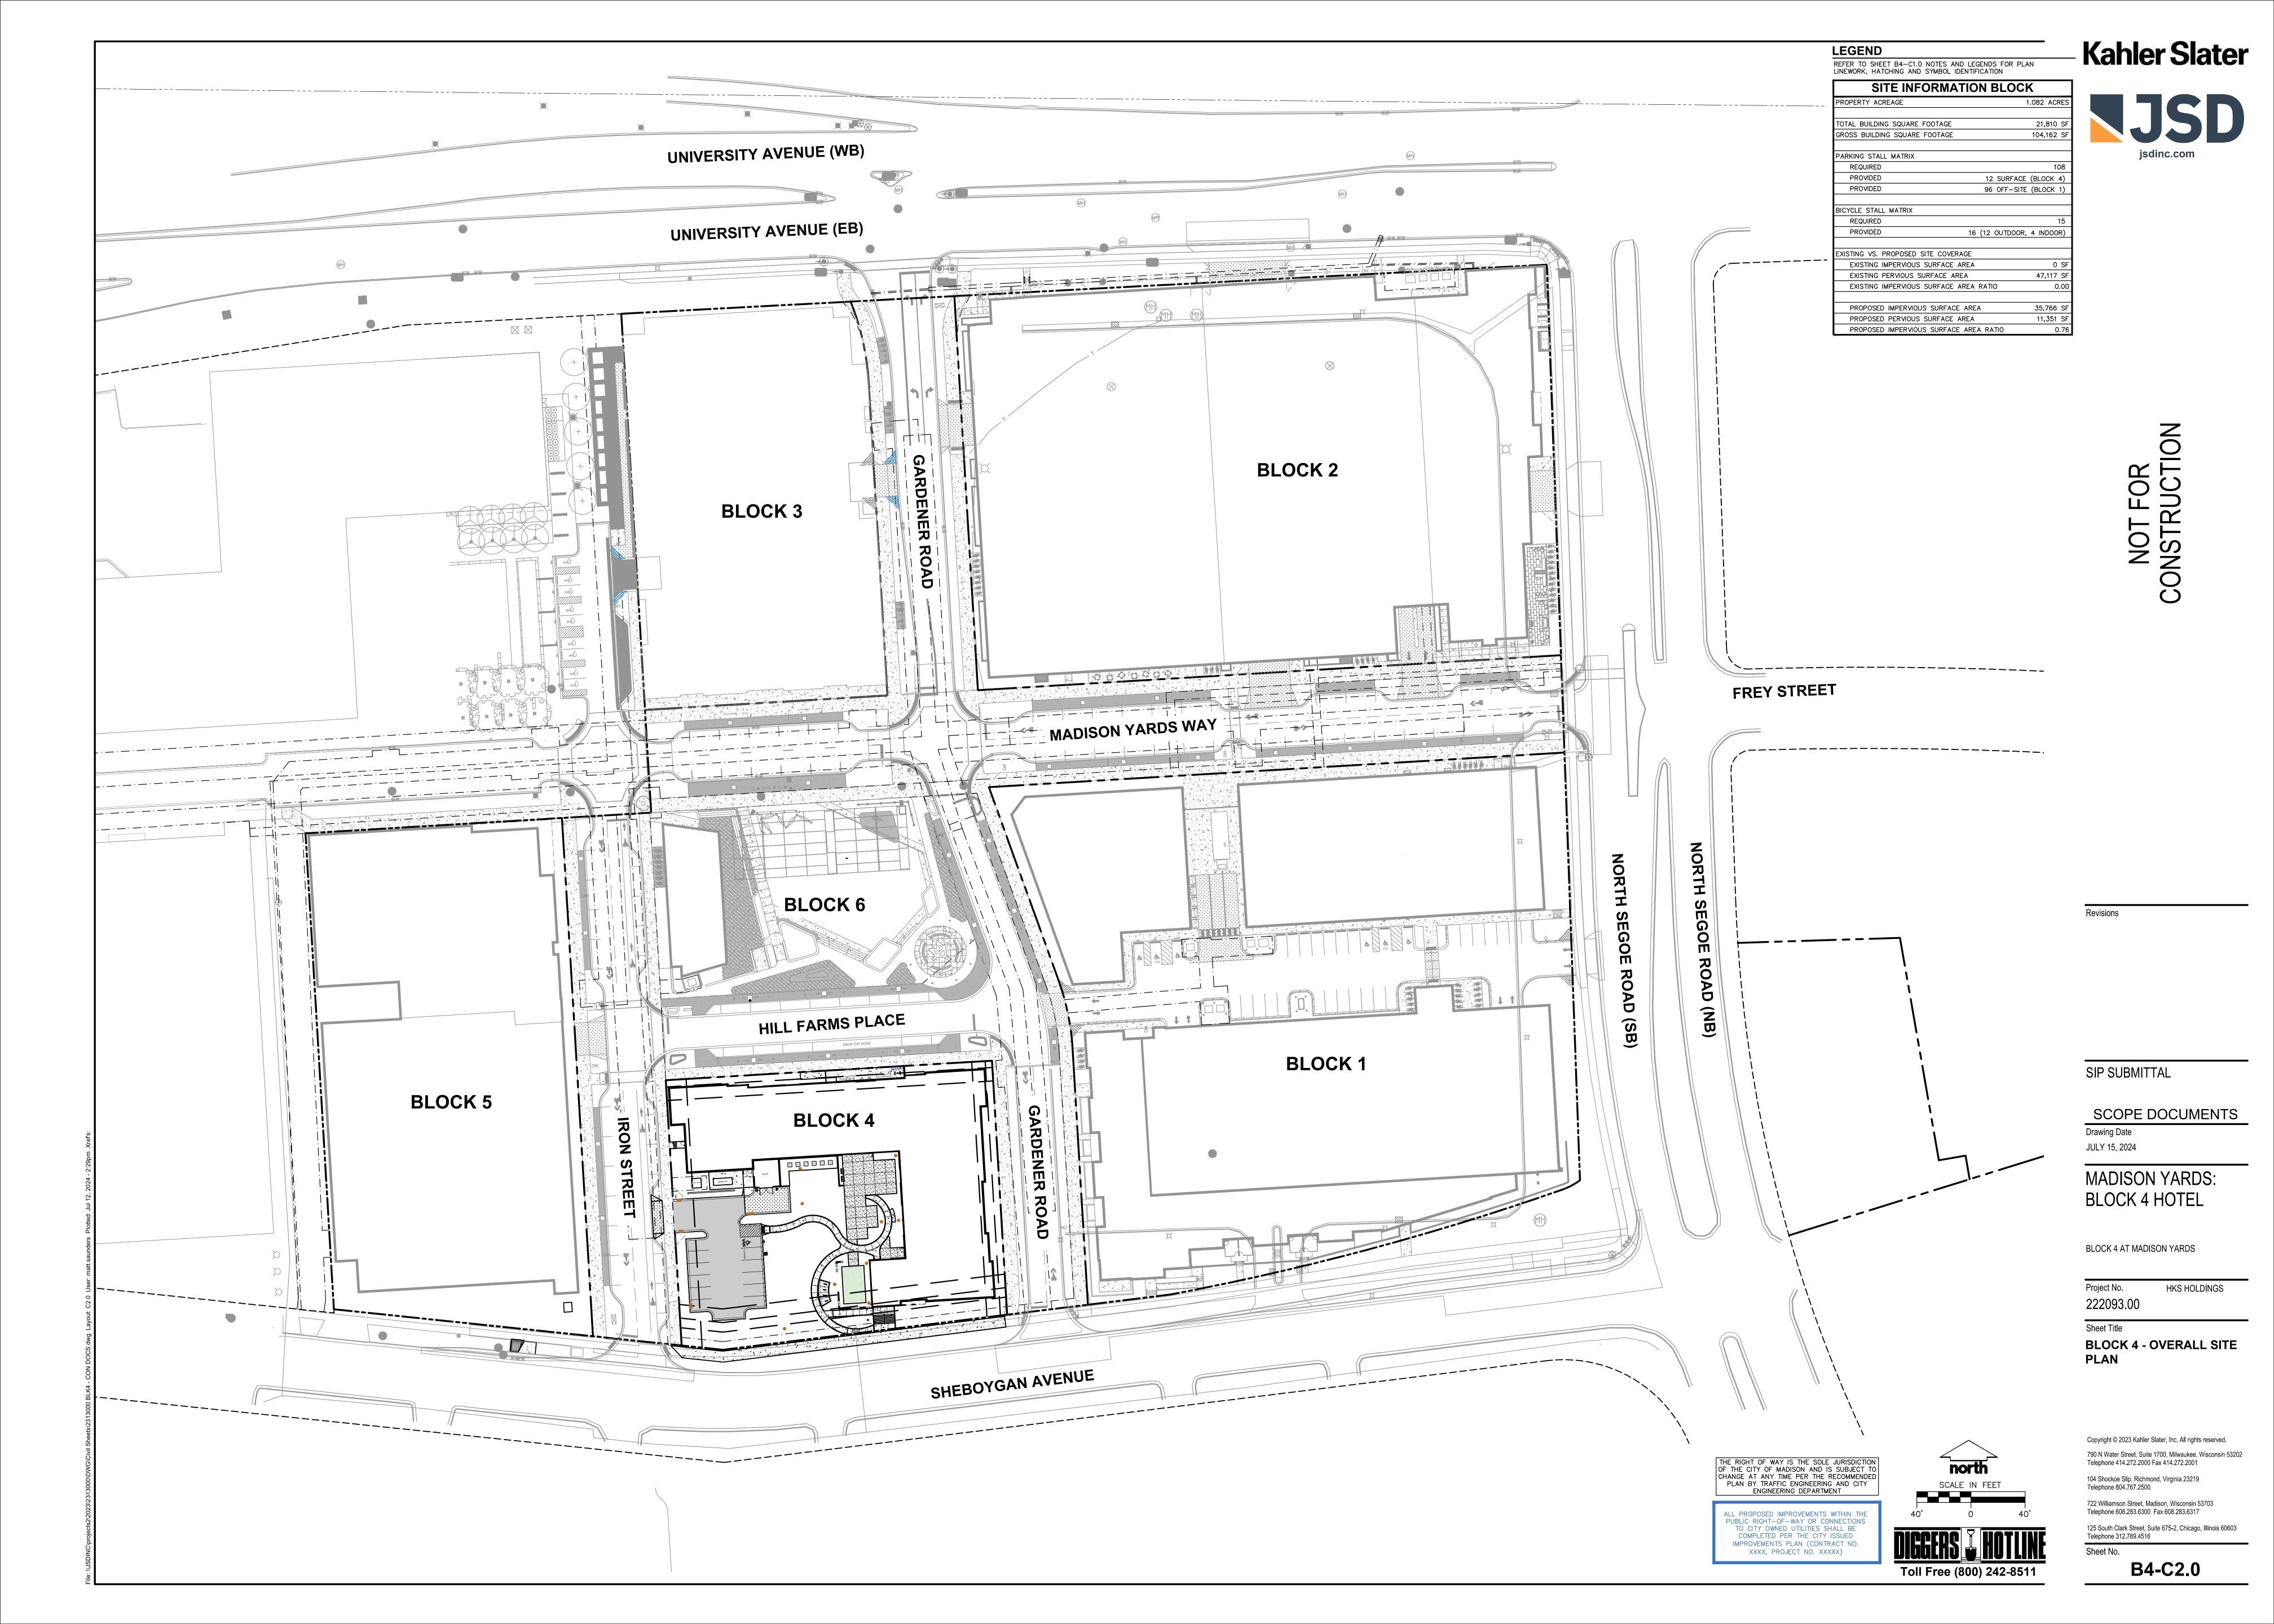**GENERAL NOTES:** 

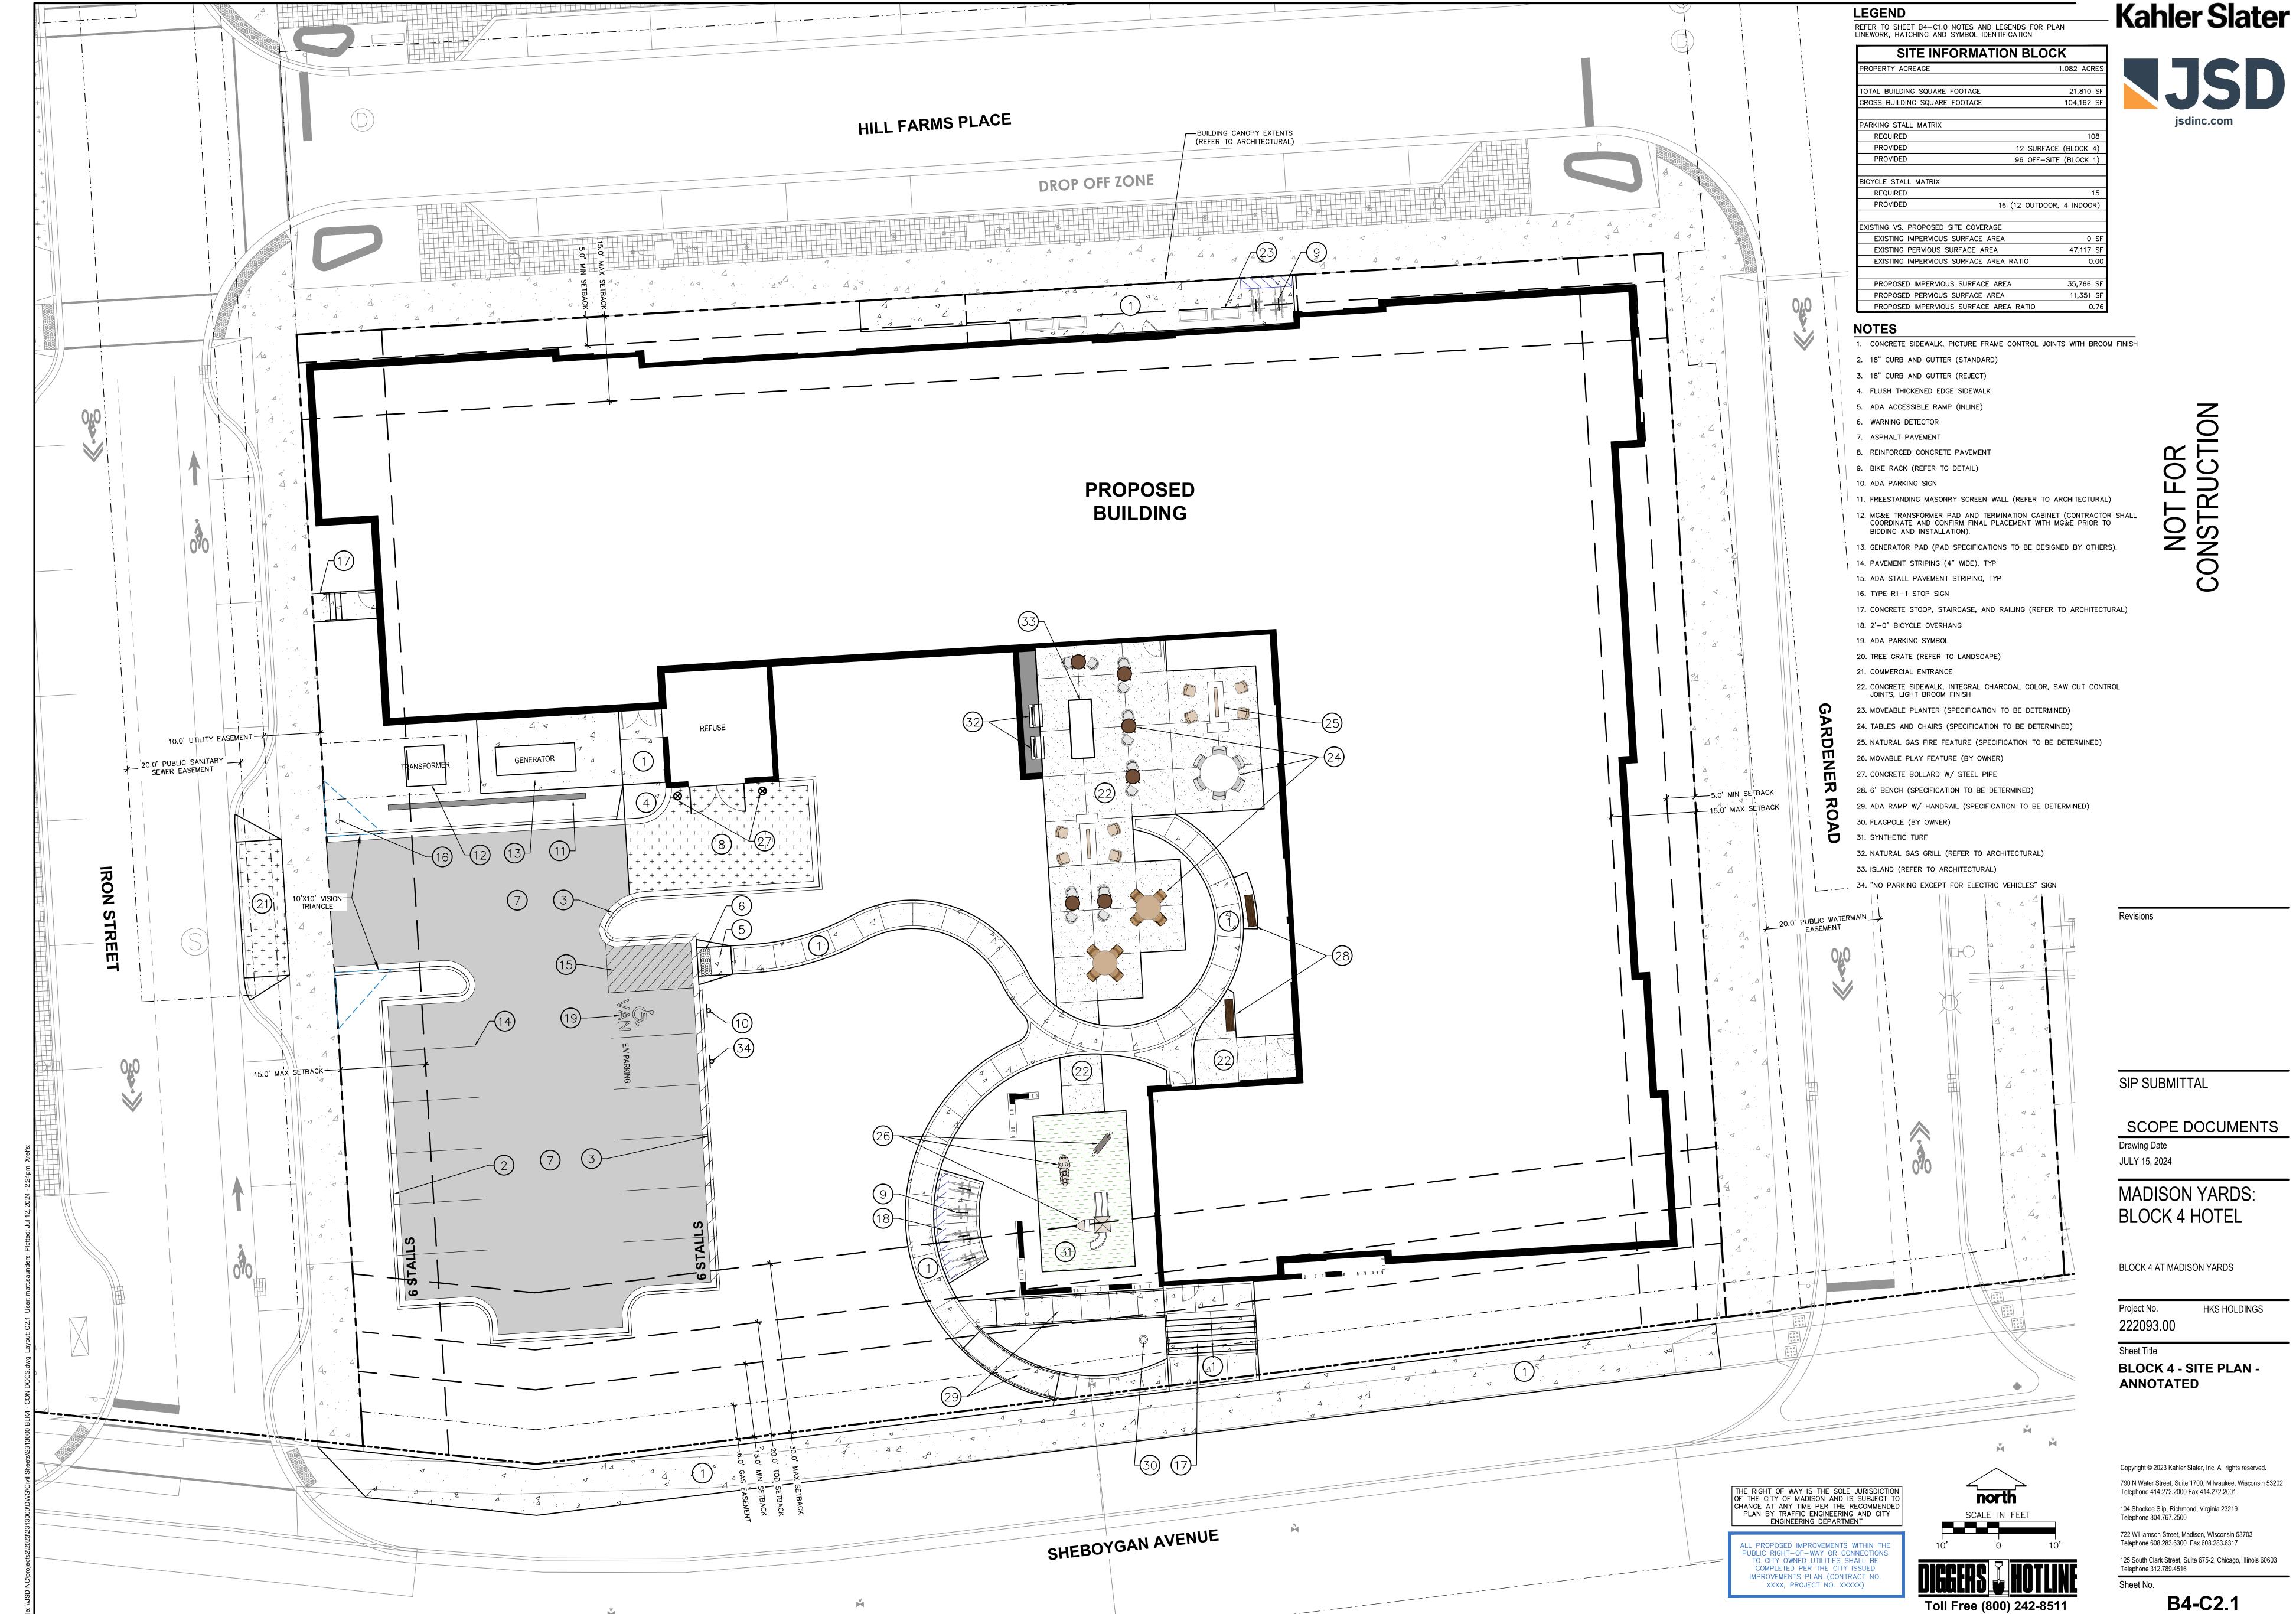OTHERWISE).

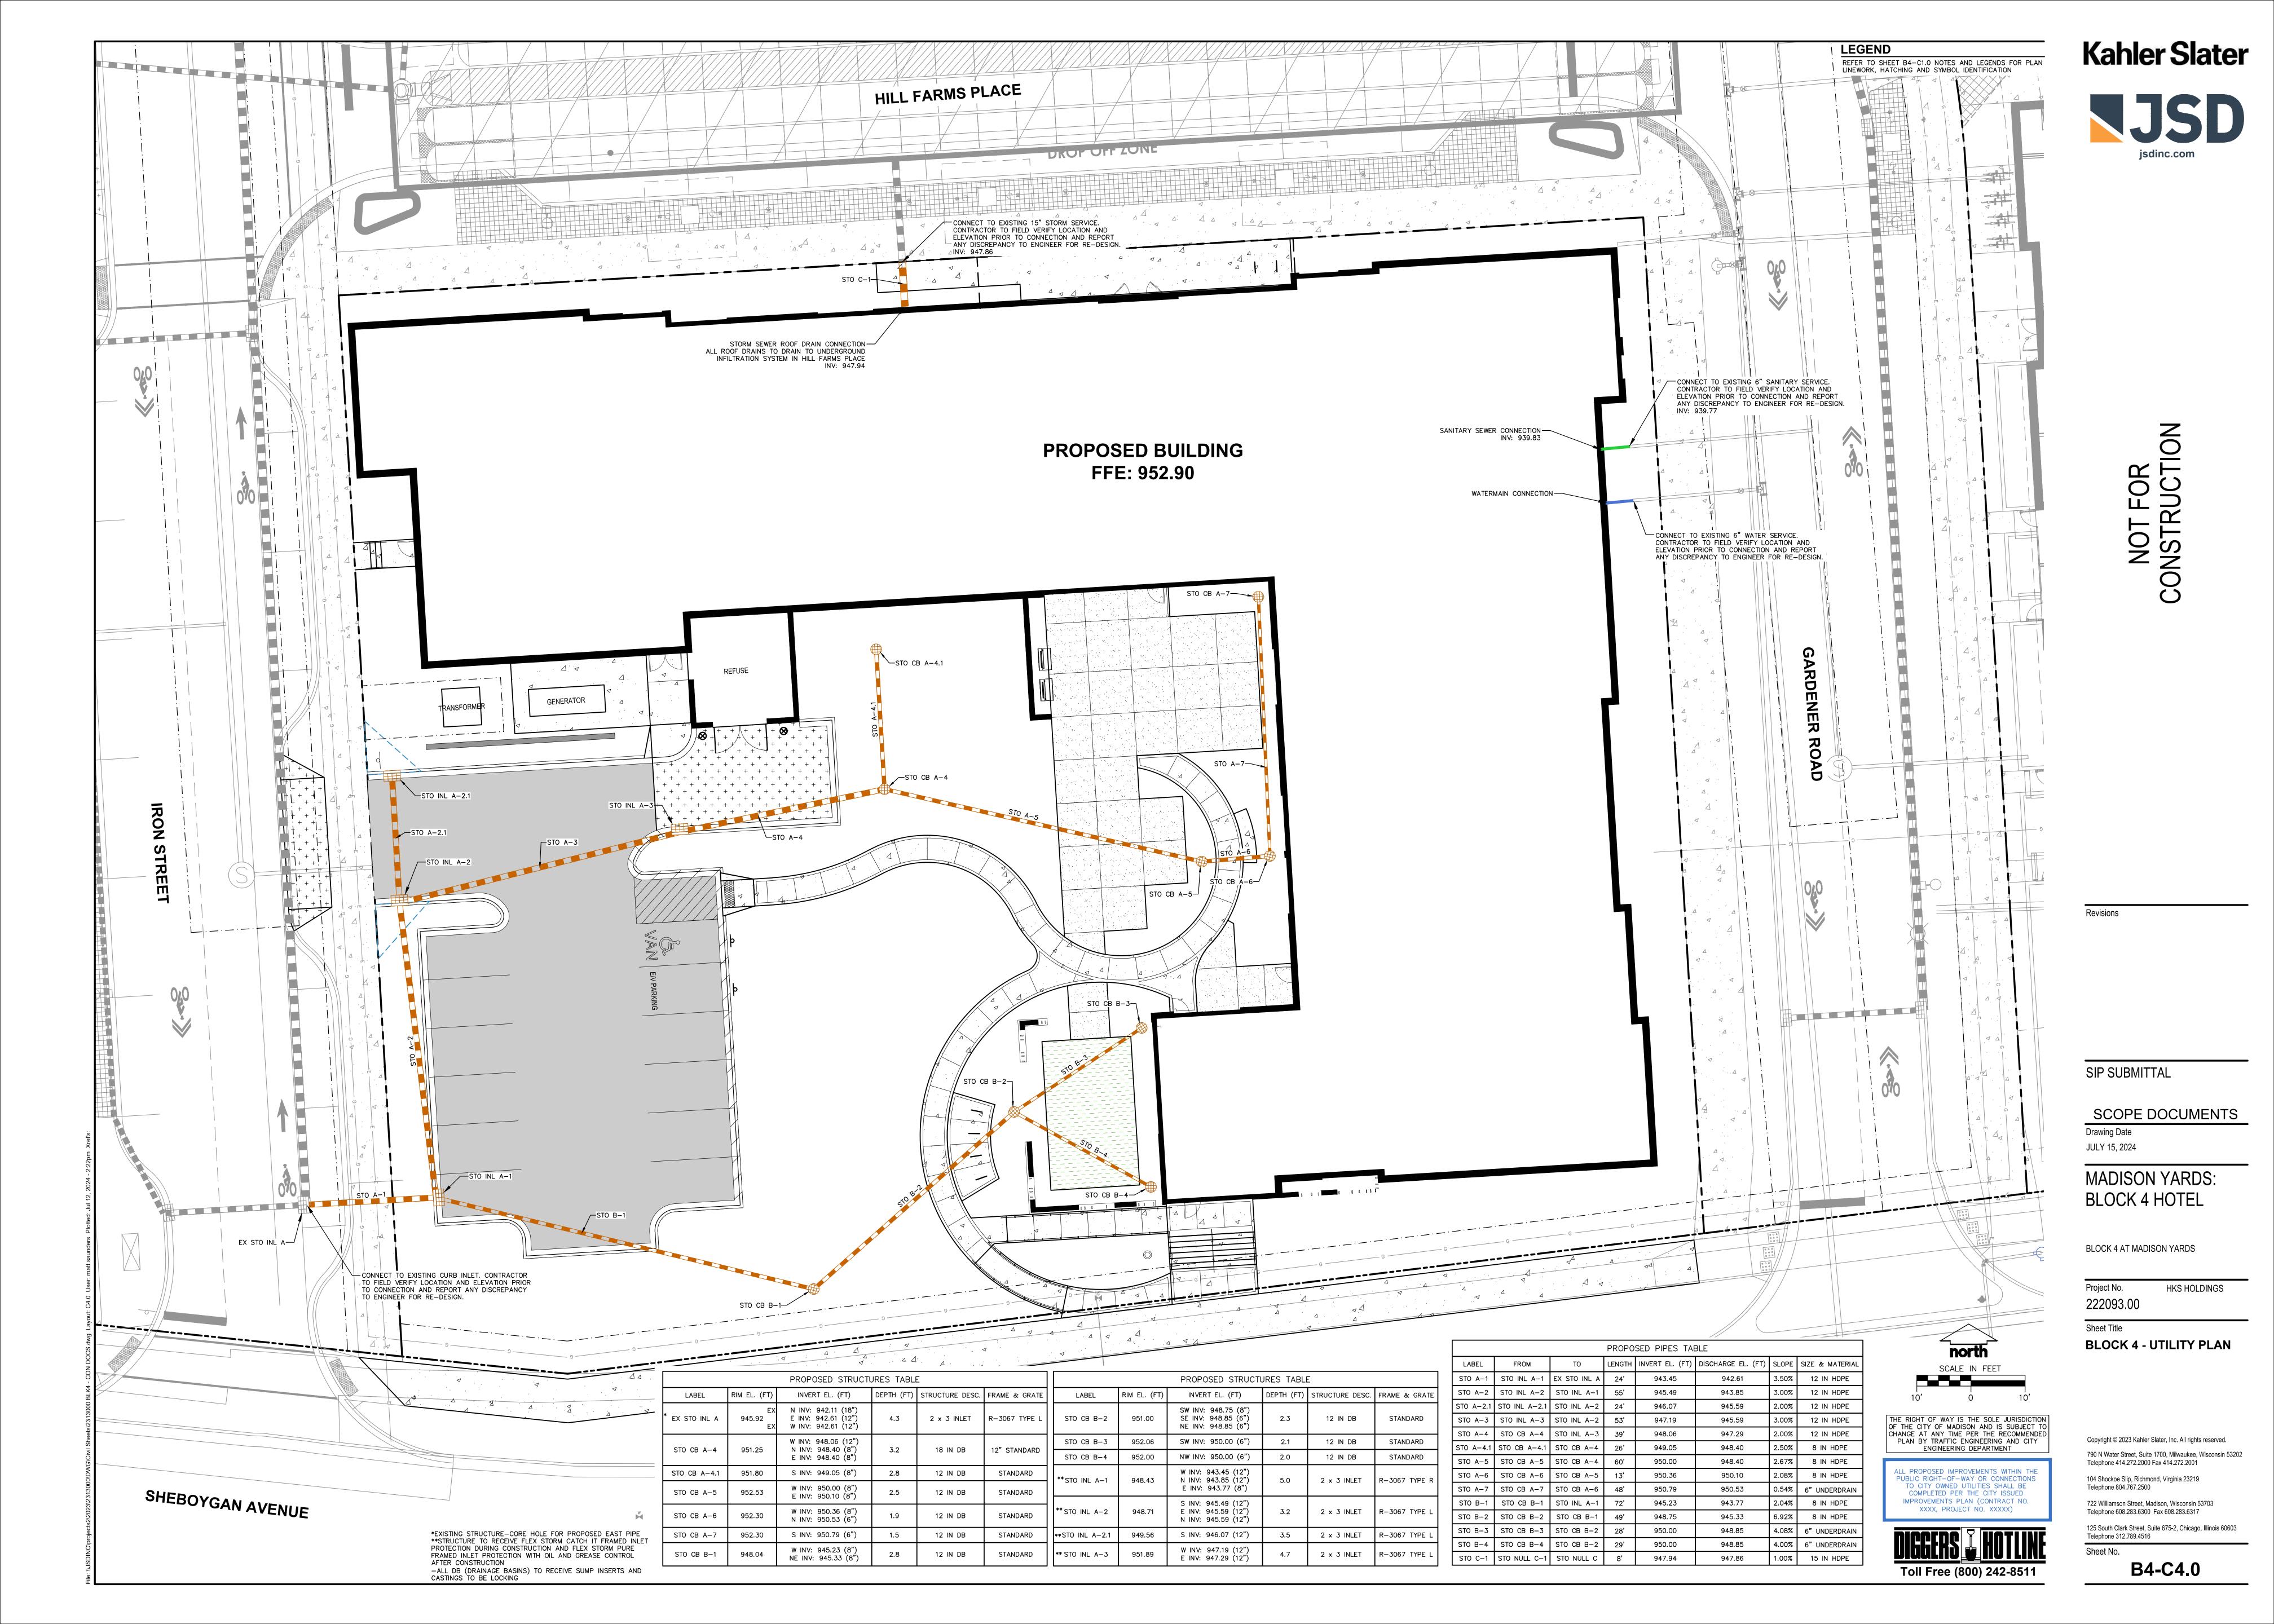1. PROTRUDING EDGES OF GEOTEXTILE SHOULD BE OVERLAPPED A MINIMUM OF

2. TYPICAL TRENCH DIMENSIONS ARE 1FT WIDE BY 2 FT HIGH (UNLESS NOTED

PERFORATED DRAIN TILE

N.T.S.

1 FT TO ENSURE COMPLETE COVERAGE OF UNDER DRAIN WIDTH.

AASHTO-252 (ADS N-12, OR

APPROVED EQUAL). SEE GRADING

PLAN FOR PIPE FLOWLINE, SIZE,



**Kahler Slater** 

JJSD jsdinc.com

CONSTRUCTION

Revisions

SIP SUBMITTAL

JULY 15, 2024

SCOPE DOCUMENTS
Drawing Date

MADISON YARDS: BLOCK 4 HOTEL

BLOCK 4 AT MADISON YARDS

Project No. HKS HOLDINGS 222093.00

Sheet Title

BLOCK 4 - DETAILS

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Sheet No.

B4-C5.0



**GENERAL NOTES** 

. REFER TO THE EXISTING CONDITIONS SURVEY FOR EXISTING CONDITIONS NOTES AND LEGEND.

SEE SHEET L2.0 FOR A COMPREHENSIVE PLANT SCHEDULE

Malus x 'Adirondack' / Adirondack Crabapple

Juniperus chinensis 'lowa' / lowa Juniper

BUGV Buxus x 'Green Velvet' / Green Velvet Boxwood

TAMEE Taxus x media 'Everlow' / Everlow Yew

BUGM Buxus x 'Green Mountain' / Green Mountain Boxwood

SCSCJ Schizachyrium scoparium 'Jazz' / Jazz Little Bluestem

SPHE Sporobolus heterolepis / Prairie Dropseed

SPHET Sporobolus heterolepis 'Tara' / Prairie Dropseed

Betula populifolia 'Whitespire' - Single / Whitespire Birch - Single

Juniperus virginiana 'Canaertii' / Canaerti Eastern Redcedar

Aronia melanocarpa 'Morton' TM / Iroquis Beauty Black Chokeberry

Calycanthus floridus 'SMNCAF' / Simply Scentsational® Sweetshrub

Diervilla sessilifolia 'Cool Splash' / Cool Splash False Honeysuckle

Rudbeckia x 'American Gold Rush' / American Gold Rush Coneflower

SCSC Schizachyrium scoparium 'Prairie Blues' / Prairie Blues Little Bluestem \*

Cornus sericea 'Farrow' / Arctic Fire® Red Twig Dogwood

Gleditsia triacanthos inermis 'Shademaster' TM / Shademaster Locust

Gymnocladus dioica 'J.C. McDaniel' TM / Prairie Titan Kentucky Coffeetree

- 2. ALL WORK IN THE ROW SHALL BE IN ACCORDANCE WITH THE MUNICIPAL STANDARD SPECIFICATIONS FOR PUBLIC WORKS CONSTRUCTION.
- JSD SHALL BE HELD HARMLESS AND DOES NOT WARRANT ANY DEVIATIONS BY THE OWNER/CONTRACTOR FROM THE APPROVED CONSTRUCTION PLANS THAT MAY RESULT IN DISCIPLINARY ACTIONS BY ANY OR ALL REGULATORY AGENCIES.
- 4. DRAWING FOR REVIEW NOT FOR CONSTRUCTION UNLESS OTHERWISE NOTED IN THE TITLE BLOCK. . THE LANDSCAPE CONTRACTOR SHALL COORDINATE ALL FINE GRADING AND TOPSOILING WITH GENERAL CONTRACTOR
- 6. REFER TO "LANDSCAPE DETAILS AND NOTES" SHEET FOR ADDITIONAL DETAILS, NOTES AND SPECIFICATION INFORMATION INCLUDING MATERIALS, GUARANTEE AND EXECUTION RELATED TO
- CONTRACTOR SHALL REVIEW SITE CONDITIONS FOR UTILITY CONFLICTS, DRAINAGE ISSUES, SUBSURFACE ROCK, AND PLANT PLACEMENT CONFLICTS PRIOR TO PLANT INSTALLATION. REPORT ANY
- 8. DO NOT COMMENCE PLANTING OPERATIONS UNTIL ALL ADJACENT SITE IMPROVEMENTS, IRRIGATION INSTALLATION (IF APPLICABLE), AND FINISH GRADING ARE COMPLETE

#### **CONTRACTOR NOTES**

1. REFER TO SHEET B4-C1.0 NOTES AND LEGENDS FOR PLAN LINEWORK, HATCHING AND SYMBOL

- 2. REFER TO SHEET B4-L2.0 FOR COMPREHENSIVE PLANT SCHEDULE.
- 3. ALL PLANTING BEDS SHALL RECEIVE SHREDDED HARDWOOD BARK MULCH, UNLESS OTHERWISE

SIP SUBMITTAL

SCOPE DOCUMENTS

Drawing Date JULY 15, 2024

MADISON YARDS: **BLOCK 4 HOTEL** 

BLOCK 4 AT MADISON YARDS

HKS HOLDINGS 222093.00

**BLOCK 4** LANDSCAPE PLAN

THE RIGHT OF WAY IS THE SOLE JURISDICTION OF THE CITY OF MADISON AND IS SUBJECT TO CHANGE AT ANY TIME PER THE RECOMMENDED PLAN BY TRAFFIC ENGINEERING AND CITY ENGINEERING DEPARTMENT


ALL PROPOSED IMPROVEMENTS WITHIN THE PUBLIC RIGHT-OF-WAY OR CONNECTIONS TO CITY OWNED UTILITIES SHALL BE COMPLETED PER THE CITY ISSUED IMPROVEMENTS PLAN (CONTRACT NO. XXXX, PROJECT NO. XXXXX)



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B4-L1.0

Sheet No.

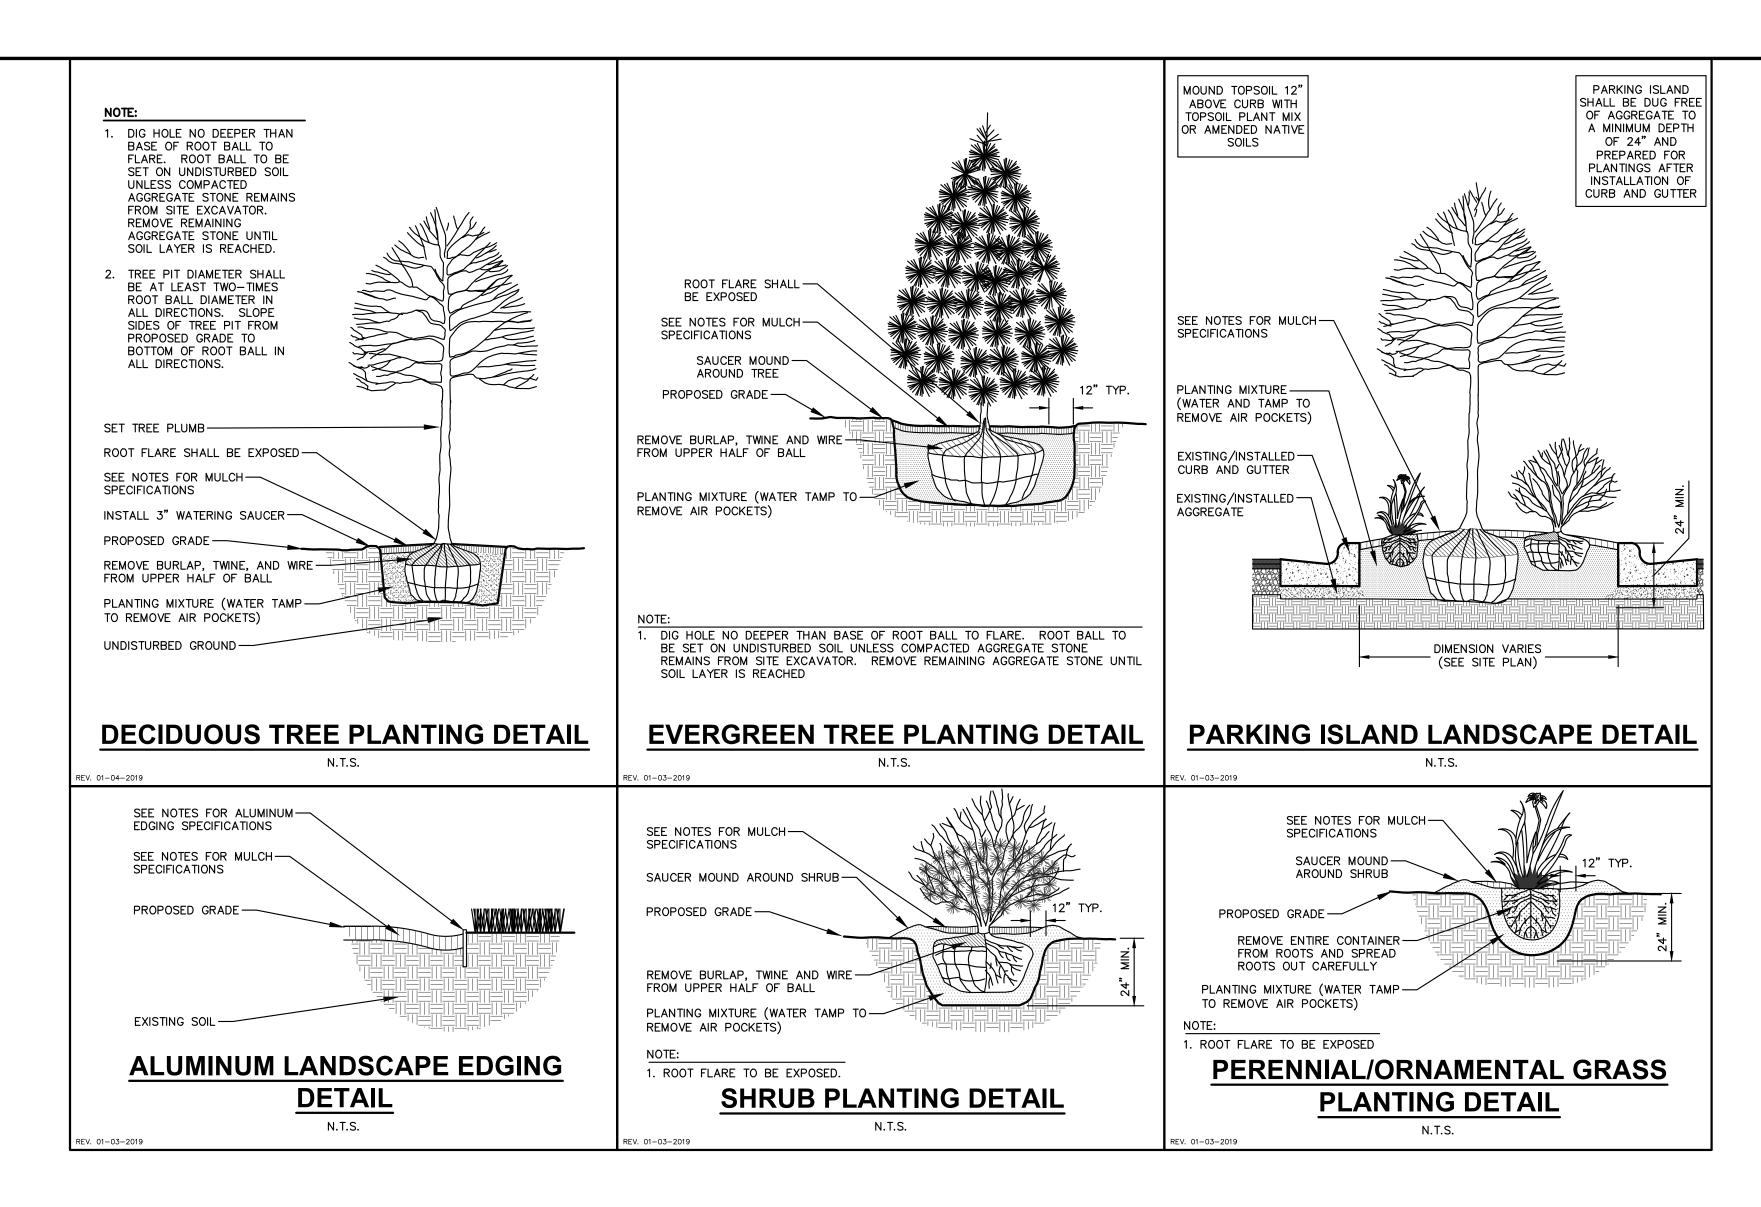

OVERSTORY  OVERSTORY  F  UPRIGHT E	MAAD <u>OECIDA</u> BEPO  GLTR  PTKC	Malus x 'Adirondack' / Adirondack Crabapple  UOUS TREES  Betula populifolia 'Whitespire' — Single / Whitespire Birch — Single  Gleditsia triacanthos inermis 'Shademaster' TM / Shademaster Locust  Gymnocladus dioica 'J.C. McDaniel' TM / Prairie Titan Kentucky Coffeetree  EN SHRUB	B & B  B & B  B & B	1.5"Cal  2.5"Cal  2.5"Cal	17 1 3
OVERSTORY  OVERSTORY  E  OVERSTORY  F  UPRIGHT E	MAAD  / DECID  BEPO  GLTR  PTKC  VERGRE	Malus x 'Adirondack' / Adirondack Crabapple  UOUS TREES  Betula populifolia 'Whitespire' — Single / Whitespire Birch — Single  Gleditsia triacanthos inermis 'Shademaster' TM / Shademaster Locust  Gymnocladus dioica 'J.C. McDaniel' TM / Prairie Titan Kentucky Coffeetree  EN SHRUB	B & B B & B	2.5"Cal 2.5"Cal	1
UPRIGHT E	BEPO GLTR PTKC VERGRE	Betula populifolia 'Whitespire' — Single / Whitespire Birch — Single  Gleditsia triacanthos inermis 'Shademaster' TM / Shademaster Locust  Gymnocladus dioica 'J.C. McDaniel' TM / Prairie Titan Kentucky Coffeetree  EN SHRUB	B & B	2.5"Cal	1
UPRIGHT E	BEPO GLTR PTKC VERGRE	Betula populifolia 'Whitespire' — Single / Whitespire Birch — Single  Gleditsia triacanthos inermis 'Shademaster' TM / Shademaster Locust  Gymnocladus dioica 'J.C. McDaniel' TM / Prairie Titan Kentucky Coffeetree  EN SHRUB	B & B	2.5"Cal	1
UPRIGHT E	GLTR PTKC VERGRE	Gleditsia triacanthos inermis 'Shademaster' TM / Shademaster Locust  Gymnocladus dioica 'J.C. McDaniel' TM / Prairie Titan Kentucky Coffeetree  EN SHRUB	B & B	2.5"Cal	1
UPRIGHT E	PTKC VERGRE	Gymnocladus dioica 'J.C. McDaniel' TM / Prairie Titan Kentucky Coffeetree  EN SHRUB			3
UPRIGHT E	VERGRE.	EN SHRUB	B & B	2.5"Cal	3
ghandra re					
Week of the last o	JUCHI				
ne harded		Juniperus chinensis 'lowa' / lowa Juniper	B & B	Min. 6' Ht.	27
	JIVIC	Juniperus virginiana 'Canaertii' / Canaerti Eastern Redcedar	B & B	Min. 6' Ht.	5
<u>DECIDUOUS</u>	S SHRUE	3S			
	ARME	Aronia melanocarpa 'Morton' TM / Iroquis Beauty Black Chokeberry	#3	Min. 24"	13
	CAFL	Calycanthus floridus 'SMNCAF' / Simply Scentsational® Sweetshrub	B & B	Min. 12"-24"	10
(°)	COSE	Cornus sericea 'Farrow' / Arctic Fire® Red Twig Dogwood	#5	Min. 24" Ht.	26
5	SISE	Diervilla sessilifolia 'Cool Splash' / Cool Splash False Honeysuckle	#3	Min. 18" Ht.	44
F	RHAR	Rhus aromatica 'Gro-Low' / Gro-Low Fragrant Sumac *	#3	Min. 24" wide	17
E PROPERTY V	/ICA	Viburnum carlesii 'SMVCB' TM / Spice Baby Koreanspice Viburnum	#3	Min. 12"-24"	7
EVERGREEN	√ SHRUL	BS			
E E	BUGV	Buxus x 'Green Velvet' / Green Velvet Boxwood	B & B	Min. 30" Ht.	24
E E	BUGM	Buxus x 'Green Mountain' / Green Mountain Boxwood	B & B	Min. 30" Ht.	9
F	PIMU	Pinus mugo / Mugo Pine	B & B	Min. 30" Ht.	10
} • \ T.	TAMEE	Taxus x media 'Everlow' / Everlow Yew	#5	Min. 24" wide	29
PERENNIALS	 S & GF	ASSES			
* /	<i>ASCHW</i>	Astilbe chinensis 'Vision in White' / Vision in White Chinese Astilbe	#1	Min. 8"-18"	21
	CANE	Calamintha nepeta 'Montrose White' / Montrose White Catmint	#1	Min. 8"-18"	39
	ЕСРИМ	Echinacea purpurea 'Magnus Superior' / Magnus Superior Coneflower	#1	Min 8"-18"	85
F	HEFC	Heuchera x 'Fire Chief' / Fire Chief Coral Bells	#1	Min. 8"-18"	22
Julian F	PAVI	Panicum virgatum 'Shenandoah' / Shenandoah Switch Grass	#1	Min. 8"-18"	126
	RUAG	Rudbeckia x 'American Gold Rush' / American Gold Rush Coneflower	#1	Min. 8"-18"	23
₹•} 5	SANEC	Salvia nemorosa 'Caradonna' / Cardonna Meadow Sage	#1	Min. 8"-18"	39
MAN S	SCSCJ	Schizachyrium scoparium 'Jazz' / Jazz Little Bluestem	#1	Min. 8"-18"	20
EMZ S	SCSC	Schizachyrium scoparium 'Prairie Blues' / Prairie Blues Little Bluestem *	#1	Min. 8"-18"	74
	SPHE	Sporobolus heterolepis / Prairie Dropseed	#1	Min. 8"-18"	40
* 5	SPHET	Sporobolus heterolepis 'Tara' / Prairie Dropseed	#1	Min. 8"-18"	193
SYMBOL C	CODE	BOTANICAL / COMMON NAME	CONT	SPACING	QT

#### **GENERAL NOTES**

- . GENERAL: ALL WORK IN THE R-O-W AND PUBLIC EASEMENTS SHALL BE IN ACCORDANCE WITH LOCAL MUNICIPAL REQUIREMENTS. JSD SHALL BE HELD HARMLESS AND DOES NOT WARRANT ANY DEVIATIONS BY THE OWNER/CONTRACTOR FROM THE APPROVED CONSTRUCTION PLANS THAT MAY RESULT IN DISCIPLINARY ACTIONS BY ANY OR ALL REGULATORY AGENCIES. LOCATE ALL UTILITIES PRIOR TO CONSTRUCTION. THE CONTRACTOR IS RESPONSIBLE FOR REPAIRING ANY DAMAGE DONE TO UTILITIES. CONTRACTOR MUST CALL 1-800-242-8511 FOR UTILITY LOCATIONS AT LEAST THREE DAYS PRIOR TO DIGGING. HAND DIG AND INSTALL ALL PLANTS THAT ARE NEAR EXISTING UTILITIES. PROTECT PREVIOUSLY INSTALLED WORK OF OTHER TRADES. CONTRACTOR IS RESPONSIBLE FOR STAKING THE PLANT MATERIALS FOR REVIEW BY OWNER PRIOR TO DIGGING AND PLACEMENT AND SHALL COORDINATE ALL FINE GRADING AND RESTORATION WITH THE GRADING CONTRACTOR.
- . DELIVERY AND HANDLING: DO NOT DELIVER MORE PLANT MATERIALS THAN CAN BE PLANTED IN ONE DAY, UNLESS ADEQUATE, APPROPRIATE AND SECURE STORAGE IS PROVIDED AND APPROVED BY OWNER'S REPRESENTATIVE. AT ALL TIMES, PROTECT ALL PLANT MATERIALS FROM WIND AND DIRECT SUN. DELIVER PLANTS WITH LEGIBLE IDENTIFICATION LABELS. PROTECT PLANTS DURING DELIVERY AND DO NOT PRUNE PRIOR TO DELIVERY. ALL TREES AND SHRUBS SHALL BE PLANTED ON THE DAY OF DELIVERY: IF THIS IS NOT POSSIBLE, PROTECT THE PLANT MATERIALS NOT PLANTED BY STORING THEM IN A SHADED, SECURE AREA, PROTECTING THE ROOT MASS WITH WET SOIL, MULCH, HAY OR OTHER SUITABLE MEDIUM. CONTRACTOR TO KEEP ALL PLANT MATERIALS ADEQUATELY WATERED TO PREVENT ROOT DESICCATION. DO NOT REMOVE CONTAINER GROWN STOCK FROM CONTAINERS BEFORE TIME OF PLANTING. DO NOT PICK UP CONTAINER OR BALLED PLANTS BY STEM OR ROOTS. ALL PLANTS SHALL BE LIFTED AND HANDLED FROM THE BOTTOM OF THE CONTAINER OR BALL. PERFORM ACTUAL PLANTING ONLY WHEN WEATHER AND SOIL CONDITIONS ARE SUITABLE IN ACCORDANCE WITH LOCALLY ACCEPTED BEST HORTICULTURAL PRACTICES.
- . MATERIALS PLANTS: ALL PLANTS SHALL CONFORM TO THE LATEST VERSION OF THE AMERICAN STANDARD FOR NURSERY STOCK ANSI Z60.1. PLANTS SHALL BE TRUE TO SPECIES AND VARIETY SPECIFIED AND NURSERY GROWN IN ACCORDANCE WITH GOOD HORTICULTURAL PRACTICES UNDER CLIMATIC CONDITIONS SIMILAR TO THOSE IN THE LOCALITY OF THE PROJECT FOR AT LEAST 2 YEARS. PLANTS SHALL BE FRESHLY DUG (DURING THE MOST RECENT FAVORABLE HARVEST SEASON). PLANTS SHALL BE SO TRAINED IN DEVELOPMENT AND APPEARANCE AS TO BE UNQUESTIONABLY SUPERIOR IN FORM, COMPACTNESS, AND SYMMETRY. PLANTS SHALL BE SOUND, HEALTHY, VIGOROUS, WELL BRANCHED AND DENSELY FOLIATED WHEN IN LEAF, AND FREE OF DISEASE AND INSECTS (ADULT EGGS, PUPAE OR LARVAE). THEY SHALL HAVE HEALTHY, WELL-DEVELOPED ROOT SYSTEMS AND SHALL BE FREE FROM PHYSICAL DAMAGE OR OTHER CONDITIONS THAT WOULD PREVENT THRIVING GROWTH OR PREMATURE MORTALITY. PLANTS SHALL BE OF THE HIGHEST QUALITY, POSSESS TYPICAL GROWTH HABITS AND FORM FOR THEIR SPECIES AND BE FREE OF INJURY. PARKWAY TREES AND PARKING LOT TREES SHALL HAVE A MINIMUM BRANCHING HEIGHT OF SIX (6) FEET ABOVE THE GROUND TO ALLOW ADEQUATE VISUAL AND PHYSICAL CLEARANCE.
- 4. PRUNING: THE CONTRACTOR SHALL PRUNE ALL TREES AND REPAIR ANY INJURIES THAT OCCURRED DURING THE PLANTING PROCESS. DOUBLE LEADERS, DEAD BRANCHES, AND LIMBS DAMAGED OR BROKEN DURING THE PLANTING PROCESS, SHALL BE PRUNED. THIS SHALL BE THE ONLY PRUNING ALLOWED AT PLANTING. PRUNING SHALL CONFORM TO THE LATEST VERSION OF THE AMERICAN STANDARD FOR TREE CARE OPERATIONS, ANSI A300. PRUNE TREES IN ACCORDANCE WITH NAA GUIDELINES. DO NOT TOP TREES. PRUNE SHRUBS ACCORDING TO STANDARD HORTICULTURAL PRACTICES. ON CUTS OVER 3/4" IN DIAMETER AND BRUISES OR SCARS ON BARK, TRACE THE INJURED CAMBIUM LAYER BACK TO LIVING TISSUE AND REMOVE. SMOOTH AND SHAPE WOUNDS SO AS NOT TO RETAIN WATER. TREAT THE AREA WITH AN APPROVED INCONSPICUOUS LATEX BASED ANTISEPTIC TREE PAINT. IF PRUNING OCCURS "IN SEASON". DO NOT PRUNE ANY OAK TREES DURING THE MONTHS FROM APRIL TO OCTOBER.
- 5. CLEANUP: THE WORK AREA SHALL BE KEPT SAFE AND NEAT AT ALL TIMES. DISPOSED OF EXCESS SOIL. REMOVE ALL CUTTINGS AND WASTE MATERIALS. SOIL AND BRANCHES. BIND AND WRAP THESE MATERIALS, ANY REJECTED PLANTS, AND ANY OTHER DEBRIS RESULTING FROM ALL PLANTING TASKS AND PROMPTLY CLEAN UP AND REMOVE FROM THE PROJECT SITE. UNDER NO CIRCUMSTANCES SHALL THE ACCUMULATION OF SOIL, BRANCHES OR OTHER DEBRIS BE ALLOWED UPON A PUBLIC PROPERTY IN SUCH A MANNER AS TO RESULT IN A PUBLIC SAFETY HAZARD OR DAMAGE. LIKEWISE, UNDER NO CIRCUMSTANCES SHALL ANY DEBRIS OR INCIDENTAL MATERIALS BE ALLOWED UPON ADJACENT PRIVATE PROPERTY.
- 6. ANY SUBSTITUTIONS IN PLANT TYPE, LOCATION, OR SIZE SHALL BE APPROVED BY LANDSCAPE ARCHITECT PRIOR TO INSTALLATION.
- 7. CONTRACTOR TO VERIFY PLANT MATERIAL QUANTITIES AND SQUARE FOOTAGES. QUANTITIES SHOWN ON PLAN TAKE PRECEDENCE OVER THOSE ON SCHEDULE.

#### LANDSCAPE MATERIAL NOTES

LANDSCAPE AREAS PER SOIL TEST.

ORNAMENTAL GRASSES SHALL BE BACKFILLED WITH TWO (2) PARTS TOPSOIL, ONE (1) PART SAND AND ONE (1) PART COMPOST. SOIL MIXTURE SHALL BE WELL BLENDED PRIOR TO INSTALLATION. MATERIALS - TOPSOIL: TOPSOIL TO BE CLEAN, FRIABLE LOAM FROM A LOCAL SOURCE, FREE FROM STONES OR DEBRIS OVER 3/4" IN DIAMETER, AND FREE FROM TOXINS OR OTHER DELETERIOUS MATERIALS. TOPSOIL SHALL HAVE A pH VALUE BETWEEN 6 AND 7. TOPSOIL AND PLANTING SOIL SHALL BE TESTED TO ENSURE CONFORMANCE WITH THESE SPECIFICATIONS AND SHALL BE AMENDED TO MEET THESE SPECIFICATIONS. PROVIDE TEST RESULTS TO OWNER'S REPRESENTATIVE PRIOR TO PLACEMENT. DO NOT PLACE FROZEN OR MUDDY TOPSOIL. APPLY SOIL AMENDMENTS TO ALL

1. MATERIALS - PLANTING MIXTURE: ALL HOLES EXCAVATED FOR TREES, SHRUBS, PERENNIALS AND

- 3. MATERIALS SOD: DISTURBED LAWN AREAS LABELED ON PLAN AS SUCH, SHALL RECEIVE 6" OF TOPSOIL AND A PREMIUM GRADE TURFGRASS SOD. ONLY IMPROVED TYPES OF SOD (ELITE) ARE ACCEPTABLE. TURFGRASS SHALL BE MACHINE CUT AT A UNIFORM THICKNESS OF .60 INCH, PLUS OR MINUS .25 INCH, AT TIME OF CUTTING. MEASUREMENT FOR THICKNESS SHALL EXCLUDE TOP GROWTH AND THATCH. LARGE ROLL TURFGRASS SOD SHALL BE CUT TO THE SUPPLIER'S STANDARD WIDTH (36-48 INCHES) AND LENGTH. BROKEN PADS AND TORN OR UNEVEN ENDS WILL NOT BE ACCEPTABLE, STANDARD SIZE SECTIONS OF TURGRASS SOD SHALL BE STRONG ENOUGH SO THAT THEY CAN BE PICKED UP AND HANDLED WITHOUT DAMAGE. TURFGRASS SOD SHALL NOT BE HARVESTED OR TRANSPLANTED WHEN MOISTURE CONTENT IS EXCESSIVELY DRY OR WET, AS THIS MAY ADVERSELY AFFECT ITS SURVIVAL. POST-PLANT IRRIGATION WILL BE NECESSARY TO ENSURE SOD STAYS ALIVE AND ROOTS INTO SOIL. THE CONTRACTOR IS RESPONSIBLE FOR WATERING SOD UNTIL TIME OF ACCEPTANCE BY THE OWNER. TURFGRASS SOD SHALL BE HARVESTED, DELIVERED, AND INSTALLED/TRANSPLANTED WITHIN A PERIOD OF 24 HOURS. TURFGRASS SOD SHALL BE RELATIVELY FREE OF THATCH, UP TO 0.5 INCH ALLOWABLE (UNCOMPRESSED). TURFGRASS SOD SHALL BE REASONABLY FREE (10 WEEDS/100 SQ. FT.) OF DISEASES, NEMATODES AND SOIL-BORNE INSECTS. ALL TURFGRASS SOD SHALL BE FREE OF GRASSY AND BROAD LEAF WEEDS AND WEED SEED. THE SOD SUPPLIER SHALL MAKE RECOMMENDATIONS TO THE CONTRACTOR REGARDING WATERING
- MATERIALS SHREDDED HARDWOOD BARK MULCH: ALL PLANTING AREAS LABELED ON PLAN SHALL RECEIVE CERTIFIED WEED FREE SHREDDED HARDWOOD BARK MULCH INSTALLED TO A MINIMUM AND CONSISTENT DEPTH OF 3-INCHES. SHREDDED HARDWOOD BARK MULCH SIZE & COLOR TO BE APPROVED BY OWNER'S REPRESENTATIVE PRIOR TO INSTALLATION. FERTILIZER SHALL BE IN ACCORDANCE WITH APPLICABLE LOCAL, COUNTY AND STATE REQUIREMENTS. SHREDDED HARDWOOD BARK MULCH AREAS SHALL NOT RECEIVE WOVEN WEED BARRIER FABRIC.

SCHEDULE. THE WATERING SCHEDULE SHOULD BEGIN IMMEDIATELY AFTER SOD IS INSTALLED.

5. MATERIALS - DECORATIVE STONE MULCH #1: ALL AREAS LABELED ON PLAN SHALL RECEIVE 3/4" TRAP STONE MULCH SPREAD TO A MINIMUM AND CONSISTENT DEPTH OF 3-INCHES. DECORATIVE

STONE MULCH TYPE, SIZE & COLOR TO BE APPROVED BY OWNER'S REPRESENTATIVE PRIOR TO

- INSTALLATION. DECORATIVE STONE MULCH AREAS SHALL RECEIVE BLACK VISQUEEN. 5. MATERIALS - DECORATIVE STONE MULCH #2: ALL AREAS LABELED ON PLAN SHALL RECEIVE 1.5" TRAP STONE MULCH SPREAD TO A MINIMUM AND CONSISTENT DEPTH OF 3-INCHES. DECORATIVE STONE MULCH TYPE, SIZE & COLOR TO BE APPROVED BY OWNER'S REPRESENTATIVE PRIOR TO INSTALLATION. DECORATIVE STONE MULCH AREAS SHALL RECEIVE BLACK VISQUEEN.
- 6. MATERIALS TREE & SHRUB RINGS: ALL TREES AND/OR SHRUBS PLANTED IN SEEDED LAWN AREAS TO BE INSTALLED WITH A MINIMUM 4' DIAMETER SHREDDED HARDWOOD BARK MULCH TREE RING SPREAD TO A CONSISTENT DEPTH OF 3-INCHES. ALL TREE RINGS SHOULD BE INSTALLED WITH A 5" DEPTH SHOVEL CUT EDGE, ANGLED 45 DEGREES INTO SOIL AT A 5' DIAMETER ABOUT THE CENTER OF THE TREE PLANTING. A PRE-EMERGENT GRANULAR HERBICIDE WEED-PREVENTER SHOULD BE MIXED WITH MULCH USED TO INSTALL TREE RING AS WELL AS TOPICALLY APPLIED TO COMPLETED INSTALLATION OF TREE RING.
- MATERIALS ALUMINUM EDGING: EDGING SHALL BE 1/8" X 4", ALUMINUM EDGING, MILL FINISH. OWNER'S REPRESENTATIVE SHALL APPROVE PRODUCT SPECIFICATION PROVIDED BY LANDSCAPE
- 8. MATERIALS TREE PROTECTION: ALL TREES TO BE INSTALLED WITH LDPE TREE GUARDS AS MANUFACTURED BY A.M. LEONARD HORTICULTURAL TOOL & SUPPLY CO., OR APPROVED EQUAL.
- 9. MATERIALS (ALTERNATE 1): TREE WATERING BAGS: ALL TREES TO BE INSTALLED WITH ONE (1) WATER BAG. PRODUCT TO BE "TREE GATOR ORIGINAL SLOW RELEASE WATERING BAG," PRODUCT NO. 98183-R OR APPROVED EQUAL. INSTALL IN ACCORDANCE WITH MANUFACTURER'S

#### **CONTRACTOR AND OWNER RESPONSIBILITY NOTES**

NEW / PROPOSED

LANDSCAPING

QUANTITY

117

60

674

3,009

**POINTS** 

**ACHIEVED** 

320

351

240

GUARANTEE: THE CONTRACTOR SHALL GUARANTEE ALL PLANTS THROUGH ONE (1) YEAR AFTER ACCEPTANCE BY THE OWNER'S REPRESENTATIVE. PLANTS SHALL BE ALIVE AND IN HEALTHY AND FLOURISHING CONDITION AT THE END OF THE GUARANTEE PERIOD. THE CONTRACTOR SHALL REPLACE (AT NO COST TO OWNER) ANY PLANTS THAT ARE DEAD OR NOT IN A VIGOROUS THRIVING CONDITION. REPLACEMENT PLANTS SHALL BE OF THE SAME KIND AND SIZE AS ORIGINALLY SPECIFIED UNLESS OTHERWISE DIRECTED BY OWNER'S REPRESENTATIVE. RESTORE BEDS AS NECESSARY FOLLOWING PLANT REPLACEMENT, INCLUDING BUT NOT LIMITED TO BEDDING, EDGING, MULCH, ETC. REPLACE PLANTS DAMAGED AT TIME OF PLANTING. REPAIR AREAS DISTURBED IN ANY WAY DURING PLANT REPLACEMENT AT NO COST TO OWNER. CONTRACTOR SHALL PROVIDE A ONE (1)—YEAR STRAIGHTENING GUARANTEE FOR ALL TREES.

- CONTRACTOR IS RESPONSIBLE FOR STAKING THE PLANT MATERIALS FOR REVIEW BY OWNER'S REPRESENTATIVE PRIOR TO DIGGING AND PLACEMENT AND SHALL COORDINATE ALL FINE GRADING AND RESTORATION WITH THE GRADING
- MAINTENANCE: (CONTRACTOR) FOR ALL PLANTINGS, SEEDED AND/OR SODDED LAWN AREAS: THE CONTRACTOR SHALL MAINTAIN ALL PLANTINGS AND LAWN AREAS FOR A MINIMUM TIME PERIOD OF 60 DAYS, UNTIL FINAL ACCEPTANCE BY OWNER'S REPRESENTATIVE. THE CONTRACTOR IS RESPONSIBLE FOR ADEQUATELY WATERING PLANTS AND LAWN/TURFGRASS DURING THIS 60 DAY ESTABLISHMENT PERIOD. CONTRACTOR IS RESPONSIBLE FOR THE ESTABLISHMENT OF HEALTHY VIGOROUS PLANT MATERIALS AND LAWN/TURFGRASS GROWTH. CONTRACTOR IS ALSO RESPONSIBLE FOR ANY PRUNING OF PLANT MATERIALS, AND SHAPING AND/OR REPLACEMENT OR SUPPLEMENT OF DEFICIENT SHREDDED HARDWOOD BARK MULCH DURING THIS PERIOD. LONG TERM PLANT MATERIALS AND LAWN/TURFGRASS MAINTENANCE AND ANY PROGRAM FOR SUCH IS THE RESPONSIBILITY OF THE OWNER. ALL PLANTINGS AND LAWN/TURFGRASS AREAS SHALL BE MAINTAINED IN A MANICURED CONDITION UNTIL THE TIME WHEN THE OWNER'S ACCEPTANCE IS GIVEN.
- MAINTENANCE: (OWNER) THE OWNER IS RESPONSIBLE FOR THE CONTINUED MAINTENANCE, REPAIR AND REPLACEMENT OF ALL LANDSCAPING MATERIALS AND WEED BARRIER FABRIC AS NECESSARY FOLLOWING THE ONE (1) YEAR CONTRACTOR GUARANTEE PERIOD.

Required landscaped areas shall be calculated based upon the total developed area of the property. Developed area is defined as that area within a single contiguous boundary which is made up of structures, parking, driveways and docking/loading facilities, but excluding the area of any building footprint at grade, land designated for open space uses such as athletic fields, and undeveloped land area on the same

(A) For all lots except those described in (B) and (C) below, five (5) landscape points shall be provided for each three hundred (300)

(B) - For lots larger than five (5) acres, points shall be provided at five (5) points per three hundred (300) square feet for the first

**TABULATION OF LANDSCAPE CREDITS AND POINTS** 

POINTS

CREDITS / EXISTING LANDSCAPING

QUANTITY

0

POINTS

**ACHIEVED** 

Five (5) developed acres, and one (1) point per one hundred (100) square feet for all additional acres.

(C) For the Industrial - Limited (IL) and Industrial - General (IG) districts, one (1) point shall be provided

LANDSCAPE CALCULATIONS AND DISTRIBUTIONS

Total square footage of developed area: <u>11,030 SQUARE FEET</u>

square feet of developed area.

Total landscape points required:

——Total square footage of developed area:

----First five (5) developed acres = ----

Remainder of developed area:

per one hundred (100) square feet of developed area.

MINIMUM

**INSTALLATION SIZE** 

.5" CAL MIN.

5-6' TALL MIN.

..5" CAL MIN.

#3 CONT., MIN. 12"-24"

#3 CONT., MIN. 12"-24"

#1 CONT., MIN. 8"-18"

14 POINTS / CAL.

5 POINTS PER SEAT ITHIN PUBLICALLY ACCESSIBL

DEVELOPED AREA. CANNOT COMPRISE MORE THAN 5% OF TOTAL REQUIRED POINTS)

TOTAL NUMBER OF POINTS PROVIDED

(MAXIMUM 200 POINTS PER TRE

——-Total landscape points required-

——Total square footage of developed area: —— Total landscape points required:

Five (5) acres =

PLANT TYPE/ELEMENT

OVERSTORY DECIDUOUS

ALL EVERGREEN TREE

JPRIGHT EVERGREEN SHRUB 3-4' TALL, MIN.

ORNAMENTAL / DECORATIVE | 4 POINTS / 10 LF

ORNAMENTAL TREE

SHRUB, DECIDUOUS

SHRUB, EVERGREEN

FENCING OR WALL

SPECIMAN TREE

**EXISTING SIGNIFICANT** 

LANDSCAPE FURNITURE

ORNAMENTAL GRASS &

zoning lot. There are three methods for calculating landscape points depending on the size of the lot and Zoning District.

#### RRIGATION (SEE SPECS):

BASE BID - DRIP IRRIGATION PROVIDED IN ALL PLANT BED AREAS SURROUNDING BUILDING

ALTERNATE BID - POP-UP IRRIGATION FOR ALL PERIMETER PLANTING BEDS AND TURFGRASS AREAS

#### LANDSCAPING:

RECOMMENDATIONS.

LANDSCAPING TO BE INSTALLED AFTER COMPLETION OF THE BUILDING INSTALLATION OF LANDSCAPING NOT TO AFFECT OPERATIONS OF THE BUILDING

#### TREE WATERING PROGRAM:

BASE BID - WATERING OF ALL TREES ON A REGULAR WEEKLY BASIS. CONTRACTOR TO KEEP A LOG OR JOURNAL OF A RECORD OF DATES AND QUANTITIES OF SUPPLEMENTAL WATERING EFFORTS

ALTERNATE BID 1\* - INSTALLATION OF ONE (1) WATERING BAG PER TREE. DOCUMENTATION OF WEEKLY WATERING PROGRAM REQUIRED \*SEE LANDSCAPE MATERIALS NOTES FOR PRODUCTS

SIP SUBMITTAL

JULY 15, 2024

SCOPE DOCUMENTS

**MADISON YARDS:** 

BLOCK 4 AT MADISON YARDS

Project No. 222093.00

**BLOCK 4** LANDSCAPE DETAILS & **NOTES** 

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Sheet No. **B4-L2.0** 


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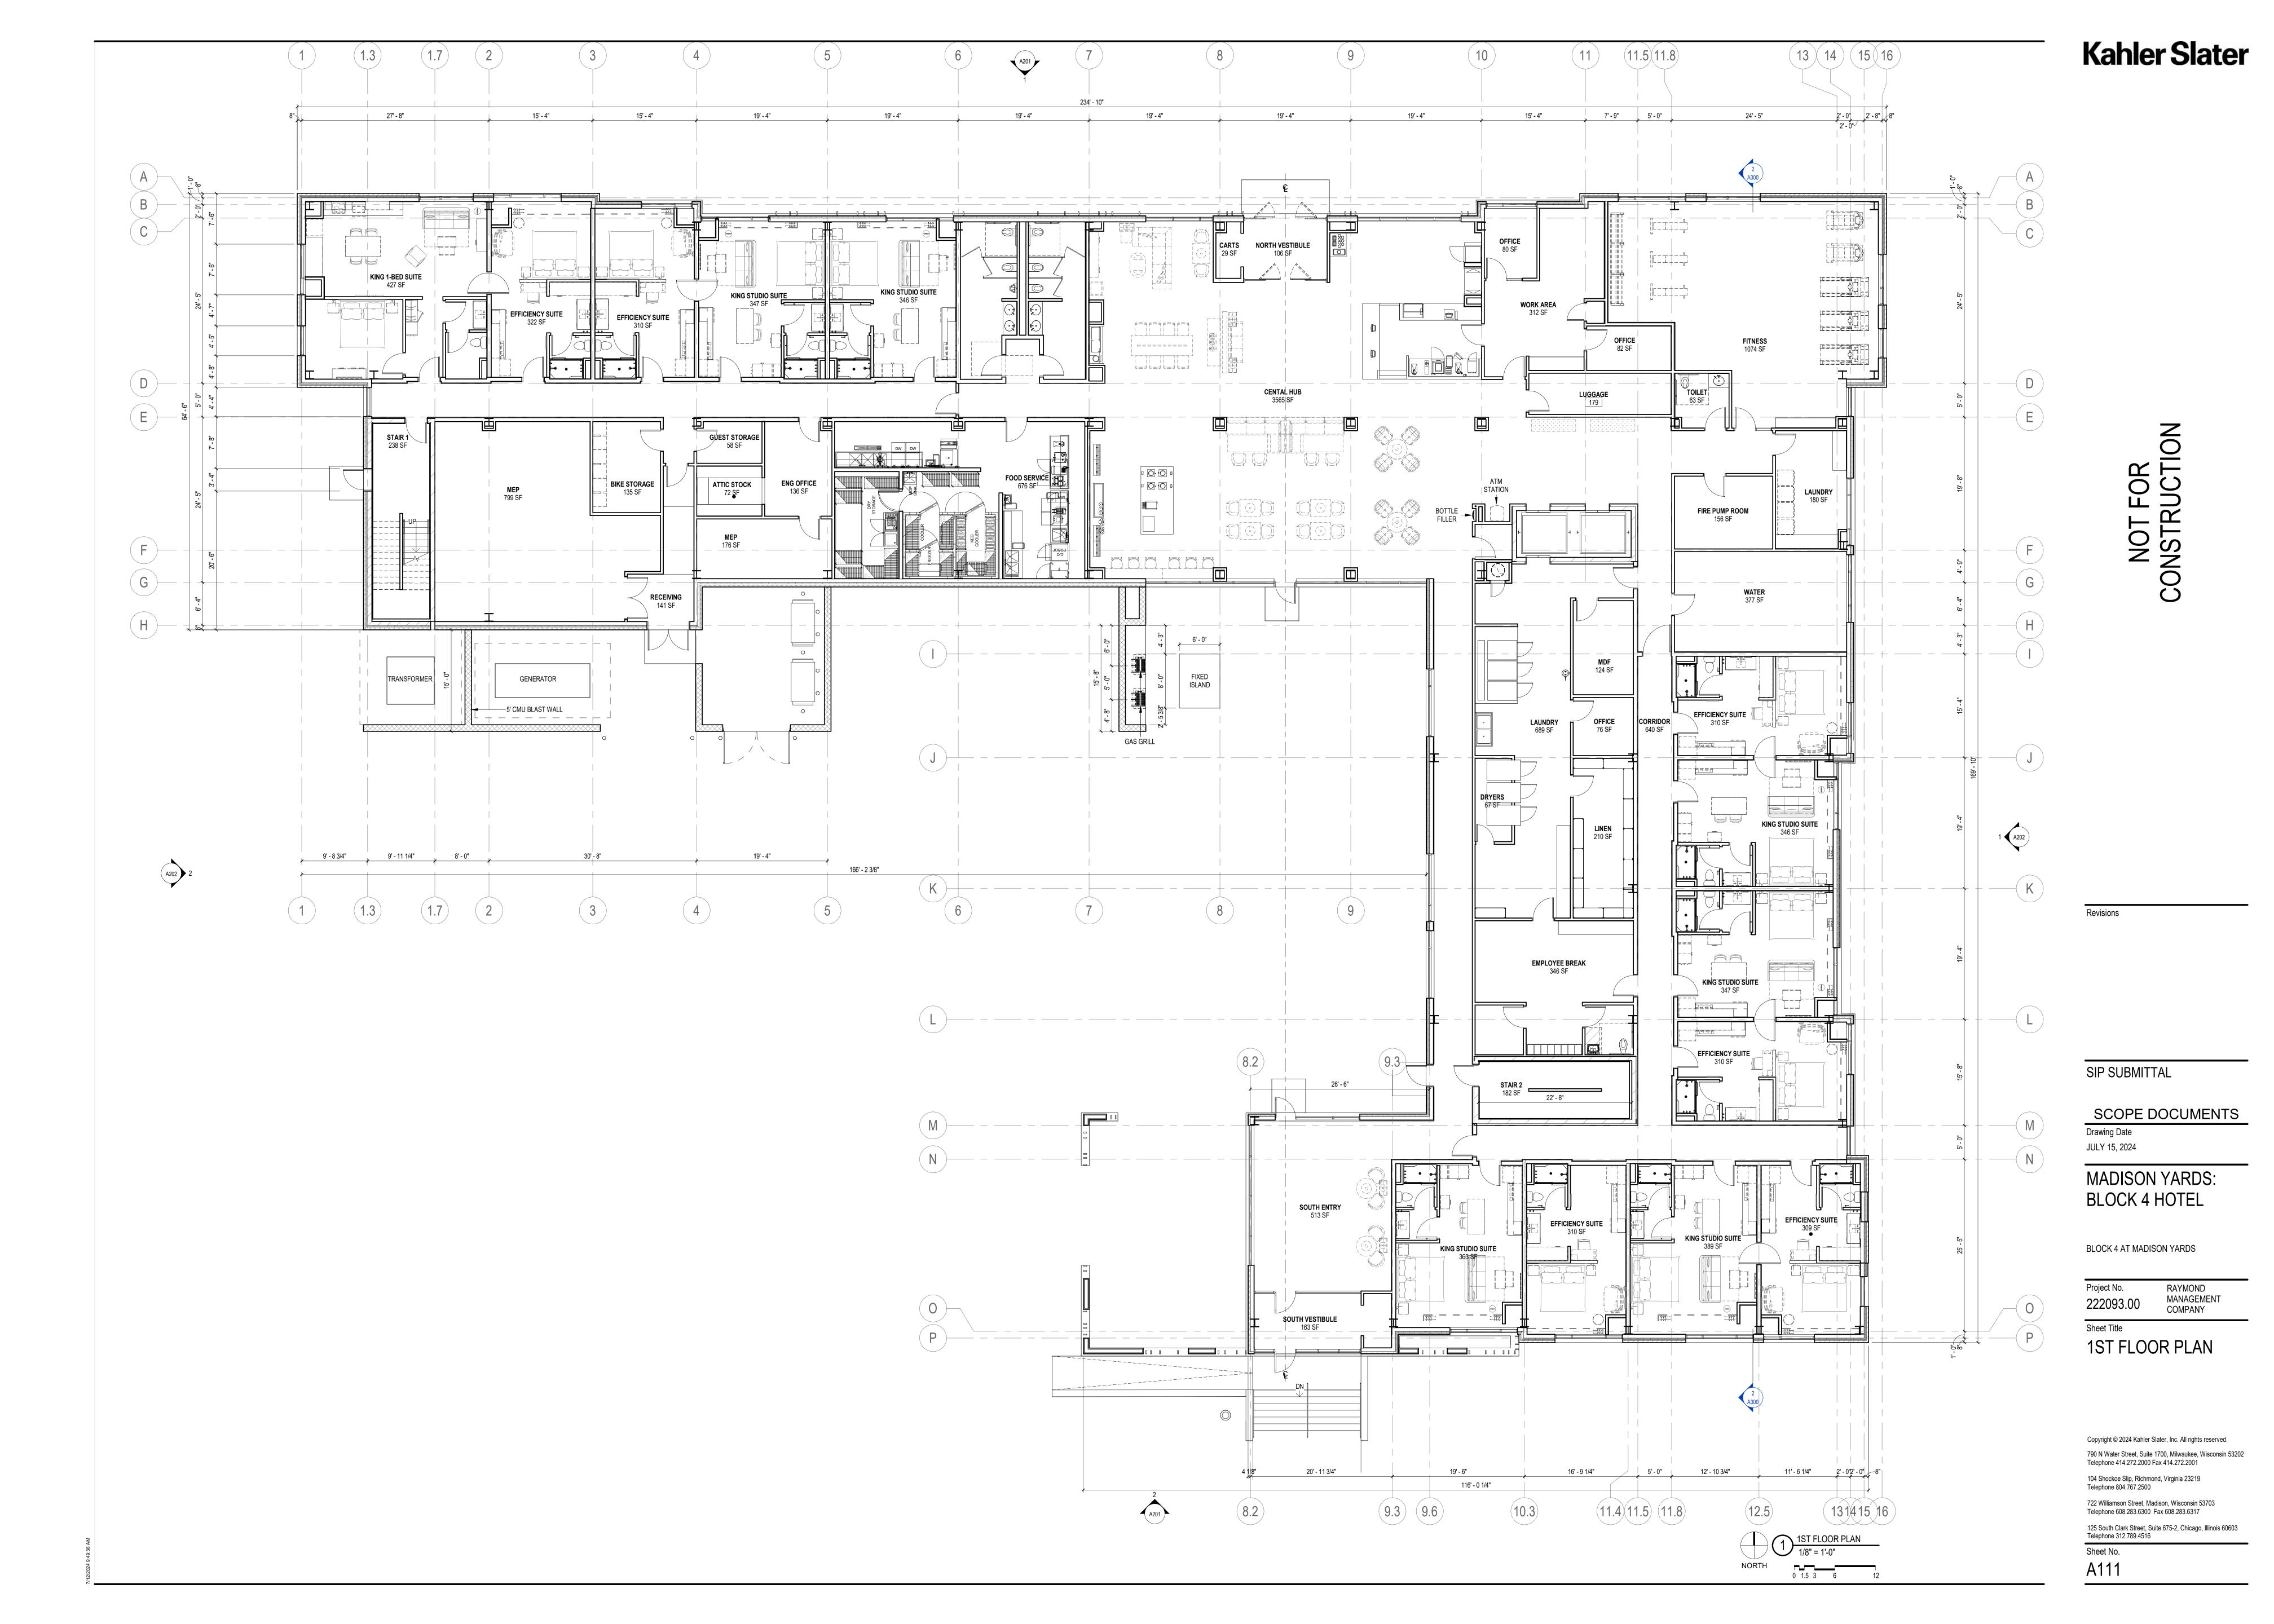
Drawing Date


**BLOCK 4 HOTEL** 

HKS HOLDINGS

722 Williamson Street, Madison, Wisconsin 53703 Telephone 608.283.6300 Fax 608.283.6317 125 South Clark Street, Suite 675-2, Chicago, Illinois 60603 Telephone 312.789.4516



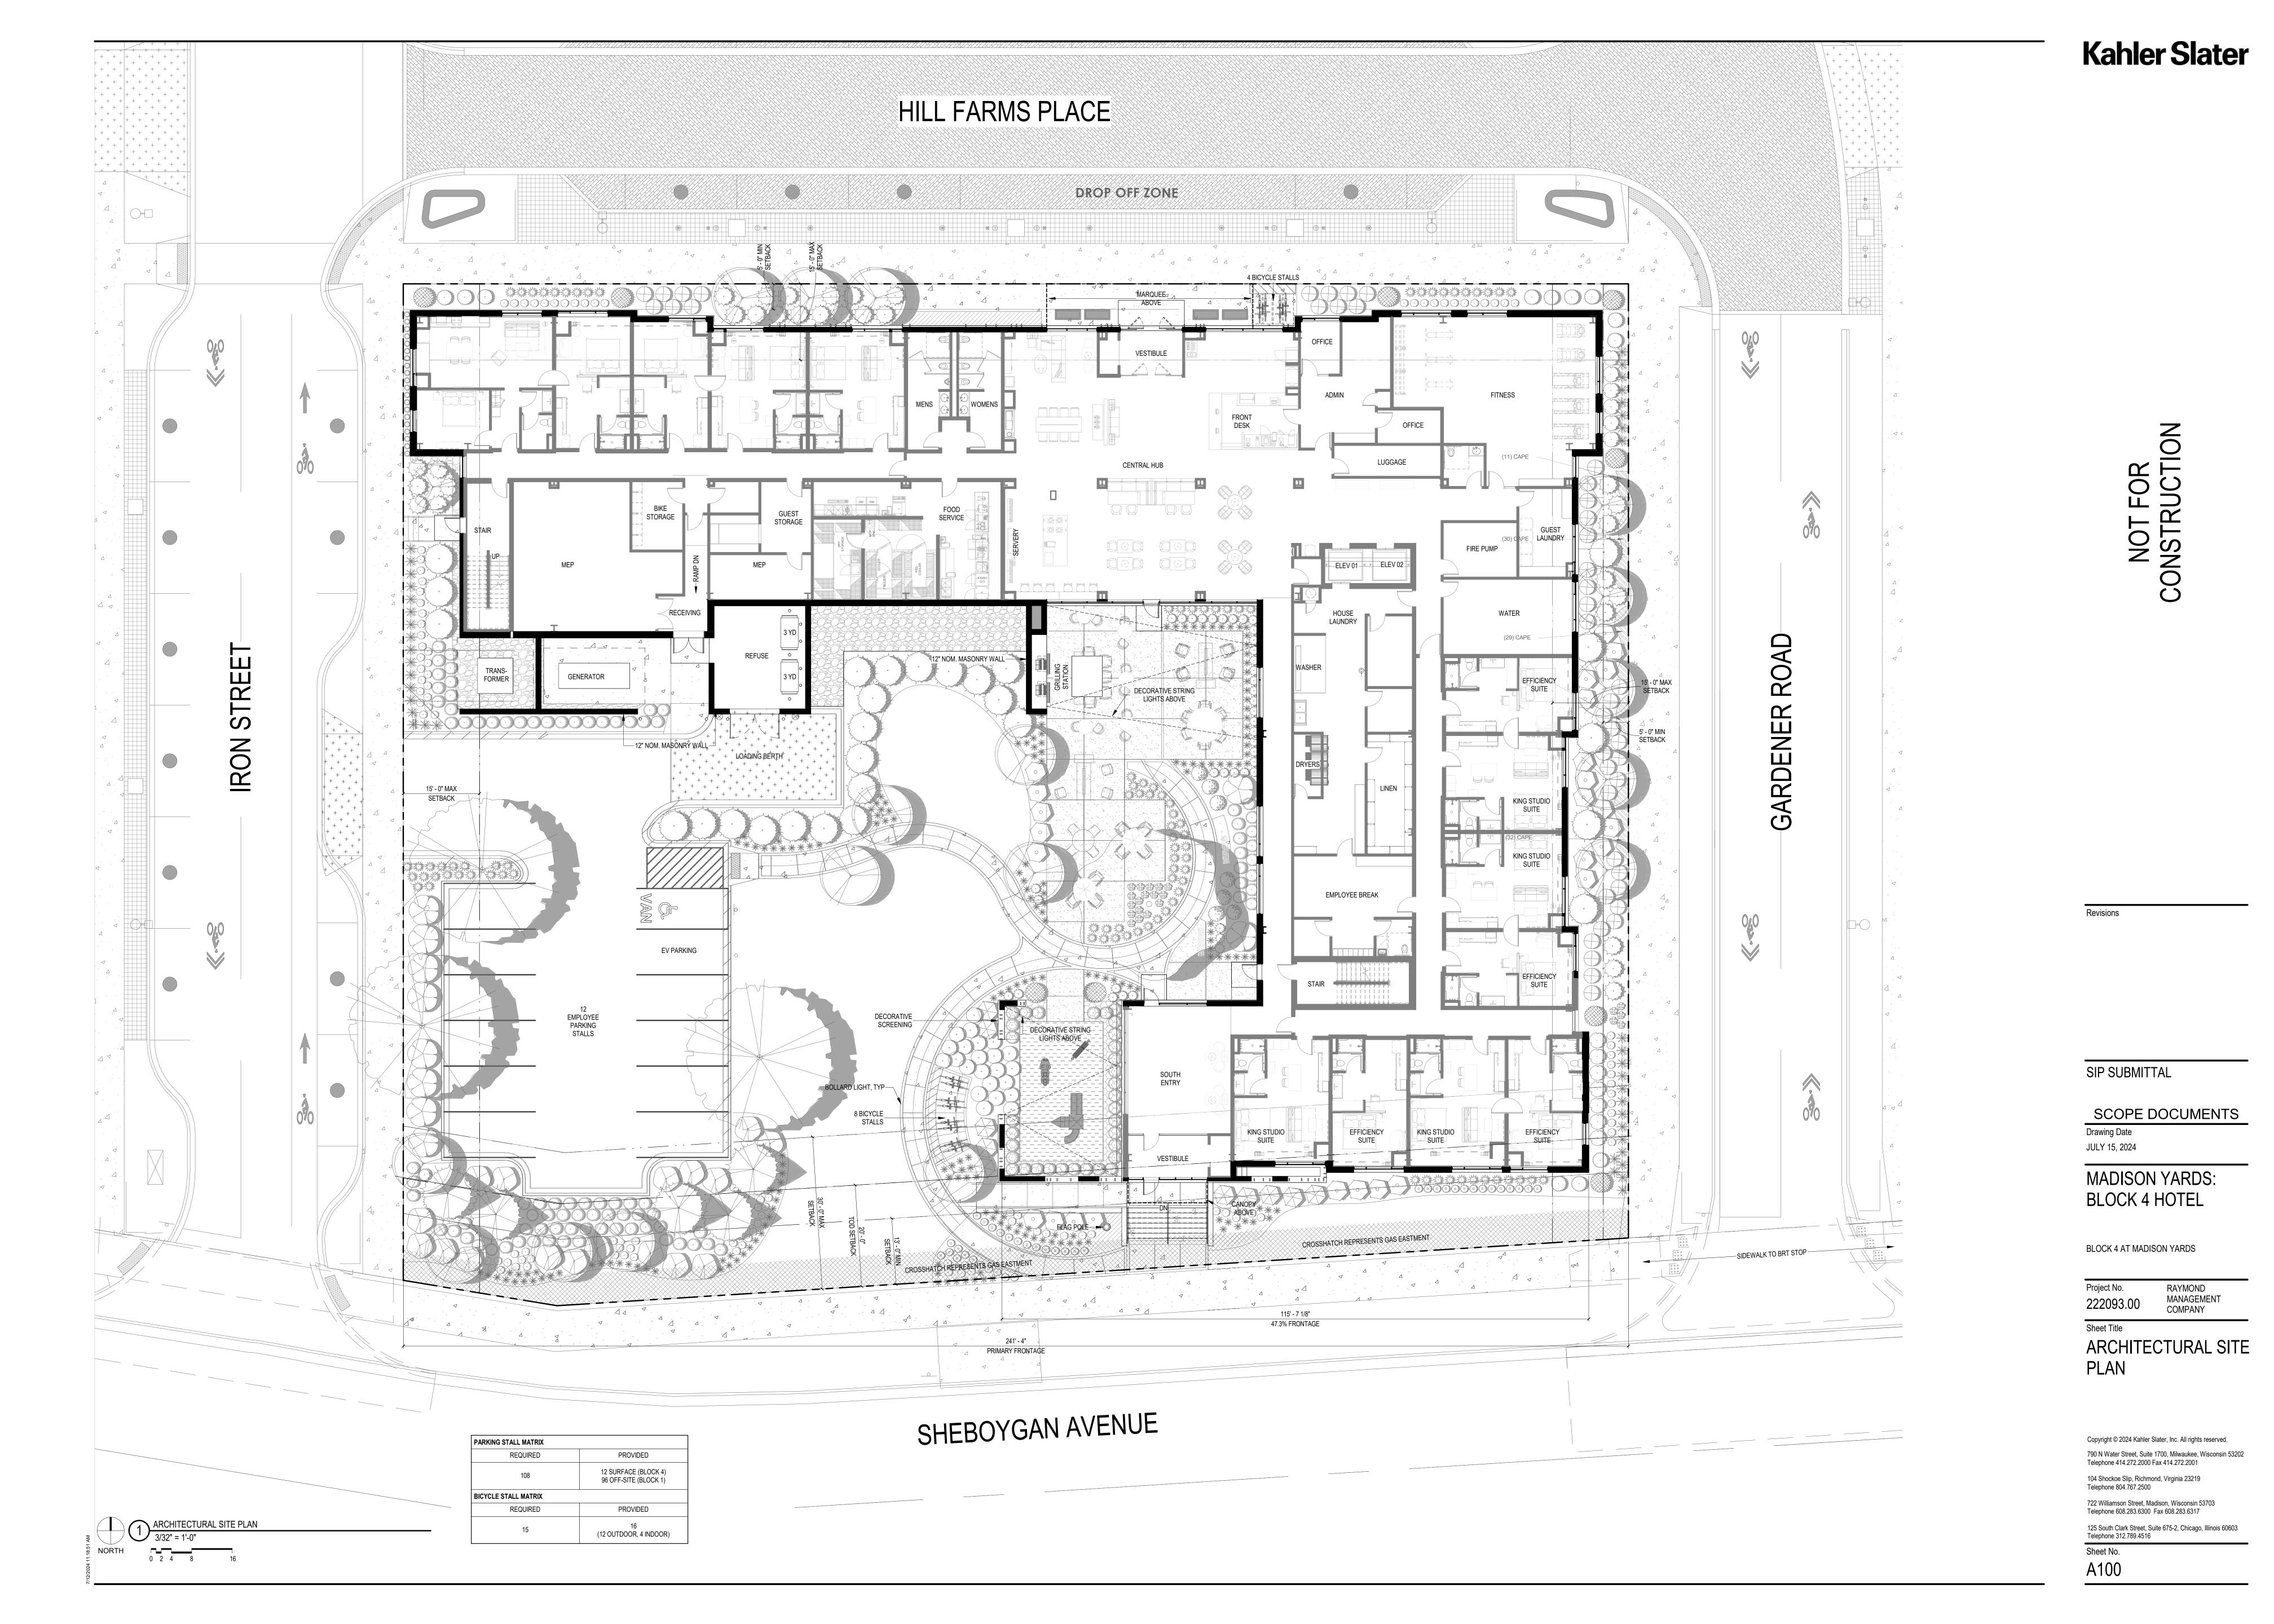

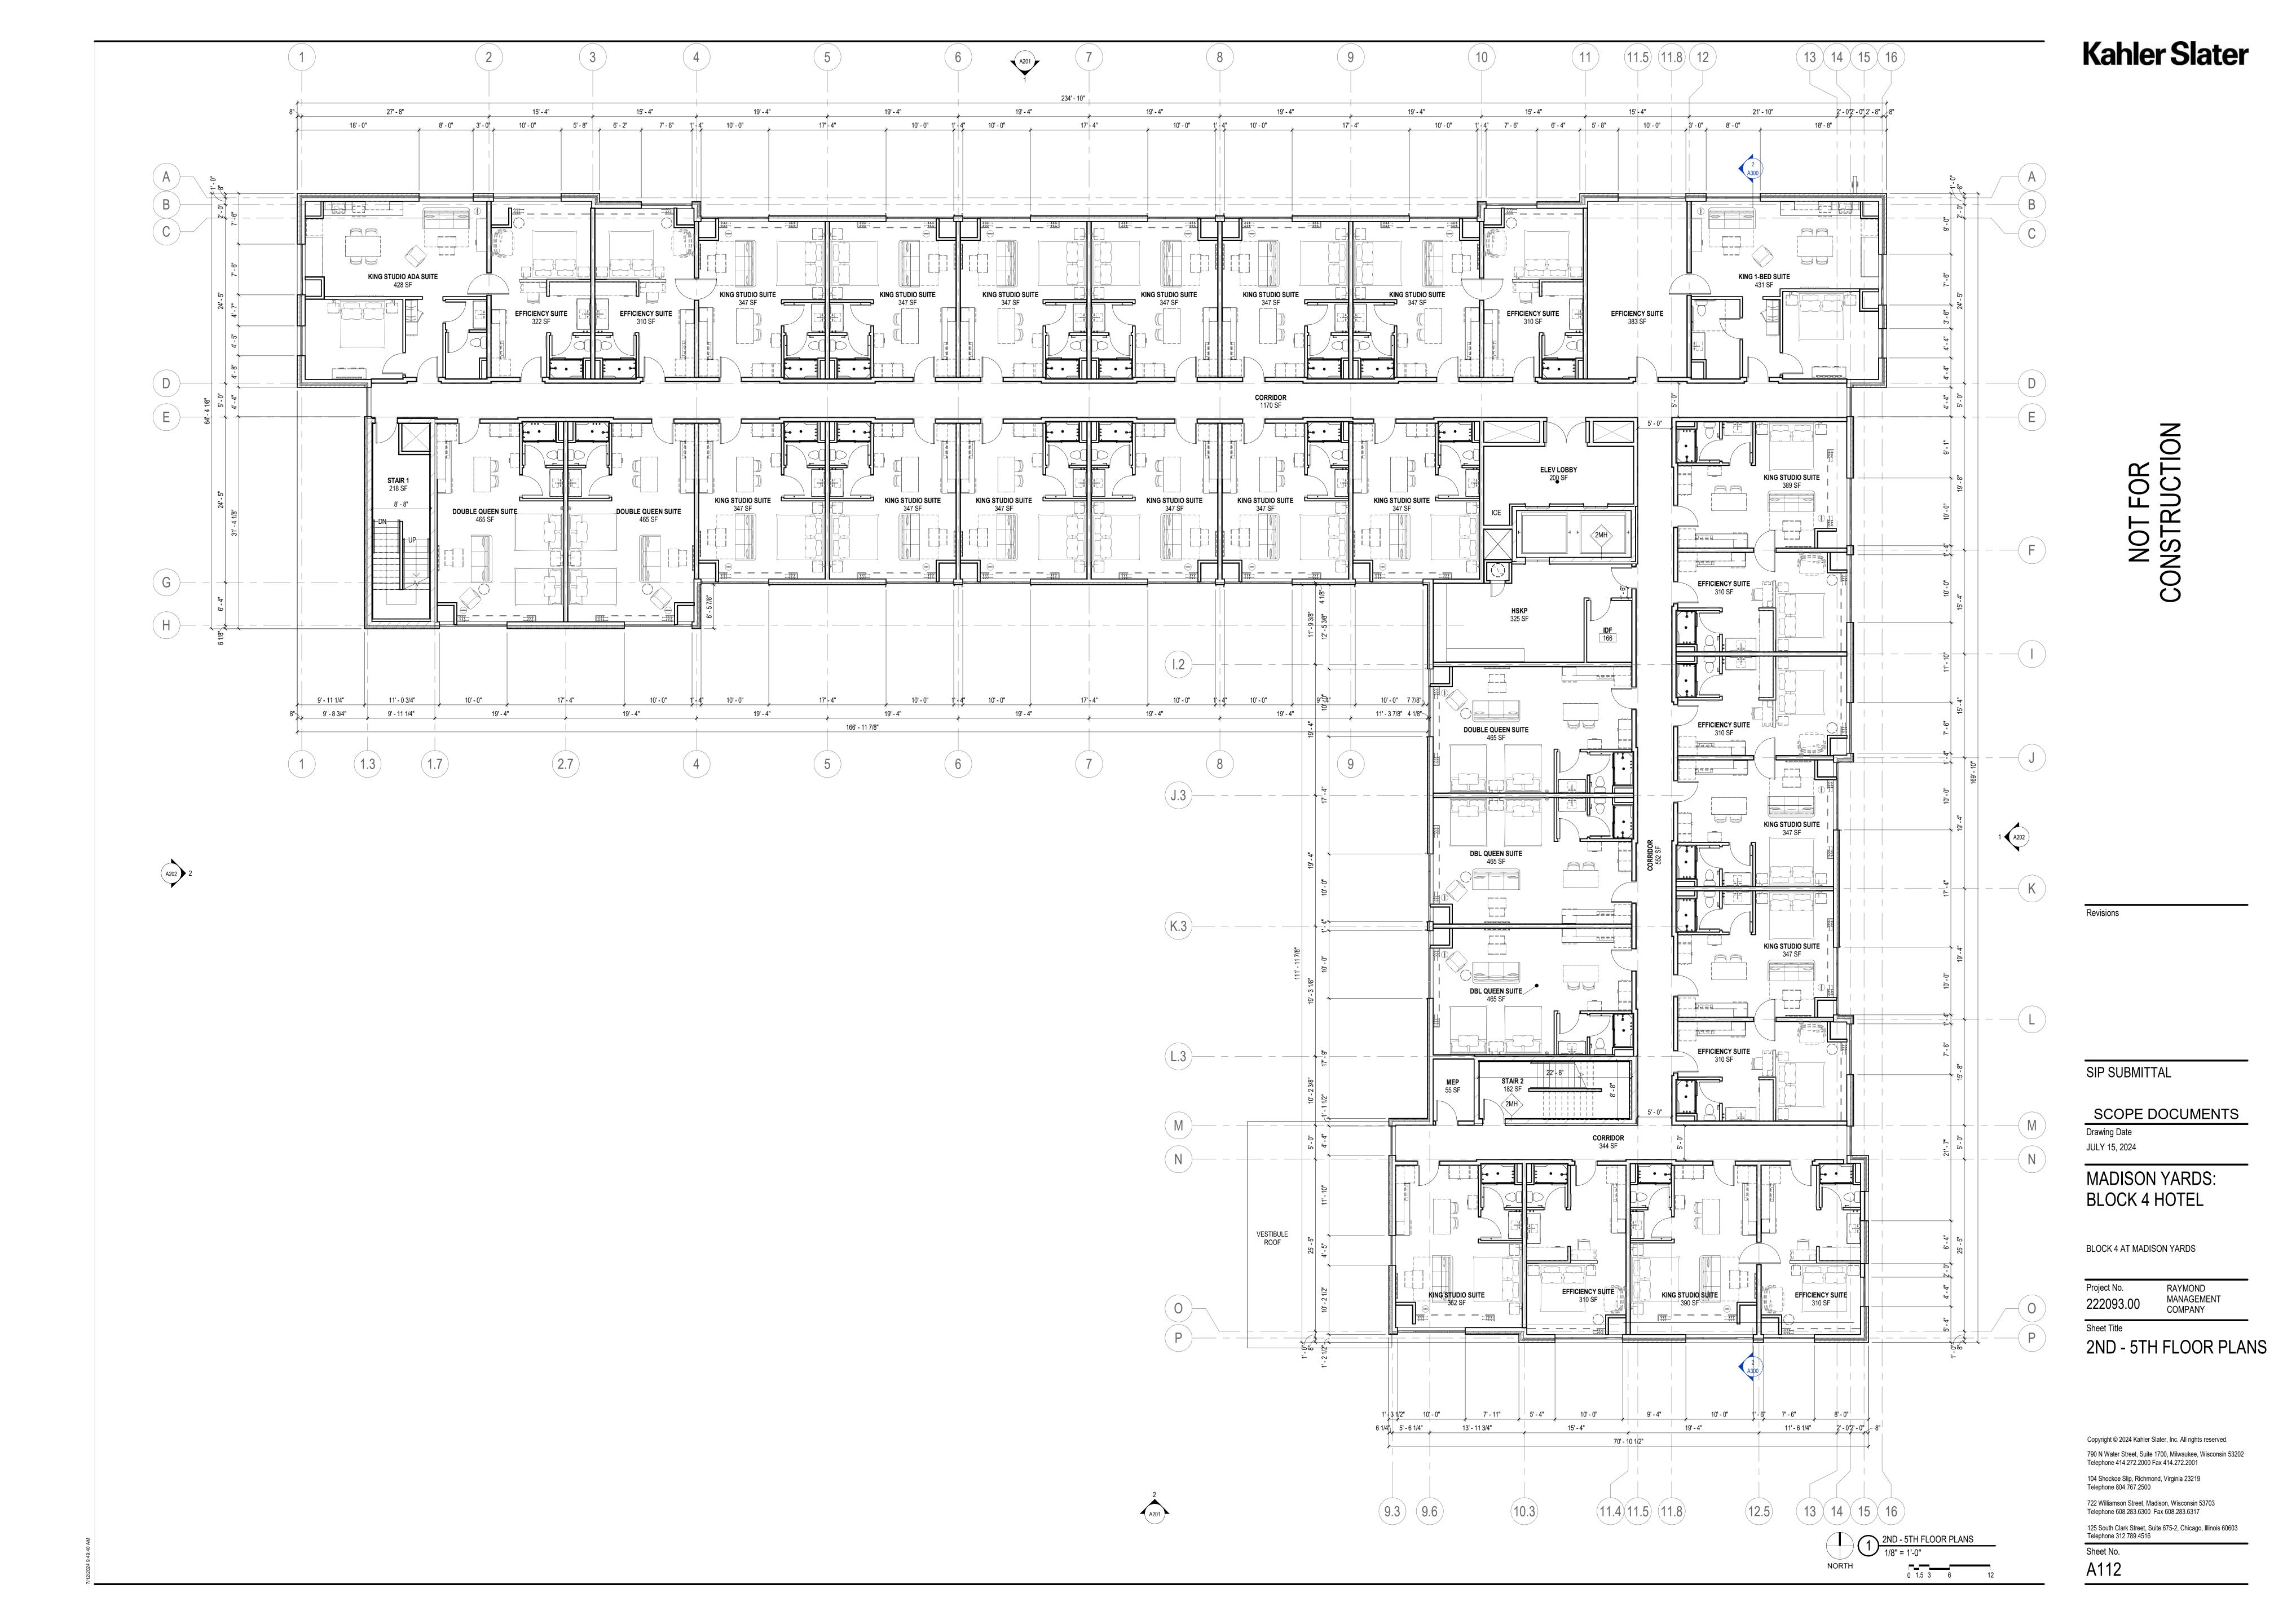

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# 4<u>TH</u> F<u>LOOR</u> 136' - 0 3/4" 3<u>RD</u> F<u>LOOR</u> 125' - 0 7/8"





EXTERIOR ELEVATION GENERAL NOTES	BRICK - DARK GRAY	BRICK - LIGHT GRAY	TEXTURED METAL PANEL	FIBER CEMENT BOARD - TAN	WOOD LOOK ACCENT
1. ALL METAL SURFACES EXPOSED TO VIEW (INCLUDING MISCELLANEOUS METALS, PIPING, MECHANICAL EQUIPMENT, LADDERS, STAIRS, RAILING, COLUMNS, PLATFORMS, ETC.) SHALL BE PAINTED, U.N.O.					
2. WINDOWS ARE ALUMINUM STOREFRONT U.N.O.  3. CONTROL JOINTS IN CMU BACKUP TO BE OFFSET FROM CONTROL JOINTS IN MASONRY/STONE VENEER. CONTROL JOINTS AT CMU BACKUP MAXIMUM 25' SPACING.					
4. PROVIDE CONTROL JOINTS AT INSIDE CORNERS OF BRICK AND STONE VENEERS.					
	THE RESIDENCE OF THE PARTY OF T				

NORTH ELEVATION

1/8" = 1'-0"

SIP SUBMITTAL SCOPE DOCUMENTS Drawing Date JULY 15, 2024 MADISON YARDS: BLOCK 4 HOTEL BLOCK 4 AT MADISON YARDS

> RAYMOND MANAGEMENT COMPANY Sheet Title **EXTERIOR ELEVATIONS**

Project No.

222093.00

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<u>WEST ELEVATION</u>
1/8" = 1'-0"



1/8" = 1'-0"

EXTERIOR ELEVATION GENERAL NOTES	BRICK - DARK GRAY	BRICK - LIGHT GRAY	TEXTURED METAL PANEL	FIBER CEMENT BOARD - TAN	WOOD LOOK ACCENT
1. ALL METAL SURFACES EXPOSED TO VIEW (INCLUDING MISCELLANEOUS METALS, PIPING, MECHANICAL EQUIPMENT, LADDERS, STAIRS, RAILING, COLUMNS, PLATFORMS, ETC.) SHALL BE PAINTED, U.N.O.					
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4. PROVIDE CONTROL JOINTS AT INSIDE CORNERS OF BRICK AND STONE VENEERS.					
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SCOPE DOCUMENTS

Drawing Date

MADISON YARDS: BLOCK 4 HOTEL

BLOCK 4 AT MADISON YARDS

Project No. RAYMOND

222093.00 MANAGEMENT
COMPANY

Sheet Title

EXTERIOR ELEVATIONS

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