

NOT FOR CONSTRUCTION

EROSION CONTROL NOTES/SPECIFICATIONS:

- EROSION CONTROL DEVICES AND/OR STRUCTURES SHALL BE INSTALLED PRIOR TO CLEARING AND GRUBBING OPERATIONS. THESE SHALL BE PROPERLY MAINTAINED FOR MAXIMUM EFFECTIVENESS UNTIL VEGETATION IS RE-ESTABLISHED.
 - EROSION CONTROL IS THE RESPONSIBILITY OF THE CONTRACTOR UNTIL ACCEPTANCE OF THIS PROJECT. EROSION CONTROL MEASURES AS SHOWN SHALL BE THE MINIMUM PRECAUTIONS THAT WILL BE ALLOWED. THE CONTRACTOR SHALL BE RESPONSIBLE FOR RECOGNIZING AND CORRECTING ALL EROSION CONTROL PROBLEMS THAT ARE THE RESULT OF CONSTRUCTION ACTIVITIES. ADDITIONAL EROSION CONTROL MEASURES, AS REQUESTED IN WRITING BY THE STATE OR LOCAL INSPECTORS, OR THE DEVELOPER'S ENGINEER, SHALL BE INSTALLED WITHIN 24 HOURS.
 - ALL EROSION CONTROL MEASURES AND STRUCTURES SERVING THE SITE MUST BE INSPECTED AT LEAST WEEKLY OR WITHIN 24 HOURS OF THE TIME 0.5 INCHES OF RAIN IS PRODUCED. ALL MAINTENANCE WILL FOLLOW AN INSPECTION WITHIN 24 HOURS. INSPECTION SCHEDULE AND RECORD KEEPING SHALL COMPLY WITH NR 216.46(9), WIS. ADM. CODE.
 - CONSTRUCTION ENTRANCES – PROVIDE A STONE TRACKING PAD AT EACH POINT OF ACCESS. INSTALL ACCORDING TO WDNR STANDARD 1057. REFER TO WDNR'S STORMWATER WEB PAGE OF TECHNICAL STANDARDS AT: [HTTP://DNR.WI.GOV/TOPIC/STORMWATER/STANDARDS/CONST-standards.html](http://dnr.wi.gov/topic/stormwater/standards/const-standards.html). THE TRACKING PAD MUST BE MAINTAINED IN A CONDITION THAT PREVENTS THE TRACKING OF MATERIAL ONTO THE PUBLIC STREET.
 - SOIL STOCKPILES – A ROW OF SILT FENCE PLACED DOWNSLOPE AND AT LEAST 10 FEET AWAY FROM THE STOCKPILE SHALL PROTECT ALL STOCKPILES. SOIL STOCKPILES THAT ARE INACTIVE FOR MORE THAN 14 CONSECUTIVE DAYS SHALL BE STABILIZED WITH SEED & MULCH, EROSION MAT, POLYMER, OR COVERED WITH TARPS OR SIMILAR MATERIAL. NO STOCKPILE SHALL BE PLACED WITHIN 20 FEET OF A DRAINAGE WAY.
 - DEWATERING – WATER PUMPED FROM THE SITE SHALL BE TREATED BY USING A TEMPORARY SEDIMENTATION BASIN, PORTABLE DEWATERING BASIN, GEOTEXTILE BAG, OR AN EQUIVALENT DEVICE. SHOW ON THE PLAN THE ANTICIPATED LOCATIONS OF DEWATERING ACTIVITY, AND PROVIDE AN ENGINEERING DETAIL OF THE DEWATERING SYSTEM. DEVICES SHALL COMPLY WITH WDNR TECHNICAL STANDARD 1061 FOUND AT: [HTTP://DNR.WI.GOV/TOPIC/STORMWATER/STANDARDS/CONST-standards.html](http://dnr.wi.gov/topic/stormwater/standards/const-standards.html). THIS WATER SHALL BE DISCHARGED IN A MANNER THAT DOES NOT INDUCE EROSION OF THE SITE OR ADJACENT PROPERTY.
- | | |
|---------------------|-------------------------|
| PUMP SIZE (MAX GPM) | TYPE I BAG SIZE (SQ-FT) |
| 50 | 25 |
| 100 | 50 |
| 150 | 75 |
- STORM SEWER INLETS – PROVIDE WDOT TYPE D "CATCHALL" INLET PROTECTION OR EQUIVALENT. REFER TO WDOT PRODUCT ACCEPTABILITY LIST AT: [HTTP://WWW.DOT.WISCONSIN.GOV/BUSINESS/ENGRSERV/PAL.HTM](http://www.dot.wisconsin.gov/business/engrserve/pal.htm). INLET PROTECTION SHALL BE INSTALLED PRIOR TO THE STORM SEWER SYSTEM RECEIVING SITE RUNOFF. OTHER THAN FOR PERFORMING MAINTENANCE, THESE DEVICES SHALL NOT BE REMOVED UNTIL PLAT-LEVEL STABILIZATION IS COMPLETE.
 - BUILDING AND WASTE MATERIALS SHALL BE PREVENTED FROM RUNNING-OFF THE SITE AND ENTERING WATERS OF THE STATE IN CONFORMANCE WITH NR151.12(6M).
 - NO SOLID MATERIAL SHALL BE DISCHARGED OR DEPOSITED INTO WATERS OF THE STATE IN VIOLATION OF CH. 30 OR 31 OF THE WISCONSIN STATE STATUTES OR 33 USC 1344 PERMITS.
 - EROSION CONTROL DEVICES SHALL ADHERE TO THE TECHNICAL STANDARDS FOUND AT: [HTTP://DNR.WI.GOV/RUNOFF/STORMWATER/TECHSTDs.HTM](http://dnr.wi.gov/runoff/stormwater/techstds.htm) AND COMPLY WITH ALL CITY OF MADISON ORDINANCES.
 - ALL DEBRIS TRACKED ONTO PUBLIC STREETS SHALL BE BE SWEEPED OR SCRAPPED CLEAN BY THE END OF EACH WORKDAY.
 - ALL BUILDING AND WASTE MATERIAL SHALL BE HANDLED PROPERLY TO PREVENT RUNOFF OF THESE MATERIALS OFF OF THE SITE.
 - ALL DISTURBED AREAS SHALL BE SEEDED IMMEDIATELY AFTER GRADING ACTIVITIES HAVE BEEN COMPLETED.
 - ALL DISTURBED AREAS, EXCEPT PAVED AREAS, SHALL RECEIVE A MINIMUM OF FOUR (4) INCHES OF TOPSOIL, FERTILIZER, SEED, AND MULCH. SEED MIXTURES SHALL BE SELECTED APPROPRIATE TO THE INTENDED FUNCTION. A QUALIFIED LANDSCAPING CONTRACTOR, LANDSCAPE ARCHITECT OR NURSERY CAN BE CONSULTED FOR RECOMMENDATIONS. SEEDING RATES SHALL BE BASED ON POUNDS OR OUNCES OF PURE LIVE SEED PER ACRE AND SHALL BE PROVIDED BY THE SEED SUPPLIER. FERTILIZER CAN BE APPLIED TO HELP PROMOTE GROWTH, BUT A SOIL TEST IS RECOMMENDED TO DETERMINE THE TYPE AND AMOUNT OF FERTILIZER TO BE APPLIED. ALL SEEDING AND RESTORATION SHALL BE IN CONFORMANCE TO WDNR TECHNICAL STANDARD 1059 FOUND AT [HTTP://DNR.WI.GOV/TOPIC/STORMWATER/STANDARDS/CONST-standards.html](http://dnr.wi.gov/topic/stormwater/standards/const-standards.html). SEEDING AND SODDING MAY ONLY BE USED FROM MAY 1ST TO SEPTEMBER 15TH OF ANY YEAR. TEMPORARY SEED SHALL BE USED AFTER SEPTEMBER 15. IF TEMPORARY SEEDING IS USED, A PERMANENT COVER SHALL ALSO BE REQUIRED AS PART OF THE FINAL SITE STABILIZATION.
 - FOR THE FIRST SIX (6) WEEKS AFTER THE INITIAL STABILIZATION OF A DISTURBED AREA, WATERING SHALL BE PERFORMED WHENEVER MORE THAN SEVEN (7) DAYS OF DRY WEATHER ELAPSE.

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SCHEDULE:

- | | |
|------------|---|
| 08/19/2024 | INSTALL SILT FENCE AND CONSTRUCTION ENTRANCE AND BEGIN DISTURBANCE OF SITE GROUND COVER. |
| | EXCAVATE FOR BIORETENTION BASINS. LEAVE 1 FOOT OF SOIL TO PROTECT NATIVE SOIL HYDRAULIC CONDUCTIVITY RATES. THE BASINS SHALL BE UTILIZED AS SEDIMENT TRAPS UNTIL THE REMAINING SITE AREA HAS BEEN STABILIZED. |
| | SEED, MULCH AND EROSION MAT STEEP SLOPES. |
| | BASE COURSE INSTALLED. APPLY SEED AND MULCH TO ALL DISTURBED AREAS. |
| | VEGETATION ESTABLISHED. PLACE THE ENGINEERED SOIL AND COMPLETE BIORETENTION BASINS. |

GENERAL NOTES:

- IT IS THE CONTRACTOR'S RESPONSIBILITY TO VERIFY THE LOCATION OF UNDERGROUND UTILITIES. UTILITIES WERE LOCATED BY OBSERVED EVIDENCE, MARKINGS PROVIDED BY DIGGER'S HOTLINE, AND RECORD DRAWINGS FROM THE CITY OF MADISON.
- CONTRACTOR SHALL VERIFY THE SIZE, TYPE, SLOPE, AND INVERTS OF ALL EXISTING STORM AND SANITARY LATERALS CALLED OUT TO BE CONNECTED TO. CONTRACTOR SHALL SUBMIT THE INFORMATION ON THE PIPES TO THE CITY INSPECTOR AND PROJECT CIVIL ENGINEER.
- ANY SIDEWALK, CURB, OR OTHER PUBLIC PROPERTY DAMAGED AS PART OF THE CONSTRUCTION OF THE UTILITIES AND BUILDING SHALL BE REPLACED IN-KIND PER THE CITY OF MADISON STANDARD SPECIFICATIONS.
- THE RIGHT-OF-WAY IS THE SOLE JURISDICTION OF THE CITY OF MADISON AND IS SUBJECT TO CHANGE AT ANY TIME PER THE RECOMMENDATION/PLAN OF THE CITY.
- CONTRACTOR SHALL INSTALL TREE PROTECTION FENCING IN THE AREA BETWEEN THE CURB AND SIDEWALK AND EXTEND IT AT LEAST 5 FEET FROM BOTH SIDES OF THE TREE ALONG THE LENGTH OF THE TERRACE. NO EXCAVATION IS PERMITTED WITHIN 5 FEET OF THE OUTSIDE EDGE OF A TREE TRUNK. IF EXCAVATION WITHIN 5 FEET OF ANY TREE IS NECESSARY, CONTRACTOR SHALL CONTACT CITY FORESTRY (266-4816) PRIOR TO EXCAVATION TO ASSESS THE IMPACT TO THE TREE AND ROOT SYSTEM. TREE PRUNING SHALL BE COORDINATED WITH CITY FORESTRY PRIOR TO THE START OF CONSTRUCTION. TREE PROTECTION SPECIFICATIONS CAN BE FOUND IN SECTION 107.13 OF CITY OF MADISON STANDARD SPECIFICATIONS FOR PUBLIC WORKS CONSTRUCTION <http://www.cityofmadison.com/business/pw/documents/stdspecs/2018/part1.pdf>. ANY TREE REMOVALS THAT ARE REQUIRED FOR CONSTRUCTION AFTER THE DEVELOPMENT PLAN IS APPROVED WILL REQUIRE AT LEAST A 72 HOUR WAIT PERIOD BEFORE A TREE REMOVAL PERMIT CAN BE ISSUED BY FORESTRY, TO NOTIFY THE ALDER OF THE CHANGE IN THE TREE PLAN.

SITE PLAN NOTES:

- PAVEMENT DESIGN SHALL BE PER THE RECOMMENDATION OF THE SOILS CONSULTANT.
- TRAFFIC CONTROL SIGNAGE SHALL BE IN ACCORDANCE WITH FEDERAL, STATE, COUNTY, CITY, AND LOCAL CODE, WHICHEVER HAS JURISDICTION.
- NEW APRONS SHALL BE CONSTRUCTED AND PLACED IN CONFORMANCE WITH THE CITY OF MADISON STANDARD DETAIL 3.02 FOR COMMERCIAL OPENINGS.


GRADING PLAN NOTES:

- ALL GRADES ARE FINISH ELEVATION UNLESS NOTED OTHERWISE.

UTILITY PLAN NOTES:

- ALL WORK WITHIN THE CITY RIGHT OF WAY AND EASEMENTS SHALL BE COMPLIANT WITH THE CITY OF MADISON STANDARD SPECIFICATIONS CURRENT AT THE TIME OF CONSTRUCTION.
- UTILITY INSTALLATION SHALL BE COORDINATED WITH ENGINEER AT LEAST 4 WEEKS PRIOR TO INSTALLATION TO ENSURE BUILDING INSPECTION APPROVAL IS OBTAINED.
- PRIVATE WATER MAINS AND WATER SERVICES SHALL BE INSTALLED AT LEAST 5 FEET HORIZONTALLY FROM ANY SANITARY SEWER.
- WATER PIPING SHALL BE INSTALLED AT LEAST 12 INCHES ABOVE AND 18 INCHES BELOW THE BOTTOM OF ANY SEWER.

Installation Details

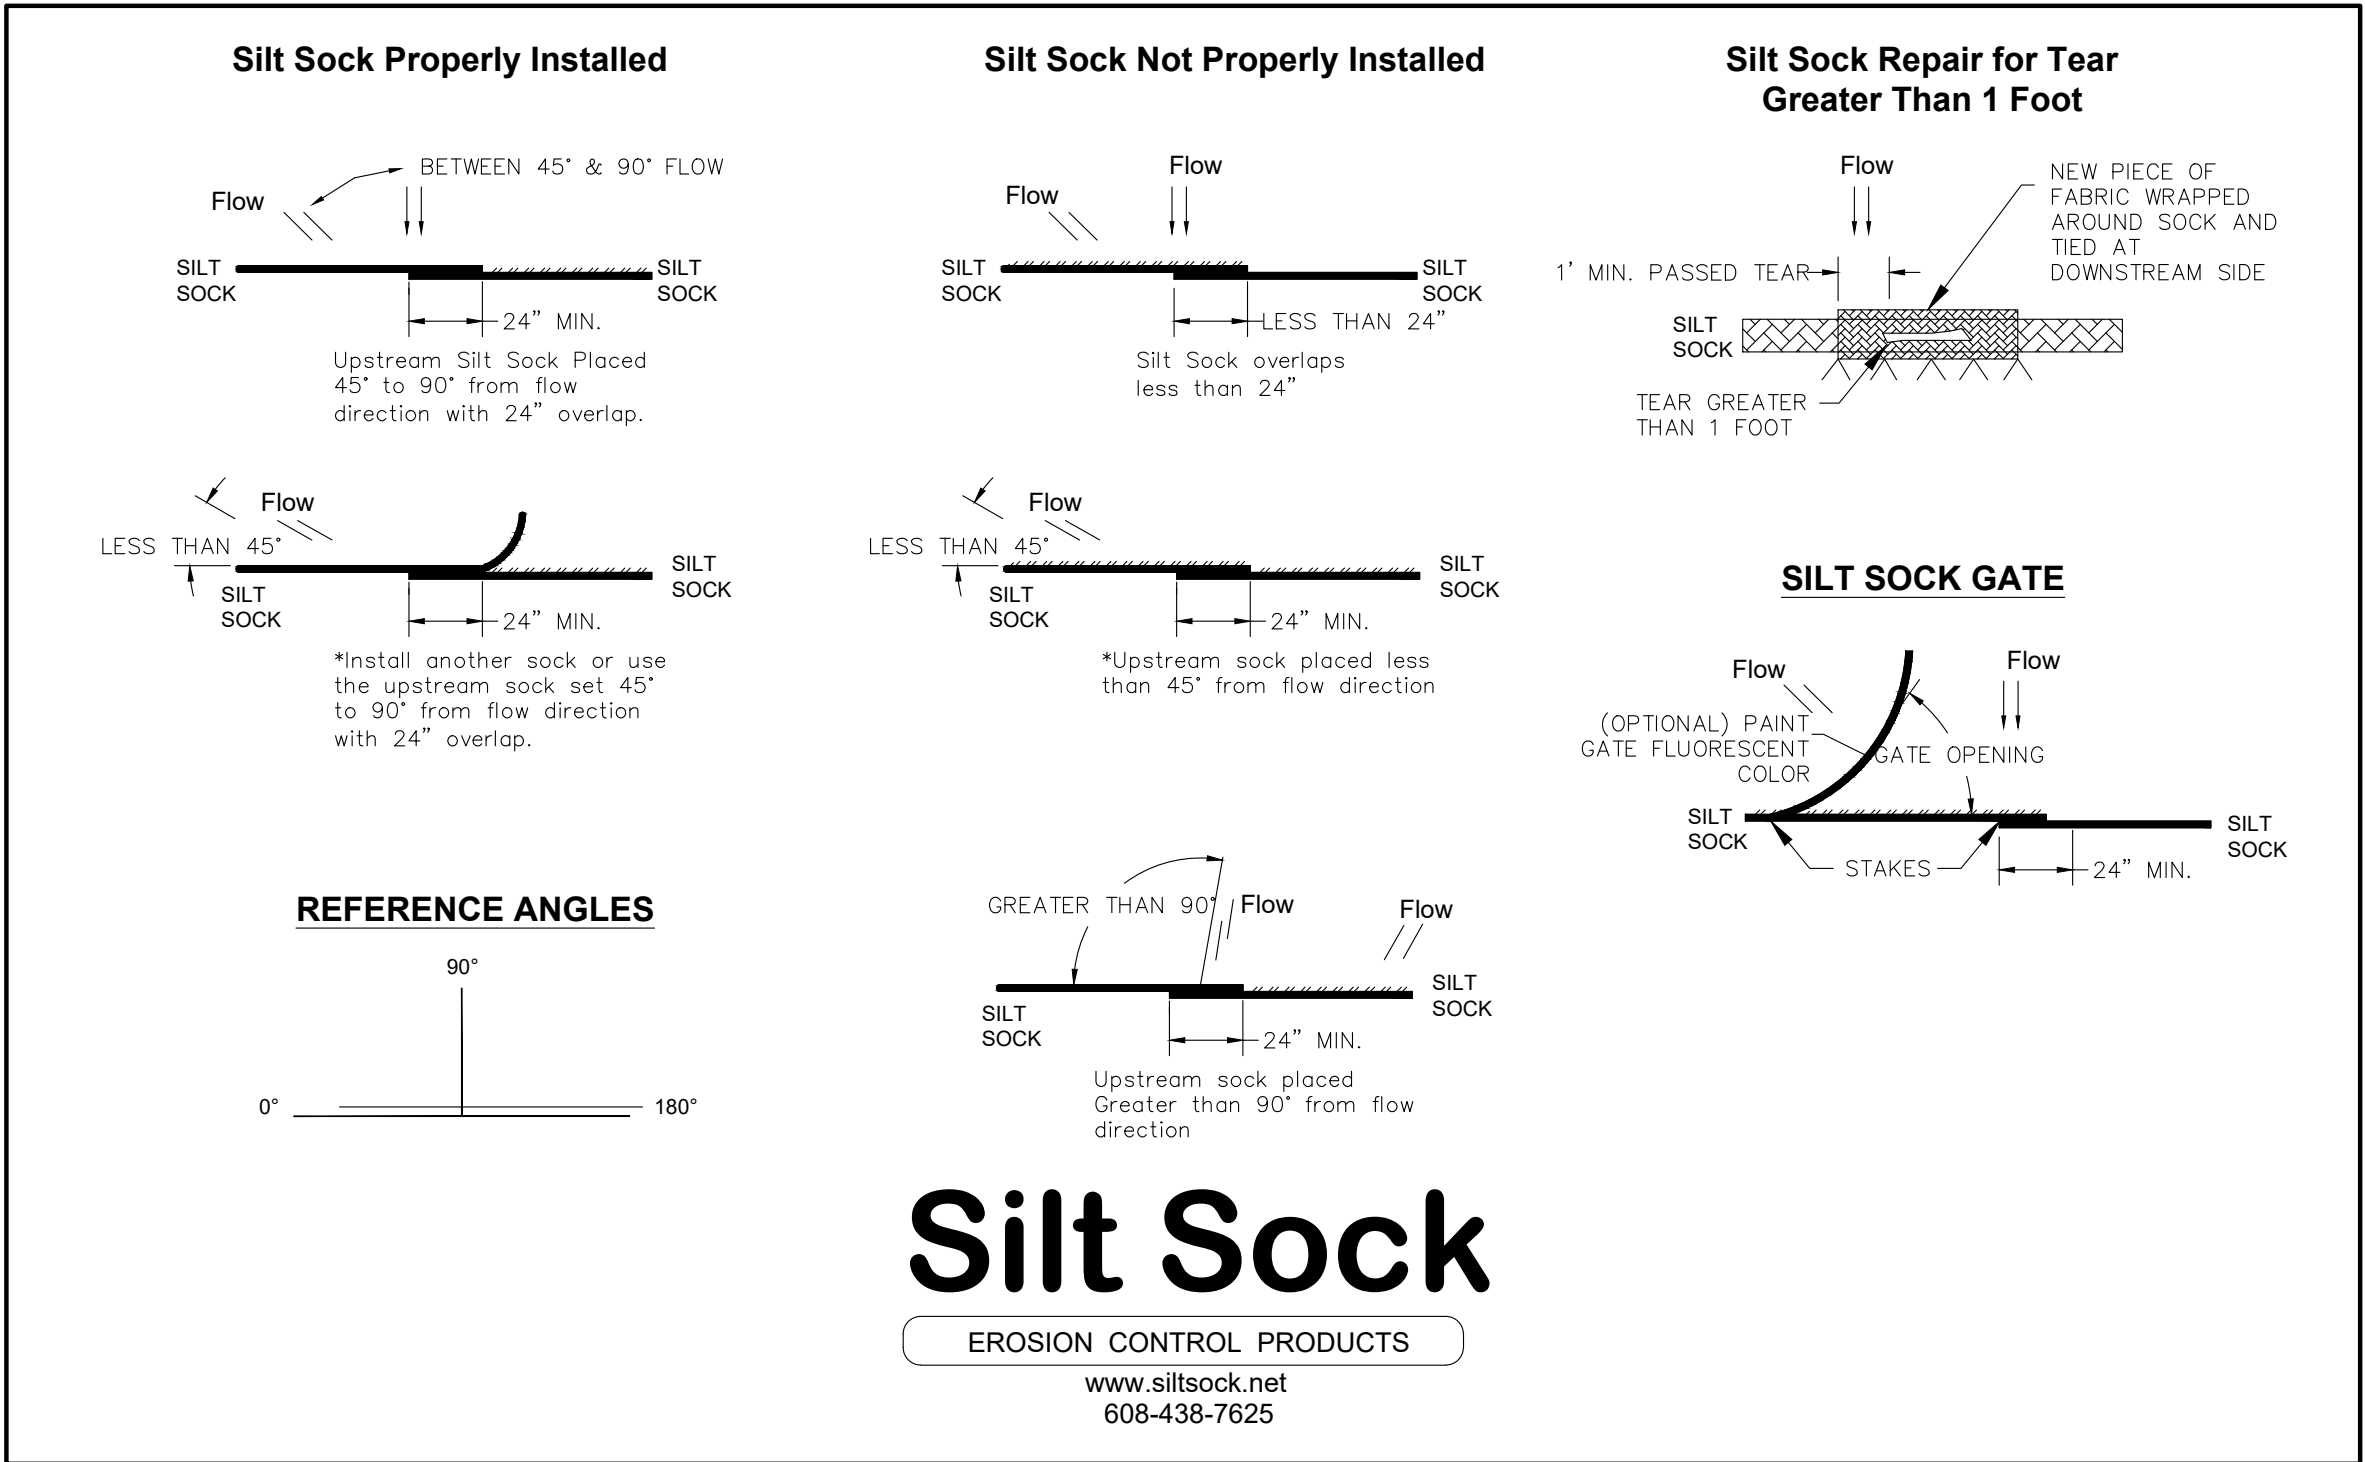

LEGEND/ ABBREVIATIONS

---	ACCESSIBLE ROUTE
---	EXISTING EASEMENT
---	PROPERTY BOUNDARY
#	PARKING STALL COUNT
L.S.	LANDSCAPED AREA
BIT.	BITUMINOUS PAVEMENT
CONC.	CONCRETE PAVEMENT
1041.02	SPOT GRADE
FG	FINISH GRADE
EG	EXISTING GRADE
SW	SIDEWALK
EP	EDGE OF PAVEMENT
FL	FLOW LINE
LP	LOW POINT
HP	HIGH POINT
TC	TOP OF CURB
TW	TOP OF WALL
BW	BOTTOM OF WALL
BOW	BACK OF WALK
FOW	FRONT OF WALK
EXP	EXPOSURE
SAN	PROPOSED SANITARY SEWER
ST	PROPOSED STORM SEWER
WM	PROPOSED WATER LATERAL
~~~~~	UTILITY LINE DEMOLITION
X	TREE REMOVAL
1041	EXISTING MINOR CONTOUR
1040	EXISTING MAJOR CONTOUR
1041	PROPOSED MINOR CONTOUR
1040	PROPOSED MAJOR CONTOUR
---	PROPOSED RIDGE LINE
---	PROPOSED SWALE/DITCH
+	ACCESSIBLE PARKING SIGN
▲	VISION TRIANGLE (NO VISUAL OBSTRUCTIONS BETWEEN HEIGHTS OF 30" AND 10')
□	RIPRAP
□	CONSTRUCTION ENTRANCE
---	SAW CUT / REMOVAL LIMITS
---	DISTURBANCE LIMITS
□	SILT FENCE
□	SILT SOCK
□	CHECK DAM
□	DIVERSION BERM
✕	INLET PROTECTION
---	USLE FLOW PATH
□	EROSION CONTROL MAT
□	BIORETENTION FACILITY

SHEET INDEX	
SHEET NUMBER	SHEET TITLE
C-001	CIVIL NOTES
C-002	CIVIL DETAILS
C-100	EXISTING CONDITIONS
C-200	EROSION CONTROL
C-300	SITE PLAN
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C-500	UTILITY PLAN
C-600	FIRE ACCESS PLAN
L-100	LANDSCAPE PLAN
A-100	BUILDING ELEVATIONS
A-200	FLOOR PLAN



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6334 Mill Pond Rd.  
Madison, WI 53718  
SCHULEBURG & DAUGHTER ENTERPRISES II, LLC  
1400 OLSTAD RD  
DEERFIELD, WI 53531-9309

PROJECT #: BSE2849  
PLOT DATE: 05/13/2024

REVISION DATES:

ISSUE DATES:

05/13/2024

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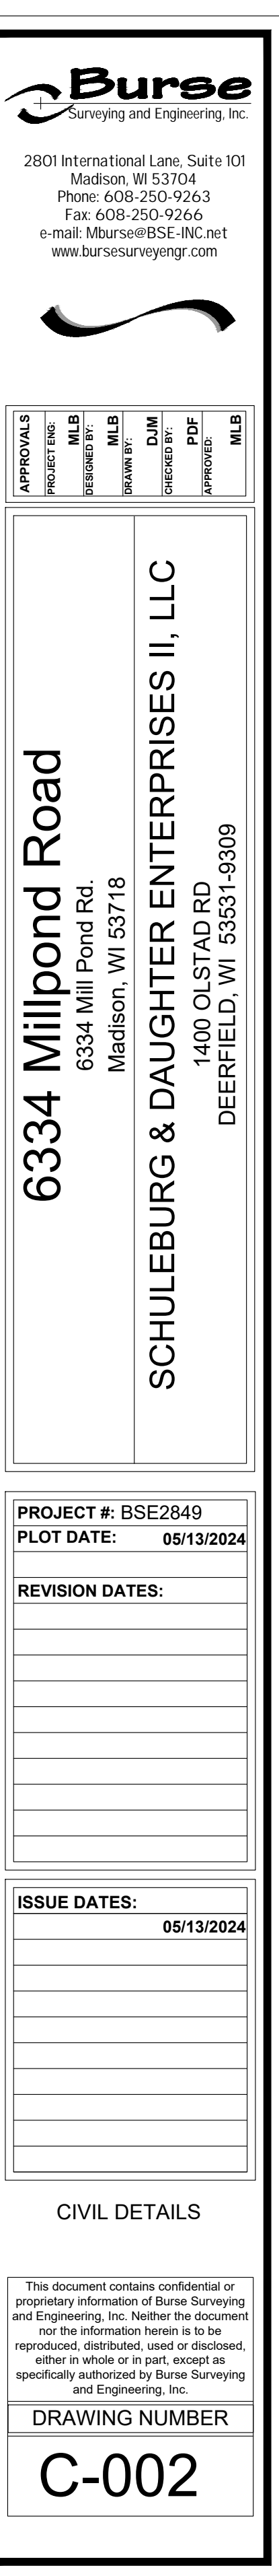
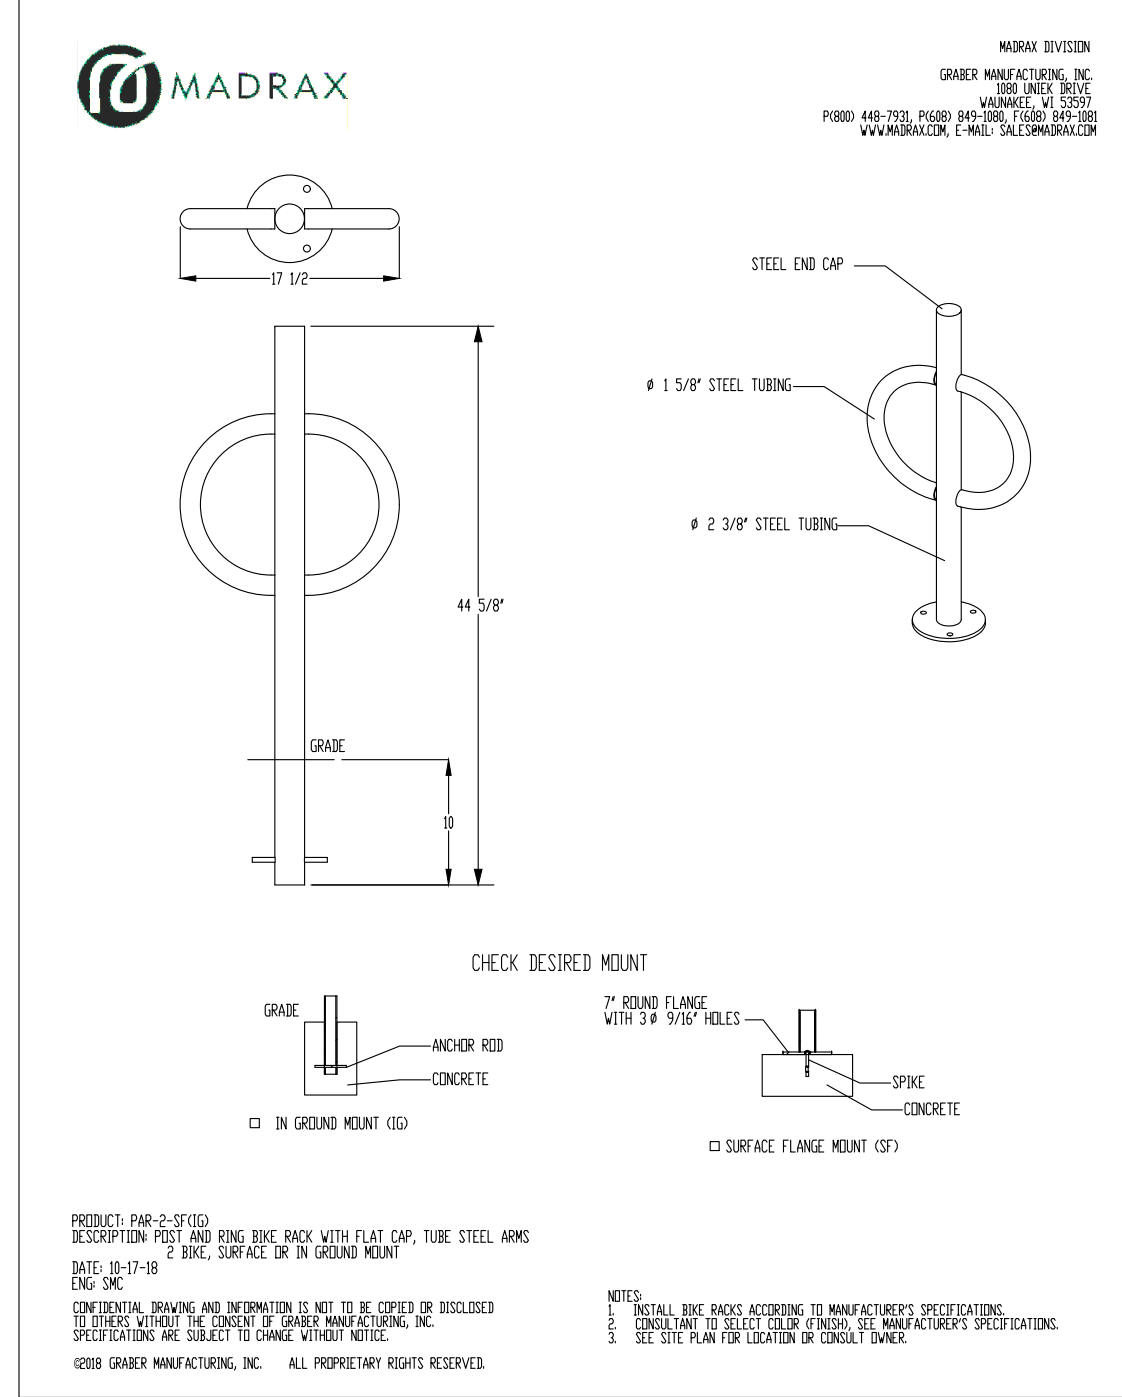
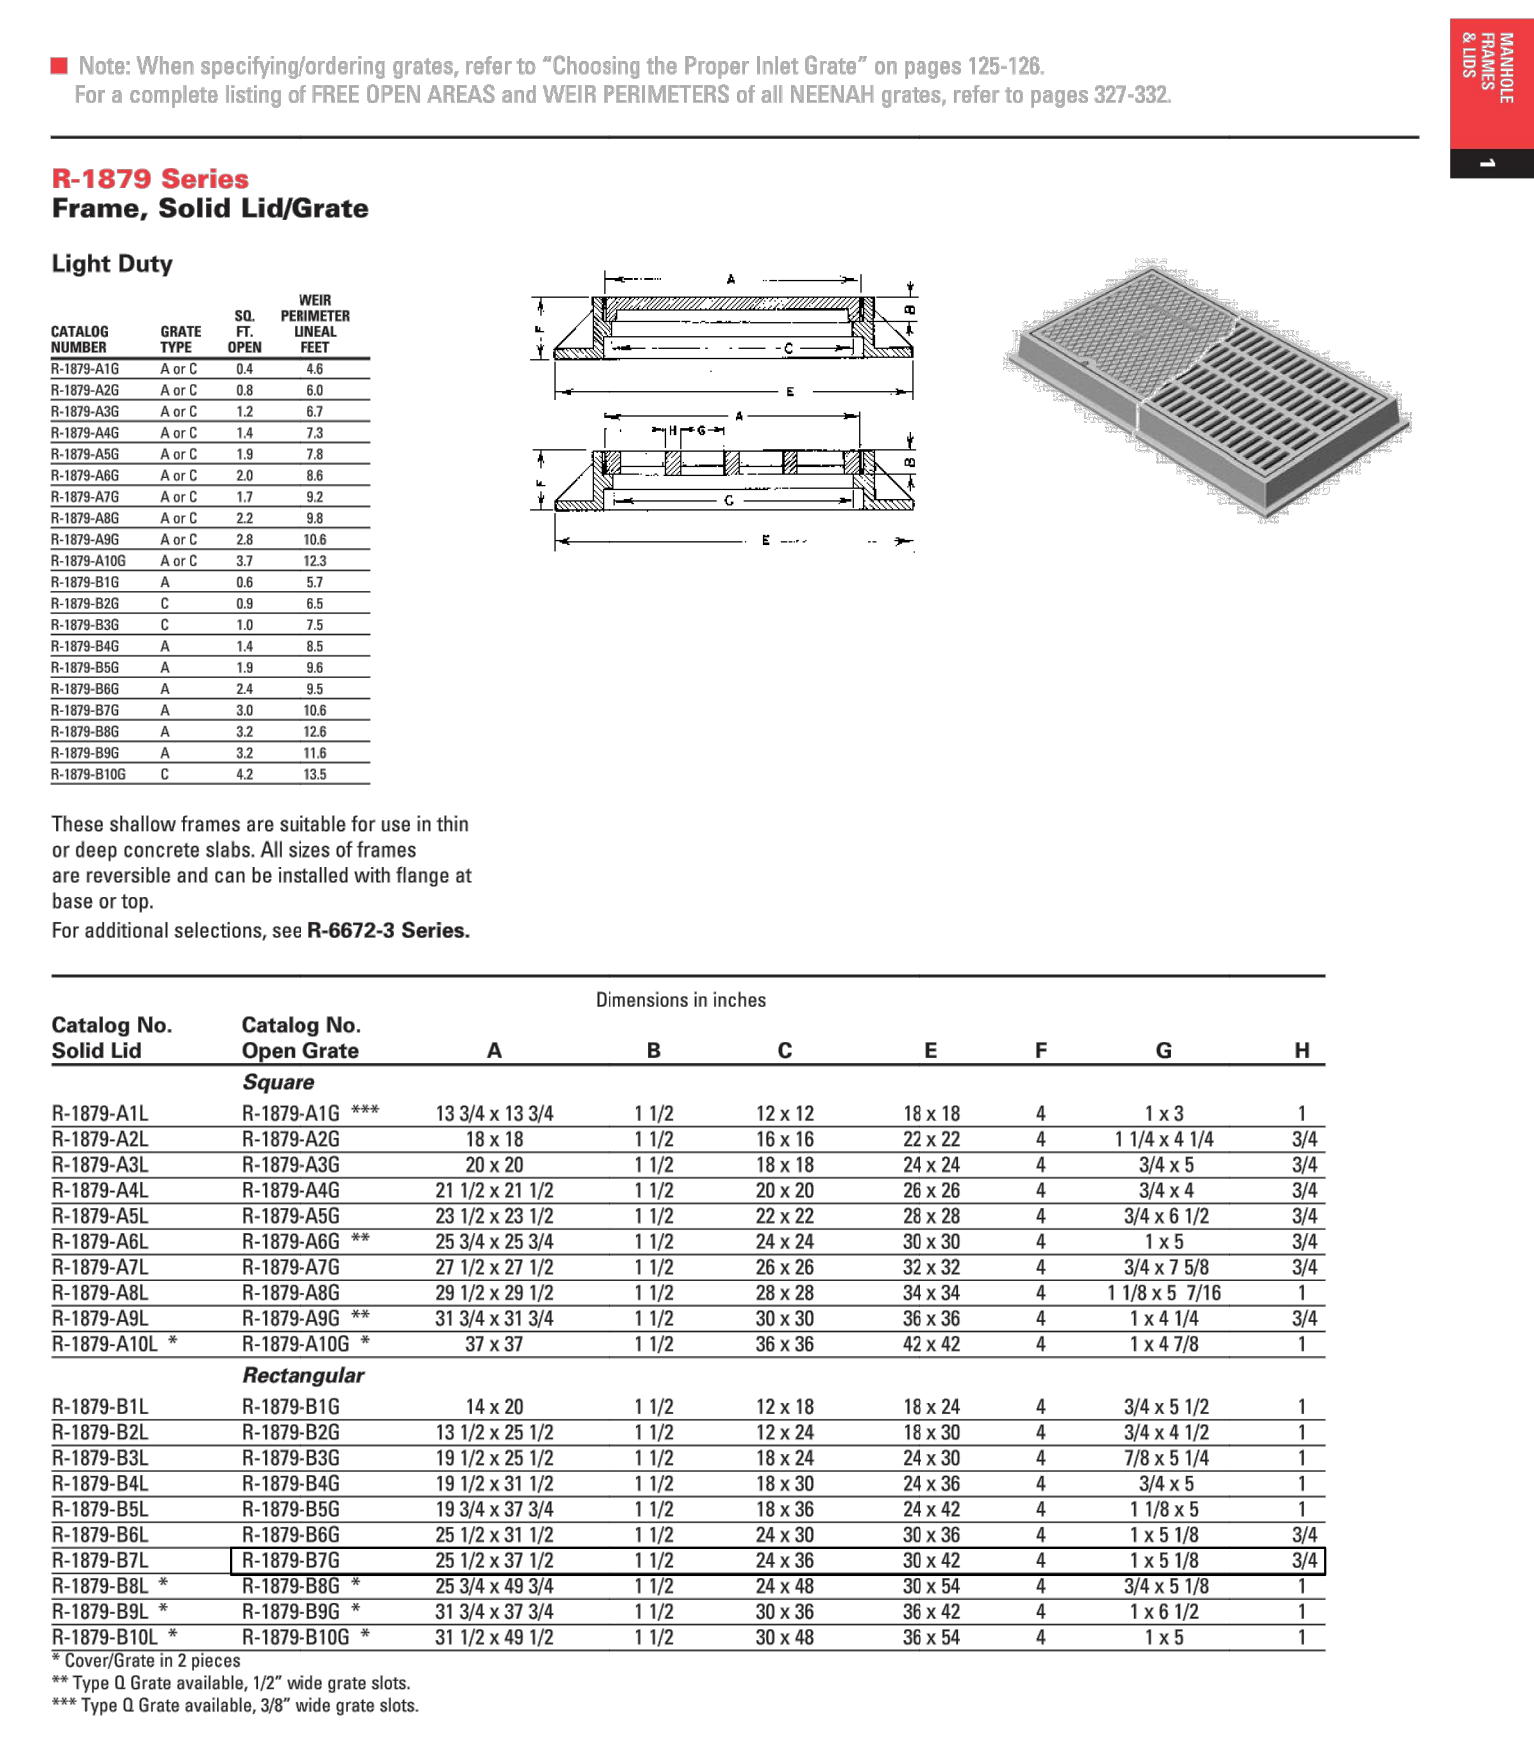
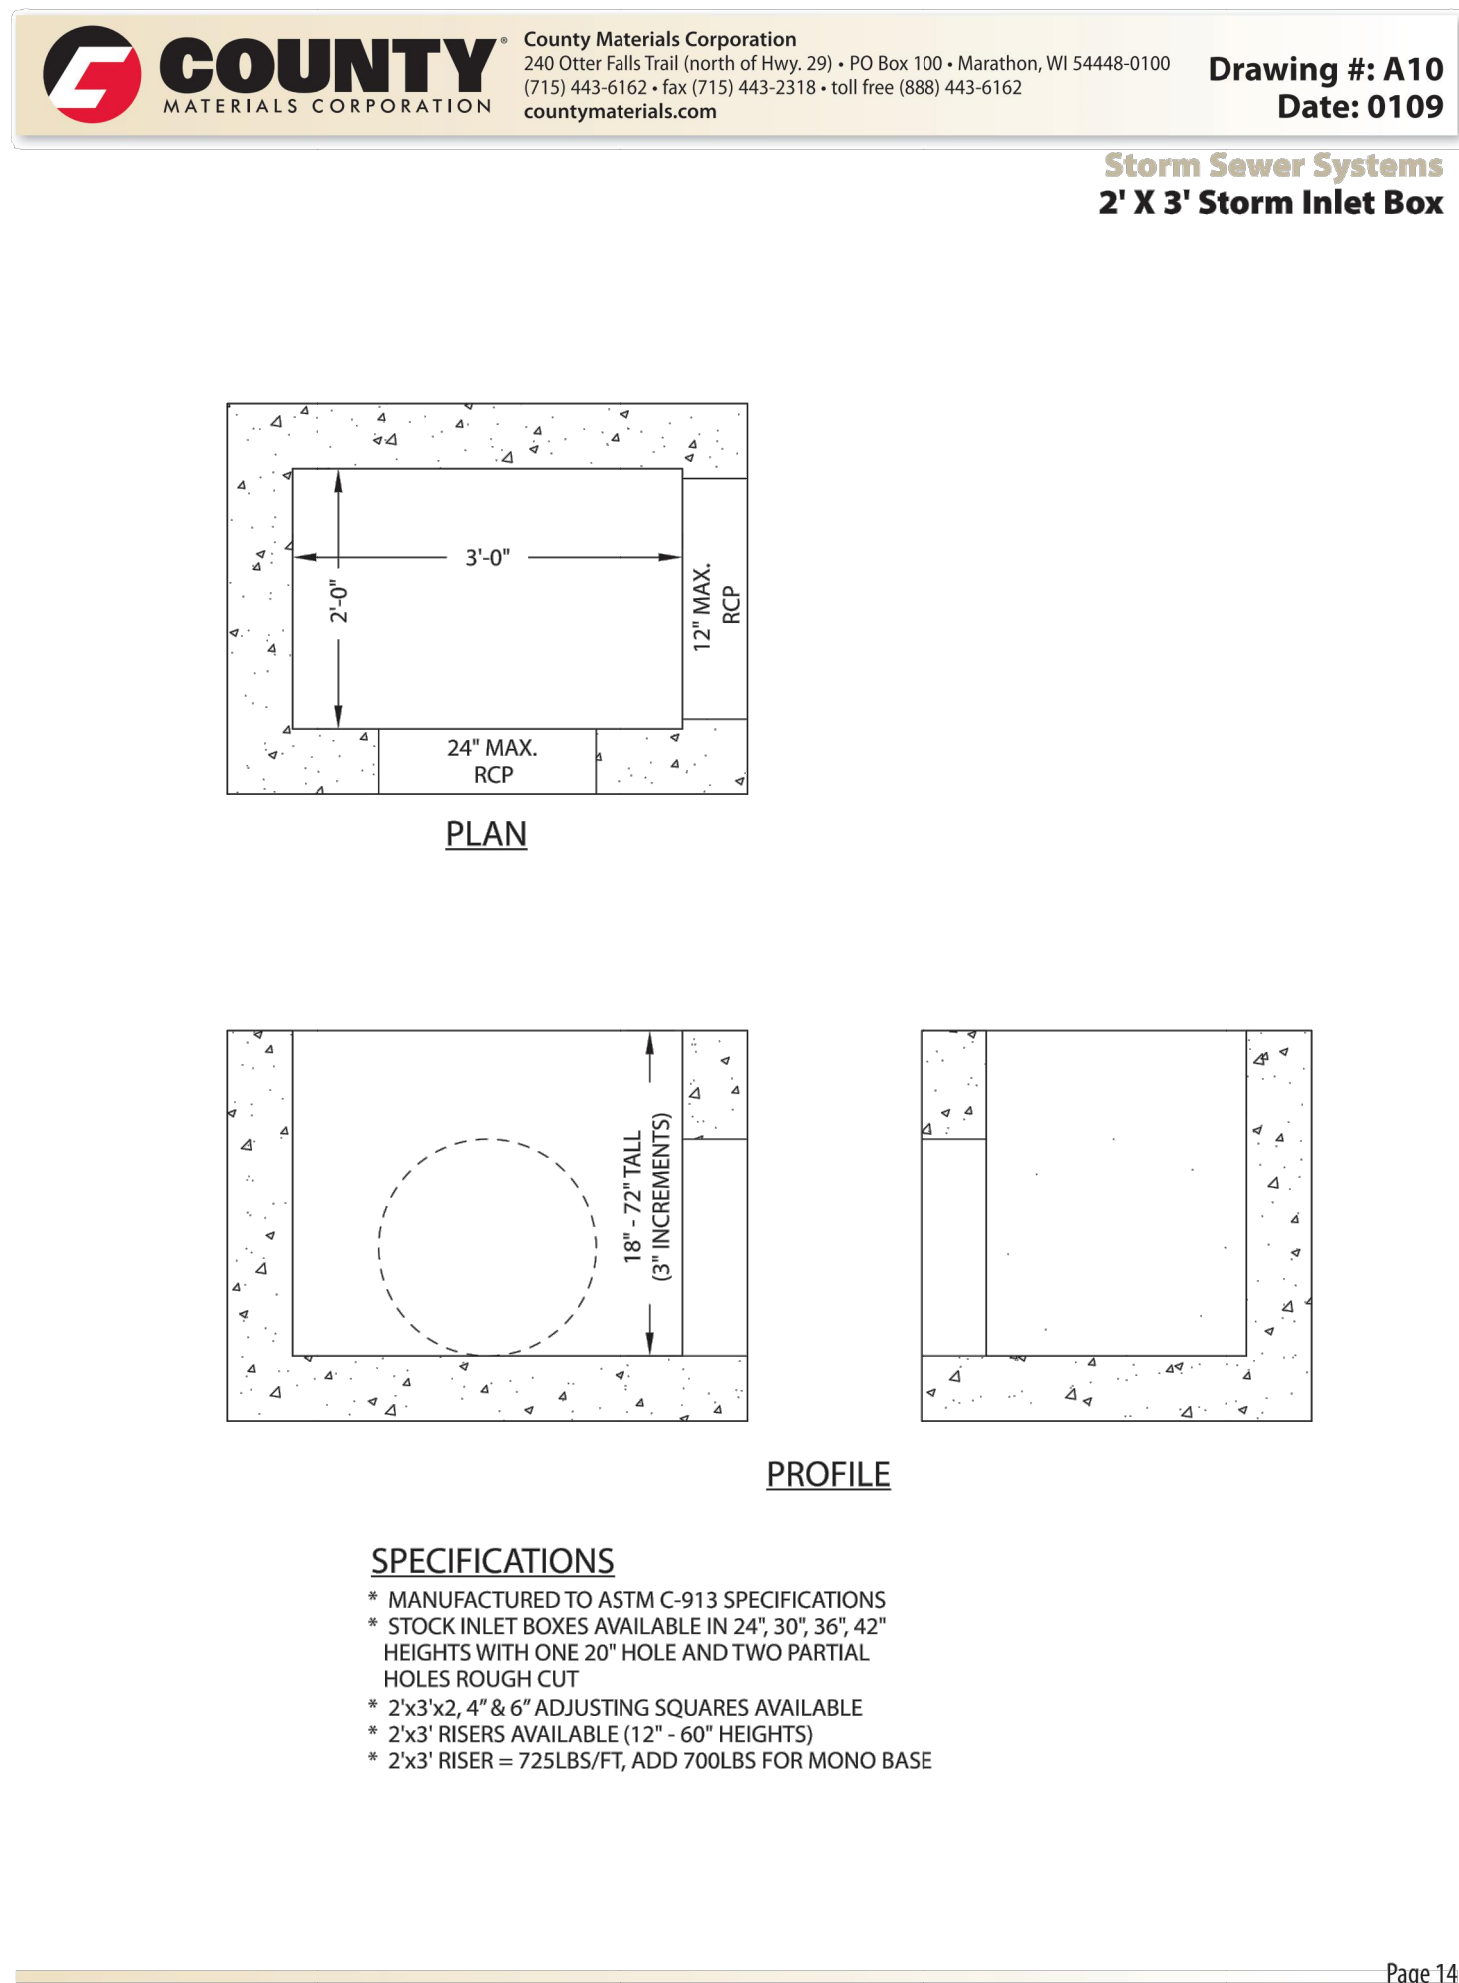
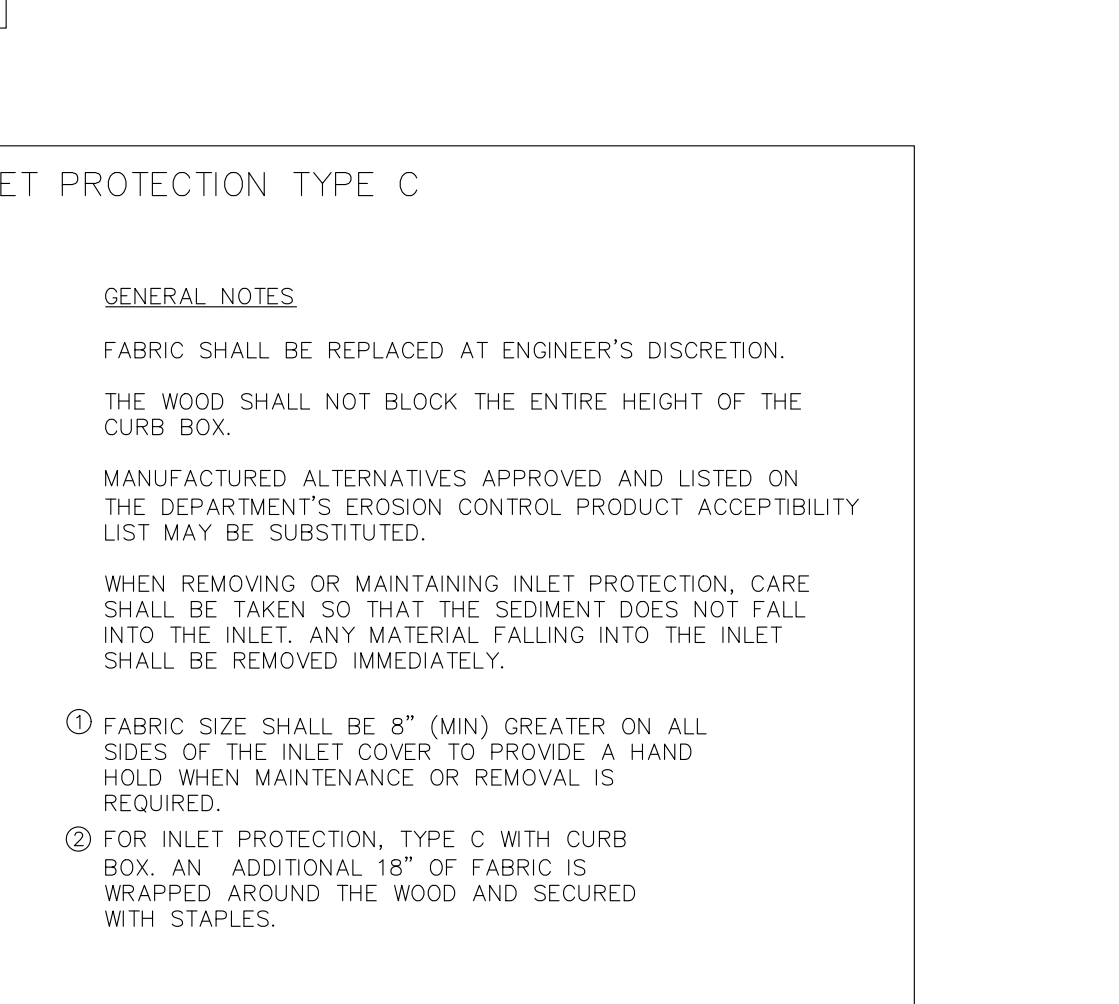
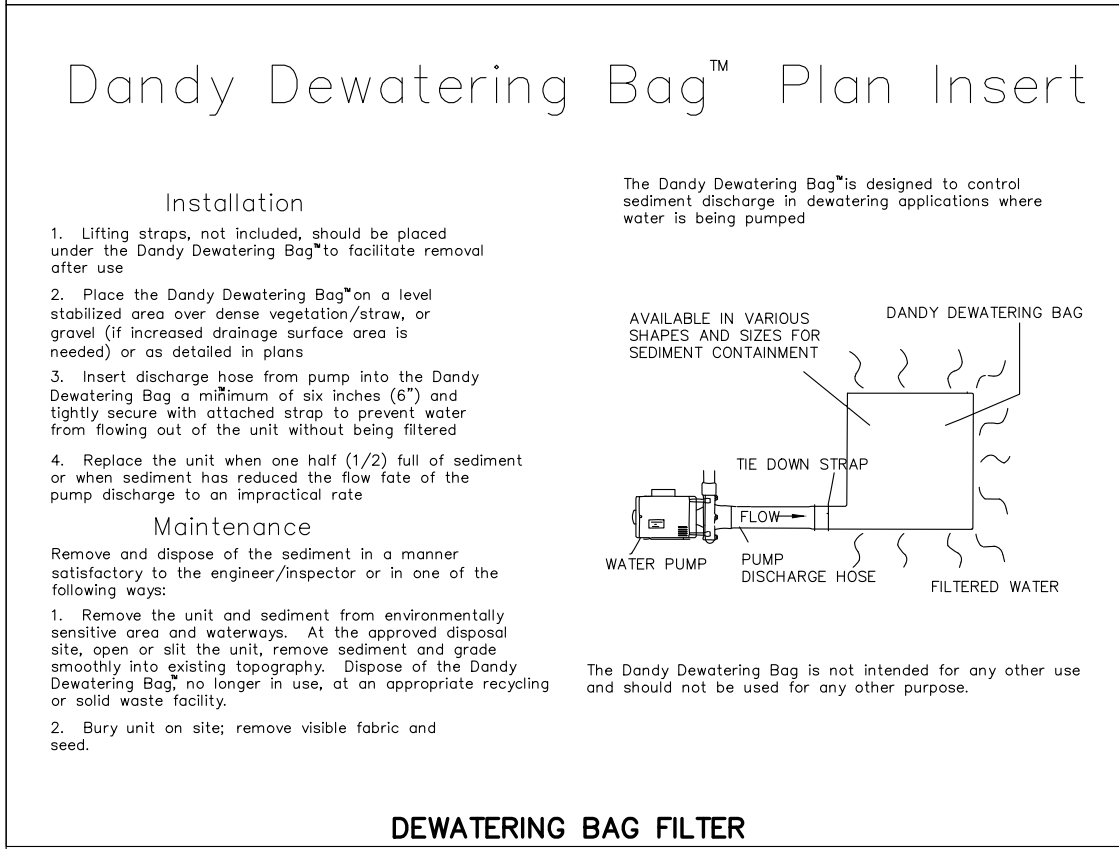
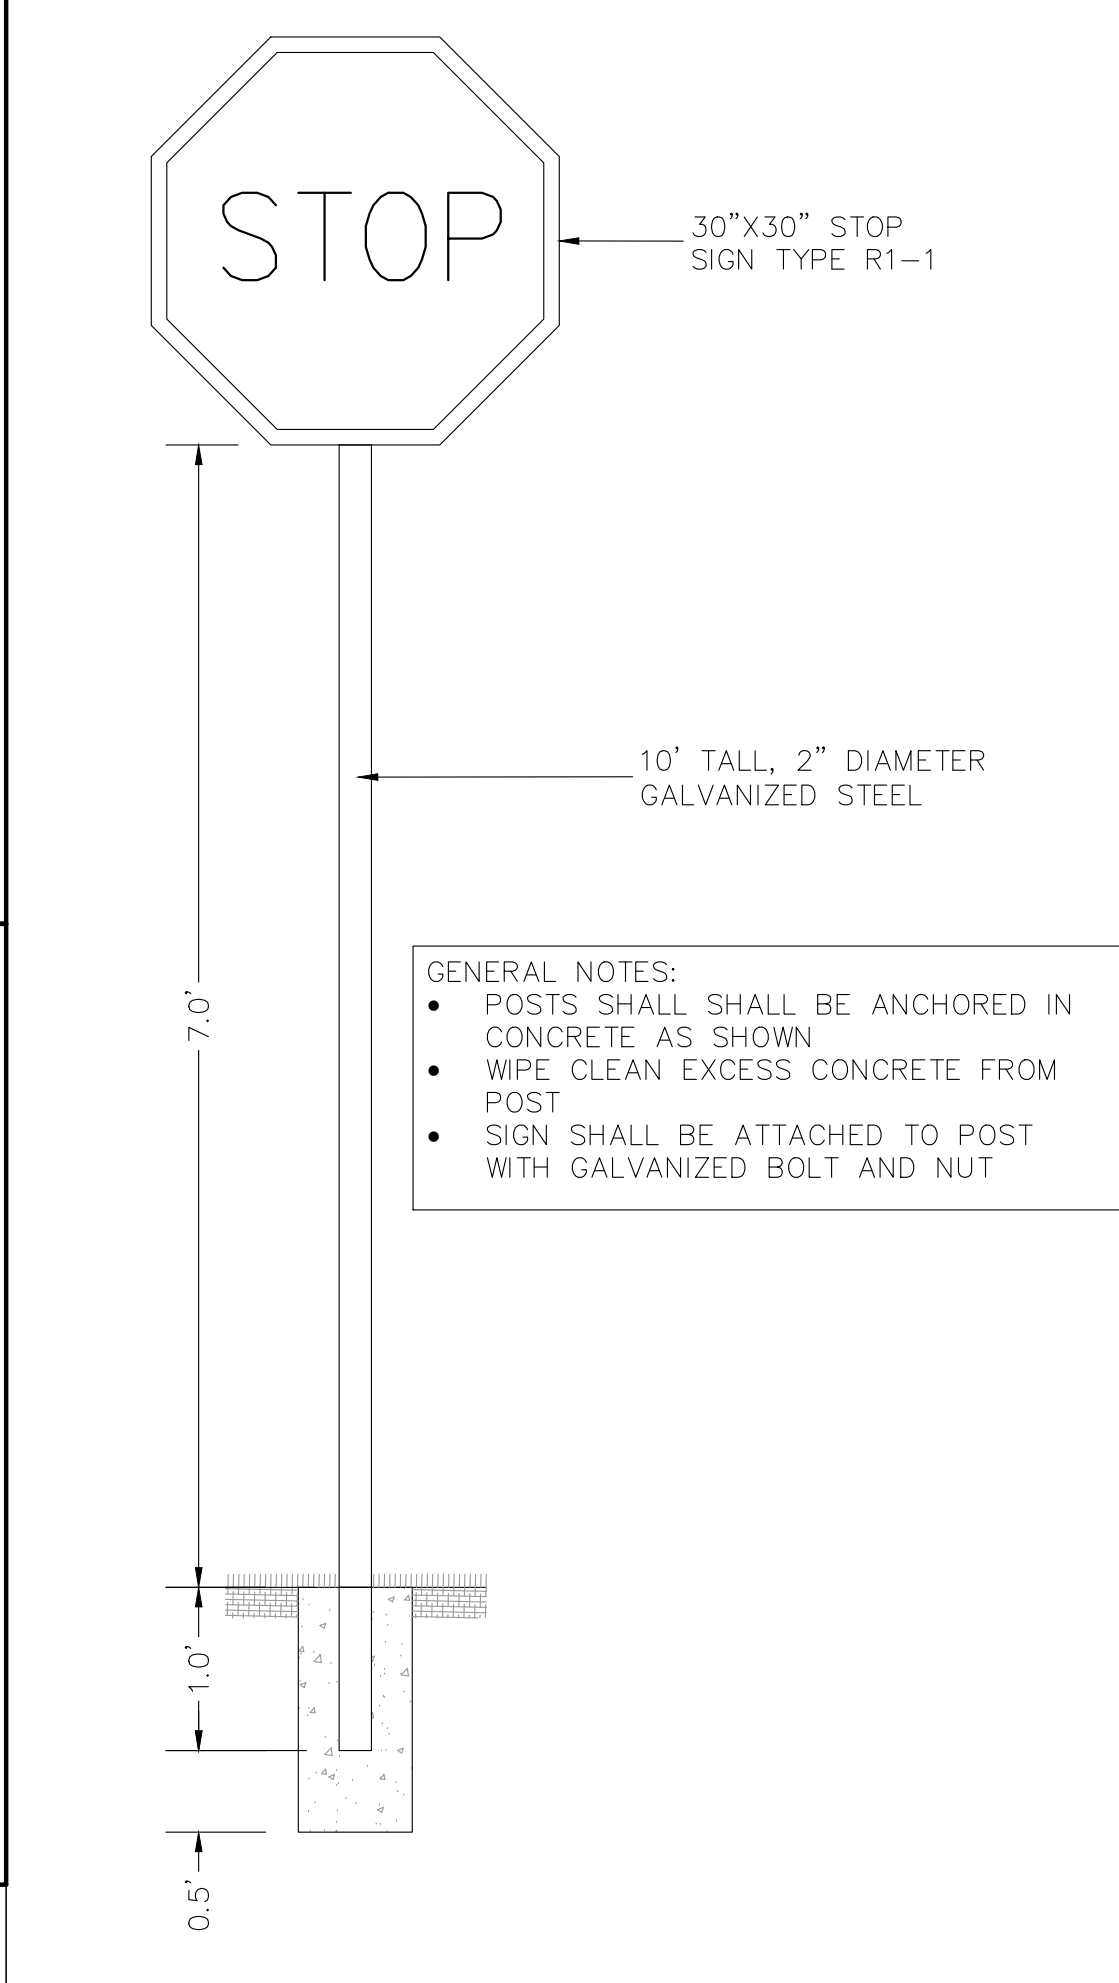
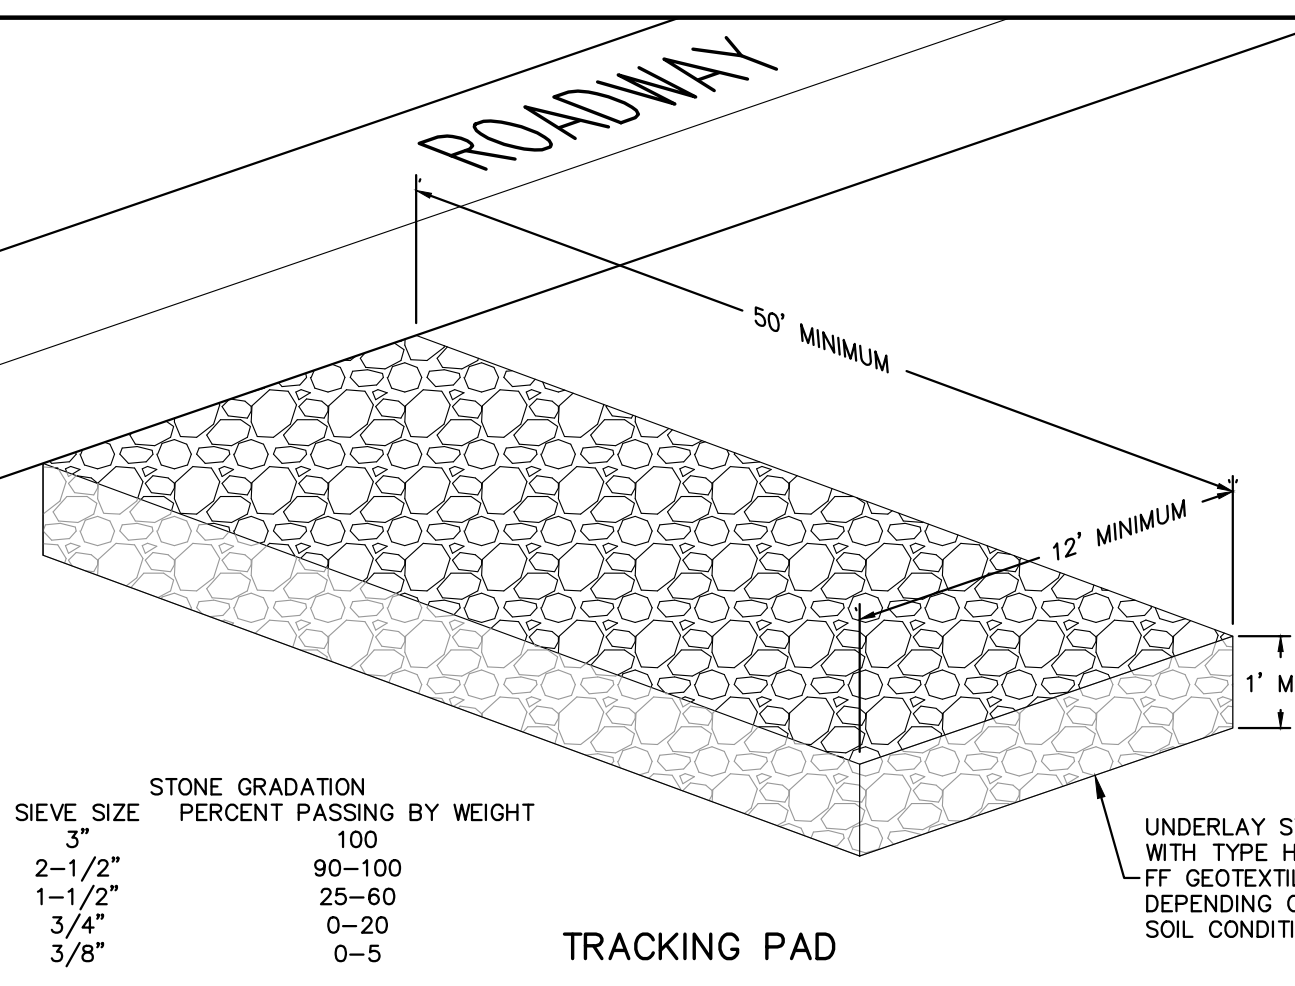
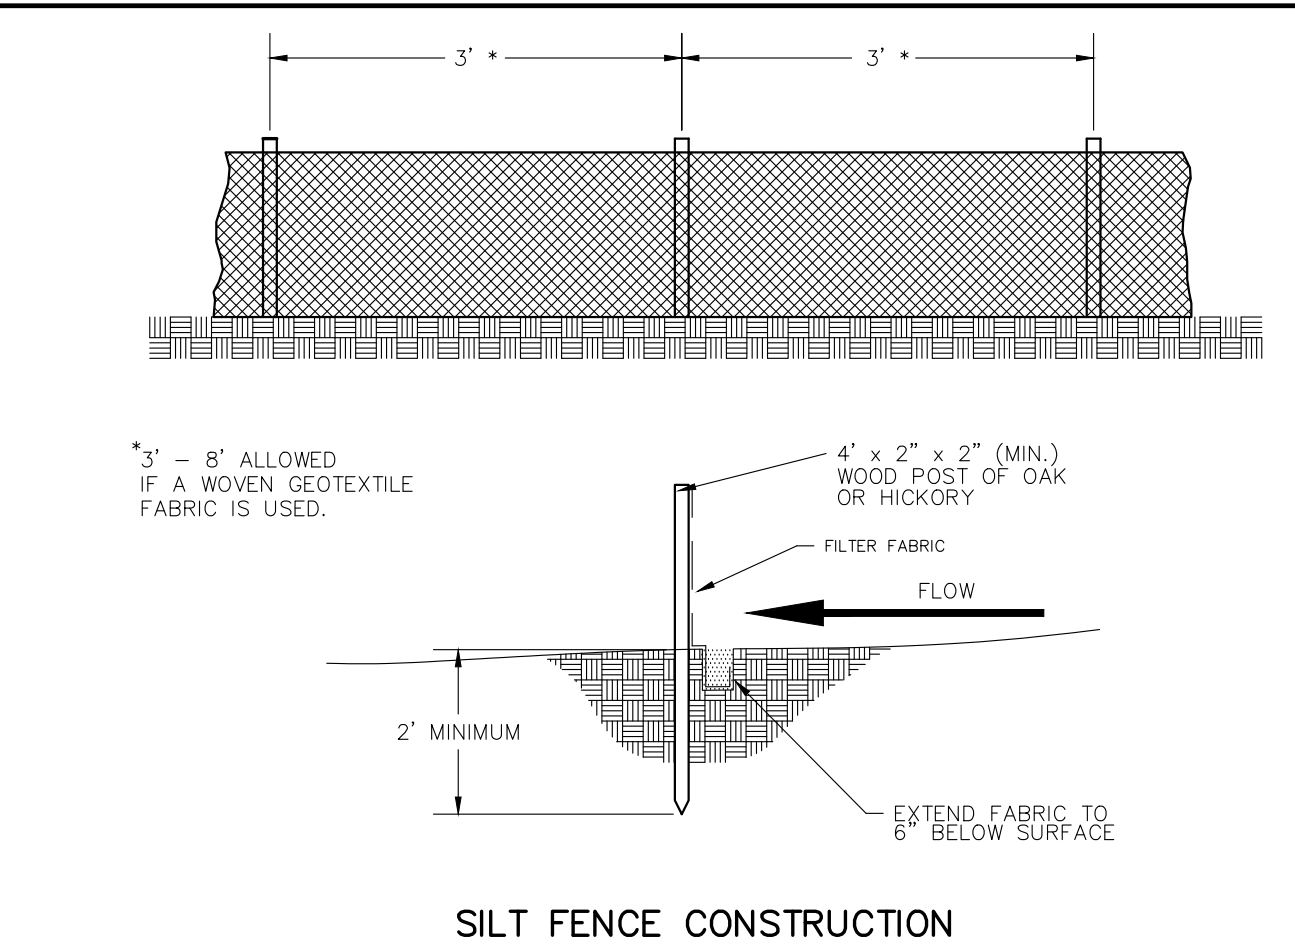
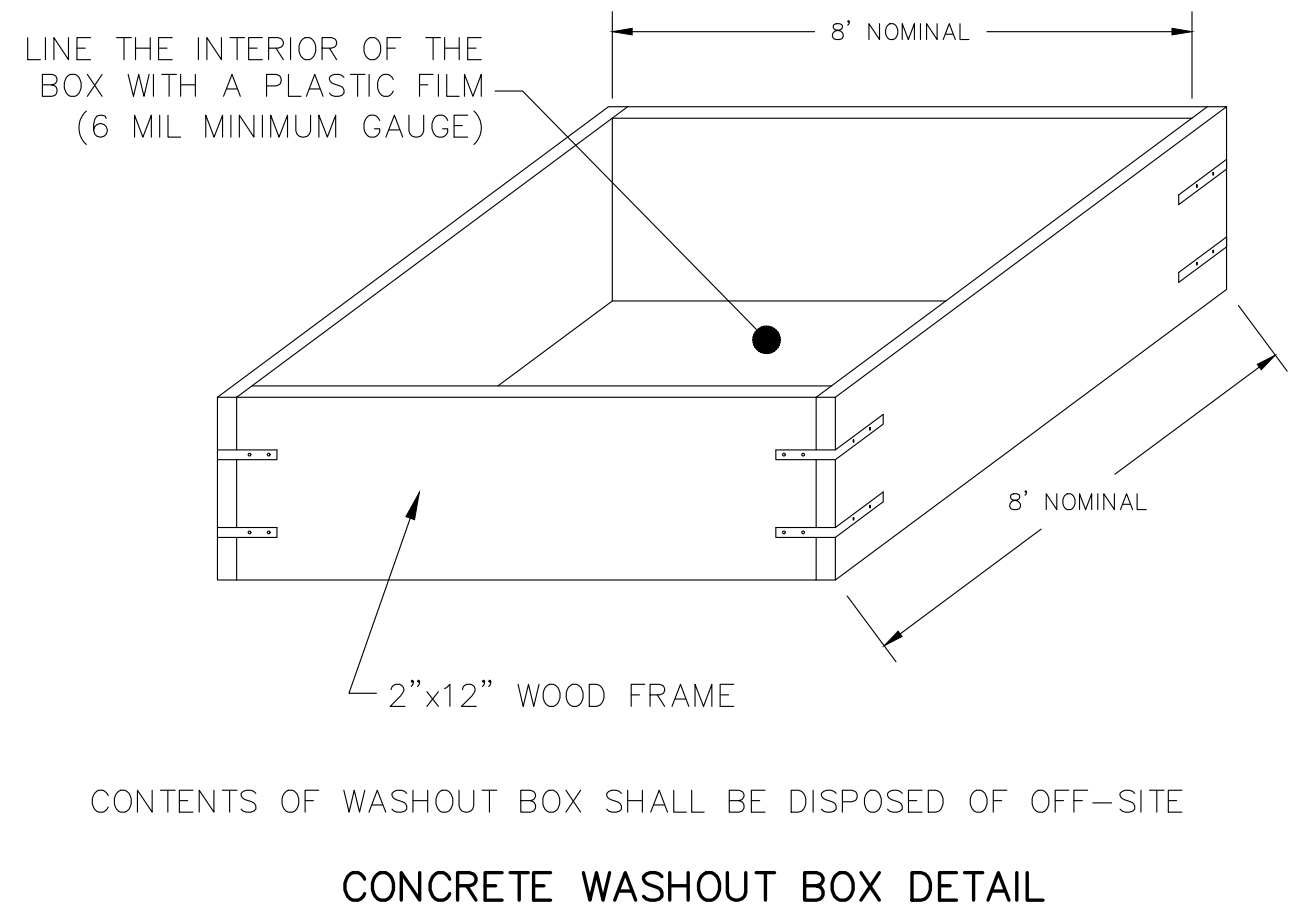
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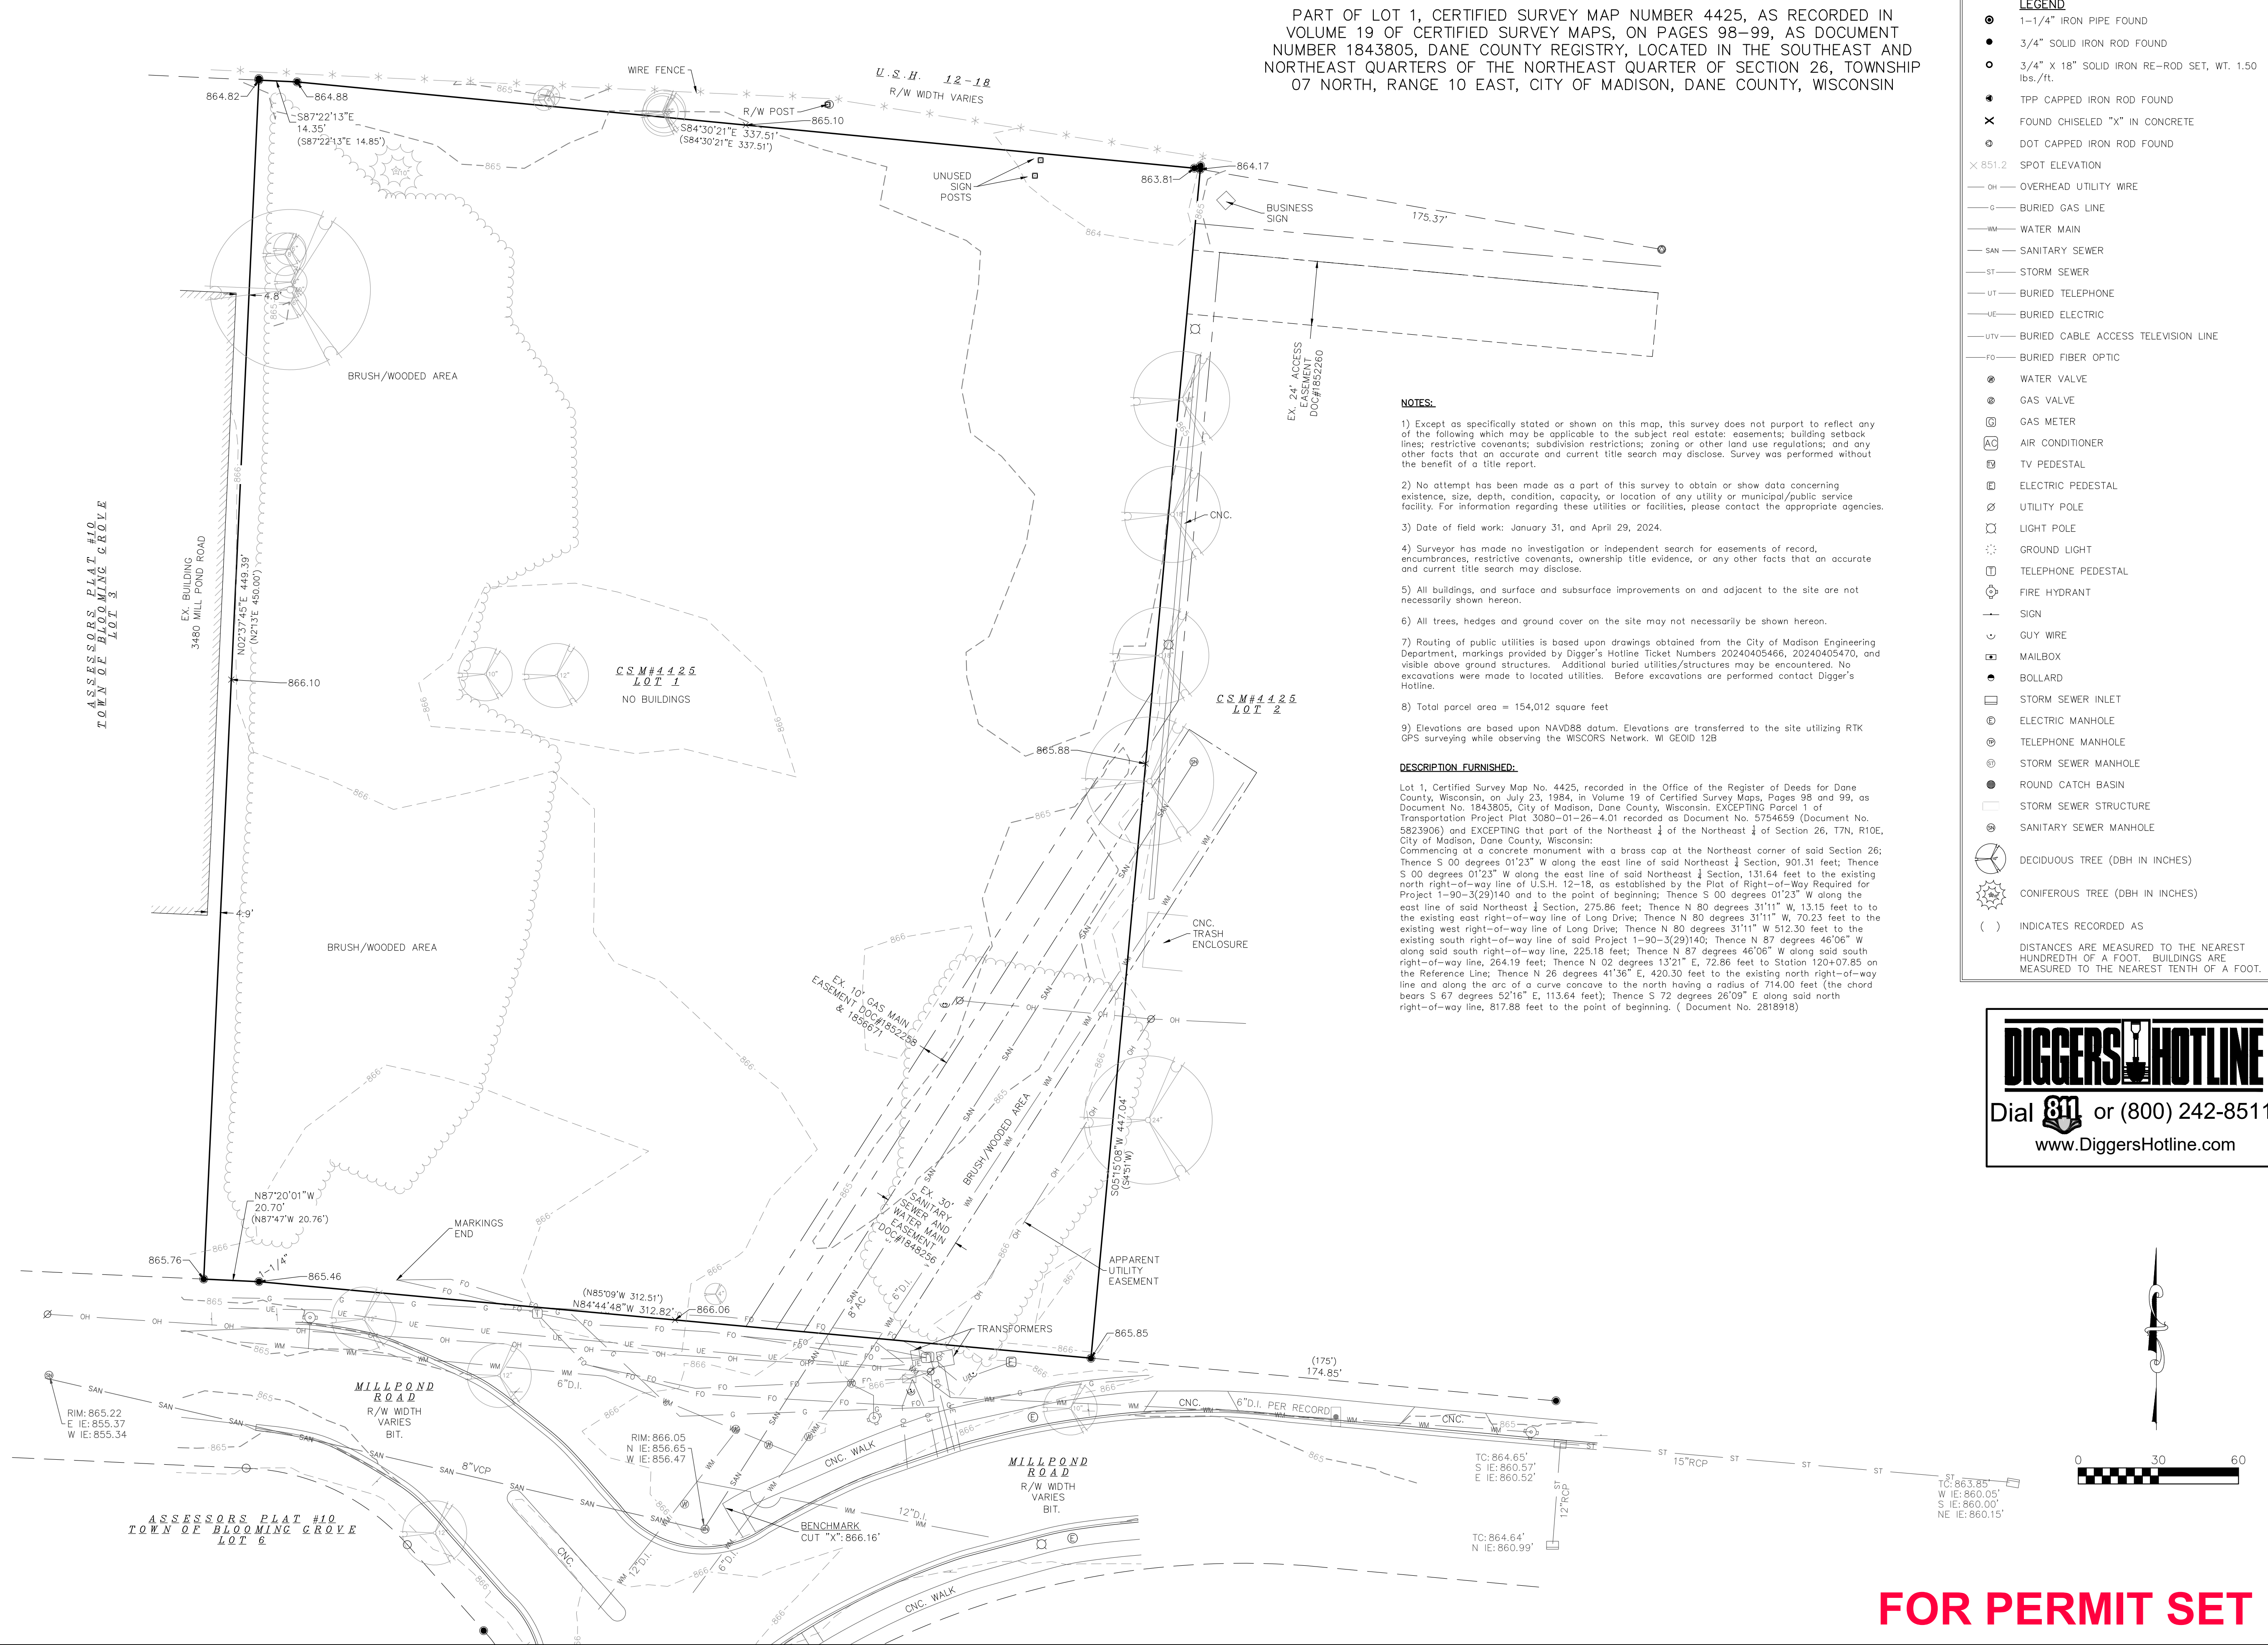
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PROJECT #: BSE2849  
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EXISTING CONDITIONS


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EROSION CONTROL PLAN


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<b>LAND USE SUMMARY TABLE</b>	
TOTAL PROPERTY AREA =	154,012 SF
BUILDING FOOTPRINT =	45,780 SF
EXTENSIVE GREEN ROOF AREA =	0 SF
PAVED AREAS >5' WIDE =	47,276 SF
LOT COVERAGE =	93,056 SF
	<b>60%</b>
	<b>MAX = 85%</b>
USEABLE OPEN SPACE (OUTSIDE BLDG FRAMEWORK) =	60,956 SF
USEABLE OPEN SPACE (WITHIN BLDG FRAMEWORK) =	0 SF
TOTAL USABLE OPEN SPACE =	60,956 SF
TOTAL NUMBER OF BEDROOMS =	0
TOTAL IMPERVIOUS AREA =	93,056 SF
	<b>60%</b>
TOTAL PERVIOUS AREA =	60,956 SF
	<b>40%</b>
TOTAL LANDSCAPED AREA =	60,956 SF
	<b>40%</b>

<b>APPROVALS</b>
<b>PROJECT ENG:</b> <b>MLB</b>
<b>DESIGNED BY:</b> <b>MLB</b>
<b>DRAWN BY:</b> <b>DJM</b>
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CIVIL/SITE PLAN


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- GENERAL NOTES:**
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  2. ANY SIDEWALK, CURB, OR OTHER PUBLIC PROPERTY DAMAGED AS PART OF THE CONSTRUCTION OF THE UTILITIES AND BUILDING SHALL BE REPLACED IN-KIND PER THE CITY OF MADISON STANDARD SPECIFICATIONS.
  3. THE RIGHT-OF-WAY IS THE SOLE JURISDICTION OF THE CITY OF MADISON AND IS SUBJECT TO CHANGE AT ANY TIME PER THE RECOMMENDATION/PLAN OF THE CITY.

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**GRADING PLAN**

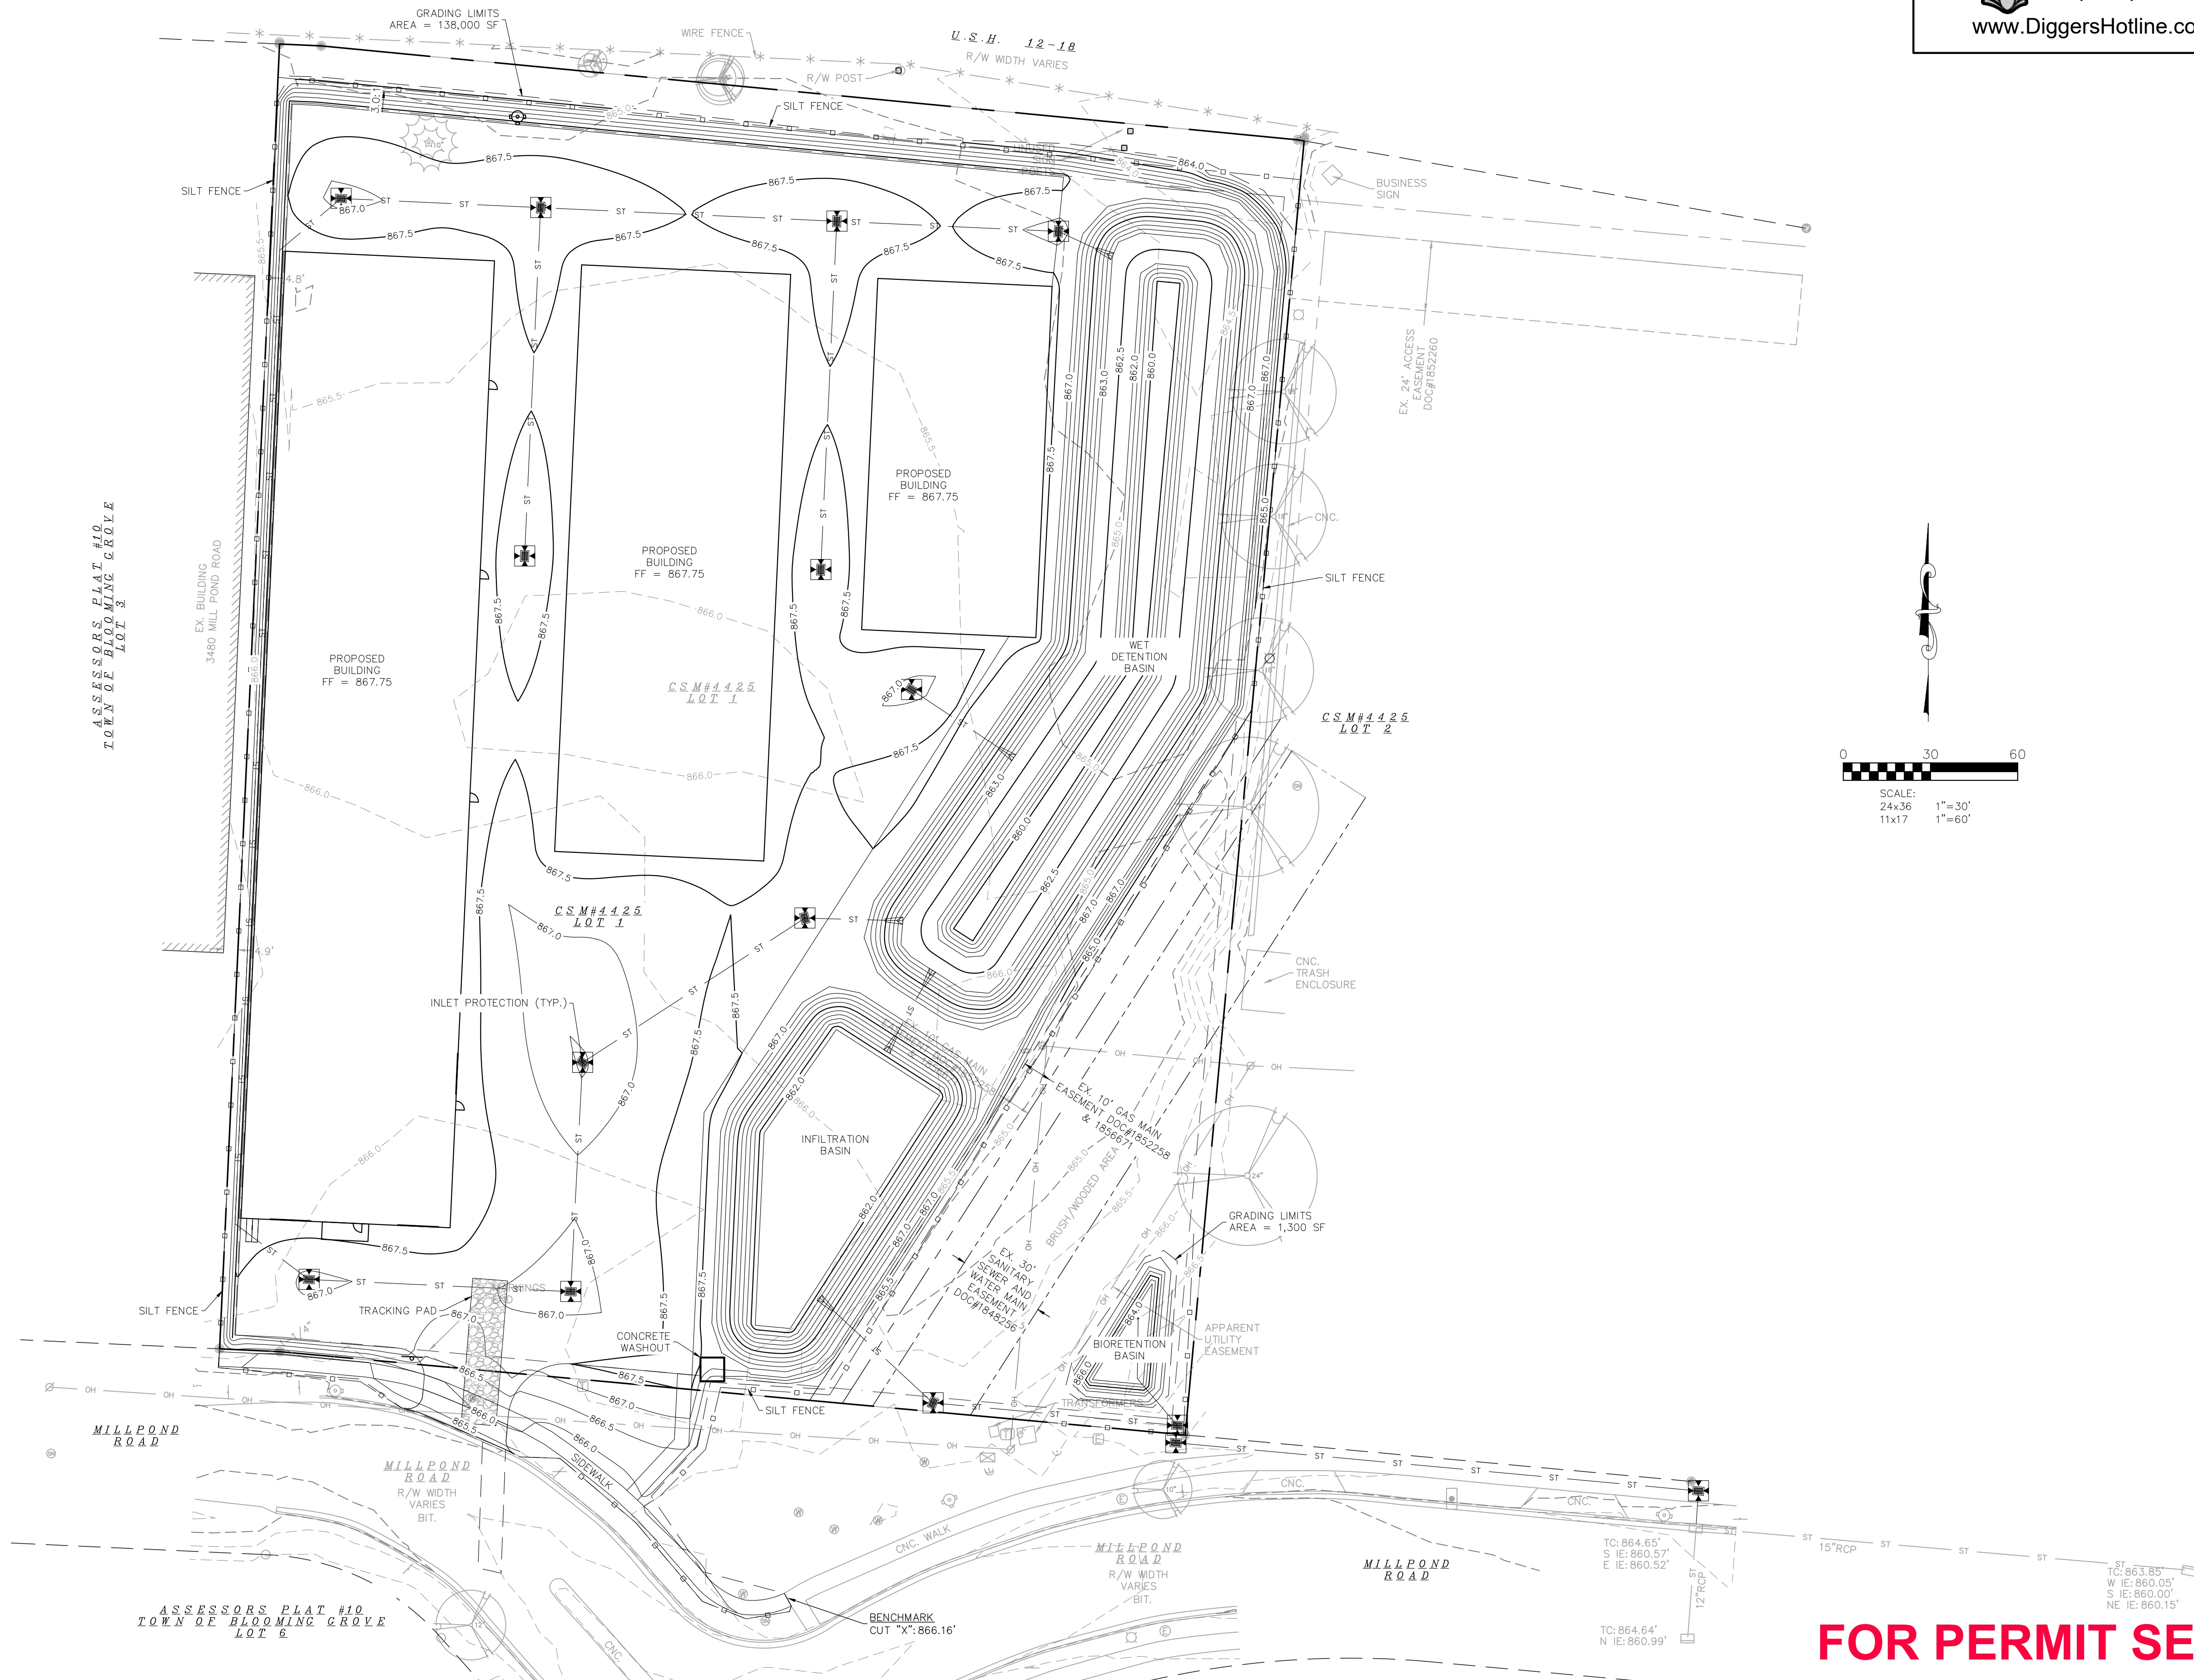
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APPROVED	PJF	
	MLB	
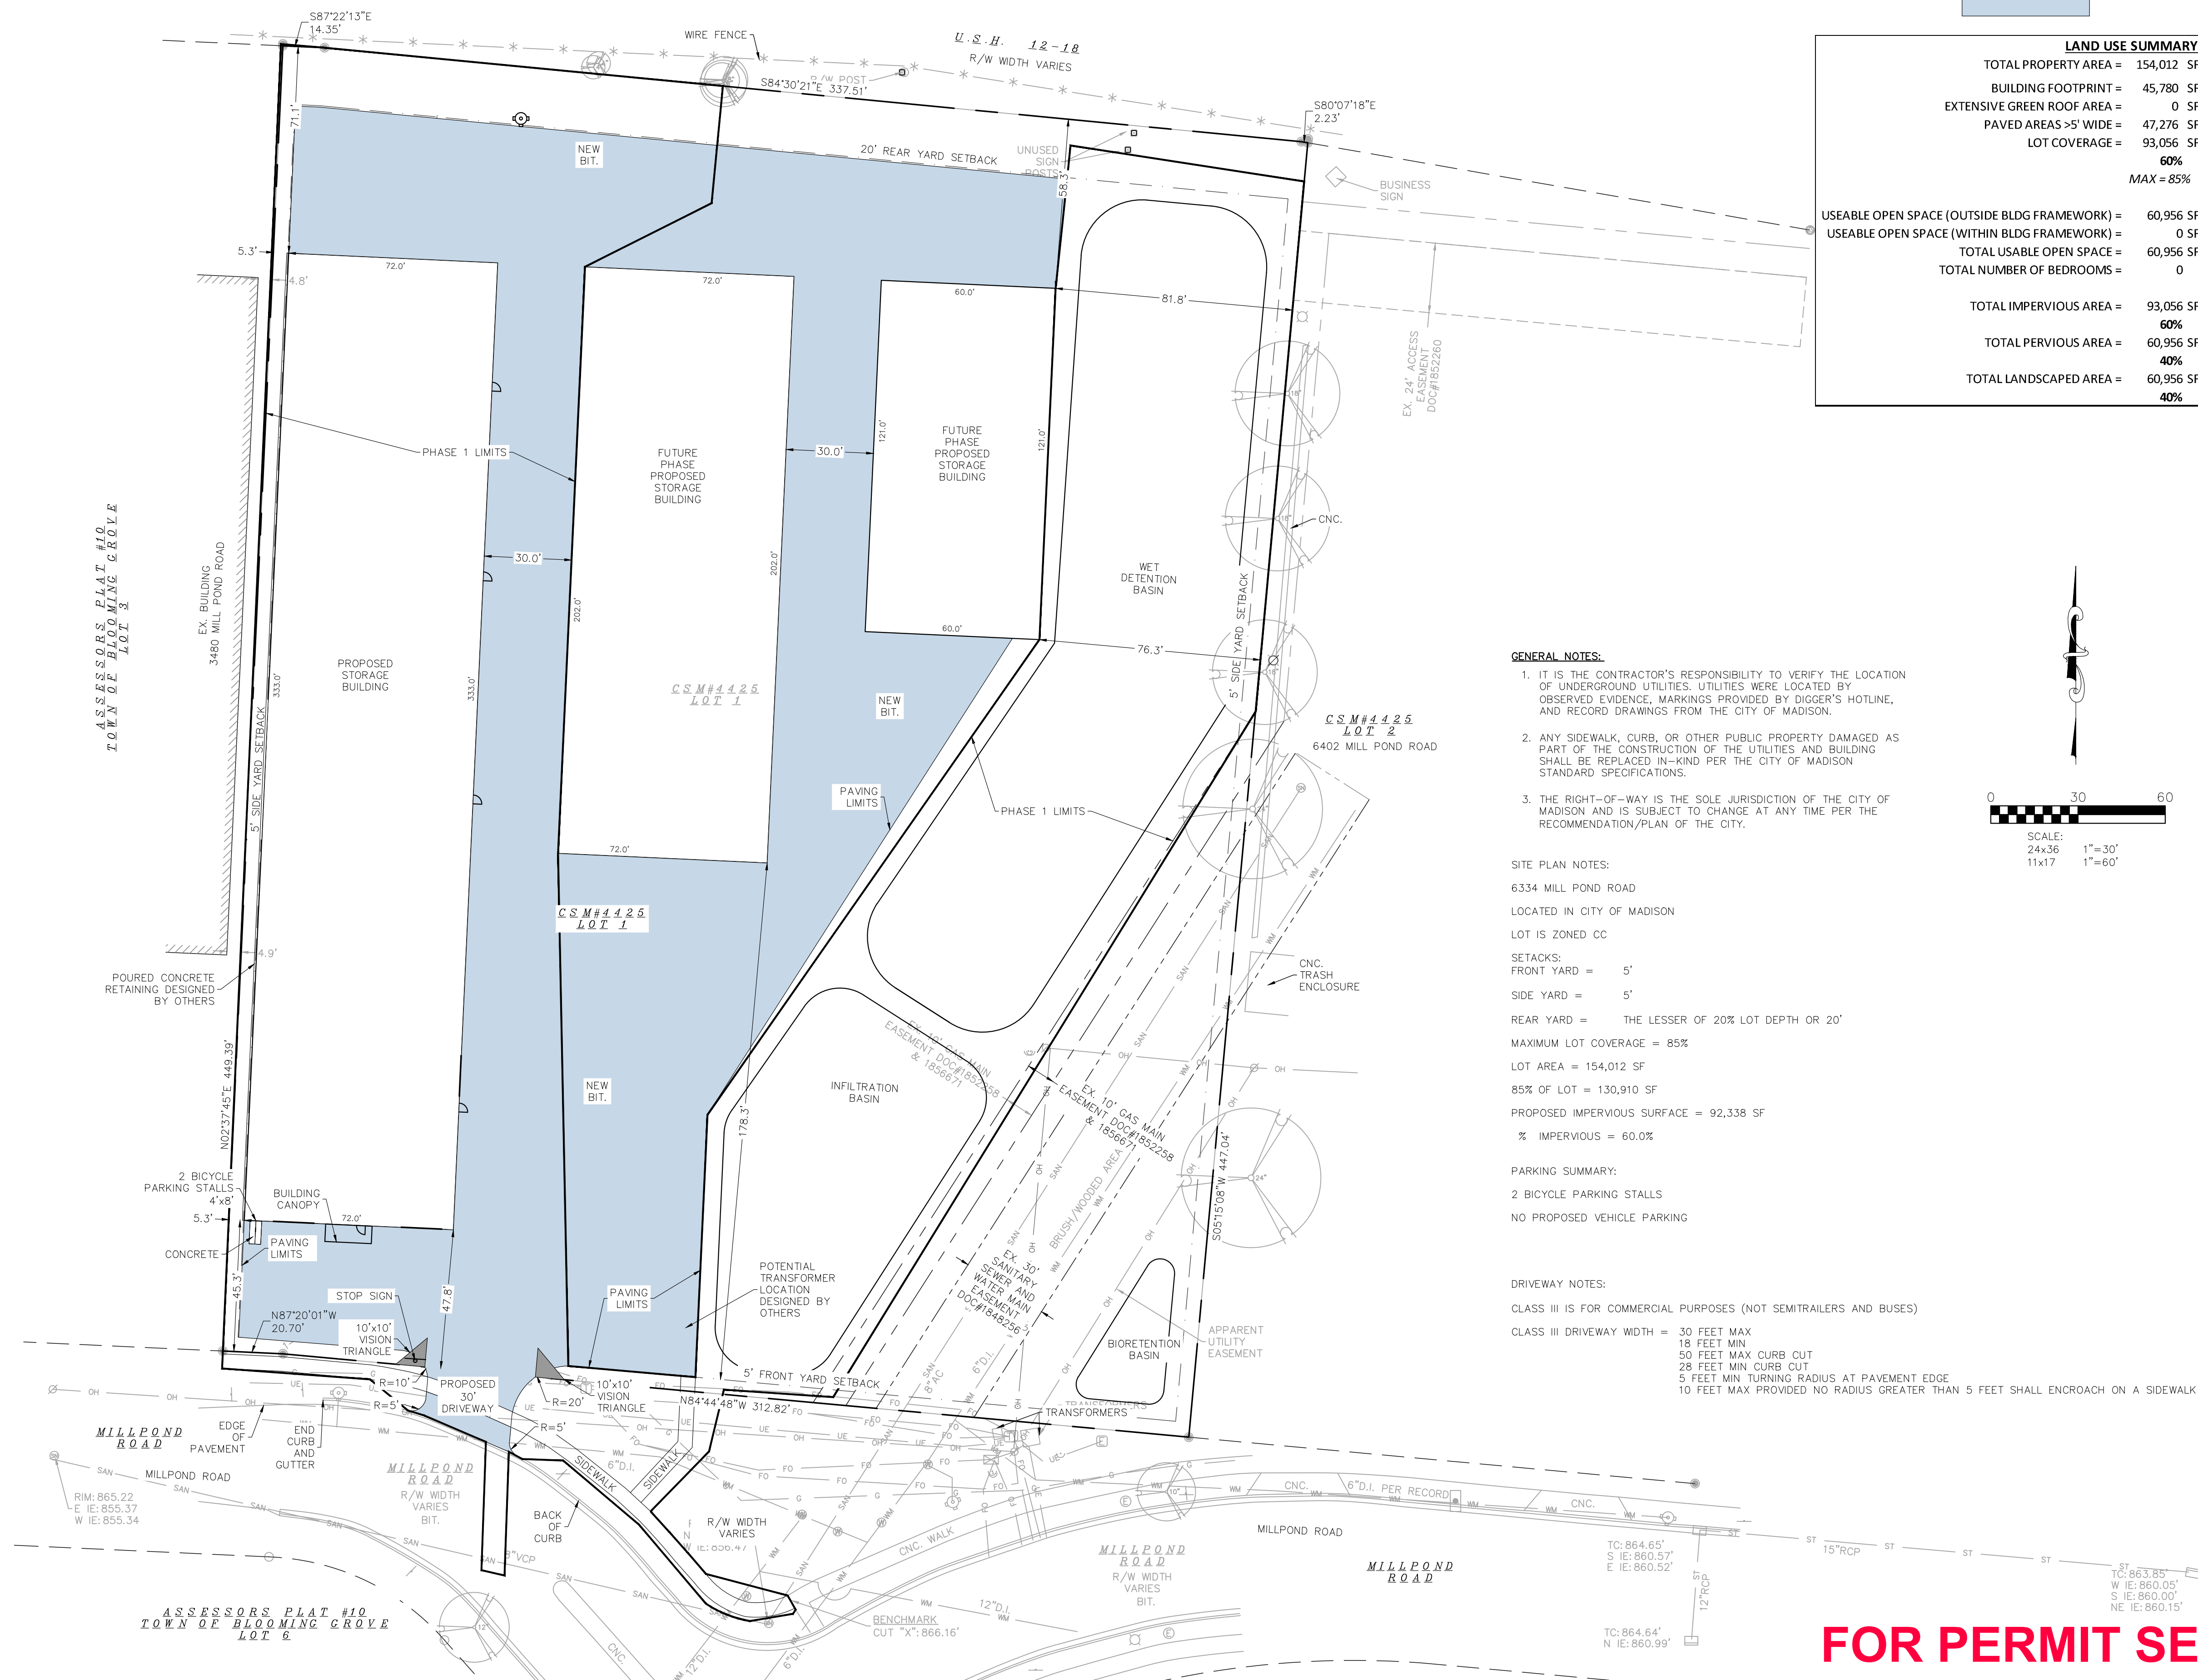
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UTILITY PLAN

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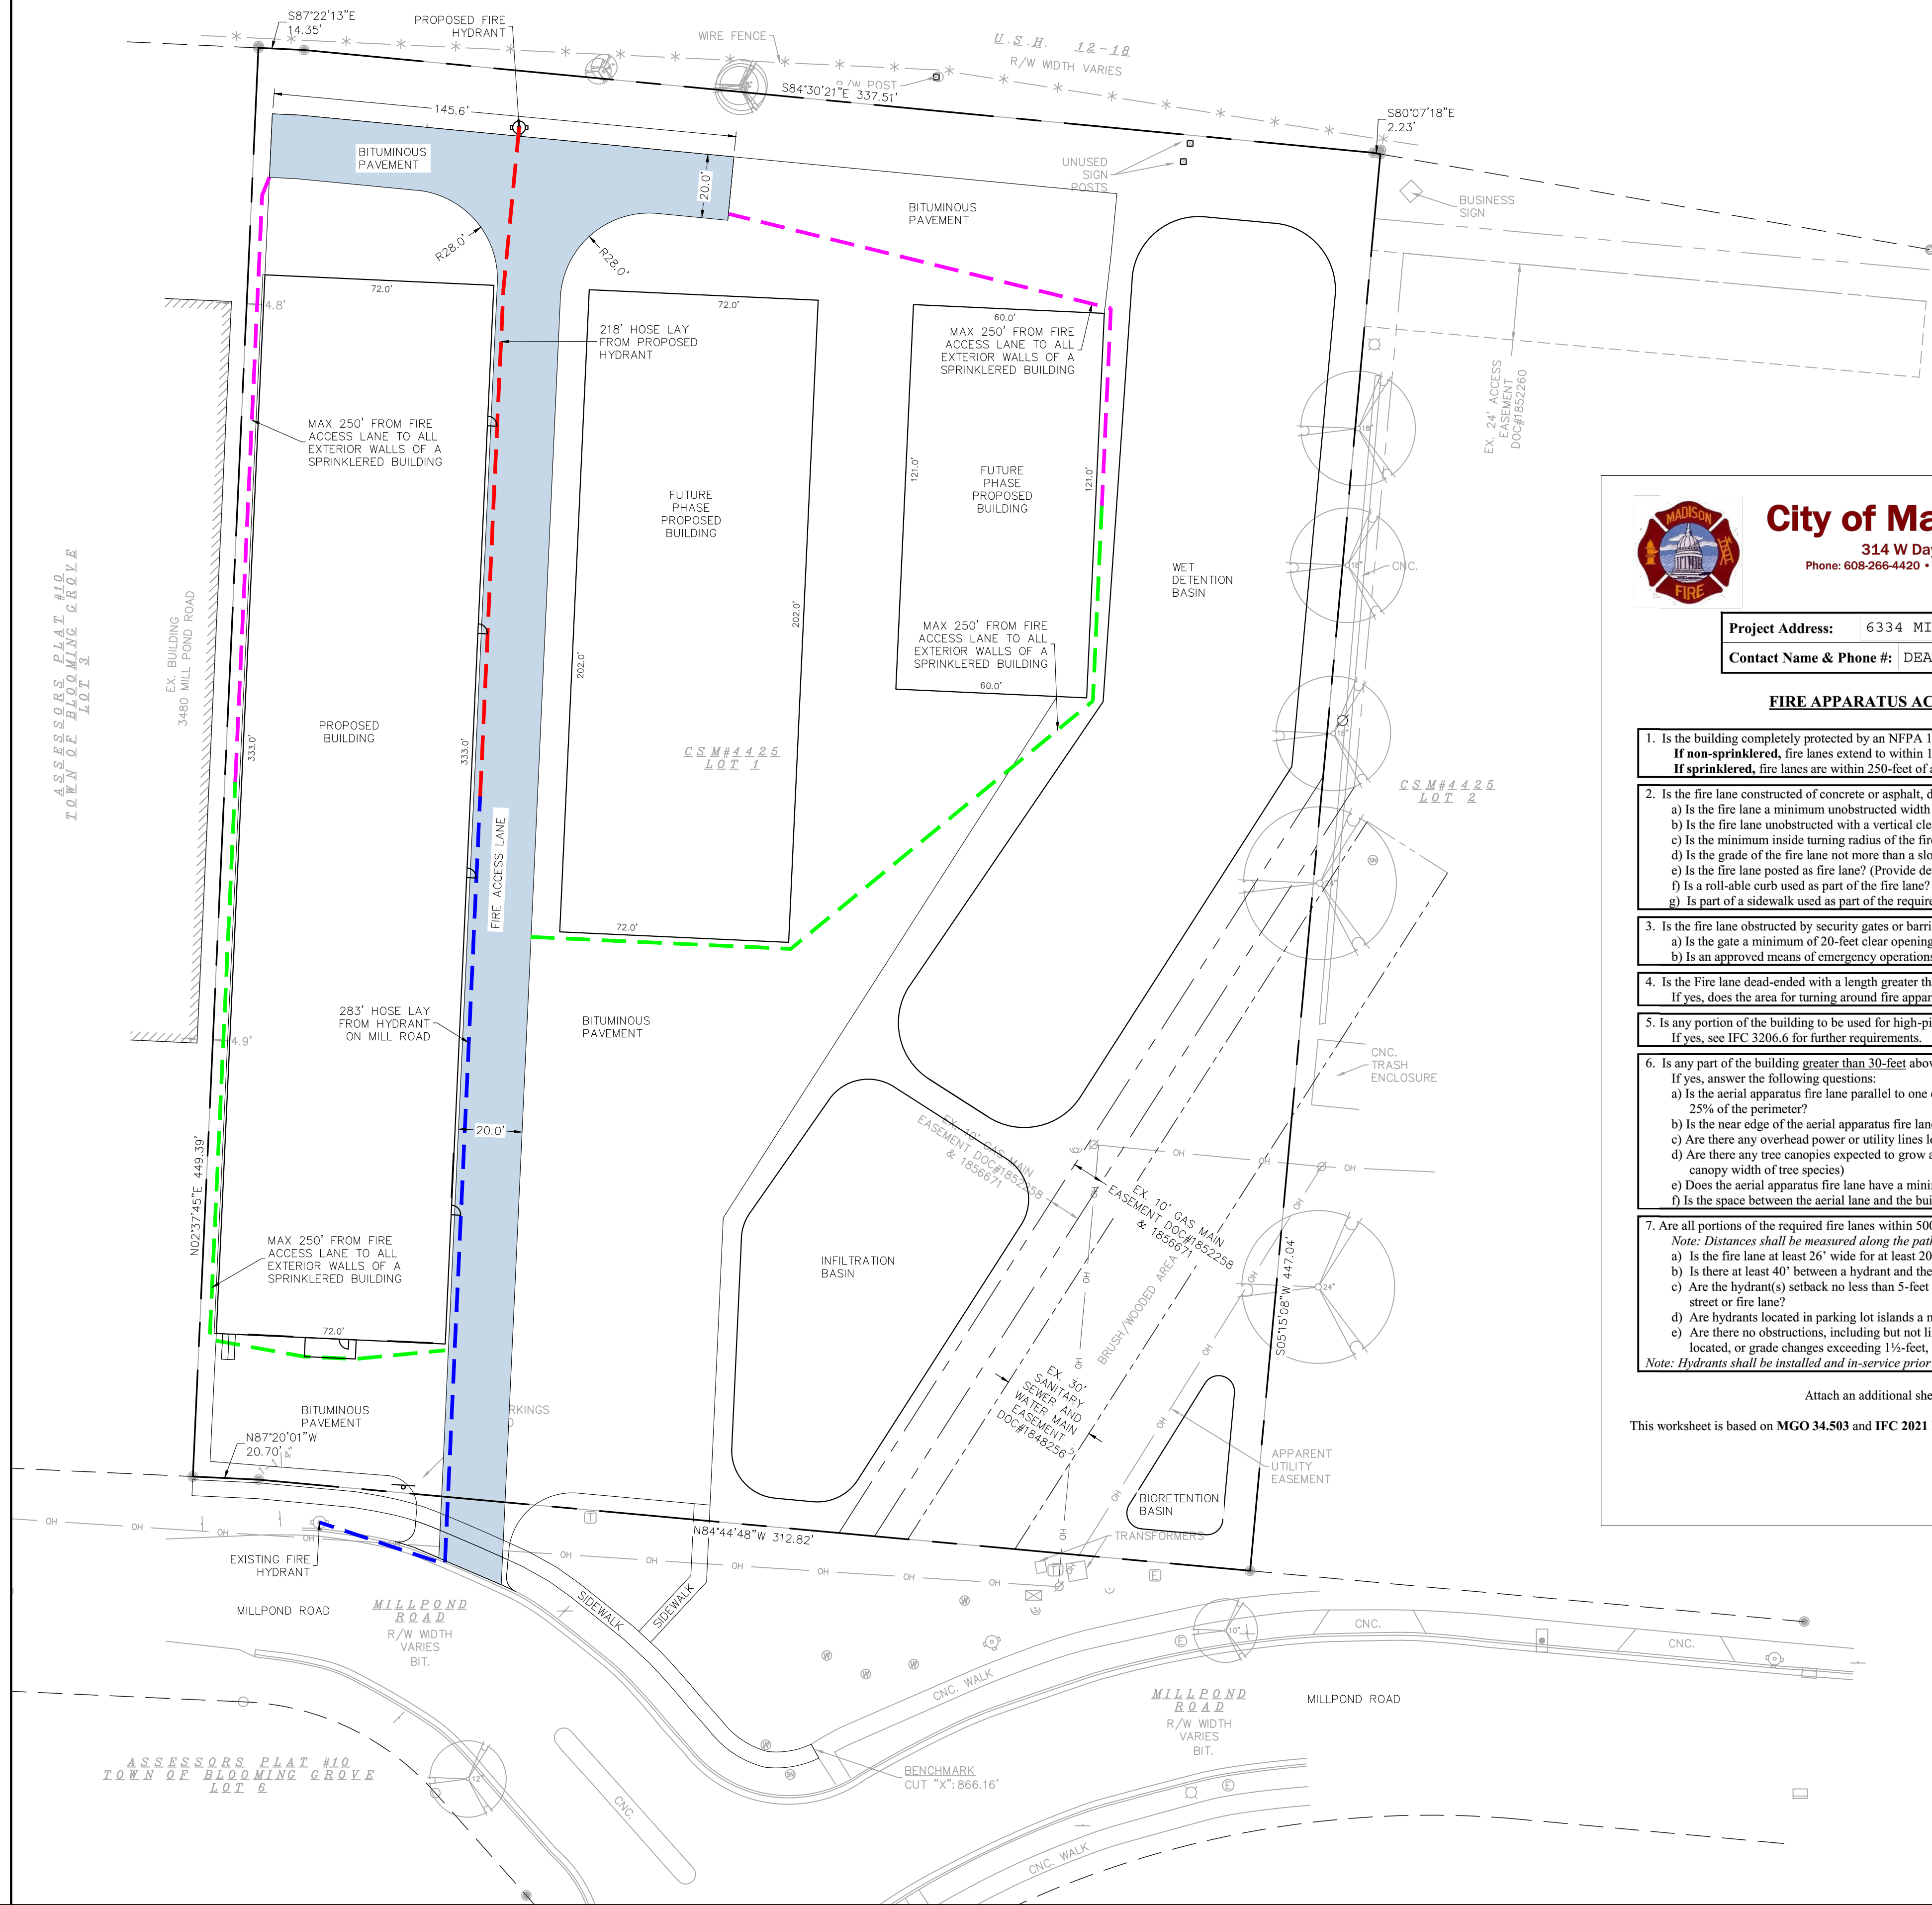
C-500

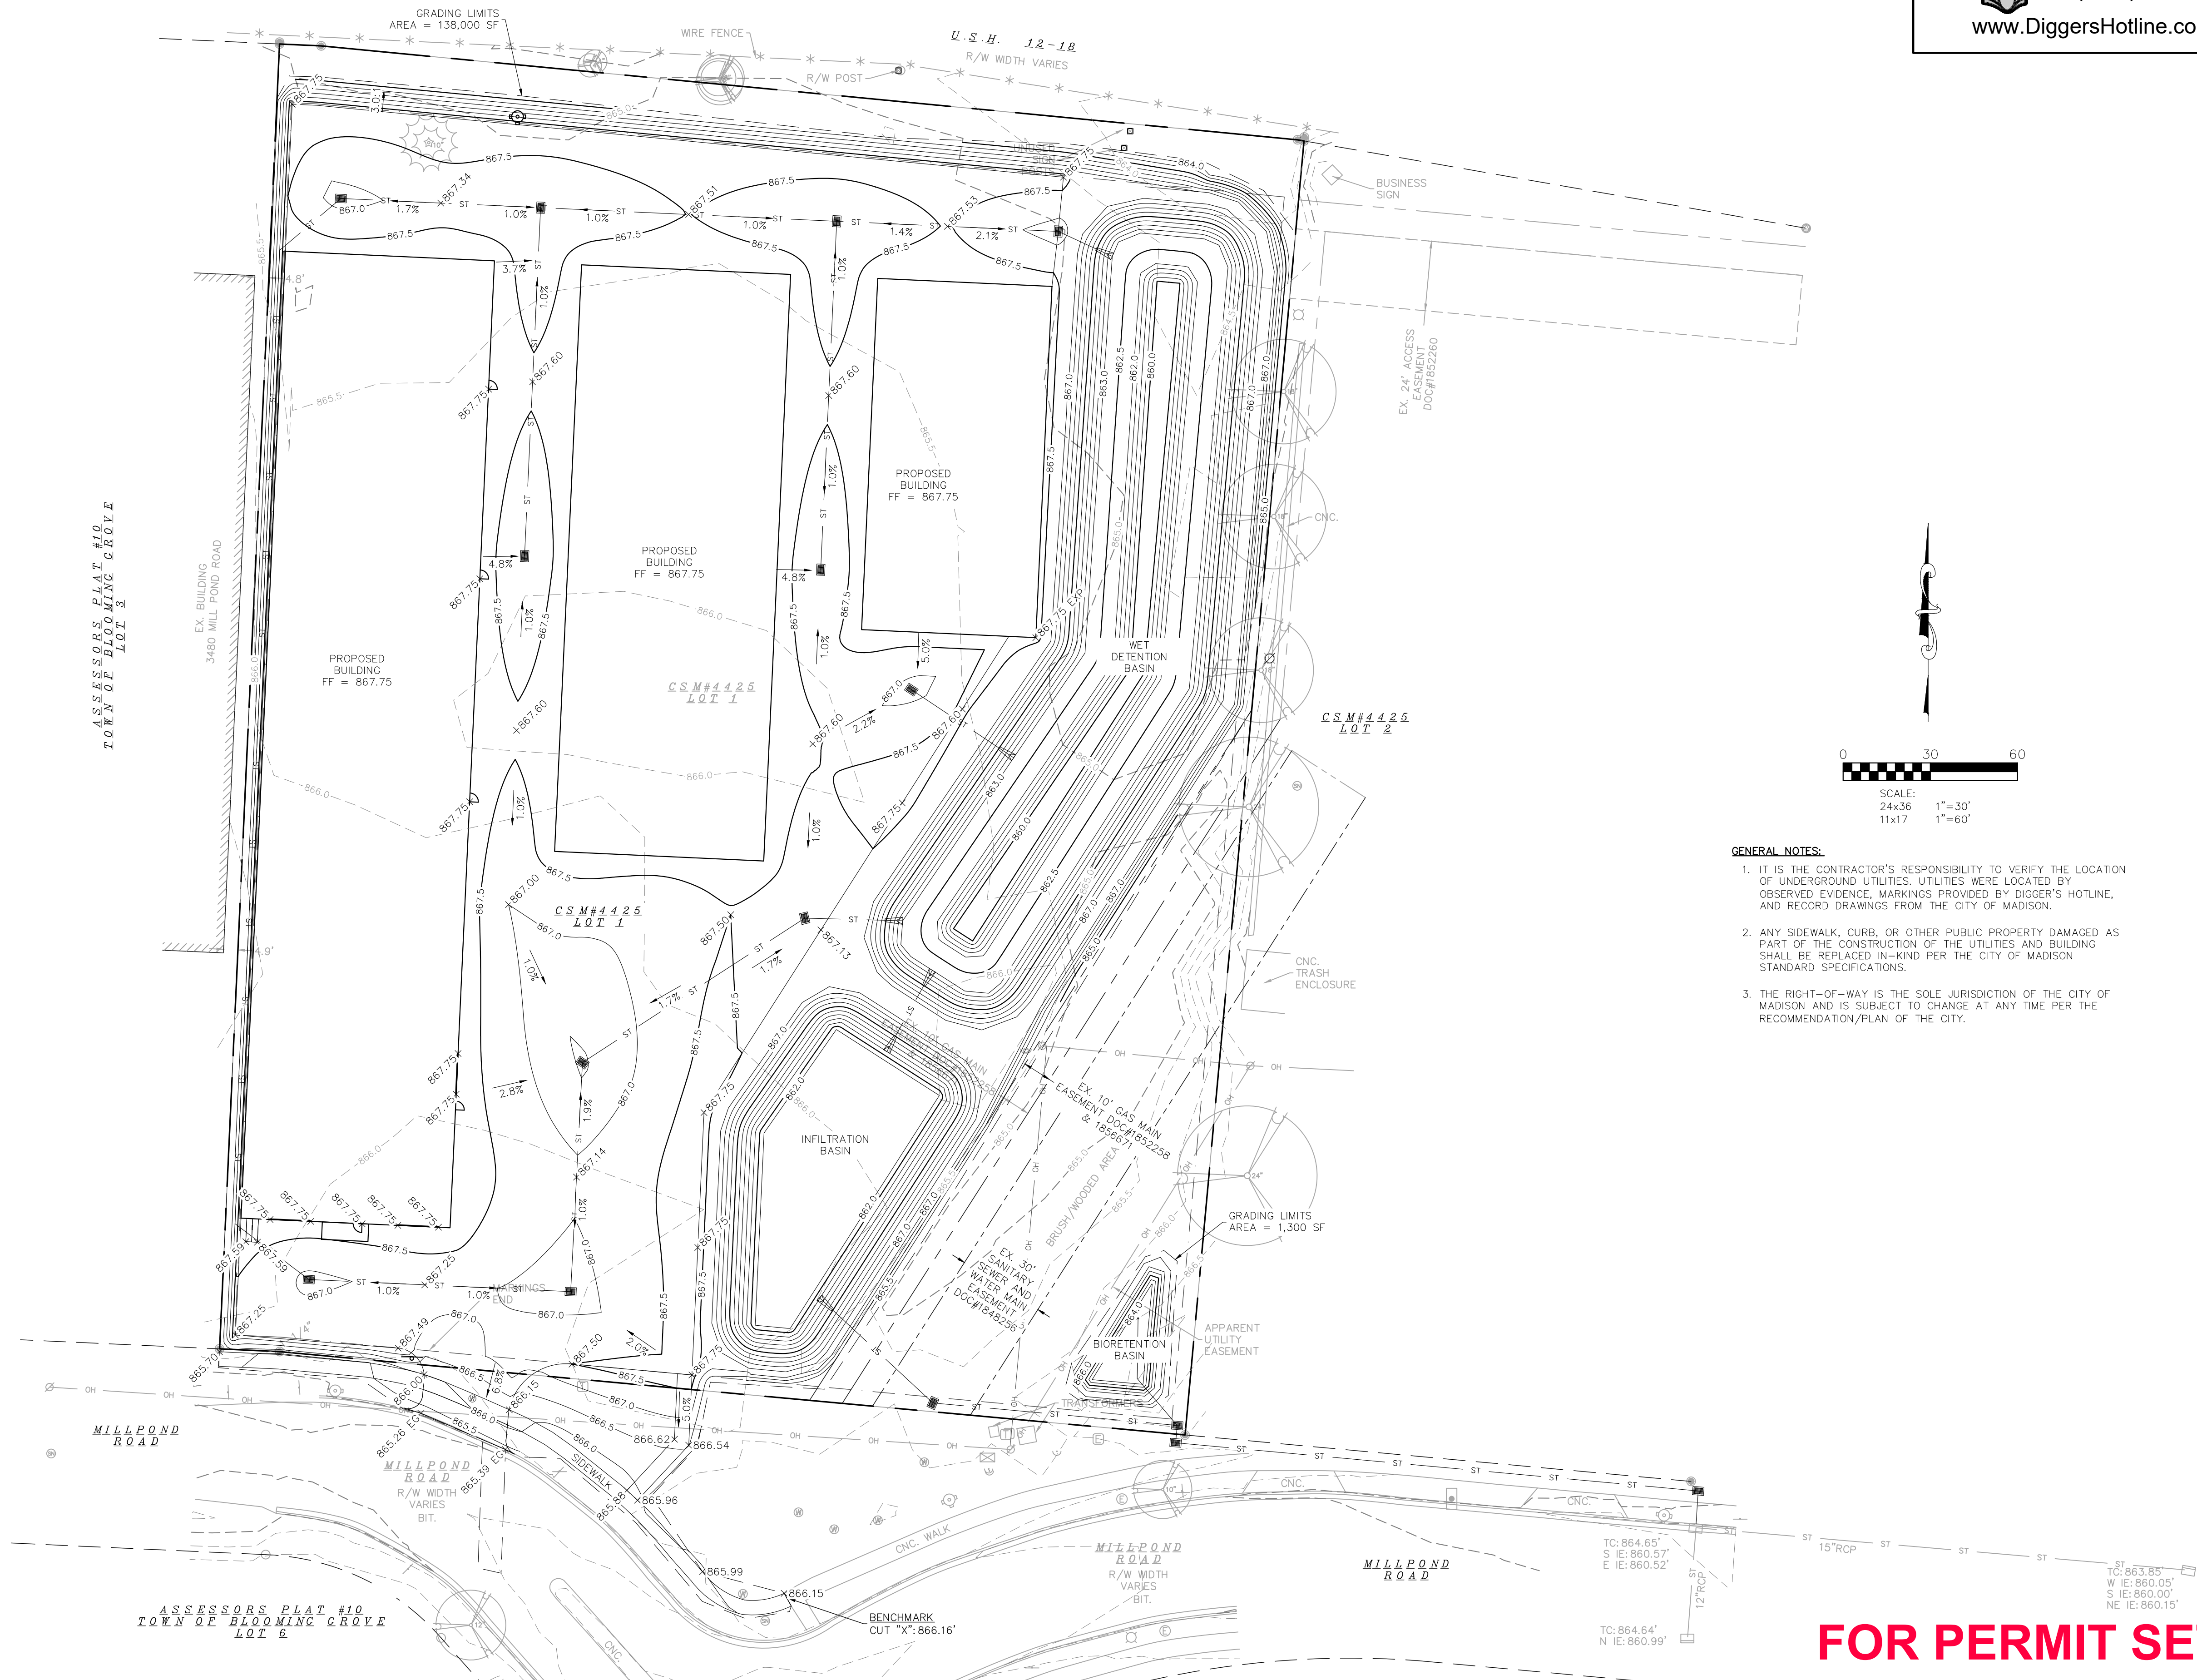- GENERAL NOTES:**
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FIRE ACCESS LANE

500' MAX HOSE LAY DISTANCE FROM AT LEAST (2) FIRE HYDRANTS TO FIRE ACCESS LANE

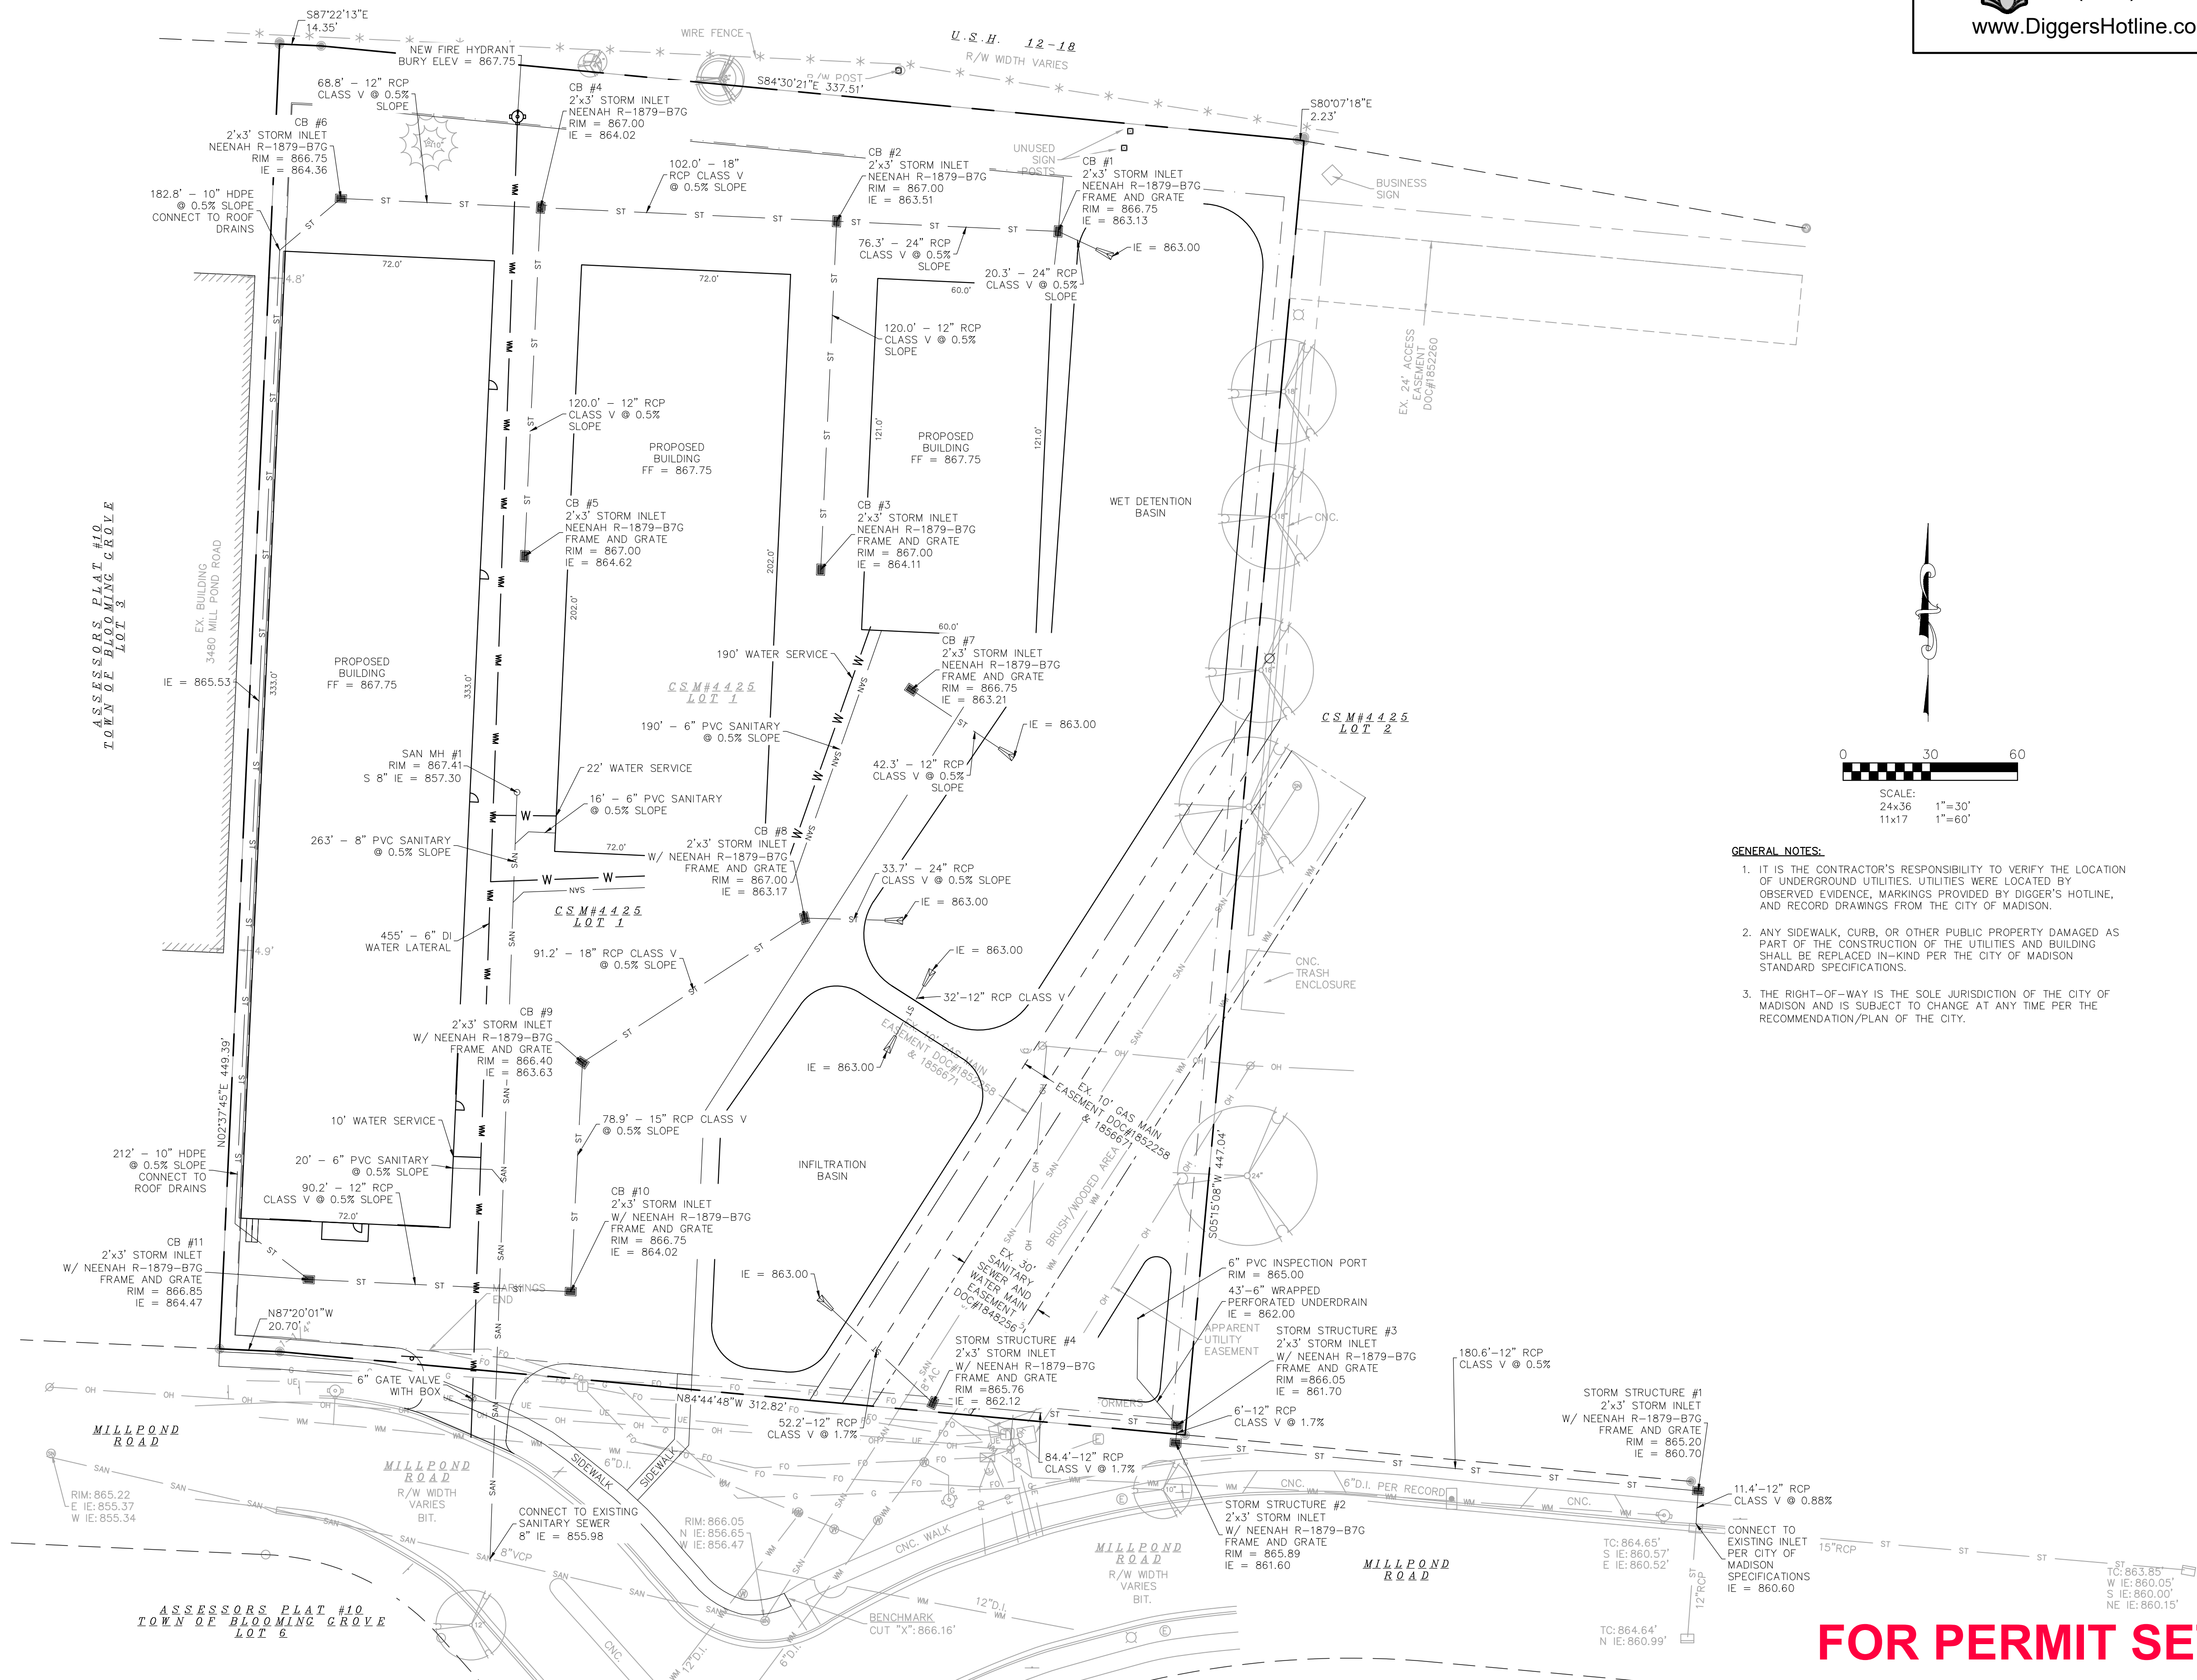HOSE LAY TO HYDRANT ON MILL POND ROAD  
HOSE LAY TO PROPOSED HYDRANT ON MILL POND ROAD  
SOUTH HOSE LAY TO EXTERIOR PORTIONS OF BUILDINGS (MAX 250FT)  
NORTH HOSE LAY TO EXTERIOR PORTIONS OF BUILDINGS (MAX 250FT)



FIRE LANE SIGNAGE DETAIL

CONSTRUCTION MANAGER TO COORDINATE PLACEMENT LOCATIONS

NOTE: FIRE ACCESS PLAN ASSUMES BUILDINGS WILL BE SPRINKLERED.

MAX 250' DISTANCE FROM FIRE ACCESS LANE TO ALL EXTERIOR WALLS OF A SPRINKLERED BUILDING

MAX 150' DISTANCE FROM FIRE ACCESS LANE TO ALL EXTERIOR WALLS OF A NONSPRINKLERED BUILDING



## City of Madison Fire Department

314 W Dayton Street, Madison, WI 53703  
Phone: 608-266-4420 • Fax: 608-267-1100 • E-mail: fire@cityofmadison.com

Project Address: 6334 MILL POND ROAD  
Contact Name & Phone #: DEAN HEFTER 608-250-9263


### FIRE APPARATUS ACCESS AND FIRE HYDRANT WORKSHEET

1. Is the building completely protected by an NFPA 13 or 13R automatic fire sprinkler system?	<input checked="" type="checkbox"/> Yes	<input type="checkbox"/> No	<input type="checkbox"/> N/A
If non-sprinklered, fire lanes extend to within 150-feet of all portions of the exterior wall?	<input type="checkbox"/> Yes	<input type="checkbox"/> No	<input checked="" type="checkbox"/> N/A
If sprinklered, fire lanes are within 250-feet of all portions of the exterior wall?	<input checked="" type="checkbox"/> Yes	<input type="checkbox"/> No	<input type="checkbox"/> N/A
2. Is the fire lane constructed of concrete or asphalt, designed to support a minimum load of 85,000 lbs?	<input checked="" type="checkbox"/> Yes	<input type="checkbox"/> No	<input type="checkbox"/> N/A
a) Is the fire lane a minimum unobstructed width of at least 20-feet?	<input checked="" type="checkbox"/> Yes	<input type="checkbox"/> No	<input type="checkbox"/> N/A
b) Is the fire lane unobstructed with a vertical clearance of at least 13½-feet?	<input checked="" type="checkbox"/> Yes	<input type="checkbox"/> No	<input type="checkbox"/> N/A
c) Is the minimum inside turning radius of the fire lane at least 28-feet?	<input checked="" type="checkbox"/> Yes	<input type="checkbox"/> No	<input type="checkbox"/> N/A
d) Is the grade of the fire lane not more than a slope of 8%?	<input checked="" type="checkbox"/> Yes	<input type="checkbox"/> No	<input type="checkbox"/> N/A
e) Is the fire lane posted as fire lane? (Provide detail of signage.)	<input checked="" type="checkbox"/> Yes	<input type="checkbox"/> No	<input type="checkbox"/> N/A
f) Is a roll-able curb used as part of the fire lane? (Provide detail of curb.)	<input type="checkbox"/> Yes	<input type="checkbox"/> No	<input checked="" type="checkbox"/> N/A
g) Is part of a sidewalk used as part of the required fire lane? (Must support +85,000 lbs.)	<input type="checkbox"/> Yes	<input checked="" type="checkbox"/> No	<input type="checkbox"/> N/A
3. Is the fire lane obstructed by security gates or barricades? If yes:	<input type="checkbox"/> Yes	<input checked="" type="checkbox"/> No	<input type="checkbox"/> N/A
a) Is the gate a minimum of 20-feet clear opening?	<input type="checkbox"/> Yes	<input type="checkbox"/> No	<input checked="" type="checkbox"/> N/A
b) Is an approved means of emergency operations installed, key vault, padlock or key switch?	<input type="checkbox"/> Yes	<input type="checkbox"/> No	<input checked="" type="checkbox"/> N/A
4. Is the Fire lane dead-ended with a length greater than 150-feet? If yes, does the area for turning around fire apparatus comply with IFC D103?	<input checked="" type="checkbox"/> Yes	<input type="checkbox"/> No	<input type="checkbox"/> N/A
5. Is any portion of the building to be used for high-piled storage in accordance with IFC Chapter 3206.6 If yes, see IFC 3206.6 for further requirements.	<input type="checkbox"/> Yes	<input checked="" type="checkbox"/> No	<input type="checkbox"/> N/A
6. Is any part of the building greater than 30-feet above the grade plane? If yes, answer the following questions:	<input type="checkbox"/> Yes	<input checked="" type="checkbox"/> No	<input type="checkbox"/> N/A
a) Is the aerial apparatus fire lane parallel to one entire side of the building and covering at least 25% of the perimeter?	<input type="checkbox"/> Yes	<input type="checkbox"/> No	<input checked="" type="checkbox"/> N/A
b) Is the near edge of the aerial apparatus fire lane between 15' and 30' from the building?	<input type="checkbox"/> Yes	<input type="checkbox"/> No	<input checked="" type="checkbox"/> N/A
c) Are there any overhead power or utility lines located across the aerial apparatus fire lane?	<input type="checkbox"/> Yes	<input type="checkbox"/> No	<input checked="" type="checkbox"/> N/A
d) Are there any tree canopies expected to grow across the aerial fire lane? (Based on mature canopy width of tree species)	<input type="checkbox"/> Yes	<input type="checkbox"/> No	<input checked="" type="checkbox"/> N/A
e) Does the aerial apparatus fire lane have a minimum unobstructed width of 26-feet?	<input type="checkbox"/> Yes	<input type="checkbox"/> No	<input checked="" type="checkbox"/> N/A
f) Is the space between the aerial lane and the building free of trees exceeding 20' in heights?	<input type="checkbox"/> Yes	<input type="checkbox"/> No	<input checked="" type="checkbox"/> N/A
7. Are all portions of the required fire lanes within 500-feet of at least (2) hydrants? Note: Distances shall be measured along the path of the hose lay as it comes off the fire apparatus.	<input checked="" type="checkbox"/> Yes	<input type="checkbox"/> No	<input type="checkbox"/> N/A
a) Is the fire lane at least 26' wide for at least 20-feet on each side of the hydrants?	<input checked="" type="checkbox"/> Yes	<input type="checkbox"/> No	<input type="checkbox"/> N/A
b) Is there at least 40' between a hydrant and the building?	<input checked="" type="checkbox"/> Yes	<input type="checkbox"/> No	<input type="checkbox"/> N/A
c) Are the hydrant(s) setback no less than 5-feet nor more than 10-feet from the curb or edge of the street or fire lane?	<input checked="" type="checkbox"/> Yes	<input type="checkbox"/> No	<input type="checkbox"/> N/A
d) Are hydrants located in parking lot islands a minimum of 3½-feet from the hydrant to the curb?	<input type="checkbox"/> Yes	<input checked="" type="checkbox"/> No	<input type="checkbox"/> N/A
e) Are there no obstructions, including but not limited to: power poles, trees, bushes, fences, posts located, or grade changes exceeding 1½-feet, within 5-feet of a fire hydrant?	<input checked="" type="checkbox"/> Yes	<input type="checkbox"/> No	<input type="checkbox"/> N/A

Attach an additional sheet if further explanation is required for any answers.

This worksheet is based on MGO 34.503 and IFC 2021 Edition Chapter 5 and Appendix D; please see the codes for further information.

Revised 06/2022

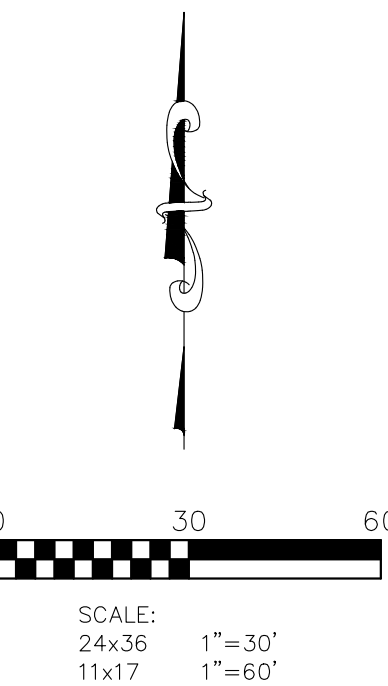

FOR PERMIT SET



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APPROVALS	PROJECT ENG	MLB	DESIGNED BY	MLB	SEALANT SIGN	DJM	CHECKED BY	PJF	APPROVED	MLB
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6334 Millpond Road  
6334 Mill Pond Rd.  
Madison, WI 53718  
SCHULEBURG & DAUGHTER ENTERPRISES II, LLC  
1400 OLSTAD RD  
DEERFIELD, WI 53531-9309

PROJECT #: BSE2849  
PLOT DATE: 05/13/2024

REVISION DATES:

ISSUE DATES:

05/13/2024

FIRE ACCESS PLAN

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DRAWING NUMBER

C-600




NOT FOR CONSTRUCTION



- NOTES:
- 1) All new turf areas and existing turf areas that are disturbed by construction to receive a minimum of 4" of topsoil, no mow seed mix, starter fertilizer, and straw mulch.
  - 2) Designated 'infiltration basin' area and side slopes of 'wet detention basin and 'bioretention basin' to receive a minimum of 4" of topsoil. 'Rainwater Renewal seed mix (supplied by Agreco) or approved equal and straw mulch.
  - 3) Lawn areas in the Mill Pond Road ROW areas that are disturbed by construction to receive a minimum of 4" of topsoil, premium bluegrass seed mix, starter fertilizer, and straw mulch.
  - 4) Turf areas in swales and on slopes in excess of 3:1 shall be mulched with straw mat.
  - 5) Designated planting beds to be mulched with shredded hardwood bark mulch spread to a depth of 3".
  - 6) Individual trees and shrub groupings in turf areas to receive shredded hardwood bark mulch plant rings (4' diameter) spread to a depth of 3".
  - 7) Designated planting beds to be separated from turf areas with 5" crisp shovel cut edge.
  - 8) Bioretention Basin to receive bark or cocoa mulch, per WDNR specifications.
  - 9) Bioretention Basin plants (RGP) to be installed 12" on center.
  - 10) Bioretention Basin to be constructed per WDNR specifications.

PLANT LIST				
KEY	QUAN	SIZE	COMMON NAME	BOTANICAL NAME ROOT
(24) Canopy Trees				
CH	3	2 1/2"	Common Hackberry	Celtis Occidentalis BB
EP	2	2 1/2"	Exclamation Planetree	Platanus Acerfolia BB
E-HL	2	12"	Existing Honeylocust	Gleditsia Trianthos EX street tree
E-LLL	1	10"	Existing Little Leaf Linden	Tilia Cordata EX street tree
KCT	2	2 1/2"	Kentucky Coffeetree	Gymnocladus Dioicus BB
QA	3	2 1/2"	Quaking Aspen	Populus Tremuloides BB
RO	4	2 1/2"	Red Oak	Quercus Rubrum BB
SWO	7	2 1/2"	Swamp White Oak	Quercus Bicolor BB
T	3	2 1/2"	Tamarack	Larix Laricina BB
(7) Ornamental Trees				
ACH	1	2"	Amur Chokecherry	Prunus Americana BB
IW	2	2"	Ironwood	Ostrya Virginiana BB
RBC	2	10"	River Birch Clump	Betula Nigra BB
WBC	2	10"	Whitespire Birch Clump	Betula Papyrifera BB
(4) Evergreen Trees				
BHS	4	5'	Black Hills Spruce	Picea Pungens Densata BB
(145) Deciduous Shrubs				
AV	9	24"	Alfreda Viburnum	Viburnum Trilobum 'Alfreda' Pot
AVB	13	24"	Arrowwood Viburnum	Viburnum Dentatum Pot
BC	9	24"	Black Chokeberry	Aronia Melanocarpa Pot
DBH	32	24"	Dwarf Bush Honeysuckle	Diervilla Lonicera Pot
MV	6	24"	Mohican Viburnum	Viburnum Lantana 'Mohican' Pot
RTD	42	24"	Red Twig dogwood	Cornus Sericea Pot
WS	14	24"	White Snowberry	Symphoricarpos Alba Pot
YTD	20	24"	Yellow Twig dogwood	Cornus Lutea Pot
(2) Tall Evergreen Shrubs				
WBJ	2	4'	Wichita Blue Juniper	Juniperus Scoparium BB
RGP 300 2 1/2" Bio-retention Plantings (Planted 12' on center) plug				

LANDSCAPE WORKSHEET	
Zoning Category:	(CC)
Landscape Points Required	
Developed Area =	92,338 SF
Landscape Points: 92,338 / 300 x 5 =	1,539 points
Total Landscape Points Required	1,539 points
Landscape Points Supplied	
Existing canopy trees - 0 @ 35 =	0 points
Proposed canopy trees - 24 @ 35 =	840 points
Existing evergreen trees - 0 @ 35 =	0 points
Proposed evergreen trees - 4 @ 35 =	140 points
Existing ornamental trees - 6 @ 15 =	90 points
Proposed ornamental trees - 7 @ 15 =	105 points
Existing upright evergreen shrubs - 0 @ 10 =	0 points
Proposed upright evergreen shrubs - 2 @ 10 =	20 points
Existing deciduous shrubs - 0 @ 3 =	0 points
Proposed deciduous shrubs - 145 @ 3 =	435 points
Existing evergreen shrubs - 0 @ 4 =	0 points
Proposed evergreen shrubs - 0 @ 4 =	0 points
Existing perennials & grasses 0 @ 2 =	0 points
Proposed perennials & grasses 0 @ 2 =	0 points
Total landscape points supplied =	1,540 points
Lot Frontage Landscape Required	
(Section 28.142(5) Development Frontage Landscaping)	
Mill Pond Road and USH 12 & 18 =	650 LF
Over story trees required 650/30' = 21.6	
Shrubs required (650.5/30') x 5 = 108.4	22 trees
	108 shrubs
Over story trees supplied	16 trees
Ornamental or evergreen trees supplied	6 trees
Shrubs supplied	108 shrubs

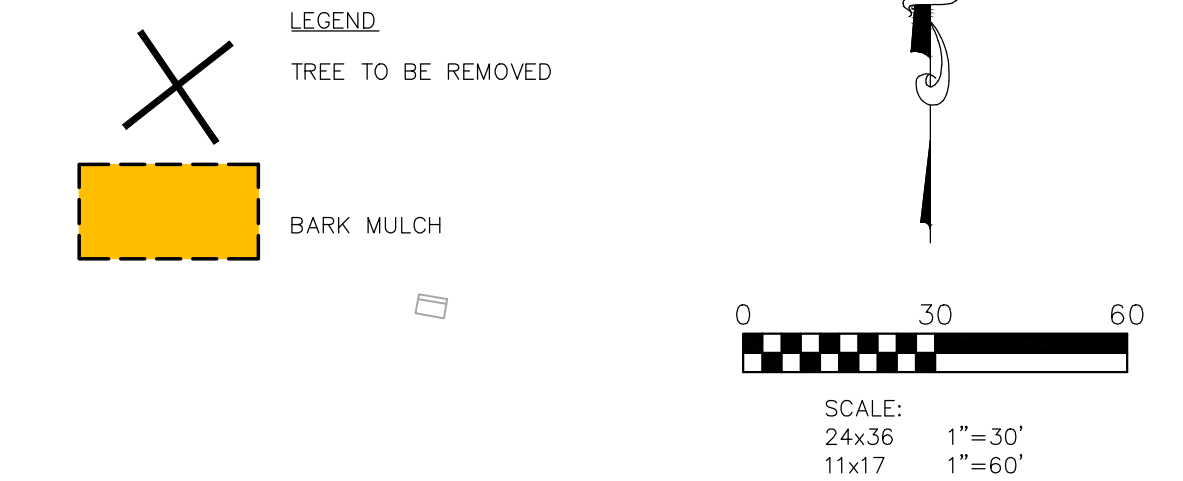

FOR PERMIT SET



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APPROVALS	PROJECT ENG	MLB	DESIGNED BY	MLB	SEALING BY	MLB	CHKD BY	MLB	DATE	MLB
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LANDSCAPE PLAN

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DRAWING NUMBER


L-100





# Proposed Building for: Harley-Davidson of Madison

76'x376x13'-8"

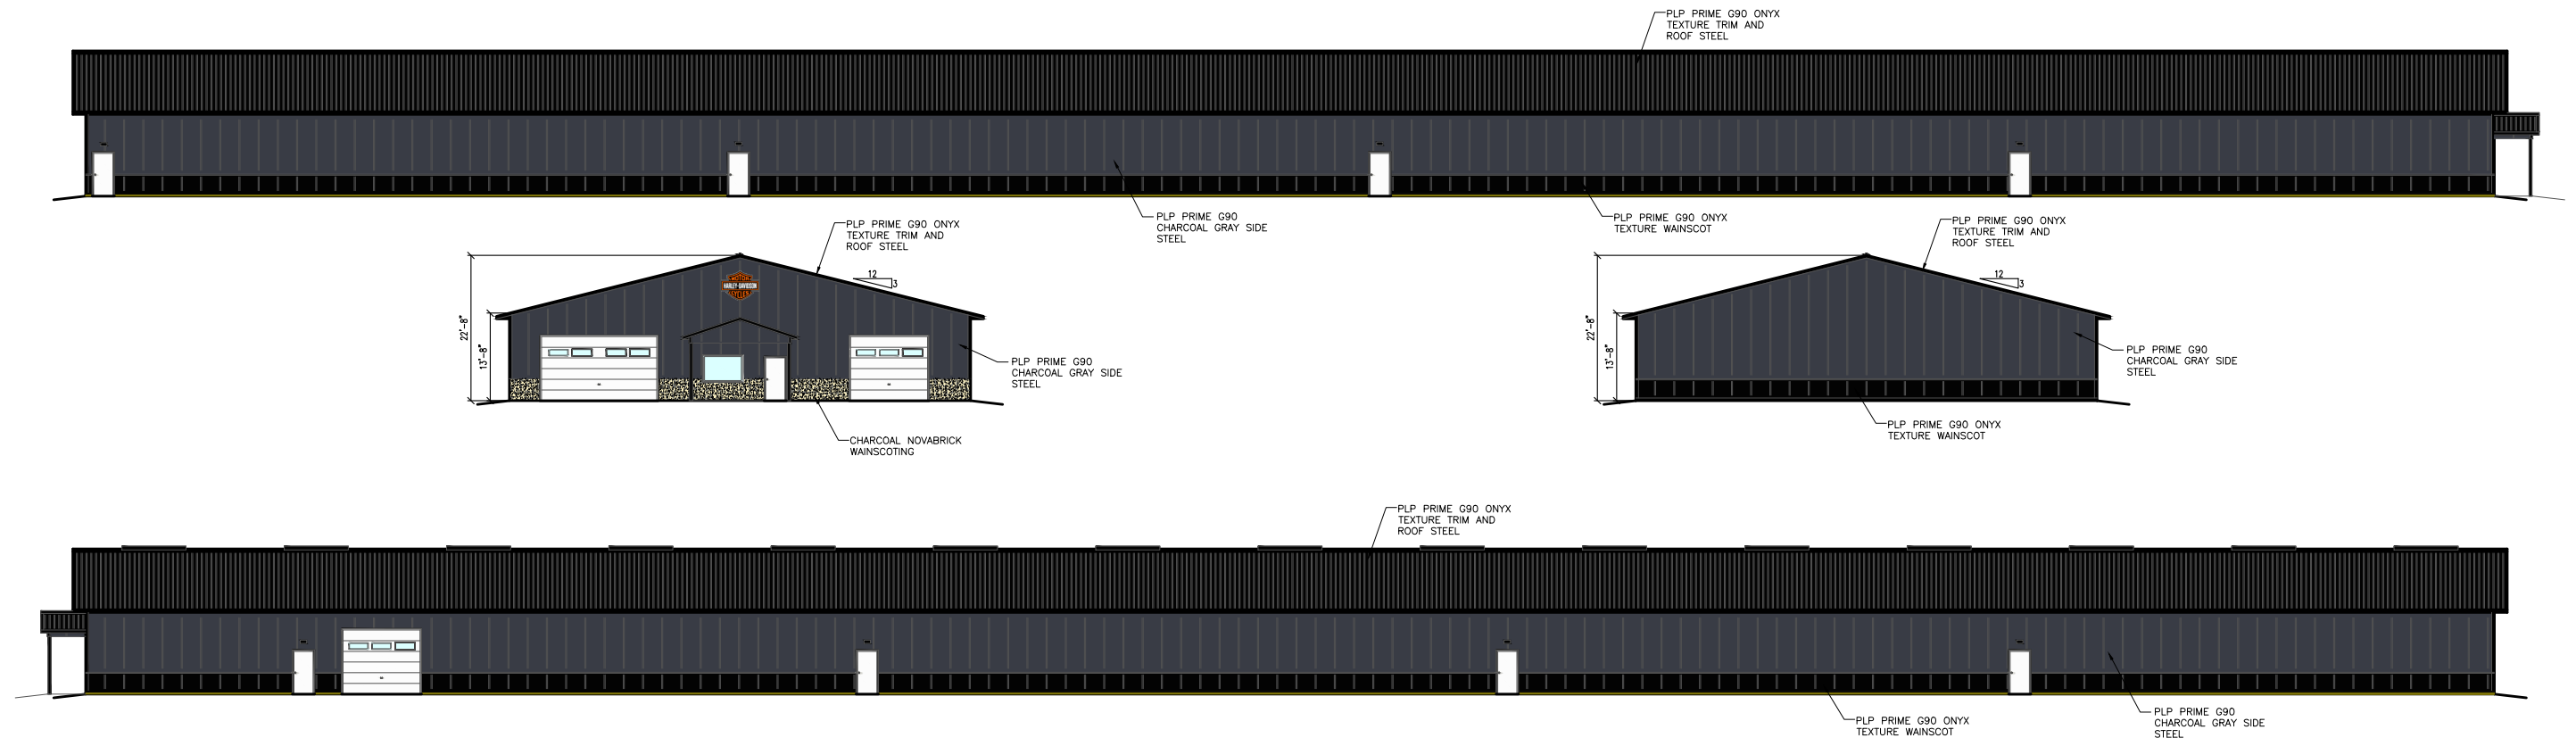

**BUILDING COLORS**  
ROOF: ONYX TEXTURE  
SIDES: CHARCOAL GRAY  
TRIM: ONYX TEXTURE  
WAINSCOTING: ONYX TEXTURE  
NOVABRICK: CHARCOAL

## BUILDING ELEVATIONS

**We Protect What You Value™**

NOTE:  
THE COLORS SHOWN ON THIS  
PROPOSAL ARE AS CLOSE TO  
THE ACTUAL PAINTED COLORS  
AS PERMITTED BY THE PRINTING  
PROCESS

SCALE: 1/32"=1'-0"

A-100





BUILDING ACCESSORY SCHEDULE				
ITEM	SIZE	B.E./T.E.	QTY	ROUGH OPENING & ACCESSORY FEATURES
[1] SOLID WALK DOOR	3' 0"x6' 8"	B.E. =100' 4"	4	R.O. 3' 4 1/2"x6' 10 1/2", PREMIUM, BRILLIANT, I.C. LOCKSET WITH LEV./LEV. D.B., LATCH GUARD, KEYED ALIKE, CLOSER, H.CAP THRESHOLD
[2] WALK DOOR 20X24 LITE	3' 0"x6' 8"	B.E. =100' 4"	4	R.O. 3' 4 1/2"x6' 10 1/2", PREMIUM, BRILLIANT, LEV./LEV. LOCKSET, KEYED ALIKE, CLOSER, H.CAP THRESHOLD
[3] OVERHEAD DOOR	12' 0"x10' 0"	B.E. =100' 4"	2	I.D. =11' 11 1/2", 13-20" HEADROOM OPTION WITH LINER, DOOR BY CLEARY SUB
[4] SOLID WALK DOOR	3' 0"x6' 8"	B.E. =100' 4"	1	R.O. 3' 4 1/2"x6' 10 1/2", PREMIUM, BRILLIANT, LATCH GUARD, KEYED ALIKE, CLOSER, H.CAP THRESHOLD, PANIC HARDWARE
[5] FIXED LITE WINDOW	6' 0"x4' 0"	T.E. = 107' 2"	1	HIGH PERFORMANCE, BRILLIANT, INSULATED DOUBLE PANE, NAIL FIN, LOW-E / WARM EDGE, TYVEK AT WINDOW ONLY
[6] OVERHEAD DOOR	18' 0"x10' 0"	B.E. =100' 4"	1	I.D. =17' 11 1/2", 13-20" HEADROOM OPTION WITH LINER, DOOR BY CLEARY SUB



190 PAOLI STREET / P.O. BOX 930220  
VERONA, WI 53593 / (800) 373-5550

DRAWN BY: WALDERA

DATE DRAWN: 5/13/24

PLAN REVISIONS:

NUMBER	DATE	BY
1		
2		
3		
4		

PROJECT NAME:  
HARLEY-DAVIDSON OF MADISON

PROJECT SITE ADDRESS:

COTTAGE GROVE, WI 53527 (DANE)

BUILDING SIZE:

72' 0" x 376' 0" x 13' 8"

SHEET NAME:

FLOOR PLAN

PROJECT NUMBER:  
PR202404

SHEET NUMBER:  
A-200

WHEN PRINTED ON 24"x36"  
PAPER SCALE IS 1/16"=1'-0"

