# 702 EAST WASHINGTON AVENUE MIXED-USE DEVELOPMENT

MADISON, WISCONSIN



PROGRESS DOCUMENTS


These documents reflect progress and intent and may be subject to change, including additional detail. These are not final construction documents and should not be used for final bidding or construction-related purposes.

CITY OF MADISON LAND-USE & URBAN DESIGN COMMISION SUBMITTAL


JANUARY 5, 2024






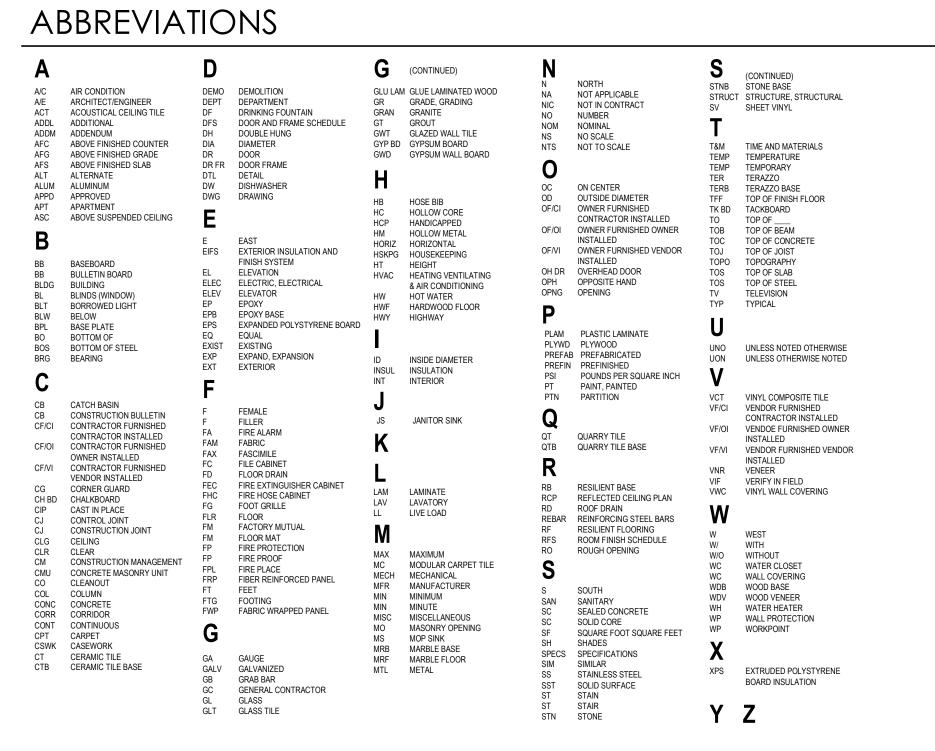

### SYMBOL LEGEND

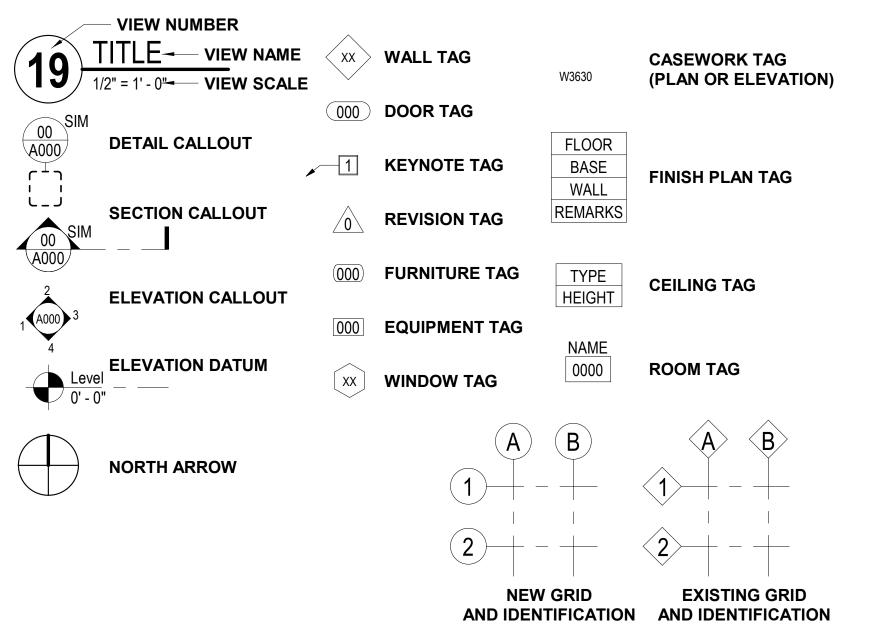

## VICINITY MAP

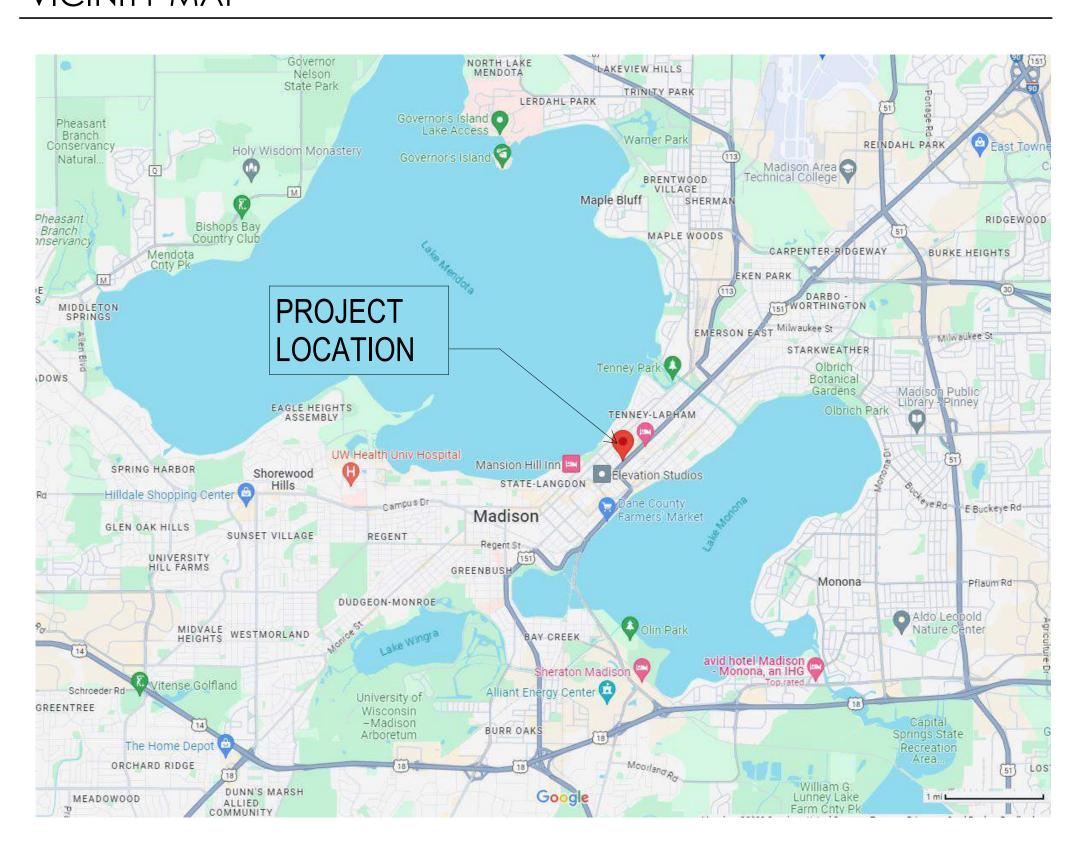

# PROJECT ADDRESS

702 EAST WASHINGTON AVENUE, MADISON, WISCONSIN 53703

# OWNER INFORMATION

T.B.D.

## WILLOW PARTNERS, LLC

725 EAST JOHNSON STREET MADISON, WI 53701


CONTACT: CHRIS HOUDEN JR EMAIL: chris@willowpartners.com MAIN: 608.405.1771 ext 201

# PROJECT TEAM

## GENERAL CONTRACTOR




## ARCHITECTURAL

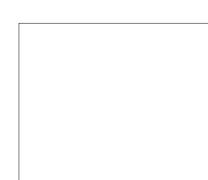

## JLA ARCHITECTS & PLANNERS

800 WEST BROADWAY - SUITE 200 MONONA, WISCONSIN 53713 CONTACT: JENNIFER CAMP EMAIL: jcamp@jla-ap.com MAIN: 608.210.1232


## CIVIL ENGINEERING

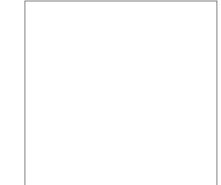

## GRAEF, INC

1010 EAST WASHINGTON AVENUE - SUITE 202 MADISON, WI 53703 CONTACT: AMY LARSON, PE EMAIL: amy.larson@graef-usa.com MAIN: 608.245.1962


## STRUCTURAL ENGINEERING

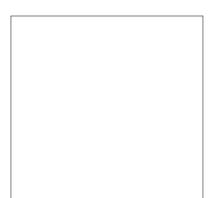

# PIERCE ENGINEERS

222 W WASHINGTON AVENUE - SUITE 650 MADISON, WI 53703 CONTACT: LUCAS MARSHALL, PE, SE EMAIL: Imarshall@pierceengineers.com MAIN: 608.729.1414

## **LANDSCAPE**

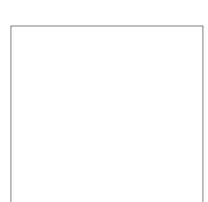

## GRAEF, INC

1010 EAST WASHINGTON AVENUE - SUITE 202 MADISON, WI 53703 CONTACT: JOE PEPITONE EMAIL: joseph.pepitone@graef-usa.com MAIN: 414.412.0297

# SET ISSUE

CITY OF MADISON LAND-USE & URBAN DESIGN COMMISION SUBMITTAL NOVEMBER 27, 2023

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JLA PROJECT NUMBER:

W22-0106

702 EAST
WASHINGTON
AVENUE MIXED-USE
DEVELOPMENT

CITY OF MADISON LAND-USE & URBAN DESIGN COMMISSION SUBMITTAL

PROGRESS DOCUMENTS

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DATE OF ISS	REVISION SCHEDULE	ANUARY 5, 20
Mark	Description	Date

HEET TITLE

INDEX SHEET

Sheet number

G001

#### **702 EAST WASHINGTON**

MIXED-USE January 5, 2024

UILDING DATA	<b>A</b> :												<b>RESIDE</b>	NTIAL															
		FIRST FLOOR		SECOND FLOOR	Т	HIRD FLOOR	FO	OURTH FLOOR	FIFTH FLOOR	SIXTH FLOOR	SE	VENTH FLOOR	EIC	SHTH FLOOR	NIN	TH FLOOR	TENTH FLOOR	ELEVE	NTH FLOOR	TWE	LFTH FLOOR	THIRTE	ENTH FLOOR	FOURTEENTH FLOOR	QTY		01		
UNIT NAME	UNIT AREA	Qty Aggregate Are	a Qty	Aggregate Area	Qty	Aggregate Area	Qty	Aggregate Area	Qty Aggregate Area	Qty Aggregate Area	Qty	Aggregate Area	Qty	Aggregate Area	Qty /	Aggregate Area	Qty Aggregate Area	Qty A	Aggregate Area	Qty	Aggregate Area	Qty /	Aggregate Area (	Qty Aggregate Area		AREA SUB-TOTALS	%	UNIT TYPE BI	REAKDOWN
IT A1	532 S.F						1	532 S.F	1 532 S.F	1 532 S.F	1	532 S.F	1	532 S.F	1	532 S.F	1 532 S.F		532 S.F		532 S.F	1	532 S.F	1 532 S.F		1 5,852 S.F	4.5%	STUDIO	
IIT A2	513 S.F		-		2	1,026 S.F	2	1,026 S.F	3 1,539 S.F	3 1,539 S.F	3	1,539 <b>S</b> .F	3	1,539 <b>S</b> .F	3	1,539 <b>S</b> .F	3 1,539 S.F	3	1,539 <b>S</b> .F	3	1,539 <b>S</b> .F	3	1,539 <b>S</b> .F -		3	1 15,903 S.F	12.7% Total Qty	:	
NIT A2.1	510 S.F						1	510 S.F			-				-											1 510 S.F	0.4% Total Per	centage	
NIT A2M	513 S.F		-		1	513 S.F	2	1,026 S.F	2 1,026 S.F	2 1,026 S.F	2	1,026 S.F	2	1,026 S.F	2	1,026 S.F	2 1,026 S.F	2	1,026 S.F	2	1,026 S.F	2	1,026 S.F -		2	1 10,773 S.F	8.6% Total Are	a:	33,573
NIT A3	535 S.F						-		-		-		-		-		-			-	-			1 535 S.F	:	1 535 S.F	0.4% Average	Unit Size:	517
			-				-		-		-		-		-			-		-	-	-	-				-		
NIT B1	634 S.F		-		-		-				-				-					-				1 634 S.F		1 634 S.F		BEDROOM	
NIT B2	659 S.F		-				-				-									-				1 659 S.F		1 659 S.F	0.4% Total Qty		
NIT B3	718 S.F						-				-				-		-			•	-			1 718 S.F		1 718 S.F	0.4% Total Per		4
NIT B4	720 S.F		-		-		-				1	720 S.F	1	720 S.F	1	720 S.F	1 720 S.F	1	720 S.F	1	720 S.F	1	720 S.F -			7 5,040 S.F	2.9% Total Are		74,583
NIT B4A	720 S.F	•	-				1	720 S.F	1 720 S.F				-		-		-									3 2,160 S.F	1.2% Average	Unit Size:	746
NIT B5	719 S.F		-		-	740.0.5	1	719 S.F	1 719 S.F	1 719 S.F		719 S.F 716 S.F	1	719 S.F 716 S.F	1	719 S.F	1 719 S.F	1	719 S.F	1	719 S.F	1	719 S.F -		1	7,190 S.F	4.1%		
NIT B6 NIT B7	716 S.F 764 S.F				1	716 \$.F 764 \$.F		716 S.F 1,528 S.F	1 716 S.F 2 1,528 S.F	1 716 S.F 2 1,528 S.F		716 S.F 1,528 S.F	1	716 S.F 1,528 S.F	1	716 \$.F 1,528 \$.F	1 716 S.F 2 1,528 S.F	1	716 S.F 1,528 S.F	1	716 \$.F 1,528 \$.F	2	716 S.F -		1	1 7,876 S.F 1 16,044 S.F	4.5%		
NIT B7M	764 S.F				1	764 S.F		1,528 S.F	2 1,528 S.F	,		1,528 S.F	2	1,528 S.F	2	1,528 S.F	2 1,528 S.F	2	1,528 S.F	2	1,528 S.F	2	1,528 S.F -		2	1 16,044 S.F	8 6%		
NIT B8	763 S.F				1	763 S.F		763 S.F	1 763 S.F			763 S.F	1	763 S.F	1	763 S.F	1 763 S.F	1	763 S.F	1	763 S.F	1	763 S.F	1 763 S.F	1	2 9,156 S.F	4 9%		
NIT B8M	763 S.F		_		_	100 0.1	1	763 S.F	1 763 S.F	1 763 S.F		763 S.F	1	763 S.F	1	763 S.F	1 763 S.F	1	763 S.F	1	763 S.F	1	763 S.F	1 763 S.F		1 8,393 S.F	4.5%		
NIT B9	669 S.F	-	-		1	669 S.F	-	,000.	-	-	-				_		-	-		_		-	-			1 669 S.F	0.4%		
NIT C1	869 S.F		-		1	869 S.F	1	869 S.F	1 869 S.F	1 869 S.F	1	869 S.F	1	869 S.F	1	869 S.F	1 869 S.F	1	869 S.F	1	869 S.F	1	869 S.F -		1	1 9,559 S.F	4.5% 1 BEI	DROOM PLUS	
											-				-												_ Total Qty	:	
			-		-		-				-				-					-							_ Total Per	centage	
											-				-		and the second			-			-			-	- Total Are	a:	9,559
											-				-												_ Average	Unit Size:	869
		-	-		-		_				-		-		_			-		_	_	-	-				-		
NIT D1	1,144 S.F				1	1,144 S.F	-			1 1,144 S.F	1	1,144 S.F	1	1,144 S.F	1	1,144 S.F	1 1,144 S.F	1	1,144 S.F	1	1,144 S.F	1	1,144 S.F -			9 10,296 S.F	3.7% 2	BEDROOM	
NIT D1A	1,144 S.F		-				1	1,144 S.F	1 1,144 S.F		-		-		-					-						2 2,288 S.F	0.8% Total Qty	:	
NIT D2	1,029 S.F						-				-		-		-					-				1 1,029 S.F		1 1,029 S.F	0.4% Total Per		2
NIT D3	1,183 S.F		-				1	1,183 S.F	1 1,183 S.F			1,183 S.F	1	1,183 S.F	1	1,183 S.F	1 1,183 S.F	1	1,183 S.F	1	1,183 S.F	1	1,183 S.F -		1	0 11,830 S.F	4.1% Total Are		64,507
NIT D4	1,186 S.F		-		1	1,186 S.F		1,186 S.F	1 1,186 S.F			1,186 S.F	1	1,186 S.F	1	1,186 S.F	1 1,186 S.F	1	1,186 S.F	1	1,186 S.F	1	1,186 S.F -		1	1 13,046 S.F	4.5% Average	Unit Size:	1,173
NIT D4M	1,186 S.F	-	-		1	1,186 S.F	1	1,186 S.F	1 1,186 S.F	1 1,186 S.F	1	1,186 S.F	1	1,186 S.F	1	1,186 S.F	1 1,186 S.F	1	1,186 S.F	1	1,186 S.F	1	1,186 S.F -		1	1 13,046 S.F	4.5%		
NIT D5	1,112 S.F	•	-		-		-				•		-		-		*			-		-		1 1,112 S.F		1 1,112 S.F	0.4%		
NIT D6	1,186 S.F		-		-		1	1,186 S.F	1 1,186 S.F	1 1,186 S.F	1	1,186 S.F	1	1,186 S.F	1	1,186 S.F	1 1,186 S.F	1	1,186 S.F	1	1,186 S.F	1	1,186 S.F -		1	0 11,860 S.F	4.1%		
		•	•		-		-				•		•		•					-		•				•	•		
NIT F1	- 1,431 S.F		-		-		- 4	1,431 S.F	1 1,431 S.F	1 1,431 S.F	-	1,431 S.F	4	1,431 S.F	-	1,431 <b>S</b> .F	1 1,431 S.F	4	1,431 S.F	- 4	1,431 S.F	- 1	1,431 S.F -		1	0 14,310 S.F	4 10/. 3	BEDROOM	
NIT F2	1,431 S.F							1,431 S.F	1,431 5.F	1,431 5.5		1,431 3.F		1,431 3.7		1,431 3.5	1,4313.F		1,431 3.5		1,431 3.5	. '	1,401 3.5	1 1,371 S.F		1 1,371 S.F	0,4% Total Qty		
NIT F3	1,306 S.F																							1 1,306 S.F		1 1,306 S.F	0.4% Total Per		
NIT F4	1,286 S.F																							1 1,286 S.F		1 1,286 S.F	0.4% Total Are		18,27
	-						-																	1,200 011		-	- Average		1,406
			-		-		-													-									
		FIRST FLOOR		SECOND FLOOR	Т	HIRD FLOOR	FO	OURTH FLOOR	FIFTH FLOOR	SIXTH FLOOR	SE	VENTH FLOOR	EIC	SHTH FLOOR	NIN	TH FLOOR	TENTH FLOOR	ELEVE	NTH FLOOR	TWE	ELFTH FLOOR	THIRTE	ENTH FLOOR	FOURTEENTH FLOOR	T-4-LBL				
BUILDIN	G SUMMARY DATA	Total	Tota	ıl	Total		Total		Total	Total	Total		Total		Total		Total	Total		Total		Total	To	otal	Total Bldg	TOTAL AREAS	% U	NIT A.S.F.	TOTAL BR COUN
		Qty Total Area	Qty	Total Area	Qty	Total Area	Qty	Total Area	Qty Total Area	Qty Total Area	Qty	Total Area	Qty	Total Area	Qty	Total Area	Qty Total Area	Qty	Total Area	Qty	Total Area	Qty	Total Area (	Qty Total Area	Qty				
NIT TOTALS:		-	-	-	12	9,600 S.F		,	22 18,019 S.F				22	18,019 S.F	22	18,019 S.F	22 18,019 S.F		18,019 S.F	22	18,019 S.F	22	18,019 S.F	12 10,708 S.F	244		100.0%	822 S.F	
OMMON SPACES						(11,368 S.F)		(2,844 S.F)	(2,841 S.F)	(2,841 S.F	)	(2,841 S.F)		(2,841 S.F)		(2,841 S.F)	(2,841 S.F)	)	(2,841 S.F)		(2,841 S.F)		(2,841 S.F)	(7,279 S.F	()	(47,060 S.F)			
UILDING	Area:					20,968 S.F	1	20,860 S.F	20,860 S.F	20,860 S.F		20,860 S.F		20,860 S.F		20,860 S.F	20,860 S.F		20,860 S.F		20,860 S.F		20,860 S.F	17,987 S.F		247,555 S.F		1,015 S.F	Per Unit
OTALS:	Efficiency:	0	.0%	0.0%	ó	45.8%		86 4%	86 4%	86 4%		86 4%		86 4%		86 4%	86.4%		86 4%		86 4%		86 4%	59.5%	/	81.0%			

UILDING DATA:																	RETAIL																
		LOV	WER LEVEL	FIRS	ST FLOOR	1.	.5 FLOOR	SEC	OND FLOOR	FOUR	RTEENTH FLOOR		N/A	T (   D)																			
UILDING SUMMARY DATA		Total		Total		Total		Total		Total		Total		Total		Total		Total		Total		Total		Total		Total		Total		Total Bldg Qty	TOTAL AREAS	%	
		Qty	Total Area	Qty	Total Area	Qty	Total Area	Qty	Total Area	Qty	Total Area	Qty	Total Area	Qty	Total Area	Qty	Total Area	Qty	Total Area	Qty	Total Area	Qty	Total Area	Qty	Total Area	Qty	Total Area	Qty	Total Area	Qty			
RKING	32,428 S.F	1	32,428 S.F																	-										1	32,428 S.F	14.3	Retail Spaces
JLTI-TENANT RETAIL																																	Total Qty:
PACE #1	8,260 S.F			1	8,260 S.F									-		-		-		-				-						1	8,260 S.F	14.3	V <sub>6</sub>
BBY	4,355 S.F			1	4,355 S.F	-		-				-		-		-		-		-		-		-				-		1	4,355 S.F	14.3	Total Percentage
ARKING 1	19,813 S.F			1	19,813 S.F	-		-				-		-		-		-		-		-		-				-		1	19,813 S.F	14.3	Total Area: 129, A Average Unit Size: 18,
ARKING 1.5	32,428 S.F			-		1	32,428 S.F	-				-		-		-		-		-						-		-		1	32,428 S.F	14.3	Average Unit Size: 18,5
ULTI-TENANT RETAIL																																	
PACE #2	5,474 S.F			-				1	5,474 S.F			-		-		-		-		-		-						-		1	5,474 S.F 26,954 S.F	14.3	<b>%</b>
PACE #2 ARKING 2	26,954 S.F					-		1	5,474 S.F 26,954 S.F			-		-		•		-		-								-		1	26,954 S.F	14.3	<u>/6</u>
ECH PENTHOUSE	803 S.F										803 S.F																						
ECH FENTHOUSE	0U3 3.F										003 <b>3.</b> F																				<u>.</u>		
ETAIL SPACE TOTALS:		1	32,428 S.F	2	32,428 S.F	1	32,428 S.F	2	32,428 S.F	1	803.S.F.																			7	129,712 S.F	100.00	6 18,530 S.F A.S.F.
		1	32, <del>4</del> 20 3.F	١	JZ,4Z0 J.F		JZ,4Z0 J.F		32, <del>4</del> 20 3.F	1	000 0.1	-	-	-	-	-	-	-	-	-	-		<u> </u>	-	<u> </u>	-	-	- 1	-	1	·	100.0	0 10,550 Э.Г А.Э.Г.
OMMON SPACES:			-		-		-		-		(31,625 S.F)		-		-		-		-		-		-		-		-		-		(32,428 S.F)		
UILDING	Area:		32,428 S.F		32,428 S.F		32,428 S.F		32,428 S.F		32,428 S.F																				162,140 S.F		23,163 S.F Per Space
OTALS:	Efficiency:		100.09/		100.0%		100.00/		100.0%		2 50/		0.00/		0.00/		U U0/		U U0/		Λ Λ0/		U U0/		U U0/		U U0/	,	Λ Λ0/		80.0%		

	TA - TOTALS	ILDING DA	BU	
g Totals	Duildin	Common	al Leasable	Tot
grotais	Dullain	Common	A.S.F. per Space	1316
Efficiency	Area	Space	Area	Qty.
8	247,555	(47,060)	200,495	244
	162,140	(32,428.00)	129,712	7
8	409,695	(79,488)	330,207	251

NOTE: Final Unit Counts, Types, Mix, and Sizes are subject to change. The Total Unit Count & Density for Entire Development shall be regulated by the Approved PUD/GDP Package and subsequently Approved PUD/SIP Packages.



BICYCLE PARKING	(PROPOSED)
BUILDING	TOTALS
Residential Short Term (Interior)	
Residential Long Term - Wall (Max.)	
Reisdential Long Term - Floor (Min)	2
Interior Residential Total Spaces:	2
Guest/Short Term - Exterior	
Commercial Space1st Floor	
Commercial Space 2nd Floor	
Exterior Spaces:	
TOTAL PROPOSED BICYCLE PARKING:	2

ELECTRIC VEHICLE STALL INFORMATION:

TOTAL PARKING SPACES: 296
2% EV INSTALLED = 6
10% EV READY = 30



JLA PROJECT NUMBER: W22-01

702 EAST
WASHINGTON AVENUE
MIXED-USE
DEVELOPMENT

DESIGN DEVELOPMENT DOCUMENTS

PROGRESS DOCUMENTS


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1	ULE	
Mark	Description	Date

DATA MATRIX

SHEET NUMBER

G102



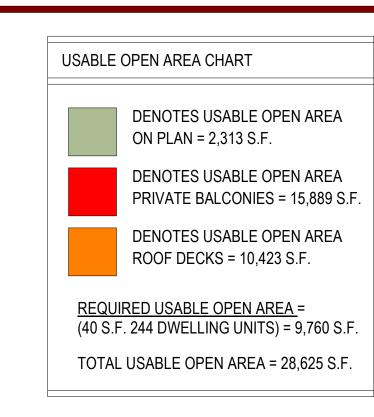

JLA PROJECT NUMBER: W22-0106

702 EAST WASHINGTON AVENUE MIXED-USE DEVELOPMENT

DESIGN DEVELOPMENT DOCUMENTS

PROGRESS DOCUMENTS

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DATE OF ISSUANCE JANUARY 5, 2024

REVISION SCHEDULE

REVISION SCHEDULE


Mark Description Date

SHEET TITLE

USEABLE OPEN AREA EXHIBIT


SHEET NUMBER

G103

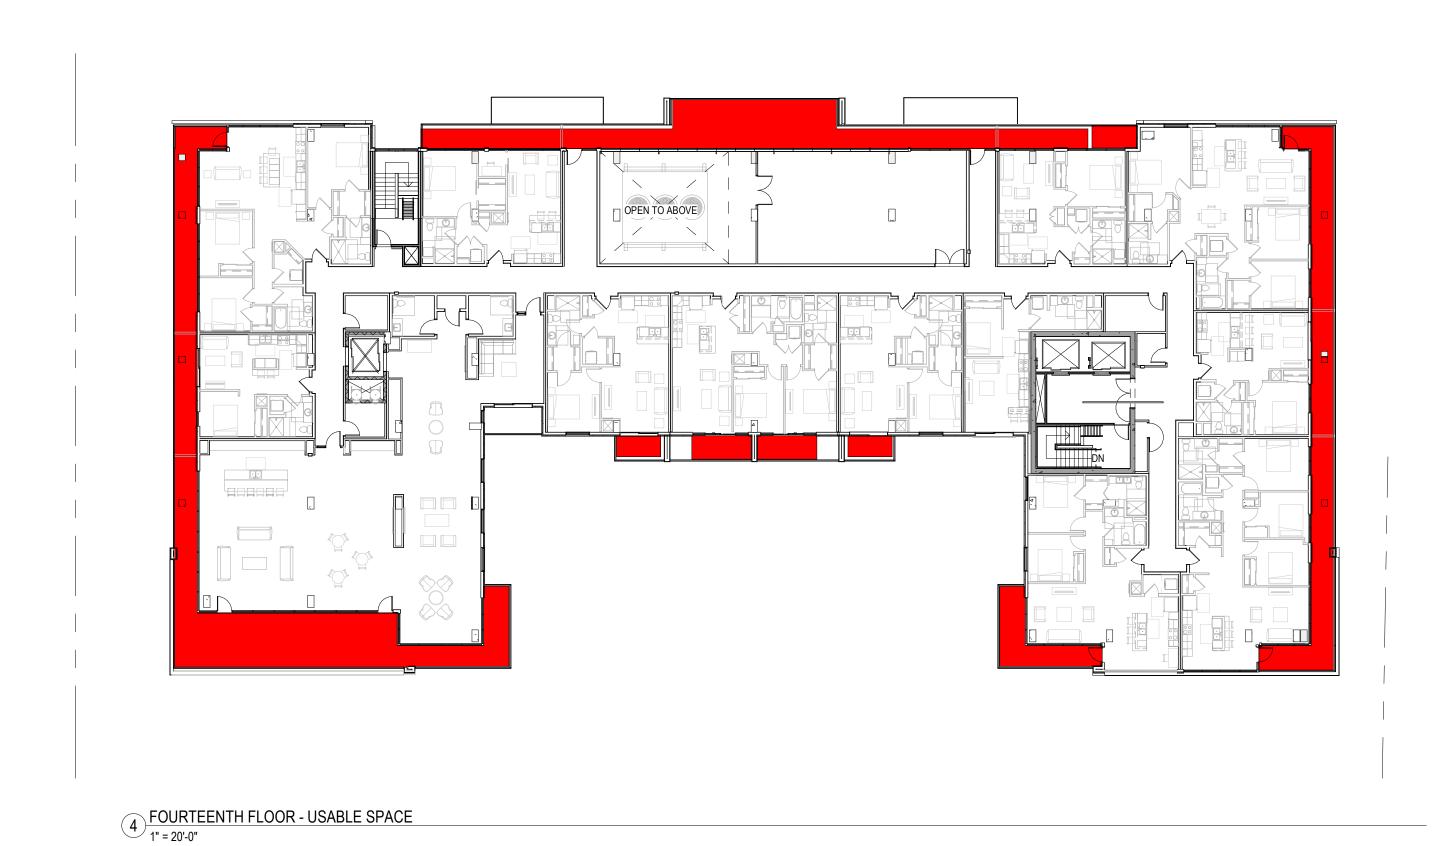



THRD FLOOR - USABLE SPACE

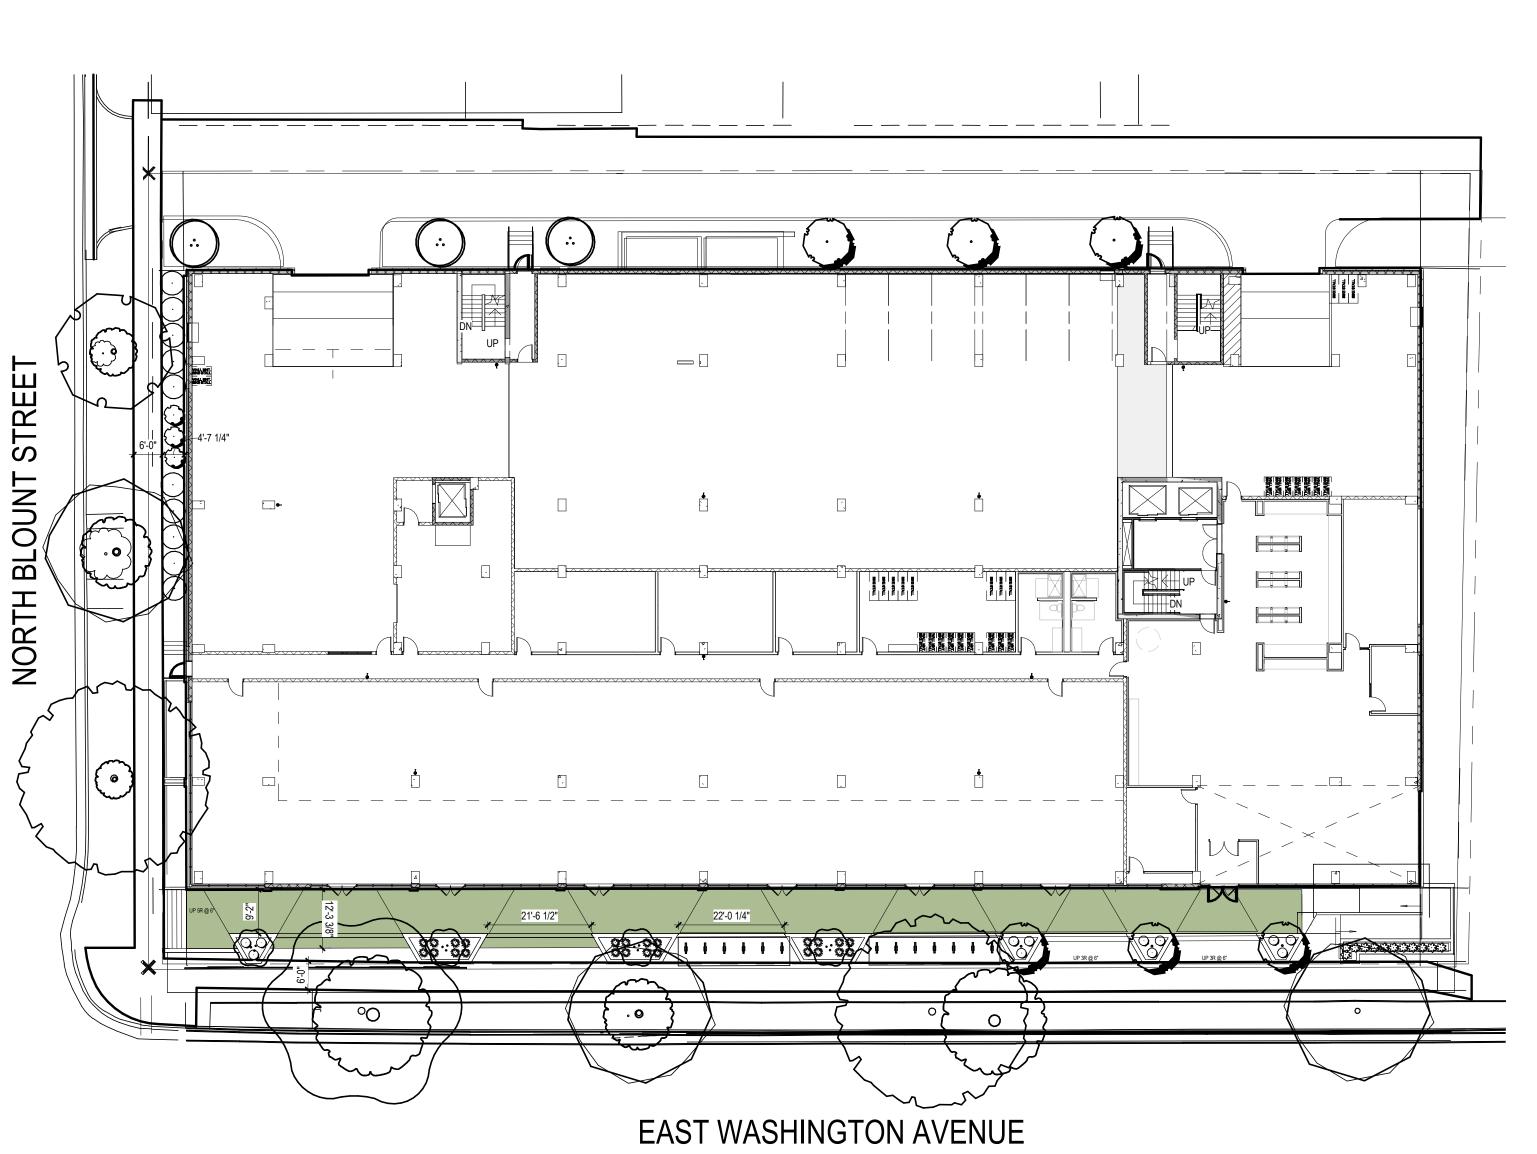

1 FIRST FLOOR - USABLE SPACE PLAN
1" = 20'-0"

3 TYPICAL FLOOR PLAN (4-13) 1" = 20'-0"

NOTED OTHERWISE. VERIFY ALL STRUCTURAL MEMBER SIZE, SPACING, REINFORCING, AND BRACING WITH STRUCTURAL DRAWINGS. STRUCTURAL MEMBERS.

GENERAL NOTES - PARKING LEVEL FLOOR PLAN

EXTERIOR DIMENSIONS ARE TO OUTSIDE FACE OF STUD OR MASONRY UNLESS 9.

INTERIOR DIMENSIONS ARE TO FACE OF STUD OR CONCRETE MASONRY UNIT WALLS UNLESS OTHERWISE NOTED.

EXTERIOR WINDOW & DOOR LOCATION DIMENSIONS ARE TO ROUGH OPENING ENDS OF WINDOW/DOOR UNLESS OTHERWISE NOTED. CONTRACTOR SHALL VERIFY ALL ROUGH OPENINGS WITH MANUFACTURER.

ALL CONCRETE MASONRY UNIT (CMU) WALLS SHALL BE TYPE M8-2X UNLESS 12. ALL METAL STUD WALLS SHALL BE AS TAGGED AND/ OR INDICATED ON THE INTERIOR WALL ASSEMBLIES SHEET, UNLESS NOTED OTHERWISE.

ANY EXPOSED STEEL THAT SUPPORTS LOAD-BEARING WALLS OR FLOORS SHALL BE PROTECTED BY MEANS OF SPRAY-FIREPROOFING. GENERAL CONTRACTOR TO COORDINATE WITH FINAL DESIGN AND INSTALLATION OF PRECAST CONCRETE 15. CONTRACTOR TO VERIFY LOCATIONS OF GAS METER, ELECTRICAL

ALL WOOD EXPOSED TO THE EXTERIOR OR IN CONTACT WITH CONCRETE OR MASONRY SHALL BE PRESSURE-TREATED.

DESIGN-BUILD MECHANICAL, ELECTRICAL, AND PLUMBING CONTRACTORS SHALL MAINTAIN A CLEAR HEIGHT OF 7'-0" MINIMUM IN VEHICLE AND

PEDESTRIAN TRAFFIC AREAS PER 2015 IBC 406. 10. VERIFY QUANTITY AND LOCATION OF INTERIOR AND EXTERIOR HOSE BIBBS WITH OWNER.

VERIFY QUANTITY, LOCATION, AND TYPE OF ELECTRICAL OUTLETS IN PARKING AREA WITH OWNER. PRIOR TO CONSTRUCTION, GENERAL CONTRACTOR TO VERIFY

REQUIREMENTS OF ALL TRADES INCLUDING: PRECAST, PLUMBING, SPRINKLERS, HVAC, ELEVATOR & ELECTRICAL. 13. GENERAL CONTRACTOR DOOR COORDINATE ALL PENETRATION AND OPENINGS THROUGH PRECAST PLANK WITH PRECAST PLAND PROVIDER, MEP CONTRACTORS, AND ARCHITECT.

COORDINATE LOCATION OF PRECAST PLANK DEPTHS W/ PRECAST SHOP DRAWINGS PRIOR TO POURING WALLS. METERS, AND THEIR SPACE REQUIREMENTS PRIOR TO CONSTRUCTION.

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702 EAST WASHINGTON AVENUE MIXED-USE DEVELOPMENT

> DESIGN DEVELOPMENT **DOCUMENTS**

PROGRESS DOCUMENTS

may be subject to change, including additional detail. These are not final construction documents and should not be used for final bidding or construction-related purposes.

DATE OF ISSUANCE JANUARY 5, 2024

REVISION SCHEDULE


OPTIONAL LOWER LEVEL 2 PLAN


SHEET NUMBER


DESIGN OF THE PROJECT IS DEVELOPED,

AND DOCUMENTED IN THE FINAL PLAN

REVIEW/ CONSTRUCTION DOCUMENTS.

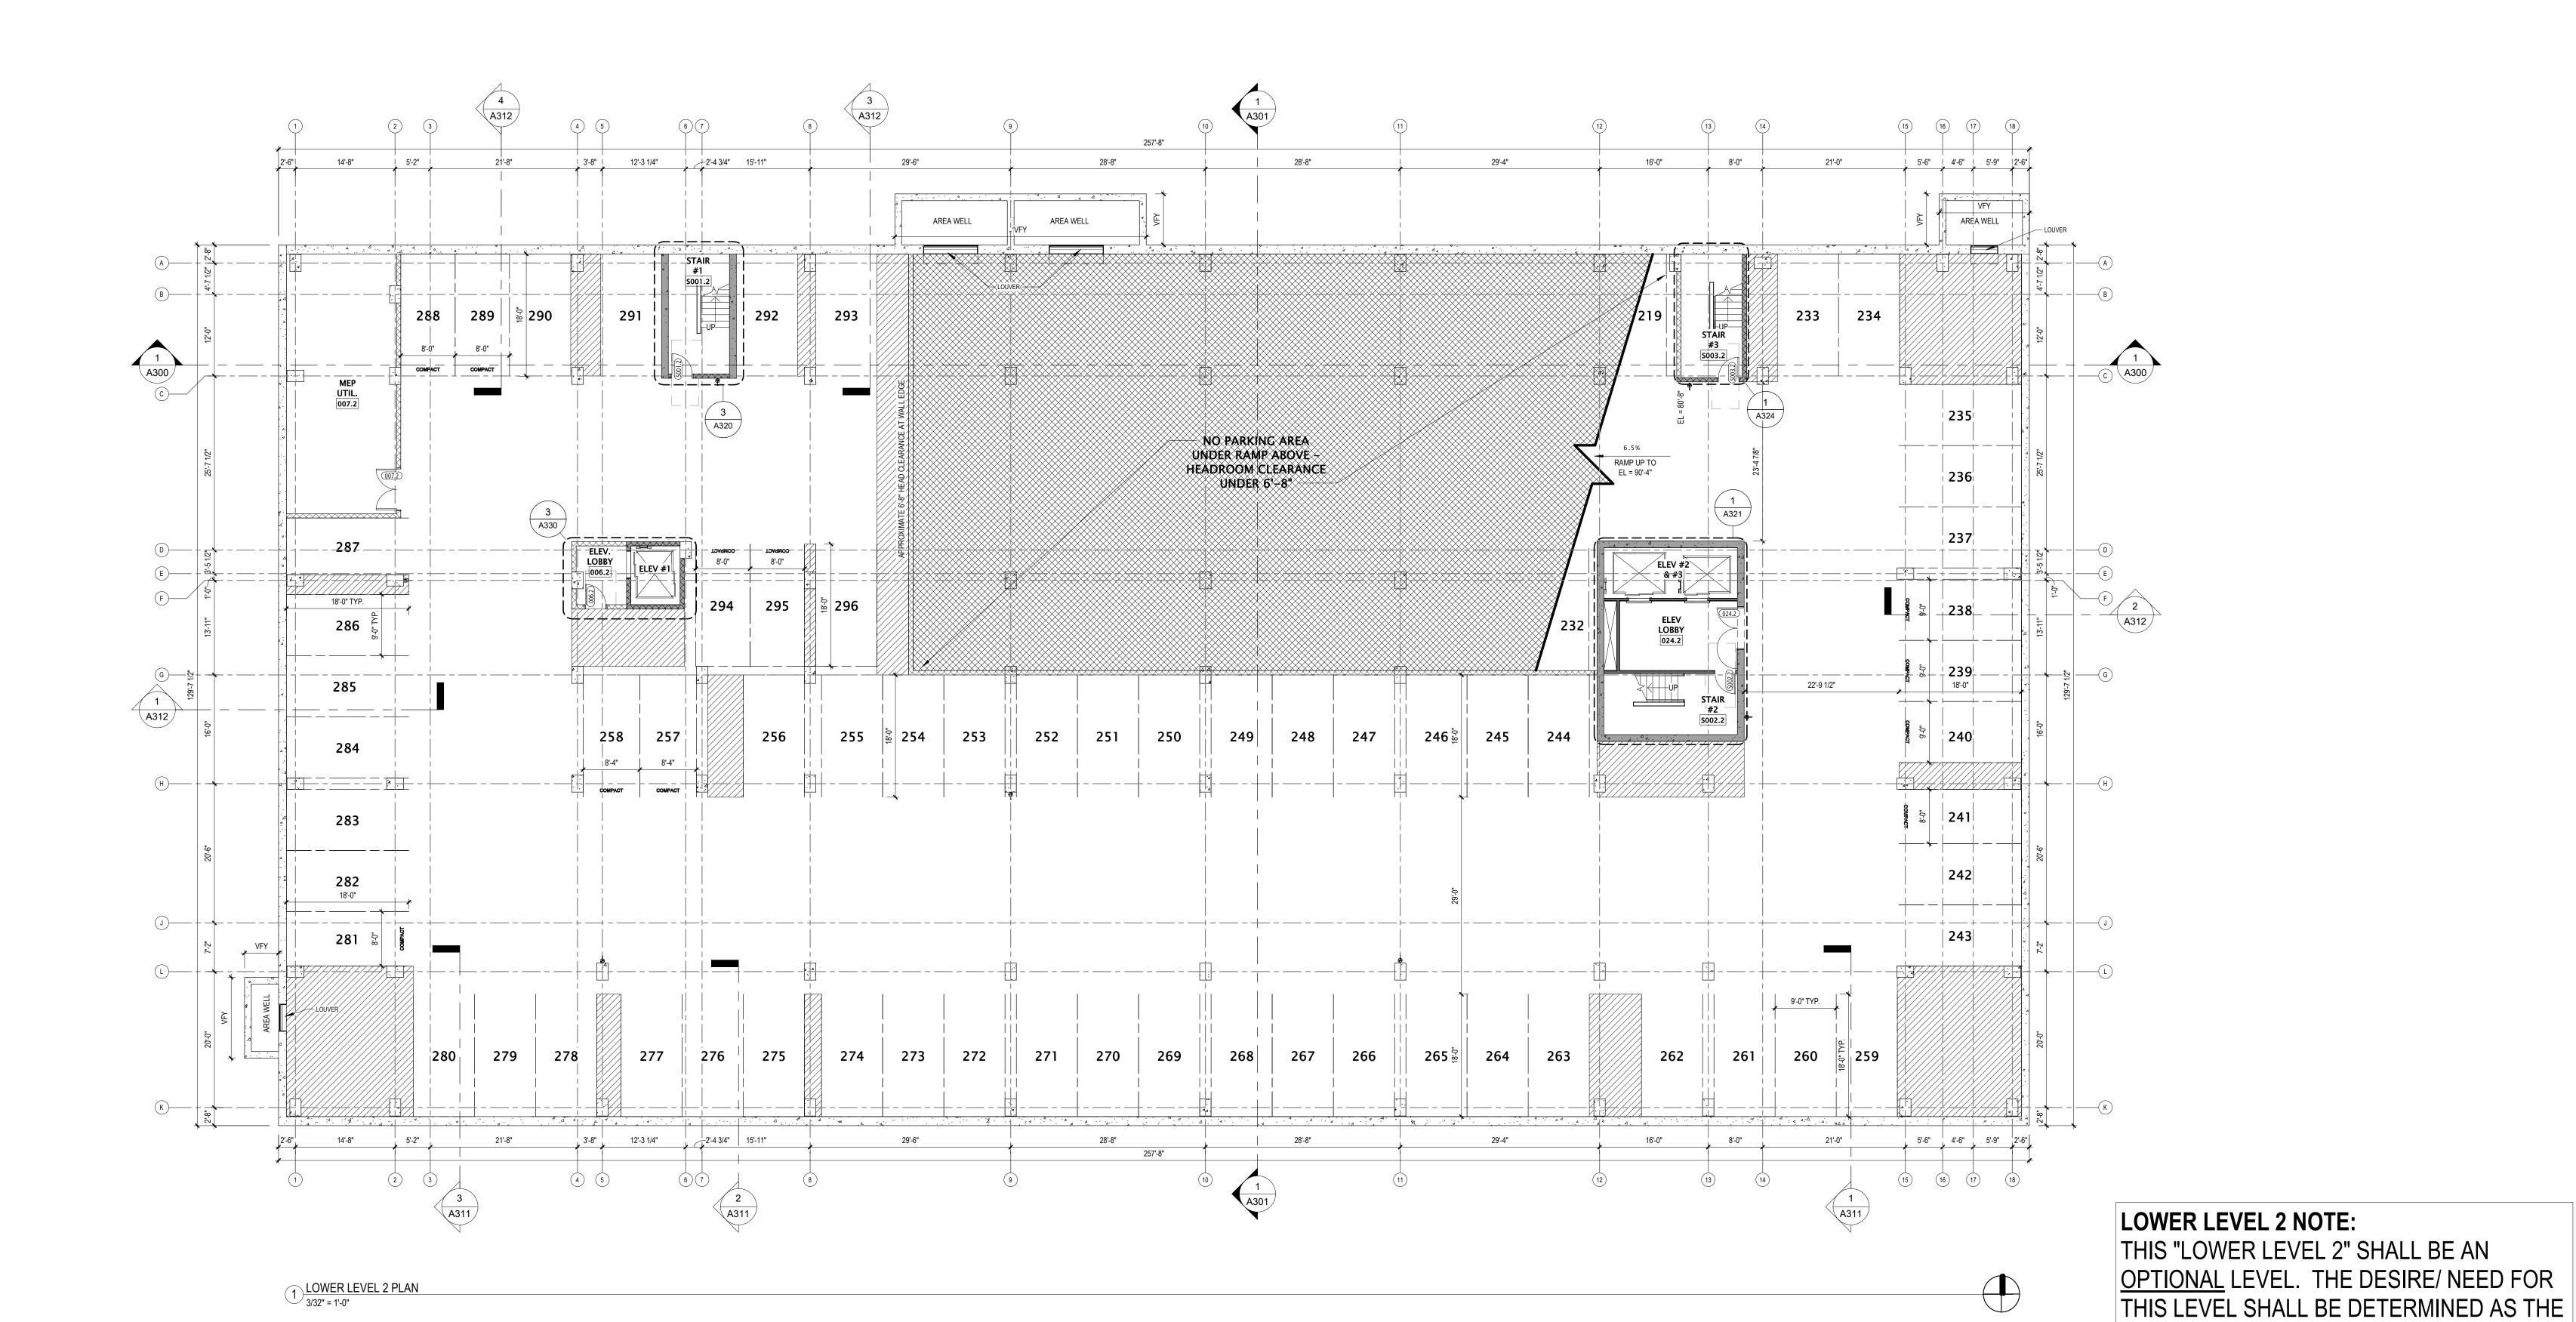

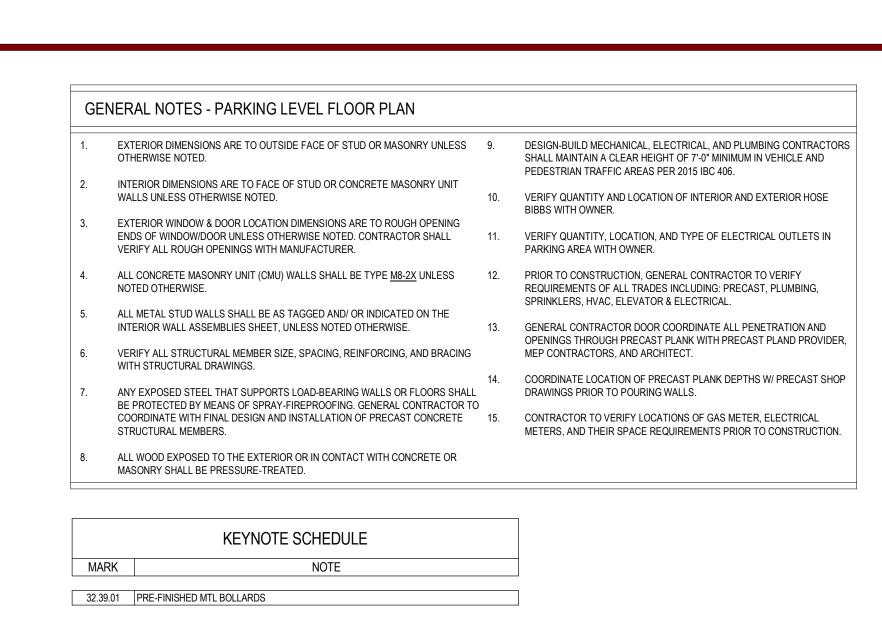

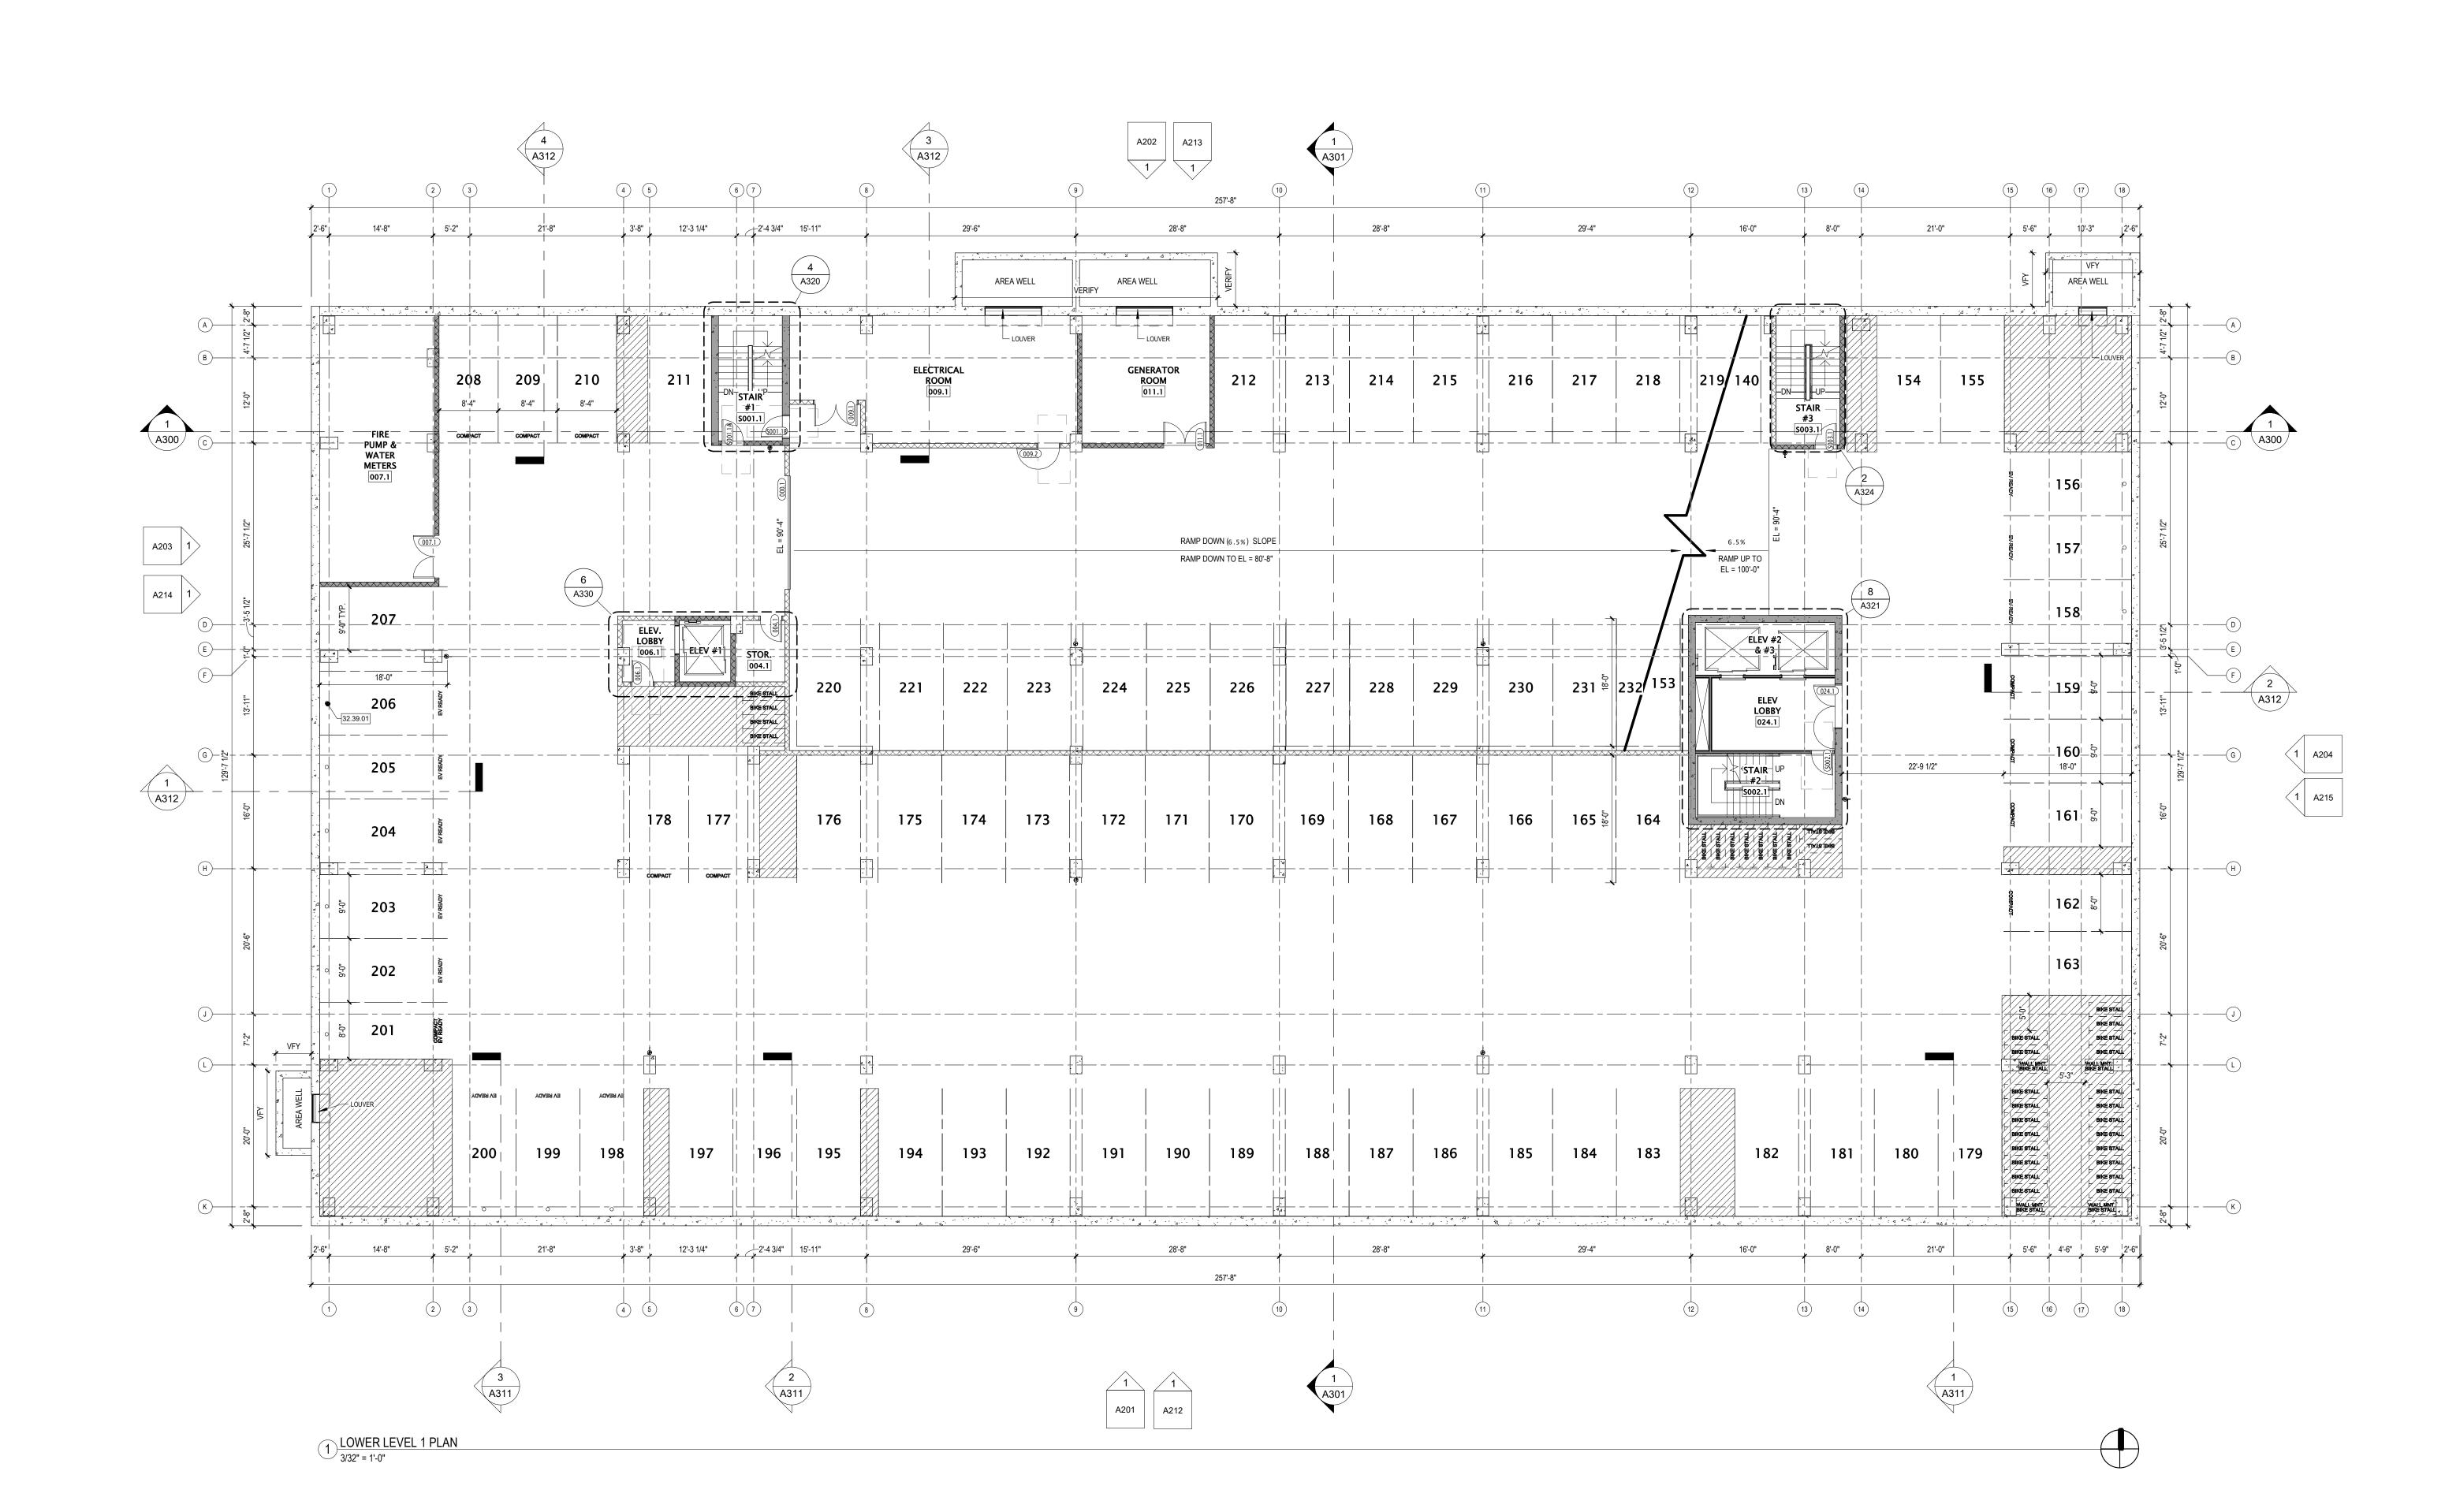



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REVISION SCHEDULE

Mark Description Date

HEET TITLE

LOWER LEVEL 1 PLAN

SHEET NUMBER

## GENERAL PLAN NOTES BUILDING DIMENSIONS ARE TO OUTSIDE FACE OF STUD 5. OR MASONRY WALLS UNLESS OTHERWISE NOTED. WINDOW & DOOR LOCATION DIMENSIONS ARE TO CENTERLINE OF WINDOW/DOOR UNLESS OTHERWISE NOTED. CONTRACTOR SHALL VERIFY ALL ROUGH OPENINGS WITH MANUFACTURER.

VERIFY ALL STRUCTURAL MEMBER SIZE, SPACING, REINFORCING, AND BRACING WITH STRUCTURAL ALL WOOD EXPOSED TO THE EXTERIOR OR IN CONTACT 8. WITH CONCRETE OR MASONRY SHALL BE PRESSURE

VERIFY ALL WINDOW, DOOR, TUB, SHOWER, FIREPLACE, 9. APPLIANCE, EQUIPMENT, ETC. ROUGH OPENINGS & CLEARANCE REQUIREMENTS WITH MANUFACTURER. PROVIDE SOUND BATT INSULATION AT ALL WALLS

SURROUNDING BATHROOMS, LAUNDRY ROOMS/

PLUMBING WALLS.

**BICYCLE PARKING SCHEDULE** 

Level

LOWER LEVEL

FIRST FLOOR

SECOND FLOOR SECOND FLOOR TOTAL BICYCLE PARKING: 28

CLOSETS, MECHANICAL ROOMS/ CLOSETS, AND OTHER

PROVIDE BLOCKING AT ALL GRAB BAR LOCATIONS -INCLUDING LOCATIONS OF FUTURE GRAB BARS & SEATS IN BATHROOMS DESIGNATED AS ACCESSIBLE.

PROVIDE FIREBLOCKING PER 2015 IBC 718.2.1 - TYPICAL THROUGHOUT ENTIRE BUILDING. FIELD VERIFY ALL CABINETRY LAYOUTS AND COORDINATE WITH THE DIMENSIONAL REQUIREMENTS OF ALL

APPLIANCES & FIXTURES. PROVIDE FINISHED END PANELS AT ALL EXPOSED CABINETRY ENDS. CAULK AT PERIMETER OF ALL TUB & SHOWER ENCLOSURES. CAULK AT PERIMETER OF ALL

COUNTERTOP BACKSPLASHES & SIDESPLASHES. INSTALL FIXTURES, ACCESSORIES, ETC. ACCORDING TO THE MOUNTING HEIGHT SCHEDULE. ALL WINDOWS & PATIO DOORS SHALL BE AS SPECIFIED IN

THE SCOPE SPECIFICATIONS AND AS INDICATED ON THE EXTERIOR MATERIAL AND WINDOW SCHEDULES.

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ARCHITECTS

JLA PROJECT NUMBER:

702 EAST

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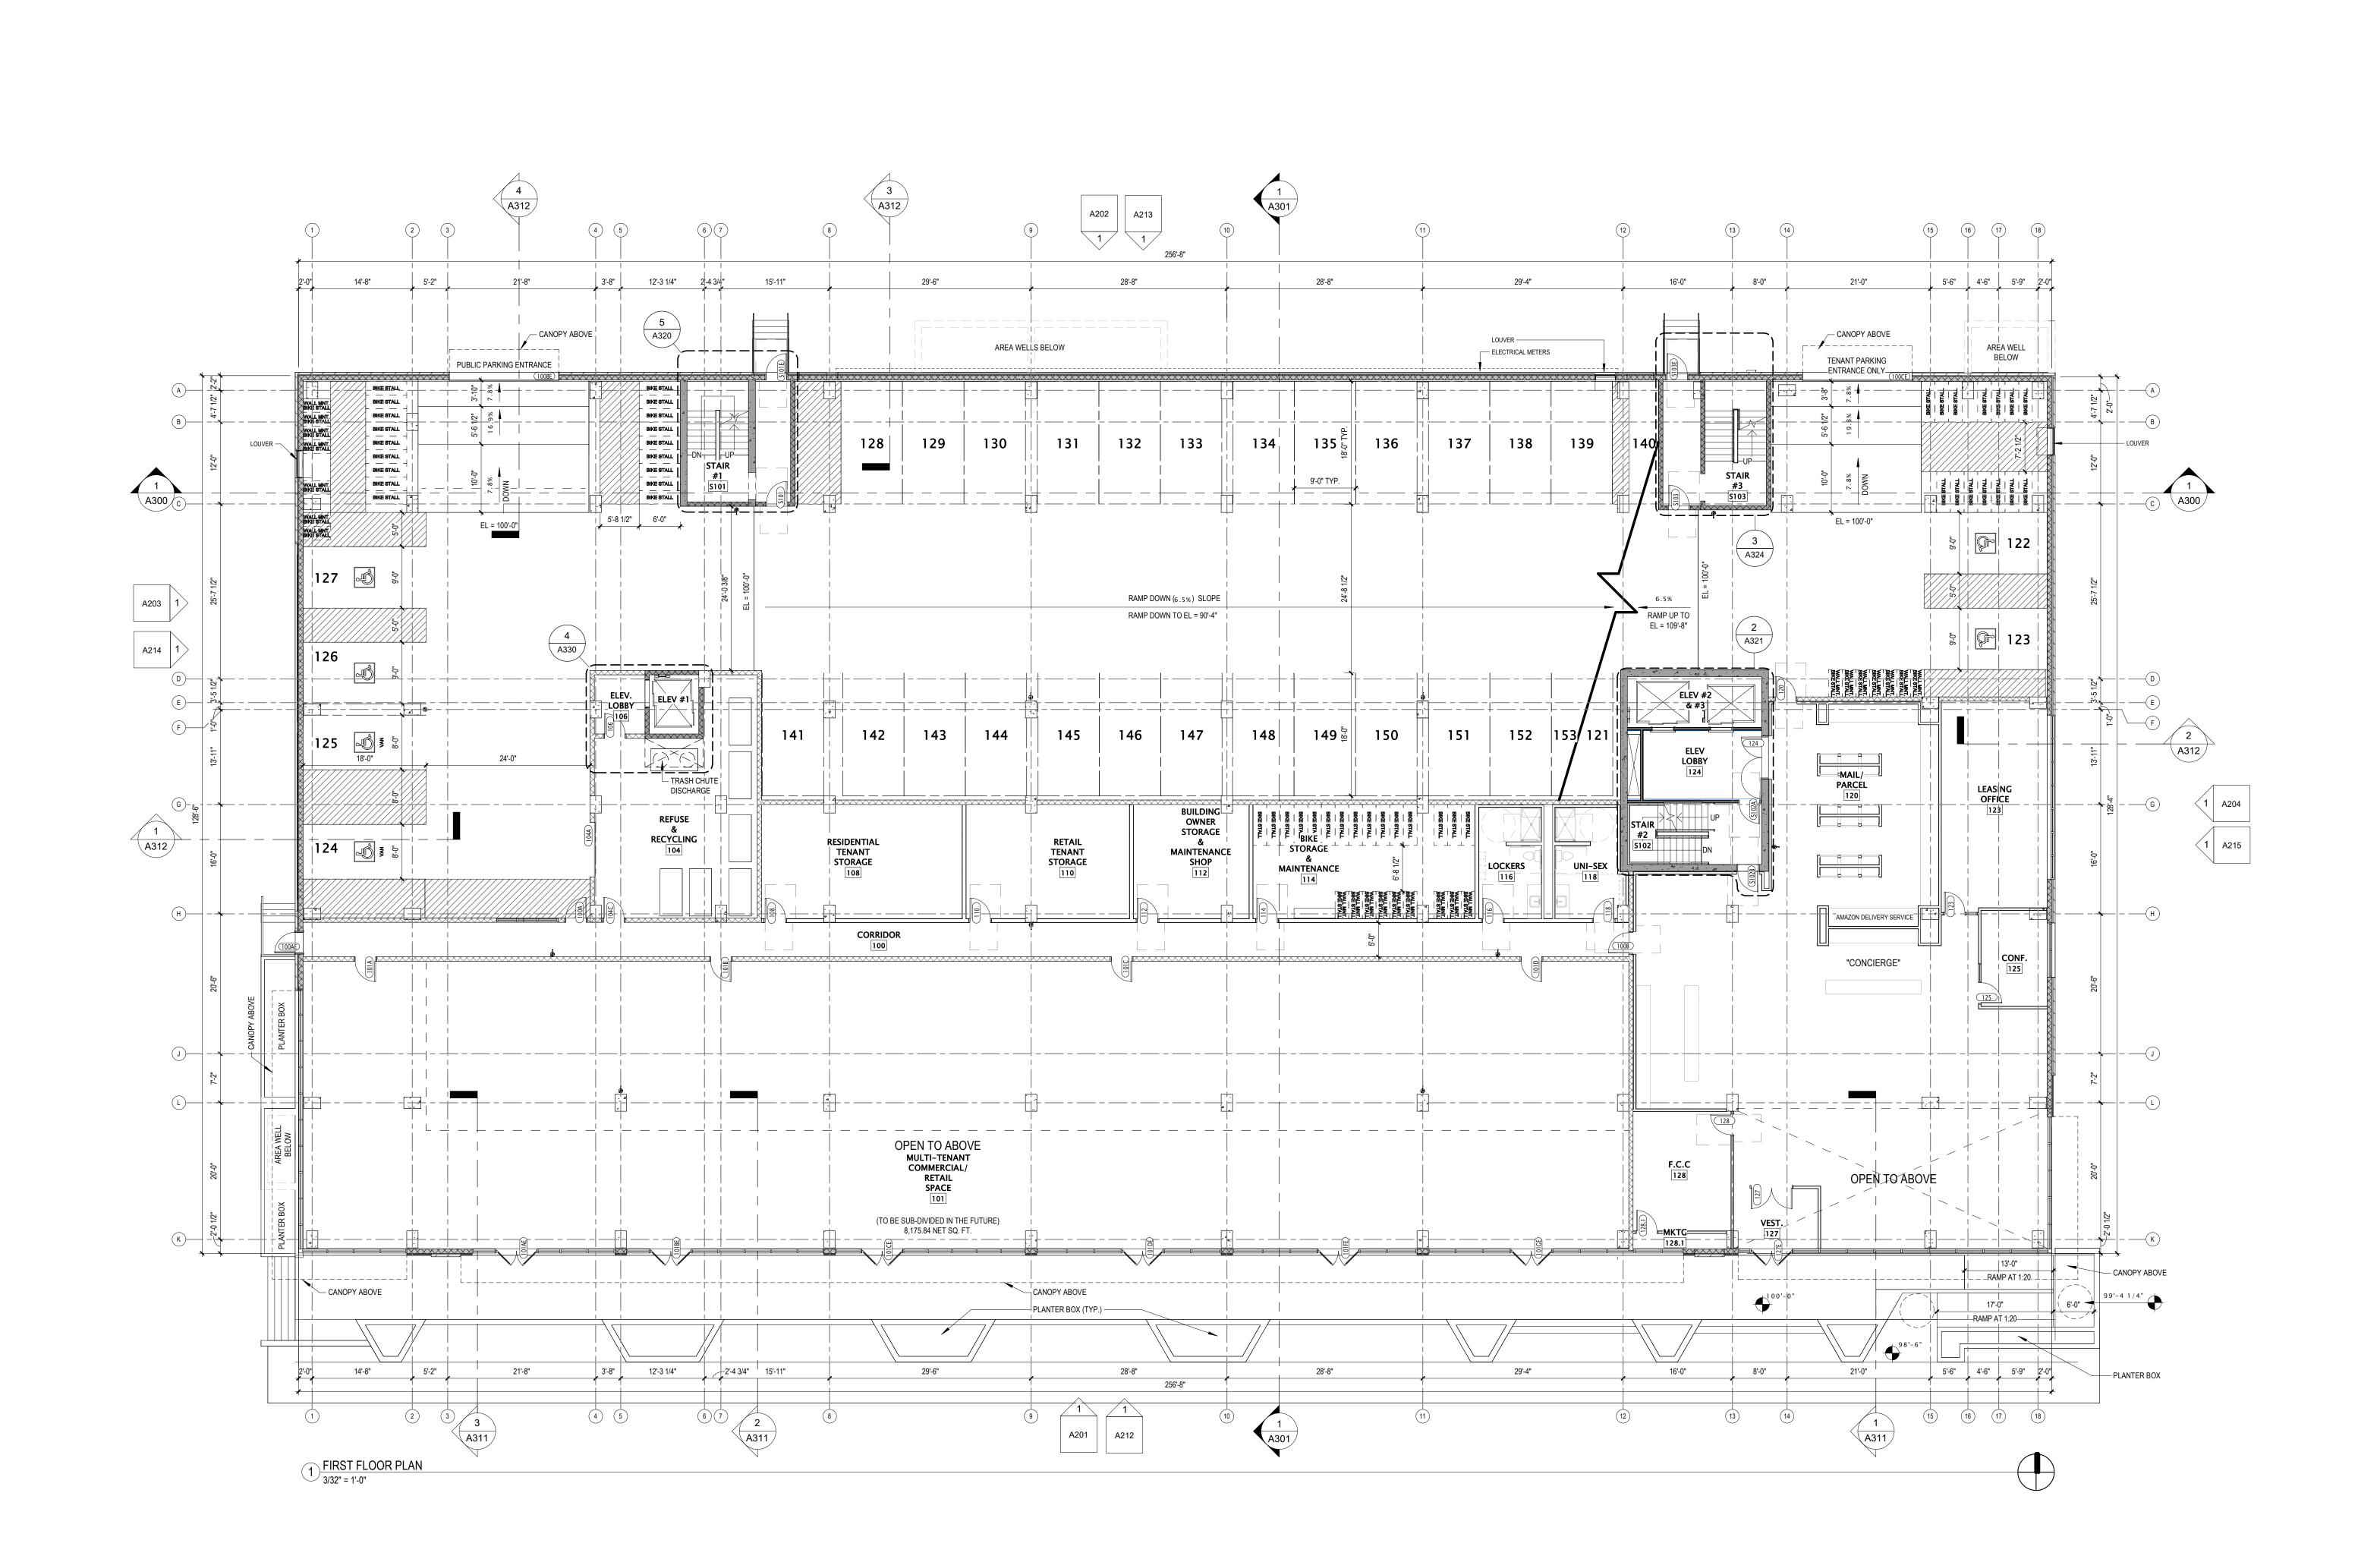
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FIRST FLOOR PLAN




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KEYNOTE SCHEDULE

32.39.01 PRE-FINISHED MTL BOLLARDS

NOTE



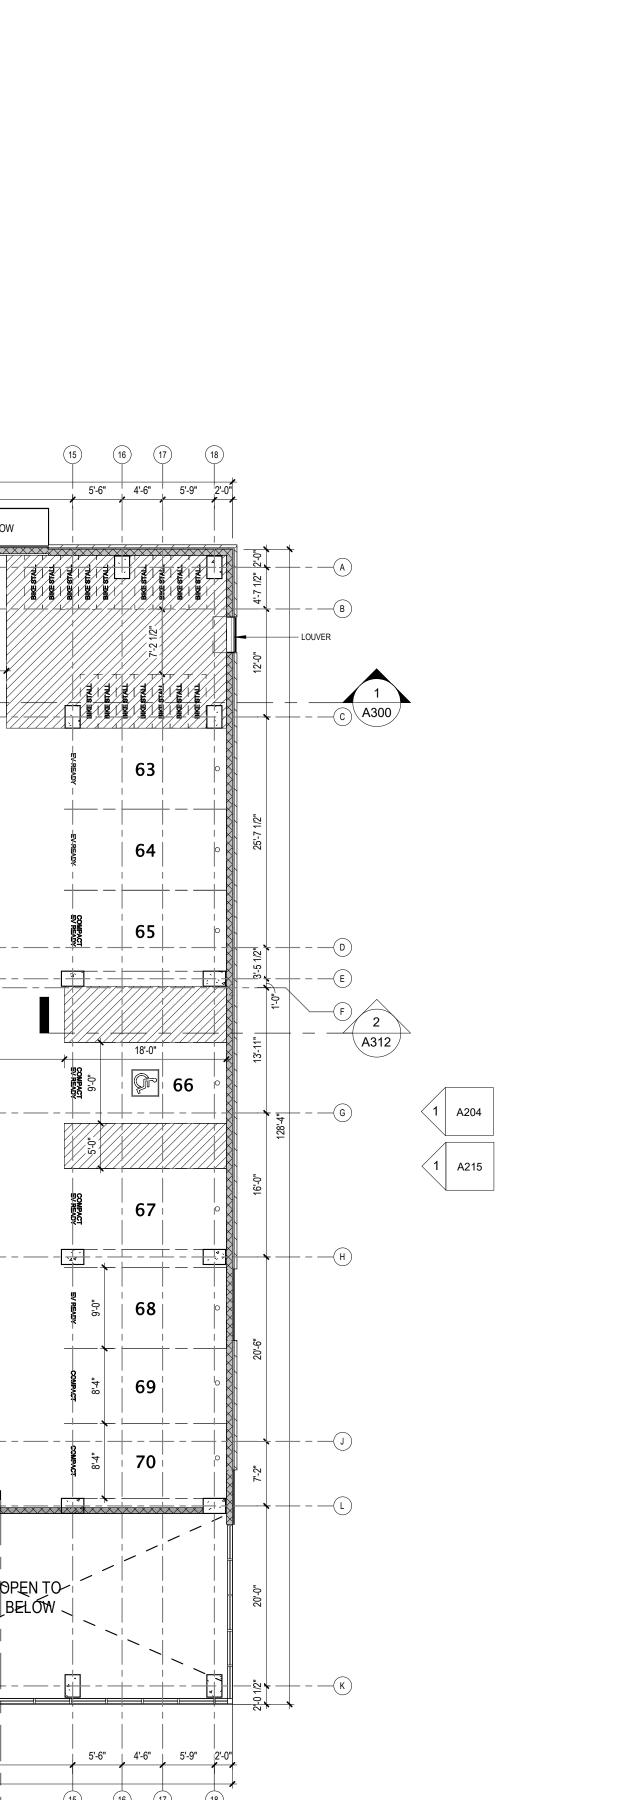

JLA PROJECT NUMBER:

702 EAST WASHINGTON AVENUE MIXED-USE DEVELOPMENT

> DESIGN DEVELOPMENT **DOCUMENTS**


PROGRESS DOCUMENTS

and should not be used for final bidding or

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PARKING 1.5

A101.5

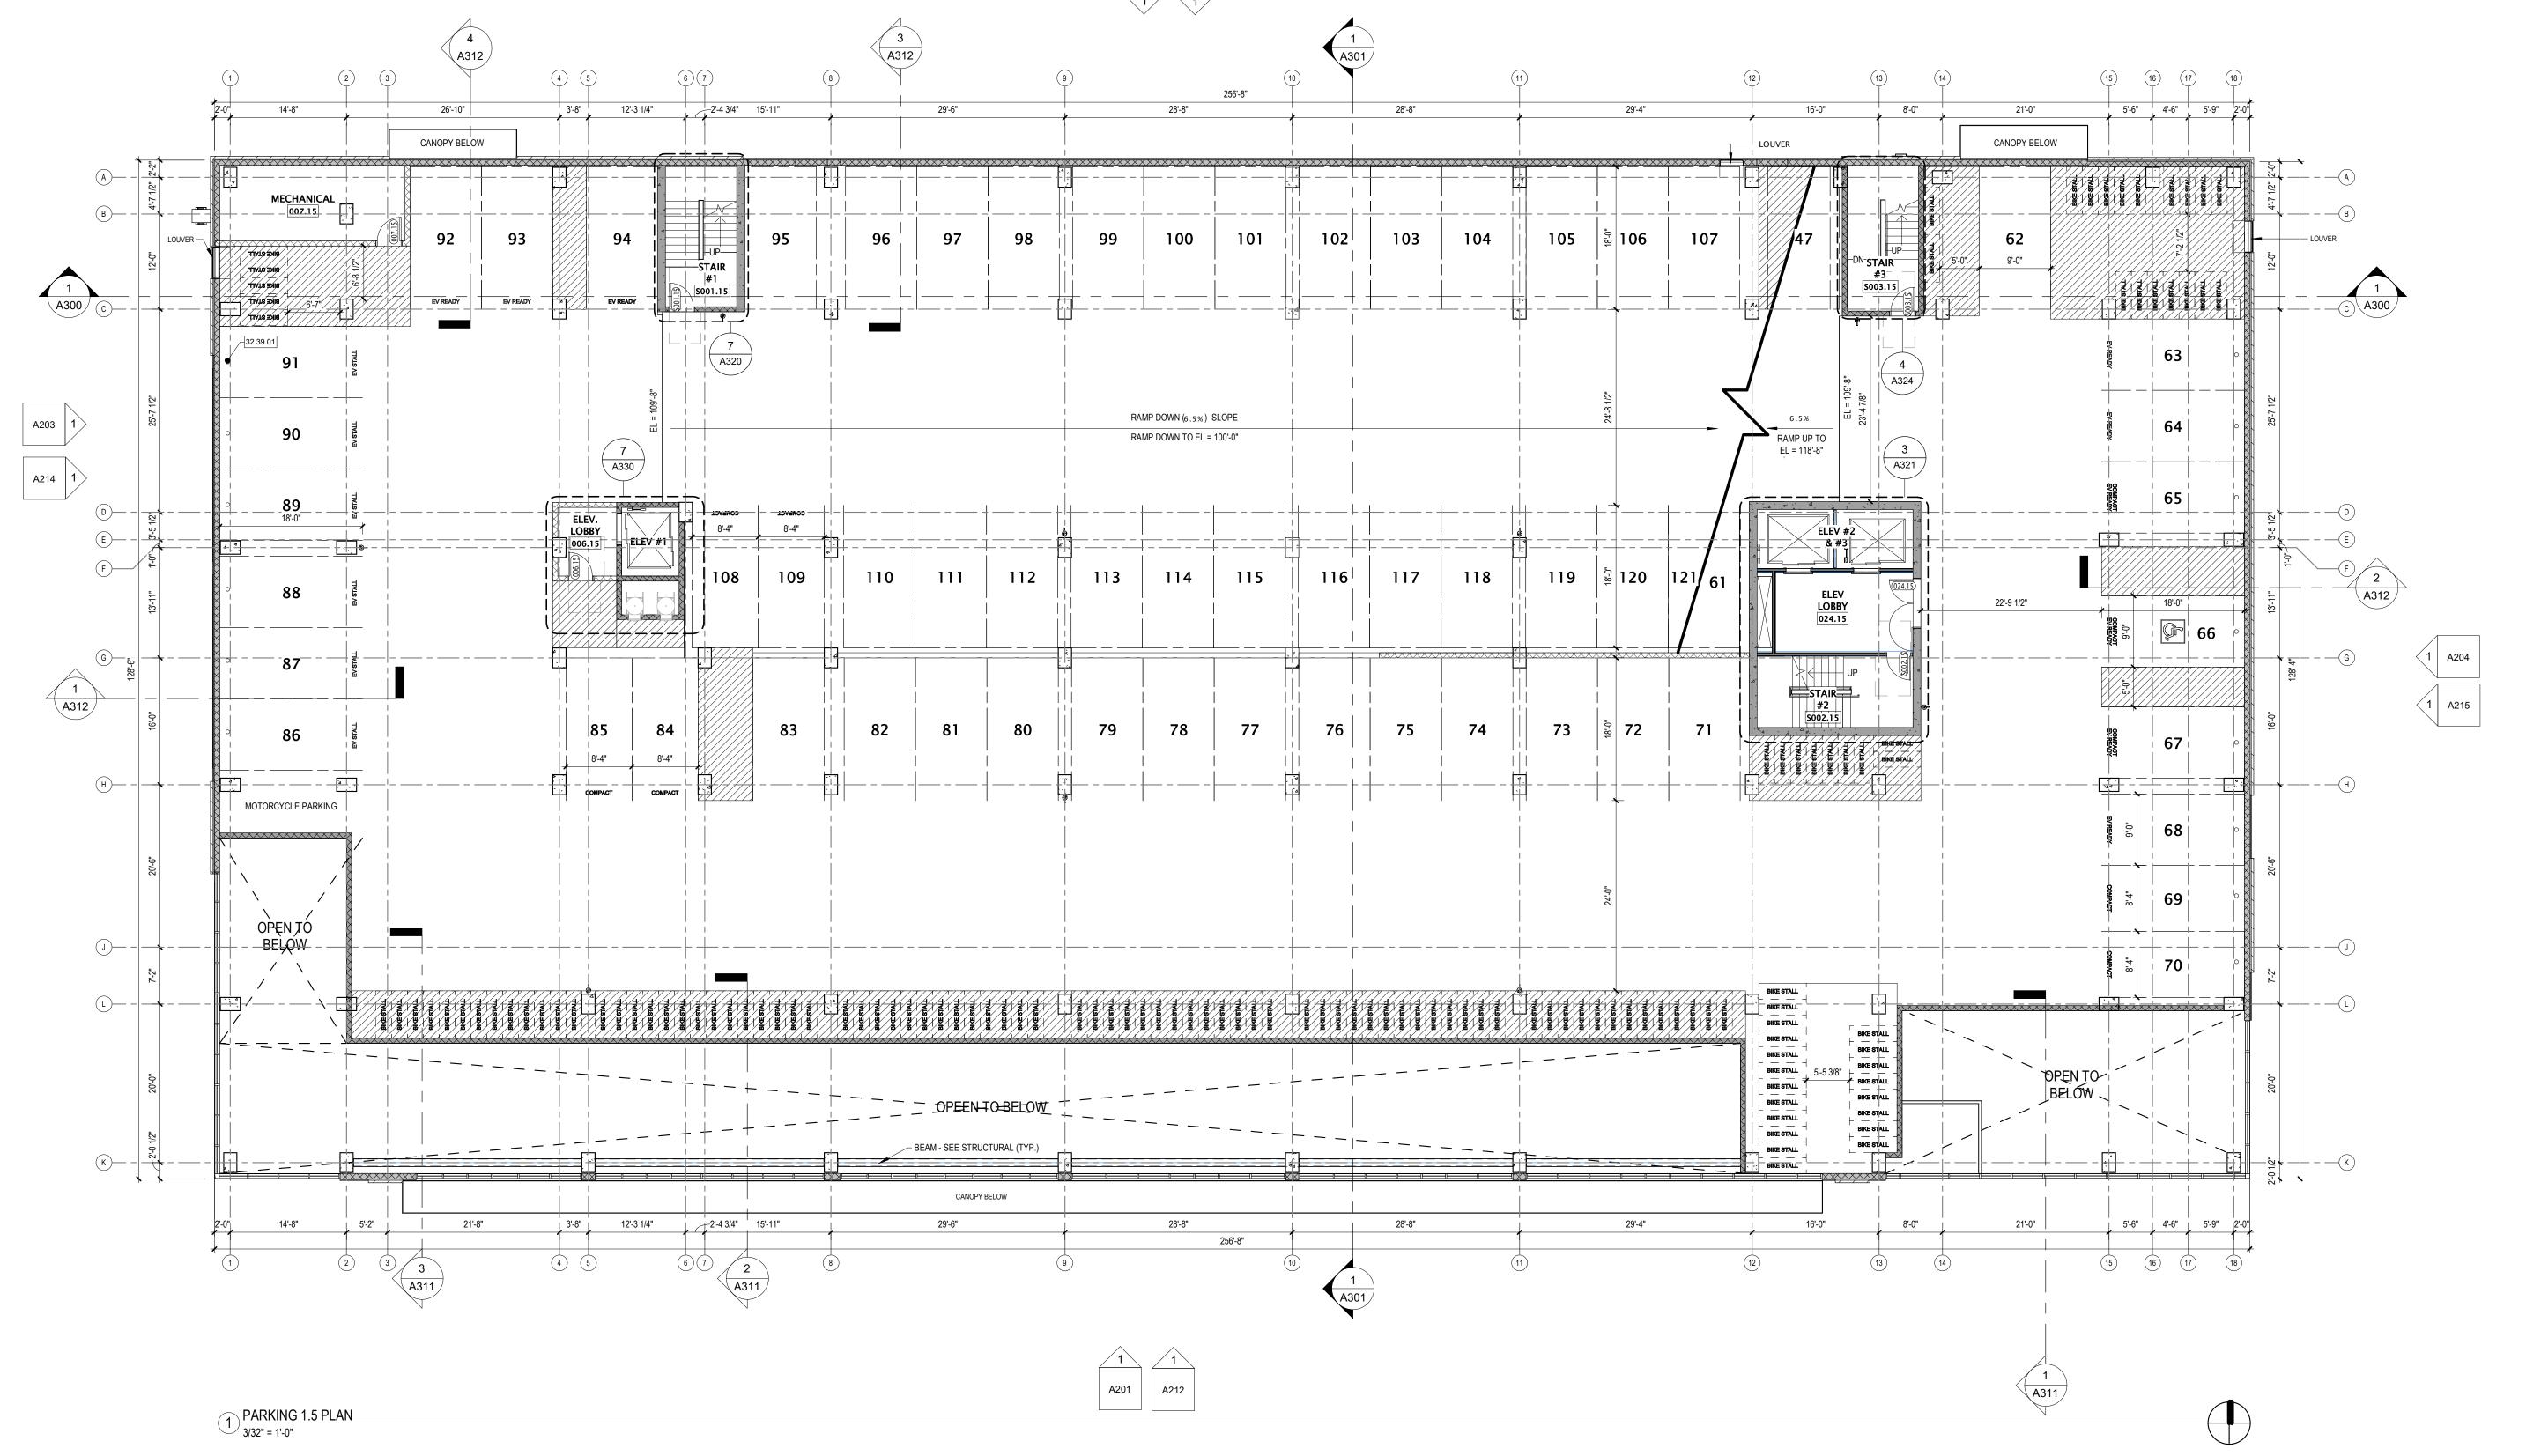

#### GENERAL PLAN NOTES BUILDING DIMENSIONS ARE TO OUTSIDE FACE OF STUD 5. OR MASONRY WALLS UNLESS OTHERWISE NOTED. WINDOW & DOOR LOCATION DIMENSIONS ARE TO CENTERLINE OF WINDOW/DOOR UNLESS OTHERWISE 6. NOTED. CONTRACTOR SHALL VERIFY ALL ROUGH OPENINGS WITH MANUFACTURER. VERIFY ALL STRUCTURAL MEMBER SIZE, SPACING, REINFORCING, AND BRACING WITH STRUCTURAL DRAWINGS. ALL WOOD EXPOSED TO THE EXTERIOR OR IN CONTACT 8. WITH CONCRETE OR MASONRY SHALL BE PRESSURE APPLIANCE, EQUIPMENT, ETC. ROUGH OPENINGS & CLEARANCE REQUIREMENTS WITH MANUFACTURER.

PROVIDE BLOCKING AT ALL GRAB BAR LOCATIONS -INCLUDING LOCATIONS OF FUTURE GRAB BARS & SEATS IN BATHROOMS DESIGNATED AS ACCESSIBLE.

PROVIDE FIREBLOCKING PER 2015 IBC 718.2.1 - TYPICAL THROUGHOUT ENTIRE BUILDING.

FIELD VERIFY ALL CABINETRY LAYOUTS AND COORDINATE WITH THE DIMENSIONAL REQUIREMENTS OF ALL

APPLIANCES & FIXTURES. PROVIDE FINISHED END PANELS

CAULK AT PERIMETER OF ALL TUB & SHOWER ENCLOSURES. CAULK AT PERIMETER OF ALL COUNTERTOP BACKSPLASHES & SIDESPLASHES.

AT ALL EXPOSED CABINETRY ENDS.

VERIFY ALL WINDOW, DOOR, TUB, SHOWER, FIREPLACE, 9. INSTALL FIXTURES, ACCESSORIES, ETC. ACCORDING TO THE MOUNTING HEIGHT SCHEDULE. ALL WINDOWS & PATIO DOORS SHALL BE AS SPECIFIED IN

THE SCOPE SPECIFICATIONS AND AS INDICATED ON THE EXTERIOR MATERIAL AND WINDOW SCHEDULES.


KEYNOTE SCHEDULE

PROVIDE SOUND BATT INSULATION AT ALL WALLS SURROUNDING BATHROOMS, LAUNDRY ROOMS/

CLOSETS, MECHANICAL ROOMS/ CLOSETS, AND OTHER

PLUMBING WALLS.

NOTE 32.39.01 PRE-FINISHED MTL BOLLARDS

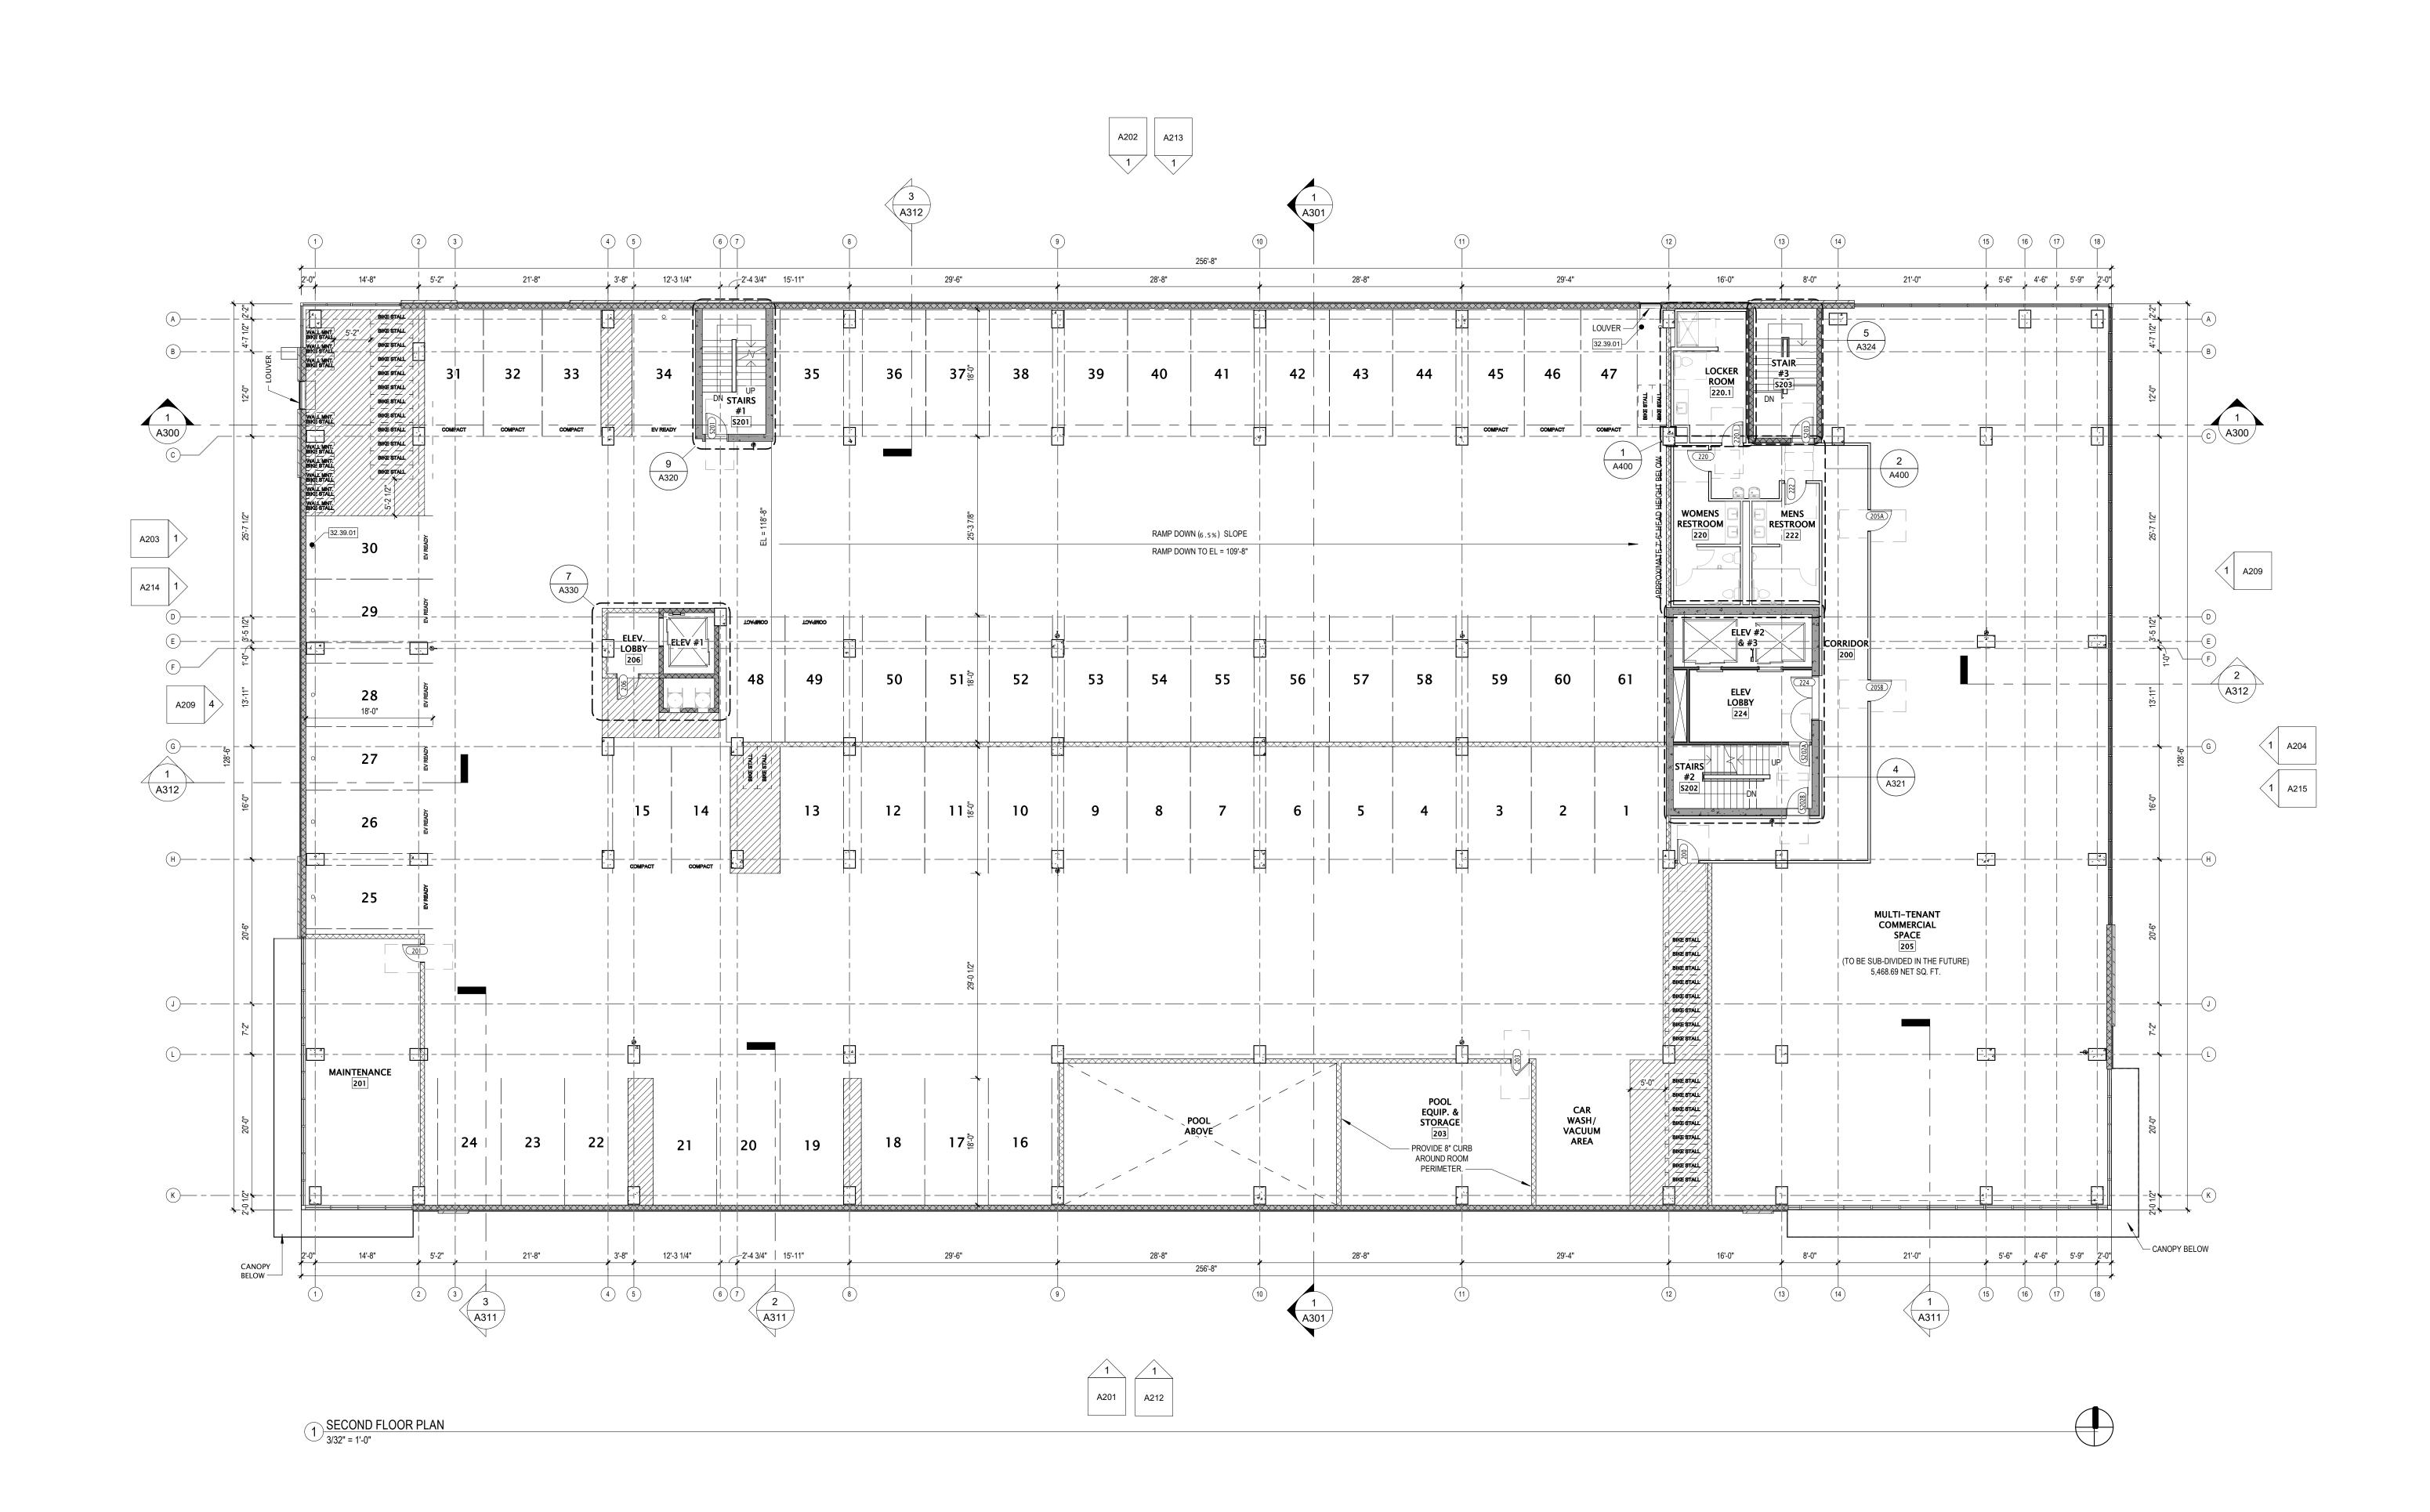

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SECOND FLOOR PLAN

Sheet Number

BUILDING DIMENSIONS ARE TO OUTSIDE FACE OF STUD 5. OR MASONRY WALLS UNLESS OTHERWISE NOTED.

OPENINGS WITH MANUFACTURER.

WINDOW & DOOR LOCATION DIMENSIONS ARE TO CENTERLINE OF WINDOW/DOOR UNLESS OTHERWISE

NOTED. CONTRACTOR SHALL VERIFY ALL ROUGH

- VERIFY ALL STRUCTURAL MEMBER SIZE, SPACING, REINFORCING, AND BRACING WITH STRUCTURAL DRAWINGS.
- ALL WOOD EXPOSED TO THE EXTERIOR OR IN CONTACT 8. WITH CONCRETE OR MASONRY SHALL BE PRESSURE
- VERIFY ALL WINDOW, DOOR, TUB, SHOWER, FIREPLACE, 9. APPLIANCE, EQUIPMENT, ETC. ROUGH OPENINGS & CLEARANCE REQUIREMENTS WITH MANUFACTURER.
- PROVIDE SOUND BATT INSULATION AT ALL WALLS SURROUNDING BATHROOMS, LAUNDRY ROOMS/ CLOSETS, MECHANICAL ROOMS/ CLOSETS, AND OTHER PLUMBING WALLS.
- PROVIDE BLOCKING AT ALL GRAB BAR LOCATIONS -INCLUDING LOCATIONS OF FUTURE GRAB BARS & SEATS IN BATHROOMS DESIGNATED AS ACCESSIBLE.
- PROVIDE FIREBLOCKING PER 2015 IBC 718.2.1 TYPICAL THROUGHOUT ENTIRE BUILDING.
- FIELD VERIFY ALL CABINETRY LAYOUTS AND COORDINATE WITH THE DIMENSIONAL REQUIREMENTS OF ALL APPLIANCES & FIXTURES. PROVIDE FINISHED END PANELS AT ALL EXPOSED CABINETRY ENDS.
- CAULK AT PERIMETER OF ALL TUB & SHOWER ENCLOSURES. CAULK AT PERIMETER OF ALL COUNTERTOP BACKSPLASHES & SIDESPLASHES. INSTALL FIXTURES, ACCESSORIES, ETC. ACCORDING TO
- THE MOUNTING HEIGHT SCHEDULE. ALL WINDOWS & PATIO DOORS SHALL BE AS SPECIFIED IN THE SCOPE SPECIFICATIONS AND AS INDICATED ON THE EXTERIOR MATERIAL AND WINDOW SCHEDULES.

#### VEGETATIVE ROOF LEGEND

REQUIREMENT: 50% OF TOTAL ROOF AREA TO BE A VEGETATIVE

3RD LEVEL ROOF/TERRACE AREA 14TH LEVEL ROOF/TERRACE AREA	= =	11,632 SF 2,008 SF
15TH LEVEL ROOF/TERRACE AREA TOTAL COMBINED ROOF AREA	=	22,366 SF 36,006 SF
3RD LEVELVEGETATIVE ROOF/TERRACE 15TH LEVEL VEGETATIVE ROOF	=	3,364 15,064 SF
PERCENTAGE OF TOTAL VEGETATIVE ROC	)F =	51.18% TOTAL





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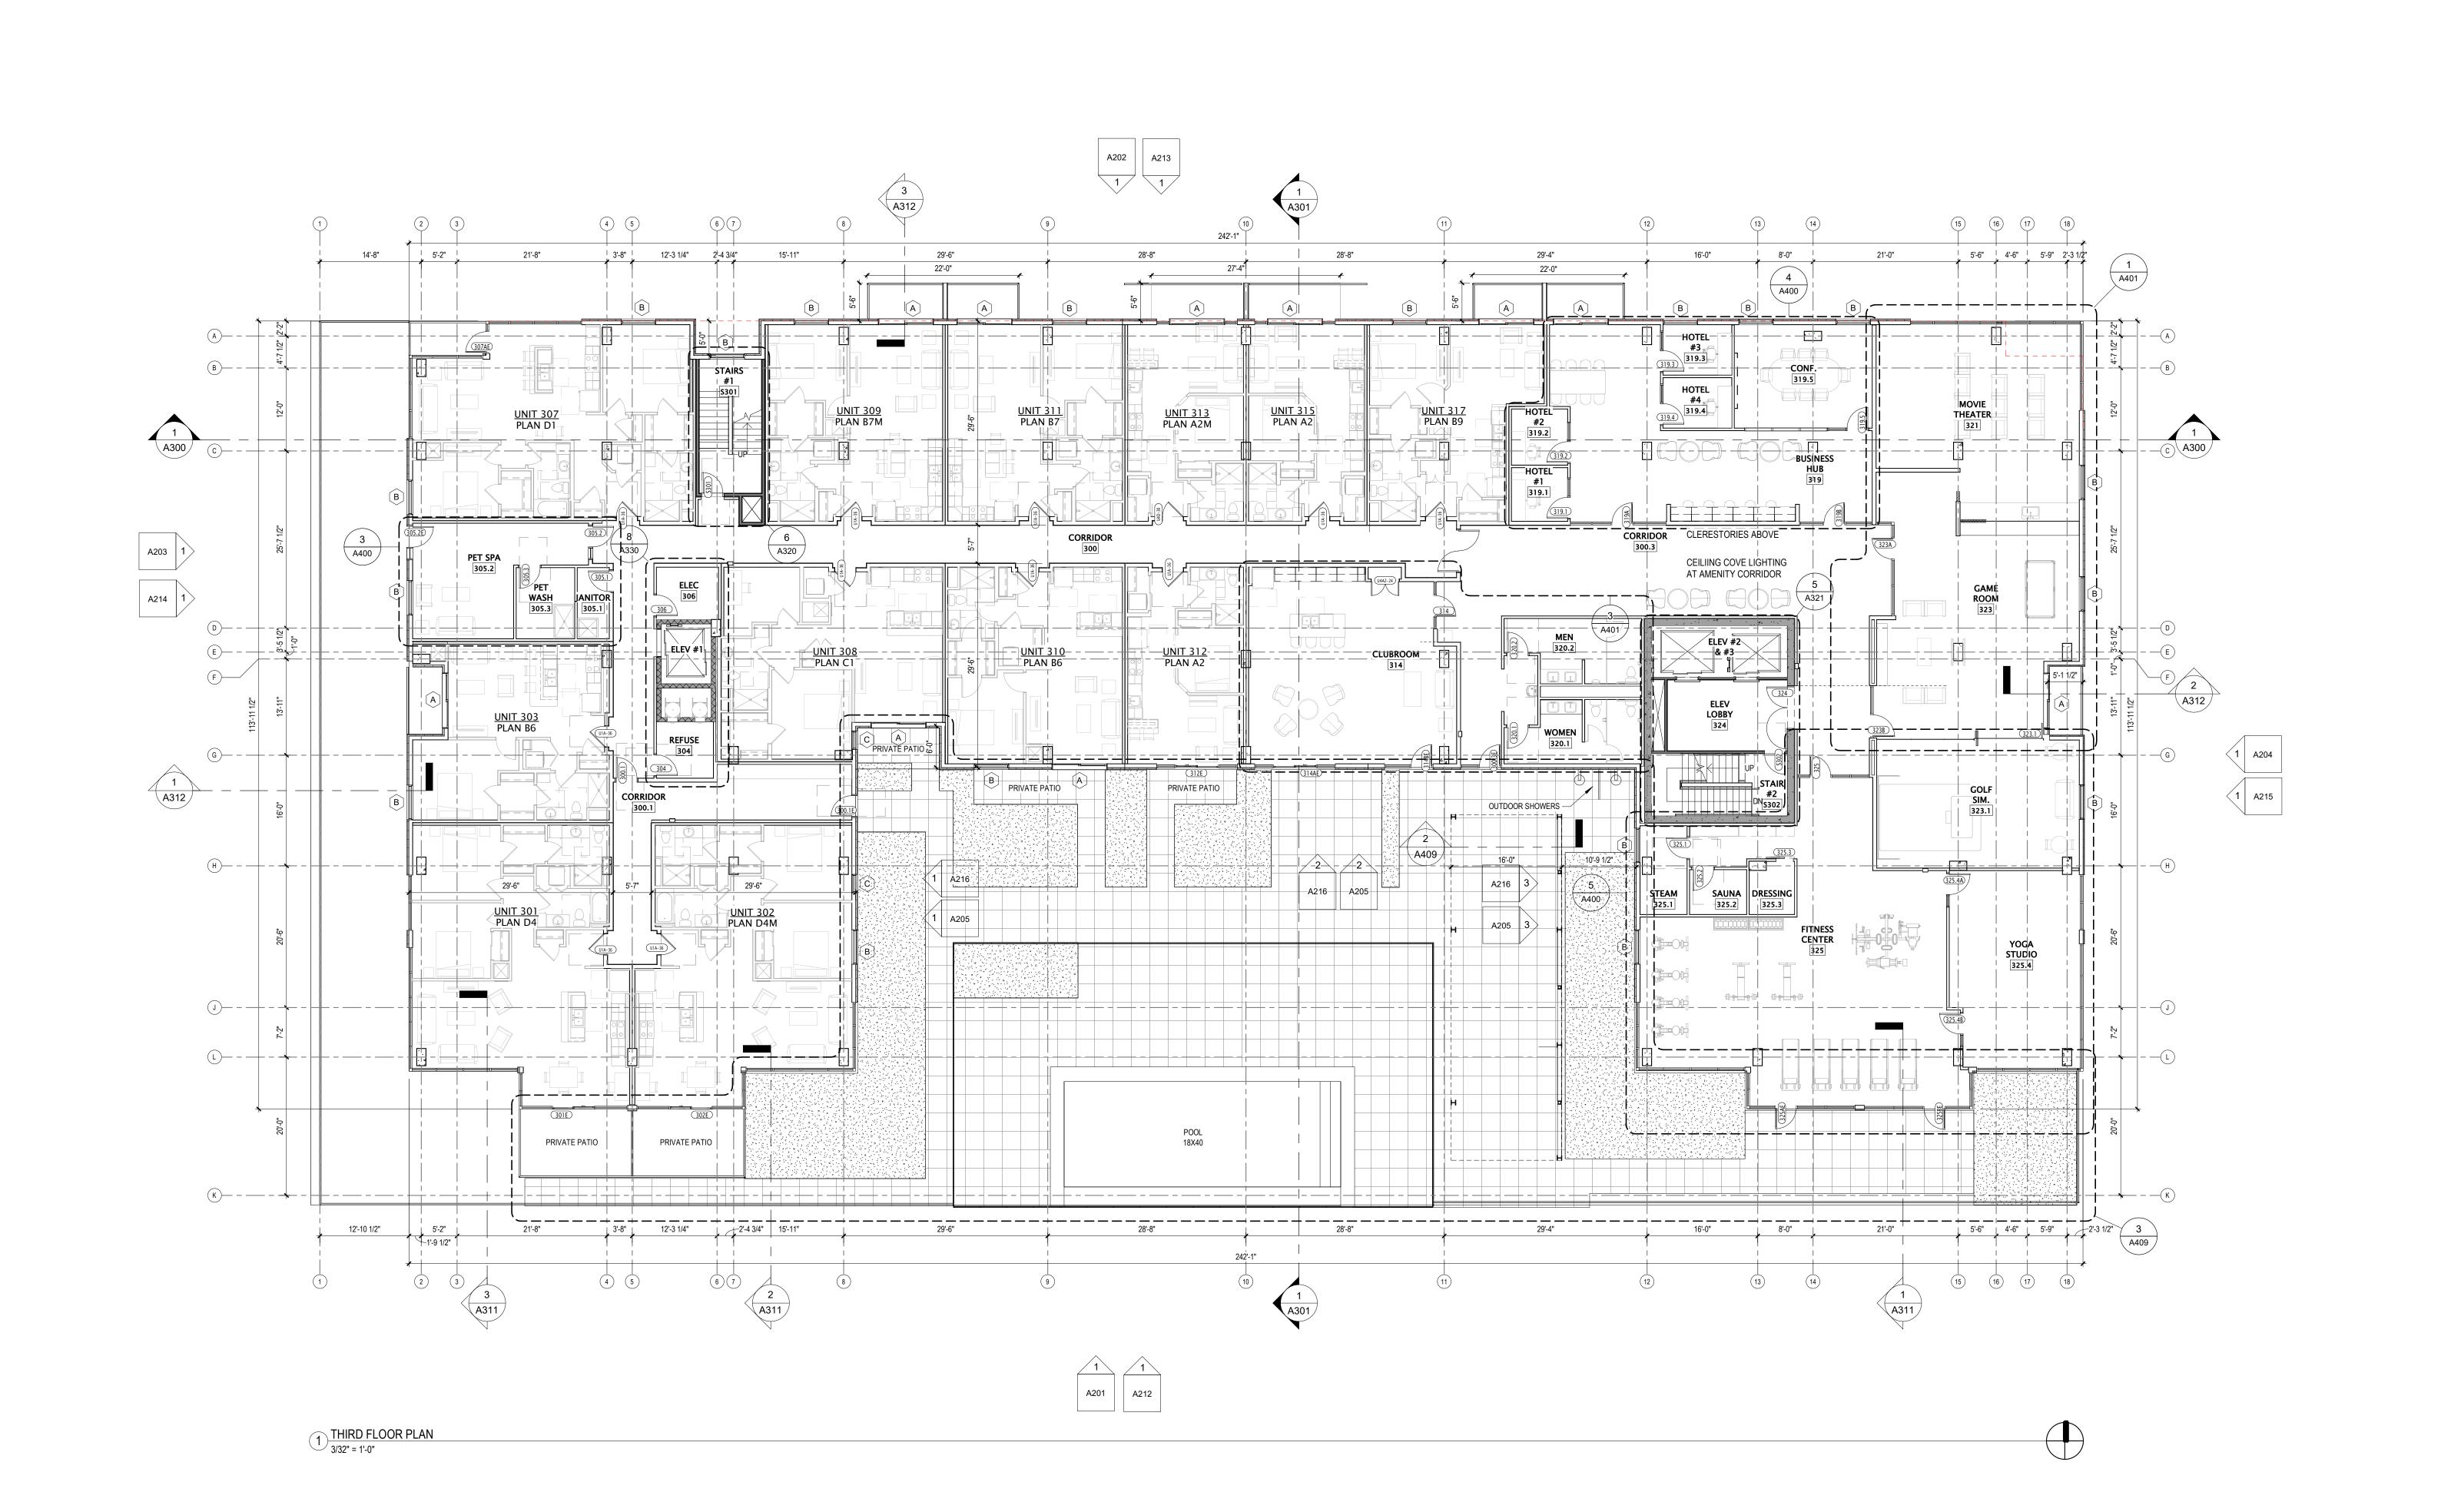
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THIRD FLOOR PLAN



BUILDING DIMENSIONS ARE TO OUTSIDE FACE OF STUD 5.
OR MASONRY WALLS UNLESS OTHERWISE NOTED.

OPENINGS WITH MANUFACTURER.

OR MASONRY WALLS UNLESS OTHERWISE NOTED.

WINDOW & DOOR LOCATION DIMENSIONS ARE TO CENTERLINE OF WINDOW/DOOR UNLESS OTHERWISE

NOTED. CONTRACTOR SHALL VERIFY ALL ROUGH

- 3. VERIFY ALL STRUCTURAL MEMBER SIZE, SPACING, REINFORCING, AND BRACING WITH STRUCTURAL
- 4. ALL WOOD EXPOSED TO THE EXTERIOR OR IN CONTACT 8. WITH CONCRETE OR MASONRY SHALL BE PRESSURE TREATED.
- TREATED.

  VERIFY ALL WINDOW, DOOR, TUB, SHOWER, FIREPLACE, 9.

  APPLIANCE, EQUIPMENT, ETC. ROUGH OPENINGS &
- CLEARANCE REQUIREMENTS WITH MANUFACTURER.

  6. PROVIDE SOUND BATT INSULATION AT ALL WALLS SURROUNDING BATHROOMS, LAUNDRY ROOMS/ CLOSETS, MECHANICAL ROOMS/ CLOSETS, AND OTHER PLUMBING WALLS.
- PROVIDE BLOCKING AT ALL GRAB BAR LOCATIONS INCLUDING LOCATIONS OF FUTURE GRAB BARS & SEATS IN BATHROOMS DESIGNATED AS ACCESSIBLE.
- PROVIDE FIREBLOCKING PER 2015 IBC 718.2.1 TYPICAL THROUGHOUT ENTIRE BUILDING.
  FIELD VERIFY ALL CABINETRY LAYOUTS AND COORDINATE

APPLIANCES & FIXTURES. PROVIDE FINISHED END PANELS

AT ALL EXPOSED CABINETRY ENDS.

CAULK AT PERIMETER OF ALL TUB & SHOWER ENCLOSURES. CAULK AT PERIMETER OF ALL

WITH THE DIMENSIONAL REQUIREMENTS OF ALL

- ENCLOSURES. CAULK AT PERIMETER OF ALL COUNTERTOP BACKSPLASHES & SIDESPLASHES.
- INSTALL FIXTURES, ACCESSORIES, ETC. ACCORDING TO THE MOUNTING HEIGHT SCHEDULE.
   ALL WINDOWS & PATIO DOORS SHALL BE AS SPECIFIED IN THE SCOPE SPECIFICATIONS AND AS INDICATED ON THE EXTERIOR MATERIAL AND WINDOW SCHEDULES.



JLA PROJECT NUMBER:

702 EAST WASHINGTON AVENUE MIXED-USE DEVELOPMENT

DESIGN DEVELOPMENT DOCUMENTS

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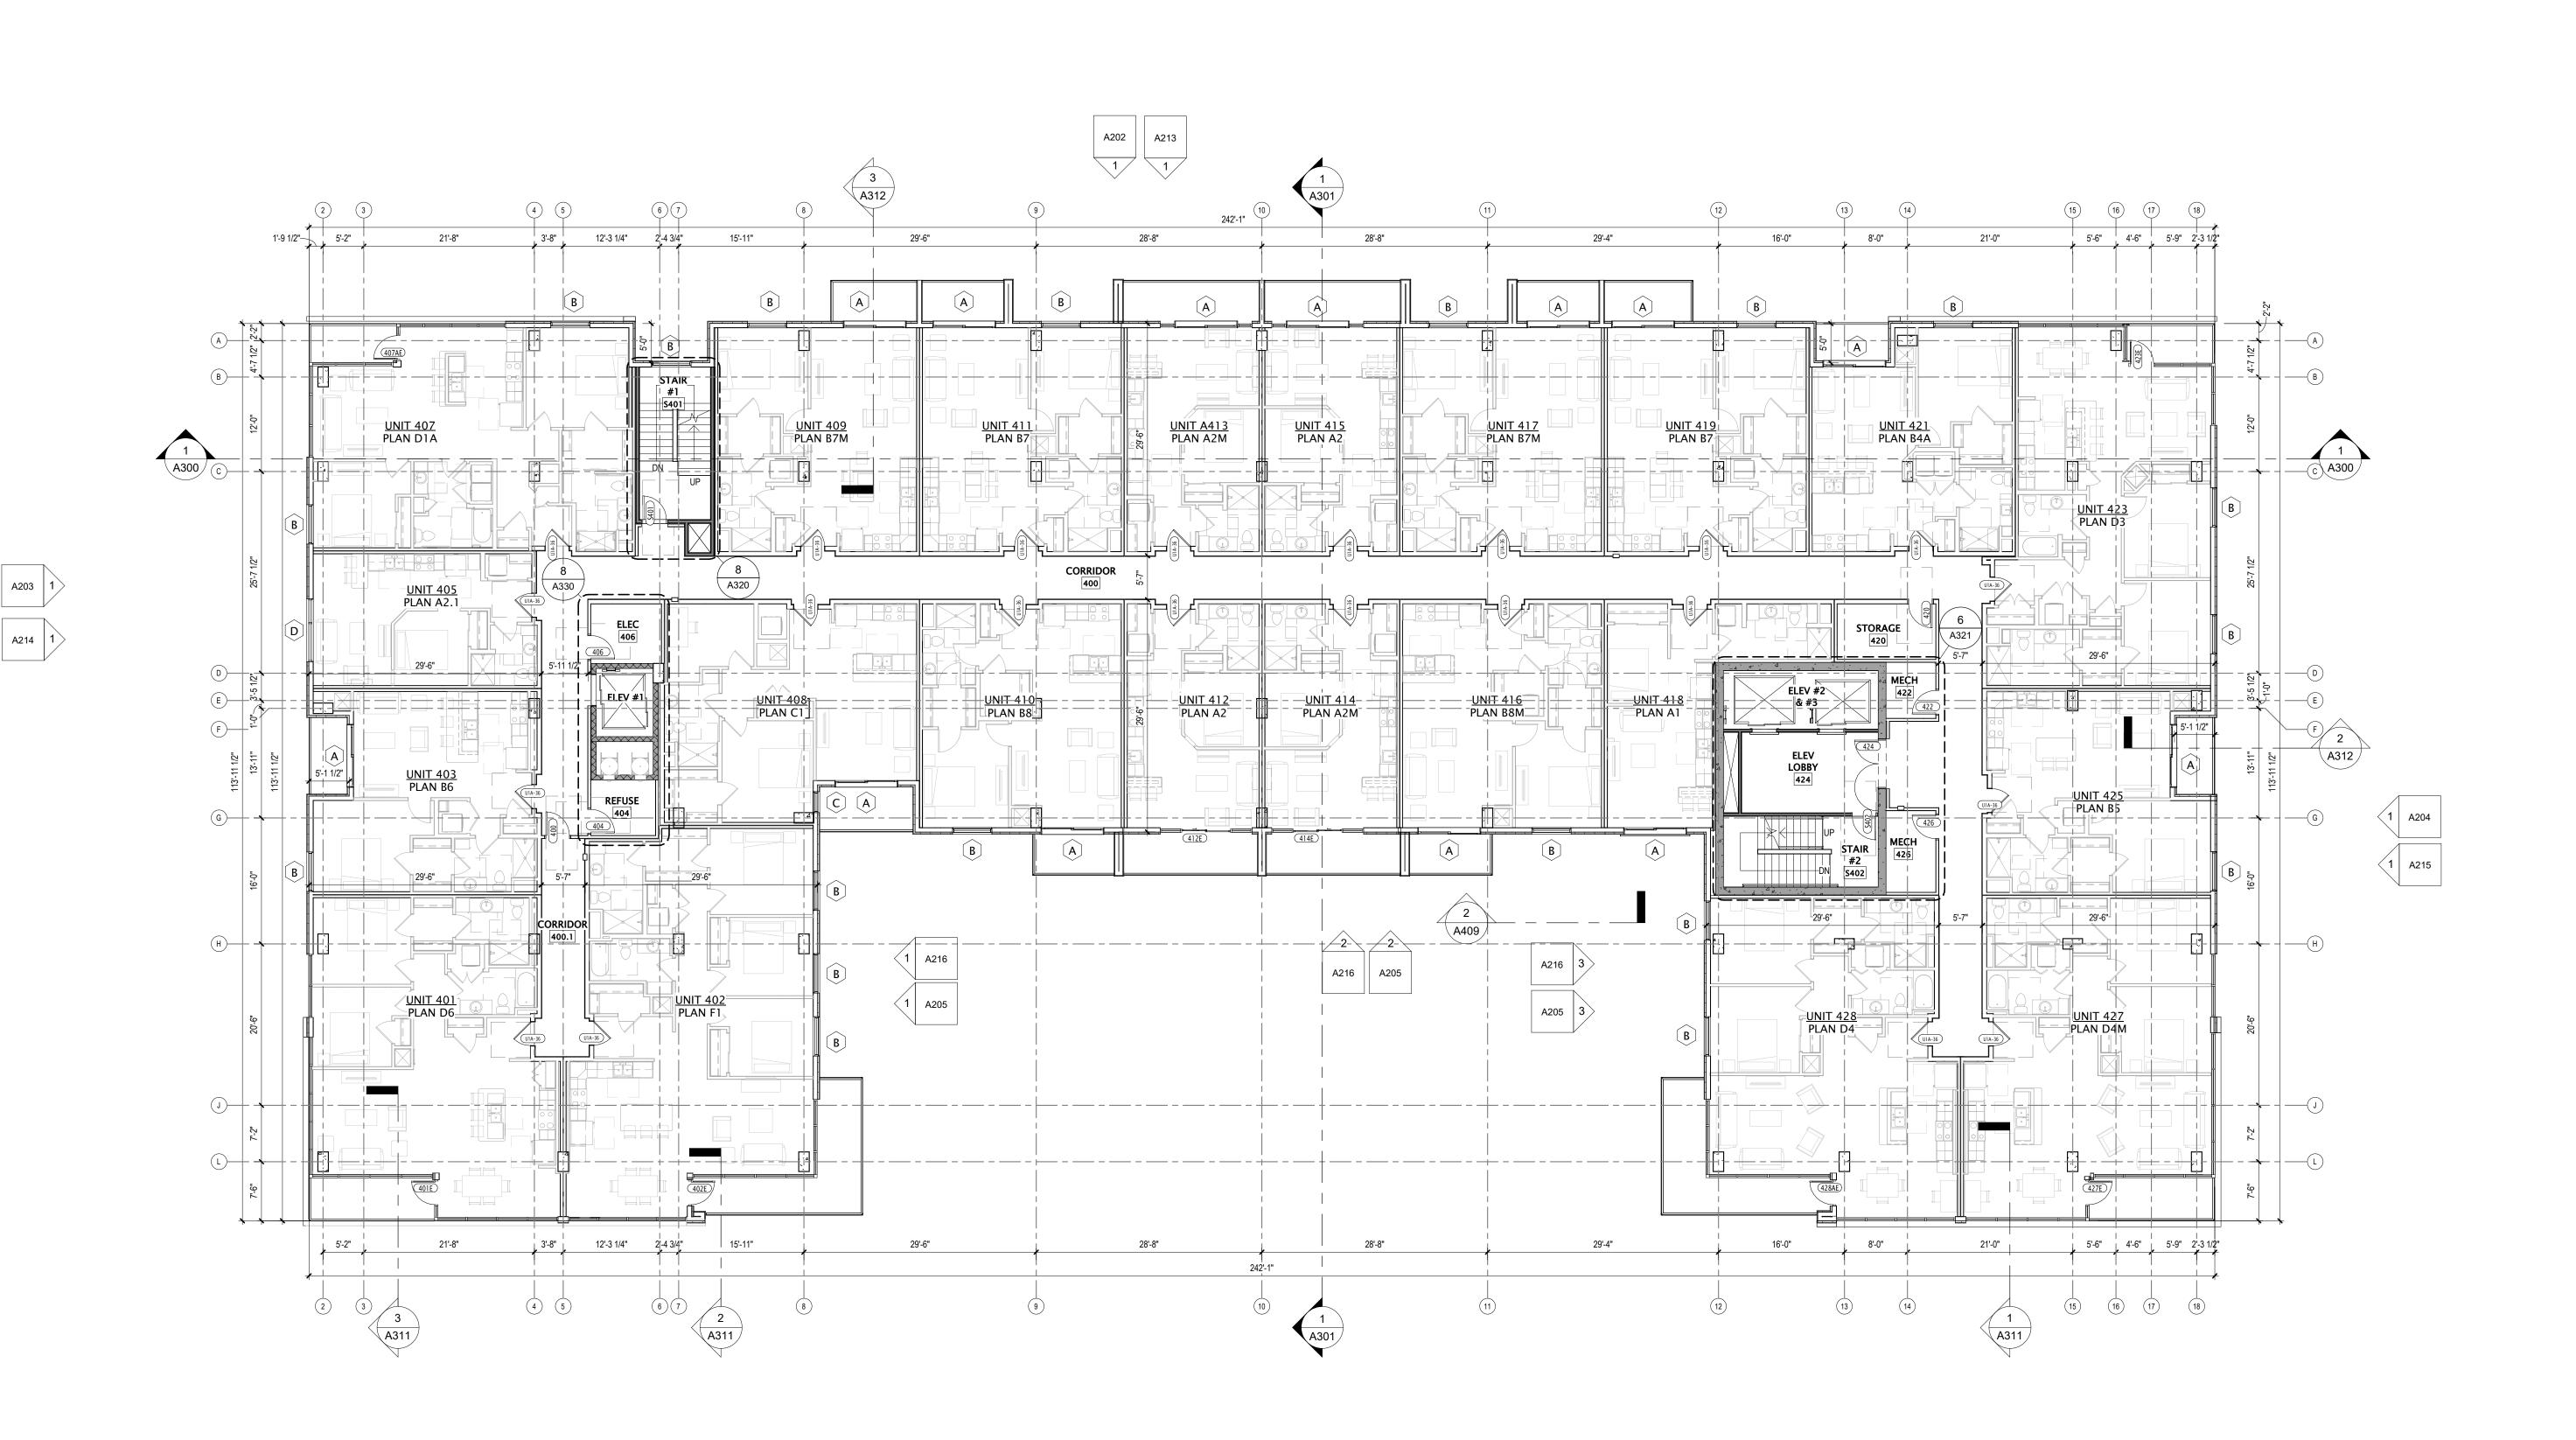
REVISION SCHEDULE

k Description

FOURTH FLOOR PLAN

sheet number

A104



1) FOURTH FLOOR PLAN
3/32" = 1'-0"

BUILDING DIMENSIONS ARE TO OUTSIDE FACE OF STUD 5.

OPENINGS WITH MANUFACTURER.

- OR MASONRY WALLS UNLESS OTHERWISE NOTED. WINDOW & DOOR LOCATION DIMENSIONS ARE TO CENTERLINE OF WINDOW/DOOR UNLESS OTHERWISE 6.
- PROVIDE FIREBLOCKING PER 2015 IBC 718.2.1 TYPICAL THROUGHOUT ENTIRE BUILDING. NOTED. CONTRACTOR SHALL VERIFY ALL ROUGH VERIFY ALL STRUCTURAL MEMBER SIZE, SPACING,
  - FIELD VERIFY ALL CABINETRY LAYOUTS AND COORDINATE WITH THE DIMENSIONAL REQUIREMENTS OF ALL APPLIANCES & FIXTURES. PROVIDE FINISHED END PANELS AT ALL EXPOSED CABINETRY ENDS.
  - CAULK AT PERIMETER OF ALL TUB & SHOWER ENCLOSURES. CAULK AT PERIMETER OF ALL COUNTERTOP BACKSPLASHES & SIDESPLASHES.

PROVIDE BLOCKING AT ALL GRAB BAR LOCATIONS -

IN BATHROOMS DESIGNATED AS ACCESSIBLE.

INCLUDING LOCATIONS OF FUTURE GRAB BARS & SEATS

- INSTALL FIXTURES, ACCESSORIES, ETC. ACCORDING TO THE MOUNTING HEIGHT SCHEDULE. ALL WINDOWS & PATIO DOORS SHALL BE AS SPECIFIED IN THE SCOPE SPECIFICATIONS AND AS INDICATED ON THE
- DRAWINGS. ALL WOOD EXPOSED TO THE EXTERIOR OR IN CONTACT 8. WITH CONCRETE OR MASONRY SHALL BE PRESSURE


REINFORCING, AND BRACING WITH STRUCTURAL

- VERIFY ALL WINDOW, DOOR, TUB, SHOWER, FIREPLACE, 9. APPLIANCE, EQUIPMENT, ETC. ROUGH OPENINGS & CLEARANCE REQUIREMENTS WITH MANUFACTURER.
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#### VEGETATIVE ROOF LEGEND

REQUIREMENT: 50% OF TOTAL ROOF AREA TO BE A VEGETATIVE

3RD LEVEL ROOF/TERRACE AREA	=	11,632 SF
14TH LEVEL ROOF/TERRACE AREA	=	2,008 SF
15TH LEVEL ROOF/TERRACE AREA	=	22,366 SF
TOTAL COMBINED ROOF AREA	=	36,006 SF
3RD LEVELVEGETATIVE ROOF/TERRACE	=	3,364
15TH LEVEL VEGETATIVE ROOF	=	15,064 SF
PERCENTAGE OF TOTAL VEGETATIVE ROO	)F =	51.18% TO

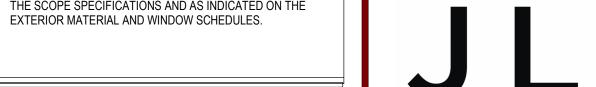

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> DESIGN DEVELOPMENT **DOCUMENTS**


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FIFTH FLOOR PLAN



DRAWINGS.

- BUILDING DIMENSIONS ARE TO OUTSIDE FACE OF STUD 5. OR MASONRY WALLS UNLESS OTHERWISE NOTED.
- WINDOW & DOOR LOCATION DIMENSIONS ARE TO

APPLIANCE, EQUIPMENT, ETC. ROUGH OPENINGS &

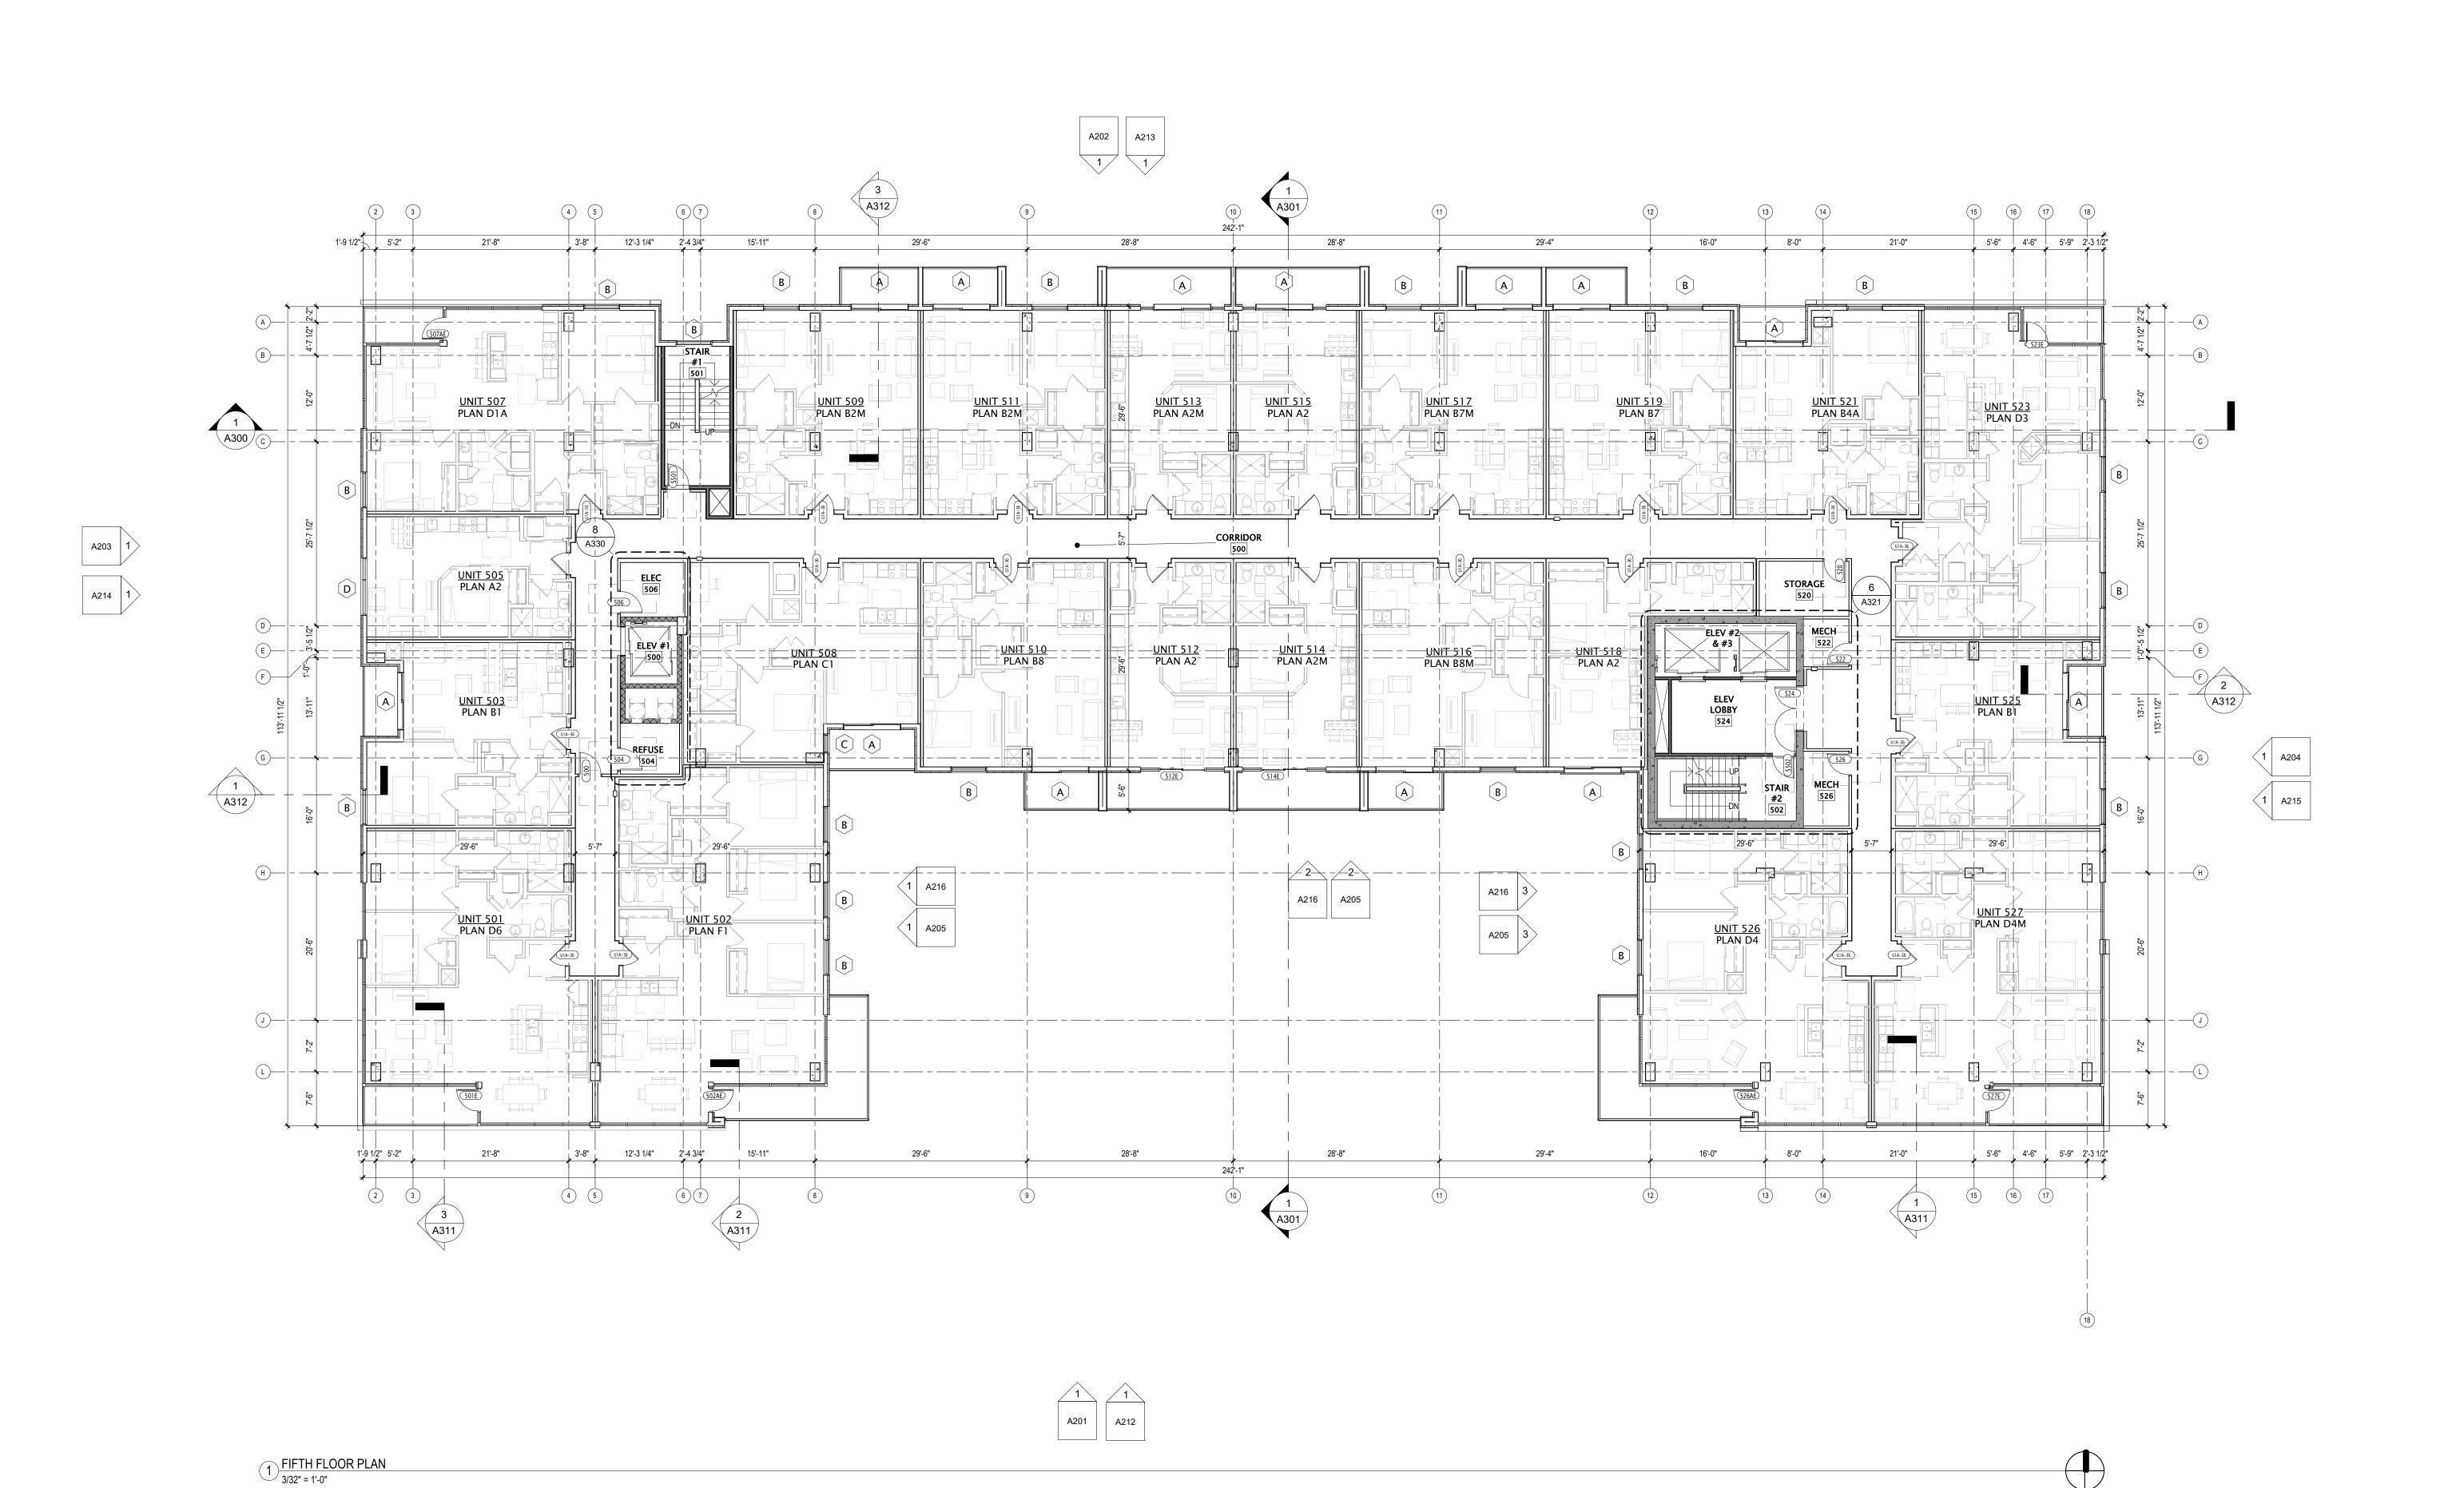PROVIDE SOUND BATT INSULATION AT ALL WALLS SURROUNDING BATHROOMS, LAUNDRY ROOMS/

CLEARANCE REQUIREMENTS WITH MANUFACTURER.

- CENTERLINE OF WINDOW/DOOR UNLESS OTHERWISE NOTED. CONTRACTOR SHALL VERIFY ALL ROUGH THROUGHOUT ENTIRE BUILDING. OPENINGS WITH MANUFACTURER.
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EXTERIOR MATERIAL AND WINDOW SCHEDULES.

PROVIDE BLOCKING AT ALL GRAB BAR LOCATIONS -

IN BATHROOMS DESIGNATED AS ACCESSIBLE.

INCLUDING LOCATIONS OF FUTURE GRAB BARS & SEATS

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#### VEGETATIVE ROOF LEGEND

REQUIREMENT: 50% OF TOTAL ROOF AREA TO BE A VEGETATIVE

3RD LEVEL ROOF/TERRACE AREA 14TH LEVEL ROOF/TERRACE AREA 15TH LEVEL ROOF/TERRACE AREA TOTAL COMBINED ROOF AREA	= = =	11,632 SF 2,008 SF 22,366 SF 36,006 SF
3RD LEVELVEGETATIVE ROOF/TERRACE 15TH LEVEL VEGETATIVE ROOF	=	3,364 15,064 SF
PERCENTAGE OF TOTAL VEGETATIVE ROO	OF =	51.18% TOTAL



3RD LEVEL ROOF/TERRACE AREA	=	11,632 SF
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3RD LEVELVEGETATIVE ROOF/TERRACE	=	3,364
15TH LEVEL VEGETATIVE ROOF	=	15,064 SF
DEDOENTA OF OF TOTAL MEDETATIME BOX	\_	E4 400/ TO3



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JLA PROJECT NUMBER:

DESIGN DEVELOPMENT **DOCUMENTS** 


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SIXTH FLOOR PLAN

A106



1) SIXTH FLOOR PLAN
3/32" = 1'-0"

BUILDING DIMENSIONS ARE TO OUTSIDE FACE OF STUD 5.
OR MASONRY WALLS UNLESS OTHERWISE NOTED.

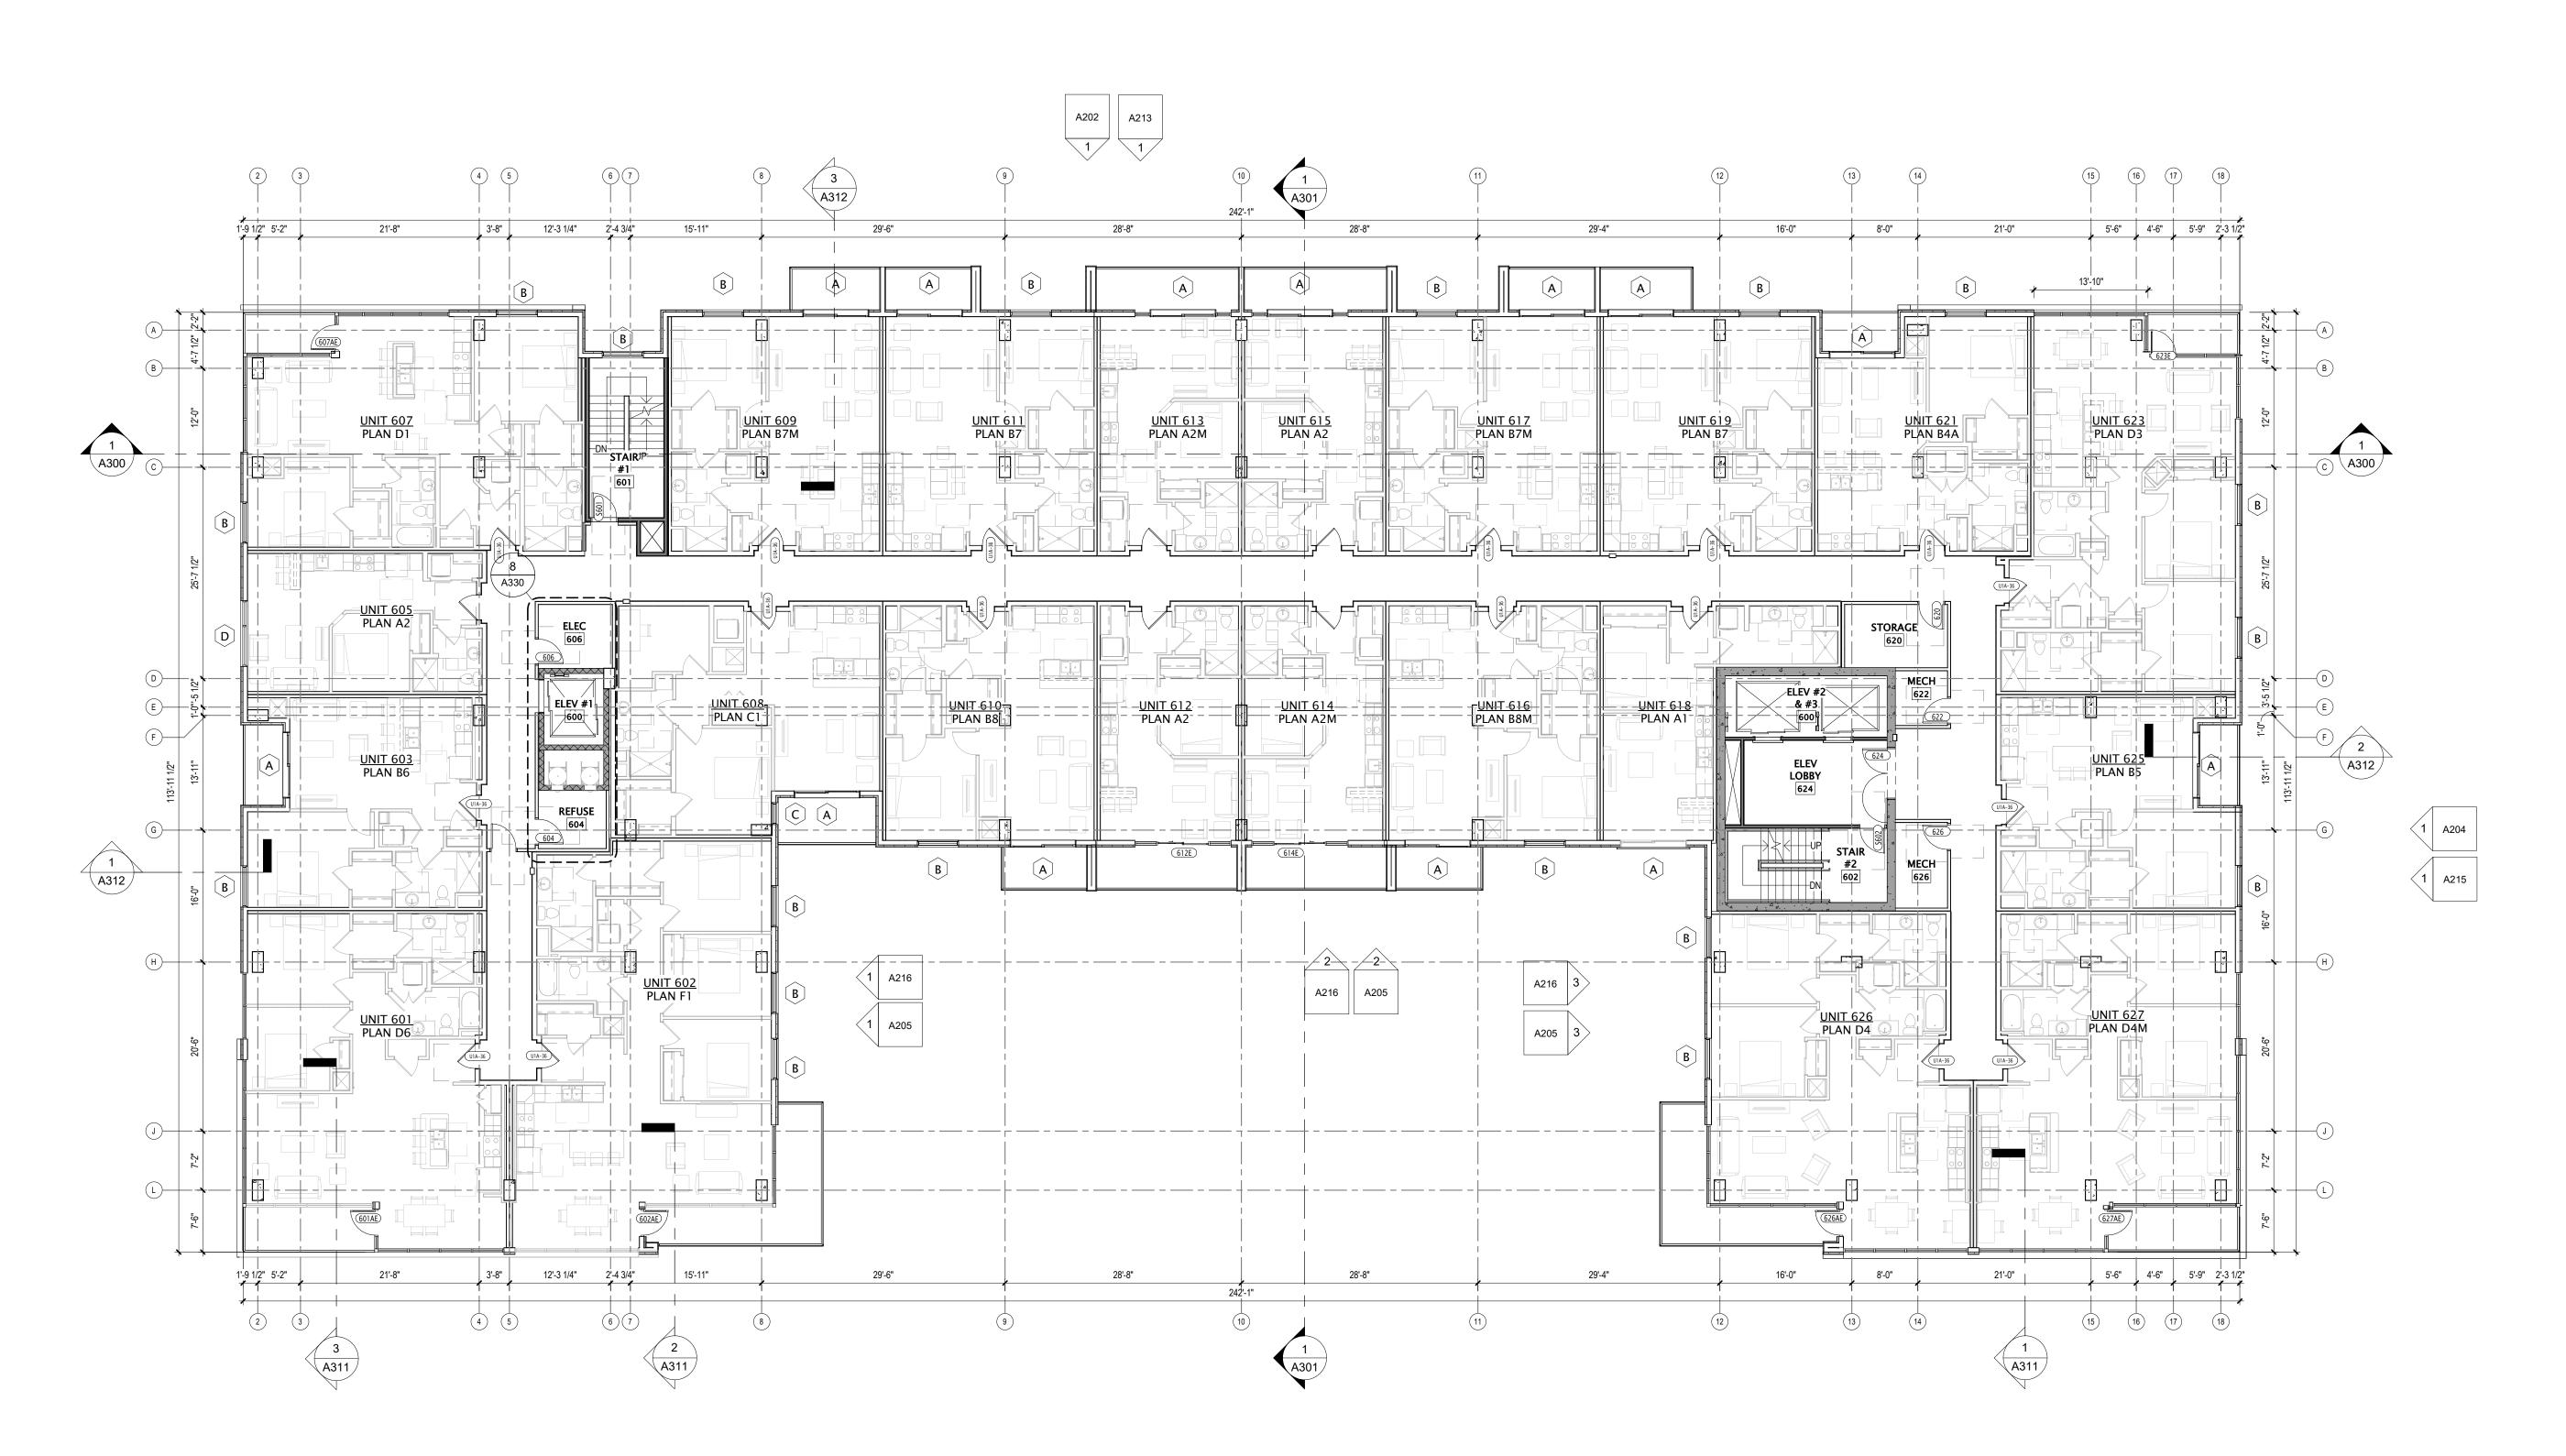OPENINGS WITH MANUFACTURER.

- WINDOW & DOOR LOCATION DIMENSIONS ARE TO CENTERLINE OF WINDOW/DOOR UNLESS OTHERWISE 6. NOTED. CONTRACTOR SHALL VERIFY ALL ROUGH
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  WITH CONCRETE OR MASONRY SHALL BE PRESSURE
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- 6. PROVIDE FIREBLOCKING PER 2015 IBC 718.2.1 TYPICAL THROUGHOUT ENTIRE BUILDING.
- FIELD VERIFY ALL CABINETRY LAYOUTS AND COORDINATE WITH THE DIMENSIONAL REQUIREMENTS OF ALL APPLIANCES & FIXTURES. PROVIDE FINISHED END PANELS AT ALL EXPOSED CABINETRY ENDS.
- CAULK AT PERIMETER OF ALL TUB & SHOWER ENCLOSURES. CAULK AT PERIMETER OF ALL COUNTERTOP BACKSPLASHES & SIDESPLASHES.
- INSTALL FIXTURES, ACCESSORIES, ETC. ACCORDING TO THE MOUNTING HEIGHT SCHEDULE.
   ALL WINDOWS & PATIO DOORS SHALL BE AS SPECIFIED IN THE SCOPE SPECIFICATIONS AND AS INDICATED ON THE

EXTERIOR MATERIAL AND WINDOW SCHEDULES.

ARCHITECTS

MADISON | MILWAUKEE | DENVER

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JLA PROJECT NUMBER:

702 EAST WASHINGTON AVENUE MIXED-USE DEVELOPMENT

DESIGN DEVELOPMENT DOCUMENTS

PROGRESS DOCUMENTS

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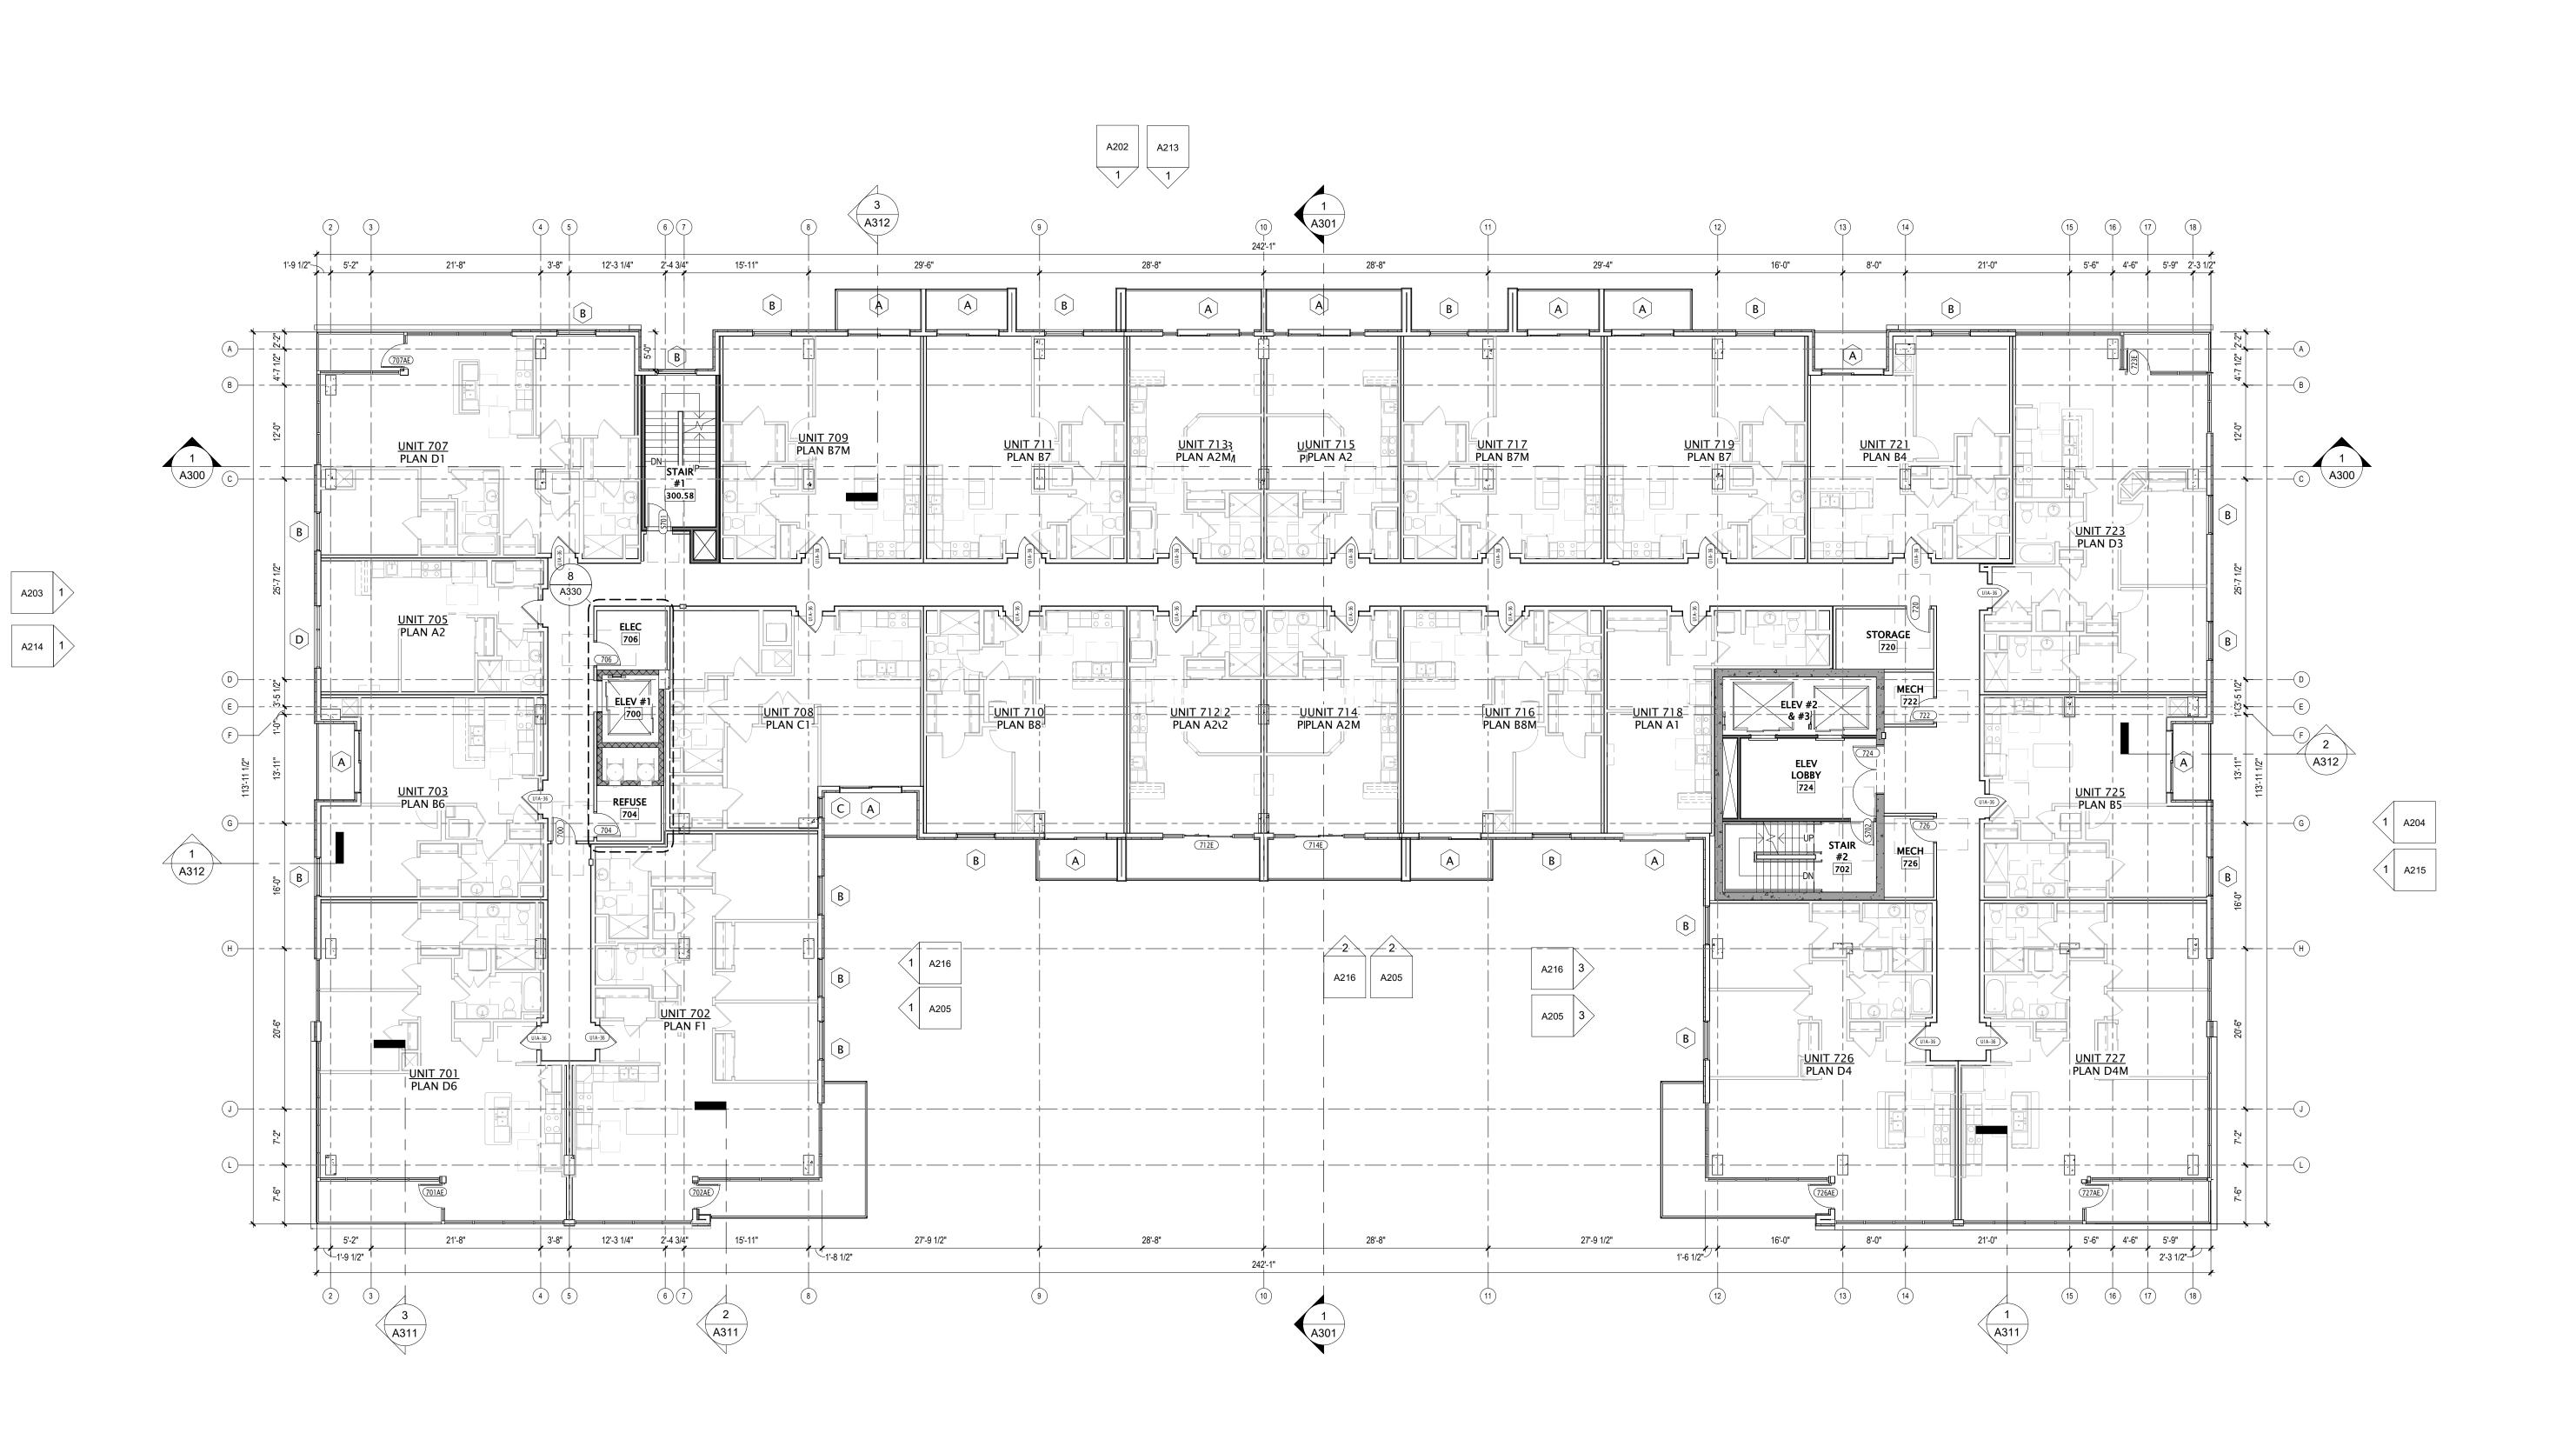
REVISION SCHEDULE

Mark Description

TYPICAL FLOOR PLAN (7-13)

SHEET NUMBER

A107



1) TYPICAL FLOOR PLAN (7-13) 3/32" = 1'-0"

- BUILDING DIMENSIONS ARE TO OUTSIDE FACE OF STUD 5.
  OR MASONRY WALLS UNLESS OTHERWISE NOTED.
- 2. WINDOW & DOOR LOCATION DIMENSIONS ARE TO CENTERLINE OF WINDOW/DOOR UNLESS OTHERWISE NOTED. CONTRACTOR SHALL VERIFY ALL ROUGH OPENINGS WITH MANUFACTURER.
- VERIFY ALL STRUCTURAL MEMBER SIZE, SPACING, REINFORCING, AND BRACING WITH STRUCTURAL
- 4. ALL WOOD EXPOSED TO THE EXTERIOR OR IN CONTACT 8. WITH CONCRETE OR MASONRY SHALL BE PRESSURE TREATED.
- TREATED.

  VERIFY ALL WINDOW, DOOR, TUB, SHOWER, FIREPLACE, 9.

  APPLIANCE, EQUIPMENT, ETC. ROUGH OPENINGS &

CLEARANCE REQUIREMENTS WITH MANUFACTURER.

- 6. PROVIDE SOUND BATT INSULATION AT ALL WALLS SURROUNDING BATHROOMS, LAUNDRY ROOMS/ CLOSETS, MECHANICAL ROOMS/ CLOSETS, AND OTHER PLUMBING WALLS.
- PROVIDE BLOCKING AT ALL GRAB BAR LOCATIONS INCLUDING LOCATIONS OF FUTURE GRAB BARS & SEATS
  IN BATHROOMS DESIGNATED AS ACCESSIBLE.

  PROVIDE FIREBLOCKING PER 2015 IBC 718.2.1 TYPICAL
- THROUGHOUT ENTIRE BUILDING.

  FIELD VERIFY ALL CABINETRY LAYOUTS AND COORDINATE WITH THE DIMENSIONAL REQUIREMENTS OF ALL APPLIANCES & FIXTURES. PROVIDE FINISHED END PANELS
- CAULK AT PERIMETER OF ALL TUB & SHOWER ENCLOSURES. CAULK AT PERIMETER OF ALL COUNTERTOP BACKSPLASHES & SIDESPLASHES.

  INSTALL FIXTURES, ACCESSORIES, ETC. ACCORDING TO

AT ALL EXPOSED CABINETRY ENDS.

THE MOUNTING HEIGHT SCHEDULE.

10. ALL WINDOWS & PATIO DOORS SHALL BE AS SPECIFIED IN THE SCOPE SPECIFICATIONS AND AS INDICATED ON THE EXTERIOR MATERIAL AND WINDOW SCHEDULES.



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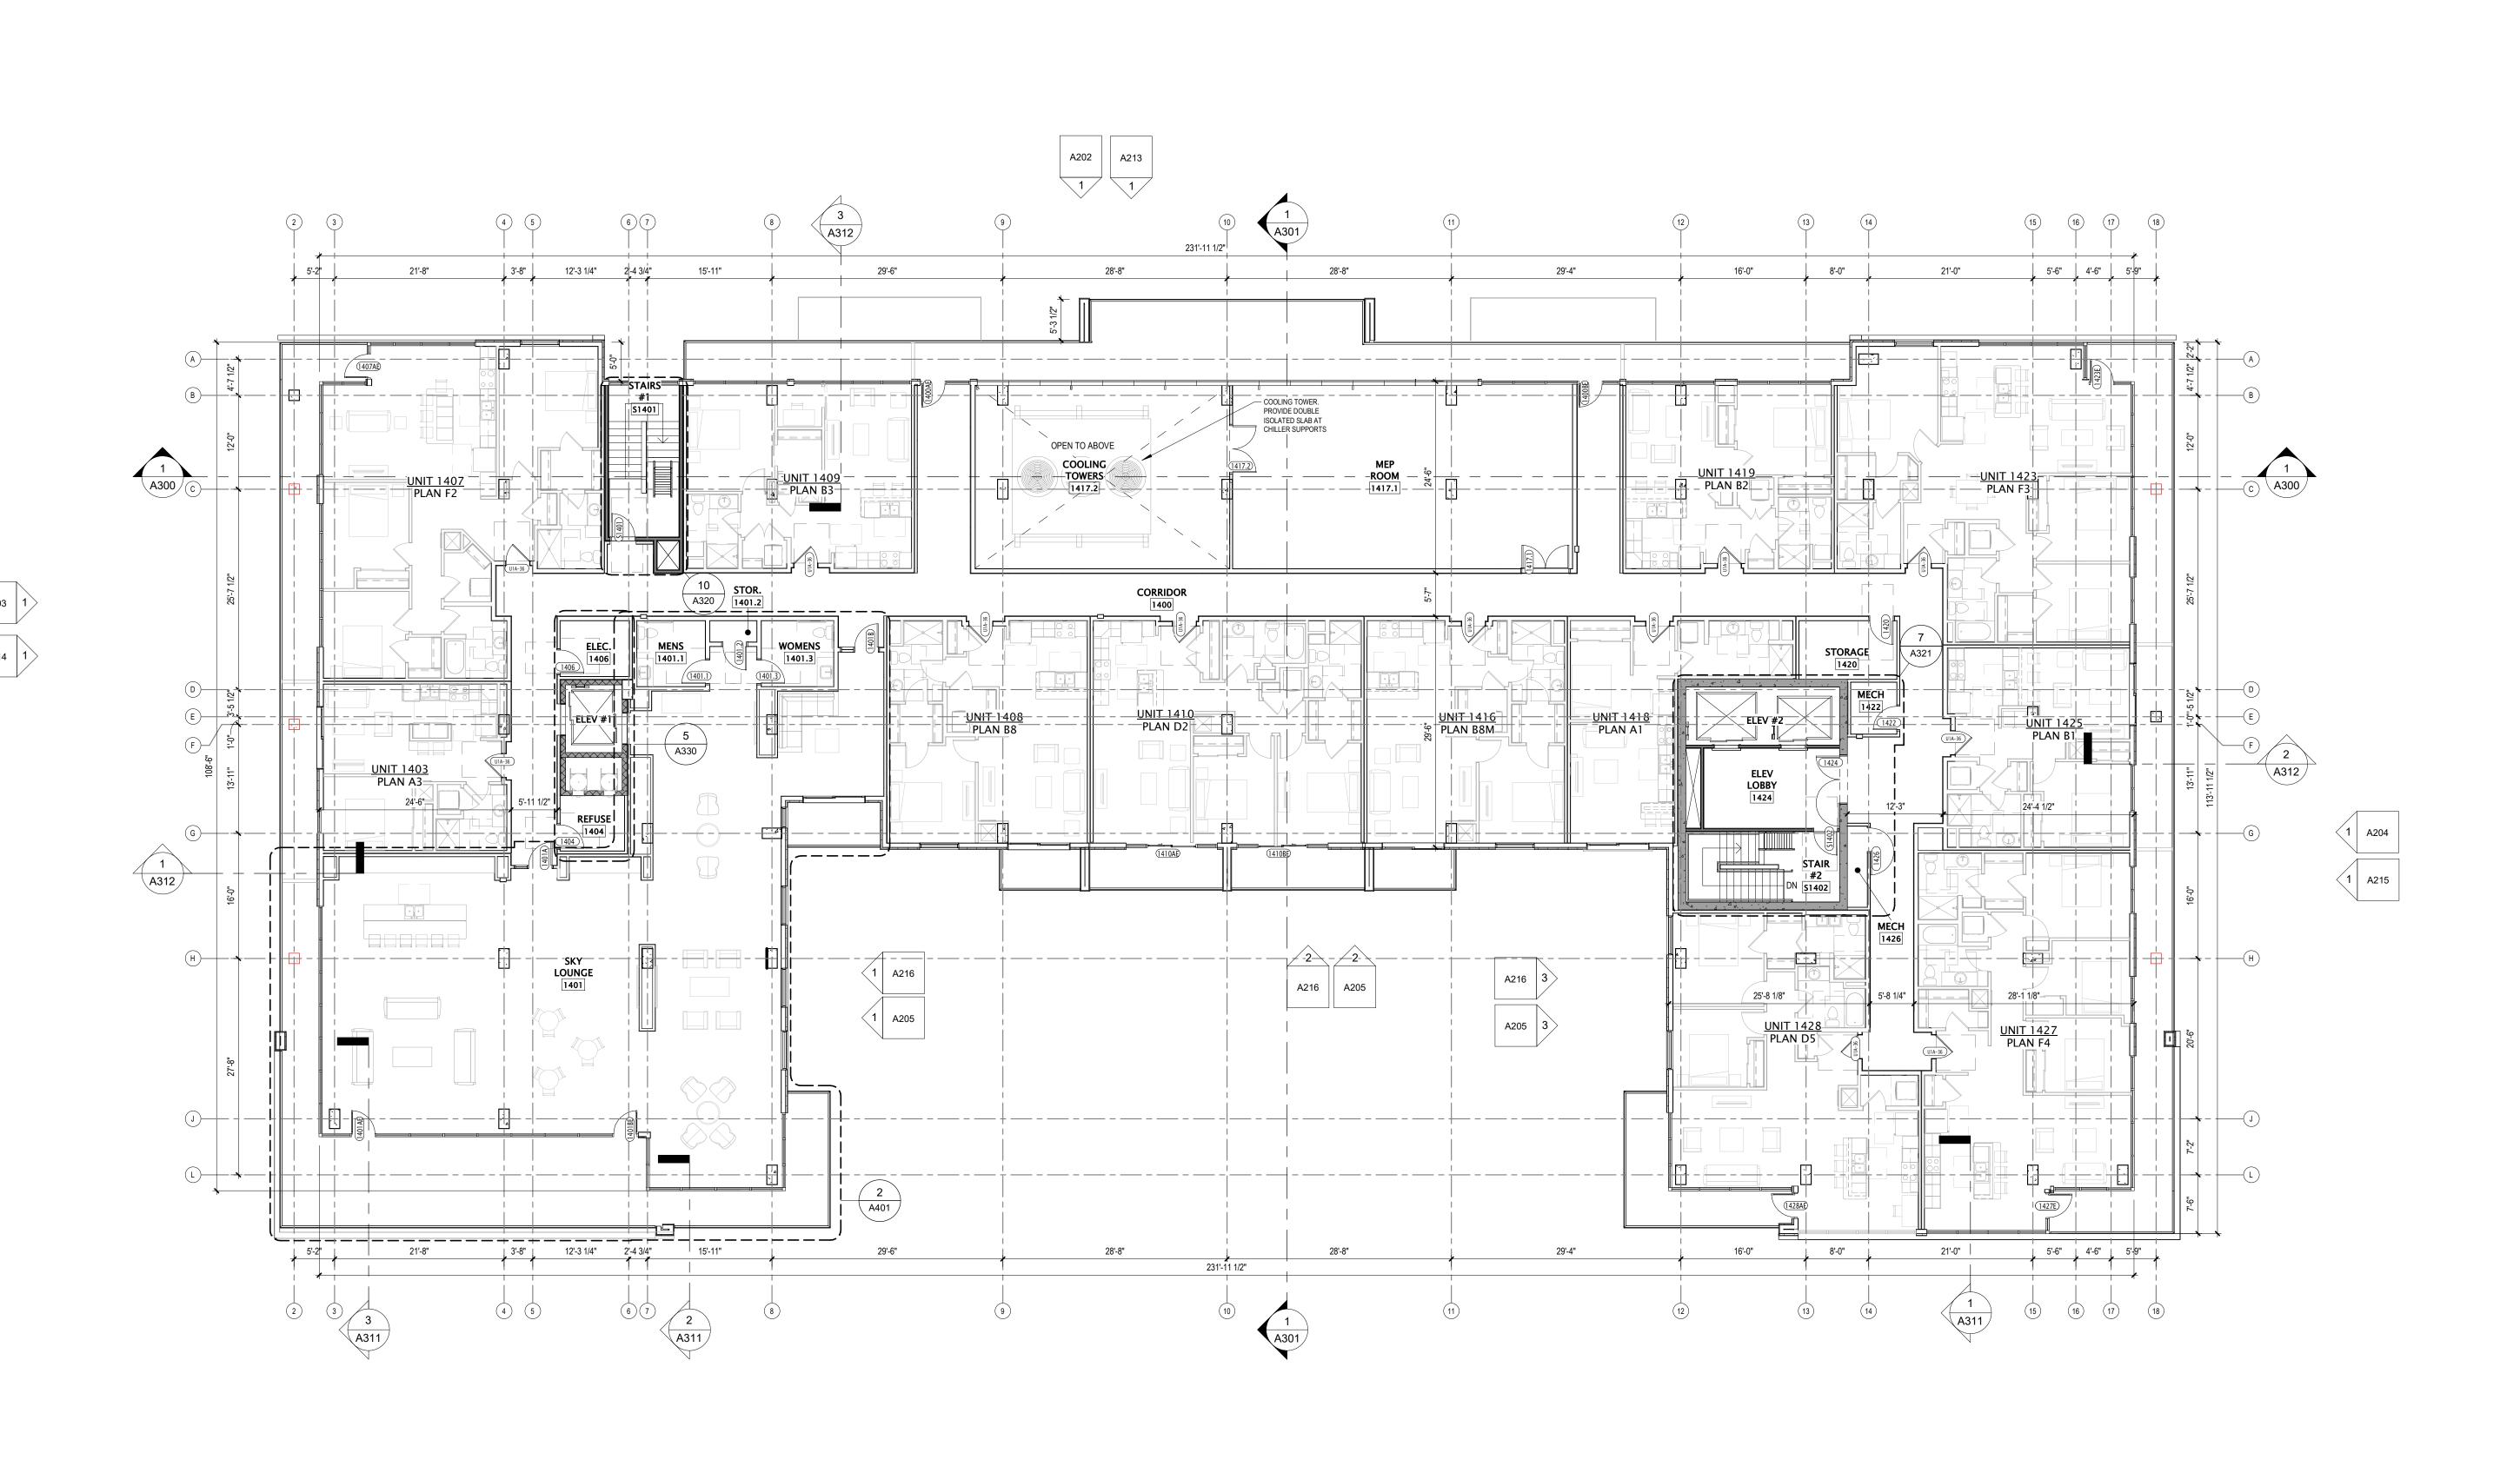
Mark Description

IEET TITLE

FOURTEENTH FLOOR PLAN

SHEET NUMBER

A114



1 1 A201 A212

1) FOURTEENTH FLOOR PLAN
3/32" = 1'-0"

#### **ROOF NOTES**

- . ROOF SHALL BE ROOF ASSEMBLY CR2-1.5X, UNLESS NOTED OTHERWISE. RIGID INSULATION SHALL BE PITCHED AT 1/4" PER FOOT (MINIMUM) TO PROVIDE ROOF DRAINAGE. SEE A501 FOR ROOF ASSEMBLY DESCRIPTIONS.
- PROVIDE TAPERED INSULATION BOARD WHERE NECESSARY OVER ROOF ASSEMBLY TO MAINTAIN A 1/4" PER FOOT MINIMUM PITCH TO ROOF DRAINS. PROVIDE A 3/16" PER FOOT MINIMUM PITCH FOR TAPERED INSULATION SADDLES AND/ OR CRICKETS WHERE NECESSARY.
- ROOF DRAINS ARE SHOWN FOR INTENT ONLY. DESIGN/BUILD PLUMBING CONTRACTOR SHALL PROVIDE NECESSARY CALCULATIONS TO DETERMINE FINAL QUANTITY, SIZE, AND LOCATION OF ROOF DRAINS AND OVERFLOW DRAINS. COORDINATE ALL ROOF DRAINS WITH ROOFING CONTRACTOR TO PROVIDE PROPER DRAINAGE.
- 4. AT ALL FIRE WALLS, PROVIDE NON-COMBUSTIBLE ROOF SHEATHING EXTENDING TO A DISTANCE OF 48" (MINIMUM) FROM BOTH SIDES OF FIRE WALL.
- 5. PROVIDE WATERTIGHT INTEGRITY AT ALL PENETRATIONS AND EQUIPMENT PER ROOFING MANUFACTURER'S STANDARD DETAILS AND REQUIREMENTS FOR WARRANTY AND CURRENT NRCA STANDARDS.
- 6. VERIFY ANY ROOFTOP EQUIPMENT AND PENETRATIONS WITH OWNER'S DESIGN / BUILD MECHANICAL, ELECTRICAL, AND PLUMBING PLANS.
- 7. DESIGN / BUILD CONTRACTORS PROVIDING ROOF PENETRATIONS MUST PROVIDE TEMPORARY WEATHERTIGHT COVERS FOR OPENING UNTIL PLACEMENT OF FINISHED WORK OR COVERING.
- 8. OVERHANGS (IF ANY) SHALL BE AS SHOWN ON ROOF PLAN.
- 9. ALL DRYERS SHALL BE VENTED WITH UL CLASSIFIED DRYER BOX & VENT. PROVIDE POWER BOOSTER FAN/ VENT IF VENT RUN EXCEEDS 25'-0".
- 10. PLUMBING DESIGN-BUILD CONTRACTOR TO COORDINATE THE LOCATION OF ROOF FROST PROOF HOSE BIB WITH OWNER. COORDINATE LOCATION WITH TRUSS LAYOUT AND UNIT LAYOUT BELOW.
- 11. PROVIDE PREFINISHED SHEET METAL COPINGS AND/ OR GRAVEL STOPS PER PLANS. REFER TO EXTERIOR ELEVATIONS MATERIAL SCHEDULE FOR SPECIFIED METAL COLORS.
- 12. PROVIDE PREFINISHED SHEET METAL DOWNSPOUTS WHERE INDICATED. REFER TO EXTERIOR ELEVATIONS MATERIAL SCHEDULE FOR SPECIFIED METAL COLORS. DESIGN/BUILD PLUMBING CONTRACTOR SHALL PROVIDE NECESSARY CALCULATIONS AND DETERMINE FINAL QUANTITY, SIZE, AND LOCATION OF DOWNSPOUTS AND SHALL COORDINATE WITH ROOFING CONTRACTOR TO PROVIDE PROPER DRAINAGE.
- 13. ROOF DRAINS AND/ OR DOWNSPOUTS SHOWN FOR INTENT ONLY. ROOFING AND PLUMBING CONTRACTORS SHALL DETERMINE AND COORDINATE FINAL ROOF DRAIN/ DOWNSPOUT SIZES AND LOCATIONS BASED ON DRAINAGE CALCULATIONS PROVIDED BY PLUMBING SUB-CONTRACTOR.

VEGETATIVE ROOF LEGEND

REQUIREMENT: 50% OF TOTAL ROOF AREA TO BE A VEGETATIVE

3RD LEVEL ROOF/TERRACE AREA = 11.632 SF

14TH LEVEL ROOF/TERRACE AREA = 2,008 SF 15TH LEVEL ROOF/TERRACE AREA = 22,366 SF TOTAL COMBINED ROOF AREA = 36,006 SF

3RD LEVELVEGETATIVE ROOF/TERRACE = 3,364 15TH LEVEL VEGETATIVE ROOF = 15,064 SF

PERCENTAGE OF TOTAL VEGETATIVE ROOF = 51.18% TOTAL



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> DESIGN DEVELOPMENT **DOCUMENTS**


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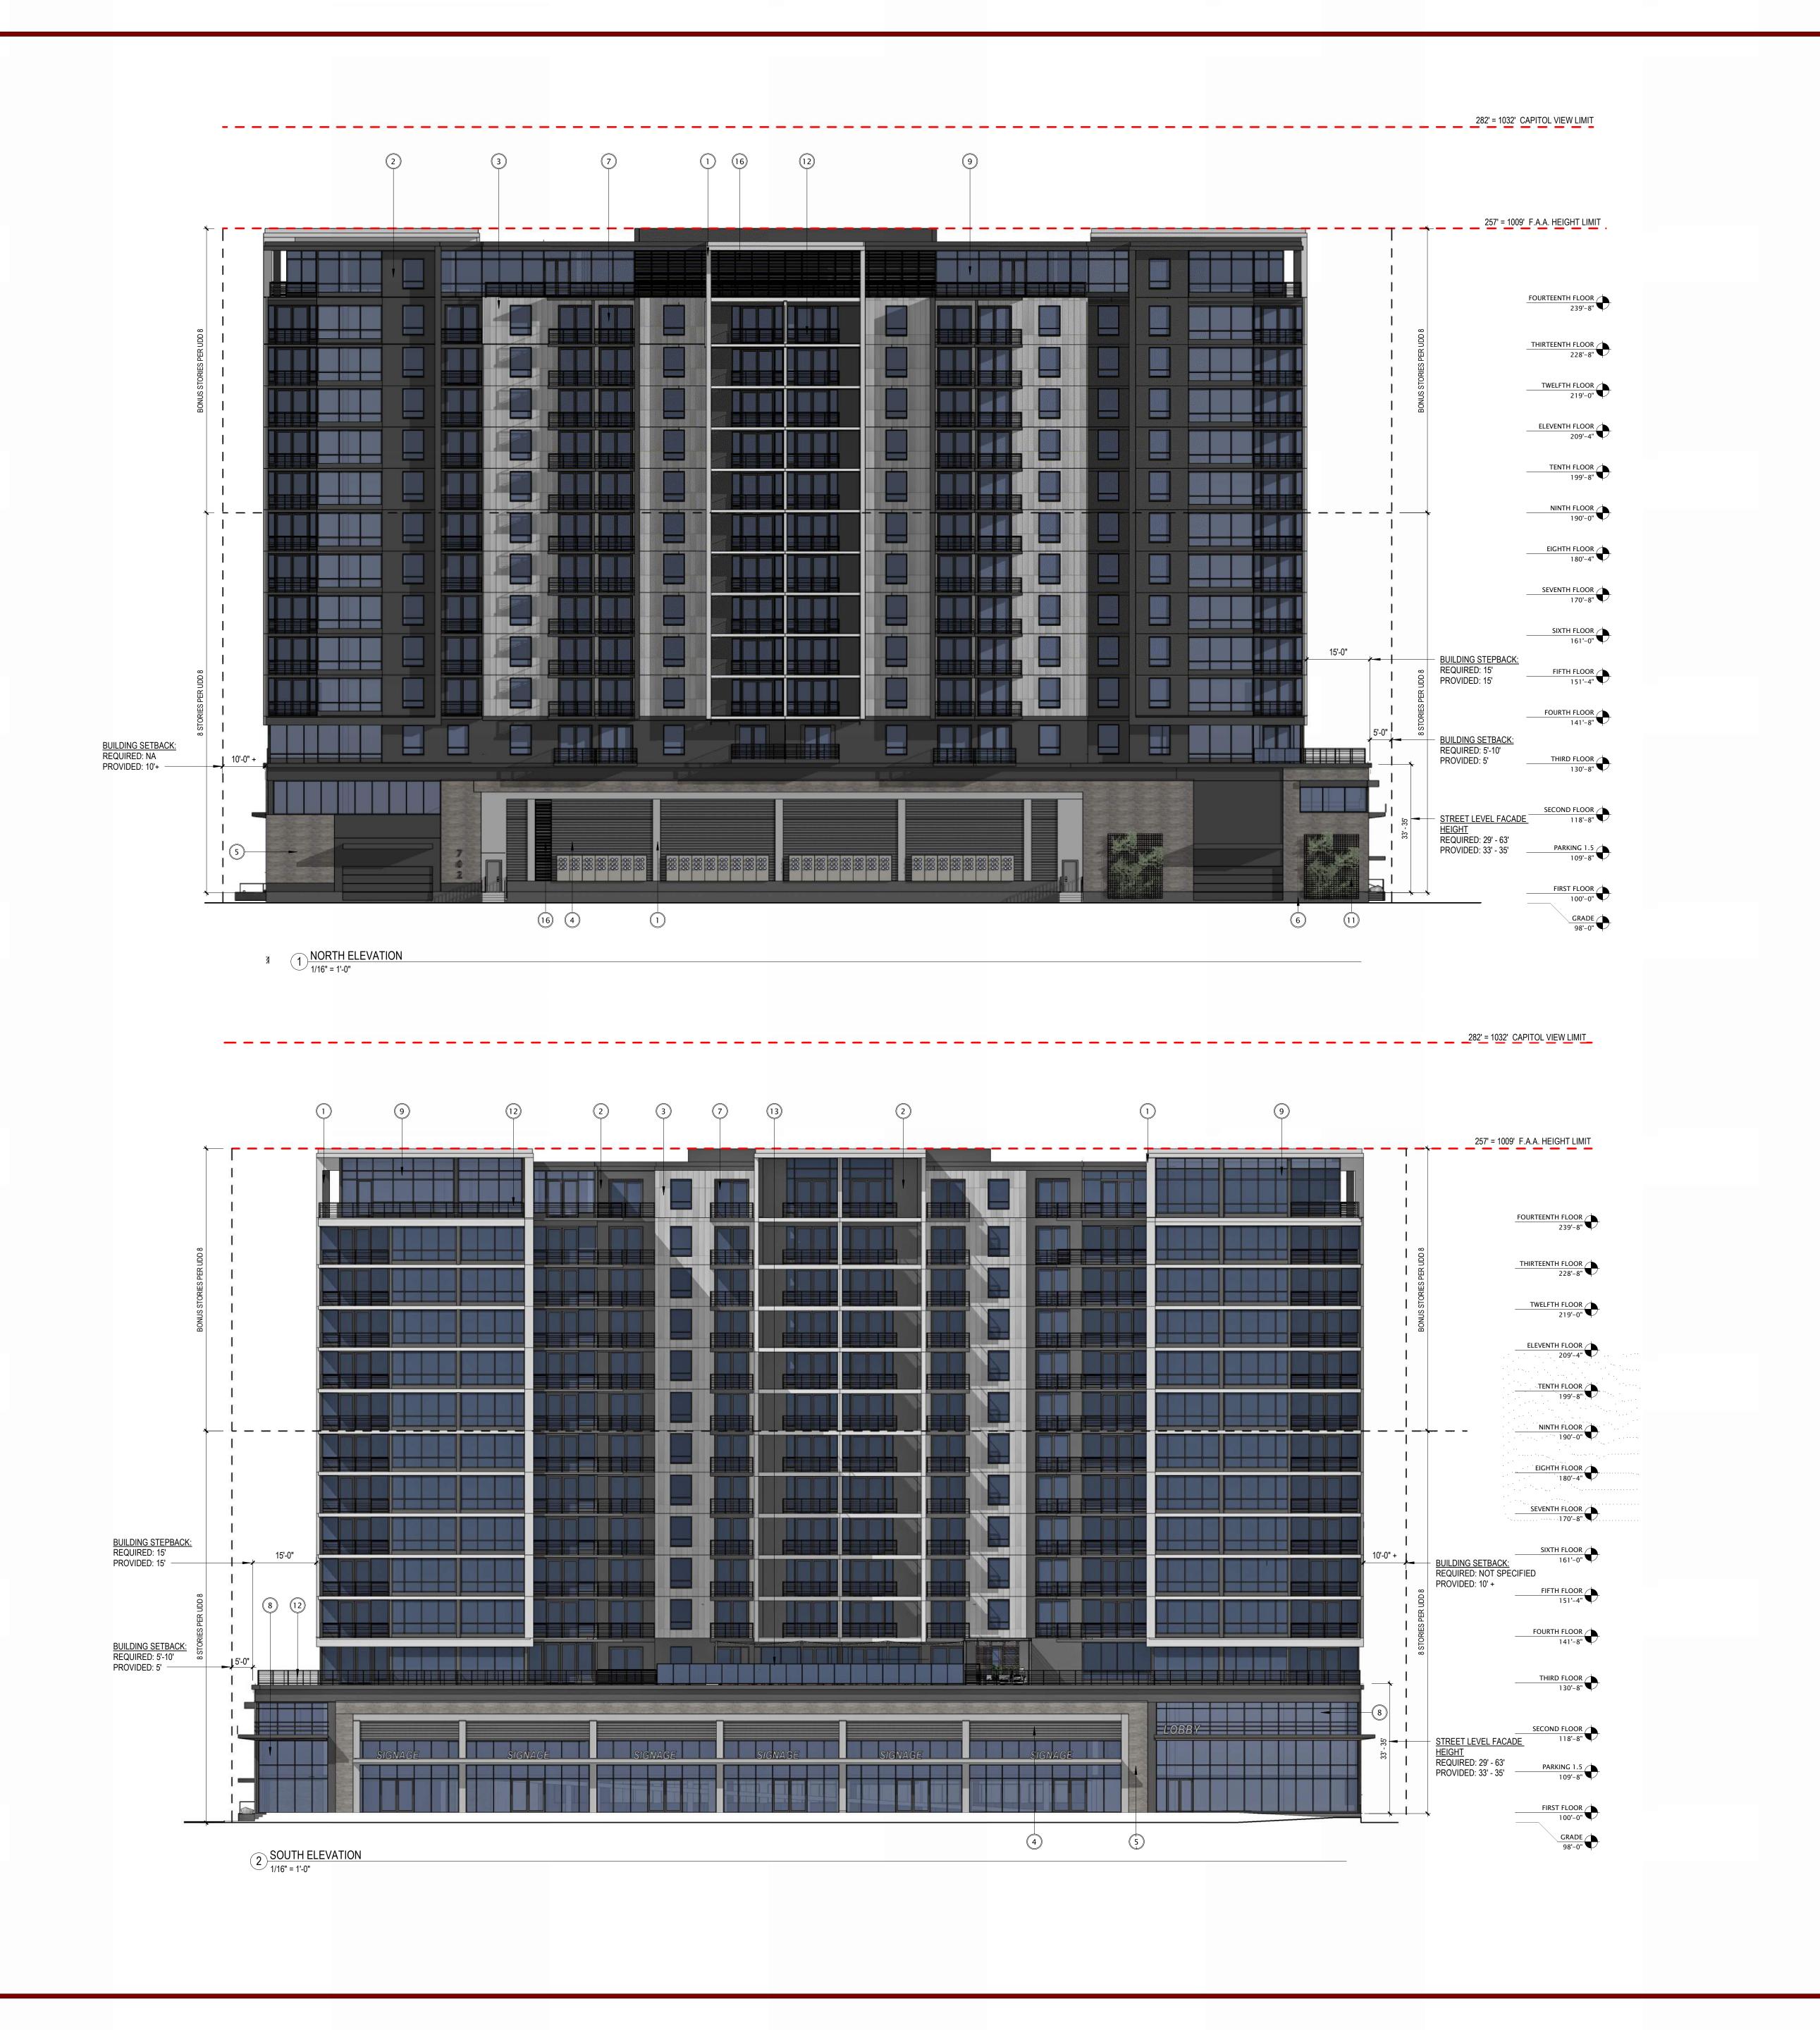
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**ROOF PLAN** 

A120



1 ROOF PLAN 3/32" = 1'-0"

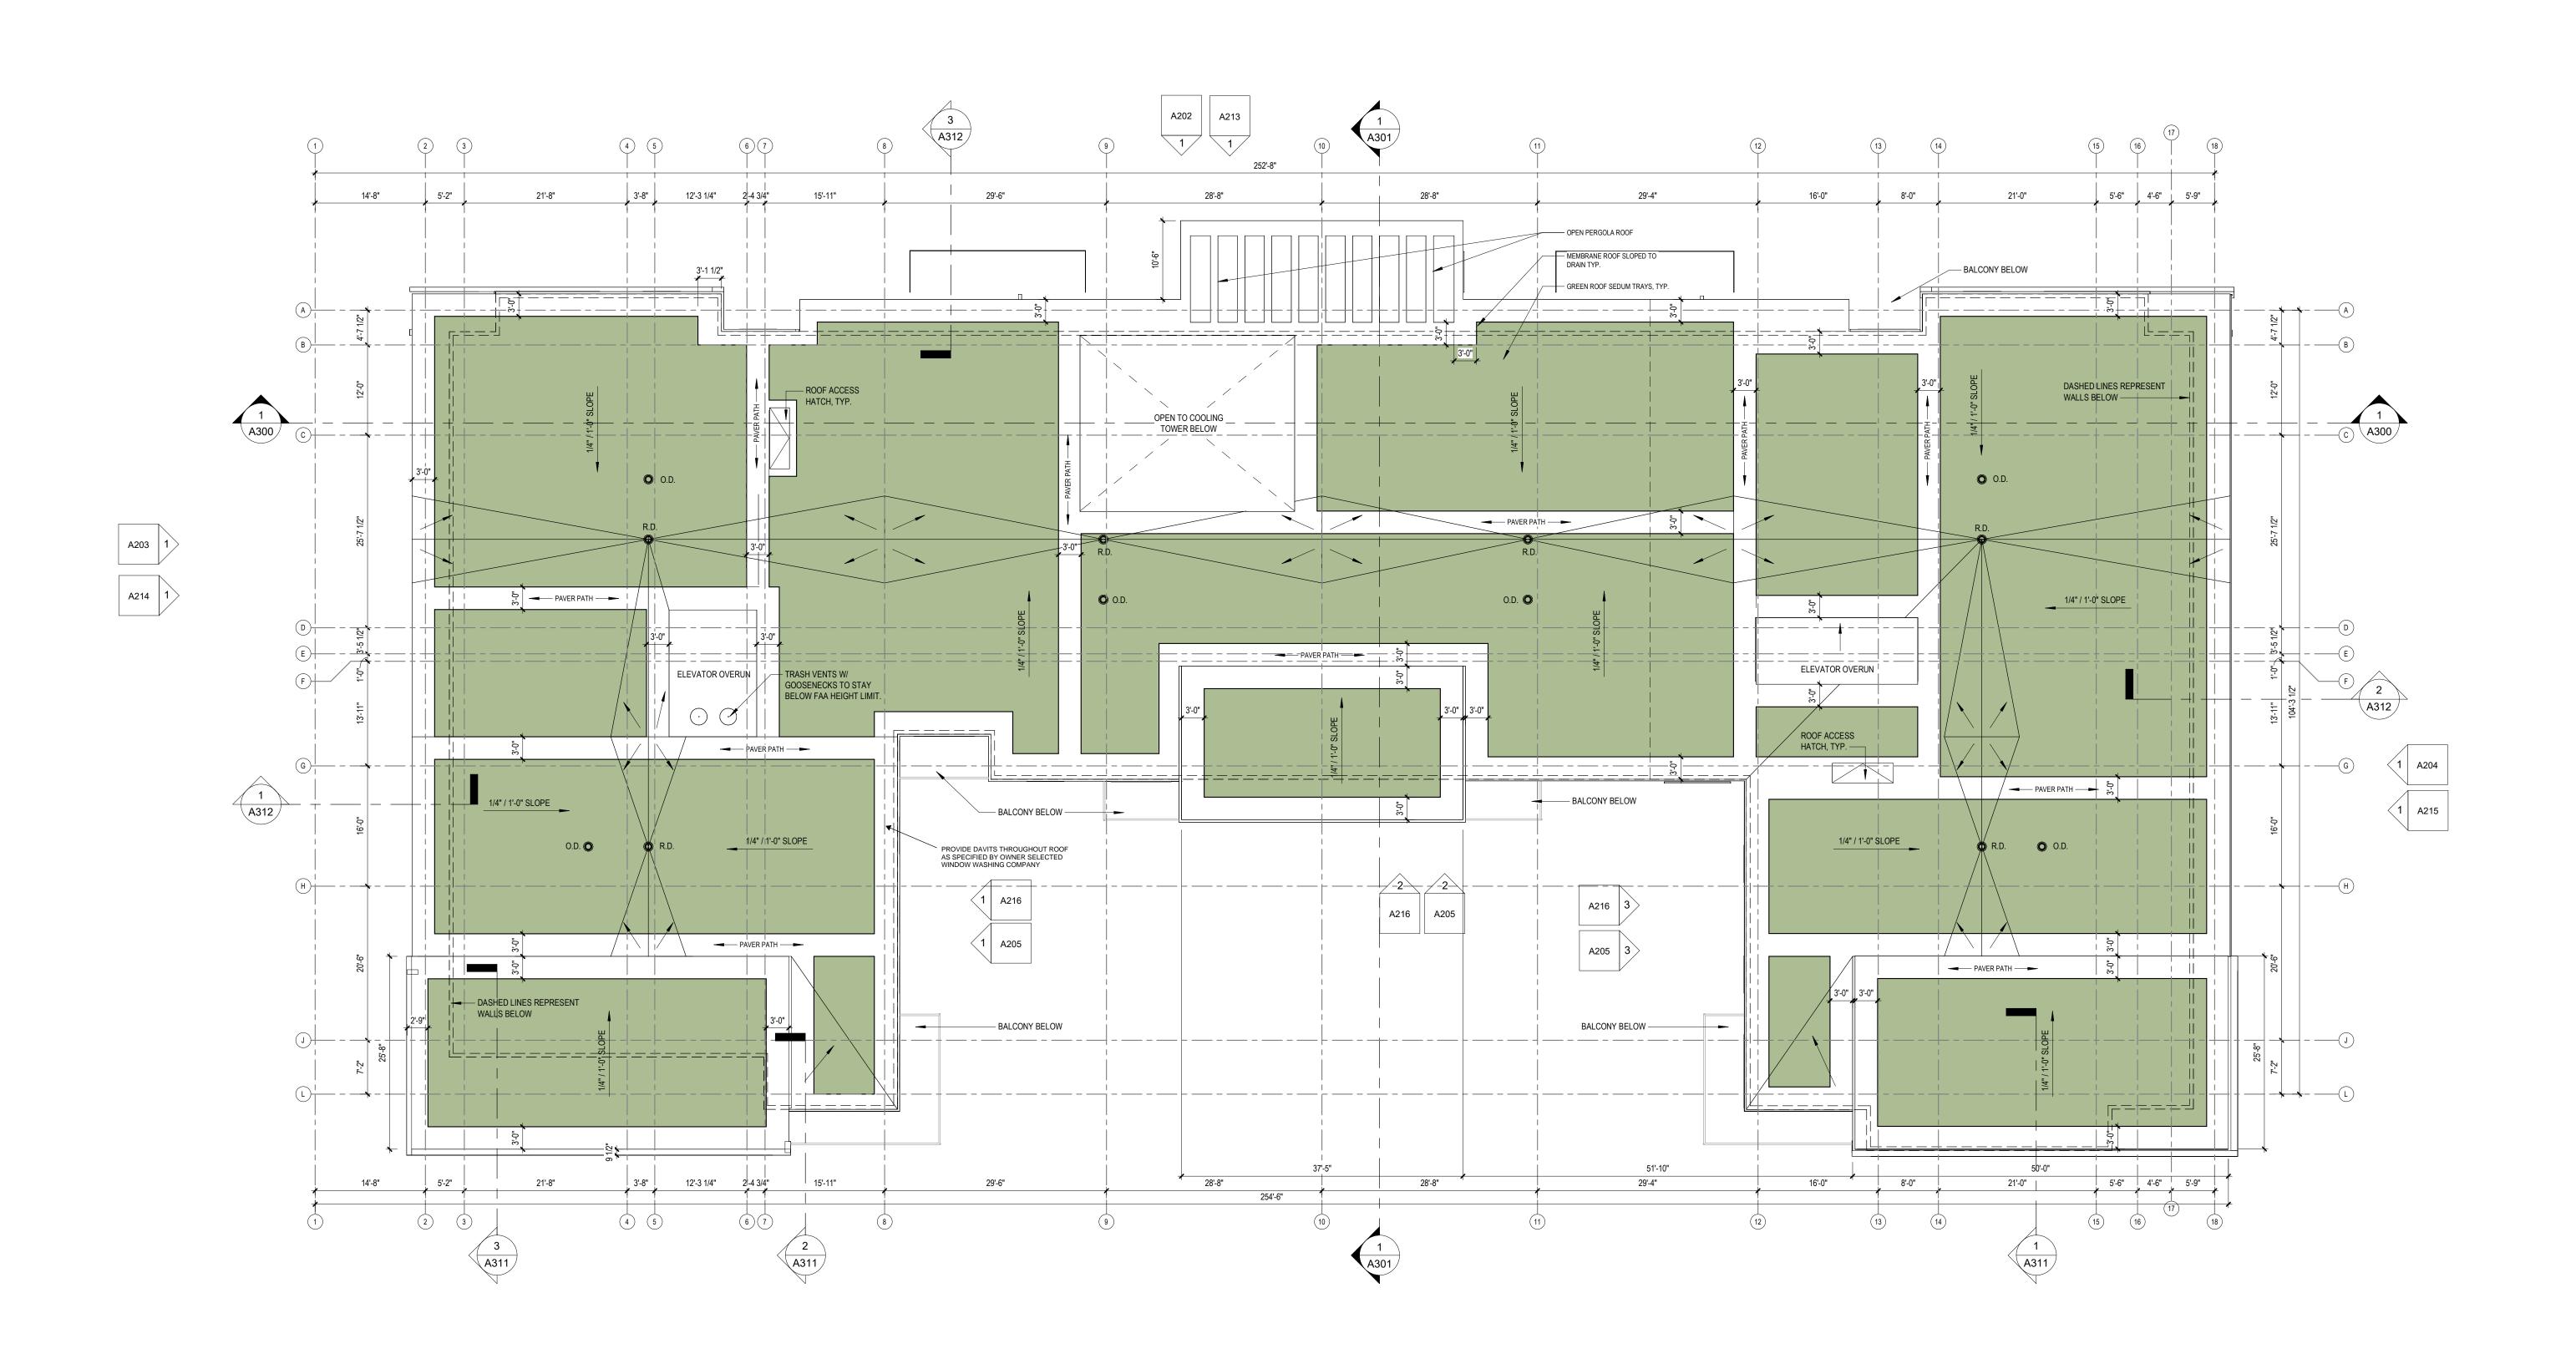

#### **ELEVATION NOTES**

- REVIEWED FOR EXTERIOR FINISHES AND AESTHETIC DESIGN INTENT ONLY. ASSEMBLIES AND PERFORMANCE NOT REVIEWED.
- G.C. TO PROVIDE MOCKUPS OF EACH EXTERIOR WALL MATERIAL/ASSEMBLIES.
- G.C. TO SUBMIT CURTAINWALL VISION GLASS AND SPANDREL GLASS SAMPLES FOR REVIEW AND APPROVAL.
- 4. VERIFY BIRD-SAFE GLASS FRIT PATTERN. 5. PROVIDE ACM REVEALS AT ACM - NO WET SEALS.
- 6. SUBMIT SCHEMATIC PANEL SYSTEM JOINT LAYOUT TO ARCHITECT FOR REVIEW AND APPROVAL.

EXTERIOR MATERIALS SCHEDULE DESCRIPTION 1 METAL PANEL 1
2 METAL PANEL 2
3 METAL PANEL 3
4 METAL PANEL 4
5 BRICK 1
6 STONE 1
7 ALUMINUM PATIO DOOR





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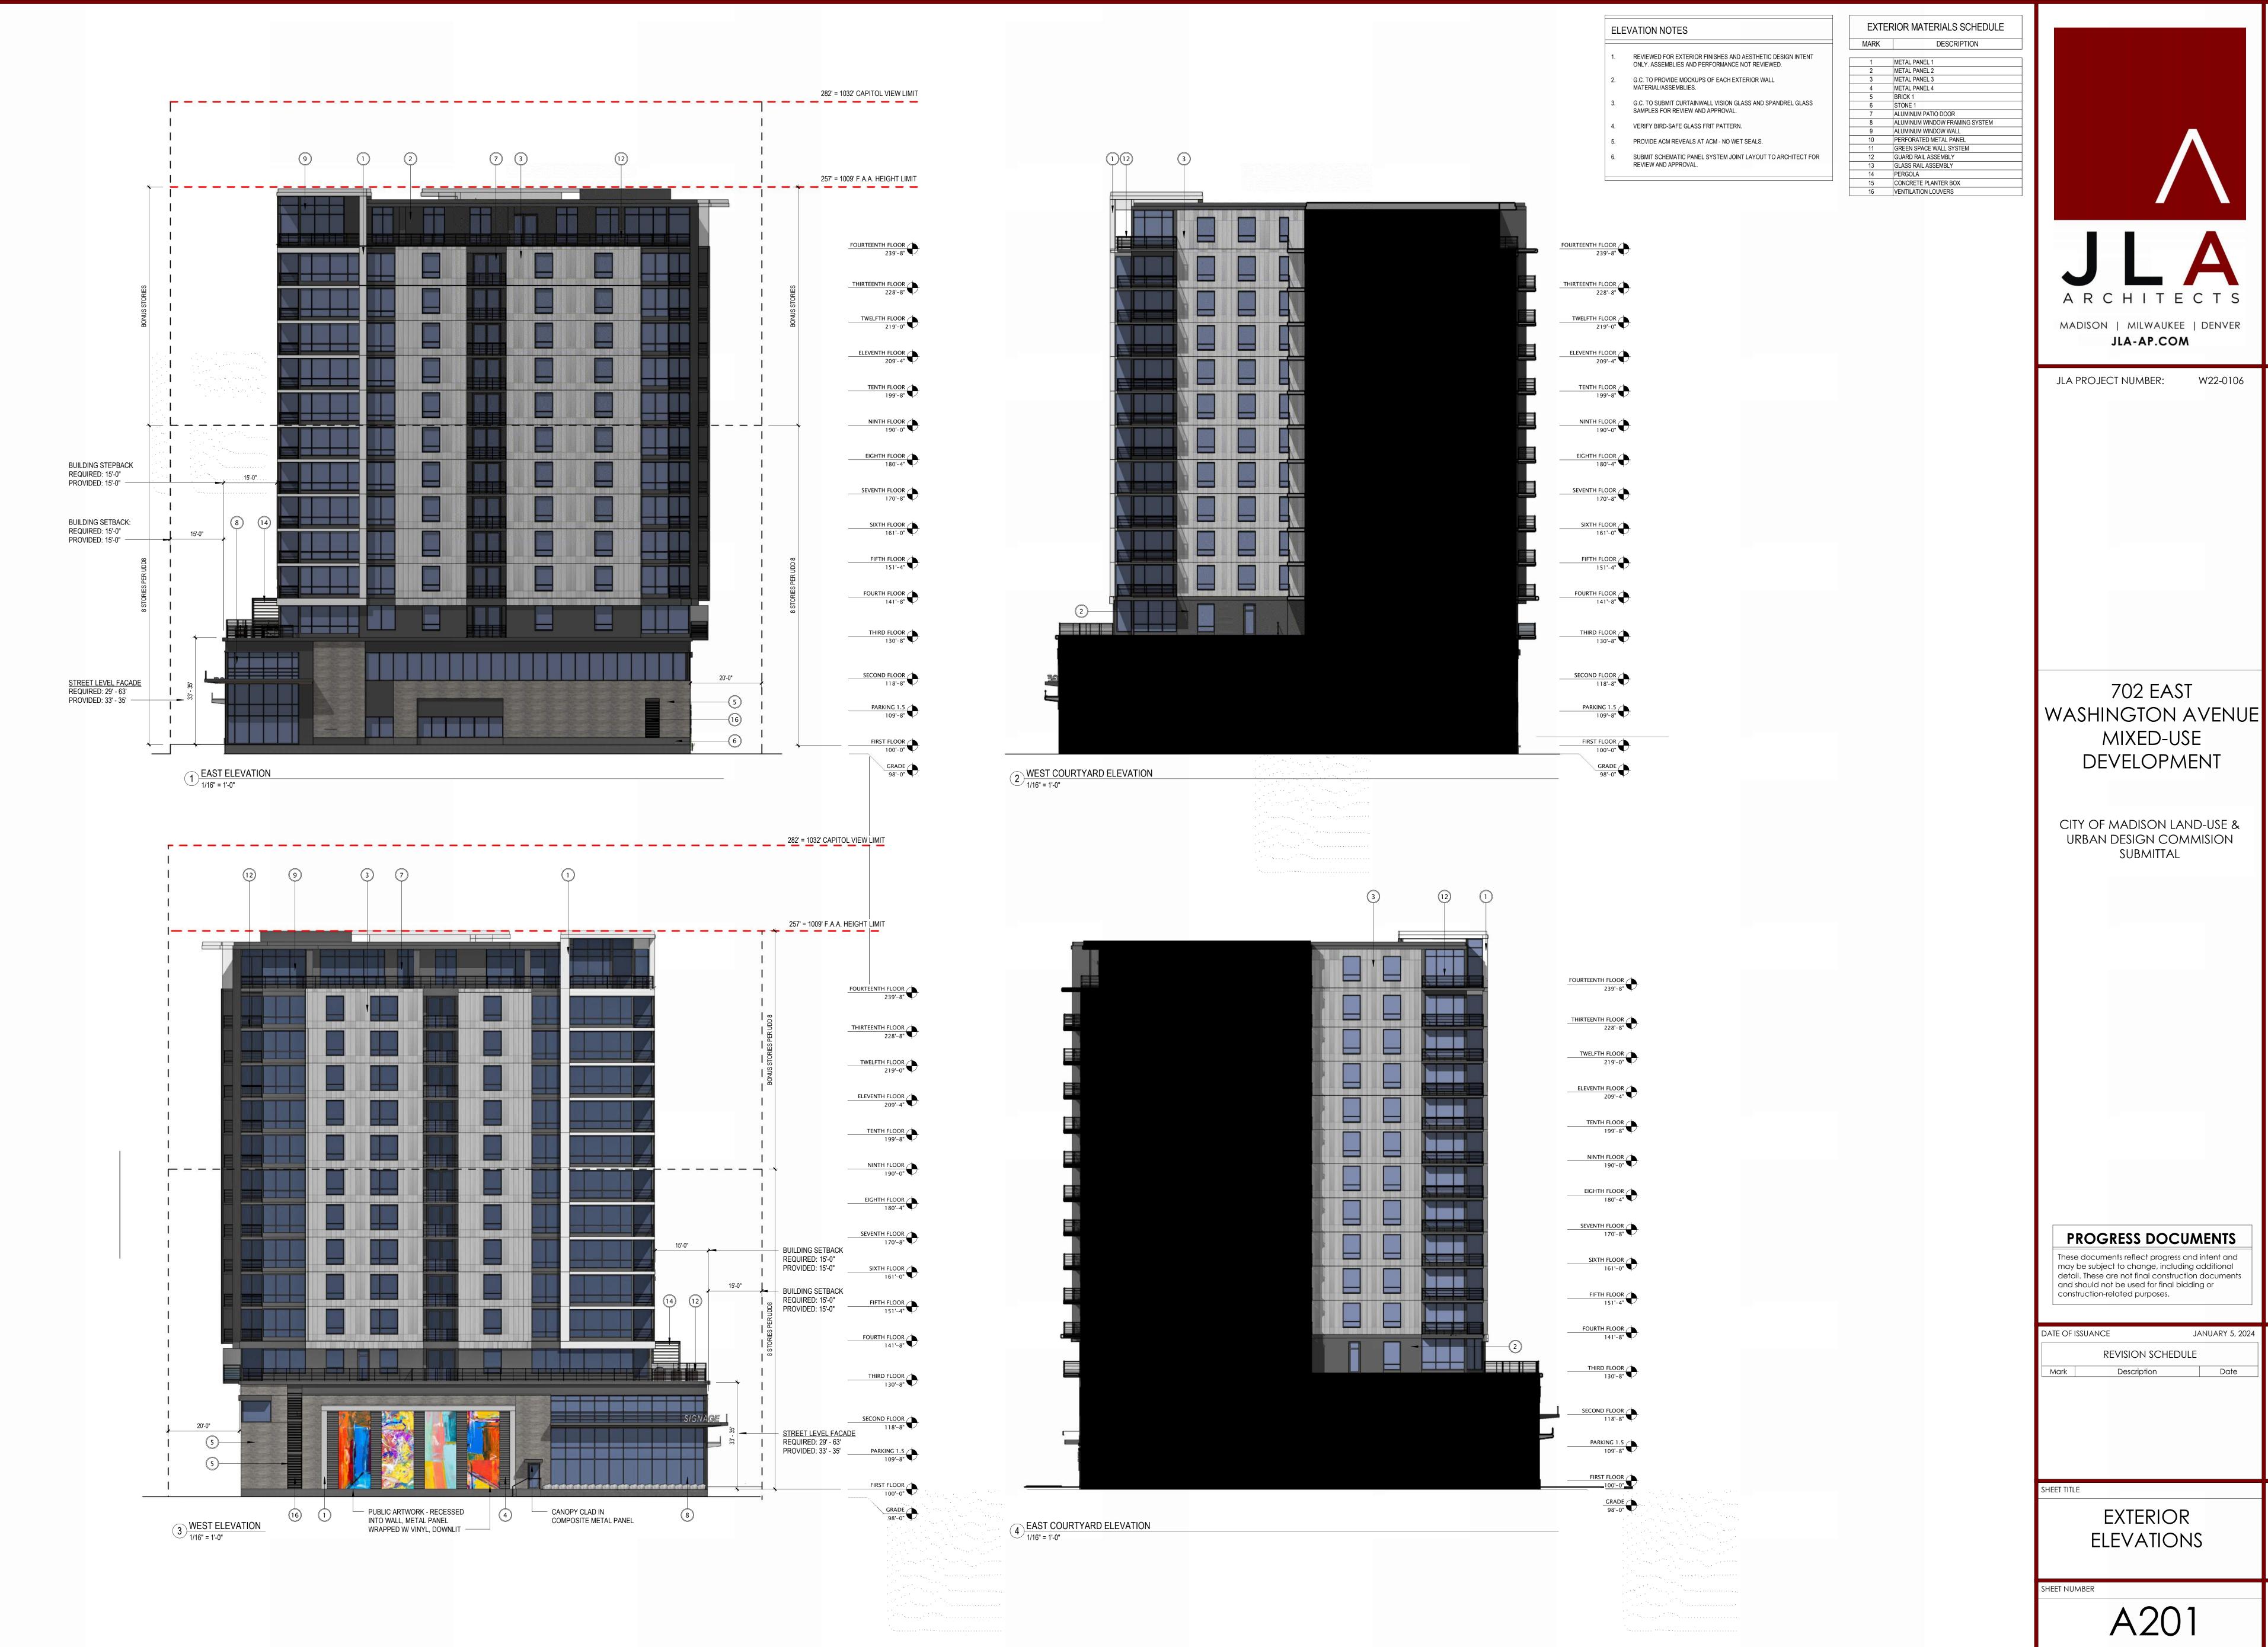
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**EXTERIOR** ELEVATIONS






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## EXTERIOR MATERIALS SCHEDULE DESCRIPTION

METAL PANEL 2 METAL PANEL 3 METAL PANEL 4 6 STONE 1
7 ALUMINUM PATIO DOOR





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**EXTERIOR** ELEVATIONS

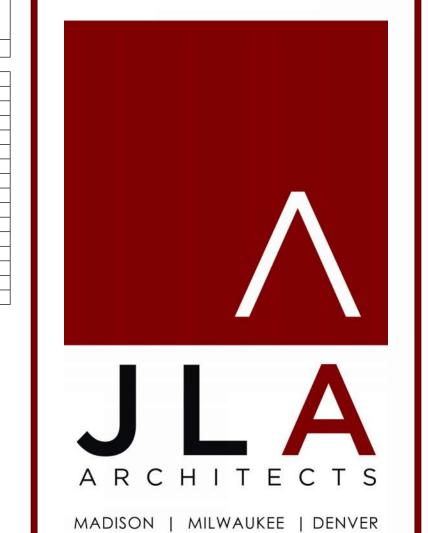