

GRAEF NOTES

1. THE BASE SURVEY WAS PREPARED BY VIERBICHER IN 2019. ALL UNDERGROUND UTILITIES AND STRUCTURES HAVE BEEN SHOWN TO A REASONABLE DEGREE OF ACCURACY AND IT SHALL BE THE CONTRACTOR'S RESPONSIBILITY TO VERIFY THEIR EXACT LOCATION AND TO AVOID DAMAGE THERETO.



JLA PROJECT NUMBER:

GRÆEF

W22-0106

1010 East Washington Avenue, Suite 202 Madison, WI 53703 608 / 242 1550

www.graef-usa.com

702 EAST
WASHINGTON AVENUE
MIXED-USE
DEVELOPMENT

CITY OF MADISON LAND-USE & URBAN DESIGN COMMISSION SUBMITTAL

DATE OF ISSUANCE

JANCE NOVEMBER 27, 2023
REVISION SCHEDULE


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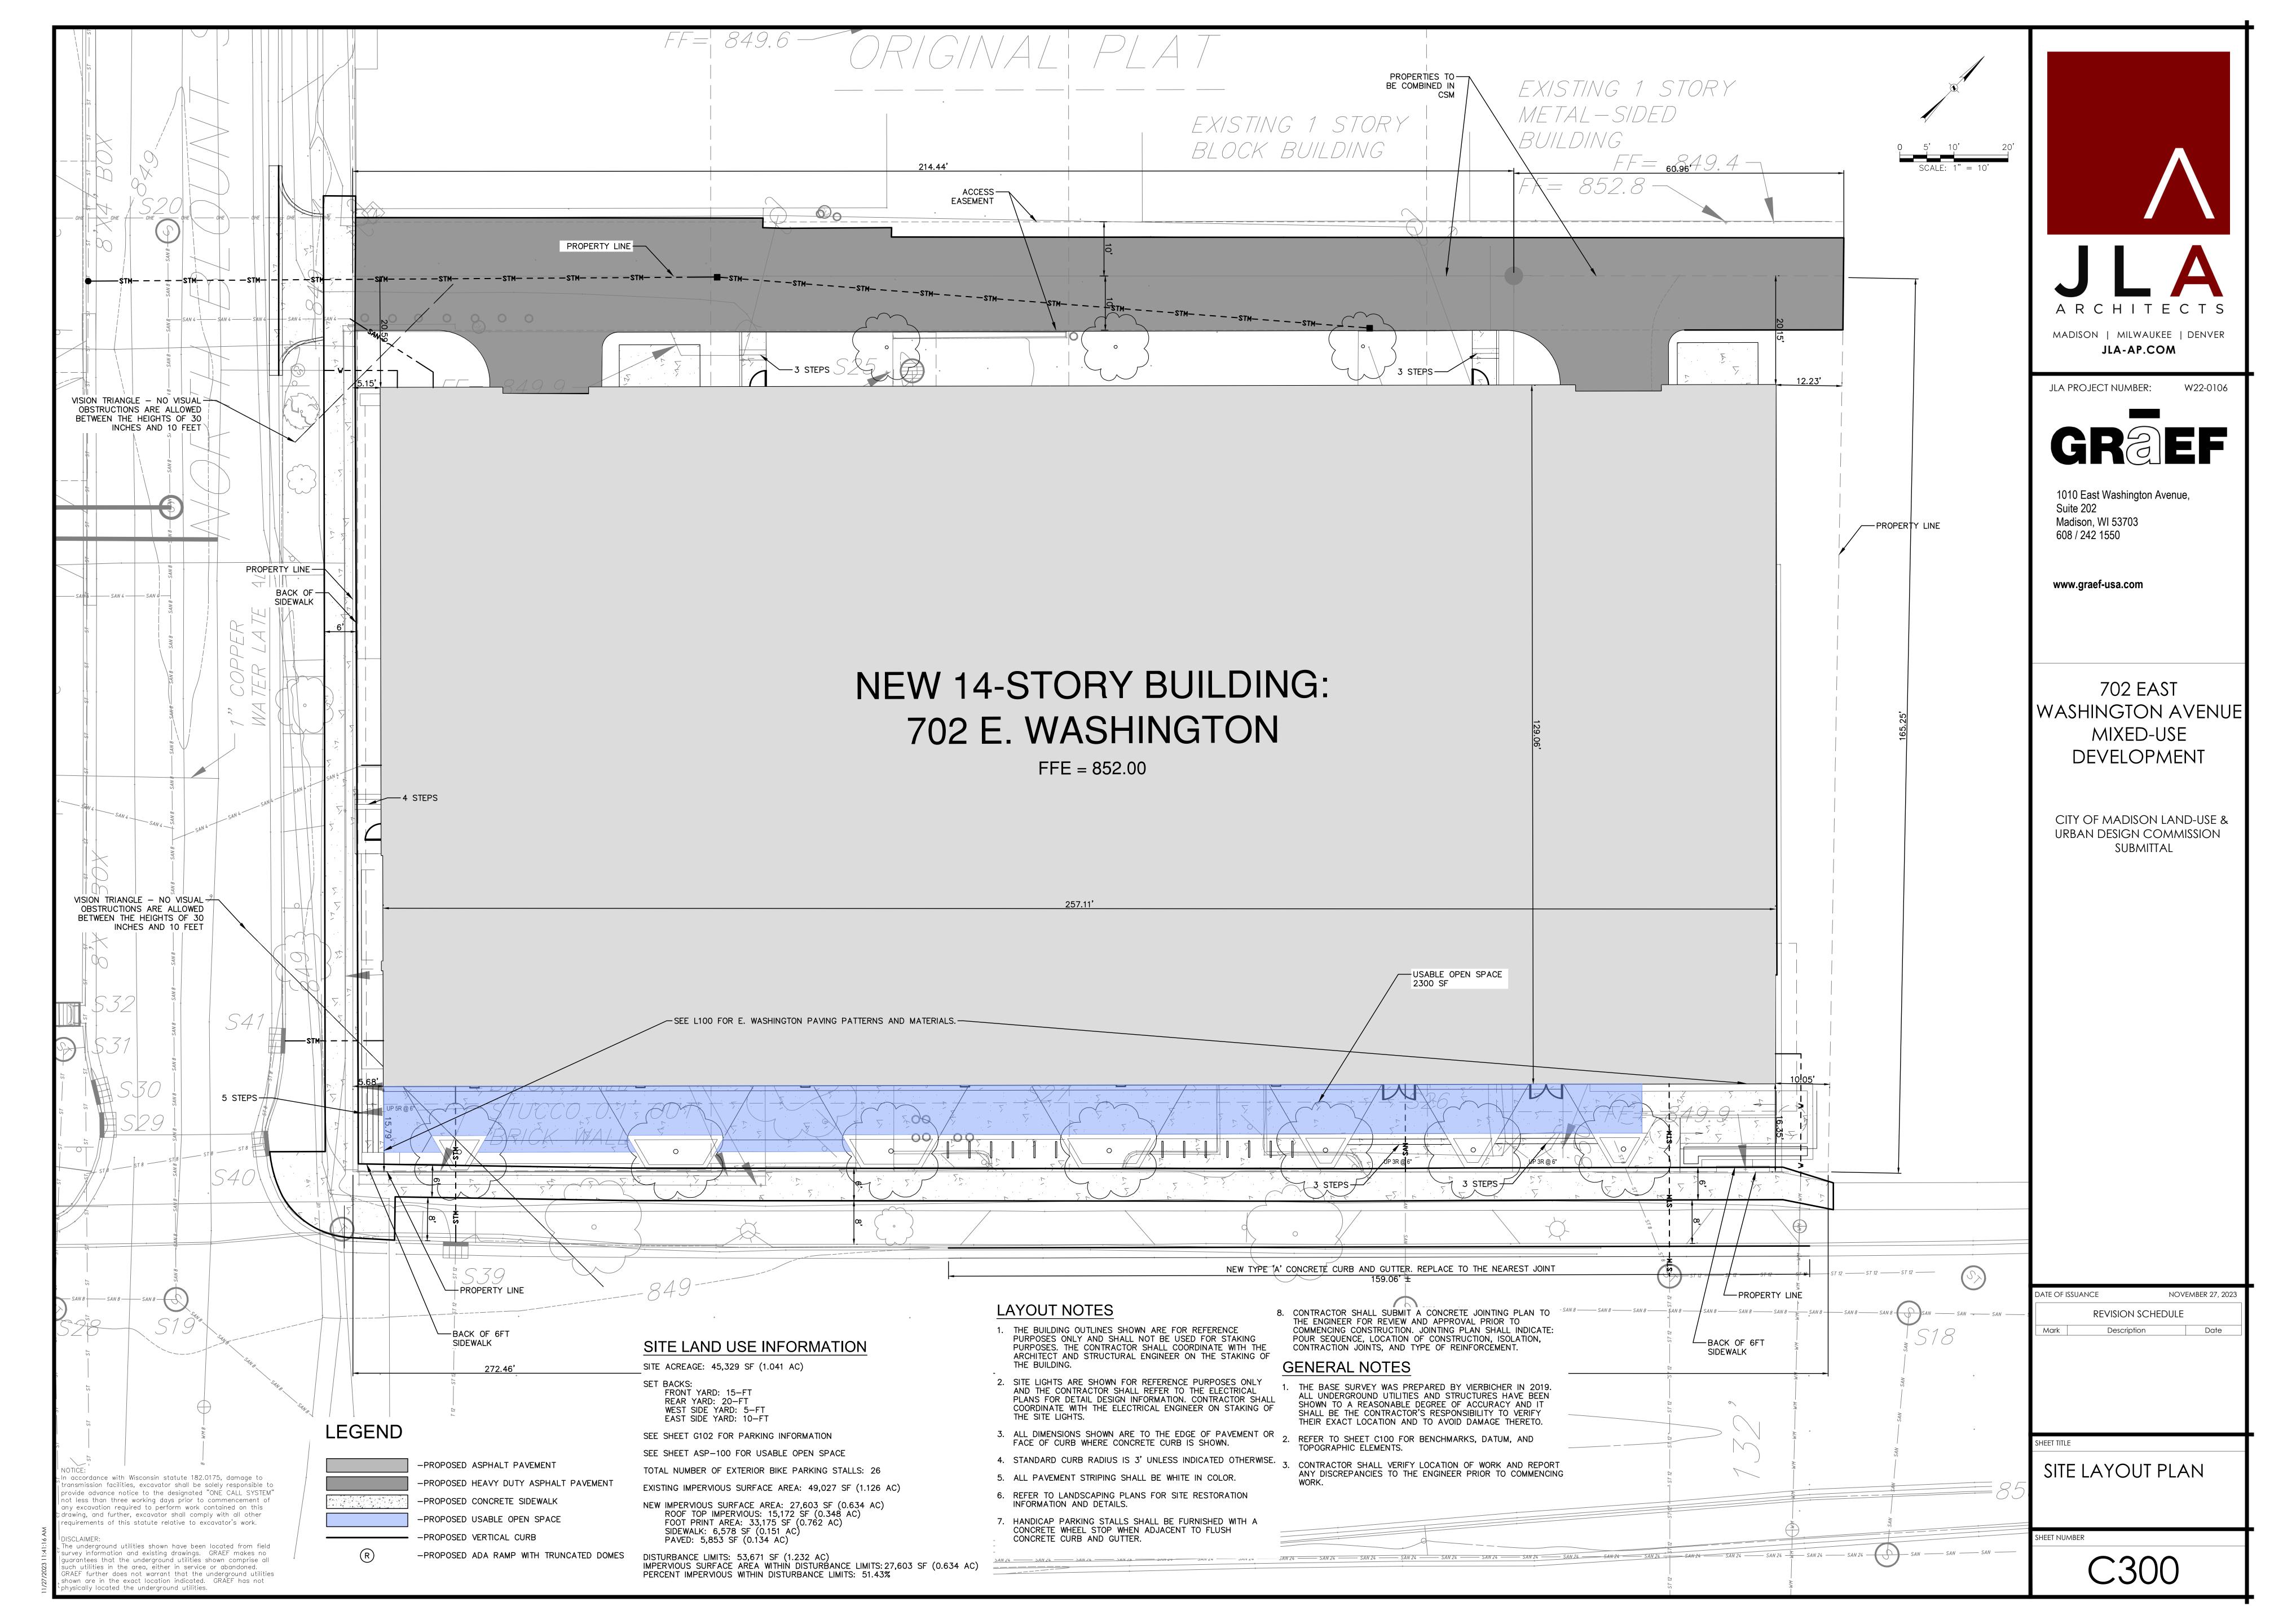
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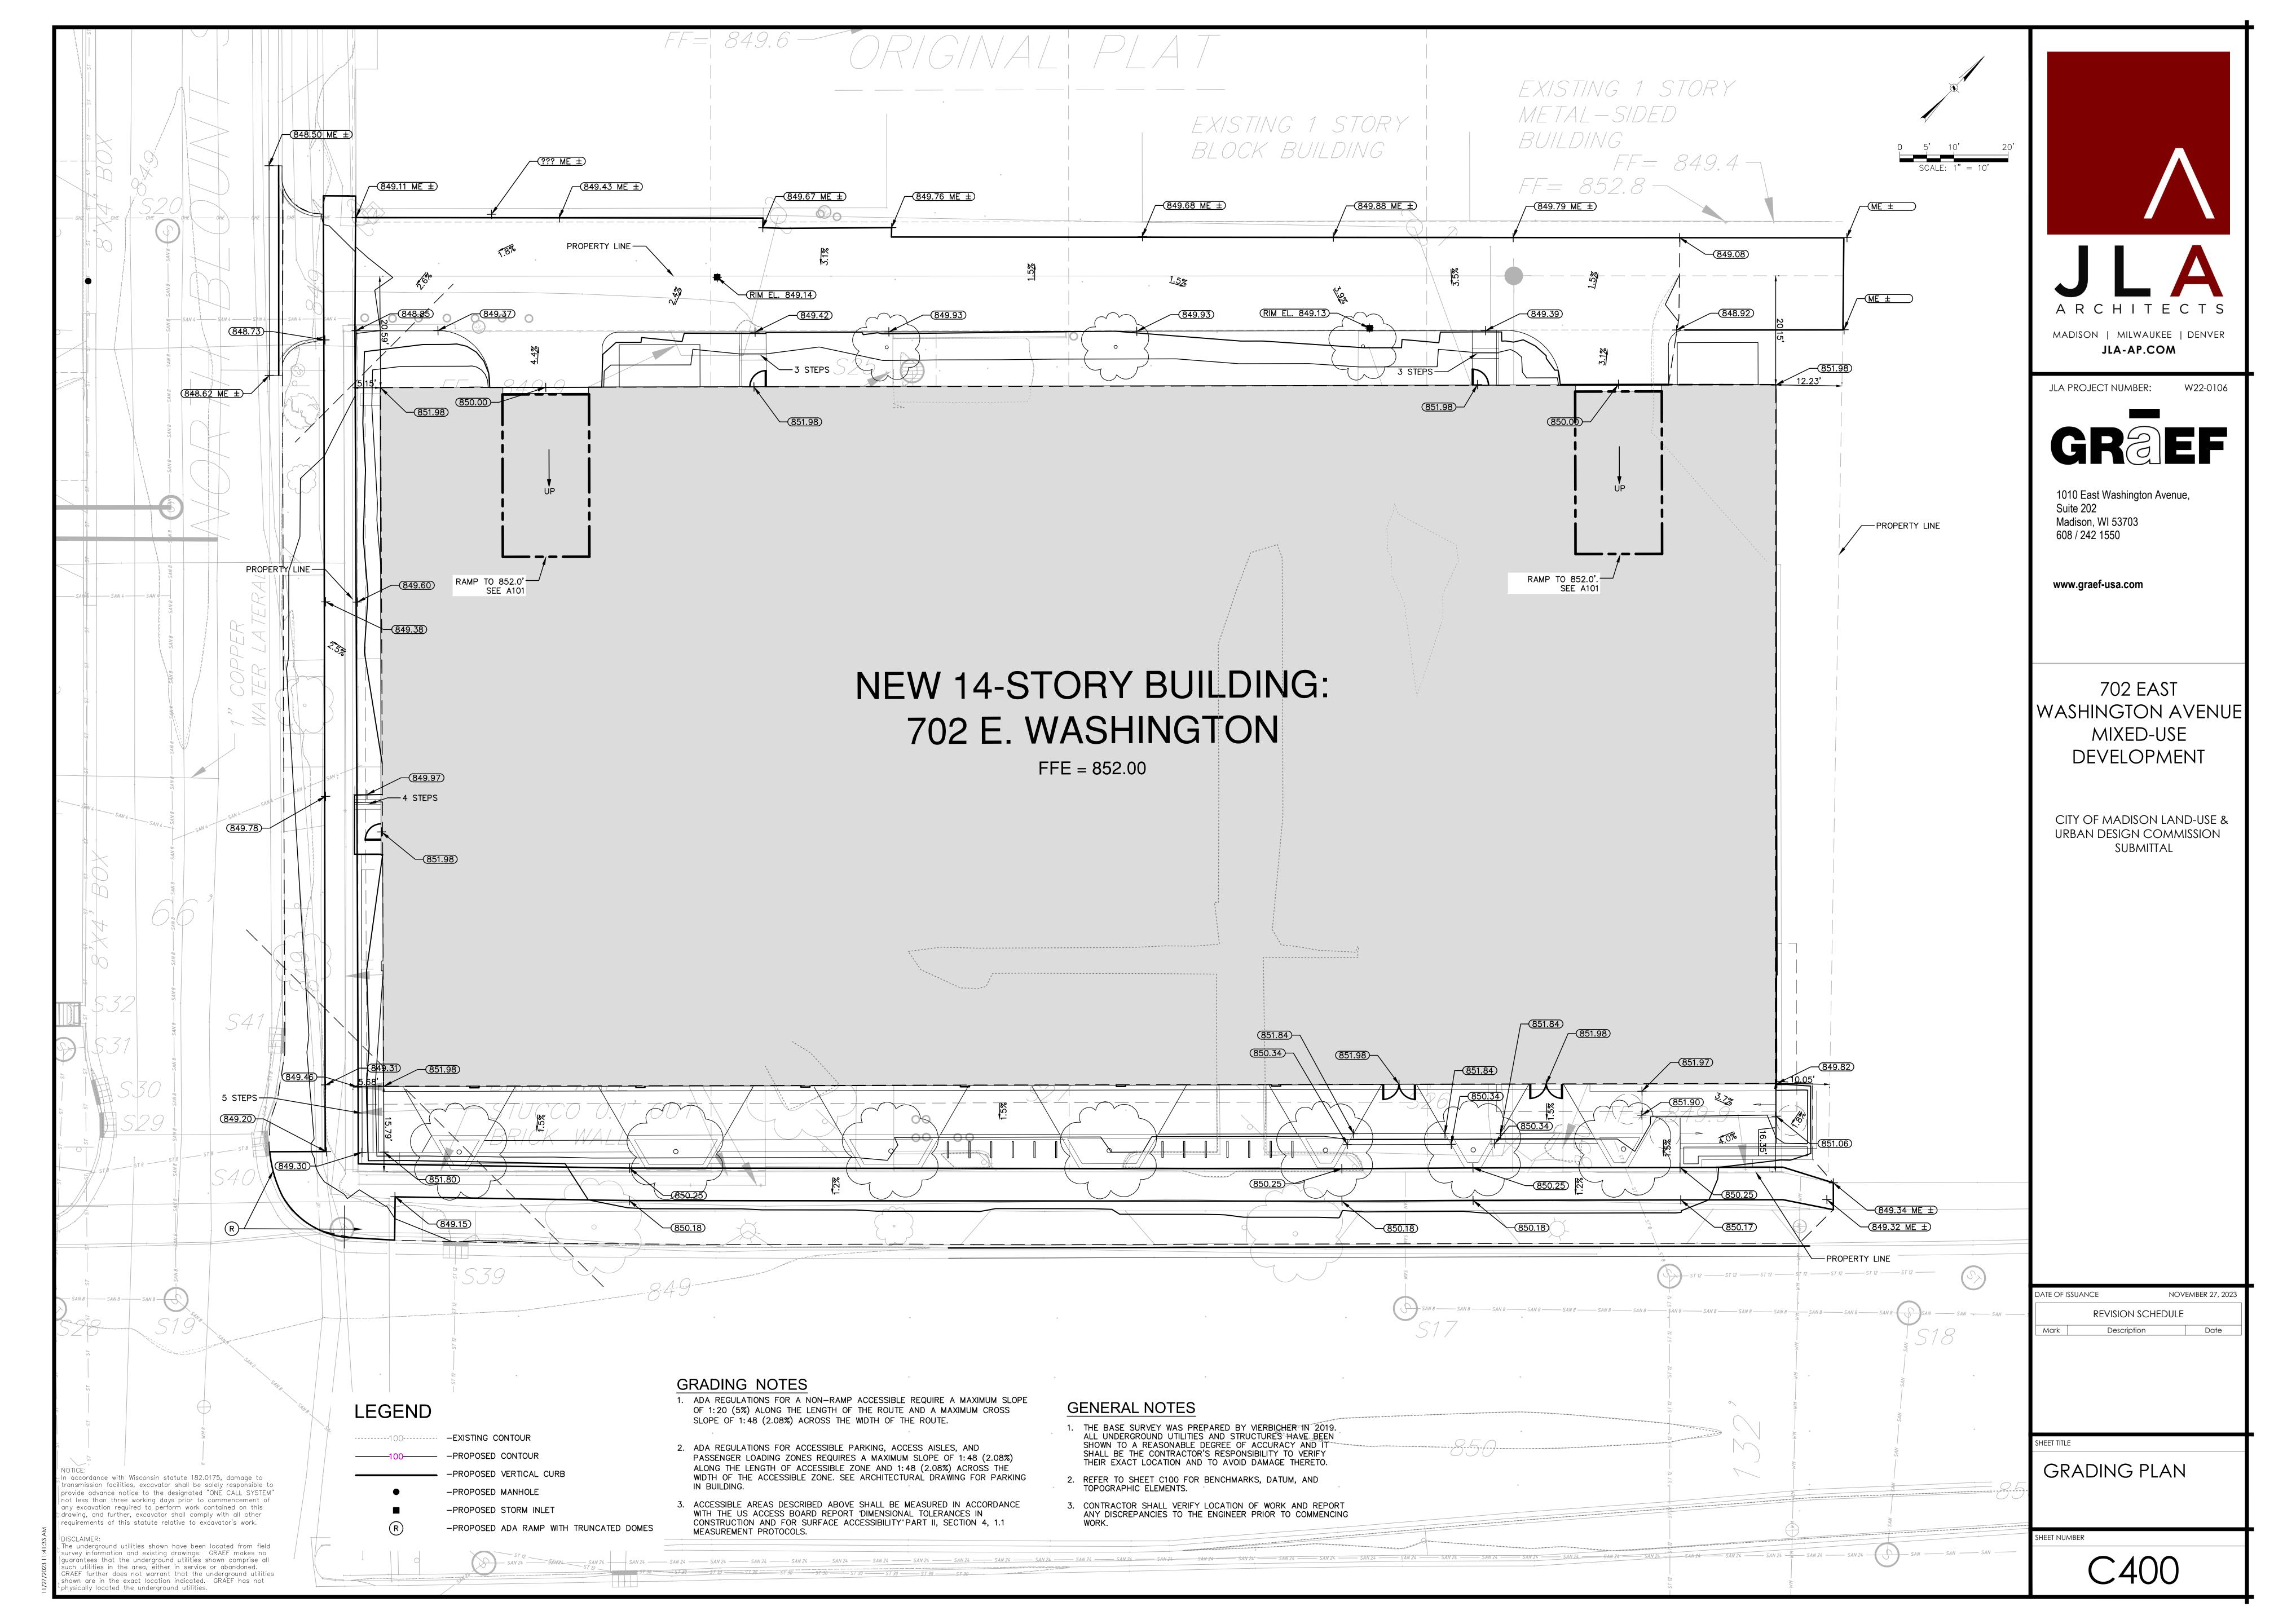
EXISTING CONDITIONS


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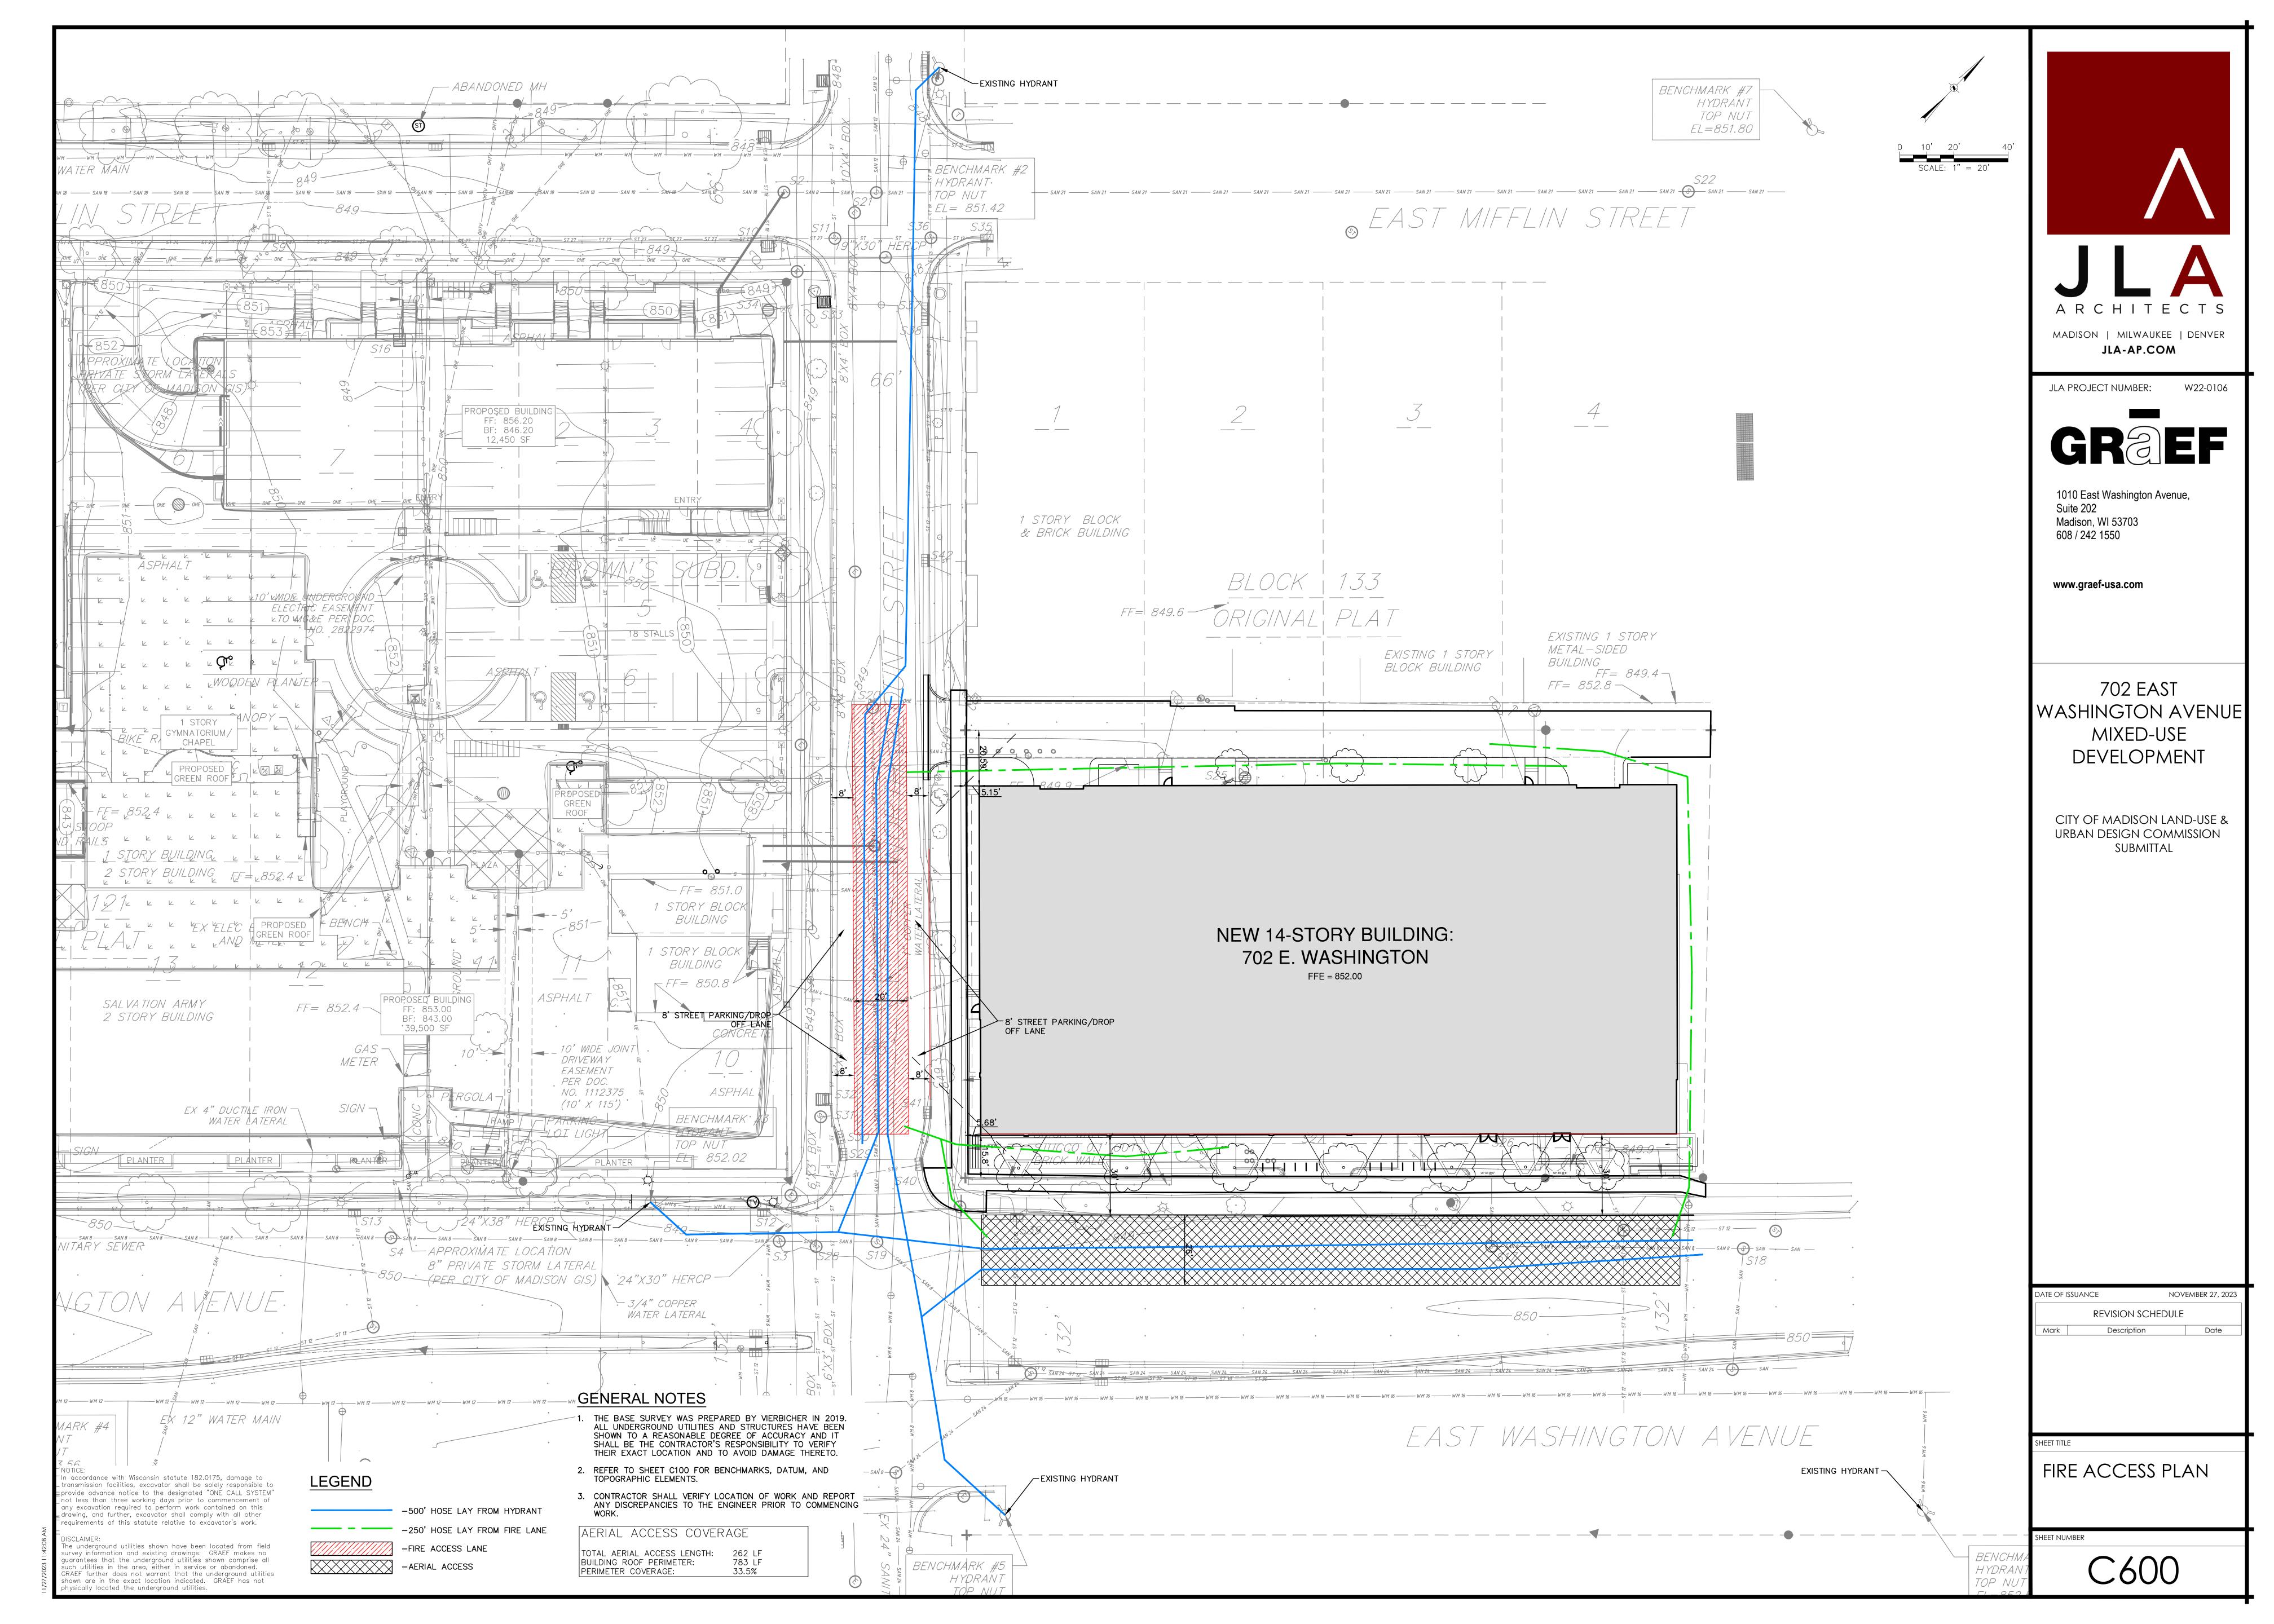
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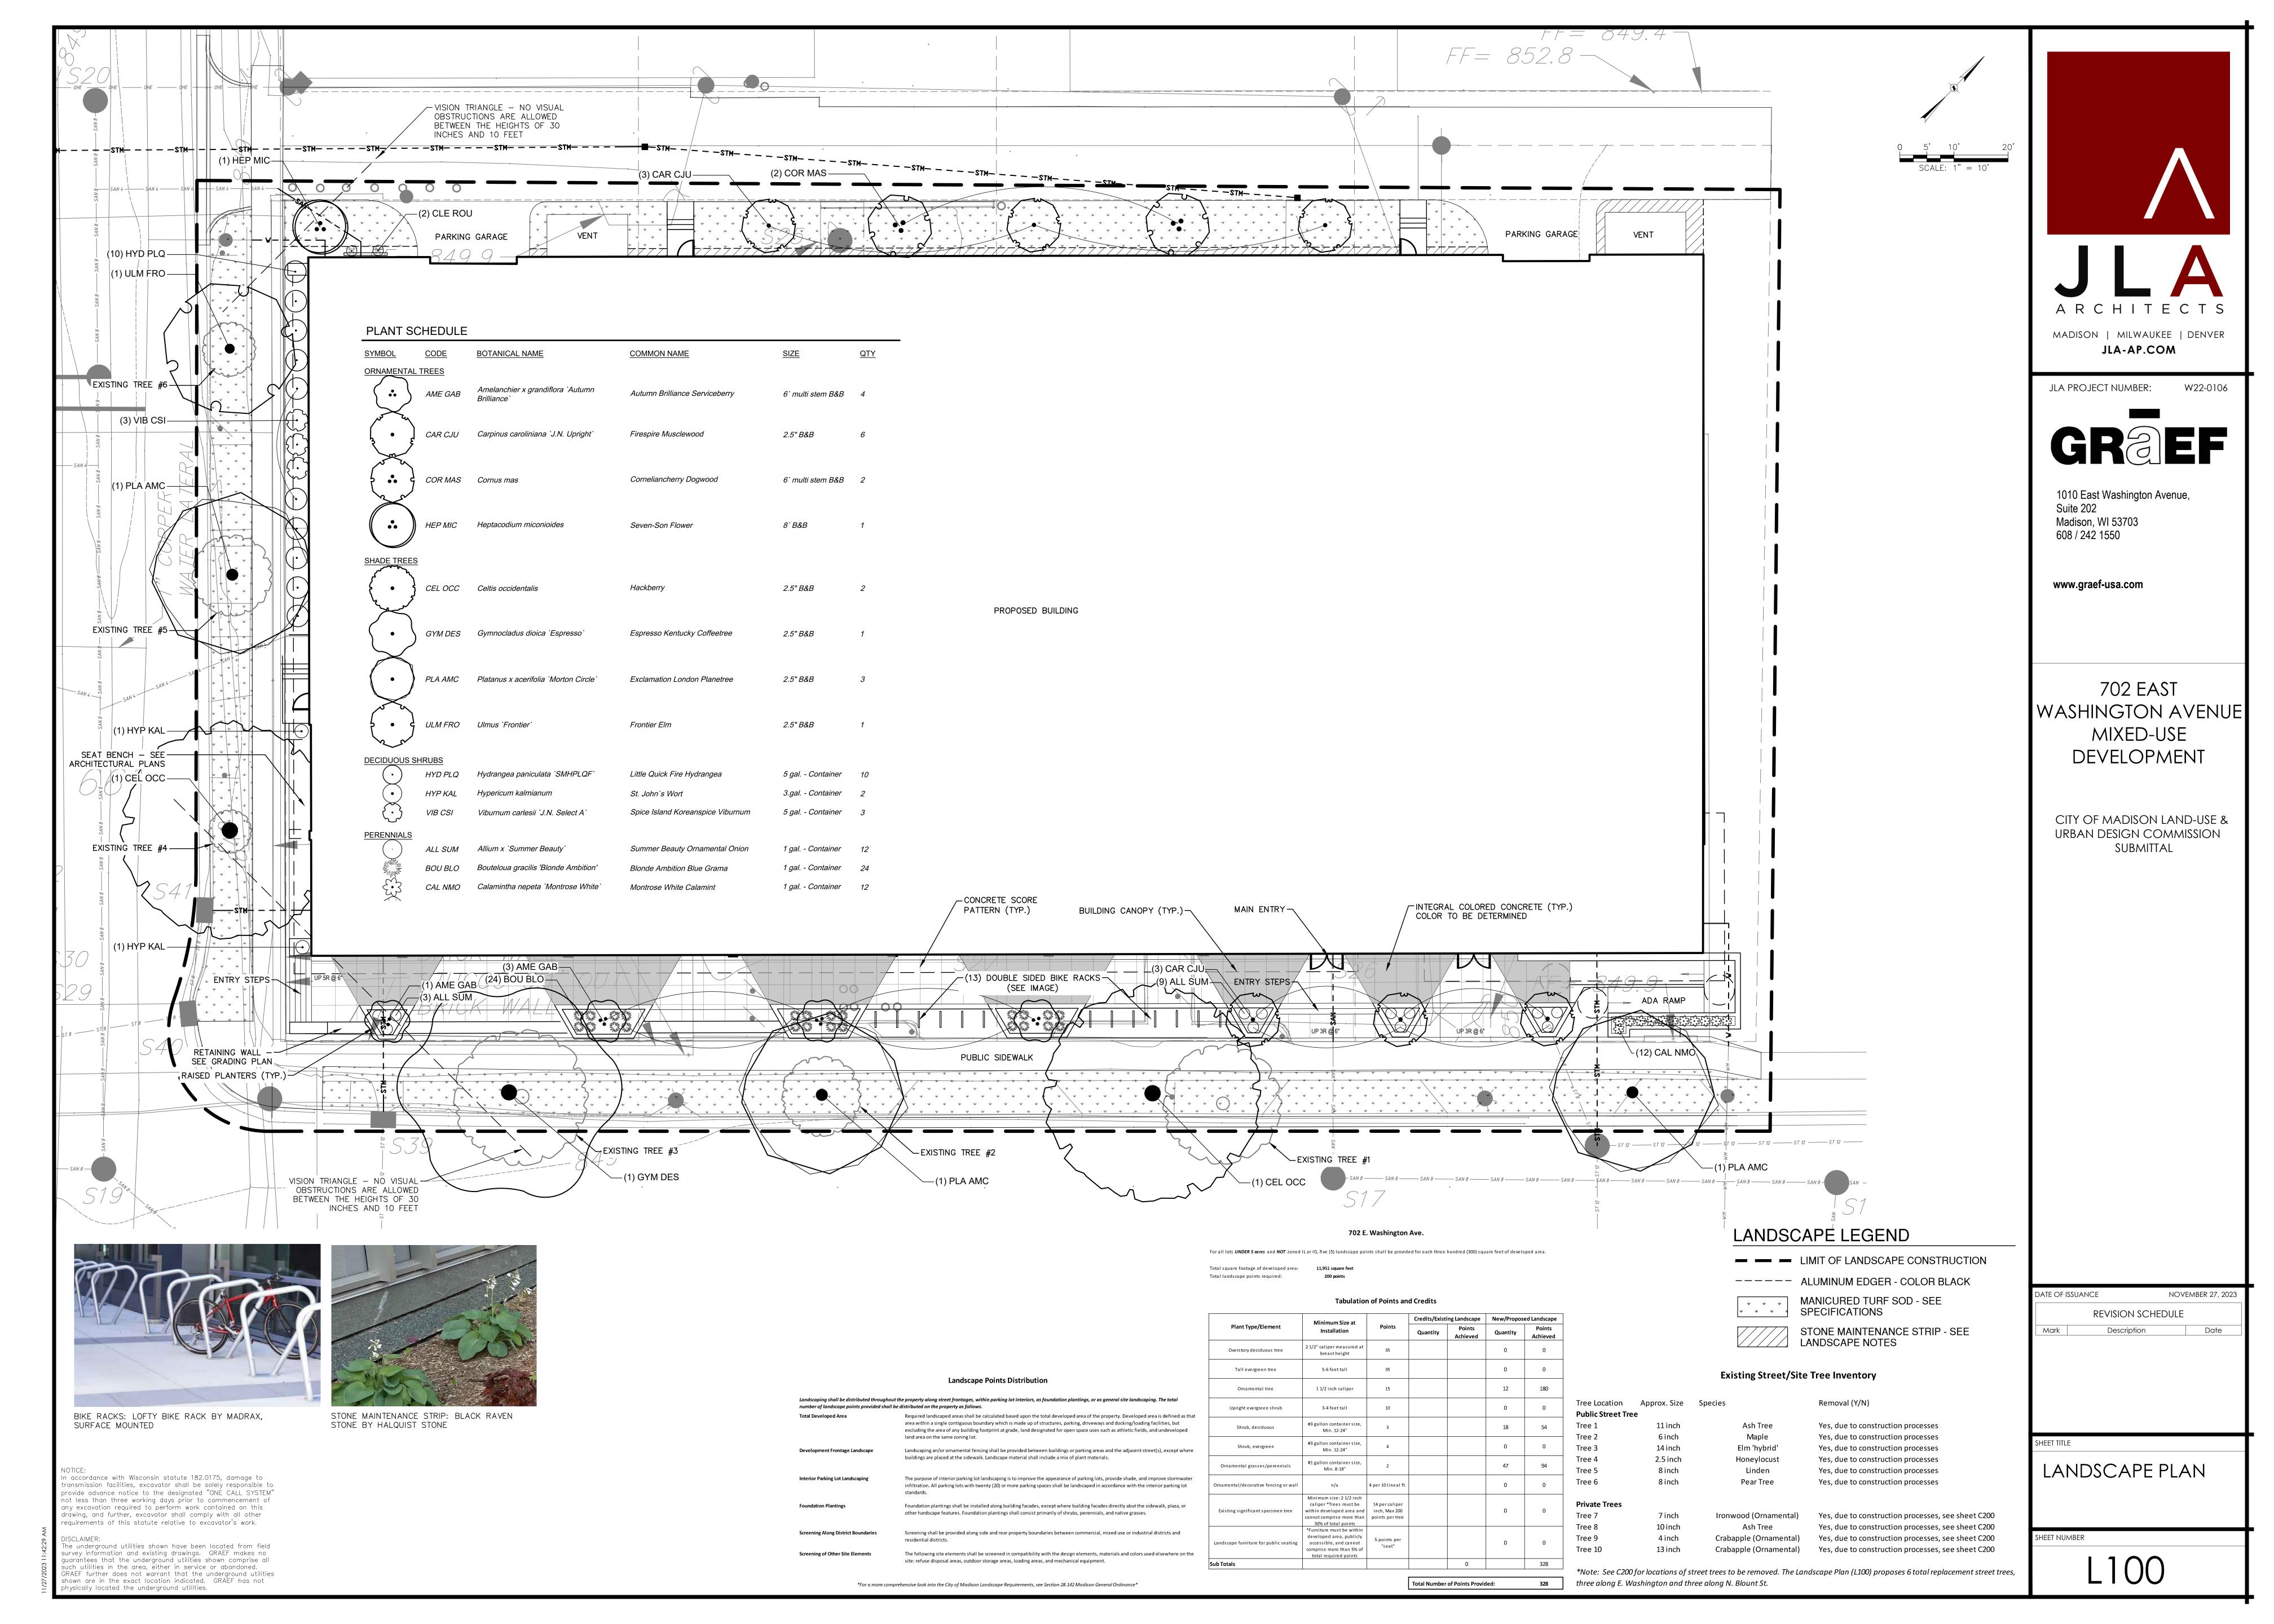









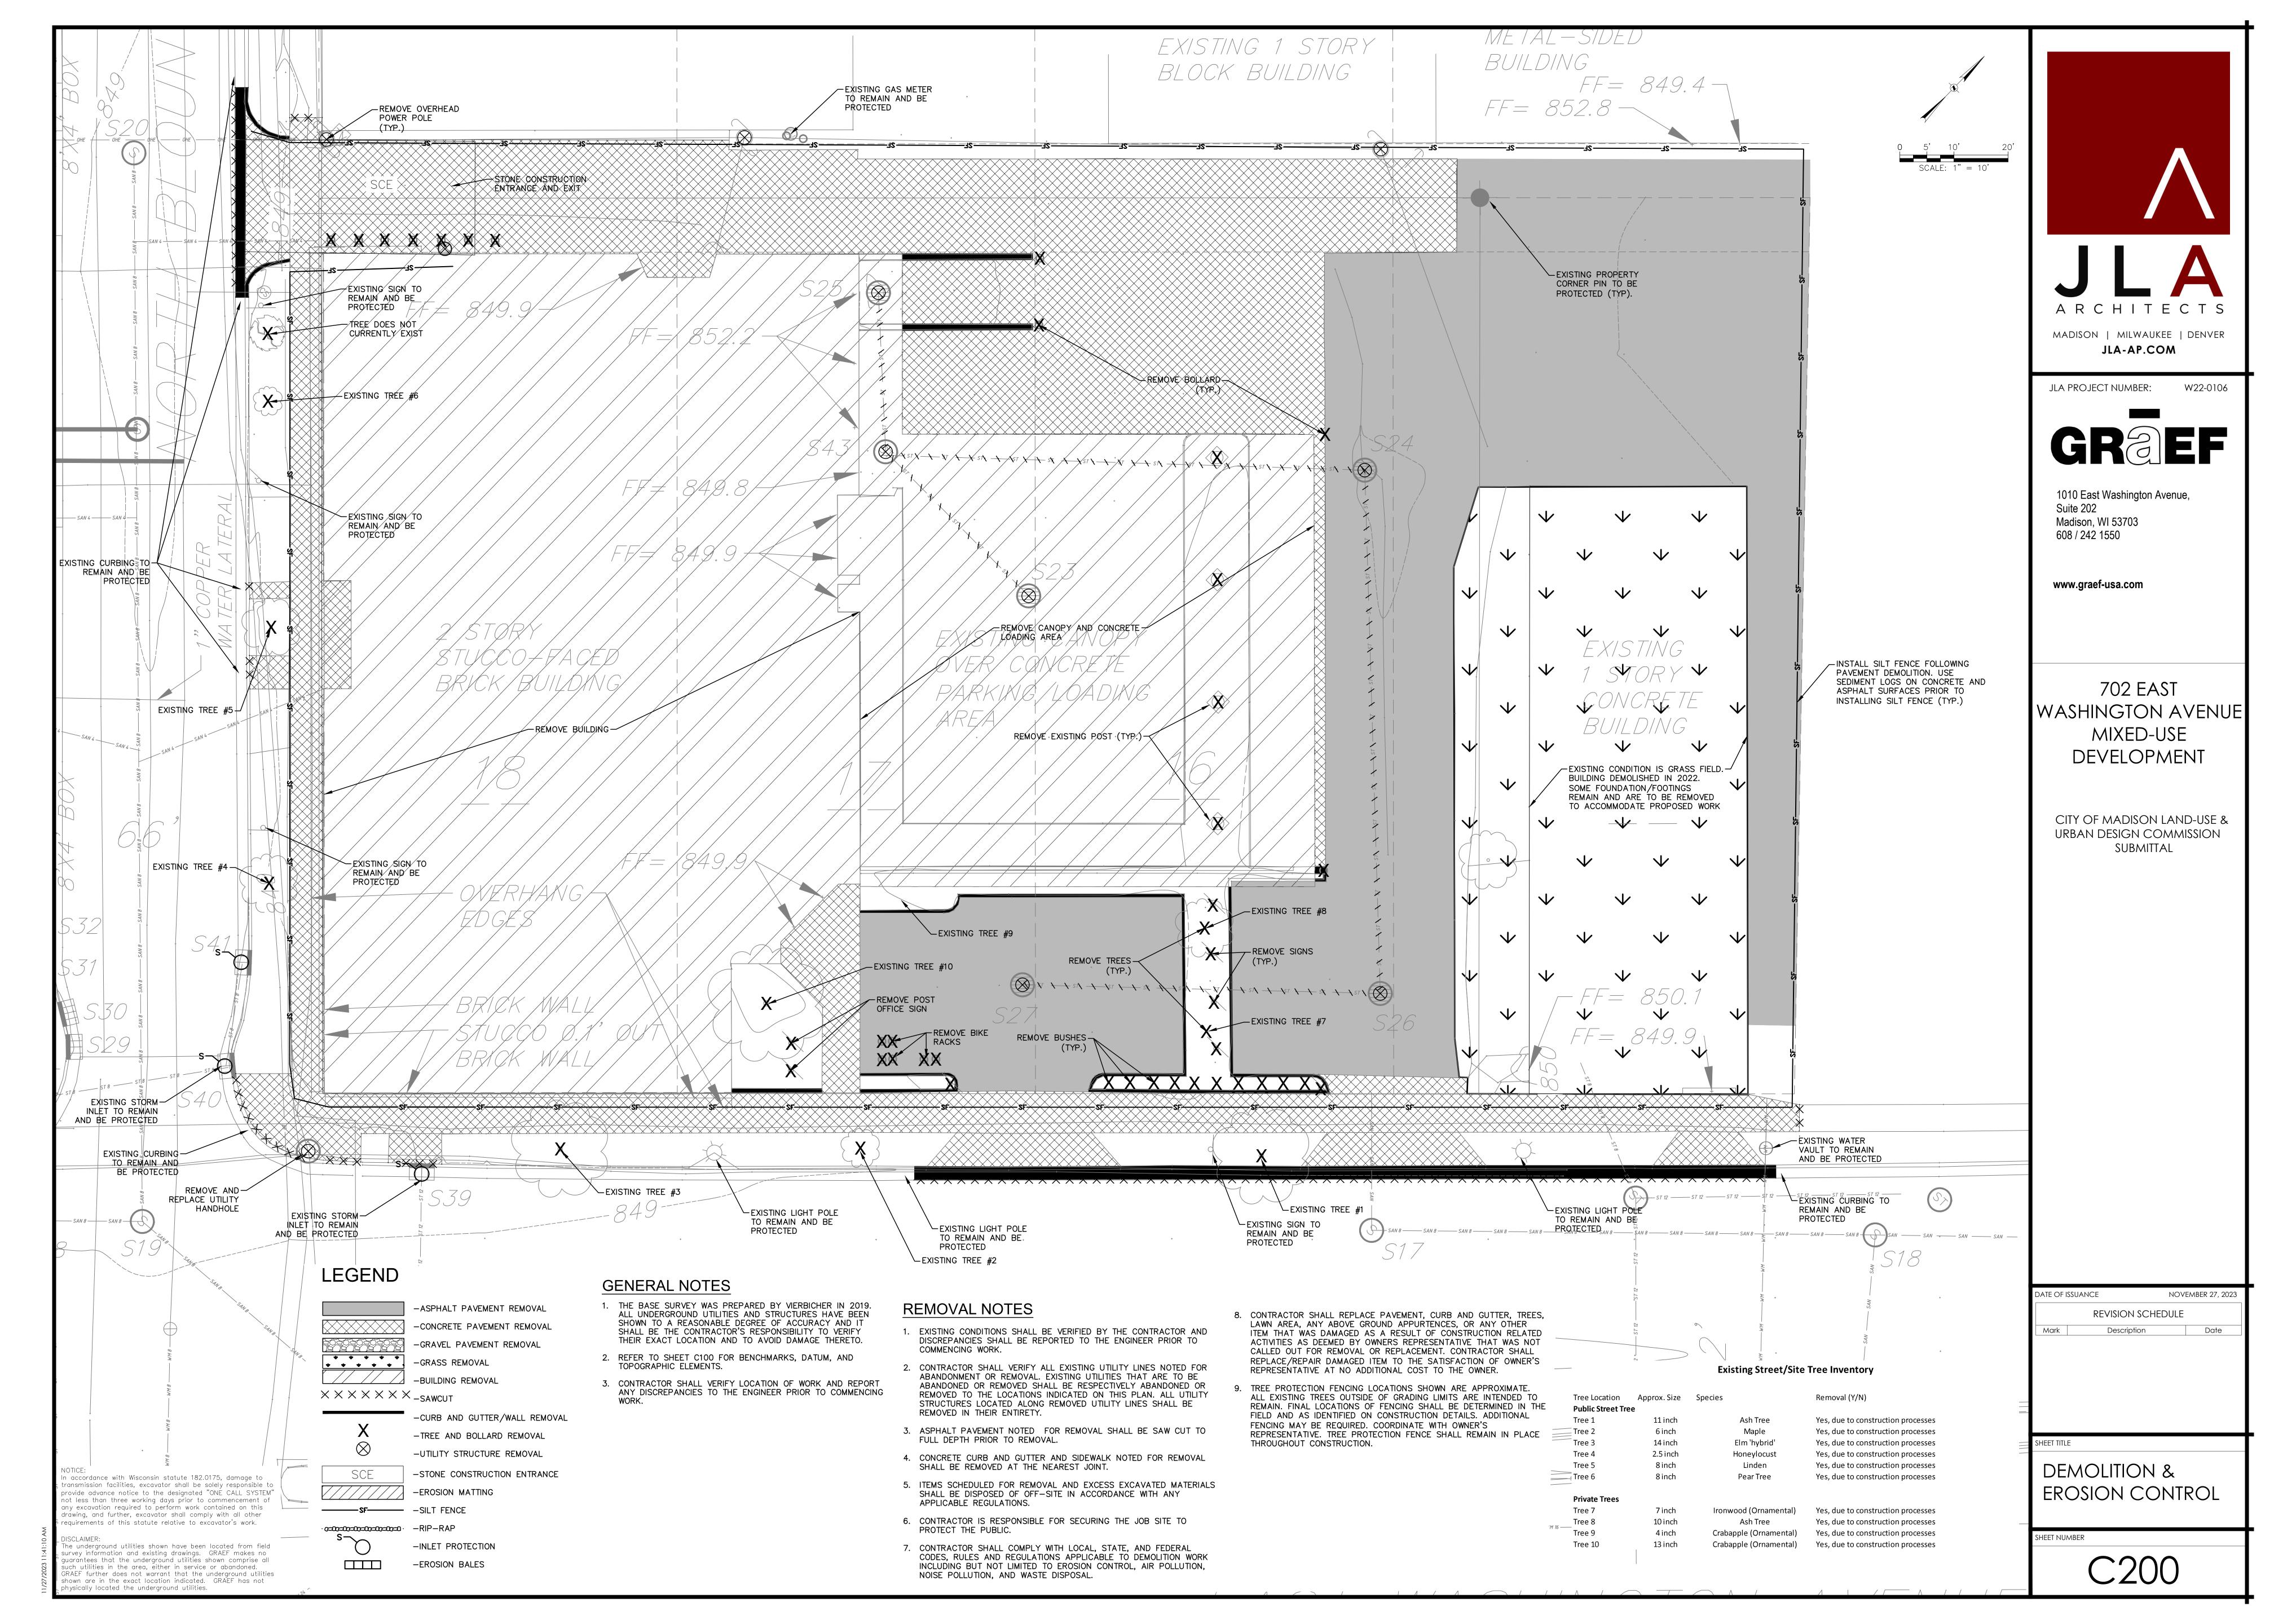

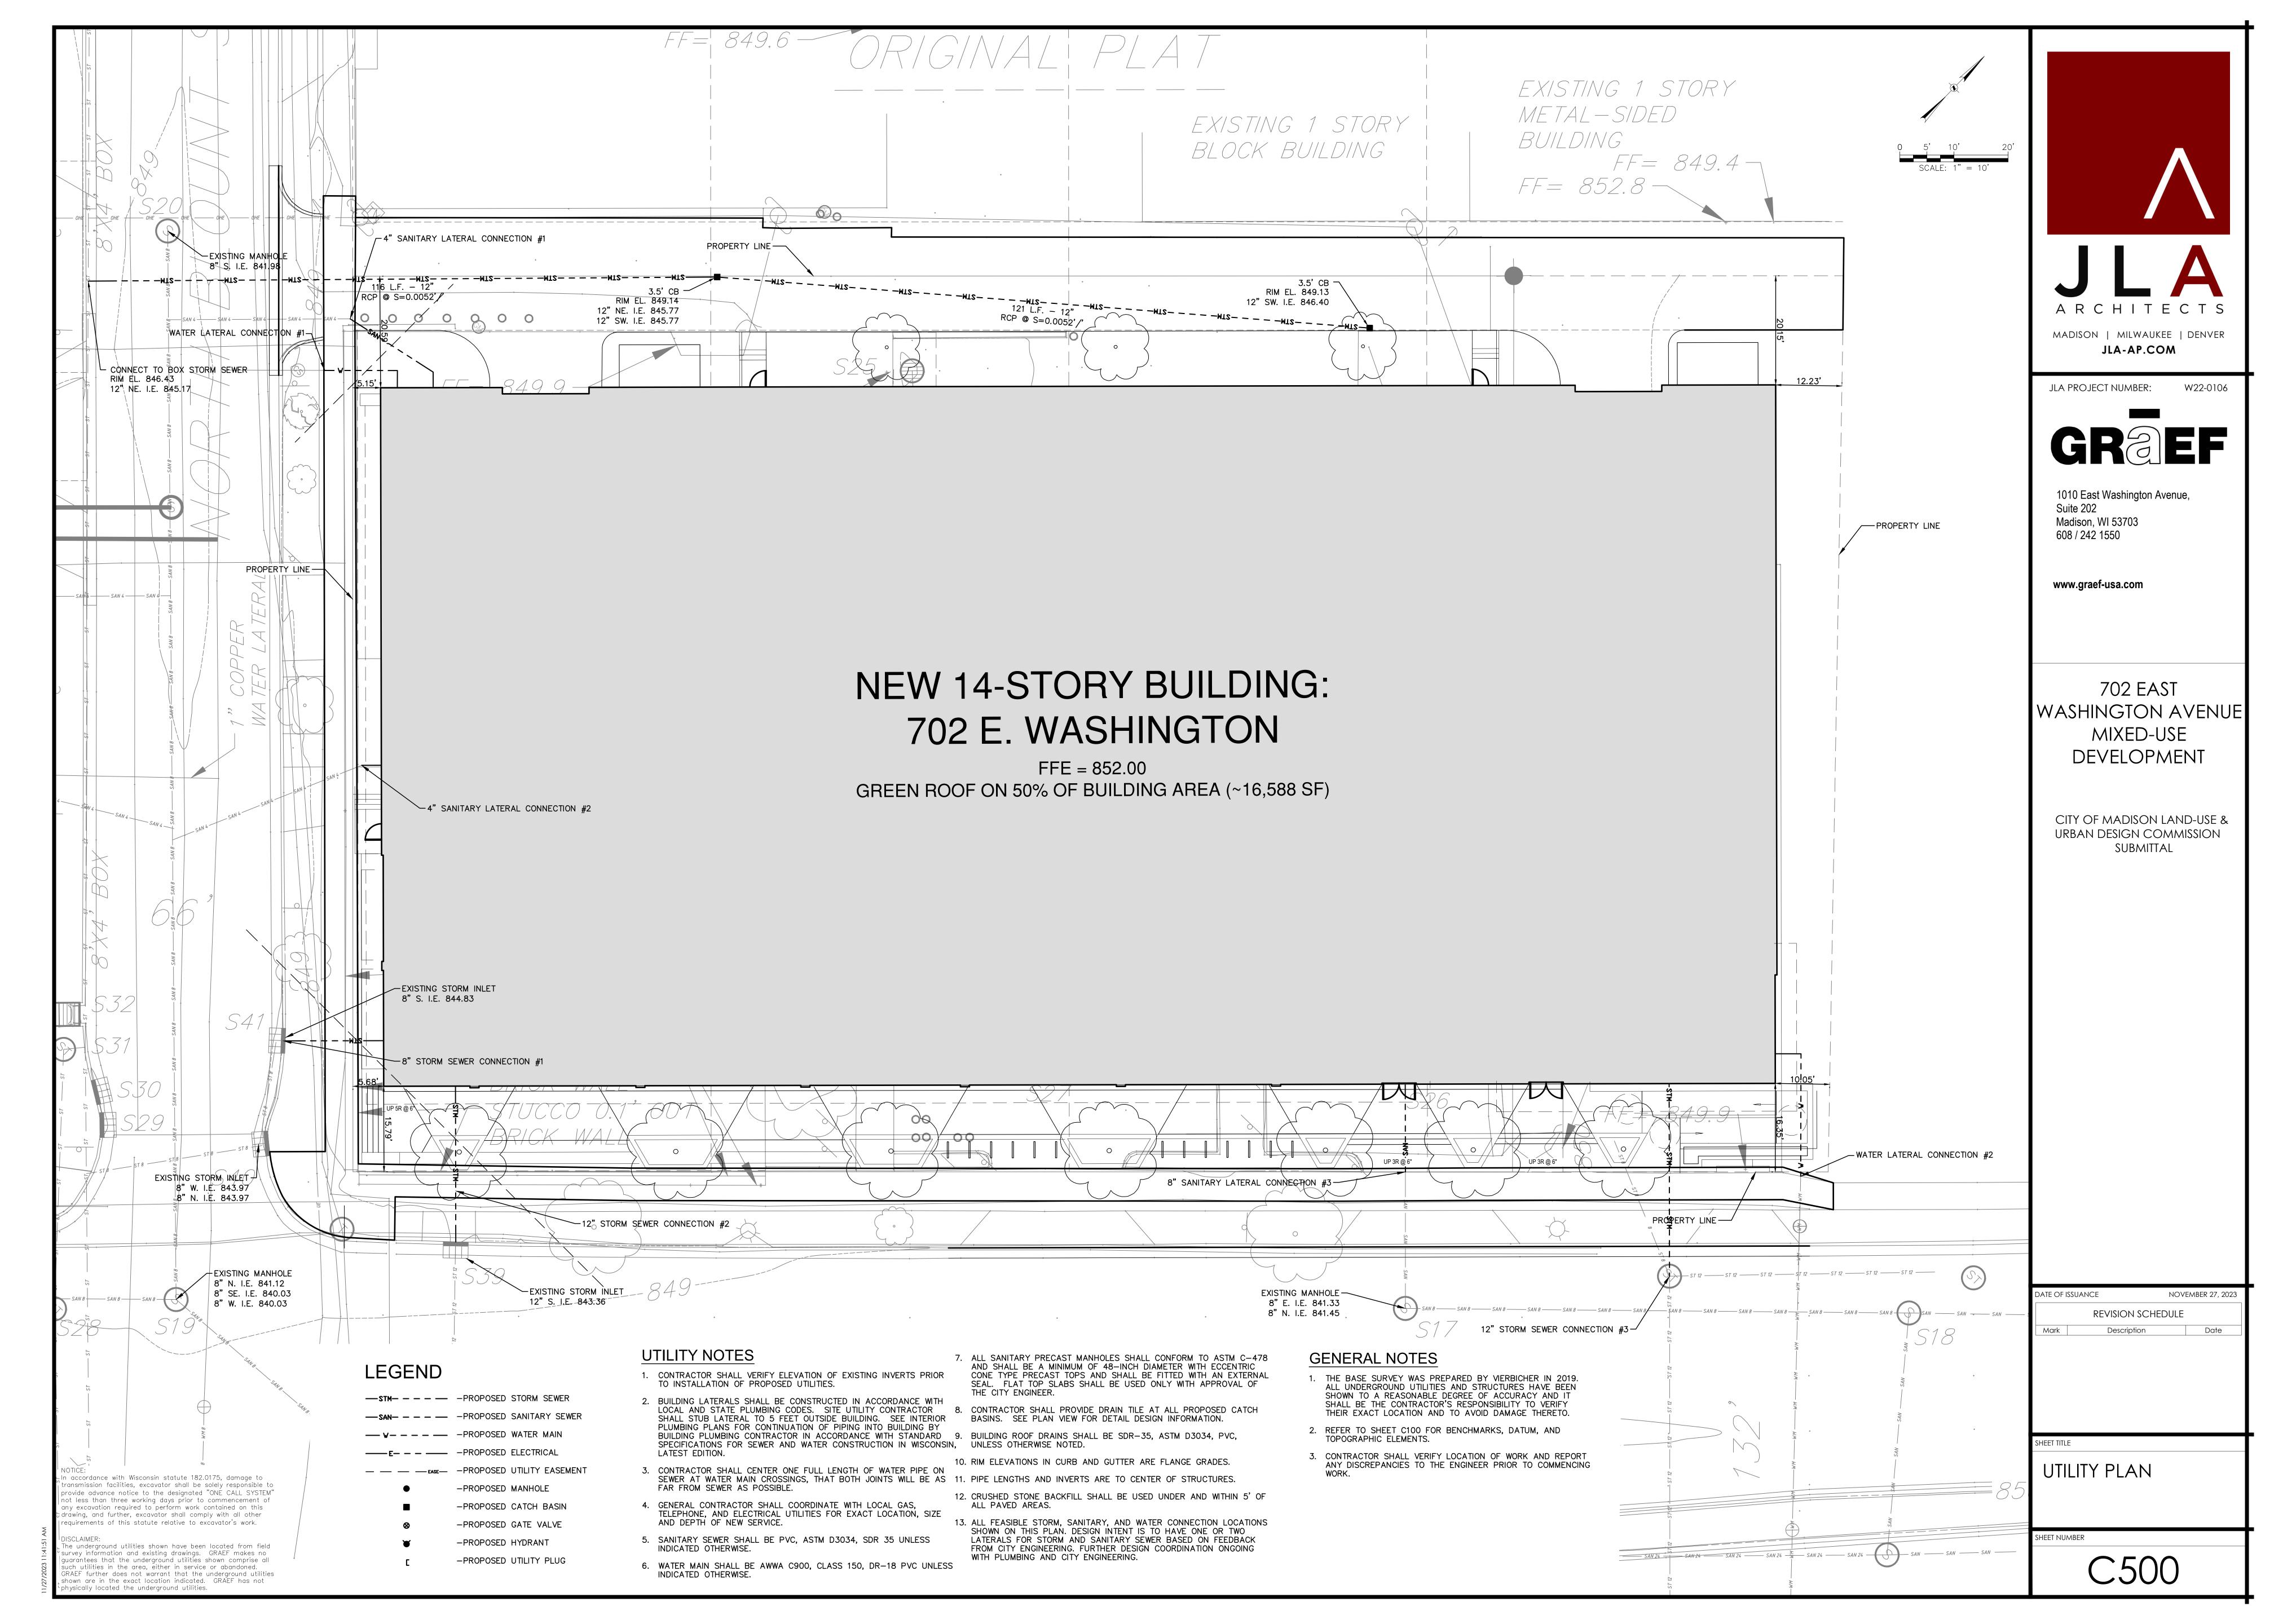

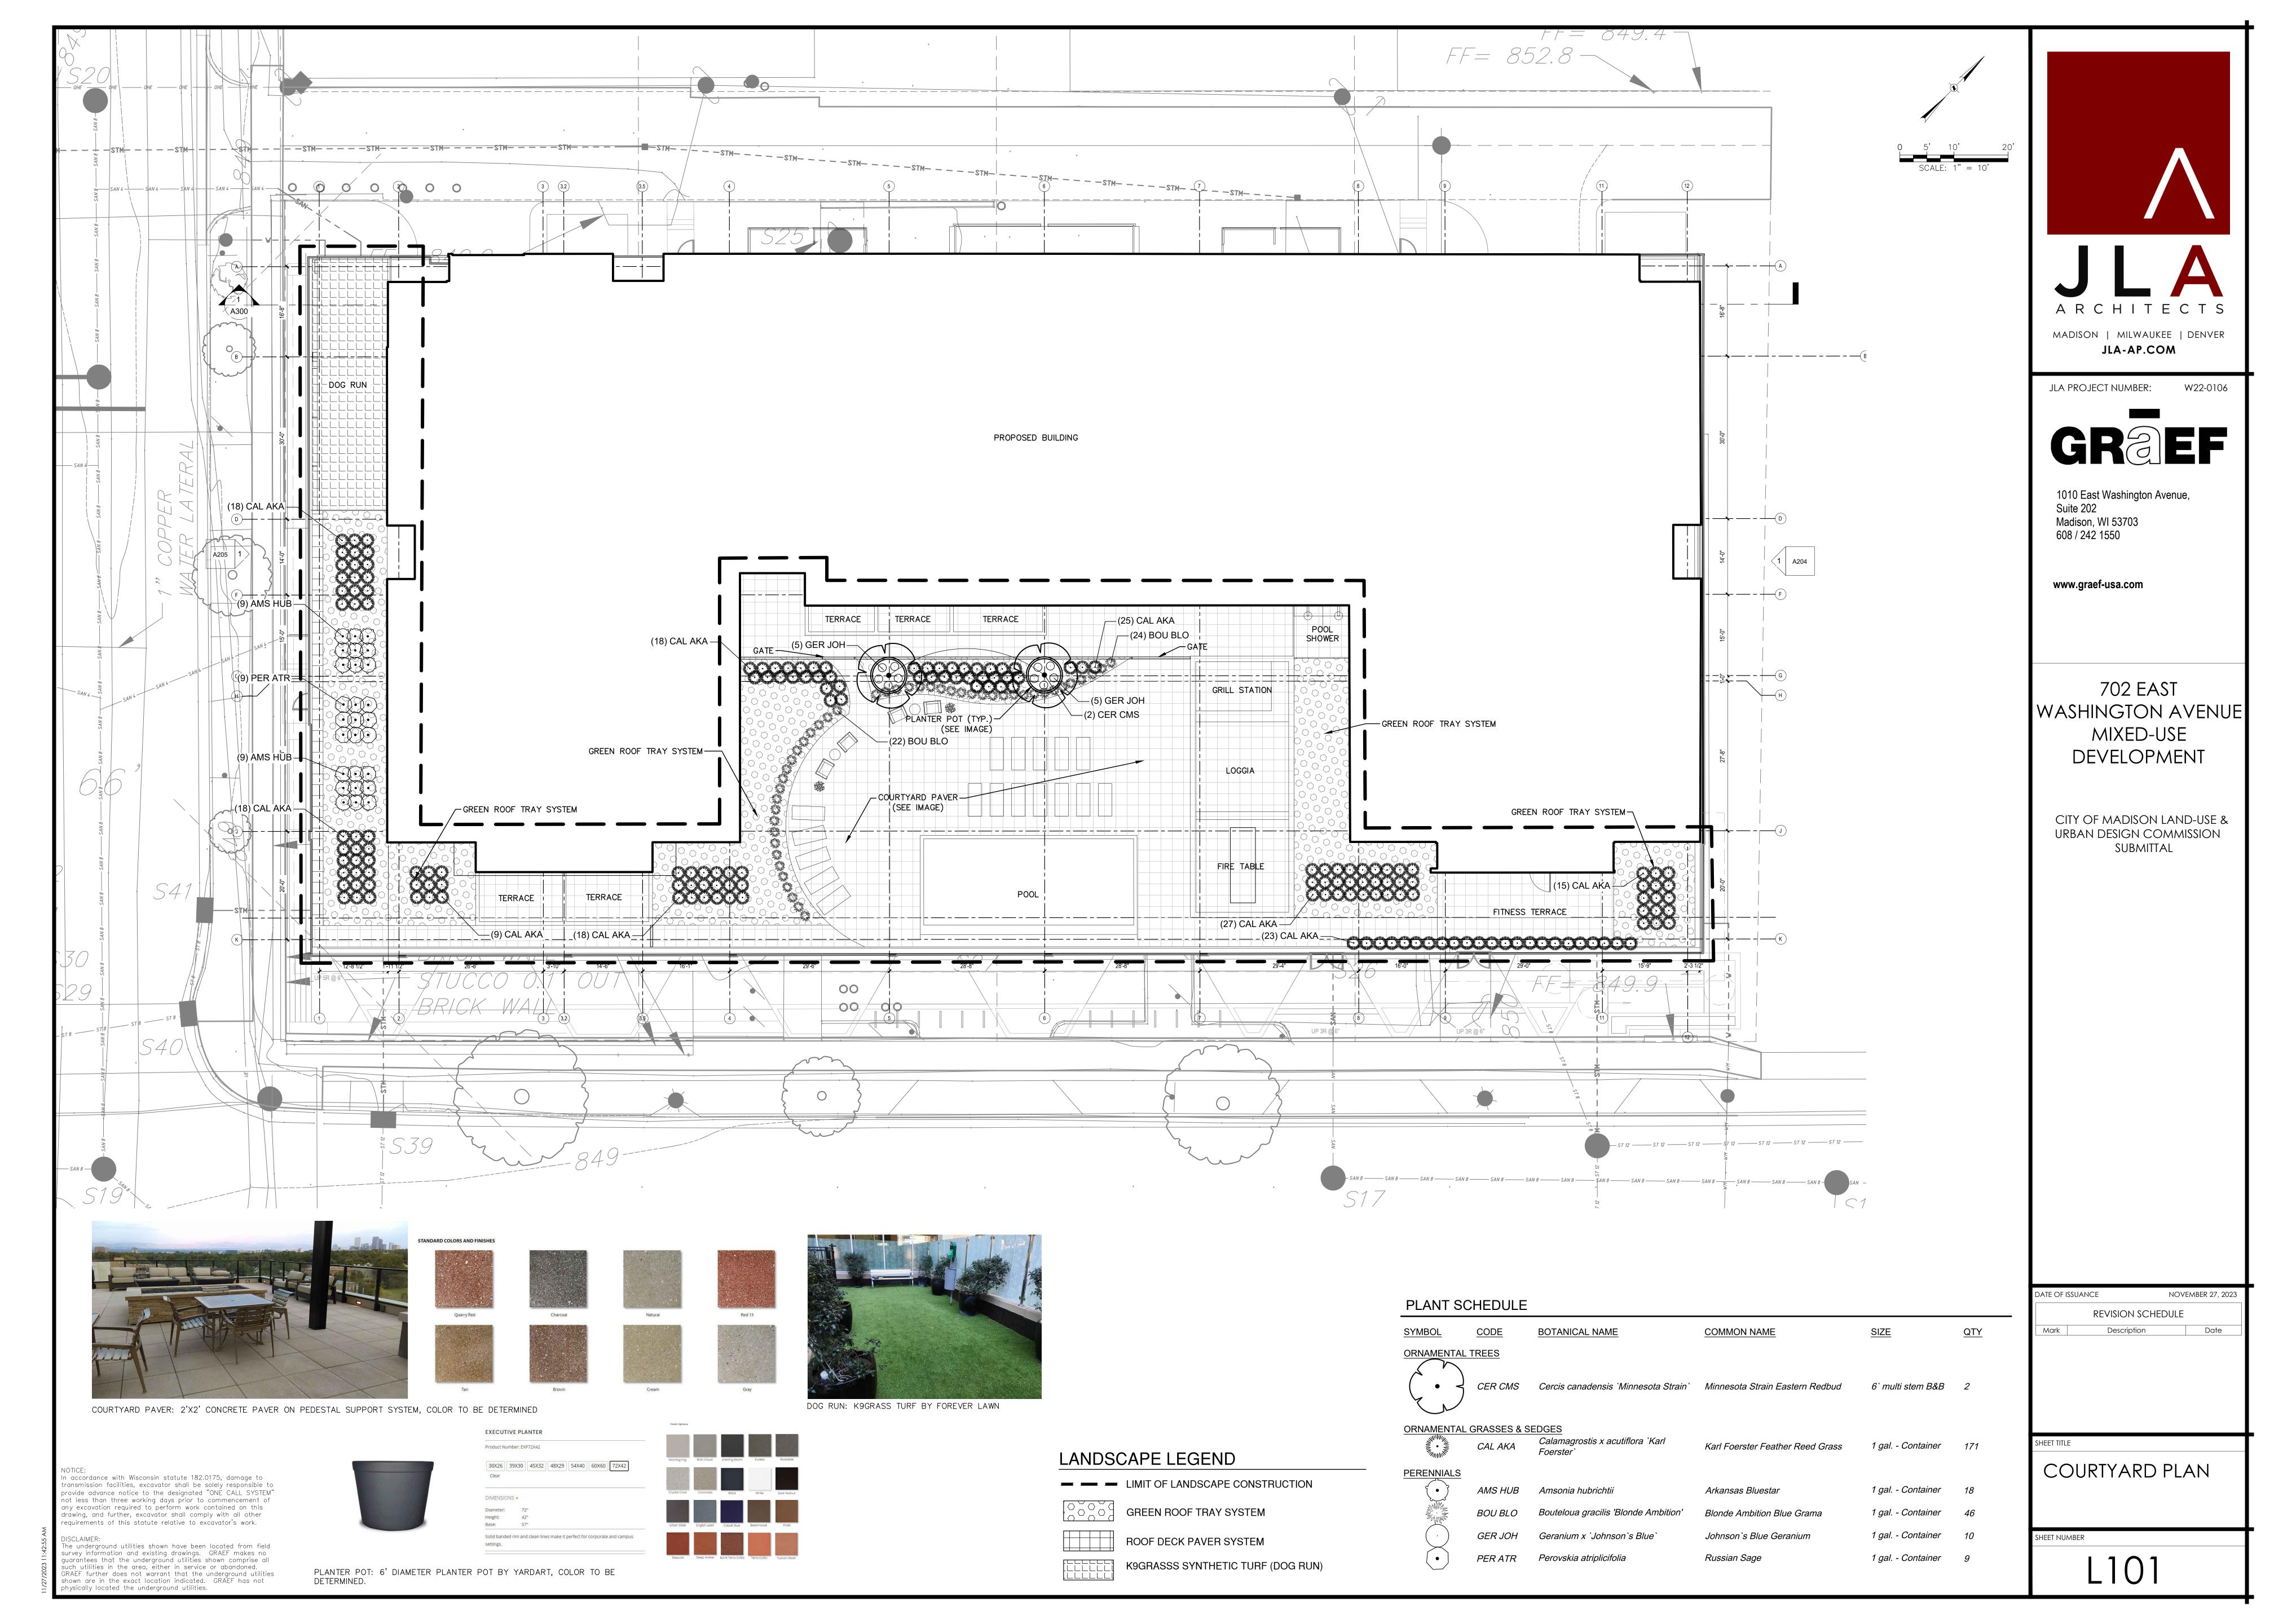


702 EAST WASHINGTON AVENUE MIXED-USE DEVELOPMENT


MADISON, WISCONSIN

CITY OF MADISON LAND-USE & URBAN DESIGN COMMISION SUBMITTAL




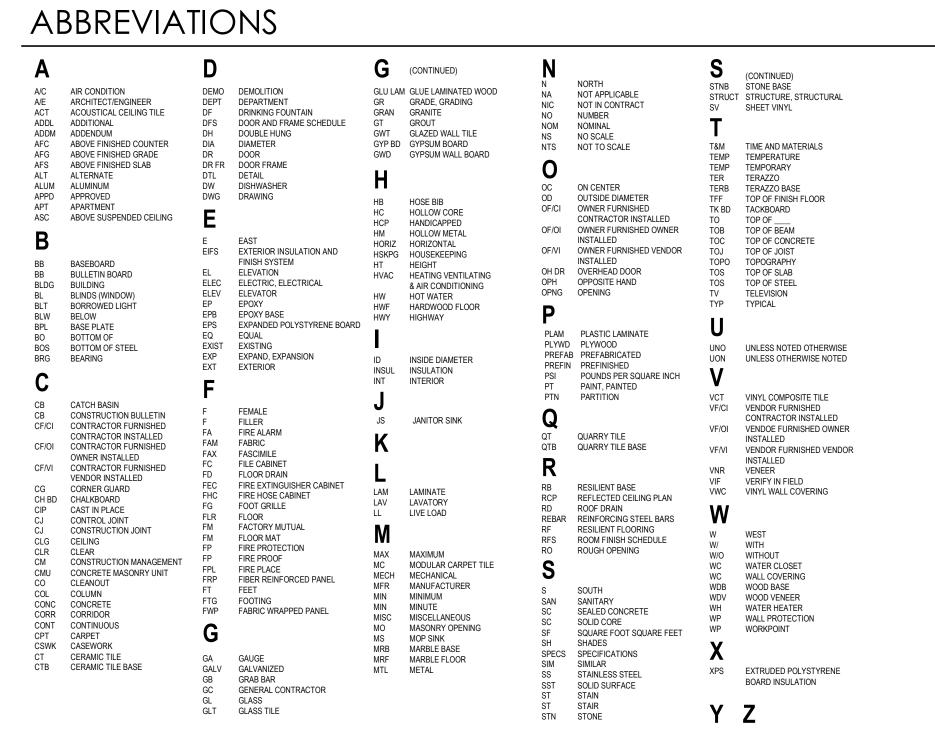

SYMBOL LEGEND

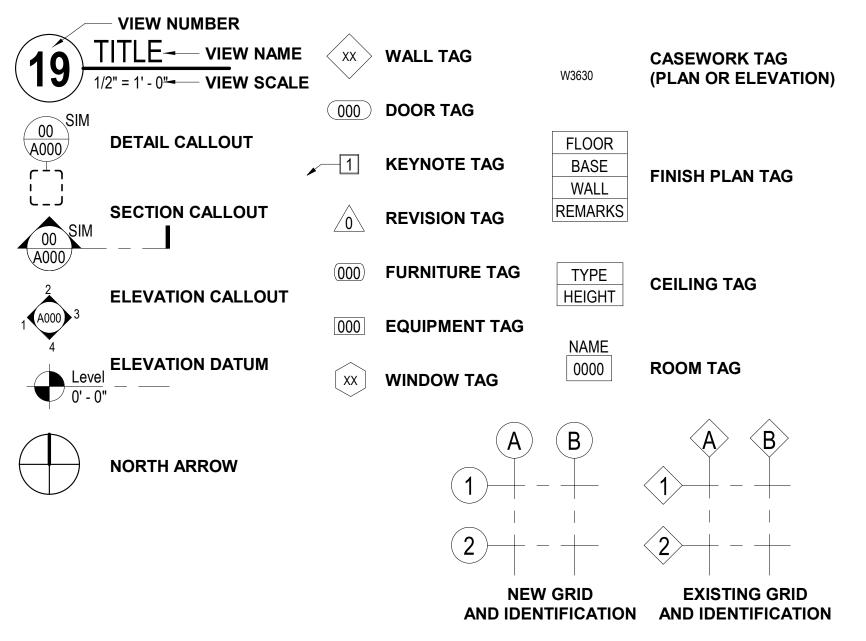

VICINITY MAP

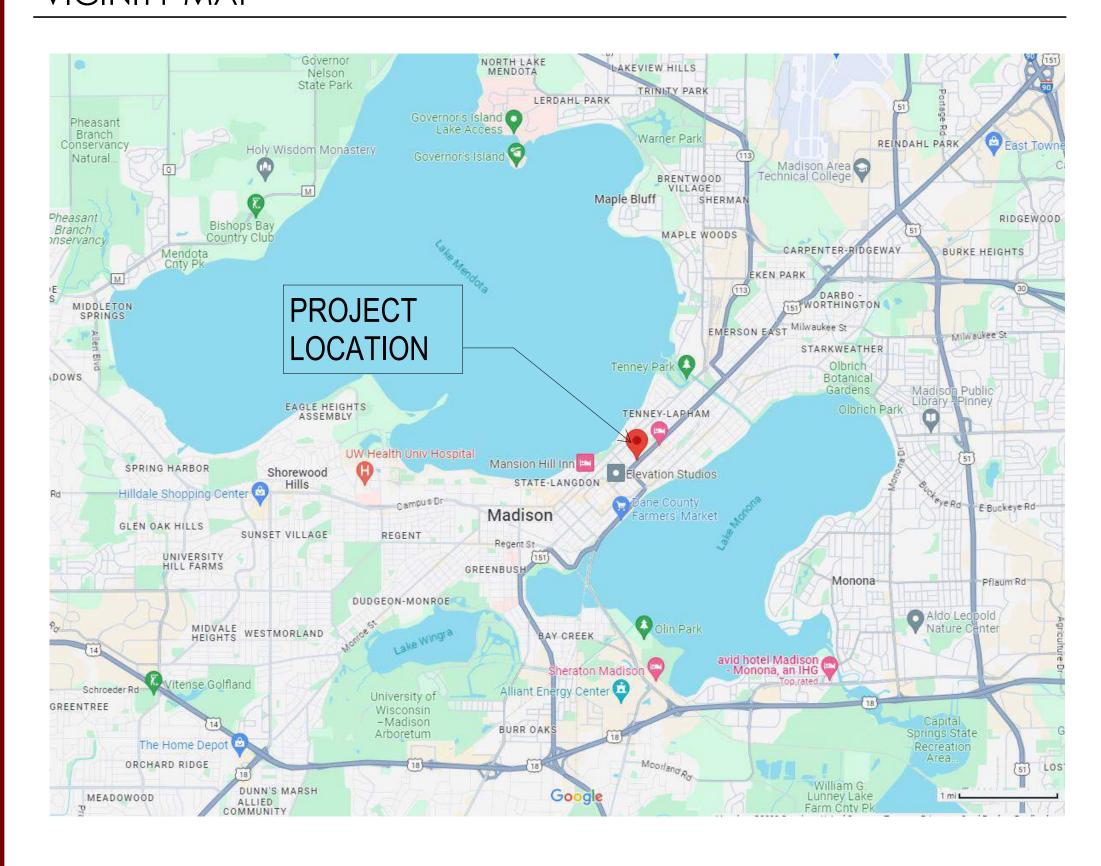

PROJECT ADDRESS

702 EAST WASHINGTON AVENUE, MADISON, WISCONSIN 53703

OWNER INFORMATION


WILLOW PARTNERS, LLC

725 EAST JOHNSON STREET MADISON, WI 53701

CONTACT: CHRIS HOUDEN JR EMAIL: chris@willowpartners.com MAIN: 608.405.1771 ext 201


PROJECT TEAM

GENERAL CONTRACTOR

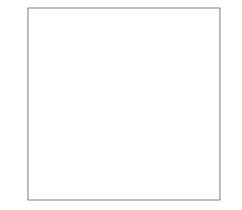

T.B.D.

ARCHITECTURAL

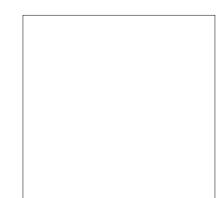

JLA ARCHITECTS & PLANNERS

800 WEST BROADWAY - SUITE 200 MONONA, WISCONSIN 53713 CONTACT: JENNIFER CAMP EMAIL: jcamp@jla-ap.com MAIN: 608.210.1232

CIVIL ENGINEERING



GRAEF, INC

1010 EAST WASHINGTON AVENUE - SUITE 202 MADISON, WI 53703 CONTACT: AMY LARSON, PE EMAIL: amy.larson@graef-usa.com MAIN: 608.245.1962


STRUCTURAL ENGINEERING



PIERCE ENGINEERS

222 W WASHINGTON AVENUE - SUITE 650 MADISON, WI 53703 CONTACT: LUCAS MARSHALL, PE, SE EMAIL: Imarshall@pierceengineers.com MAIN: 608.729.1414

LANDSCAPE

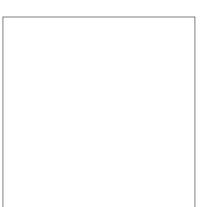

GRAEF, INC

1010 EAST WASHINGTON AVENUE - SUITE 202 MADISON, WI 53703 CONTACT: JOE PEPITONE EMAIL: joseph.pepitone@graef-usa.com MAIN: 414.412.0297

SET ISSUE

CITY OF MADISON LAND-USE & URBAN DESIGN COMMISION SUBMITTAL NOVEMBER 27, 2023

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W22-0106

702 EAST
WASHINGTON
AVENUE MIXED-USE
DEVELOPMENT

CITY OF MADISON LAND-USE & URBAN DESIGN COMMISION SUBMITTAL

PROGRESS DOCUMENTS These documents reflect progress and intent and may be subject to change, including additional detail. These are not final construction documents and should not be used for final bidding or

DATE OF ISSUA	REVISION SCHEDULE	OVEMBER 27, 202
Mark	Description	Date

HEET TITLE

INDEX SHEET

Sheet number

G001

702 EAST WASHINGTON MIXED-USE PROJECT DATA

November 27, 2023

	70111001 27, 20	.20																															
	UNIT NAME		STUDIOS				1 BED	ROOM			1 BR+DEN			2 BEDR	ROOMS				3 BEDI	ROOMS		UNITS	AL MS	AON E IES	CIAL	чпаL :A LE	(4) GROSS FINISHED AREA (S.F.)	ICY	SSS HED .F.)	(6) TOTAL GROSS AREA (S.F.)	PARKING	<u>უ დ</u>	RATIO
		A 1	A2	А3	B1	B2	В3	В4	В5	В6	C1	D1	D2	D3	D4	D5	D6	F1	F2	F3	F4	TOTAL	(1) TOTAL BEDROOMS	(2) COMMOI SPACE AMENITIES	COMMERCIA NET AREA LEASABLE	(3) RESIDENTIA NET AREA LEASABLE	GRC IED / S.F.)	EFFICIENC)	(5) GROSS UNFINISHED AREA (S.F.)	AL C A (S	RKIN	SURFACE	S R
	BEDROOMS	1	1	1	1	1	1	1	1	1	1	2	2	2	2	2	2	3	3	3	3	0	(1) BEDI	SF AM	NE NE) RE NEI LEA	(4) NISH)	EFFIC	(5) UNFI ARE	TOT	PA PA	PA	RK
	AREA (S.F.)	466	515	536	635	655	715	715	720	760	865	1,020	1,115	1,140	1,185	1,190	1,210	1,285	1,310	1,365	1,435	Ξ	_	9		(3	문	_		9	(2)		A A
	14	1	0	1	1	1	1	0	0	2	0	1	1	0	0	0	0	1	1	1	0	12	20	3,140	-	10,622	17,315	61.3%	1,845	19,160			
	13	1	5	0	0	0	0	1	2	6	1	0	0	1	1	2	1	0	0	0	1	22	29	-	-	17,971	21,305	84.4%	-	21,305			
	12	1	5	0	0	0	0	1	2	6	1	0	0	1	1	2	1	0	0	0	1	22	29	-	_	17,971	21,305	84.4%	-	21,305			
	11	1	5	0	0	0	0	1	2	6	1	0	0	1	1	2	1	0	0	0	1	22	29	-	_	17,971	21,305	84.4%	-	21,305			
	10	1	5	0	0	0	0	1	2	6	1	0	0	1	1	2	1	0	0	0	1	22	29	-	-	17,971	21,305	84.4%	-	21,305			
	9	1	5	0	0	0	0	1	2	6	1	0	0	1	1	2	1	0	0	0	1	22	29	-	-	17,971	21,305	84.4%	-	21,305			
	8	1	5	0	0	0	0	1	2	6	1	0	0	1	1	2	1	0	0	0	1	22	29	-	-	17,971	21,305	84.4%	-	21,305			
S S	7	1	5	0	0	0	0	1	2	6	1	0	0	1	1	2	1	0	0	0	1	22	29	-	-	17,971	21,305	84.4%	-	21,305			
0		1	5	0	0	0	0	1	2	6	1	0	0	1	1	2	1	0	0	0	1	22	29	-	_	17,971	21,305	84.4%	-	21,305			
0	5	1	5	0	0	0	0	1	2	6	1	0	0	1	1	2	1	0	0	0	1	22	29	-	_	17,971	21,305	84.4%	-	21,305			
<u>-</u>	4	1	5	0	0	0	0	1	2	6	1	0	0	1	1	2	1	0	0	0	1	22	29	-	_	17,971	21,305	84.4%	-	21,305			
-	3	0	4	0	0	0	0	0	1	3	1	0	0	1	0	2	0	0	0	0	0	12	15	8,225	_	9,445	21,280	44.4%	-	21,280			
	2 (P2)	0	0	0	0	0	0	0	0	0	0	0	0	0	0	0	0	0	0	0	0	0	0	435	5,690	-	7,825	72.7%	25,110	32,935	64		
	(P1.5)	0	0	0	0	0	0	0	0	0	0	0	0	0	0	0	0	0	0	0	0	0	0	_	_	_	-	N/A	28,075	28,075	60		
	1 (P1)	0	0	0	0	0	0	0	0	0	0	0	0	0	0	0	0	0	0	0	0	0	0	3,335	8,425	_	14,515	58.0%	18,425	32,940	32		
	LL-1	0	0	0	0	0	0	0	0	0	0	0	0	0	0	0	0	0	0	0	0	0	0	-	-	_	-	N/A	32,940	32,940	79		
	LL-2 (8)	0	0	0	0	0	0	0	0	0	0	0	0	0	0	0	0	0	0	0	0	0	0	_	_	_	_	. ,,, .	26,195	26,195	64	PER U	UNIT PER BR
	TOTALS	11	54	1	1	1	1	10	21	65	11	1	1	11	10	22	10	1	1	1	10	244	325	15,135	14,115	199,777	273,985	78.1%	132,590				.23 0.92
	PERCENT	4.5%	22.1%	0.4%	0.4%	0.4%	0.4%	4.1%	8.6%	26.6%	4.5%	0.4%	0.4%	4.5%	4.1%	9.0%	4.1%	0.4%	0.4%	0.4%	4.1%				1					l	l .		
	ILICEINI				1							1										1											

4.5%

819 Average N.S.F. per unit 1,031 Average G.S.F per unit (only gross finished areas of floors 3-14) 436 Average S.F. per space (only parking levels)

JLA ARCHITECTS

BR+Den 1.0 per Unit 2 BR 1.0 per Unit 3 BR 1.5 per Unit 3 BR 1.5 per Unit 3 BR 1.5 per Unit 3 BR 2 1.5 per Unit 3 BR 3 1.5 per Unit 4 BR 4 1.5 per Unit 5 BR 5 1.5 per Unit 6 BR 6 1.5 per Unit 7 BR 7 1.5 per Unit 7 BR 7 1.5 per Unit 7 BR 8 1.5 per Unit 7 BR 8 1.5 per Unit 7 BR 8 2 1.5 per Uni			DICTULE I AIL	KING (REQUIRED)	
BR+Den 1.0 per Unit 2 BR 1.0 per Unit 3 BR 1.5 per Unit 3 Cong Term Residential Sub-Total: 2 Residential Long Term - Floor (Min.) 18 Residential Long Term - Wall (25% Max.) 6 Total Long Term (Secured) Spaces: 2 RESIDENTIAL GUEST & COMMERCIAL SPACE BICYCLE PARKING Commercial Space Area (SF) TOTALS Commercial Space 1st Flr 8425 Commercial Space 2nd Flr 5690 Guest - Exterior (1 PER 10 Units)	•	_		Required Bicycle Parking Totals	
Residential Long Term - Floor (Min.) Residential Long Term - Wall (25% Max.) Total Long Term (Secured) Spaces: RESIDENTIAL GUEST & COMMERCIAL SPACE BICYCLE PARKING Commercial Space Area (SF) TOTALS Commercial Space 2nd Flr 8425 Commercial Space 2nd Flr 5690 Guest - Exterior (1 PER 10 Units)	1BR	1.0	per Unit		165
Residential Sub-Total: Residential Long Term - Floor (Min.) Residential Long Term - Wall (25% Max.) Total Long Term (Secured) Spaces: RESIDENTIAL GUEST & COMMERCIAL SPACE BICYCLE PARKING Commercial Space Area (SF) TOTALS Commercial Space 1st Flr 8425 Commercial Space 2nd Flr 5690 Guest - Exterior (1 PER 10 Units)	1BR+Den	1.0	per Unit		1:
Residential Long Term - Floor (Min.) Residential Long Term - Wall (25% Max.) Total Long Term (Secured) Spaces: RESIDENTIAL GUEST & COMMERCIAL SPACE BICYCLE PARKING Commercial Space Area (SF) TOTALS Commercial Space 1st Flr 8425 Commercial Space 2nd Flr 5690 Guest - Exterior (1 PER 10 Units)	2BR	1.0	per Unit		5!
Residential Long Term - Floor (Min.) Residential Long Term - Wall (25% Max.) Total Long Term (Secured) Spaces: RESIDENTIAL GUEST & COMMERCIAL SPACE BICYCLE PARKING Commercial Space Area (SF) TOTALS Commercial Space 1st Flr 8425 Commercial Space 2nd Flr 5690 Guest - Exterior (1 PER 10 Units)	3BR	1.5	per Unit		20
Residential Long Term - Wall (25% Max.) Total Long Term (Secured) Spaces: RESIDENTIAL GUEST & COMMERCIAL SPACE BICYCLE PARKING Commercial Space Area (SF) TOTALS Commercial Space 1st Flr 8425 Commercial Space 2nd Flr 5690 Guest - Exterior (1 PER 10 Units)	Long Term Resident	ial Sub	-Total:		25
Total Long Term (Secured) Spaces: RESIDENTIAL GUEST & COMMERCIAL SPACE BICYCLE PARKING Commercial Space Area (SF) TOTALS Commercial Space 1st Flr 8425 Commercial Space 2nd Flr 5690 Guest - Exterior (1 PER 10 Units)	Residenti	ial Long	Term - Floor (Min.)		18
RESIDENTIAL GUEST & COMMERCIAL SPACE BICYCLE PARKING Commercial Space Area (SF) TOTALS Commercial Space 1st Flr 8425 Commercial Space 2nd Flr 5690 Guest - Exterior (1 PER 10 Units)	Residential Lo	ng Teri	m - Wall (25% Max.)		6
Commercial Space Area (SF) TOTALS Commercial Space 1st Flr 8425 Commercial Space 2nd Flr 5690 Guest - Exterior (1 PER 10 Units)	Total Lo	ng Teri	m (Secured) Spaces:		25
Commercial Space 1st Flr 8425 Commercial Space 2nd Flr 5690 Guest - Exterior (1 PER 10 Units)	RESIDENT	IAL G	UEST & COM	MERCIAL SPACE BICYCLE PARKING	
Commercial Space 2nd Flr 5690 Guest - Exterior (1 PER 10 Units)	Commercial Space	:e	Area (SF)	TOTALS	
Guest - Exterior (1 PER 10 Units)	Commercial Space 1	st Flr	8425		
	Commercial Space 2	nd Flr	5690		
Short Term Exterior Spaces:	Guest - Exteri	or (1 PE	R 10 Units)		2
Charles of the control of the contro	Short Term	Exterio	or Spaces:		3

BICYCLE PAR	KING (PROPOSED)
BUILDING	TOTALS
Residential Short Term (Interior)	5
Residential Long Term - Wall (Max.)	30
Reisdential Long Term - Floor (Min)	221
Interior Residential Total Spaces:	256
Guest/Short Term - Exterior	19
Commercial Space1st Floor	4
Commercial Space 2nd Floor	3
Exterior Spaces:	26
TOTAL PROPOSED BICYCLE PARKING:	282

ELECTRIC VEHICLE STALL INFORMATION: TOTAL PARKING SPACES: 299 2% EV INSTALLED = 6 10% EV READY = 30

702 EAST WASHINGTON AVENUE MIXED-USE DEVELOPMENT

madison | milwaukee | denver

JLA-AP.COM

JLA PROJECT NUMBER:

CITY OF MADISON LAND-USE & URBAN DESIGN COMMISION SUBMITTAL

DATE OF ISSUANCE NOVEMBER 27, 2023 REVISION SCHEDULE

DATA MATRIX

G102

PROJECT DATA NOTES:

- 1 TOTAL UNIT & BEDROOM COUNT ASSUMES IDENTICAL FOOTPRINT FROM FLOORS 4 THRU 13.
- 2 COMMON AMENTIY SPACES ARE INCLUDED IN THE GROSS FINISHED AREAS.

27.0%

- 3 RESIDENTIAL NET LEASABLE AREA INCLUDES UNITS ONLY (NOT BALCONIES).
- 4 GROSS FINISHED AREA DOES NOT INCLUDE PARKING AREAS OR MECHANICAL ROOMS.
- 5 GROSS UNFINISHED AREA INCLUDES THE 14TH FLOOR MECHANICAL PLANT AND PARKING AREAS (INCLUDING THE STAIRS, ELEVATORS, MECHANICAL, AND STORAGE SPACES WITHIN THE PARKING AREAS).


4.5%


22.5%

- 6 TOTAL GROSS AREA = GROSS FINISHED AREAS + GROSS UNFINISHED AREAS.
- 7 STRUCTURED PARKING COUNTS AT EACH FLOOR IS COUNTED TO THE BOTTOM OF THE RAMP TO THE FLOOR BELOW.

40.6%

8 LOWER-LEVEL 2 (LL-2) SHALL BE AN 'OPTIONAL' LEVEL. THE NEED / DESIRE FOR THIS LEVEL SHALL BE DETERMINED AS THE DESIGN OF THE PROJECT IS DEVELOPED & DOCUMENTED FOR FINAL PLAN APPROVAL.

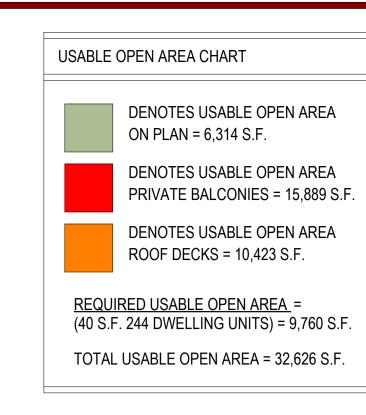

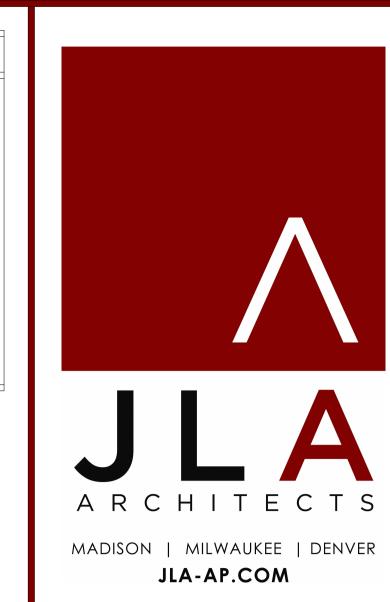


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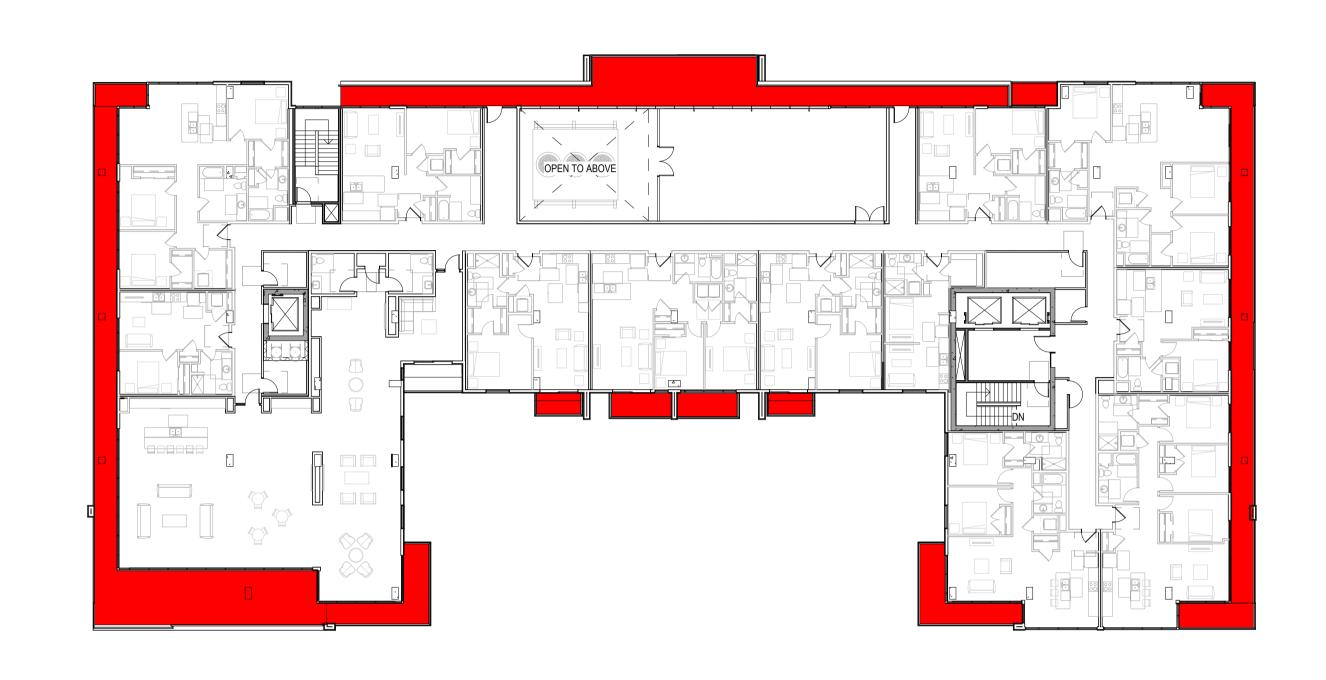
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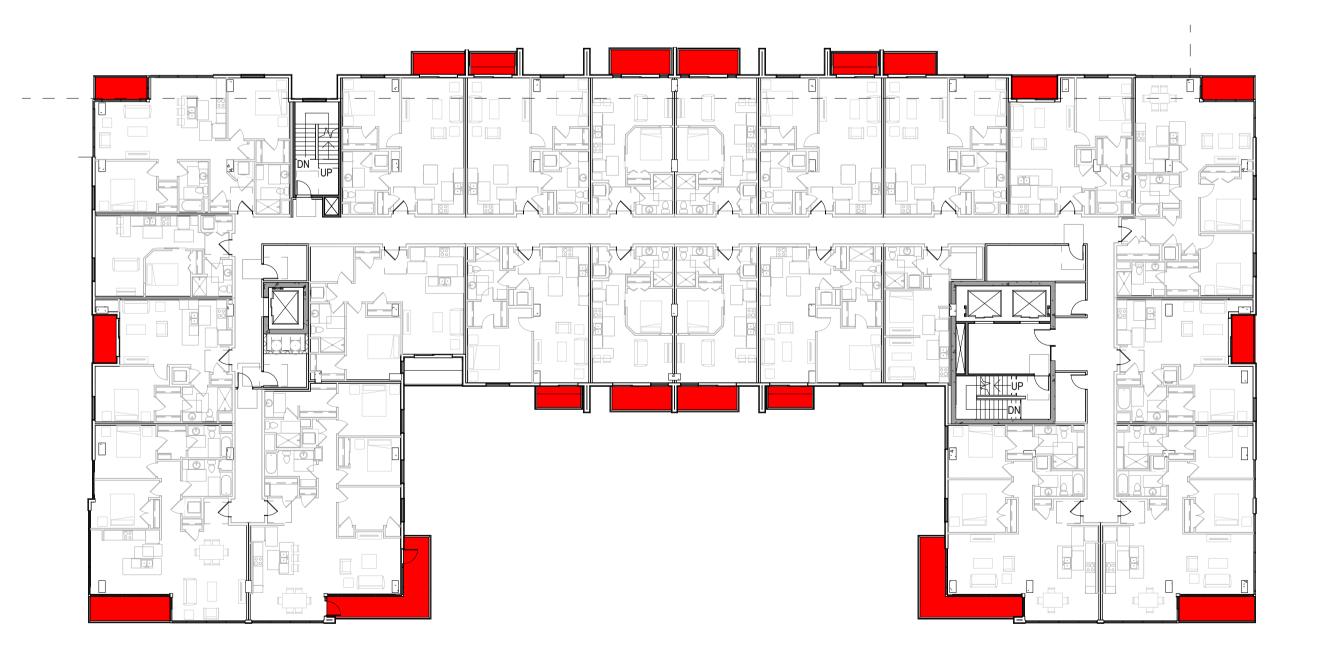
ARCHITECTURAL SITE PLAN

SHEET NUMBER

ASP-100

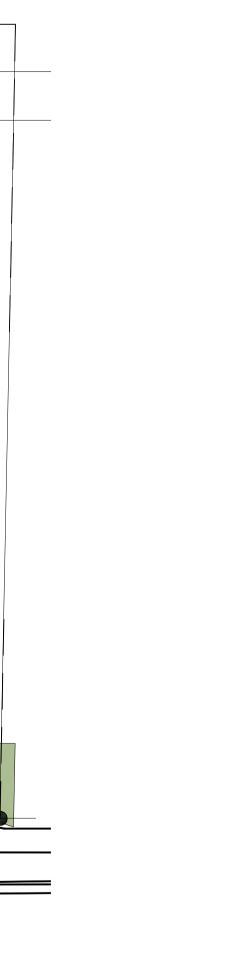


FOURTEENTH FLOOR - USABLE SPACE
1" = 20'-0"



3 TYPICAL FLOOR PLAN (4-13) 1" = 20'-0"



2 THIRD FLOOR - USABLE SPACE 1" = 20'-0"

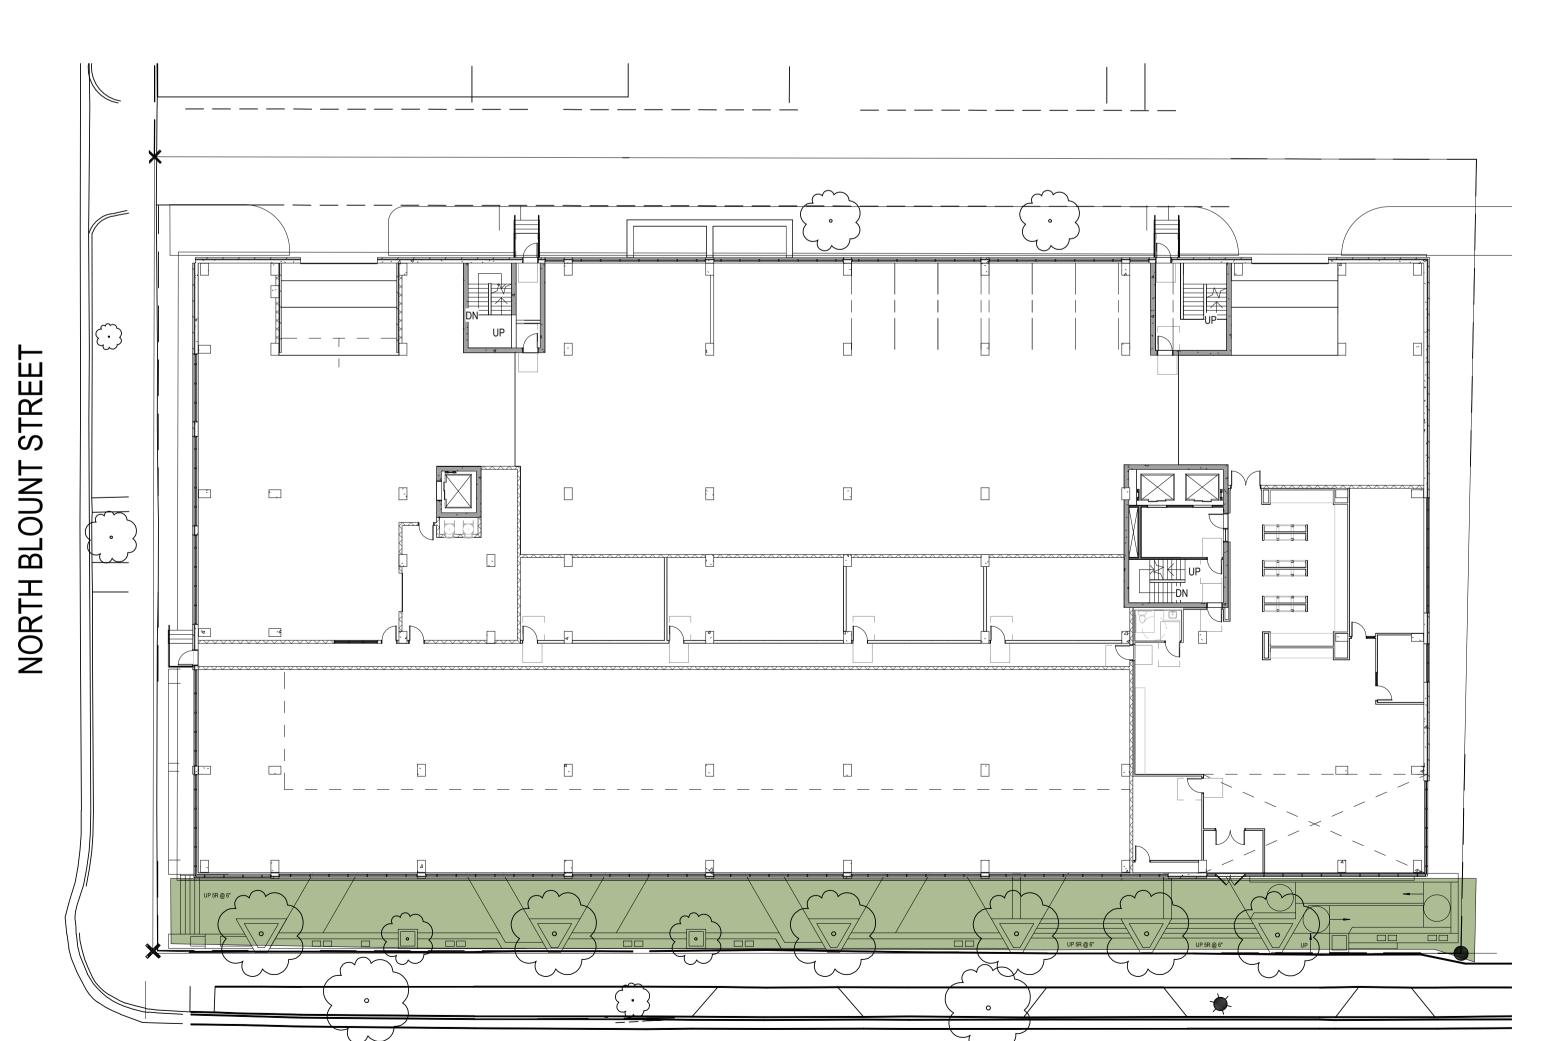

EAST WASHINGTON AVENUE

1) FIRST FLOOR - USABLE SPACE PLAN 1" = 20'-0"

OTHERWISE NOTED. EXTERIOR WINDOW & DOOR LOCATION DIMENSIONS ARE TO ROUGH OPENING NOTED OTHERWISE. STRUCTURAL MEMBERS.

GENERAL NOTES - PARKING LEVEL FLOOR PLAN

EXTERIOR DIMENSIONS ARE TO OUTSIDE FACE OF STUD OR MASONRY UNLESS 9.

INTERIOR DIMENSIONS ARE TO FACE OF STUD OR CONCRETE MASONRY UNIT WALLS UNLESS OTHERWISE NOTED.

ENDS OF WINDOW/DOOR UNLESS OTHERWISE NOTED. CONTRACTOR SHALL 11. VERIFY ALL ROUGH OPENINGS WITH MANUFACTURER.

ALL CONCRETE MASONRY UNIT (CMU) WALLS SHALL BE TYPE M8-2X UNLESS 12. ALL METAL STUD WALLS SHALL BE AS TAGGED AND/ OR INDICATED ON THE INTERIOR WALL ASSEMBLIES SHEET, UNLESS NOTED OTHERWISE.

VERIFY ALL STRUCTURAL MEMBER SIZE, SPACING, REINFORCING, AND BRACING WITH STRUCTURAL DRAWINGS. ANY EXPOSED STEEL THAT SUPPORTS LOAD-BEARING WALLS OR FLOORS SHALL BE PROTECTED BY MEANS OF SPRAY-FIREPROOFING. GENERAL CONTRACTOR TO COORDINATE WITH FINAL DESIGN AND INSTALLATION OF PRECAST CONCRETE 15. CONTRACTOR TO VERIFY LOCATIONS OF GAS METER, ELECTRICAL

ALL WOOD EXPOSED TO THE EXTERIOR OR IN CONTACT WITH CONCRETE OR MASONRY SHALL BE PRESSURE-TREATED.

DESIGN-BUILD MECHANICAL, ELECTRICAL, AND PLUMBING CONTRACTORS SHALL MAINTAIN A CLEAR HEIGHT OF 7'-0" MINIMUM IN VEHICLE AND

PEDESTRIAN TRAFFIC AREAS PER 2015 IBC 406. 10. VERIFY QUANTITY AND LOCATION OF INTERIOR AND EXTERIOR HOSE BIBBS WITH OWNER.

VERIFY QUANTITY, LOCATION, AND TYPE OF ELECTRICAL OUTLETS IN PARKING AREA WITH OWNER. PRIOR TO CONSTRUCTION, GENERAL CONTRACTOR TO VERIFY

REQUIREMENTS OF ALL TRADES INCLUDING: PRECAST, PLUMBING, SPRINKLERS, HVAC, ELEVATOR & ELECTRICAL. 13. GENERAL CONTRACTOR DOOR COORDINATE ALL PENETRATION AND OPENINGS THROUGH PRECAST PLANK WITH PRECAST PLAND PROVIDER, MEP CONTRACTORS, AND ARCHITECT.

COORDINATE LOCATION OF PRECAST PLANK DEPTHS W/ PRECAST SHOP DRAWINGS PRIOR TO POURING WALLS. METERS, AND THEIR SPACE REQUIREMENTS PRIOR TO CONSTRUCTION.

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Description

OPTIONAL LOWER

LEVEL 2 PLAN

SHEET NUMBER


THIS LEVEL SHALL BE DETERMINED AS THE

DESIGN OF THE PROJECT IS DEVELOPED,

AND DOCUMENTED IN THE FINAL PLAN

REVIEW/ CONSTRUCTION DOCUMENTS.

A090

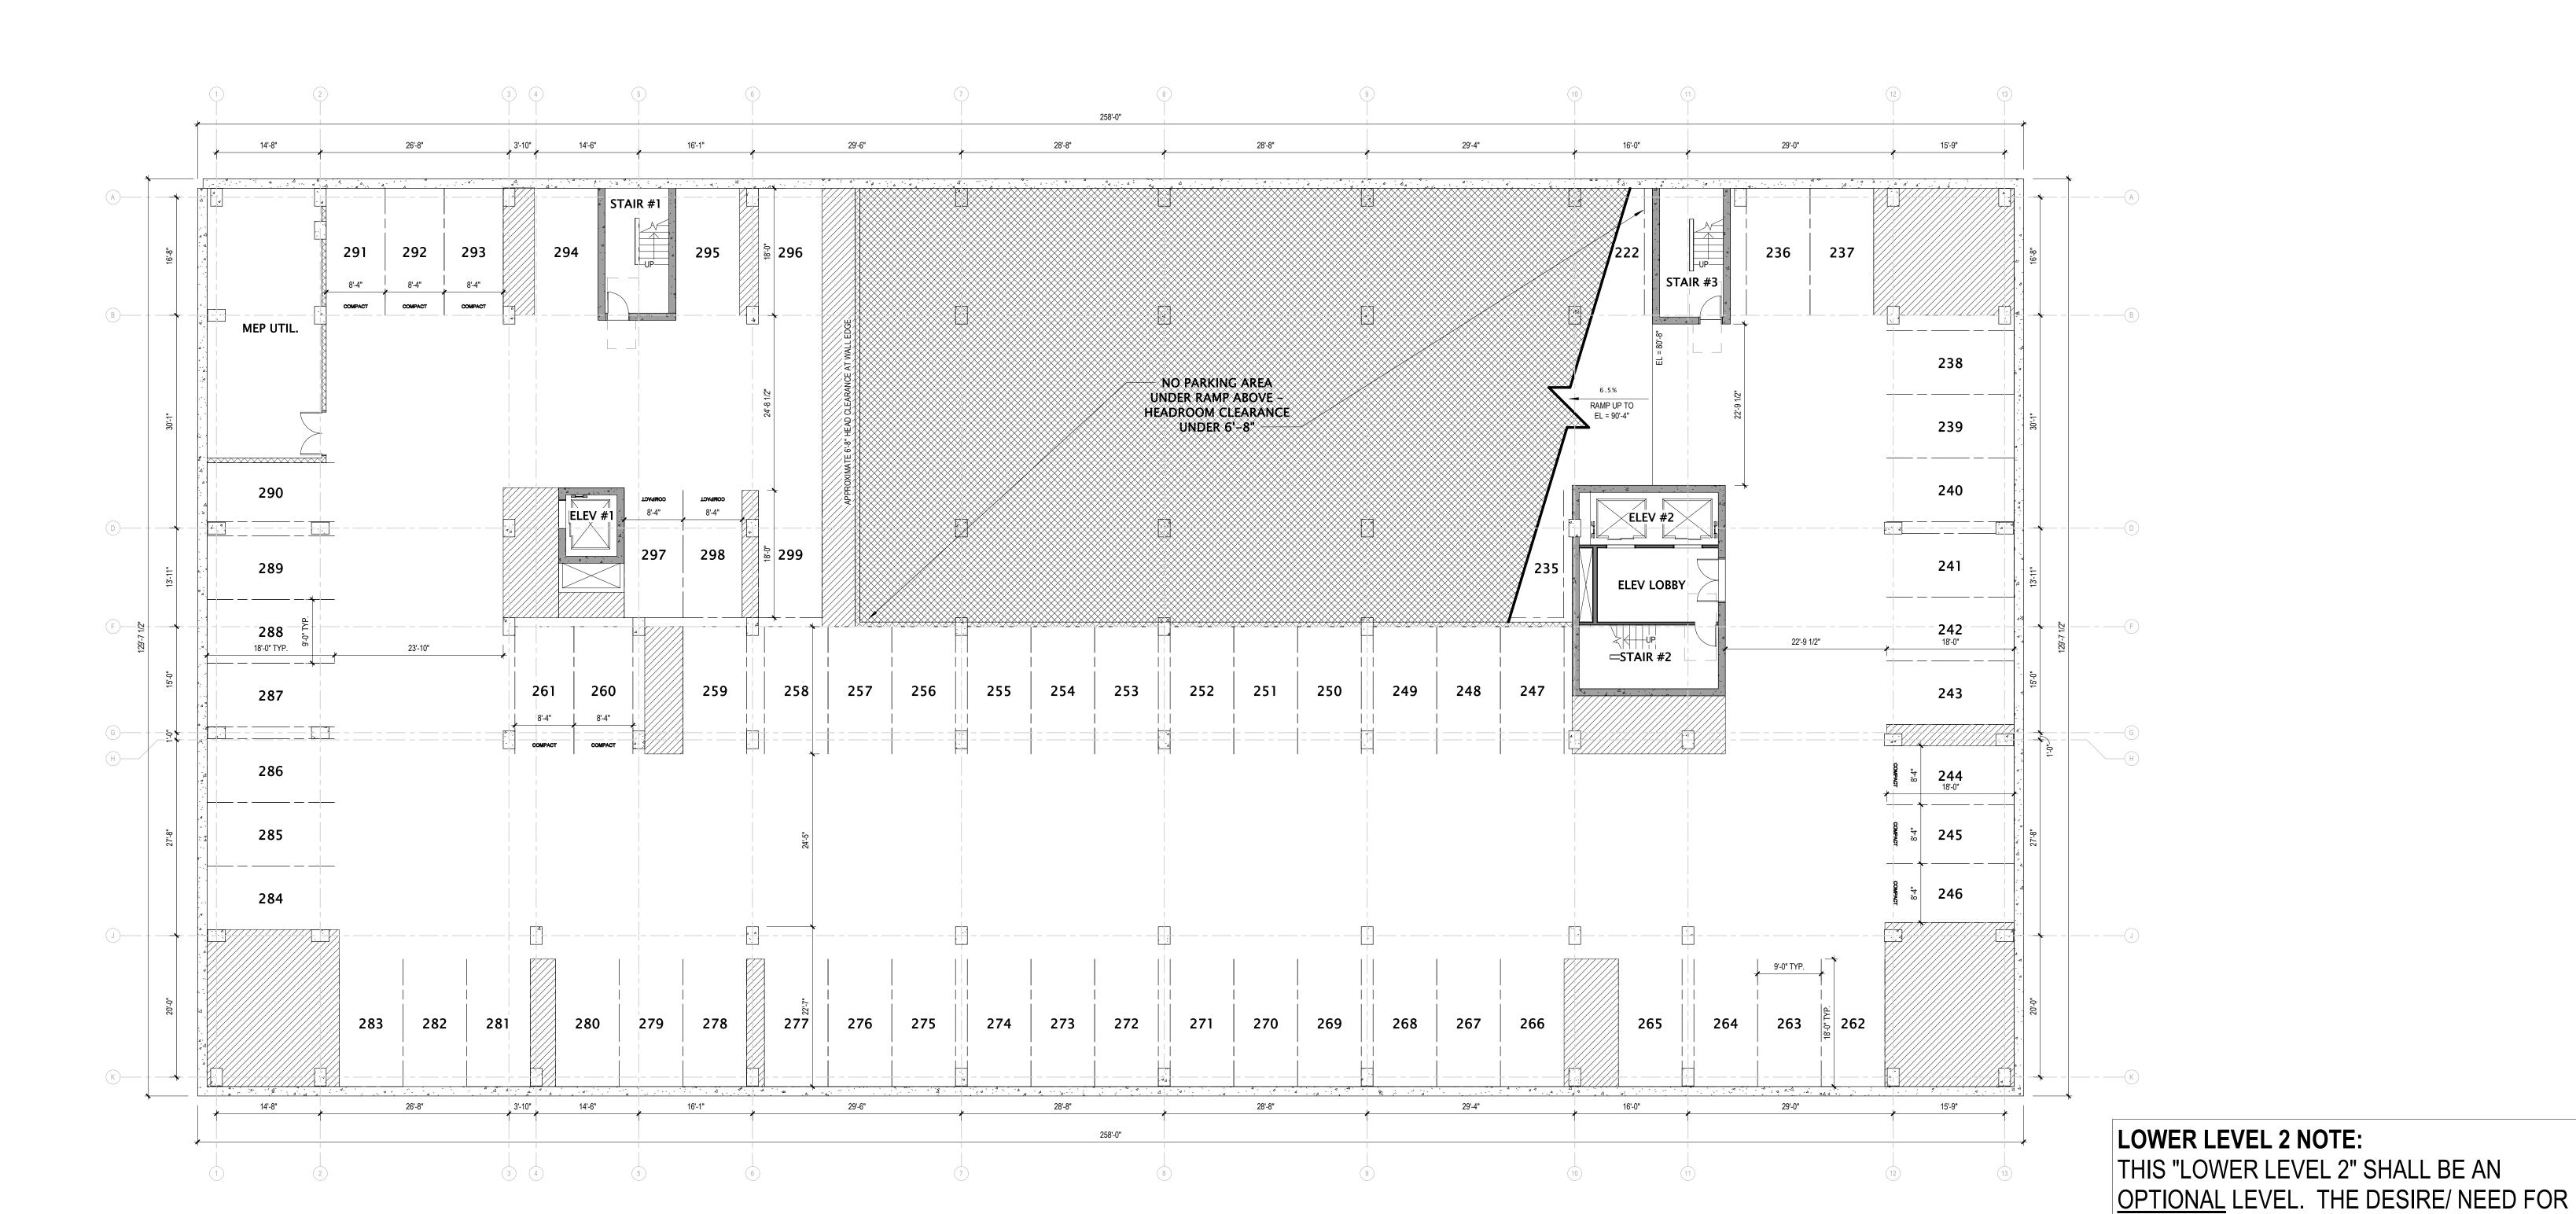

1 LOWER LEVEL 2
3/32" = 1'-0"

WITH STRUCTURAL DRAWINGS.

GENERAL NOTES - PARKING LEVEL FLOOR PLAN

- EXTERIOR DIMENSIONS ARE TO OUTSIDE FACE OF STUD OR MASONRY UNLESS 9. OTHERWISE NOTED.
- INTERIOR DIMENSIONS ARE TO FACE OF STUD OR CONCRETE MASONRY UNIT WALLS UNLESS OTHERWISE NOTED.
- EXTERIOR WINDOW & DOOR LOCATION DIMENSIONS ARE TO ROUGH OPENING ENDS OF WINDOW/DOOR UNLESS OTHERWISE NOTED. CONTRACTOR SHALL 11. VERIFY QUANTITY, LOCATION, AND TYPE OF ELECTRICAL OUTLETS IN VERIFY ALL ROUGH OPENINGS WITH MANUFACTURER.
- ALL CONCRETE MASONRY UNIT (CMU) WALLS SHALL BE TYPE M8-2X UNLESS 12. NOTED OTHERWISE.
- ALL METAL STUD WALLS SHALL BE AS TAGGED AND/ OR INDICATED ON THE INTERIOR WALL ASSEMBLIES SHEET, UNLESS NOTED OTHERWISE. VERIFY ALL STRUCTURAL MEMBER SIZE, SPACING, REINFORCING, AND BRACING
- ANY EXPOSED STEEL THAT SUPPORTS LOAD-BEARING WALLS OR FLOORS SHALL BE PROTECTED BY MEANS OF SPRAY-FIREPROOFING. GENERAL CONTRACTOR TO COORDINATE WITH FINAL DESIGN AND INSTALLATION OF PRECAST CONCRETE 15. CONTRACTOR TO VERIFY LOCATIONS OF GAS METER, ELECTRICAL STRUCTURAL MEMBERS.
- ALL WOOD EXPOSED TO THE EXTERIOR OR IN CONTACT WITH CONCRETE OR MASONRY SHALL BE PRESSURE-TREATED.

DESIGN-BUILD MECHANICAL, ELECTRICAL, AND PLUMBING CONTRACTORS SHALL MAINTAIN A CLEAR HEIGHT OF 7'-0" MINIMUM IN VEHICLE AND PEDESTRIAN TRAFFIC AREAS PER 2015 IBC 406.

- 10. VERIFY QUANTITY AND LOCATION OF INTERIOR AND EXTERIOR HOSE BIBBS WITH OWNER.
- PARKING AREA WITH OWNER.
- PRIOR TO CONSTRUCTION, GENERAL CONTRACTOR TO VERIFY REQUIREMENTS OF ALL TRADES INCLUDING: PRECAST, PLUMBING,
- SPRINKLERS, HVAC, ELEVATOR & ELECTRICAL. 13. GENERAL CONTRACTOR DOOR COORDINATE ALL PENETRATION AND OPENINGS THROUGH PRECAST PLANK WITH PRECAST PLAND PROVIDER, MEP CONTRACTORS, AND ARCHITECT.
- COORDINATE LOCATION OF PRECAST PLANK DEPTHS W/ PRECAST SHOP DRAWINGS PRIOR TO POURING WALLS.

METERS, AND THEIR SPACE REQUIREMENTS PRIOR TO CONSTRUCTION.

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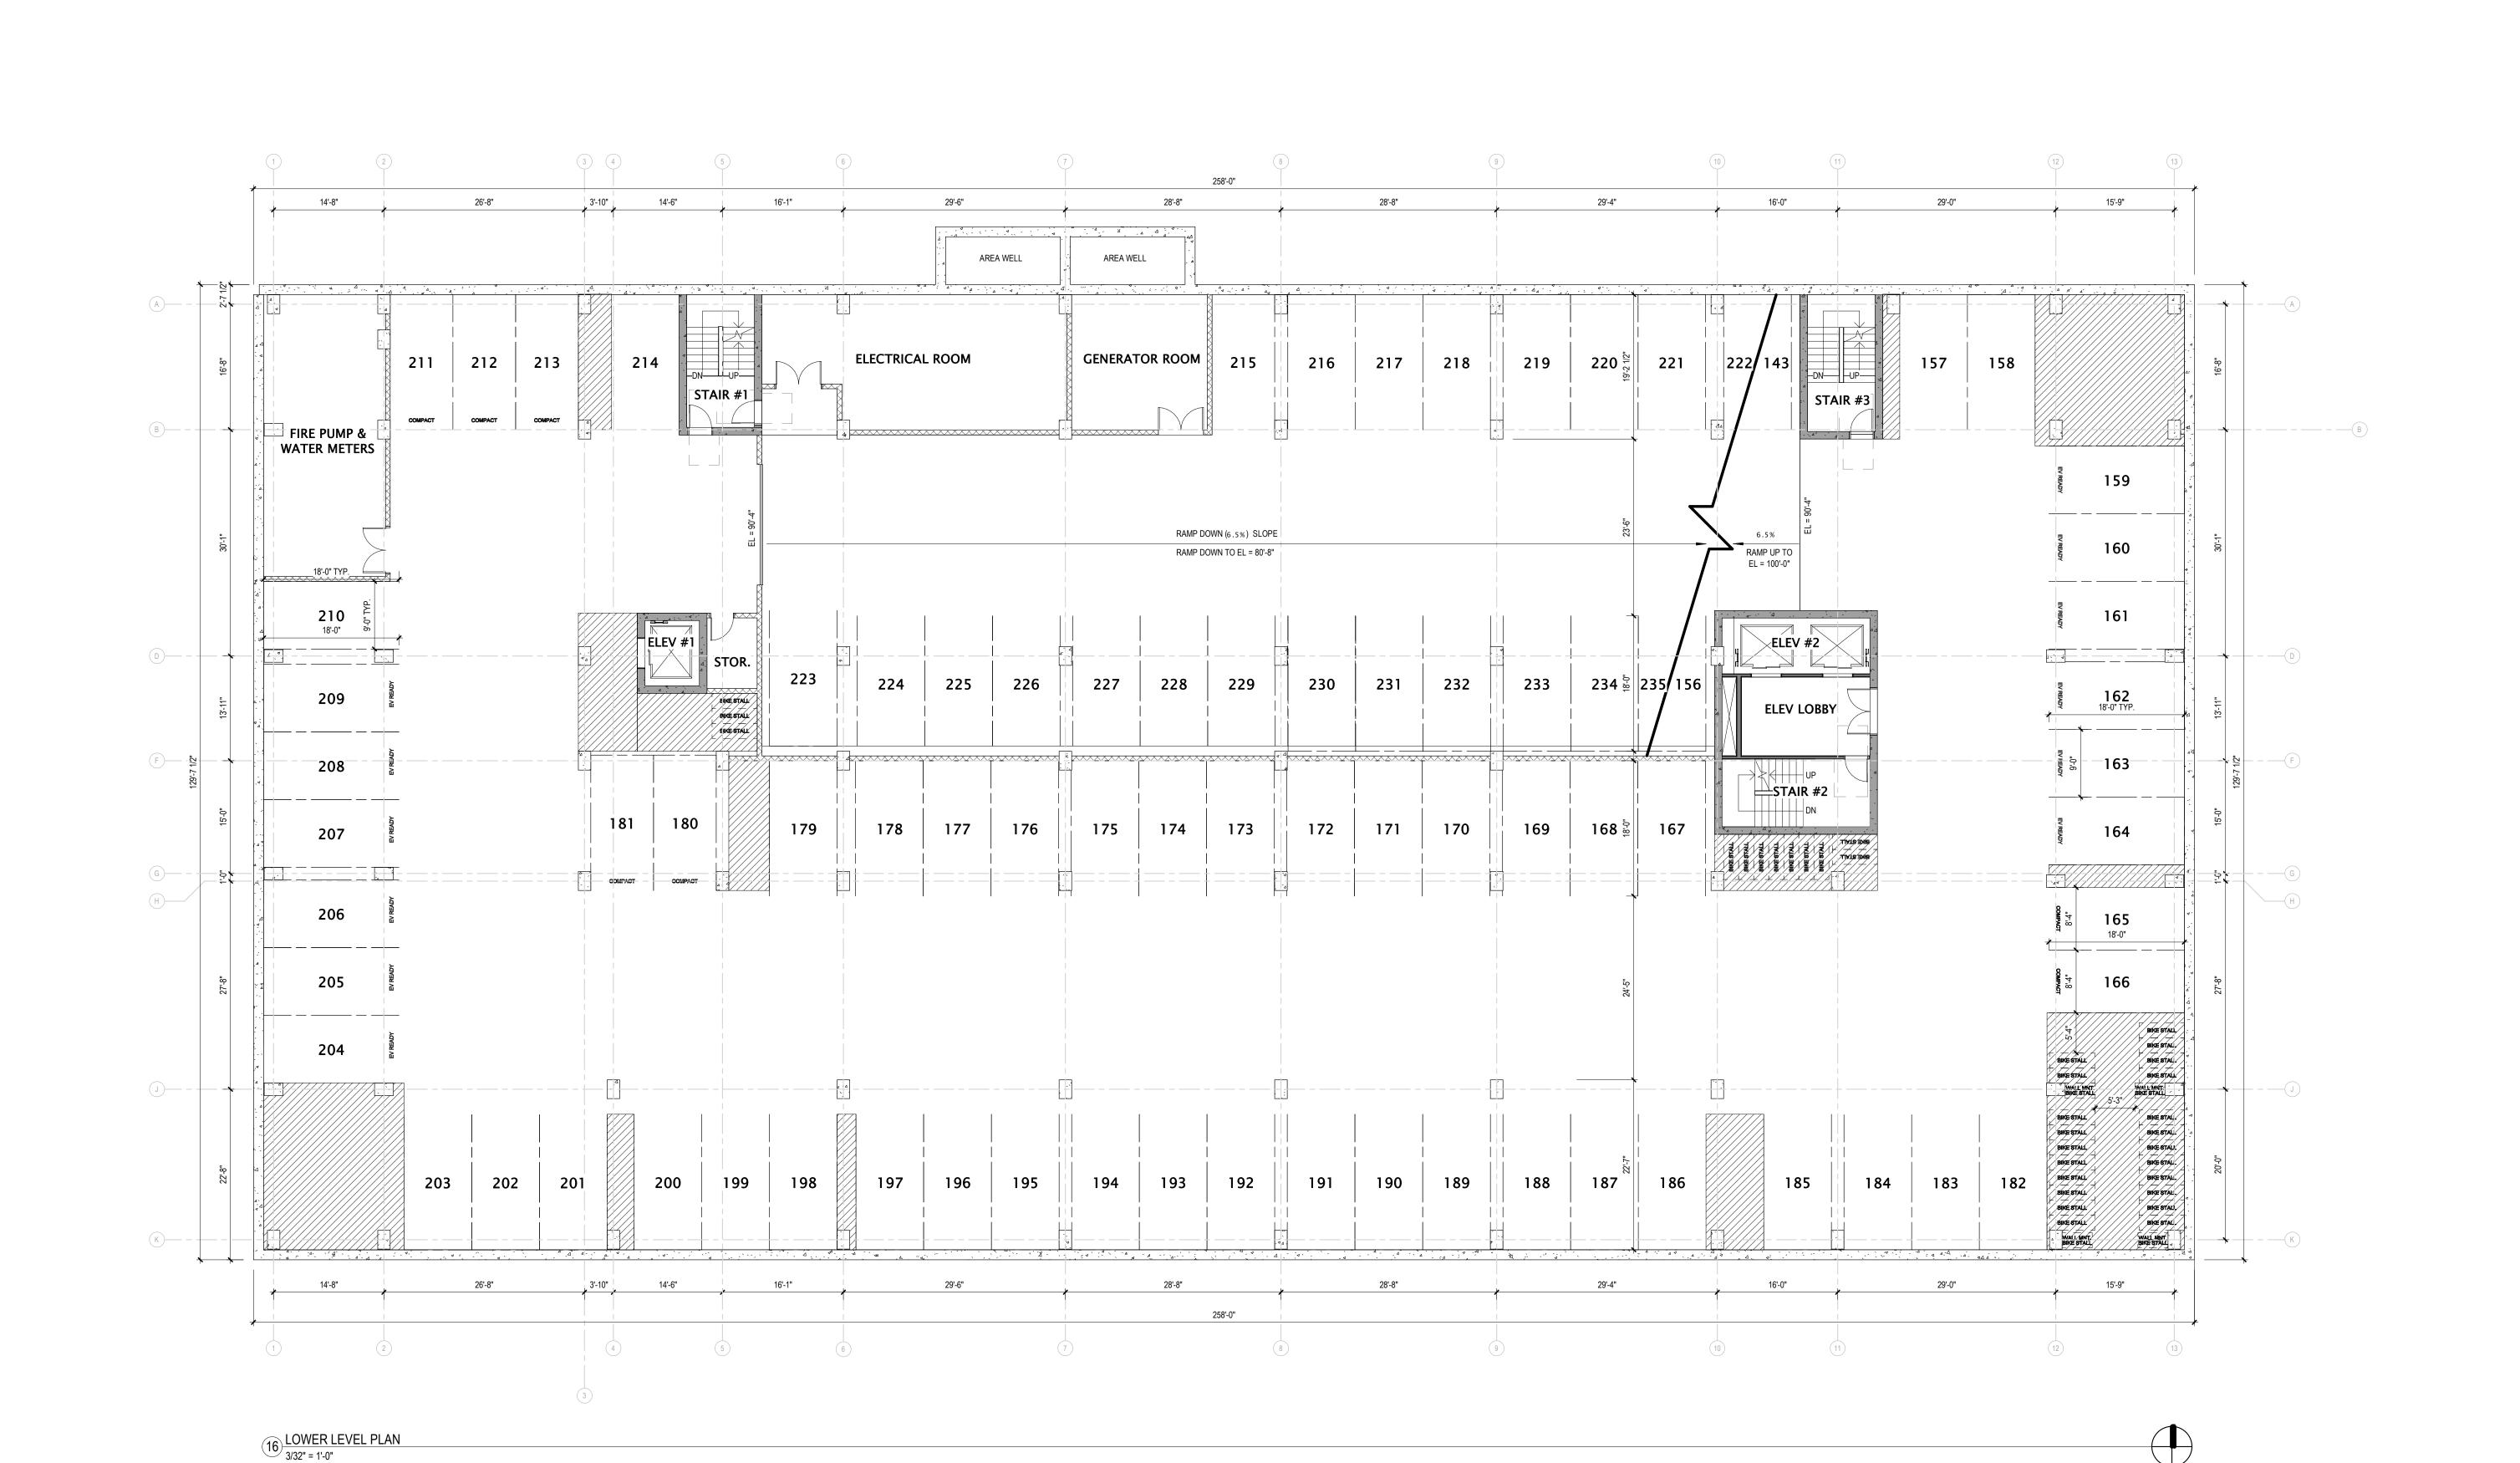
702 EAST WASHINGTON AVENUE MIXED-USE DEVELOPMENT

CITY OF MADISON LAND-USE & URBAN DESIGN COMMISION SUBMITTAL

DATE OF ISSUANCE NOVEMBER 27, 2023 REVISION SCHEDULE Description

LOWER LEVEL 1 PLAN

SHEET NUMBER



BUILDING DIMENSIONS ARE TO OUTSIDE FACE OF STUD 5. OR MASONRY WALLS UNLESS OTHERWISE NOTED.

OPENINGS WITH MANUFACTURER.

- WINDOW & DOOR LOCATION DIMENSIONS ARE TO CENTERLINE OF WINDOW/DOOR UNLESS OTHERWISE 6.
- VERIFY ALL STRUCTURAL MEMBER SIZE, SPACING,

NOTED. CONTRACTOR SHALL VERIFY ALL ROUGH

- REINFORCING, AND BRACING WITH STRUCTURAL
- ALL WOOD EXPOSED TO THE EXTERIOR OR IN CONTACT 8. WITH CONCRETE OR MASONRY SHALL BE PRESSURE
- VERIFY ALL WINDOW, DOOR, TUB, SHOWER, FIREPLACE, 9. INSTALL FIXTURES, ACCESSORIES, ETC. ACCORDING TO APPLIANCE, EQUIPMENT, ETC. ROUGH OPENINGS & CLEARANCE REQUIREMENTS WITH MANUFACTURER.
- PROVIDE SOUND BATT INSULATION AT ALL WALLS SURROUNDING BATHROOMS, LAUNDRY ROOMS/ CLOSETS, MECHANICAL ROOMS/ CLOSETS, AND OTHER PLUMBING WALLS.
- PROVIDE BLOCKING AT ALL GRAB BAR LOCATIONS -INCLUDING LOCATIONS OF FUTURE GRAB BARS & SEATS IN BATHROOMS DESIGNATED AS ACCESSIBLE.
- PROVIDE FIREBLOCKING PER 2015 IBC 718.2.1 TYPICAL THROUGHOUT ENTIRE BUILDING.
- FIELD VERIFY ALL CABINETRY LAYOUTS AND COORDINATE WITH THE DIMENSIONAL REQUIREMENTS OF ALL

APPLIANCES & FIXTURES. PROVIDE FINISHED END PANELS

- AT ALL EXPOSED CABINETRY ENDS. CAULK AT PERIMETER OF ALL TUB & SHOWER ENCLOSURES. CAULK AT PERIMETER OF ALL COUNTERTOP BACKSPLASHES & SIDESPLASHES.
- THE MOUNTING HEIGHT SCHEDULE.
- ALL WINDOWS & PATIO DOORS SHALL BE AS SPECIFIED IN THE SCOPE SPECIFICATIONS AND AS INDICATED ON THE EXTERIOR MATERIAL AND WINDOW SCHEDULES.



JLA PROJECT NUMBER:


702 EAST WASHINGTON AVENUE MIXED-USE DEVELOPMENT

CITY OF MADISON LAND-USE & URBAN DESIGN COMMISION SUBMITTAL

NOVEMBER 27, 2023 DATE OF ISSUANCE REVISION SCHEDULE Description

FIRST FLOOR PLAN

SHEET NUMBER

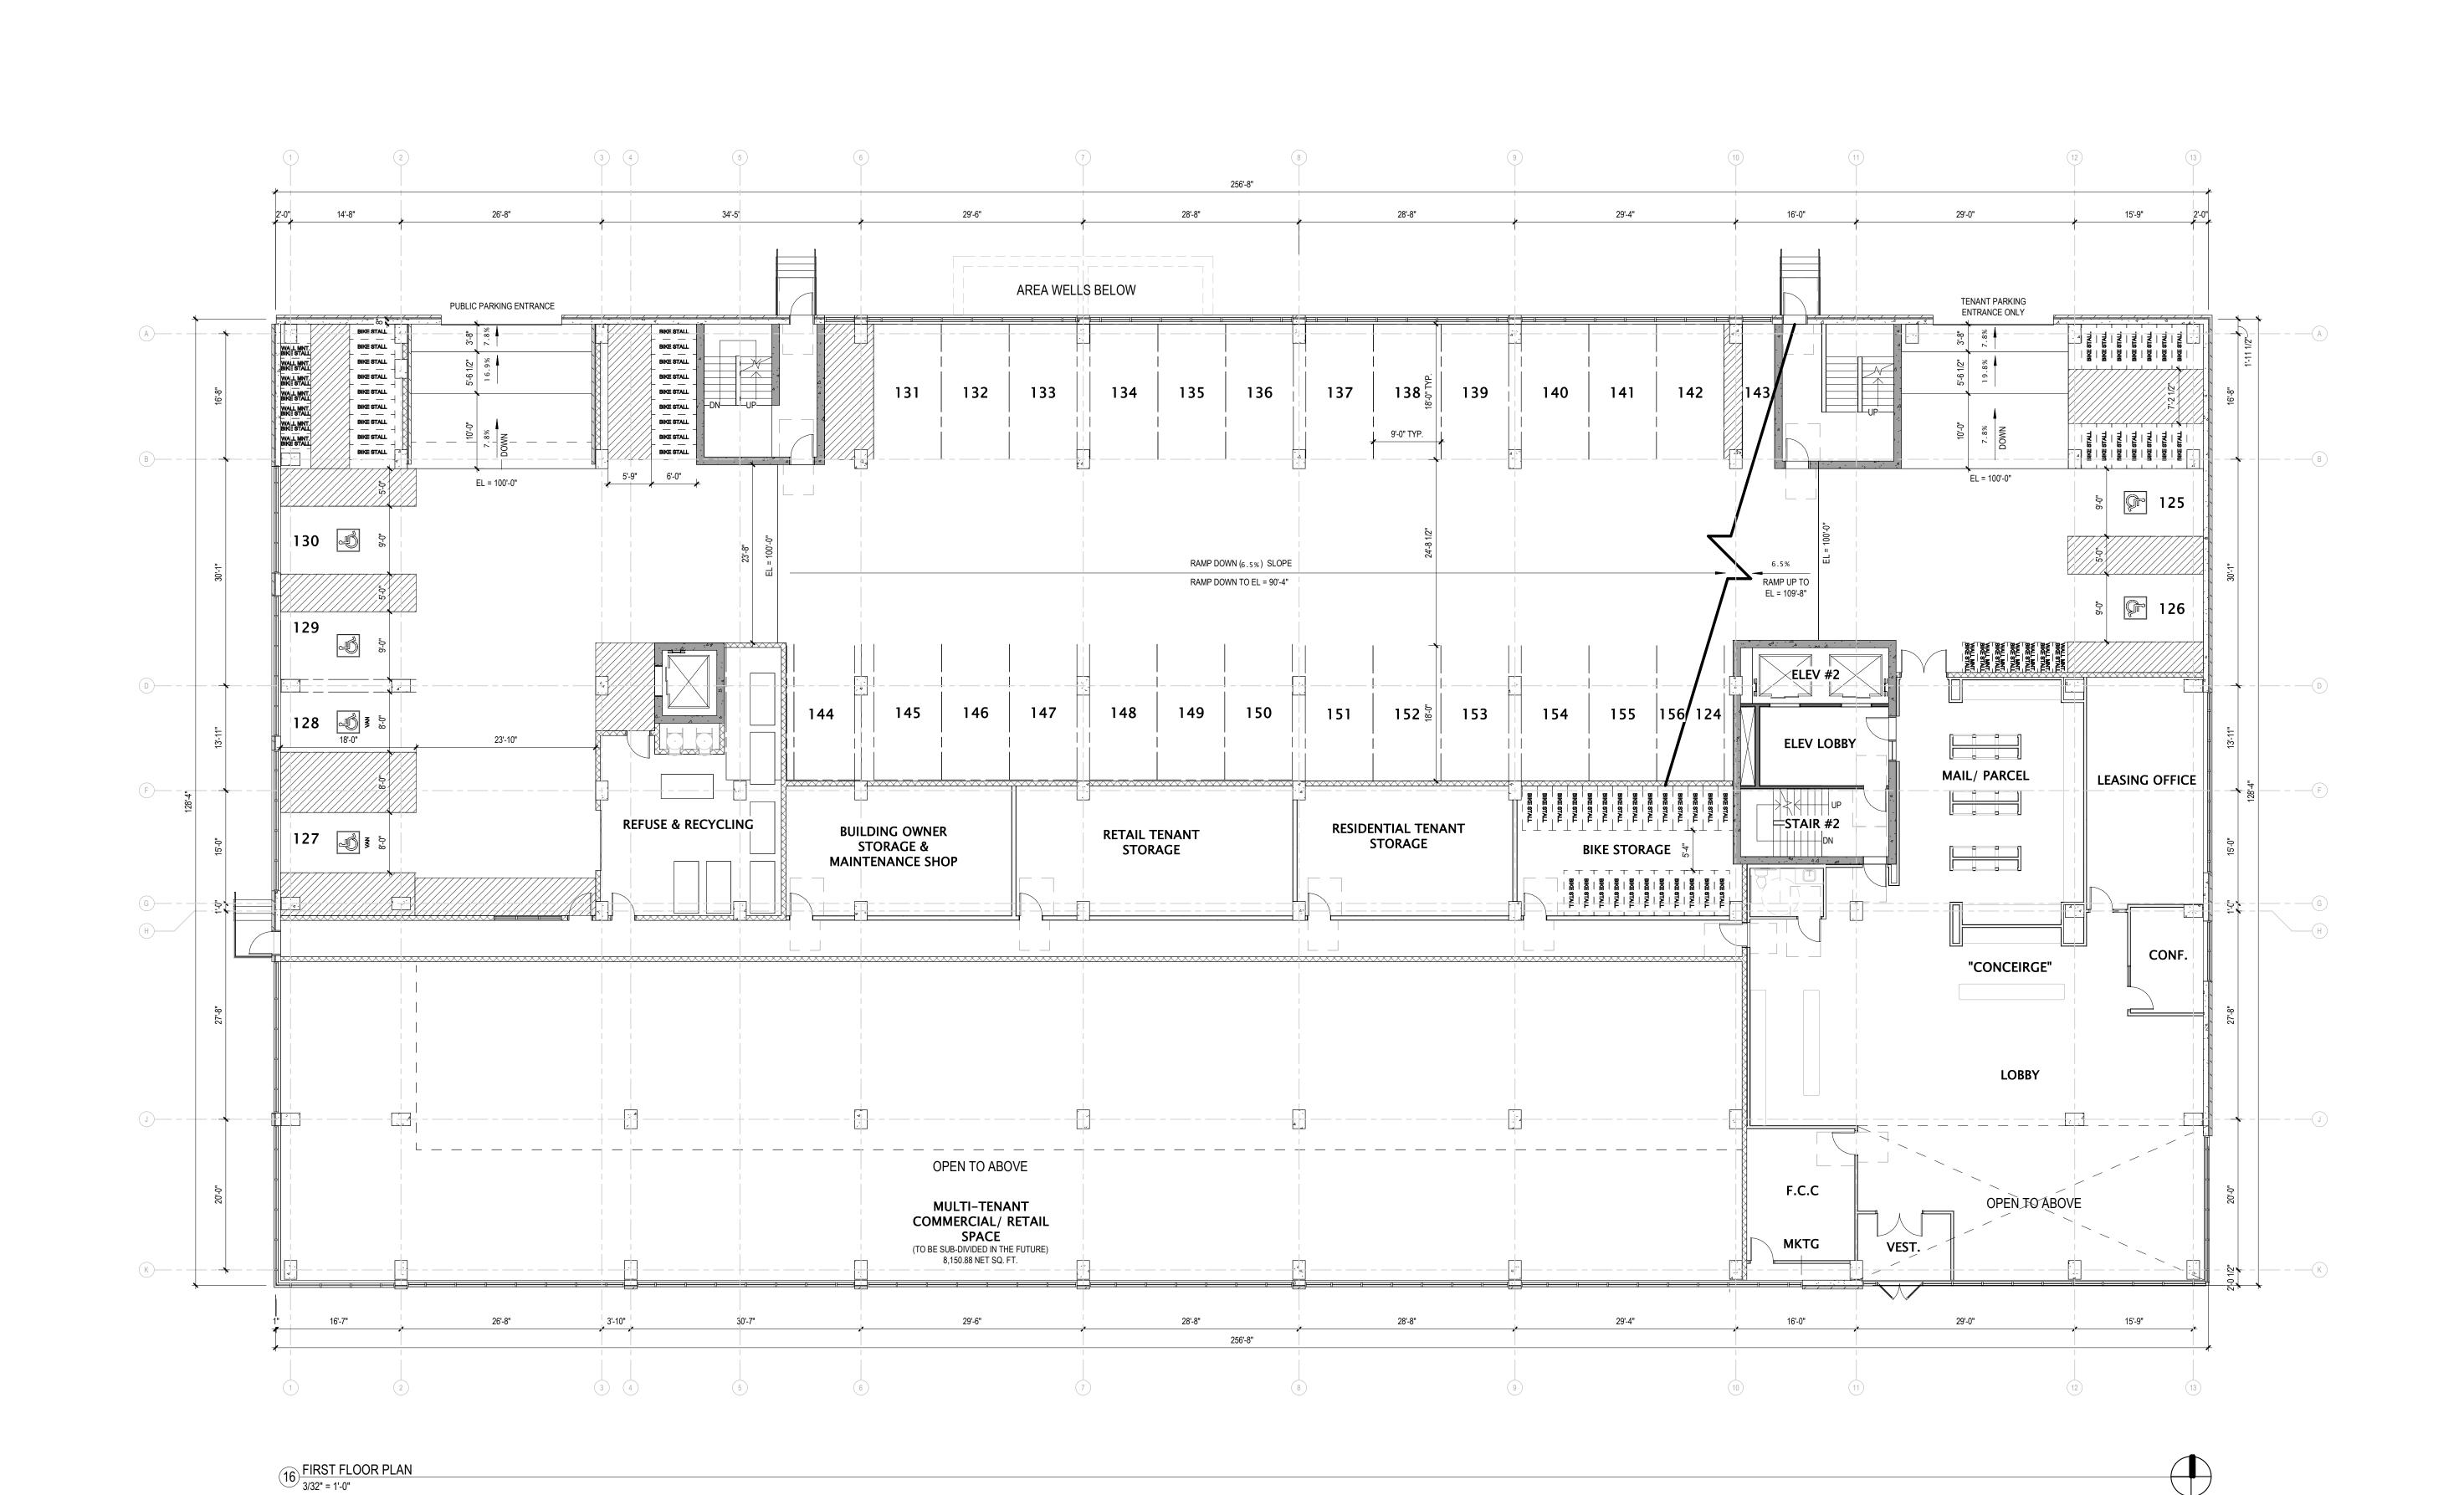

BUILDING DIMENSIONS ARE TO OUTSIDE FACE OF STUD 5. OR MASONRY WALLS UNLESS OTHERWISE NOTED.

WINDOW & DOOR LOCATION DIMENSIONS ARE TO CENTERLINE OF WINDOW/DOOR UNLESS OTHERWISE NOTED. CONTRACTOR SHALL VERIFY ALL ROUGH OPENINGS WITH MANUFACTURER.

VERIFY ALL STRUCTURAL MEMBER SIZE, SPACING, REINFORCING, AND BRACING WITH STRUCTURAL DRAWINGS.

ALL WOOD EXPOSED TO THE EXTERIOR OR IN CONTACT 8. WITH CONCRETE OR MASONRY SHALL BE PRESSURE

VERIFY ALL WINDOW, DOOR, TUB, SHOWER, FIREPLACE, 9. APPLIANCE, EQUIPMENT, ETC. ROUGH OPENINGS &

CLEARANCE REQUIREMENTS WITH MANUFACTURER.

PROVIDE SOUND BATT INSULATION AT ALL WALLS SURROUNDING BATHROOMS, LAUNDRY ROOMS/ CLOSETS, MECHANICAL ROOMS/ CLOSETS, AND OTHER PLUMBING WALLS.

PROVIDE BLOCKING AT ALL GRAB BAR LOCATIONS -INCLUDING LOCATIONS OF FUTURE GRAB BARS & SEATS IN BATHROOMS DESIGNATED AS ACCESSIBLE.

PROVIDE FIREBLOCKING PER 2015 IBC 718.2.1 - TYPICAL THROUGHOUT ENTIRE BUILDING. FIELD VERIFY ALL CABINETRY LAYOUTS AND COORDINATE

APPLIANCES & FIXTURES. PROVIDE FINISHED END PANELS AT ALL EXPOSED CABINETRY ENDS. CAULK AT PERIMETER OF ALL TUB & SHOWER

WITH THE DIMENSIONAL REQUIREMENTS OF ALL

ENCLOSURES. CAULK AT PERIMETER OF ALL COUNTERTOP BACKSPLASHES & SIDESPLASHES.

INSTALL FIXTURES, ACCESSORIES, ETC. ACCORDING TO THE MOUNTING HEIGHT SCHEDULE. 10. ALL WINDOWS & PATIO DOORS SHALL BE AS SPECIFIED IN THE SCOPE SPECIFICATIONS AND AS INDICATED ON THE EXTERIOR MATERIAL AND WINDOW SCHEDULES.

ARCHITECTS MADISON | MILWAUKEE | DENVER

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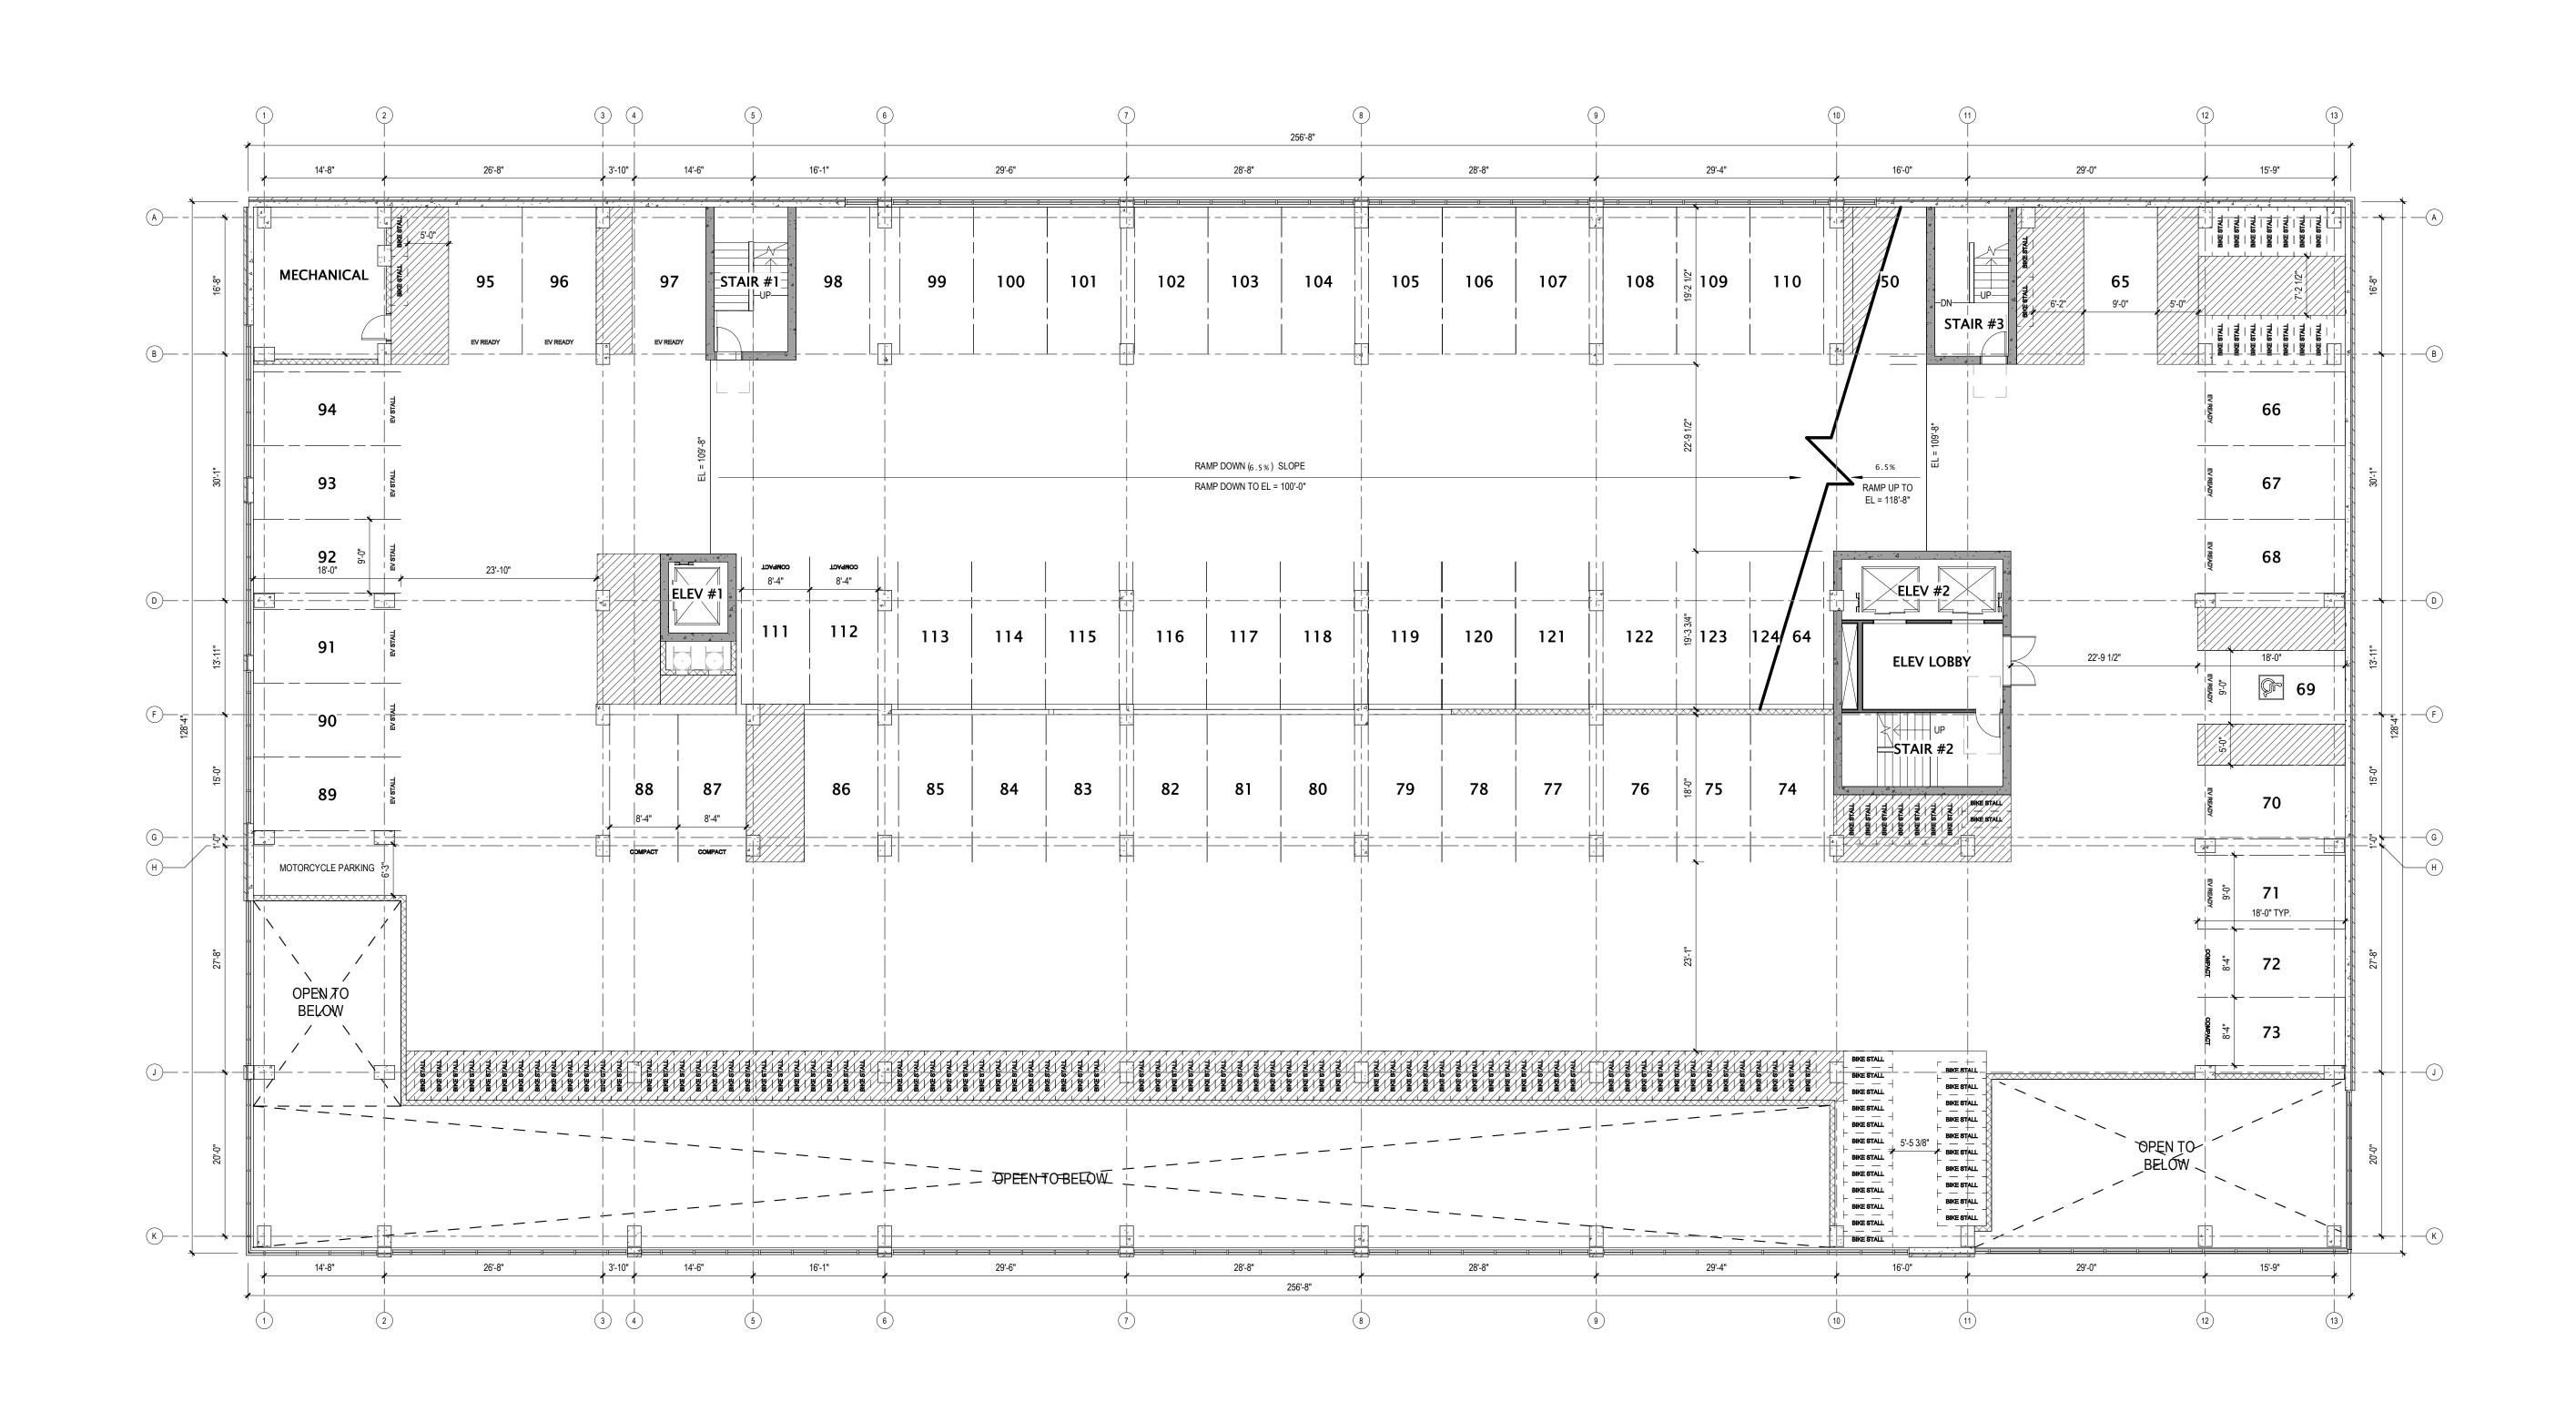
702 EAST WASHINGTON AVENUE MIXED-USE DEVELOPMENT

CITY OF MADISON LAND-USE & URBAN DESIGN COMMISION SUBMITTAL

DATE OF ISSUANCE NOVEMBER 27, 2023 REVISION SCHEDULE

PARKING 1.5

A101.5



1 PARKING 1.5 3/32" = 1'-0"

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- WINDOW & DOOR LOCATION DIMENSIONS ARE TO CENTERLINE OF WINDOW/DOOR UNLESS OTHERWISE 6. PROVIDE FIREBLOCKING PER 2015 IBC 718.2.1 - TYPICAL NOTED. CONTRACTOR SHALL VERIFY ALL ROUGH
- VERIFY ALL STRUCTURAL MEMBER SIZE, SPACING, REINFORCING, AND BRACING WITH STRUCTURAL DRAWINGS.

OPENINGS WITH MANUFACTURER.

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PROVIDE BLOCKING AT ALL GRAB BAR LOCATIONS -INCLUDING LOCATIONS OF FUTURE GRAB BARS & SEATS IN BATHROOMS DESIGNATED AS ACCESSIBLE.

WITH THE DIMENSIONAL REQUIREMENTS OF ALL

THROUGHOUT ENTIRE BUILDING. FIELD VERIFY ALL CABINETRY LAYOUTS AND COORDINATE

APPLIANCES & FIXTURES. PROVIDE FINISHED END PANELS

ALL WINDOWS & PATIO DOORS SHALL BE AS SPECIFIED IN

THE SCOPE SPECIFICATIONS AND AS INDICATED ON THE

CAULK AT PERIMETER OF ALL TUB & SHOWER ENCLOSURES. CAULK AT PERIMETER OF ALL

COUNTERTOP BACKSPLASHES & SIDESPLASHES.

EXTERIOR MATERIAL AND WINDOW SCHEDULES.

AT ALL EXPOSED CABINETRY ENDS.

THE MOUNTING HEIGHT SCHEDULE.

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JLA PROJECT NUMBER:

702 EAST WASHINGTON AVENUE MIXED-USE DEVELOPMENT


CITY OF MADISON LAND-USE & URBAN DESIGN COMMISION SUBMITTAL

DATE OF ISSUANCE NOVEMBER 27, 2023 REVISION SCHEDULE

Description

SECOND FLOOR PLAN

SHEET NUMBER

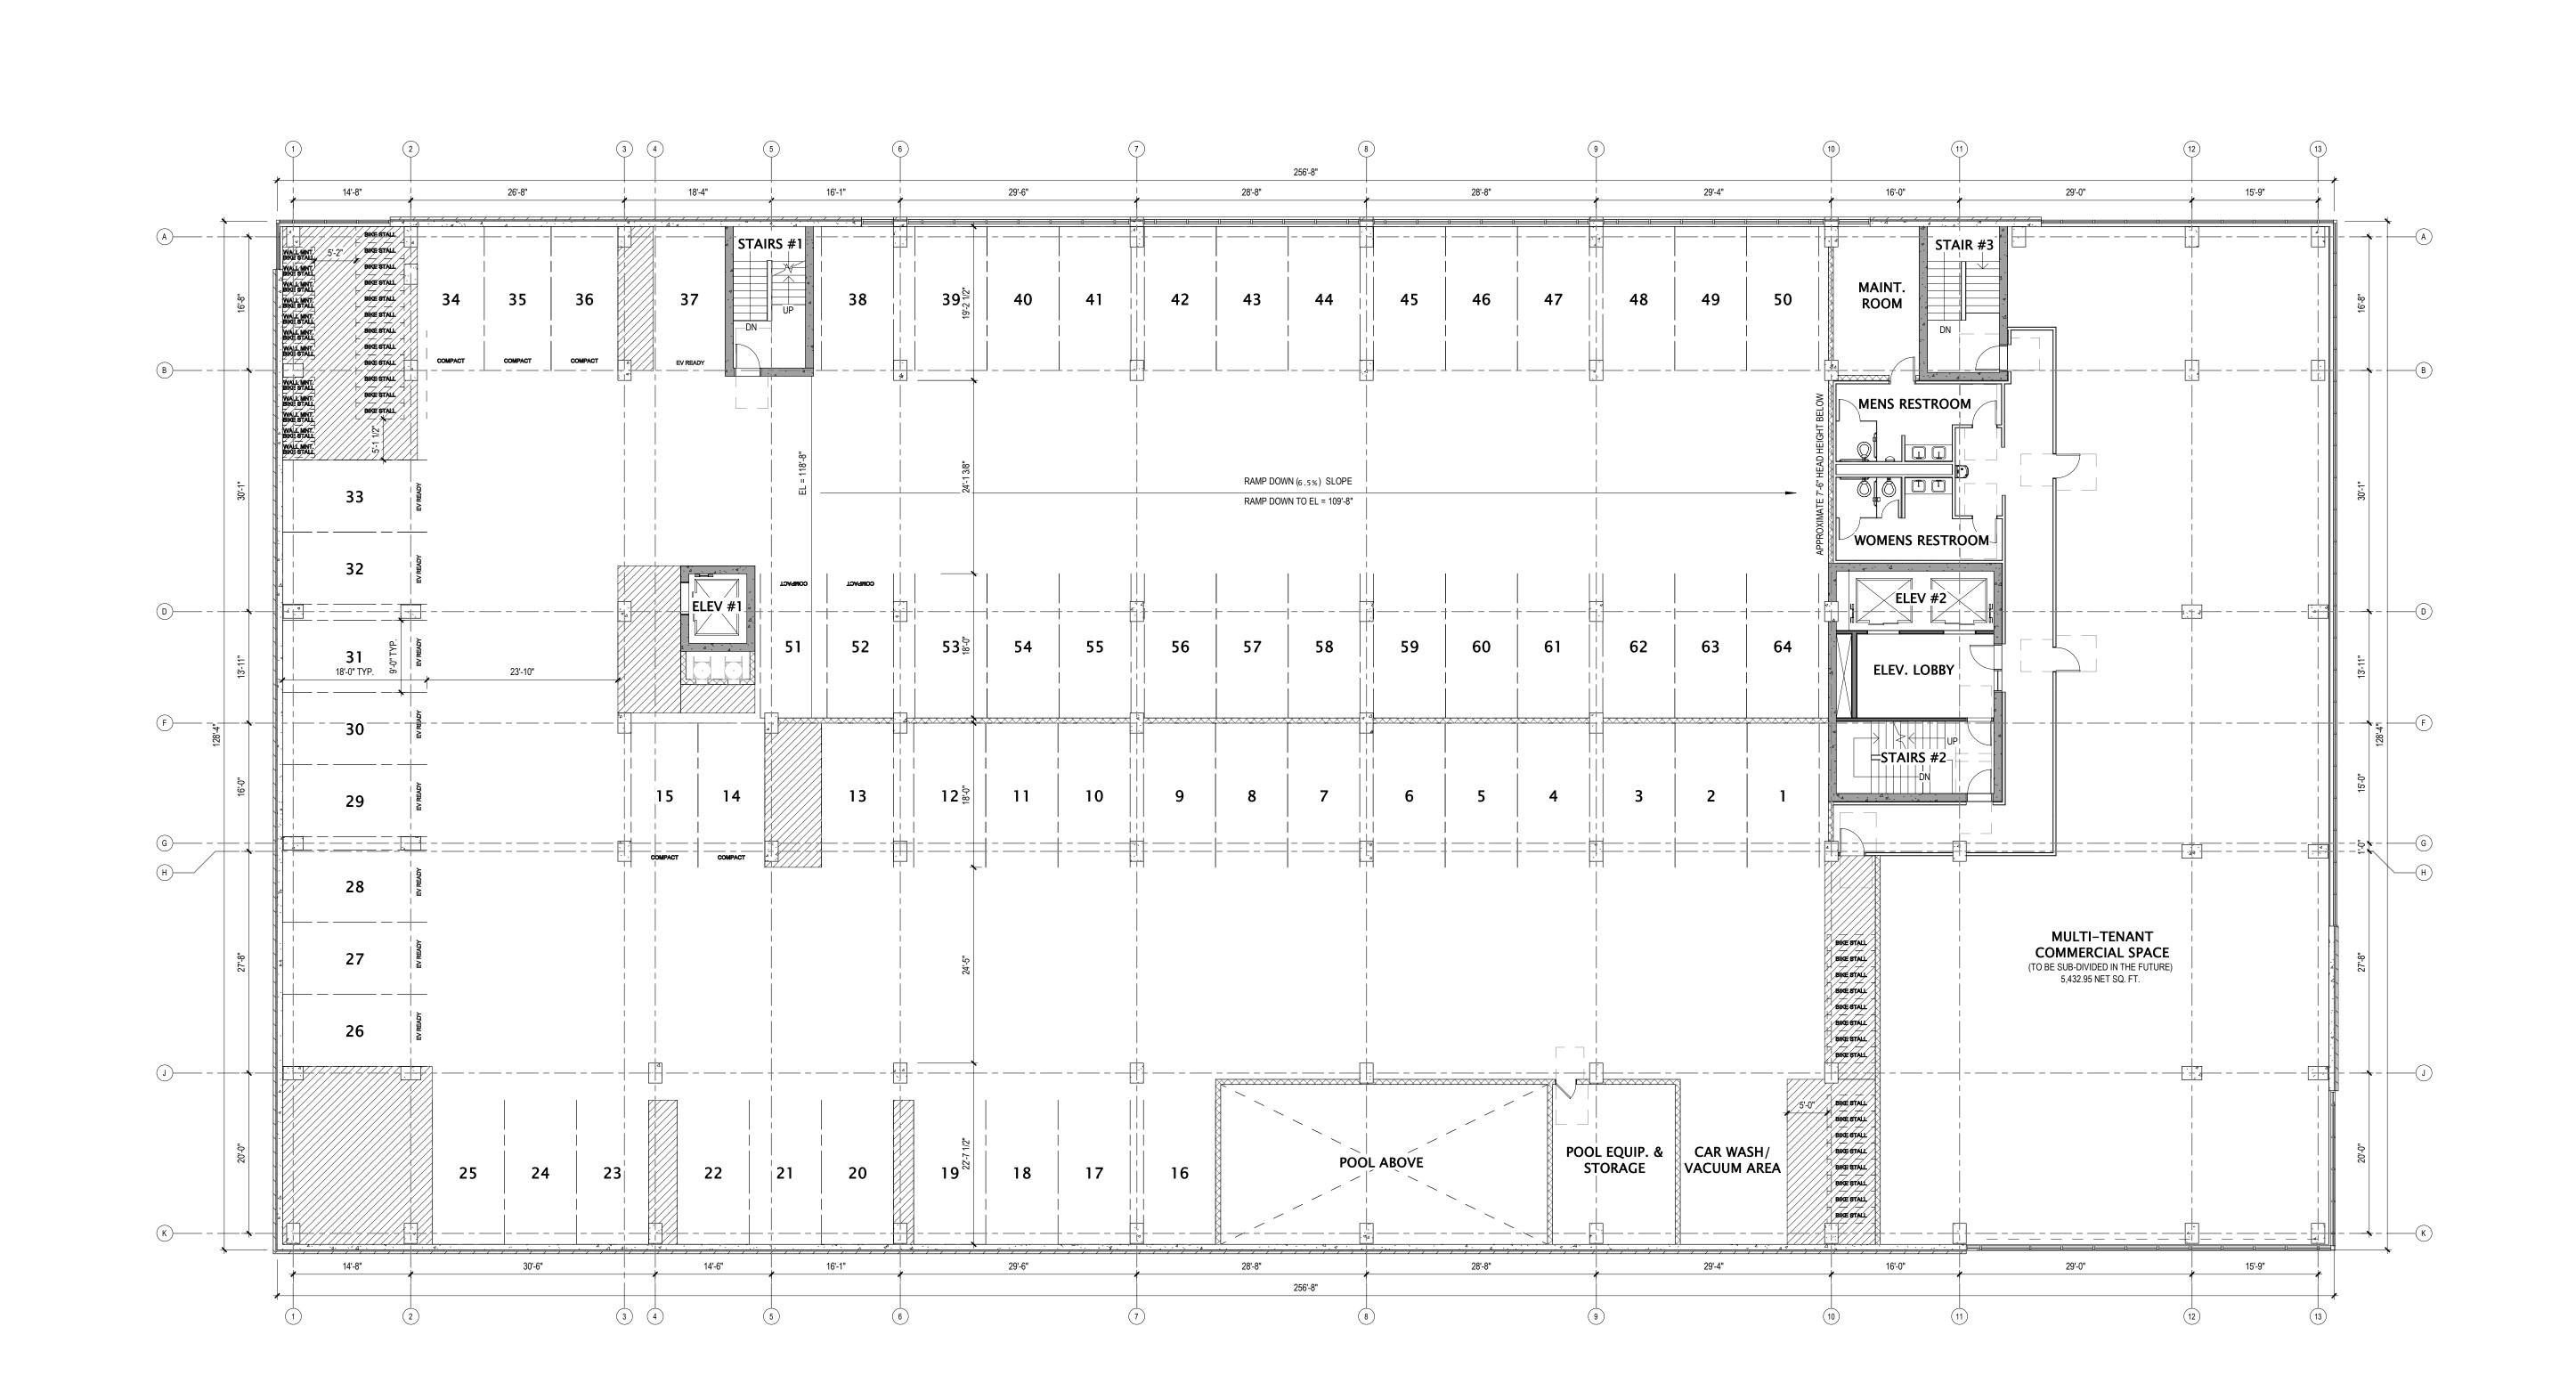

 $16) \frac{\text{SECOND FLOOR PLAN}}{3/32" = 1'-0"}$

BUILDING DIMENSIONS ARE TO OUTSIDE FACE OF STUD 5. OR MASONRY WALLS UNLESS OTHERWISE NOTED.

OPENINGS WITH MANUFACTURER.

- WINDOW & DOOR LOCATION DIMENSIONS ARE TO CENTERLINE OF WINDOW/DOOR UNLESS OTHERWISE 6. NOTED. CONTRACTOR SHALL VERIFY ALL ROUGH
- VERIFY ALL STRUCTURAL MEMBER SIZE, SPACING, REINFORCING, AND BRACING WITH STRUCTURAL DRAWINGS.
- ALL WOOD EXPOSED TO THE EXTERIOR OR IN CONTACT 8. WITH CONCRETE OR MASONRY SHALL BE PRESSURE
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- PROVIDE FIREBLOCKING PER 2015 IBC 718.2.1 TYPICAL THROUGHOUT ENTIRE BUILDING.
 - FIELD VERIFY ALL CABINETRY LAYOUTS AND COORDINATE WITH THE DIMENSIONAL REQUIREMENTS OF ALL APPLIANCES & FIXTURES. PROVIDE FINISHED END PANELS AT ALL EXPOSED CABINETRY ENDS.

INSTALL FIXTURES, ACCESSORIES, ETC. ACCORDING TO

- CAULK AT PERIMETER OF ALL TUB & SHOWER ENCLOSURES. CAULK AT PERIMETER OF ALL COUNTERTOP BACKSPLASHES & SIDESPLASHES.
- THE MOUNTING HEIGHT SCHEDULE. ALL WINDOWS & PATIO DOORS SHALL BE AS SPECIFIED IN THE SCOPE SPECIFICATIONS AND AS INDICATED ON THE EXTERIOR MATERIAL AND WINDOW SCHEDULES.

VEGETATIVE ROOF LEGEND

REQUIREMENT: 50% OF TOTAL ROOF AREA TO BE A VEGETATIVE

3RD LEVEL ROOF/TERRACE AREA 14TH LEVEL ROOF/TERRACE AREA	= =	11,632 SF 2,008 SF
15TH LEVEL ROOF/TERRACE AREA TOTAL COMBINED ROOF AREA	=	22,366 SF 36,006 SF
3RD LEVELVEGETATIVE ROOF/TERRACE 15TH LEVEL VEGETATIVE ROOF	= =	3,364 14,776 SF
PERCENTAGE OF TOTAL VEGETATIVE ROC)F =	50.38% TOTAL



ARCHITECTS

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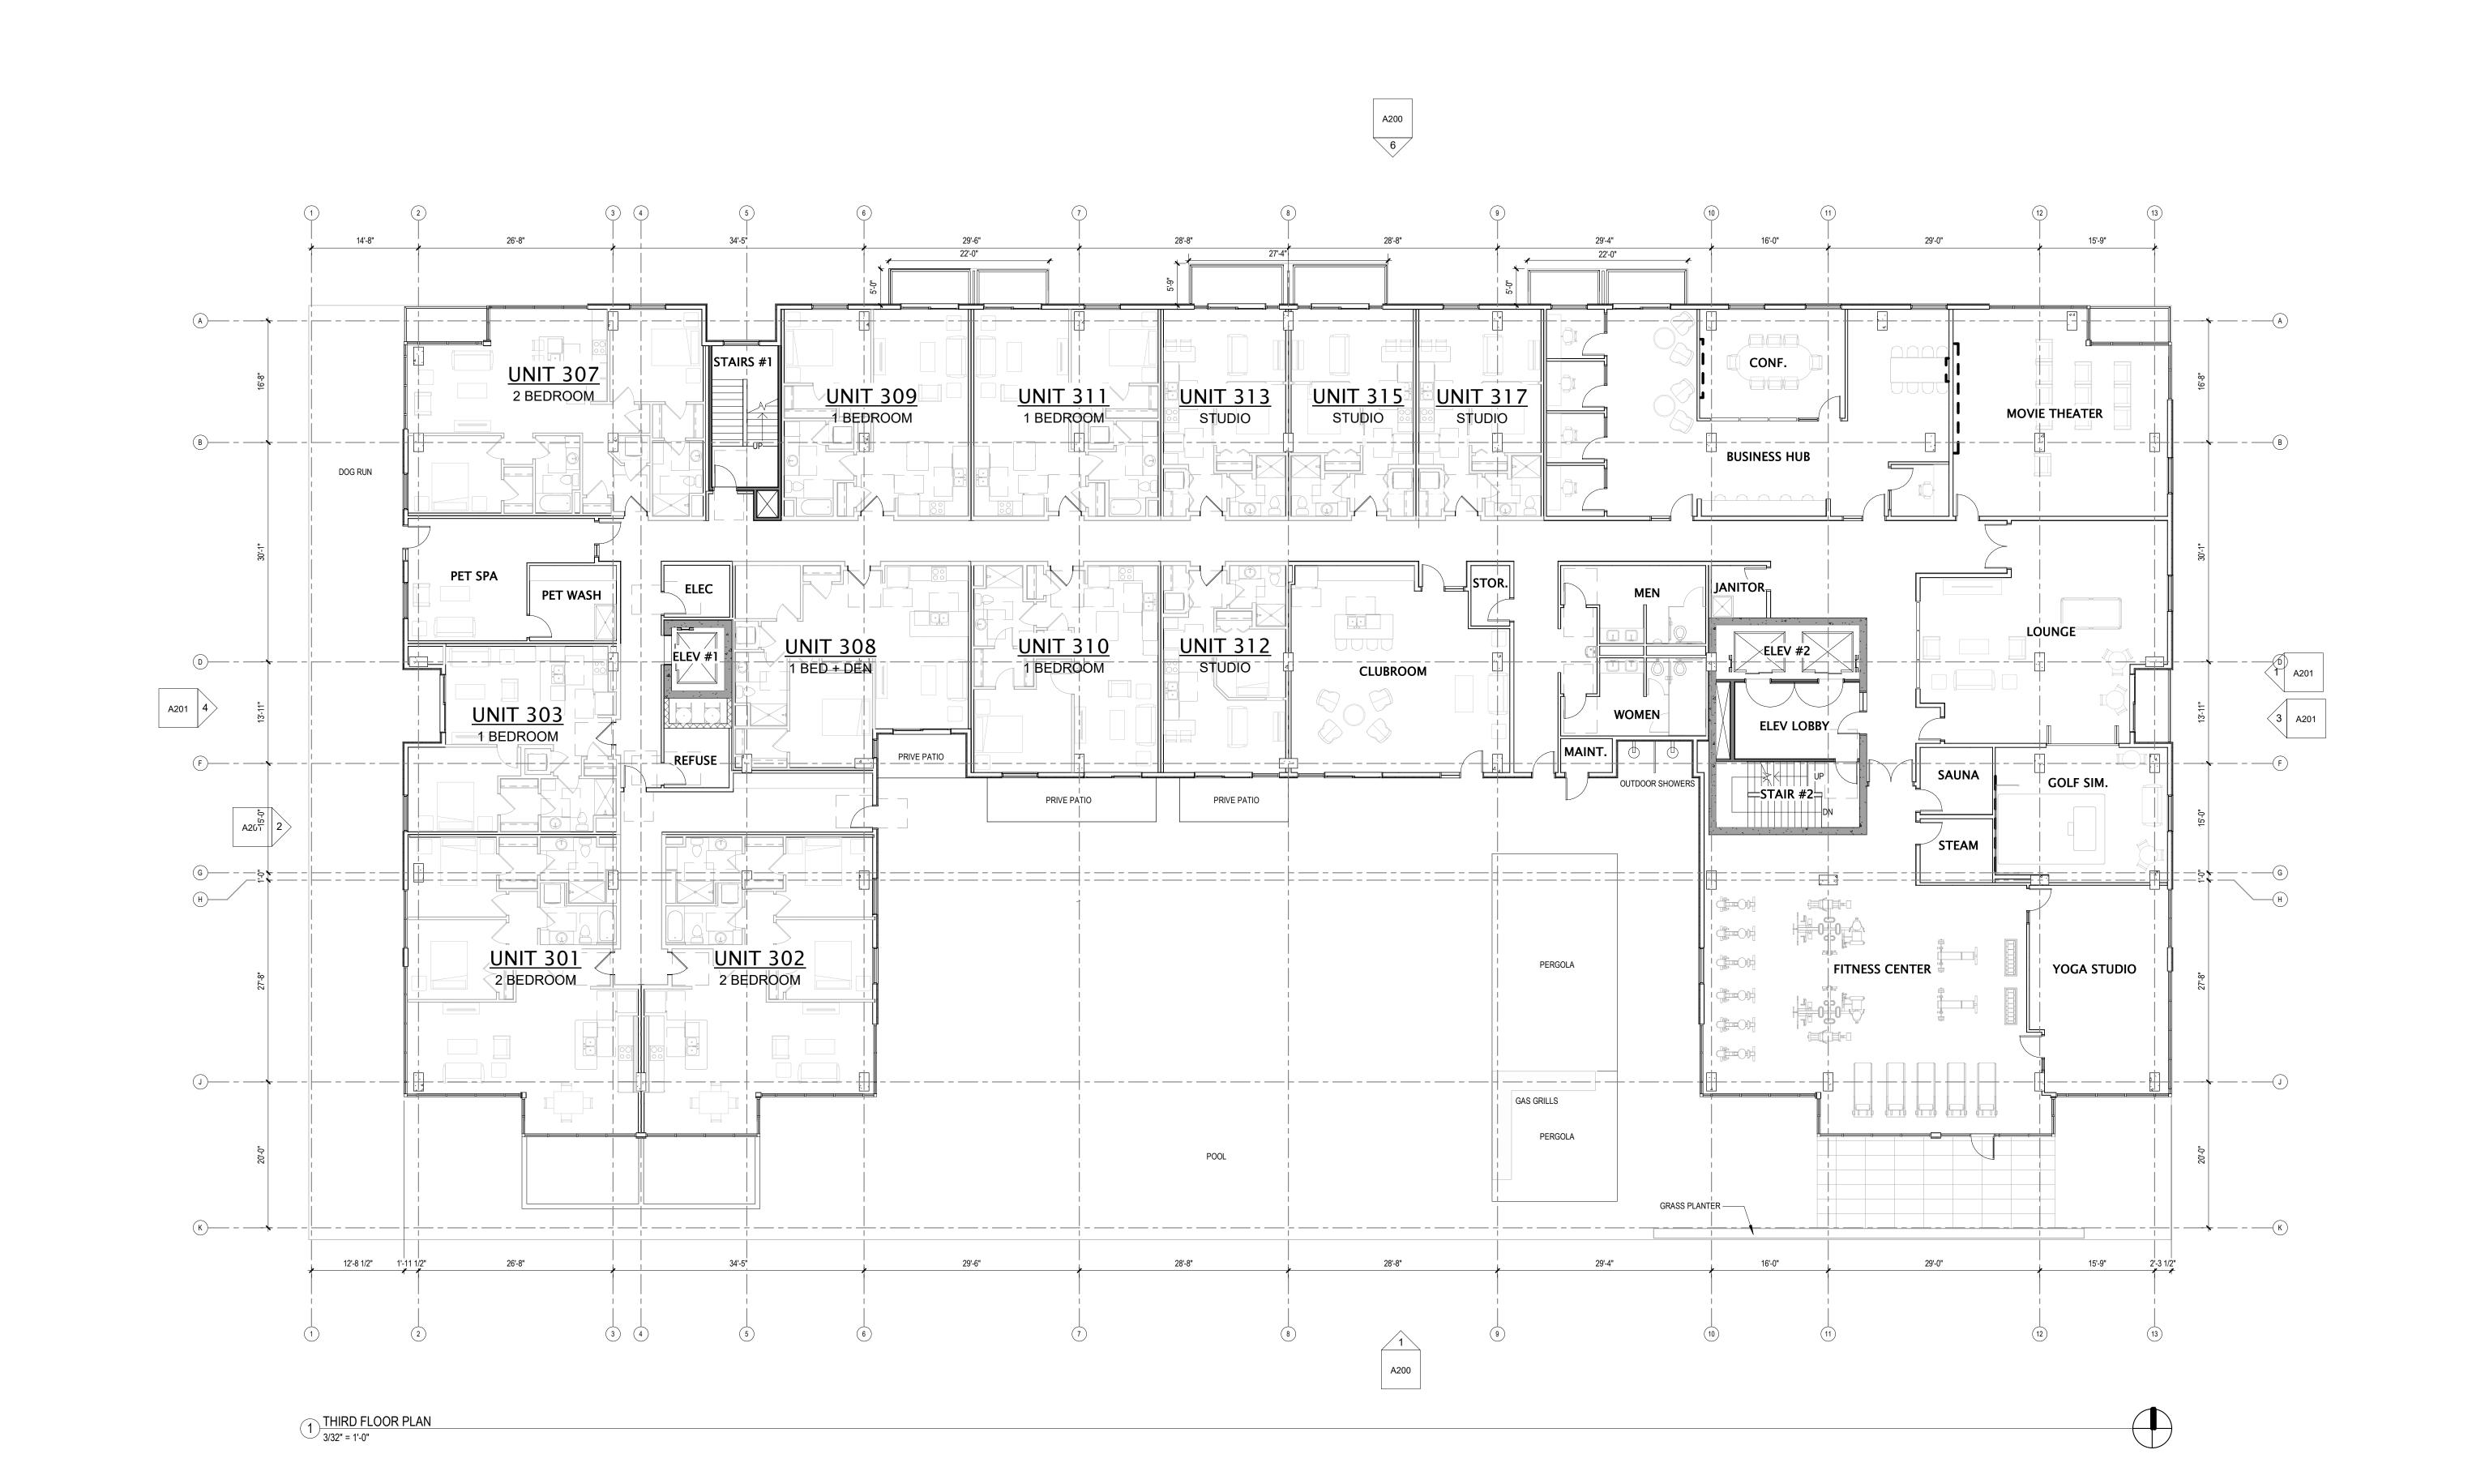
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702 EAST WASHINGTON AVENUE MIXED-USE DEVELOPMENT

CITY OF MADISON LAND-USE & URBAN DESIGN COMMISION SUBMITTAL

DATE OF ISSUANCE NOVEMBER 27, 2023 REVISION SCHEDULE

THIRD FLOOR PLAN



- BUILDING DIMENSIONS ARE TO OUTSIDE FACE OF STUD 5. OR MASONRY WALLS UNLESS OTHERWISE NOTED.
- WINDOW & DOOR LOCATION DIMENSIONS ARE TO CENTERLINE OF WINDOW/DOOR UNLESS OTHERWISE
- OPENINGS WITH MANUFACTURER. VERIFY ALL STRUCTURAL MEMBER SIZE, SPACING, REINFORCING, AND BRACING WITH STRUCTURAL
- ALL WOOD EXPOSED TO THE EXTERIOR OR IN CONTACT 8. CAULK AT PERIMETER OF ALL TUB & SHOWER WITH CONCRETE OR MASONRY SHALL BE PRESSURE

NOTED. CONTRACTOR SHALL VERIFY ALL ROUGH

- VERIFY ALL WINDOW, DOOR, TUB, SHOWER, FIREPLACE, 9. APPLIANCE, EQUIPMENT, ETC. ROUGH OPENINGS &
- CLEARANCE REQUIREMENTS WITH MANUFACTURER. PROVIDE SOUND BATT INSULATION AT ALL WALLS SURROUNDING BATHROOMS, LAUNDRY ROOMS/ CLOSETS, MECHANICAL ROOMS/ CLOSETS, AND OTHER PLUMBING WALLS.
- PROVIDE BLOCKING AT ALL GRAB BAR LOCATIONS -INCLUDING LOCATIONS OF FUTURE GRAB BARS & SEATS IN BATHROOMS DESIGNATED AS ACCESSIBLE.
- PROVIDE FIREBLOCKING PER 2015 IBC 718.2.1 TYPICAL THROUGHOUT ENTIRE BUILDING.
- FIELD VERIFY ALL CABINETRY LAYOUTS AND COORDINATE WITH THE DIMENSIONAL REQUIREMENTS OF ALL APPLIANCES & FIXTURES. PROVIDE FINISHED END PANELS
- ENCLOSURES. CAULK AT PERIMETER OF ALL COUNTERTOP BACKSPLASHES & SIDESPLASHES.

AT ALL EXPOSED CABINETRY ENDS.

INSTALL FIXTURES, ACCESSORIES, ETC. ACCORDING TO THE MOUNTING HEIGHT SCHEDULE.

EXTERIOR MATERIAL AND WINDOW SCHEDULES.

ALL WINDOWS & PATIO DOORS SHALL BE AS SPECIFIED IN

THE SCOPE SPECIFICATIONS AND AS INDICATED ON THE



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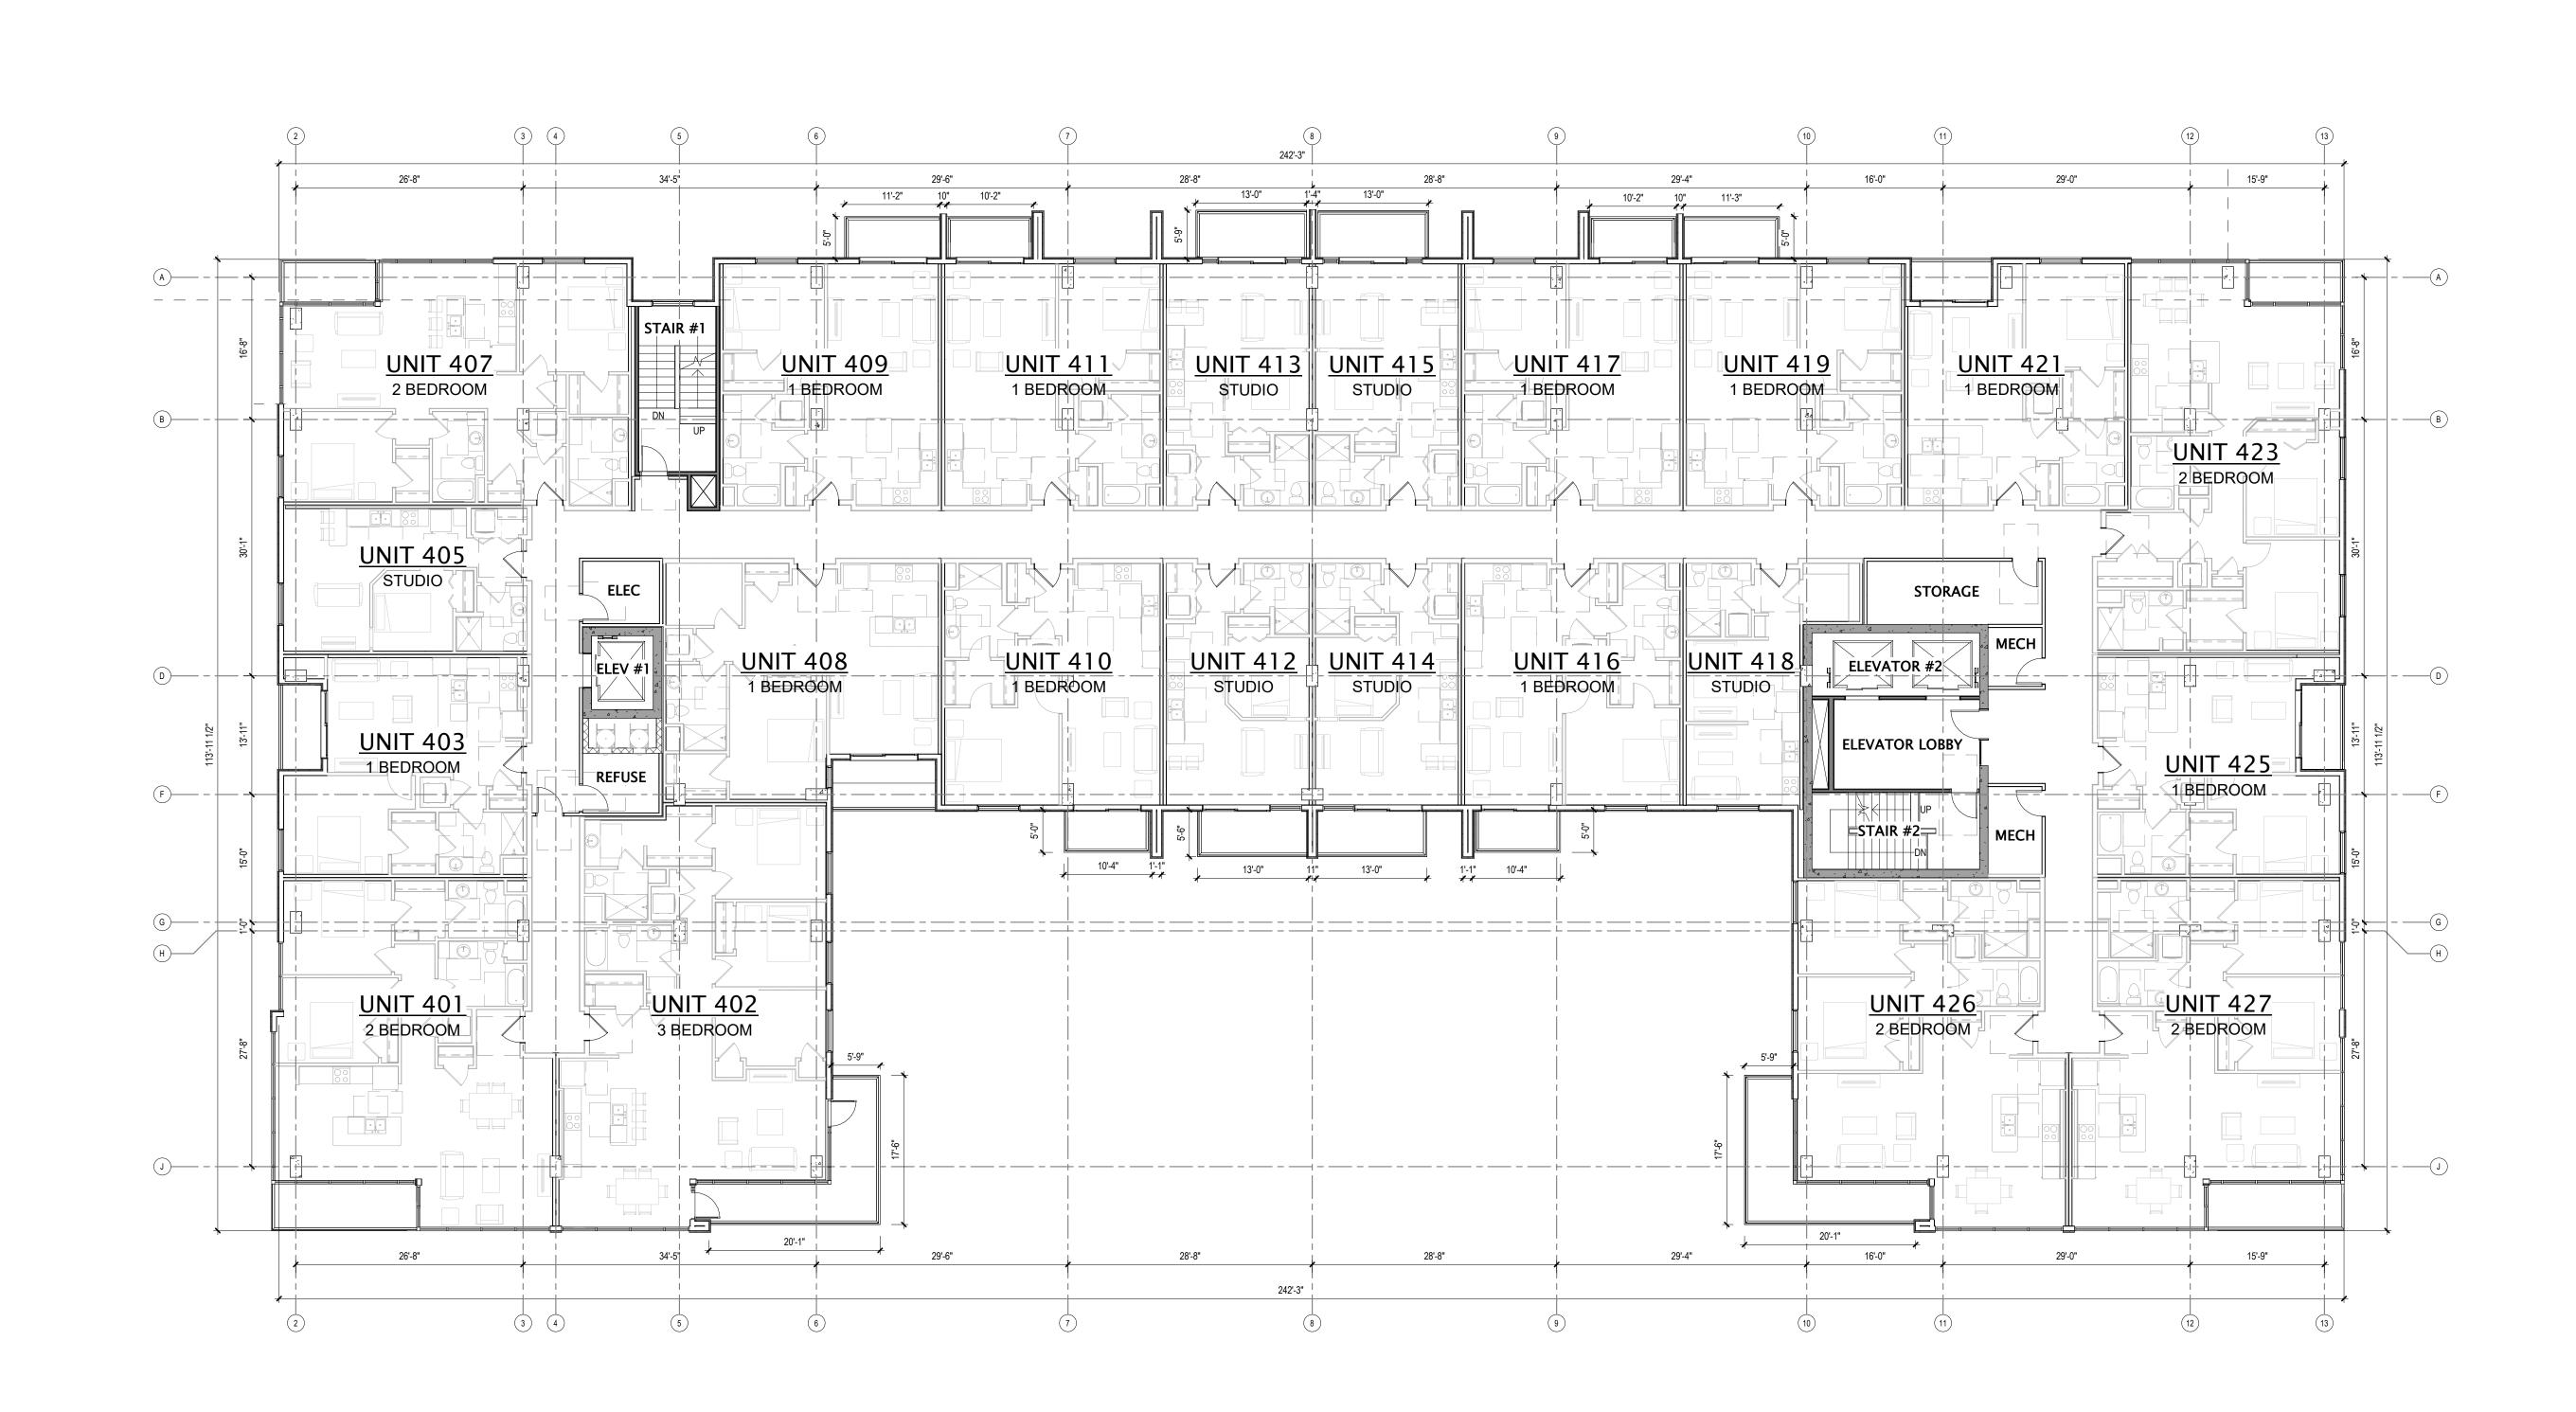
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CITY OF MADISON LAND-USE & URBAN DESIGN COMMISION SUBMITTAL

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TYPICAL FLOOR PLAN

Sheet Number




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 - WINDOW & DOOR LOCATION DIMENSIONS ARE TO CENTERLINE OF WINDOW/DOOR UNLESS OTHERWISE 6.

NOTED. CONTRACTOR SHALL VERIFY ALL ROUGH

VERIFY ALL STRUCTURAL MEMBER SIZE, SPACING, REINFORCING, AND BRACING WITH STRUCTURAL

OPENINGS WITH MANUFACTURER.

- WITH CONCRETE OR MASONRY SHALL BE PRESSURE
- VERIFY ALL WINDOW, DOOR, TUB, SHOWER, FIREPLACE, 9. INSTALL FIXTURES, ACCESSORIES, ETC. ACCORDING TO APPLIANCE, EQUIPMENT, ETC. ROUGH OPENINGS & CLEARANCE REQUIREMENTS WITH MANUFACTURER.
- PROVIDE SOUND BATT INSULATION AT ALL WALLS SURROUNDING BATHROOMS, LAUNDRY ROOMS/ CLOSETS, MECHANICAL ROOMS/ CLOSETS, AND OTHER PLUMBING WALLS.
- PROVIDE BLOCKING AT ALL GRAB BAR LOCATIONS -INCLUDING LOCATIONS OF FUTURE GRAB BARS & SEATS IN BATHROOMS DESIGNATED AS ACCESSIBLE. PROVIDE FIREBLOCKING PER 2015 IBC 718.2.1 - TYPICAL
- THROUGHOUT ENTIRE BUILDING. FIELD VERIFY ALL CABINETRY LAYOUTS AND COORDINATE WITH THE DIMENSIONAL REQUIREMENTS OF ALL APPLIANCES & FIXTURES. PROVIDE FINISHED END PANELS AT ALL EXPOSED CABINETRY ENDS.
- ALL WOOD EXPOSED TO THE EXTERIOR OR IN CONTACT 8. CAULK AT PERIMETER OF ALL TUB & SHOWER ENCLOSURES. CAULK AT PERIMETER OF ALL COUNTERTOP BACKSPLASHES & SIDESPLASHES.
 - THE MOUNTING HEIGHT SCHEDULE. ALL WINDOWS & PATIO DOORS SHALL BE AS SPECIFIED IN THE SCOPE SPECIFICATIONS AND AS INDICATED ON THE EXTERIOR MATERIAL AND WINDOW SCHEDULES.

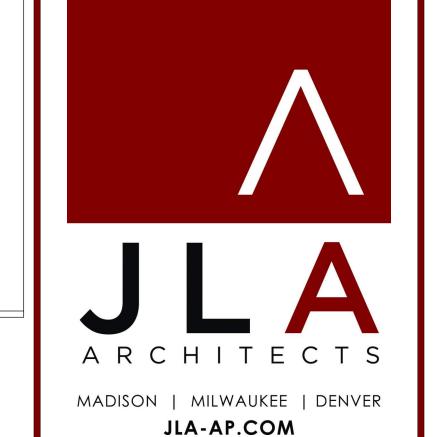

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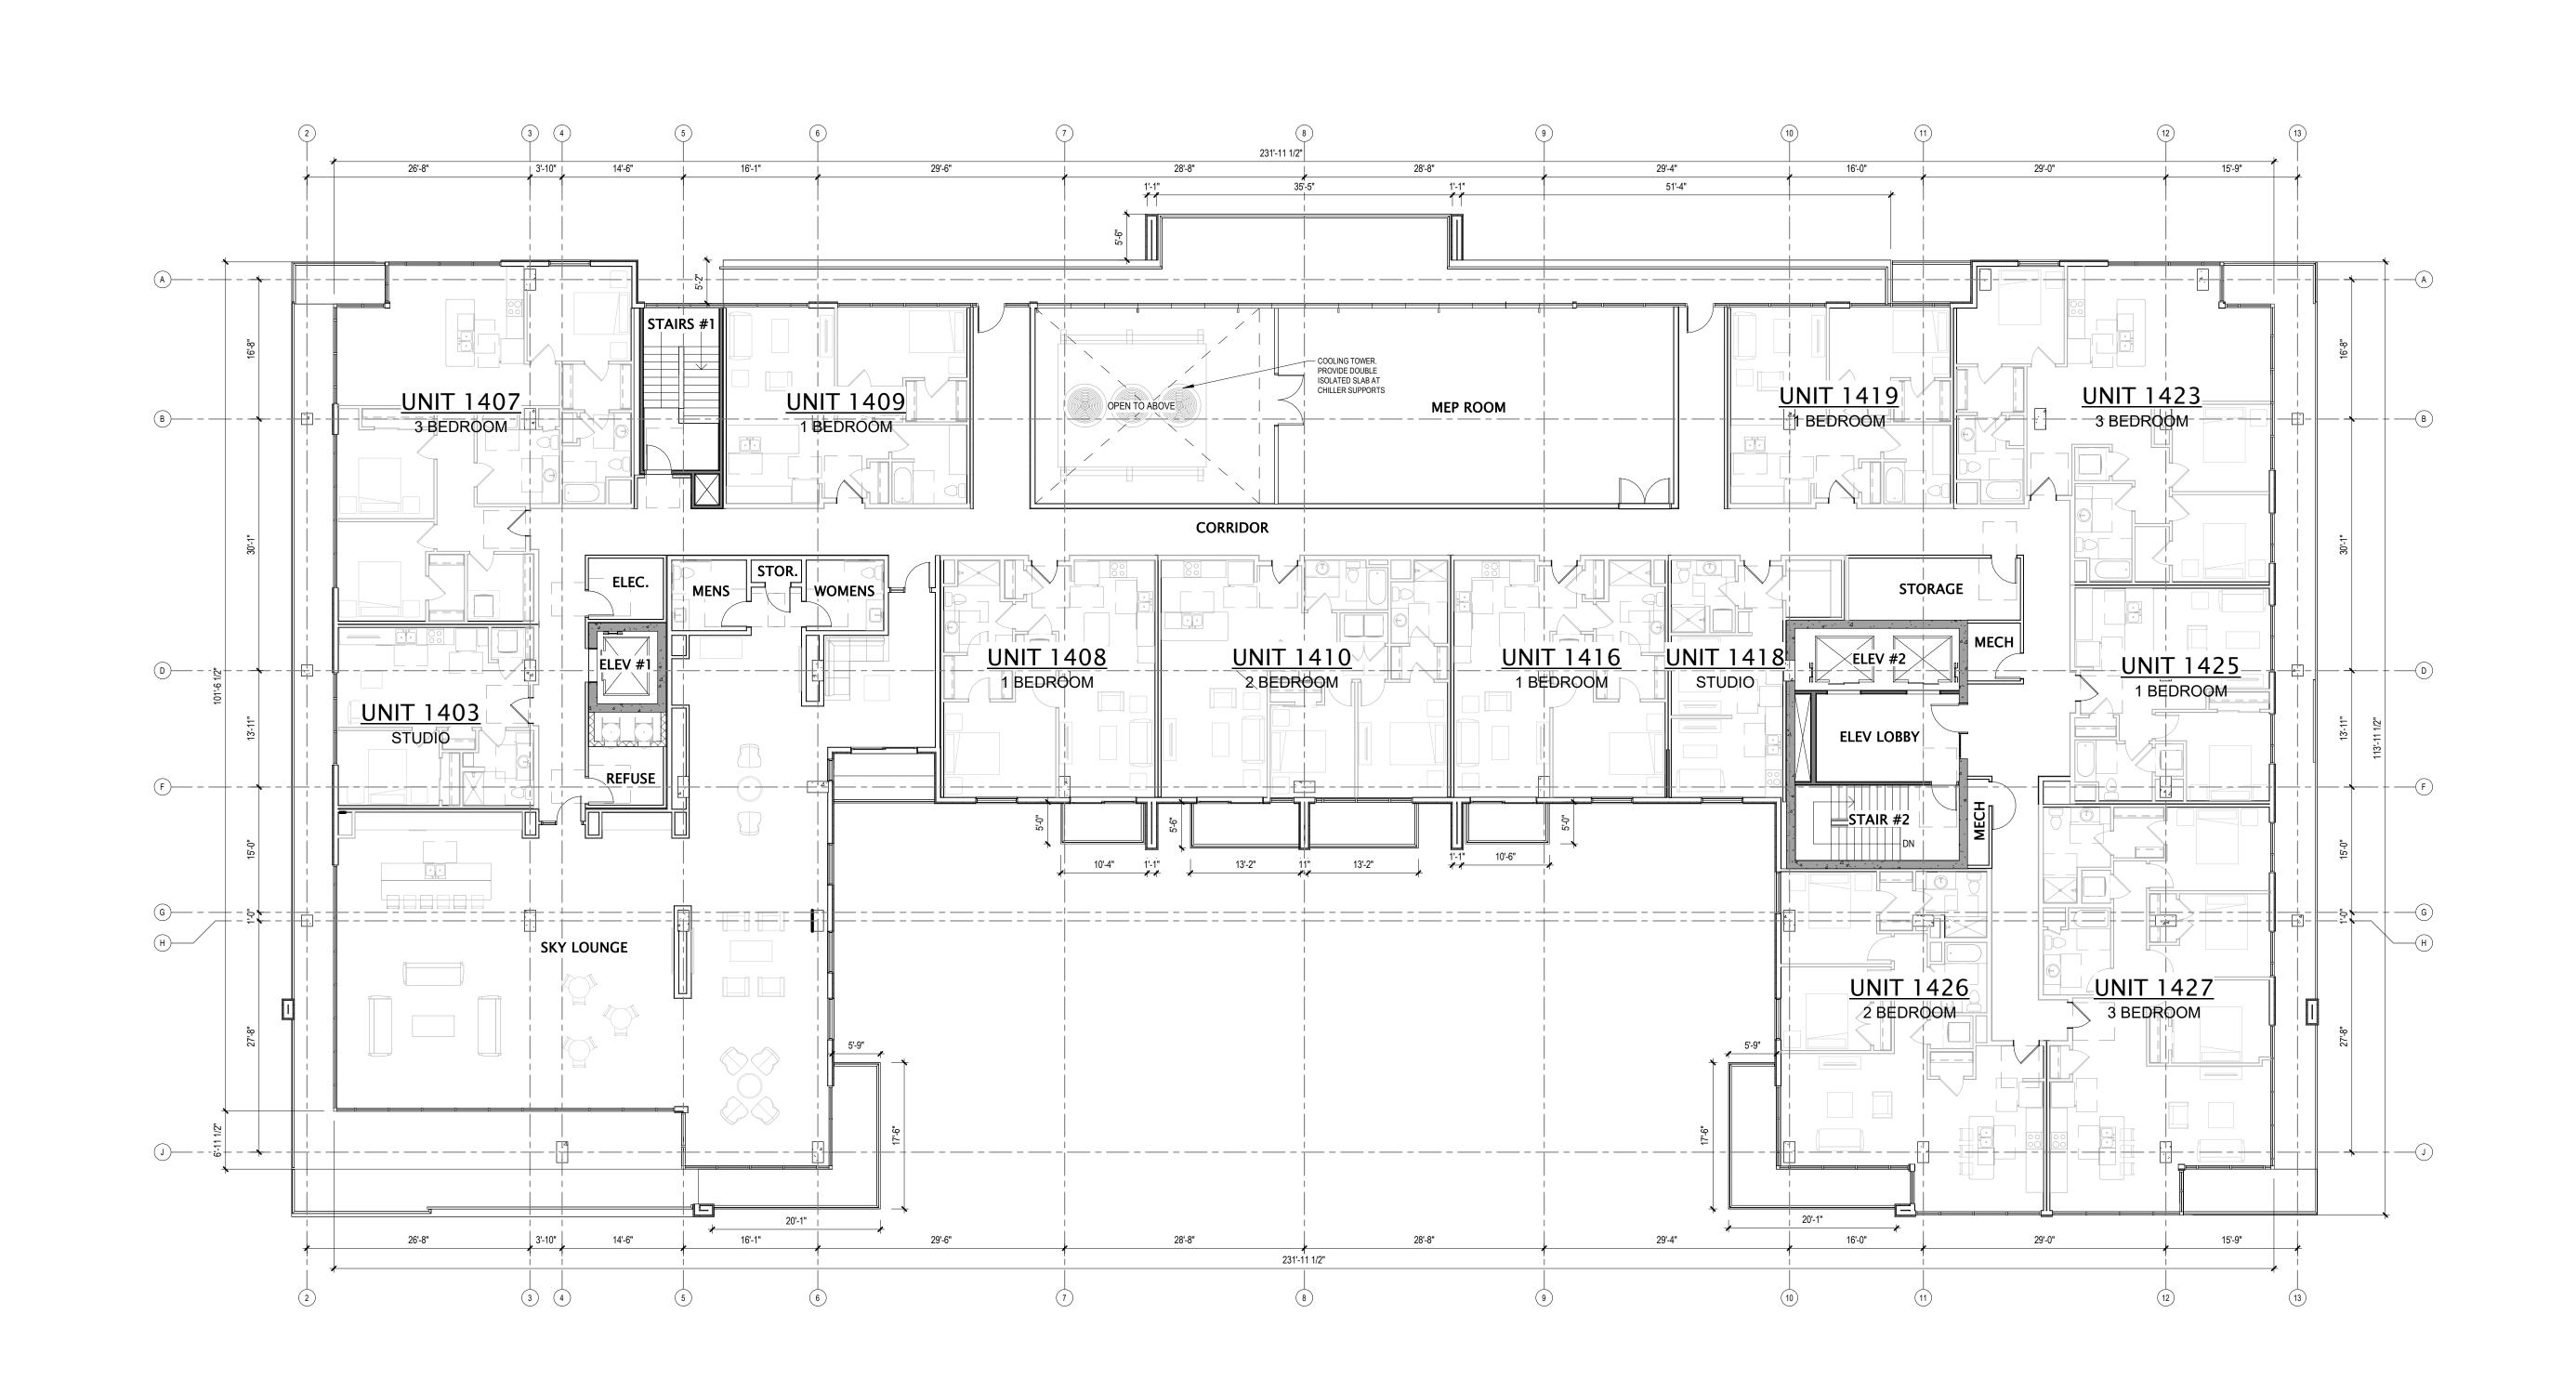
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CITY OF MADISON LAND-USE & URBAN DESIGN COMMISION SUBMITTAL

NOVEMBER 27, 2023 DATE OF ISSUANCE REVISION SCHEDULE

FOURTEENTH FLOOR PLAN

SHEET NUMBER



ROOF NOTES

- ROOF SHALL BE ROOF ASSEMBLY WR1-X, UNLESS NOTED OTHERWISE. TOP CHORDS OF TRUSSES SHALL BE PITCHED AT 1/4" PER FOOT (MINIMUM) TO PROVIDE ROOF DRAINAGE. SEE A501 FOR FOR ROOF ASSEMBLY DESCRIPTIONS.
- 2. PROVIDE TAPERED INSULATION BOARD WHERE NECESSARY OVER ROOF ASSEMBLY TO MAINTAIN A 1/4" PER FOOT MINIMUM PITCH TO ROOF DRAINS. PROVIDE A 3/16" PER FOOT MINIMUM PITCH FOR TAPERED INSULATION SADDLES AND/ OR CRICKETS WHERE NECESSARY.
- ROOF DRAINS ARE SHOWN FOR INTENT ONLY. DESIGN/BUILD PLUMBING CONTRACTOR SHALL PROVIDE NECESSARY CALCULATIONS TO DETERMINE FINAL QUANTITY, SIZE, AND LOCATION OF ROOF DRAINS AND OVERFLOW DRAINS. COORDINATE ALL ROOF DRAINS WITH ROOFING CONTRACTOR TO PROVIDE PROPER DRAINAGE.
- AT ALL FIRE WALLS, PROVIDE NON-COMBUSTIBLE ROOF SHEATHING EXTENDING TO A DISTANCE OF 48" (MINIMUM) FROM BOTH SIDES OF FIRE WALL.
- 5. PROVIDE WATERTIGHT INTEGRITY AT ALL PENETRATIONS AND EQUIPMENT PER ROOFING MANUFACTURER'S STANDARD DETAILS AND REQUIREMENTS FOR WARRANTY AND CURRENT NRCA STANDARDS.
- VERIFY ANY ROOFTOP EQUIPMENT AND PENETRATIONS WITH OWNER'S DESIGN / BUILD MECHANICAL, ELECTRICAL, AND PLUMBING PLANS.
- 7. DESIGN / BUILD CONTRACTORS PROVIDING ROOF PENETRATIONS MUST PROVIDE TEMPORARY WEATHERTIGHT COVERS FOR OPENING UNTIL PLACEMENT OF FINISHED WORK OR COVERING.
- 8. OVERHANGS (IF ANY) SHALL BE AS SHOWN ON ROOF PLAN.
- 9. PROVIDE CONTINUOUS ATTIC DRAFTSTOPPING AT LOCATIONS INDICATED ON ROOF PLAN. EXTEND DRAFTSTOPPING FULLY INTO SOFFITS AND PENETRATIONS. SEAL ALL JOINTS WITH CAULK AND/ OR TAPE AS NEEDED TO PROVIDE SMOKETIGHT SEAL.
- ALL JOINTS WITH CAULK AND/ OR TAPE AS NEEDED TO PROVIDE SMOKETIGHT SEAL.

 10. ALL DRYERS SHALL BE VENTED WITH U.L. CLASSIFIED DRYER BOX & VENT. PROVIDE POWER BOOSTER FAN/ VENT IF VENT RUN EXCEEDS 25'-0".
- 11. PLUMBING DESIGN-BUILD CONTRACTOR TO COORDINATE THE LOCATION OF ROOF FROST PROOF HOSE BIB WITH OWNER. COORDINATE LOCATION WITH TRUSS LAYOUT AND UNIT LAYOUT BELOW.
- 12. PROVIDE PREFINISHED SHEET METAL COPINGS AND/ OR GRAVEL STOPS PER PLANS. REFER TO EXTERIOR ELEVATIONS MATERIAL SCHEDULE FOR SPECIFIED METAL COLORS.
- 13. PROVIDE PREFINISHED SHEET METAL DOWNSPOUTS WHERE INDICATED. REFER TO EXTERIOR ELEVATIONS MATERIAL SCHEDULE FOR SPECIFIED METAL COLORS. DESIGN/BUILD PLUMBING CONTRACTOR SHALL PROVIDE NECESSARY CALCULATIONS AND DETERMINE FINAL QUANTITY, SIZE, AND LOCATION OF DOWNSPOUTS AND SHALL COORDINATE WITH ROOFING CONTRACTOR TO PROVIDE PROPER DRAINAGE.
- 14. *ROOF DRAINS AND/ OR DOWNSPOUTS SHOWN FOR INTENT ONLY. ROOFING AND PLUMBING CONTRACTORS SHALL DETERMINE AND COORDINATE FINAL ROOF DRAIN/ DOWNSPOUT SIZES AND LOCATIONS BASED ON DRAINAGE CALCULATIONS PROVIDED BY PLUMBING SUB-CONTRACTOR.

VEGETATIVE ROOF LEGEND

REQUIREMENT: 50% OF TOTAL ROOF AREA TO BE A VEGETATIVE

3RD LEVEL ROOF/TERRACE AREA = 11,632 SF 14TH LEVEL ROOF/TERRACE AREA = 2,008 SF 15TH LEVEL ROOF/TERRACE AREA = 22,366 SF TOTAL COMBINED ROOF AREA = 36,006 SF

3RD LEVELVEGETATIVE ROOF/TERRACE = 3,364 15TH LEVEL VEGETATIVE ROOF = 14,776 SF

PERCENTAGE OF TOTAL VEGETATIVE ROOF = 50.38% TOTAL

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JLA PROJECT NUMBER:

702 EAST

WASHINGTON AVENUE

MIXED-USE

DEVELOPMENT

CITY OF MADISON LAND-USE & URBAN DESIGN COMMISION SUBMITTAL


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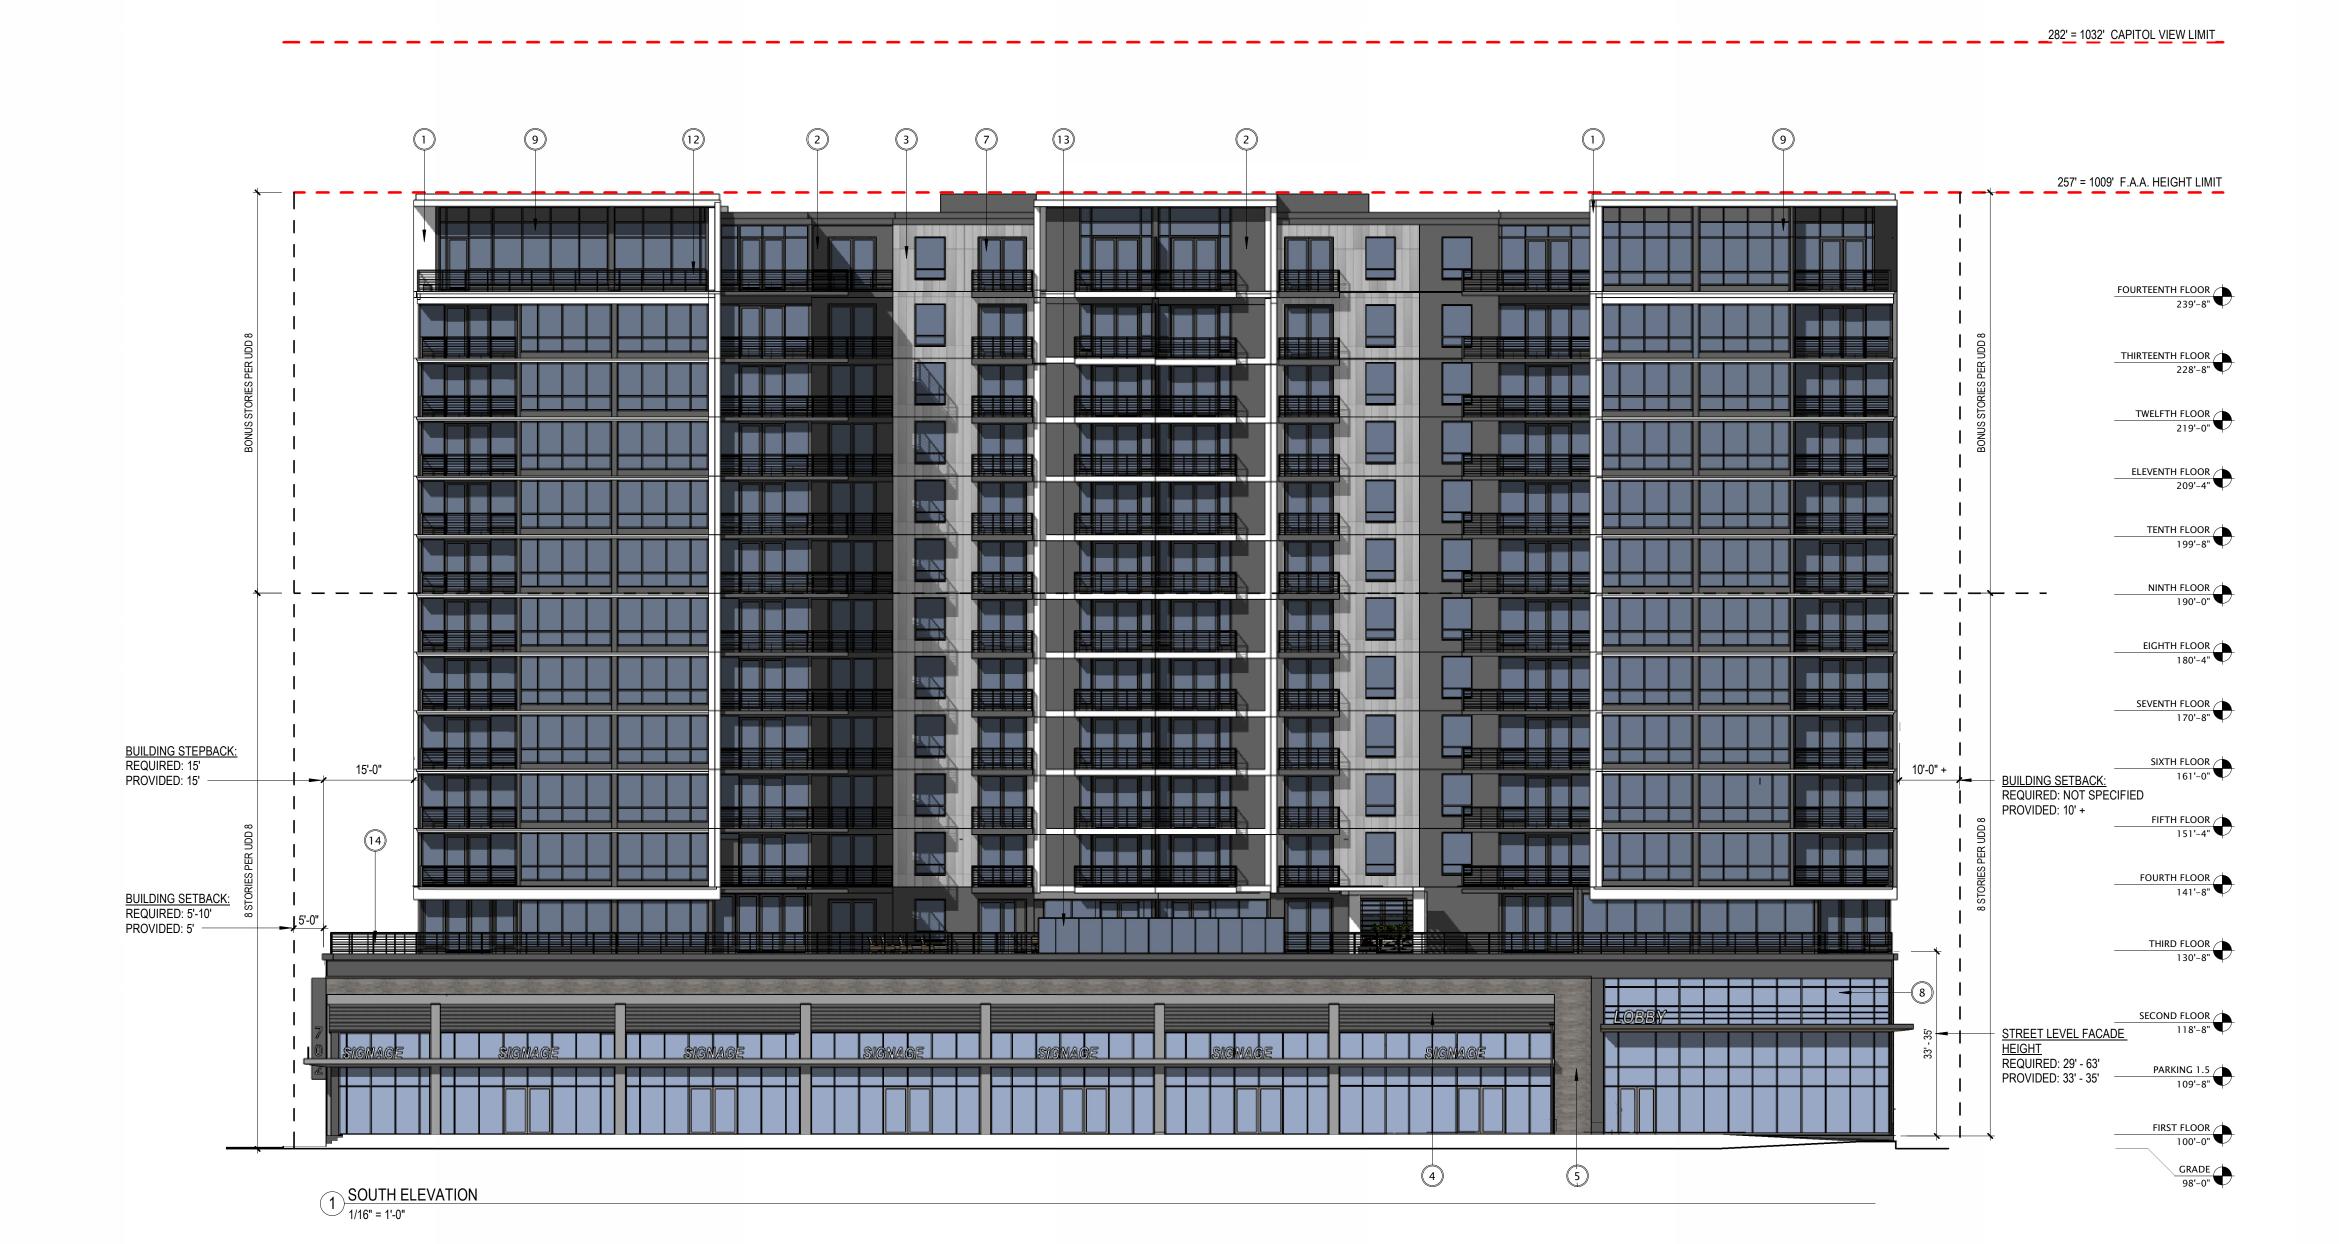
Mark Description Date

ROOF PLAN

eet number





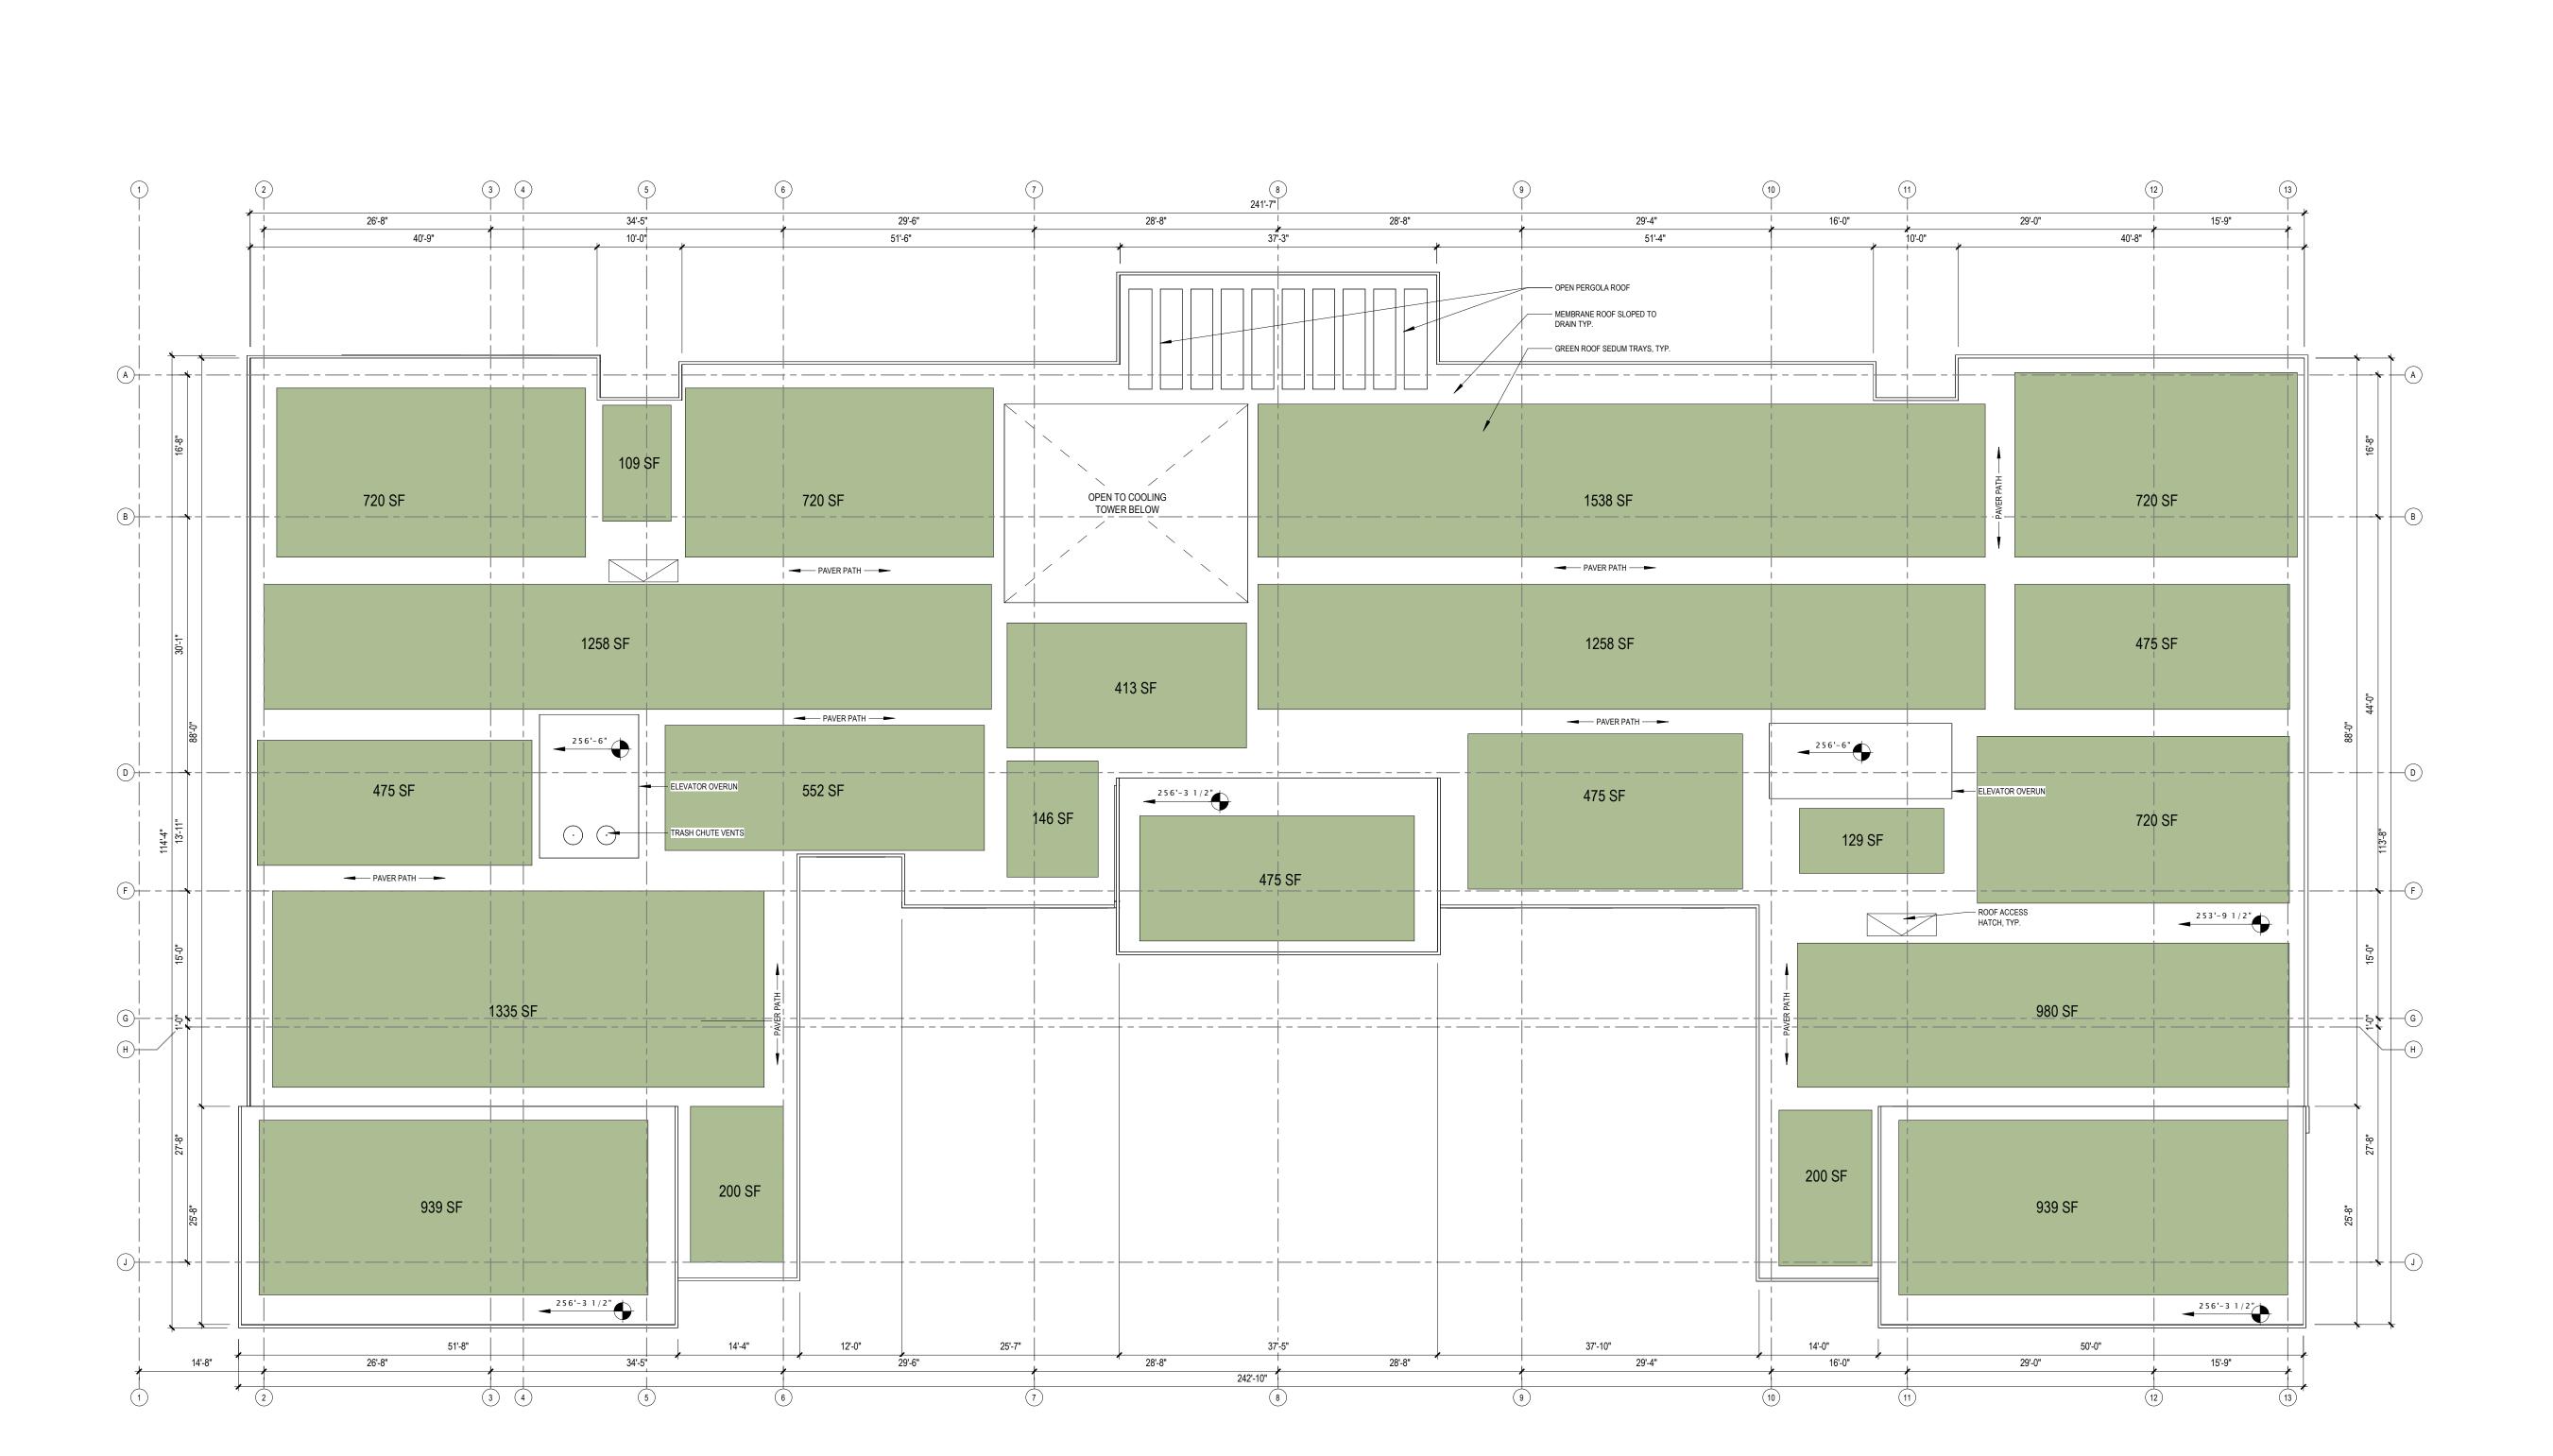

EXTERIOR MATERIALS SCHEDULE

MARK DESCRIPTION

1 METAL PANEL 1
2 METAL PANEL 2
3 METAL PANEL 3
4 METAL PANEL 4
5 BRICK 1
6 STONE 1
7 ALUMINUM PATIO DOOR
8 ALUMINUM WINDOW FRAMING SYSTEM
9 ALUMINUM WINDOW WALL
11 GREEN SPACE WALL SYSTEM
12 GUARD RAIL ASSEMBLY
13 GLASS RAIL ASSEMBLY
14 PERGOLA



JLA PROJECT NUMBER:

W22-0106

702 EAST
WASHINGTON AVENUE
MIXED-USE
DEVELOPMENT

CITY OF MADISON LAND-USE & URBAN DESIGN COMMISION SUBMITTAL

DATE OF ISSUANCE NOVEMBER 27, 2023


REVISION SCHEDULE


Mark Description Date

SHEET TITLE

EXTERIOR ELEVATIONS

SHEET NUMBER

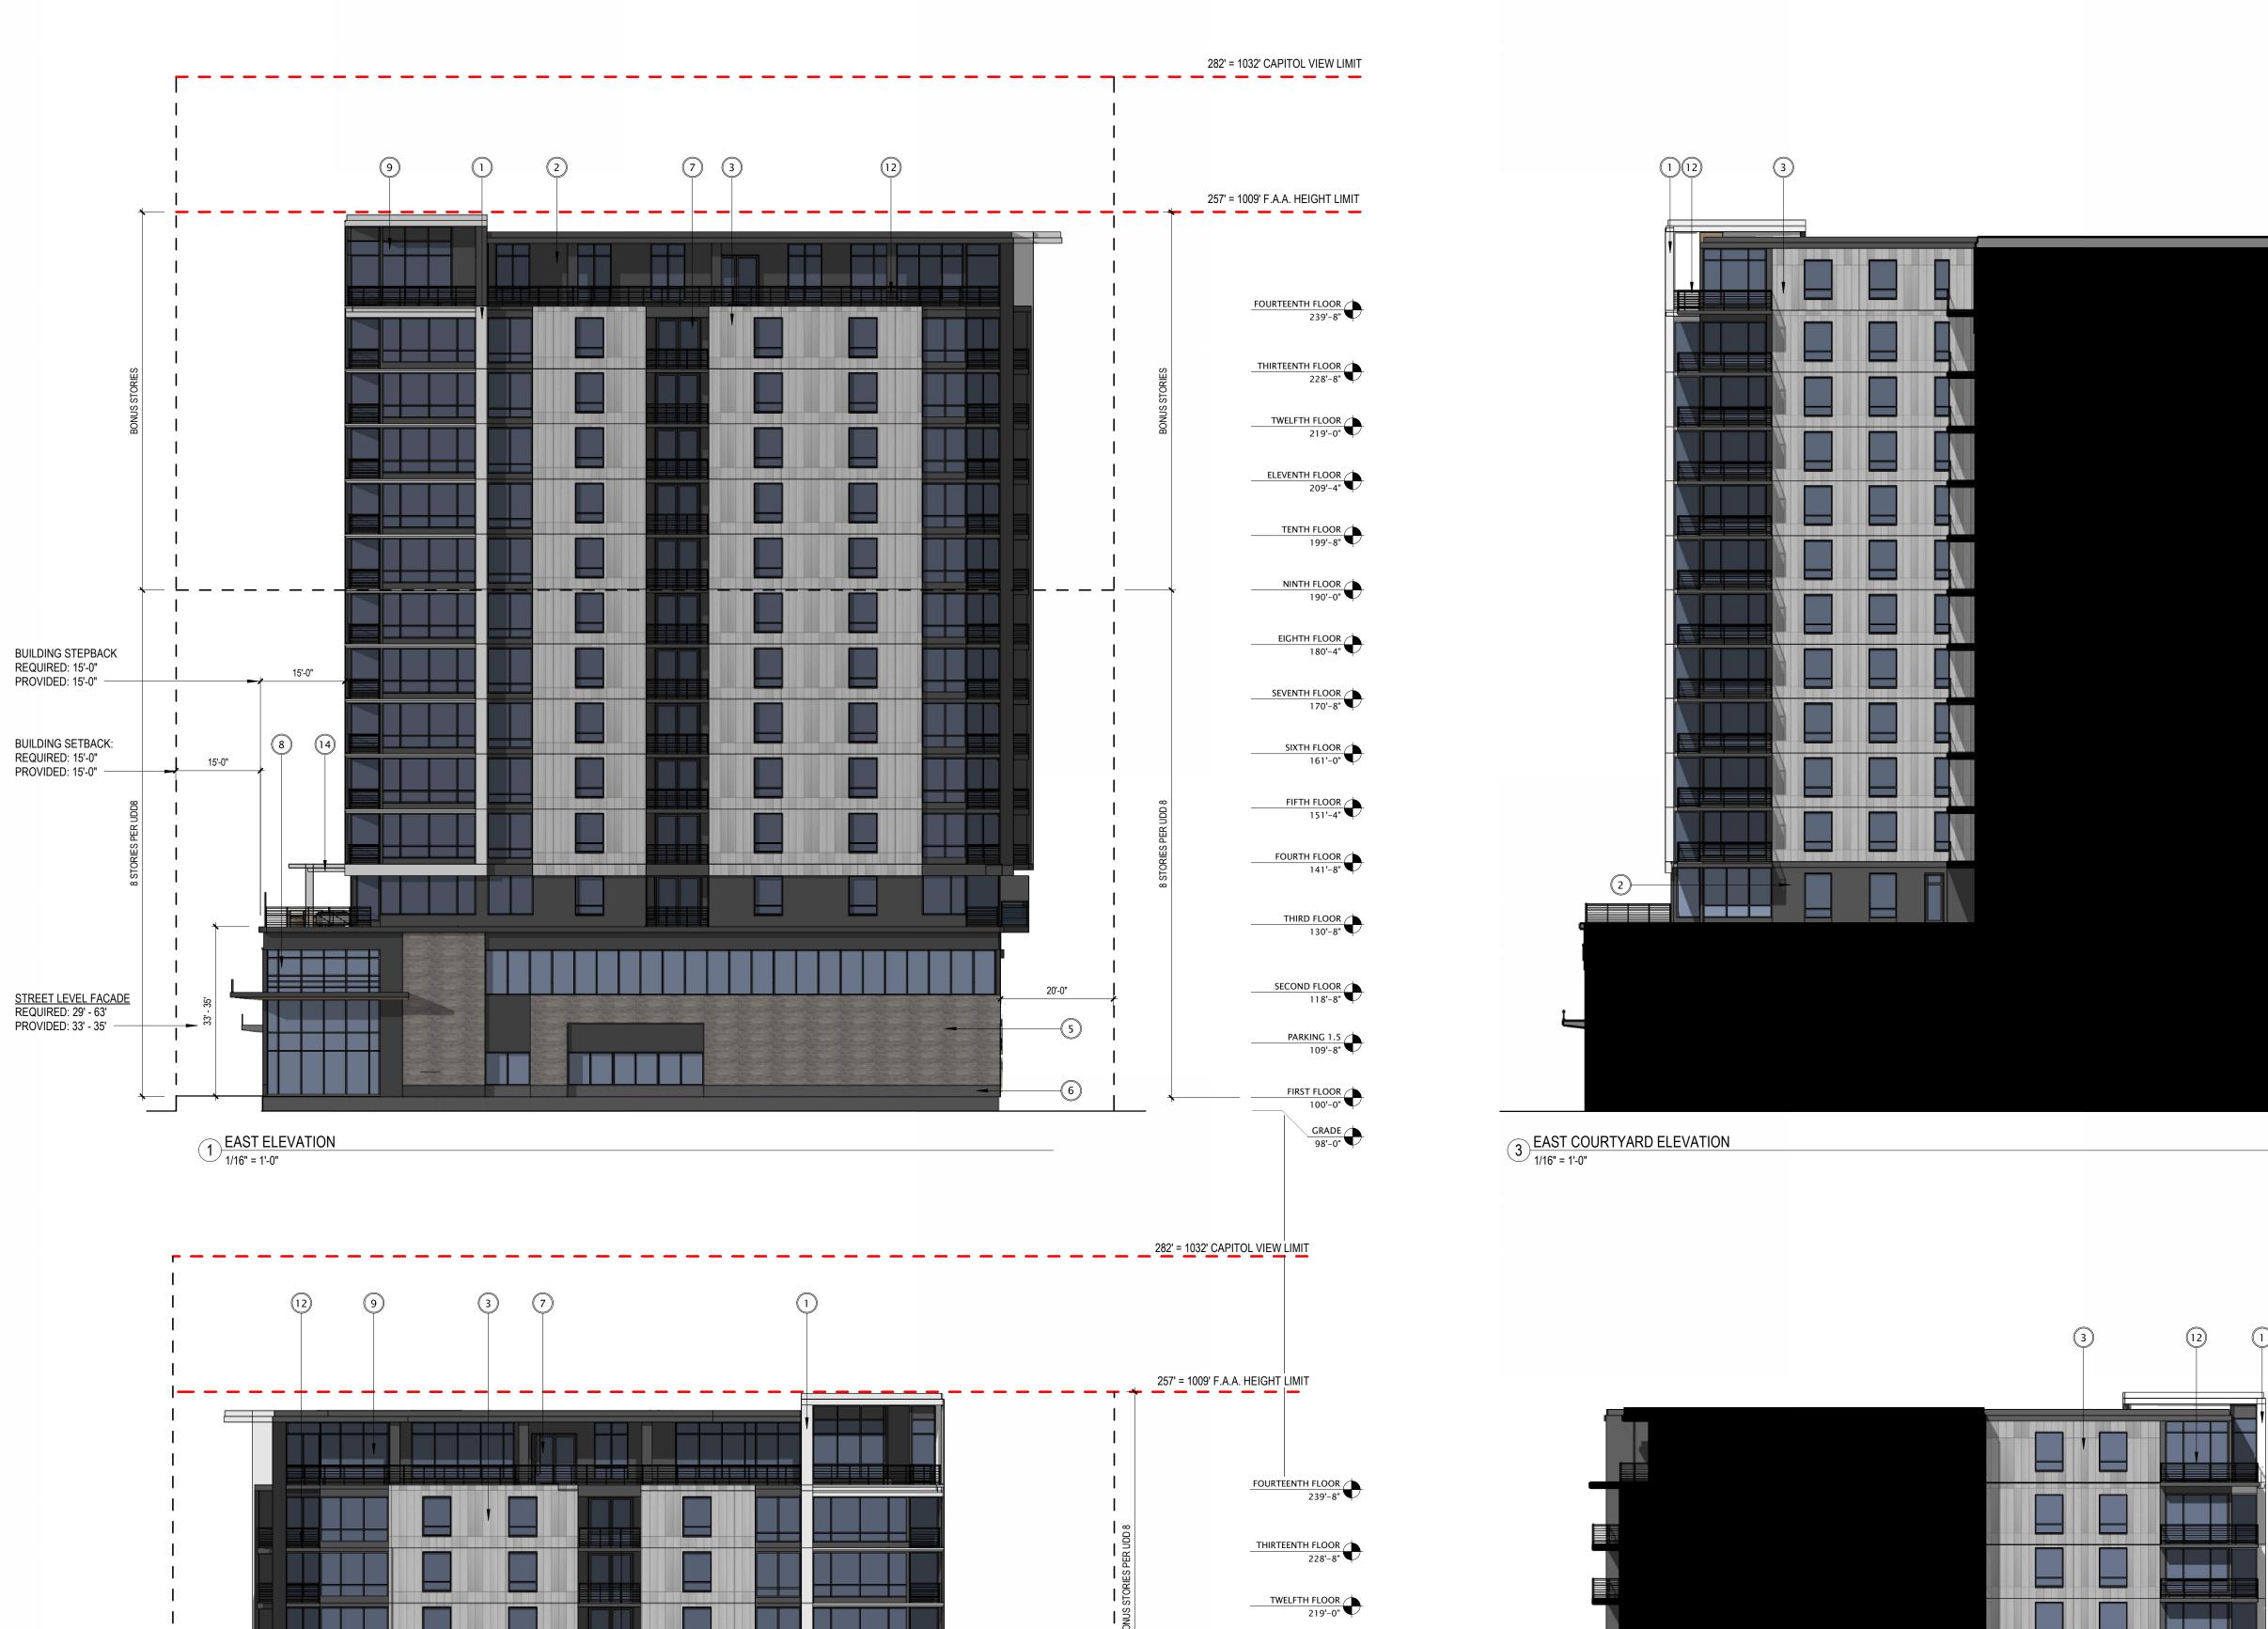

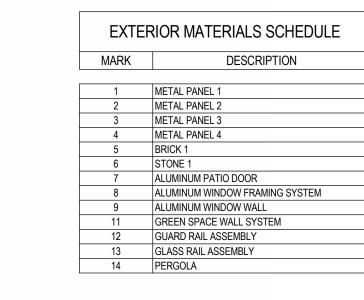

FOURTEENTH FLOOR 239'-8"

THIRTEENTH FLOOR 228'-8"

TWELFTH FLOOR 219'-0"

ELEVENTH FLOOR 209'-4"

TENTH FLOOR

NINTH FLOOR

EIGHTH FLOOR 180'-4"

SEVENTH FLOOR

SIXTH FLOOR

FIFTH FLOOR

FOURTH FLOOR

THIRD FLOOR

SECOND FLOOR

FIRST FLOOR

GRADE 98'-0"



JLA PROJECT NUMBER: W22-0106

702 EAST WASHINGTON AVENUE MIXED-USE DEVELOPMENT

CITY OF MADISON LAND-USE & URBAN DESIGN COMMISION SUBMITTAL

DATE OF ISSUANCE NOVEMBER 27, 2023

REVISION SCHEDULE

Mark Description Date

EXTERIOR


SHEET NUMBER

A201


ELEVATIONS





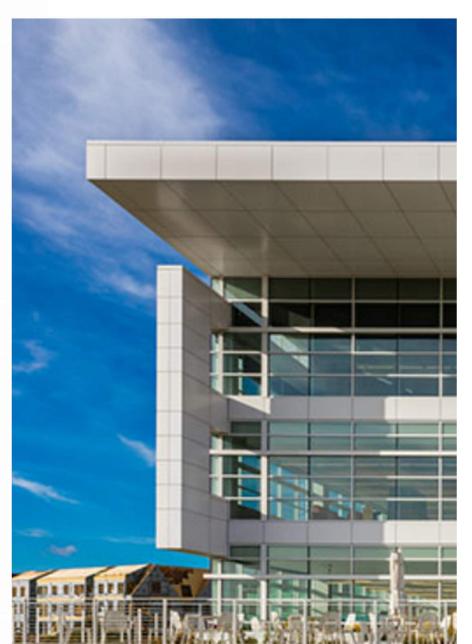



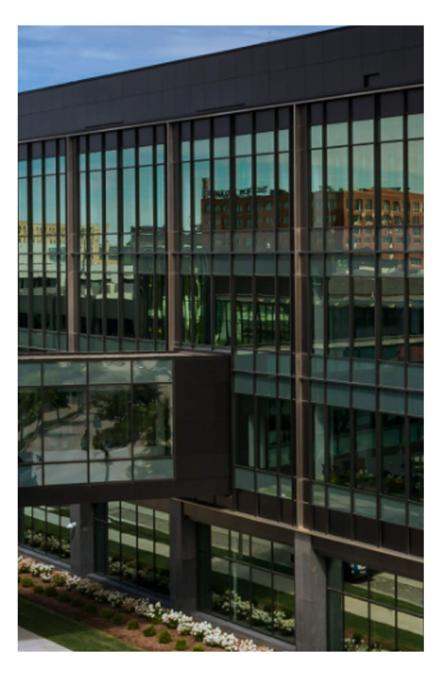

METAL PANEL 2



METAL PANEL 3



METAL PANEL 4



ALUM FRAMING SYSTEM




ALUM WINDOW WALL




ALUM PATIO DOOR



ARCHITECTURAL LOUVER

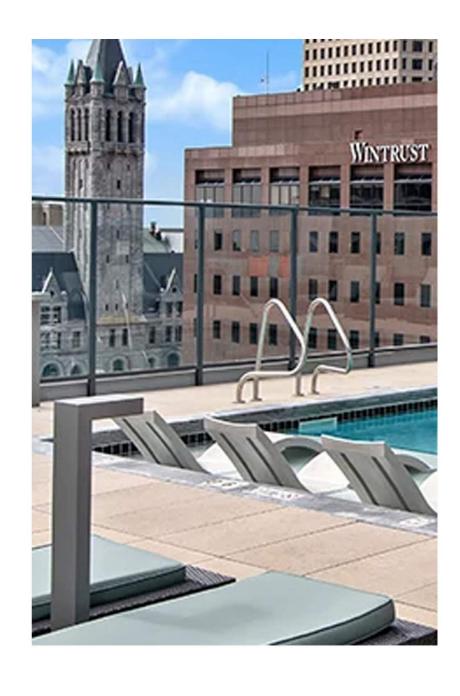


GLASS GUARDRAIL ASSEMBLY

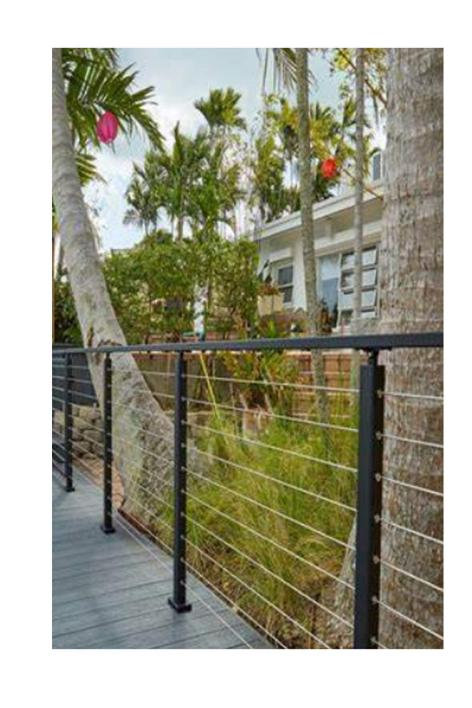


GUARDRAIL ASSEMBLY




GREEN SCREEN

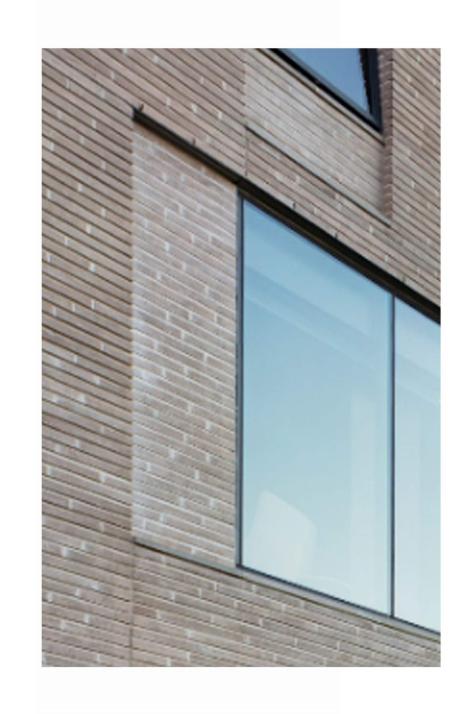


BRICK 1

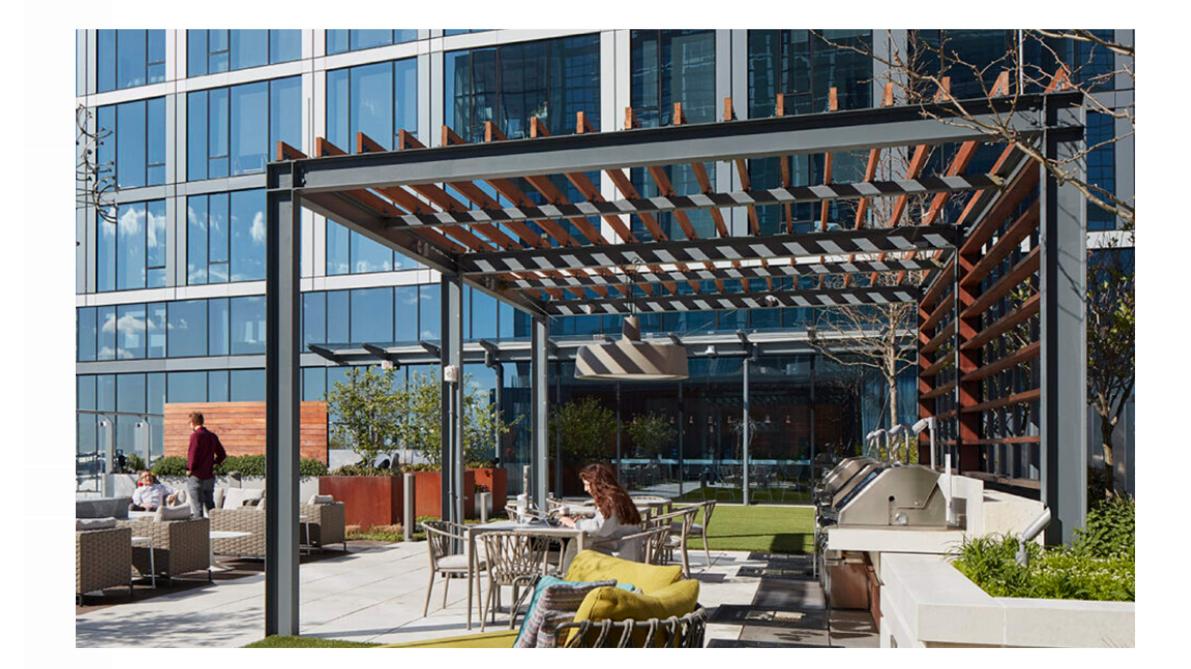

PERGOLA

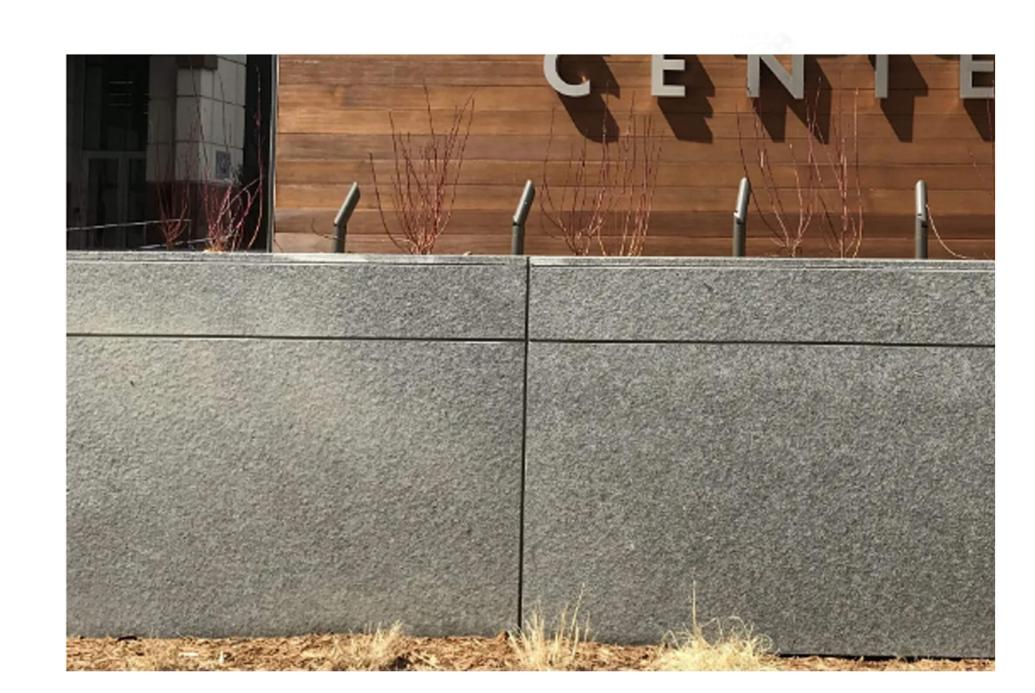

STONE 1

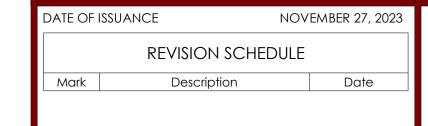

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702 EAST

WASHINGTON AVENUE

MIXED-USE


DEVELOPMENT


CITY OF MADISON LAND-USE & URBAN DESIGN COMMISION SUBMITTAL

JLA PROJECT NUMBER:

DIGITAL MATERIAL BOARD

Sheet Number

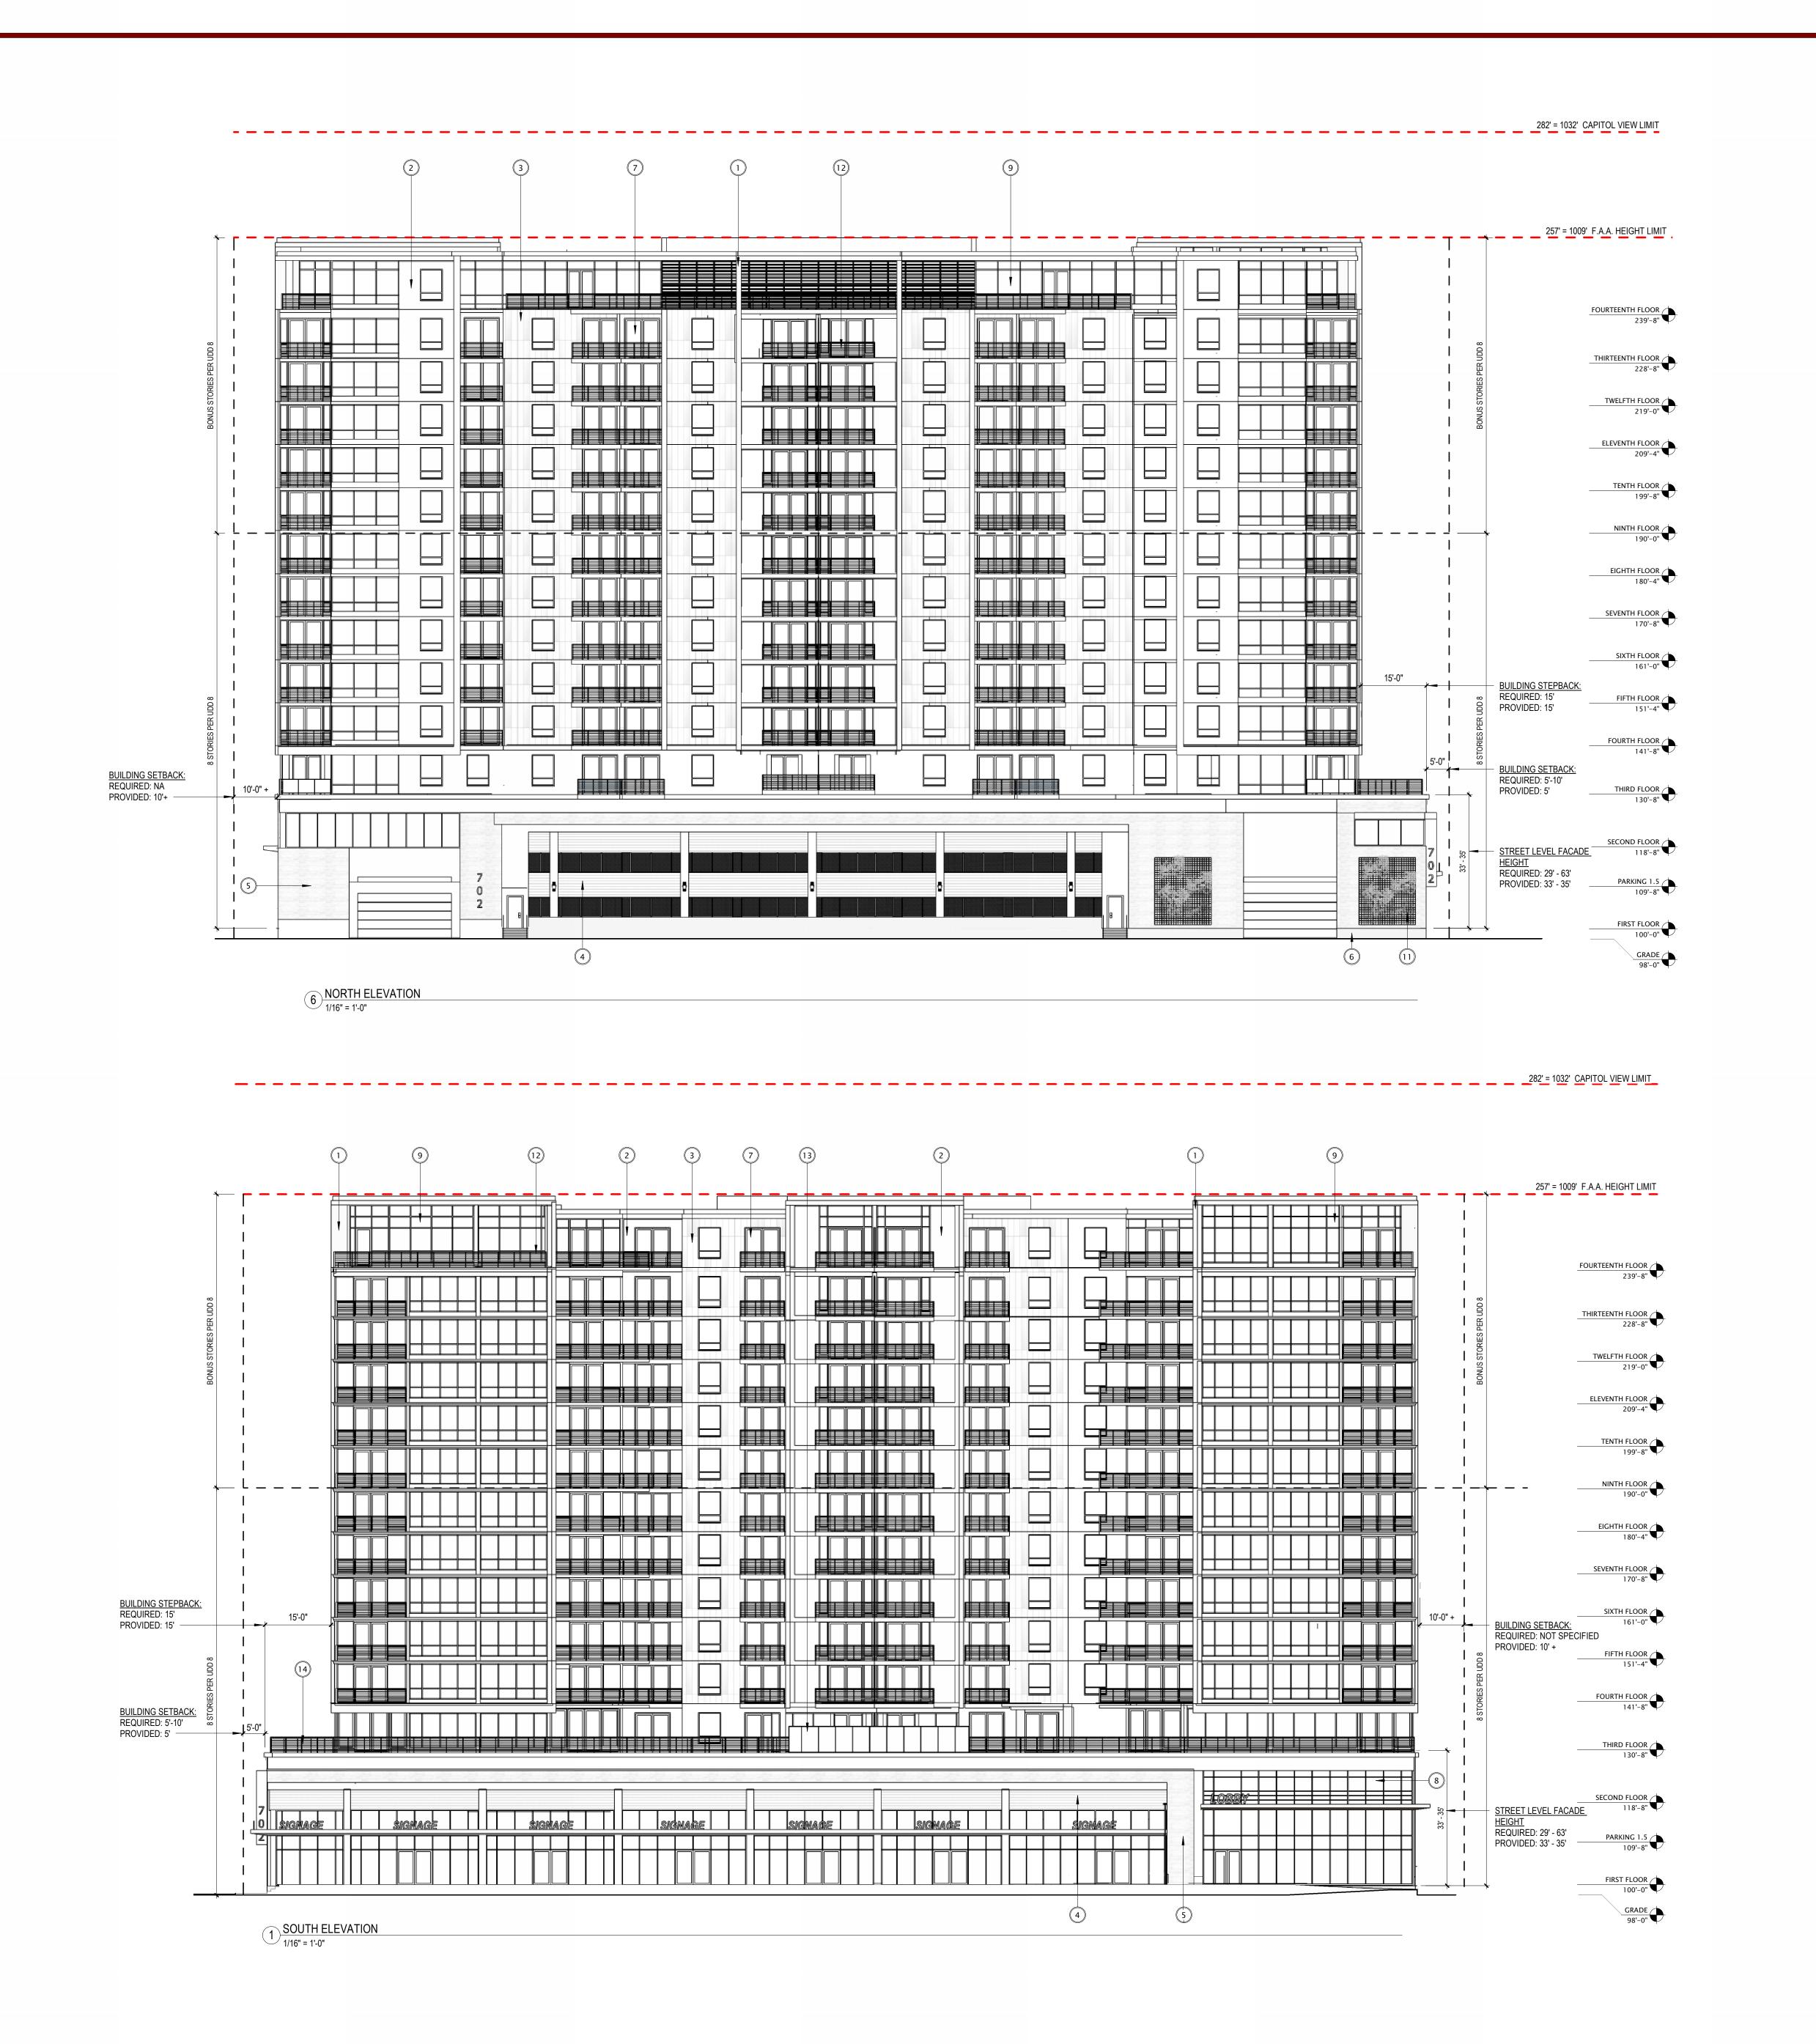

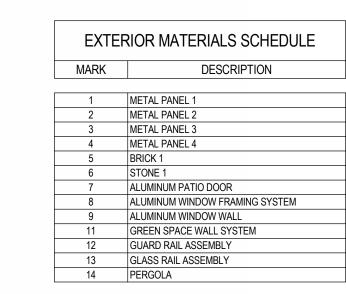



JLA PROJECT NUMBER: W22

702 EAST WASHINGTON AVENUE MIXED-USE DEVELOPMENT

CITY OF MADISON LAND-USE & URBAN DESIGN COMMISION SUBMITTAL

DATE OF ISSUANCE NOVEMBER 27, 2023


REVISION SCHEDULE


Mark Description Date

SHEET TITLE

EXTERIOR ELEVATIONS

SHEET NUMBER

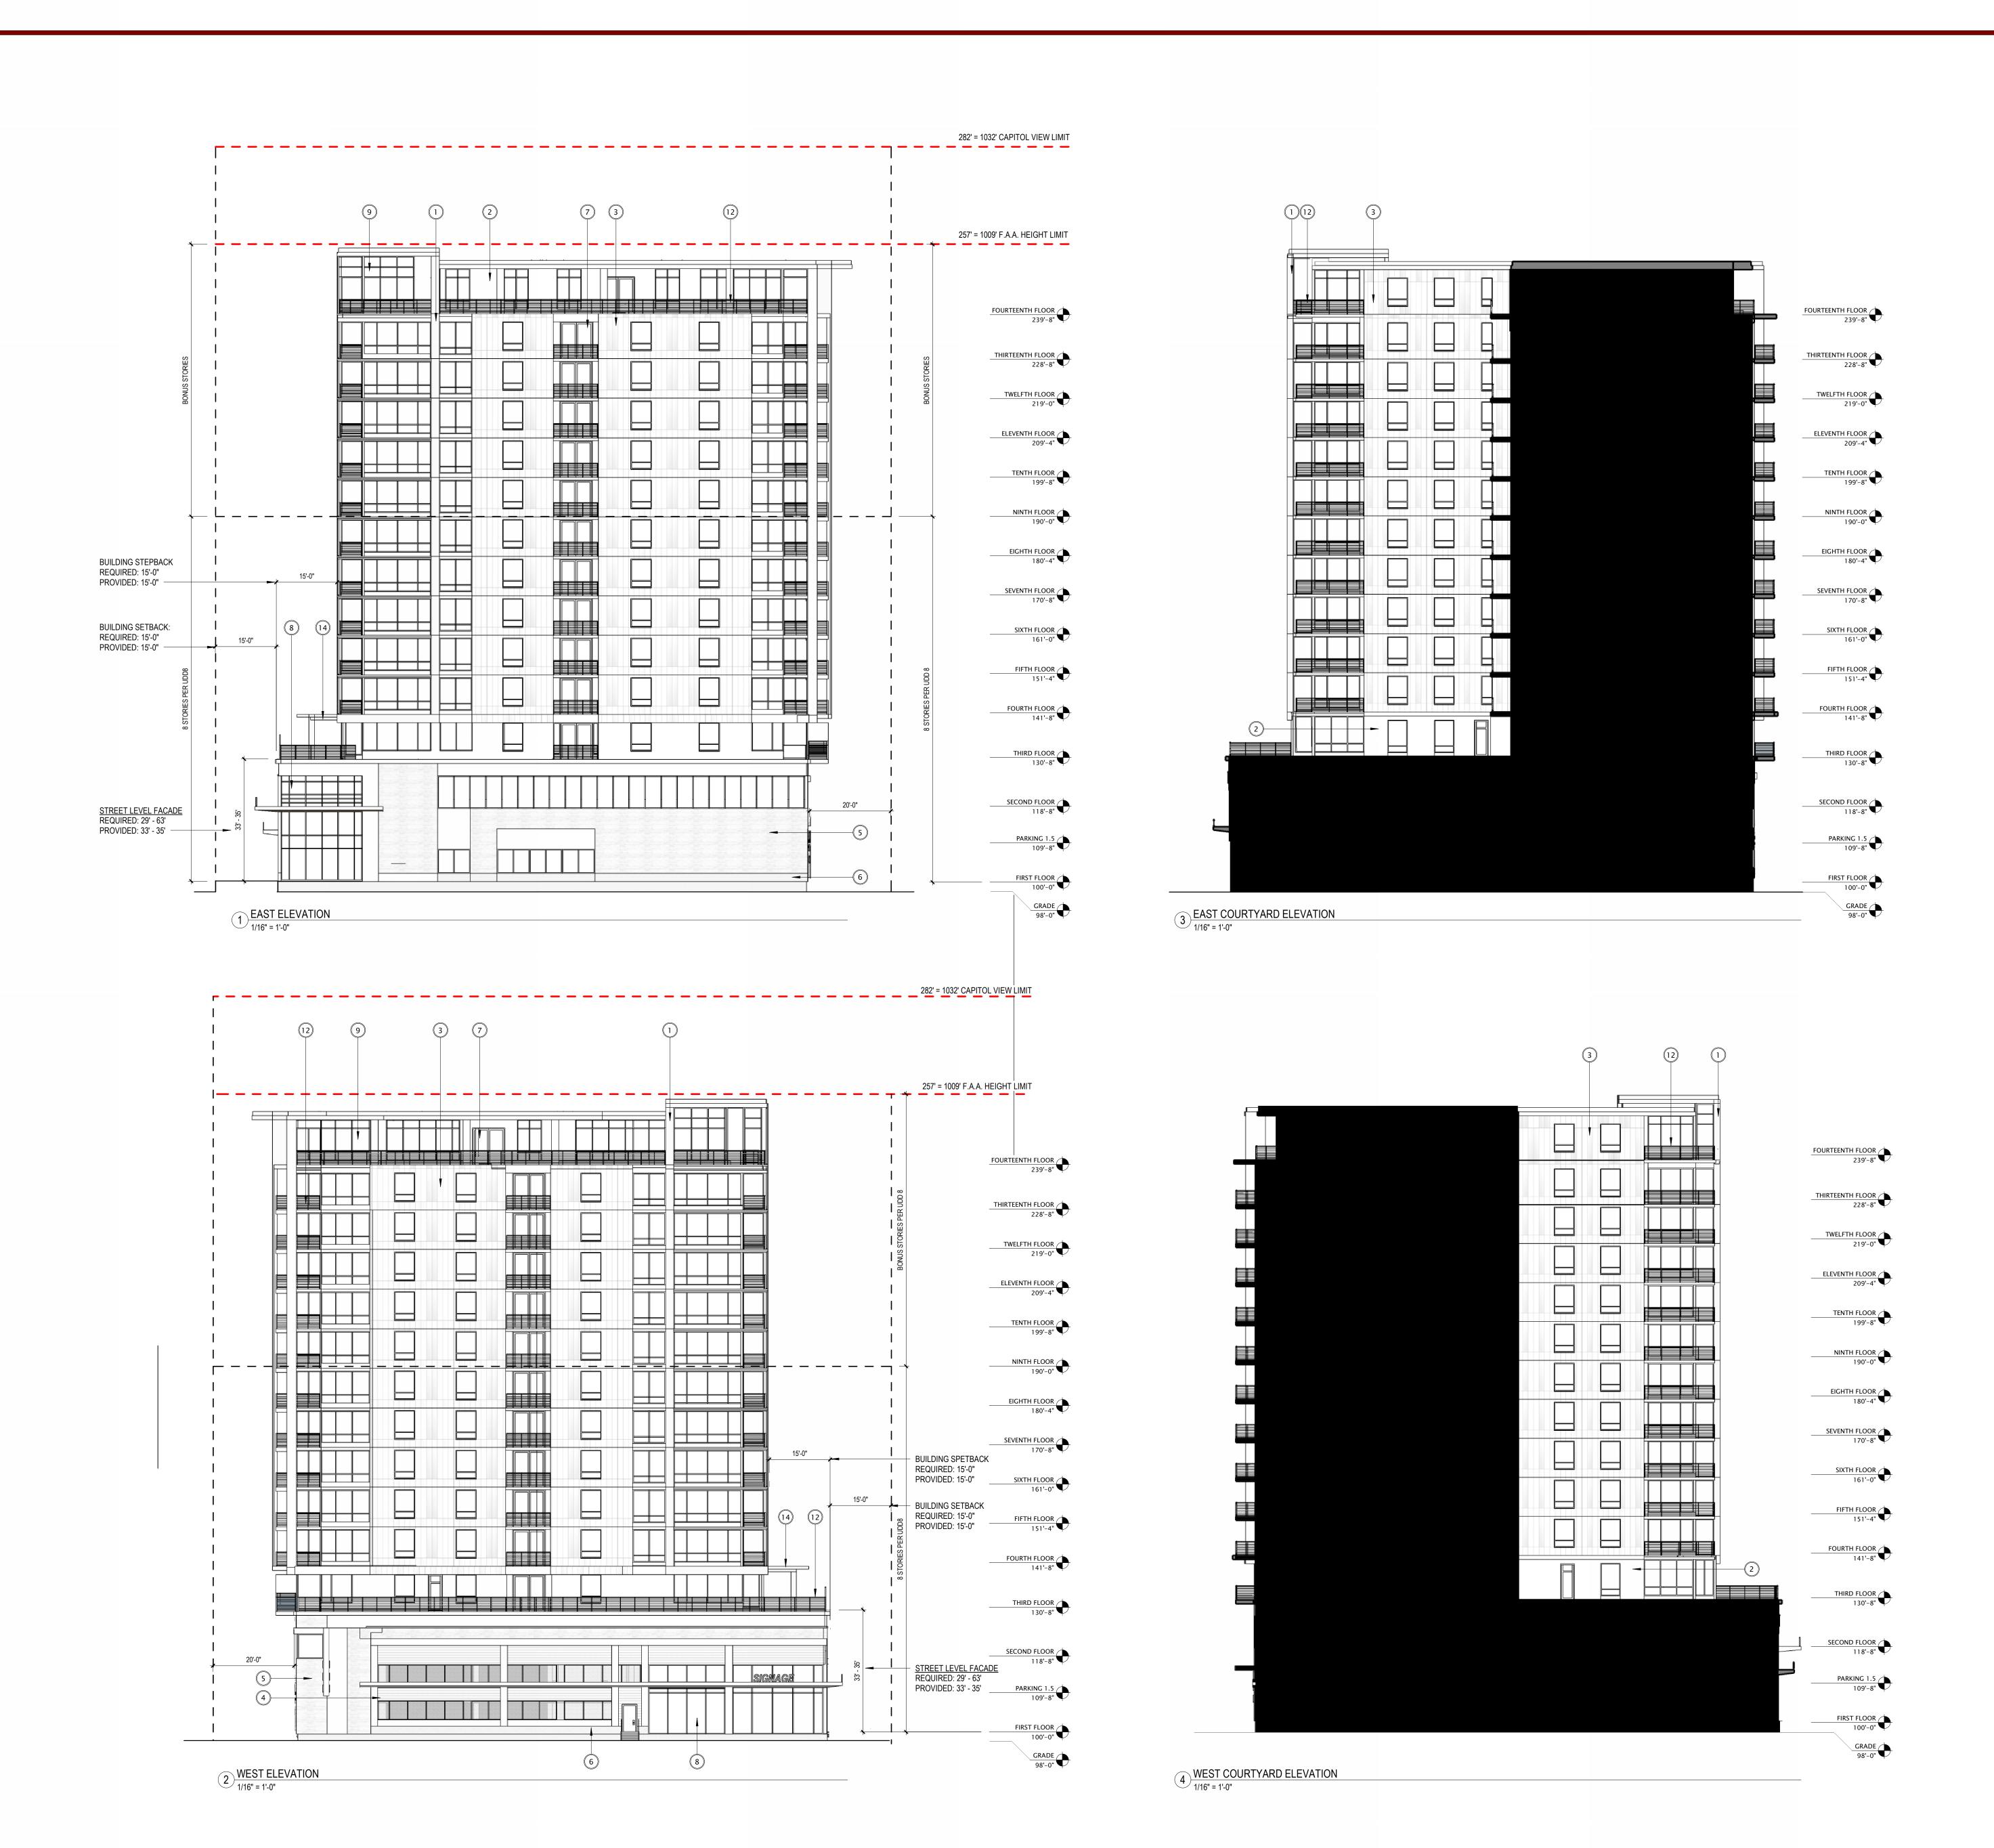

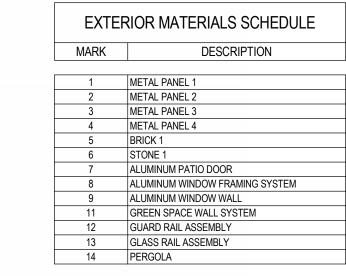



JLA PROJECT NUMBER: W22-0106

702 EAST
WASHINGTON AVENUE
MIXED-USE
DEVELOPMENT

CITY OF MADISON LAND-USE & URBAN DESIGN COMMISION SUBMITTAL

DATE OF ISSUANCE NOVEMBER 27, 2023

REVISION SCHEDULE

Mark Description Date

EXTERIOR ELEVATIONS

SHEET NUMBER

BIRD GLASS CALCULATIONS 702 E. WASHINGTON 50+ SQ FT AND REQUIRE A BIRD GLAZING SAFETY SYSTEM ON A MIN. OF 85% OF THE GLAZING 11/21/2023

								WALL DESIGNATION										
				SOUTH E	SOUTH ELEVATION SOUTH ELEVATION RECESS				EAST ELEVATION EAST ELEVATION RECESS			NORTH E	LEVATION	WEST EL	EVATION	WEST ELEVA	TION RECESS	
WINDOW DESIGNATION	WIDTH	HEIGHT	AREA	# WINDOW	GLZ AREA	# WINDOW	GLZ AREA	# WINDOW	GLZ AREA	# WINDOW	GLZ AREA	# WINDOW	# GLZ AREA	# WINDOW	GLZ AREA	# WINDOW	GLZ AREA	
WINDOW A 4/8 X 6/9	4.7	6.8	32.0			7.0	223.7	9.0		287.6 6.0	191.8	22.0	703.1	. 9.0	287.6	4.0	127.8	
				TOTAL GLZ	0.0	TOTAL GLZ	223.7	TOTAL GLZ		287.6 TOTAL GLZ	191.8	TOTAL GLZ	703.1	TOTAL GLZ	287.6	TOTAL GLZ	127.8	
				WALL AREA	7715	WALL AREA	7274	WALL AREA		7,470.0 WALL AREA	1,512.0	WALL AREA	14,987.0	WALL AREA	15,060.0	WALL AREA	1,459.0	
				0.00%	% GLAZING	3.08%	% GLAZING	3.85%	% GLAZING	12.68%	% GLAZING	4.69%	% GLAZING	1.91%	% GLAZING	8.76%	% GLAZING	

								WALL DESIGNATION												
				SOUTH EL	EVATION	SOUTH ELEV	ATION RECESS	EAS	Γ ELEVATION	EAST ELEVA	TION RECESS	NORTH E	LEVATION	WEST EI	LEVATION	WEST ELEVA	TION RECESS			
PATIO DESIGNATION	WIDTH	HEIGHT	AREA	# PATIO	GLZ AREA	# PATIO	GLZ AREA	# PATIO	GLZ AREA	# PATIO	GLZ AREA	# PATIO	GLZ AREA	# PATIO	GLZ AREA	# PATIO	GLZ AREA			
PATIO P 8/0 X 9/0	8.0	9.0	72.0			20.0	1440.0	3.0	216	.0		20.0	1440.0	3.0	216.0					
				TOTAL GLZ	0.0	TOTAL GLZ	1440.0	TOTAL GLZ	216	.0 TOTAL GLZ	0.0	TOTAL GLZ	1440.0	TOTAL GLZ	216.0	TOTAL GLZ	0.0			
				WALL AREA	7715.0	WALL AREA	7274.0	WALL AREA	7470	.0 WALL AREA	1512.0	WALL AREA	14987.0	WALL AREA	15060.0	WALL AREA	1459.0			
				0.00%	% GLAZING	19.80%	% GLAZING	2.89%	% GLAZING	0.00%	% GLAZING	9.61%	% GLAZING	1.43%	% GLAZING	0.00%	% GLAZING			

							WALL DESI	GNATION						
		SOUTH E	ELEVATION SOUTH ELE	EVATION RECES	S EA	ST ELEVATION	EAST EL	EVATION RECES	S NORTH E	LEVATION	WEST EL	EVATION WI	EST ELEVAT	TION RECESS
SF DESIGNATION	WIDTH HEIGHT	AREA # SF	GLZ AREA # SF	GLZ AREA	# SF	GLZ AREA	# SF	GLZ AREA	# SF	GLZ AREA # 5	SF	GLZ AREA # S	F C	GLZ AREA
STOREFRONT 1 14/9 X 11/0	14.8 11.0	162.8 1.0	162.8											
STOREFRONT 2 28/6 X 11/0	28.5 11.0	313.5 2.0												
STOREFRONT 3 27/6 X 11/0	27.5 11.0	302.5 1.0												
STOREFRONT 4 26/8 X 11/0	26.7 11.0	293.7 2.0												
STOREFRONT 5 35/2 X 11/0	35.2 11.0	387.2 1.0												
STOREFRONT 6 46/10 X 16/8	46.9 16.7	783.2 1.0												
STOREFRONT 7 14/9 X 4/3	14.8 4.3													
STOREFRONT 8 28/6 X 4/3	28.5 4.3	122.6 1.0												
STOREFRONT 10 26 /8 X 4 /3	27.5 4.3	118.3 1.0												
STOREFRONT 10 26/8 X 4/3	26.7 4.3 35.2 4.3	114.8 1.0 151.4 1.0												
STOREFRONT 11 35/2 X 4/3 STOREFRONT 12 46/10 X 7/6	35.2 4.3 46.9 7.5													
STOREFRONT 13 14/8 X 7/7	14.7 7.6		10.	0 1117.	2									
STOREFRONT 14 7/7 X 8/6	7.6 8.5	64.6	3.											
STOREFRONT 15 3/10 X 8/6	3.9 8.5	33.2	1.											
STOREFRONT 16 18/0 X 8/7	18.0 8.6		1.											
STOREFRONT 17 18/8 X 8/7	18.7 8.6		1.											
STOREFRONT 18 10/8 X 8/7	10.7 8.6		1.											
STOREFRONT 19 19/11 X 16/8	20.0 16.7	334.0	1	52.	1.	0 334	.0							
STOREFRONT 20 7/7 X 5/7	7.6 5.6				1.									
STOREFRONT 21 23/7 X 5/7	23.6 5.6				1.									
STOREFRONT 22 19/11 X 7/6	20.0 7.5				1.									
STOREFRONT 23 89/4 X 7/7	89.4 7.6				1.									
STOREFRONT 24 4/9 X 8/10	4.8 8.9				6.									
STOREFRONT 25 16/5 X 7/7	16.5 7.6				3.				+					
STOREFRONT 26 7/8 X 6/8	7.6 6.7	50.9			3.									
STOREFRONT 27 7/4 X 7/7	7.4 7.6				3.									
STOREFRONT 28 3/9 X 8/7	3.8 8.6							1.0 32.	7					
STOREFRONT 29 11/11 X 8/7	12.0 8.6							1.0 103.						
STOREFRONT 30 4/6 X 7/8	4.5 7.7	34.7						2.0 69.						
STOREFRONT 31 3/0 X 8/6	3.0 8.5	25.5						1.0 25.						
STOREFRONT 32 21/0 X 4/2	21.0 4.2	88.2							1.0	88.2				
STOREFRONT 33 22/8 X 4/2	22.7 4.2								4.0	381.4				
STOREFRONT 34 16/9 X 4/2	16.8 4.2	70.6							2.0					
STOREFRONT 35 15/11 X 4/2	16.0 4.2								2.0					
STOREFRONT 36 20/0 X 4/2	20.0 4.2	84.0							2.0					
STOREFRONT 37 38/11 X 7/7	39.0 7.6								1.0					
STOREFRONT 38 15/4 X 5/8	15.4 5.7								1.0					
STOREFRONT 39 11/1 X 8/10	11.1 8.9								6.0	592.7				
STOREFRONT 40 14/10 X 8/9	14.9 8.8	131.1							2.0					
STOREFRONT 41 14/10 X 7/7	14.9 7.6								4.0					
STOREFRONT 42 20/9 X 4/5	20.8 4.5										1.0	93.6		
STOREFRONT 43 20/7 X 4/5	20.6 4.5										1.0	92.7		
STOREFRONT 44 18/5 X 4/5	18.5 4.5	83.3									1.0	83.3		
STOREFRONT 45 18/4 X 10/11	18.4 11.0	202.4									1.0	202.4		
STOREFRONT 46 21/9 X 10/11	21.8 11.0										1.0			
STOREFRONT 47 20/9 X 4/2	20.8 4.2	87.4									1.0	87.4		
STOREFRONT 48 20/7 X 4/2	20.6 4.2	86.5									1.0	86.5		
STOREFRONT 49 18/5 X 4/2	18.5 4.2	77.7									1.0	77.7		
STOREFRONT 50 18/4 X 4/2	18.4 4.2	77.3									1.0	77.3		
STOREFRONT 51 21/9 X 4/2	21.8 4.2										1.0	91.6		
STOREFRONT 52 5/10 X 5/8	5.9 5.7	33.6									1.0	33.6		
STOREFRONT 53 5/5 X 9/0	5.5 9.0	49.5									5.0	247.5		
STOREFRONT 54 7/4 X 6/8	7.4 6.7	49.6									1.0	49.6		
STOREFRONT 55 3/0 X 8/8	3.0 8.7	26.1									1.0	26.1	1.0	26.:
STOREFRONT 56 16/5 X 6/8	16.5 6.7	110.6									1.0	110.6		
STOREFRONT 57 3/9 X 7/9	3.8 7.8										1.0			
STOREFRONT 58 11/7 X 7/10	11.6 7.9										2.0	183.3		
STOREFRONT 59 7/7 X 7/8	7.6 7.7										2.0			
STOREFRONT 60 16/2 X 7/7	16.2 7.6										2.0	246.2		
STOREFRONT 61 11/11 X 8/7	12.0 8.6												1.0	103.
STOREFRONT 62 4/3 X 8/7	4.3 8.6												3.0	110.
STOREFRONT 63 10/11 X 7/7	11.0 7.6	83.6											2.0	0.0
		TOTAL GLZ	3772.5 TOTAL GLZ	1597.	0 TOTAL GLZ	2292.	.2 TOTAL G	LZ 230.	7 TOTAL GLZ	2437.2 TC	OTAL GLZ	2058.7 TO	TAL GLZ	240.
		WALL AREA	7715.0 WALL AREA	7274.	0 WALL AREA	7470.	.0 WALL AF	REA 1512.	0 WALL AREA	14987.0 W	ALL AREA	15060.0 WA	ALL AREA	1459.
		48.90%	% GLAZING 21.95	% % GLAZING	30.689	% GLAZING	15.	26% % GLAZING	16.26%	% GLAZING	13.67%	% GLAZING	16.47% 9	% GLAZING

	TOTALS														
SOUTH E	LEVATION	SOUTH ELEV	ATION RECESS	EAS ⁻	T ELEVATION		EAST ELEVA	TION RECESS	NORTH EI	EVATION	WEST EL	EVATION	WEST ELEVA	TION RECESS	
TOTAL GLZ	3,772.5	TOTAL GLZ	3,260.7	TOTAL GLZ	-	2,795.8	TOTAL GLZ	422.4	TOTAL GLZ	4,580.3	TOTAL GLZ	2,562.3	TOTAL GLZ	368.1	
WALL AREA	7,715.0	WALL AREA	7,274.0	WALL AREA	-	7,470.0	WALL AREA	1,512.0	WALL AREA	14,987.0	WALL AREA	15,060.0	WALL AREA	1,459.0	
48.90%	% GLAZING	44.83%	% GLAZING	37.43%	% GLAZING		27.94%	% GLAZING	30.56%	% GLAZING	17.01%	% GLAZING	25.23%	% GLAZING	

CITY OF MADISON ORDINANCE - 28.129

28.129 BIRD-SAFE GLASS REQUIREMENTS:

(1) Statement of Purpose: The Bird-Safe Glass Requirements in this section are intended to reduce the heightened risk for bird collisions with glass on specified building designs and configurations. (2) Applicability: Subsection (4) applies to all exterior construction and development activity, including the expansion of existing buildings and structures, as specified therein.

(3) Measuring Glass Area: Under this Ordinance, glass area shalle be measured as one (1) continuous panel of glass or other transparent material, or a set of two (2) or more such panels divided by mullions of six (6) inches in width or narrower. Panels surrounded on all sides by solid walls or mullions wider than six (6) inches shall be considered individual windows. Spandrel or opaque

reflectivity of 14% or less shall not be included in the calculation of glass area. See Revised Figure 1. (4) Bird-Safe Glass Treatment Requirements: Glass areas on the following buildings or structures shall be treated to reduce the risk of bird collision by incorporating a pattern of visual markers that are either; a) dots or other isolated shapes that are 1/4" in diameter or larger and spaced at not more than a two-inch (2") by two-inch (2") pattern; or b) lines that are 1/8" in width or greater and

spaced no more than 2" apart; low reflective opaque materials; building-integrated structures like non-glass double-skin facades, metal screens, fixed solar shading, exterior insect screens, and other features that cover the glass surface; or other similar mitigation treatments approved by the Zoning Administrator. (a) Buildings or structures over 10,000 square feet: For any building or structure over 10,000 square feet in size (floor area of above-grade stories), bird-safe glass treatment is required as follows:

1. For building facades where the first sixty (60) feet (See REVISED Figure 2) from grade are comprised of greater than or equal to fifty percent (50%) glass: a. At least eighty-five percent (85%) of the glass must be treated; andb. All glass within fifteen (15) feet of a building corner must be treated when see through or fly through conditions exist. See Figure 3.

For building facades where the first sixty (60) feet from grade are comprised of less than fifty percent (50%) glass;
 a. At least eighty-five percent (85%) of the glass on glass areas fifty (50) square feet or over must be treated; and

b. Of all glass areas over fifty (50) square feet, any glass within fifteen (15) feet of a building corner must be treated.


3. All glass railings must be treated.

4. All glass on enclosed building connections shall be treated up to sixty (60) feet above grade.


(b) Sky-bridges: For buildings and structures of any size, all glass on above-ground bridges must be treated.


(c) At grade glass: For buildings and structures of any size, all at grade glass features such as sound walls or glass screens must be treated. (5) This Ordinance shall become effective October 1, 2020.

SPANDRELL (OPAQUE) GLASS MUST HAVE A REFLECTIVITY OF 14% OR ✓ LESS IN ORDER TO NOT BE COUNTED IN GLASS AREA CALCULATIONS

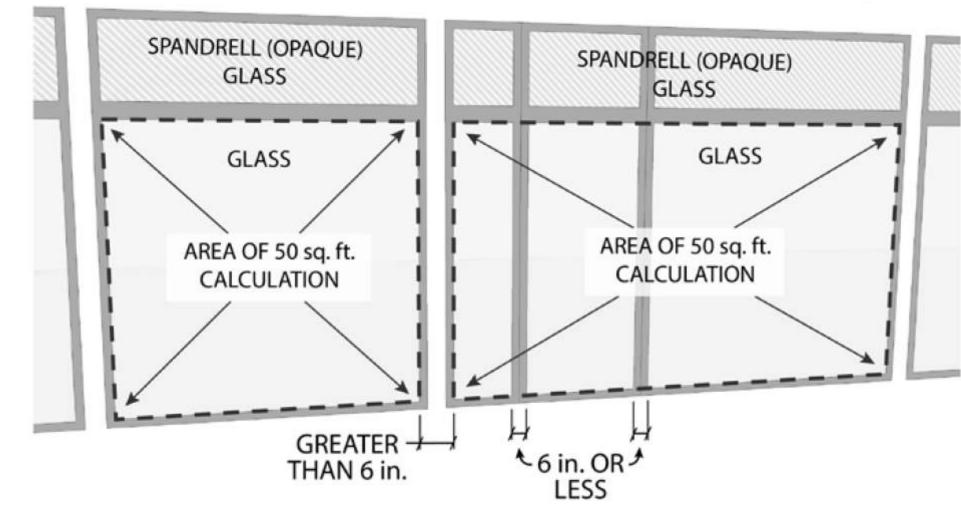

1) FIGURE 1 - WINDOW MULLION GRAPHIC 12" = 1'-0"

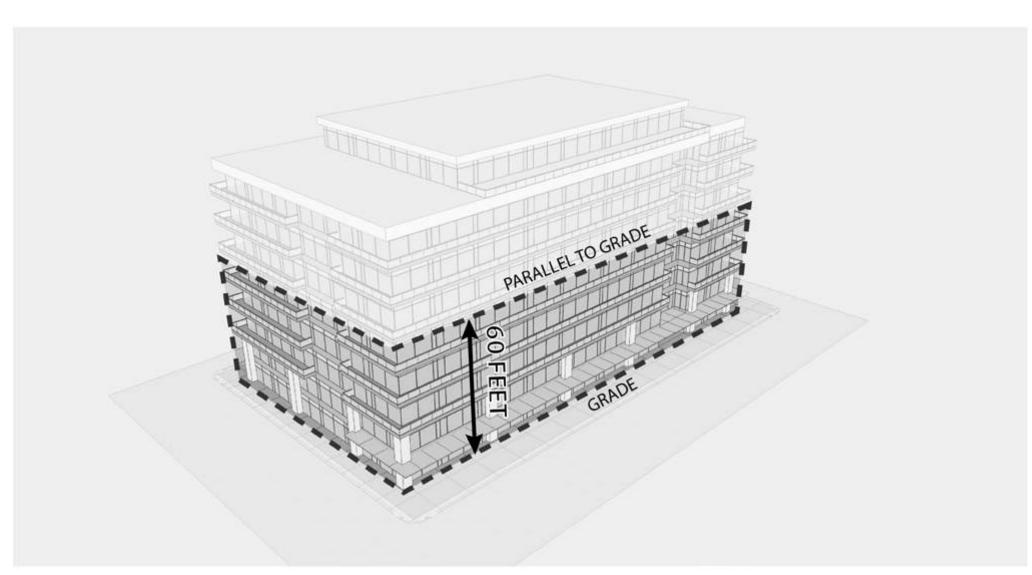

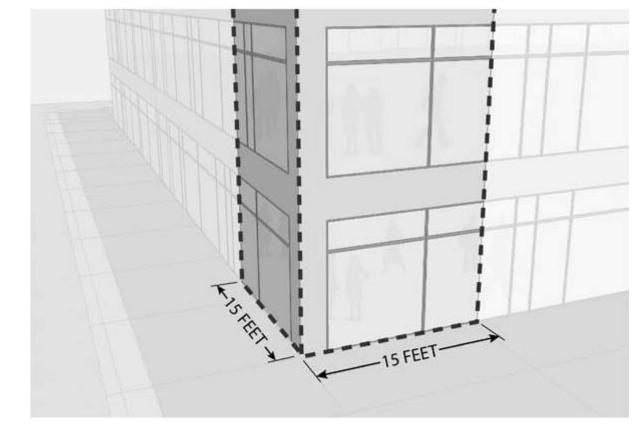

3 FIGURE 3 - GLASS CORNER GRAPHIC 12" = 1'-0"

MADISON | MILWAUKEE | DENVER

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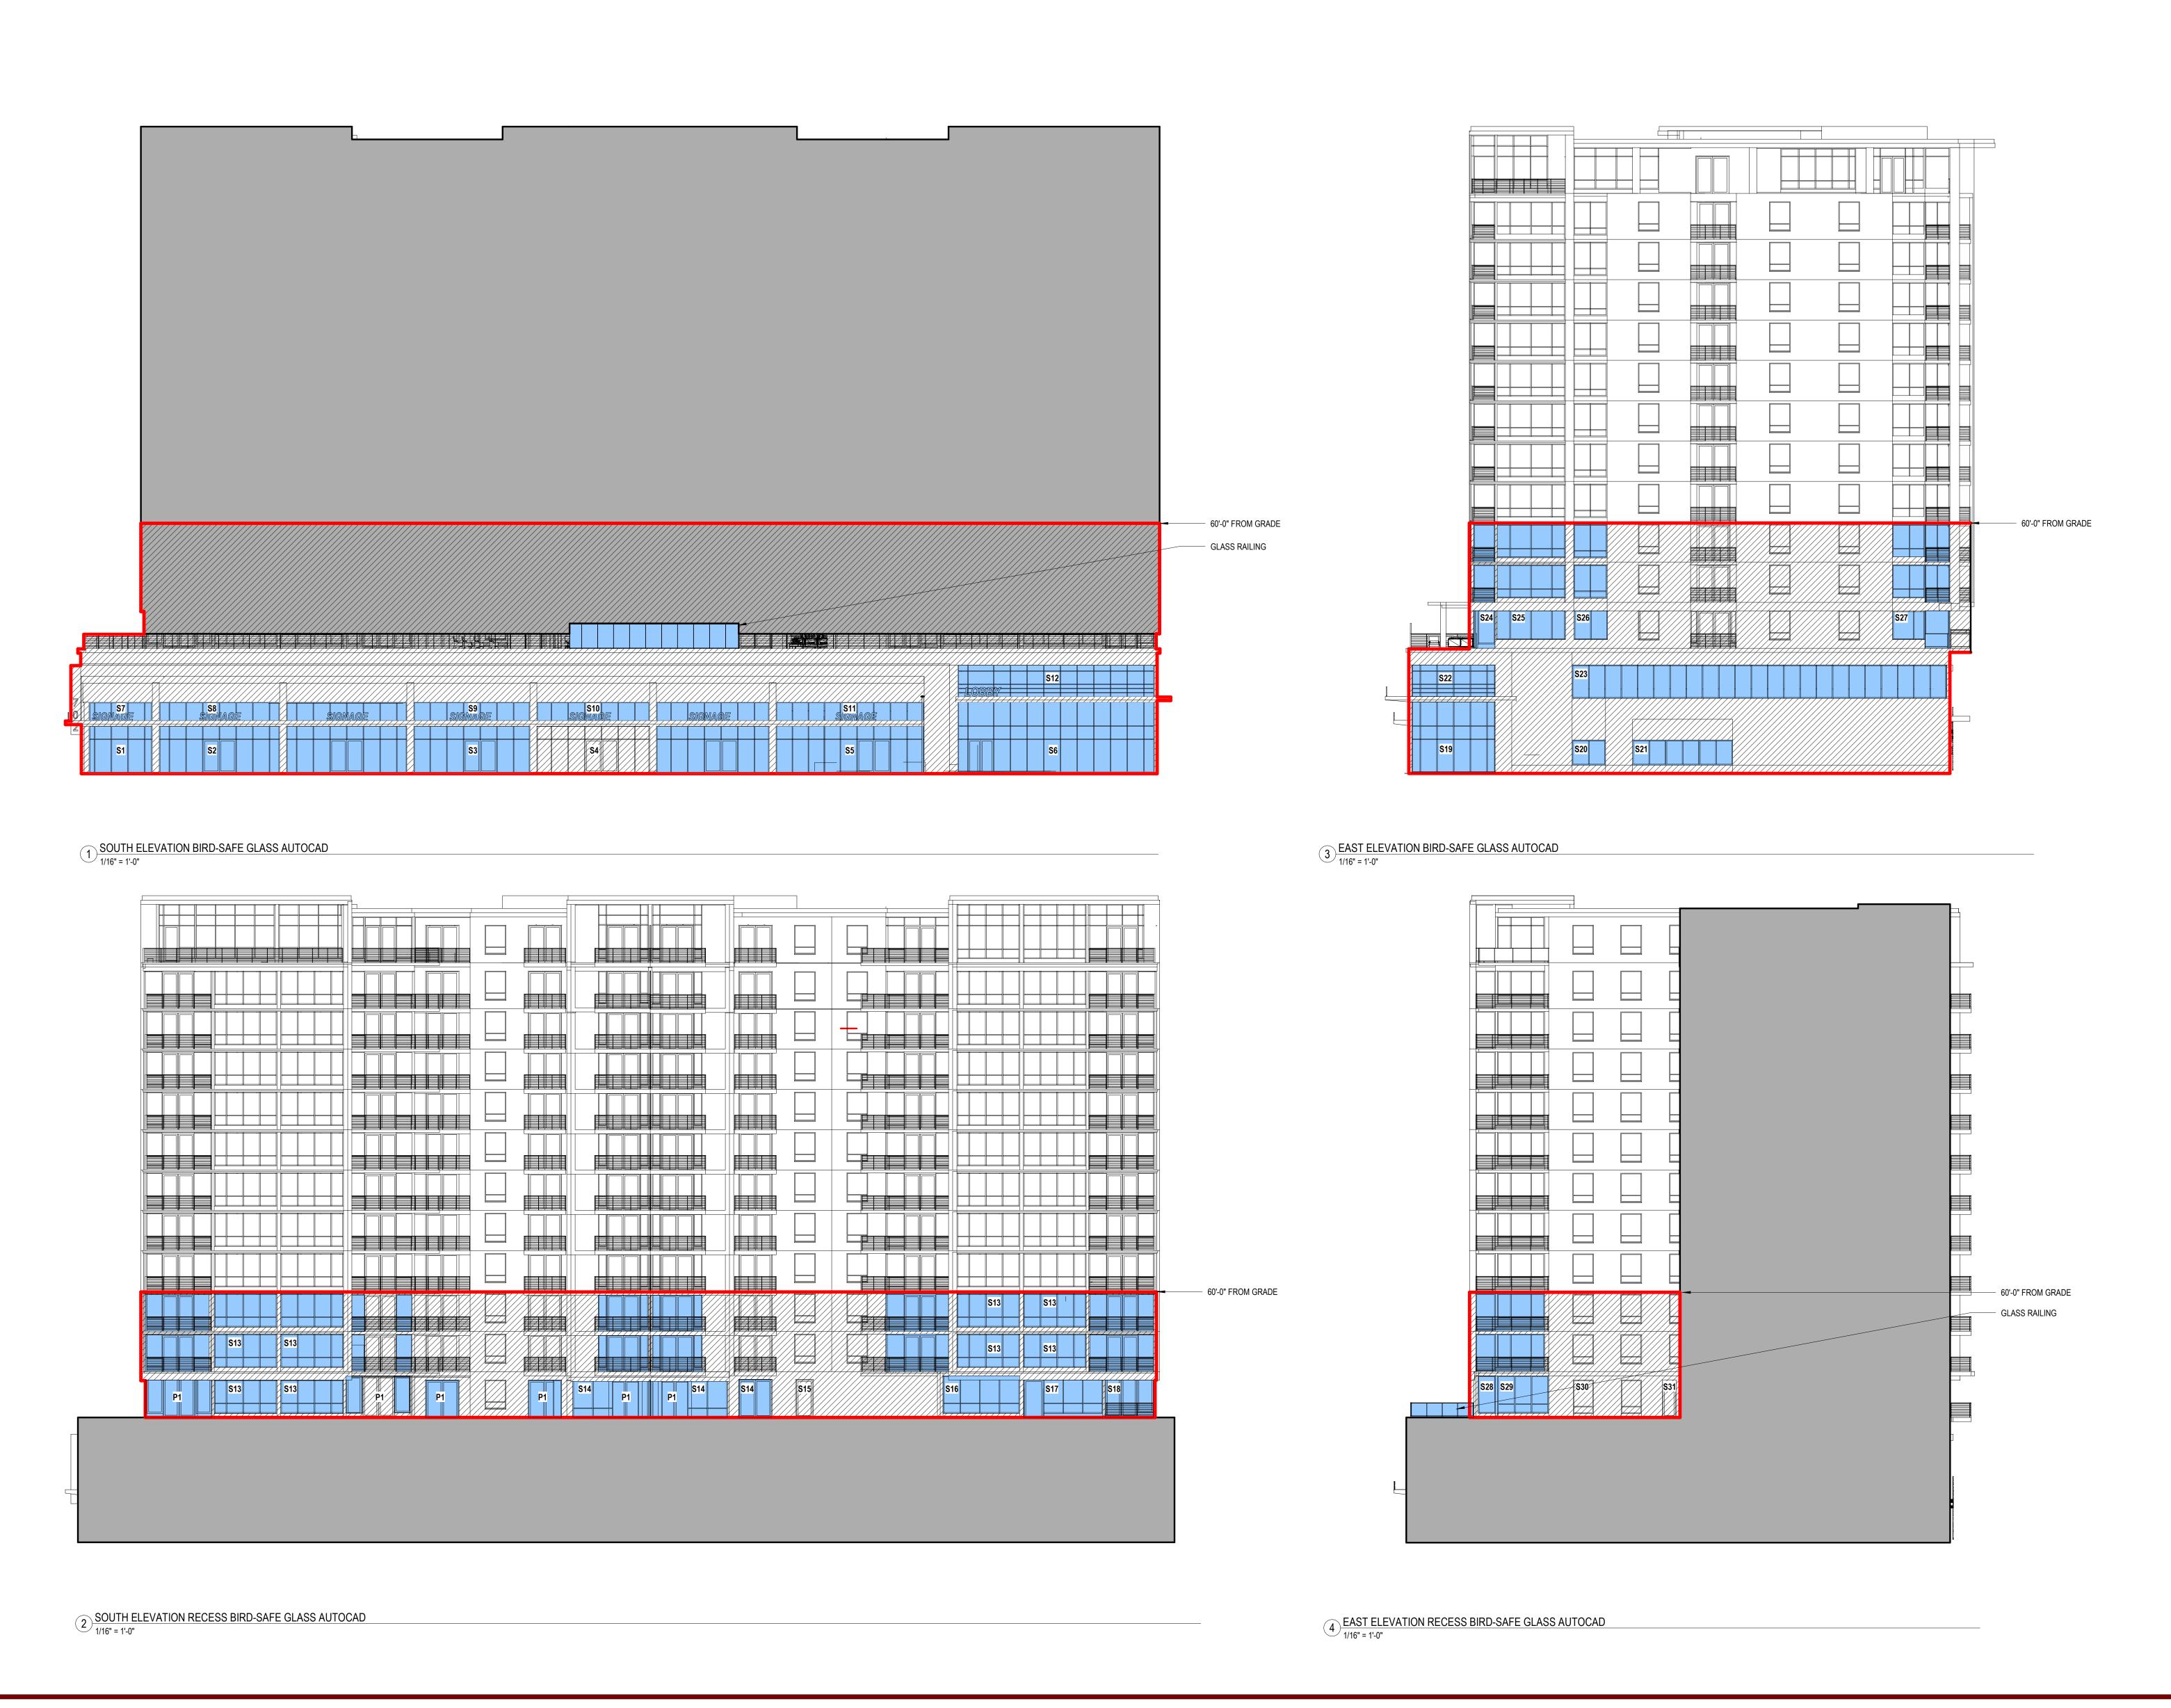
JLA PROJECT NUMBER:

702 EAST WASHINGTON AVENUE MIXED-USE DEVELOPMENT

CITY OF MADISON LAND-USE & URBAN DESIGN COMMISION SUBMITTAL

DATE OF ISSUANCE NOVEMBER 27, 2023 REVISION SCHEDULE

BIRD-SAFE GLASS REQUIREMENTS





JLA PROJECT NUMBER: W22-0106

702 EAST WASHINGTON AVENUE MIXED-USE DEVELOPMENT

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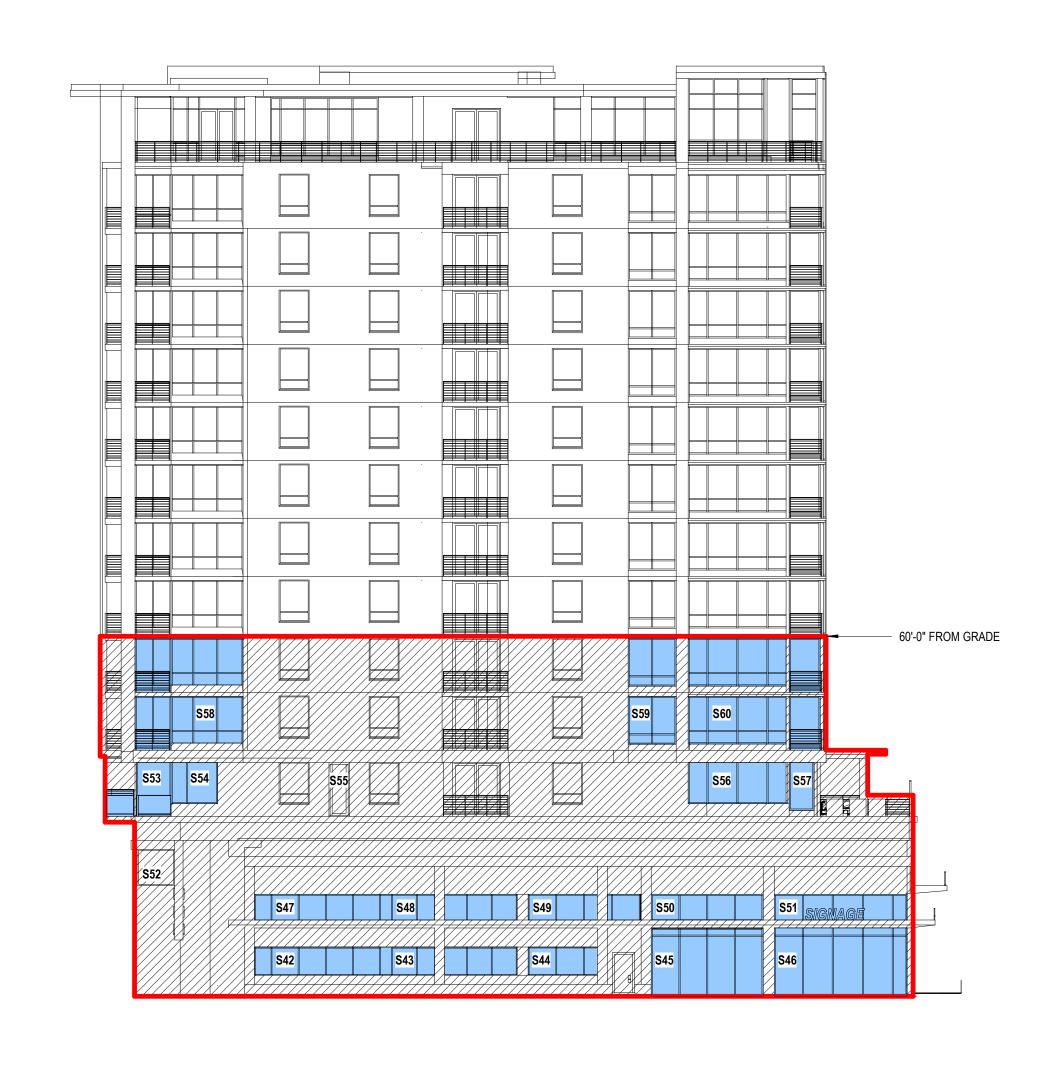
BIRD-SAFE GLASS
EXTERIOR
ELEVATIONS


SHEET NUMBER



NORTH ELEVATION BIRD-SAFE GLASS AUTOCAD

1/16" = 1'-0"



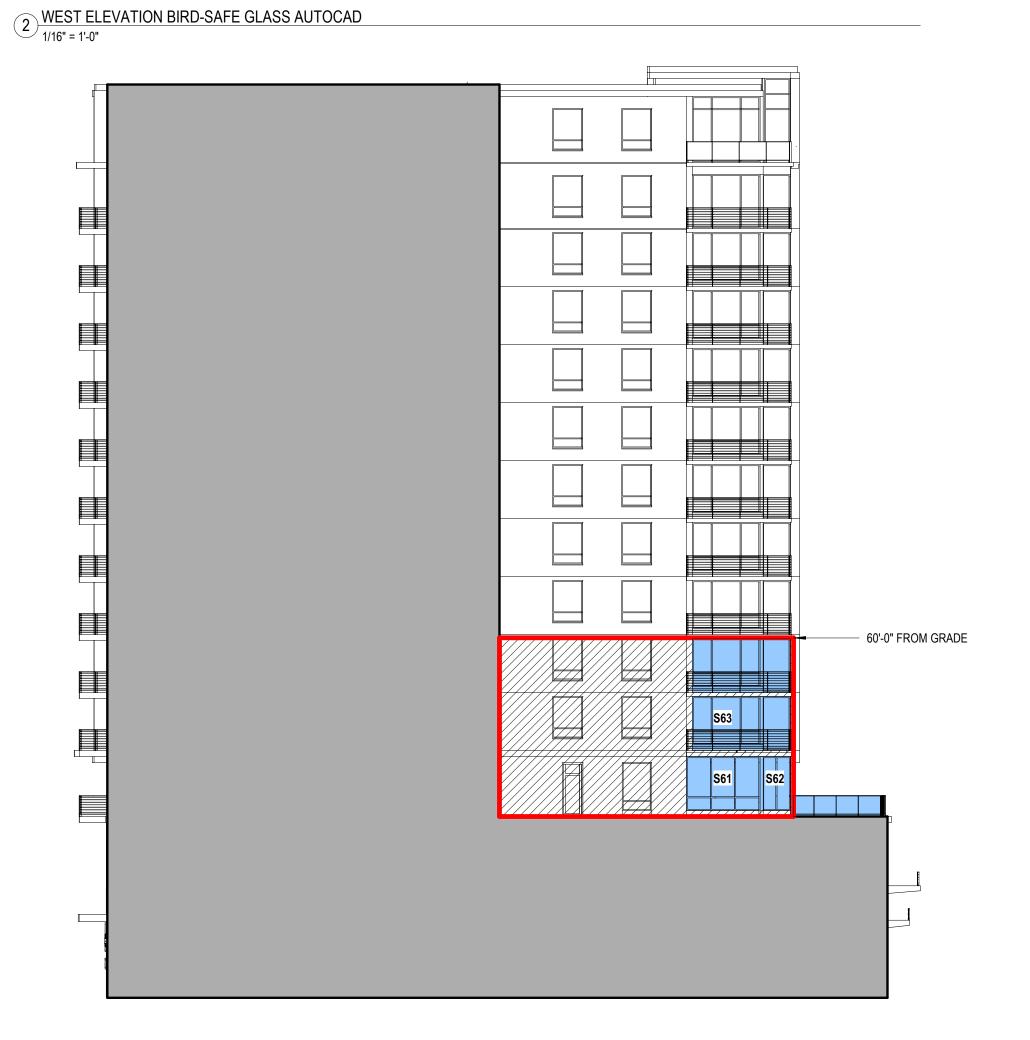

WEST ELEVATION RECESS BIRD-SAFE GLASS AUTOCAD
1/16" = 1'-0"



JLA PROJECT NUMBER: W22-0106

702 EAST WASHINGTON AVENUE MIXED-USE DEVELOPMENT

CITY OF MADISON LAND-USE & URBAN DESIGN COMMISION SUBMITTAL

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Mark

Description

Date

BIRD-SAFE GLASS EXTERIOR ELEVATIONS

SHEET NUMBER