Johnson Financial Group - Building Renovation

448 S. Gammon Road | Madison, WI 53719

PROJECT TEAM

TENANT

Johnson Financial Group

555 Main Street Racine, WI 53403

ARCHITECT

The Redmond Company

W228 N745 Westmound Drive Waukesha, WI 53186

PROJECT CONTACT: Eric Ohlfs EMAIL: eohlfs@theredmondco.com P: 262.896.3787

CONTRACTOR

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PROJECT CONTACT: Matt Hartenstein EMAIL: mhartenstein@stevensconstruction.com P: 608.222.5930

STRUCTURAL ENGINEER REYN Engineering Inc. 131 Seeboth: Suite 220

Milwaukee, WI 53204

PROJECT CONTACT: Ken Sosinski
EMAIL: ken@reynengineering.com
P: 414-644-0109

LANDSCAPE ARCHITECT Heller & Associates, LLC

PO Box 1359 Lake Geneva, WI 53147


PROJECT CONTACT: David Heller EMAIL: david@wdavidheller.com P: 262.639.9733

SHEET INDEX

	SHEET INDEX - UD	C
GENERAL		
G001	UDC Index	
CENTEDAL		
GENERAL G002	Contextual Site Information	
G002 G003	Existing Building Photos	
0003	Existing building Friotos	
SURVEY		
SURVEY	Plat of Survey with Topography	
ARCHITECT		
AS001	Site Demolition Plan & Site Details	
AS100	Architectural Site Plan	
PRESENTAT		
AP100	New Lower Level Presentation Plan	
AP101	New First Floor Presentation Plan	
AP102	New Roof Presentation Plan	
AP200	Exterior Rendering	
AP201	Exterior Renderings	
AP202	New Exterior Elevations - Colored	
AP203	New Exterior Elevations - Black & White	
LANDSCAPE		1
L1.0	Overall Landscape Plan	
L1.1	Enlarged Landscape Plan	
L1.2	Landscape Details, Notes & Schedules	
ELECTRIC:		
ELECTRICAL		
ES100	Site Photometric Plan	
ES101	Light Fixture 'OC' & 'OD' Cutsheets	
ES102	Light Fixture 'OE' Cutsheet	
ES103	Light Fixture 'OF' Cutsheet	

VICINTITY MAP

PROJECT SITE -

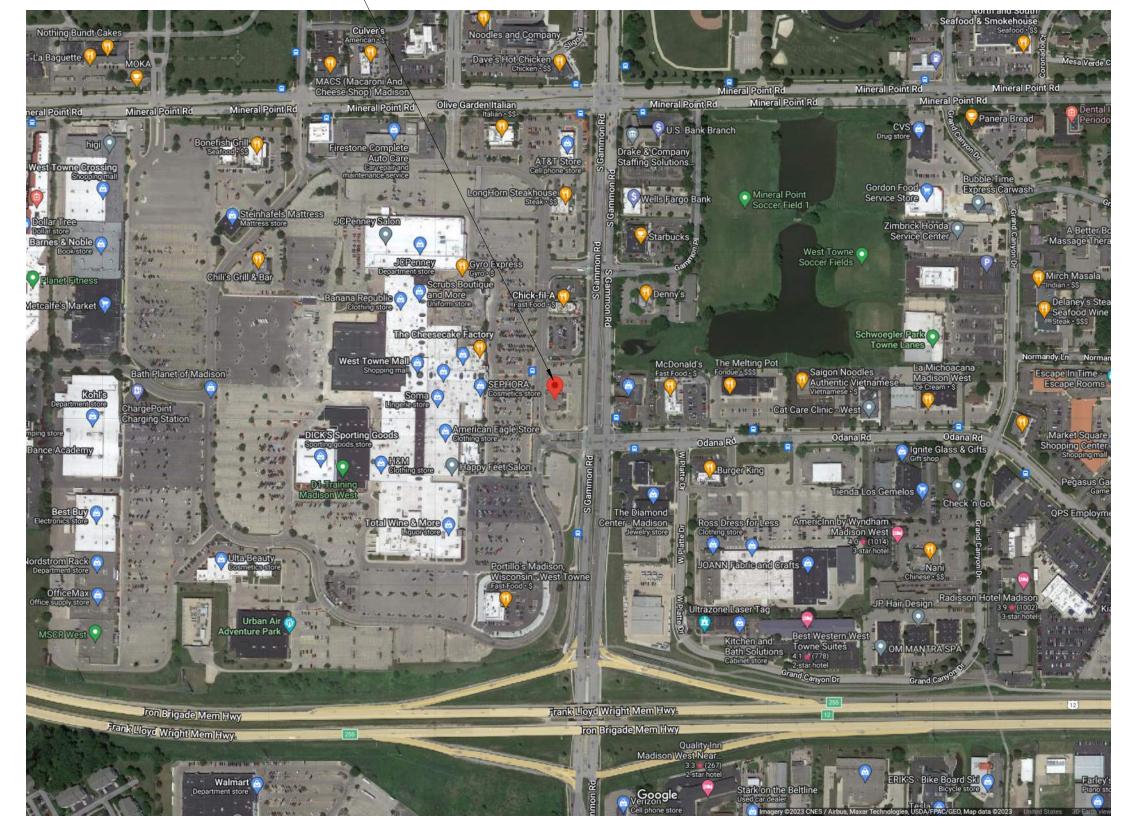

THE ED MON DRIVE | WALKESHA, WISCONSIN 53186 | P: 262.549.9600

ohnson Financial Group Suilding Renovation

UDC SUBMITTAL


UDC Index

G001


ADJACENT CHICK-FIL-A PROPERTY TO THE NORTH ON GAMMON RD.



PROPERTY ACROSS GAMMON RD. TO THE EAST

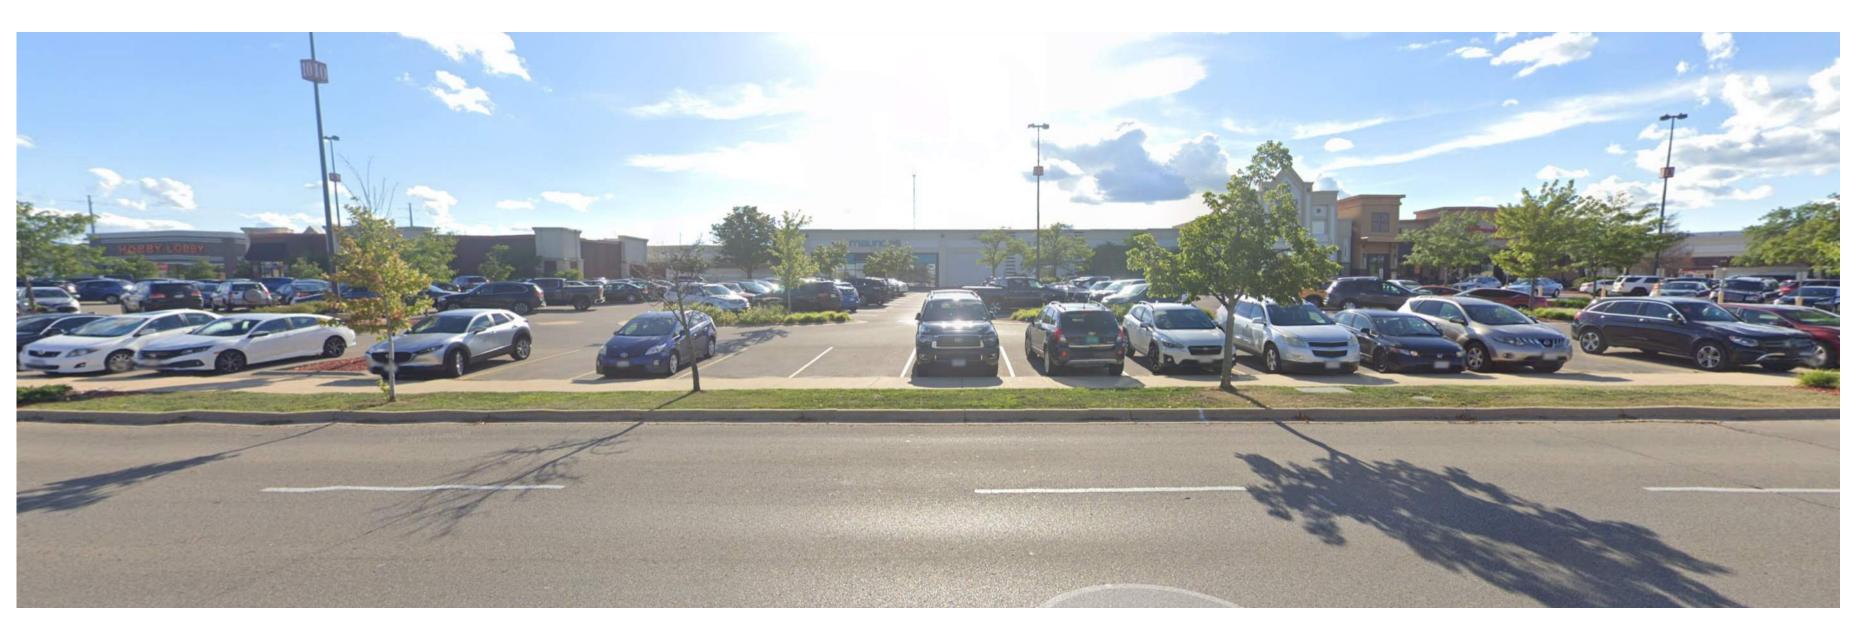

WESTPOINTE MALL TO THE WEST OF THE PROPERTY

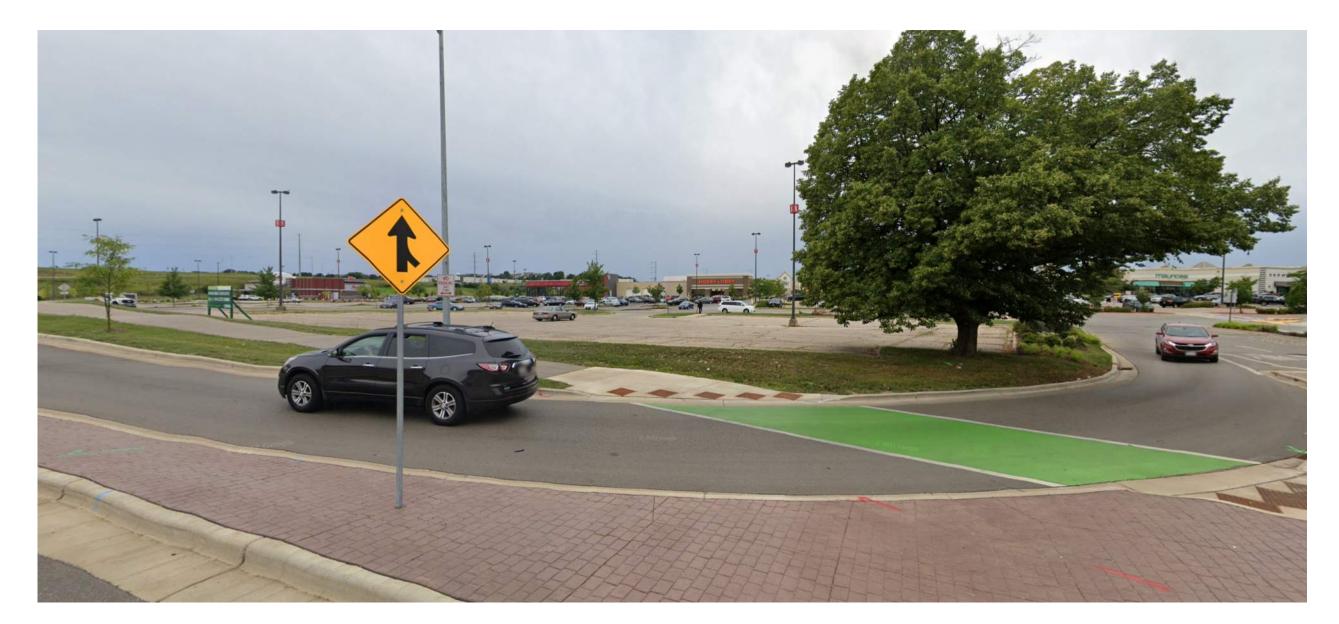

VACANT LOT TO THE SOUTH

Johnson Financial Group
Building Renovation

Project Number 24013
Date 10/17/2023
Revisions # Description Date

Contextual Site Information

G002

2023 The Redmond Compa



EXISTING EAST ELEVATION OF CURRENT PROPERTY



EXISTING SOUTH ELEVATION OF CURRENT PROPERTY




EXISTING NORTH ELEVATION OF CURRENT PROPERTY





EXISTING WEST ELEVATION OF CURRENT PROPERTY

Existing Building Photos

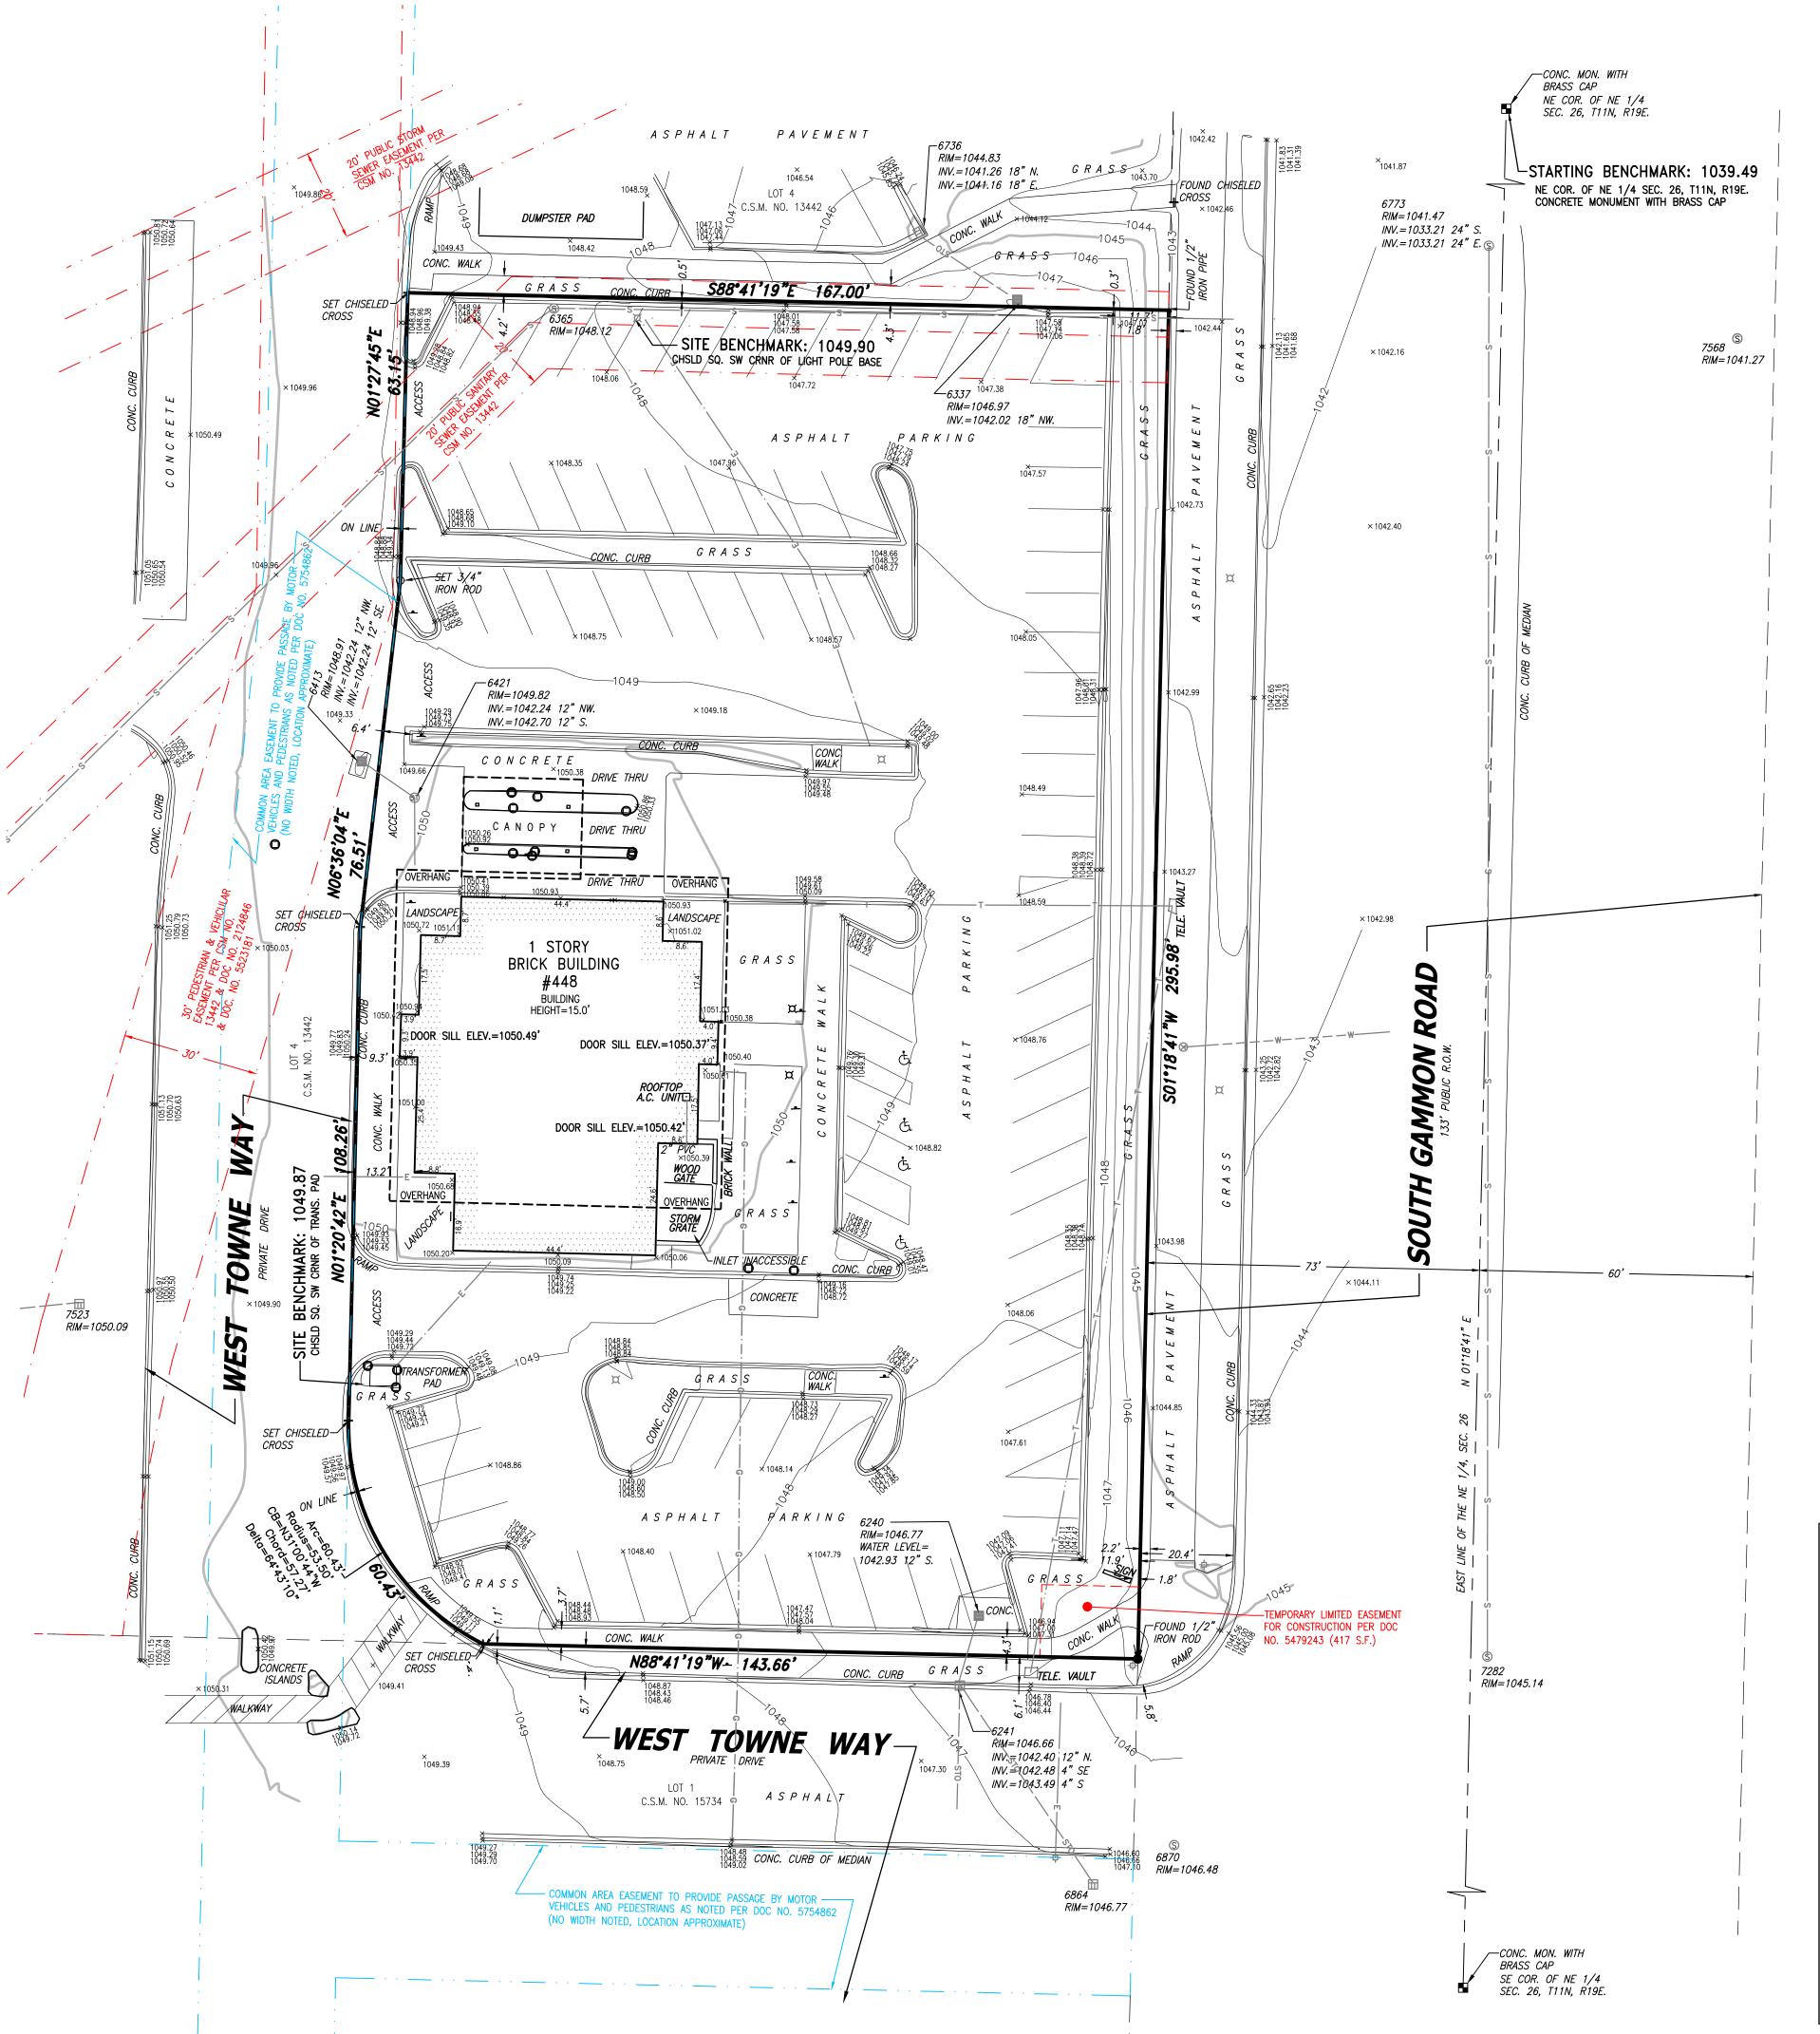



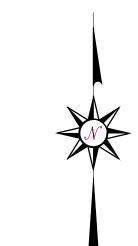

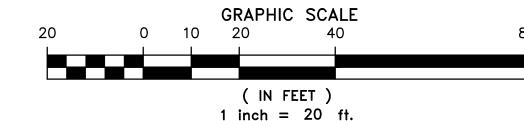

© SANITARY MANHOLE

UNKNOWN MANHOLE

■ M.I.S. MANHOLE

STORM MANHOLE

■ INLET (ROUND)

■ INLET (SQUARÉ)

CURB INLET

GAS VALVE

GAS METER

o HYDRANT

⊗ WATER VALVE

WELL HEAD

ਰ STAND PIPE

¤ LIGHT POLE

ø utility pole

k GUY POLE

 GUY WIRE

* SPOT/YARD LIGHT

© ELECTRIC MANHOLE

E ELECTRIC PEDESTAL

TELEPHONE MANHOLE

□ ELECTRIC METER

₩ALL INDICATOR VALVE

∮ POST INDICATOR VALVE

- LEGEND • INDICATES FOUND 1" IRON PIPE □ TELEPHONE PEDESTAL ○ INDICATES SET 1" IRON PIPE CABLE PEDESTAL + INDICATES FOUND CHISELED CROSS □ CONTROL BOX FIDER OPTIC PEDESTAL/SIGN SANITARY CLEANOUT OR VENT Ф TRAFFIC LIGHT SEPTIC TANK ACCESS COVER © COMMUNICATION MANHOLE BOLLARD + SOIL BORING/MONITORING WELL ₹ WATER SURFACE ♦ WETLANDS FLAG MARSH FLAGPOLE STORM SEWER END SECTION PARKING METER SIGN 🛱 MAILBOX * RAILROAD CROSSING SIGNAL HANDICAP SPACE * CONIFEROUS TREE © WATER SERVICE CURB STOP DECIDUOUS TREE - MARKED GAS MAIN
 - MARKED ELECTRIC — · —— OVERHEAD WIRES MARKED TELEPHONE - MARKED CABLE TV LINE —··——F0— MARKED FIBER OPTIC — · · · — B— BURIED ELECTRIC SERVICE CHAIN LINK FENCE

PLAT OF SURVEY WITH TOPOGRAPHY

CLIENT

Johnson Financial Group

SITE ADDRESS

448 S. Gammon Road, Madison, Dane County, Wisconsin.

LEGAL DESCRIPTION

Lot 3 of Certified Surevy Map No. 13442, Part of Lot 2 of Dane County Certified Survey Map Number 3422 and lands being part of the Northeast 1/4 if Section 26, Township 7 North, Range 8 East, City of Madison, Dane County, Wisconsin.

TITLE REPORT

This survey was prepared based on Knight Barry Title Group, Letter Report No. 2234003, dated of August 24, 2023 which lists the following easements and/or restrictions:

Easement recorded as Document No. 518065; Easement Assignment recorded as Document No. 1172678. Affects property by location, general in nature cannot be plotted.

Easements, restrictions and operating agreement recorded as Document No. 1239177; Supplements recorded as Document Nos. 1303874, 1288279, 1359322, 1657737, 1752610, 1786646 and 2124846. Affects property by location, shown.

Easements, restrictions and operating agreement recorded as Document No. 1902238 and amended in instruments recorded as Document Nos. 2124847, 2654695, and 4001570. Use restriction, cannot be plotted.

Easement recorded as Document No. 1272585 and modified in instruments recorded as Document Nos. 2142936, 2890668, 3250638, 3250639, and 4198529. Does not affect property by location, not shown.

Public Sanitary Sewer Easement recorded as Document No. 1281760; amended and modified by instruments recorded as Document Nos. 1677835, 2142191 and 2145961. Does not affect property by location, not shown.

Public Sanitary Sewer Easement recorded as Document No. 1355553; as amended and modified by instruments recorded as Document Nos. 1677835, 2142191, and 2145961. Does not affect property by location, not shown.

Amended and Restated Easement, Restriction and Operating Agreement recorded as Document No. 1740913; as amended in instrument recorded as Document No. 2610739. Use restriction, cannot be plotted.

Easement, Restriction and Operating Agreement recorded as Document No. 2388740 and Assumption Agreement recorded as Document No. 2388741. Affects property by location, general in nature cannot be

Easement, Restriction and Operating Agreement recorded as Document No. 2297282; Assumption Agreement recorded as Document No. 2297283. Affects property by location, general in nature cannot be plotted

Planned Commercial Site recorded as Document No. 2291039 and as Document No. 2112324. Affects property by location, general in nature cannot be plotted.

Construction and Operating Agreement recorded as Document No. 3198520. Affects property by location,

general in nature cannot be plotted. Construction and Operating Agreement recorded as Document No. 3198523. Affects property by location,

general in nature cannot be plotted. Declaration of Conditions, Covenants and Restrictions recorded as Document No. 4195268. Affects property by

Easements, restrictions and other matters shown on Certified Survey Map No. 13442 recorded February 4,

2013 as Document No. 4957544. Affects property by location, shown.

Transportation Project Plat No. 5992-10-30-4.02 recorded April 8, 2019, as Document No. 5479243. Affects property by location, shown.

Access Easement Agreement recorded September 18, 2019, as Document No. 5523181. Affects property by

Operating and Reciprocal Easement Agreement recorded July 27, 2021, as Document No. 5754862. Affects

BASIS OF BEARINGS

-Revised per CSM note, all bearings are referenced to the Wisconsin County Coordinate System, Dane County Zone. The E. Line of the NE 1/4 of Section 26, T 7 N, R 8 E, is measured to bear S01°18'41"W, per CSM 13442. -Vertical Datum is based North American Vertical Datum of 1988

MUNICIPAL ZONING

The zoning information noted below is taken from the municipal code ordinance. It does not reflect all zoning restrictions that may apply. It is not intended to be used in lieu of a comprehensive zoning report as stated in ALTA Table A item 6(a) nor to be relied on for site development purposes.

Municipal Code: Sec. 28.069

Site is zoned: RMX (Regional Mixed Use) Front setback: Min. of 50% of street-facing building shall be set back no more than 25'

location, general in nature cannot be plotted.

Side setback: None

Rear setback: The lesser of 20% of lot depth or 20 feet Maximum building height: 5 stories/78 feet

FLOOD NOTE

effective date of January 2, 2009, not printed.

According to the flood insurance rate map of the County of Dane, see Community Panel No. 550250395G,

PARKING SPACES

There are 79 regular parking spaces and 4 handicap space marked on this site.

The Land Area of the subject property is 50,434 square feet or 1.1578 acres.

Site Ingress and Egress to a Public Road provided by Document No. 5754862


Inlet 6413 is full of debris.


I Certify that I have surveyed the above described property (Property), and the above map is correct to the best of my professional knowledge and belief and shows the size and location of the Property, its exterior boundaries, the location and dimensions visible structures thereon, boundary fences, apparent easements and roadways and wisible encroachments, if any. This survey is made for the exclusive use of the present owners of the Property and also those who purchase, mortgage, or guarantee the title

Date: July 27, 2013


thereto, within one (1) year from date hereof. DANIEL

S-2812 GERMANTOWN Professional Land Surveyor Registration Number S-2812

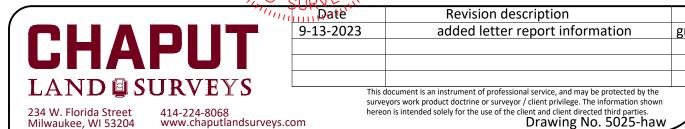

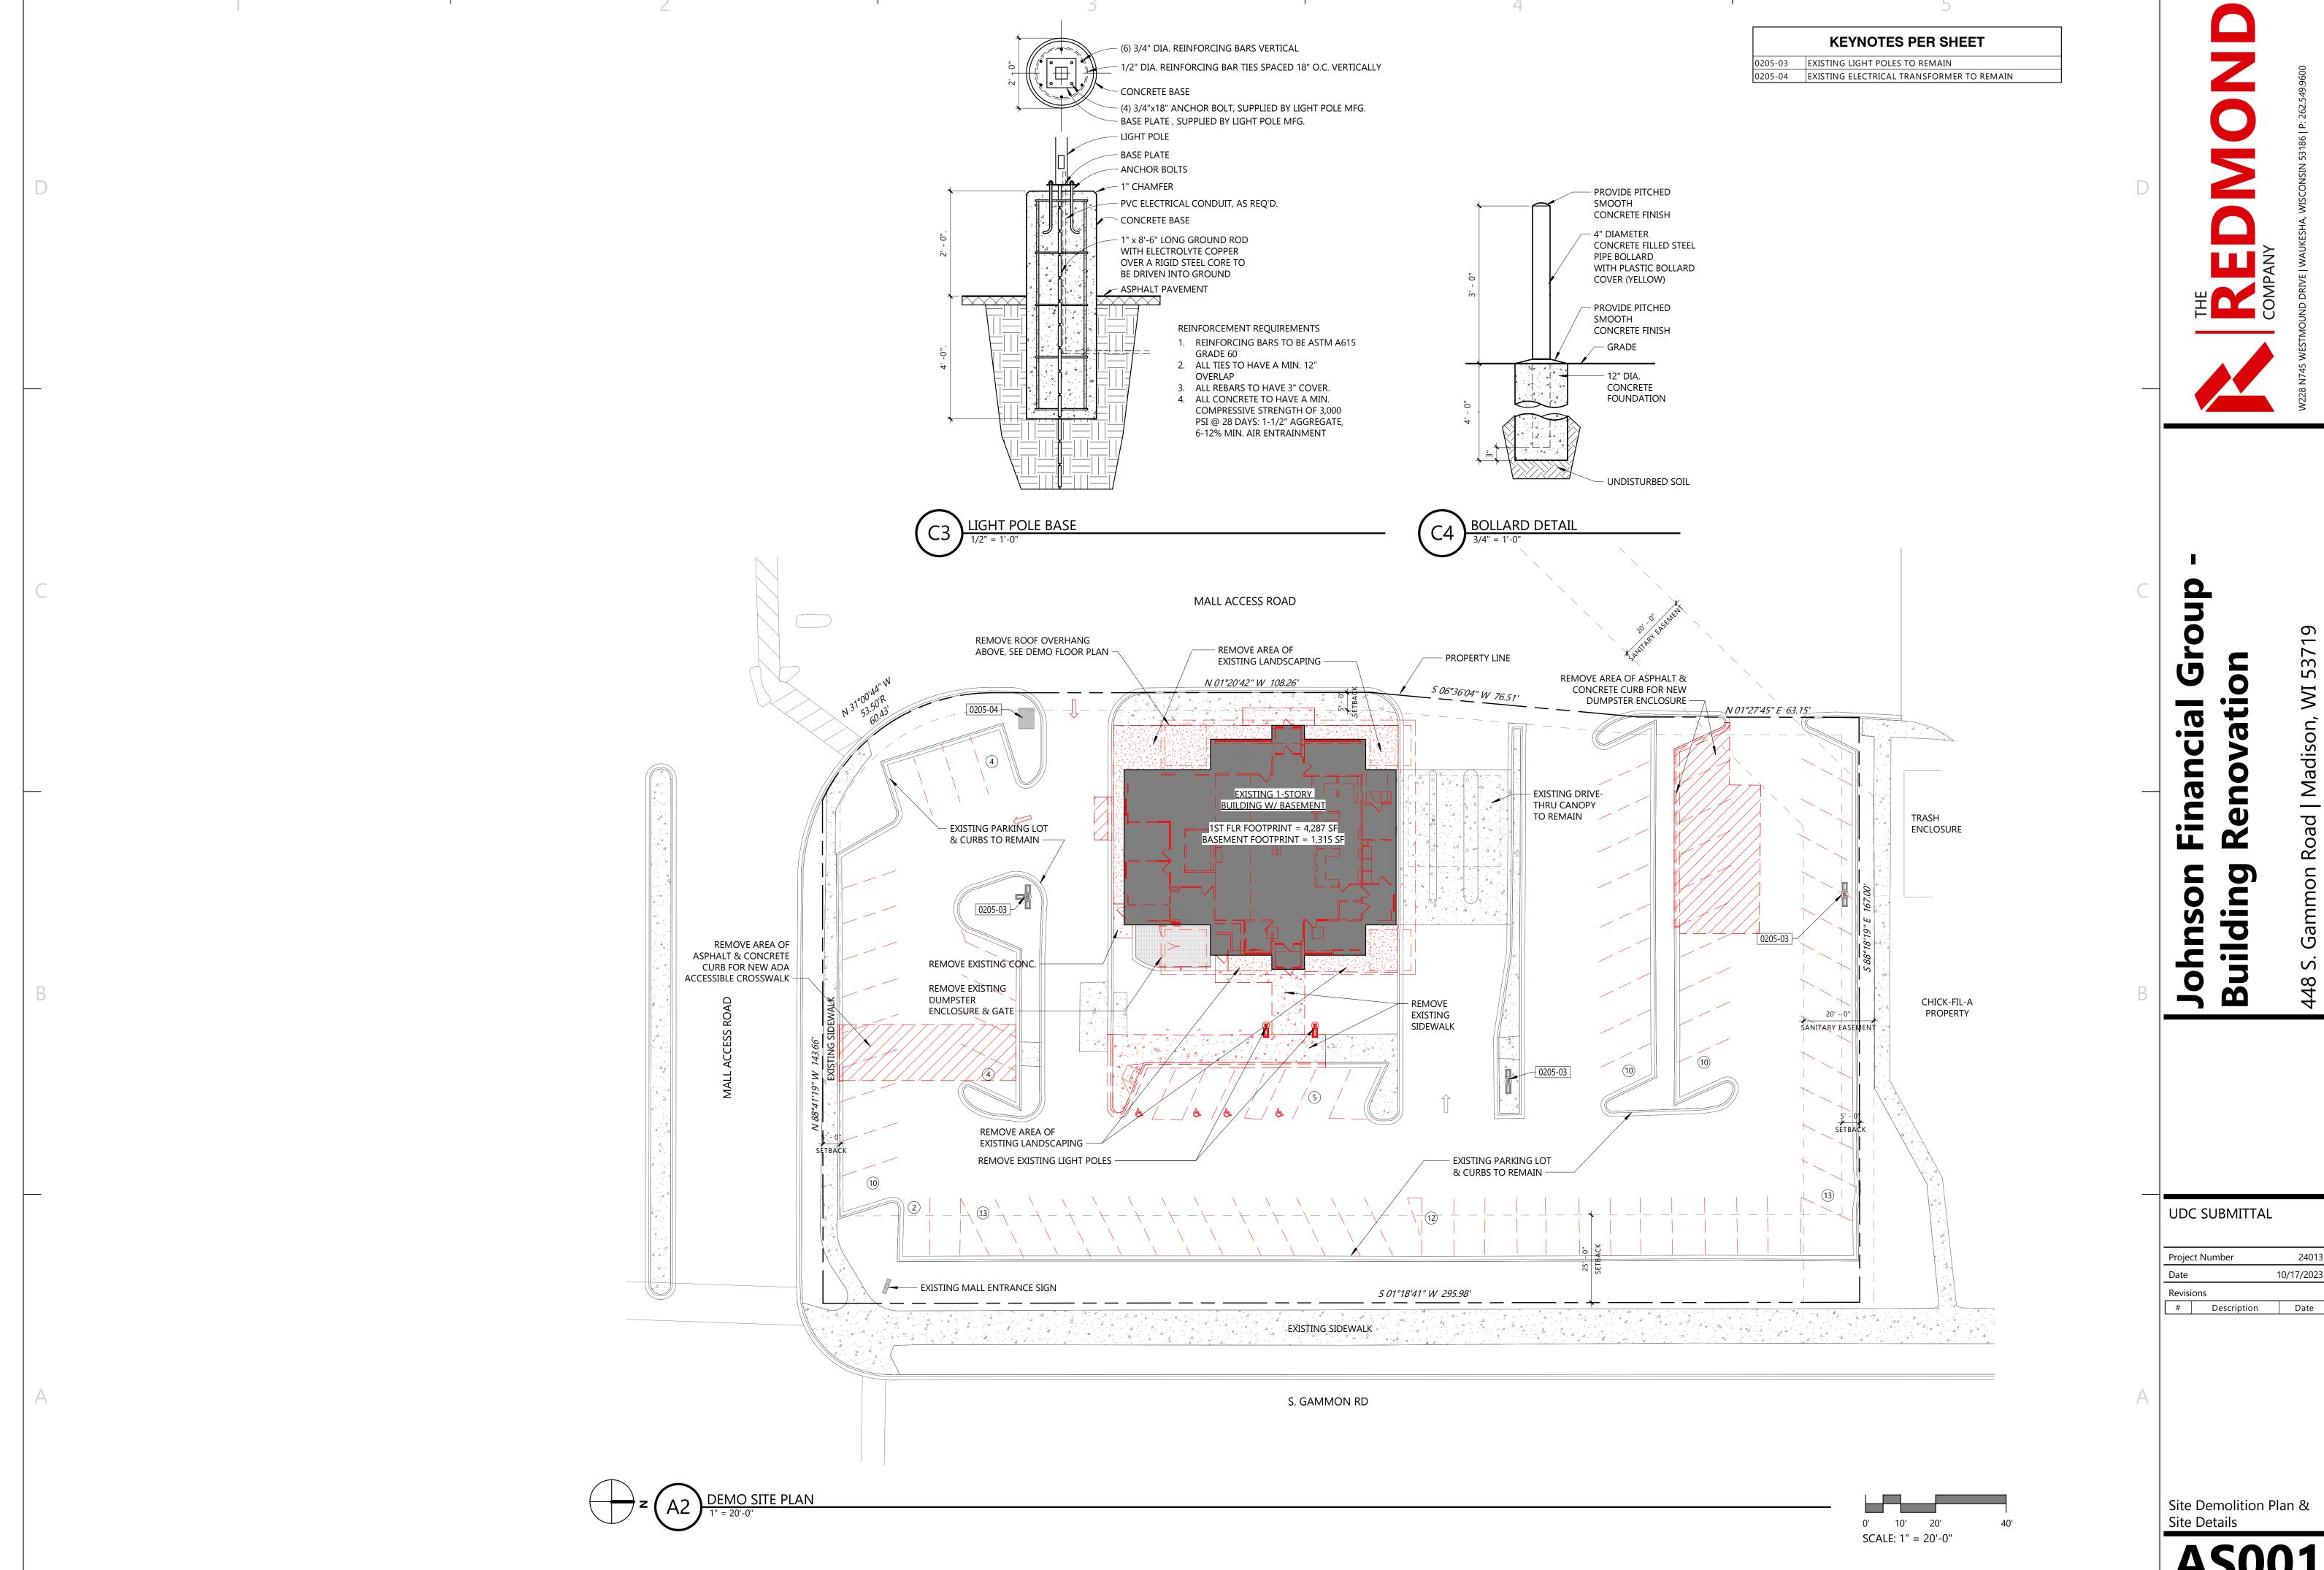

Projec	ct Number	24013	
Date		10/17/2023	
Revisi	ons		
#	Description	Date	

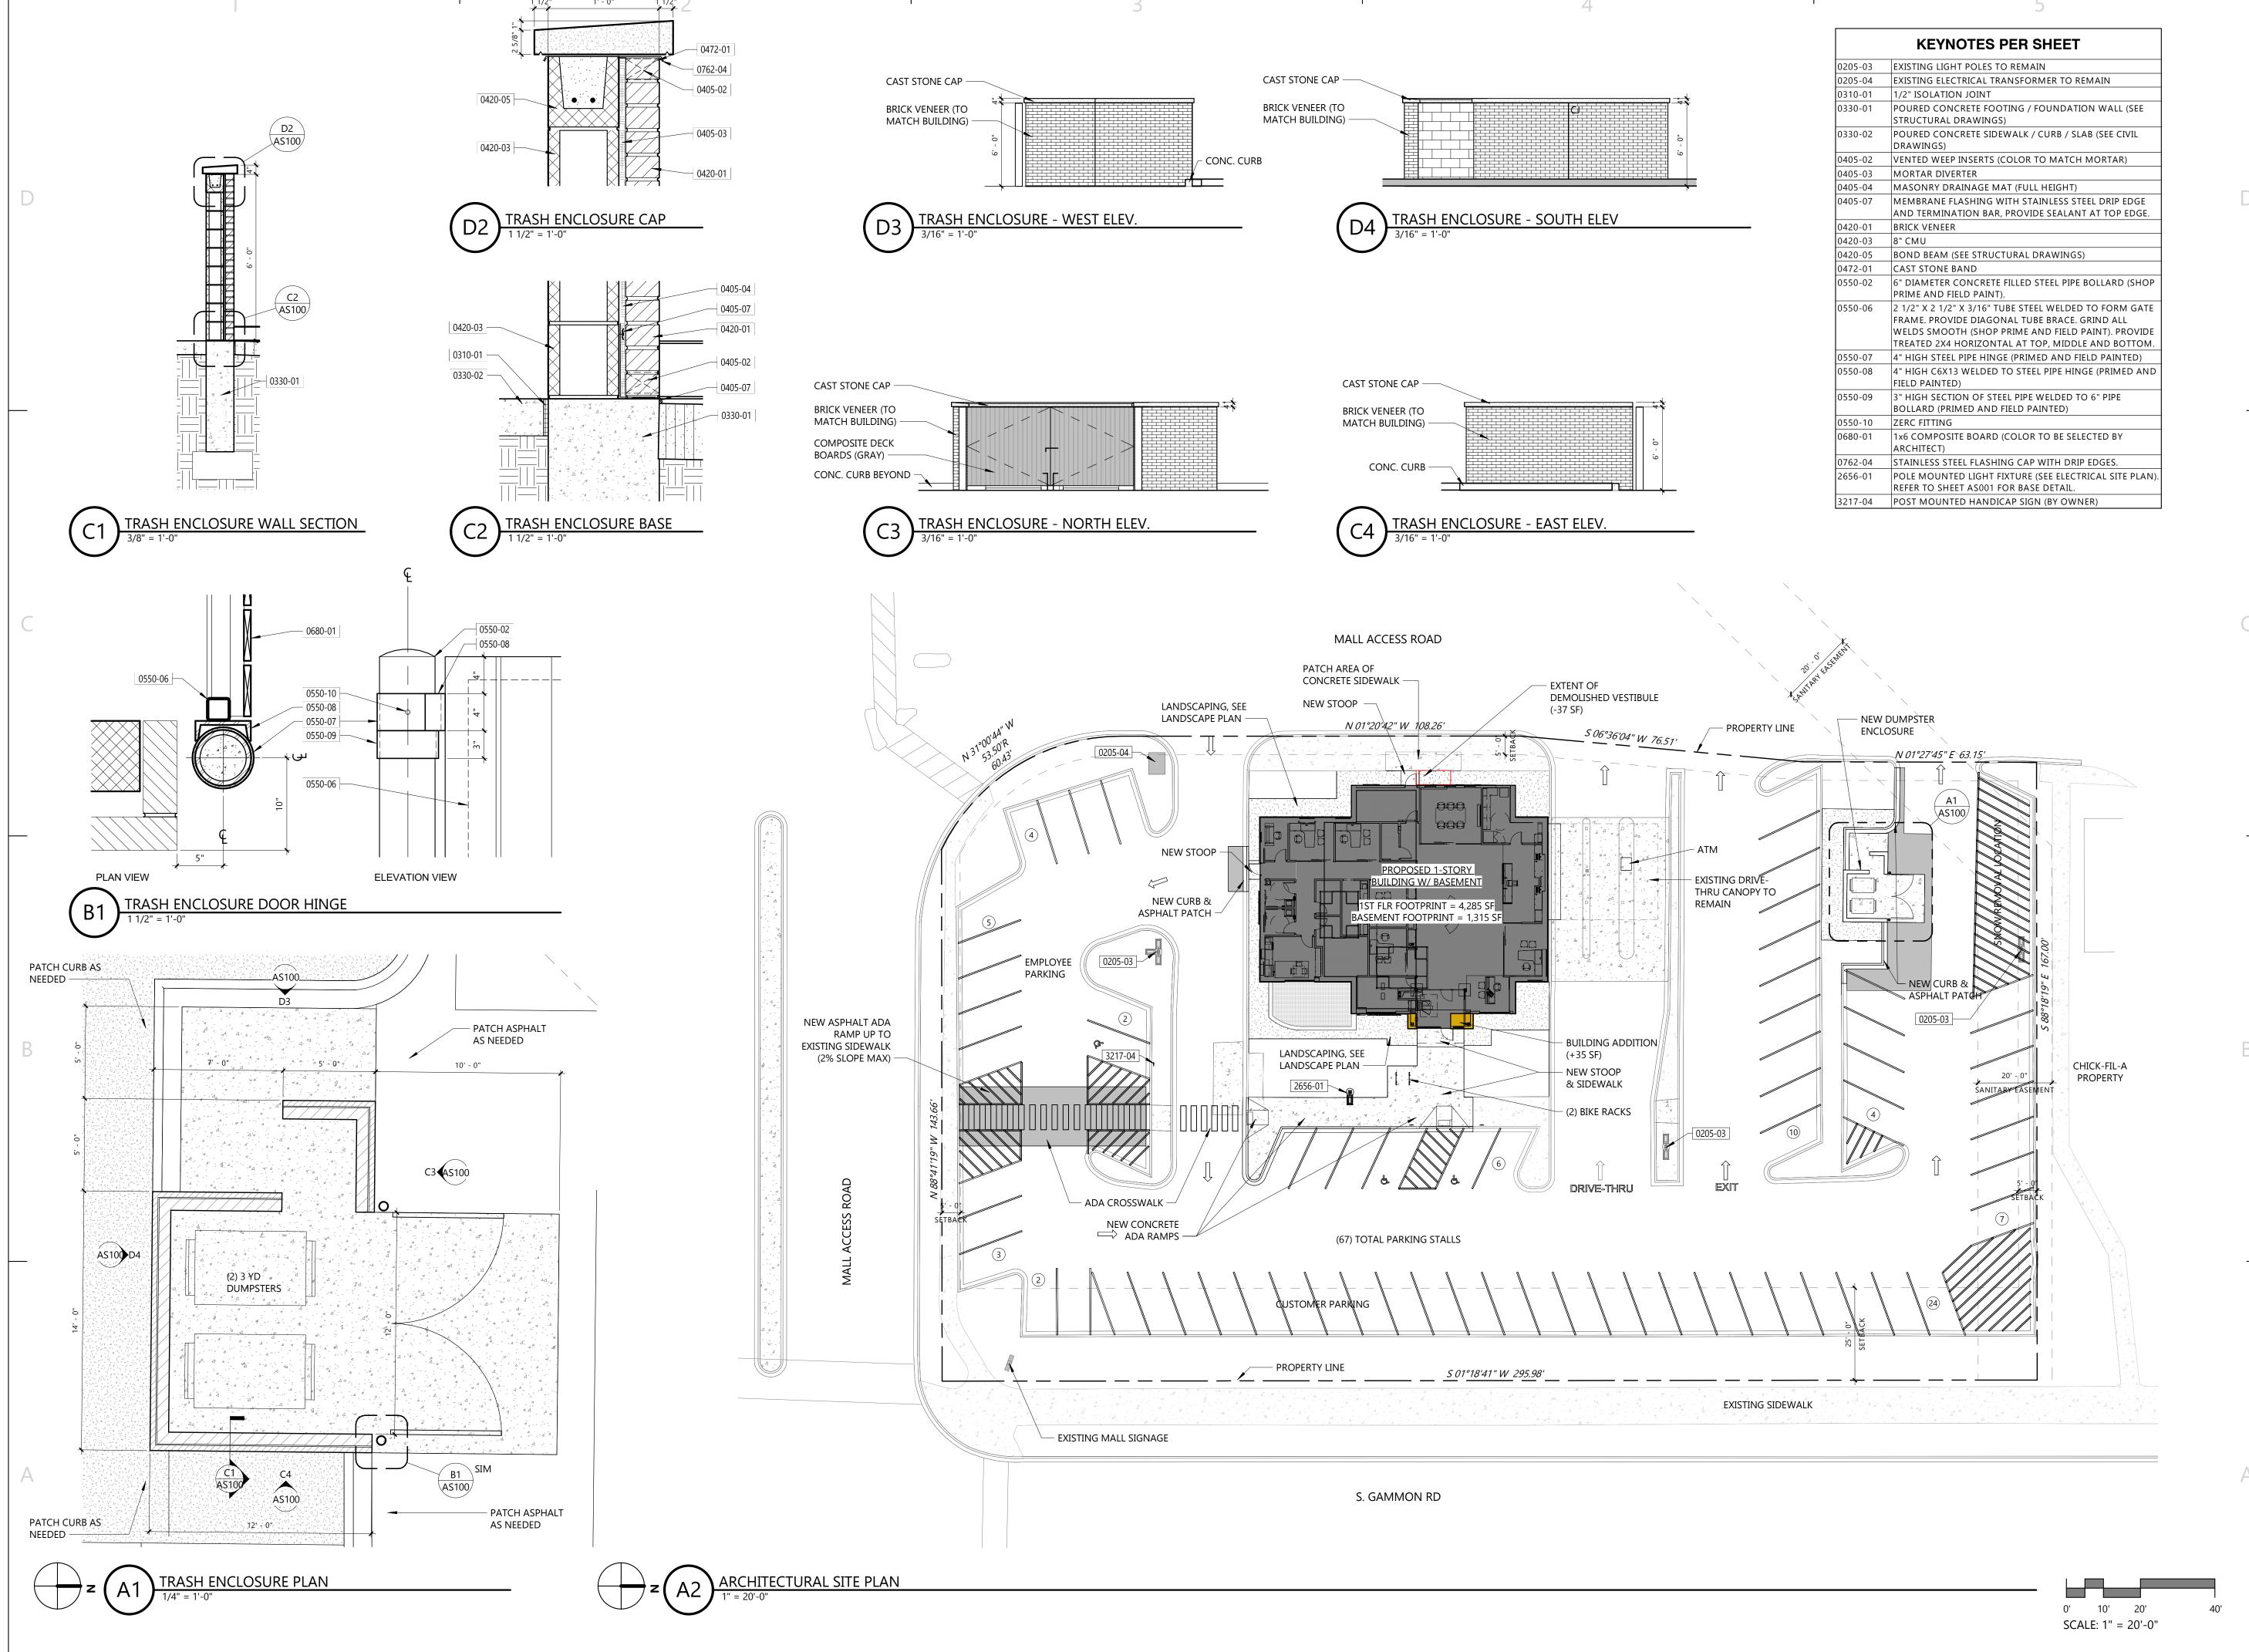



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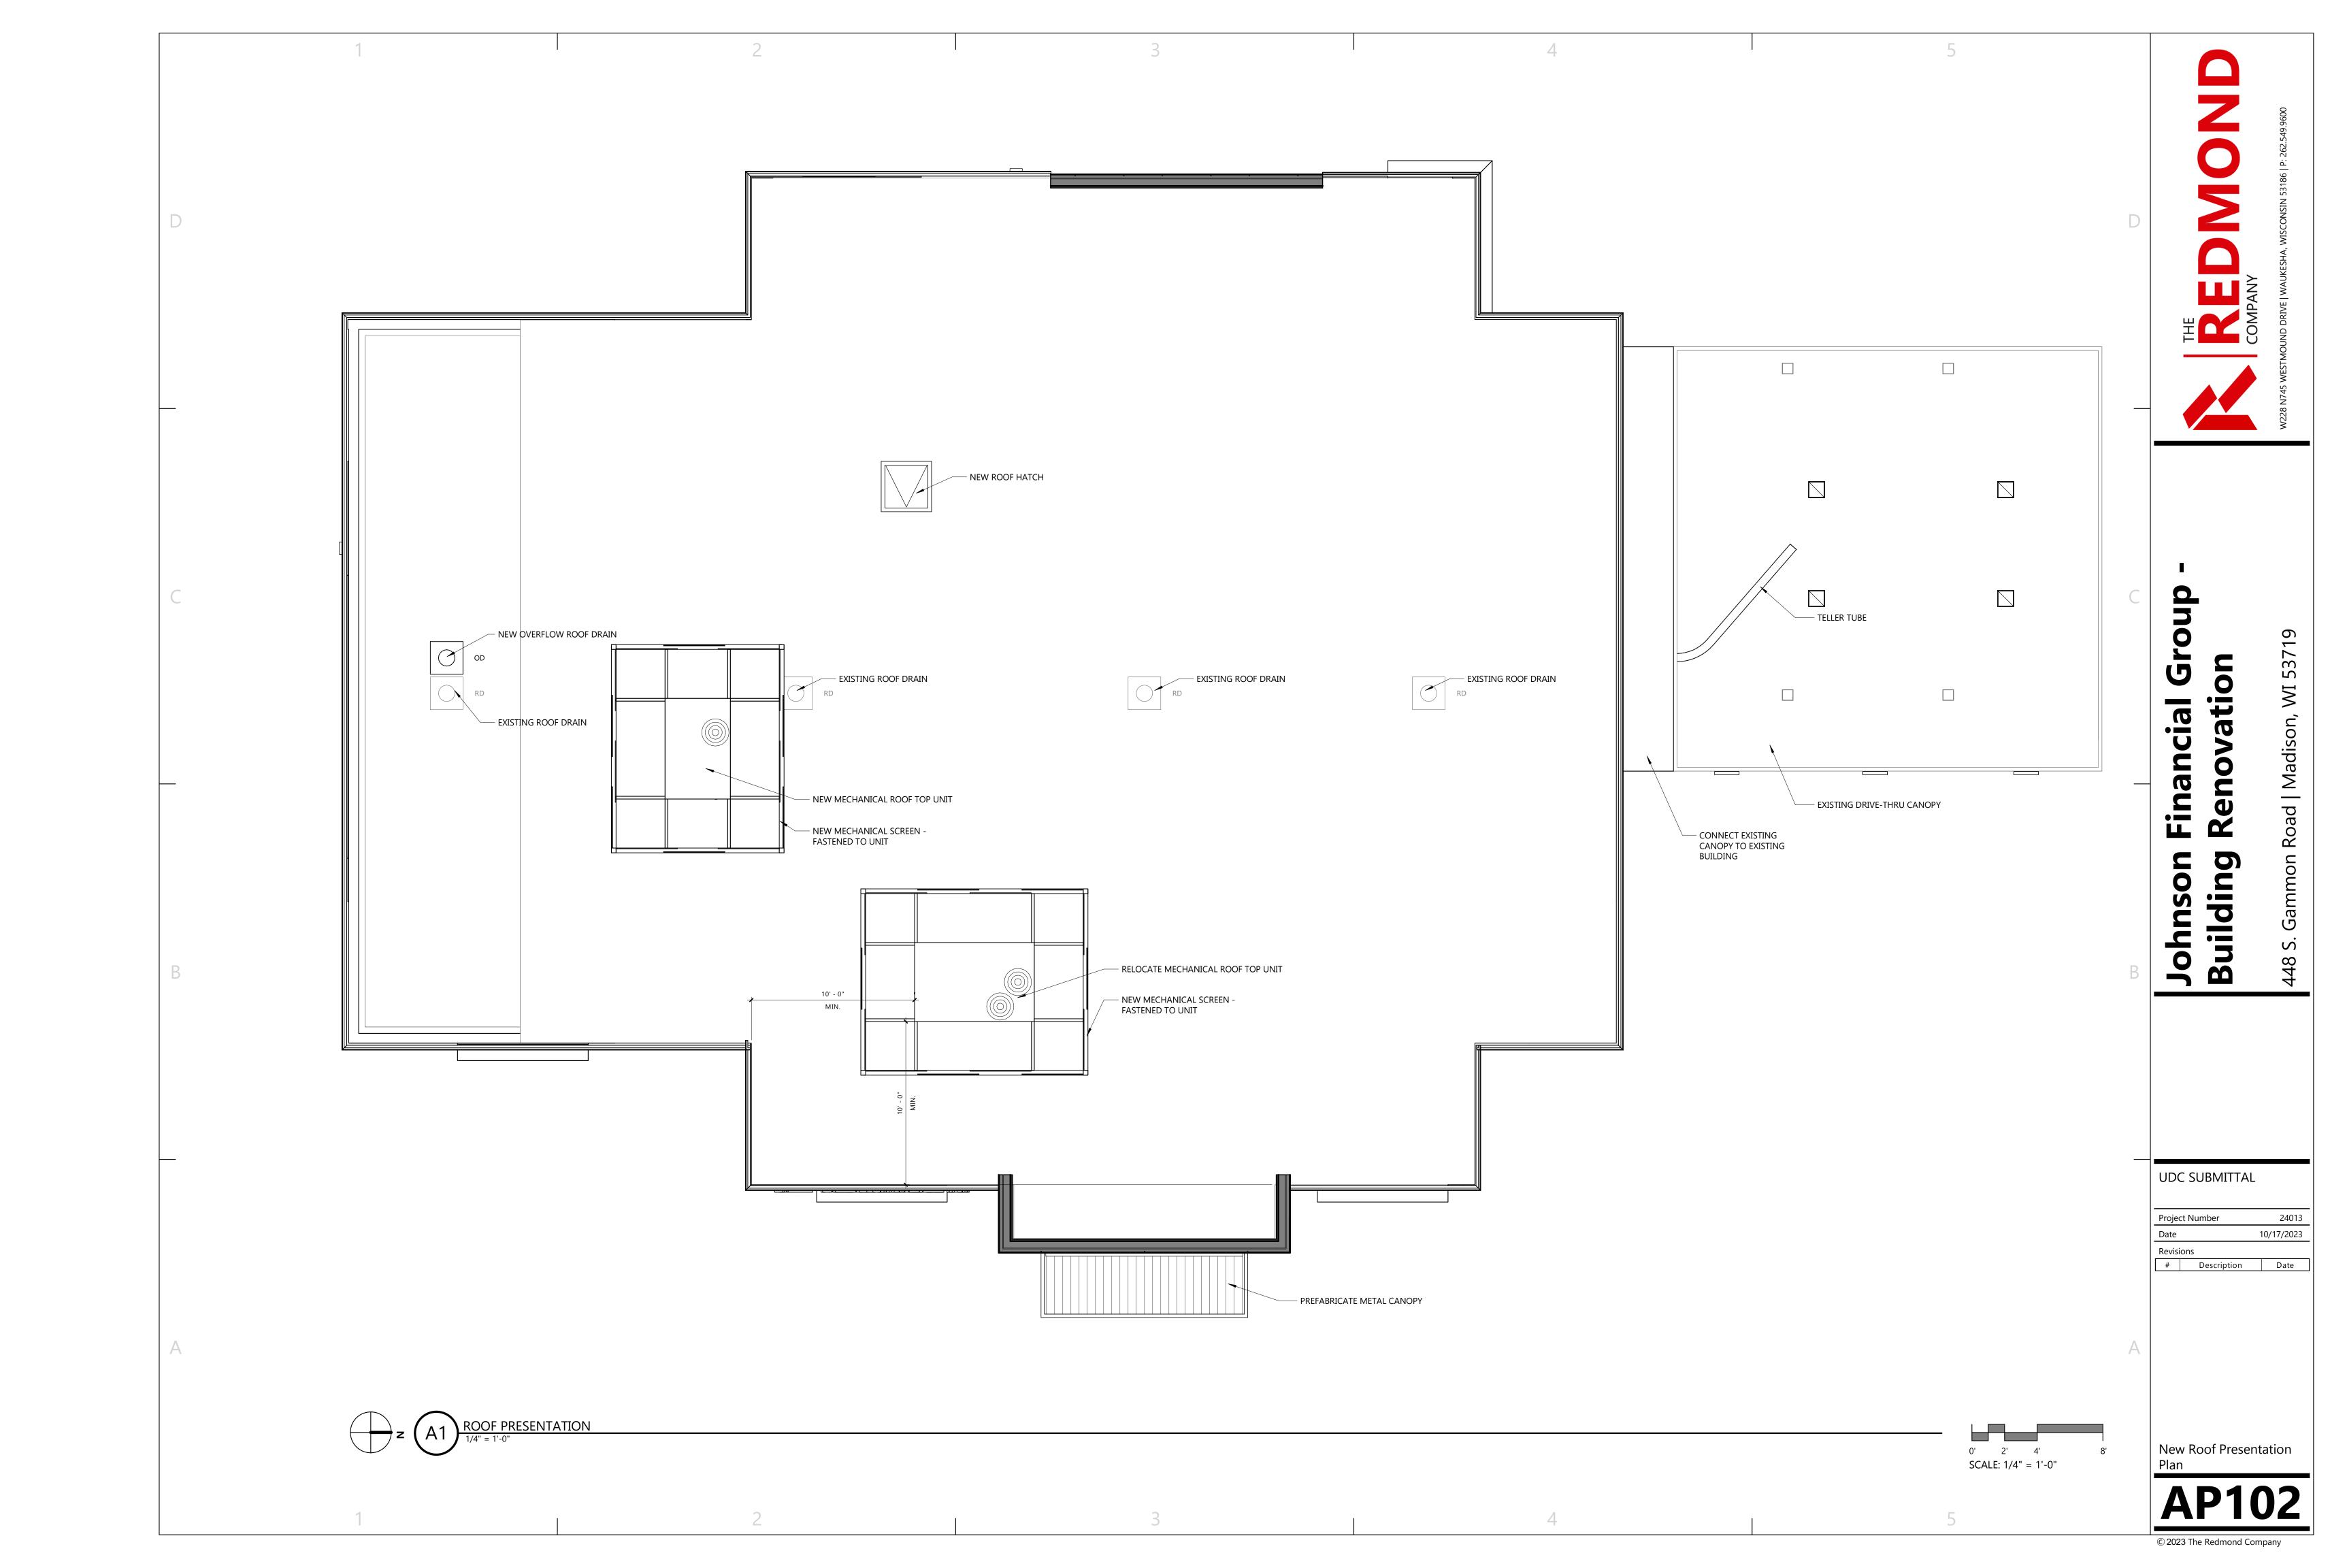
UDC SUBMITTAL

Project Number 10/17/2023 # Description Date

Architectural Site Plan



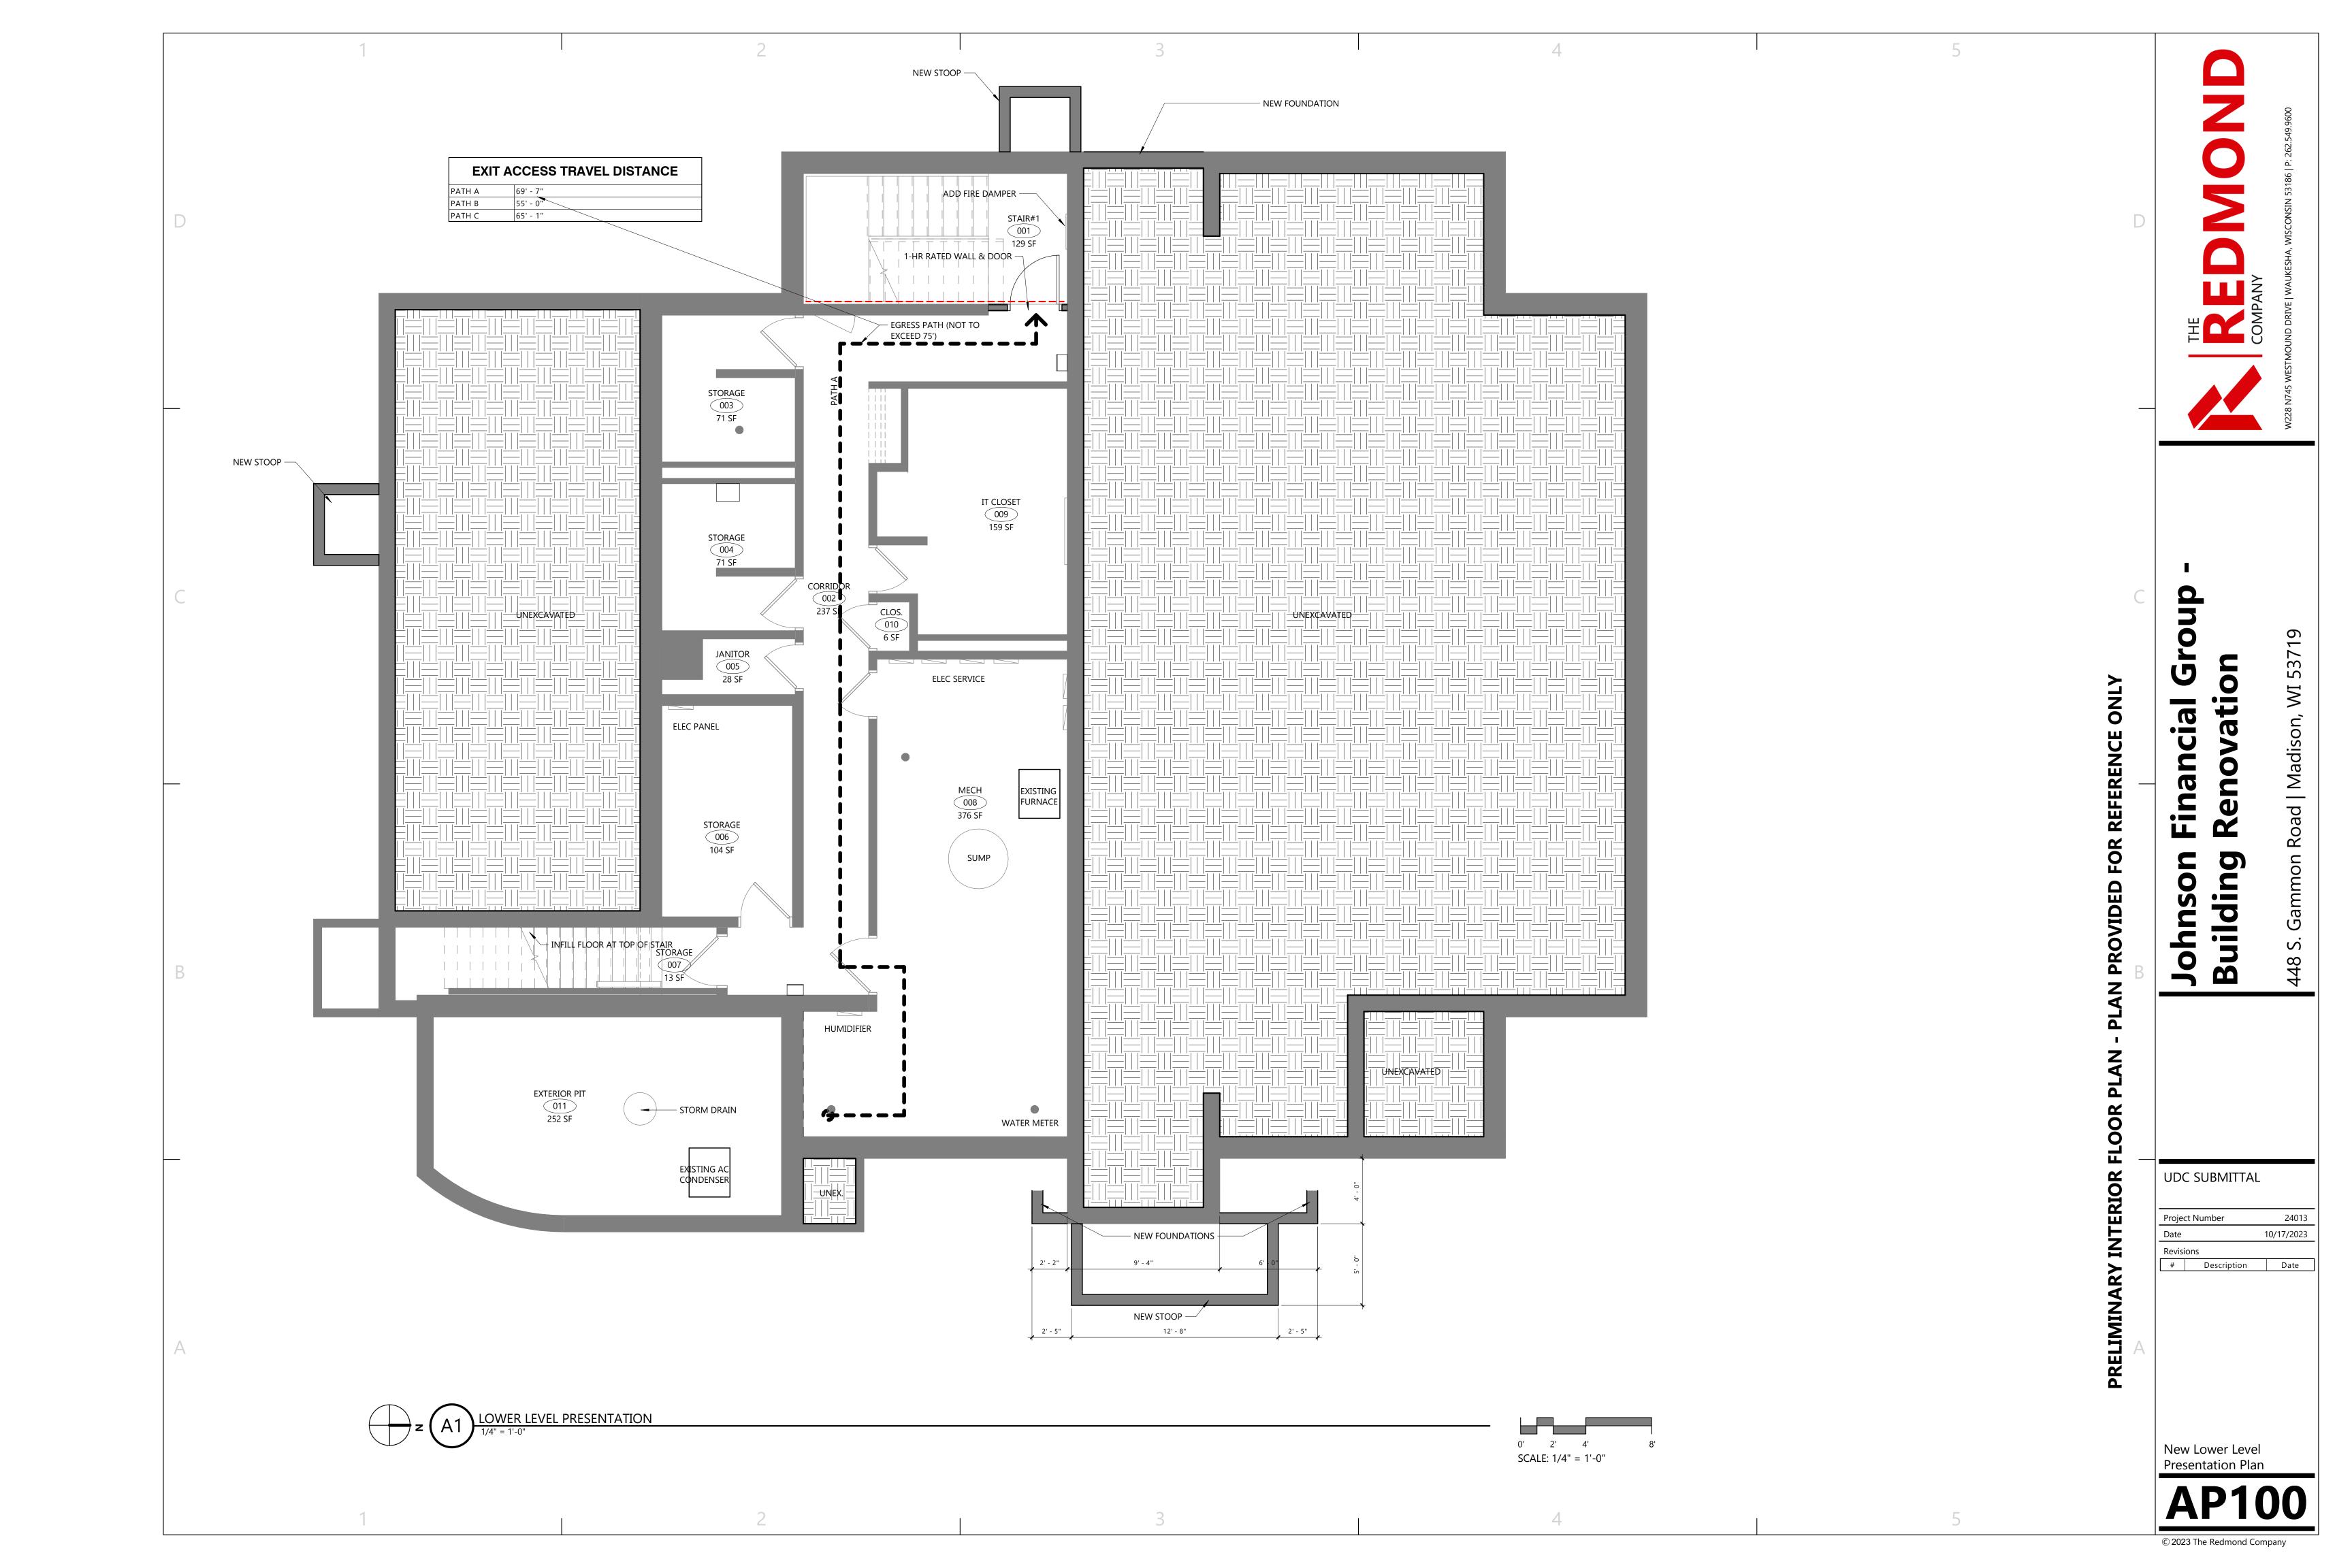

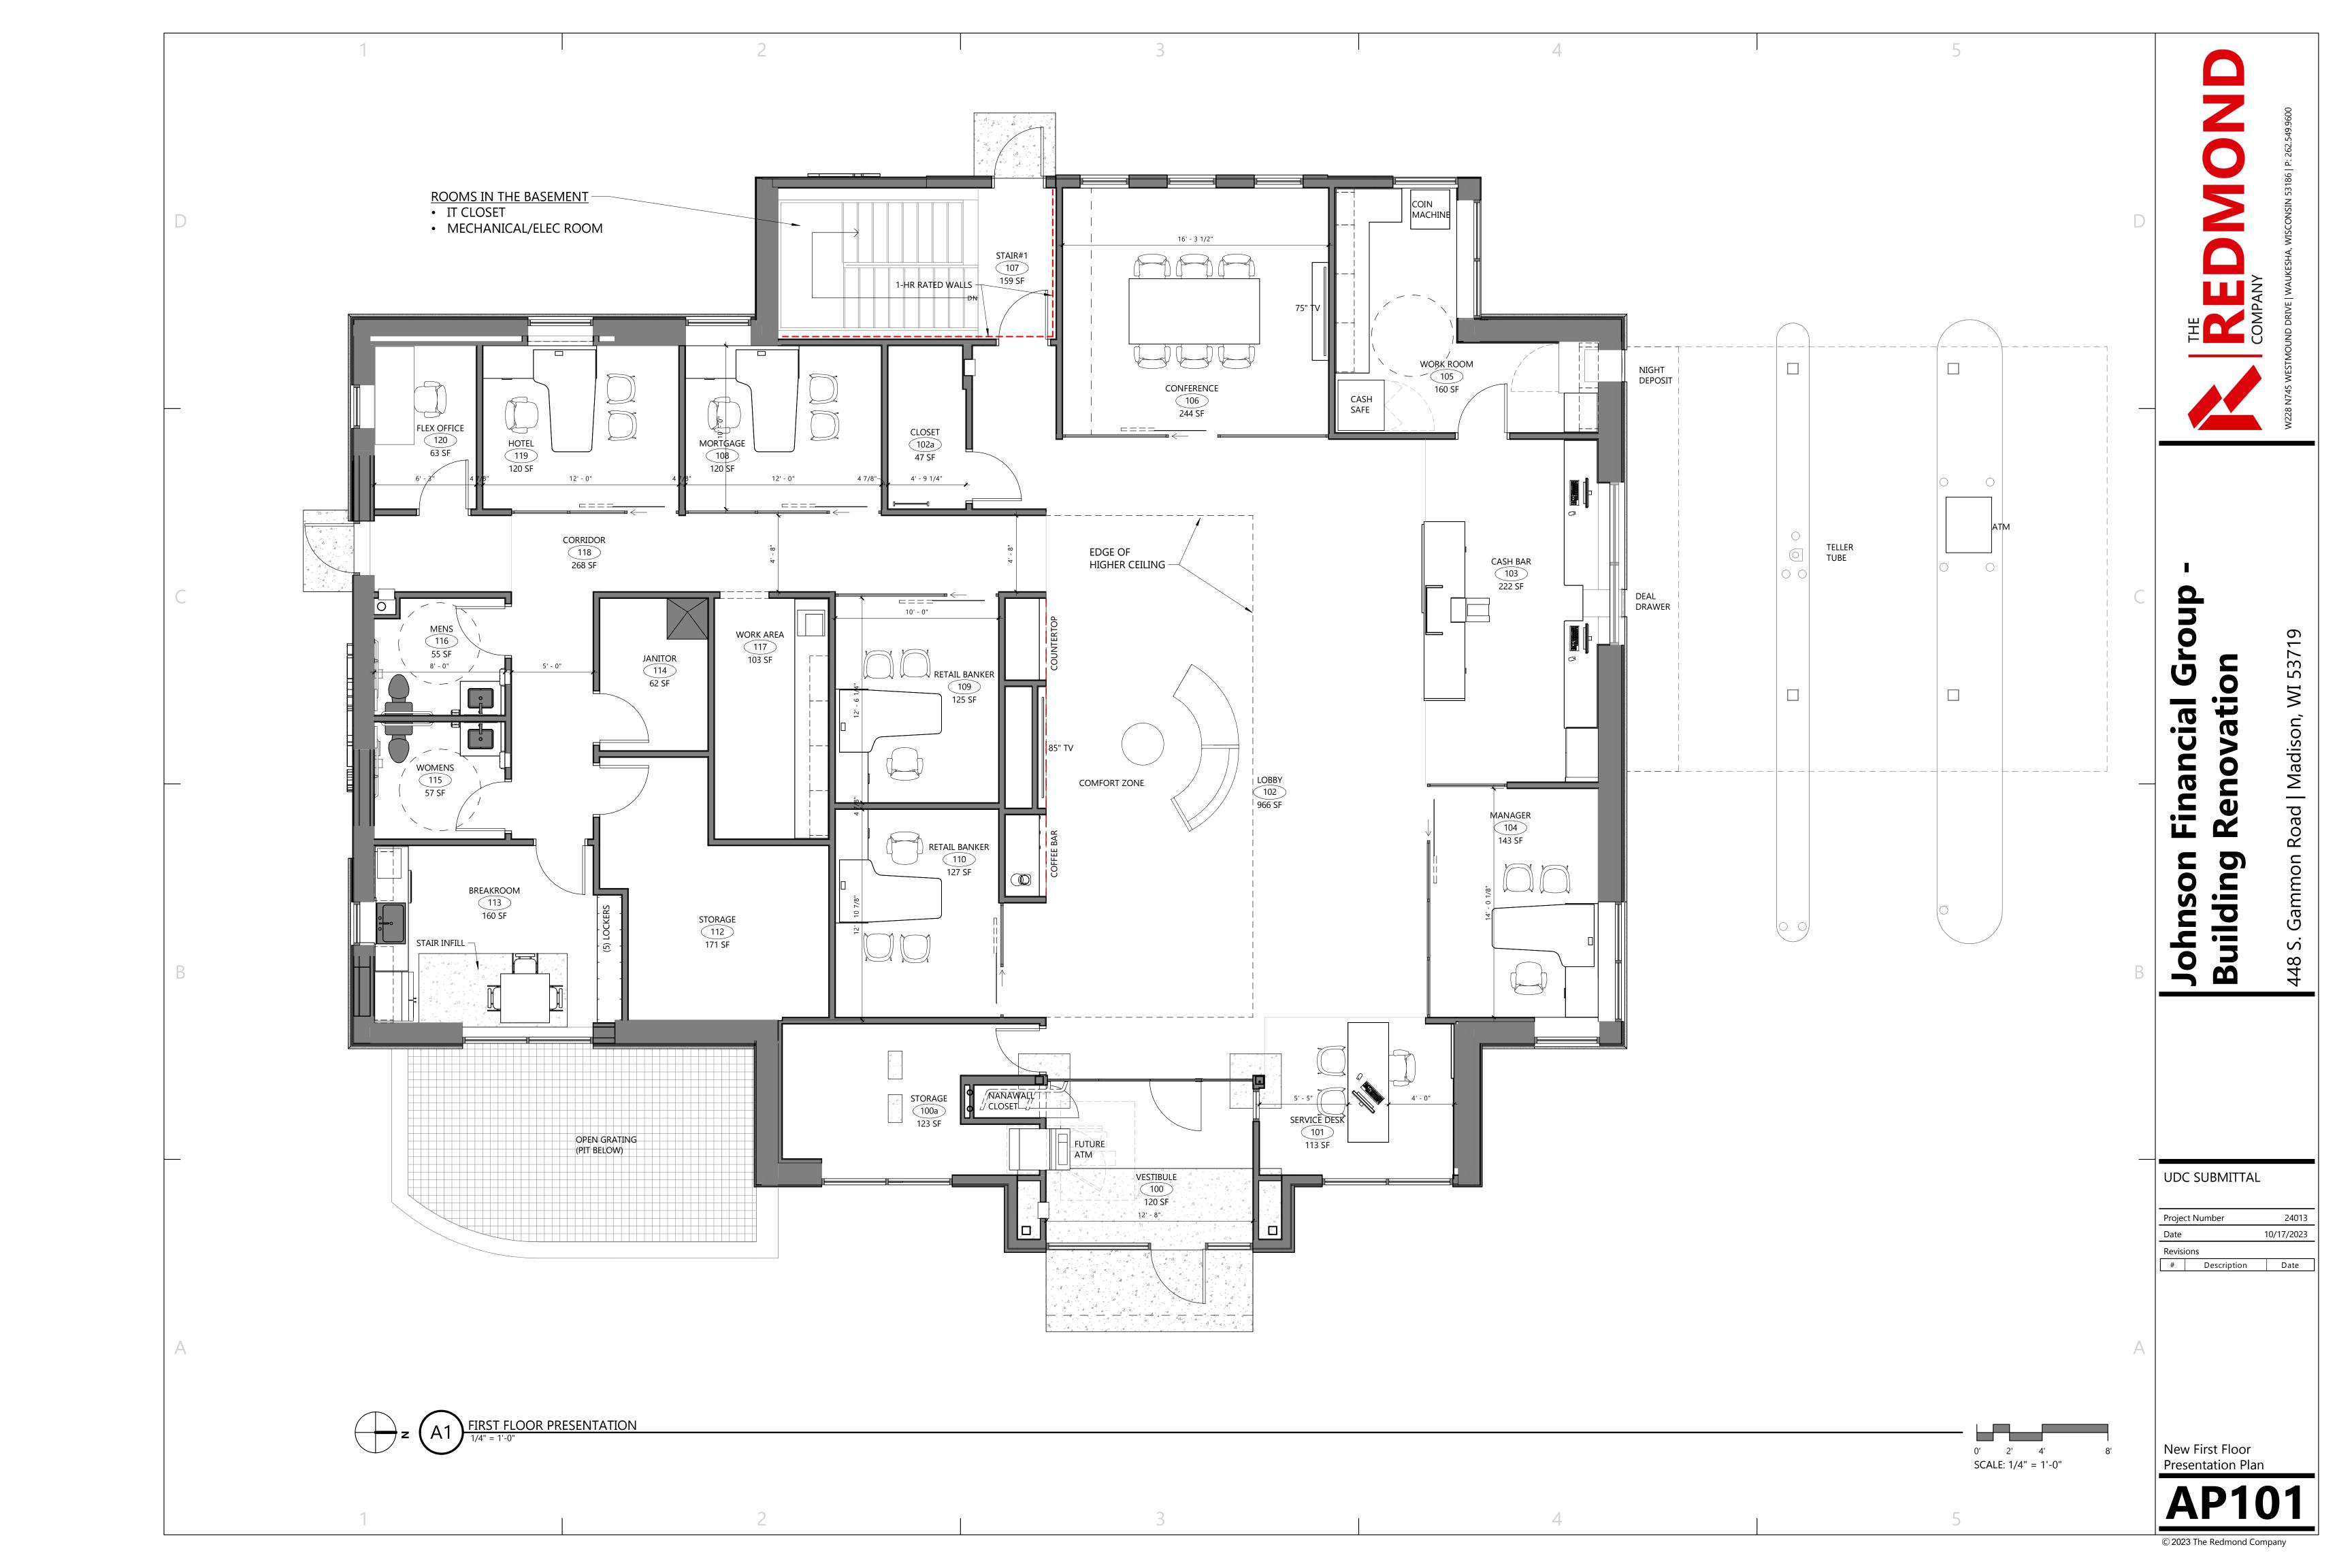



Building Johnson

UDC SUBMITTAL

Project Number 10/17/2023 # Description Date

NOTE: RENDERING IS SCHAMTIC IN NATURE. REFER TO LANDCAPING PLANS FOR LANDSCAPE DESIGN. REFER TO PRODUCT SAMPLES FOR EXTERIOR BUILDING MATERIALS.

Exterior Rendering

© 2023 The Redmond Company

VIEW FROM NORTHEAST



VIEW FROM NORTHEAST



VIEW FROM SOUTHWEST




UDC SUBMITTAL

10/17/2023 Revisions # Description Date

Exterior Renderings



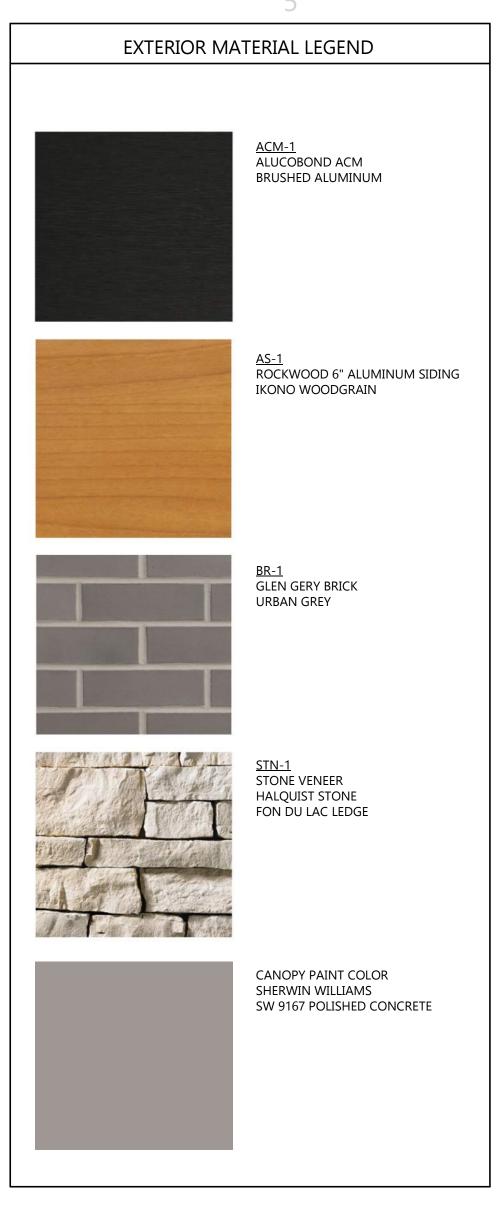

	KEYNOTES PER SHEET
472-01	CAST STONE BAND
771-02	PREFINISHED ALUMINUM FASCIA ANCHORED TO TREATED WOOD BLOCKING AND SET IN NON-CURING SEALANT PER MANUFACTURER'S INSTALLATION GUIDELINES. COLOR TO MATCH BREAK METAL BM-1.
991-04	PAINT EXISTING PRE-ENGINEERED CANOPY FASCIA & SOFFIT PAINT COLOR PT-7. PAINT COLUMNS PAINT COLOR PT-6.
014-01	BACK LIT SIGNAGE. PROVIDE PLYWOOD BACKING FOR SIGNAGE ATTACHMENT.
070-01	CANTILEVERED CANOPY - COLOR TO MATCH BREAK METAL BM-1.
082-01	MECHANICAL SCREENING ATTACHED TO EXISTING ROOF TOP
CM-1	ALUMINUM COMPOSITE METAL PANEL - COLOR #1
\S-1	ALUMINUM SIDING
32020-B	4.5" DEEP THERMALLY BROKEN CENTER SET COMMERCIAL STOREFRONT SYSTEM. BLACK MULLIONS.
3R-1	BRICK VENEER
STN-1	STONE VENEER

Johnson Financial
Building Renovation

Group

53719

Road | Madison,

UDC SUBMITTAL

Project	Number	24013
Date		10/17/2023
Revisions		
#	Description	Date

New Exterior Elevations -Colored

AP202





KEYNOTES PER SHEET				
472-01	CAST STONE BAND			
771-02	PREFINISHED ALUMINUM FASCIA ANCHORED TO TREATED WOOD BLOCKING AND SET IN NON-CURING SEALANT PER MANUFACTURER'S INSTALLATION GUIDELINES. COLOR TO MATCH BREAK METAL BM-1.			
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\S-1	ALUMINUM SIDING			
2020-В	4.5" DEEP THERMALLY BROKEN CENTER SET COMMERCIAL STOREFRONT SYSTEM. BLACK MULLIONS.			
R-1	BRICK VENEER			
TN-1	STONE VENEER			

Johnson Financial (Building Renovatio

d | Madison,

UDC SUBMITTAL

Project Number 24013

Date 10/17/2023

Revisions # Description Date

New Exterior Elevations -Black & White

AP203

 \aleph

HELLER &
ASSOCIATES, LL
LANDSCAPE ARCHITECTUR
LANDSCAPE ARCHITECTUR
P.O. Box 1359
Lake Geneva, Wisconsin 53147-1359
ph 262.639.9733
david@wdavidheller.com

JOHNSON FINANCIAL GROUP

448 S. Gammon Rd. Madison, WI

ISSUANCE AND REVISIONS

7.26.23 FIRST ISSUE
7.28.23 REV. SITE PLAN
9.20.23 REV. SITE PLAN
10.02.23 REV. SITE PLAN

Information contained herein is based on survey information, field inspection, and believed to be accurate.

SHEET TITLE

OVERALL LANDSCAPE PLAN

S. GAMMON ROAD




PROJECT MANAGER WDH
PROJECT NUMBER 23-041

DATE 10.02.23

SHEET NUMBER

L 1.0

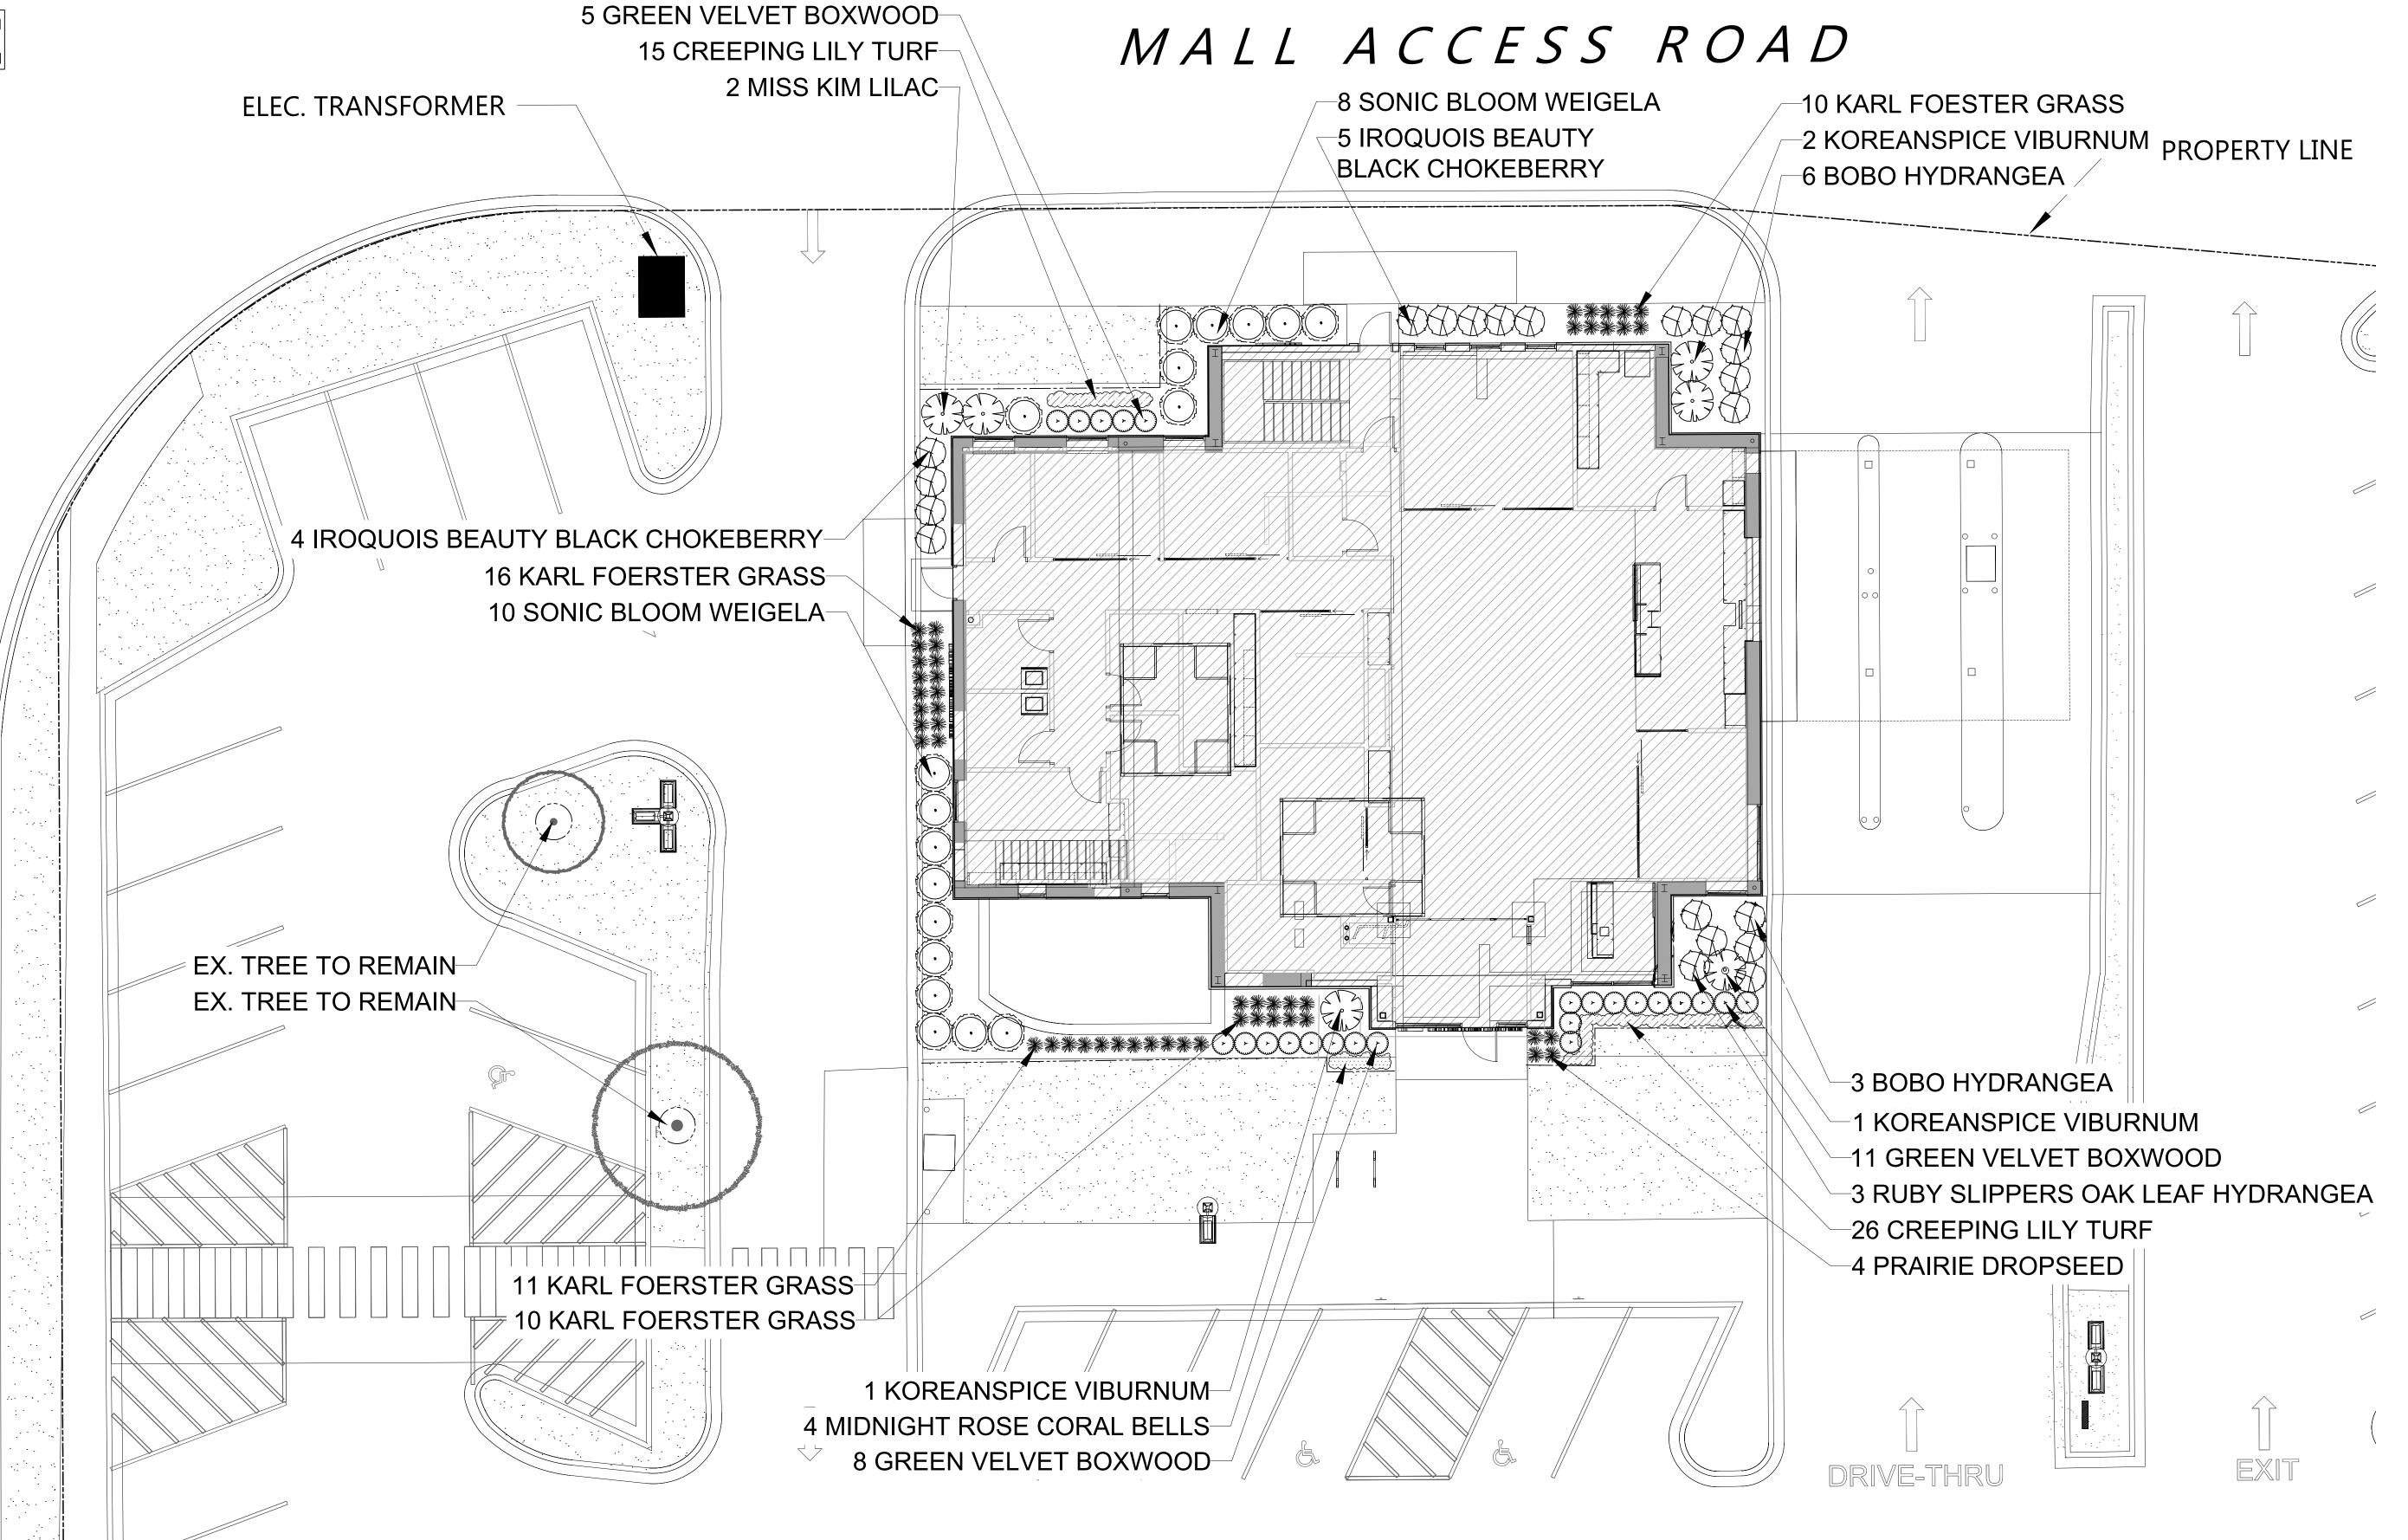

JOHNSON FINANCIAL GROUP

448 S. Gammon Rd. Madison, WI

ISSUANCE AND REVISIONS

DATE DESCRIPTION 7.26.23 FIRST ISSUE 7.28.23 REV. SITE PLAN 9.20.23 REV. SITE PLAN 10.02.23 REV. SITE PLAN

Information contained herein is based on survey information, field

SHEET TITLE ENLARGED LANDSCAPE PLAN

PROJECT MANAGER 23-041

PROJECT NUMBER

DATE SHEET NUMBER


10.02.23

ENLARGED LANDSCAPE PLAN NORTH Scale: 1" = 8'0"



- 1. Contractor responsible for contacting Diggers Hotline (811 or 800-242-8511) to have site marked prior to excavation or planting.
- 2. Contractor to verify all plant quantities shown on Plant & Material List and landscape planting symbols and report any discrepancies to Landscape Architect or General Contractor.
- 3. All plantings shall comply with standards as described in American Standard of Nursery Stock Z60.1 ANSI (latest version). Landscape Architect reserves the right to inspect, and potentially reject any plants that are inferior, compromised, undersized, diseased, improperly transported, installed incorrectly or damaged. No sub-standard "B Grade" or "Park Grade" plant material shall be accepted. Plant material shall originate from nursery(ies) with a similar climate as the planting site.
- 4. Any potential plant substitutions must be approved by Landscape Architect or Owner. All plants must be installed as per sizes indicated on Plant & Material Schedule, unless approved by Landscape Architect. Any changes to sizes shown on plan must be submitted in writing to the Landscape Architect prior to installation.
- 5. Topspoil in Parking Lot Islands (if applicable): All parking lot islands to be backfilled with topsoil to a minimum depth of 12" to insure long-term plant health. Topsoil should be placed within 3" of finish grade by General Contractor / Excavation Contractor during rough grading operations/activity. The landscape contractor shall be responsible for the fine grading of all disturbed areas, planting bed areas, and lawn areas. Crown all parking lot islands a minimum of 4" to provide proper drainage, unless otherwise specified.
- 6. Tree Planting: Plant all trees slightly higher than finished grade at the root flare. Remove excess soil from the top of the root ball, if needed. Remove and discard non-biodegradable ball wrapping and support wire. Removed biodegradable burlap and wire cage (if present) from the top $\frac{1}{3}$ of the rootball and carefully bend remaining wire down to the bottom of the hole. Once the tree has been placed into the hole and will no longer be moved, score the remaining $\frac{2}{3}$ of the burlap and remove the twine. Provide three slow release fertilizer for each tree planted.
- 7. Tree Planting: Backfill tree planting holes 80% existing soils removed from excavation and 20% plant starter mix. Avoid air pockets and do not tamp soil down. Discard any gravel, rocks, heavy clay, or concrete pieces. When hole is $\frac{2}{3}$ full, trees shall be watered thoroughly, and water left to soak in before proceeding to fill the remainder of the hole. Water again to full soak in the new planting. Each tree shall receive a 3" deep, 4-5' diameter (see planting details or planting plan) shredded hardwood bark mulch ring around all trees planted in lawn areas. Do not build up any mulch onto the trunk of any tree. Trees that are installed incorrectly will be replaced at the time and expense of the Landscape Contractor.
- 8. Shrub Planting: All shrubs to be planted in groupings as indicated on the Landscape Plan. Install with the planting of shrubs a 50 50 mix of plant starter with topsoil. Install topsoil into all plant beds as needed to achieve proper grade and displace undesirable soil (see planting detail). Remove all excessive gravel, clay and stones from plant beds prior to planting. When hole(s) are $\frac{2}{3}$ full, shrubs shall be watered thoroughly, and water left to soak in before proceeding. Provide slow-release fertilizer packets at the rater of 1 per 24" height/diameter of shrub at planting.
- 9. Mulching: All tree and shrub planting beds to receive a 3" deep layer of high quality shredded hardwood bark mulch (not pigment dyed or enviro-mulch). All perennial planting areas (groupings) shall receive a 2" layer of double-shredded hardwood bark mulch, and groundcover areas a 2" layer of the same mulch. Do not mulch annual flower beds (if applicable). Do not allow mulch to contact plant stems and tree trunks.
- 10. Edging: All planting beds shall be edged with a 4" deep spade edge using a flat landscape spade or a mechanical edger. Bedlines are to be cut crisp, smooth as per plan. A clean definition between landscape beds and lawn is required. Pack mulch against lawn edge to hold in place.
- 11. Plant bed preparation/Soil Amendment composition: All perennial, groundcover and annual areas (if applicable) are required to receive a blend of organic soil (Soil Amendments) amendments prior to installation. Roto-till the following materials at the following ratio, into existing soil beds or installed topsoil beds to a depth of approximately 8"-10". Containerized and balled & burlapped plant material should be back-filled with amended soil:
 - Per 100 SF of bed area (Soil Amendment composition):
 - 3/4 CY Peat Moss or Mushroom Compost
 - 3/4 CY blended/pulverized Topsoil1/4 CY composted manure
 - In roto-tilled beds only, also include in above mixture:
 - 2 lbs Starter Fertilizer
- 12. Lawn Installation for all sodded turfgrass areas: Contractor to furnish and prepare blended topsoil (2" minimum) and sod bed, removing all debris and stones ½" and larger. Apply a 10-10-10 starter lawn fertilizer uniformly throughout areas prior to laying sod. Use only premium sod blend according to TPI (revised 1995) and ASPA Standards. Install sod uniformly with staggered joints, laid tightly end to end and side to side. Roll sod with a walk behind roller and water immediately upon installation to a 3" depth. Stake any sod installed on slopes steeper than 1:3, and in all swale applications. Contractor is responsible to provide a smooth, uniform, healthy turf, and is responsible for the first two mowings of the newly installed turf, and is also responsible for watering during this period.
- 13. Warranty and Replacements: All plantings are to be watered thoroughly at the time of planting, through construction and upon completion of project as required. Trees, Evergreens, and Shrubs (deciduous and evergreen) shall be guaranteed (100% replacement) for a minimum of one (1) year from the date of project completion. Perennials, groundcovers, and ornamental grasses shall be guaranteed for a minimum of one (1) growing season. Perennials, groundcovers, and ornamental grasses planted after September 15th shall be guaranteed through May 31st of the following year. Only one replacement per plant will be required during the warranty period, except for losses or replacements due to failure to comply with specified requirements. Watering and general ongoing maintenance instructions are to be supplied by the Landscape Contractor to the Owner upon completion of the project.
- 14. The Landscape Contractor is responsible for the watering and maintenance of all landscape areas for a period of 45 days after the substantial completion of the landscape installation. This shall include all trees, shrubs, evergreens, perennials, ornamental grasses, turf grass, no-mow grass, and native prairie seed mix, stormwater seed mix, and other native seed mixes. Work also includes weeding, edging, mulching (only if required), fertilizing, trimming, sweeping up grass clippings, pruning and deadheading.
- 15. Project Completion: Landscape Contractor is responsible to conduct a final review of the project, upon completion, with the Landscape Architect, Client or Owner / Client Representative, and the General Contractor to answer questions, provide written care instructions for new plantings and turf, and insure that all specifications have been met


LANDSCAPE GENERAL NOTES

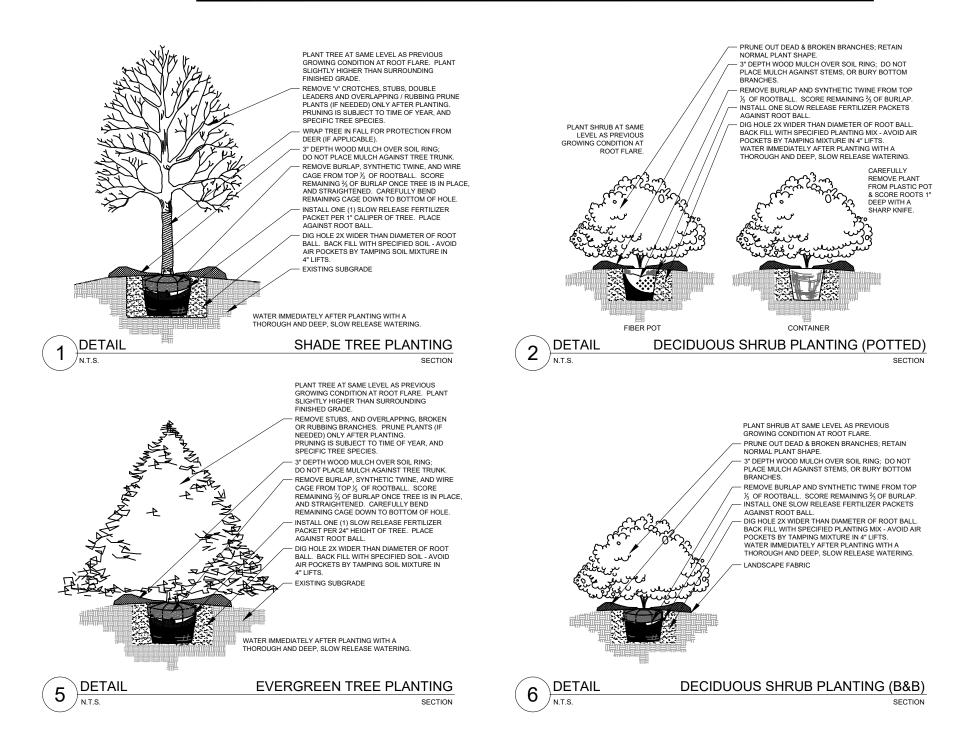

PLANT		PLANT MATERIAL PROPOSED		_			PLAN
KEY	QUANTITY	BOTANICAL NAME	COMMON NAME	UNIT		SPECIFICATION / NOTES	SPACI
roposed	Landscape Cor	nstruction Preparation					
	10	Removal of existing foundation plantings		Hour			
PLANT		PLANT MATERIAL PROPOSED		CALIPER/HEIGHT			PLAI
KEY	QUANTITY	BOTANICAL NAME	COMMON NAME	SIZE	ROOT	SPECIFICATION / NOTES	SPACI
	ITAL TREES (DE	-					
RBFC	0	Malus x 'Red Barron'	Red Barron Flowering Crabapple	2.0"	B&B	Straight central leader, full and even crown. Prune only after planting	
	1	1					
PLANT		PLANT MATERIAL PROPOSED		HEIGHT			PLA
KEY	QUANTITY	BOTANICAL NAME	COMMON NAME	SIZE	ROOT	SPECIFICATION / NOTES	SPACI
VERGREE	N TREES						
EGA	6	Thuja occidentalis 'Smargd'	Emerald Green Arborvitae	6'	B&B	Evenly shaped tree with branching to the ground	12
	1			T			
PLANT		PLANT MATERIAL PROPOSED		SHRUB	ROOT/		PLAI
KEY	QUANTITY	BOTANICAL NAME	COMMON NAME	SIZE (HEIGHT)	CONT.	SPECIFICATION / NOTES	SPACI
	N SHURBS			- -			- all
GMB	5	Buxus 'Green Mountain'	Green Mountain Boxwood	30"	B&B	Full rounded well branched shrub	24"
GVB	19	Buxus 'Green Velvet'	Green Velvet Boxwood	24"	Cont.	Full rounded well branched shrub	24-3
DIANT		DIANT MATERIAL PROPOSED		CURUR	DOOT!		DI AI
PLANT		PLANT MATERIAL PROPOSED	001414011114145	SHRUB	ROOT/	CDECISION ANOTES	PLA
KEY	QUANTITY	BOTANICAL NAME	COMMON NAME	SIZE (HEIGHT)	CONT.	SPECIFICATION / NOTES	SPACI
	IS SHRUBS				.		400
IBBC	9	Aronia melanocarpa 'Iroquois Beauty'	Iroquois Beauty Black Chokeberry	#5	Cont.	Full, well rooted plant, evenly shaped	42'
RSOLH	3	Hydrangea quercifolia 'Ruby Slippers'	Ruby Slippers Oak Leaf Hydrangea	24"	Cont.	Full, well rooted plant, evenly shaped	42'
BBH	9	Hydrangea paniculata 'ILVOBO'	Bobo Hydrangea	24"	Cont.	Full, well rooted plant, evenly shaped	42'
MKL	2	Syringa patula 'Miss Kim'	Miss Kim Dwarf Lilac	30"	Cont.	Full, well rooted plant, evenly shaped	60'
KSV	4	Viburnum carlesii	Fragrant Koreanspice Viburnum	36"	Cont.	Full, well rooted plant, evenly shaped	60
SBW	18	Weigela florida 'Bokrasopin'	Sonic Bloom Wiegela	24"	Cont.	Full, well rooted plant, evenly shaped	42'
PLANT	0.1441777	PLANT MATERIAL PROPOSED	2014101111111	CONTAINER		CDECIFICATION (NOTES	PLAN
KEY	QUANTITY	BOTANICAL NAME	COMMON NAME	SIZE		SPECIFICATION / NOTES	SPACI
	ITAL GRASSES		Wall Farmatan Farathan Band Corre	44	C	Full well rested about	15.1
KFRG	72	Calamagrostis acutiflora 'Karl Foerster'	Karl Foerster Feather Reed Grass	#1	Cont.	Full, well rooted plant	15-1
PDS	4	Sporobolus heterolepis	Prairie Dropseed	#1	Cont.	Full, well rooted plant	18"
PLANT		PLANT MATERIAL PROPOSED		CONTAINER			PLAN
KEY	QUANTITY	BOTANICAL NAME	COMMON NAME	SIZE		SPECIFICATION / NOTES	SPACI
	US PERENNIA		COMMON NAME	JIZE		SPECIFICATION / NOTES	Jr ACI
HRD	5	Hemerocallis 'Happy Returns'	Hanny Poturne Daylilly	#1	Cont.	Full, well rooted plant, evenly shaped	18"
	4		Happy Returns Daylilly	#1 #1			18"
MRCB	4	Heuchera 'Midnight Rose'	Midnight Rose Coralbells	#1	Cont.	Full, well rooted plant, evenly shaped	10
PLANT		PLANT MATERIAL PROPOSED		CONTAINER			PLAN
KEY	QUANTITY	BOTANICAL NAME	COMMON NAME	SIZE		SPECIFICATION / NOTES	SPACI
	OVERS & VINE		COMMUNICIA MANAIE	JILE		SECULICATION / NOTES	JACI
CLT	41	Liripoe spicata	Creeping Lilly Turf	Qt.	Pot	Full, well rooted plant	12'
CLI	41	Empoe spicata	Creeping Liny run	Qι.	101	i an, wen rooted plant	12
PLAN		PLANT MATERIAL PROPOSED		CONTAINER			PLAN
KEY	QUANTITY	SPECIFIED SEED MIX / SOD		SIZE		SPECIFICATION / NOTES	SPACI
LAWN	115	Lawn Establishment Area / Grading Area		JILL	SY	SI ECHICATION / NOTES	Jr ACI
F\\ \A\1.4	113	Lawn Establishment Alea / Glading Alea			31		
SOD	115	Sodded Areas (identified on plan)	see plan for area delineation		SY	Fresh cut, weed free; Bluegrass Blend Sod; Water immediately after installation	
300	110		Joe p. and demication		51	say, meed meet all standard brains down whater miniediately after historiation	
lardscape	Materials						
-	66	CMU Retaining Wall	Length: 33 LF Avg Height: 24"		FSF	Belgard Diamond Pro Smooth Face series; Color = Moonlight	
		-				· • • • • • • • • • • • • • • • • • • •	
	20	Shredded Hardwood Mulch (3" depth)	Area: 2,200 SF		CY	Bark Mulch; apply Preemergent after installation of mulch	
	13.5	Soil Amendments (2" depth)	Area: 2,200 SF		CY	, , , , , , , , , , , , , , , , , , ,	
	,_	(E depui)			٠.		
		Pulverized Tonsoil (Lawn Area)	Δrea: 1 025 SF		۲V		
	3.5 13.5	Pulverized Topsoil (Lawn Area) Pulverized Topsoil (2" over bed areas)	Area: 1,025 SF Area: 2,200 SF		CY CY		

installation as outlined on this Landscape Master Plan. In the event that a discrepancy occurs between this schedule and the Landscape Master Plan, the Landscape Master Plan- including the graphics and notations depicted therein- shall govern.

PLANT & MATERIAL SCHEDULE

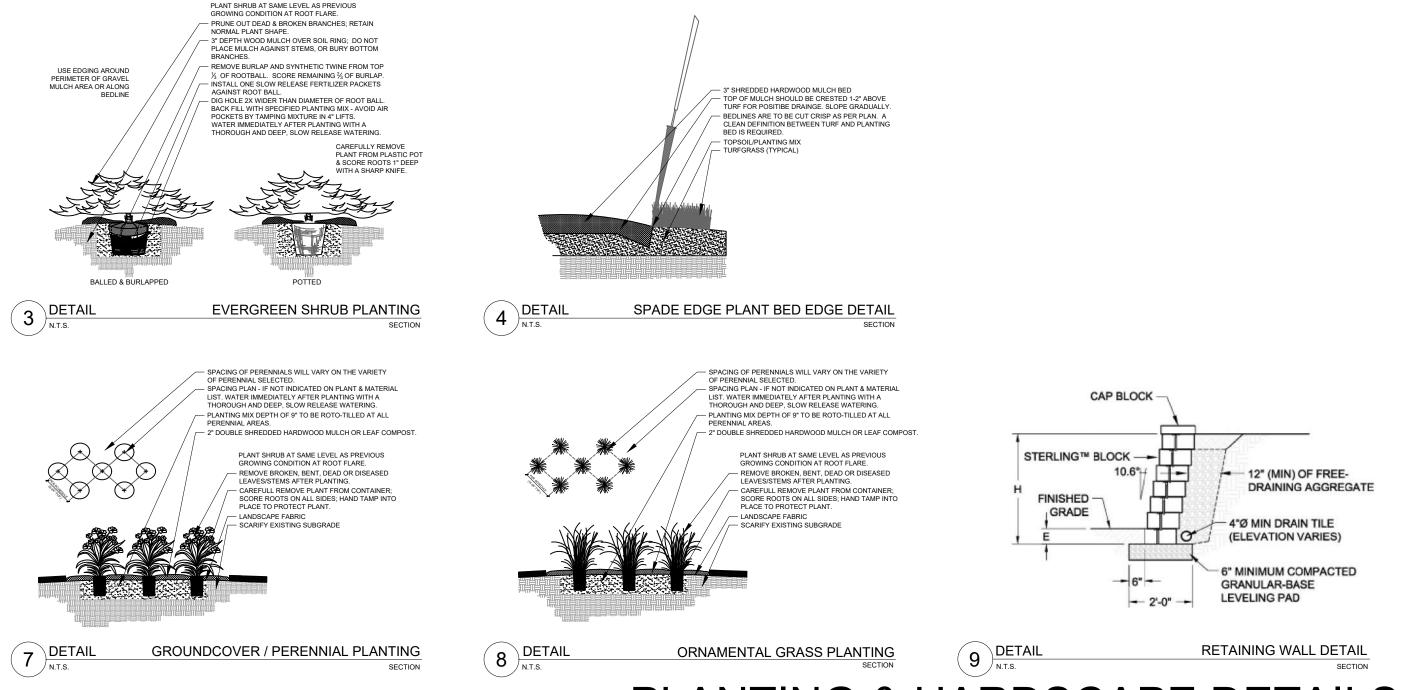

PLANTING & HARDSCAPE DETAILS

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ROJECT

JOHNSON FINANCIAL GROUP

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ISSUANCE AND REVISIONS

7.26.23 FIRST ISSUE
7.28.23 REV. SITE PLAN
9.20.23 REV. SITE PLAN
10.02.23 REV. SITE PLAN

Information contained herein is based on survey information, field inspection, and believed to be accurate.

LANDSCAPE
DETAILS,
NOTES &
SCHEDULES

PROJECT MANAGER WDH
PROJECT NUMBER 23-041

DATE 10.02.23

SHEET NUMBER

L 1.2