

SITE PLAN

GENERAL NOTES:

CONTRACTOR.

REQUIRED.

THE CITY.

760I University Ave, Ste 201 608.836.3690 Middleton, WI 53562

ISSUED

Issued for UDC Informational - Jan. 24, 2022 Land Use & UDC Submittal - February 07, 2022 Updated Land Use & UDC Submittal - May 10, 2022 Updated Land Use & UDC Submittal - Oct. 26, 2022 Updated Land Use & UDC Submittal - Feb. 13, 2023 Updated Land Use & UDC Submittal - May 15, 2023

PROJECT TITLE 430, 432, 444 State Street

Madison, Wisconsin

SHEET TITLE Site Plan


SHEET NUMBER

PROJECT NO.

GRAPHIC SCALE

I INCH = I0 FT (24X36 SHEET)

1939

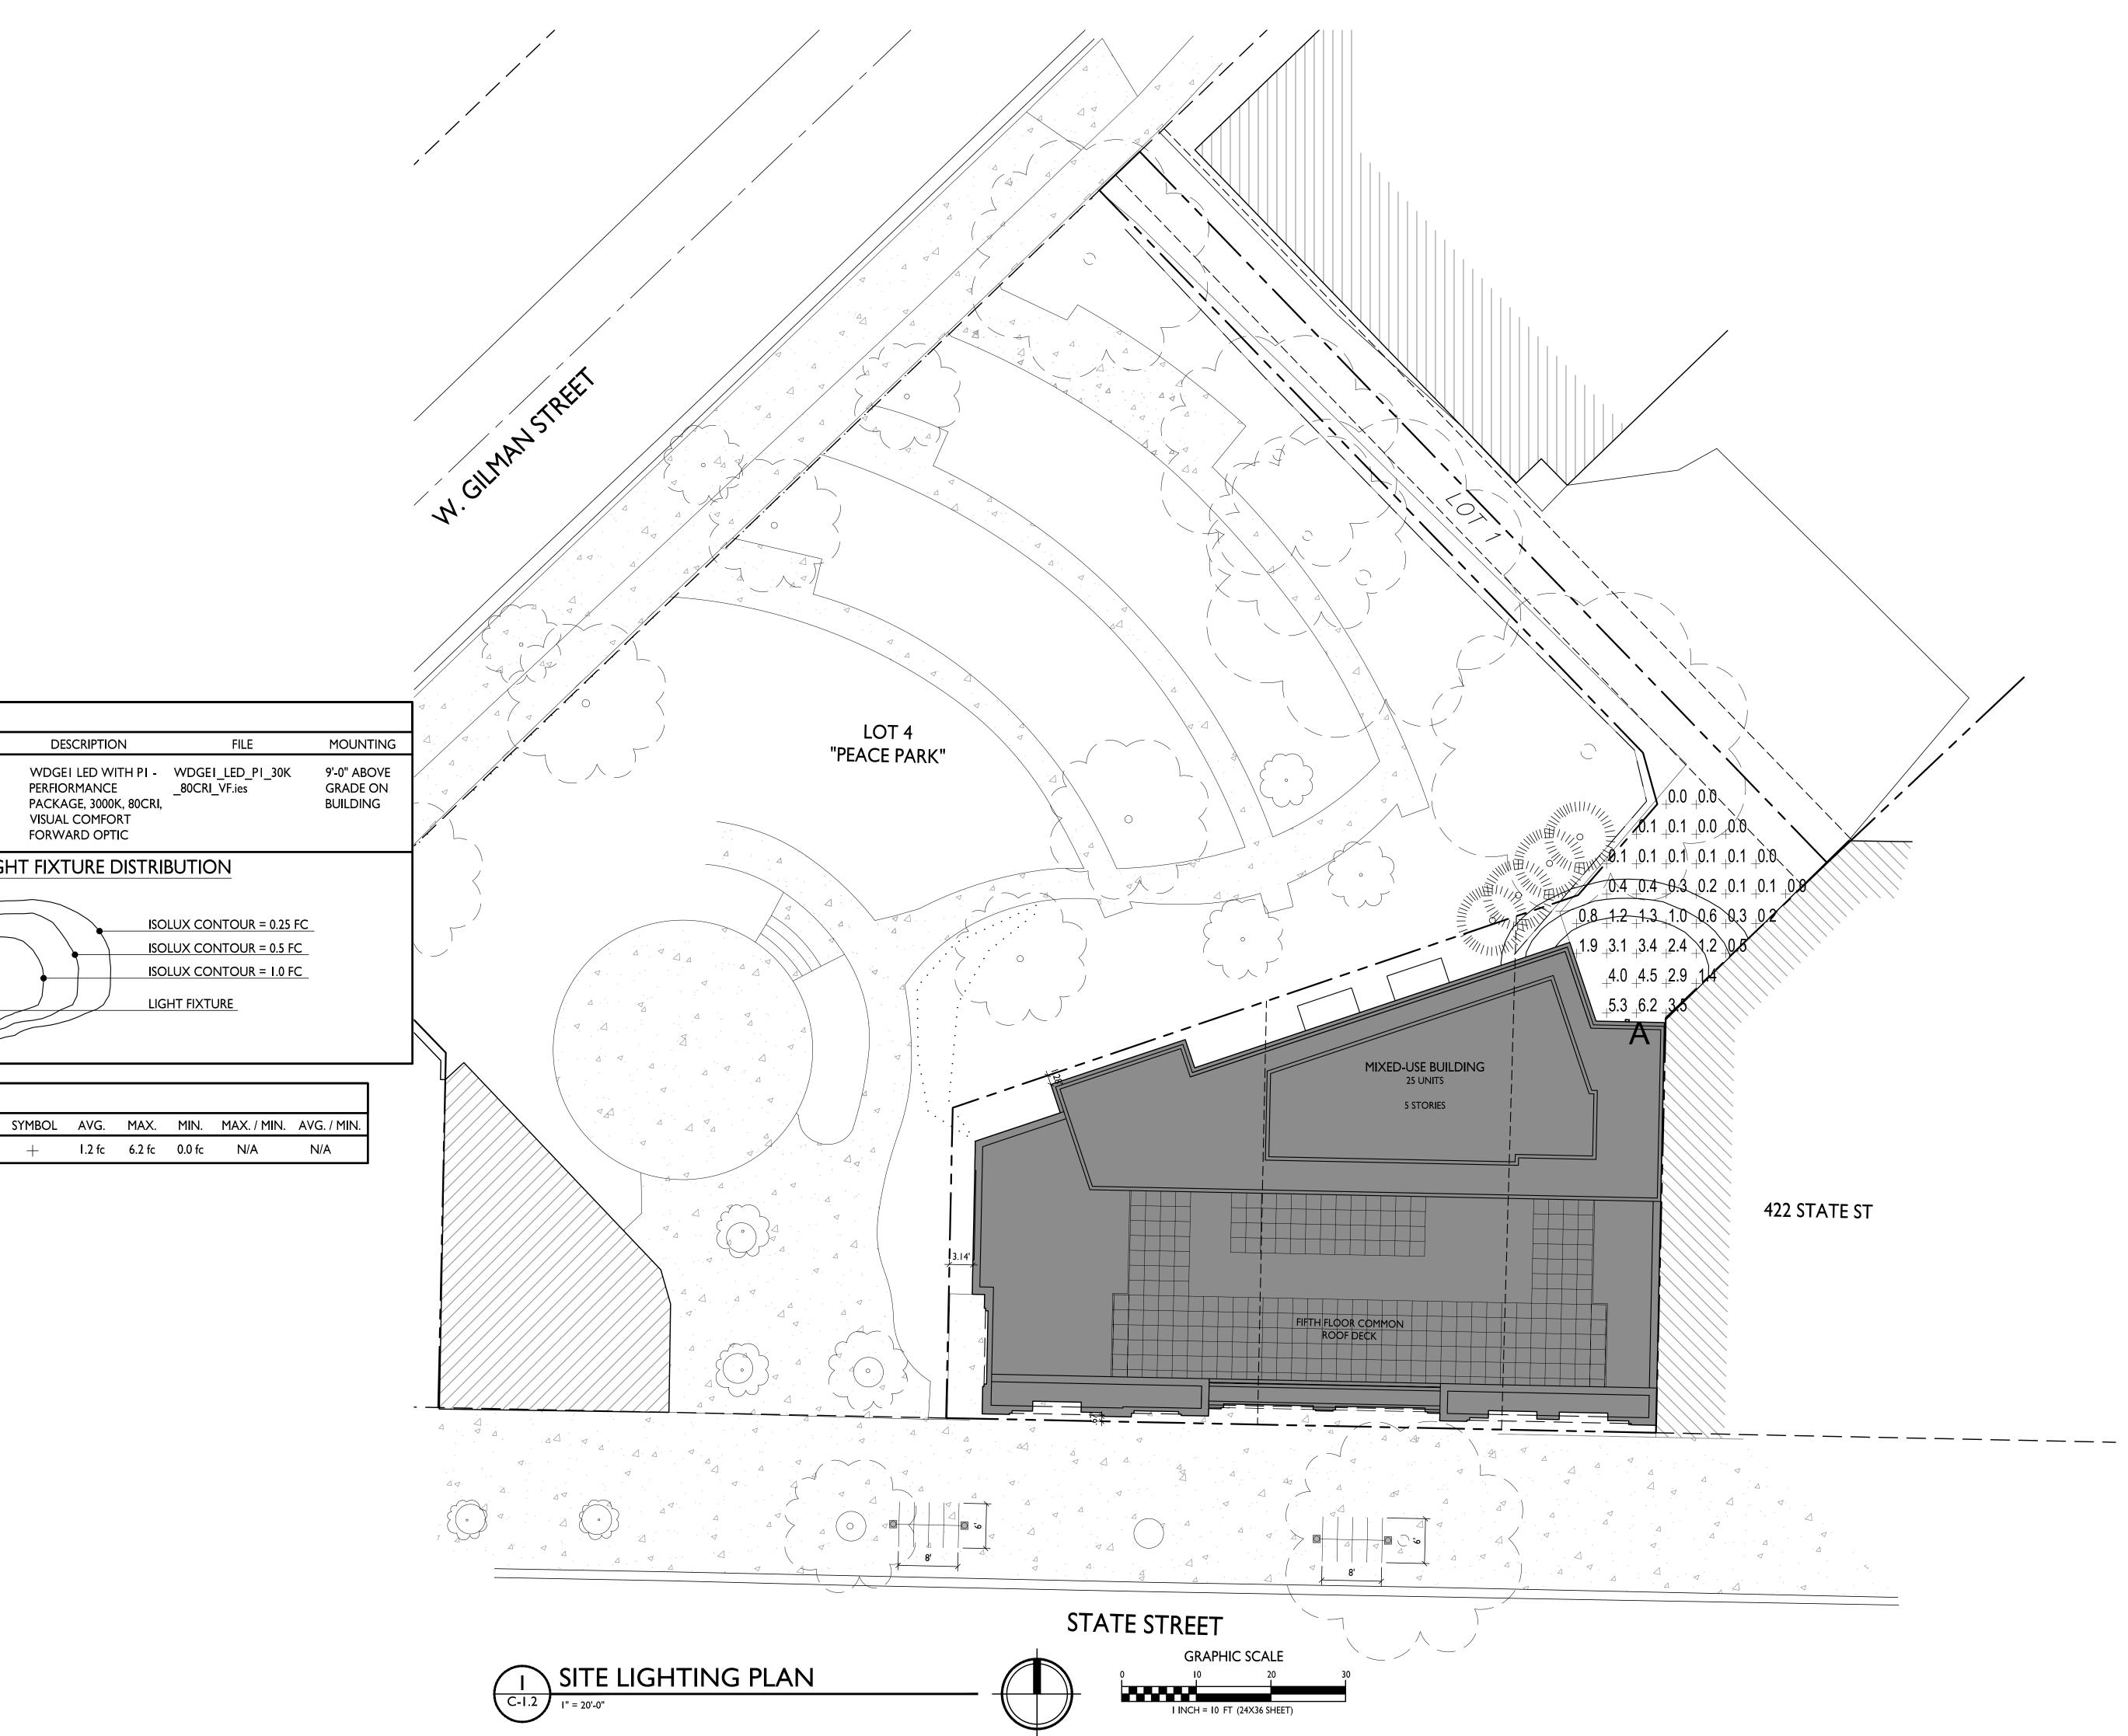

LUMINAIRE SCHEDULE

LIGHT LEVEL STATISTICS

DESCRIPTION

Rear Building Lighting

A I LITHONIA WDGEI LED PI LIGHTING 30K 80CRI VF

SYMBOL LABEL QTY. MANUF.

DESCRIPTION

EXAMPLE LIGHT FIXTURE DISTRIBUTION

WDGEI LED WITH PI - WDGEI_LED_PI_30K
PERFIORMANCE __80CRI_VF.ies
PACKAGE, 3000K, 80CRI,
VISUAL COMFORT
FORWARD OPTIC

FILE

ISOLUX CONTOUR = 0.25 FC

ISOLUX CONTOUR = 0.5 FC

ISOLUX CONTOUR = 1.0 FC

LIGHT FIXTURE

I.2 fc 6.2 fc 0.0 fc N/A

CATALOG



Issued for UDC Informational - Jan. 24, 2022
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SHEET TITLE


Site Lighting Plan

SHEET NUMBER

C-1.2


PROJECT NO.

1939

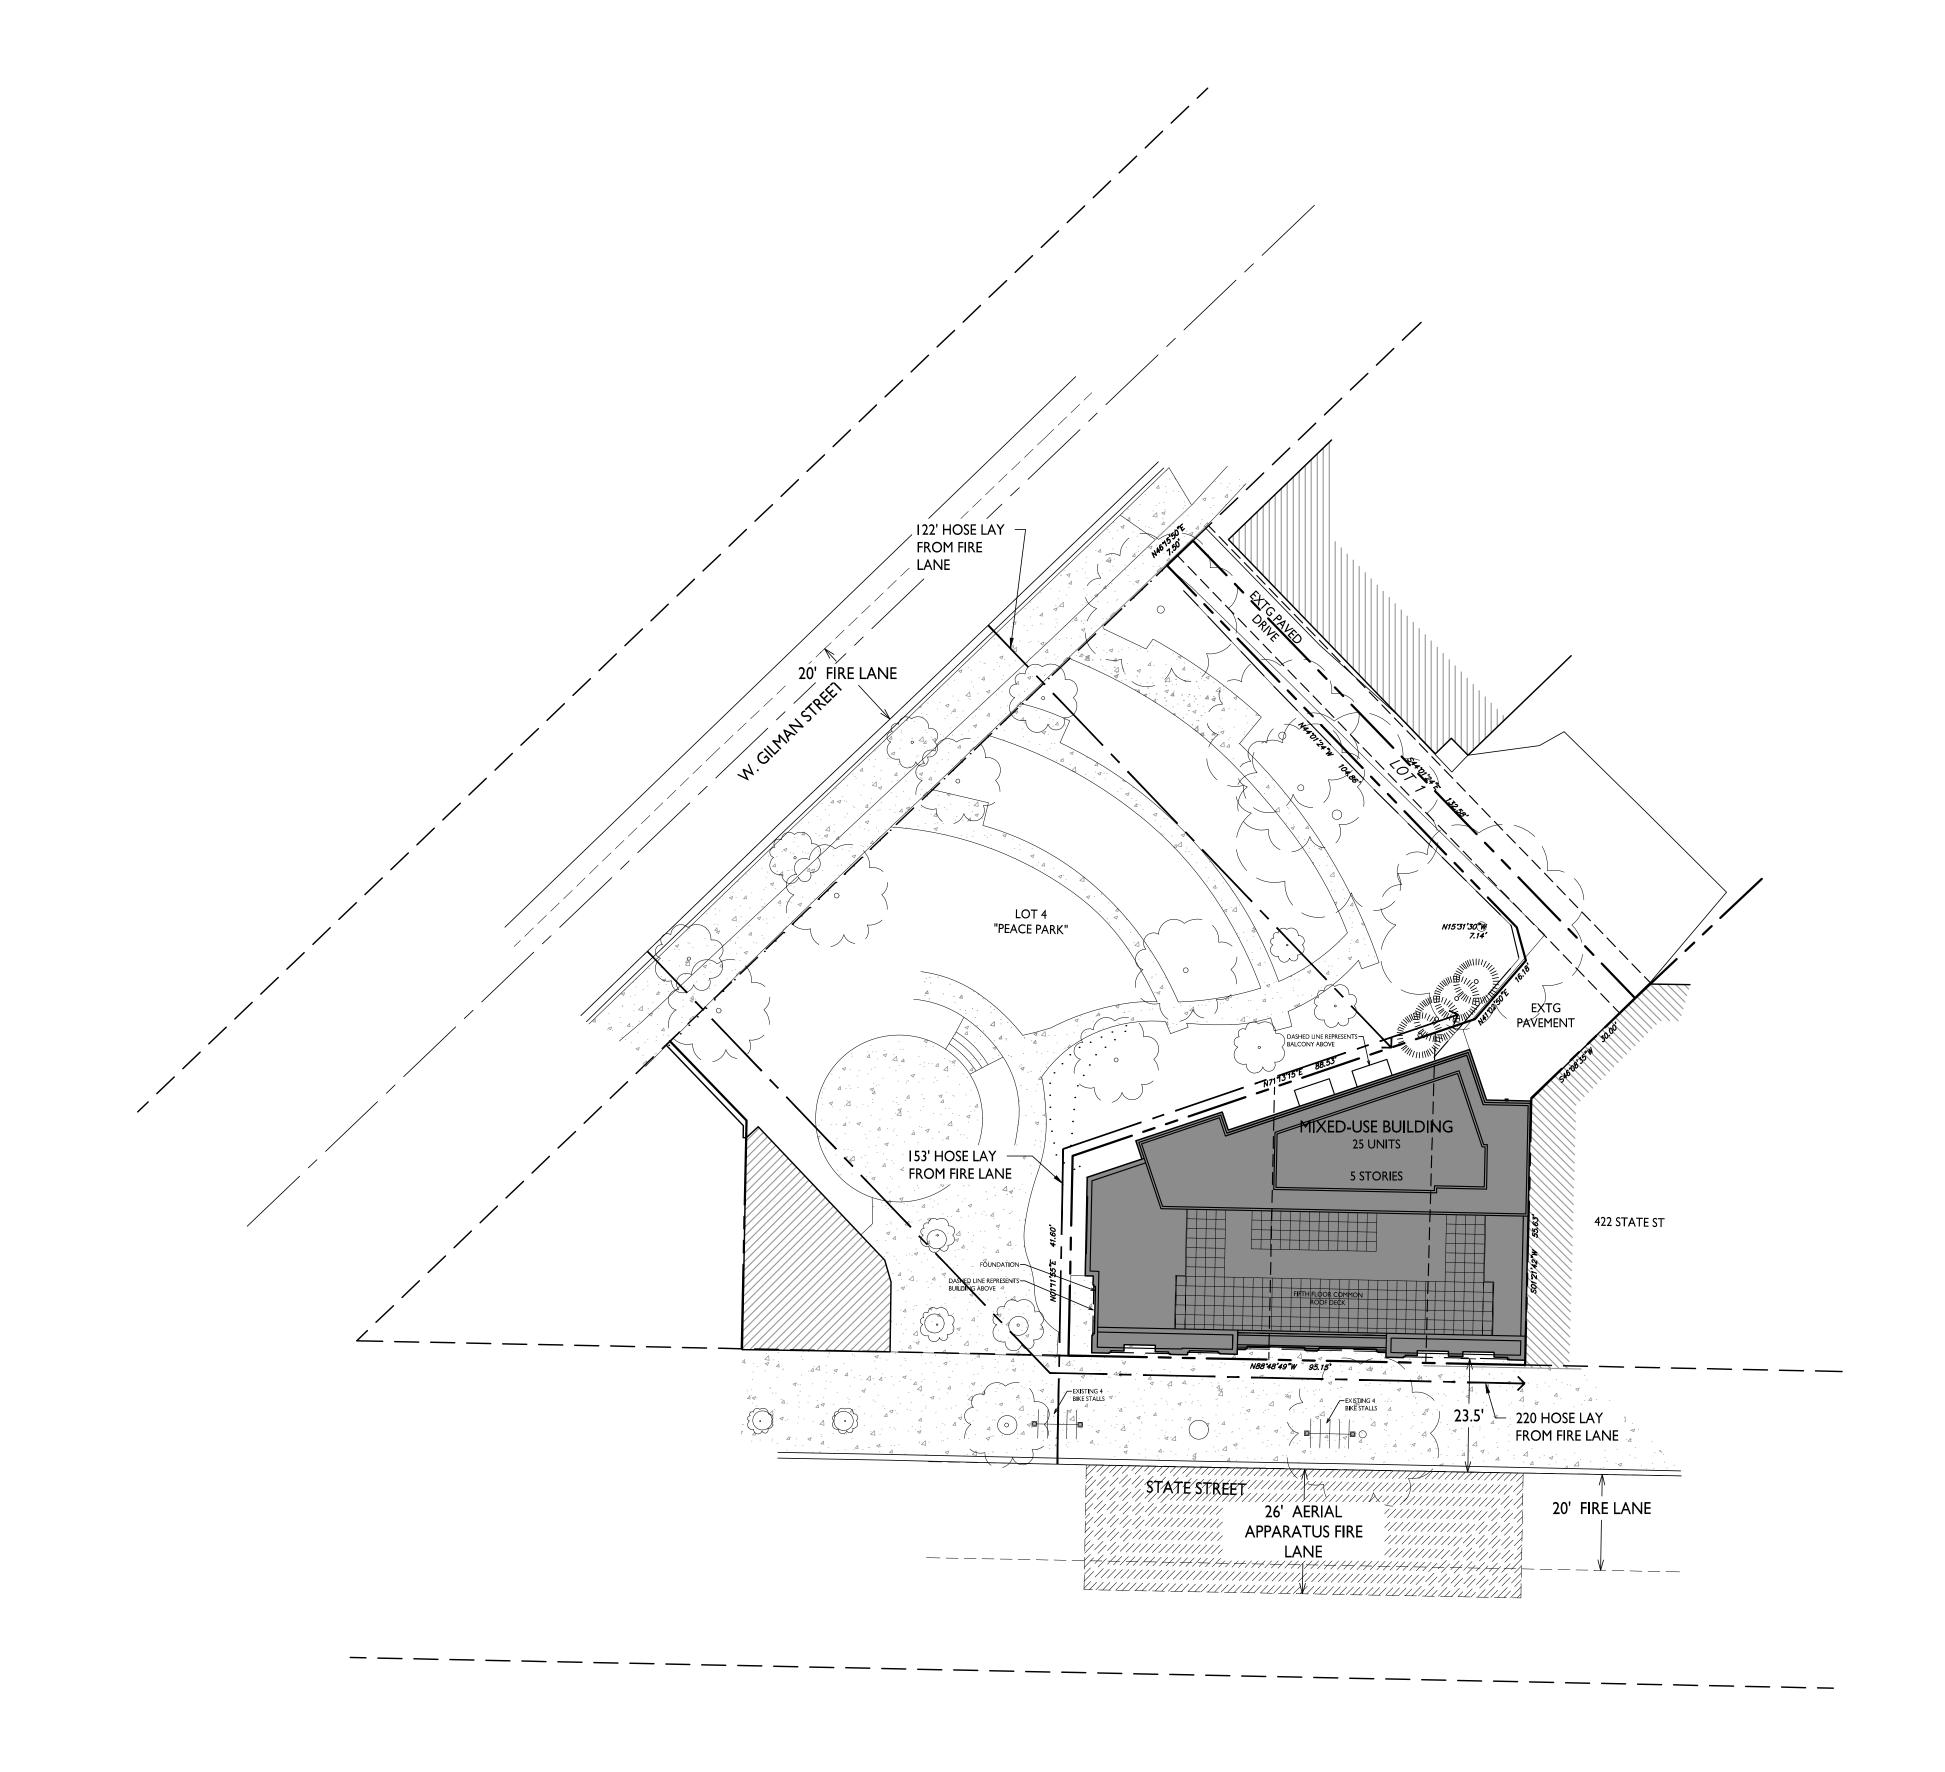





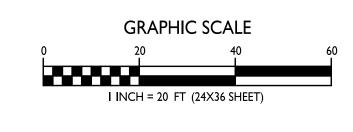



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State Street

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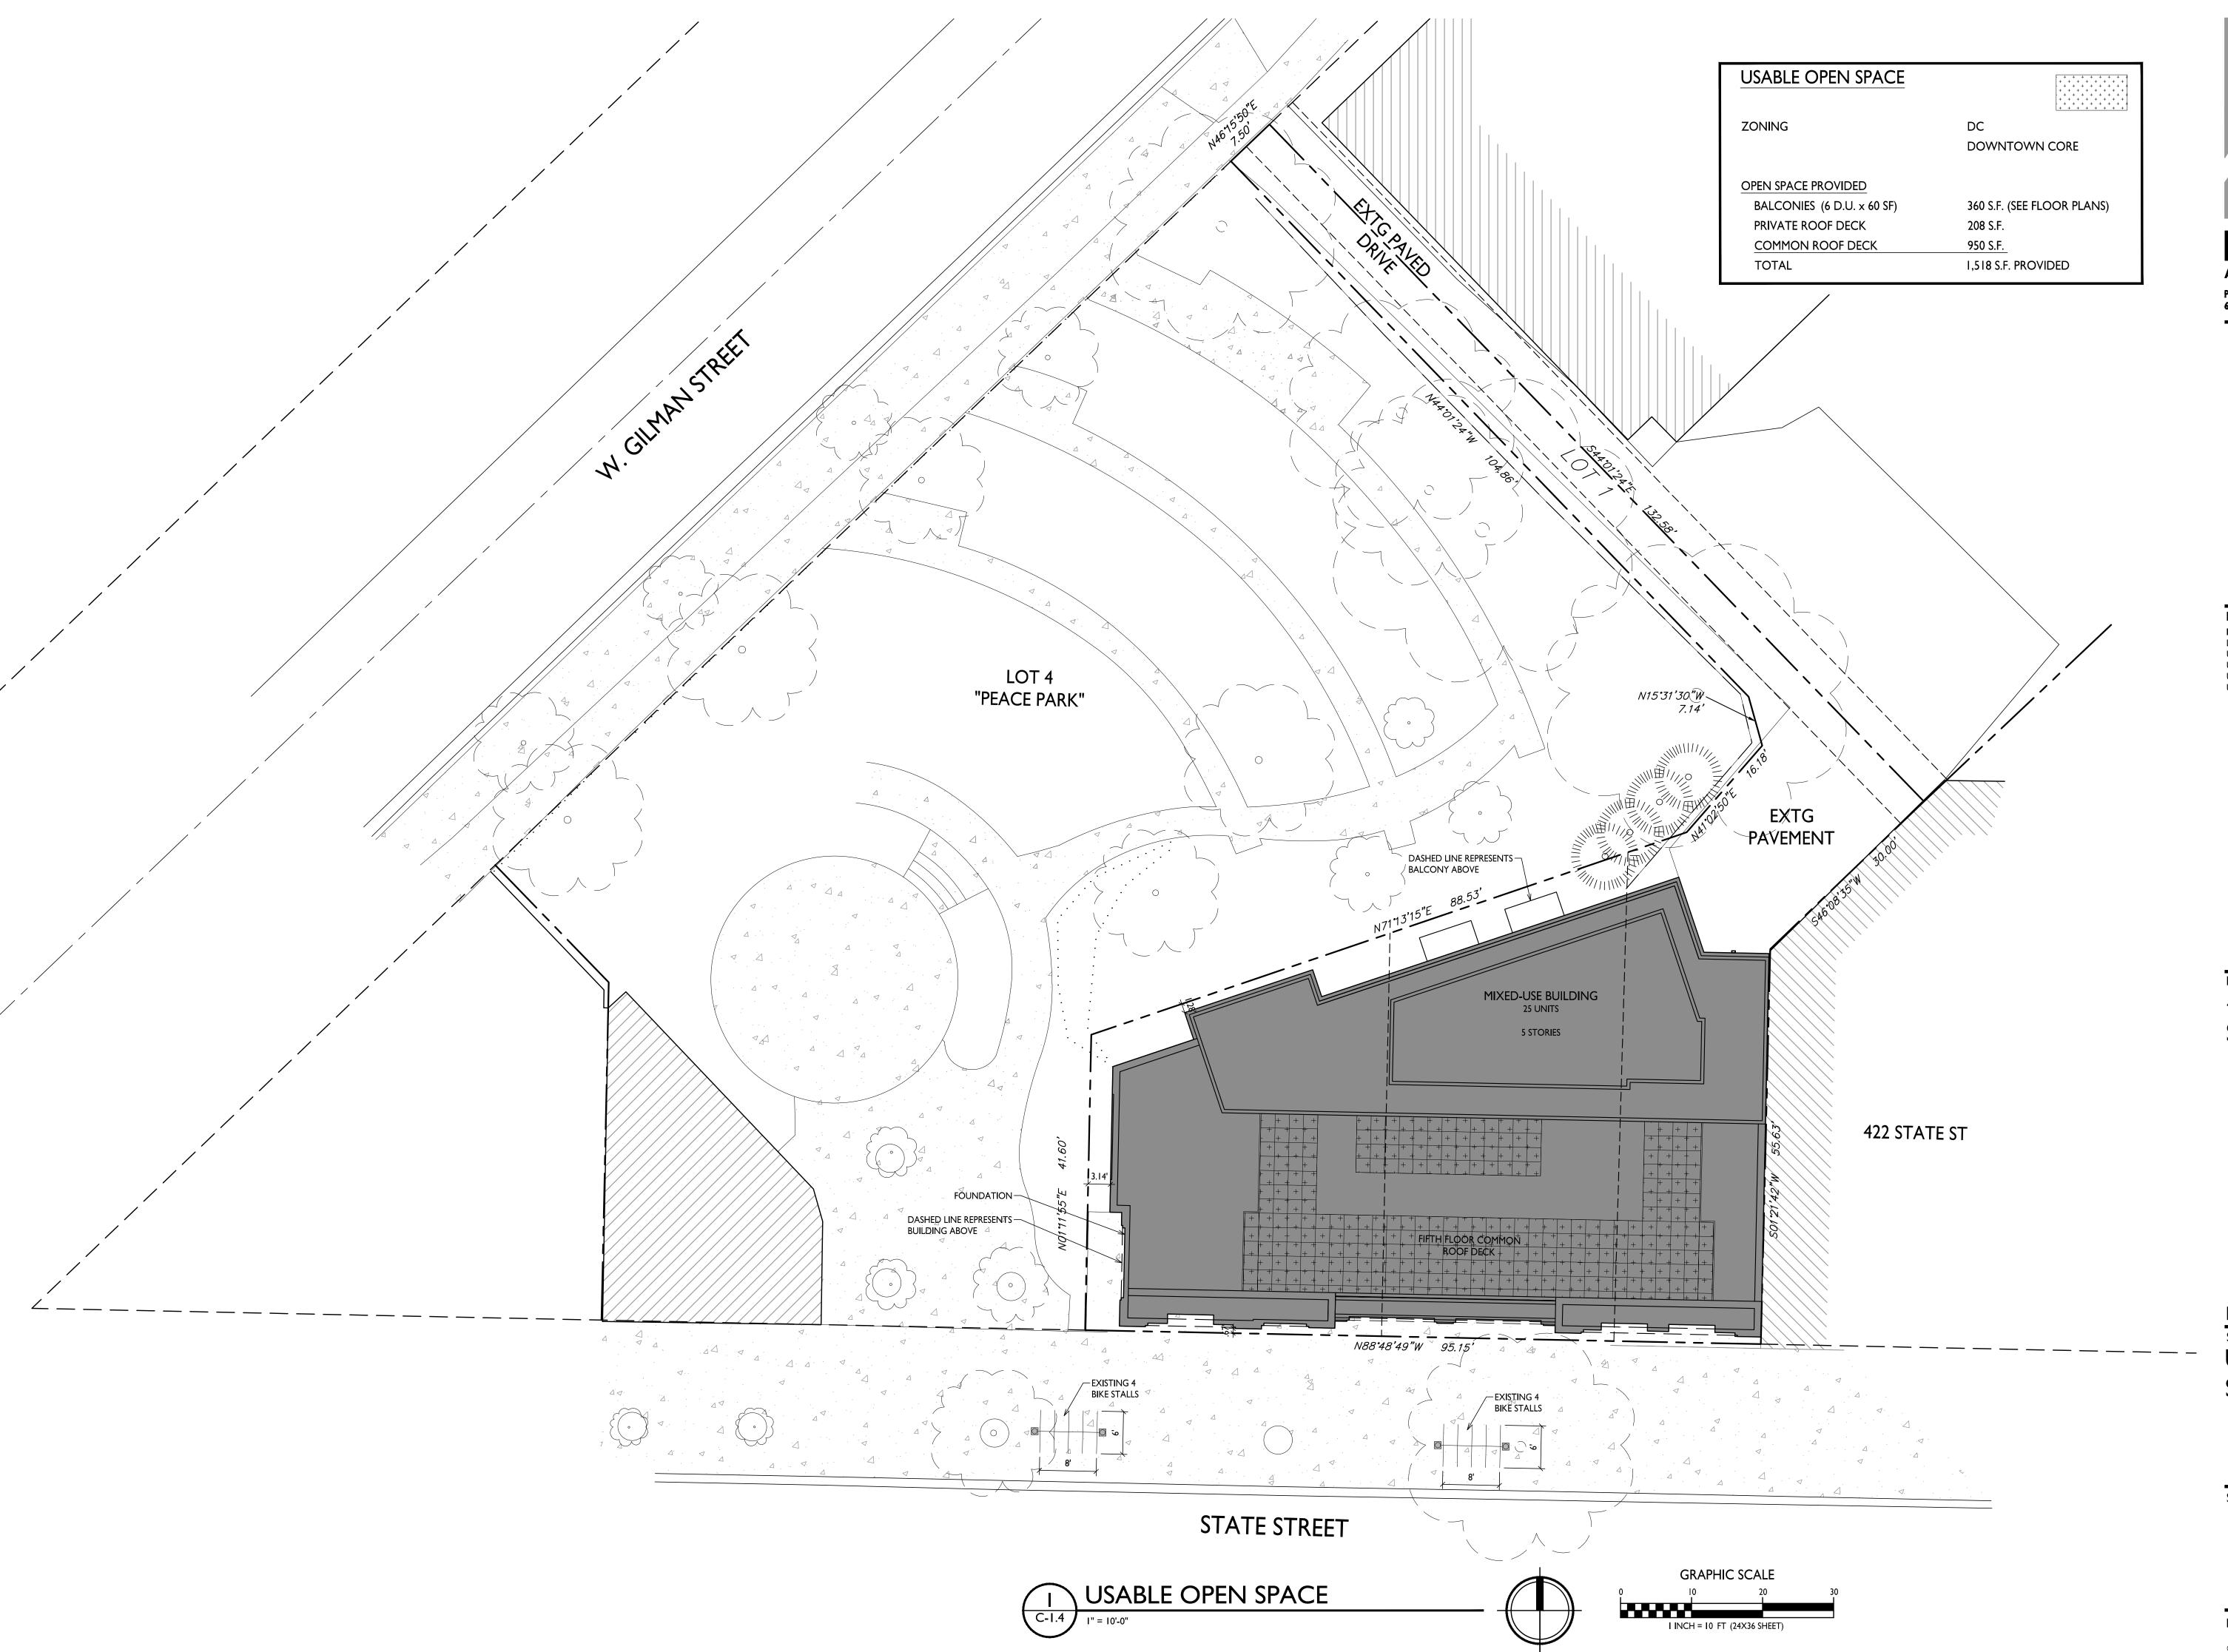
Fire Department


Access Plan

SHEET NUMBER

C-1.3

PROIECT NO.



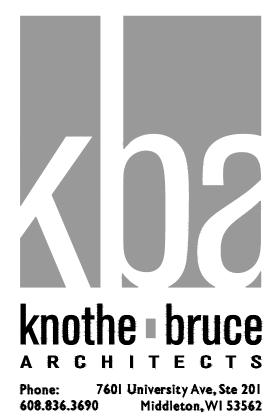

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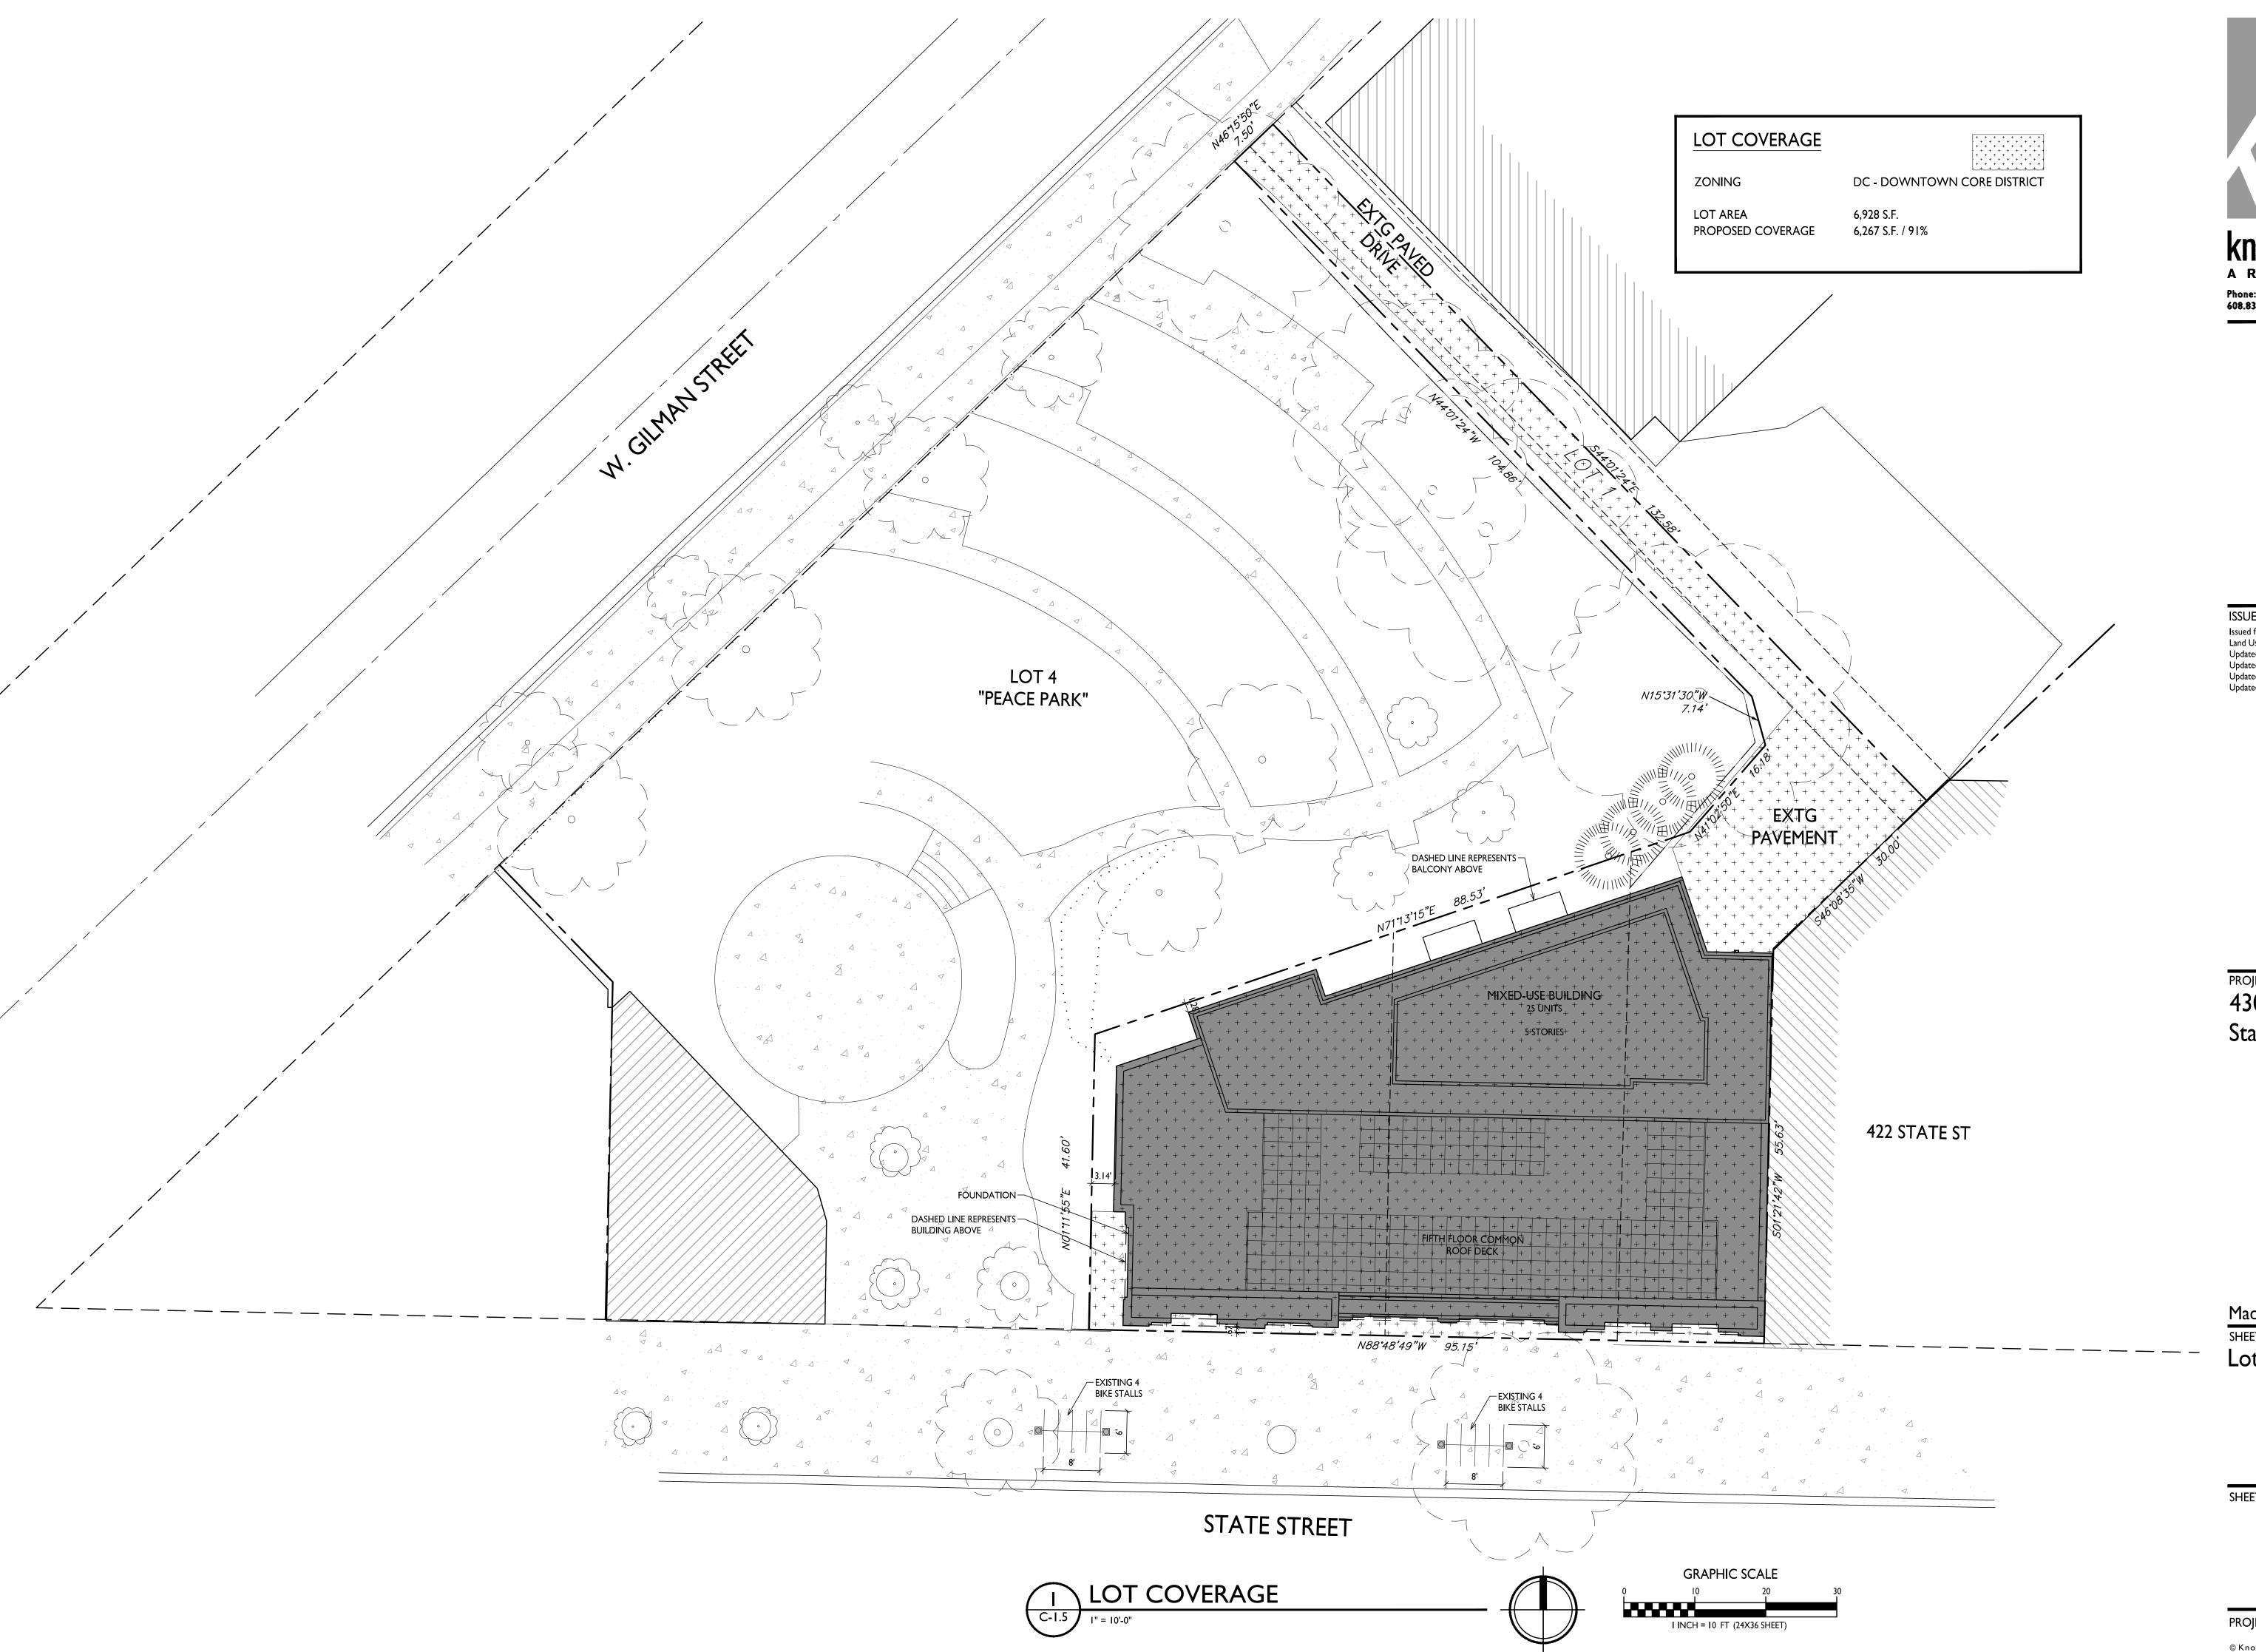
PROJECT TITLE 430, 432, 444 State Street


Madison, Wisconsin SHEET TITLE Usable Open Space

SHEET NUMBER

C-1.4

PROJECT NO.



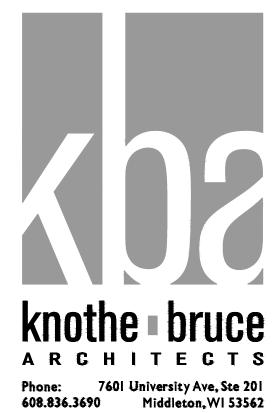

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PROJECT TITLE
430, 432, 444
State Street

Madison, Wisconsin SHEET TITLE


Lot Coverage

SHEET NUMBER

C-1.5


PROJECT NO.


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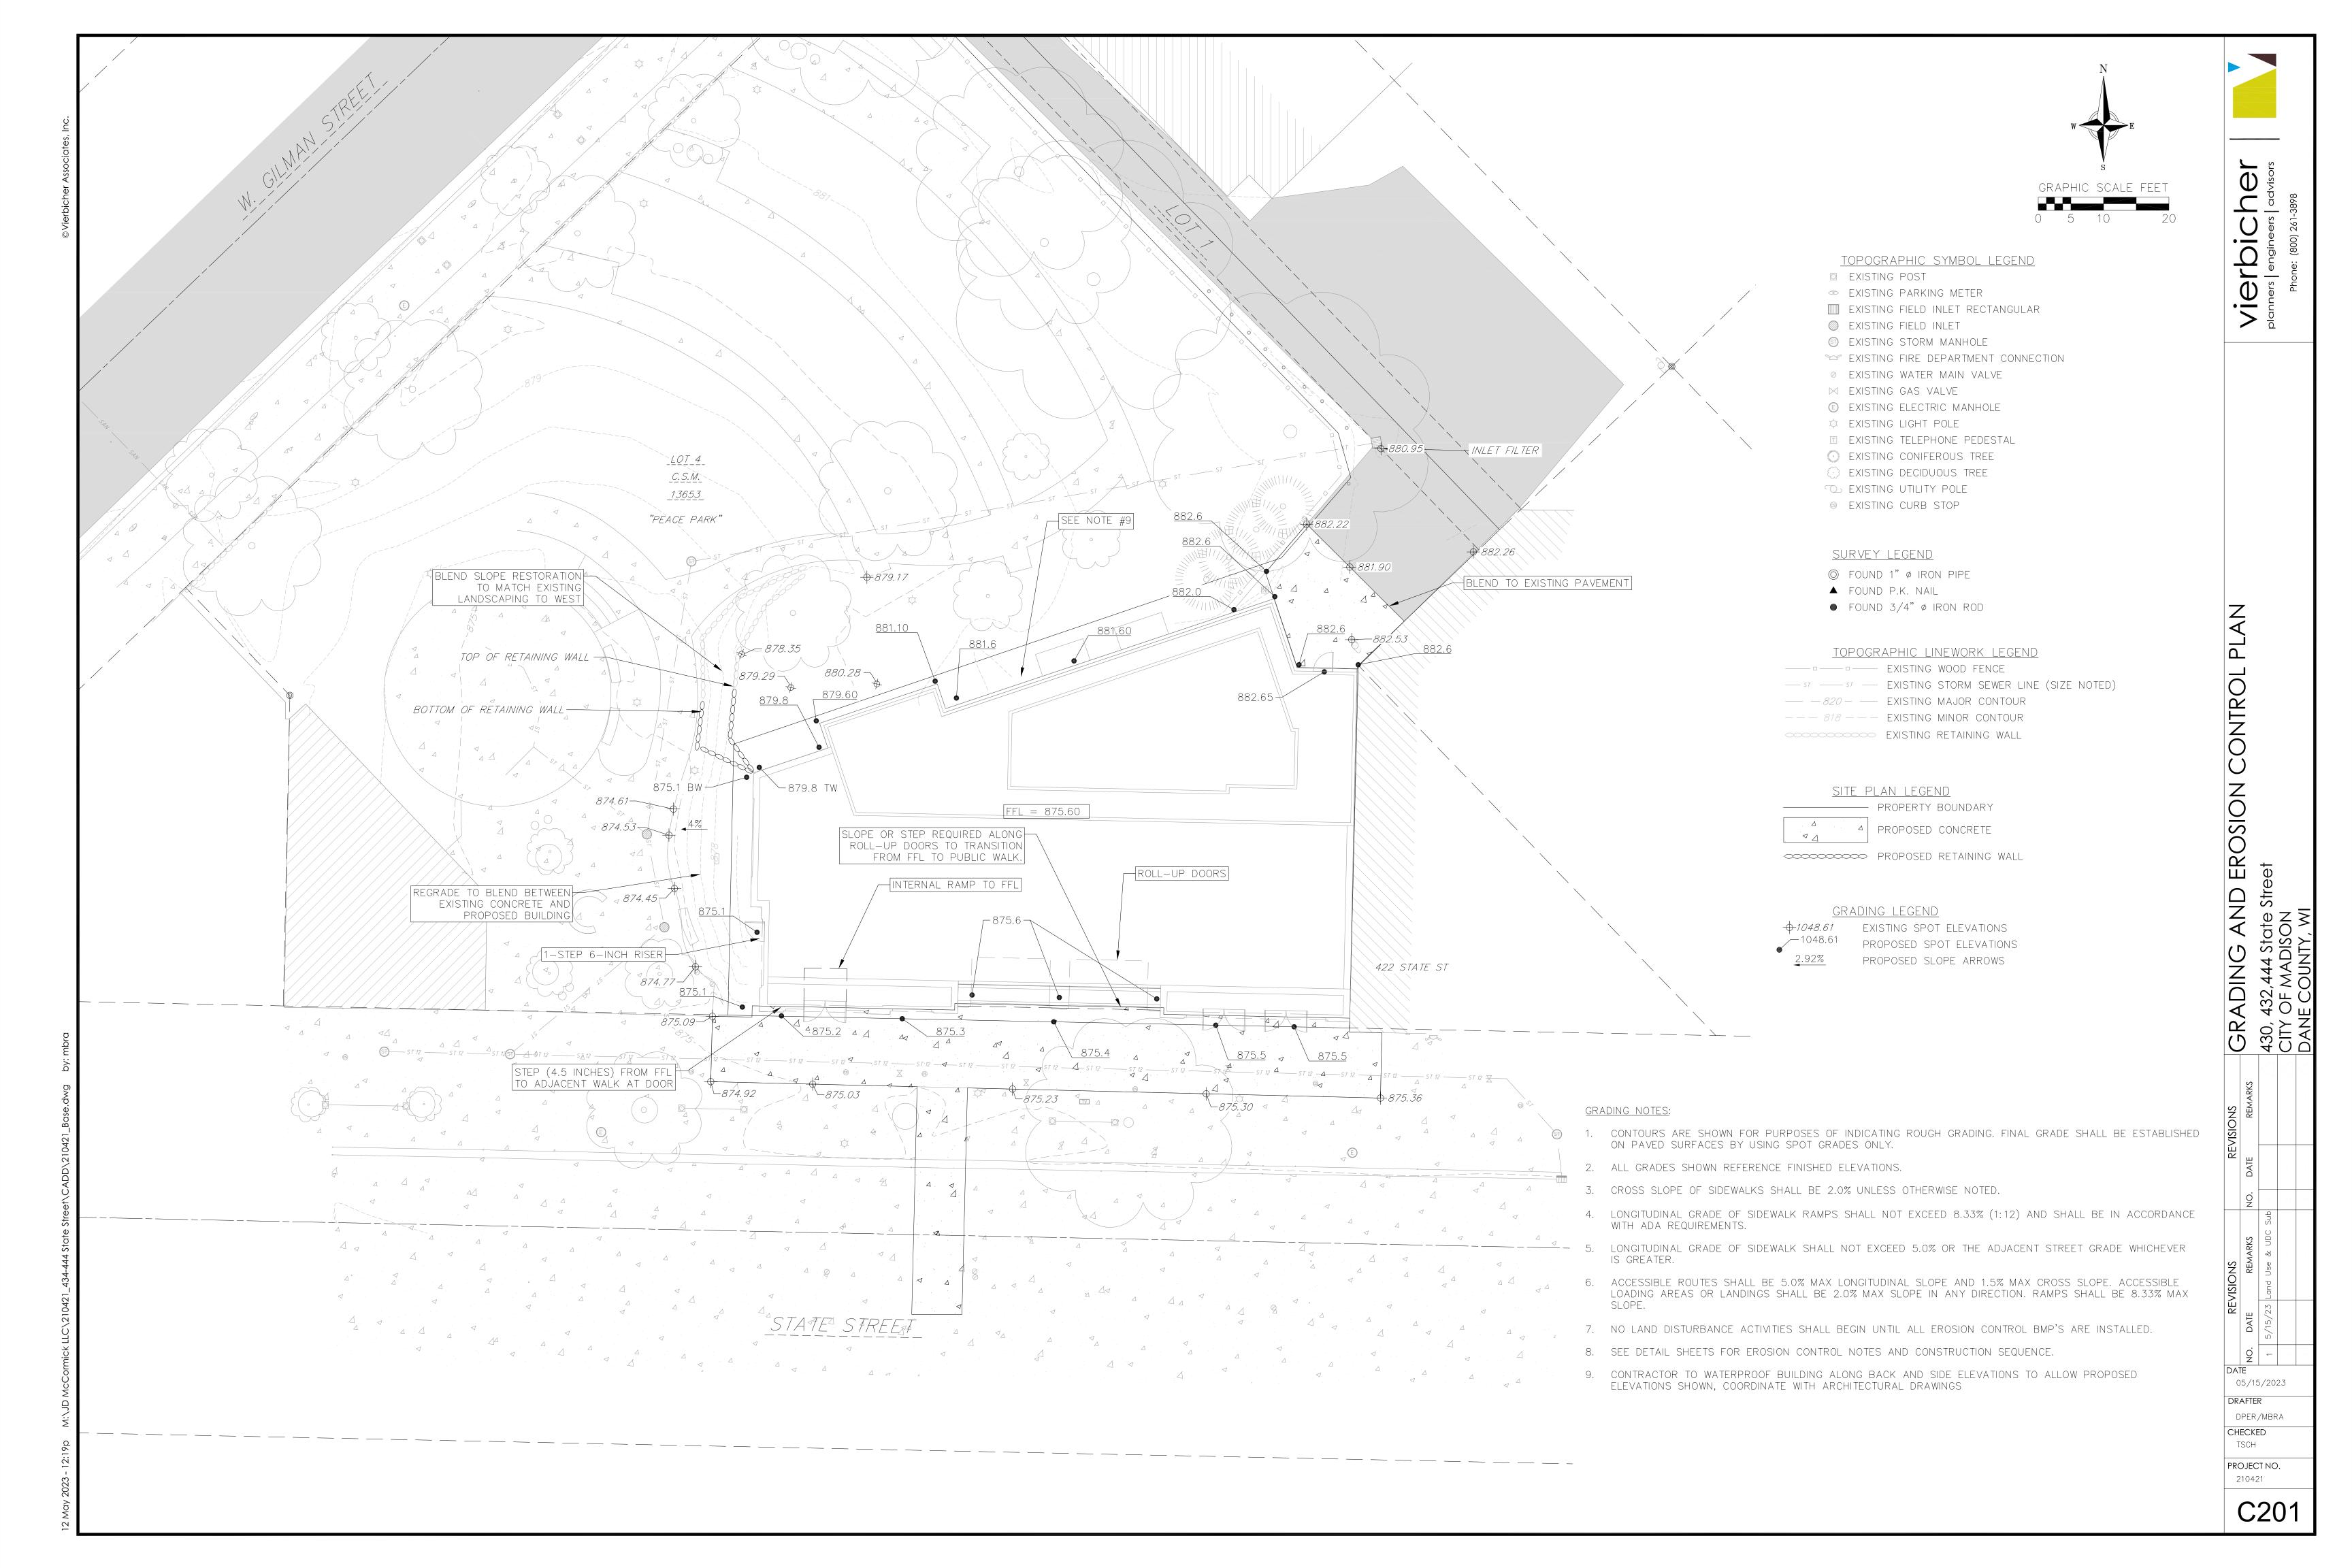
05/15/2023

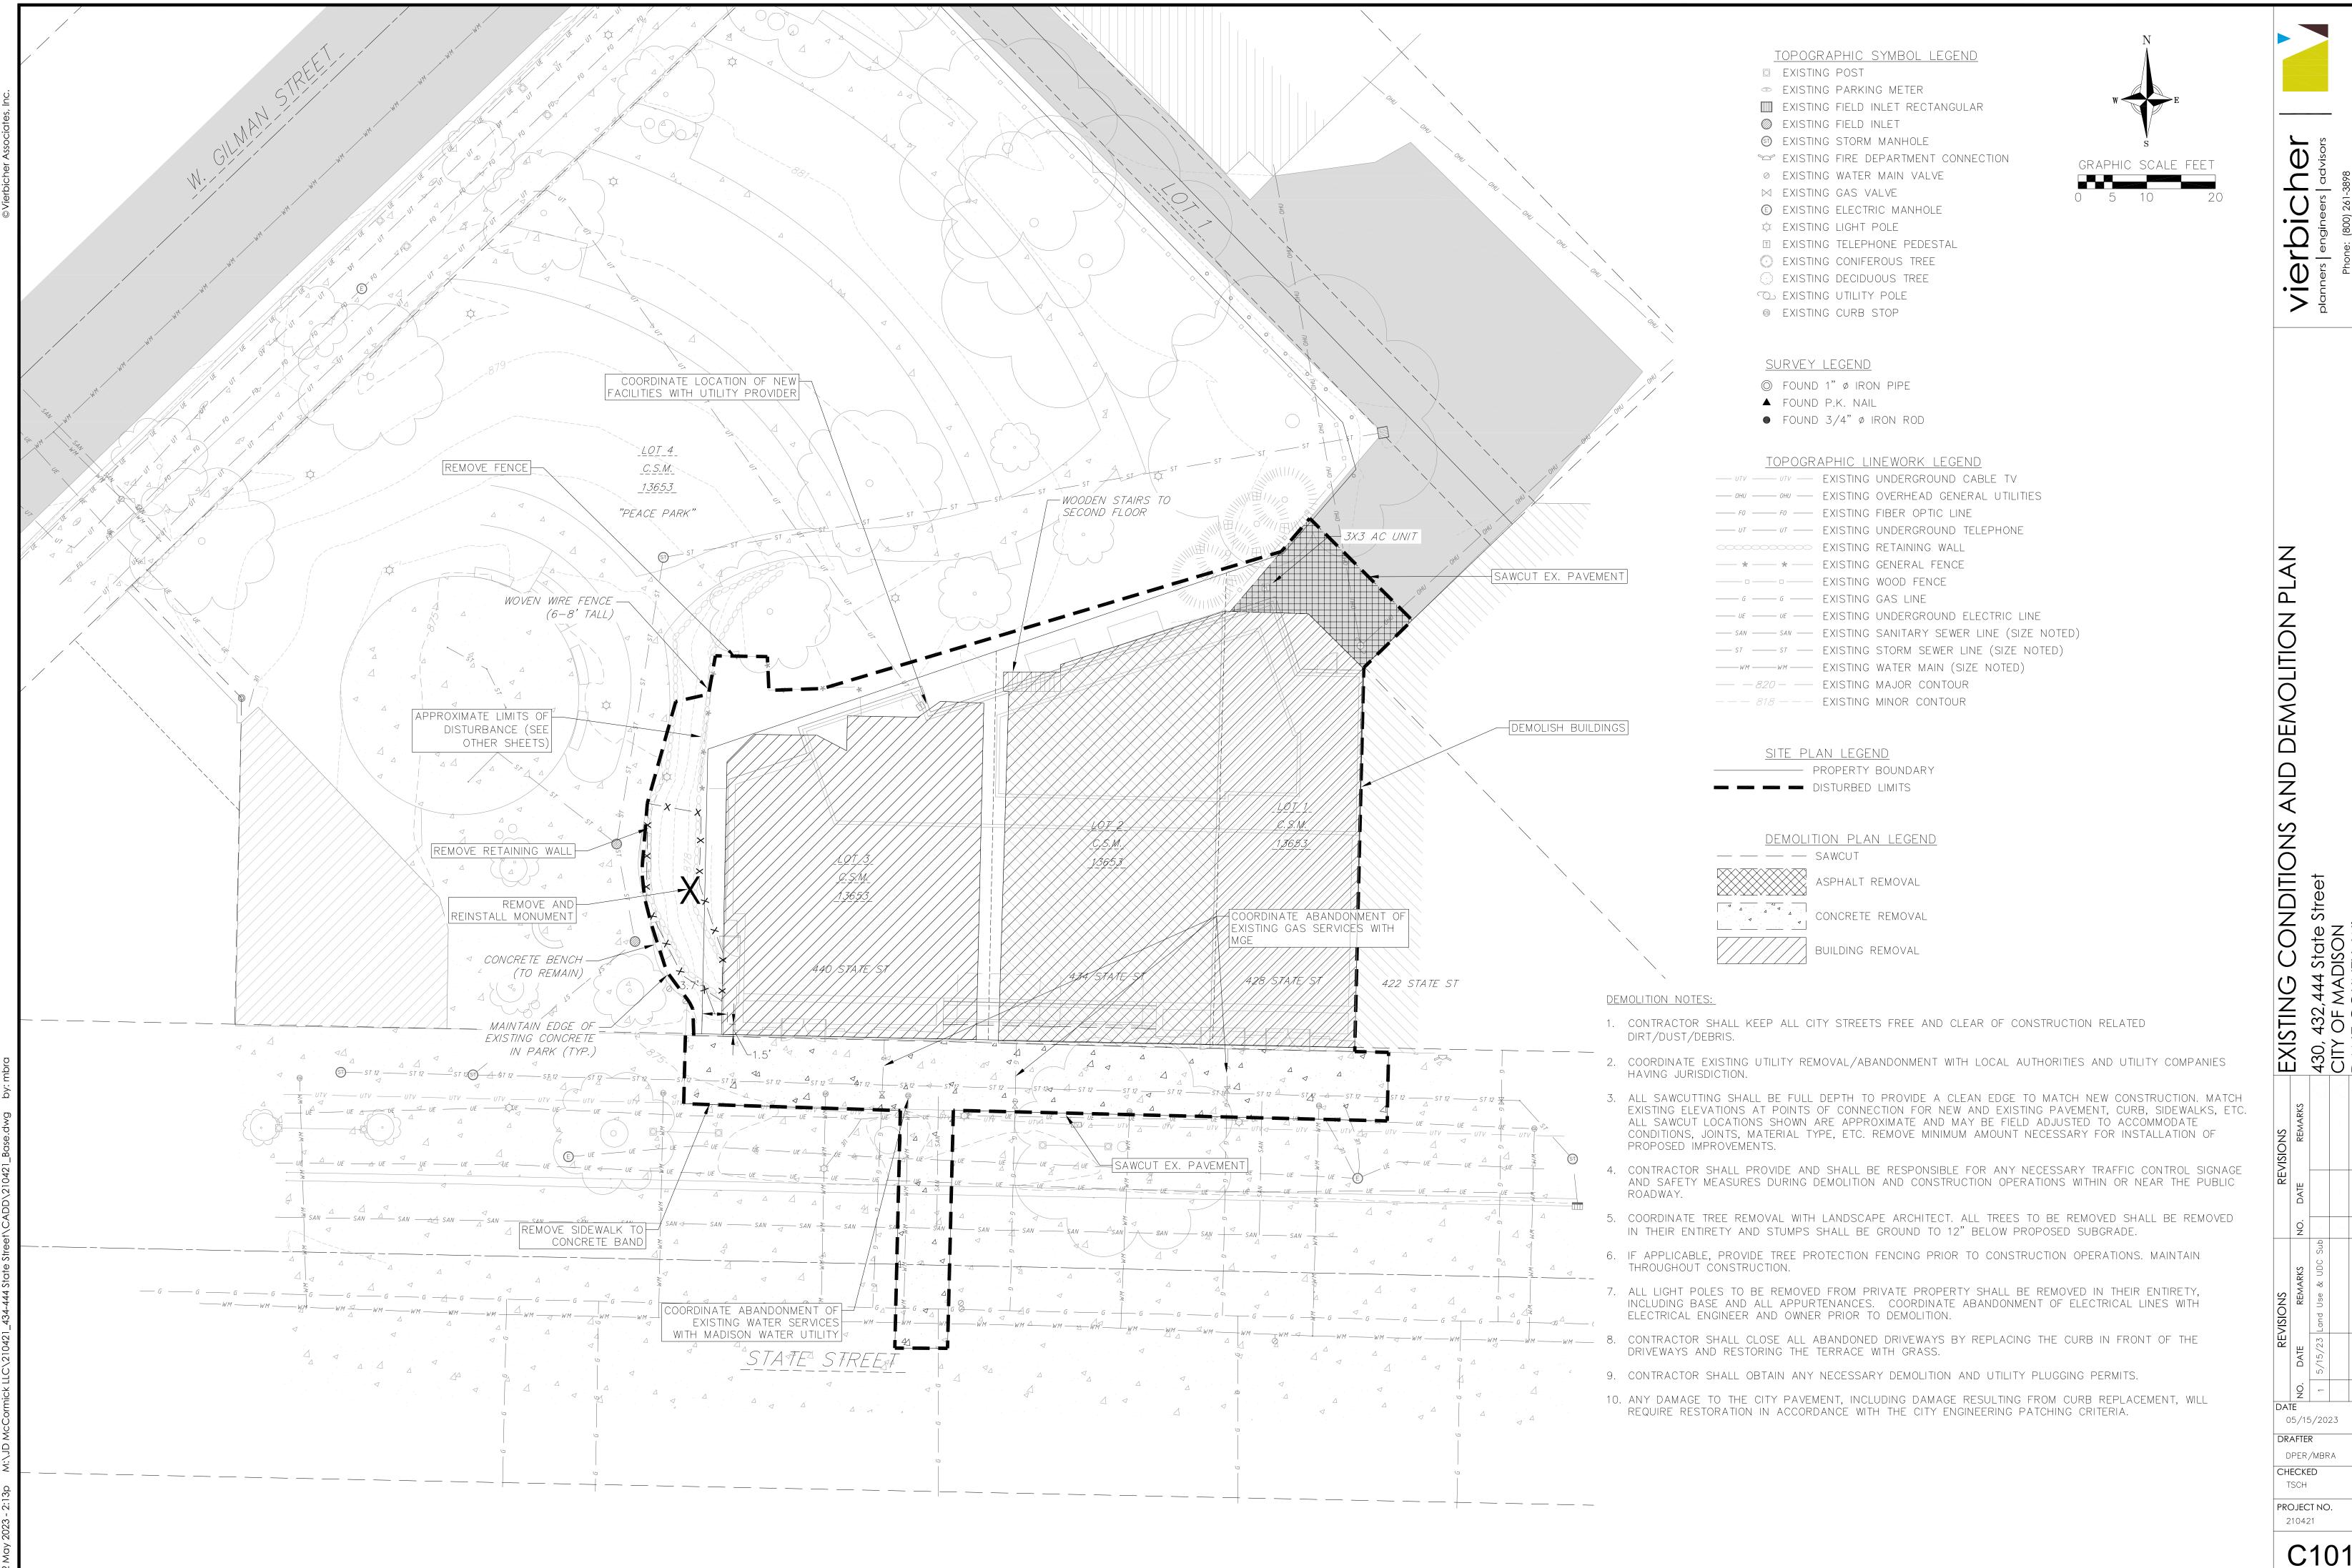
DPER/MBRA




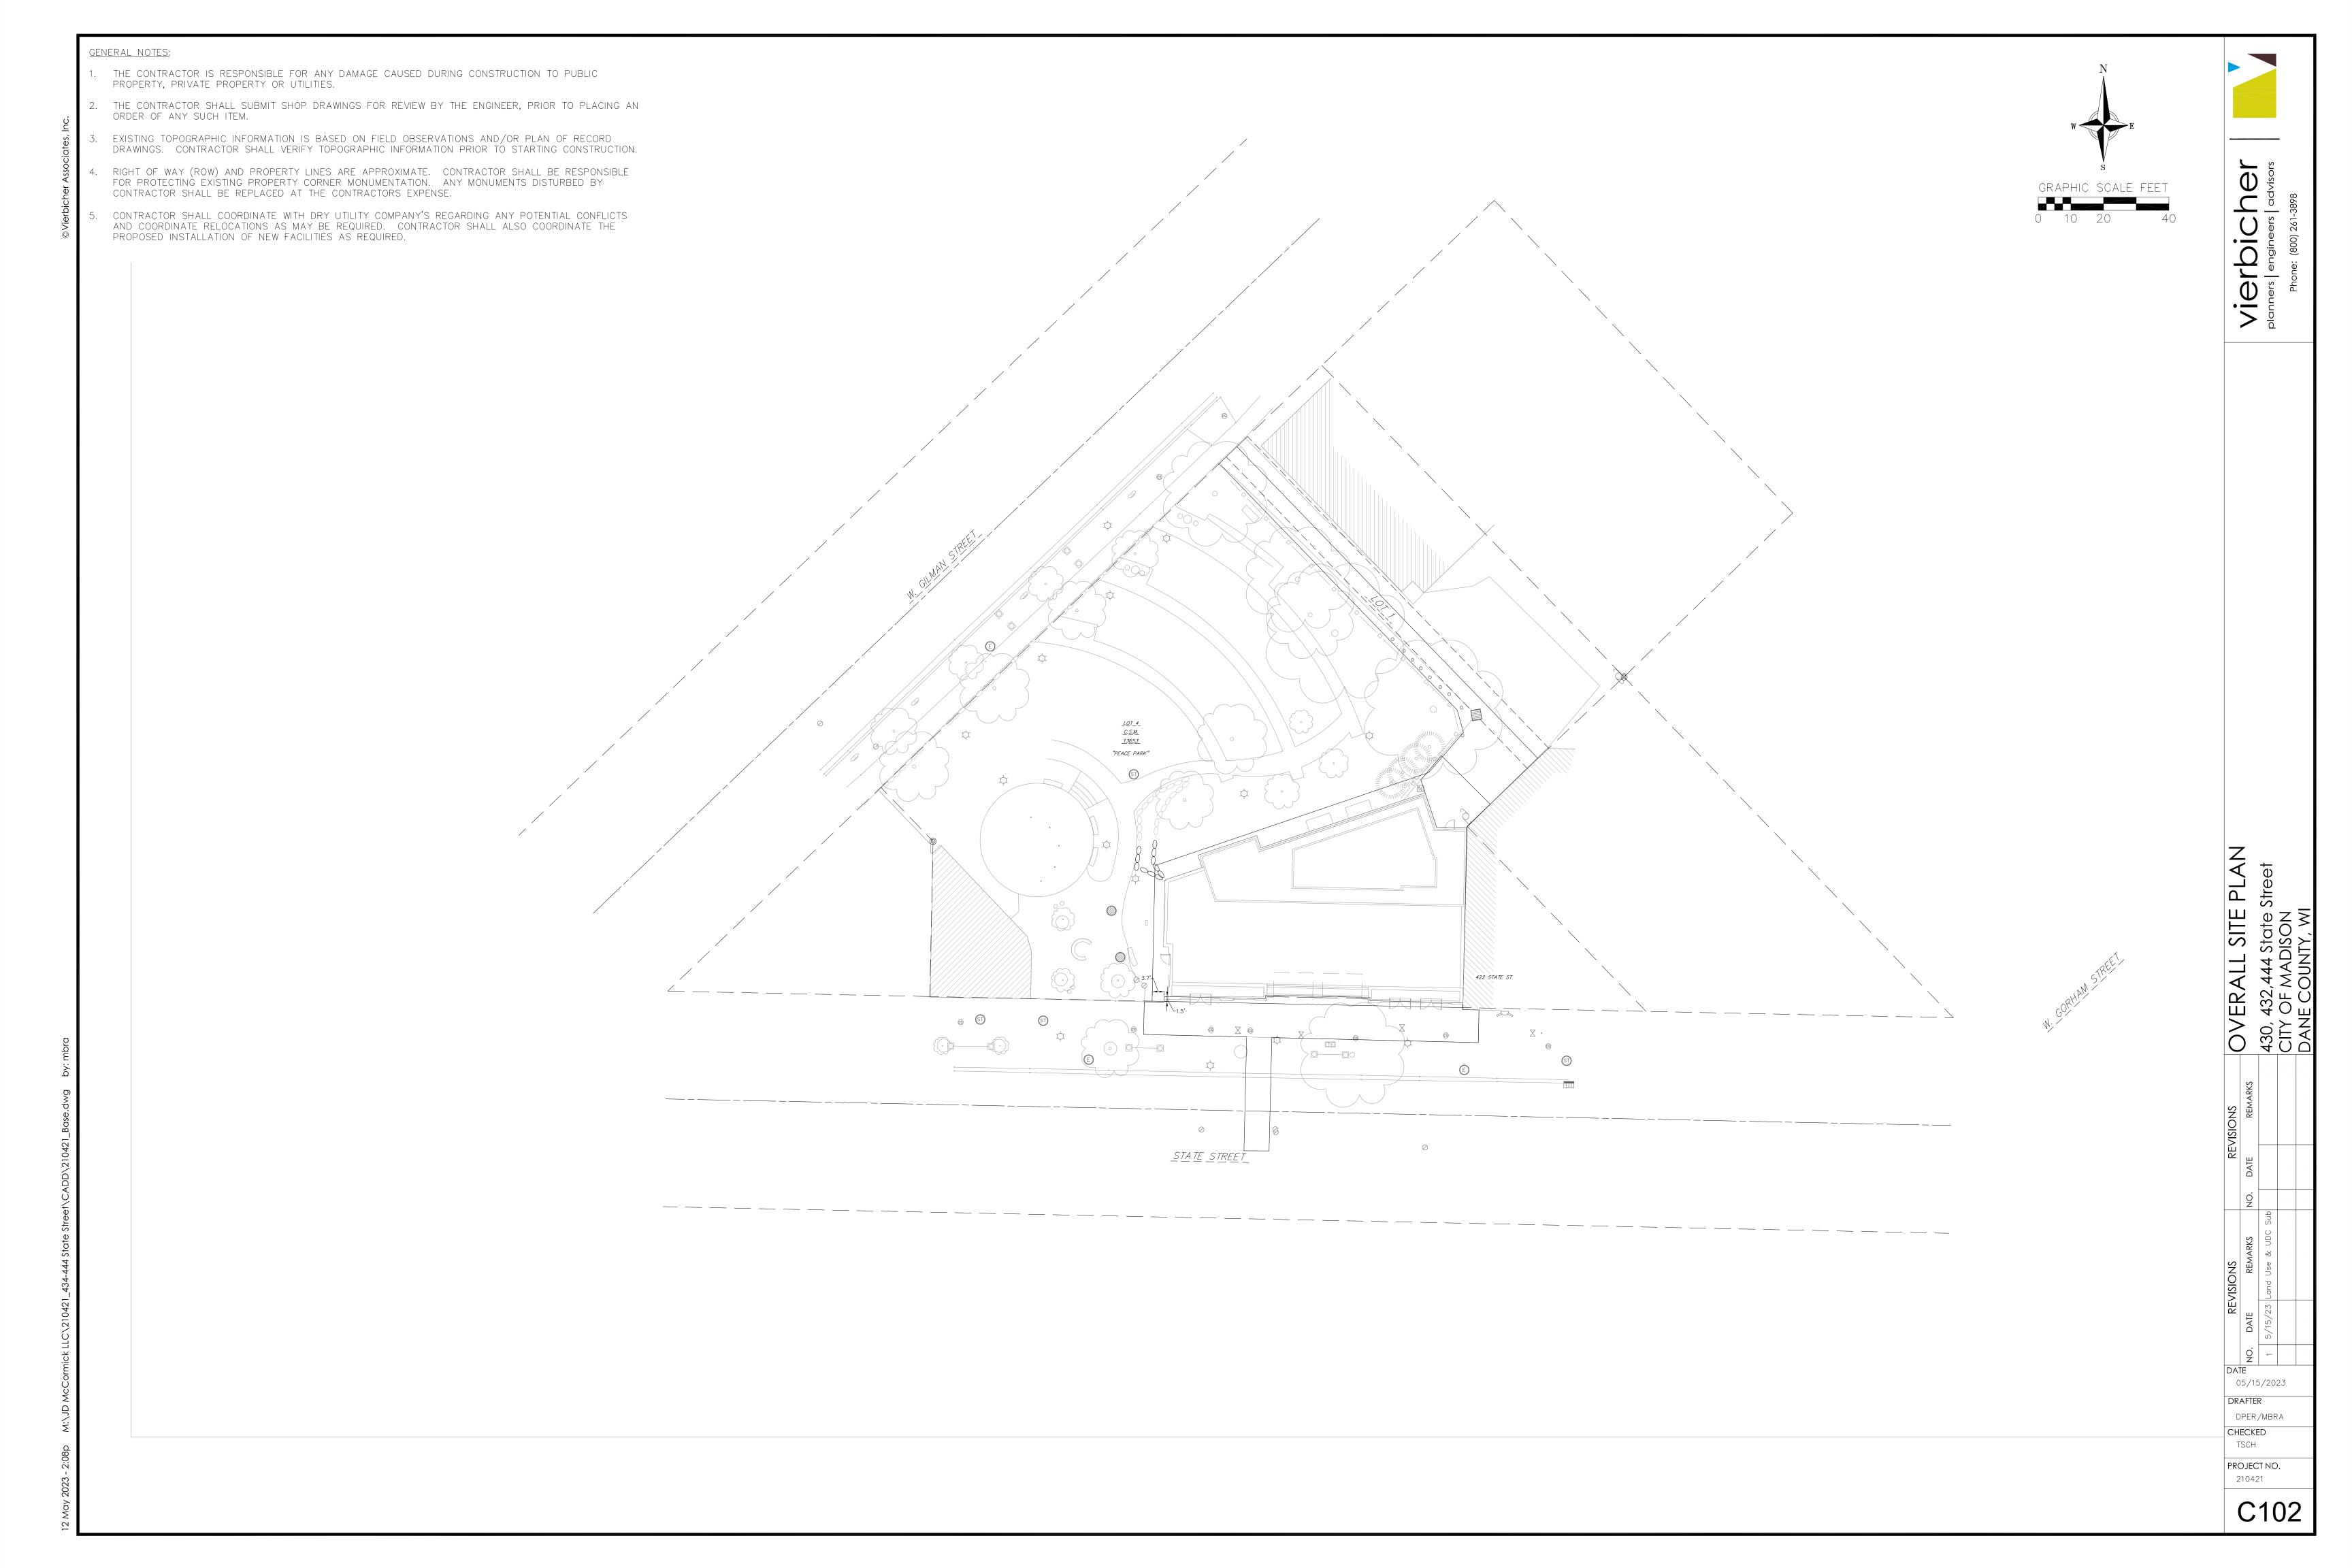

C103

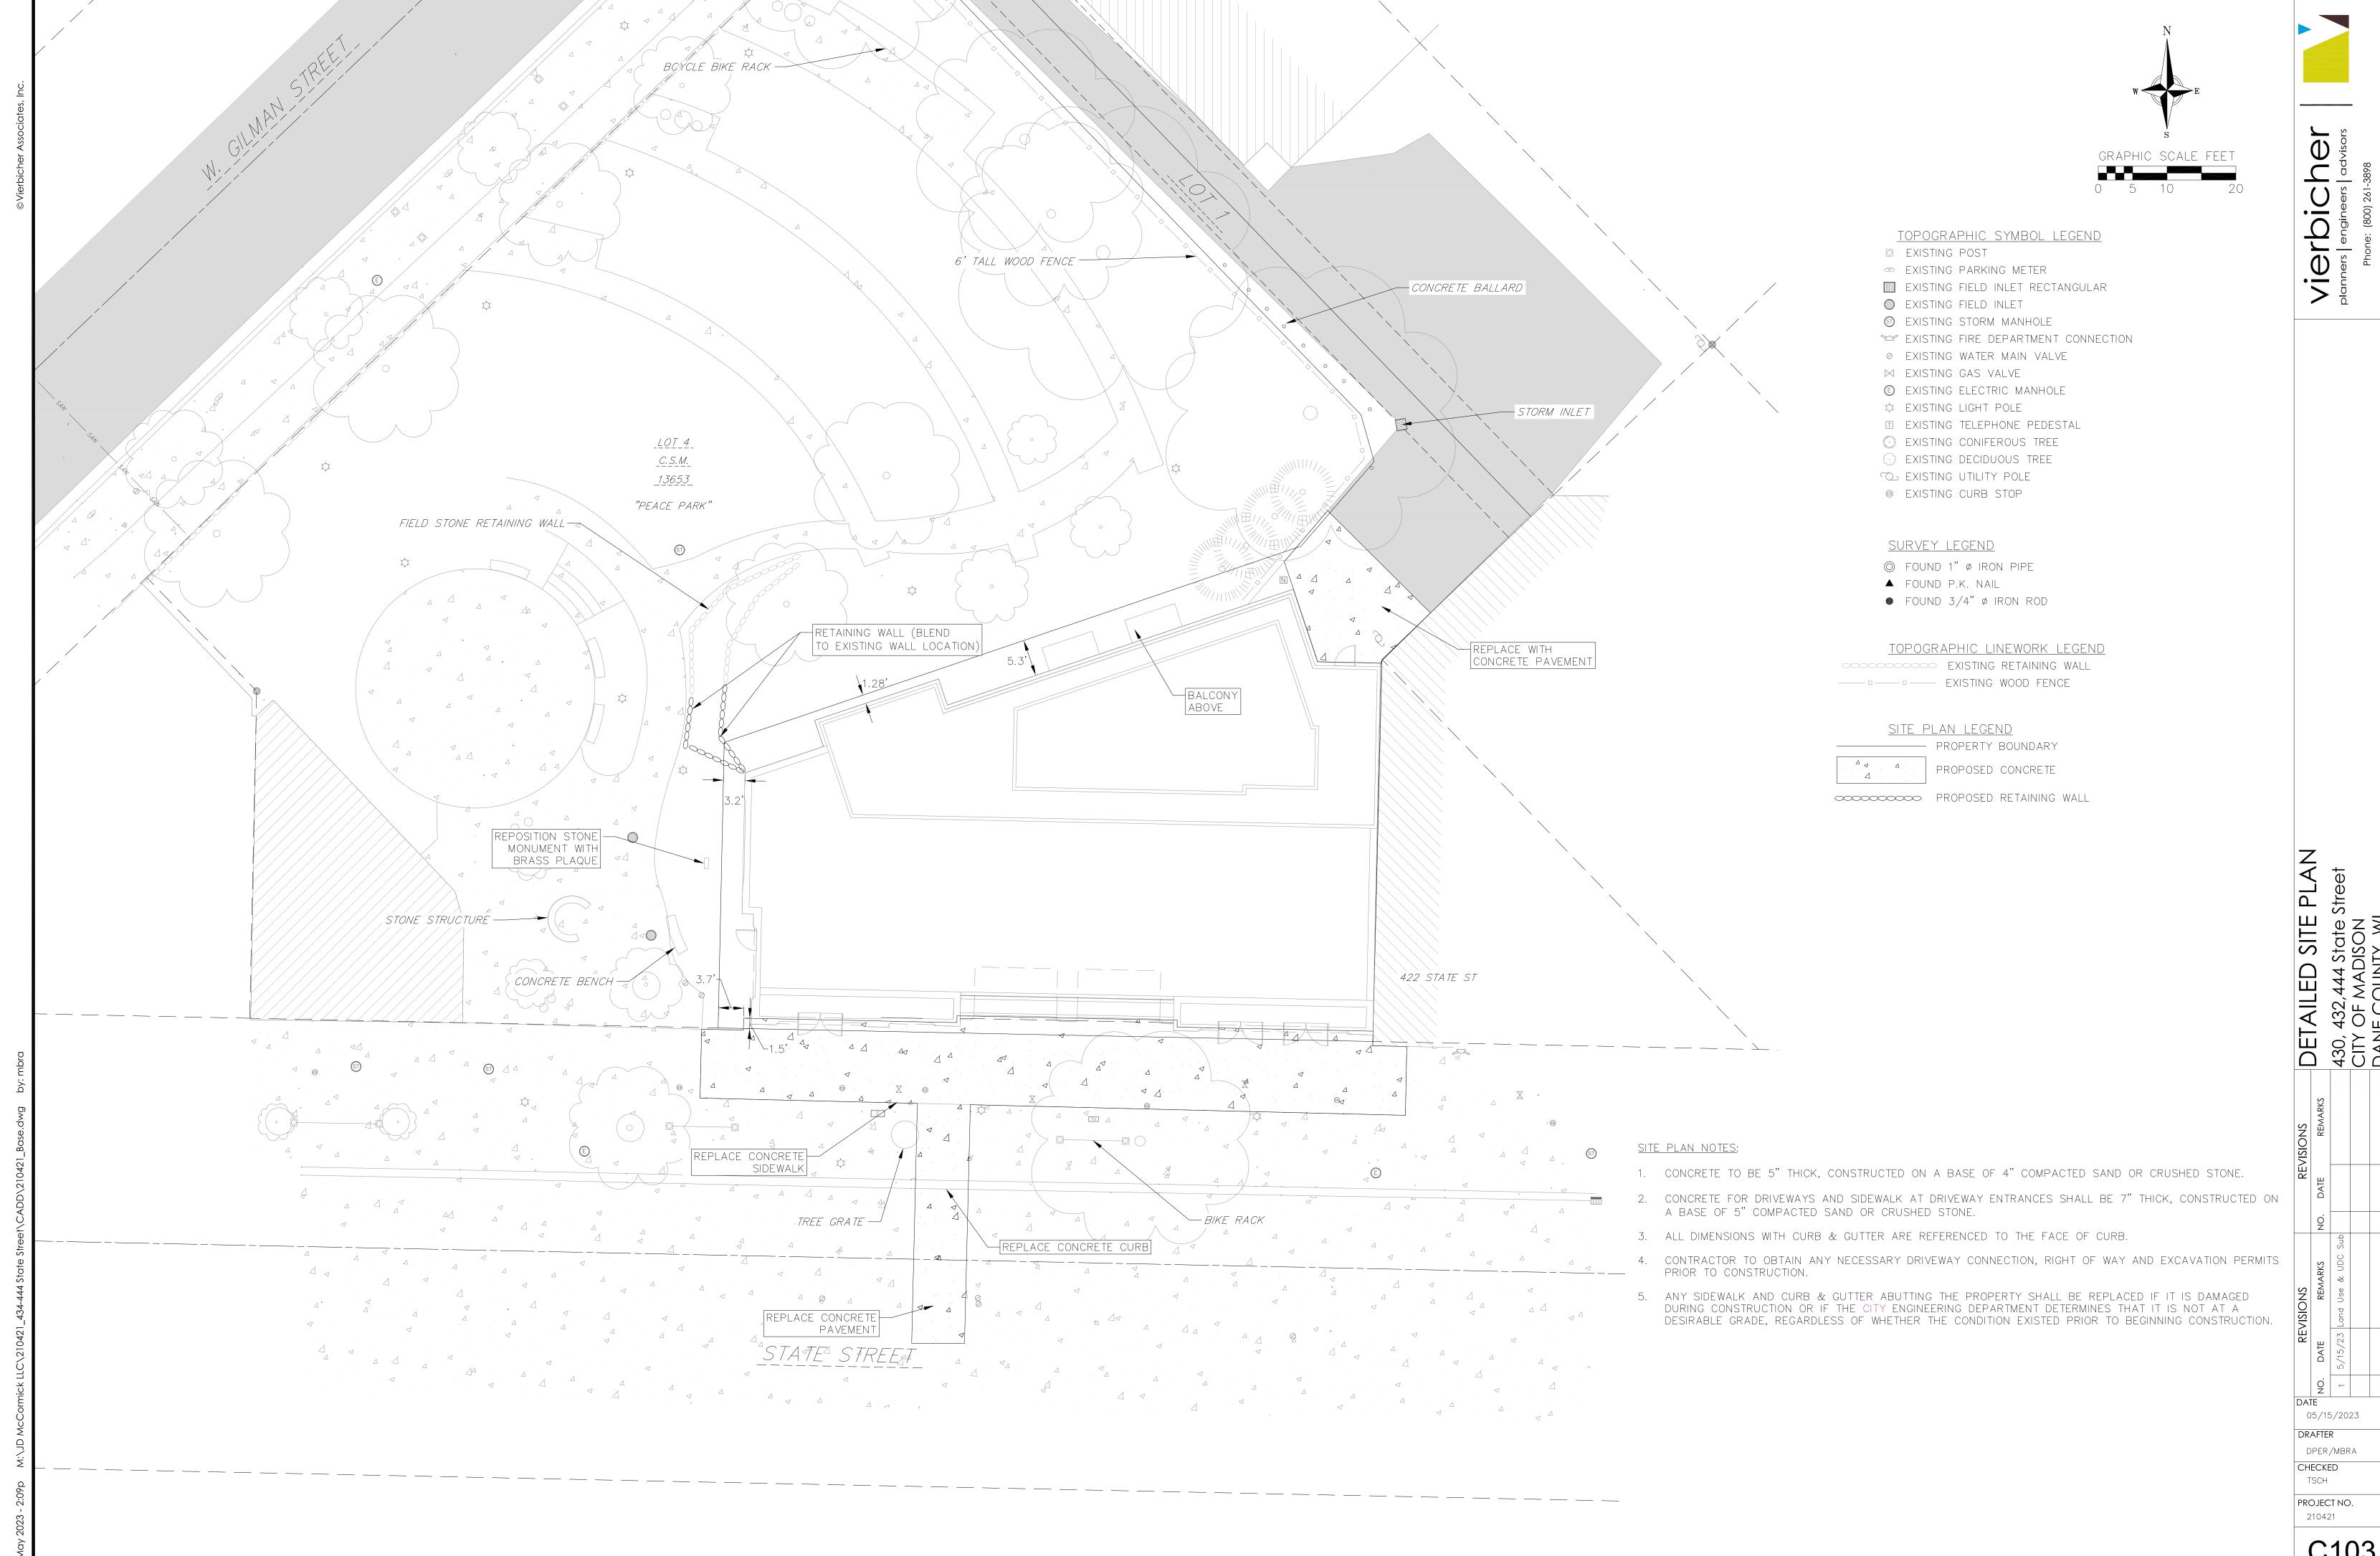

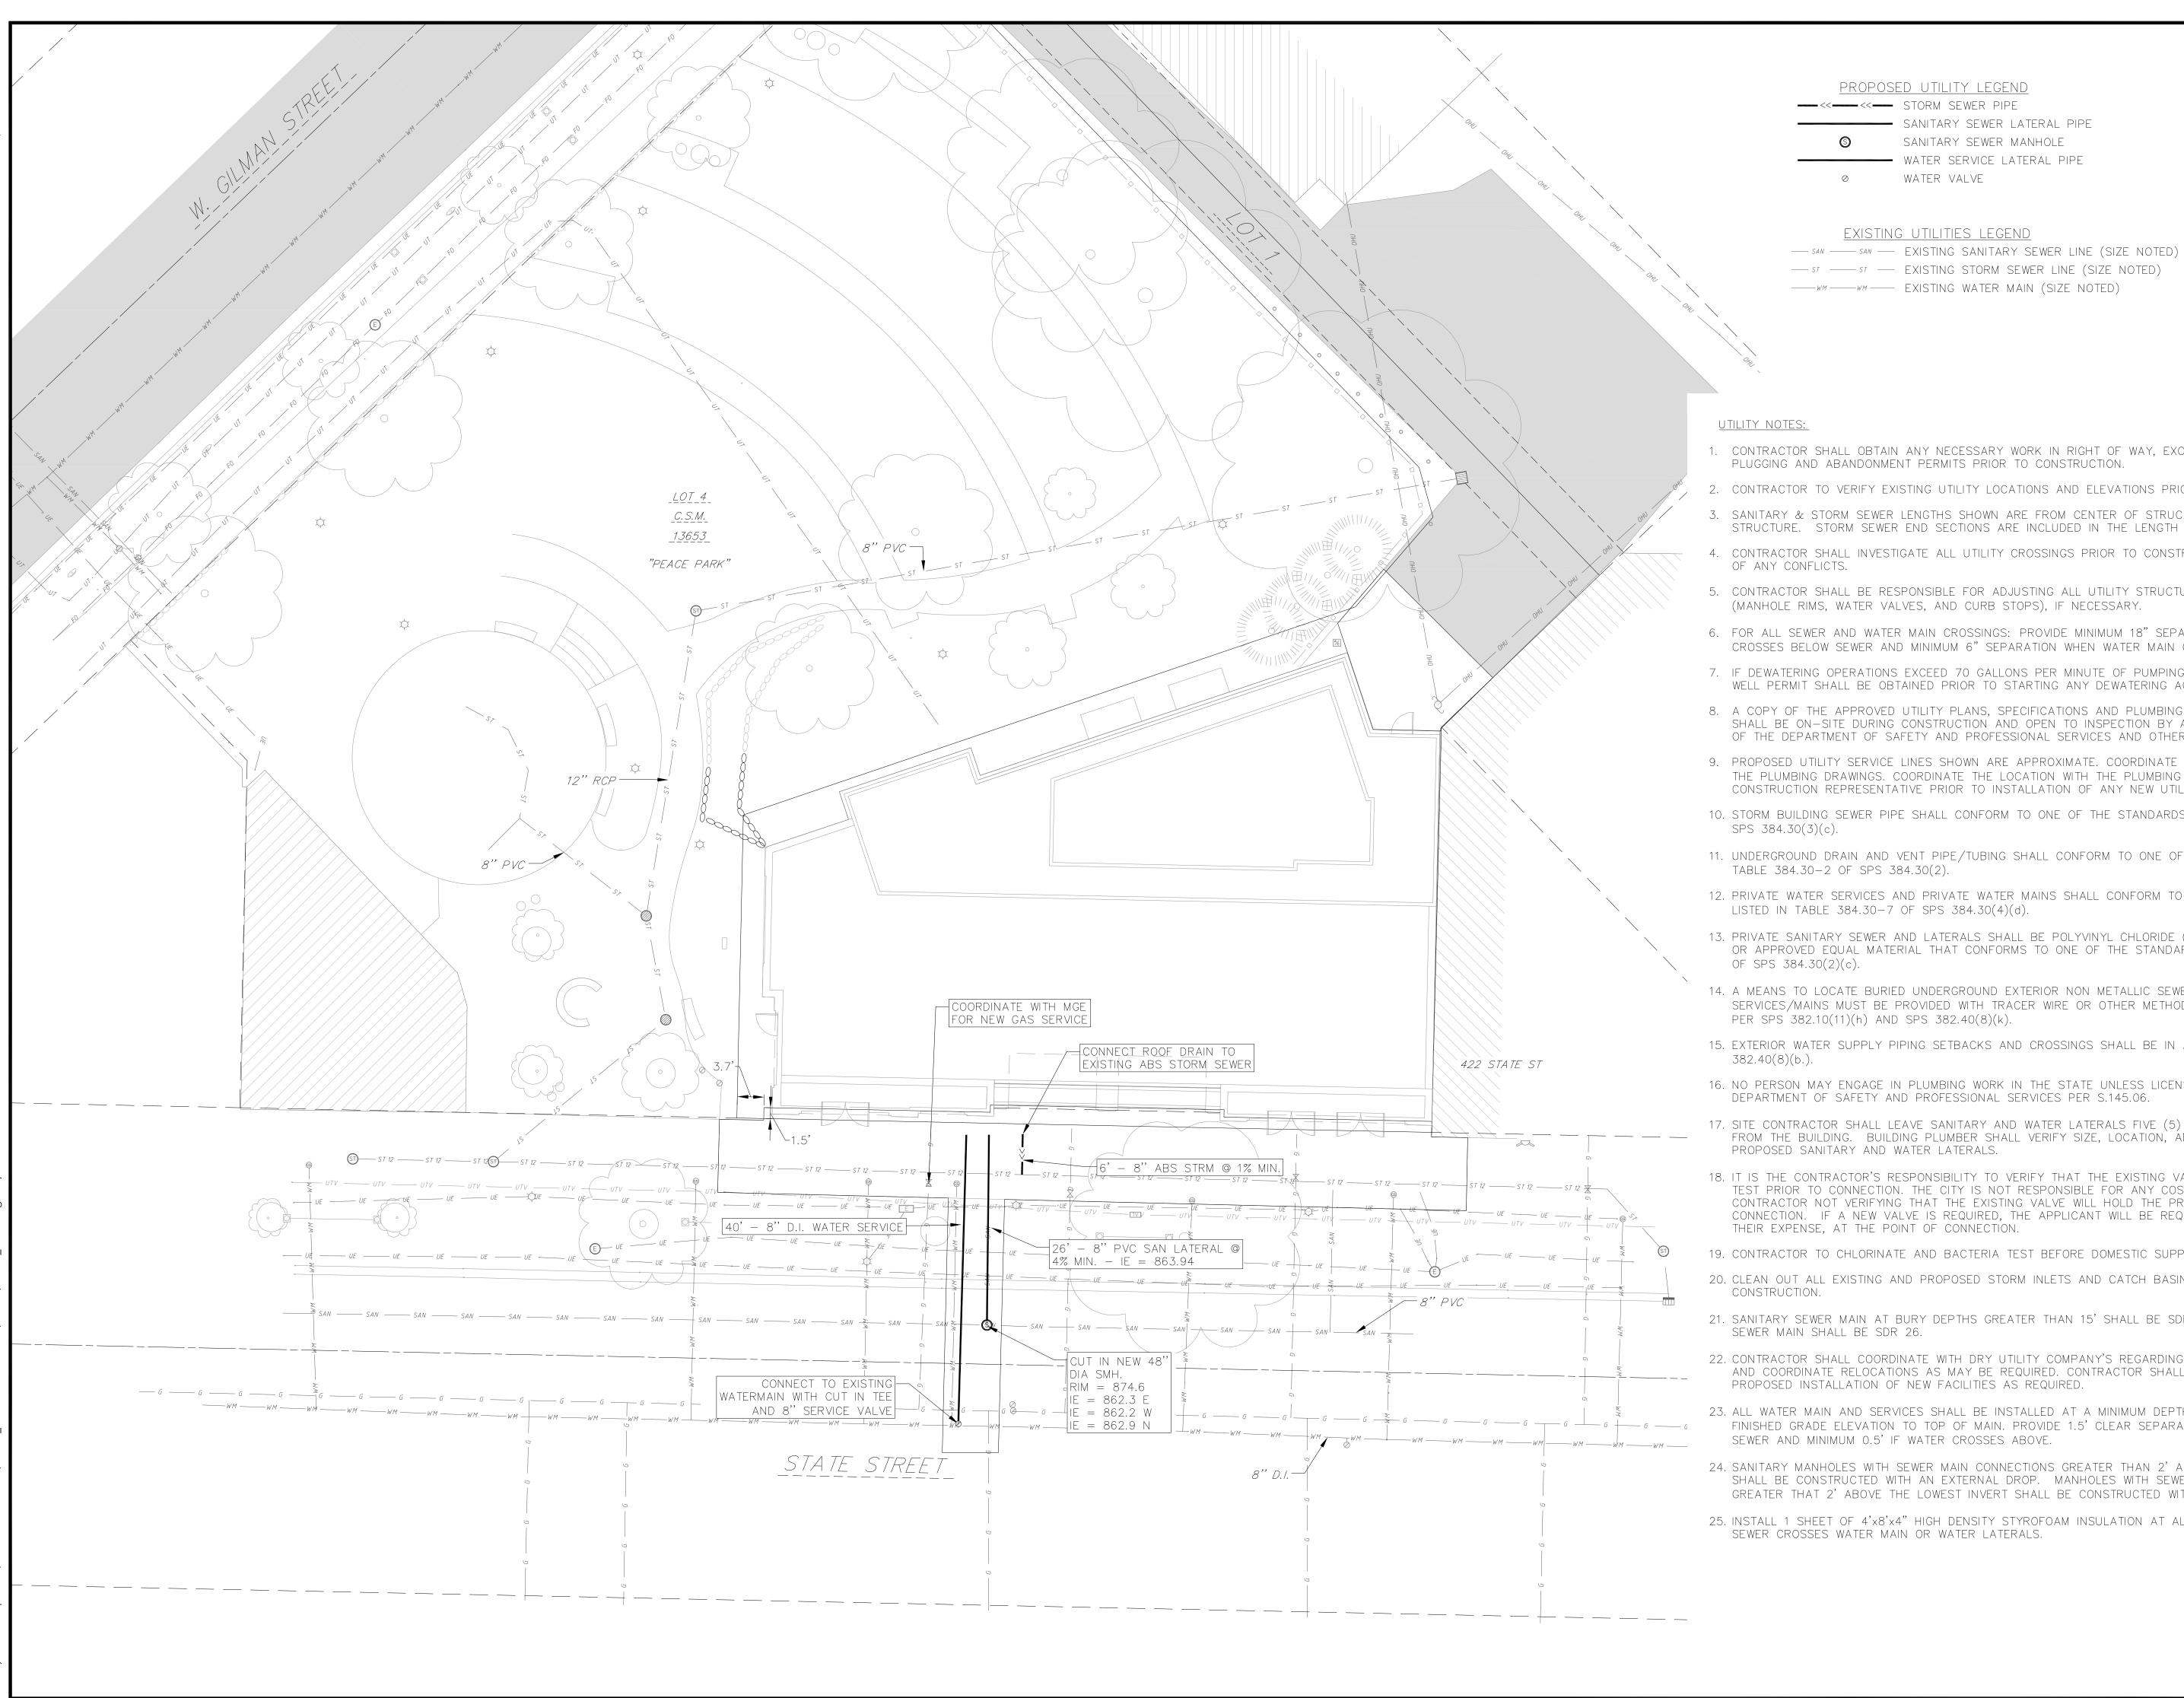

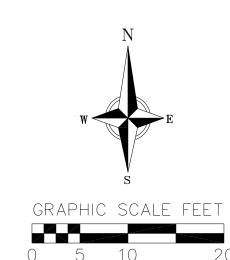

EXISTING UTILITIES LEGEND

SANITARY SEWER MANHOLE

WATER VALVE

STMH - STORM MANHOLE FI - FIELD INLET CI - CURB INLET CB - CATCH BASIN

Vierbic

<u>ABBREVIATIONS</u> EW - ENDWALL SMH - SANITARY MANHOLE

- 1. CONTRACTOR SHALL OBTAIN ANY NECESSARY WORK IN RIGHT OF WAY, EXCAVATION, UTILITY CONNECTION, PLUGGING AND ABANDONMENT PERMITS PRIOR TO CONSTRUCTION.
- 2. CONTRACTOR TO VERIFY EXISTING UTILITY LOCATIONS AND ELEVATIONS PRIOR TO STARTING WORK.
- 3. SANITARY & STORM SEWER LENGTHS SHOWN ARE FROM CENTER OF STRUCTURE TO CENTER OF STRUCTURE. STORM SEWER END SECTIONS ARE INCLUDED IN THE LENGTH AND SLOPE OF THE PIPE.
- 4. CONTRACTOR SHALL INVESTIGATE ALL UTILITY CROSSINGS PRIOR TO CONSTRUCTION AND NOTIFY ENGINEER
- 5. CONTRACTOR SHALL BE RESPONSIBLE FOR ADJUSTING ALL UTILITY STRUCTURES TO FINISHED GRADE (MANHOLE RIMS, WATER VALVES, AND CURB STOPS), IF NECESSARY.
- 6. FOR ALL SEWER AND WATER MAIN CROSSINGS: PROVIDE MINIMUM 18" SEPARATION WHEN WATER MAIN CROSSES BELOW SEWER AND MINIMUM 6" SEPARATION WHEN WATER MAIN CROSSES ABOVE SEWER.
- 7. IF DEWATERING OPERATIONS EXCEED 70 GALLONS PER MINUTE OF PUMPING CAPACITY, A DEWATERING WELL PERMIT SHALL BE OBTAINED PRIOR TO STARTING ANY DEWATERING ACTIVITIES.
- 8. A COPY OF THE APPROVED UTILITY PLANS, SPECIFICATIONS AND PLUMBING PERMIT APPROVAL LETTER SHALL BE ON-SITE DURING CONSTRUCTION AND OPEN TO INSPECTION BY AUTHORIZED REPRESENTATIVES OF THE DEPARTMENT OF SAFETY AND PROFESSIONAL SERVICES AND OTHER LOCAL INSPECTORS.
- 9. PROPOSED UTILITY SERVICE LINES SHOWN ARE APPROXIMATE. COORDINATE THE EXACT LOCATIONS WITH THE PLUMBING DRAWINGS. COORDINATE THE LOCATION WITH THE PLUMBING CONTRACTOR AND/OR OWNER'S CONSTRUCTION REPRESENTATIVE PRIOR TO INSTALLATION OF ANY NEW UTILITIES.
- 10. STORM BUILDING SEWER PIPE SHALL CONFORM TO ONE OF THE STANDARDS LISTED IN TABLE 384.30-6 OF
- 11. UNDERGROUND DRAIN AND VENT PIPE/TUBING SHALL CONFORM TO ONE OF THE STANDARDS LISTED IN TABLE 384.30-2 OF SPS 384.30(2).
- 12. PRIVATE WATER SERVICES AND PRIVATE WATER MAINS SHALL CONFORM TO ONE OF THE STANDARDS LISTED IN TABLE 384.30-7 OF SPS 384.30(4)(d).
- 13. PRIVATE SANITARY SEWER AND LATERALS SHALL BE POLYVINYL CHLORIDE (PVC) ASTM D3034 SDR 35 OR APPROVED EQUAL MATERIAL THAT CONFORMS TO ONE OF THE STANDARDS LISTED IN TABLE 384.30-3
- 14. A MEANS TO LOCATE BURIED UNDERGROUND EXTERIOR NON METALLIC SEWERS/MAINS AND WATER SERVICES/MAINS MUST BE PROVIDED WITH TRACER WIRE OR OTHER METHODS IN ORDER TO BE LOCATED
- 15. EXTERIOR WATER SUPPLY PIPING SETBACKS AND CROSSINGS SHALL BE IN ACCORDANCE WITH SPS
- 16. NO PERSON MAY ENGAGE IN PLUMBING WORK IN THE STATE UNLESS LICENSED TO DO SO BY THE DEPARTMENT OF SAFETY AND PROFESSIONAL SERVICES PER S.145.06.
- 17. SITE CONTRACTOR SHALL LEAVE SANITARY AND WATER LATERALS FIVE (5) FEET SHORT (HORIZONTALLY) FROM THE BUILDING. BUILDING PLUMBER SHALL VERIFY SIZE, LOCATION, AND INVERT ELEVATION OF PROPOSED SANITARY AND WATER LATERALS.
- 18. IT IS THE CONTRACTOR'S RESPONSIBILITY TO VERIFY THAT THE EXISTING VALVES WILL HOLD THE PRESSURE TEST PRIOR TO CONNECTION. THE CITY IS NOT RESPONSIBLE FOR ANY COSTS INCURRED DUE TO THE CONTRACTOR NOT VERIFYING THAT THE EXISTING VALVE WILL HOLD THE PRESSURE TEST PRIOR TO CONNECTION. IF A NEW VALVE IS REQUIRED, THE APPLICANT WILL BE REQUIRED TO INSTALL ONE AT THEIR EXPENSE, AT THE POINT OF CONNECTION.
- 19. CONTRACTOR TO CHLORINATE AND BACTERIA TEST BEFORE DOMESTIC SUPPLY PURPOSES
- 20. CLEAN OUT ALL EXISTING AND PROPOSED STORM INLETS AND CATCH BASINS AT THE COMPLETION OF
- 21. SANITARY SEWER MAIN AT BURY DEPTHS GREATER THAN 15' SHALL BE SDR 21. ALL OTHER SANITARY
- 22. CONTRACTOR SHALL COORDINATE WITH DRY UTILITY COMPANY'S REGARDING ANY POTENTIAL CONFLICTS AND COORDINATE RELOCATIONS AS MAY BE REQUIRED. CONTRACTOR SHALL ALSO COORDINATE THE PROPOSED INSTALLATION OF NEW FACILITIES AS REQUIRED.
- 23. ALL WATER MAIN AND SERVICES SHALL BE INSTALLED AT A MINIMUM DEPTH OF 6.5' FROM TOP OF FINISHED GRADE ELEVATION TO TOP OF MAIN. PROVIDE 1.5' CLEAR SEPARATION IF WATER CROSSES BELOW SEWER AND MINIMUM 0.5' IF WATER CROSSES ABOVE.
- 24. SANITARY MANHOLES WITH SEWER MAIN CONNECTIONS GREATER THAN 2' ABOVE THE LOWEST INVERT SHALL BE CONSTRUCTED WITH AN EXTERNAL DROP. MANHOLES WITH SEWER LATERAL CONNECTIONS GREATER THAT 2' ABOVE THE LOWEST INVERT SHALL BE CONSTRUCTED WITH AN INTERNAL DROP.
- 25. INSTALL 1 SHEET OF 4'x8'x4" HIGH DENSITY STYROFOAM INSULATION AT ALL LOCATIONS WHERE STORM SEWER CROSSES WATER MAIN OR WATER LATERALS.

05/15/2023

Street


C202

DRAFTER

CHECKED TSCH

DPER/MBRA

PROJECT NO. 210421

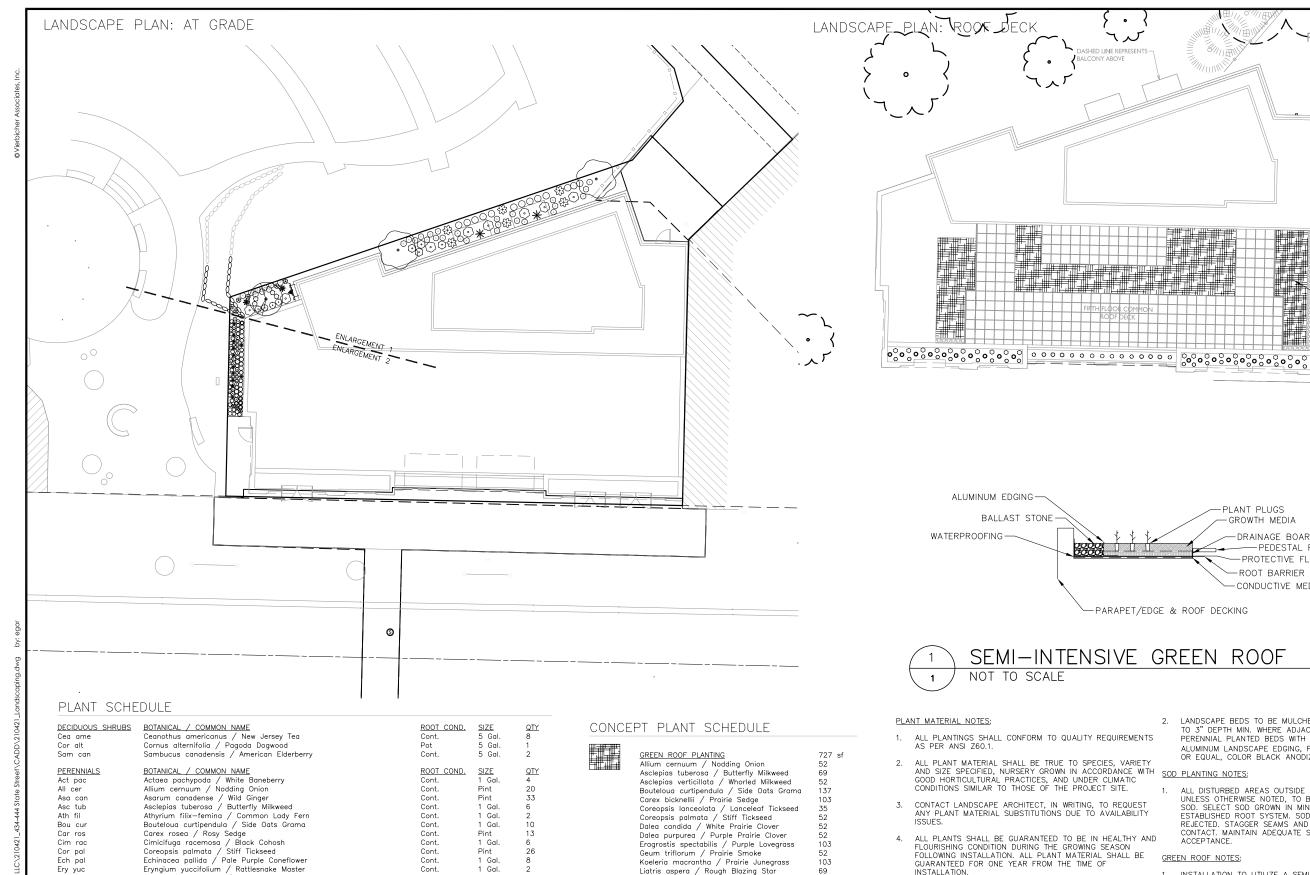

Cont.

Cont.

Cont

Cont.

Cont.

Cont. Cont. 1 Gal.

1 Gal. 1 Gal.

1 Gal.

1 Gal.

Gal.

1 Gal.

1 Gal.

1 Gal. 1 Gal.

Ech pal

Ery yuc

Gér mac Geu tri

Lia pyc

Mon pun

Ono sen Pan vir

Sch sco

Geranium maculatum / Spotted Geranium Geum triflorum / Prairie Smoke

Matteuccia struthiopteris / Ostrich Fern Monarda punctata / Spotted Horsemint Onoclea sensibilis / Sensitive Fern

Parthenocissus quinquefolia engelmannii / Engelmann Virginia Creepe

Liatris aspera / Rough Blazing Star Liatris pycnostachya / Gayfeather

Panicum virgatum / Switch Grass

Polemonium reptans / Greek Valerian

Rudbeckia hirta / Black-eyed Susan

Schizachyrium scoparium / Little Bluestem Sporobolus heterolepis / Prairie Dropseed

2. LANDSCAPE BEDS TO BE MULCHED WITH WHITE CEDAR MULCH TO 3" DEPTH MIN. WHERE ADJACENT TURF GRASS, EDGE PERENNIAL PLANTED BEDS WITH COMMERCIAL GRADE

-PLANT PLUGS

-GROWTH MEDIA

-DRAINAGE BOARD - PEDESTAL PAVERS PROTECTIVE FLEECE ROOT BARRIER

CONDUCTIVE MEDIUM

FLOURISHING CONDITION DURING THE GROWING SEASON FOLLOWING INSTALLATION. ALL PLANT MATERIAL SHALL BE GUARANTEED FOR ONE YEAR FROM THE TIME OF

LANDSCAPE MATERIAL NOTES:

103

205

Liatris aspera / Rough Blazing Star Liatris cylindracea / Cylindrical Blazing Star Lupinus perennis / Wild Lupine Monarda punctata / Spotted Horsemint

Ruellia humilis / Wild Petunia
Schizachyrium scoparium / Little Bluestem

Sporobolus heterolepis / Prairie Dropseed

Symphyotrichum ericoides / Heath Aster

Phlox pilosa / Downy Phlox Rudbeckia hirta / Black-eyed Susan


CONTRACTOR SHALL PROVIDE A SUITABLE AMENDED TOPSOIL BLEND FOR ALL PLANTING AREAS WHERE SOIL CONDITIONS ARE UNSUITABLE FOR PLANT GROWTH. TOPSOIL SHALL CONFORM TO QUALITY REQUIREMENTS AS PER SECTION 625.2(1) OF THE "STANDARD SPECIFICATIONS FOR HIGHWAY CONSTRUCTION." PROVIDE A MINIMUM OF 18" OF TOPSOIL IN ALL PLANTING AREAS AND 6" OF TOPSOIL IN AREAS TO BE

ALUMINUM LANDSCAPE EDGING, PERMALOC CLEANLINE % "X4" OR EQUAL, COLOR BLACK ANODIZED.

ALL DISTURBED AREAS OUTSIDE OF PROPERTY BOUNDARY, UNLESS OTHERWISE NOTED, TO BE REPAIRED WITH TURFGRASS SOD. SELECT SOD GROWN IN MINERAL SOILS WITH ESTABLISHED ROOT SYSTEM. SOD GROWN IN PEAT WILL BE REJECTED. STAGGER SEAMS AND ROLL TO ENSURE SOIL CONTACT. MAINTAIN ADEQUATE SOIL MOISTURE UNTIL FINAL

GREEN ROOF NOTES:

- INSTALLATION TO UTILIZE A SEMI-INTENSIVE VEGETATED ROOFING SYSTEM, HANGING GARDENS SYSTEM #2210 OR EQUAL
- FOLLOW ALL SPECIFICATIONS OUTLINED BY SYSTEM MANUFACTURER.
- MANUFACTURER.
 INSTALL GREEN ROOF PLUG PLANTINGS AS 2" X 2" X 4" OR
 2.25" X 2.25" X 5" DEEP PLUGS, 12" ON CENTER IN A TRIANGULAR GRID PATTERN. PLANT SPECIES IN ODD NUMBERED GROUPS OF 5–9 PLANTS, DISTRIBUTING EACH SPECIES RANDOMLY ACROSS PLANTING AREA FOR NATURAL

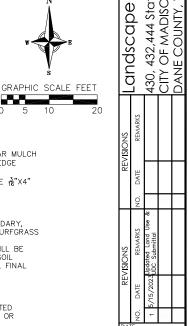

ndscape Plan , 432,444 State Street , OF MADISON NE COUNTY, WI

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vierbic

422 STATE ST


GREEN ROOF PLANTING -BALLAST STONE

5/15/2023

TSCH PROJECT NO. 210421

EGOR

L101

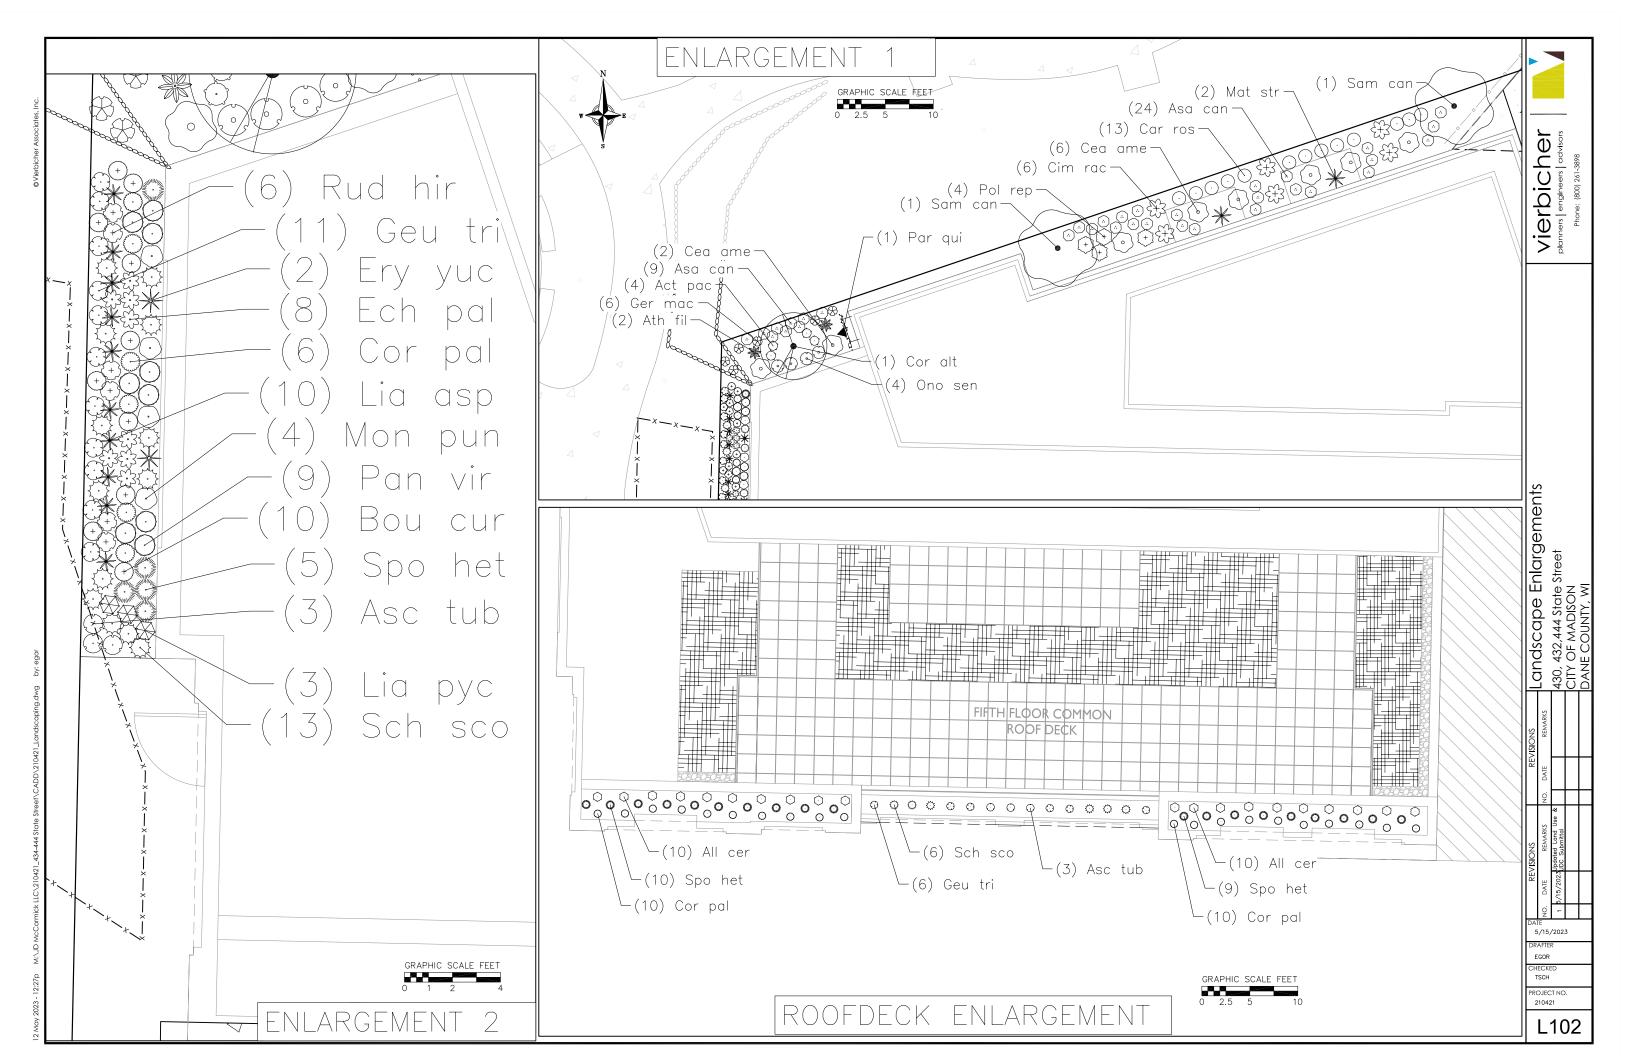



City of Madison Fire Department

314 W Dayton Street, Madison, WI 53703-2506

Phone: 608-266-4420 • Fax: 608-267-1100 • E-mail: fire@cityofmadison.com


Project Address: 430, 432, 444 State Street, Madison, WI	
Contact Name & Phone #: Kevin Burow (608) 575-3126	


FIRE APPARATUS ACCESS AND FIRE HYDRANT WORKSHEET

1. Is the building completely protected by an NFPA 13 or 13R automatic fire sprinkler system? If non-sprinklered, fire lanes extend to within 150-feet of all portions of the exterior wall? If sprinklered, fire lanes are within 250-feet of all portions of the exterior wall?	X Yes Yes X Yes	No No No	N/A N/A N/A
2. Is the fire lane constructed of concrete or asphalt, designed to support a minimum load of 85,000 lbs? a) Is the fire lane a minimum unobstructed width of at least 20-feet? b) Is the fire lane unobstructed with a vertical clearance of at least 13½-feet? c) Is the minimum inside turning radius of the fire lane at least 28-feet? d) Is the grade of the fire lane not more than a slope of 8%? e) Is the fire lane posted as fire lane? (Provide detail of signage.) f) Is a roll-able curb used as part of the fire lane? (Provide detail of curb.) g) Is part of a sidewalk used as part of the required fire lane? (Must support +85,000 lbs.)		☐ No	 N/A N/A N/A N/A N/A N/A N/A N/A N/A
3. Is the fire lane obstructed by security gates or barricades? If yes: a) Is the gate a minimum of 20-feet clear opening? b) Is an approved means of emergency operations installed, key vault, padlock or key switch?	Yes Yes Yes	X No No No	N/A N/A N/A N/A
4. Is the Fire lane dead-ended with a length greater than 150-feet? If yes, does the area for turning around fire apparatus comply with IFC D103?	Yes Yes	X No No	N/A N/A
5. Is any portion of the building to be used for high-piled storage in accordance with IFC Chapter 3206.6 If yes, see IFC 3206.6 for further requirements.	Yes	X No	□ N/A
6. Is any part of the building greater than 30-feet above the grade plane?	X Yes	☐ No	□ N/A
 6. Is any part of the building greater than 30-feet above the grade plane? If yes, answer the following questions: a) Is the aerial apparatus fire lane parallel to one entire side of the building and covering at least 25% of the perimeter? b) Is the near edge of the aerial apparatus fire lane between 15' and 30' from the building? c) Are there any overhead power or utility lines located across the aerial apparatus fire lane? d) Are there any tree canopies expected to grow across the aerial fire lane? (Based on mature canopy width of tree species) 	X Yes X Yes X Yes Yes Yes X Yes	No No No No No No	 N/A N/A N/A N/A N/A
If yes, answer the following questions: a) Is the aerial apparatus fire lane parallel to one entire side of the building and covering at least 25% of the perimeter? b) Is the near edge of the aerial apparatus fire lane between 15' and 30' from the building? c) Are there any overhead power or utility lines located across the aerial apparatus fire lane? d) Are there any tree canopies expected to grow across the aerial fire lane? (Based on mature	X Yes X Yes Yes	☐ No ☐ No ☑ No ☑ No	□ N/A □ N/A □ N/A
If yes, answer the following questions: a) Is the aerial apparatus fire lane parallel to one entire side of the building and covering at least 25% of the perimeter? b) Is the near edge of the aerial apparatus fire lane between 15' and 30' from the building? c) Are there any overhead power or utility lines located across the aerial apparatus fire lane? d) Are there any tree canopies expected to grow across the aerial fire lane? (Based on mature canopy width of tree species) e) Does the aerial apparatus fire lane have a minimum unobstructed width of 26-feet? f) Is the space between the aerial lane and the building free of trees exceeding 20' in heights?	X Yes X Yes Yes X Yes X Yes Yes Yes Yes Yes	☐ No ☐ No ☑ No ☐ No ☐ No ☐ No ☐ No ☑ No	 N/A N/A N/A N/A N/A N/A N/A
If yes, answer the following questions: a) Is the aerial apparatus fire lane parallel to one entire side of the building and covering at least 25% of the perimeter? b) Is the near edge of the aerial apparatus fire lane between 15' and 30' from the building? c) Are there any overhead power or utility lines located across the aerial apparatus fire lane? d) Are there any tree canopies expected to grow across the aerial fire lane? (Based on mature canopy width of tree species) e) Does the aerial apparatus fire lane have a minimum unobstructed width of 26-feet?	X Yes X Yes Yes X Yes X Yes X Yes	☐ No ☐ No ☑ No ☑ No ☐ No ☐ No	 N/A N/A N/A N/A N/A

Attach an additional sheet if further explanation is required for any answers.


This worksheet is based on MGO 34.503 and IFC 2015 Edition Chapter 5 and Appendix D; please see the codes for further information.

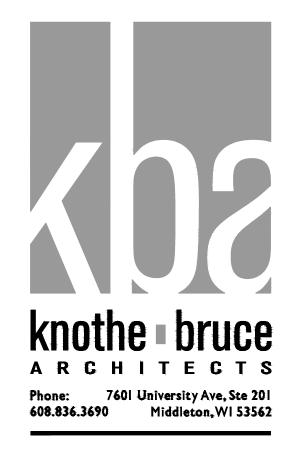

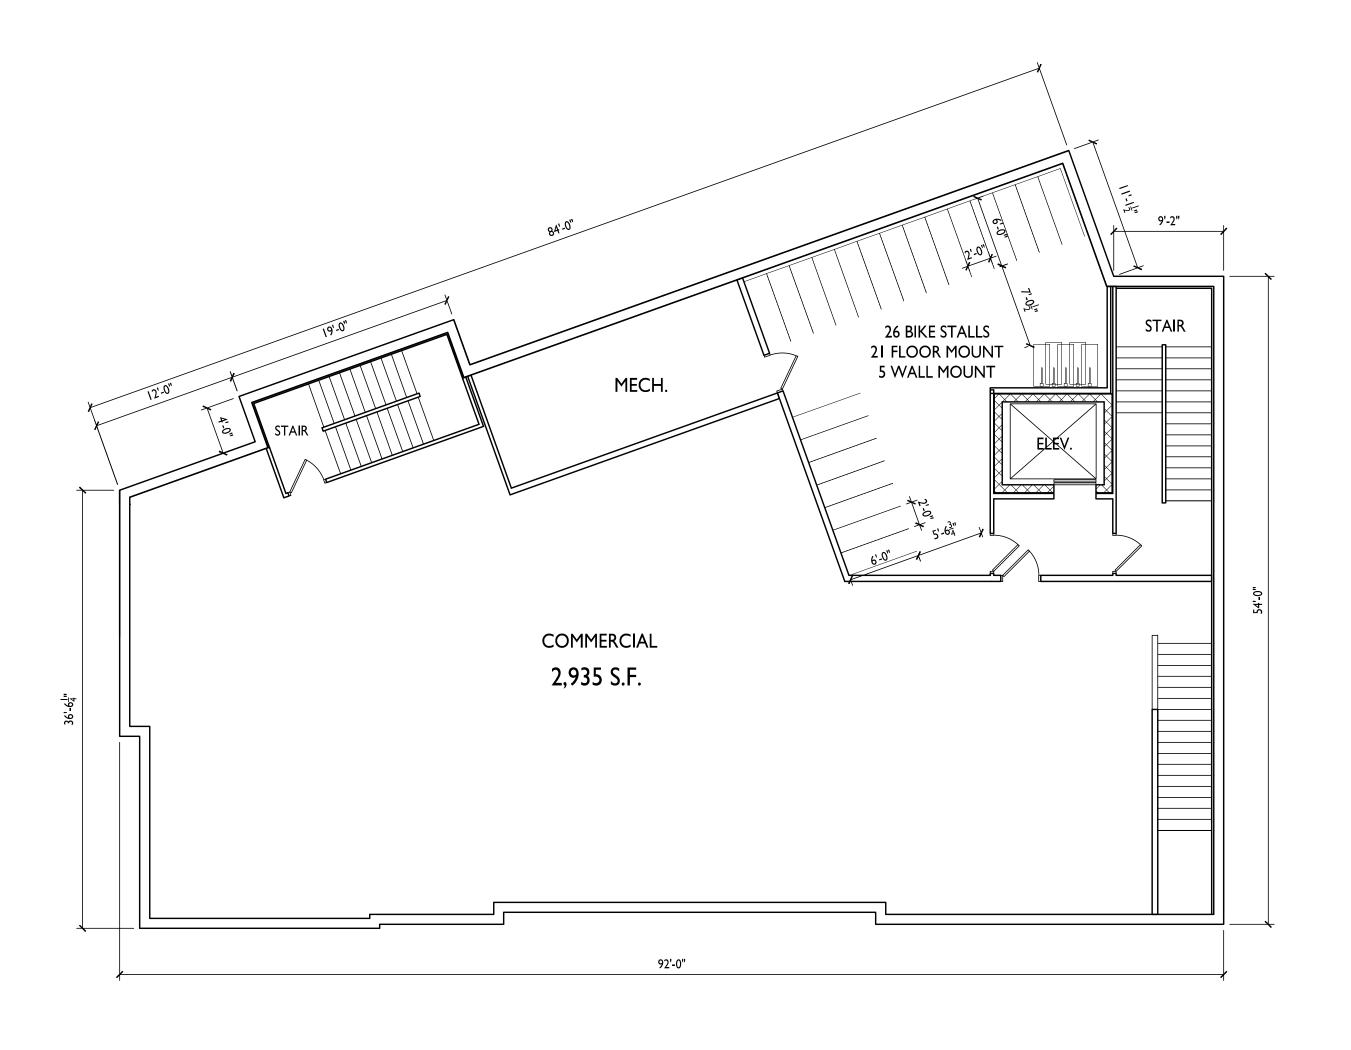

BASEMENT FLOOR PLAN

1/8" = 1'-0"

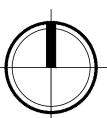

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PROJECT TITLE
430, 432, 444
State Street

Madison, Wisconsin
SHEET TITLE
Basement Floor
Plan


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PROJECT NO.


CT NO. **19**





FIRST FLOOR PLAN

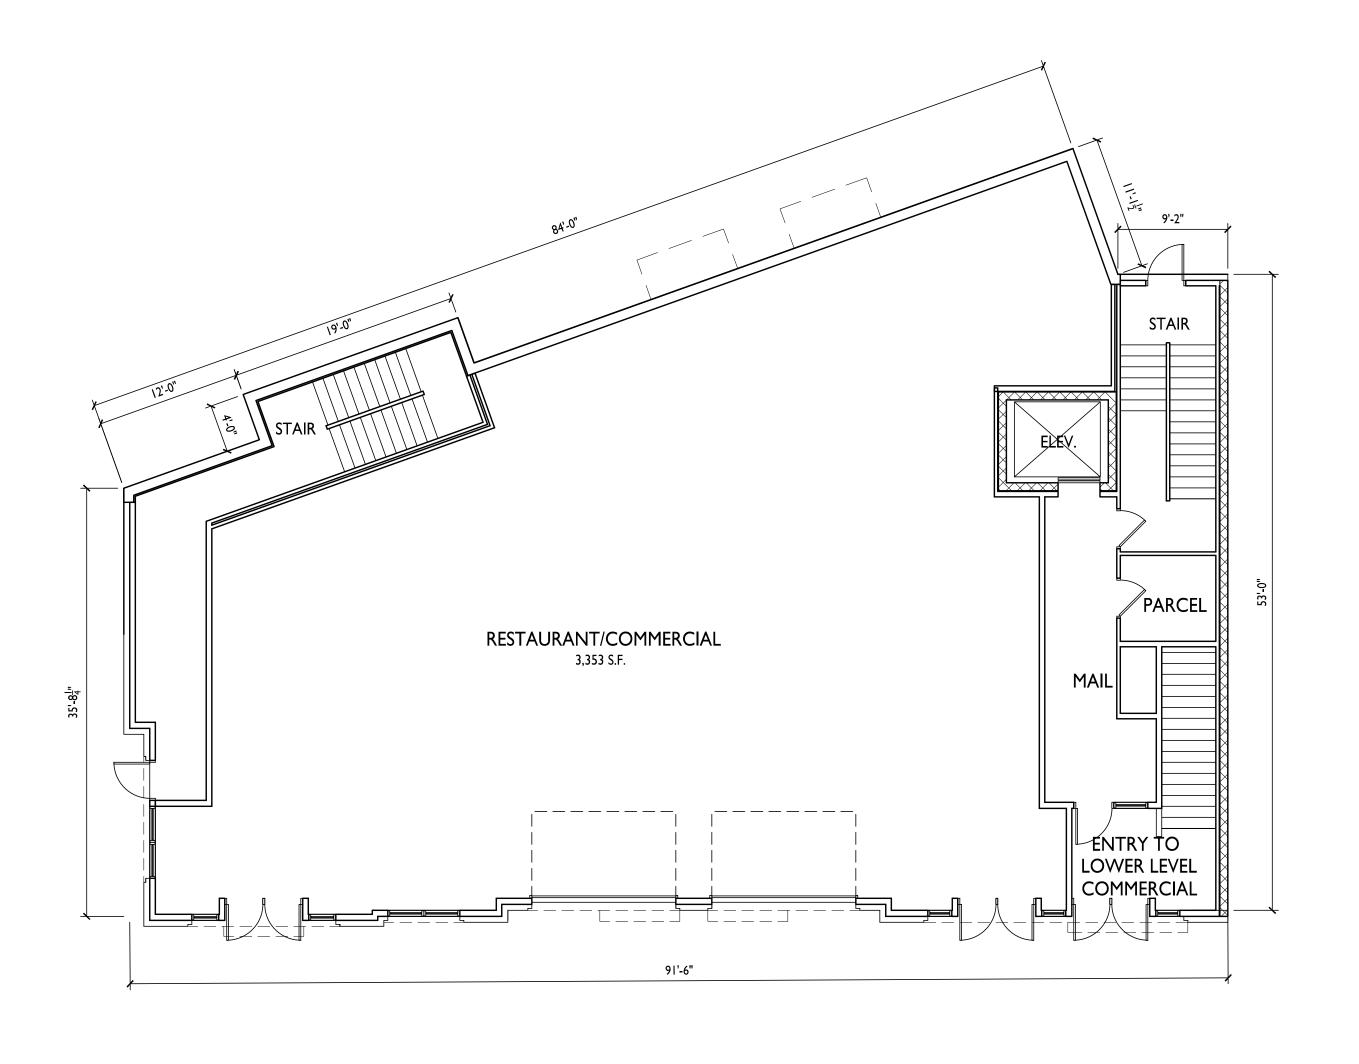1/8" = 1'-0"

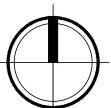

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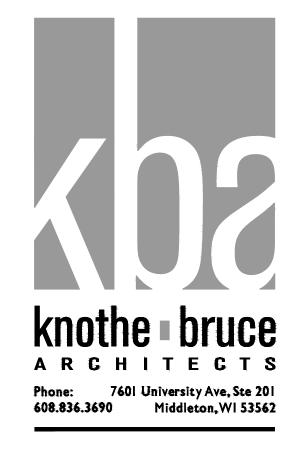
SHEET TITLE
First Floor Plan

SHEET NUMBER



PROJECT NO.


CT NO. 1939



STUDIO STUDIO STUDIO STAIR MECH.

SECOND FLOOR PLAN

1/8" = 1'-0"

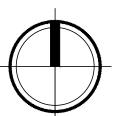

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430, 432, 444
State Street

Madison, Wisconsin

Second Floor Plan


SHEET NUMBER

A-1.2

PROJECT NO.


ECT NO. 1939



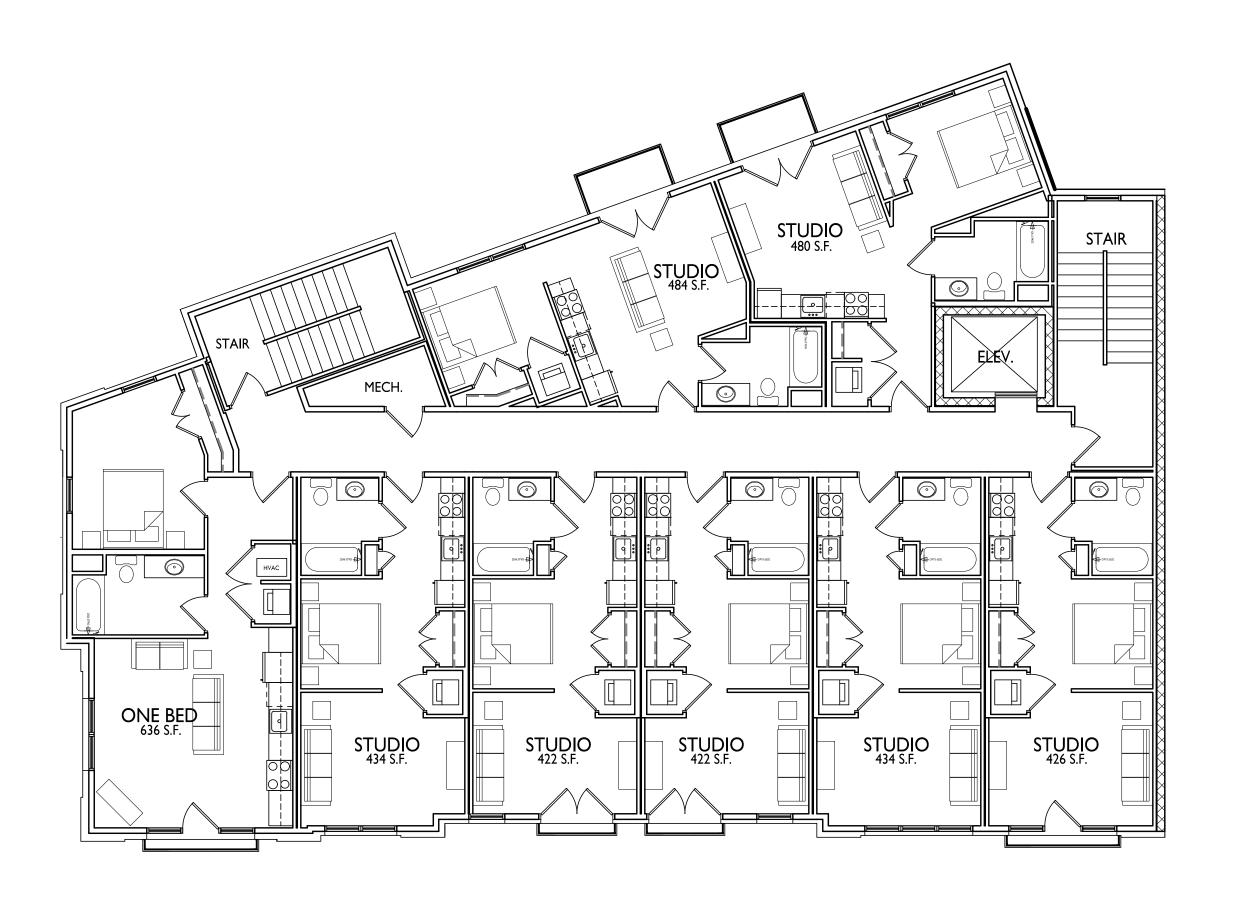

THIRD FLOOR PLAN

1/8" = 1'-0"

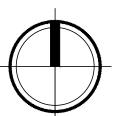

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State Street

Madison, Wisconsin

SHEET TITLE
Third Floor Plan


SHEET NUMBER

A-1.3

PROJECT NO.


ECT NO. 1939



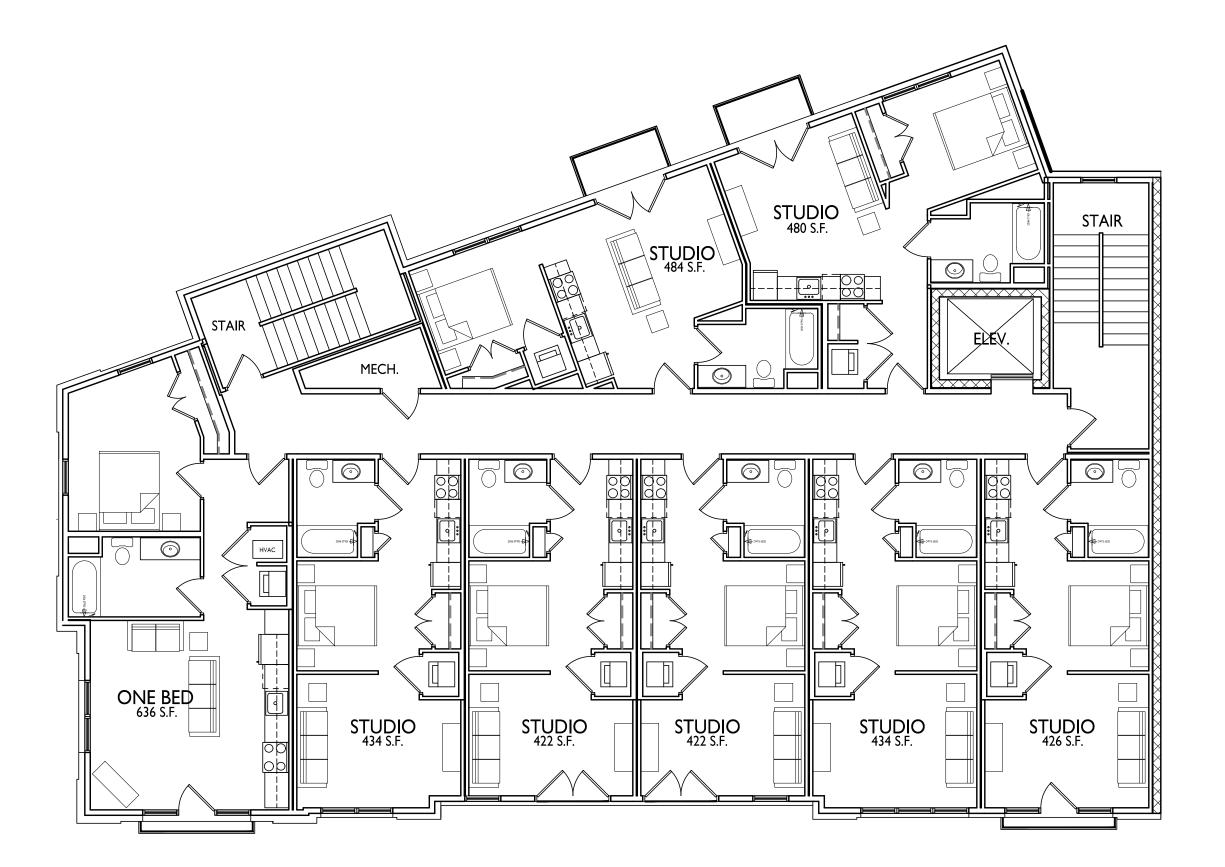

FOURTH FOURTH PLAN

I/8" = I'-0"

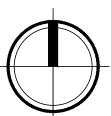

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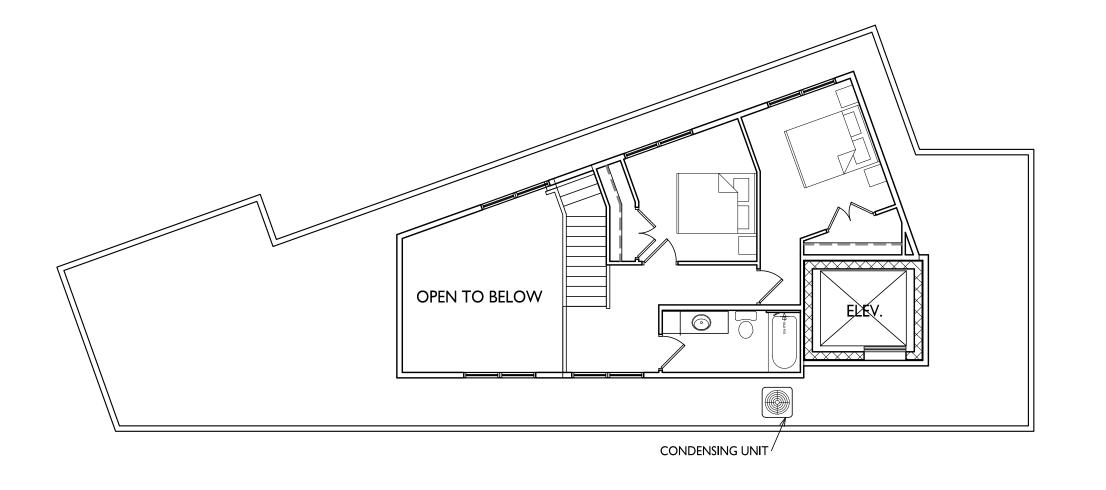
SHEET TITLE
Fourth Floor Plan

SHEET NUMBER




PROJECT NO.

NO. 1939







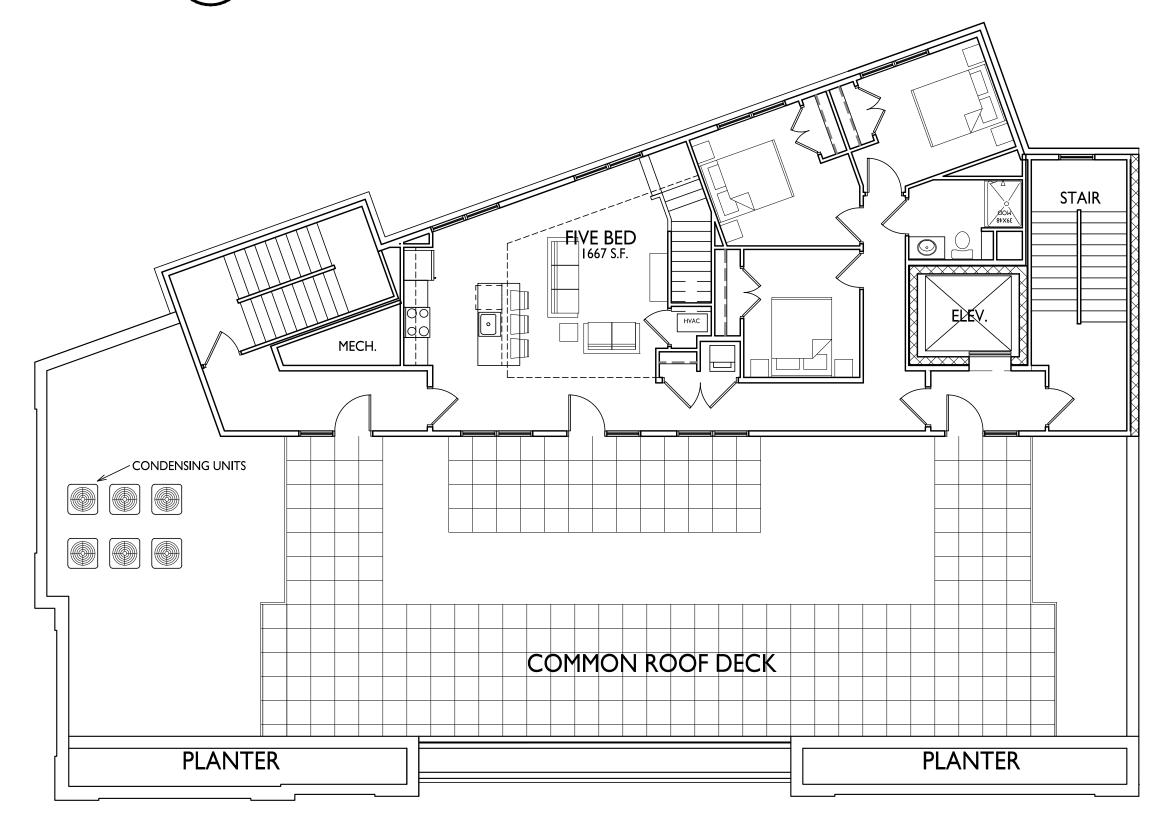

FIFTH FLOOR PLAN

| 1/8" = 1'-0"

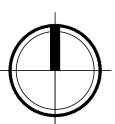

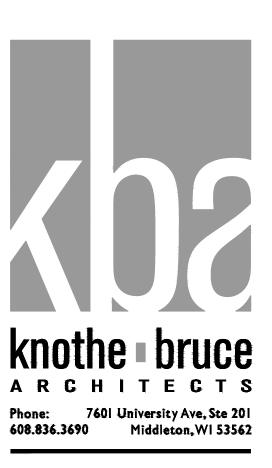

ISSUED

Issued for UDC Informational - Jan. 24, 2022
Land Use & UDC Submittal - February 07, 2022
Updated Land Use & UDC Submittal - May 10, 2022
Updated Land Use & UDC Submittal - Oct. 26, 2022
Updated Land Use & UDC Submittal - Feb. 13, 2023
Updated Land Use & UDC Submittal - May 15, 2023


PROJECT TITLE
430, 432, 444
State Street


Madison, Wisconsin SHEET TITLE
Fifth Floor Plan


SHEET NUMBER

A-1.5

PROJECT NO.

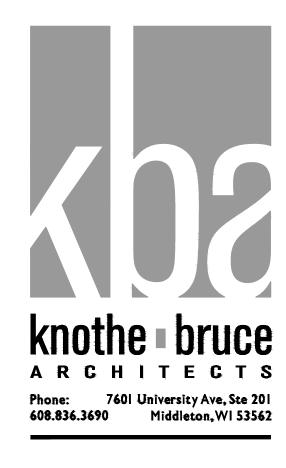

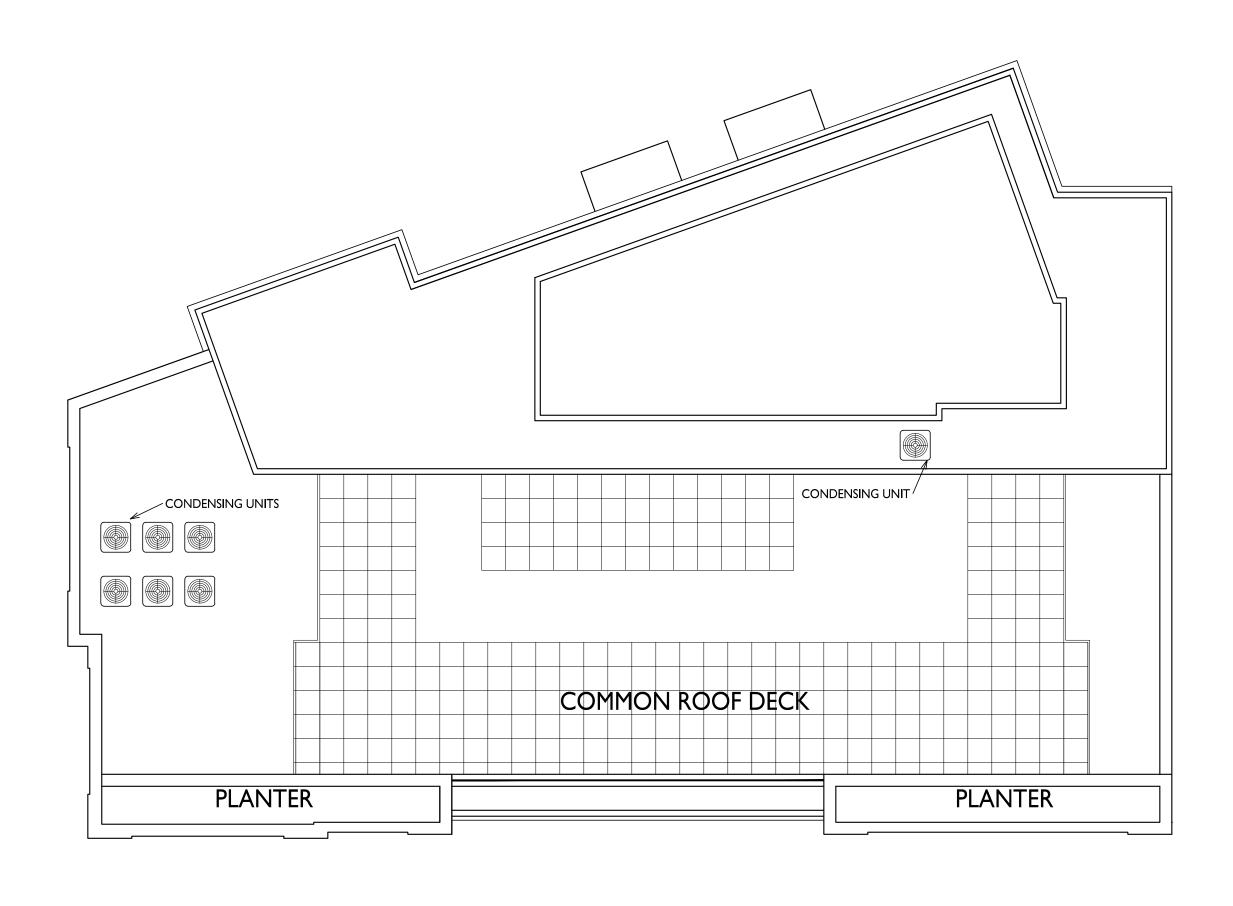

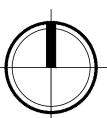

ISSUED

Issued for UDC Informational - Jan. 24, 2022
Land Use & UDC Submittal - February 07, 2022
Updated Land Use & UDC Submittal - May 10, 2022
Updated Land Use & UDC Submittal - Oct. 26, 2022
Updated Land Use & UDC Submittal - Feb. 13, 2023
Updated Land Use & UDC Submittal - May 15, 2023

PROJECT TITLE
430, 432, 444
State Street

Madison, Wisconsin

SHEET TITLE
Roof Plan

SHEET NUMBER

A-1.6

PROJECT NO.



ISSUED

Issued for UDC Informational - January 24, 2022

Land Use & UDC Submittal - February 07, 2022

Lindated Land Use & UDC Submittal - May 10

Updated Land Use & UDC Submittal - May 10, 2022
Updated Land Use & UDC Submittal October 26, 2022
Updated Land Use & UDC Submittal - Febuary

Updated Land Use & UDC Submittal - Fel 13, 2023 Updated Land Use & UDC Submittal - Ma

Updated Land Use & UDC Submittal - May 15, 2023

PROJECT TITLE

State Street
Development

434 - 444 State Street

EXTERIOR ELEVATIONS


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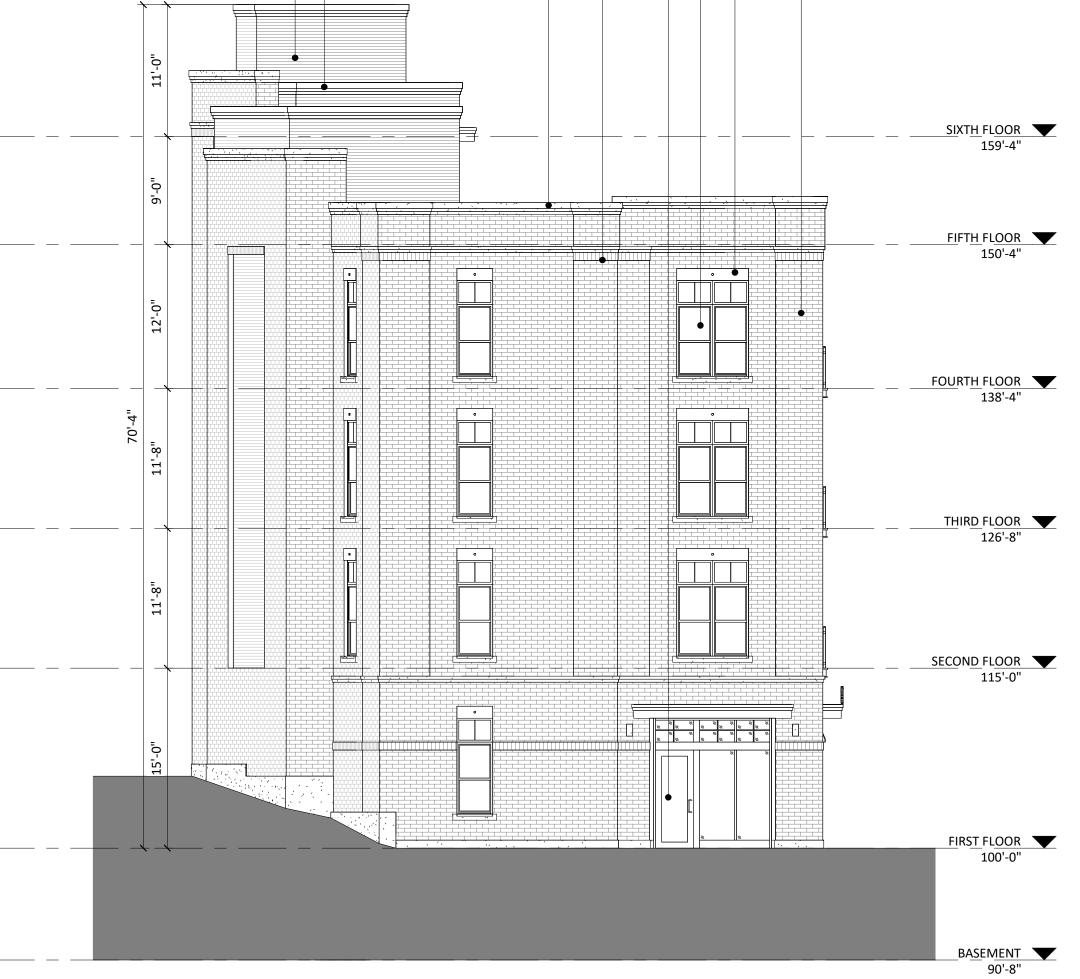
A-2.1

PROJECT NUMBER 1939
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2 ELEVATION - WEST 1/8" = 1'-0"





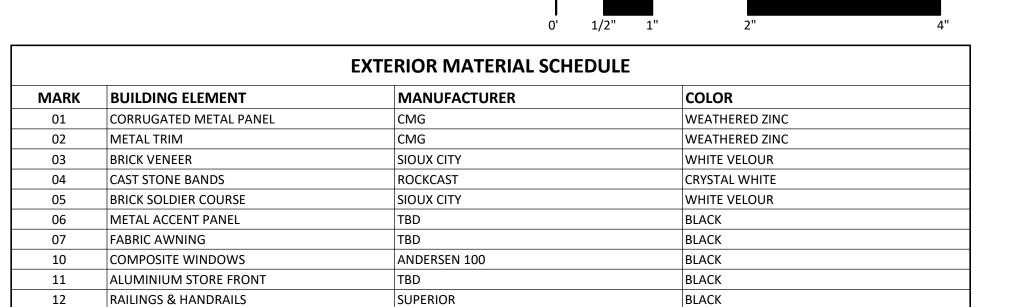

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Updated Land Use & UDC Submittal - May 15,

PROJECT TITLE

State Street Development


434 - 444 State Street SHEET TITLE

EXTERIOR ELEVATIONS

SHEET NUMBER


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1/8" = 1 '- 0"

2 ELEVATION - EAST A-2.2 1/8" = 1'-0"

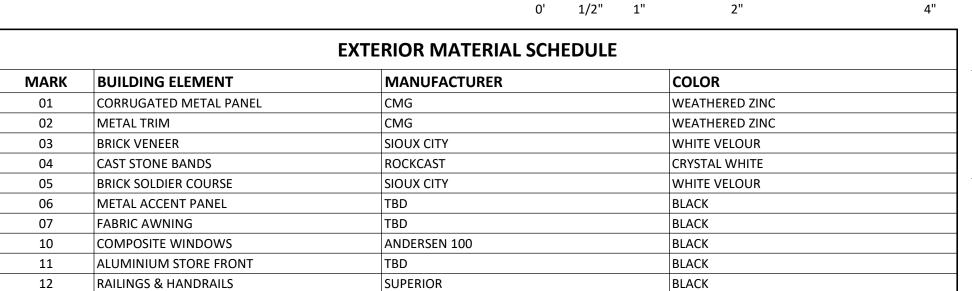

13, 2023

2023

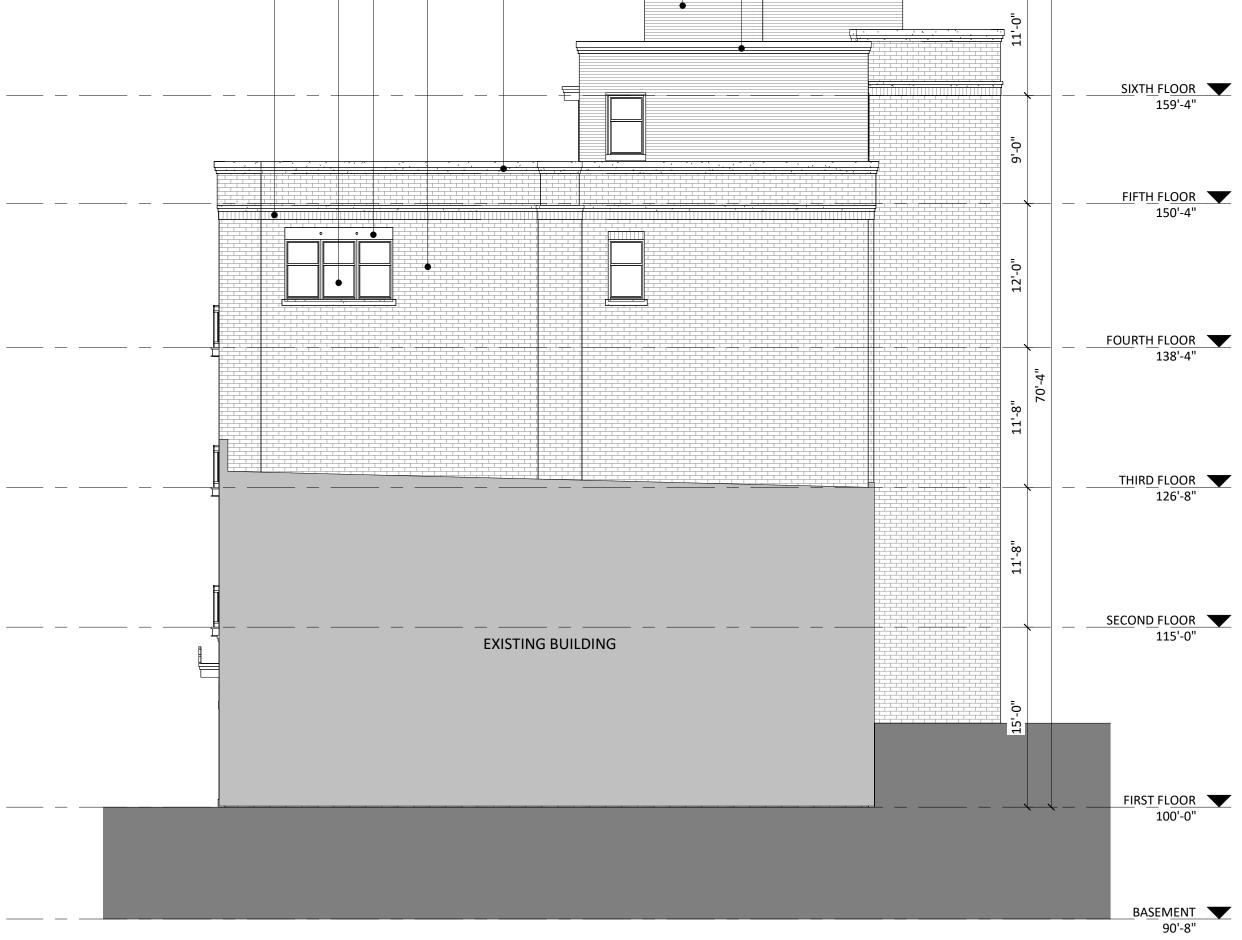State Street

Development

Updated Land Use & UDC Submittal - Febuary

Updated Land Use & UDC Submittal - May 15,

434 - 444 State Street
SHEET TITLE
EXTERIOR
ELEVATIONS

SHEET NUMBER


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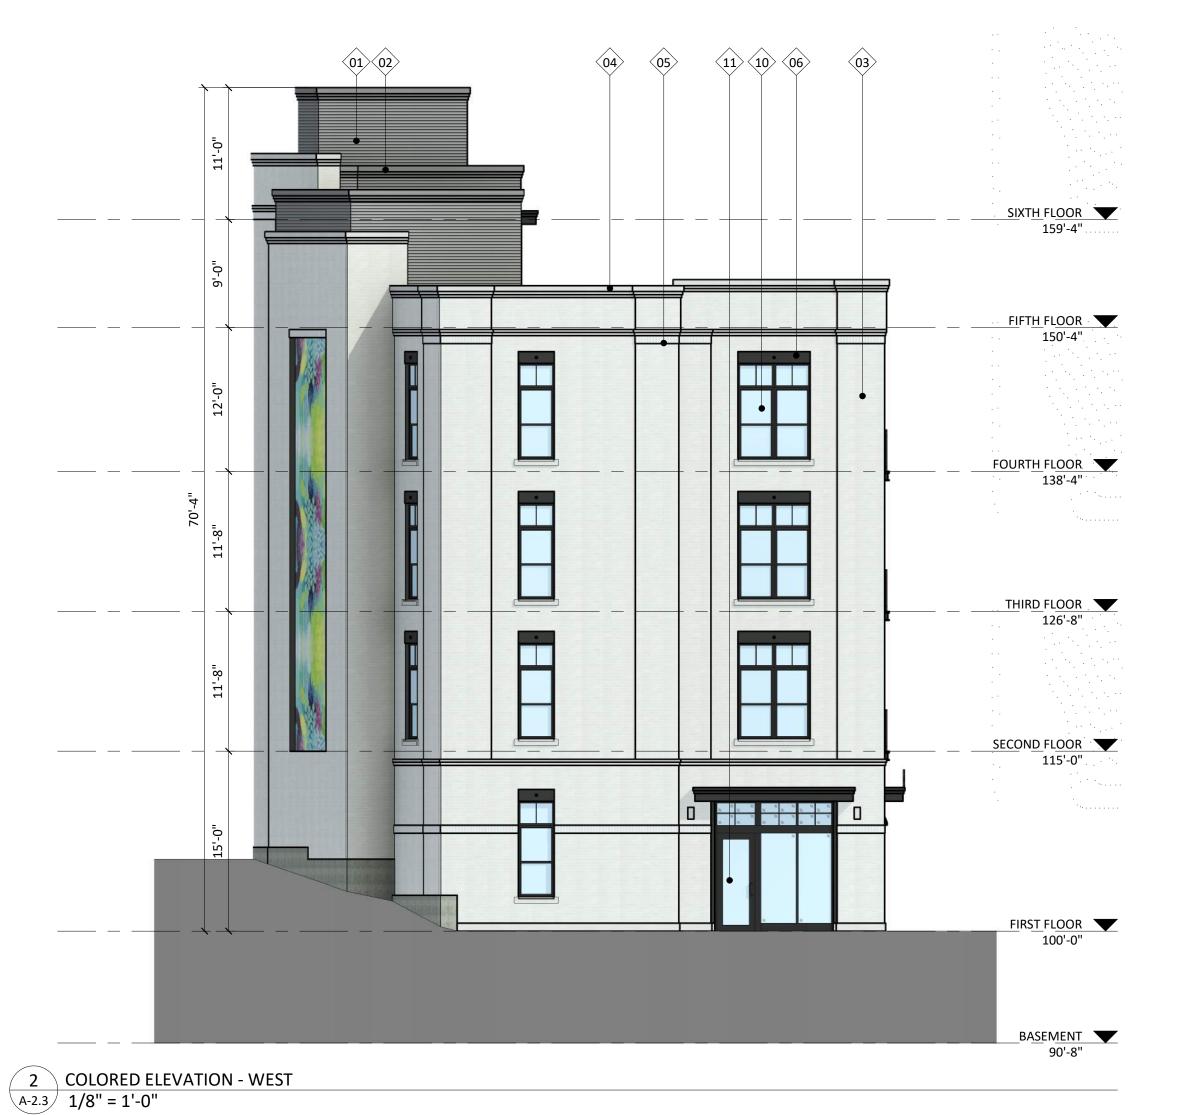
A-2.3

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1 COLORED ELEVATION - SOUTH
A-2.3 1/8" = 1'-0"





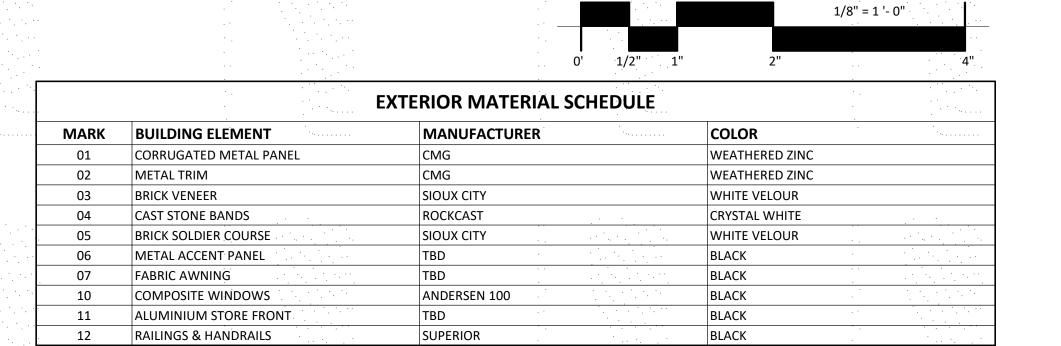

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Updated Land Use & UDC Submittal - Febuary 13, 2023
Updated Land Use & UDC Submittal - May 15, 2023

PROJECT TITLE

State Street Development

434 - 444 State Street
SHEET TITLE

EXTERIOR
ELEVATIONS
COLORED


SHEET NUMBER

BASEMENT \

A-2.4

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BLACK

2 COLORED ELEVATION - EAST 1/8" = 1'-0"

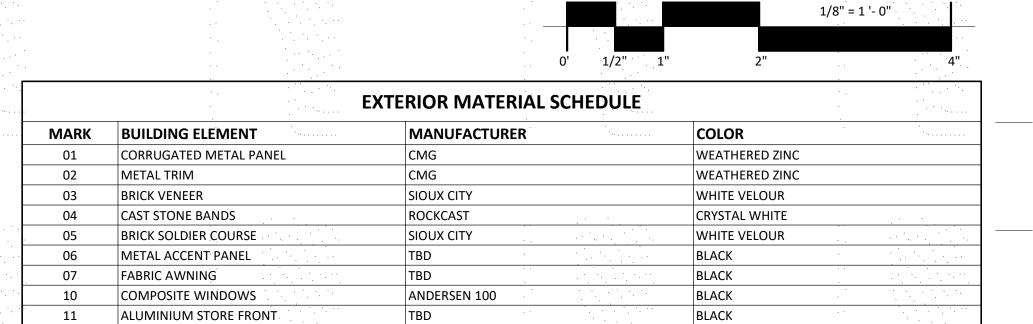SUPERIOR

RAILINGS & HANDRAILS

























