

526 PINNEY STREET MADISON, WI 53714

ROYSTER LOT 60



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SITE

C100 SITE PLAN

C200 GRADING & EROSION CONTROL PLAN

C300 UTILITY PLAN

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E200 SITE LIGHTING PHOTOMETRIC PLAN

ARCHITECTURAL

100 LL & 1ST FLR PLAN 101 2ND & 3RD FLR PLAN 102 4TH FLR & ROOF PLAN 200 EXTERIOR ELEVATIONS

A201 EXTERIOR ELEVATIONS

300 BUILDING SECTIONS

A900 EXTERIOR RENDERING
A901 EXTERIOR RENDERING


A902 EXTERIOR RENDERING

A903 EXTERIOR RENDERING

904 MATERIAL BOARD



06/12/2023 PROJECT NUMBER: 723129-01

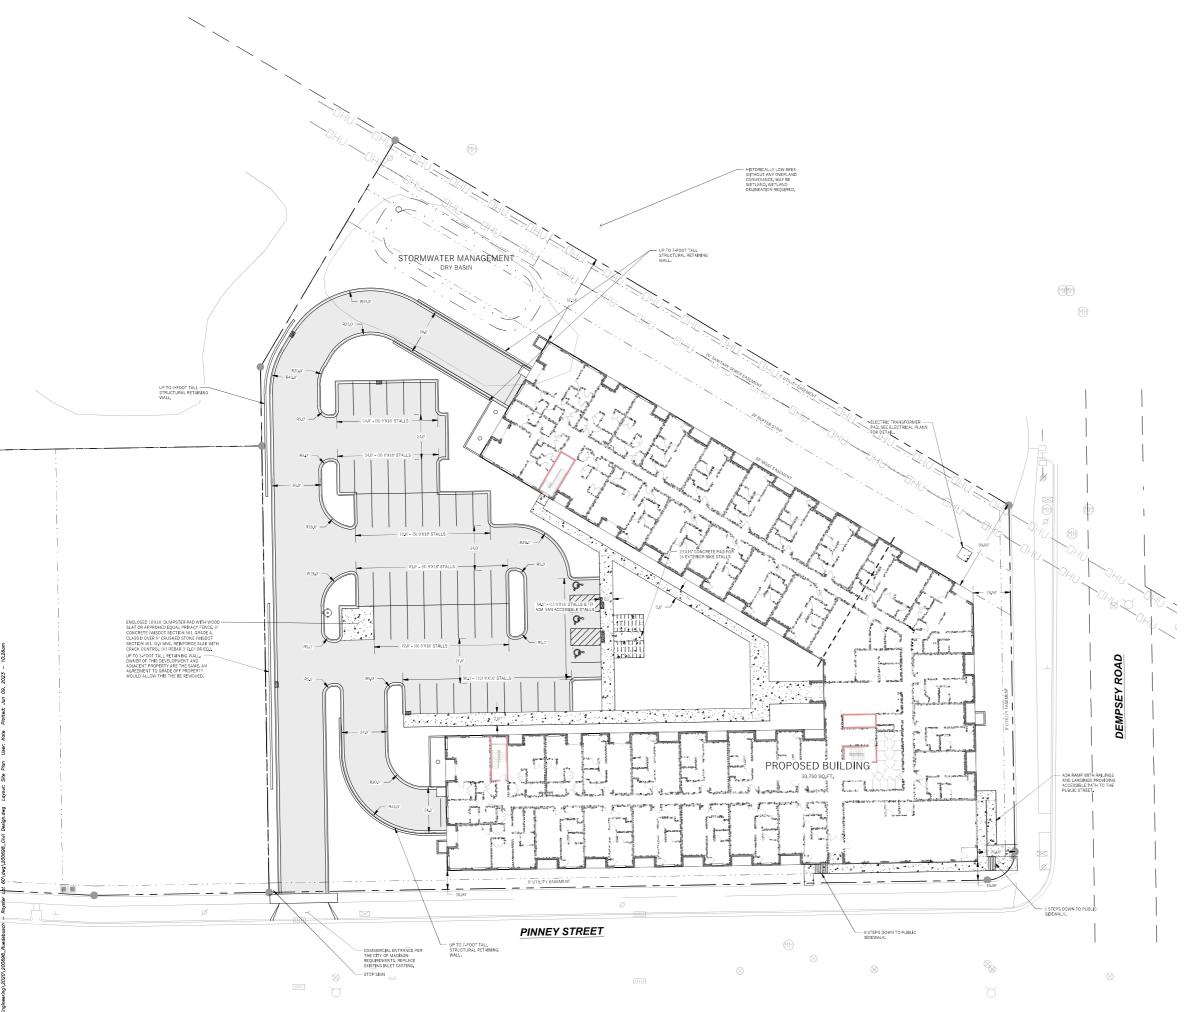



GENERAL NOTES

SITE INFORMATION BLOCK:
SITE ADDRESS: 526 PINNEY STREET
SITE ACREAGE: 122,642 SQ.FT. (2,92 AC)
USE OF PROPERTY: MULTIFAMILY RESIDENTIAL
ZONING: TRADITIONAL EMPLOYMENT (TE)

SETBACKS: FRONT YARD: 0-FEET (PINNEY STREET) SIDE YARD: 0-FEET (DEMPSEY ROAD) SIDE YARD: 10-FEET (WEST ZONED TR-UZ) REAR YARD: 20-FEET

JMBER OF BEDROOMS: 156 2 BEDROOM OR LESS: 156 3 BEDROOM: 0 JMBER OF DWELLINGS: 138

ARKING MAXIMUM: 7.5 PER DIWELLING — 345 OTAL NUMBER OF PARKING STALLS: 154 UMBER OF STALLS DESIGNATED ACCESSIBLE: 4 SURFACE PARKING STALLS: 51 SURFACE ADA PARKING STALLS: 10 UNDERGROUND PARKING STALLS: 103

EV STALLS REQUIRED: 2% OF TOTAL = 3.1 EV STALLS PROVIDED: 4 EV READY STALLS REQUIRED: 10% OF TOTAL = 15.4 EV READY STALLS PROVIDED: 16

EVERDUS STALIS PROVIDED. 18

BIKE STALLS REQUISED: 19 FEB UNT UP TO 2 BEDROOM + 1 PER
ADDITIONAL BEDROOM + 1 GUEST STALL PER 10 UNITS = 152

TOTAL NUMBER OF PIEK STALLS: 1322

SURFACE SHORT TERM BIKE STALLS (GUEST STALLS): 16

INTERIOR LOWN STEM BIKE STALLS (GIM 90) GO TOTALL: 1:

EXISTING IMPERINDUS SURFACE AREA: 0 SQ.FT.




CITY OF MADISON, DANE COUNTY, WI Sheet Title: SITE PLAN

ROYSTER CORNERS - LOT 60

Revisions:
No. Date: Description:

	Number	20-0698
DIGGERG V MOTILUE	Set Type	SCHEMATIC DESIG
<u>uieeths 🕹 Huilint</u>	Date Issued	06/09/2023
Toll Free (800) 242-8511 -or- 811 Hearing Impaired TDD (800) 542-2289 www.DiggersHotline.com	Sheet Number	C100

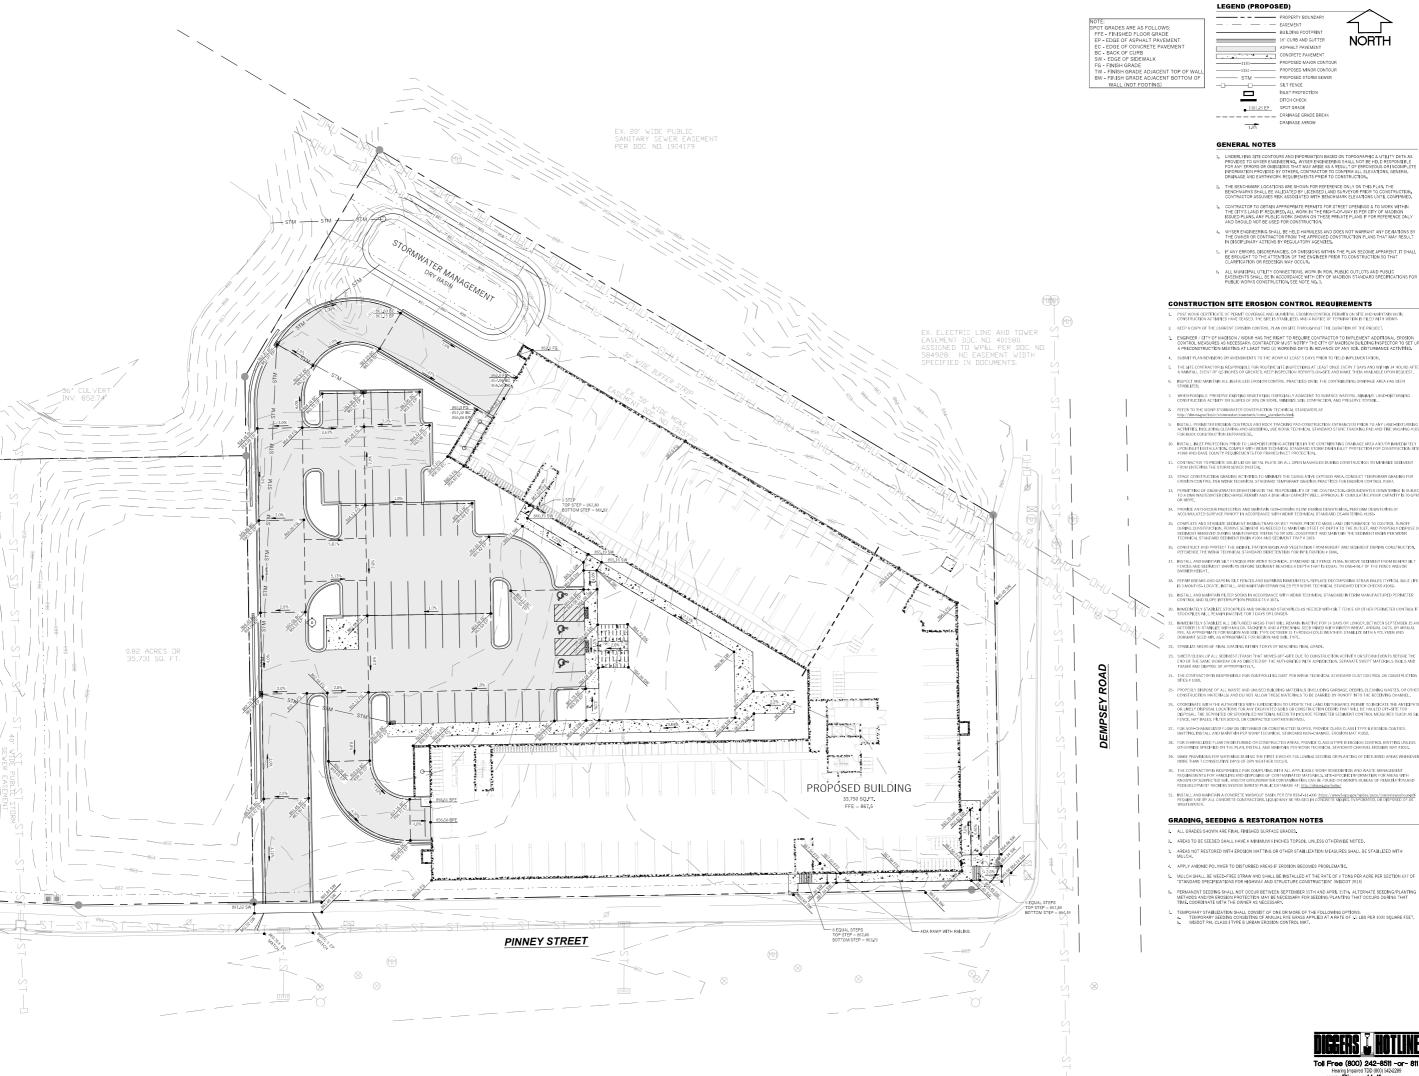



NORTH PROPOSED MAJOR CONTOU

WYSER

1181 PROPOSED MINOR CONTOUR SILT FENCE

SILT FENCE
INLET PROTECTION
DITCH CHECK

1181.25 EP
DRAIMAGE GRADE BREAK
DRAIMAGE ARROW

- I. UNDERLYING SITE CONTOURS AND INFORMATION BASED ON TOPOGRAPHIC & UTILITY DATA AS PROVIDED TO WYSEE RUMINEERING. WYSEE RUMINEERING SHALL, NOT BE HELD RESPONSIBLE FOR ANY ERRORS OR OMISSIONS THAT MAY ARRISE AS RESULT OF ERRORDUS OR HOUSEAST HAN FACIORS TO CONFIRM ALL BLEVATIONS, GENERAL PROBABAGE AND EASTMOOTH REQUIREMENTS PRIPE TO CONFIRM ALL BLEVATIONS, GENERAL DEPARTMENT AND EASTMOOTH REQUIREMENTS PRIPE TO CONSTRUCTION.
- THE BENCHMARK LOCATIONS ARE SHOWN FOR REFERENCE ONLY ON THIS PLAN. THE BENCHMARKS SHALL BE VALIDATED BY LICENSED LAND SURVEYOR PRIOR TO CONSTRE CONTRACTOR ASSUMES RISK ASSOCIATED WITH BENCHMARK ELEVATIONS UNTIL CON
- 4. WYSER ENGINEERING SHALL BE HELD HARMLESS AND DOES NOT WARRANT ANY DEVIATIONS B THE OWNER OR CONTRACTOR FROM THE APPROVED CONSTRUCTION PLANS THAT MAY RESULT IN DISCIPLINARY ACTIONS BY REGULATORY AGENCIES.

- POST WIDNE CERTIFICATE OF PERMIT COVERAGE AND MUNICIPAL EROSION CONTROL PERMITS ON SITE AND MAINTAIN UNTIL CONSTRUCTION ACTIVITIES HAVE CEASED, THE SITE IS STABILIZED, AND A NOTICE OF TERMINATION IS FILED WITH WIDNE.
- 2. KEEP A COPY OF THE CURRENT EROSION CONTROL PLAN ON SITE THROUGHOUT THE DURATION OF THE PROJECT.

- 5. THE SITE CONTRACTOR IS RESPONSIBLE FOR ROUTINE SITE INSPECTIONS AT LEAST ONCE EVERY 7 DAYS AND WITHIN 24 H A RAINFALL EVENT OF 0.5 INCHES OR GREATER. KEEP INSPECTION REPORTS ON-SITE AND MAKE THEM AVAILABLE UPON RI
- INSPECT AND MAINTAIN ALL INSTALLED EROSION CONTROL PRACTICES UNTIL THE CONTRIBUTING DRAINAGE AREA HAS BEEN STABILIZED.
- WHEN POSSIBLE: PRESERVE EXISTING VEGETATION (ESPECIALLY ADJACENT TO SURFACE Y
 CONSTRUCTION ACTIVITY ON SLOPES OF 20% OR MORE, MINIMIZE SOIL COMPACTION, AND

- 16. CONSTRUCT AND PROTECT THE BIDINFILTRATION BASIN AND VEGETATION FROM RUNOF REFERENCE THE WIDNET ECHNICAL STANDARD BIORETENTION FOR INFILTRATION # 1004.
- INSTALL AND MAINTAIN SILT FERCING PER WORR TECHNICAL STANDARD SILT FERCE #1056. F FERCES AND SEDIMENT BARRIERS BEFORE SEDIMENT REACHES A DEPTH THAT IS EQUAL TO BARRIER HIGHT.
- INSTALL AND MAINTAIN FILTER SOCKS IN ACCORDANCE WITH IVDNR TECHNICAL STANDARD INTERIM MANUFACTURED PERIMETER CONTROL AND SLOPE INTERRUPTION PRODUCTS # 1071.
- M. IMMEDIATELY STABILIZE STOCKPILES AND SURROUND STOCKPILES AS NEEDED WITH SILT FENCE OR OTHER PERIMET STOCKPILES WILL REMAIN INACTIVE FOR 7 DAYS OR LONGER.
- 22. STABILIZE AREAS OF FINAL GRADING WITHIN 7 DAYS OF REACHING FINAL GRADE.

- 25. PROPERLY DISPOSE OF ALL WASTE AND UNUSED BUILDING MATERIALS (INCLUDING GARBAGE, DEBRIS, CLEANING WASTES, OR OTHE CONSTRUCTION MATERIALS) AND DO NOT ALLOW THESE MATERIALS TO BE CARRIED BY RUNOFF INTO THE RECEIVING CHANNEL.

- FOR NON-CHANNELIZED FLOW ON DISTURBED OR CONSTRUCTED SLOPES, PROVIDE CLASS CLASS MATTING, INSTALL AND MAINTAIN PER WORR TECHNICAL STANDARD NON-CHANNEL EROSION MA

3). INSTALL AND MAINTAIN A CONCRETE WASHOUT BASIN PER EPA 833-F-11-06: https://www3-epa.gov/ingdes/pub/concretewashout.pdf. PEQUIRE USE BY ALL CONCRETE CONTRACTORS. LIQUID MAY BE REUSED IN CONCRETE MIXING, EVAPORATED, OR DISPOSED OF AS WASTEWARD.

GRADING, SEEDING & RESTORATION NOTES

- 2. AREAS TO BE SEEDED SHALL HAVE A MINIMUM 6 INCHES TOPSOIL UNLESS OTHERWISE NOTED.
- 4. APPLY ANIONIC POLYMER TO DISTURBED AREAS IF EROSION BECOMES PROBLEMATIC.

- TEMPORARY STABILIZATION SHALL CONSIST OF ONE OR MORE OF THE FOLLOWING OPTIONS:
 TEMPORARY SEEDING CONSISTING OF ANNUAL RYE GRASS APPLIED AT A RATE OF 1.5 LBS PER 10
 WISDOT PAL CLASS IT TYPE B URBAN EROSION CONTROL MAT.



6/09/2023 C200

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COUNTY,

DANE

MADISON,


OF

CITY (Sheet Title: GRADING

9

CORNERS

ROYSTER

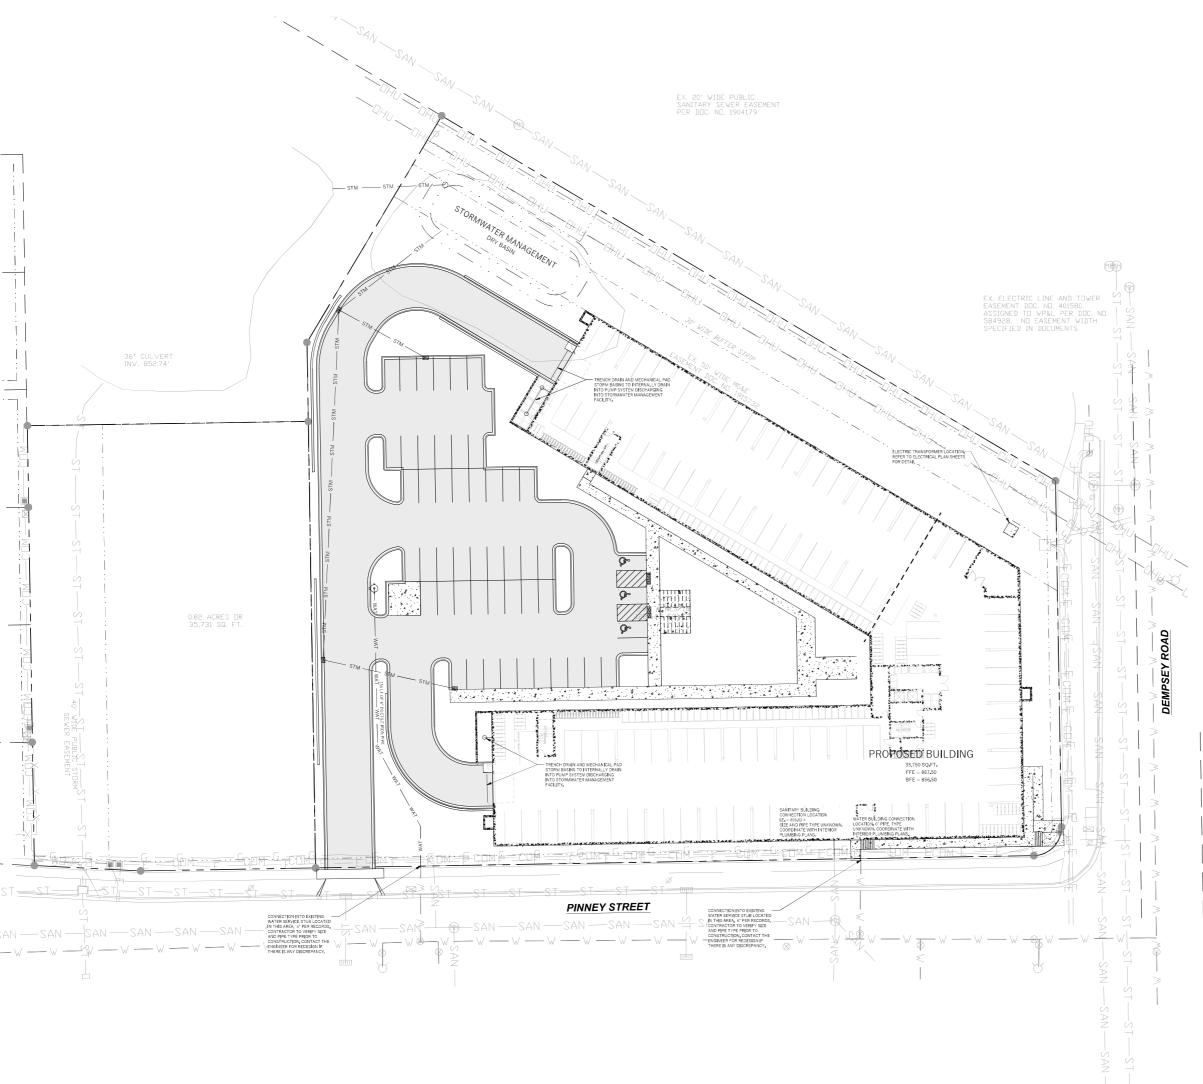

LEGE

END (PROPO	SED)	
	PROPOSED PROPERTY BOUNDARY	
	EASEMENT	
	BUILDING FOOTPRINT	
	18" CURB AND GUTTER	NORTH
	ASPHALT PAVEMENT	11011111
A	CONCRETE PAVEMENT	
WAT	PROPOSED WATER MAIN	
- SAN	PROPOSED SANITARY SEWER	

STM PROPOSED STORM SEWER
GAS PROPOSED GAS SERVICE (DESIGN BY OTHERS) E PROPOSED MAS SERVICE LICENSE OF OTHERS)

STORMWATER TREATMENT FACILITY

DRAINAGE GARDE BREAK

1,0%
DRAINAGE ARROW

GENERAL NOTES

- THE BENCHMARK LOCATIONS ARE SHOWN FOR REFERENCE ONLY THIS PLAN, THE BENCHMARKS SHALL BE VALIDATED BY LICENSED LAND SURVEYOR PRIOR TO CONSTRUCTION CONTRACTOR ASSUMES RISK ASSOCIATED WITH BENCHMARK ELEVATIONS UNTIL CONF
- CONTRACTOR TO OSTAIN APPROPRIATE PERMITS FOR STREET OPENINGS & TO WORK WITHIN THE CITY'S LAND IT REQUIRED, ALL WORK IN THE RIGHT-OF-WAY IS PER CITY OF MADISON ISSUED PLANS, ANY PUBLIC WORKS HOWN ON THESE PRIVATE PLANS IF FOR REFERENCE ONLY AND SHOULD NOT BE USED FOR CONSTRUCTION.
- IF ANY ERRORS, DISCREPANCIES, OR OMISSIONS WITHIN THE PLAN BECOME APPARENT, IT SHA BE BROUGHT TO THE ATTENTION OF THE ENGINEER PRIOR TO CONSTRUCTION SO THAT CLARIFICATION OR REDESIGN MAY OCCUR.

UTILITY NOTES

- DIMENSIONS TAKE PRECEDENCE OVER SCALE, CONTRACTOR TO VERIFY ALL DIMENSIONS IN FIELD.
- LENGTHS OF ALL UTILITIES ARE TO CENTER OF STRUCTURES OR FITTINGS AND MAY VARY SLIGHTLY FROM PLAN. LENGTHS SHALL BE VERIFIED IN THE FIELD DURING CONSTRUCTION.
- CONTRACTOR SHALL VERIFY ALL ELEVATIONS, LOCATIONS, AND SIZES OF SANITARY, WATER AND STORM LATERALS AND CHECK ALL UTILITY CROSSINGS FOR CONFLICTS.
- 4. THE PROPOSED IMPROVEMENTS MUST BE CONSTRUCTED IN ACCORDANCE WITH ENGINEERING PLANS DESIGNED TO MEET ORDINANCES AND REQUIREMENTS OF THE MUNICIPALITY AND WISDOS, AND WORK.

- WISDOT, WISDISPS, AND WORK,
 PARIOT TO CONSTRUCTION THE CONTRACTOR IS RESPONSIBLE FOR:

 EXAMINING A LL SITES CONDITIONS RELATIVE TO THE CONDITIONS INDICATED ON THE
 ENGINEERING DRAWINGS, ANY DISCERPANCES AND TO BE REPORTED TO THE ENGINEER
 AND RESOLVED PRIOR TO THE START OF CONSTRUCTION.
 OSHANING ALL PERMITS INCLUDING FERMIT COSTS, AFF EES, METER DEPORTS, SONDS,
 OSHANING ALL PRIVATIONS AND INSTRUME SHADEST OF ANY DISCREPANCY, NO
 WORK SHALL DEPREMEND WITH THE DESCRIPTION OF SHAY DISCREPANCY.
 NOTIFYING ALL UTILITIES PRIOR TO THE INSTALLATION OF ANY UNDERGROUND
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 CONSTRUCTION OF ORBING OF THE APPROPRIATE CONSTRUCTION OSSERVATION.

- THE CONTRACTOR IS RESPONSIBLE FOR PROVIDING THE ENGINEER WITH AS-BULT.
 CONDITIONS OF THE DESIGNATED IMPROVEMENTS IN ORDER THAT THE APPROPRIATE DAMINISS ON AD INTERMEDIATE OF THE PROPRIATE DAMINISS ON AD INTERMEDIATE OF THE PROPRIATE OF THE
- ANY SANTARY SEIVER, SANTARY SEIVER SERVICES, WATER MAIN, WATER SERVICES, STORM SEIVER, OR OTHER UTLITIES, WHICH ARE DANAGED BY THE CONTRACTORS, SHALL BE REPARKED TO THE OWNERS SATISFACTION AT THE CONTRACTOR'S EXPENSE, NO BLASTING IS ALLOWED WITHIN 30 FEET OF EXISTING UTLITIES,
- 11. ALL PRIVATE INTERCEPTOR WATER MAIN AND WATER SERVICES SHALL BE INSTALLED WITH A MINIMUM BURY, PROVIDE INSULATION ABOVE PIPES WITH LESS THAN 5' OF GROUND COVER.
- 12. GRANLAR BACKEL MATERIALS ARE REQUIRED HALL VILLY TRENVELS UNDER SOCIALIZATION AND PROPOSED PREVE AREAS UNLESS OFFENDRES RECEPTED BY A GEOTEMBOL. BENEVERS, ALL UTLIFY TERROR BACKELL SHALL BE COMPACTED PER SPECIFICATIONS, ALL PAYMENTS PATCHING SHALL COMPACT OF PERSON PROPERTY OF MATERIAL STANDARD SPECIFICATIONS FOR PUBLIC WORKS CONSTRUCTION, ADDITIONAL PAYMENT MILLING AND OVERLAY MAY BE EXQUIRED BY PERIOR.
- CONTRACTOR SHALL NOTIFY THE MUNICIPAL PUBLIC WORKS DEPARTMENT A MINIMUM OF 48 HOURS BEFORE CONNECTING TO PUBLIC UTILITIES.
- ALL NON-INSTALLIC BUILDING SEWER AND WATER SERVICES MUST BE ACCOMPANIED BY MEANS OF LOCATING UNDERGROUND PIPE, TRACER WIRE VALVE BOXES SHALL BE INSTALLED ON ALL LATERALS AND AS INDICATED ON THESE PLANS.
- ALL, EXTERIOR CLEANOUTS SHALL BE PROVIDED WITH A FROST SLEEVE IN ACCORDANCE WITH SPS 382,34(5)(a)b AND SPS 384,30(2)(c).
- 16. ALL PRIVATE PLUMBING MATERIALS SHALL CONFORM TO SPS 384.30.
- 17. ALL PRIVATE PIPE JOINTS SHALL BE INSTALLED PER SPS 384.40.

- 20. INLET CASTINGS SHALL BE SET TO GRADE PRIDR TO AND SEPARATE FROM THE POURING OF THE CONCRETE CURB AND GUTTER. BIS REQUIRED THAT THREE FEET OF CONCRETE CURB AND GUTTER ON BLOCK BY THE INLET SHALL BE OUNCED BY HAMO, OUT THROUGH THE WHICH SHALL BE AMINIOUN OF TWO INVESTE THICK, THE INLET SHALL BE PLACED ON THE WHICH SHALL BE AMINIOUN OF TWO INVESTE THICK, THE INLET SHALL BE PLACED ON THE WHICH SHALL BE AMINIOUN OF TWO INVESTE THE CASTING ADMINISTRATION FOR SHAPE WAS THE PLACED ON THE CASTING, ONCE THE CASTING ADJUSTMENT IS COMPLETE, THESE FEET OF CURB AND GUTTER OVER EACH SECOND THE CASTING ADJUSTMENT IS COMPLETE. THESE FEET OF CURB AND GUTTER OVER EACH SECOND THE CASTING ADJUSTMENT IS COMPLETE. THESE FEET OF CURB AND GUTTER OVER EACH SECOND THE CASTING ADJUSTMENT IS COMPLETE. THESE FEET OF CURB AND GUTTER OVER EACH SECOND THE CASTING ADJUSTMENT IS COMPLETE. THESE FEET OF CURB AND GUTTER OVER EACH SECOND THE CASTING ADJUSTMENT IS COMPLETE. THESE FEET OF CURB AND GUTTER OVER EACH SECOND THE CASTING ADJUSTMENT IS COMPLETE. THESE FEET OF CURB AND GUTTER OVER EACH SECOND THE CASTING ADJUSTMENT IS COMPLETE. THESE FEET OF CURB AND GUTTER OVER EACH SECOND THE CASTING ADJUSTMENT IS COMPLETE. THESE FEET OF CURB AND GUTTER OVER EACH SECOND THE CASTING ADJUSTMENT IS COMPLETE. THESE FEET OF CURB AND GUTTER OVER EACH SECOND THE CASTING ADJUSTMENT IS COMPLETE. THESE FEET OF CURB AND GUTTER OVER EACH SECOND THE CONTROL OF THE COMPLETE. THESE FEET OF CURB AND GUTTER OVER EACH SECOND THE CONTROL OF THE CONTROL
- THE CURB INLET SHALL HAVE A CATCH-ALL HR-I OIL AND GREASE FILTER OR APPROVED EQUIVALENT INSTALLED WITHIN THEM.
- CONTRACTOR SHALL VERIFY AND COORDINATE ALL UTILITY CONNECTIONS WITH THE BUILDING PRIOR TO CONSTRUCTION.
- THE CONTRACTOR SHALL CONDUCT HIS OPERATIONS SO AS TO BE IN CONFORMANCE WITH THE CITY EROSION CONTROL AND STORMWATER ORDINANCE, AND DNR ADMINISTRATIVE RULE NR 215 AT ALL TIMES.

Toll Free (800) 242-8511 -or- 811 www.Diggeral-lotline.com




KOYSTER CORNERS - LOT 60	ons		CITY OF MADISON, DANE COUNTY, WI	Sheet Title: UTILITY PLAN	
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Date: JUNE 9, 2023 Scale: 1" = 20'-0" Designer: kms Job#

Seal:
To protect against legal liability the plans presented herein are "schematic," and should not be outsourced as "biddable" or "construction documents" unles approved by the Landscape

approved by the Landscape
Designer. This is not an origina
document unless stamped in
red, as ORIGINAL.

L100

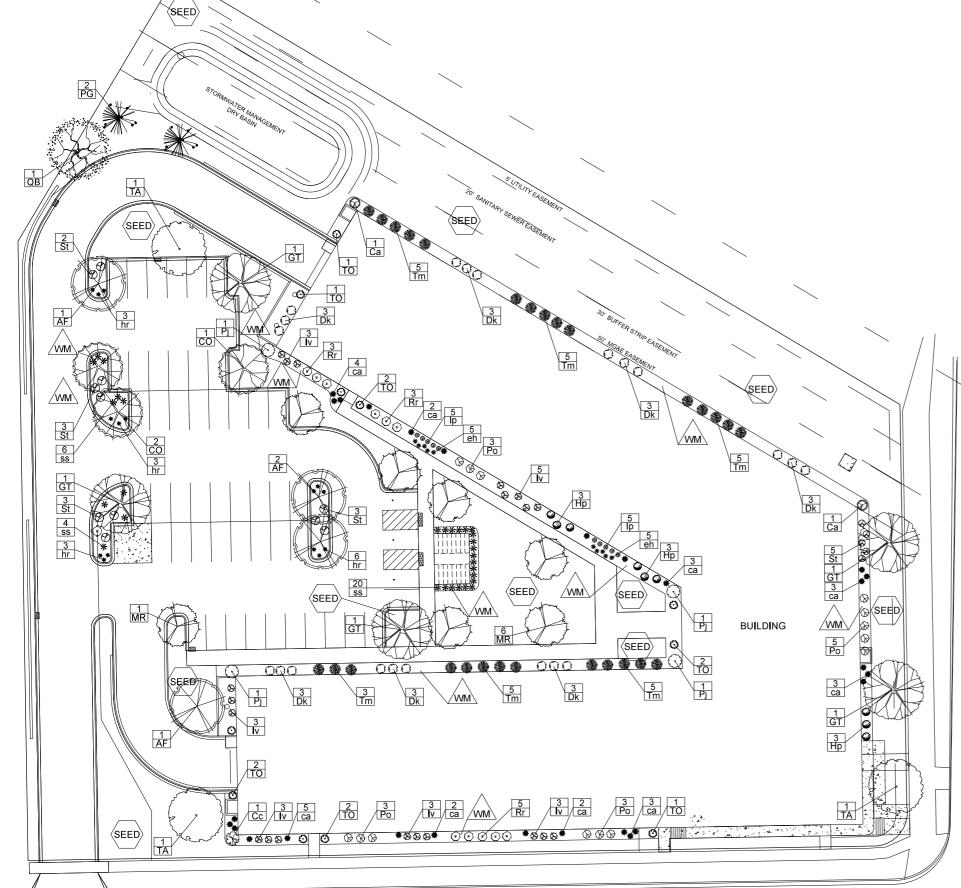

PLANT LIST

	KEY	SCIENTIFIC NAME	COMMON NAME	QTY	SIZE	ROOT	STEM
		DECIDUOUS TREES					
	AF	Acer x freemanii 'Jefersred'	Autumn Blaze Maple	4	2"	B&B	
	СО	Celtis occidentalis	Common Hackberry	3	2"	B&B	
	GT	Gleditsia triacanthos var. inermis 'Skyline'	Skyline Honeylocust	5	2"	B&B	
	QB	Quercus bicolor	Swamp White Oak	1	2"	B&B	
	TA	Tilia americana 'McKSentry'	American Sentry Linden	3	2"	B&B	
		ORNAMENTAL TREES					
	MR	Malus 'JFS-KW5'	Royal Raindrops Crabapple	7	2"	B&B	
		EVERGREEN TREES					
_	PG	Picea glauca var. densata	Black Hills Spruce	2	6'	B&B	
\Box	TO	Thuja occidentalis 'Emerald Green'	Emerald Green Arborvitae	11	6'	B&B	
7		EVERGREEN SHRUBS					
ROAD	Tm	Taxus x media 'Tautonii'	Taunton Yew	28	#5	Cont.	
\mathcal{O}		DECIDUOUS SHRUBS					
\simeq	Ca	Cornus alba 'Bailhalo'	Ivory Halo Dogwood	2	#5	Cont.	
	Cc	Cotinus coggygria 'NCC01'	Winecraft Black Smokebush	1	#5	Cont.	
>	Dk	Diervilla 'G2X885411'	Kodiak Red Bush Honeysuckle	21	#3	Cont.	
ш	Hp	Hydrangea paniculata 'SMHPLQF'	Little Quickfire Hydrangea	9	#3	Cont.	
$\overline{\alpha}$	lv	Itea virginica 'Sprich'	Little Henry Dwarf Sweetspire	20	#3	Cont.	
2,	Pj	Physocarpus opulifolius 'JEFAM'	Amber Jubilee Ninebark	4	#3	Cont.	
EMPSEY	Po	Physocarpus opulifolius 'SMPOTW'	Tiny Wine Ninebark	14	#3	Cont.	
>	Rr	Rosa 'Radtko'	Double Knock Out Rose	11	#5	Cont.	
	St	Spiraea betulifolia 'Tor'	Tor Birchleaf Spirea	16	#3	Cont.	
		ORNAMENTAL GRASSES & PERENNIALS					
	ca	Calamagrostis x acutiflora 'Karl Foerster'	Karl Foerster Feather Reed Grass	28	#1	Cont.	
	eh	Echinacea 'Hot Papaya'	Hot Papaya Coneflower	10	#1	Cont.	
	hr	Hemerocallis 'Rosy Returns'	Rosy Returns Daylily	15	#1	Cont.	
	l p	Lavandul x intermedia 'Niko'	Phenomenal Lavender	10	#1	Cont.	
	ss	Schizachyrium scoparium 'Prairie Blues'	Prairie Blue Little Bluestem Grass	30	#1	Cont.	


www '

Brown Dyed Wood Mulch with Dimex EdgePro polyvinyl (black plastic) edging


Premium sunny grass seed blend with (Class 1 Type B single net)

LANDSCAPE NOTES:

- Please refer to Grading & Erosion Control Plan for final contour information.
- •See CIVIL PLANS for Stormwater Basin details
- Individual tree and shrub groupings in lawn areas to receive wood mulch rings with trench edge.
- Add street trees per the direction of the City Forester, as required.

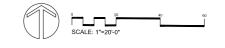

PINNEY STREET

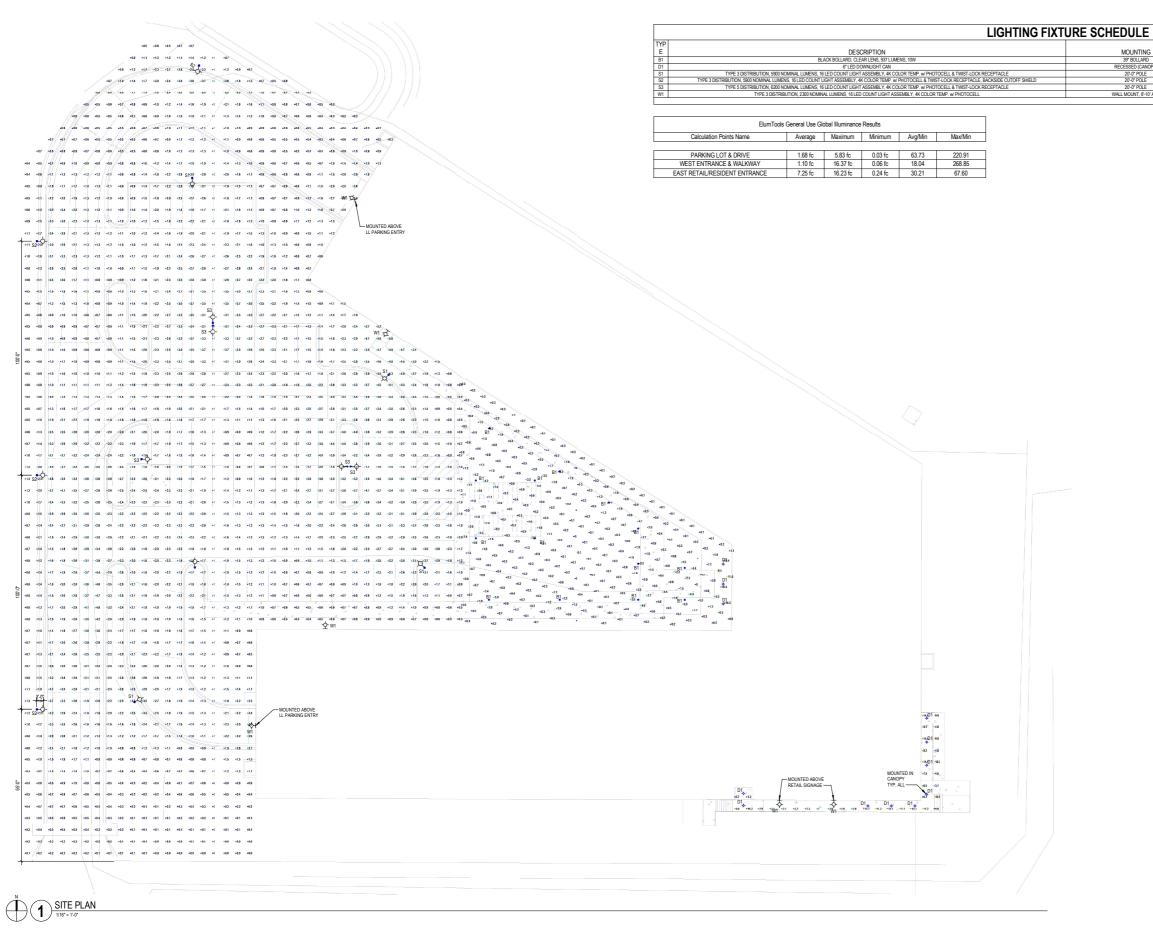

ENGINEER OF RECORD: First and Last Name DIRECT PHONE: (000)-000-0000 EMAIL ADDRESS: name@eua.com


ROYSTER LOT 60


526 PINNEY STREET MADISON, WI 53714

PROJECT NUMBER: 723129

SHEET NAME:

SITE LIGHTING PHOTOMETRIC PLAN

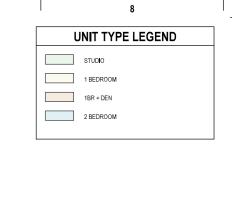

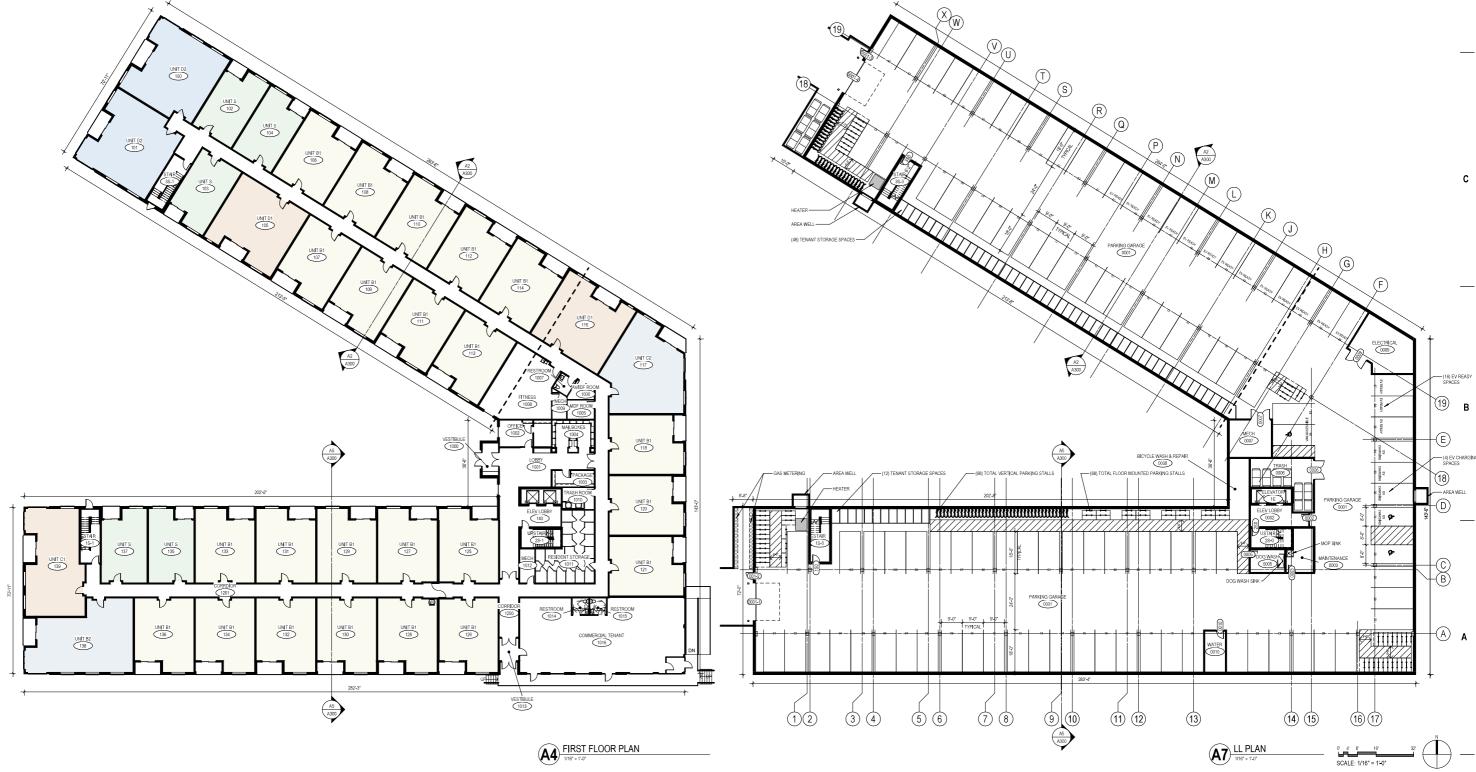





ISSUANCE AND R

DATE DESCRIPTION
06/12/2023 PLAN COMMISSION SUBMITTAL

PROGRESS DOCUMENTS NOT FOR CONSTRUCTION

These documents reflect progress and intest and may be subject to change, including additional datal. These are not final construction documents and shall not be used for final bidding or construction-related purpose.


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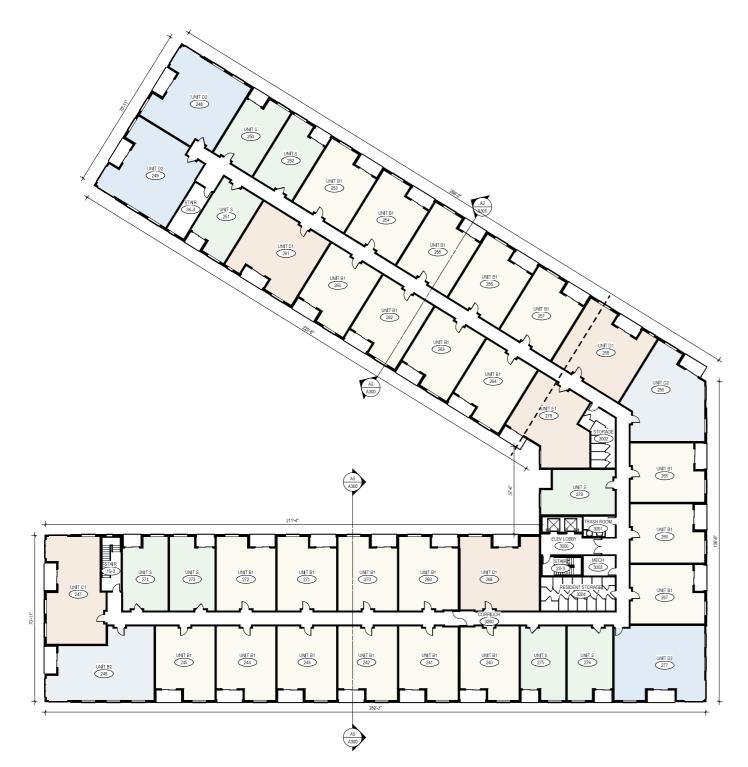
526 PINNEY STREET MADISON, WI 53714

PROJECT NUMBER: 723129-01

SHEET NAME:

LL & 1ST FLR PLAN
A100



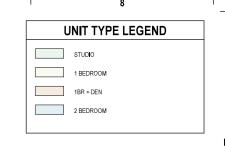



THIRD FLOOR PLAN

SECOND FLOOR PLAN

1/18" = 1'-2"

0' 4' 8' 16' 32' SCALE: 1/16" = 1'-0"

eu:a



ISSUANCE AND RE

DATE DESCRIPTION
08/12/2023 PLAN COMMISSION SUBMITTAL

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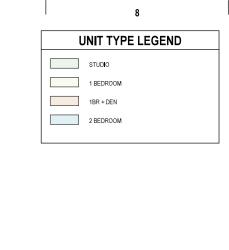
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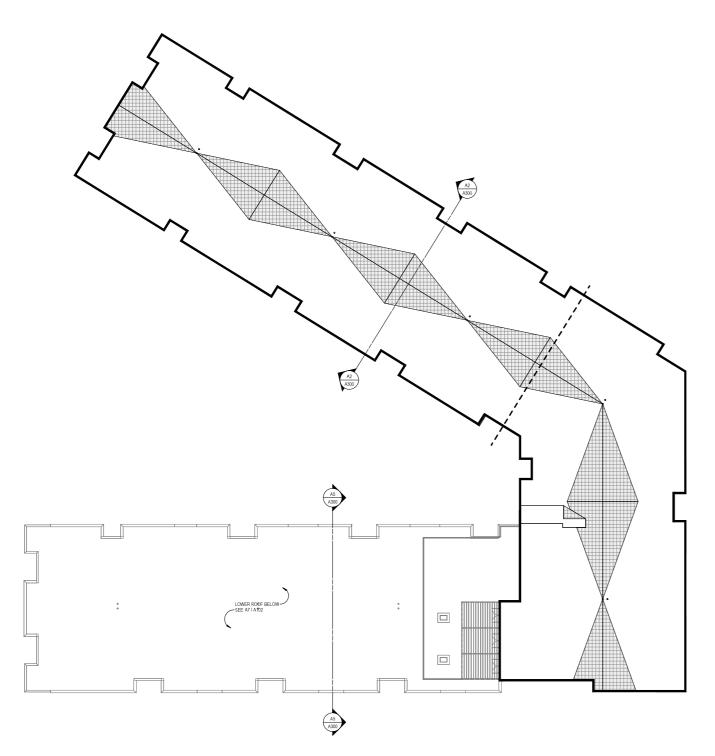
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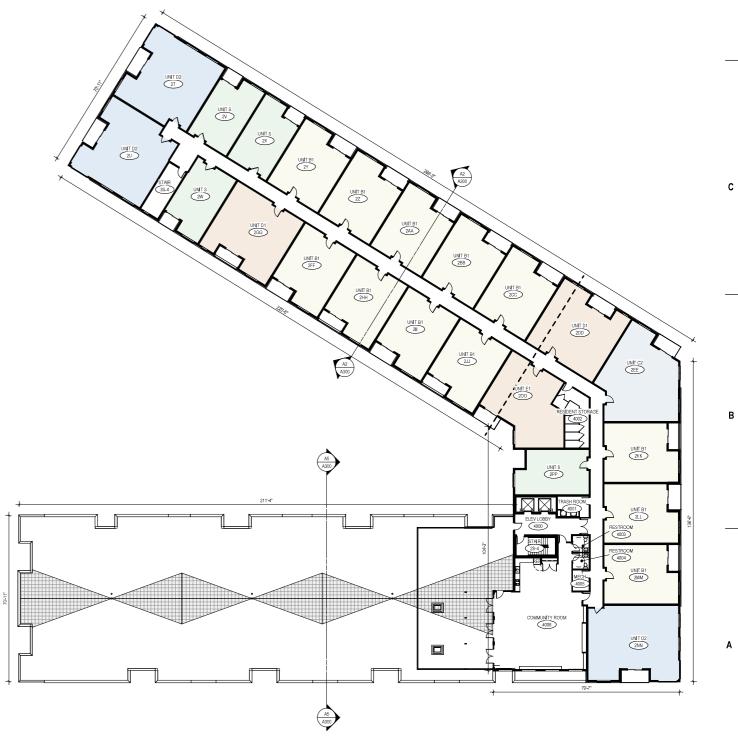
PROJECT NUMBER: 723129-01
PROJECT MANAGER: RS

SHEET NAME:

2ND & 3RD FLR PLAN A101







OVERALL ROOF PLAN
1/16" = 1-0"

1 2 3 4 5 6 7

FOURTH FLOOR PLAN

1/16° = 1-0°

0" 4" 8" 16" 32 SCALE: 1/16" = 1"0"

eu:a



ISSUANCE AND R

DESCRIPTION
PLAN COMMISSION SUBMITTAL
NC

PROGRESS DOCUMENTS
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ROYSTER LOT 60

526 PINNEY STREET MADISON, WI 53714

PROJECT NUMBER: 723129-01
PROJECT MANAGER: RS

SHEET NAME:

4TH FLR & ROOF PLAN A102

SHEET NOTES -EXTERIOR ELEVATIONS

T.O. WALL 150'-0' 3RD FLR 122'-5' SIGNAGE METAL CANOPY WITH WOOD SOFFIT SOUTH ELEVATION

1/8" = 1'-0"









ISSUANCE AND REVISIONS

DESCRIPTION

PROGRESS DOCUMENTS NOT FOR CONSTRUCTION PROJECT INFORMATION **ROYSTER LOT 60**

526 PINNEY STREET

MADISON, WI 53714

PROJECT NUMBER: 723129-01

EXTERIOR ELEVATIONS

SHEET NOTES -EXTERIOR ELEVATIONS



NORTHEAST ELEVATION
1/8" = 1-0"







ISSUANCE AND REVISIONS

DESCRIPTION

PROGRESS DOCUMENTS NOT FOR CONSTRUCTION PROJECT INFORMATION **ROYSTER LOT 60**

526 PINNEY STREET MADISON, WI 53714

PROJECT NUMBER: 723129-01

EXTERIOR ELEVATIONS

SHEET NOTES -EXTERIOR ELEVATIONS

8

2. PROVIDE CONTINUOUS SEALANT AND BOCKER ROO AT ALL PRECAST CONDET

ALL NEDGE AND OUTSIDE CORNERS OF PRECAST TIMM TON OUT OF MITTERS

4. EXTERIOR SICANGE ON BULIDING TO DE COORDINATED AND VERIFIED WITH AP

OWNER AND SIGANGE VERDERS

5. ALL VERTICAL INSIDE CORNERS TO HAVE 11/2 MOVEMENT JOINT.

My INDICATES MOVEMENT JOINT - 1/2 CRAP

T.O. WALL 150'-0" TRUSS BEARING 143'-6 3/4" 4TH FLR 134'-6 7/8' Ш \blacksquare 3RD FLR 122'-5" 2ND FLR 111'-3 1/8' 1ST FLR 100'-0'

NORTH COURTYARD ELEVATION



SOUTH COURTYARD ELEVATION





ISSUANCE AND REVISIONS

DATE DESCRIPTION
06/12/2023 PLAN COMMISSION SUBMITTAL

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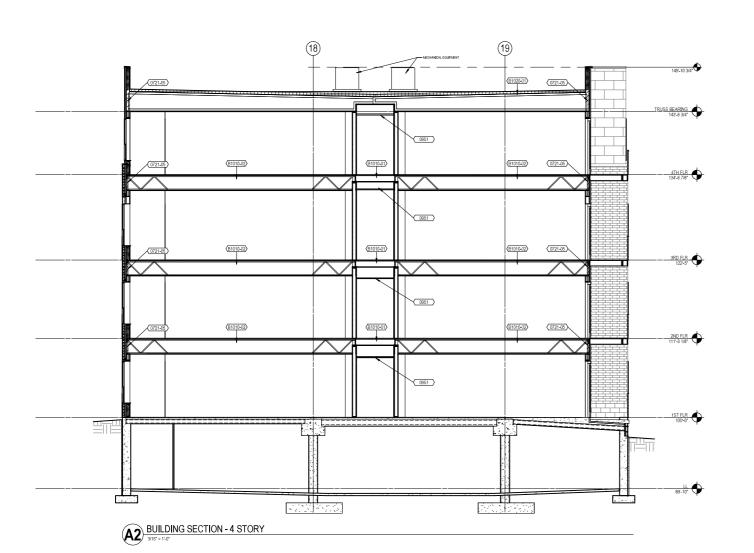
ROYSTER LOT 60


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PROJECT NUMBER: 723129-01
PROJECT MANAGER: RS

SHEET NAM

EXTERIOR ELEVATIONS **A202**





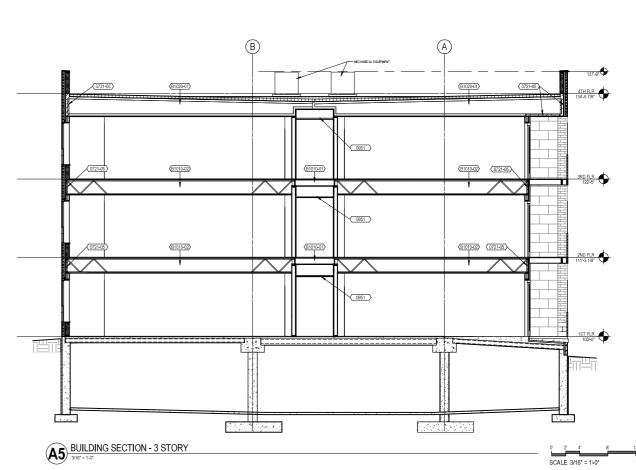



1 2 3 4 5 6

PROGRESS DOCUMENTS NOT FOR CONSTRUCTION

These documents rediced progress and intent and may be subject to change, including additioned distal. These are not final construction documents and shall not be used for final b

ROYSTER LOT 60

PROJECT INFORMATION

526 PINNEY STREET MADISON, WI 53714

PROJECT NUMBER: 723129-01
PROJECT MANAGER: RS

SHEET NAME: BUILDING SECTIONS A300







526 PINNEY STREET MADISON, WI 53714

PROJECT NUMBER: 723129-01

EXTERIOR RENDERING **A900**







526 PINNEY STREET MADISON, WI 53714

PROJECT NUMBER: 723129-01

EXTERIOR RENDERING **A901**







526 PINNEY STREET MADISON, WI 53714

PROJECT NUMBER: 723129-01

EXTERIOR RENDERING







526 PINNEY STREET MADISON, WI 53714


PROJECT NUMBER: 723129-01

EXTERIOR RENDERING **A903**





BRICK 1

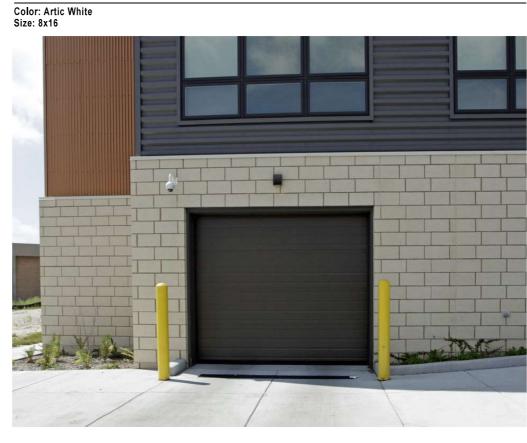

BRICK 2


Color: Artic White Size: Module



Storefront Color: Black



Composite/Vinyl Window System Color: Black

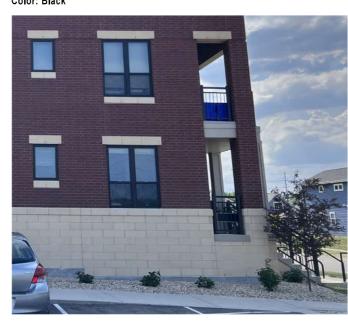

Canopy Wood Soffit



Precast Color: Buff



Railings Color: Black



ISSUANCE AND REVISIONS

PROGRESS DOCUMENTS NOT FOR CONSTRUCTION

PROJECT INFORMATION

Royster Lot 60

EXTERIOR MATERIALS

SHEET INFORMATION

D



DEVELOPMENT A CONSTRUCTION UEDEBUSCH

526 Pinney Street

PROJECT NUMBER: 723129-01



CITY OF MADISON LANDSCAPE WORKSHEET

Section 28.142 Madison General Ordinance

•				
Project Location / Address	526 Pinney	Street		
Name of Project	ter Corners Lo	+60		
Owner/Contact Ruedel Contact Phone (408) 24	busch Development 5	Construction, (n	c Carl Ruedeb	usch
Contact Phone (408) 24	3- 905Z Cont	tact Email <u>Carl</u>	Cruedebusch.co	m
* *	ns for zoning lots greater th UST be prepared by a regist	•	· · ·	;
Applicability			i i	
The following standards apply to buildings, structures and parking their accessory structures. The enfollowing conditions apply, in whether the standards apply to be standard	g lots, except the construction tire development site must be	n of detached single brought up to comp	-family and two-family liance with this section u	dwellings and
(a) The area of site distu	rbance is less than ten percer	nt (10%) of the entir	e development site durin	g any ten-(10)
year period.			!	
(b) Gross floor area is on	ly increased by ten percent (1	0%) during any ten-	10) year period.	
(c) No demolition of a pr	incipal building is involved.			
(d) Any displaced landsca	aping elements must be replace	ced on the site and sh	own on a revised landsca	aping plan.
	e size of the lot and Zoning D nose described in (b) and (c)	District.		
	square feet of developed area.			
	points required 1,40			
	a five (5) acres, points shall b (5) developed acres, and one (
Total square foot	age of developed area			
Five (5) acres = $\frac{1}{2}$	217,800 square feet			
First five (5) dev	eloped acres = 3,630 points			
Remainder of de-	veloped area			
Total landscape p	points required			
` ,	- Limited (IL) and Industria 1) square feet of developed are		stricts, one (1) point sha	all be provided
Total square foot	age of developed area	·		
Total landscape p	points required		 	

Tabulation of Points and Credits

Use the table to indicate the quantity and points for all existing and proposed landscape elements.

DI 475 - / El	Minimum Size at Installation	Points	Credits/ Existing Landscaping		New/ Proposed Landscaping		
Plant Type/ Element			Quantity	Points Achieved	Quantity	Points Achieved	
Overstory deciduous tree	2½ inch caliper measured diameter at breast height (dbh)	35			No	560	
Tall evergreen tree (i.e. pine, spruce)	5-6 feet tall	35			Z	70	
Ornamental tree	1 1/2 inch caliper	15			7	105	
Upright evergreen shrub (i.e. arborvitae)	3-4 feet tall	10			И	110	
Shrub, deciduous	#3 gallon container size, Min. 12"-24"	3			98	294	
Shrub, evergreen	#3 gallon container size, Min. 12"-24"	4			28	112	
Ornamental grasses/ perennials	#1 gallon container size, Min. 8"-18"	2			93	192	
Ornamental/ decorative fencing or wall	n/a	4 per 10 lineal ft.					
Existing significant specimen tree	Minimum size: 2 ½ inch caliper dbh. *Trees must be within developed area and cannot comprise more than 30% of total required points.	14 per caliper inch dbh. Maximum points per tree: 200					
Landscape furniture for public seating and/or transit connections	* Furniture must be within developed area, publically accessible, and cannot comprise more than 5% of total required points.	5 points per "seat"					
Sub Totals						1443	

Total Number of Points Provided 1,443

^{*} As determined by ANSI, ANLA- American standards for nursery stock. For each size, minimum plant sizes shall conform to the specifications as stated in the current American Standard for Nursery Stock.

Landscaping shall be distributed throughout the property along street frontages, within parking lot interiors, as foundation plantings, or as general site landscaping. The total number of landscape points provided shall be distributed on the property as follows.

Total Developed Area

Required landscaped areas shall be calculated based upon the total developed area of the property. Developed area is defined as that area within a single contiguous boundary which is made up of structures, parking, driveways and docking/loading facilities, but excluding the area of any building footprint at grade, land designated for open space uses such as athletic fields, and undeveloped land area on the same zoning lot.

Development Frontage Landscaping

Landscaping and/or ornamental fencing shall be provided between buildings or parking areas and the adjacent street(s), except where buildings are placed at the sidewalk. Landscape material shall include a mix of plant materials.

Interior Parking Lot Landscaping

The purpose of interior parking lot landscaping is to improve the appearance of parking lots, provide shade, and improve stormwater infiltration. All parking lots with twenty (20) or more parking spaces shall be landscaped in accordance with the interior parking lot standards.

Foundation Plantings


Foundation plantings shall be installed along building facades, except where building facades directly abut the sidewalk, plaza, or other hardscape features. Foundation plantings shall consist primarily of shrubs, perennials, and native grasses.

Screening Along District Boundaries

Screening shall be provided along side and rear property boundaries between commercial, mixed use or industrial districts and residential districts.

Screening of Other Site Elements

The following site elements shall be screened in compatibility with the design elements, materials and colors used elsewhere on the site: refuse disposal areas, outdoor storage areas, loading areas, and mechanical equipment.

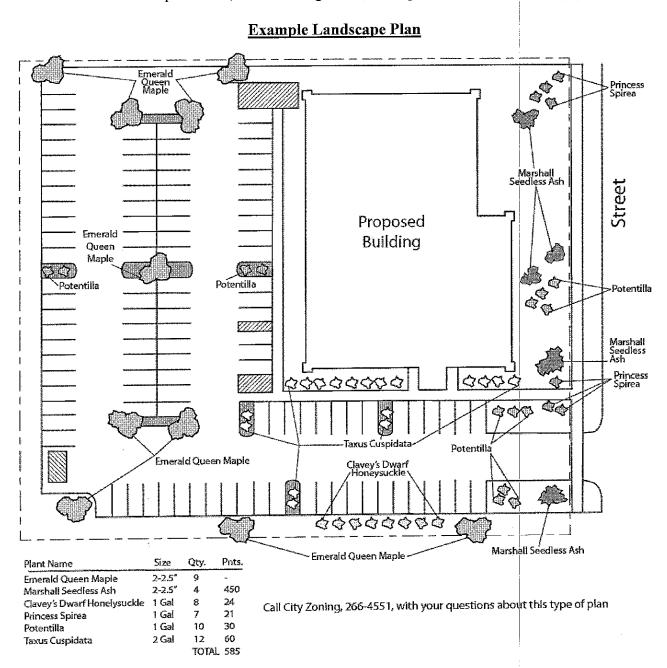

LANDSCAPE PLAN AND LANDSCAPE WORKSHEET INSTRUCTIONS

Refer to Zoning Code Section 28.142 LANDSCAPING AND SCREENING REQUIREMENTS for the complete requirements for preparing and submitting a Landscape Plan and Landscape Worksheet.

Applicability.

The following standards apply to all exterior construction and development activity, including the expansion of existing buildings, structures and parking lots, except the construction of detached single-family and two-family dwellings and their accessory structures. The entire development site must be brought up to compliance with this section unless all of the following conditions apply, in which case only the affected areas need to be brought up to compliance:

- (a) The area of site disturbance is less than ten percent (10%) of the entire development site during any ten-(10) year period.
- (b) Gross floor area is only increased by ten percent (10%) during any ten-(10) year period.
- (c) No demolition of a principal building is involved.
- (d) Any displaced landscaping elements must be replaced on the site and shown on a revised landscaping plan.

Landscape Plan and Design Standards.

Landscape plans shall be submitted as a component of a site plan, where required, or as a component of applications for other actions, including zoning permits, where applicable. Landscape plans for zoning lots greater than ten thousand (10,000) square feet in size must be prepared by a registered landscape architect.

- (a) Elements of the landscape plan shall include the following:
 - 1. Plant list including common and Latin names, size and root condition (i.e. container or ball & burlap).
 - 2. Site amenities, including bike racks, benches, trash receptacles, etc.
 - 3. Storage areas including trash and loading.
 - 4. Lighting (landscape, pedestrian or parking area).
 - 5. Irrigation.
 - 6. Hard surface materials.
 - 7. Labeling of mulching, edging and curbing.
 - 8. Areas of seeding or sodding.
 - 9. Areas to remain undisturbed and limits of land disturbance.
 - 10. Plants shall be depicted at their size at sixty percent (60%) of growth.
 - 11. Existing trees eight (8) inches or more in diameter.
 - 12. Site grading plan, including stormwater management, if applicable.
- (b) Plant Selection. Plant materials provided in conformance with the provisions of this section shall be nursery quality and tolerant of individual site microclimates.
- (c) Mulch shall consist of shredded bark, chipped wood or other organic material installed at a minimum depth of two (2) inches.

Landscape Calculations and Distribution.

Required landscaped areas shall be calculated based upon the total developed area of the property. Developed area, for the purpose of this requirement, is defined as that area within a single contiguous boundary which is made up of structures, parking driveways and docking/loading facilities, but **excluding** the area of any building footprint at grade, land designated for open space uses such as athletic fields, and undeveloped land area on the same zoning lot.

- (a) Landscaping shall be distributed throughout the property along street frontages, within parking lot interiors, and as foundation plantings, or as general site landscaping.
- (b) Planting beds or planted areas must have at least seventy-five percent (75%) vegetative cover.
- (c) Canopy tree diversity requirements for new trees:
 - 1. If the development site has fewer than 5 canopy trees, no tree diversity is required.
 - 2. If the development site has between 5 and 50 canopy trees, no single species may comprise more than 33% of trees.
 - 3. If the development site has more than 50 canopy trees, no single species may comprise more than 20% of trees.

Development Frontage Landscaping.

Landscaping and/or ornamental fencing shall be provided between buildings or parking areas and the adjacent street(s), except where buildings are placed at the sidewalk. Landscape material shall include a mix of plant material meeting the following minimum requirements:

- (a) One (1) overstory deciduous tree and five (5) shrubs shall be planted for each thirty (30) lineal feet of lot frontage. Two (2) ornamental trees or two (2) evergreen trees may be used in place of one (1) overstory deciduous tree.
- (b) In cases where building facades directly abut the sidewalk, required frontage landscaping shall be deducted from the required point total.
- (c) In cases where development frontage landscaping cannot be provided due to site constraints, the zoning administrator may waive the requirement or substitute alternative screening methods for the required landscaping.
- (d) Fencing shall be a minimum of three (3) feet in height, and shall be constructed of metal, masonry, stone or equivalent material. Chain link or temporary fencing is prohibited.

Interior Parking Lot Landscaping.

The purpose of interior parking lot landscaping is to improve the appearance of parking lots, provide shade, and improve stormwater infiltration. All parking lots with twenty (20) or more parking spaces shall be landscaped in accordance with the following interior parking lot standards.

- (a) For new development on sites previously undeveloped or where all improvements have been removed, a minimum of eight percent (8%) of the asphalt or concrete area of the parking lot shall be devoted to interior planting islands, peninsulas, or landscaped strips. For changes to a developed site, a minimum of five percent (5%) of the asphalt or concrete area shall be interior planting islands, peninsulas, or landscaped strips. A planting island shall be located at least every twelve (12) contiguous stalls with no break or alternatively, landscaped strips at least seven (7) feet wide between parking bays.
- (b) The primary plant materials shall be shade trees with at least one (1) deciduous canopy tree for every one hundred sixty (160) square feet of required landscaped area. Two (2) ornamental deciduous trees may be substituted for one (1) canopy tree, but ornamental trees shall constitute no more than twenty-five percent (25%) of the required trees. No light poles shall be located within the area of sixty percent (60%) of mature growth from the center of any tree.
- (c) Islands may be curbed or may be designed as uncurbed bio-retention areas as part of an approved low impact stormwater management design approved by the Director of Public Works. The ability to maintain these areas over time must be demonstrated. (See Chapter 37, Madison General Ordinances, Erosion and Stormwater Runoff Control.)

Foundation Plantings.

Foundation plantings shall be installed along building facades, except where building facades directly abut the sidewalk, plaza, or other hardscape features. Foundation plantings shall consist primarily of shrubs, perennials, and native grasses. The Zoning Administrator may modify this requirement for development existing prior to the effective date of this ordinance, as long as improvements achieve an equivalent or greater level of landscaping for the site.

Screening Along District Boundaries.

Screening shall be provided along side and rear property boundaries between commercial, mixed use or industrial districts and residential districts. Screening shall consist of a solid wall, solid fence, or hedge with year-round foliage, between six (6) and eight (8) feet in height, except that within the front yard setback area, screening shall not exceed four (4) feet in height. Height of screening shall be measured from natural or approved grade. Berms and retaining walls shall not be used to increase grade relative to screening height.

Screening of Other Site Elements.

The following site elements shall be screened in compatibility with the design elements, materials and colors used elsewhere on the site, as follows:

- (a) Refuse Disposal Areas. All developments, except single family and two family developments, shall provide a refuse disposal area. Such area shall be screened on four (4) sides (including a gate for access) by a solid, commercial-grade wood fence, wall, or equivalent material with a minimum height of six (6) feet and not greater than seven (7) feet.
- (b) Outdoor Storage Areas. Outdoor storage areas shall be screened from abutting residential uses with a by a building wall or solid, commercial-grade wood fence, wall, year-round hedge, or equivalent material, with a minimum height of six (6) feet and not greater than seven (7) feet. Screening along district boundaries, where present, may provide all or part of the required screening.
- (c) <u>Loading Areas</u>. Loading areas shall be screened from abutting residential uses and from street view to the extent feasible by a building wall or solid, commercial-grade wood fence, or equivalent material, with a minimum height of six (6) feet and not greater than seven (7) feet. Screening along district boundaries, where present, may provide all or part of the required screening.
- (d) <u>Mechanical Equipment</u>. All rooftop and ground level mechanical equipment and utilities shall be fully screened from view from any street or residential district, as viewed from six (6) feet above ground level. Screening may consist of a building wall or fence and/or landscaping as approved by the Zoning Administrator.

Maintenance.

The owner of the premises is responsible for the watering, maintenance, repair and replacement of all landscaping, fences, and other landscape architectural features on the site. All planting beds shall be kept weed free. Plant material that has died shall be replaced no later than the upcoming June 1.