URBAN DESIGN COMMISSION APPLICATION

UDC

City of Madison Planning Division Madison Municipal Building, Suite 017 215 Martin Luther King, Jr. Blvd. P.O. Box 2985 Madison, WI 53701-2985 (608) 266-4635



Complete all sections of this application, including the desired meeting date and the action requested.

If you need an interpreter, translator, materials in alternate formats or other accommodations to access these forms, please call the phone number above immediately.

FOR OFFICE USE ONLY:

Paid Receipt #
Date received
Received by
Aldermanic District
Zoning District
Urban Design District
Submittal reviewed by 76596 Legistar #

1. Project Information

Address:	Address:					
Title:						
2. Application Type (check all that						
UDC meeting date requested						
New development	U U	r previously-approved development				
Informational	Initial approval	Final approval				
3. Project Type						
Project in an Urban Design Dis	trict	Signage				
Project in the Downtown Core		Comprehensive Design Review (CDR)				
Mixed-Use District (UMX), or Mix Project in the Suburban Employ	yment Center District (SEC),	Signage Variance (i.e. modification of signage height, area, and setback)				
Campus Institutional District (C District (EC)	CI), or Employment Campus	Signage Exception				
Planned Development (PD)		Other				
General Development Pla Specific Implementation		Please specify				
Planned Multi-Use Site or Resi	dential Building Complex					
4. Applicant, Agent, and Property	Owner Information					
Applicant name		Company				
Street address		City/State/Zip				
Telephone		Email				
Project contact person		Company				
Street address		City/State/Zip				
Telephone		Email				
Property owner (if not applicant)						
Street address		City/State/Zip				
Telephone		Email				

Urban Design Commission Application (continued)

5. Required Submittal Materials

Application Form

- Letter of Intent
 - · If the project is within an Urban Design District, a summary of how the development proposal addresses the district criteria is required
 - For signage applications, a summary of how the proposed signage is consistent with the applicable CDR or Signage Variance review criteria is required.
- Development Plans (Refer to checklist on Page 4 for plan details)
- Filing fee
- **Electronic Submittal***
- Notification to the District Alder
 - Please provide an email to the District Alder notifying them that you are filing this UDC application. Please send this as early in the process as possible and provide a copy of that email with the submitted application.

Both the paper copies and electronic copies must be submitted prior to the application deadline before an application will be scheduled for a UDC meeting. Late materials will not be accepted. A completed application form is required for each UDC appearance.

For projects also requiring Plan Commission approval, applicants must also have submitted an accepted application for Plan Commission consideration prior to obtaining any formal action (initial or final approval) from the UDC. All plans must be legible when reduced.

*Electronic copies of all items submitted in hard copy are required. Individual PDF files of each item submitted should be compiled on a CD or flash drive, or submitted via email to udcapplications@cityofmadison.com. The email must include the project address, project name, and applicant name. Electronic submittals via file hosting services (such as Dropbox.com) are not allowed. Applicants who are unable to provide the materials electronically should contact the Planning Division at (608) 266-4635 for assistance.

6. Applicant Declarations

- Prior to submitting this application, the applicant is required to discuss the proposed project with Urban Design 1 Commission staff. This application was discussed with Jessica Vaughn on August 18, 2022
- The applicant attests that all required materials are included in this submittal and understands that if any required information 2. is not provided by the application deadline, the application will not be placed on an Urban Design Commission agenda for consideration.

Name of applicant Luke Stauffacher Authorizing signature of property owner Que Maboushin

7. Application Filing Fees Fees are required to be paid with the first application for either initial or final approval of a project, unless the project is part of the combined application process involving the Urban Design Commission in conjunction with Plan Commission and/or Common Council consideration. Make checks payable to City Treasurer. Credit cards may be used for application fees of less than \$1,000.

Please consult the schedule below for the appropriate fee for your request:

- Urban Design Districts: \$350 (per §35.24(6) MGO).
- Minor Alteration in the Downtown Core District (DC) or Urban Mixed-Use District (UMX) : \$150 (per §33.24(6)(b) MGO)
- Comprehensive Design Review: \$500 (per §31.041(3)(d)(1)(a) MGO)
- Minor Alteration to a Comprehensive Sign Plan: \$100 (per §31.041(3)(d)(1)(c) MGO)
- All other sign requests to the Urban Design Commission, including, but not limited to: appeals from the decisions of the Zoning Administrator, requests for signage variances (i.e. modifications of signage height, area, and setback), and additional sign code approvals: \$300 (per §31.041(3)(d)(2) MGO)

A filing fee is not required for the following project applications if part of the combined application process involving both Urban Design Commission and Plan Commission:

Date /

Relationship to property Developer

- Project in the Downtown Core District (DC), Urban Mixed-Use District (UMX), or Mixed-Use Center District (MXC)
- Project in the Suburban Employment Center District (SEC), Campus Institutional District (CI), or **Employment Campus District (EC)**
- Planned Development (PD): General Development Plan (GDP) and/or Specific Implementation Plan (SIP)
- Planned Multi-Use Site or Residential Building Complex

Each submittal must include fourteen (14) 11" x 17" collated paper copies. Landscape and Lighting plans (if required) must be full-sized and legible. Please refrain from using plastic covers or spiral binding.

-27-2023

Introduction

The City of Madison's Urban Design Commission (UDC) has been created to:

- Encourage and promote high quality in the design of new buildings, developments, remodeling, and additions so as to maintain and improve the established standards of property values within the City.
- Foster civic pride in the beauty and nobler assets of the City, and in all other ways possible assure a functionally efficient and visually attractive City in the future.

Types of Approvals

There are three types of requests considered by the UDC:

- <u>Informational Presentation</u>. Applicants may, at their discretion, request to make an Informational Presentation to the UDC prior to seeking any approvals to obtain early feedback and direction before undertaking detailed design. Applicants should provide details on the context of the site, design concept, site and building plans, and other relevant information to help the UDC understand the proposal and provide feedback. (Does not apply to CDR's or Signage Variance requests)
- <u>Initial Approval</u>. Applicants may, at their discretion, request initial approval of a proposal by presenting preliminary design information. As part of their review, the Commission will provide feedback on the design information that should be addressed at Final Approval stage.
- <u>Final Approval</u>. Applicants may request Final Approval of a proposal by presenting all final project details. Recommendations or concerns expressed by the UDC in the initial approval must be addressed at this time.

Presentations to the Commission

Primarily, the UDC is interested in the appearance and design quality of projects. Emphasis should be given to the site plan, landscape plan, lighting plan, building elevations, exterior building materials, color scheme, and graphics.

When presenting projects to the UDC, applicants must fill out a registration slip provided in the meeting room and present it to the Secretary. Presentations should generally be limited to 5 minutes or as extended by motion by consent of the Commission. The Commission will withhold questions until the end of the presentation.

Applicants are encouraged to consider the use of various graphic presentation material including a locator map, photographs, renderings/model, scale drawings of the proposal in context with adjacent buildings/uses/signs, etc., as may be deemed appropriate to describe the project and its surroundings. Graphics should be mounted on rigid boards so that they may be easily displayed. Applicants/presenters are responsible for all presentation materials, AV equipment and easels.

URBAN DESIGN DEVELOPMENT PLANS CHECKLIST

The items listed below are minimal application requirements for the type of approval indicated. Please note that the UDC and/ or staff may require additional information in order to have a complete understanding of the project.

Providing additional

information beyond these

minimums may generate

from the Commission.

a greater level of feedback

1. Informational Presentation

- Locator Map
- □ Letter of Intent (If the project is within an Urban Design District, a summary of <u>how</u> the development proposal addresses the district criteria is required)
- Contextual site information, including photographs and layout of adjacent buildings/structures
- Site Plan
- □ Two-dimensional (2D) images of proposed buildings or structures.

2. Initial Approval

- Locator Map
- □ Letter of Intent (If the project is within a Urban Design District, a summary of <u>how</u> the development proposal addresses the district criteria is required)
- □ Contextual site information, including photographs and layout of adjacent buildings/ structures
- □ Site Plan showing location of existing and proposed buildings, walks, drives, bike lanes, bike parking, and existing trees over 18" diameter
- □ Landscape Plan and Plant List (*must be legible*)
- Building Elevations in both black & white and color for all building sides (include material callouts)
- D PD text and Letter of Intent (if applicable)

3. Final Approval

All the requirements of the Initial Approval (see above), plus:

- □ Grading Plan
- □ Proposed Signage (if applicable)
- Lighting Plan, including fixture cut sheets and photometrics plan (*must be legible*)
- Utility/HVAC equipment location and screening details (with a rooftop plan if roof-mounted)
- D PD text and Letter of Intent (if applicable)
- □ Samples of the exterior building materials (presented at the UDC meeting)

4. Comprehensive Design Review (CDR) and Variance Requests (Signage applications only)

- Locator Map
- Letter of Intent (a summary of how the proposed signage is consistent with the CDR or Signage Variance criteria is required)
- □ Contextual site information, including photographs of existing signage both on site and within proximity to the project site
- □ Site Plan showing the location of existing signage and proposed signage, dimensioned signage setbacks, sidewalks, driveways, and right-of-ways
- Proposed signage graphics (fully dimensioned, scaled drawings, including materials and colors, and night view)
- □ Perspective renderings (emphasis on pedestrian/automobile scale viewsheds)
- □ Illustration of the proposed signage that meets Ch. 31, MGO compared to what is being requested.
- Graphic of the proposed signage as it relates to what the Ch. 31, MGO would permit

Requirements for All Plan Sheets

- 1. Title block
- 2. Sheet number
- 3. North arrow
- 4. Scale, both written and graphic
- 5. Date
- Fully dimensioned plans, scaled at 1"= 40' or larger

** All plans must be legible, including the full-sized landscape and lighting plans (if required)

> Providing additional information beyond these minimums may generate a greater level of feedback from the Commission.



February 27, 2023



Ms. Jessica Vaughn Urban Design Commission Secretary – Planning Division City of Madison Department of Planning & Community & Economic Development 215 Martin Luther King Jr Blvd, Suite 017 Madison, Wisconsin 53701

Re: UDC Final - Phase I

4846 Eastpark Blvd. Cascade Development – The American Center Project KBA Project #2155

Ms. Vaughn:

The following is submitted together with conceptual drawings for the Urban Design Commission's consideration. We are requesting Initial/Final approval for Lot 49-60 of Cascade Developments project at The American Center. These lots are part of Phase I, which includes all lots to be created north of Dreamer Drive. Lot 49 & 50 are considered a Residential Building Complex. We are also including Outlot 22 in this submittal. Outlot 22 will be a privately owned park with a public access easement.

Project Organizational Structure:

Owner: Cascade Development 5150 High Crossing Blvd. Madison, WI 53718 (608) 354-8748 Contact: Luke Stauffacher Luke@cascadedevelop.com

Engineer: Vierbicher 999 Fourier Drive, Suite 201 Madison, WI 53717 (608) 821-3961 Contact: Matthew W. Schreiner msch@vierbicher.com Architect: Knothe & Bruce Architects, LLC 7601 University Avenue, Ste 201 Middleton, WI 53562 (608) 836-3690 Contact: Greg Held Gheld@knothebruce.com

Landscape Design: Olson Toon Landscaping 3570 Pioneer Road Verona, WI 53593 (608) 827-9401 Contact: Brad Fregien Brad@olsontoon.com

Background

The American Center has experienced diminished demand for large corporate office projects over the past several years. At the same time, The American Center has not been a destination outside of

regular business hours, with activity in the park largely ending when employees return home. TAC planners and city staff recognized integrating residential uses into the park could add vibrancy and support for other uses within the park. Planning staff made this land use change contingent upon breaking up the existing large parcels with new public streets to improve circulation, and creating dedicated open space for recreational use by residents. TAC is currently finalizing the plat to create Dreamer Drive and The Commons. The Commons will feature programmed outdoor activities for the park. The Cascade project will plat the lands north and south of Dreamer Drive, creating new public roads and lots for development.

The American Center and City of Madison Input

The project team has met with City planning staff and representatives of The American Center on numerous occasions to discuss the proposed project. Highlights include a City of Madison Development Assistance Team (DAT) meeting on August 18, 2022, a meeting with the City of Madison Zoning department on September 22, 2022, and a meeting with Alder Paulson on October 13, 2022. Planners from The American Center have attended these meetings and have been involved throughout. The American Center Project Review Committee (PRC) gave initial reactions to the overall project concept at a presentation on November 16, 2022, and the PRC reviewed Phase I plans on January 25, 2023. An informational presentation was made to the Urban Design Commission on February 15, 2023.

This input has helped shape the proposed development with refinements to the site layout and building design, easements, setbacks, stormwater management and zoning. In addition to an Urban Design Commission recommendation to the Plan Commission, this project will require approval by The American Center's Design and Control Committee upon recommendation by the PRC.

Previous Approvals

Common Council approved the preliminary and final plats and the rezoning of the lots on February 7, 2023.

Project Description

Phase I will provide 404 dwelling units and 8,000 SF of commercial space in 4 buildings. The building on Lot 47, which fronts the north side of the Commons on Dreamer Drive, will be a five-story mixed-use building with commercial space on the first floor. Buildings on lots 48, 49 and 50 will be four-story apartment buildings. All buildings will feature underground parking and internal trash/recycling collection. Amenity space for tenants including pools, community and exercise rooms will be included in the project. Cascade will manage the project with their own on-site staff. The overall project will provide approximately 950 dwelling units and 14,000 s.f. of commercial space when complete.

Site Layout

A plat has been recorded for this development which includes right-of-way for a new public street (Luminous Land) running north to Eastpark from Dreamer Drive. This new public street will improve circulation and connectivity, which was one of the stipulations from Madison Planning in changing the land use here.

Cross access easements will be provided allowing shared access to parking throughout the development, reducing the number of curb-cuts needed. Buildings have been oriented to the street and parking has been positioned to allow screening from the street where possible.

Two acres have been designated as park in this phase of the project. This park will be privately owned with a public access easement over it allowing it to be enjoyed by all residents, employees, and visitors to TAC.

The topography of the site allows for varied exposures which will add variation and visual interest to the buildings. This topography will also be incorporated into the park.

Architecture

The building design has been refined through input from the PRC. The design features clean, modern lines and high-quality materials that will fit in well with the existing buildings within the park. Featured materials include natural stone and brick veneers, fiber composite siding and composite panels. The mixed-use building on The Commons will be five-stories tall, all other buildings are four-stories. Buildings will range from 55-68 feet in height. All buildings will comply with FAA height regulations and the viewshed deed restriction from the American Family corporate offices. Mechanical equipment will be screened, with equipment located on rooftops screened by building parapets.

Parking

Bus Rapid Transit will serve this site and Planning staff have indicated they would encourage any parking reduction the developer is comfortable with, especially any reduction in surface parking. The developer was also encouraged to use the smaller surface stall size, which have been incorporated into the site plan. There will be 312 structured vehicle stalls and 43 surface stalls. Cross access easements will be provided with Lot 50. Total structured and surface parking will bring the parking ratio to 1.55 stalls per dwelling unit. The project will also provide a total of 225 bicycle stalls, which meets the multi-family requirements in the zoning ordinance.

Landscaping

The Landscape design features native plants and natural treatments. At the park the natural topography will provide opportunities for grade change and terraces.

Exterior Lighting

Exterior lighting will comply with Madison ordinances and will be high efficiency LED and Dark Sky compliant.

Lot 49-50 Site Development Data:

Densities:	
Lot Area	208,686 S.F. / 4.79 acres
Dwelling Units	201 DU
Lot Area / D.U.	I,038 S.F./D.U.
Density	42 units/acre
Open Space Required	40 S.F./D.U.*
Open Space Provided	*Each unit has a balcony in excess of 40 SF
Lot Coverage	119,200 S.F. = 57%
Building Height:	4 Stories – 54'-0''
Dwelling Unit Mix:	
Studio	33
One Bedroom	84
One Bedroom + Den	8
Two Bedroom	<u>76</u>
Total Dwelling Units	201

Vehicle Parking:					
Surface	121 stalls				
Structured	191 stalls				
Total	312 stalls				
EV Stalls:					
EV Installed	5 stalls				
EV Ready	20 stalls				
Total	25 stalls				
Bicycle Parking:					
Surface Guest	24 stalls				
Underground Garage F.M.	147 stalls				
Underground Garage W.M.	54 stalls				
Total	225 stalls				

Project Schedule


Streets and infrastructure are scheduled for summer of 2023. Phase I building construction would start immediately following.


Thank you for your time and consideration of our proposal.


Sincerely,

My & Hell


Greg J Held, AIA Member

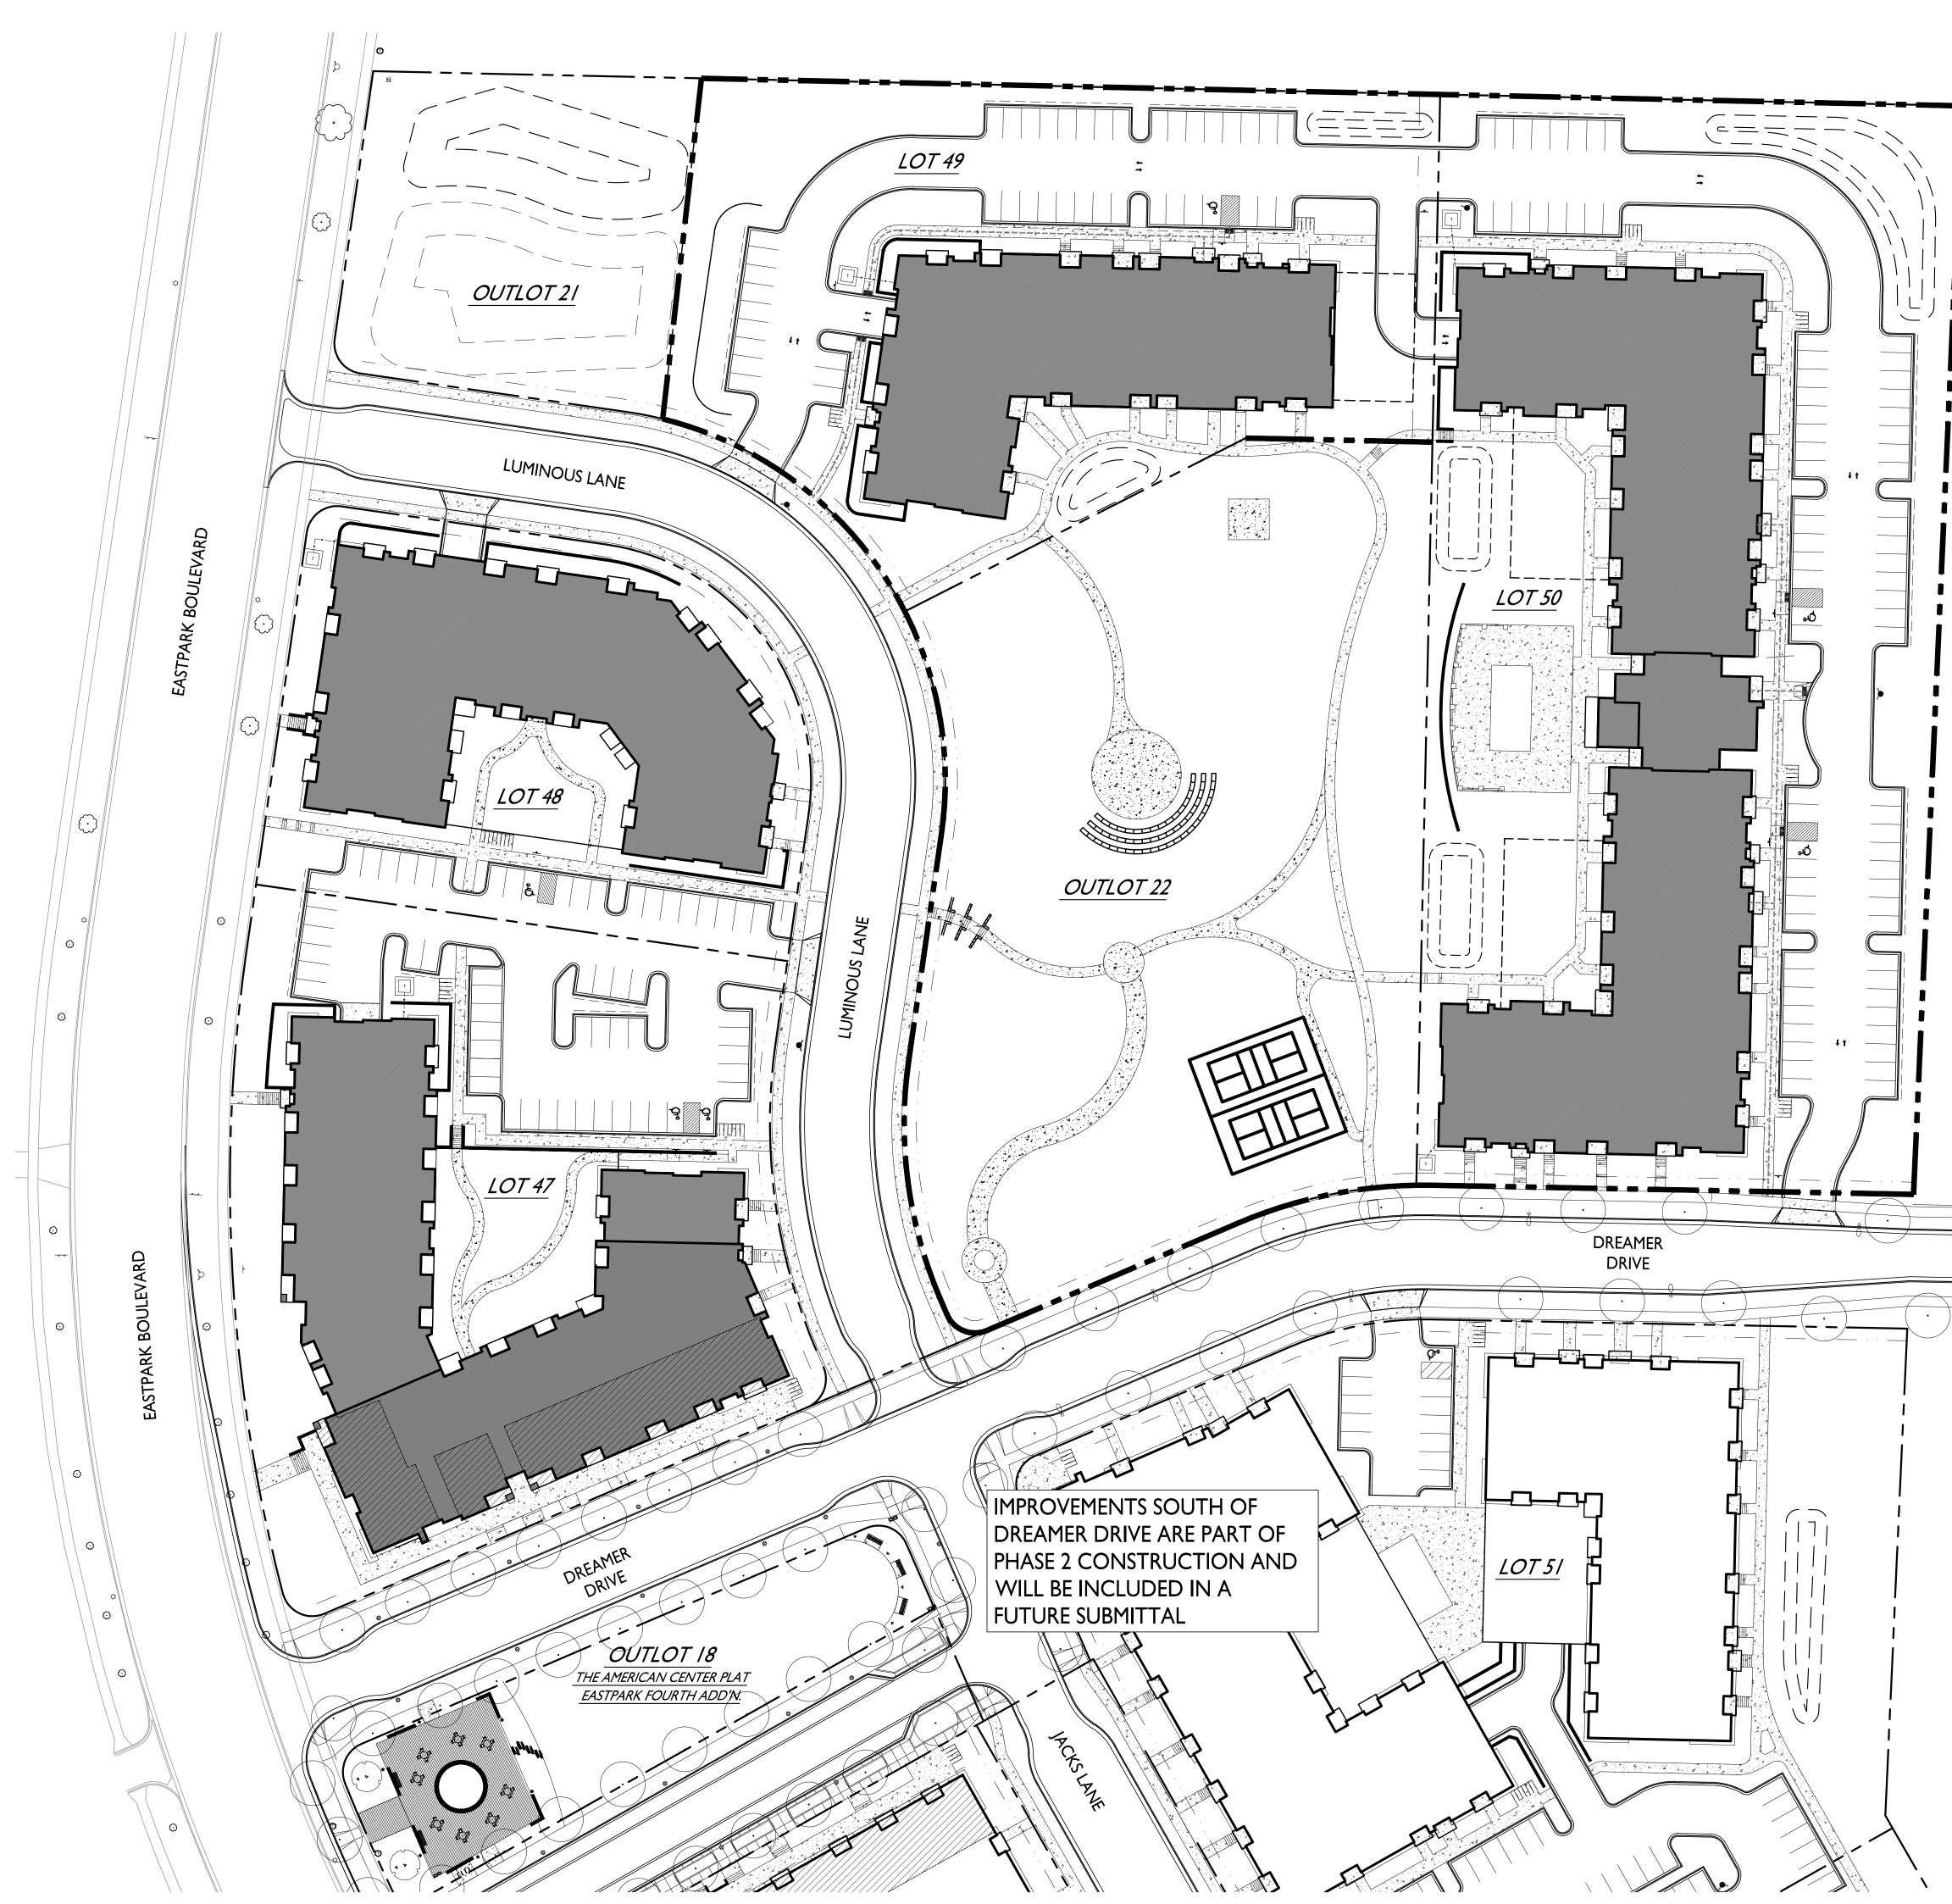

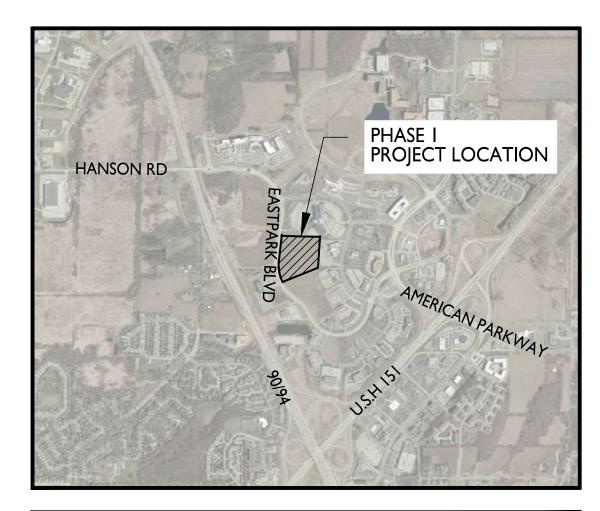

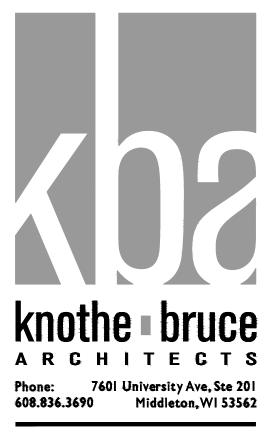

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A-2.1EXTERIOR ELEVATIONSA-2.2EXTERIOR ELEVATIONSA-2.3ELEVATIONS COLOREDA-2.4ELEVATIONS COLORED	
ARCHITECTURAL LOT 50	
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	GRAPH	IC SCALE	
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	I INCH = 40 F1	Г (24X36 SHEET)	

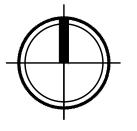ISSUED Issued for LUA & UDC Submittals - February 27, 2023

PROJECT TITLE CASCADE -THE AMERICAN CENTER EASTPARK FIFTH ADDITION


4846 Eastpark Blvd. Madison, Wl SHEET TITLE Phase I - Overall Site Plan

Lot 49-50

SHEET NUMBER

C-1.0 PROJECT NO.

2155 © Knothe & Bruce Architects, LLC

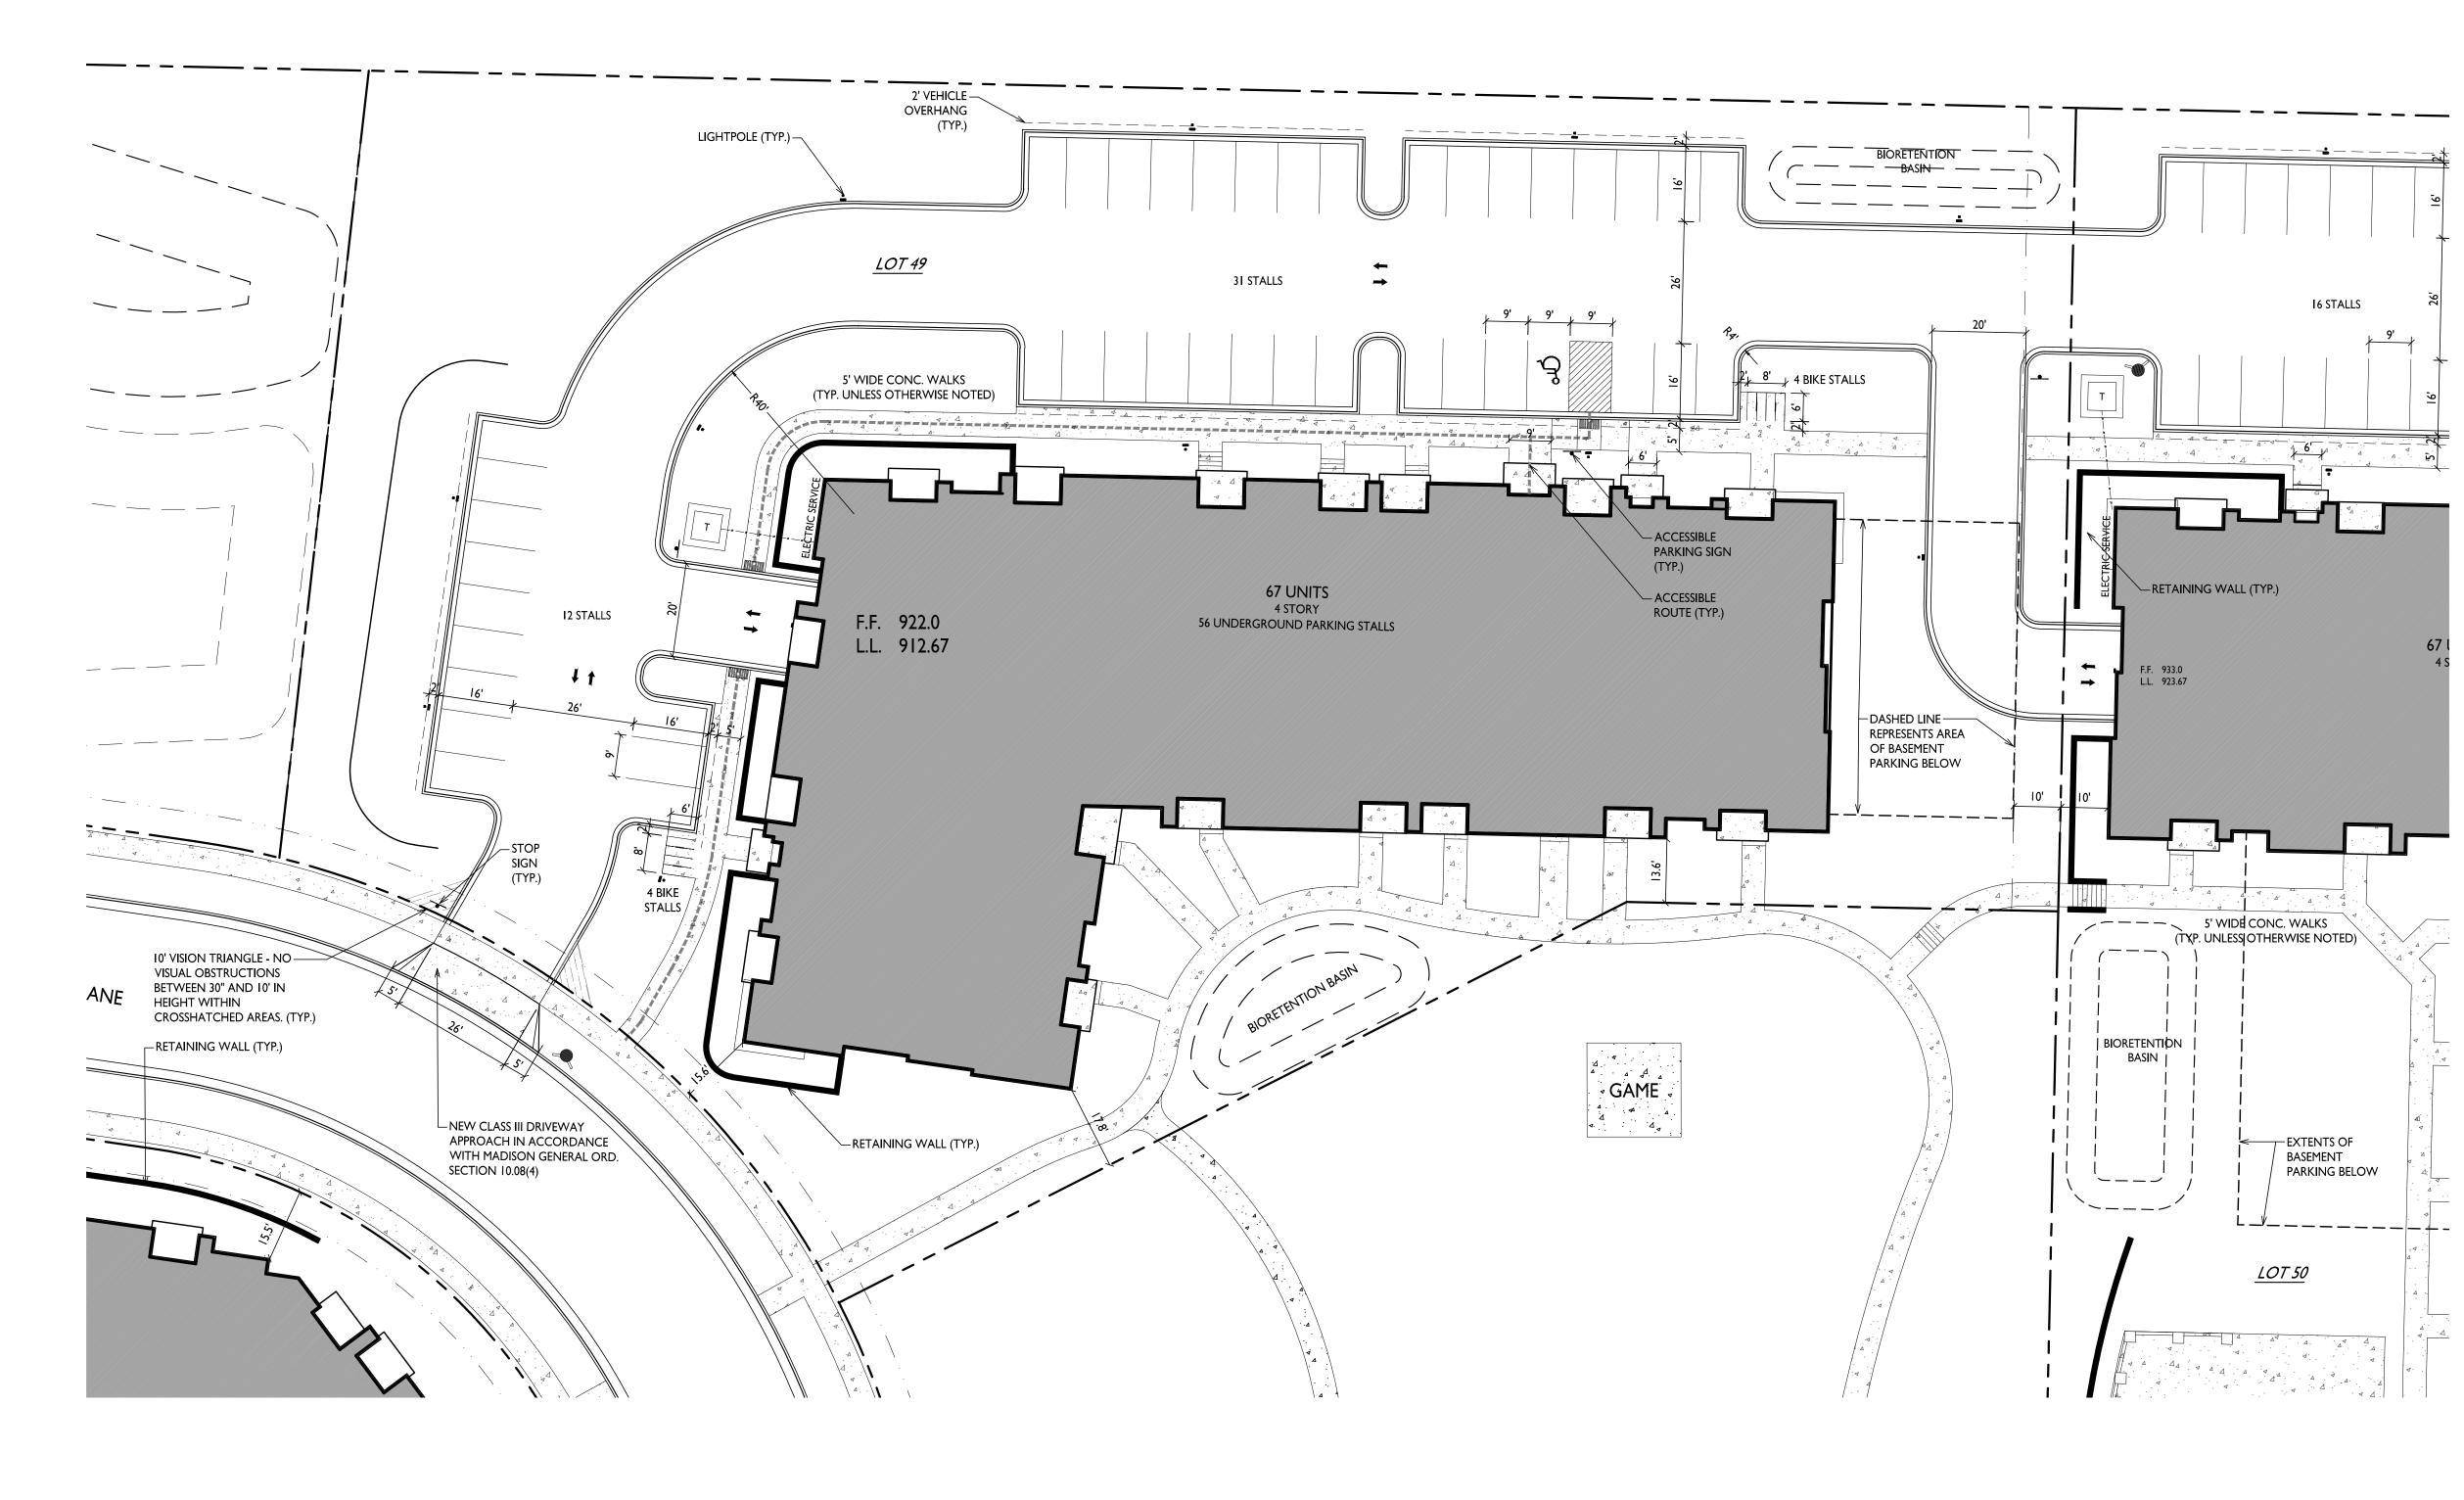

Zoning	TR-U2	
Densities:		
Lot Area	74,337 S.F./I.7I AC	RES
Dwelling Units	67 units	
Lot Area / D.U.	I,II0 S.F./D.U.	
Density	39 units/Acre	
	PROVIDED	ZONING REQUIREMENTS
Lot Coverage	40,600 S.F. (53%)	75% Max.
Building Height	4 stories/54'-0"	4 Stories/52' Max.
Gross Building Area	95,002 S.F.	
Dwelling Unit Mix:		
Studio	9	
One Bedroom	30	
Two Bedroom	28	
Total Dwelling Units	67	
Vehicle Parking Stalls:		
Underground Garage	56	
Surface	43	
Total	99	
Electric Vehicle Parking Stall	s:	
EV Installed	2	2 - Min. 2% of Residential Stalls
EV Ready	6	6 - Min. 10% of Residential Stalls
Total	8	8 - Min. EV Required
Bicycle Parking:		
Long-Term Covered Garag	e 67	67 - Min. 100% of Req'd
(49 F.M. & I	8 W.M.)	
Short-Term Guest - Surface		7 - Min. 10% of Units
	75	

ARCHITECTS Phone: 7601 University Ave, Ste 201 608.836.3690 Middleton, WI 53562

GENERAL NOTES:

I. THE APPLICANT SHALL REPLACE ALL SIDEWALK AND CURB AND GUTTER THAT ABUTS THE PROPERTY THAT IS DAMAGED BY THE CONSTRUCTION, OR ANY SIDEWALK AND CURB AND GUTTER WHICH THE CITY ENGINEER DETERMINES NEEDS TO BE REPLACED BECAUSE IT IS NOT AT A DESIRABLE GRADE, REGARDLESS OF WHETHER THE CONDITION EXISTED PRIOR TO BEGINNING CONSTRUCTION.

2. ALL WORK IN THE PUBLIC RIGHT OF WAY SHALL BE PERFORMED BY A CITY-LICENSED CONTRACTOR.

3. ALL DAMAGE TO THE PAVEMENT ON CITY STREETS, AND ADJACENT TO THIS DEVELOPMENT SHALL BE RESTORED IN ACCORDANCE WITH THE CITY OF MADISON'S PAVEMENT PATCHING CRITERIA.

4. ALL PROPOSED STREET TREE REMOVALS WITHIN THE RIGHT OF WAY SHALL BE REVIEWED BY CITY FORESTRY BEFORE THE PLAN COMMISSION MEETING. STREET TREE REMOVALS REQUIRE APPROVAL AND A TREE REMOVAL PERMIT ISSUED BY CITY FORESTRY. ANY STREET TREE REMOVALS REQUESTED AFTER THE DEVELOPMENT PLAN IS APPROVED BY THE PLAN COMMISSION OR THE BOARD OF PUBLIC WORKS AND CITY FORESTRY WILL REQUIRE A MINIMUM OF A 72-HOUR REVIEW PERIOD WHICH SHALL INCLUDE THE NOTIFICATION OF THE ALDERPERSON WITHIN WHO'S DISTRICT IS AFFECTED BY THE STREET TREE REMOVAL(S) PRIOR TO A TREE REMOVAL PERMIT BEING ISSUED.

5. AS DEFINED BY THE SECTION 107.13 OF CITY OF MADISON STANDARD SPECIFICATIONS FOR PUBLIC WORKS CONSTRUCTION: NO EXCAVATION IS PERMITTED WITHIN 5 FEET OF THE TRUNK OF THE STREET TREE OR WHEN CUTTING ROOTS OVER 3 INCHES IN DIAMETER. IF EXCAVATION IS NECESSARY, THE CONTRACTOR SHALL CONTACT MADISON CITY FORESTRY (266-4816) PRIOR TO EXCAVATION. CITY OF MADISON FORESTRY PERSONNEL SHALL ASSESS THE IMPACT TO THE TREE AND TO ITS ROOT SYSTEM PRIOR TO WORK COMMENCING. TREE PROTECTION SPECIFICATIONS CAN BE FOUND ON THE FOLLOWING WEBSITE: CITYOFMADISON.COM/BUSINESS/PW/SPECS.CFM

6. CONTRACTOR SHALL TAKE PRECAUTIONS DURING CONSTRUCTION TO NOT DISFIGURE, SCAR, OR IMPAIR THE HEALTH OF ANY STREET TREE. CONTRACTOR SHALL OPERATE EQUIPMENT IN A MANNER AS TO NOT DAMAGE THE BRANCHES OF THE STREET TREE(S). THIS MAY REQUIRE USING SMALLER EQUIPMENT AND LOADING AND UNLOADING MATERIALS IN A DESIGNATED SPACE AWAY FROM TREES ON THE CONSTRUCTION SITE. ANY DAMAGE OR INJURY TO EXISTING STREET TREES (EITHER ABOVE OR BELOW GROUND) SHALL BE REPORTED IMMEDIATELY TO CITY FORESTRY AT 266-4816. PENALTIES AND REMEDIATION SHALL BE REQUIRED.

7. SECTION 107.13(G) OF CITY OF MADISON STANDARD SPECIFICATIONS FOR PUBLIC WORKS CONSTRUCTION ADDRESSES SOIL COMPACTION NEAR STREET TREES AND SHALL BE FOLLOWED BY CONTRACTOR. THE STORAGE OF PARKED VEHICLES, CONSTRUCTION EQUIPMENT, BUILDING MATERIALS, REFUSE, EXCAVATED SPOILS OR DUMPING OF POISONOUS MATERIALS ON OR AROUND TREES AND ROOTS WITHIN FIVE (5) FEET OF THE TREE OR WITHIN THE PROTECTION ZONE IS PROHIBITED.


8. ON THIS PROJECT, STREET TREE PROTECTION ZONE FENCING IS REQUIRED. THE FENCING SHALL BE ERECTED BEFORE THE DEMOLITION, GRADING OR CONSTRUCTION BEGINS. THE FENCE SHALL INCLUDE THE ENTIRE WIDTH OF TERRACE AND, EXTEND AT LEAST 5 FEET ON BOTH SIDES OF THE OUTSIDE EDGE OF THE TREE TRUNK. DO NOT REMOVE THE FENCING TO ALLOW FOR DELIVERIES OR EQUIPMENT ACCESS THROUGH THE TREE PROTECTION ZONE.

9. STREET TREE PRUNING SHALL BE COORDINATED WITH MADISON FORESTRY AT A MINIMUM OF TWO WEEKS PRIOR TO THE START OF CONSTRUCTION FOR THIS PROJECT. ALL PRUNING SHALL FOLLOW THE AMERICAN NATIONAL STANDARDS INSTITUTE (ANSI) A300 - PART I STANDARDS FOR PRUNING.

10. AT LEAST ONE WEEK PRIOR TO STREET TREE PLANTING, CONTRACTOR SHALL CONTACT CITY FORESTRY AT (608) 266-4816 TO SCHEDULE INSPECTION AND APPROVAL OF NURSERY TREE STOCK AND REVIEW PLANTING SPECIFICATIONS WITH THE LANDSCAPER.

11. APPROVAL OF PLANS FOR THIS PROJECT DOES NOT INCLUDE ANY APPROVAL TO PRUNE, REMOVE, OR PLANT TREES IN THE PUBLIC RIGHT-OF-WAY. PERMISSION FOR SUCH ACTIVITIES MUST BE OBTAINED FROM THE CITY FORESTER (266-4816).

12. THE PUBLIC RIGHT-OF-WAY IS THE SOLE JURISDICTION OF THE CITY OF MADISON AND IS SUBJECT TO CHANGE AT ANY TIME. NO ITEMS SHOWN ON THIS SITE PLAN IN THE RIGHT-OF-WAY ARE PERMANENT AND MAY NEED TO BE REMOVED AT THE APPLICANTS EXPENSE UPON NOTIFICATION BY THE CITY.

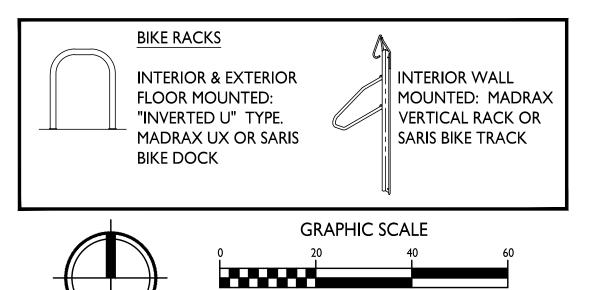

I INCH = 20 FT (24X36 SHEET)

ISSUED Issued for LUA & UDC Submittals - February 27, 2023

PROJECT TITLE CASCADE -THE AMERICAN CENTER EASTPARK FIFTH ADDITION


4846 Eastpark Blvd. Madison, WI SHEET TITLE Site Plan



SHEET NUMBER



PROJECT NO. 2155 © Knothe & Bruce Architects, LLC

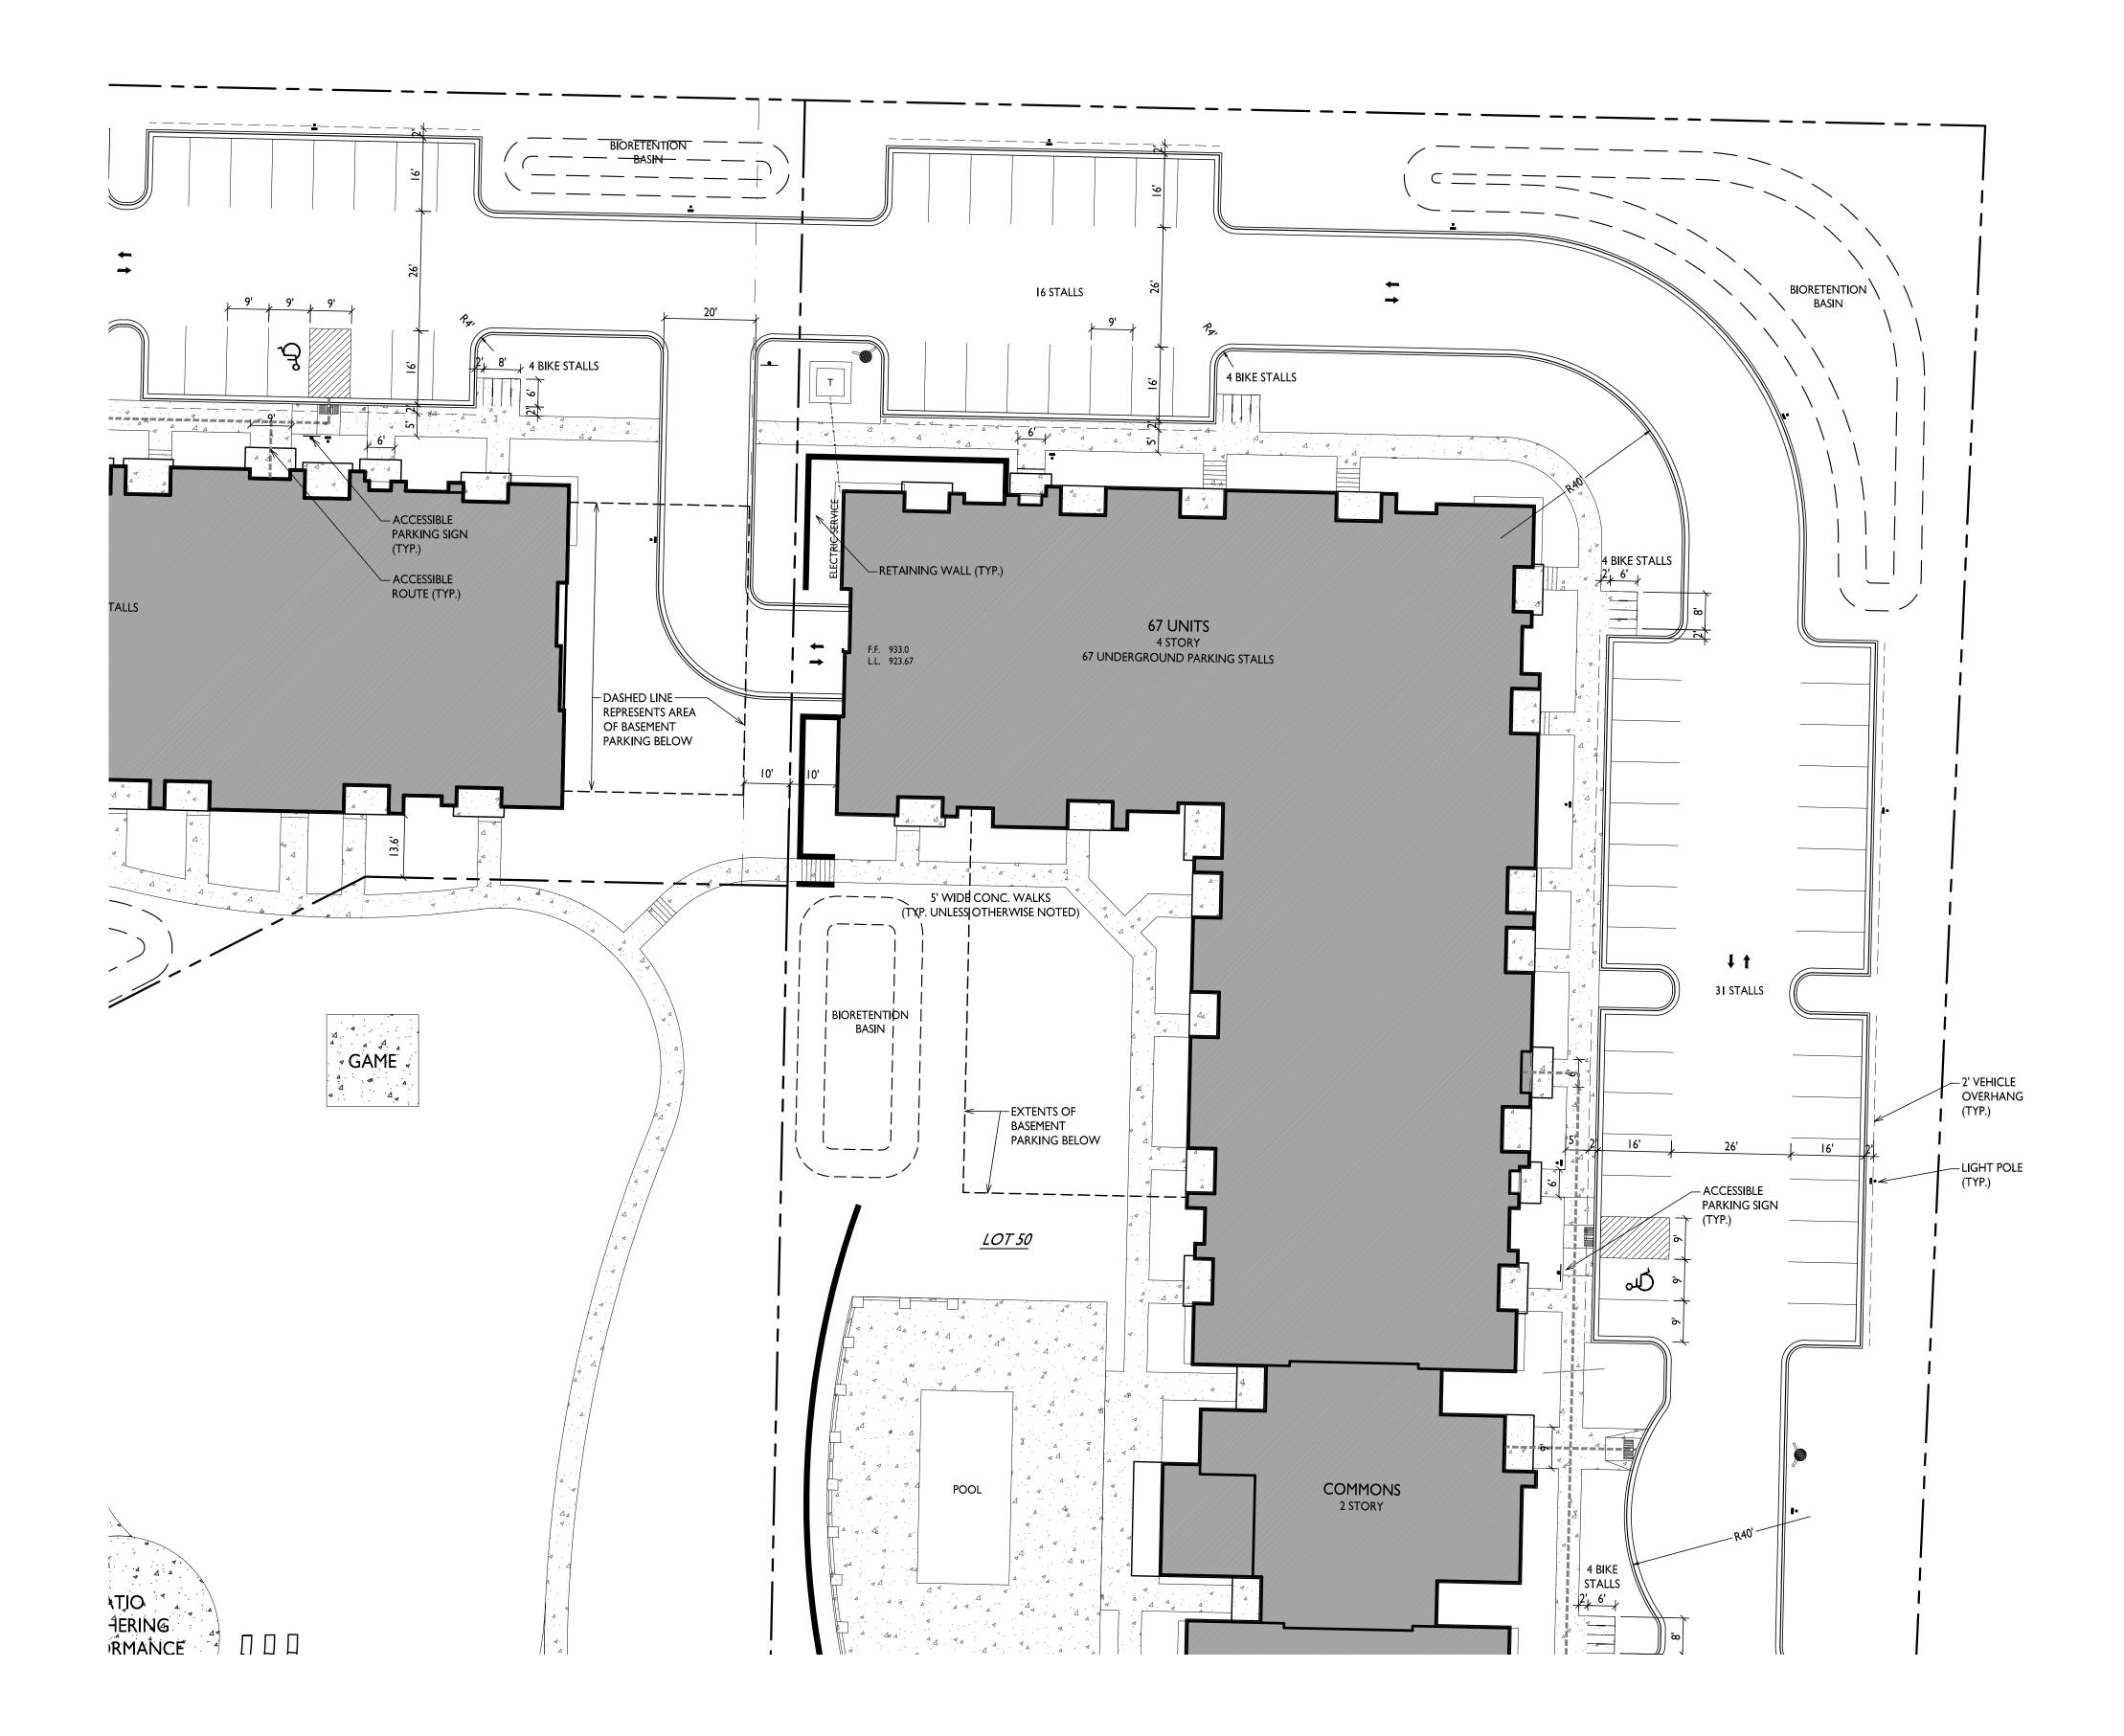

Site Development Data: Zoning Densities:	TR-U2	
Lot Area	134,349 S.F./3.08 AC	DEC
Dwelling Units	134 units	.NE3
Lot Area / D.U.	1,003 S.F./D.U.	
Density	43.5 units/Acre	
Density	PROVIDED	ZONING REQUIREMENTS
Lot Coverage	79,200 S.F. (59%)	75% Max.
Building Height	4 stories/54'-0"	4 Stories/52' Max.
Gross Building Area	199,967 S.F.	
Gross Building / Irea	177,707 5.1.	
Dwelling Unit Mix:		
Studio	24	
One Bedroom	54	
One Bedroom + Den	8	
Two Bedroom	48	
Total Dwelling Units	134	
Vehicle Parking Stalls:		
Underground Garage	135	
Surface	78	
Total	213	
Electric Vehicle Parking Stalls:		
EV Installed	3	3 - Min. 2% of Residential Stalls
EV Ready	14	14 - Min. 10% of Residential Stalls
Total	17	17 - Min. EV Required
Bicycle Parking:		
Long-Term Covered Garage	134	134 - Min. 100% of Req'd
(98 F.M. & 36 V	V.M.)	,
Short-Term Guest - Surface	16	14 - Min. 10% of Units
Total	150	148 - Min. Bike Stalls Required



GENERAL NOTES:

I. THE APPLICANT SHALL REPLACE ALL SIDEWALK AND CURB AND GUTTER THAT ABUTS THE PROPERTY THAT IS DAMAGED BY THE CONSTRUCTION, OR ANY SIDEWALK AND CURB AND GUTTER WHICH THE CITY ENGINEER DETERMINES NEEDS TO BE REPLACED BECAUSE IT IS NOT AT A DESIRABLE GRADE, REGARDLESS OF WHETHER THE CONDITION EXISTED PRIOR TO BEGINNING CONSTRUCTION.

2. ALL WORK IN THE PUBLIC RIGHT OF WAY SHALL BE PERFORMED BY A CITY-LICENSED CONTRACTOR.

3. ALL DAMAGE TO THE PAVEMENT ON CITY STREETS, AND ADJACENT TO THIS DEVELOPMENT SHALL BE RESTORED IN ACCORDANCE WITH THE CITY OF MADISON'S PAVEMENT PATCHING CRITERIA.

4. ALL PROPOSED STREET TREE REMOVALS WITHIN THE RIGHT OF WAY SHALL BE REVIEWED BY CITY FORESTRY BEFORE THE PLAN COMMISSION MEETING. STREET TREE REMOVALS REQUIRE APPROVAL AND A TREE REMOVAL PERMIT ISSUED BY CITY FORESTRY. ANY STREET TREE REMOVALS REQUESTED AFTER THE DEVELOPMENT PLAN IS APPROVED BY THE PLAN COMMISSION OR THE BOARD OF PUBLIC WORKS AND CITY FORESTRY WILL REQUIRE A MINIMUM OF A 72-HOUR REVIEW PERIOD WHICH SHALL INCLUDE THE NOTIFICATION OF THE ALDERPERSON WITHIN WHO'S DISTRICT IS AFFECTED BY THE STREET TREE REMOVAL(S) PRIOR TO A TREE REMOVAL PERMIT BEING ISSUED.

5. AS DEFINED BY THE SECTION 107.13 OF CITY OF MADISON STANDARD SPECIFICATIONS FOR PUBLIC WORKS CONSTRUCTION: NO EXCAVATION IS PERMITTED WITHIN 5 FEET OF THE TRUNK OF THE STREET TREE OR WHEN CUTTING ROOTS OVER 3 INCHES IN DIAMETER. IF EXCAVATION IS NECESSARY, THE CONTRACTOR SHALL CONTACT MADISON CITY FORESTRY (266-4816) PRIOR TO EXCAVATION. CITY OF MADISON FORESTRY PERSONNEL SHALL ASSESS THE IMPACT TO THE TREE AND TO ITS ROOT SYSTEM PRIOR TO WORK COMMENCING. TREE PROTECTION SPECIFICATIONS CAN BE FOUND ON THE FOLLOWING WEBSITE: CITYOFMADISON.COM/BUSINESS/PW/SPECS.CFM

6. CONTRACTOR SHALL TAKE PRECAUTIONS DURING CONSTRUCTION TO NOT DISFIGURE, SCAR, OR IMPAIR THE HEALTH OF ANY STREET TREE. CONTRACTOR SHALL OPERATE EQUIPMENT IN A MANNER AS TO NOT DAMAGE THE BRANCHES OF THE STREET TREE(S). THIS MAY REQUIRE USING SMALLER EQUIPMENT AND LOADING AND UNLOADING MATERIALS IN A DESIGNATED SPACE AWAY FROM TREES ON THE CONSTRUCTION SITE. ANY DAMAGE OR INJURY TO EXISTING STREET TREES (EITHER ABOVE OR BELOW GROUND) SHALL BE REPORTED IMMEDIATELY TO CITY FORESTRY AT 266-4816. PENALTIES AND REMEDIATION SHALL BE REQUIRED.

7. SECTION 107.13(G) OF CITY OF MADISON STANDARD SPECIFICATIONS FOR PUBLIC WORKS CONSTRUCTION ADDRESSES SOIL COMPACTION NEAR STREET TREES AND SHALL BE FOLLOWED BY CONTRACTOR. THE STORAGE OF PARKED VEHICLES, CONSTRUCTION EQUIPMENT, BUILDING MATERIALS, REFUSE, EXCAVATED SPOILS OR DUMPING OF POISONOUS MATERIALS ON OR AROUND TREES AND ROOTS WITHIN FIVE (5) FEET OF THE TREE OR WITHIN THE PROTECTION ZONE IS PROHIBITED.


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9. STREET TREE PRUNING SHALL BE COORDINATED WITH MADISON FORESTRY AT A MINIMUM OF TWO WEEKS PRIOR TO THE START OF CONSTRUCTION FOR THIS PROJECT. ALL PRUNING SHALL FOLLOW THE AMERICAN NATIONAL STANDARDS INSTITUTE (ANSI) A300 - PART I STANDARDS FOR PRUNING.

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PROJECT TITLE CASCADE -THE AMERICAN CENTER EASTPARK FIFTH ADDITION

ISSUED


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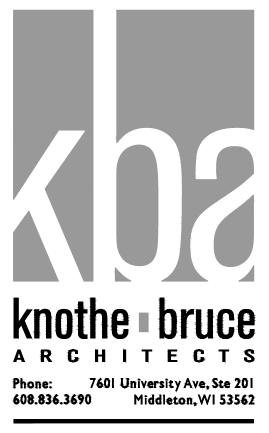
4846 Eastpark Blvd. Madison, WI SHEET TITLE Partial Site Plan -North

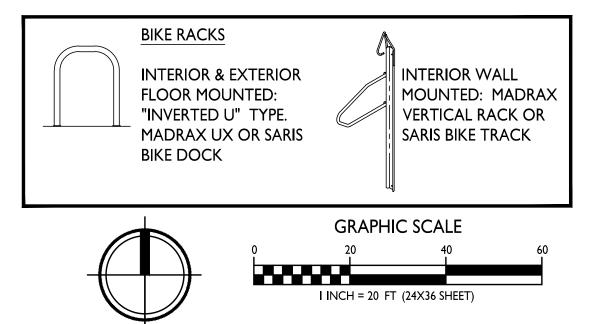

© Knothe & Bruce Architects, LLC

C-I.2
PROJECT NO. 2155



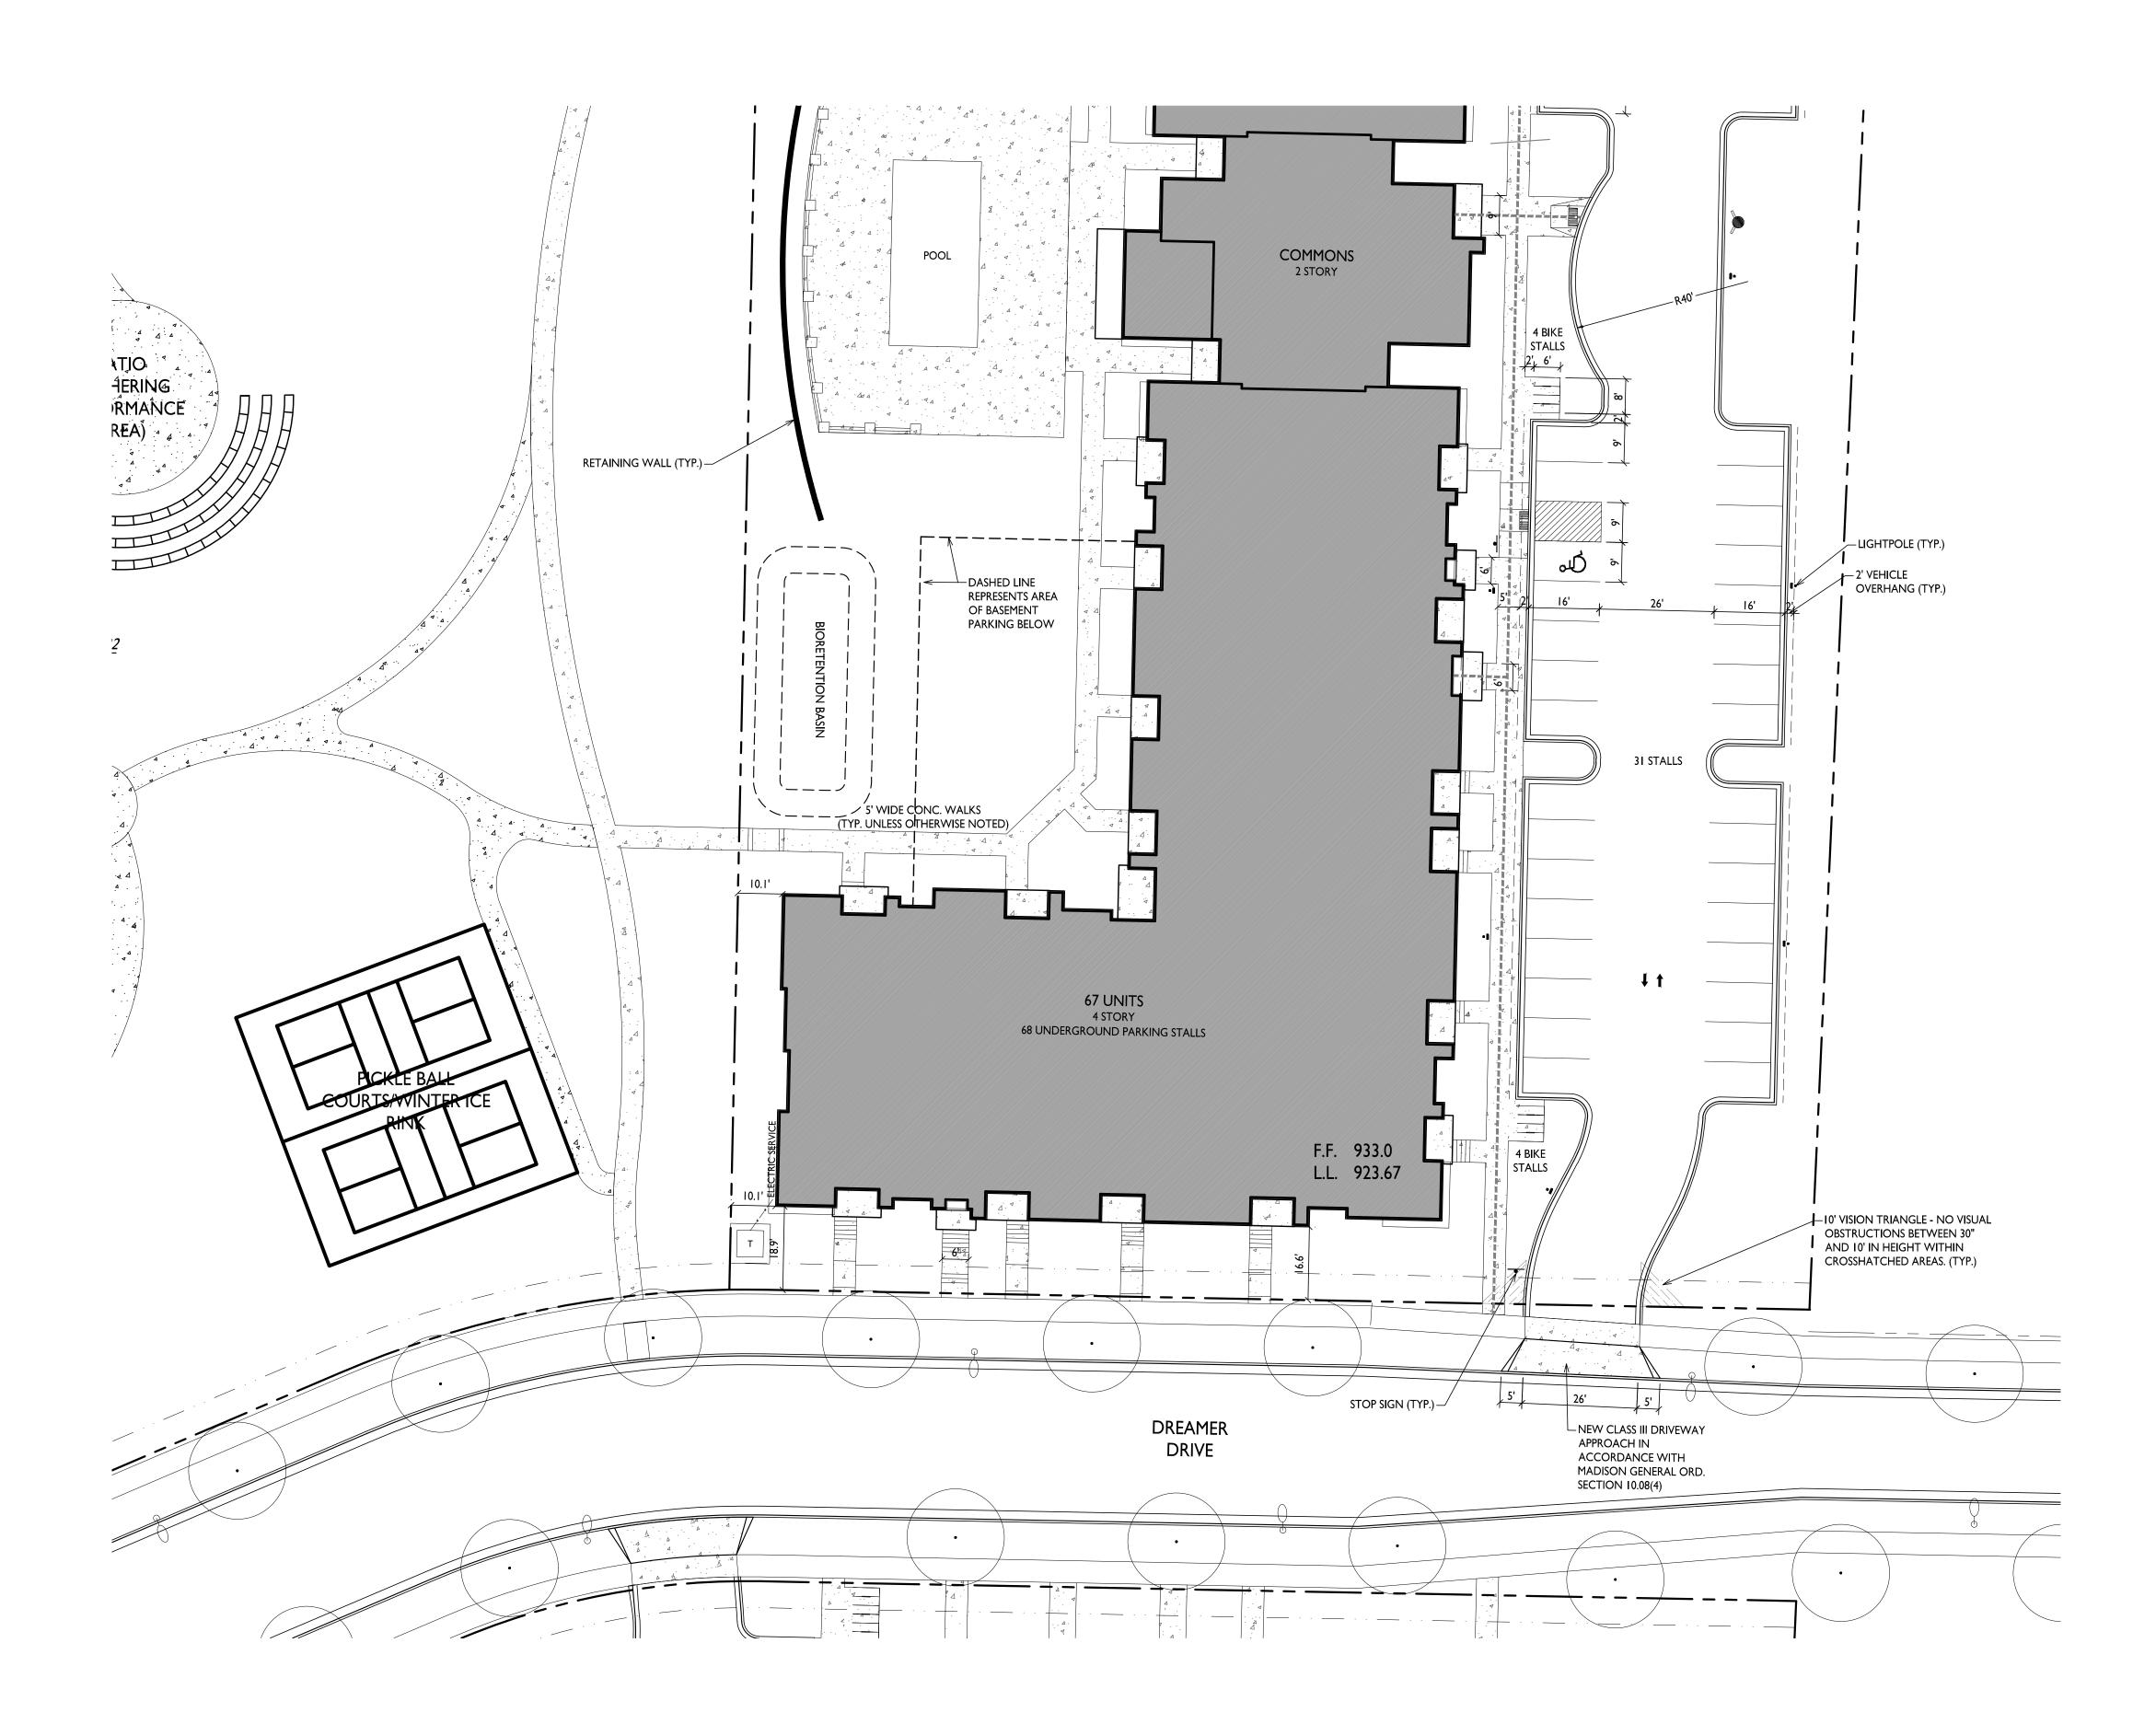

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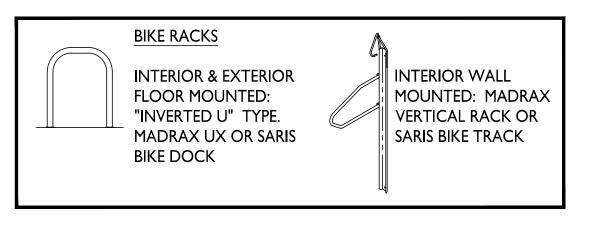
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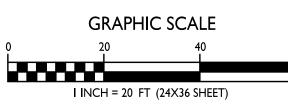
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ISSUED

PROJECT TITLE CASCADE -THE AMERICAN CENTER EASTPARK FIFTH ADDITION


4846 Eastpark Blvd. Madison, WI SHEET TITLE Partial Site Plan -South

Lot 50

SHEET NUMBER

C-1.3

PROJECT NO. 2155 © Knothe & Bruce Architects, LLC

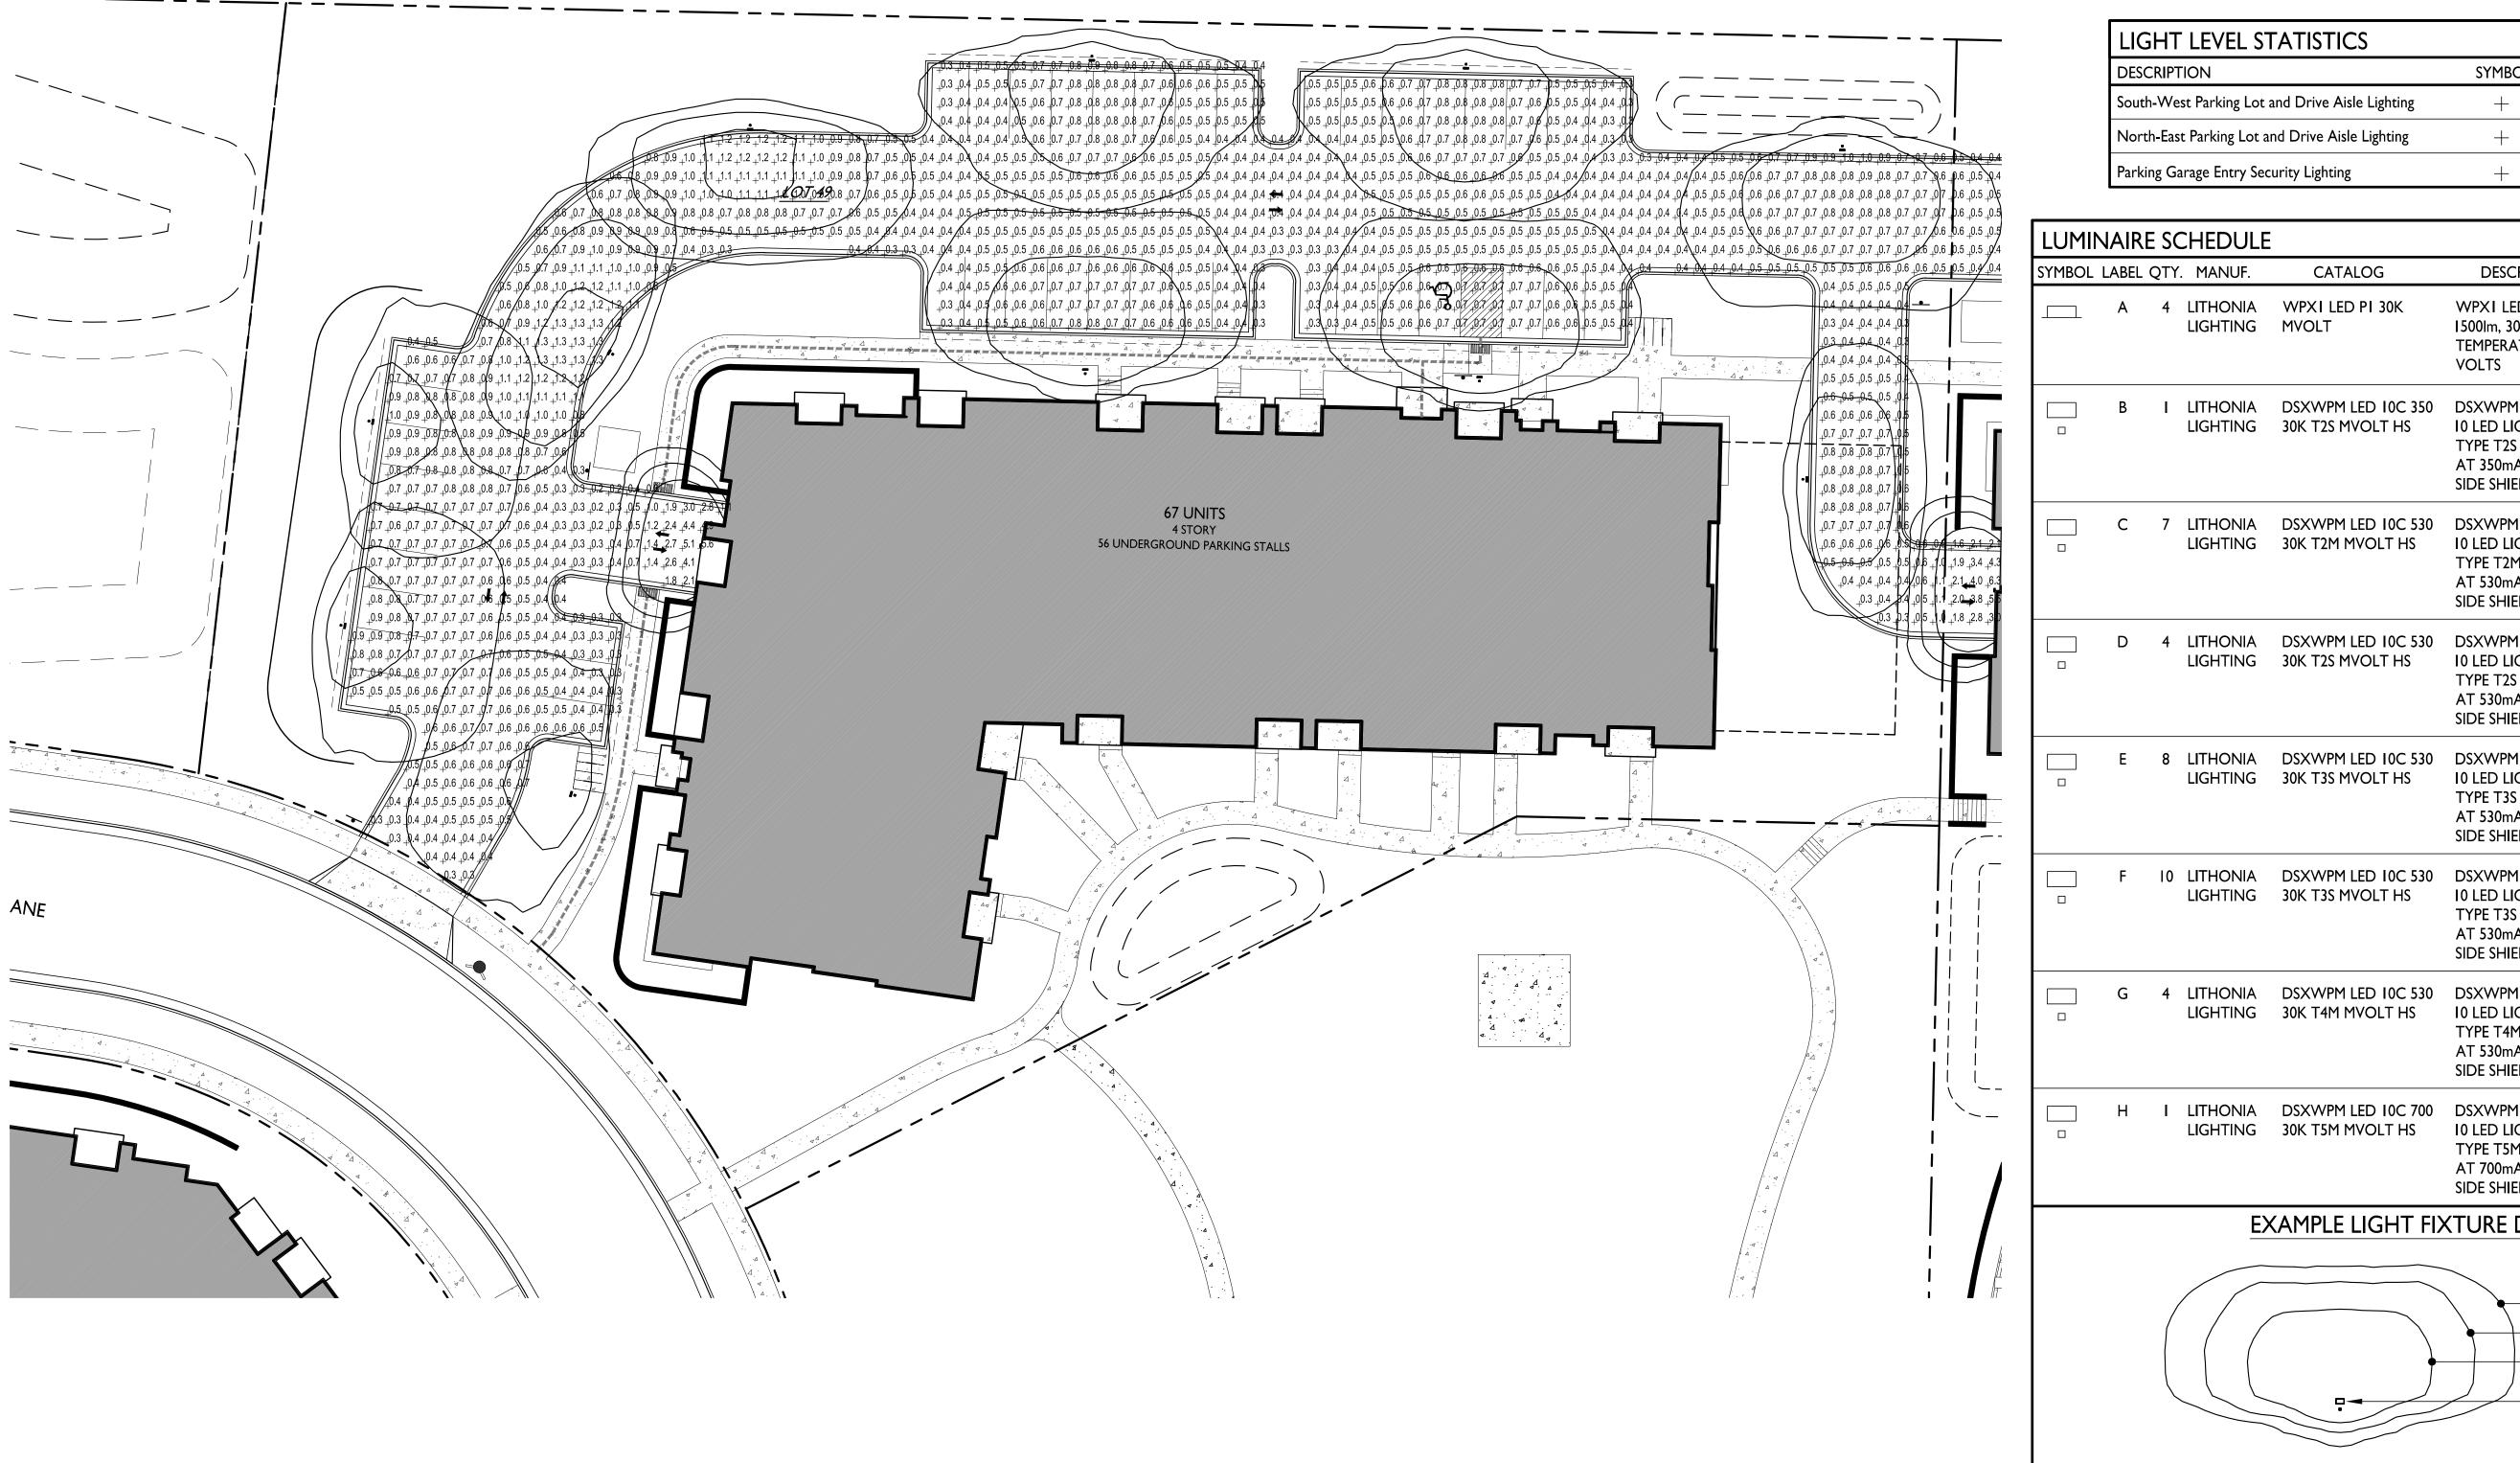

VEL STATISTICS						
	SYMBOL	AVG.	MAX.	MIN.	MAX. / MIN.	AVG. / MIN.
king Lot and Drive Aisle Lighting	+	0.7 fc	6.4 fc	0.2 fc	32.0:I	3.5:I
ing Lot and Drive Aisle Lighting	+	0.6 fc	6.3 fc	0.2 fc	31.5:1	3.0:I
Entry Security Lighting	+	2.4 fc	5.7 fc	0.5 fc	11.4:1	4.8:I

DULE							
NUF.	CATALOG	DESCRIPTION	FILE	MOUNTING			
IONIA ITING	WPXI LED PI 30K MVOLT	WPXI LED WALLPACK, I500lm, 3000K COLOR TEMPERATURE, I20-277 VOLTS	WPX1_LED_P1 _30K_MVOLT.ies	8'-0" ABOVE GRADE ON BUILDING			
IONIA ITING	DSXWPM LED IOC 350 30K T2S MVOLT HS	DSXWPM LED WITH (I) I0 LED LIGHT ENGINE, TYPE T2S OPTIC, 3000K AT 350mA, WITH HOUSE SIDE SHIELD	DSXWPM_LED_10C _350_30K_T2S _MVOLT_HS.ies	16'-0" POLE ON 2'-0" TALL CONC. BASE			
IONIA HTING	DSXWPM LED IOC 530 30K T2M MVOLT HS	DSXWPM LED WITH (I) I0 LED LIGHT ENGINE, TYPE T2M OPTIC, 3000K AT 530mA, WITH HOUSE SIDE SHIELD	DSXWPM_LED_10C _530_30K_T2M _MVOLT_HS.ies	16'-0" POLE ON 2'-0" TALL CONC. BASE			
IONIA ITING	DSXWPM LED IOC 530 30K T2S MVOLT HS	DSXWPM LED WITH (I) I0 LED LIGHT ENGINE, TYPE T2S OPTIC, 3000K AT 530mA, WITH HOUSE SIDE SHIELD	DSXWPM_LED_10C _530_30K_T2S _MVOLT_HS.ies	16'-0" POLE ON 2'-0" TALL CONC. BASE			
IONIA HTING	DSXWPM LED IOC 530 30K T3S MVOLT HS	DSXWPM LED WITH (I) I0 LED LIGHT ENGINE, TYPE T3S OPTIC, 3000K AT 530mA, WITH HOUSE SIDE SHIELD	DSXWPM_LED_10C _530_30K_T3S _MVOLT_HS.ies	16'-0" POLE ON 2'-0" TALL CONC. BASE			
IONIA ITING	DSXWPM LED IOC 530 30K T3S MVOLT HS	DSXWPM LED WITH (I) I0 LED LIGHT ENGINE, TYPE T3S OPTIC, 3000K AT 530mA, WITH HOUSE SIDE SHIELD	DSXWPM_LED_10C _530_30K_T3S _MVOLT_HS.ies	18'-0" POLE ON FLUSH CONC. BASE			
IONIA ITING	DSXWPM LED IOC 530 30K T4M MVOLT HS	DSXWPM LED WITH (I) I0 LED LIGHT ENGINE, TYPE T4M OPTIC, 3000K AT 530mA, WITH HOUSE SIDE SHIELD	DSXWPM_LED_10C _530_30K_T4M _MVOLT_HS.ies	16'-0" POLE ON 2'-0" TALL CONC. BASE			
IONIA HTING	DSXWPM LED IOC 700 30K T5M MVOLT HS	DSXWPM LED WITH (I) I0 LED LIGHT ENGINE, TYPE T5M OPTIC, 3000K AT 700mA, WITH HOUSE SIDE SHIELD	DSXWPM_LED_10C _700_30K_T5M _MVOLT_HS.ies	16'-0" POLE ON 2'-0" TALL CONC. BASE			

EXAMPLE LIGHT FIXTURE DISTRIBUTION

ISOLUX CONTOUR = 0.25 FC ISOLUX CONTOUR = 0.5 FC ISOLUX CONTOUR = 1.0 FC LIGHT FIXTURE

knothe bruce ARCHITECTS Phone: 7601 University Ave, Ste 201 608.836.3690 Middleton, WI 53562

ISSUED Issued for LUA & UDC Submittals - February 27, 2023

PROJECT TITLE CASCADE -THE AMERICAN CENTER EASTPARK FIFTH ADDITION


4846 Eastpark Blvd. Madison, WI SHEET TITLE Site Lighting Plan

Lot 49


SHEET NUMBER

C-2.1 PROJECT NO.

2155 © Knothe & Bruce Architects, LLC

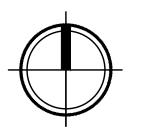

GRAPHIC SCALE I INCH = 20 FT (24X36 SHEET)

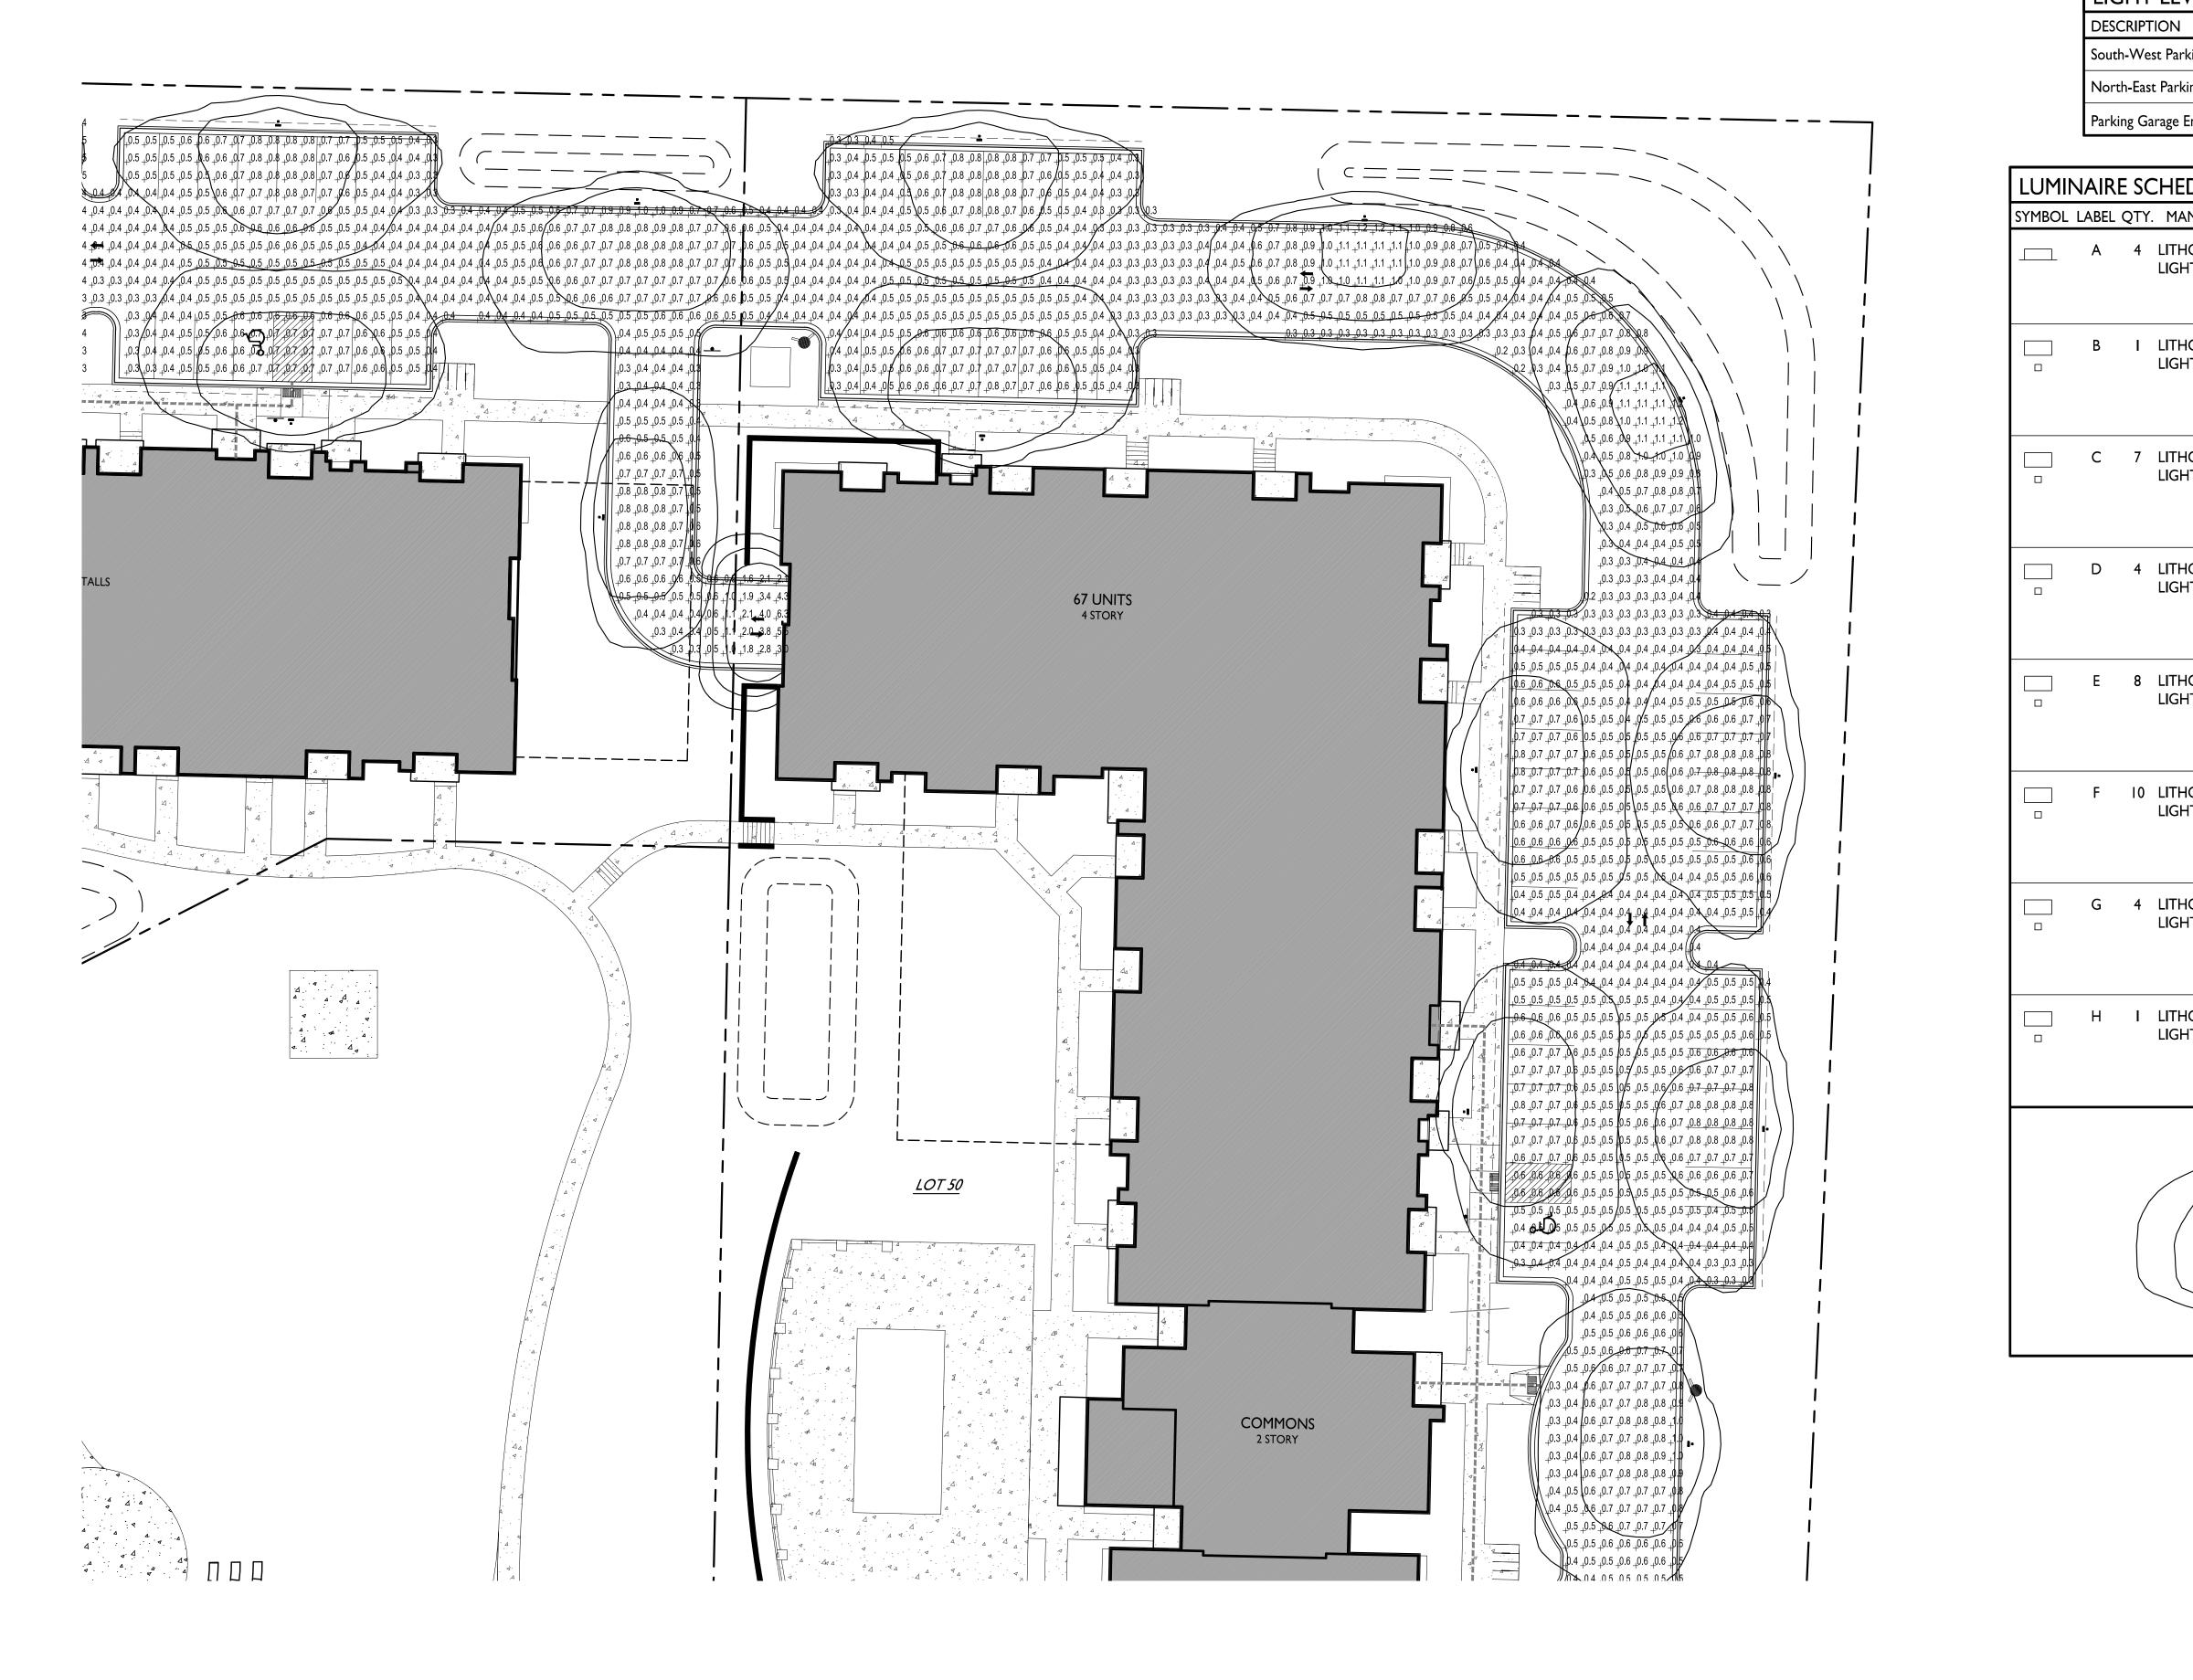


LIGHT LEVEL STATISTICS

VLL STATISTICS						
	SYMBOL	AVG.	MAX.	MIN.	MAX. / MIN.	AVG. / MIN.
king Lot and Drive Aisle Lighting	+	0.7 fc	6.4 fc	0.2 fc	32.0:I	3.5:I
ing Lot and Drive Aisle Lighting	+	0.6 fc	6.3 fc	0.2 fc	31.5:1	3.0:I
Entry Security Lighting	+	2.4 fc	5.7 fc	0.5 fc	11.4:1	4.8:I

DULE							
NUF.	CATALOG	DESCRIPTION	FILE	MOUNTING			
IONIA ITING	WPXI LED PI 30K MVOLT	WPXI LED WALLPACK, I500lm, 3000K COLOR TEMPERATURE, I20-277 VOLTS	WPX1_LED_P1 _30K_MVOLT.ies	8'-0" ABOVE GRADE ON BUILDING			
IONIA ITING	DSXWPM LED IOC 350 30K T2S MVOLT HS	DSXWPM LED WITH (I) I0 LED LIGHT ENGINE, TYPE T2S OPTIC, 3000K AT 350mA, WITH HOUSE SIDE SHIELD	DSXWPM_LED_10C _350_30K_T2S _MVOLT_HS.ies	16'-0" POLE ON 2'-0" TALL CONC. BASE			
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IONIA HTING	DSXWPM LED IOC 530 30K T3S MVOLT HS	DSXWPM LED WITH (I) 10 LED LIGHT ENGINE, TYPE T3S OPTIC, 3000K AT 530mA, WITH HOUSE SIDE SHIELD	DSXWPM_LED_10C _530_30K_T3S _MVOLT_HS.ies	18'-0" POLE ON FLUSH CONC. BASE			
IONIA HTING	DSXWPM LED IOC 530 30K T4M MVOLT HS	DSXWPM LED WITH (I) I0 LED LIGHT ENGINE, TYPE T4M OPTIC, 3000K AT 530mA, WITH HOUSE SIDE SHIELD	DSXWPM_LED_10C _530_30K_T4M _MVOLT_HS.ies	16'-0" POLE ON 2'-0" TALL CONC. BASE			
IONIA HTING	DSXWPM LED IOC 700 30K T5M MVOLT HS	DSXWPM LED WITH (I) I0 LED LIGHT ENGINE, TYPE T5M OPTIC, 3000K AT 700mA, WITH HOUSE SIDE SHIELD	DSXWPM_LED_10C _700_30K_T5M _MVOLT_HS.ies	16'-0" POLE ON 2'-0" TALL CONC. BASE			

EXAMPLE LIGHT FIXTURE DISTRIBUTION

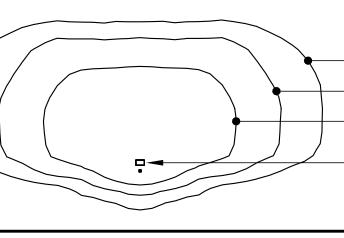

ISOLUX CONTOUR = 0.25 FC ISOLUX CONTOUR = 0.5 FC ISOLUX CONTOUR = 1.0 FC LIGHT FIXTURE **Knothe bruce** A R C H I T E C T S Phone: 7601 University Ave, Ste 201 608.836.3690 Middleton, WI 53562

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PROJECT TITLE CASCADE -THE AMERICAN CENTER EASTPARK FIFTH ADDITION


4846 Eastpark Blvd. Madison, WI SHEET TITLE Site Lighting Plan -North

Lot 50 Sheet NUMBER

C-2.2 PROJECT NO.



GRAPHIC SCALE 0 20 40 I INCH = 20 FT (24X36 SHEET)

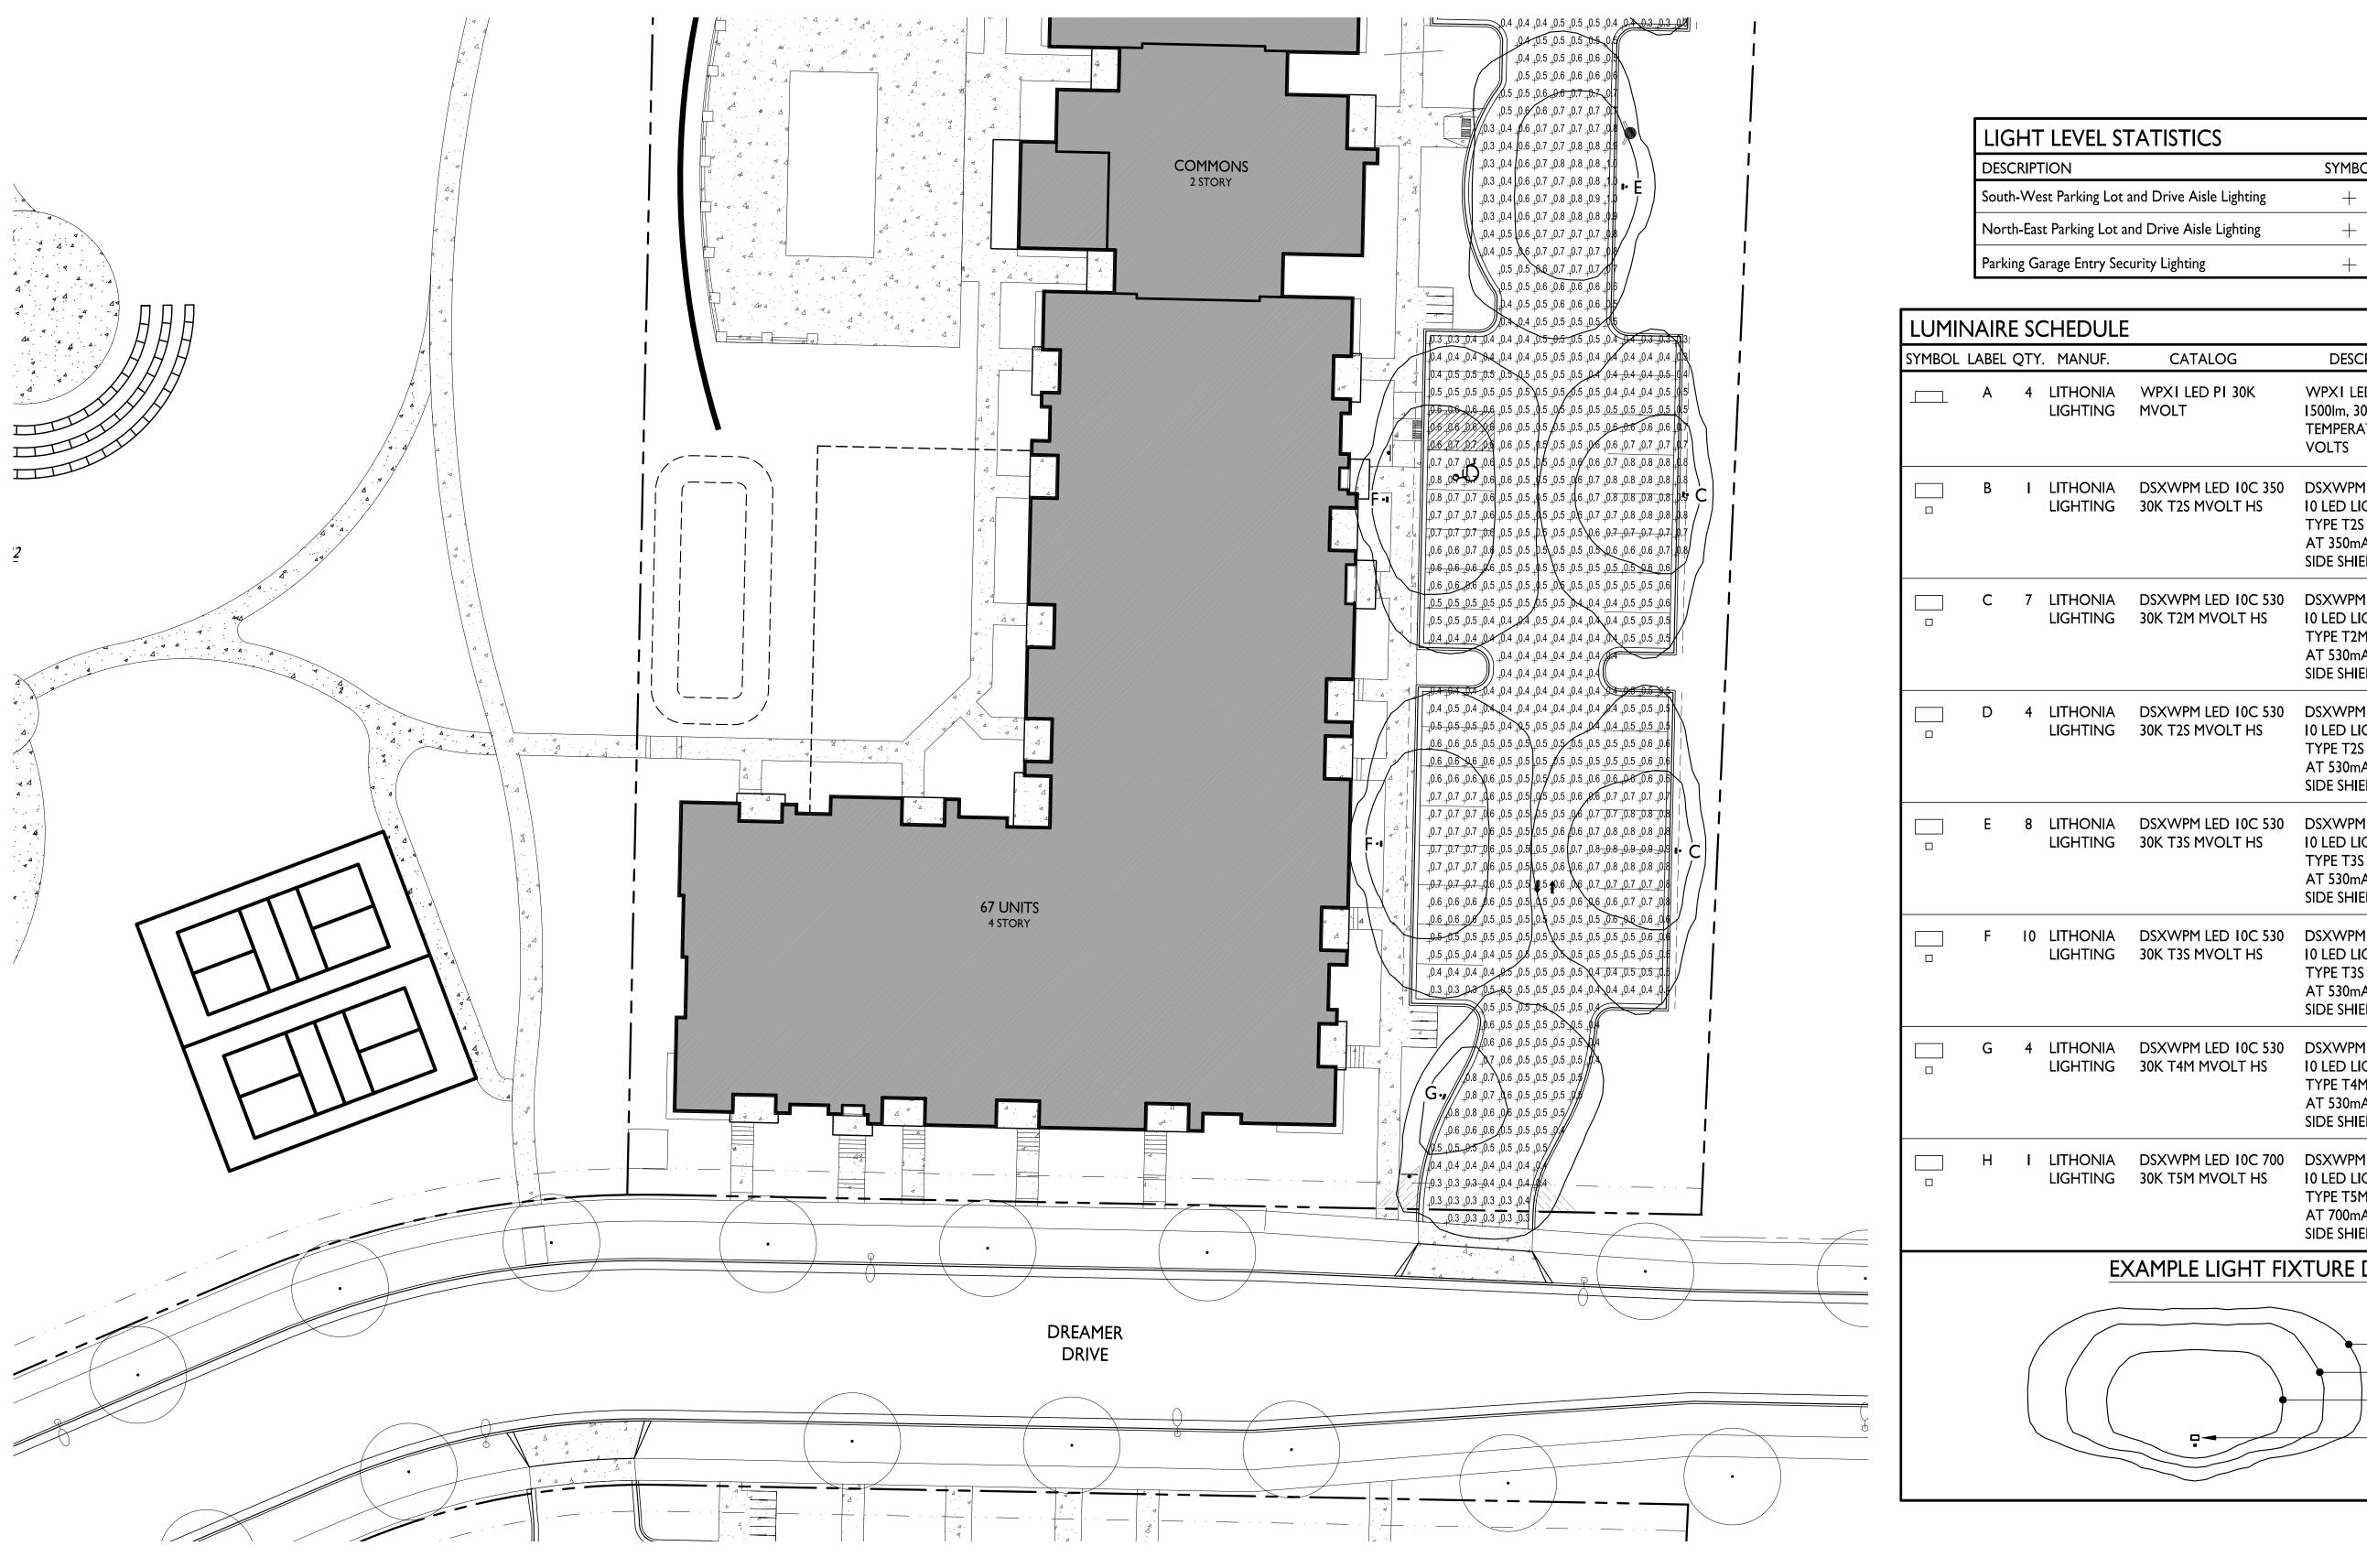

VLL STATISTICS						
	SYMBOL	AVG.	MAX.	MIN.	MAX. / MIN.	AVG. / MIN.
king Lot and Drive Aisle Lighting	+	0.7 fc	6.4 fc	0.2 fc	32.0:I	3.5:I
ing Lot and Drive Aisle Lighting	+	0.6 fc	6.3 fc	0.2 fc	31.5:1	3.0:I
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DULE				
NUF.	CATALOG	DESCRIPTION	FILE	MOUNTING
IONIA ITING	WPXI LED PI 30K MVOLT	WPXI LED WALLPACK, I500lm, 3000K COLOR TEMPERATURE, I20-277 VOLTS	WPX1_LED_P1 _30K_MVOLT.ies	8'-0" ABOVE GRADE ON BUILDING
IONIA ITING	DSXWPM LED IOC 350 30K T2S MVOLT HS	DSXWPM LED WITH (I) I0 LED LIGHT ENGINE, TYPE T2S OPTIC, 3000K AT 350mA, WITH HOUSE SIDE SHIELD	DSXWPM_LED_10C _350_30K_T2S _MVOLT_HS.ies	16'-0" POLE ON 2'-0" TALL CONC. BASE
ionia Iting	DSXWPM LED IOC 530 30K T2M MVOLT HS	DSXWPM LED WITH (I) I0 LED LIGHT ENGINE, TYPE T2M OPTIC, 3000K AT 530mA, WITH HOUSE SIDE SHIELD	DSXWPM_LED_10C _530_30K_T2M _MVOLT_HS.ies	16'-0" POLE ON 2'-0" TALL CONC. BASE
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IONIA ITING	DSXWPM LED IOC 530 30K T3S MVOLT HS	DSXWPM LED WITH (I) I0 LED LIGHT ENGINE, TYPE T3S OPTIC, 3000K AT 530mA, WITH HOUSE SIDE SHIELD	DSXWPM_LED_10C _530_30K_T3S _MVOLT_HS.ies	16'-0" POLE ON 2'-0" TALL CONC. BASE
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knothe • bruce ARCHITECTS
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 Middleton, WI 53562

ISSUED Issued for LUA & UDC Submittals - February 27, 2023

PROJECT TITLE CASCADE -THE AMERICAN CENTER EASTPARK FIFTH ADDITION

4846 Eastpark Blvd. Madison, WI SHEET TITLE Site Lighting Plan -South


Lot 50 SHEET NUMBER

C-2.3 PROJECT NO.





GRAPHIC SCALE I INCH = 20 FT (24X36 SHEET)

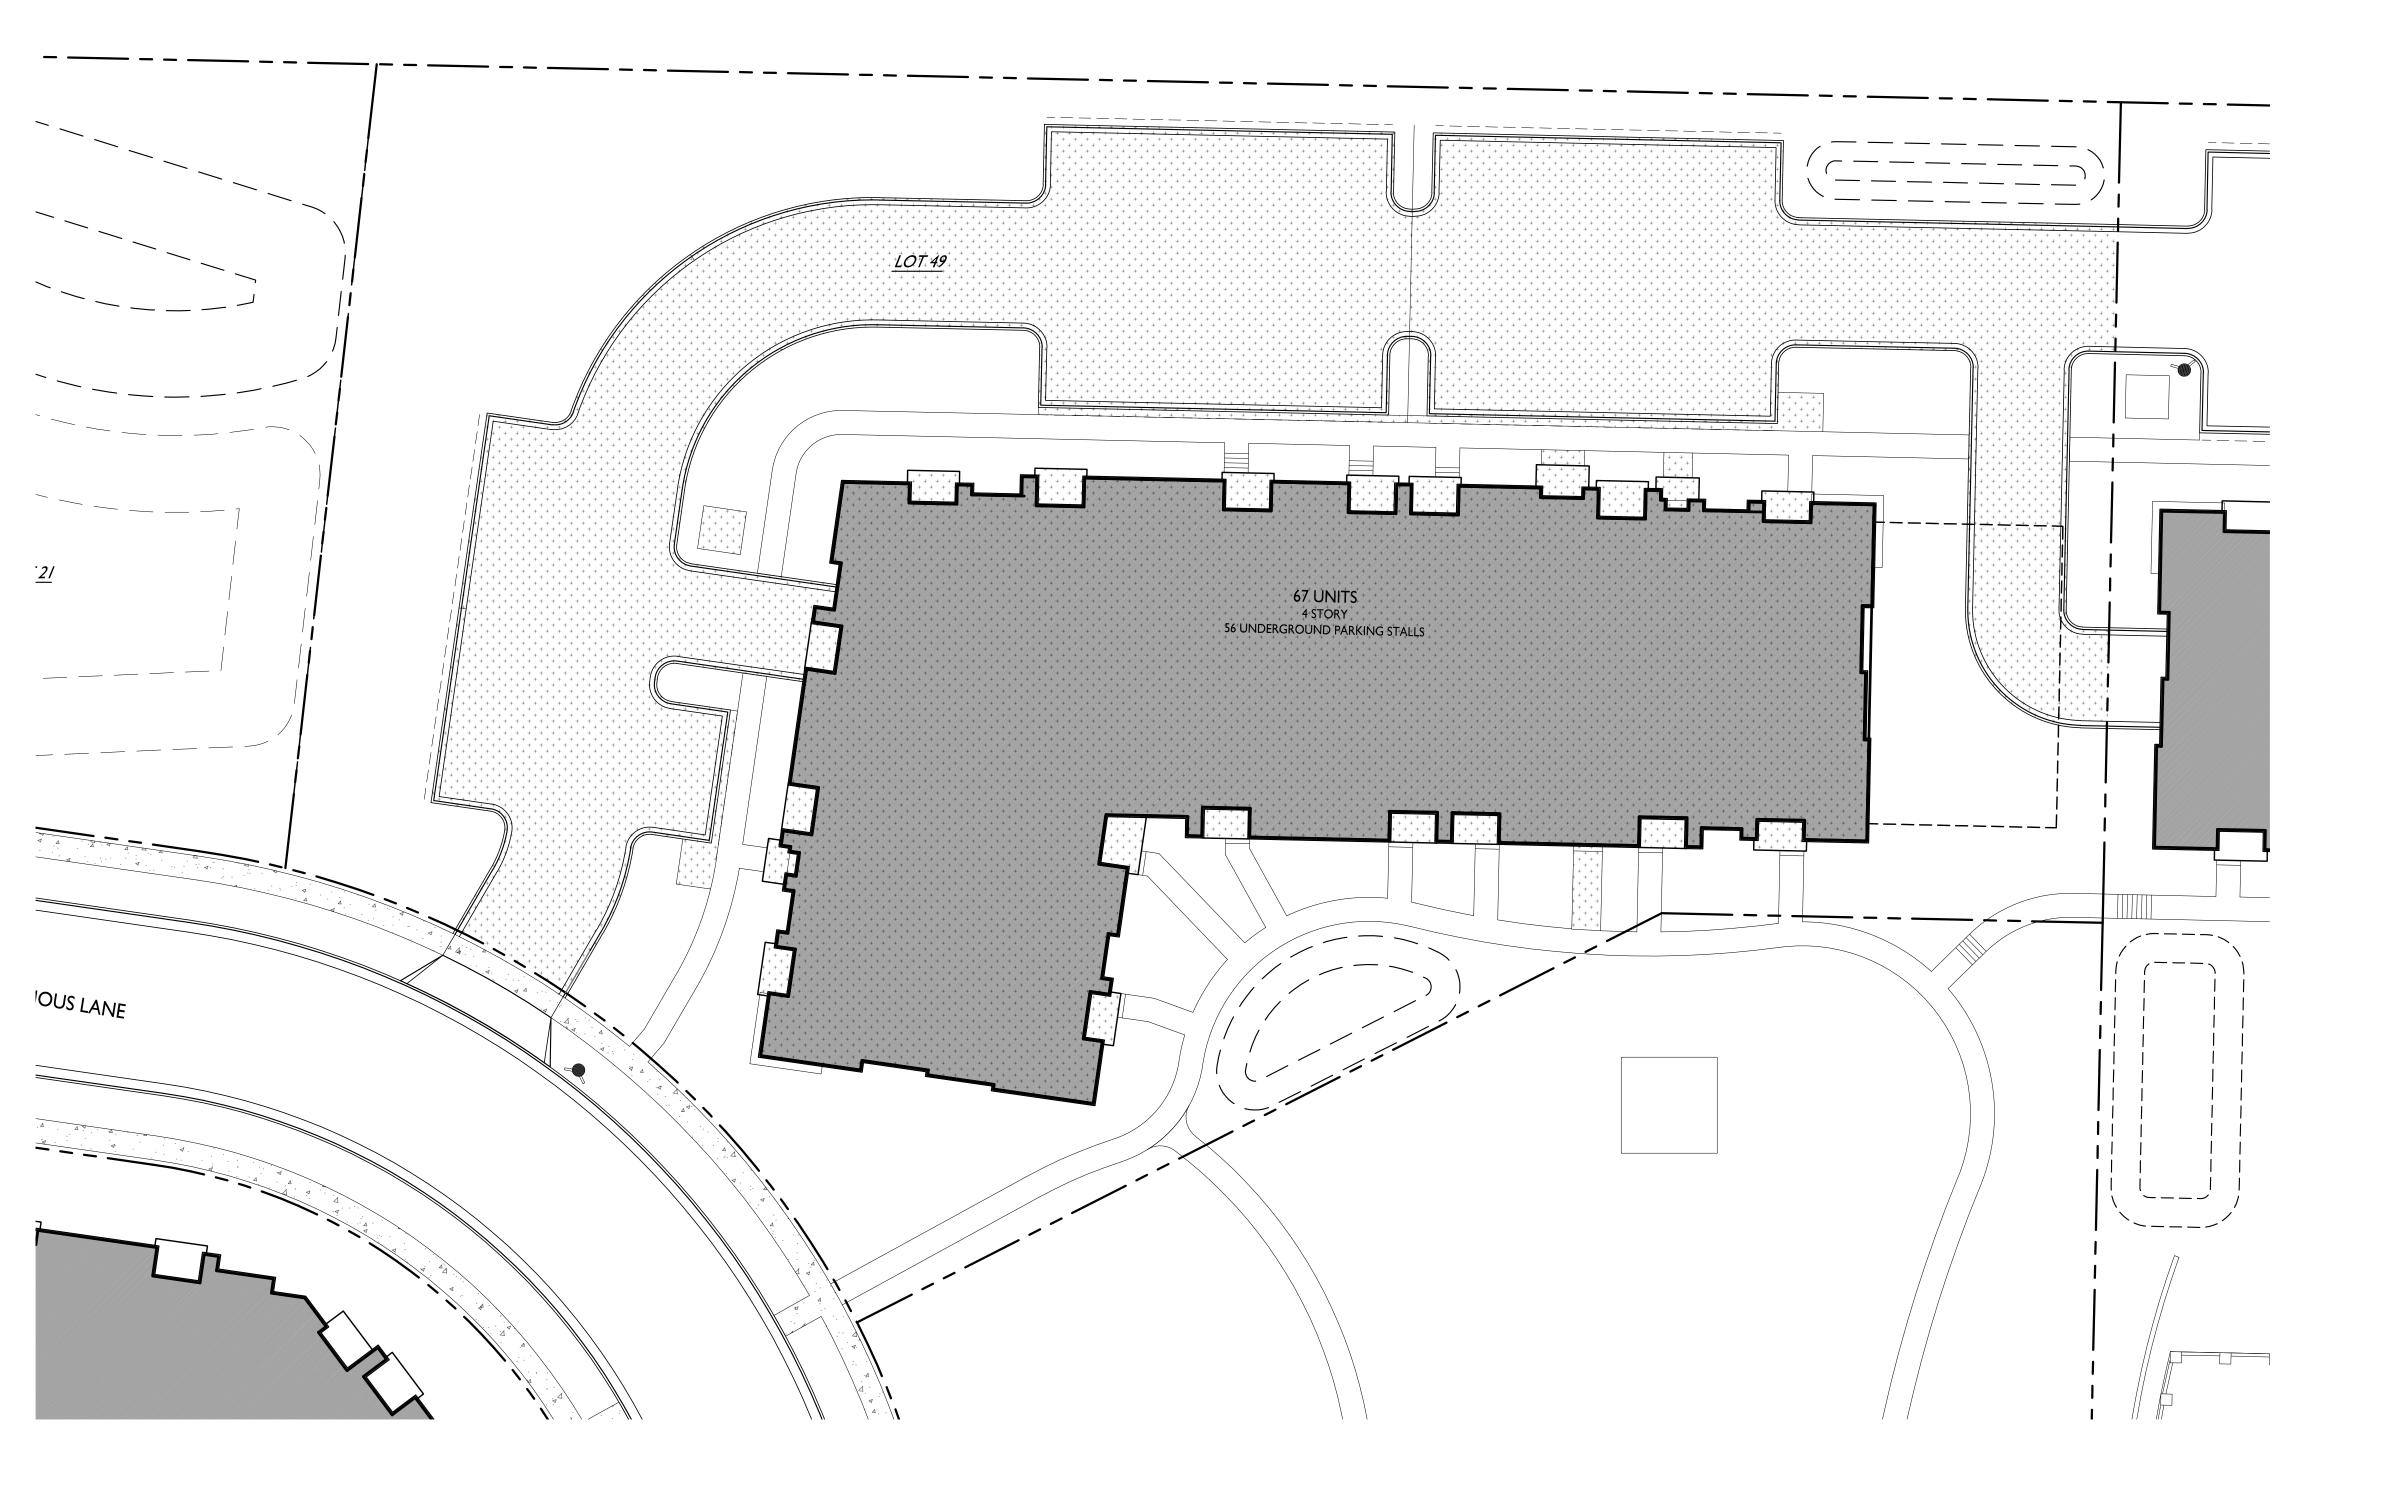


LOT COVERAGE

ZONING MAXIMUM LOT COVERAGE 80% LOT AREA PROPOSED COVERAGE

74,337 S.F. 40,600 S.F. / 53%

TR-U2

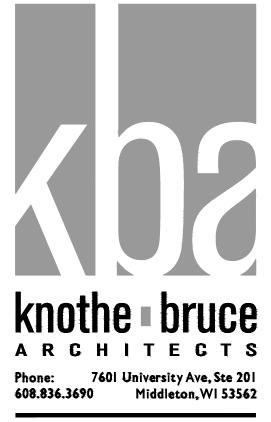

ISSUED Issued for LUA & UDC Submittals - February 27, 2023

PROJECT TITLE THE AMERICAN CENTER EASTPARK FIFTH ADDITION

4846 Eastpark Blvd. Madison, Wl SHEET TITLE Lot Coverage

Lot 49

Sheet Number


PROJECT NO.

C-3.1

2155 © Knothe & Bruce Architects, LLC



	GRAPHI	C SCALE	
0	20	40 I	60 I
	I INCH = 20 FT	(24X36 SHEET)	

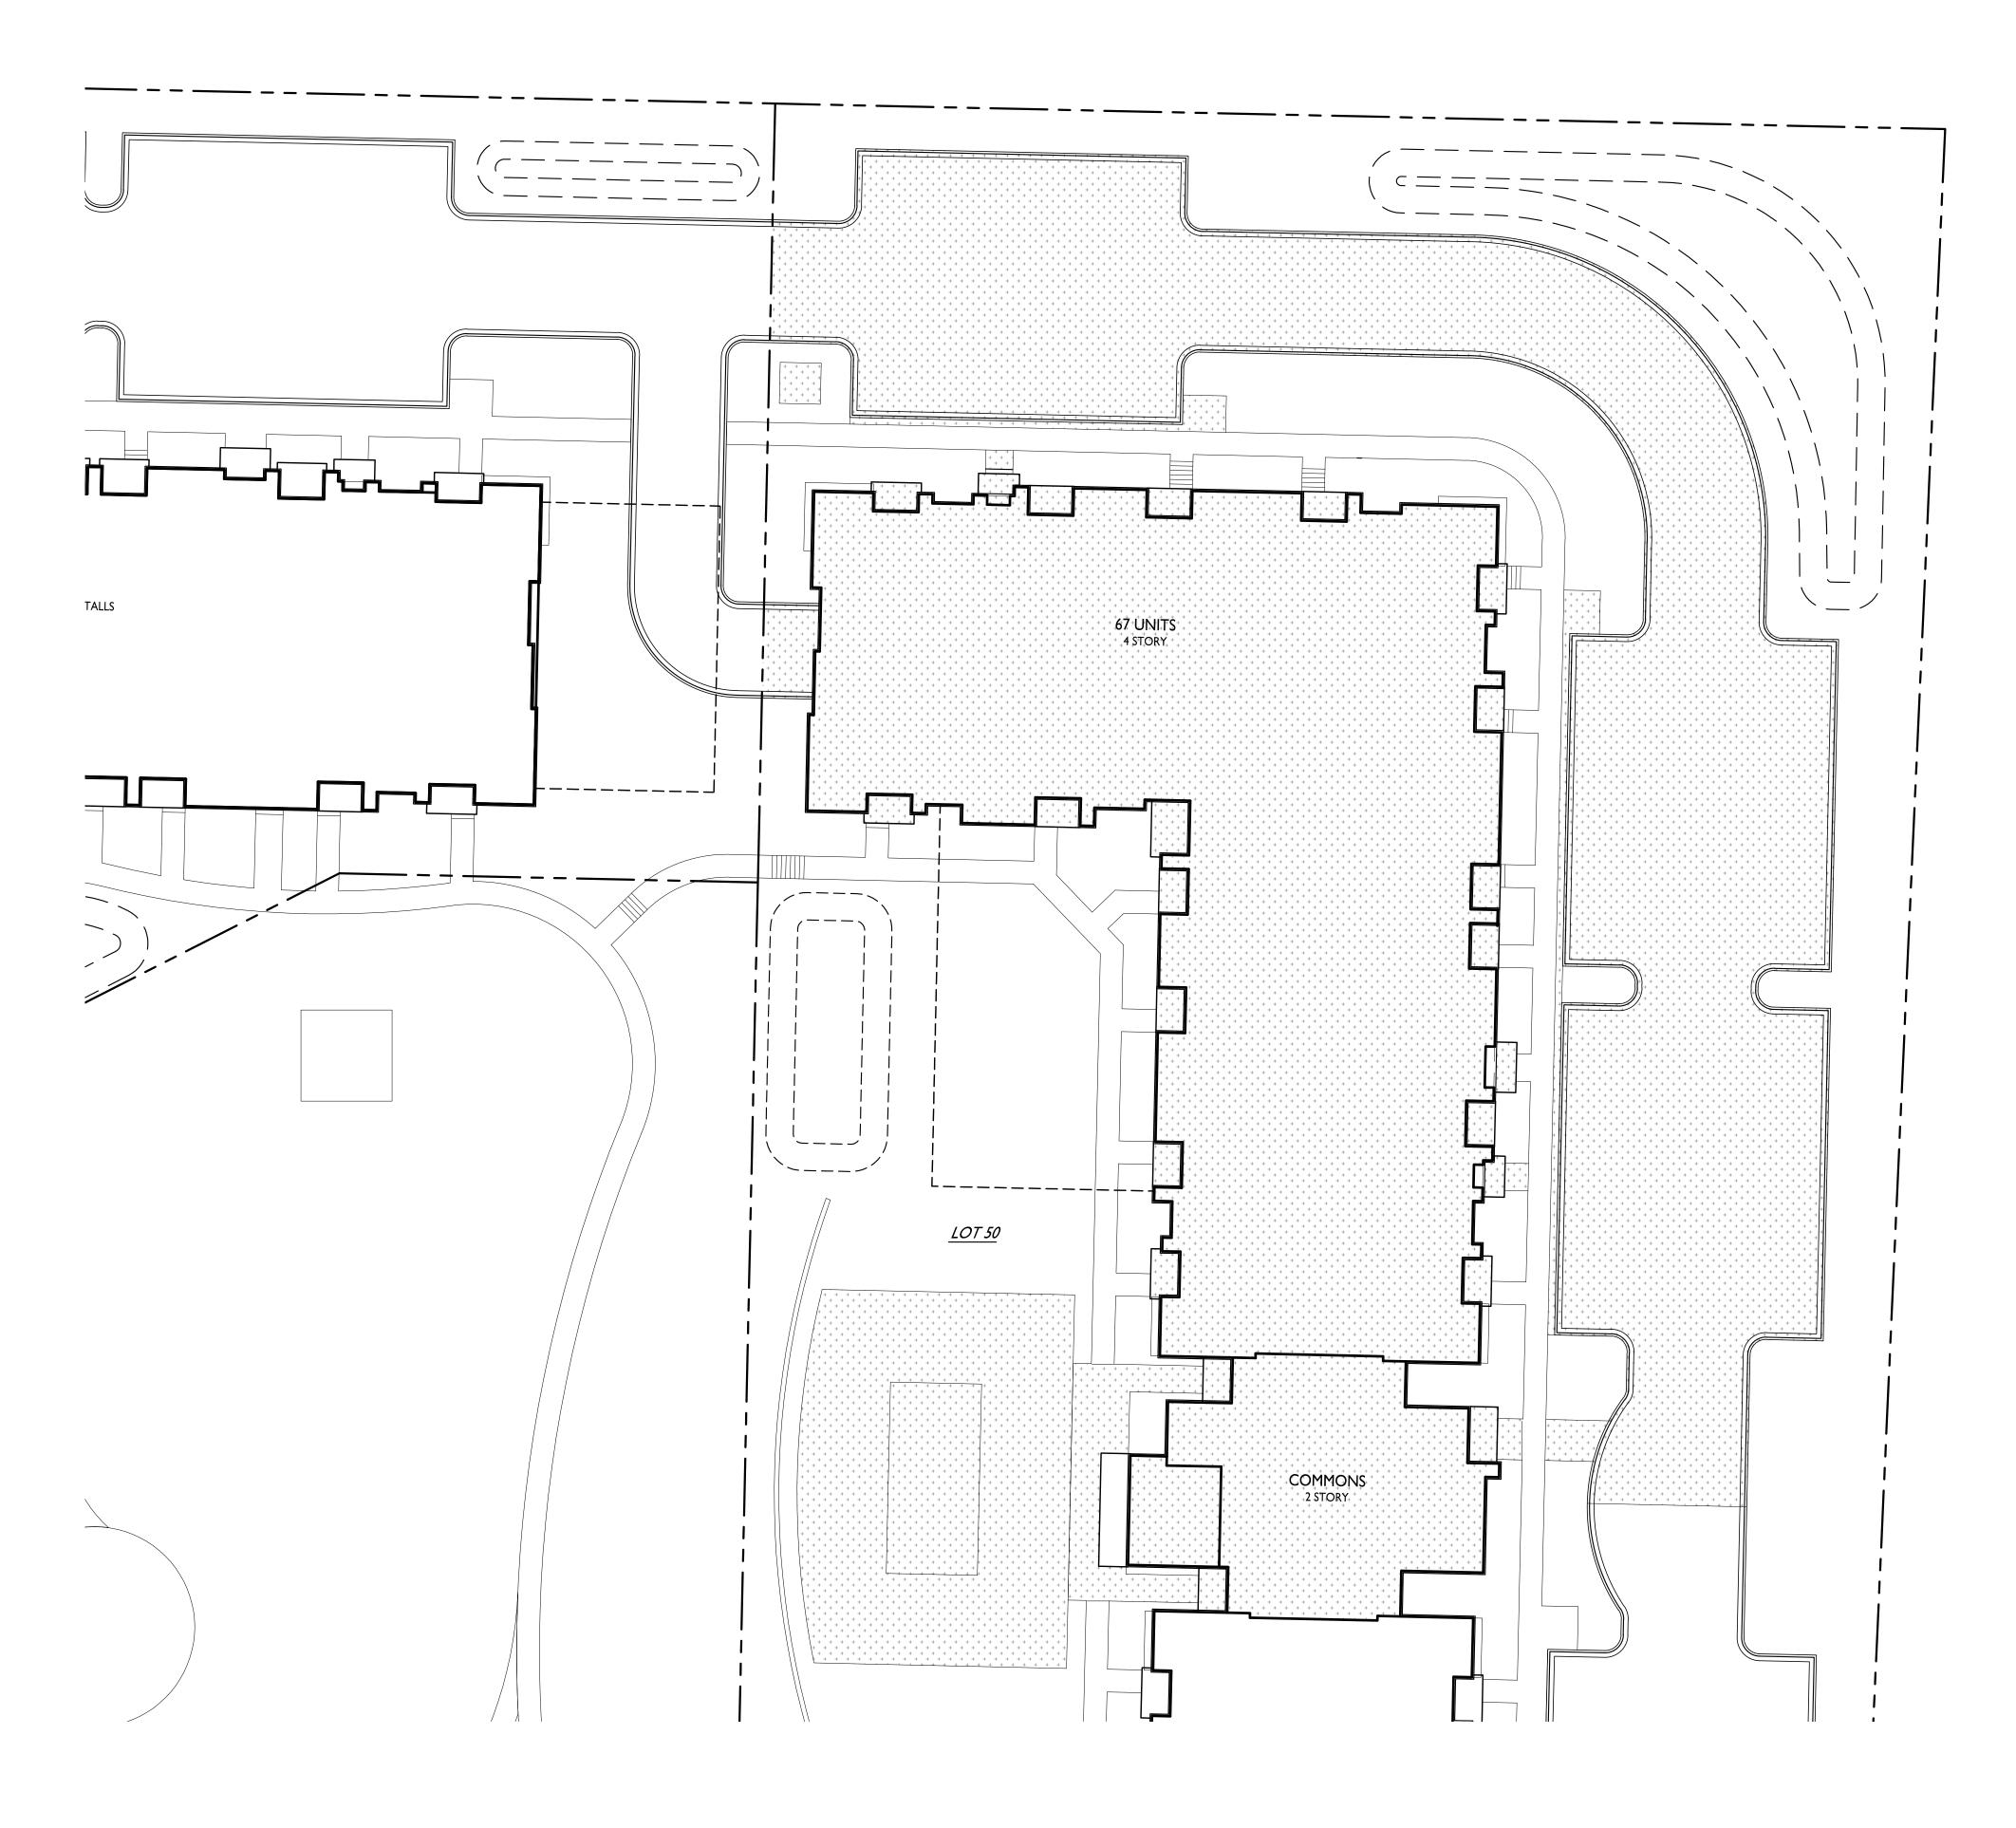


LOT COVERAGE

ZONING MAXIMUM LOT COVERAGE 80% LOT AREA PROPOSED COVERAGE

134,349 S.F. 79,200 S.F. / 59%

TR-U2

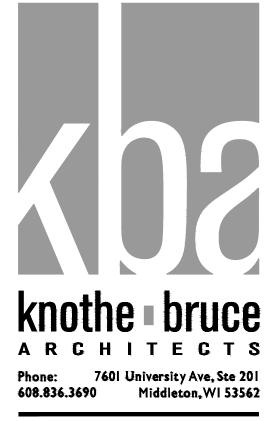

ISSUED Issued for LUA & UDC Submittals - February 27, 2023

PROJECT TITLE THE AMERICAN CENTER EASTPARK FIFTH ADDITION

4846 Eastpark Blvd. Madison, Wl SHEET TITLE Lot Coverage North




C-3.2


PROJECT NO. 2155 © Knothe & Bruce Architects, LLC



GRAPHIC SCALE I INCH = 20 FT (24X36 SHEET)

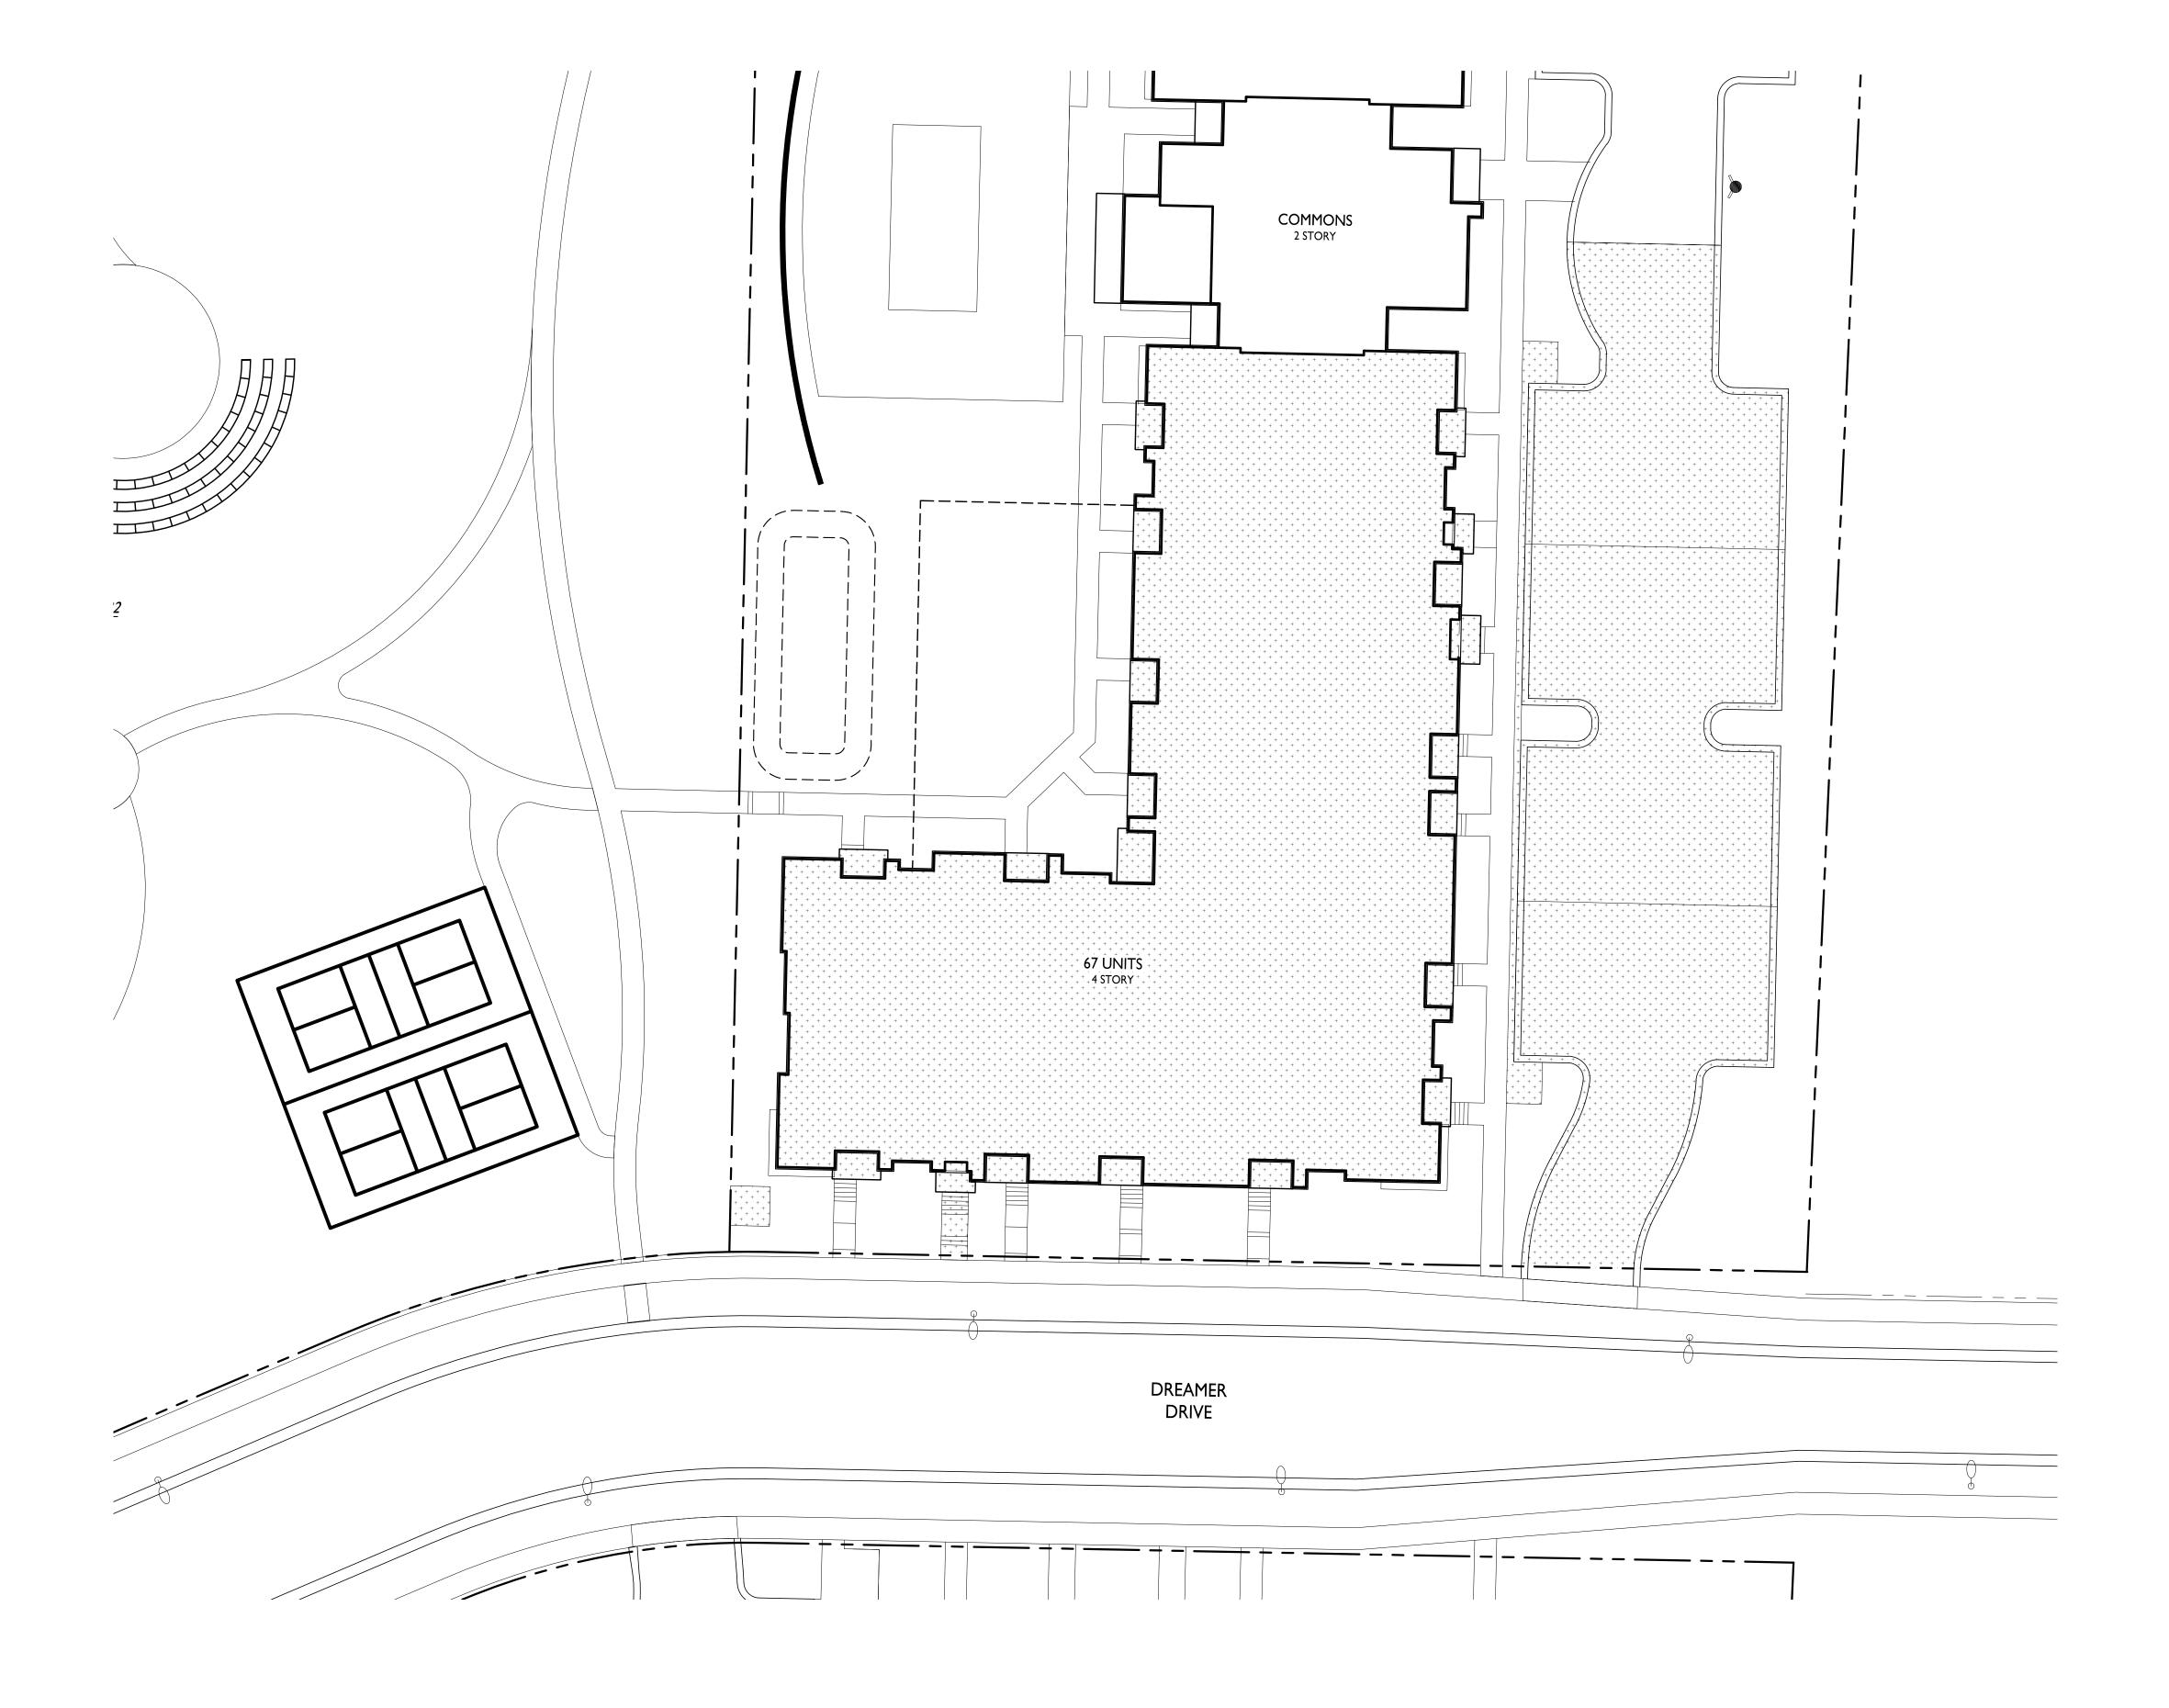

SEE SHEET C-1.3A FOR LOT COVERAGE DATA

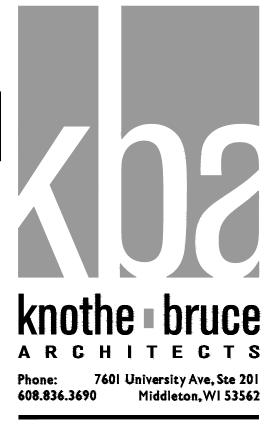

ISSUED Issued for LUA & UDC Submittals - February 27, 2023

PROJECT TITLE CASCADE -THE AMERICAN CENTER EASTPARK FIFTH ADDITION

4846 Eastpark Blvd. Madison, WI SHEET TITLE Lot Coverage South



C-3.3

GRAPHIC SCALE 0 20 40 1 INCH = 20 FT (24X36 SHEET)

PROJECT NO. 2155 © Knothe & Bruce Architects, LLC

CASCADE - PHASE 1 - SITE IMPROVEMENTS THE AMERICAN CENTER LOTS 49-50 CITY OF MADISON, WISCONSIN





THE LOCATION OF EXISTING UTILITIES, BOTH UNDERGROUND AND OVERHEAD ARE APPROXIMATE ONLY AND HAVE NOT BEEN INDEPENDENTLY VERIFIED BY THE OWNER OR ITS REPRESENTATIVE. THE CONTRACTOR SHALL BE RESPONSIBLE FOR DETERMINING THE EXACT LOCATION OF ALL EXISTING UTILITIES WHETHER SHOWN ON THESE PLANS OR NOT, BEFORE COMMENCING WORK, AND SHALL BE FULLY RESPONSIBLE FOR ANY AND ALL DAMAGES WHICH MIGHT BE CAUSED BY THE CONTRACTOR'S FAILURE TO EXACTLY LOCATE AND PRESERVE ANY AND ALL UTILITIES.

> CALL DIGGER'S HOTLINE 1-800-242-8511

SITE BENCHMARKS



TOP NUT OF HYDRANT ELEV = 910.30



TOP NUT OF HYDRANT ELEV = 921.17





(4)

TOP NUT OF HYDRANT ELEV = 910.30

TOP NUT OF HYDRANT

ELEV = 921.85

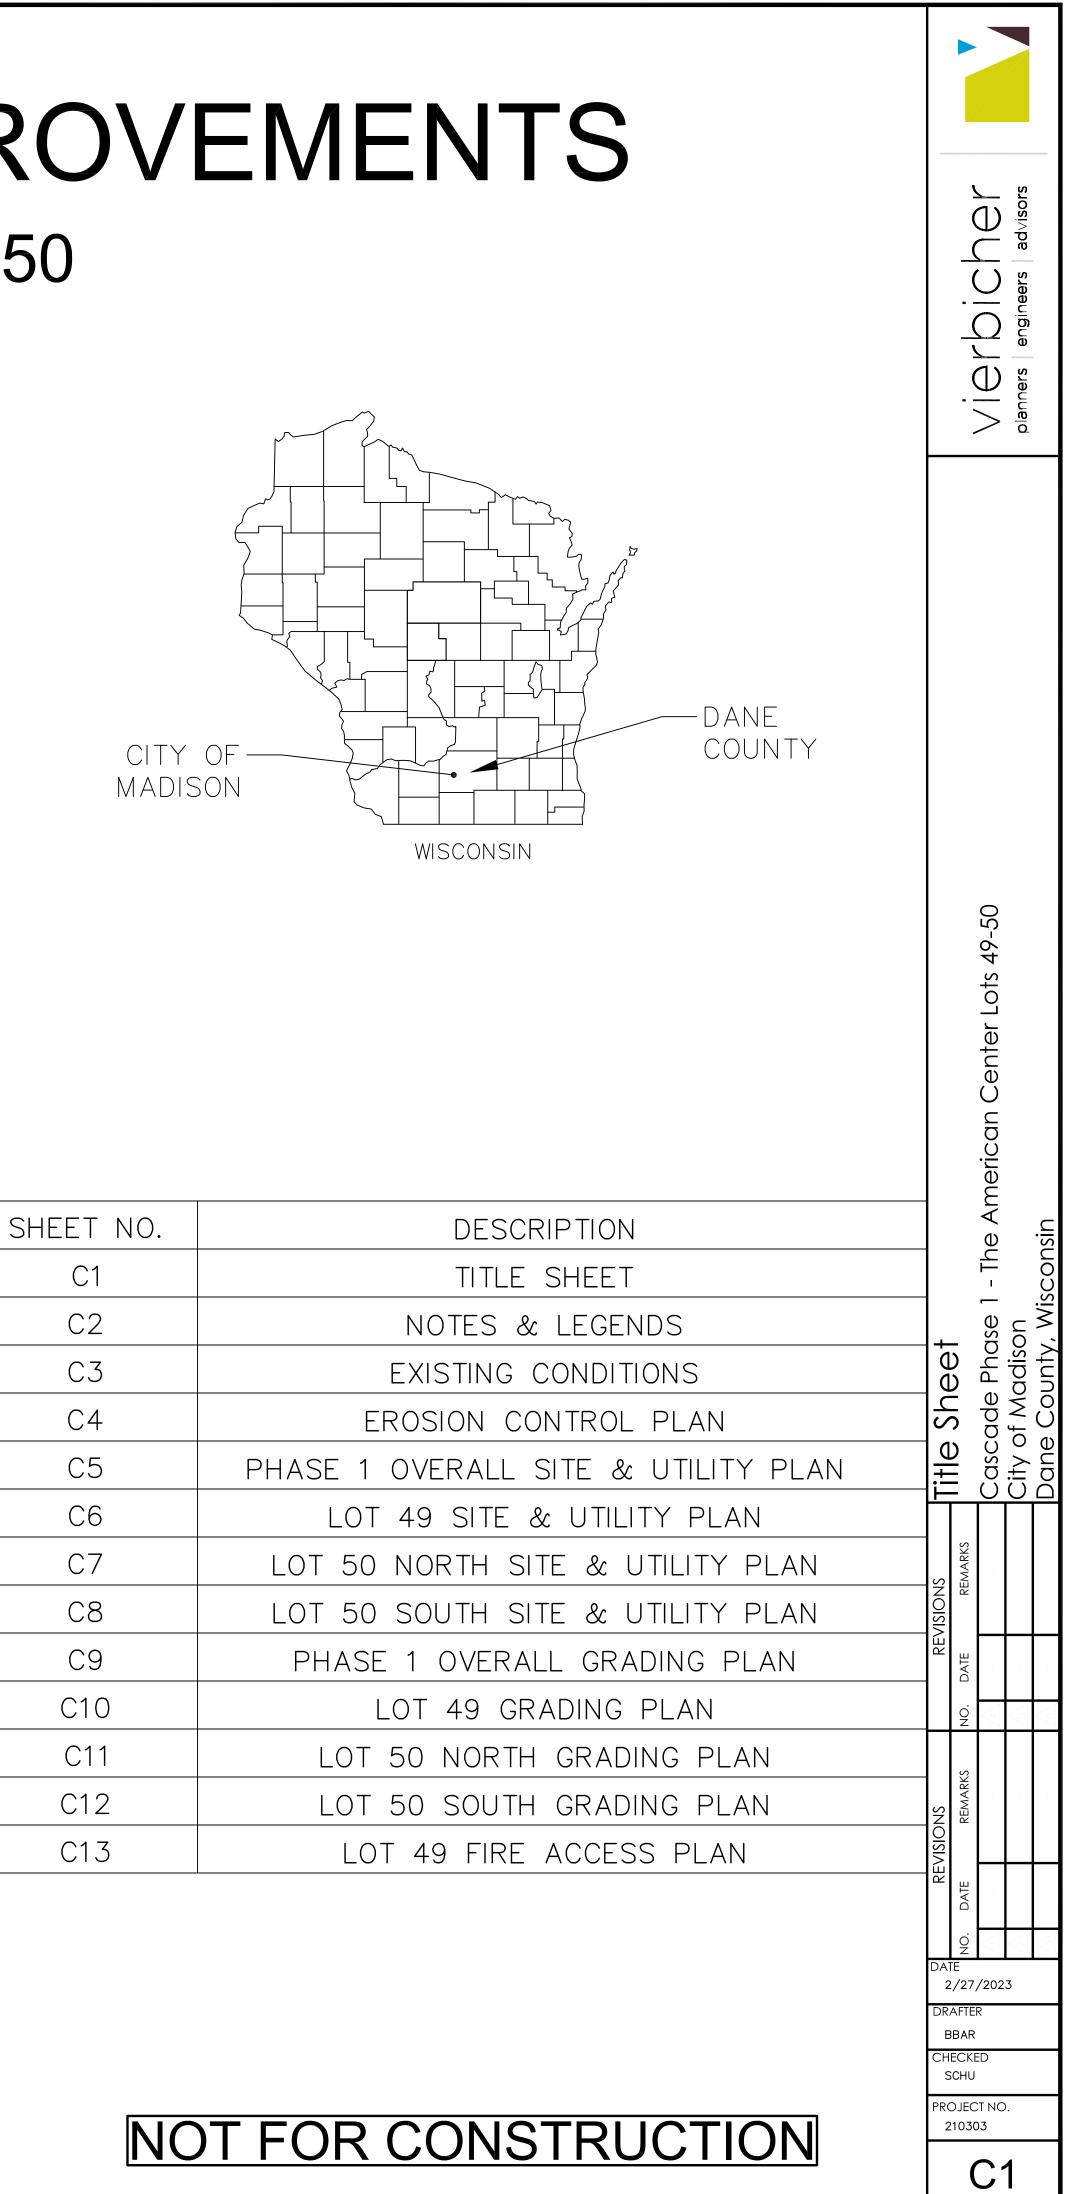

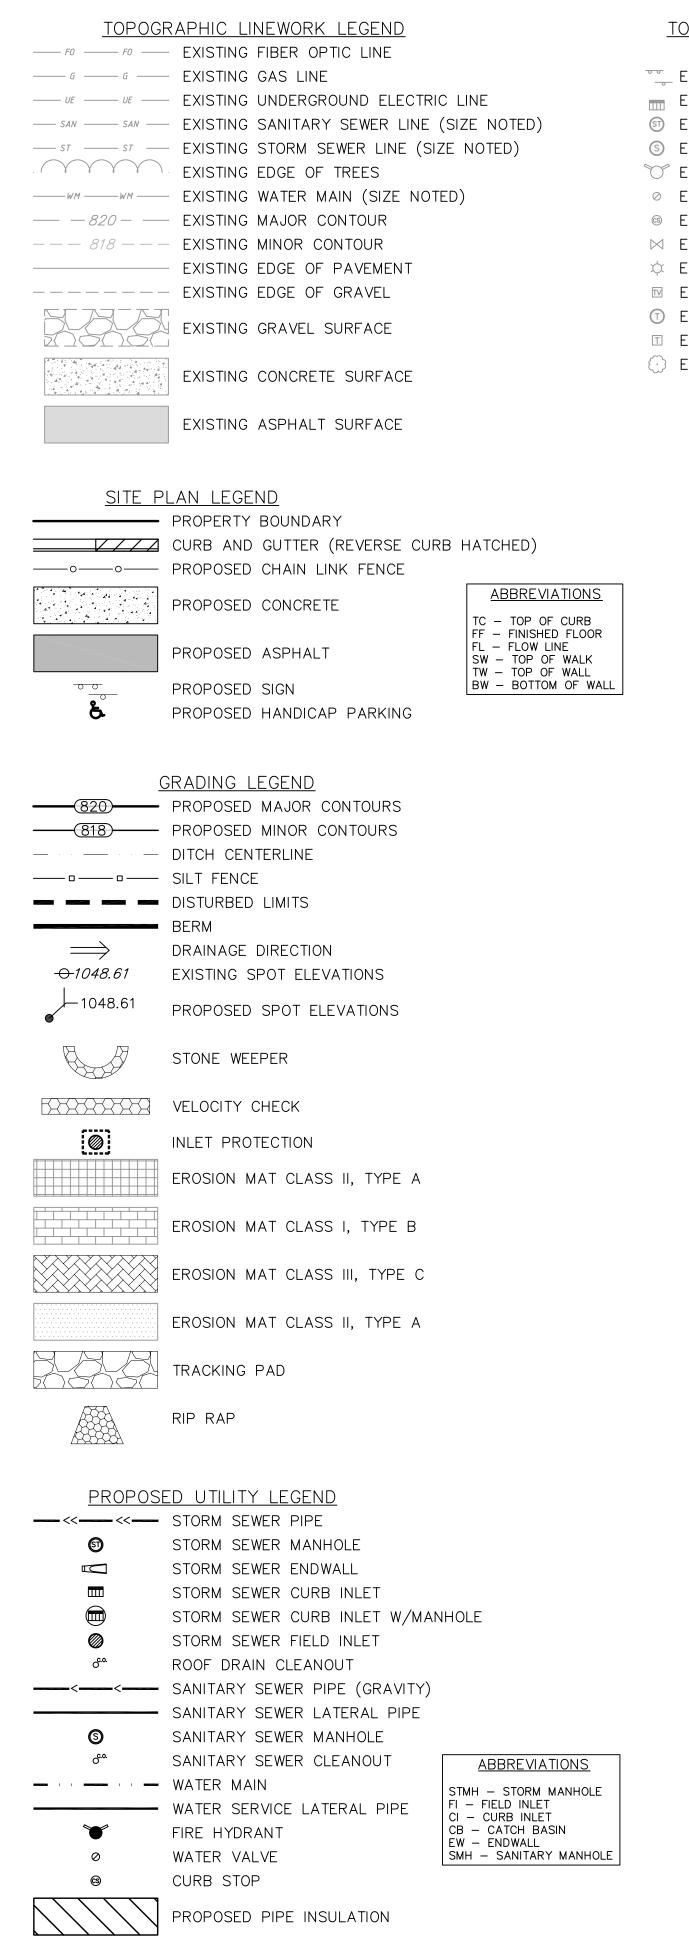

TOPOGRAPHIC SYMBOL LEGEND

- EXISTING SIGN (TYPE NOTED)
- EXISTING CURB INLET
- I EXISTING STORM MANHOLE
- S EXISTING SANITARY MANHOLE
- C EXISTING FIRE HYDRANT
- EXISTING WATER MAIN VALVE
- © EXISTING CURB STOP
- ⋈ EXISTING GAS VALVE
- $\dot{\mathbf{x}}$ EXISTING LIGHT POLE
- EXISTING TV PEDESTAL
- ① EXISTING TELEPHONE MANHOLE
- I EXISTING TELEPHONE PEDESTAL
- (·) EXISTING DECIDUOUS TREE

GENERAL NOTES:

- 1. THE CONTRACTOR IS RESPONSIBLE FOR ANY DAMAGE CAUSED DURING CONSTRUCTION TO PUBLIC PROPERTY, PRIVATE PROPERTY OR UTILITIES.
- 2. THE CONTRACTOR SHALL SUBMIT SHOP DRAWINGS FOR REVIEW BY THE ENGINEER, PRIOR TO PLACING AN ORDER OF ANY SUCH ITEM.
- 3. EXISTING TOPOGRAPHIC INFORMATION IS BASED ON FIELD OBSERVATIONS AND/OR PLAN OF RECORD DRAWINGS. CONTRACTOR SHALL VERIFY TOPOGRAPHIC INFORMATION PRIOR TO STARTING CONSTRUCTION.
- 4. RIGHT OF WAY (ROW) AND PROPERTY LINES ARE APPROXIMATE. CONTRACTOR SHALL BE RESPONSIBLE FOR PROTECTING EXISTING PROPERTY CORNER MONUMENTATION. ANY MONUMENTS DISTURBED BY CONTRACTOR SHALL BE REPLACED AT THE CONTRACTORS EXPENSE.
- 5. CONTRACTOR SHALL COORDINATE WITH DRY UTILITY COMPANY'S REGARDING ANY POTENTIAL CONFLICTS AND COORDINATE RELOCATIONS AS MAY BE REQUIRED. CONTRACTOR SHALL ALSO COORDINATE THE PROPOSED INSTALLATION OF NEW FACILITIES AS REQUIRED.

DEMOLITION NOTES:

- 1. CONTRACTOR SHALL KEEP ALL CITY STREETS FREE AND CLEAR OF CONSTRUCTION RELATED DIRT/DUST/DEBRIS.
- 2. COORDINATE EXISTING UTILITY REMOVAL/ABANDONMENT WITH LOCAL AUTHORITIES AND UTILITY COMPANIES HAVING JURISDICTION.
- ALL SAWCUTTING SHALL BE FULL DEPTH TO PROVIDE A CLEAN EDGE TO MATCH NEW CONSTRUCTION. MATCH EXISTING ELEVATIONS AT POINTS OF CONNECTION FOR NEW AND EXISTING PAVEMENT, CURB, SIDEWALKS, ETC. ALL SAWCUT LOCATIONS SHOWN ARE APPROXIMATE AND MAY BE FIELD ADJUSTED TO ACCOMMODATE CONDITIONS, JOINTS, MATERIAL TYPE, ETC. REMOVE MINIMUM AMOUNT NECESSARY FOR INSTALLATION OF PROPOSED IMPROVEMENTS.
- 4. CONTRACTOR SHALL PROVIDE AND SHALL BE RESPONSIBLE FOR ANY NECESSARY TRAFFIC CONTROL SIGNAGE AND SAFETY MEASURES DURING DEMOLITION AND CONSTRUCTION OPERATIONS WITHIN OR NEAR THE PUBLIC ROADWAY.
- 5. COORDINATE TREE REMOVAL WITH LANDSCAPE ARCHITECT. ALL TREES TO BE REMOVED SHALL BE REMOVED IN THEIR ENTIRETY AND STUMPS SHALL BE GROUND TO 12" BELOW PROPOSED SUBGRADE.
- 6. CONTRACTOR SHALL OBTAIN ANY NECESSARY DEMOLITION AND UTILITY PLUGGING PERMITS.
- 7. ANY DAMAGE TO THE CITY PAVEMENT, INCLUDING DAMAGE RESULTING FROM CURB REPLACEMENT, WILL REQUIRE RESTORATION IN ACCORDANCE WITH THE CITY ENGINEERING PATCHING CRITERIA.

SITE PLAN NOTES:

- 1. CONCRETE TO BE 5" THICK, CONSTRUCTED ON A BASE OF 4" COMPACTED SAND OR CRUSHED STONE.
- CONCRETE FOR DRIVEWAYS AND SIDEWALK AT DRIVEWAY ENTRANCES SHALL BE 7" THICK, CONSTRUCTED ON A BASE OF 5" COMPACTED SAND OR CRUSHED STONE.
- 3. ALL DIMENSIONS WITH CURB & GUTTER ARE REFERENCED TO THE FACE OF CURB.
- 4. CONTRACTOR SHALL DEEP TILL ANY DISTURBED AREAS AFTER CONSTRUCTION IS COMPLETE AND BEFORE RESTORING.
- 5. CONTRACTOR TO OBTAIN ANY NECESSARY DRIVEWAY CONNECTION, RIGHT OF WAY AND EXCAVATION PERMITS PRIOR TO CONSTRUCTION.
- 6. ALL ABANDONED DRIVEWAYS ADJACENT TO THE SITE SHALL BE REPLACED WITH CURB AND THE TERRACE SHALL BE RESTORED WITH GRASS.
- 7. ANY SIDEWALK AND CURB & GUTTER ABUTTING THE PROPERTY SHALL BE REPLACED IF IT IS DAMAGED DURING CONSTRUCTION.

GRADING NOTES:

- 1. CONTOURS ARE SHOWN FOR PURPOSES OF INDICATING ROUGH GRADING. FINAL GRADE SHALL BE ESTABLISHED ON PAVED SURFACES BY USING SPOT GRADES ONLY.
- 2. ALL GRADES SHOWN REFERENCE FINISHED ELEVATIONS.
- 3. CROSS SLOPE OF SIDEWALKS SHALL BE 2.0% UNLESS OTHERWISE NOTED.
- 4. LONGITUDINAL GRADE OF SIDEWALK RAMPS SHALL NOT EXCEED 8.33% (1:12) AND SHALL BE IN ACCORDANCE WITH ADA REQUIREMENTS.
- 5. LONGITUDINAL GRADE OF SIDEWALK SHALL NOT EXCEED 5.0% OR THE ADJACENT STREET GRADE WHICHEVER IS GREATER.
- 6. ACCESSIBLE ROUTES SHALL BE 5.0% MAX LONGITUDINAL SLOPE AND 1.5% MAX CROSS SLOPE. ACCESSIBLE LOADING AREAS OR LANDINGS SHALL BE 2.0% MAX SLOPE IN ANY DIRECTION. RAMPS SHALL BE 8.33% MAX SLOPE.
- 7. NO LAND DISTURBANCE ACTIVITIES SHALL BEGIN UNTIL ALL EROSION CONTROL BMP'S ARE INSTALLED.
- 8. SEE DETAIL SHEETS FOR EROSION CONTROL NOTES AND CONSTRUCTION SEQUENCE.

UTILITY NOTES:

- OF THE DEPARTMENT OF SAFETY AND PROFESSIONAL SERVICES AND OTHER LOCAL INSPECTORS.

- FORESTRY.

NOT FOR CONSTRUCTION

1. CONTRACTOR SHALL OBTAIN ANY NECESSARY WORK IN RIGHT OF WAY, EXCAVATION, UTILITY CONNECTION, PLUGGING AND ABANDONMENT PERMITS PRIOR TO CONSTRUCTION.

2. CONTRACTOR TO VERIFY EXISTING UTILITY LOCATIONS AND ELEVATIONS PRIOR TO STARTING WORK.

3. SANITARY & STORM SEWER LENGTHS SHOWN ARE FROM CENTER OF STRUCTURE TO CENTER OF STRUCTURE. STORM SEWER END SECTIONS ARE INCLUDED IN THE LENGTH AND SLOPE OF THE PIPE.

4. CONTRACTOR SHALL INVESTIGATE ALL UTILITY CROSSINGS PRIOR TO CONSTRUCTION AND NOTIFY ENGINEER OF ANY CONFLICTS.

5. CONTRACTOR SHALL BE RESPONSIBLE FOR ADJUSTING ALL UTILITY STRUCTURES TO FINISHED GRADE (MANHOLE RIMS, WATER VALVES, AND CURB STOPS), IF NECESSARY.

6. FOR ALL SEWER AND WATER MAIN CROSSINGS: PROVIDE MINIMUM 18" SEPARATION WHEN WATER MAIN CROSSES BELOW SEWER AND MINIMUM 6" SEPARATION WHEN WATER MAIN CROSSES ABOVE SEWER. 7. IF DEWATERING OPERATIONS EXCEED 70 GALLONS PER MINUTE OF PUMPING CAPACITY, A DEWATERING

WELL PERMIT SHALL BE OBTAINED PRIOR TO STARTING ANY DEWATERING ACTIVITIES. 8. A COPY OF THE APPROVED UTILITY PLANS, SPECIFICATIONS AND PLUMBING PERMIT APPROVAL LETTER SHALL BE ON-SITE DURING CONSTRUCTION AND OPEN TO INSPECTION BY AUTHORIZED REPRESENTATIVES

9. PROPOSED UTILITY SERVICE LINES SHOWN ARE APPROXIMATE. COORDINATE THE EXACT LOCATIONS WITH THE PLUMBING DRAWINGS. COORDINATE THE LOCATION WITH THE PLUMBING CONTRACTOR AND/OR OWNER'S CONSTRUCTION REPRESENTATIVE PRIOR TO INSTALLATION OF ANY NEW UTILITIES.

10. STORM BUILDING SEWER PIPE SHALL CONFORM TO ONE OF THE STANDARDS LISTED IN TABLE 384.30-6 OF SPS 384.30(3)(c).

11. UNDERGROUND DRAIN AND VENT PIPE/TUBING SHALL CONFORM TO ONE OF THE STANDARDS LISTED IN TABLE 384.30-2 OF SPS 384.30(2).

12. PRIVATE WATER SERVICES AND PRIVATE WATER MAINS SHALL CONFORM TO ONE OF THE STANDARDS LISTED IN TABLE 384.30-7 OF SPS 384.30(4)(d).

13. PRIVATE SANITARY SEWER AND LATERALS SHALL BE POLYVINYL CHLORIDE (PVC) ASTM D3034 - SDR 35 OR APPROVED EQUAL MATERIAL THAT CONFORMS TO ONE OF THE STANDARDS LISTED IN TABLE 384.30-3 OF SPS 384.30(2)(c).

14. A MEANS TO LOCATE BURIED UNDERGROUND EXTERIOR NON METALLIC SEWERS/MAINS AND WATER SERVICES/MAINS MUST BE PROVIDED WITH TRACER WIRE OR OTHER METHODS IN ORDER TO BE LOCATED PER SPS 382.10(11)(h) AND SPS 382.40(8)(k).

15. EXTERIOR WATER SUPPLY PIPING SETBACKS AND CROSSINGS SHALL BE IN ACCORDANCE WITH SPS 382.40(8)(b.).

16. NO PERSON MAY ENGAGE IN PLUMBING WORK IN THE STATE UNLESS LICENSED TO DO SO BY THE DEPARTMENT OF SAFETY AND PROFESSIONAL SERVICES PER S.145.06.

17. SITE CONTRACTOR SHALL LEAVE SANITARY AND WATER LATERALS FIVE (5) FEET SHORT (HORIZONTALLY) FROM THE BUILDING. BUILDING PLUMBER SHALL VERIFY SIZE, LOCATION, AND INVERT ELEVATION OF PROPOSED SANITARY AND WATER LATERALS.

18. IT IS THE CONTRACTOR'S RESPONSIBILITY TO VERIFY THAT THE EXISTING VALVES WILL HOLD THE PRESSURE TEST PRIOR TO CONNECTION. THE CITY IS NOT RESPONSIBLE FOR ANY COSTS INCURRED DUE TO THE CONTRACTOR NOT VERIFYING THAT THE EXISTING VALVE WILL HOLD THE PRESSURE TEST PRIOR TO CONNECTION. IF A NEW VALVE IS REQUIRED, THE APPLICANT WILL BE REQUIRED TO INSTALL ONE AT THEIR EXPENSE. AT THE POINT OF CONNECTION.

19. CONTRACTOR TO CHLORINATE AND BACTERIA TEST BEFORE DOMESTIC SUPPLY PURPOSES

20. CLEAN OUT ALL EXISTING AND PROPOSED STORM INLETS AND CATCH BASINS AT THE COMPLETION OF CONSTRUCTION.

21. SANITARY SEWER MAIN AT BURY DEPTHS GREATER THAN 15' SHALL BE SDR 21. ALL OTHER SANITARY SEWER MAIN SHALL BE SDR 26.

22. ALL WATER MAIN AND SERVICES SHALL BE INSTALLED AT A MINIMUM DEPTH OF 6.5' FROM TOP OF FINISHED GRADE ELEVATION TO TOP OF MAIN. PROVIDE 1.5' CLEAR SEPARATION IF WATER CROSSES BELOW SEWER AND MINIMUM 0.5' IF WATER CROSSES ABOVE.

23. SANITARY MANHOLES WITH SEWER MAIN CONNECTIONS GREATER THAN 2' ABOVE THE LOWEST INVERT SHALL BE CONSTRUCTED WITH AN EXTERNAL DROP. MANHOLES WITH SEWER LATERAL CONNECTIONS GREATER THAT 2' ABOVE THE LOWEST INVERT SHALL BE CONSTRUCTED WITH AN INTERNAL DROP.

24. INSTALL 1 SHEET OF 4'x8'x4" HIGH DENSITY STYROFOAM INSULATION AT ALL LOCATIONS WHERE STORM SEWER CROSSES WATER MAIN OR WATER LATERALS.

STREET TREE NOTES:

ALL PROPOSED STREET TREE REMOVALS WITHIN THE RIGHT OF WAY SHALL BE REVIEWED BY CITY FORESTRY. STREET TREE REMOVALS REQUIRE APPROVAL AND A TREE REMOVAL PERMIT ISSUED BY CITY

2. CONTRACTOR SHALL TAKE PRECAUTIONS DURING CONSTRUCTION TO NOT DISFIGURE, SCAR, OR IMPAIR THE HEALTH OF ANY STREET TREE. CONTRACTOR SHALL OPERATE EQUIPMENT IN A MANNER AS TO NOT DAMAGE THE BRANCES OF THE STREET TREES. ANY DAMAGE OR INJURY TO EXISTING STREET TREES (EITHER ABOVE OR BELOW GROUND) SHALL BE REPORTED IMMEDIATELY TO CITY FORESTRY.


3. AS DEFINED BY SECTION 107.13 OF CITY OF MADISON STANDARD SPECIFICATIONS FOR PUBLIC WORKS CONSTRUCITON: NO EXCAVATION IS PERMITTED WITHIN 5 FEET OF THE TRUNK OF THE STREET TREE OR WHEN CUTTING ROOTS OVER 3 INCHES IN DIAMETER. IF EXCAVATION IS NECESSARY, THE CONTRACTOR SHALL CONTACT MADISON CITY FORESTRY PRIOR TO EXCAVATION. CITY OF MADISON FORESTRY PERSONNEL SHALL ASSES THE IMPACT TO THE TREE AND TO ITS ROOT SYSTEM PRIOR TO WORK COMMENCING.

SECTION 107.13(g) OF THE CITY OF MADISON STANDARD SPECIFICATIONS FOR PUBLIC WORKS CONSTRUCTION ADDRESSES SOIL COMPACTION NEAR STREET TREES AND SHALL BE FOLLOWED BY CONTRACTOR. THE STORAGE OF PARKED VEHICLES, CONSTRUCTION EQUIPMENT, BUILDING MATERIALS, REFUSE, EXCAVATED SPOILS, OR DUMPING OF POISONOUS MATERIALS ON OR AROUND TREES AND ROOTS WITHIN 5 FEET OF THE TREE OR WITHIN THE PROTECTION ZONE IS PROHIBITED.

5. STREET TREE PRUNING SHALL BE COORDINATED WITH CITY FORESTRY AT A MINIMUM OF TWO WEEKS PRIOR TO THE START OF CONSTRUCTION.

Notes & Legends		Cascade Phase 1 - The American Center Lots 49-50	City of Madison	Dane County, Wisconsin
REVISIONS	REMARKS			
REV	NO. DATE			
	NO.	$\sqrt{4}$	2	<u>\</u>
REVISIONS	REMARKS			
RE	NO. DATE			
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<u>SURVEY LEGEND</u>

- 🖄 BENCHMARK
- 🗙 FOUND CHISELED "X"
- PUBLIC LAND CORNER AS NOTED
- FOUND NAIL
- ◎ FOUND 1" Ø IRON PIPE
- FOUND P.K. NAIL
- FOUND 1 1/4" Ø IRON ROD ● FOUND 3/4" ø IRON ROD
- SET NAIL

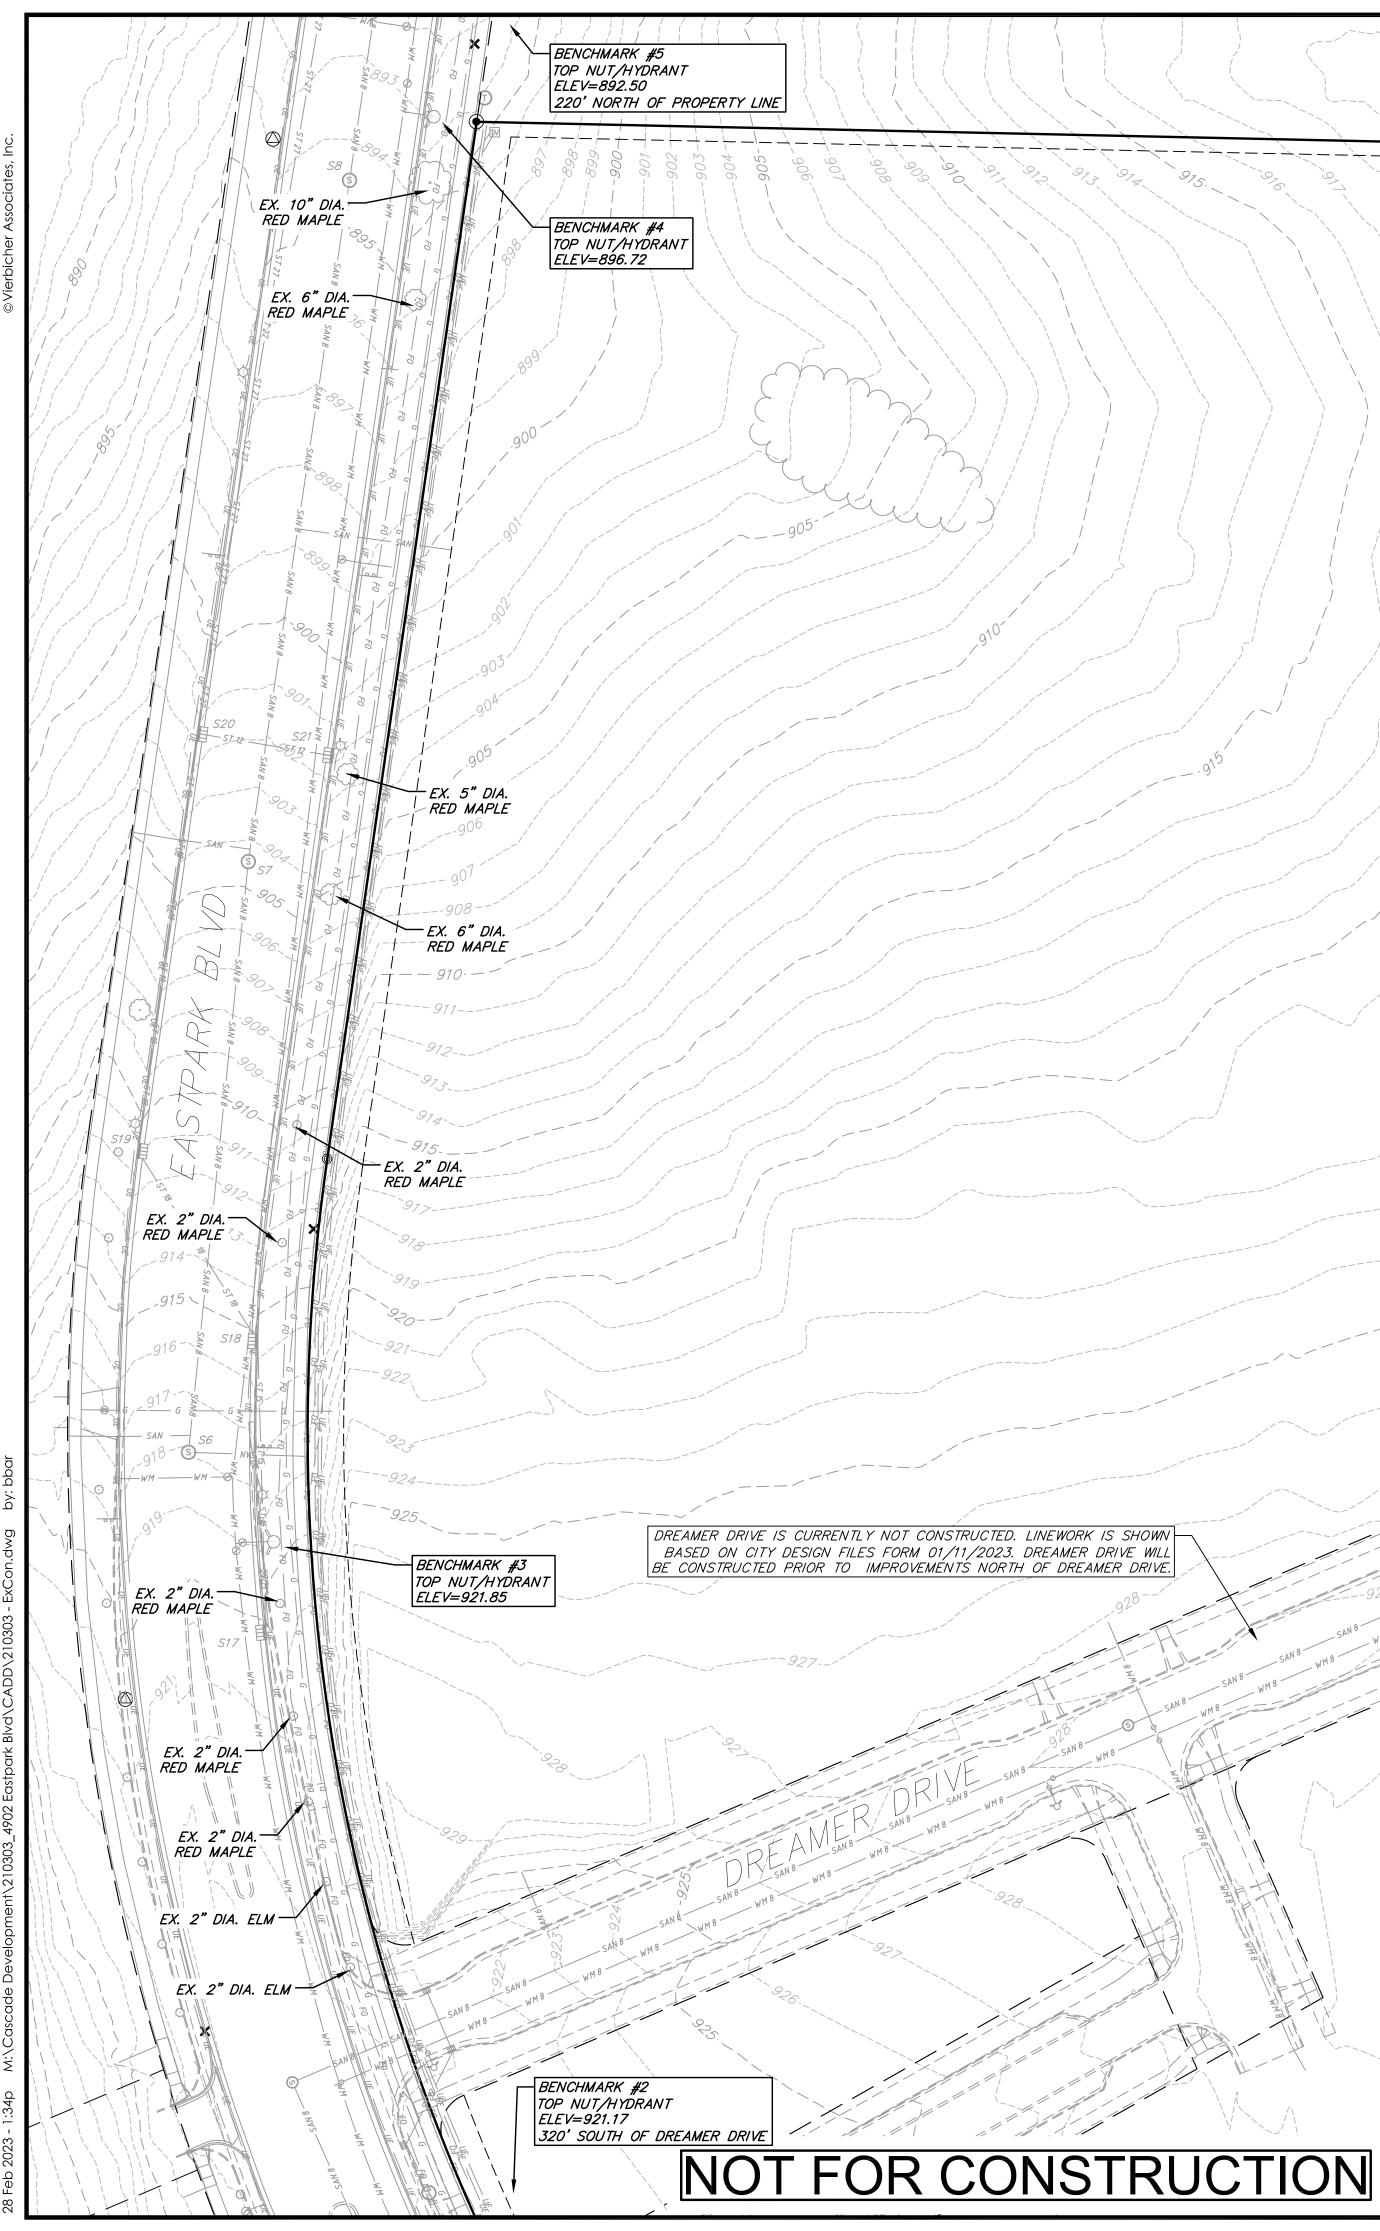
TOPOGRAPHIC SYMBOL LEGEND

- EXISTING SIGN (TYPE NOTED)
- EXISTING CURB INLET
- (ST) EXISTING STORM MANHOLE
- S EXISTING SANITARY MANHOLE
- C EXISTING FIRE HYDRANT
- ⊘ EXISTING WATER MAIN VALVE
- © EXISTING CURB STOP
- 🖂 EXISTING GAS VALVE
- \Diamond EXISTING LIGHT POLE
- M EXISTING TV PEDESTAL
- (T) EXISTING TELEPHONE MANHOLE
- EXISTING TELEPHONE PEDESTAL
- EXISTING DECIDUOUS TREE

- ----- EXISTING SILT FENCE

- EXISTING EDGE OF TREES
- ---- 928 ---- EXISTING MINOR CONTOUR



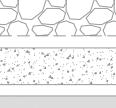






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EXIST	ING SA	NITARY	STRUCTU	RE TABLE
NAME	ΤΥΡΕ	RIM/TC	INVERT	DIRECTION
S1	SMH	903.36	891.16	SE
			891.03	NW
S2	SMH	905.86	889.66	SE
			889.61	SW
			890.81	NW
			895.64	NW
S3	SMH	909.73	899.71	SE
			899.85	NW
S4	SMH	917.44	907.37	SE
			907.47	NW
S5	SMH	921.62	911.72	SE
			911.76	W
			911.83	NW
S6	SMH	917.90	907.28	N
			907.35	E
S7	SMH	904.37	893.84	N
			893.93	S
S8	SMH	894.48	883.69	N
			883.78	S
S9	SMH	890.05	877.47	N
			876.55	S
			876.47	W
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<u>GENERAL NOTES:</u>

- 1. This plan is not intended to be a property survey as defined in Chapter A–E 7 of the Wisconsin Administrative Code. The property lines shown on this plan are based on found monumentation, Certified Survey Map #15829, recorded as Document # 5778376 and subsequent surveys of record.
- 2. This plan is based upon field survey work performed on August 17, 18 and 24, 2022. Any changes in site conditions after August 24, 2022 are not reflected by this plan.
- 3. This plan is referenced to the Wisconsin County Coordinate System-Dane Zone, NAD 83 (2011). Elevations are referenced to NAVD 88 (2012) datum. Field data was obtained using Robotic Total Station and GPS.
- 4. All underground utilities have been located per markings placed on the ground or maps provided by the utilities (owners) and/or their authorized representatives. Markings are per Digger's Hotline ticket #20223311075 and #20223311078. No private locate request was made. Vierbicher does not warrant the locations marked or mapped by others. Sewer and water pipe sizes were obtained from the City of Madison GTweb site. Some storm sewer pipe sizes were measured during the survey.
- 5. No attempt has been made as a part of this plan to obtain or show data concerning condition,or capacity of any utility or municipal/public service facility. For information regarding these utilities contact the appropriate agencies.
- 6. Surveyor has made no investigation or independent search for easements of record, encumbrances, restrictive covenants, or ownership title evidence, or any other facts that a title search might reveal, except those easements shown on the Creek Crossing At St. Francis plat.



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NAM		E RIM/TC	INVERT	DIRECTIO
S11	L CIN	906.23	901.53	SE
			901.79	NW
S12	2 STM	H 907.63	903.21	NE
			902.89	S
			903.16	NW
S13	3 CIN	907.57	903.68	SW
S14	1 CIN	912.70	909.19	SE
			909.24	NW
S15	5 CIN	919.28	914.88	E
			914.73	SE
			914.93	SW
S16	5 CIN	918.59	915.39	W
S17	7 CIN	920.61	917.21	N
S18	3 CIN	915.63	912.32	S
			912.07	NW
S19) CIN	911.41	907.32	N
			907.37	SE
S20) CIN	901.86	896.83	N
			897.30	E
			897.06	S
S21	L CIN	902.02	898.32	w
S22	2 STM	H 890.10	880.45	N
			880.45	E
			883.70	S
			880.40	W
S23	3 CIN	890.31	880.40	N
			880.40	E
			880.40	W
S24	1 CIN	890.38	882.20	NE
			881.73	w

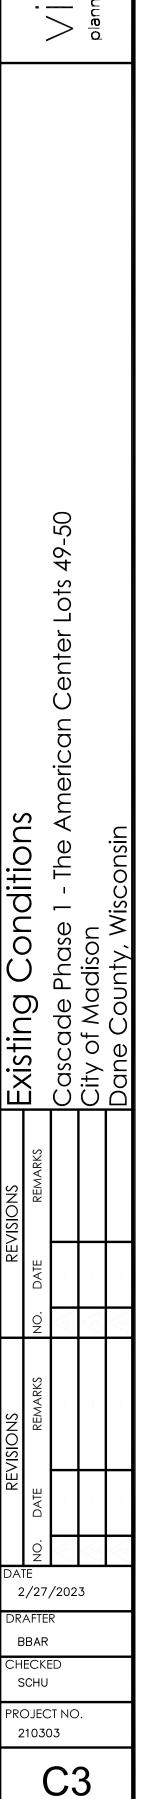EXISTING STORM STRUCTURE TABLE

_____ -----——*<____*___

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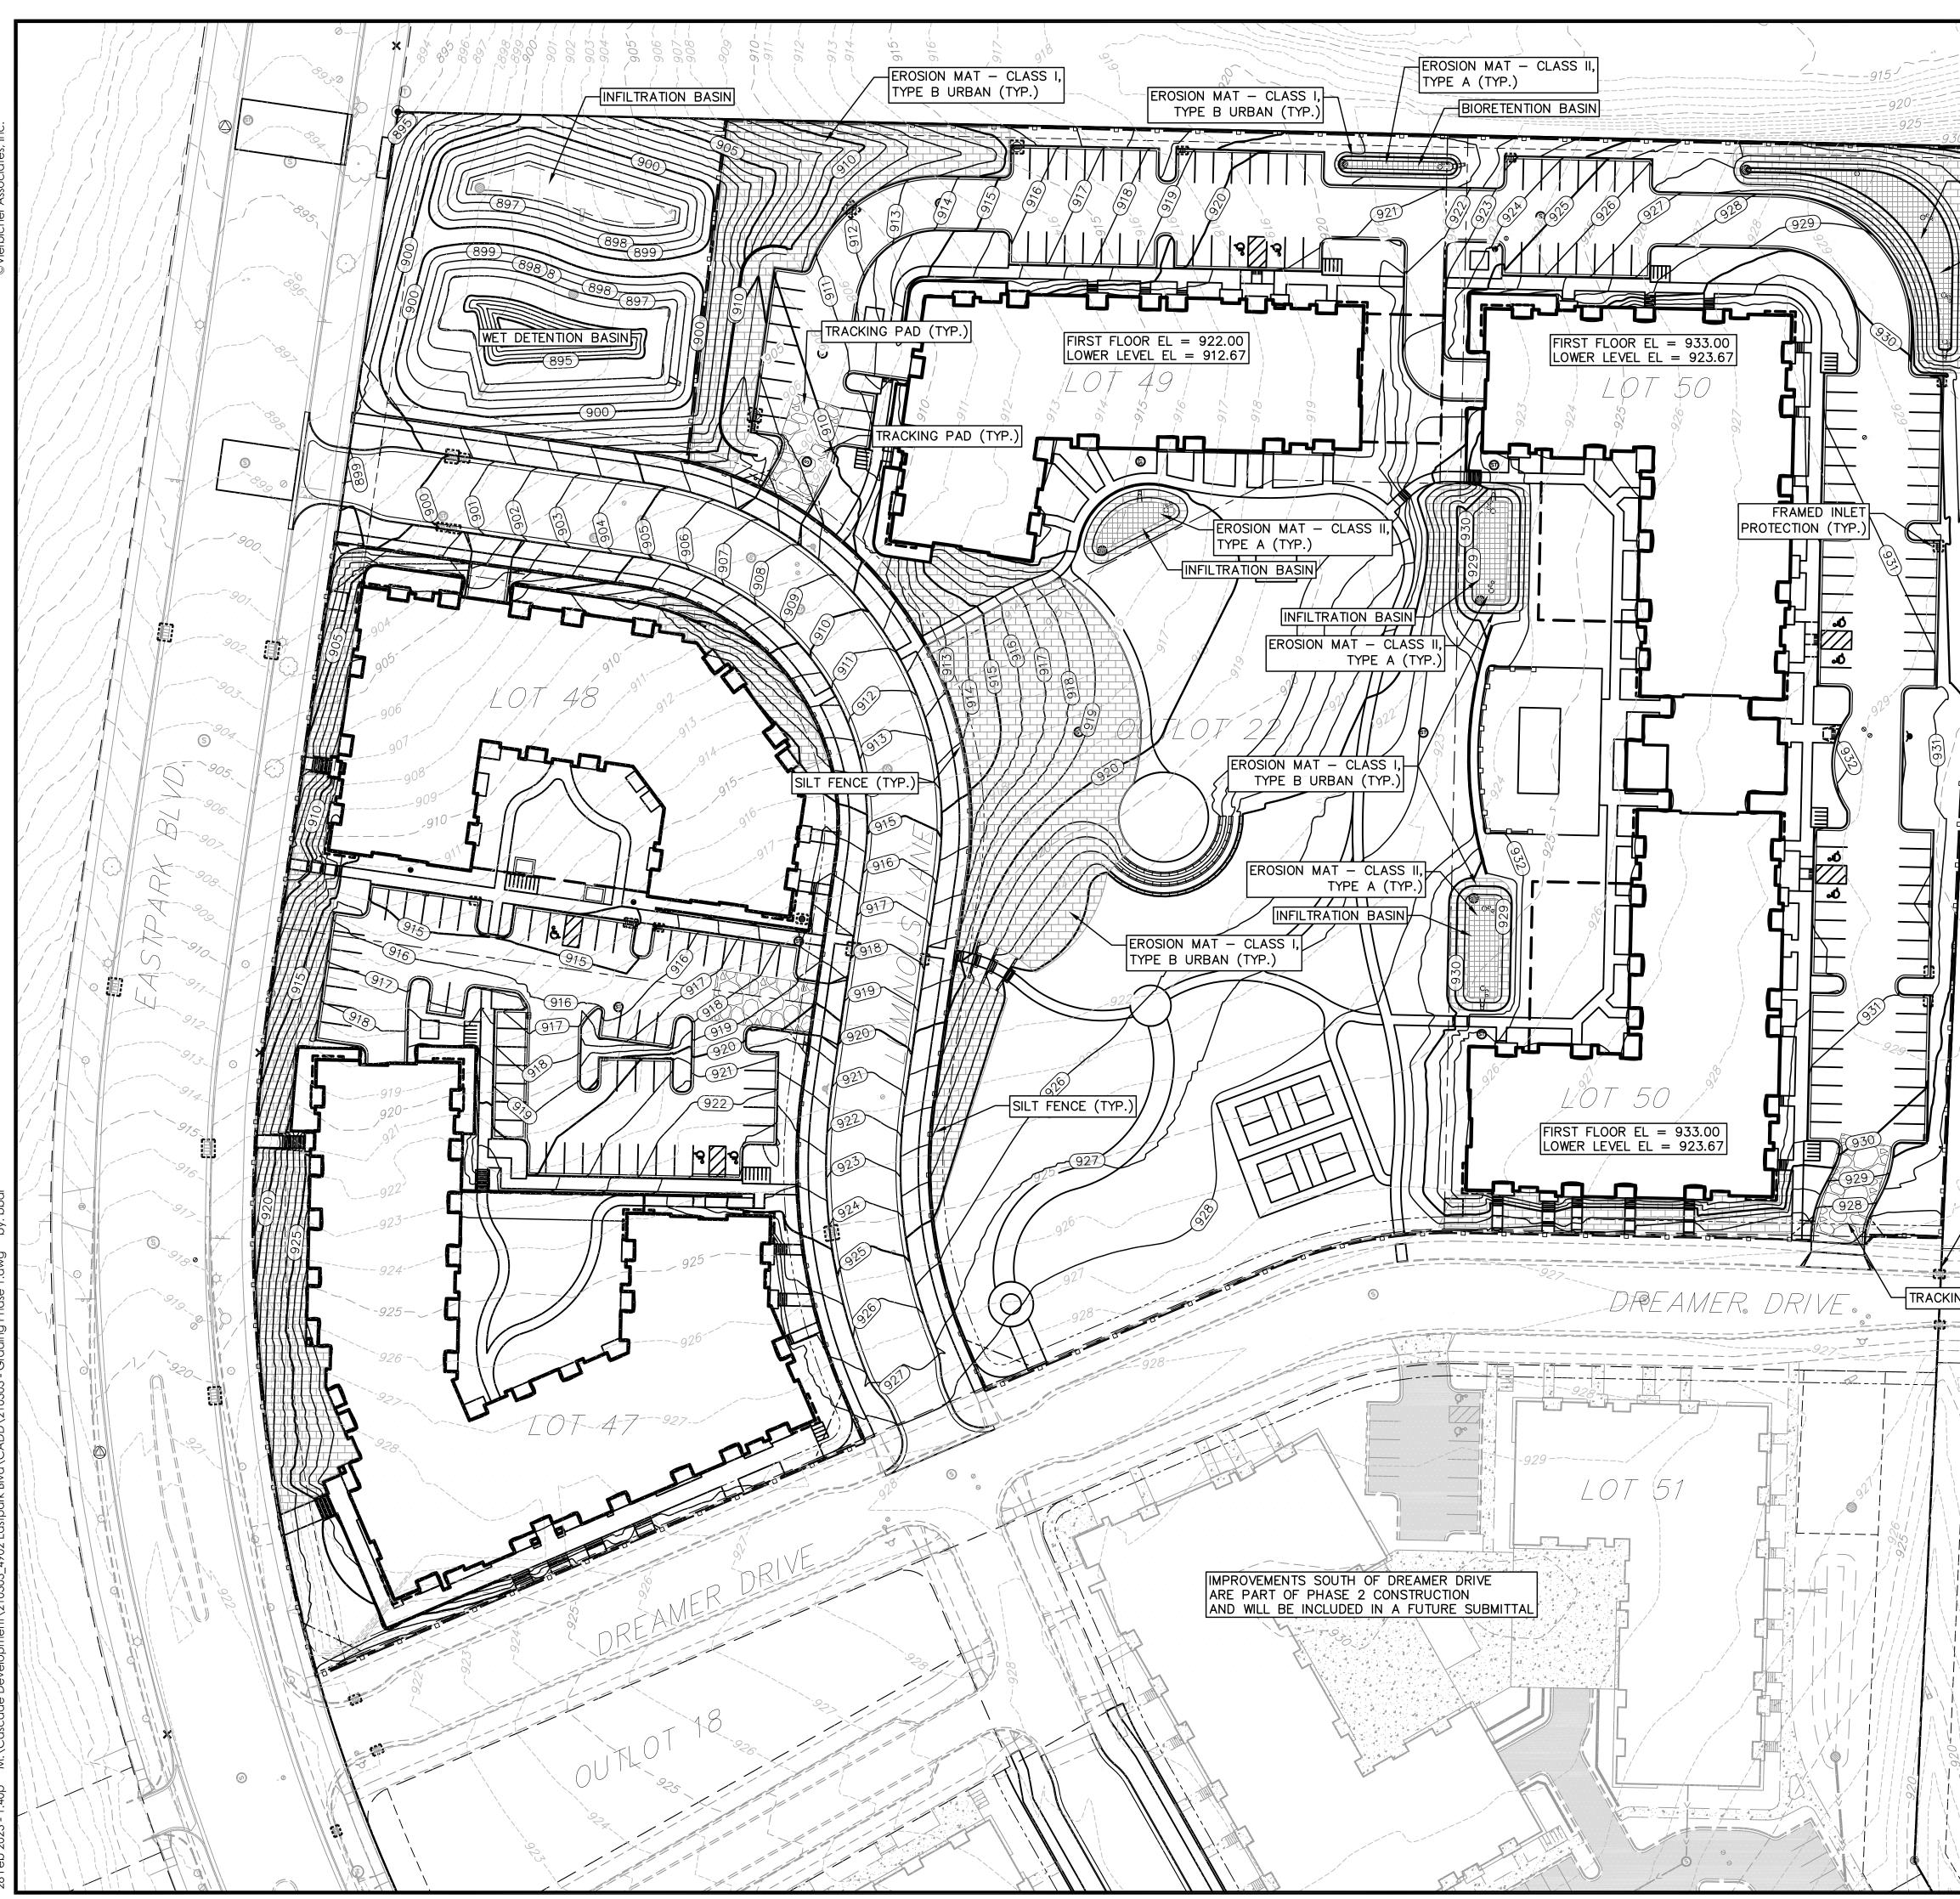
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TOPOGRAPHIC LINEWORK LEGEND


- ----- FO ----- EXISTING FIBER OPTIC LINE
- ----- G ----- EXISTING GAS LINE
- ----- UE ----- EXISTING UNDERGROUND ELECTRIC LINE
- SAN SAN EXISTING SANITARY SEWER LINE (SIZE NOTED)
- ---- st ----- st ---- EXISTING STORM SEWER LINE (SIZE NOTED)
- - EXISTING EDGE OF PAVEMENT
- ----- EXISTING EDGE OF GRAVEL
 - EXISTING GRAVEL SURFACE
 - EXISTING CONCRETE SURFACE

EXISTING ASPHALT SURFACE








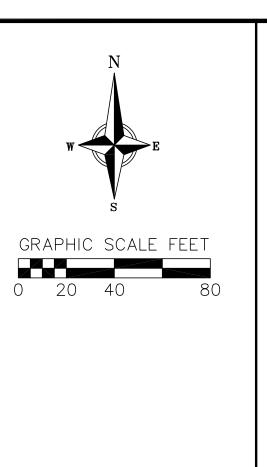


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		VIERDICU	planners engineers ad	
		Center Lots 49-50		
		Cascade Phase 1 - The American Center Lots 49-50	City of Madison	Dane County, Wisconsin
	REMARKS			
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	REMARKS			
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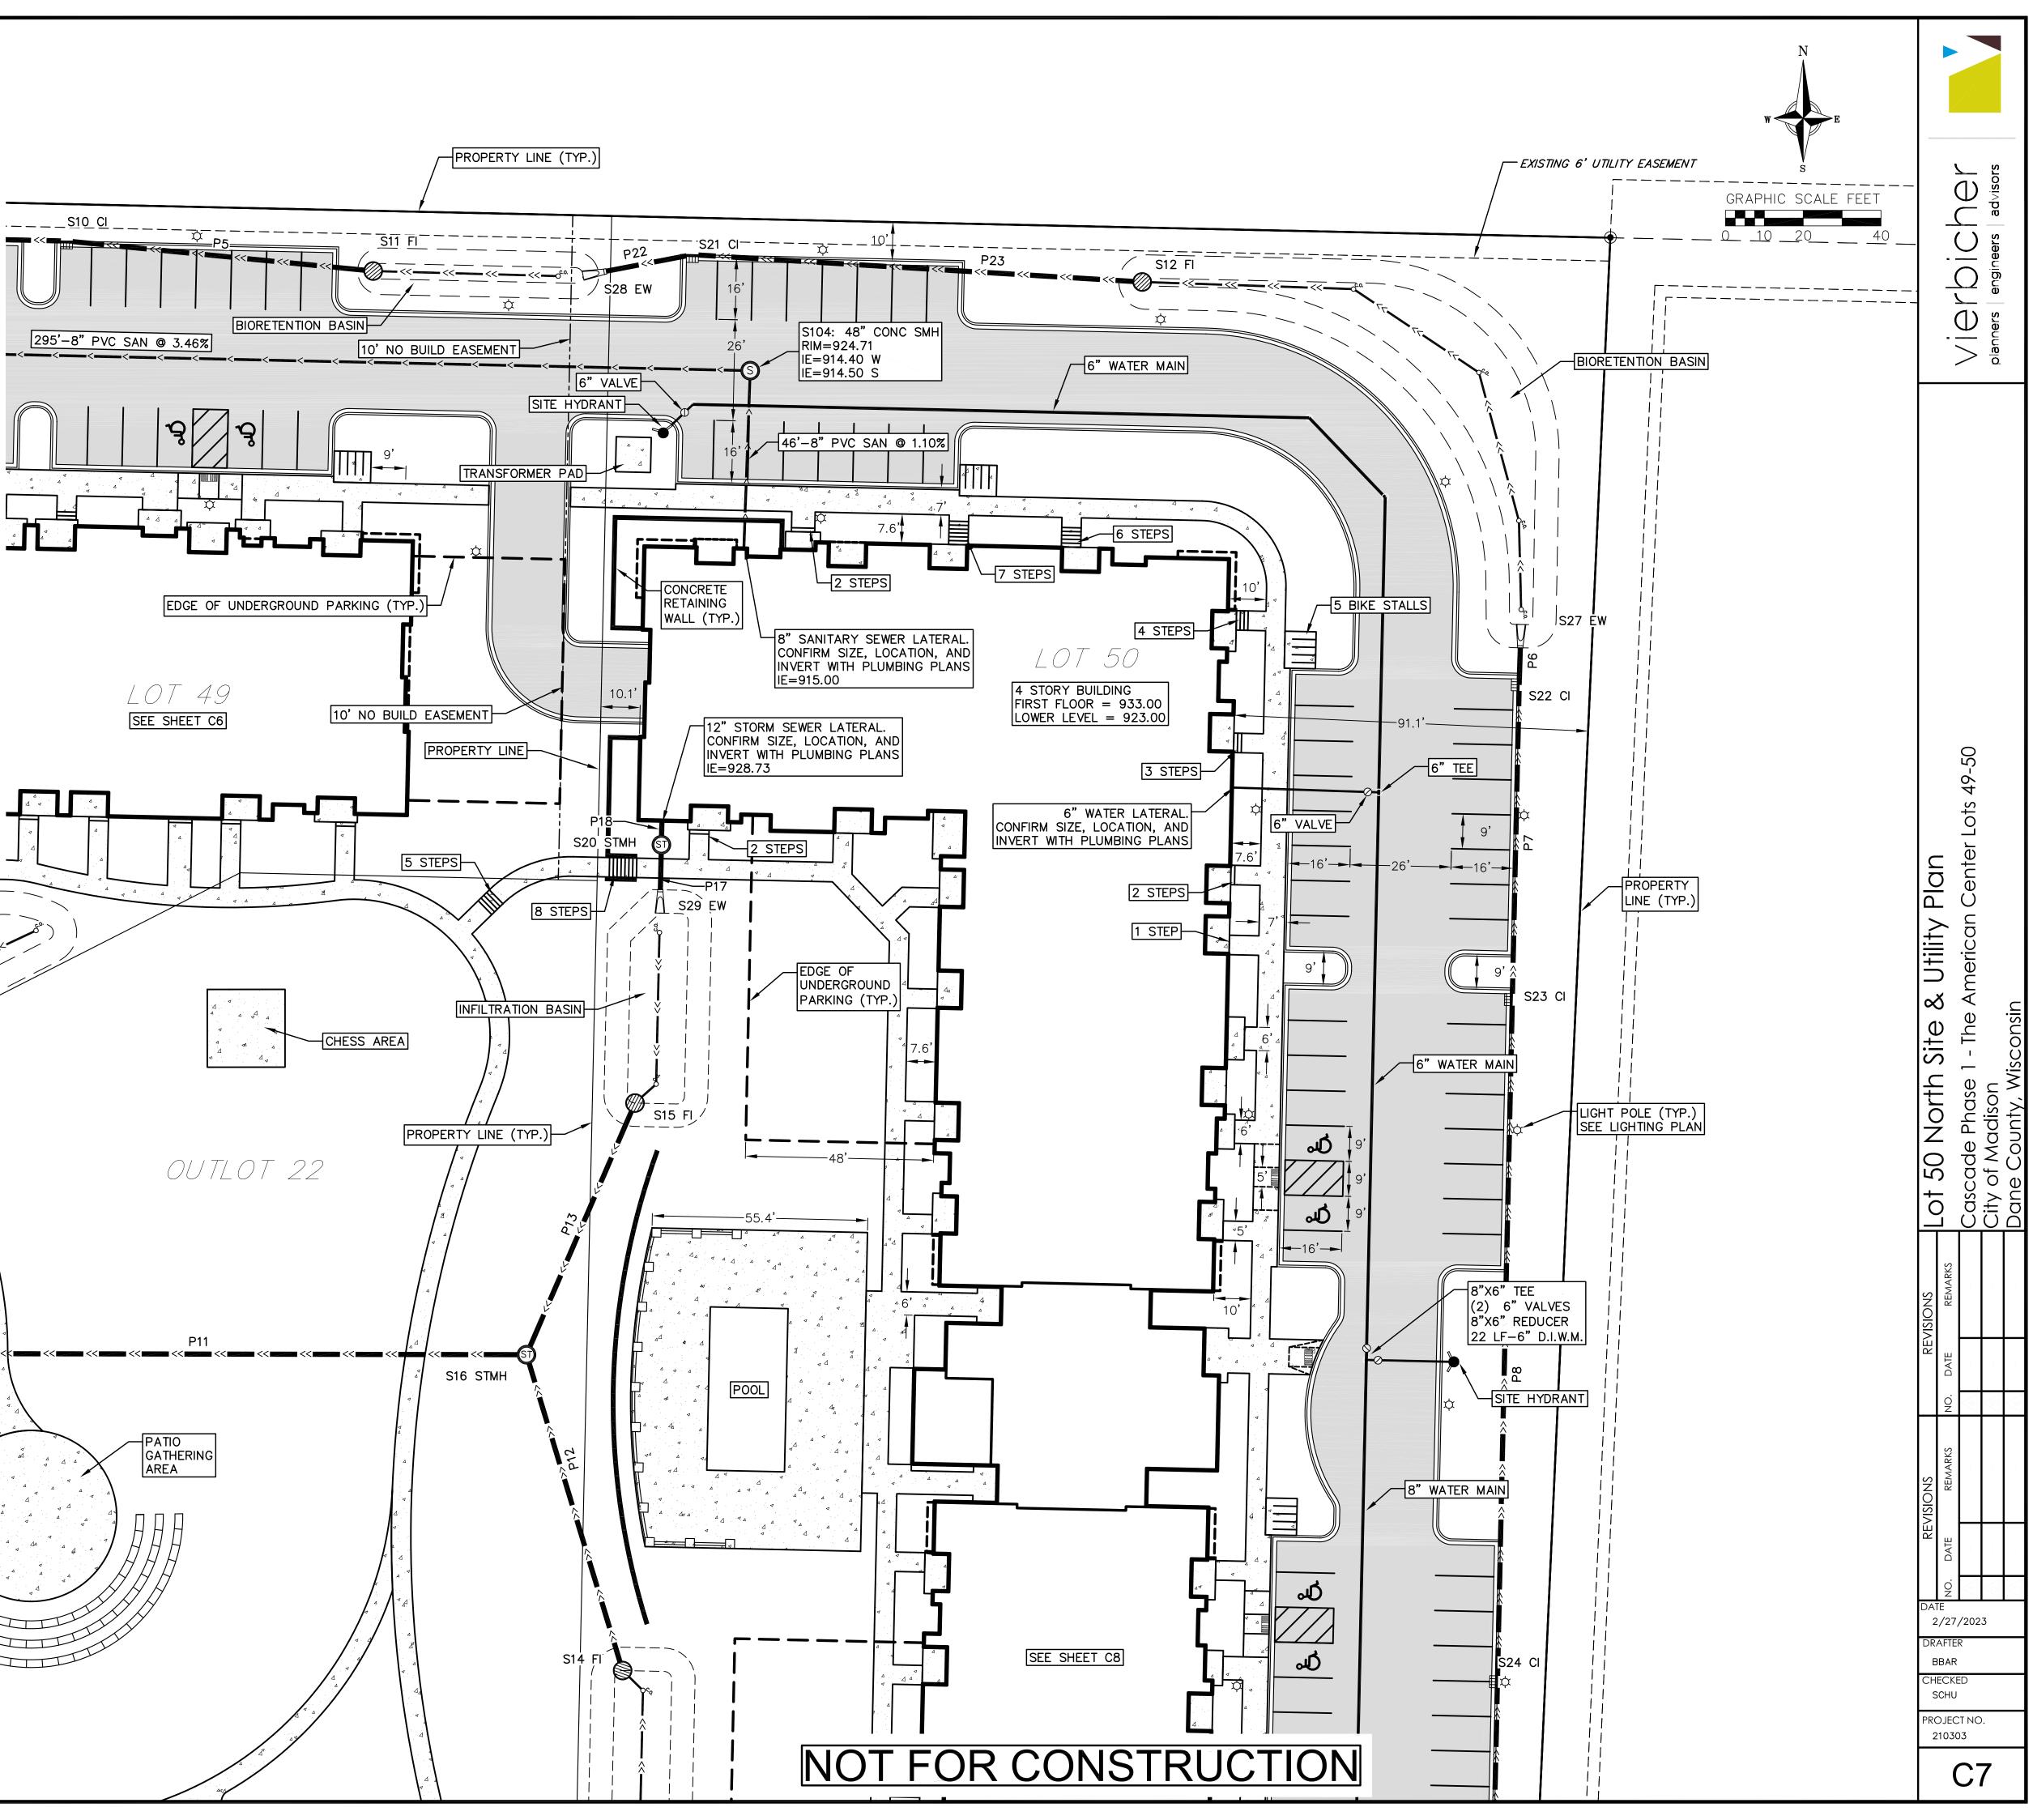





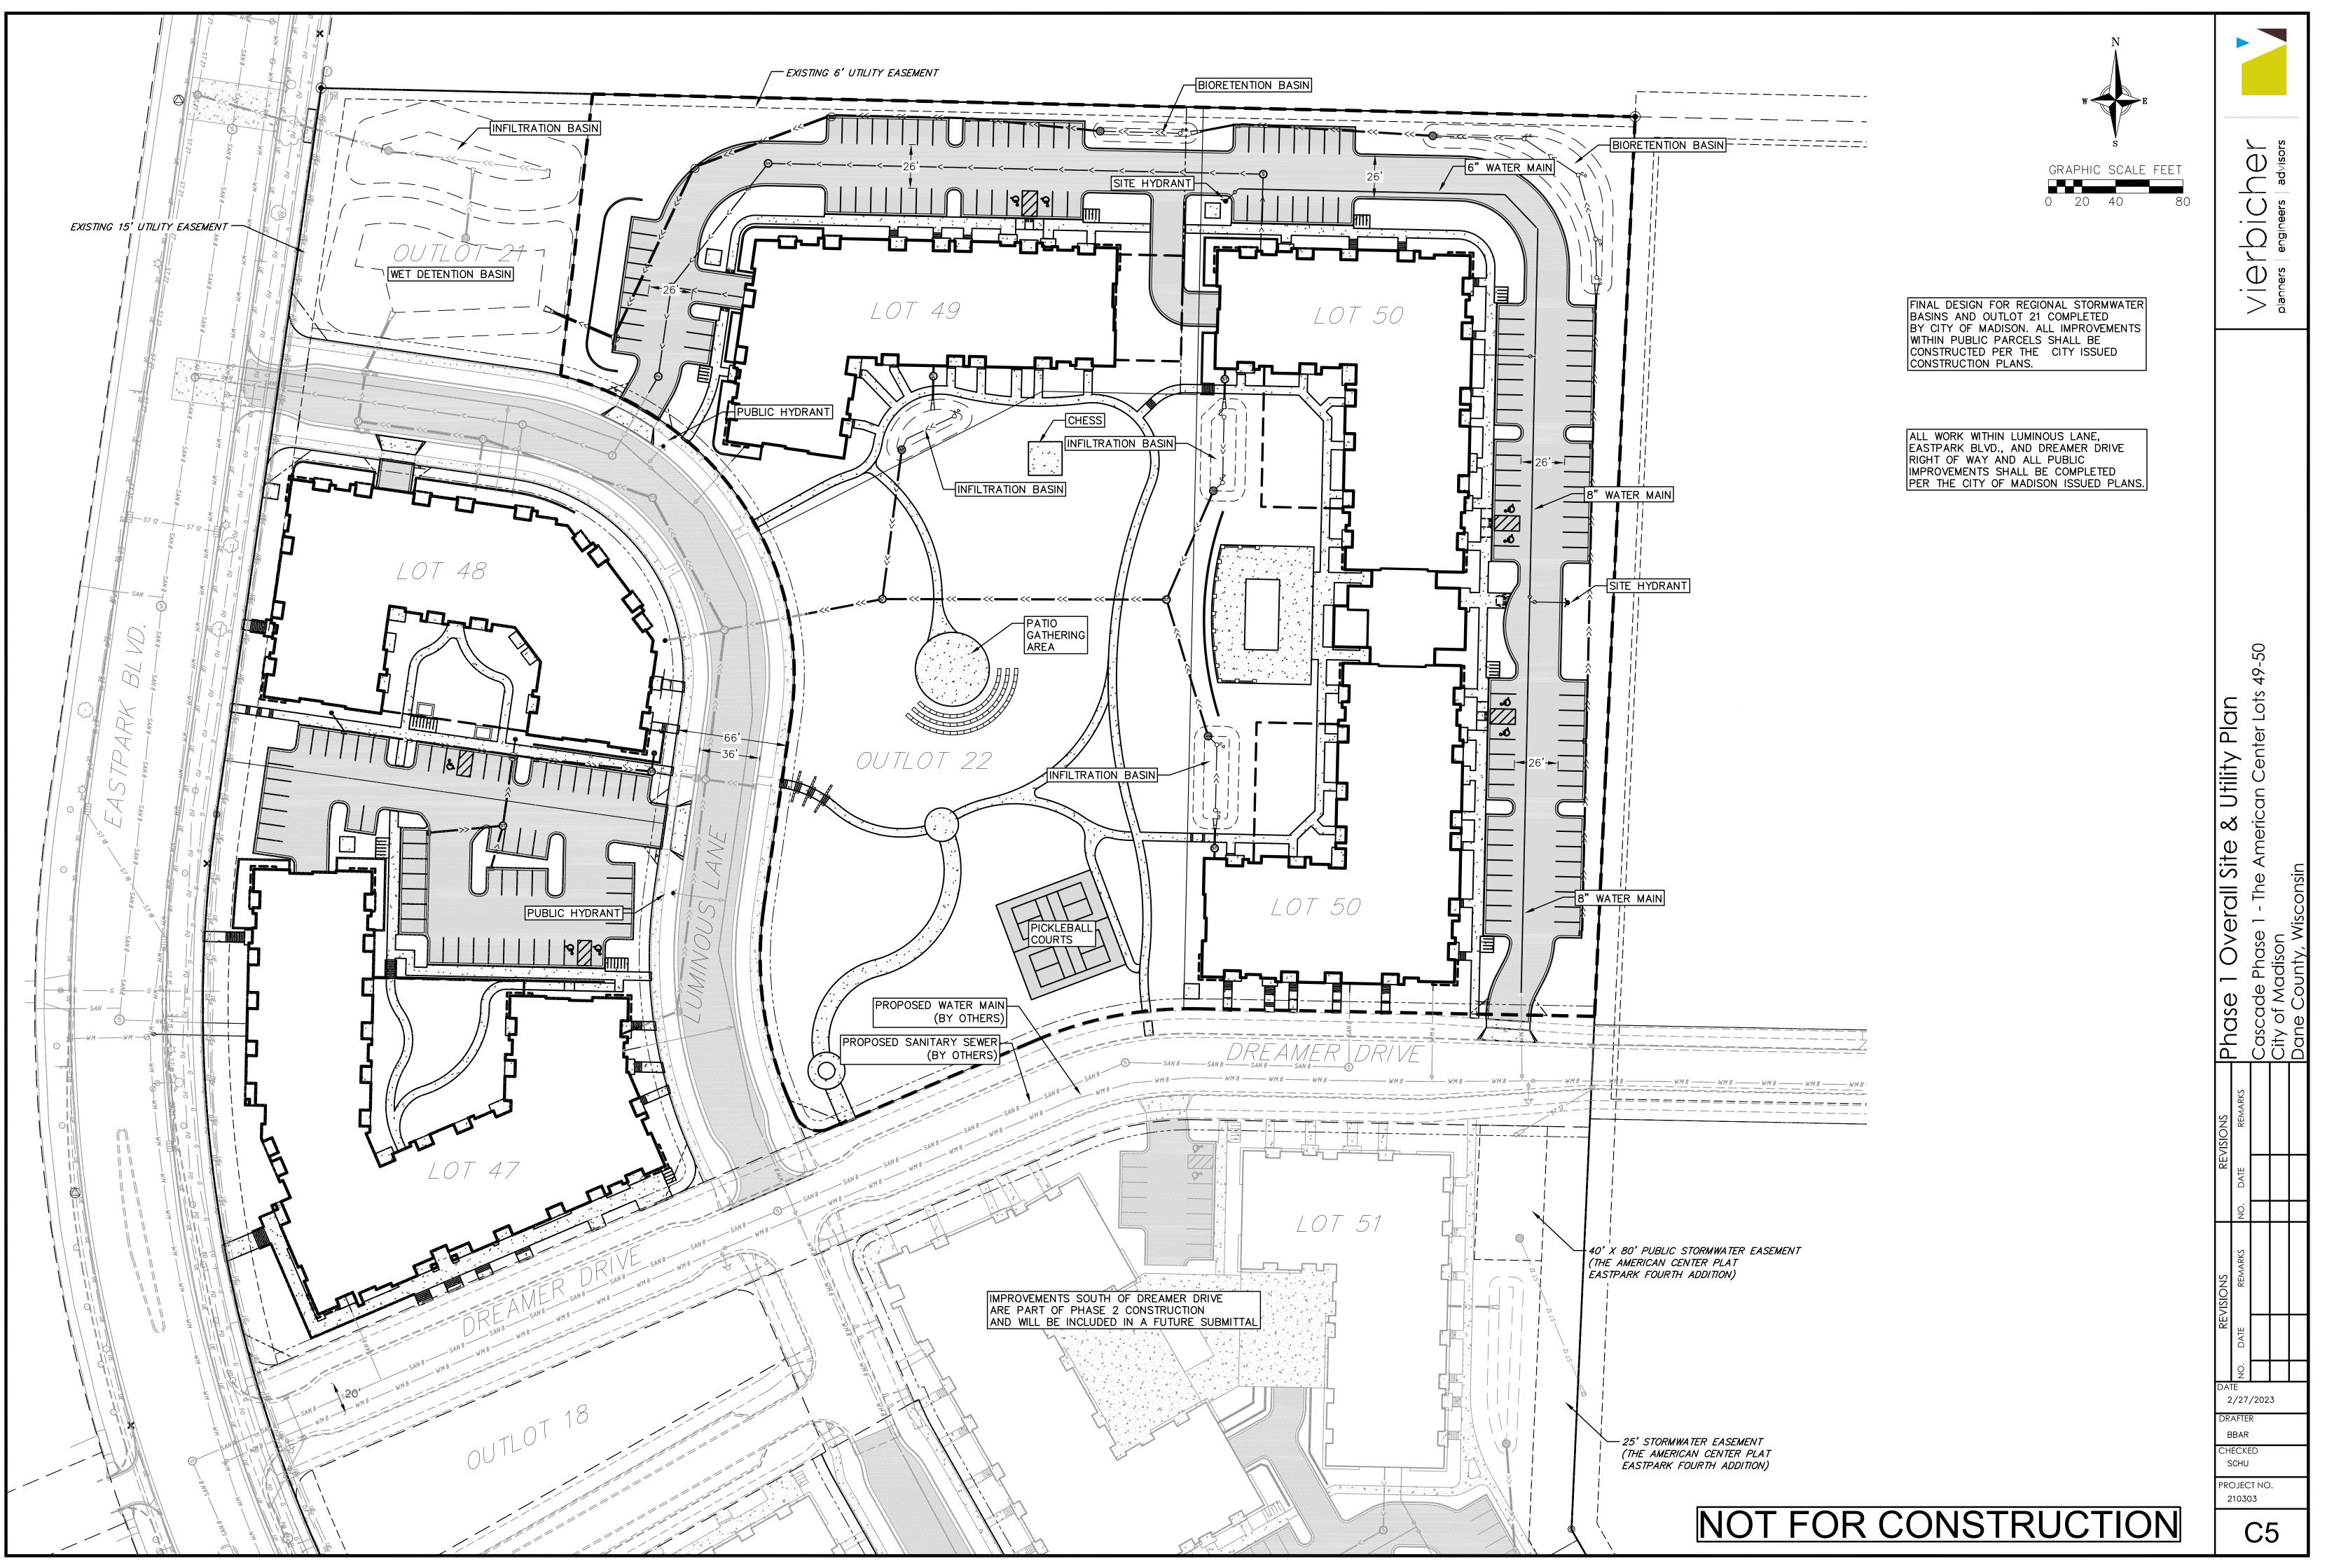

		ST	FORM	PIPE	TABLE			
PIPE NAME	PIPE TYPE	SIZE (IN.)	FROM	то	LENGTH (FT)	START INV	END INV	SLOPE
P4	RCP	12	S9	S10	81	911.27	914.77	4.32%
P5	RCP	12	S10	S11	79	914.77	916.50	2.18%
P6	RCP	12	S27	S22	16	925.40	925.48	0.50%
P7	RCP	12	S22	S23	81	925.48	925.88	0.50%
P8	RCP	12	S23	S24	176	925.88	926.76	0.50%
P10	RCP	12	S381	S17	47	909.34	909.81	1.00%
P11	RCP	12	S17	S16	169	909.81	923.18	7.92%
P12	RCP	12	S16	S14	85	923.18	926.00	3.32%
P13	RCP	12	S16	S15	70	923.18	926.00	4.00%
P14	RCP	12	S17	S18	90	909.81	916.00	6.91%
P17	RCP	12	S29	S20	18	928.50	928.68	1.00%
P18	RCP	12	S20		6	928.68	928.74	1.00%

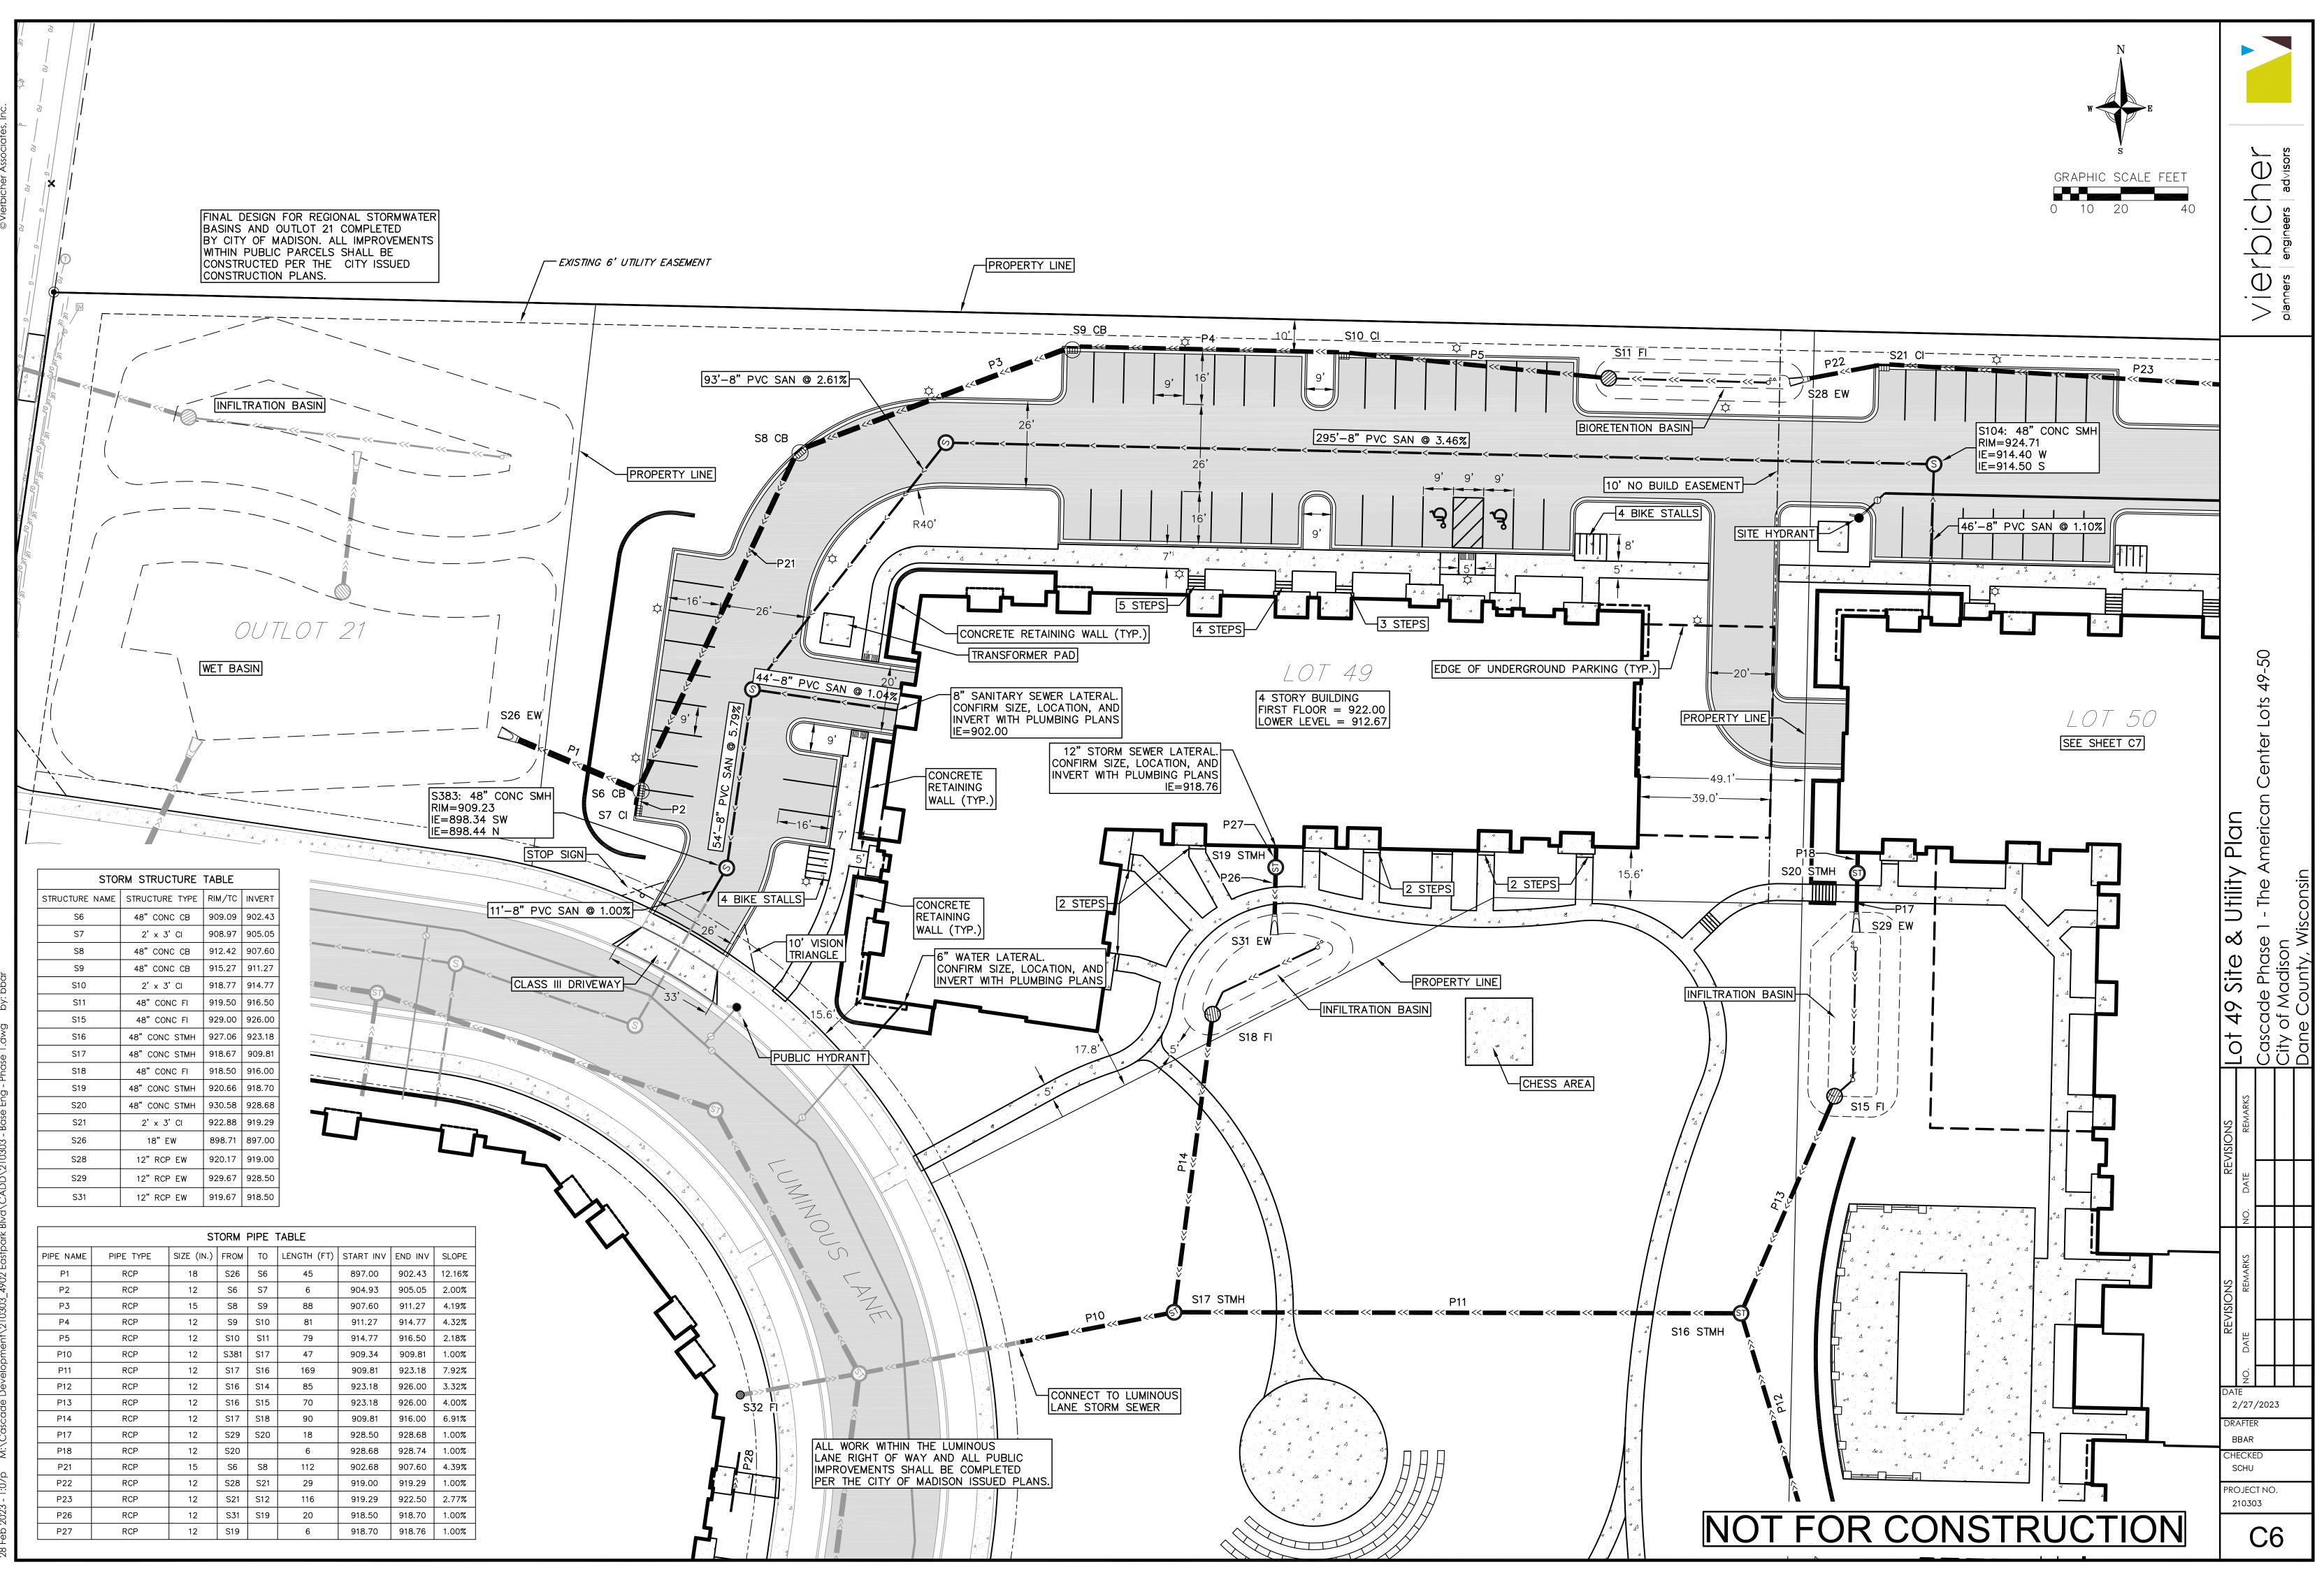
STORM STRUCTURE TABLE						
STRUCTURE NAME	STRUCTURE TYPE	RIM/TC	INVERT			
S9	48" CONC CB	915.27	911.27			
S10	2' x 3' Cl	918.77	914.77			
S11	48" CONC FI	919.50	916.50			
S12	48" CONC FI	926.50	922.50			
S13	48" CONC STMH	930.92	928.68			
S14	48" CONC FI	929.00	926.00			
S15	48" CONC FI	929.00	926.00			
S16	48" CONC STMH	927.06	923.18			
S17	48" CONC STMH	918.67	909.81			
S18	48" CONC FI	918.50	916.00			
S19	48" CONC STMH	920.66	918.70			
S20	48" CONC STMH	930.58	928.68			
S21	2' x 3' CI	922.88	919.29			
S22	2' x 3' CI	929.75	925.48			
S23	2' x 3' CI	930.38	925.88			
S24	2' x 3' CI	931.33	926.76			
S25	2' x 3' CI	930.17	927.43			
S27	12" RCP EW	926.57	925.40			
S28	12" RCP EW	920.17	919.00			
S29	12" RCP EW	929.67	928.50			
S30	12" RCP EW	929.67	928.50			
S31	12" RCP EW	919.67	918.50			




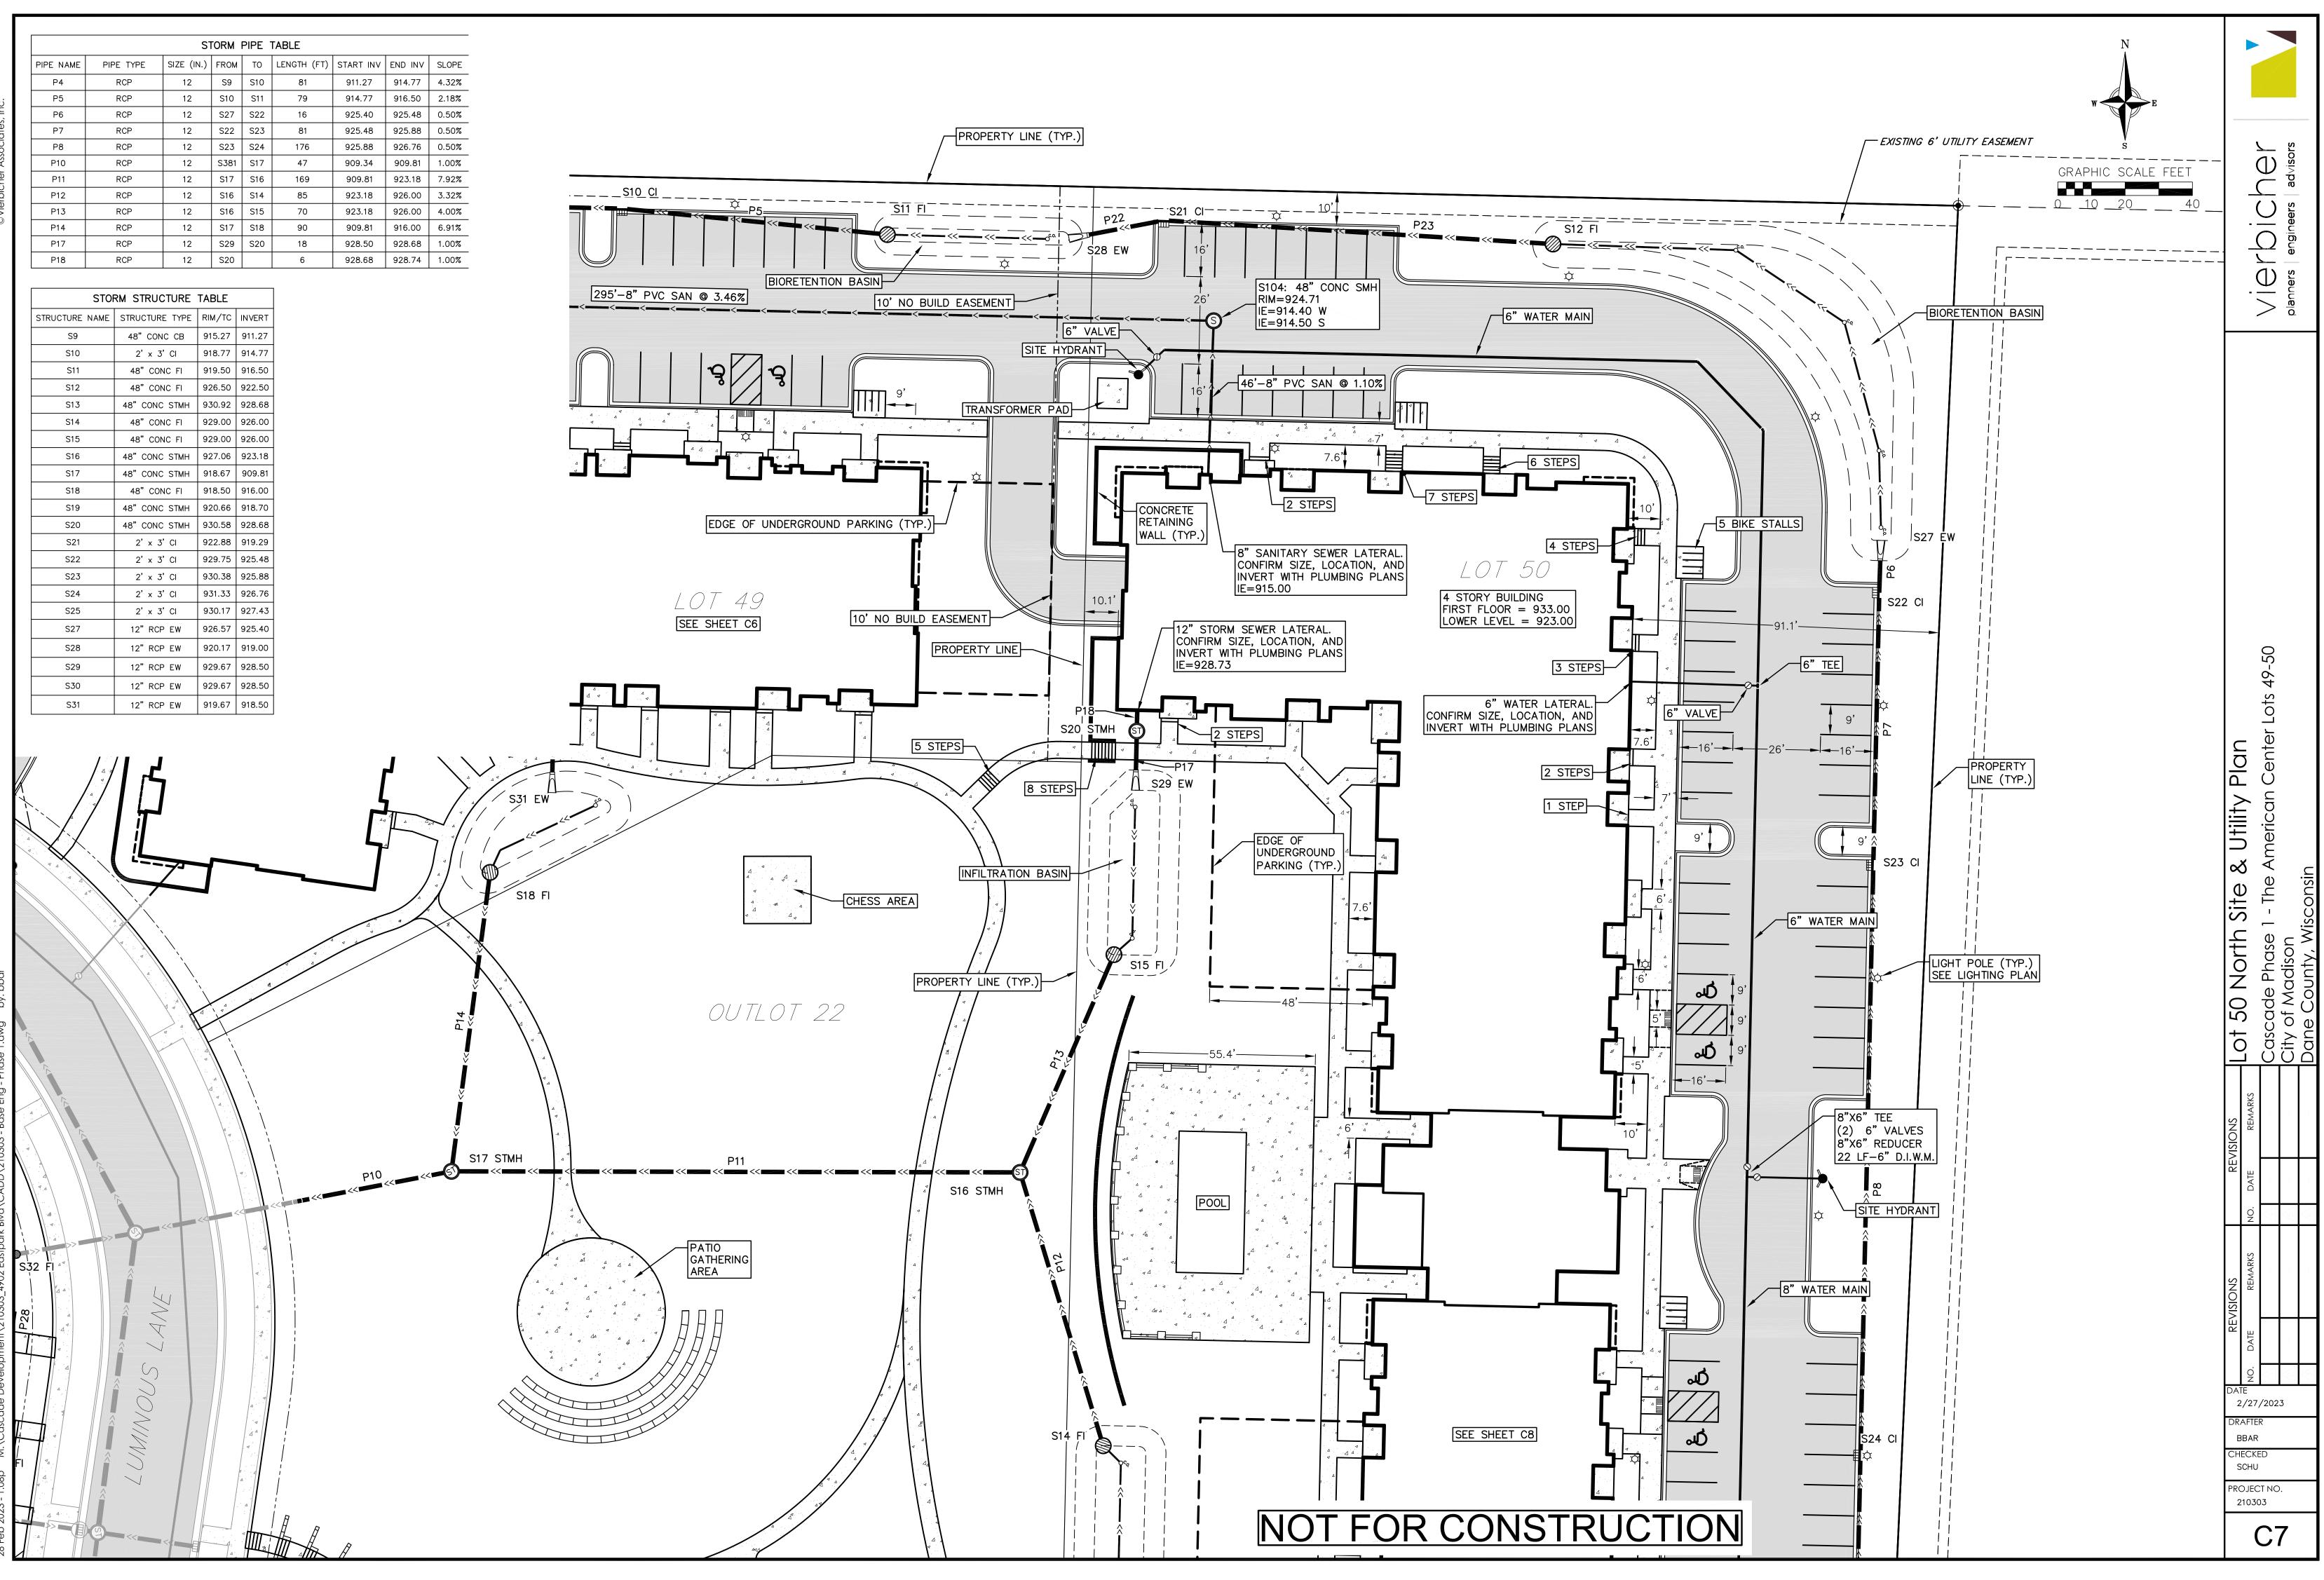







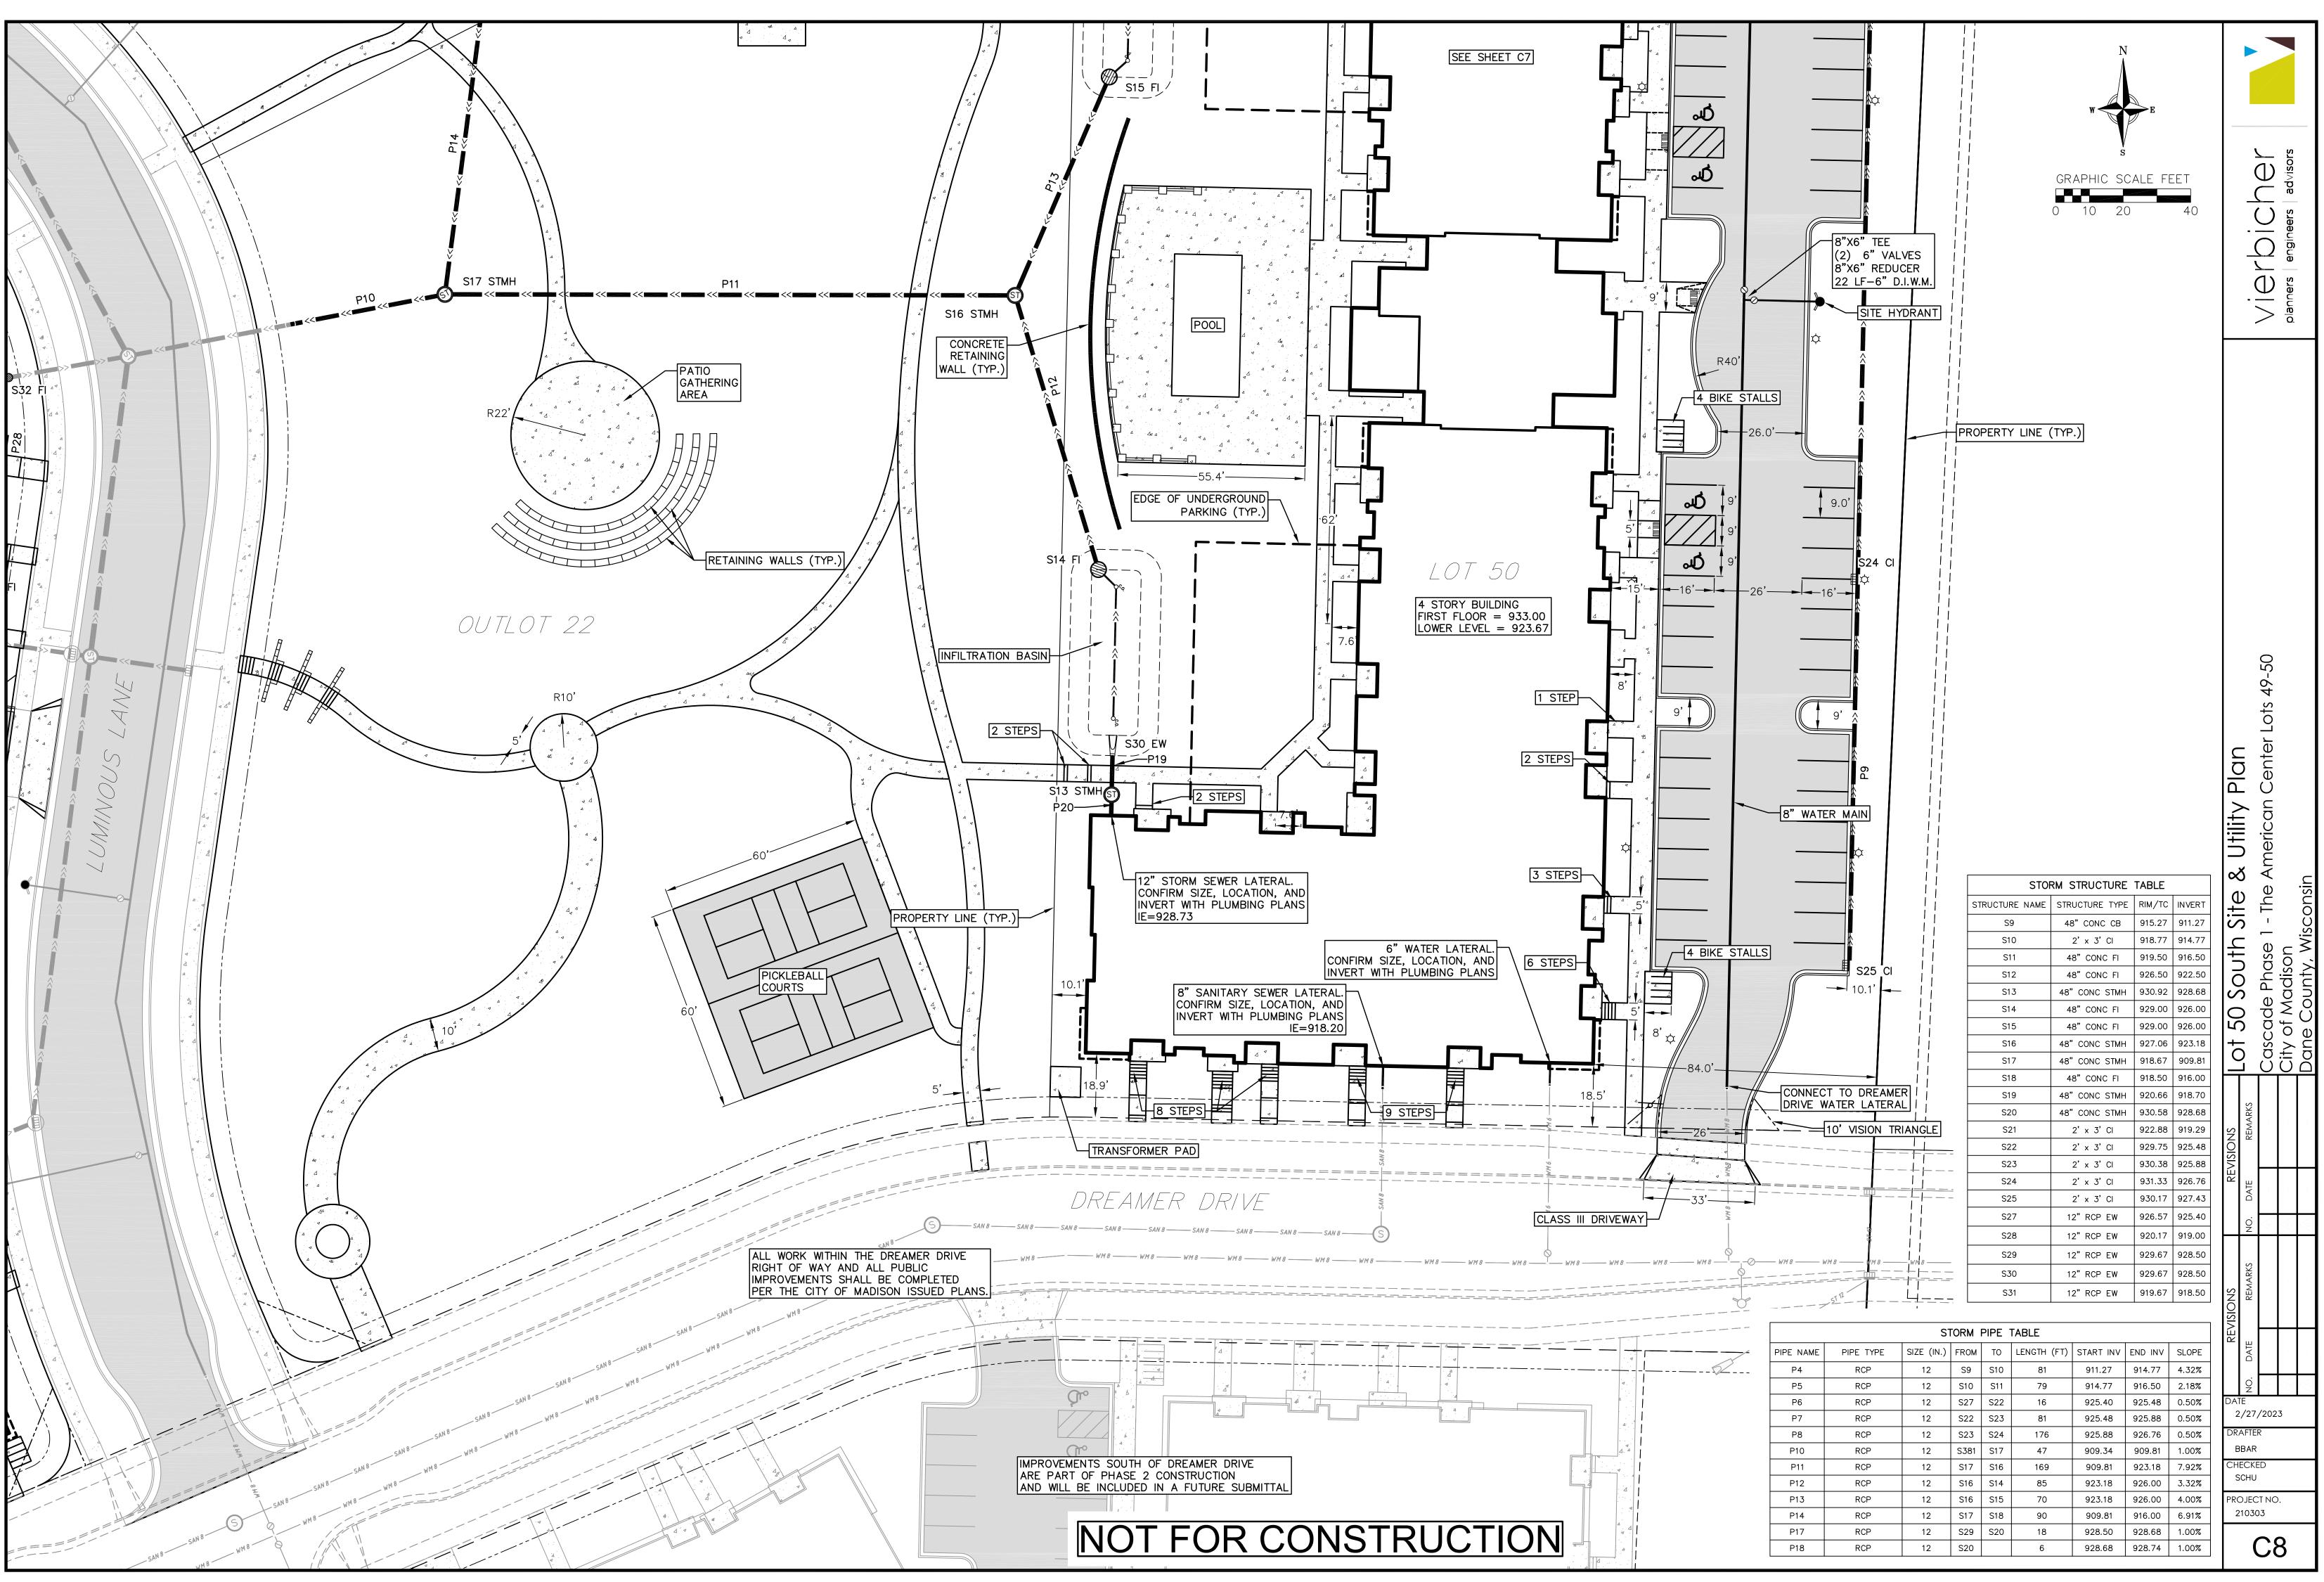

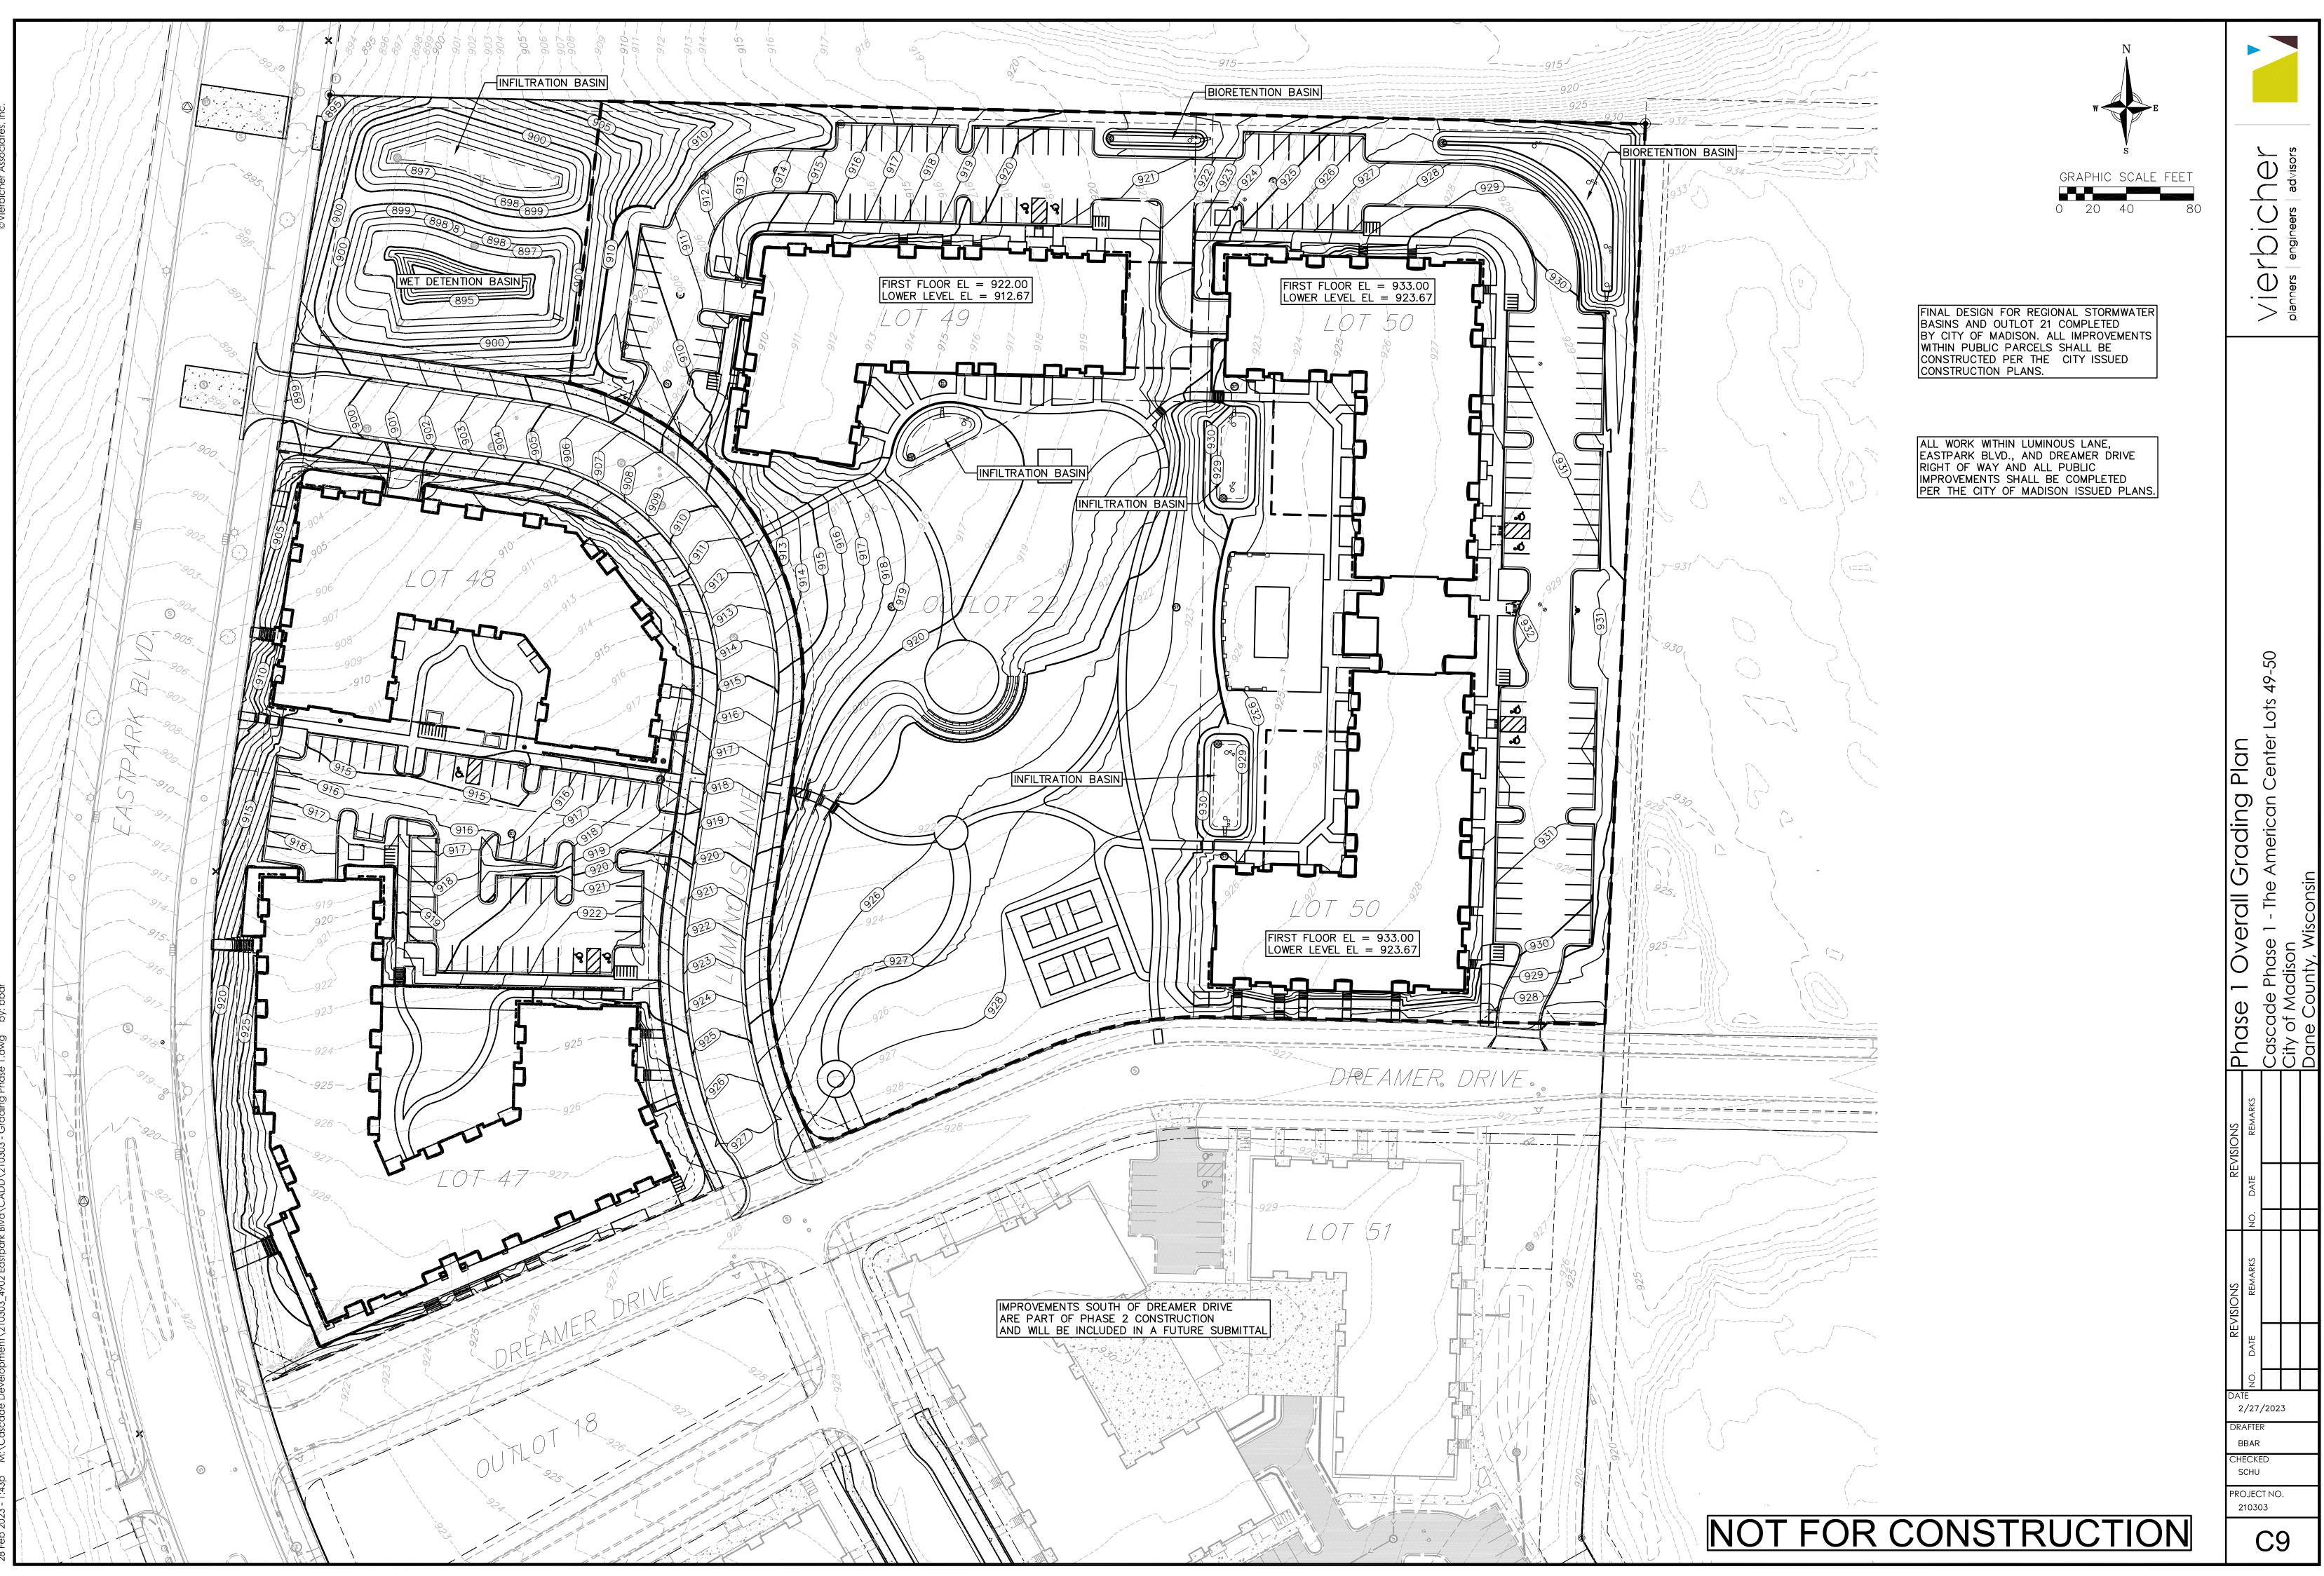


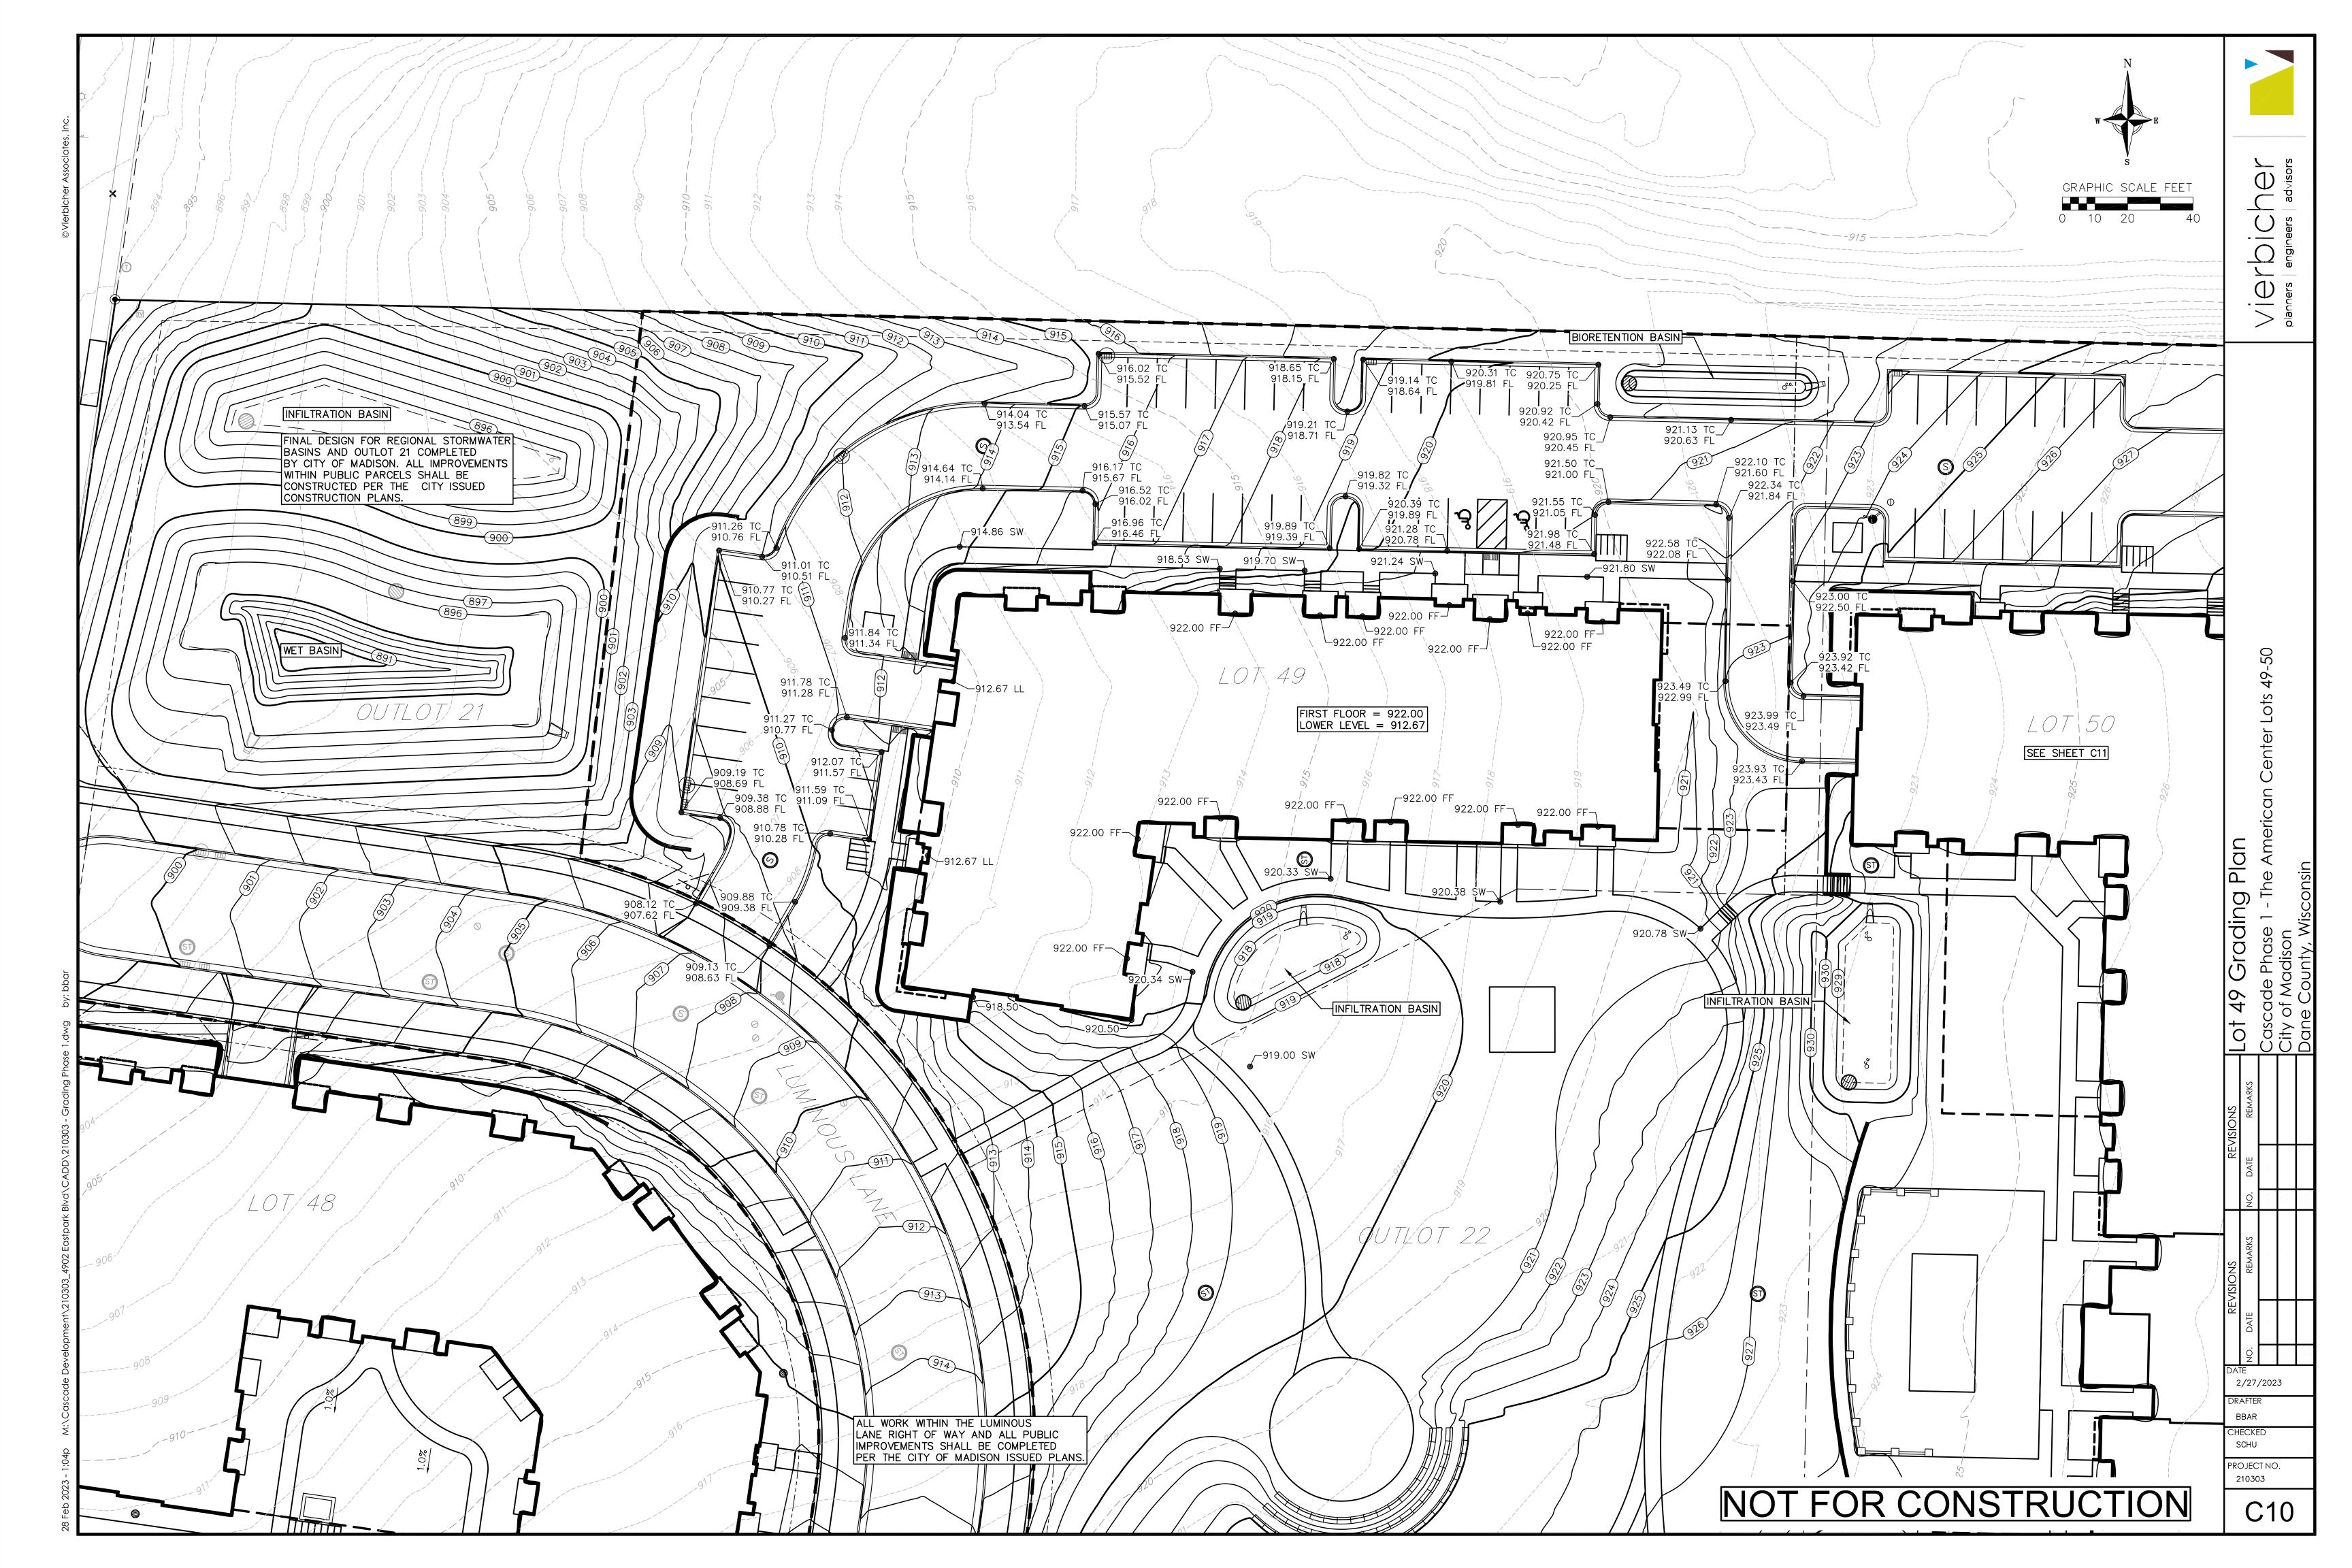





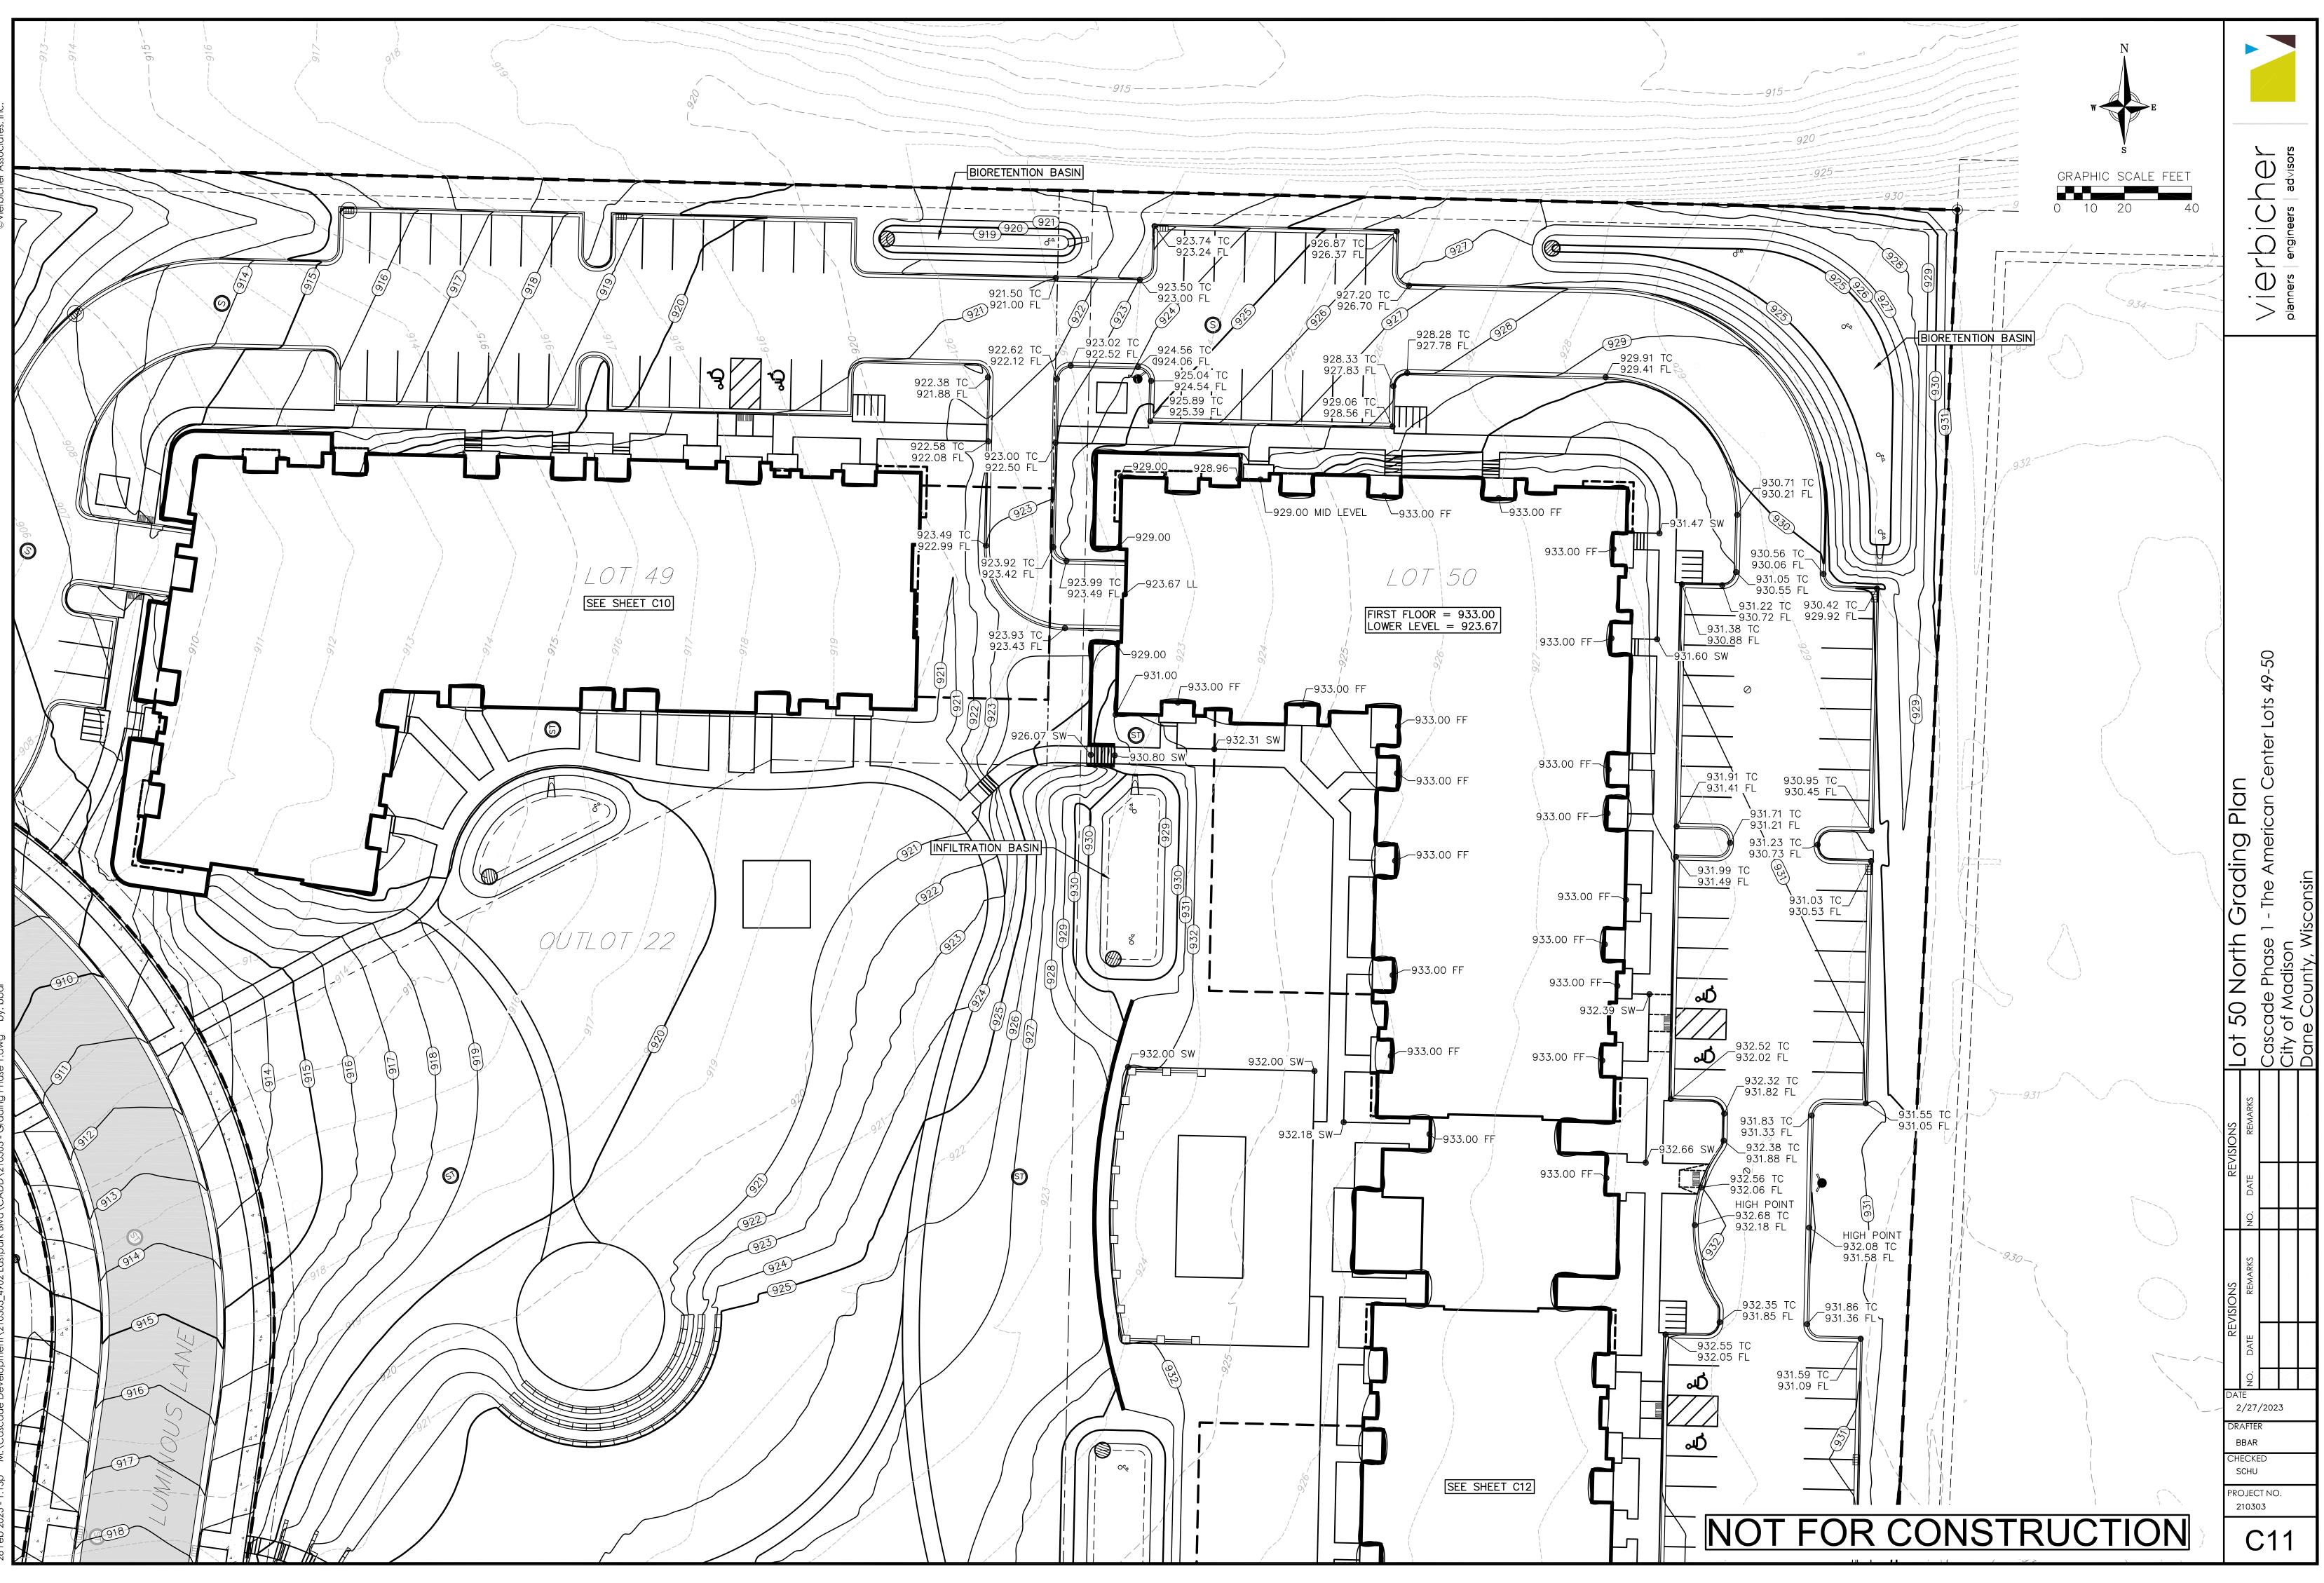


:8 Feb 2023 - 1:13p M:\Cascade Development\210303_4902 Eastpark Blvd\CADD\210303 - Grading Phase 1.dwg b

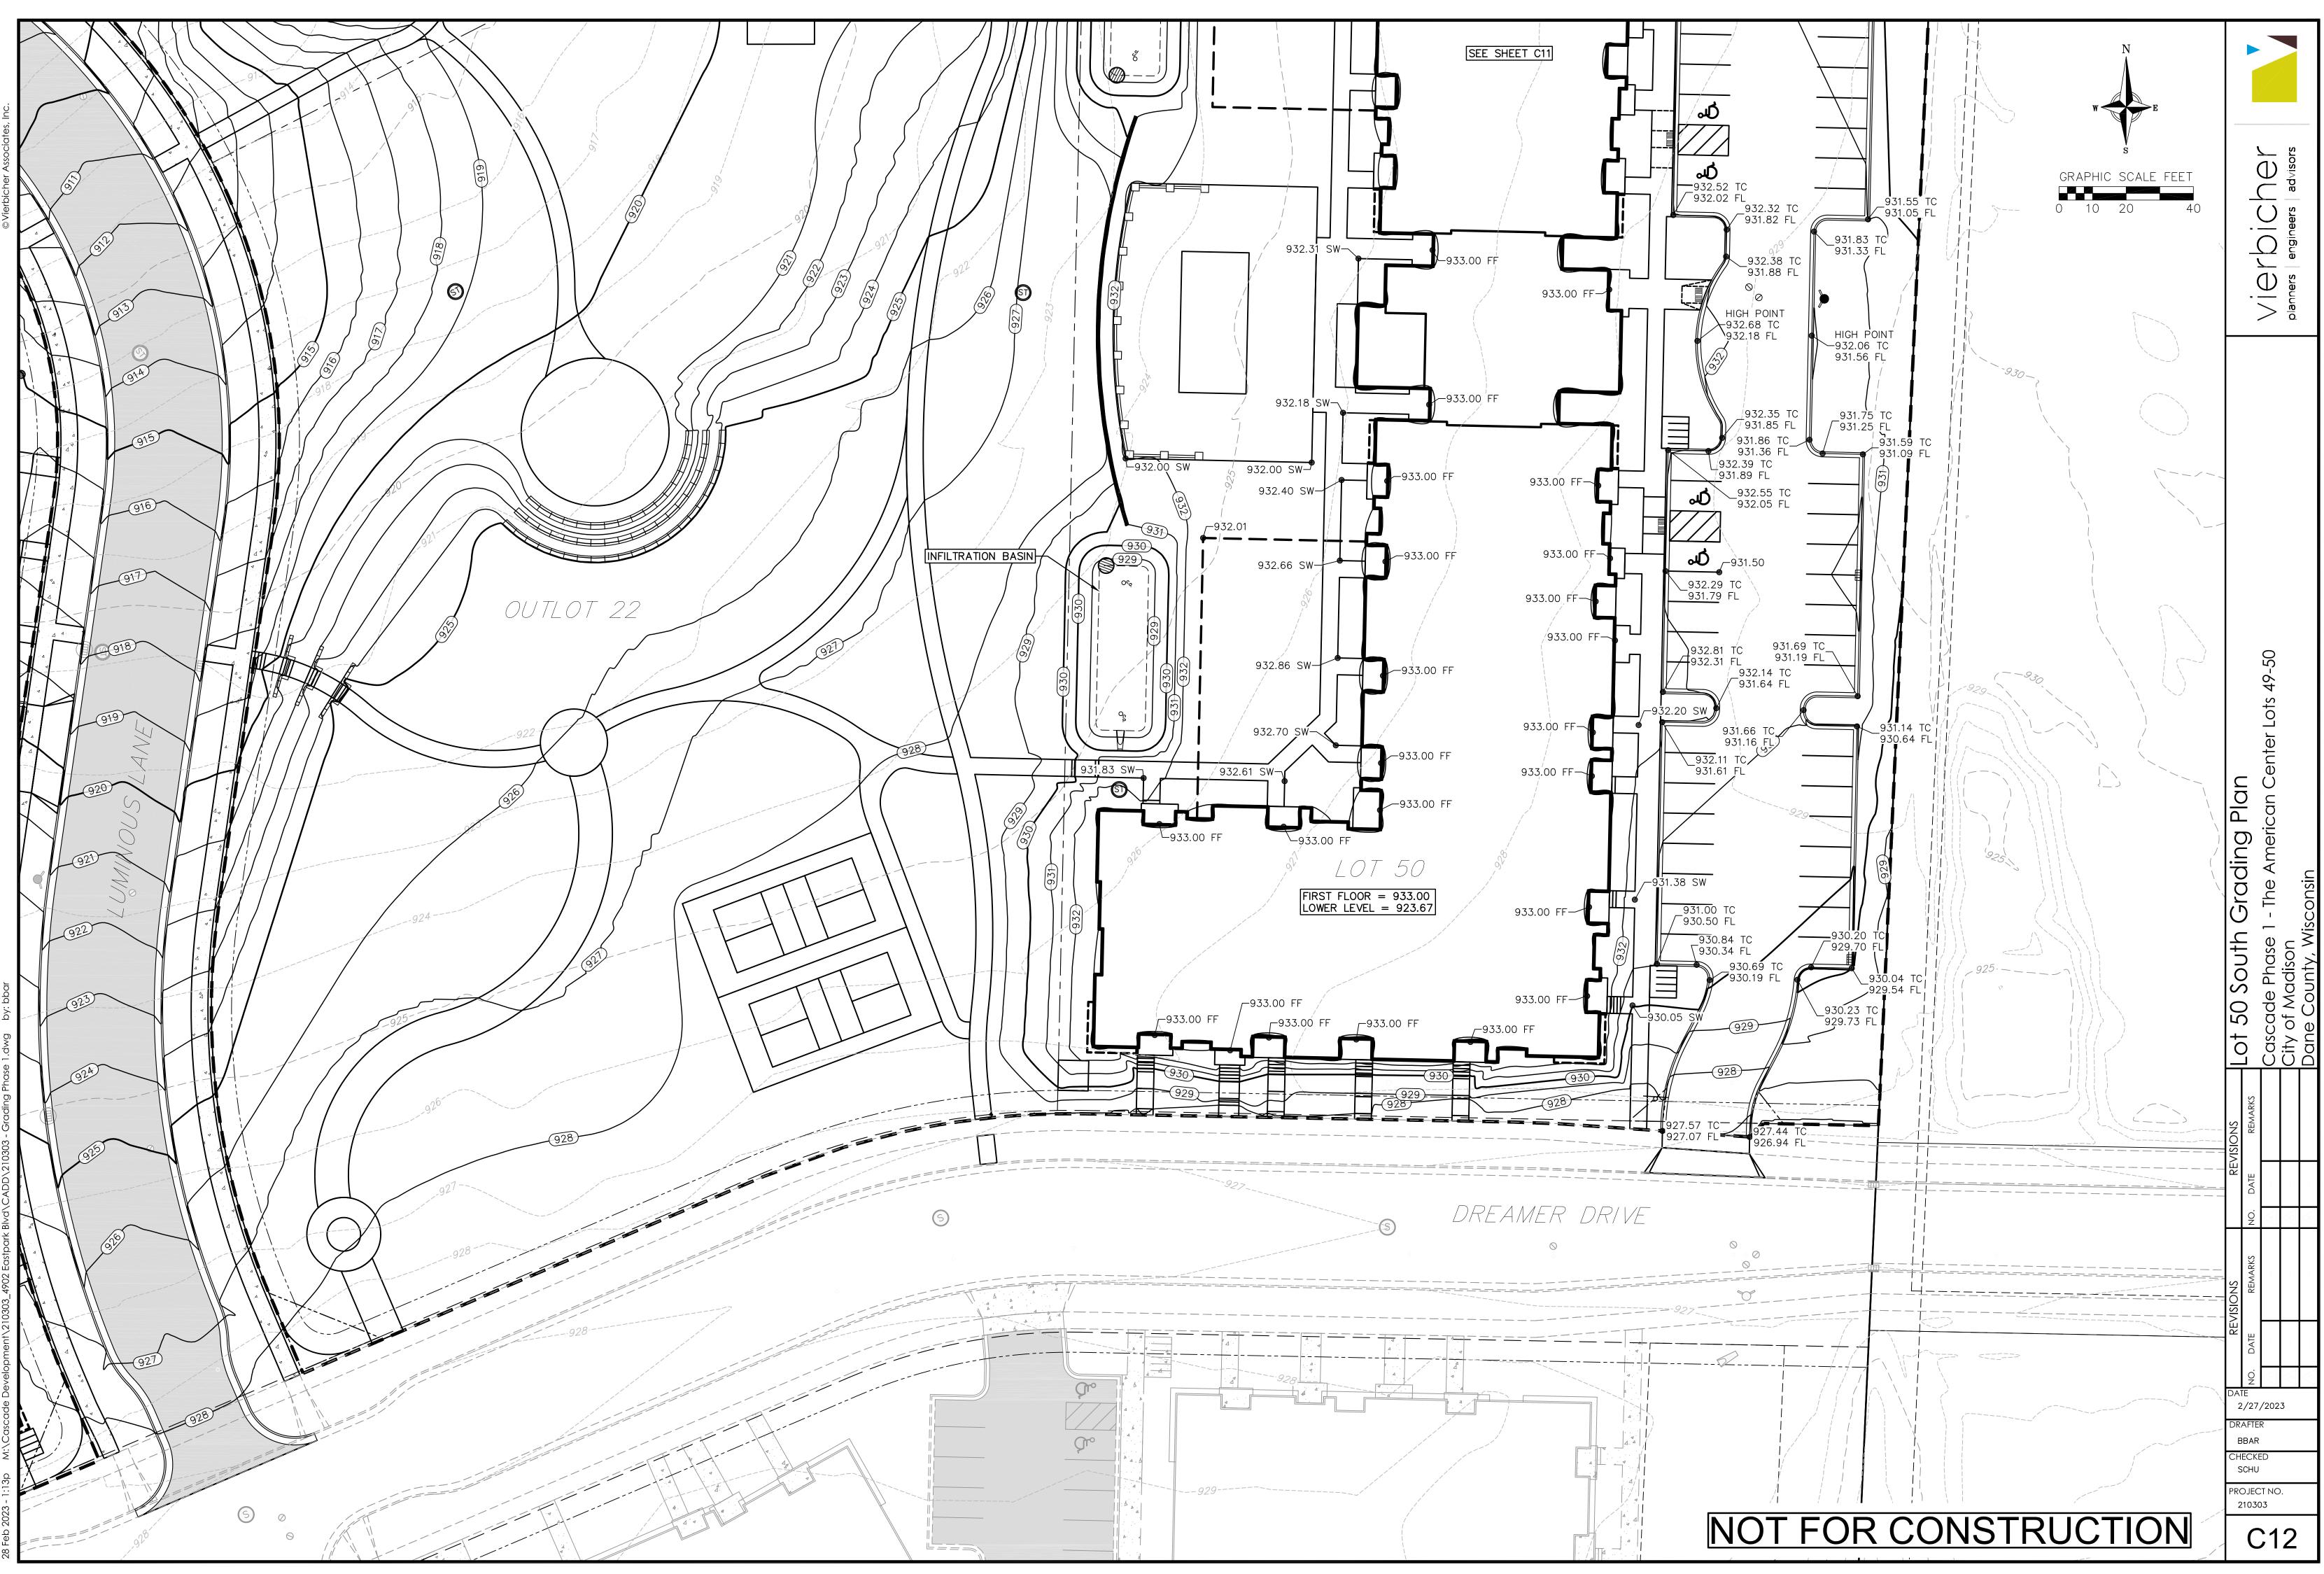

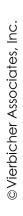

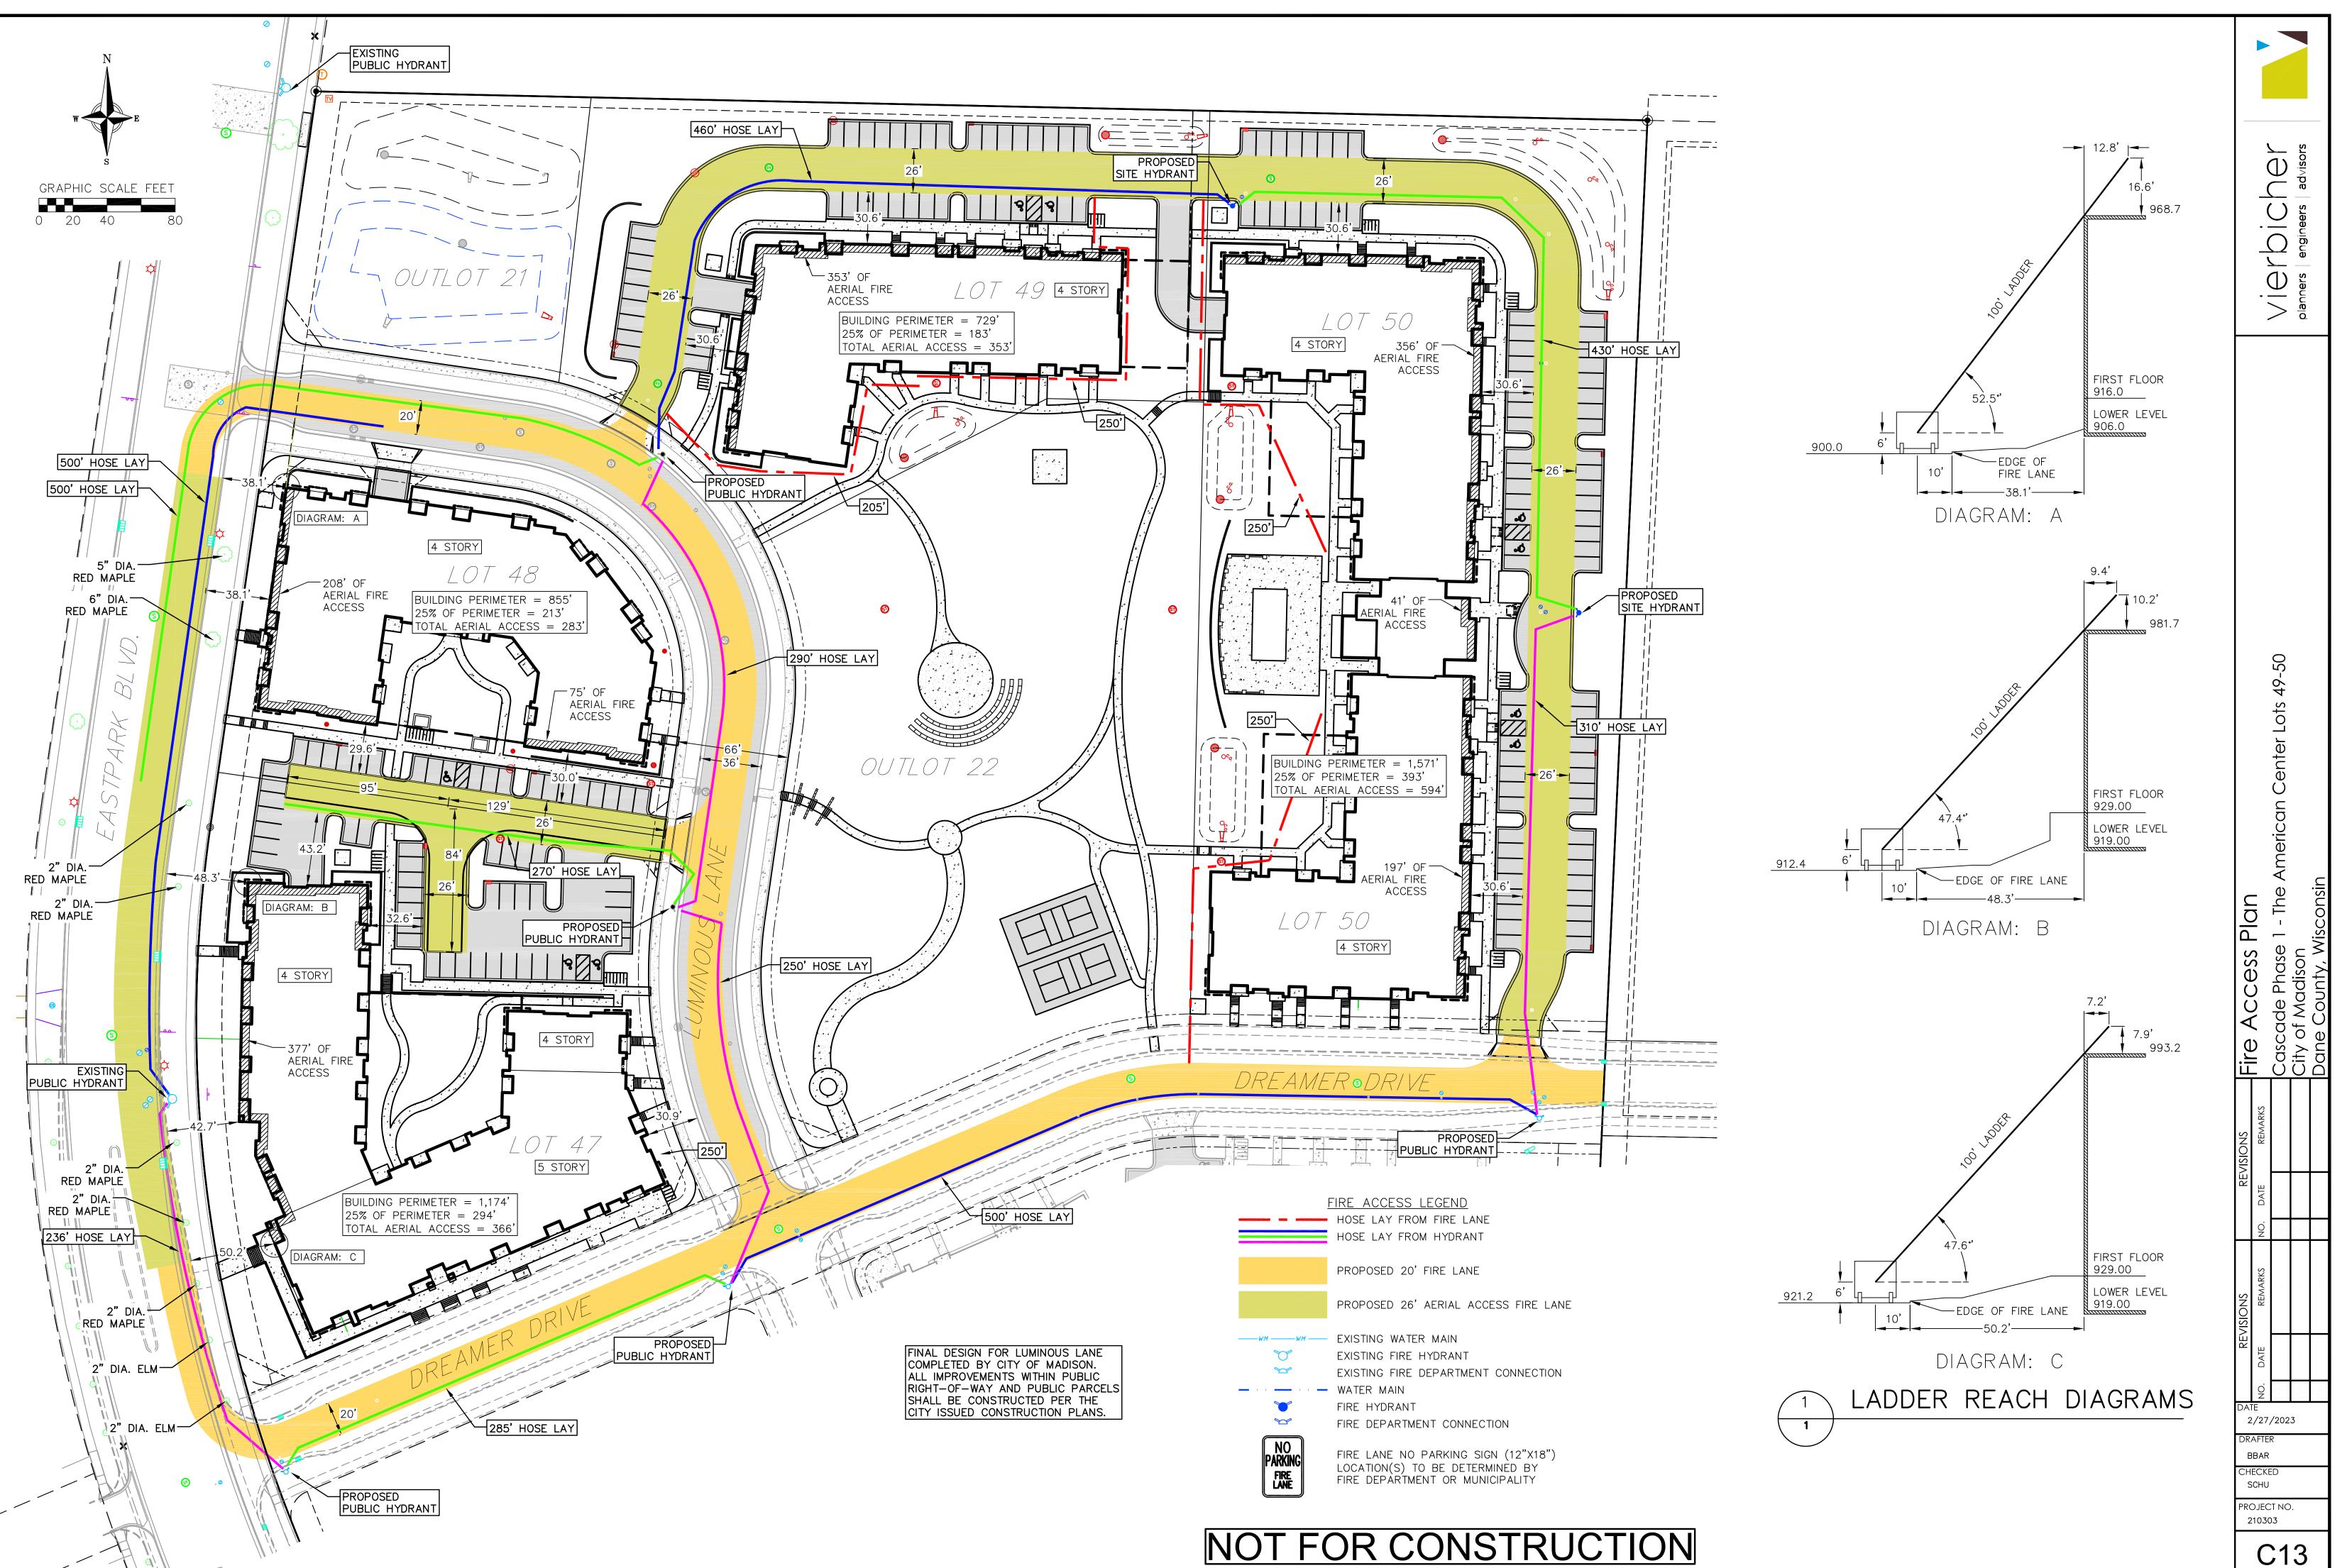

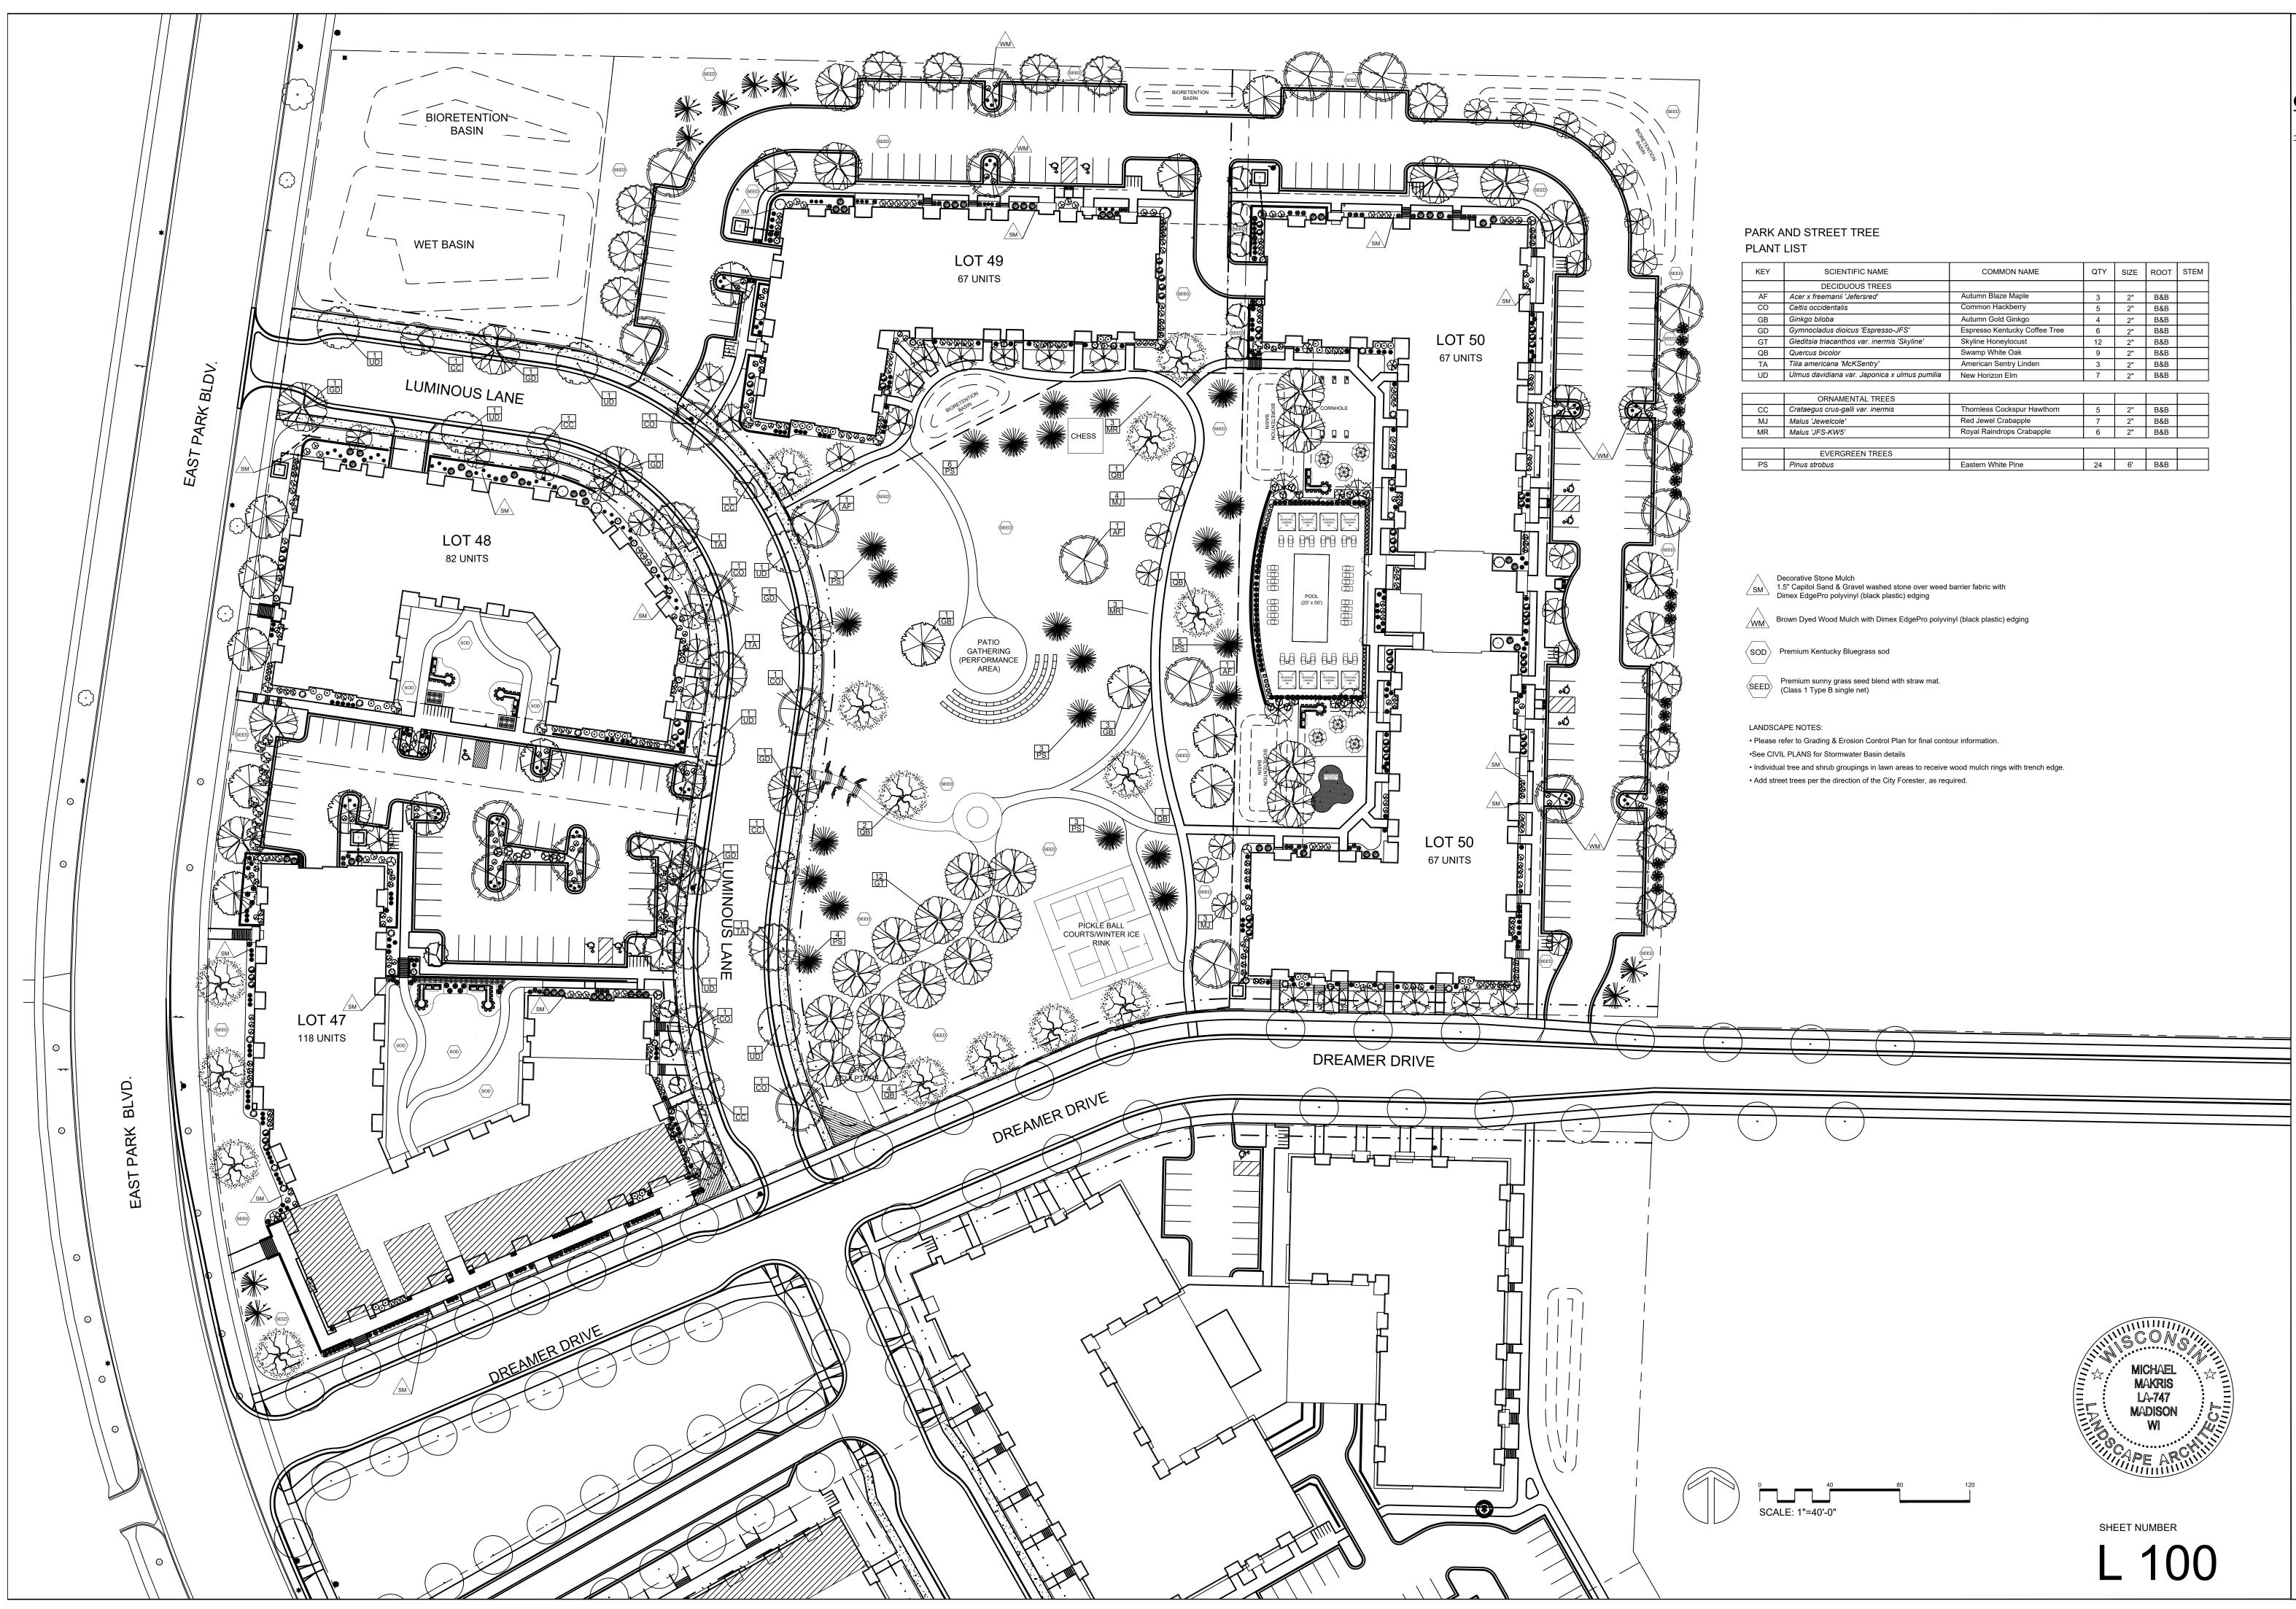



3570 Pioneer Road Verona, WI 53593 PH: (608) 827-9401 FAX: (608) 827-9402 WEB: www.olsontoon.com

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KEY	SCIENTIFIC NAME	COMMON NAME	QTY	SIZE	ROOT	STEM
	DECIDUOUS TREES					
AF	Acer x freemanii 'Jefersred'	Autumn Blaze Maple	3	2"	B&B	
CO	Celtis occidentalis	Common Hackberry	5	2"	B&B	
GB	Ginkgo biloba	Autumn Gold Ginkgo	4	2"	B&B	
GD	Gymnocladus dioicus 'Espresso-JFS'	Espresso Kentucky Coffee Tree	6	2"	B&B	
GT	Gleditsia triacanthos var. inermis 'Skyline'	Skyline Honeylocust	12	2"	B&B	
QB	Quercus bicolor	Swamp White Oak	9	2"	B&B	
TA	Tilia americana 'McKSentry'	American Sentry Linden	3	2"	B&B	
UD	Ulmus davidiana var. Japonica x ulmus pumilia	New Horizon Elm	7	2"	B&B	
	ORNAMENTAL TREES					
CC	Crataegus crus-galli var. inermis	Thornless Cockspur Hawthorn	5	2"	B&B	
MJ	Malus 'Jewelcole'	Red Jewel Crabapple	7	2"	B&B	
MR	Malus 'JFS-KW5'	Royal Raindrops Crabapple	6	2"	B&B	
	EVERGREEN TREES					
PS	Pinus strobus	Eastern White Pine	24	6'	B&B	

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Date: January 6, 2023 Scale: 1'-0"=40'-0" Designer: kms Job #

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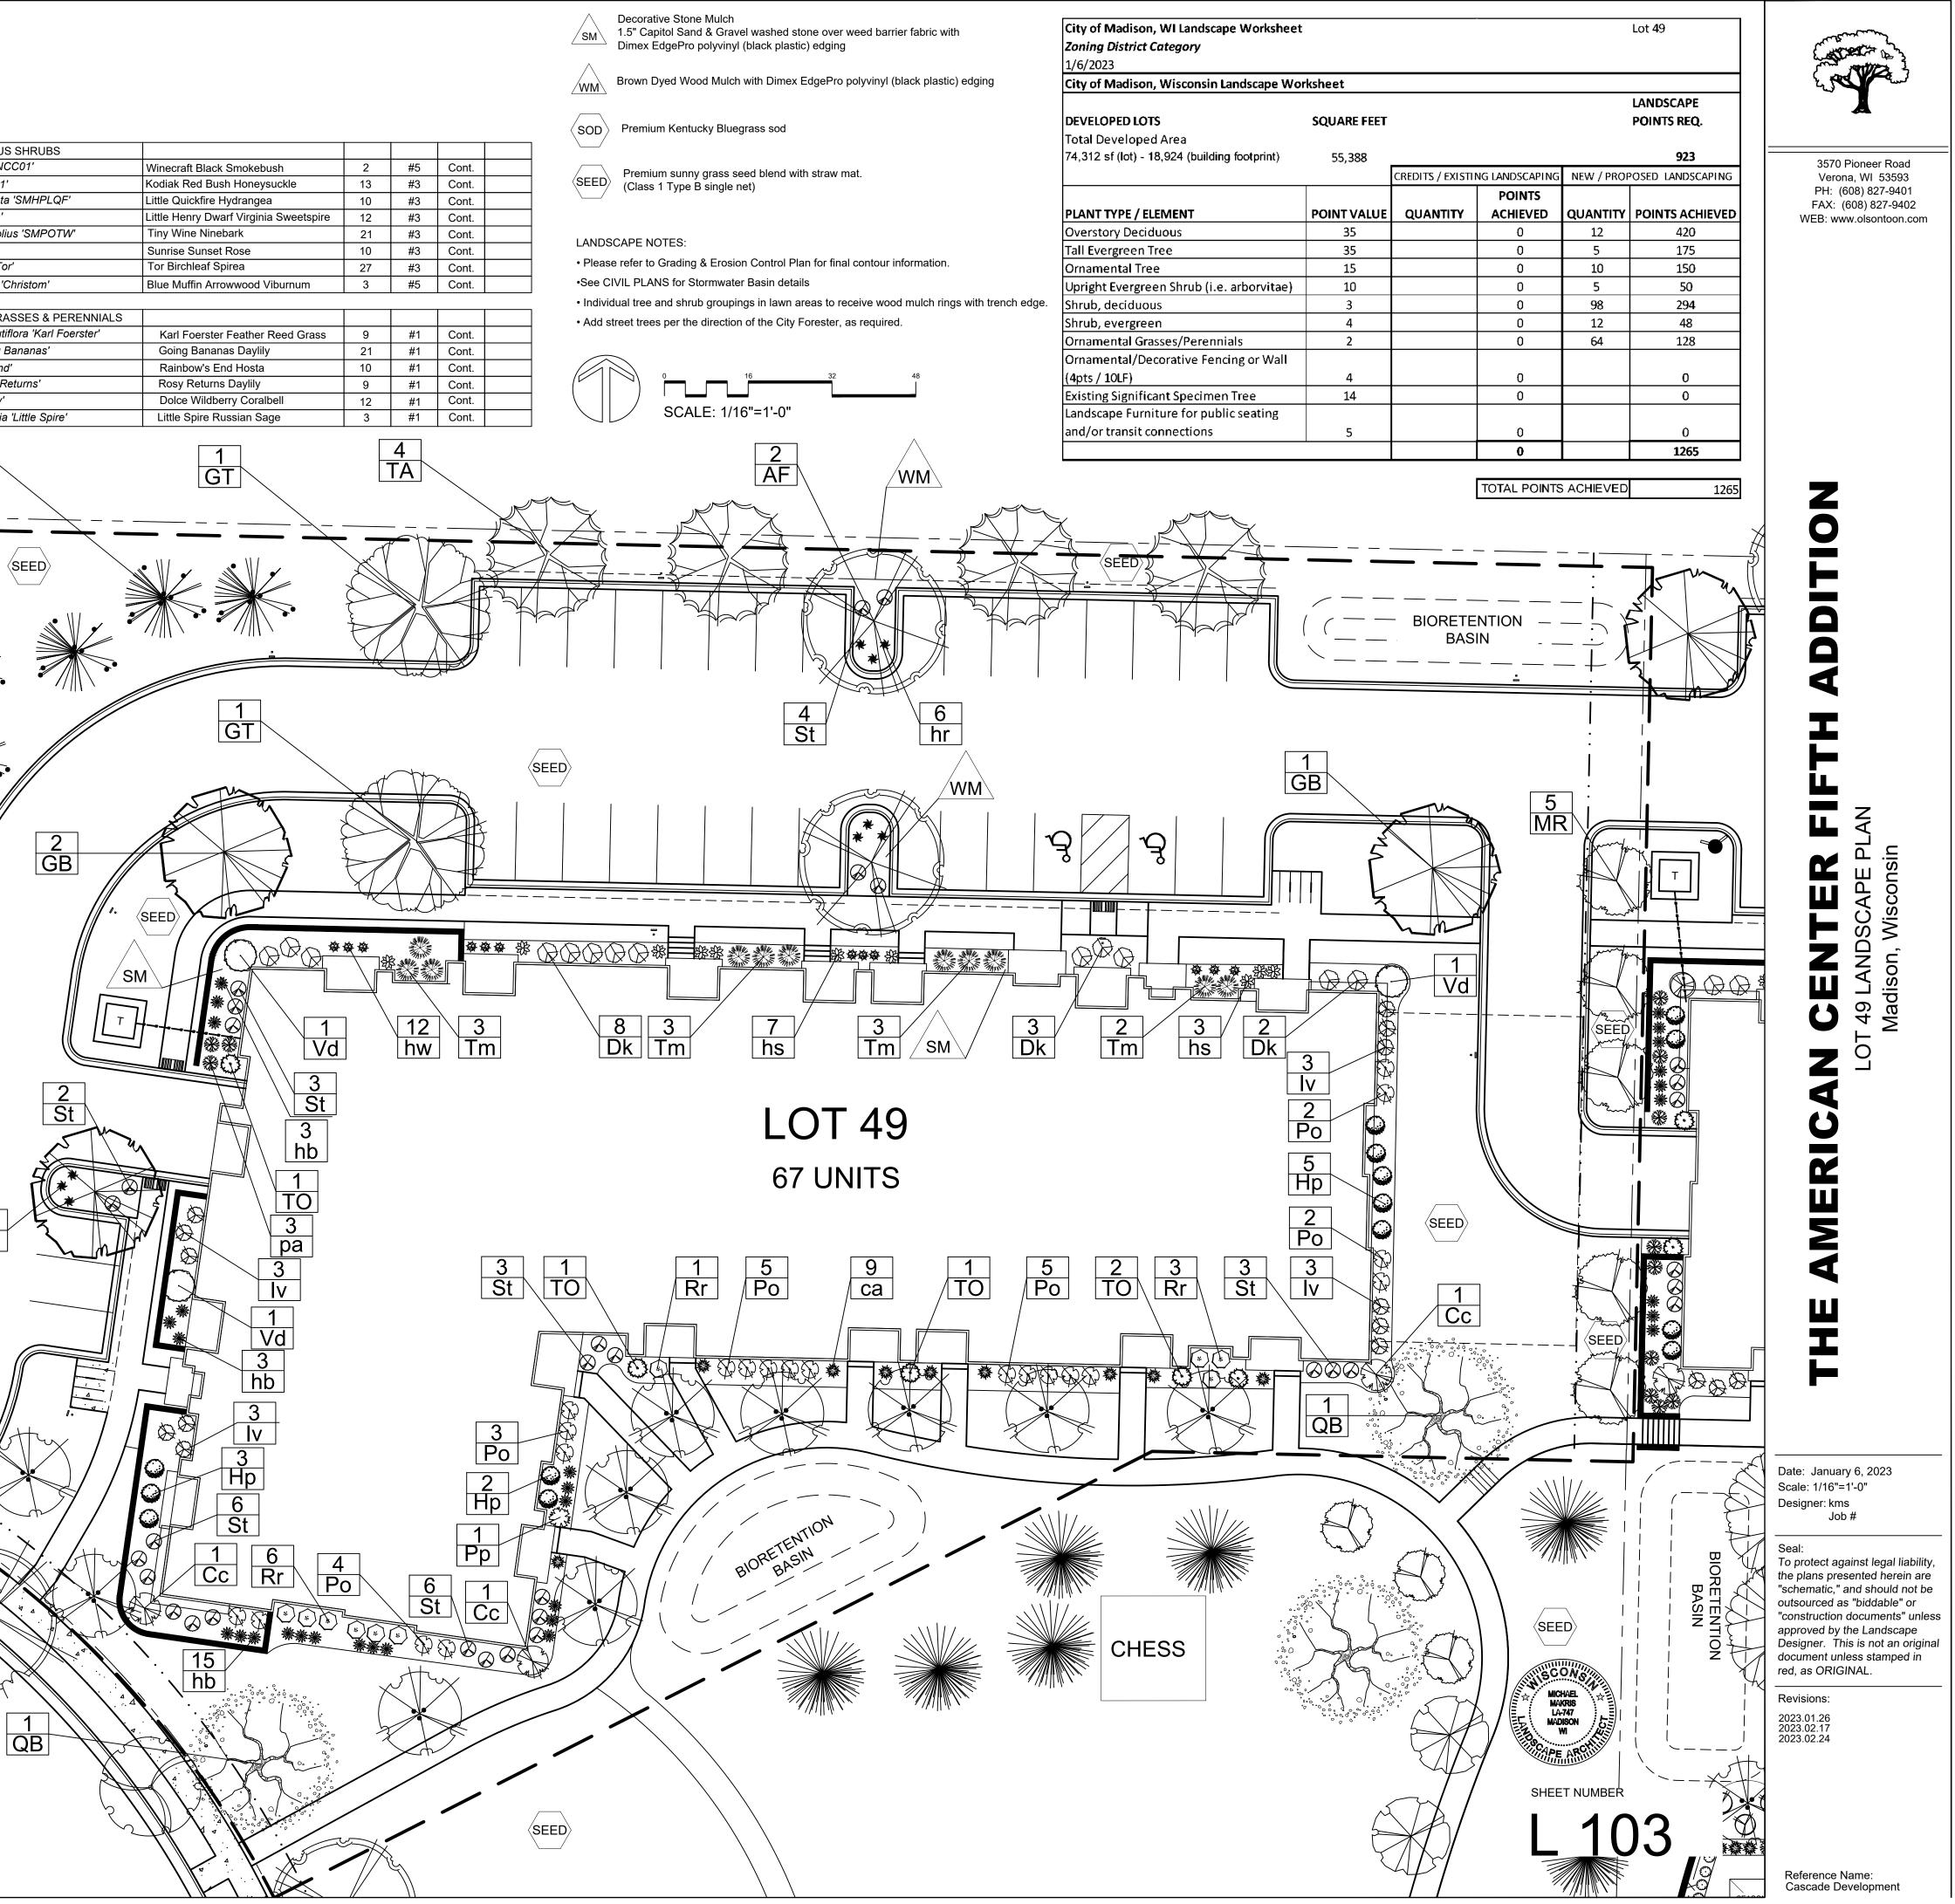
Seal: To protect against legal liability, the plans presented herein are "schematic," and should not be outsourced as "biddable" or "construction documents" unless approved by the Landscape Designer. This is not an original document unless stamped in red, as ORIGINAL.


Revisions: 2023.01.26 2023.02.17 2023.02.24

> Reference Name: Cascade Development

LOT 49 PLANT LIST QTY SIZE ROOT STEM KEY SCIENTIFIC NAME COMMON NAME DECIDUOUS TREES AF Acer x freemanii 'Jefersred' Autumn Blaze Maple 4 | 2" | B&B DECIDUOUS SHRUBS GB Ginkgo biloba Autumn Gold Ginkgo 3 2" B&B Cc Cotinus coggygria 'NCC01' GT Gleditsia triacanthos var. inermis 'Skyline' Skyline Honeylocust 2 2" B&B Dk Diervilla 'G2X885411' QB Quercus bicolor Swamp White Oak 2 2" B&B Hp Hydrangea paniculata 'SMHPLQF' TA Tilia americana 'McKSentry' American Sentry Linden 7 | 2" | B&B Itea virginica 'Sprich' lv Po Physocarpus opulifolius 'SMPOTW' ORNAMENTAL TREES Rr Rosa 'BAlset' St Spiraea betulifolia 'Tor' SR Syringa reticulata 'Ivory Silk' Ivory Silk Japanese Tree Lilac 10 2" B&B Vd Viburnum dentatum 'Christom' **ORNAMENTAL GRASSES & PERENNIALS** EVERGREEN TREES ca Calamagrostis x acutiflora 'Karl Foerster' Black Hills Spruce PG Picea glauca var. densata 5 6' B&B Thuja occidentalis 'Emerald Green' hb Hemerocallis 'Going Bananas' то Emerald Green Arborvitae 5 6' B&B hs Hosta 'Rainbow's End' hr Hemerocallis 'Rosy Returns' EVERGREEN SHRUBS hw Heuchera 'Wildberry' Pp Picea pungens 'Globosa' Dwarf Globe Blue Spruce 1 | #5 | Cont. pa Perovskia atriplicifolia 'Little Spire' Tm *Taxus x media 'Tautonii'* 11 #5 Cont. Taunton Yew 5 PG SEED BIORETENTION $\langle \text{SEED} \rangle$ WET BASIN 3 hr ΤĂ AF 10 SR LUMINOUS LANE

SM



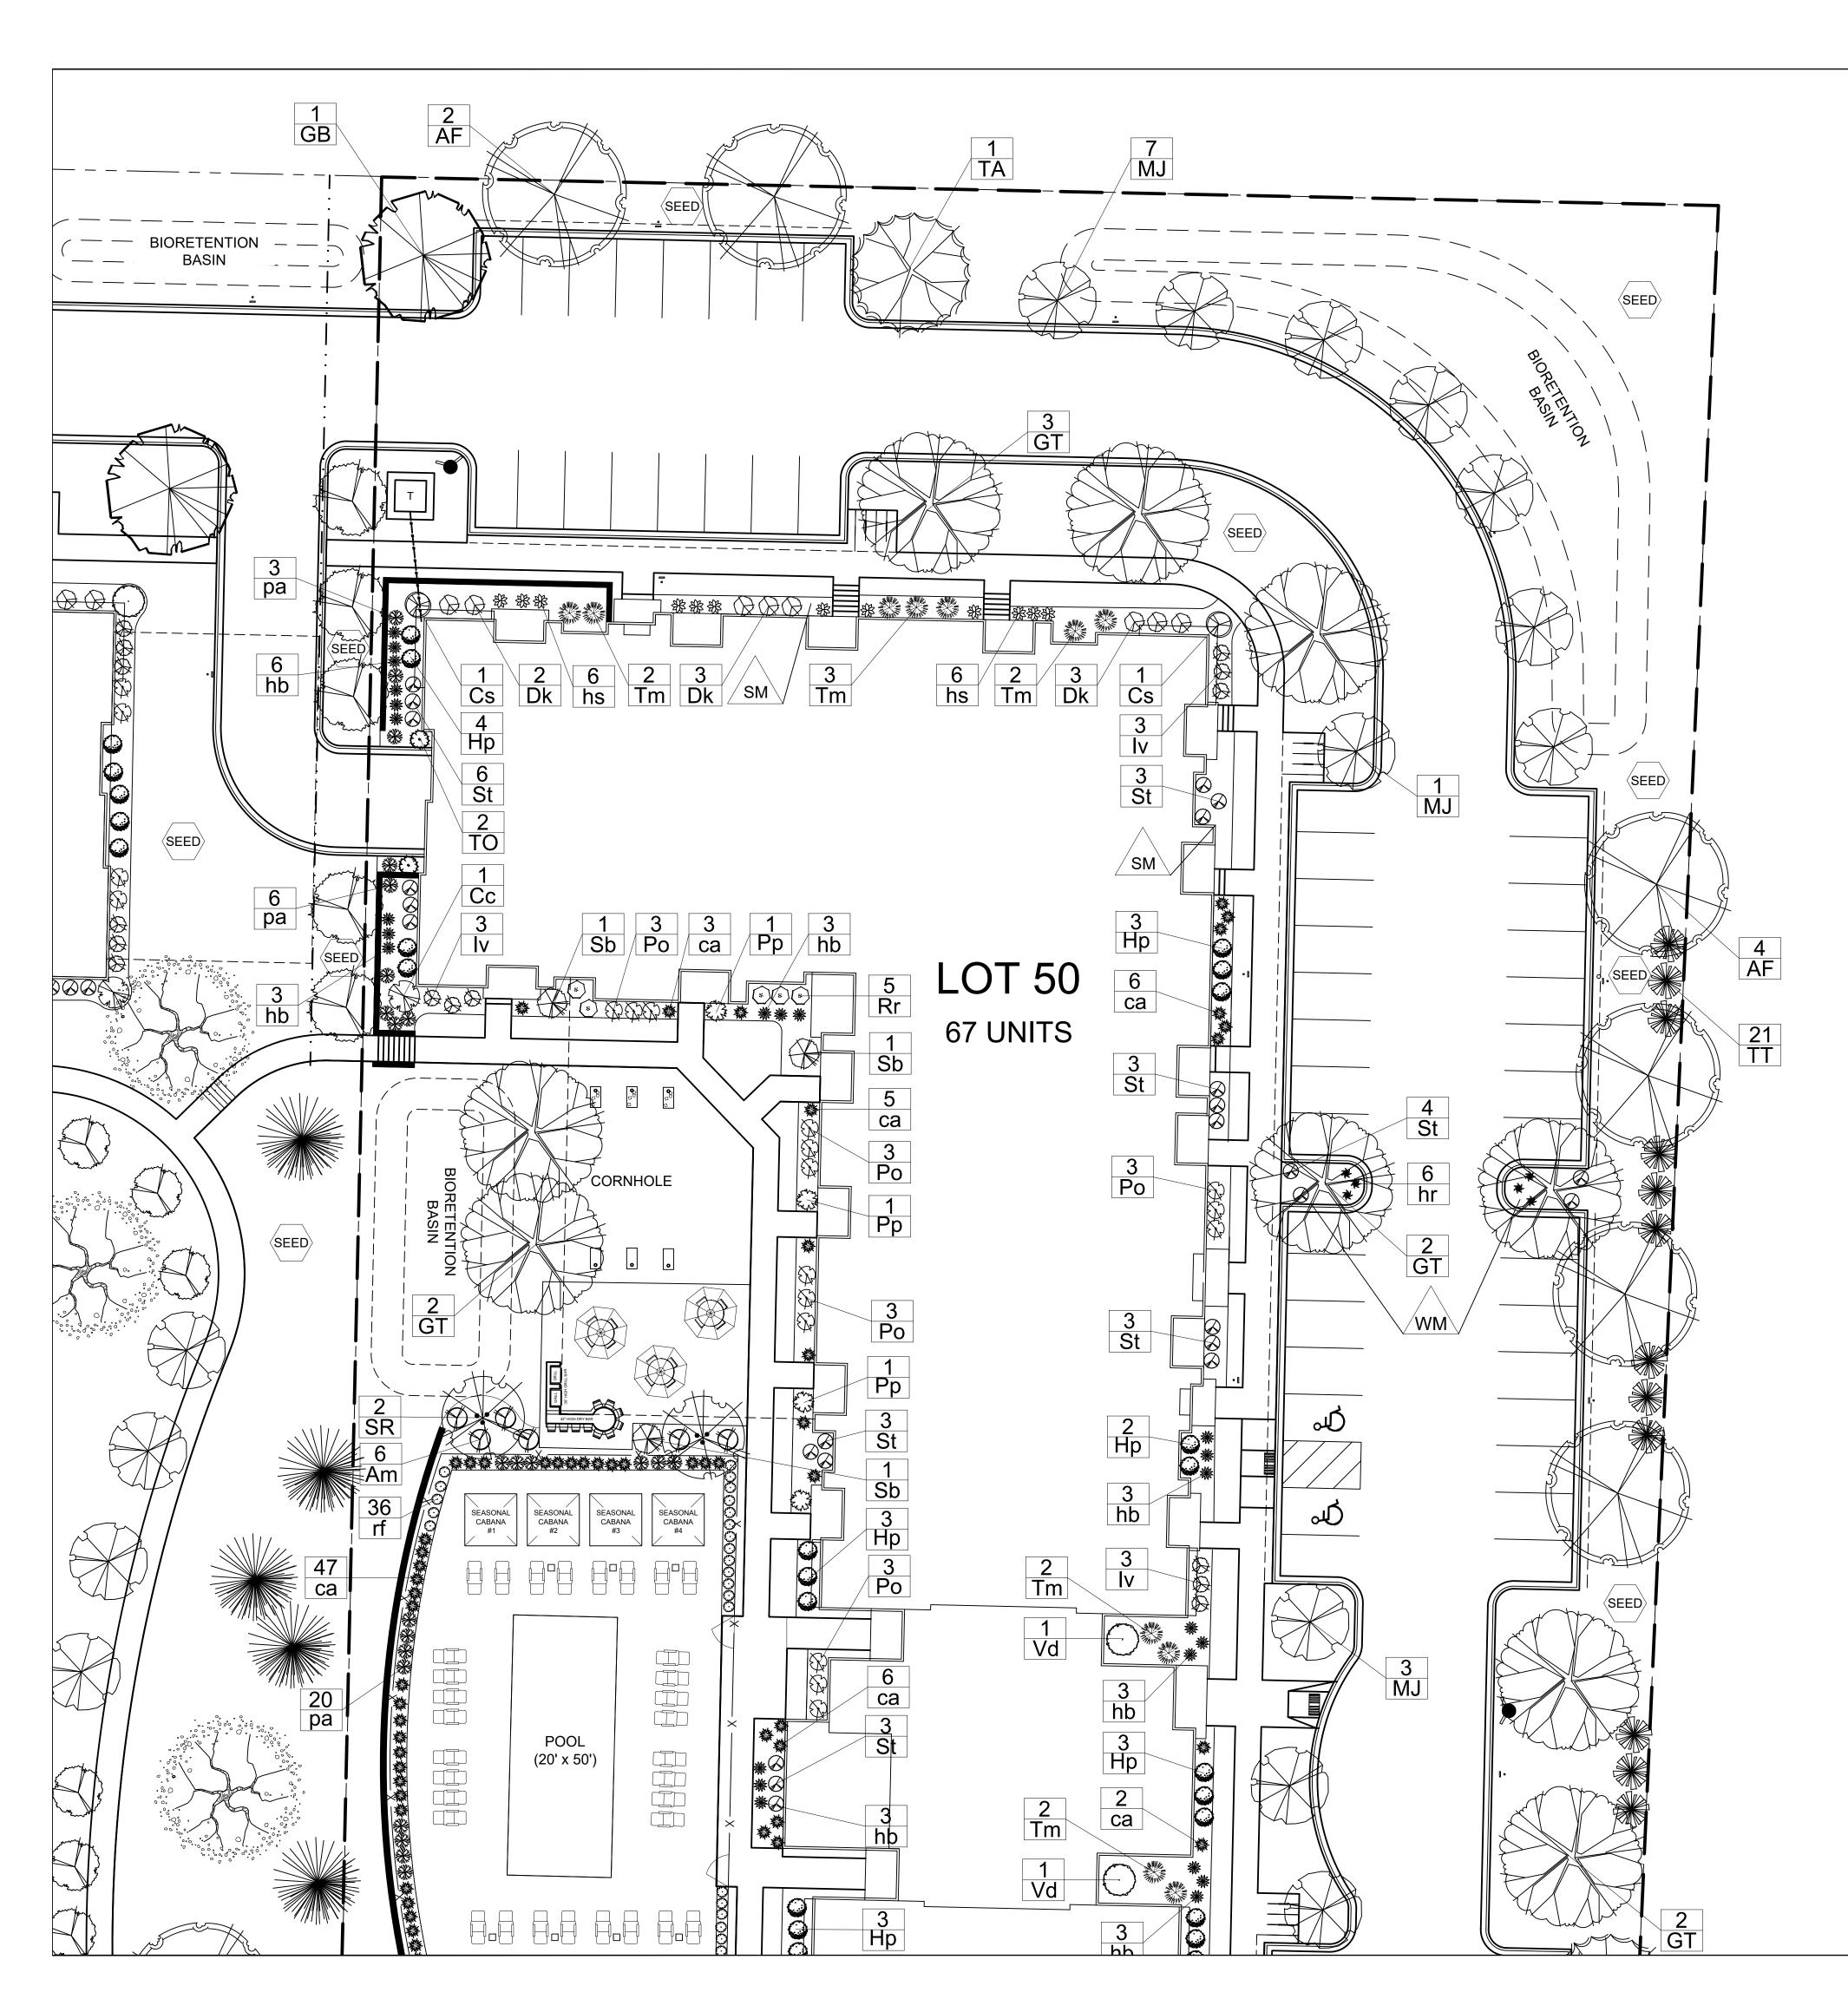

City of Madison, WI Landscape Worksh Zoning District Category 1/6/2023 City of Madison, Wisconsin Landscape DEVELOPED LOTS Total Developed Area 134,789 sf (lot) - 40,694 (building footprin PLANT TYPE / ELEMENT **Overstory Deciduous** Tall Evergreen Tree Ornamental Tree Upright Evergreen Shrub (i.e. arborvita Shrub, deciduous Shrub, evergreen Ornamental Grasses/Perennials Ornamental/Decorative Fencing or Wa (4pts / 10LF) Existing Significant Specimen Tree Landscape Furniture for public seating and/or transit connections


LOT 50 PLANT LIST

KEY	SCIENTIFIC NAME	COMMON NAME	QTY	SIZE	ROOT	STEN
	DECIDUOUS TREES					
AF	Acer x freemanii 'Jefersred'	Autumn Blaze Maple	8	2"	B&B	
GB	Ginkgo biloba	Autumn Gold Ginkgo	1	2"	B&B	
GT	Gleditsia triacanthos var. inermis 'Skyline'	Skyline Honeylocust	11	2"	B&B	
TA	Tilia americana 'McKSentry'	American Sentry Linden	5	2"	B&B	
		· ·				
	ORNAMENTAL TREES					
MJ	Malus 'Jewelcole'	Red Jewel Crabapple	12	2"	B&B	
SR	Syringa reticulata 'Ivory Silk'	Ivory Silk Japanese Tree Lilac	10	2"	B&B	
			1			
	EVERGREEN TREES					
PG	Picea glauca var. densata	Black Hills Spruce	2	6'	B&B	
то	Thuja occidentalis 'Smaragd'	Emerald Green Arborvitae	3	6'	B&B	
TT	Thuja occidentalis 'Techny'	Techny Arborvitae	21	6'	B&B	
			1		I	1
	EVERGREEN SHRUBS					
Рр	Picea pungens 'Globosa'	Dwarf Globe Blue Spruce	7	#5	Cont.	
Tm	Taxus x media 'Tautonii'	Taunton Yew	16	#5	Cont.	
	DECIDUOUS SHRUBS					
Am	Aronia melanocarpa 'Morton'	Iroquois Beauty Chokeberry	12	#3	Cont.	
Сс	Cotinus coggygria 'NCC01'	Winecraft Black Smokebush	1	#5	Cont.	
Cs	Cornus alba 'Bailhalo'	Ivory Halo Red Twig Dogwood	2	#5	Cont.	
Dk	Diervilla 'G2X885411'	Kodiak Red Bush Honeysuckle	11	#3	Cont.	
Нр	Hydrangea paniculata 'SMHPLQF'	Little Quickfire Hydrangea	30	#3	Cont.	
lv	Itea virginica 'Sprich'	Little Henry Dwarf Virginia Sweetspire	25	#3	Cont.	
Pa	Physocarpus opulifolius 'Jefam'	Amber Jubilee Ninebark	1	#3	Cont.	
Po	Physocarpus opulifolius 'SMPOTW'	Tiny Wine Ninebark	29	#3	Cont.	
Rr	Rosa 'BAlset'	Sunrise Sunset Rose	14	#3	Cont.	
Sb	Syringa 'SMSJBP7'	Bloomerang Dark Purple Lilac	5	#5	Cont.	
St	Spiraea betulifolia 'Tor'	Tor Birchleaf Spirea	50	#3	Cont.	
Vd	Viburnum dentatum 'Christom'	Blue Muffin Arrowwood Viburnum	2	#5	Cont.	
	ORNAMENTAL GRASSES & PERENNIALS		07	#4	Cant	
ca	Calamagrostis x acutiflora 'Karl Foerster' Hemerocallis 'Going Bananas'	Karl Foerster Feather Reed Grass	97	#1	Cont.	
hb	Hosta 'Rainbow's End'	Going Bananas Daylily Rainbow's End Hosta	35 20	#1	Cont.	
hs	Hemerocallis 'Rosy Returns'	Rainbow's End Hosta Rosy Returns Daylily	12	#1 #1	Cont. Cont.	
hr	Perovskia atriplicifolia 'Little Spire'	Little Spire Russian Sage	29	#1	Cont.	
pa rf	Rudbeckia x 'American Gold Rush'	Am. Gold Rush Black-eyed Susan	36	#1	Cont.	
	Rudbeckia X American Gold Rush	Ani. Oolu Rush Diack-eyeu Susan	30	# I	UUIII.	

WM	Brown Dyed Wood Mulch with Di
	Premium Kentucky Bluegrass so
SEED	Premium sunny grass seed bler (Class 1 Type B single net)

LANDSCAPE NOTES:

• Please refer to Grading & Erosion Control Plan for final contour information. •See CIVIL PLANS for Stormwater Basin details • Individual tree and shrub groupings in lawn areas to receive wood mulch rings with trench edge. • Add street trees per the direction of the City Forester, as required.

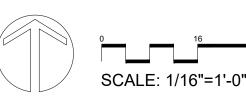

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sheet			Lot 50				
e Worksheet							
				LANDSCAPE			
SQUARE FEET				POINTS REQ.			
94,095			1568				
	CREDITS / EXISTIN	EXISTING LANDSCAPING NEW / PROPOSED LANI		OSED LANDSCAPING			
		POINTS					
POINT VALUE	QUANTITY	ACHIEVED	QUANTITY	POINTS ACHIEVED			
35		0	25	875			
35		0	2	70			
15		0	22	330			
10		0	24	240			
3		0	182	546			
4		0	23	92			
2		0	229	458			
4		0		0			
14		0		0			
5		0		0			
		0		2611			
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TOTAL POINTS ACHIEVED

2611

sod

end with straw mat.



SHEET NUMBER



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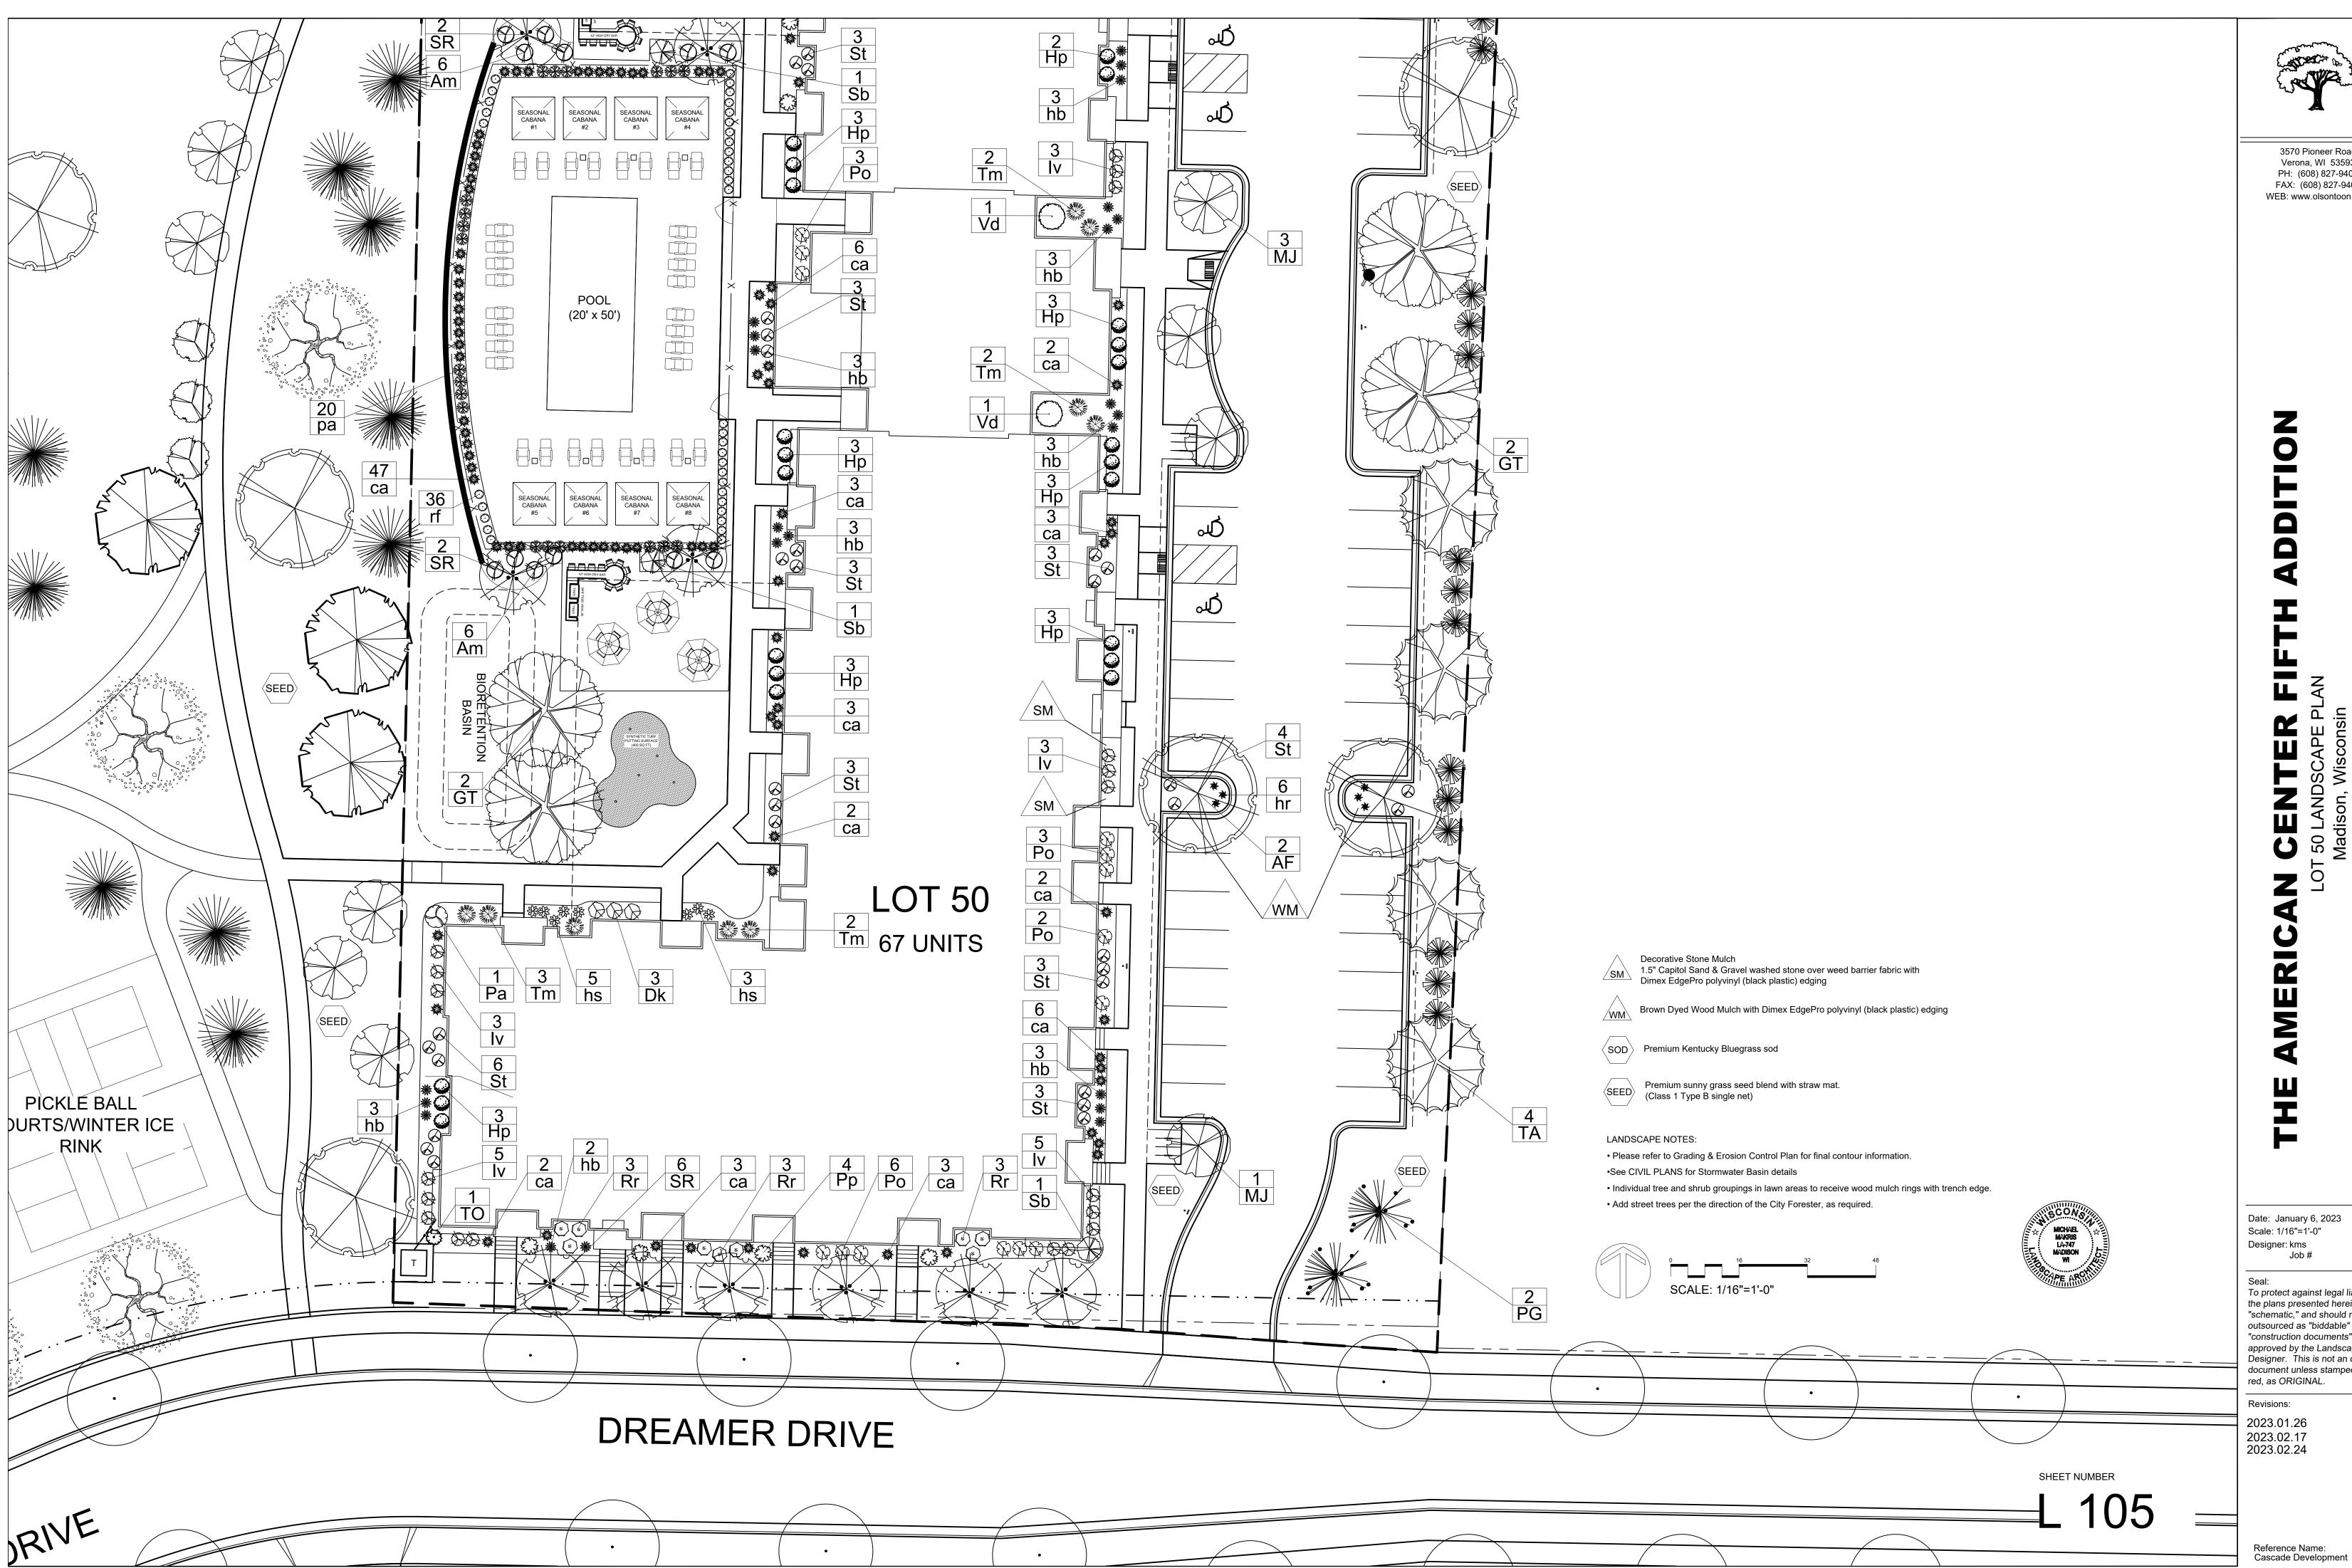
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Date: January 6, 2023 Scale: 1/16"=1'-0" Designer: kms Job #

Seal:

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Revisions: 2023.01.26 2023.02.17 2023.02.24



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Seal: To protect against legal liability, the plans presented herein are "schematic," and should not be

Designer: kms Job #


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ADDITION



		and the second s
NAME	COMMON NAME	QTY
TREES		
ed'	Autumn Blaze Maple	4
	Autumn Gold Ginkgo	4
inermis 'Skyline'	Skyline Honeylocust	12
	Swamp White Oak	9
		•
TREES		
	Red Jewel Crabapple	7
	Royal Raindrops Crabapple	6
TREES		
	Eastern White Pine	24

STREET -OLSON 👗 TOON LANDSCAPING 2 3570 Pioneer Road

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Date: January 6, 2023 Scale: 1/16"=1'-0" Designer: kms Job #

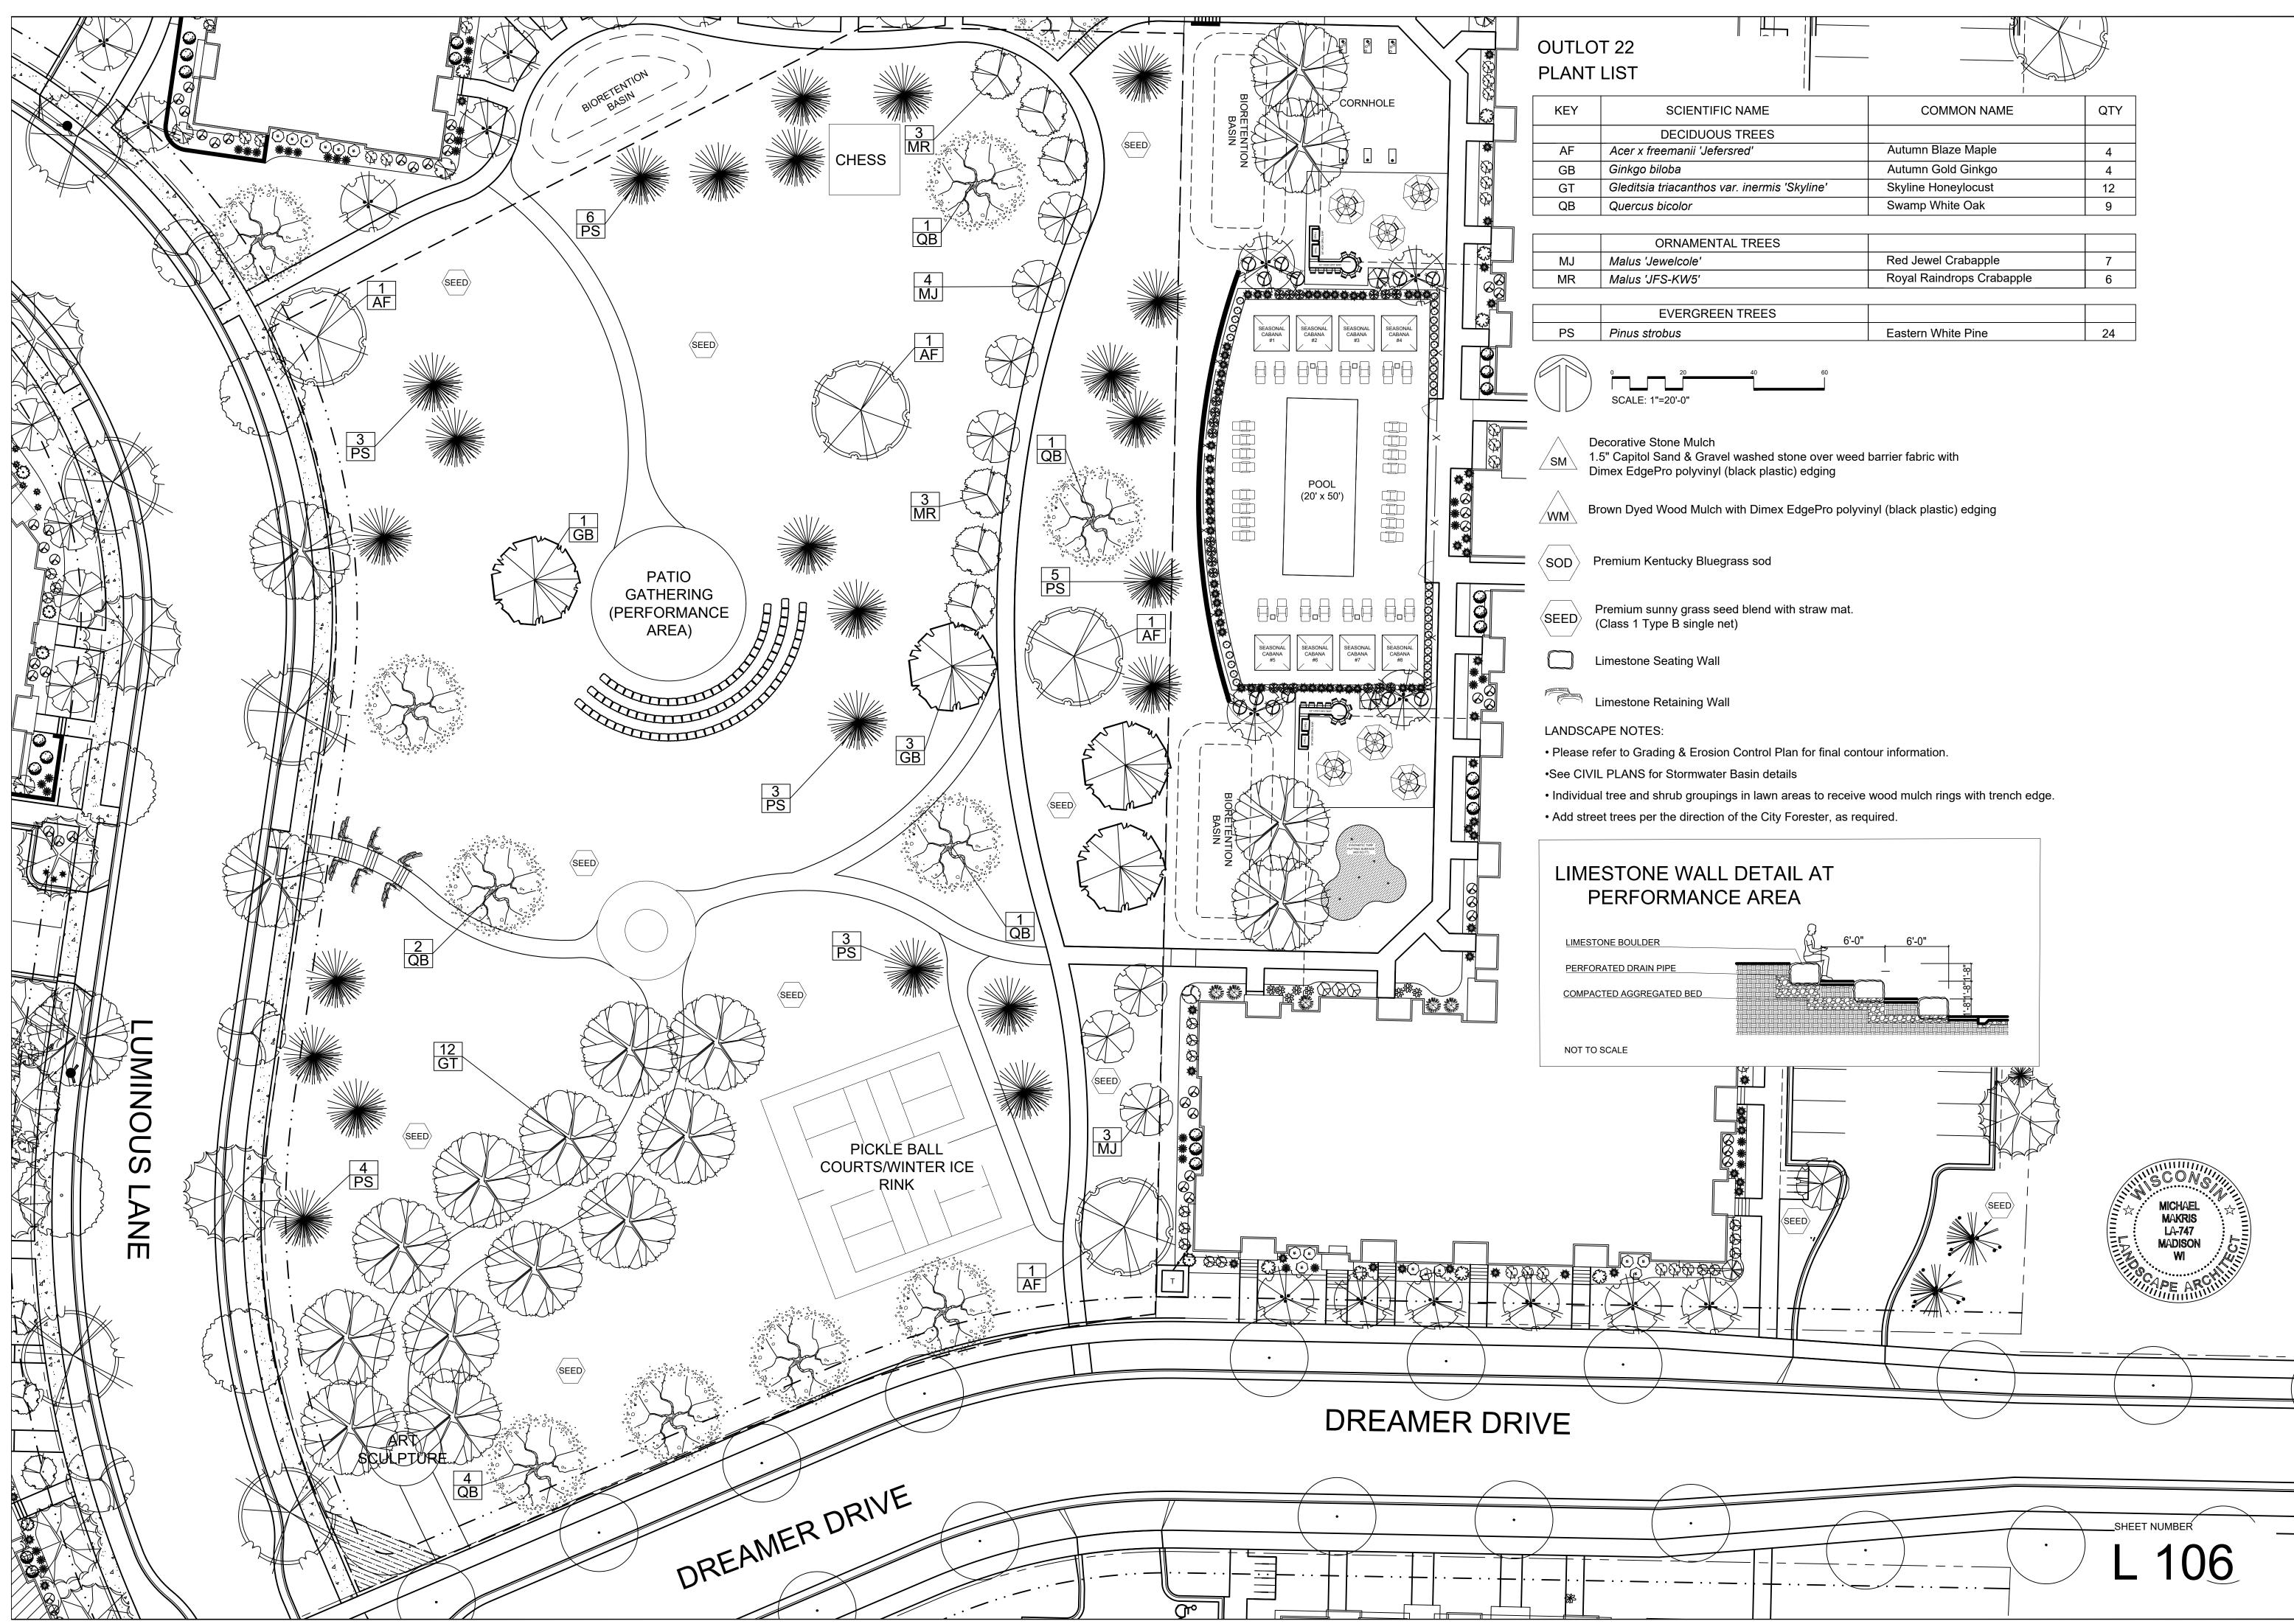
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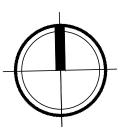
Revisions: 2023.01.26 2023.02.17 2023.02.24


2023.03.01

Reference Name: Cascade Development





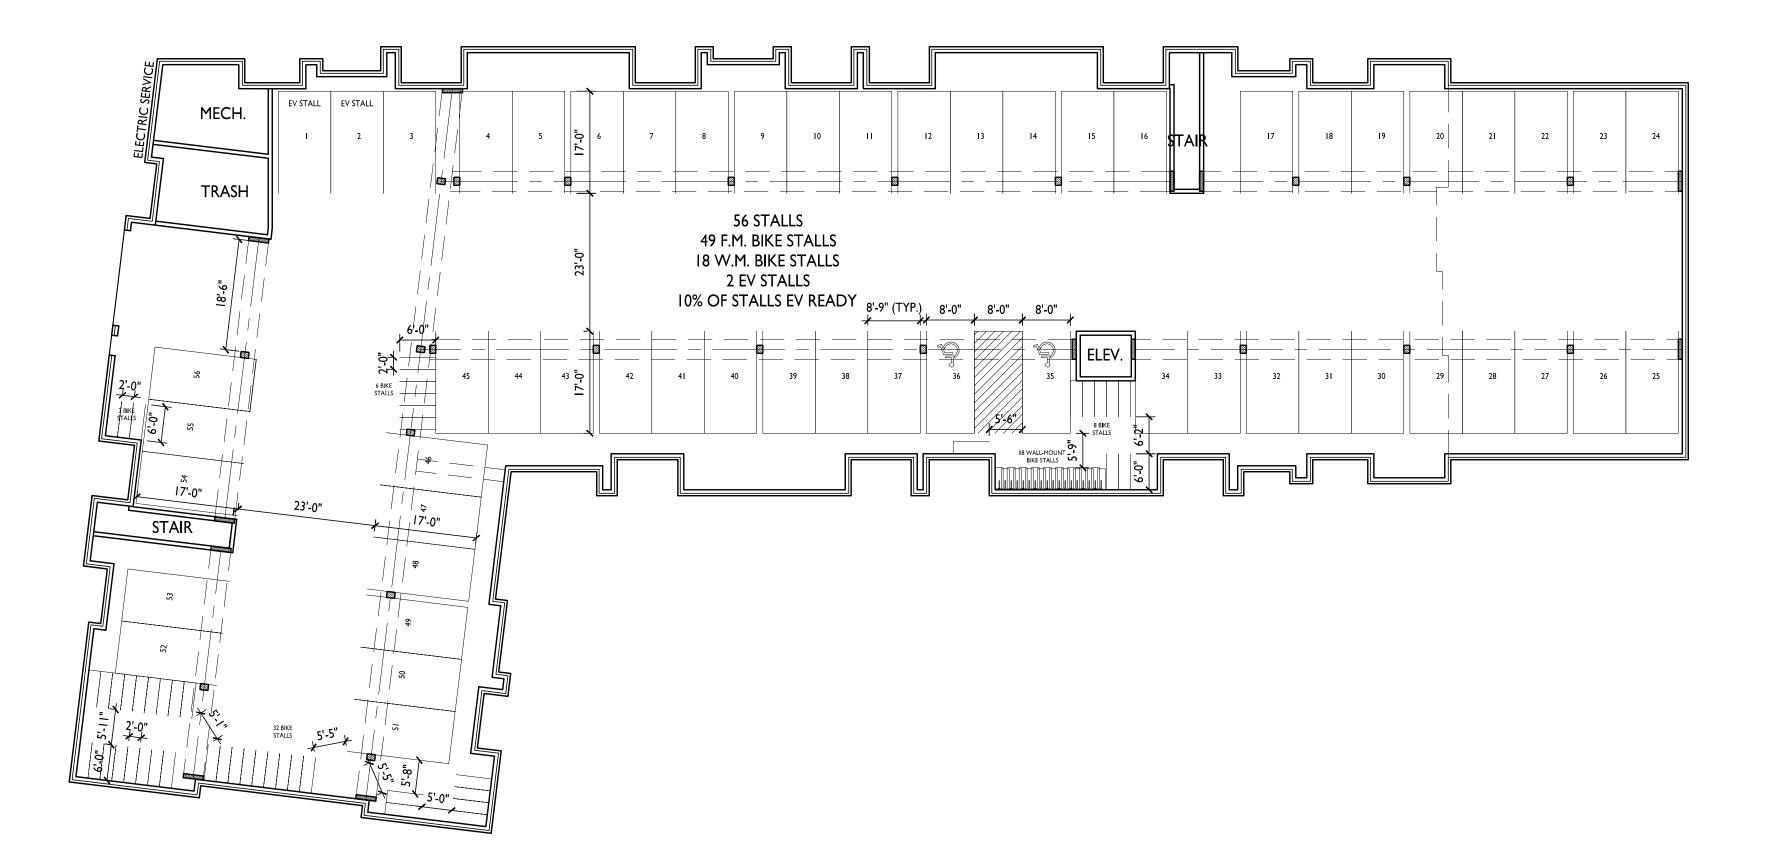

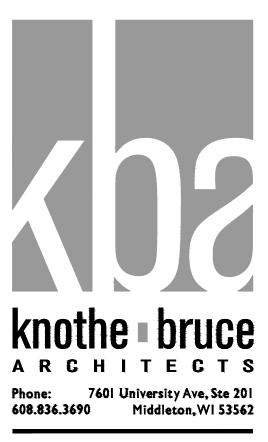

PROJECT TITLE CASCADE -THE AMERICAN CENTER EASTPARK FIFTH ADDITION

4846 Eastpark Blvd. Madison, WI SHEET TITLE Basement Plan


Lot 49

SHEET NUMBER


A-1.0





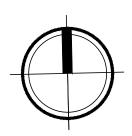

]
ONE BED 815 S.F.	ONE BED 815 S.F.	ONE BED 815 S.F.	ONE BED 815 S.F.	MAIL/PARCEL LOBBY	STAIR	TWO BED 1148 S.F.	
R./MECH.	TWO BED 1148 S.F.	ONE BED 815 S.F.	STUDIO 586 S.F.	ST	FUDIO 665 S.F.	TWO BED 1162 S.F.	
O BED B6 S.F.							

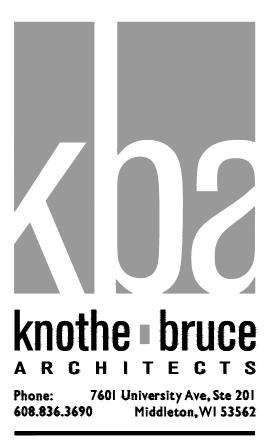


PROJECT TITLE CASCADE -THE AMERICAN CENTER EASTPARK FIFTH ADDITION

4846 Eastpark Blvd. Madison, WI SHEET TITLE First Floor Plan


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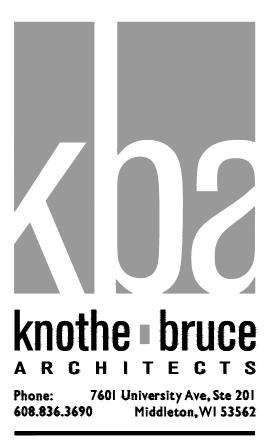
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ONE BED 815 S.F.	ONE BED 815 S.F.	ONI 81.	E BED 5 S.F.	ONE I 815 S	BED .f.	ONE 815	BED S.F.	STAIR	Т	WO BED 1204 S.F.	ļ
OR./MECH.	TWO BFD		ONE BE	D	ONE BE	D	ST	UDIO		TWO BFD	
	TWO BED 1148 S.F.		815 S.F.		815 S.F.		6	65 S.F.		TWO BED 1162 S.F.	
			[[
BED											




ISSUED Issued for LUA & UDC Submittals - February 27, 2023

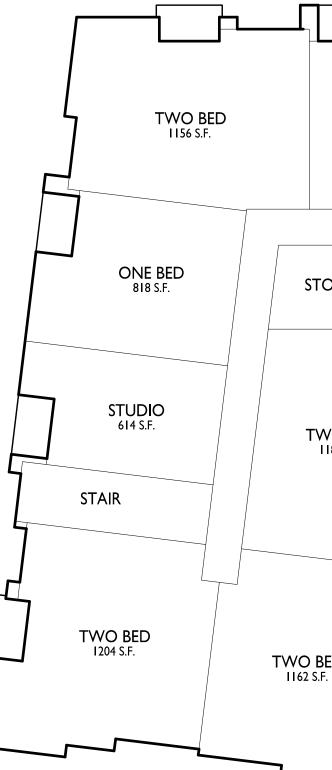PROJECT TITLE CASCADE -THE AMERICAN CENTER EASTPARK FIFTH ADDITION


4846 Eastpark Blvd. Madison, WI SHEET TITLE Second Floor Plan

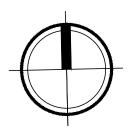Lot 49 SHEET NUMBER


A-1.2

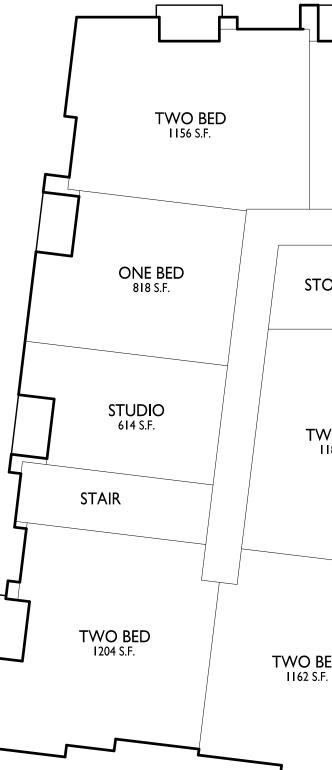



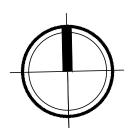

ONE BED 815 S.F.	ONE BED 815 S.F.	ONE BED 815 S.F.	ONE BED 815 S.F.	ONE BED 815 S.F.	STAIR	TWO BED I204 S.F.	ļ
OR./MECH.							
	TWO BED 1148 S.F.	ONE BI 815 S.F.	ED ONE B . 815 S.	ED S	GTUDIO 665 S.F.	TWO BED 1162 S.F.	
VO BED 1186 S.F.							
BED							

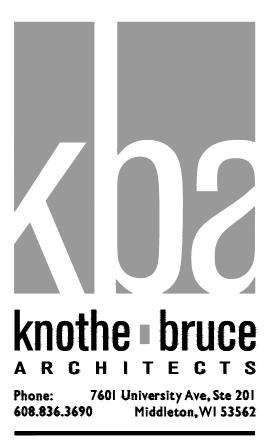


PROJECT TITLE CASCADE -THE AMERICAN CENTER EASTPARK FIFTH ADDITION

4846 Eastpark Blvd. Madison, WI SHEET TITLE Third Floor Plan


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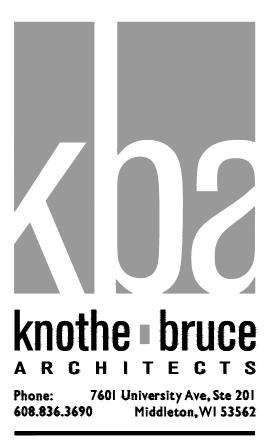
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OR./MECH.	TWO BED 1148 S.F.	ONE B 815 S.F	ED ONE 1 815 S	BED .F.	STUDIO 665 S.F.	TWO BED 1162 S.F.	
BED F.							
F.							



PROJECT TITLE CASCADE -THE AMERICAN CENTER EASTPARK FIFTH ADDITION

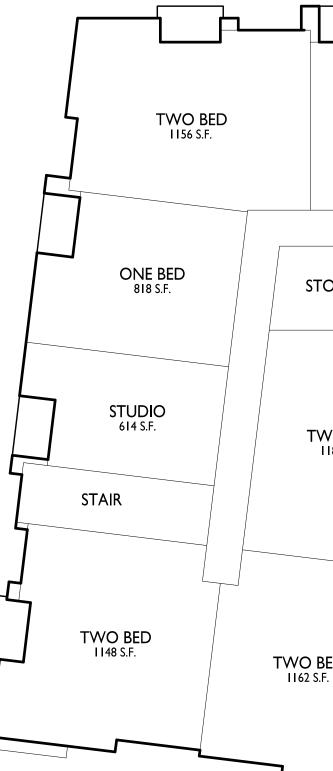4846 Eastpark Blvd. Madison, WI SHEET TITLE Fourth Floor Plan


Lot 49

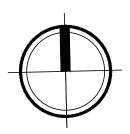SHEET NUMBER

A-1.4



- 1 ELEVATION NORTH A-2.1 1/8" = 1'-0"

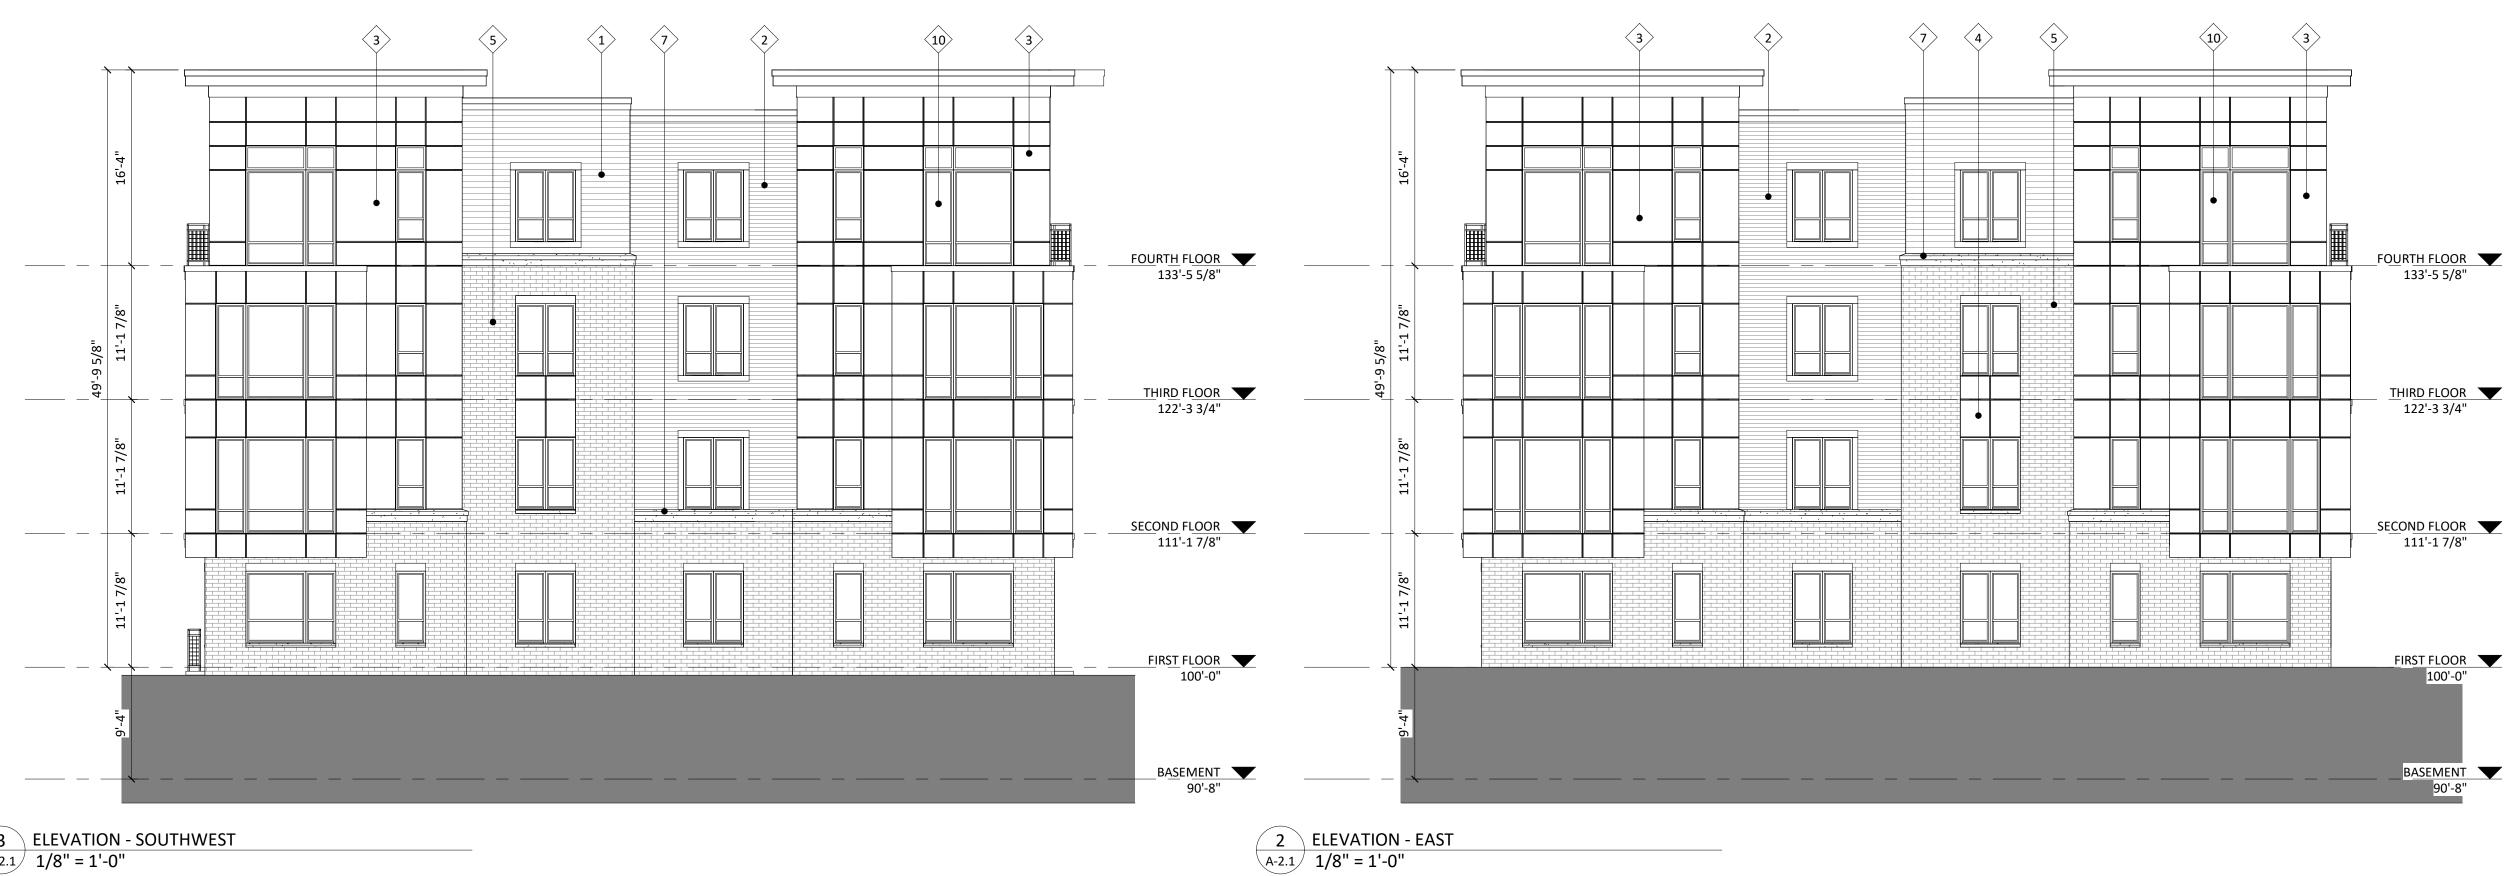

1/8" = 1 '- 0"

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12

3 ELEVATION - SOUTHWEST A-2.1 1/8" = 1'-0"

NOT FOR CONSTRUCTION



ISSUED

	EXTERIOR MATERIAL SCHEDULE				
MARK	BUILDING ELEMENT	MANUFACTURER	COLOR		
	COMPOSITE LAP 6"	JAMES HARDIE	RICH ESPRESSO		
	COMPOSITE LAP 4"	JAMES HARDIE	AGED PEWTER		
	COMPOSITE PANEL	JAMES HARDIE	BLUE		
	COMPOSITE PANEL	JAMES HARDIE	SILVER		
	BRICK VENEER	CLOUD CERAMICS	WINTER BLEND		
	CAST STONE	ROCKCAST	CRYSTAL WHITE		
	COMPOSITE WINDOWS	ANDERSEN 100	BLACK		
	ALUMINIUM STOREFRONT	N/A	BLACK		
	RAILINGS & HANDRAILS	SUPERIOR	BLACK		

PROJECT TITLE Cascade - The American Center LOT 49

East Park Blvd. Madison, WI SHEET TITLE EXTERIOR ELEVATIONS LOT 49


SHEET NUMBER

A-2.1 PROJECT NUMBER 2155 © Knothe & Bruce Architects, LLC





3 ELEVATION - WEST A-2.2 1/8" = 1'-0"

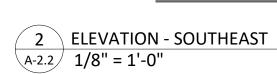

1/8" = 1 '- 0"

10

11 12



EXTERIOR MATERIAL SCHEDULE				
MARK	BUILDING ELEMENT	MANUFACTURER	COLOR	
	COMPOSITE LAP 6"	JAMES HARDIE	RICH ESPRESSO	
	COMPOSITE LAP 4"	JAMES HARDIE	AGED PEWTER	
	COMPOSITE PANEL	JAMES HARDIE	BLUE	
	COMPOSITE PANEL	JAMES HARDIE	SILVER	
	BRICK VENEER	CLOUD CERAMICS	WINTER BLEND	
	CAST STONE	ROCKCAST	CRYSTAL WHITE	
	COMPOSITE WINDOWS	ANDERSEN 100	BLACK	
	ALUMINIUM STOREFRONT	N/A	BLACK	
	RAILINGS & HANDRAILS	SUPERIOR	BLACK	

American Center


Madison, WI SHEET TITLE EXTERIOR ELEVATIONS LOT 49

SHEET NUMBER






1 COLORED ELEVATION - NORTH A-2.3 1/8" = 1'-0"

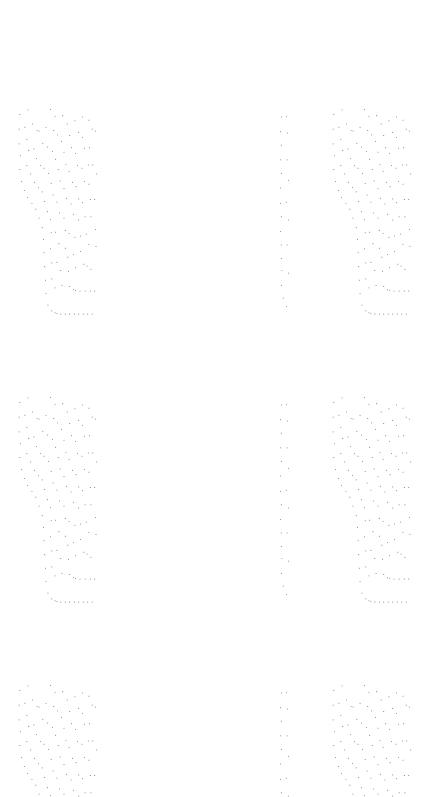



3 COLORED ELEVATION - SOUTHWEST A-2.3 1/8" = 1'-0"

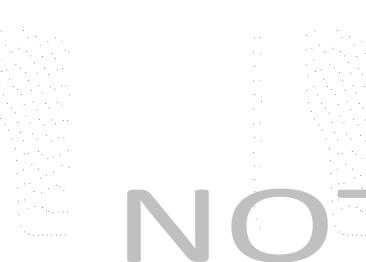






1/8" = 1 '- 0" NOT FOR CONSTRUCTION 2 10 11 12

	EXT	FERIOR MATERIAL SCHEDULE	
MARK	BUILDING ELEMENT	MANUFACTURER	COLOR
	COMPOSITE LAP 6"	JAMES HARDIE	RICH ESPRESSO
	COMPOSITE LAP 4"	JAMES HARDIE	AGED PEWTER
	COMPOSITE PANEL	JAMES HARDIE	BLUE
	COMPOSITE PANEL	JAMES HARDIE	SILVER
	BRICK VENEER	CLOUD CERAMICS	WINTER BLEND
	CAST STONE	ROCKCAST	CRYSTAL WHITE
	COMPOSITE WINDOWS	ANDERSEN 100	BLACK
	ALUMINIUM STOREFRONT	N/A	BLACK
	RAILINGS & HANDRAILS	SUPERIOR	BLACK

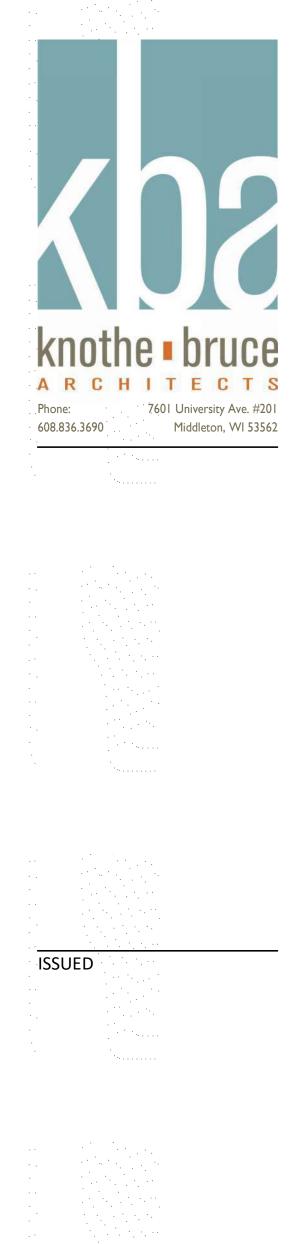

PROJECT TITLE Cascade - The American Center LOT 49

East Park Blvd. Madison, WI SHEET TITLE EXTERIOR ELEVATIONS COLORED LOT 49 SHEET NUMBER A-2.3 PROJECT NUMBER 2155





3 COLORED ELEVATION - WEST A-2.4 1/8" = 1'-0"




2 COLORED ELEVATION - SOUTHEAST A-2.4 1/8" = 1'-0"

	EX	TERIOR MATERIAL SCHEDULE	 	
MARK	BUILDING ELEMENT	MANUFACTURER		COLOR
			•.	
	COMPOSITE LAP 6"	JAMES HARDIE		RICH ESPRESSO
	COMPOSITE LAP 4"	JAMES HARDIE	۰.	AGED PEWTER
	COMPOSITE PANEL	JAMES HARDIE	•	BLUE
	COMPOSITE PANEL	JAMES HARDIE		SILVER
	BRICK VENEER	CLOUD CERAMICS	•••	WINTER BLEND
	CAST STONE	ROCKCAST		CRYSTAL WHITE
	COMPOSITE WINDOWS	ANDERSEN 100		BLACK
	ALUMINIUM STOREFRONT	N/A		BLACK
	RAILINGS & HANDRAILS	SUPERIOR		BLACK


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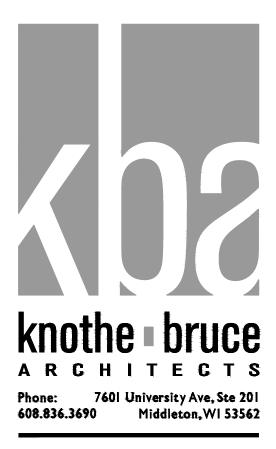
PROJECT TITLE Cascade - The American Center LOT 49

East Park Blvd. Madison, WI SHEET TITLE EXTERIOR ELEVATIONS COLORED LOT 49 SHEET NUMBER A-2.4 PROJECT NUMBER 2155



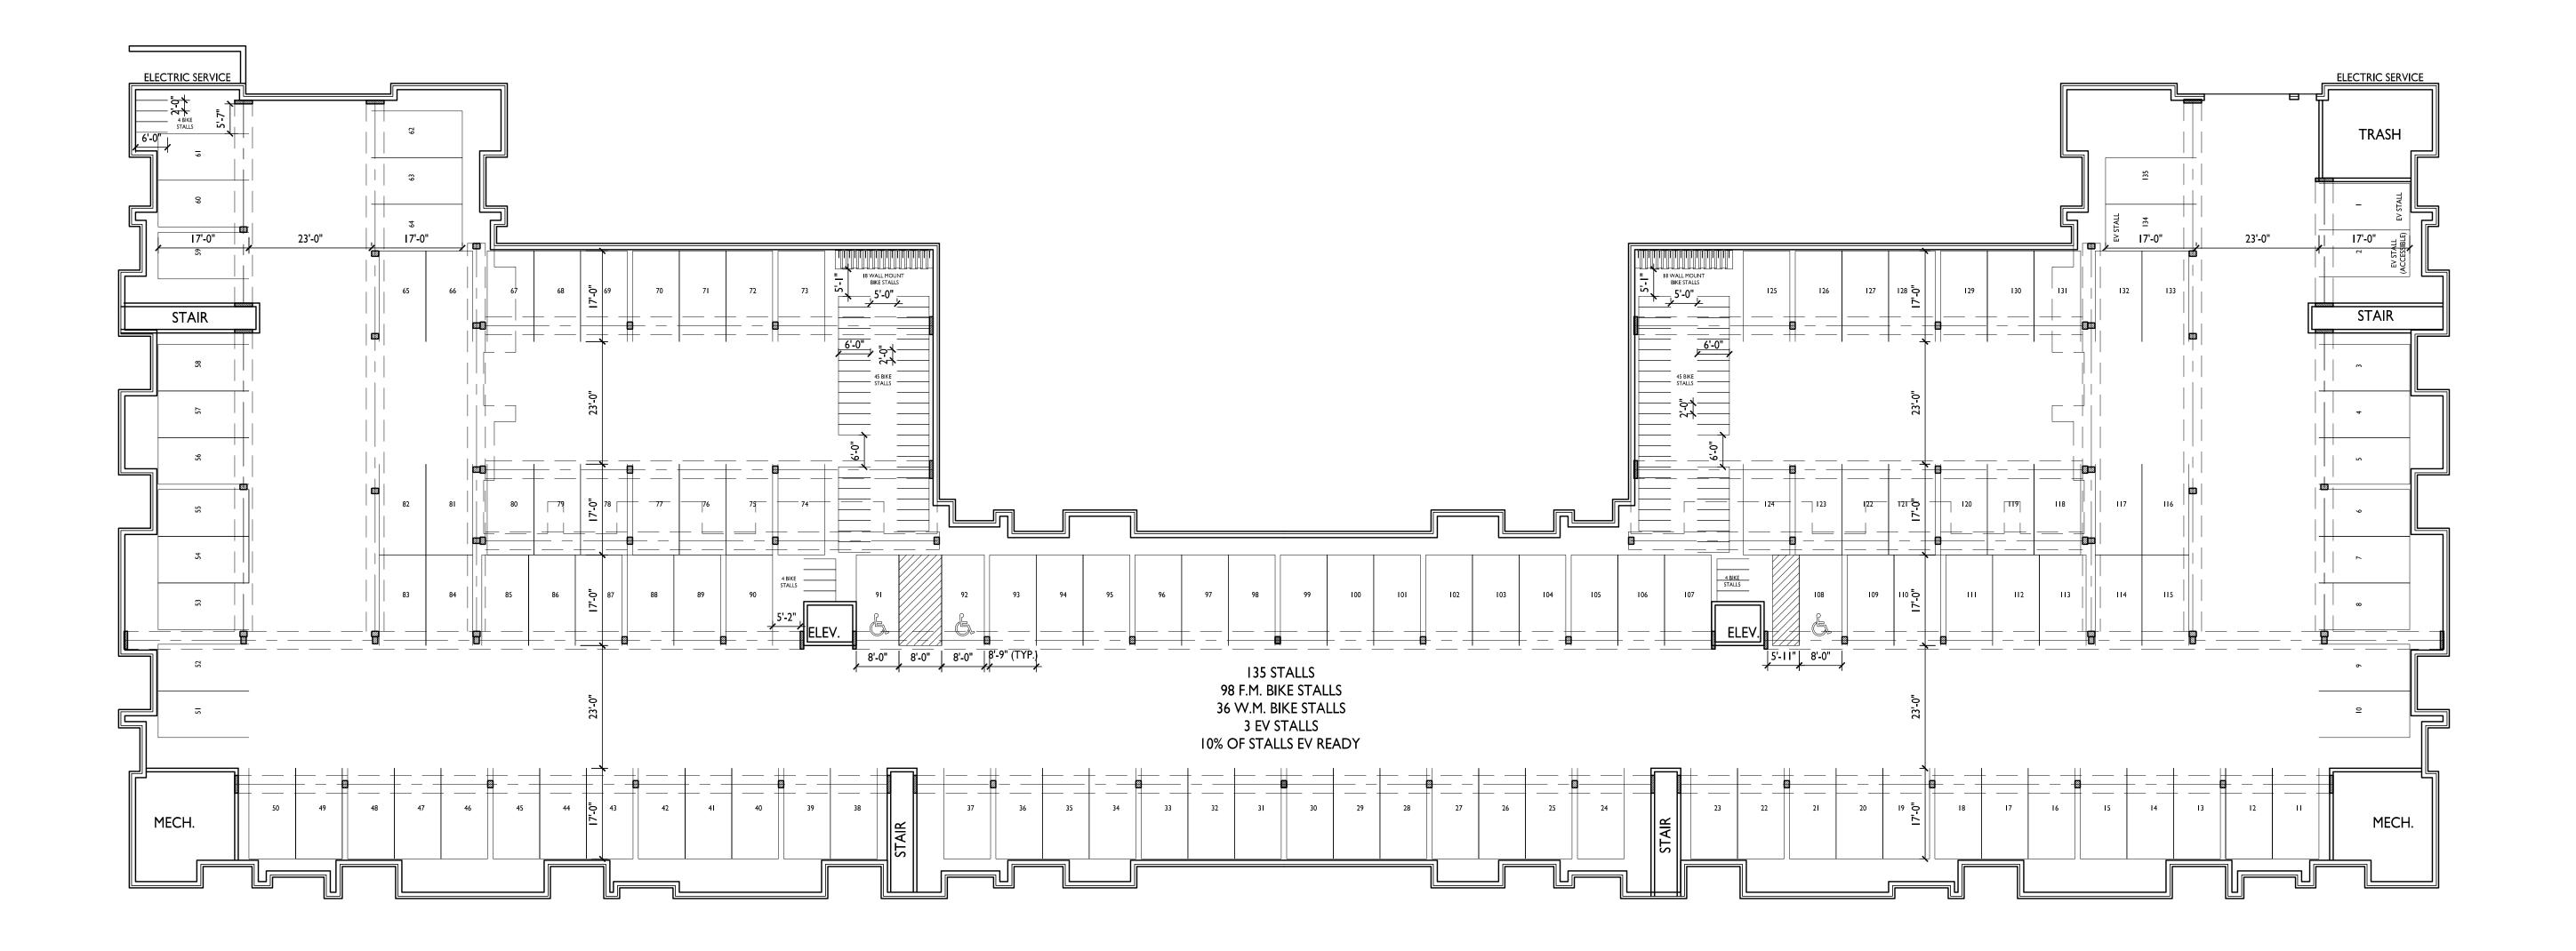



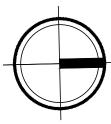


PROJECT TITLE CASCADE -THE AMERICAN CENTER EASTPARK FIFTH ADDITION


4846 Eastpark Blvd. Madison, WI SHEET TITLE Basement Plan



A-1.0 PROJECT NO. 2155

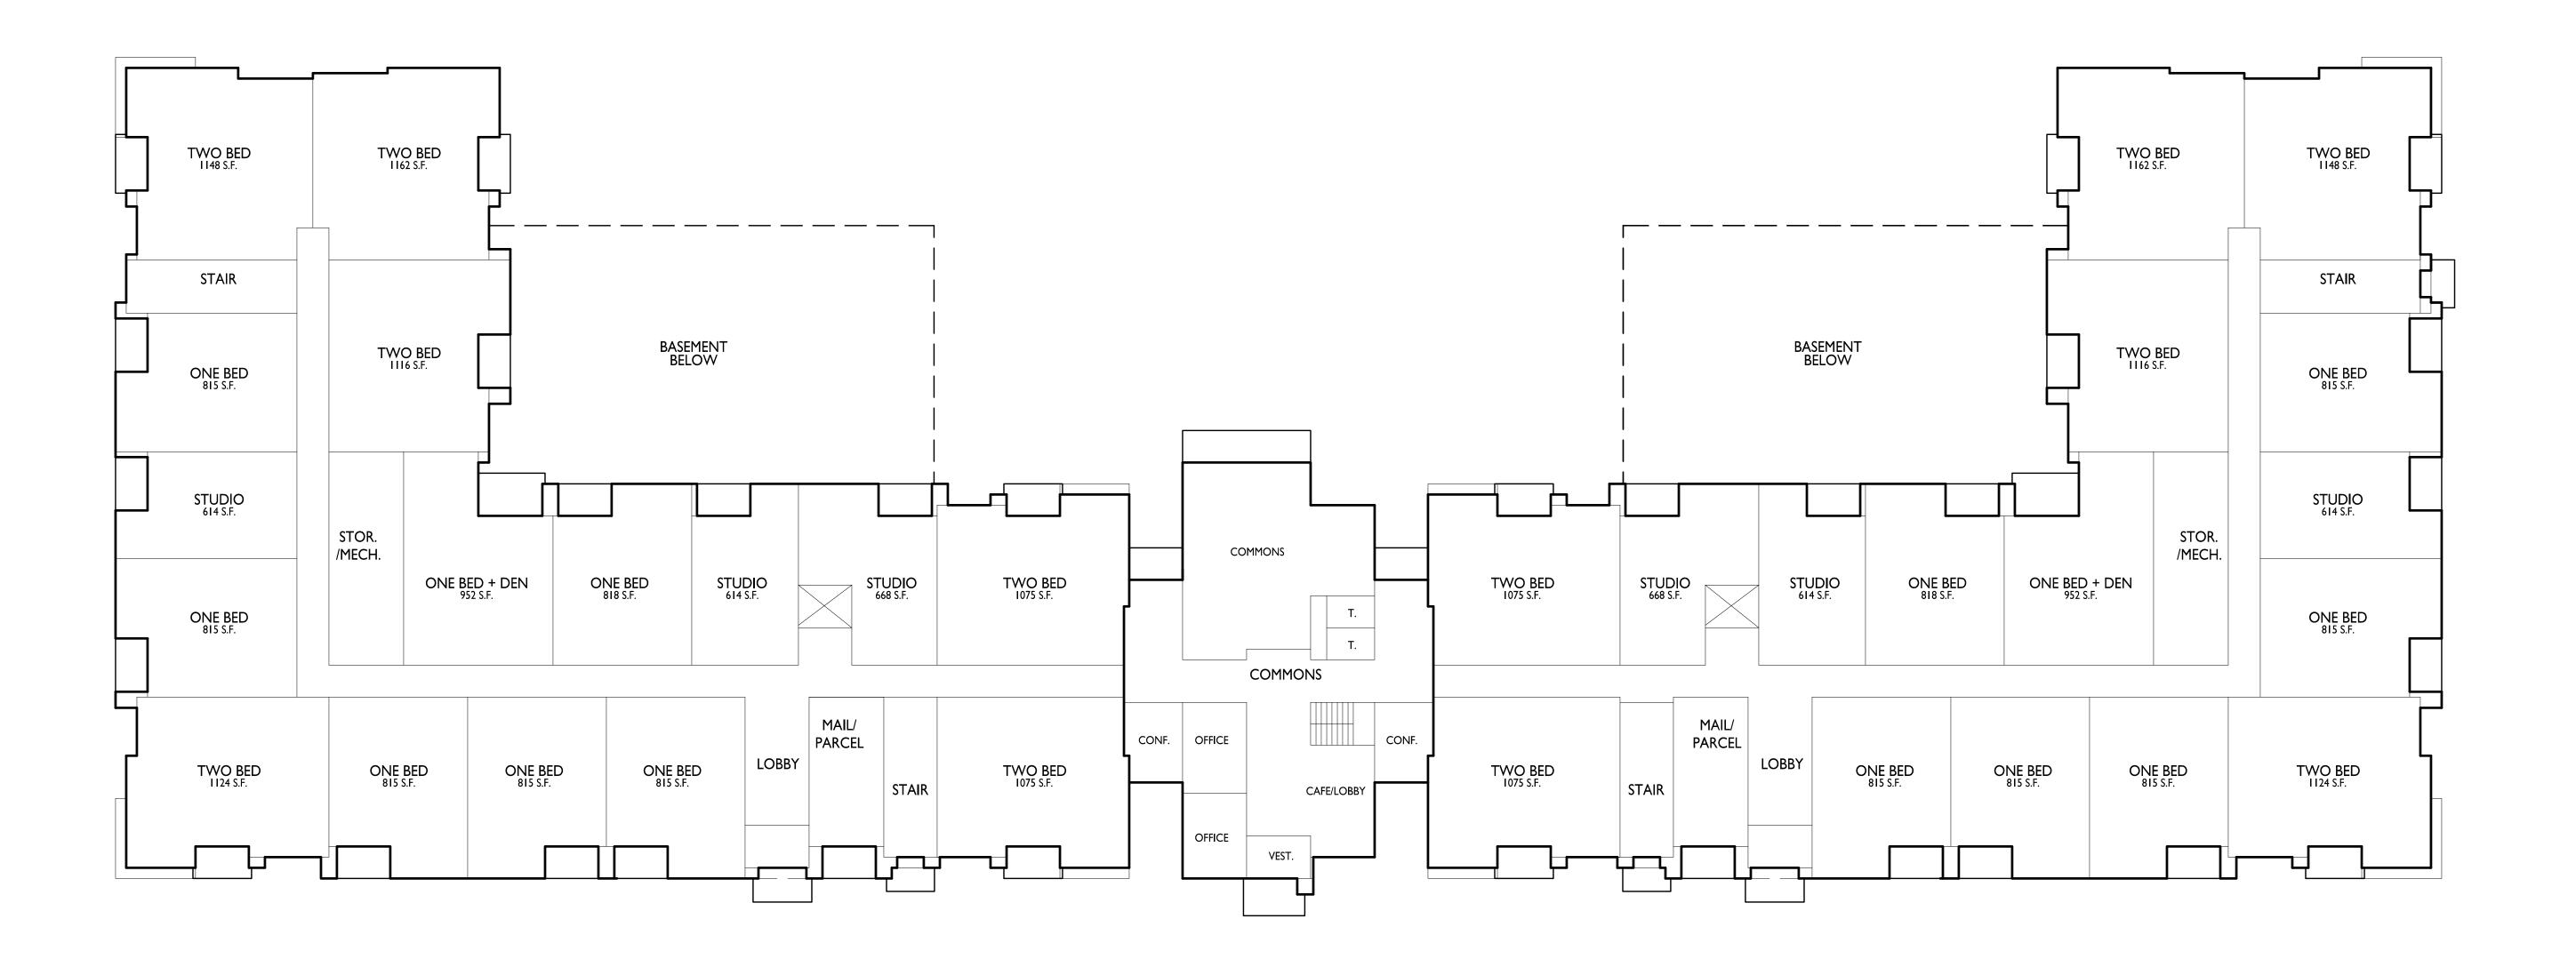



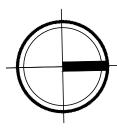



PROJECT TITLE CASCADE -THE AMERICAN CENTER EASTPARK FIFTH ADDITION


4846 Eastpark Blvd. Madison, WI SHEET TITLE First Floor Plan




A-1.1





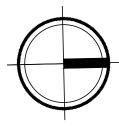

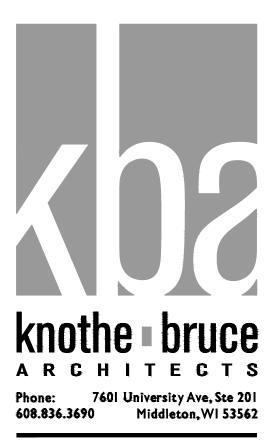

PROJECT TITLE CASCADE -THE AMERICAN CENTER EASTPARK FIFTH ADDITION


4846 Eastpark Blvd. Madison, WI SHEET TITLE Second Floor Plan




A-1.2





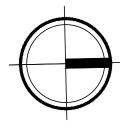



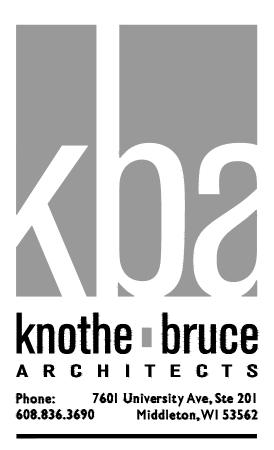

PROJECT TITLE CASCADE -THE AMERICAN CENTER EASTPARK FIFTH ADDITION


4846 Eastpark Blvd. Madison, WI SHEET TITLE Third Floor Plan




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PROJECT TITLE CASCADE -THE AMERICAN CENTER EASTPARK FIFTH ADDITION

4846 Eastpark Blvd. Madison, WI SHEET TITLE Fourth Floor Plan

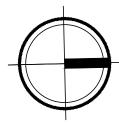

A-1.4


NOT FOR CONSTRUCTION

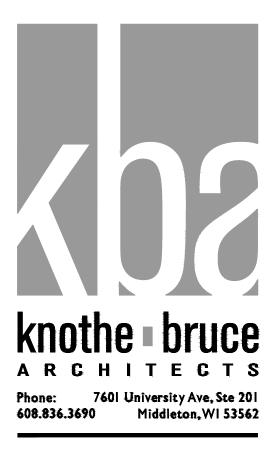2 ELEVATION - EAST 2 A-2.1 1/8" = 1'-0"



1 ELEVATION - EAST 1 A-2.1 1/8" = 1'-0"



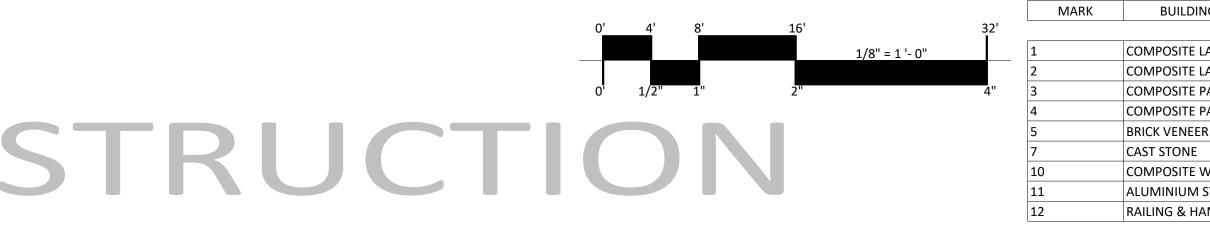



ISSUED

PROJECT TITLE
Cascade - The
American Center
LOT 50


East Park Blvd. <u>Madison, WI</u> SHEET TITLE EXTERIOR ELEVATIONS LOT 50

SHEET NUMBER


A-2.1 PROJECT NUMBER 2155 © Knothe & Bruce Architects, LLC

EXTERIOR MATERIAL SCHEDULE					
NG ELEMENT	MANUFACTURER	COLOR			
LAP 6"	JAMES HARDIE	RICH ESPRESSO			
LAP 4"	JAMES HARDIE	AGED PEWTER			
PANEL	JAMES HARDIE	BLUE			
PANEL	JAMES HARDIE	SILVER			
ER	CLOUD CERAMICS	WINTER BLEND			
	ROCKCAST	CRYSTAL WHITE			
WINDOWS	ANDERSEN 100	BLACK			
STOREFRONT	N/A	BLACK			
ANDRAILS	SUPERIOR	BLACK			


NOT FOR CONSTRUCTION

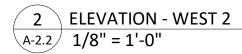



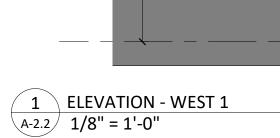



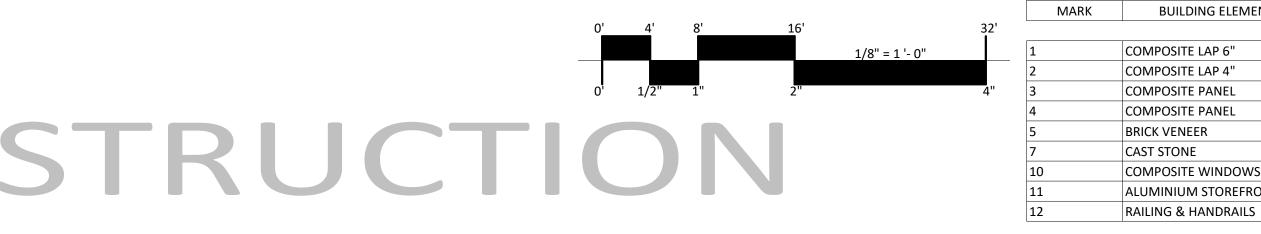



ISSUED


EXTERIOR MATERIAL SCHEDULE					
ING ELEMENT	MANUFACTURER	COLOR			
LAP 6"	JAMES HARDIE	RICH ESPRESSO			
LAP 4"	JAMES HARDIE	AGED PEWTER			
PANEL	JAMES HARDIE	BLUE			
PANEL	JAMES HARDIE	SILVER			
ER	CLOUD CERAMICS	WINTER BLEND			
	ROCKCAST	CRYSTAL WHITE			
WINDOWS	ANDERSEN 100	BLACK			
1 STOREFRONT	N/A	BLACK			
IANDRAILS	SUPERIOR	BLACK			

PROJECT TITLE Cascade - The American Center LOT 50

East Park Blvd. Madison, WI SHEET TITLE EXTERIOR ELEVATIONS LOT 50

SHEET NUMBER

A-2.2 PROJECT NUMBER 2155 © Knothe & Bruce Architects, LLC

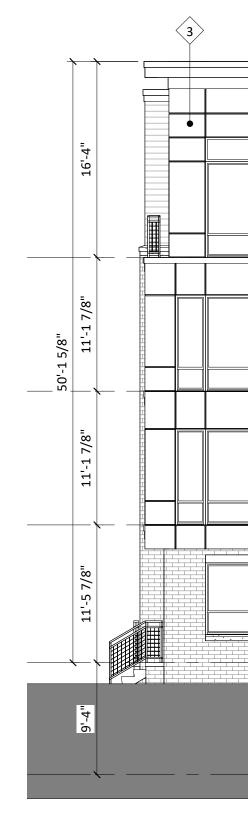


1 ELEVATION - SOUTH A-2.3 1/8" = 1'-0"

NOT FOR CONSTRUCTION





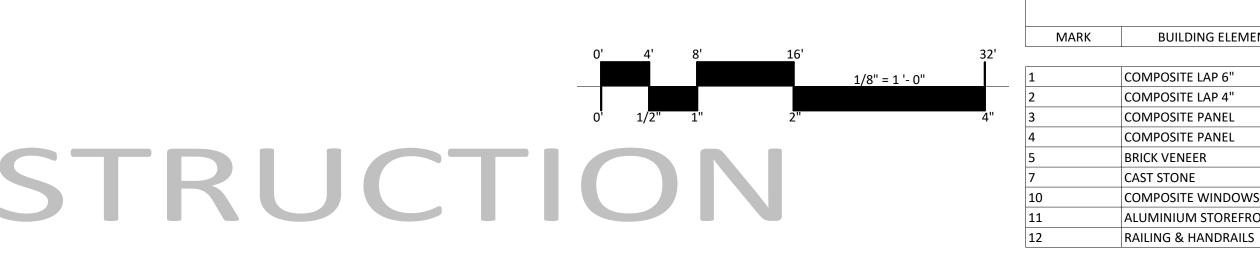

EXTERIOR MATERIAL SCHEDULE					
DING ELEMENT	MANUFACTURER	COLOR			
E LAP 6"	JAMES HARDIE	RICH ESPRESSO			
E LAP 4"	JAMES HARDIE	AGED PEWTER			
E PANEL	JAMES HARDIE	BLUE			
E PANEL	JAMES HARDIE	SILVER			
ER	CLOUD CERAMICS	WINTER BLEND			
E	ROCKCAST	CRYSTAL WHITE			
E WINDOWS	ANDERSEN 100	BLACK			
A STOREFRONT	N/A	BLACK			
HANDRAILS	SUPERIOR	BLACK			

SHEET TITLE EXTERIOR ELEVATIONS LOT 50

SHEET NUMBER






1 ELEVATION - NORTH A-2.4 1/8" = 1'-0"

NOT FOR CONSTRUCTION



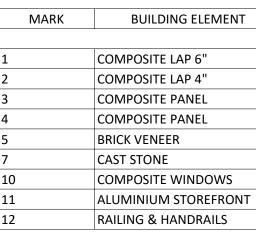

ROCKCAST

SUPERIOR

N/A

ANDERSEN 100

2 ELEVATION - TERRACE - NORTH A-2.4 1/8" = 1'-0"





ISSUED

PROJECT TITLE Cascade - The American Center LOT 50

East Park Blvd. Madison, WI SHEET TITLE EXTERIOR ELEVATIONS LOT 50

SHEET NUMBER



			🔪 🥄 FIRST FLOOR 🔍
			100'-0"
			9'-4"
			BASEMENT 90'-8"
	EXTERIOR MATERIAL SCHI	EDULE	
DING ELEMENT	MANUFACTURER	COLOR	
E LAP 6"	JAMES HARDIE	RICH ESPRESSO	
E LAP 4"	JAMES HARDIE	AGED PEWTER	
E PANEL	JAMES HARDIE	BLUE	
E PANEL	JAMES HARDIE	SILVER	
EER	CLOUD CERAMICS	WINTER BLEND	

CRYSTAL WHITE

BLACK

BLACK

BLACK








1 COLORED ELEVATION - EAST 1 A-2.5 1/8" = 1'-0"



2 COLORED ELEVATION - EAST 2 A-2.5 1/8" = 1'-0"



	EXTERIOR MATERIAL SC	CHEDULE	•••	
DING ELEMENT	MANUFACTURER		COLOR	
			• .	
E LAP 6"	JAMES HARDIE	RICH ESPRESSO		
E LAP 4"	JAMES HARDIE	AGED PEWTER	· .	
E PANEL	JAMES HARDIE	BLUE	•	
E PANEL	JAMES HARDIE	SILVER		
EER	CLOUD CERAMICS	WINTER BLEND	· .	
IE	ROCKCAST	CRYSTAL WHITE		
E WINDOWS	ANDERSEN 100	BLACK	·	1961
M STOREFRONT	N/A	BLACK		
HANDRAILS	SUPERIOR	BLACK		

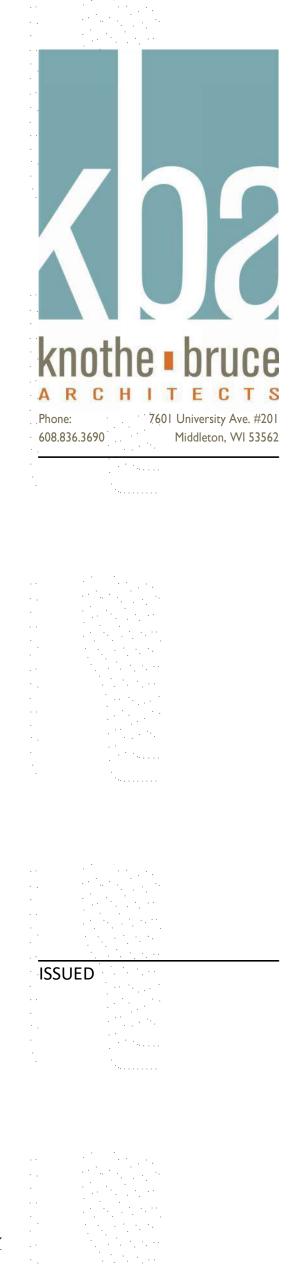

PROJECT TITLE Cascade - The American Center LOT 50

11'-1

11'-5 7/8

9

SECOND FLOOR 111'-5 7/8"

FIRST FLOOR 100'-0"

BAŞEMENT 90'-8"

East Park Blvd. Madison, WI SHEET TITLE EXTERIOR ELEVATIONS COLORED LOT 50 SHEET NUMBER A-2.5 PROJECT NUMBER 2155









2 COLORED ELEVATION - WEST 2 A-2.6 1/8" = 1'-0"






EXTERIOR MATERIAL SCHEDULE			
DING ELEMENT	MANUFACTURER	COLOR	
E LAP 6"	JAMES HARDIE	RICH ESPRESSO	
E LAP 4"	JAMES HARDIE	AGED PEWTER	
E PANEL	JAMES HARDIE	BLUE	
E PANEL	JAMES HARDIE	SILVER	
EER	CLOUD CERAMICS	WINTER BLEND	
E	ROCKCAST	CRYSTAL WHITE	
E WINDOWS	ANDERSEN 100	BLACK	
M STOREFRONT	N/A	BLACK	
HANDRAILS	SUPERIOR	BLACK	





PROJECT TITLE Cascade - The American Center LOT 50

East Park Blvd. Madison, WI SHEET TITLE EXTERIOR ELEVATIONS COLORED LOT 50 SHEET NUMBER

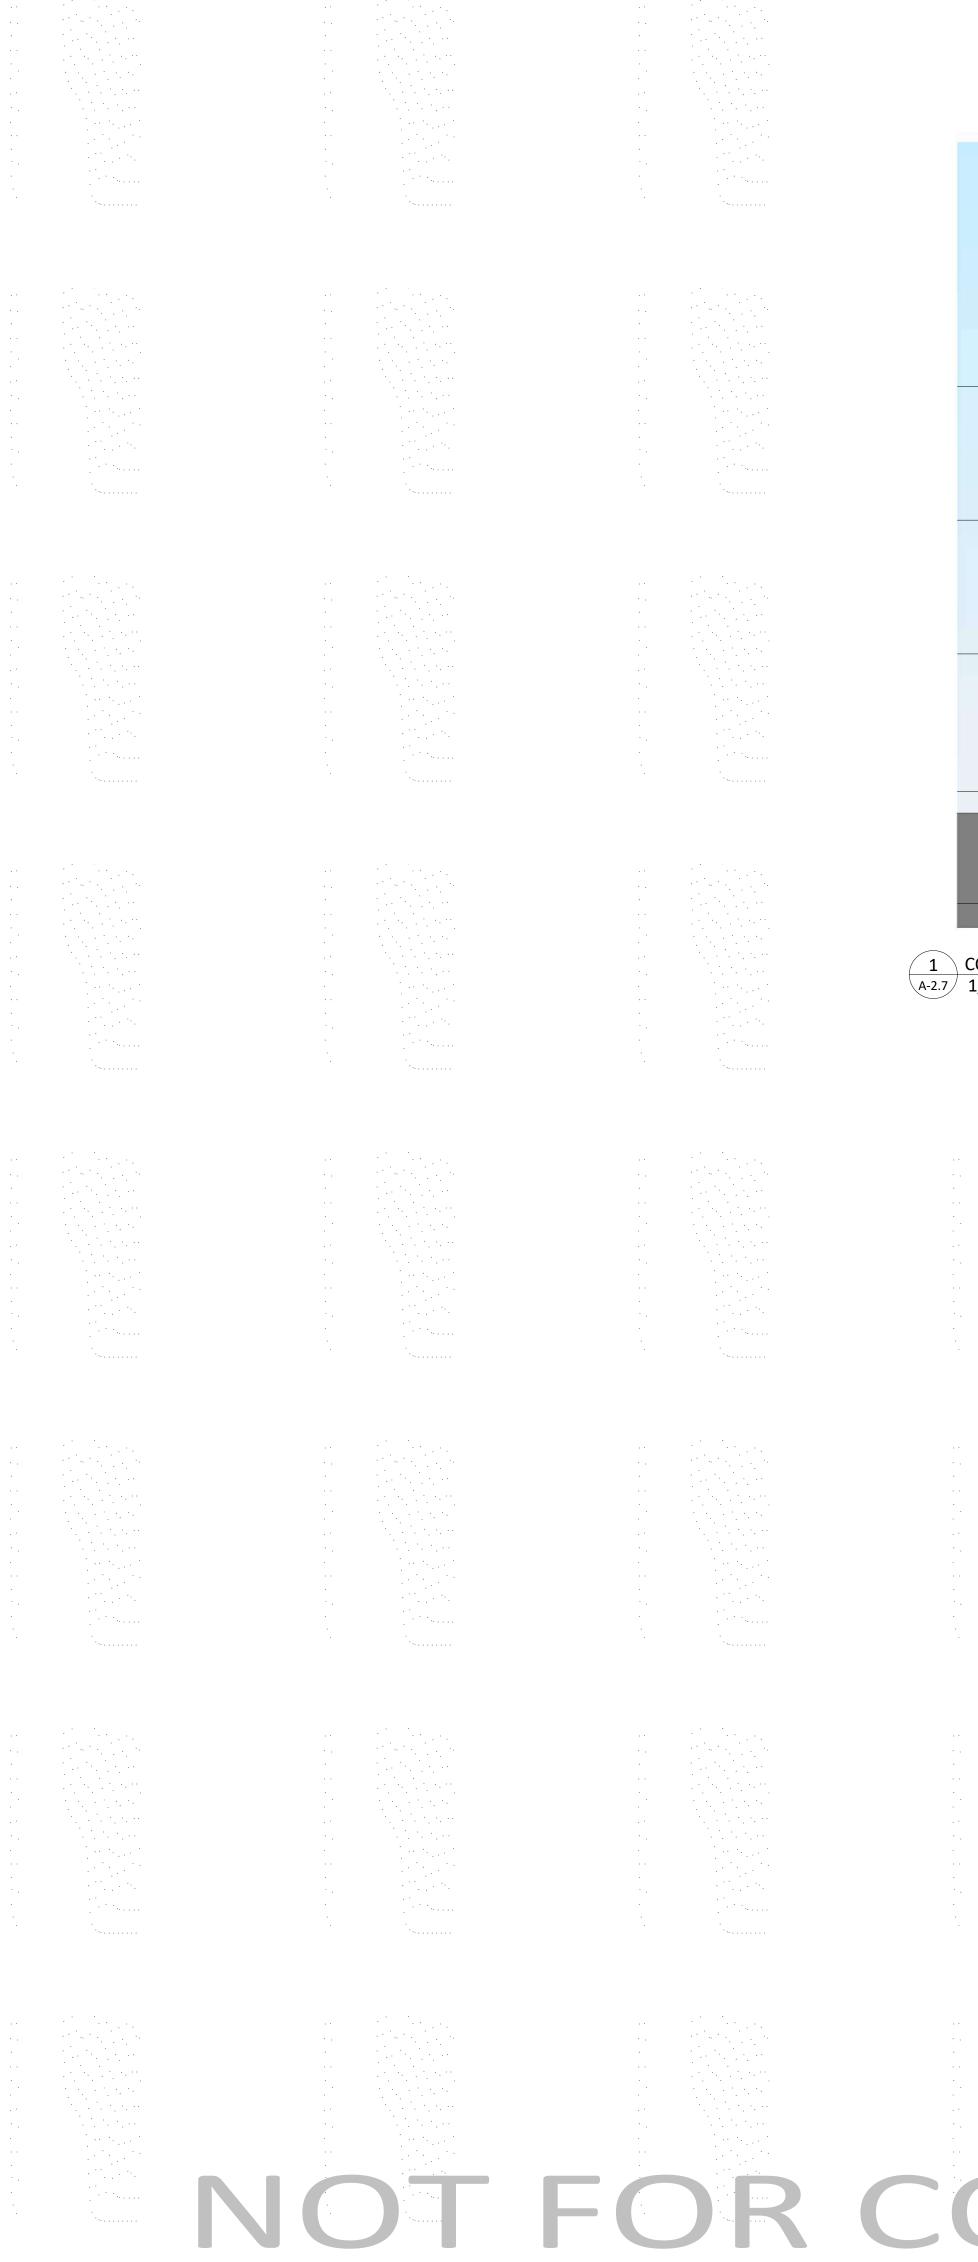



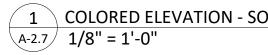

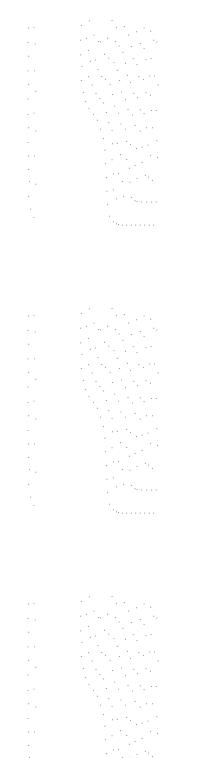






EXTERIOR MATERIAL SCHEDULE			
NG ELEMENT	MANUFACTURER		COLOR
LAP 6"	JAMES HARDIE	RICH ESPRESSO	
LAP 4"	JAMES HARDIE	AGED PEWTER	
PANEL	JAMES HARDIE	BLUE	
PANEL	JAMES HARDIE	SILVER	
R	CLOUD CERAMICS	WINTER BLEND	
	ROCKCAST	CRYSTAL WHITE	
WINDOWS	ANDERSEN 100	BLACK	i de la companya de l
STOREFRONT	N/A	BLACK	
ANDRAILS	SUPERIOR	BLACK	


PROJECT TITLE Cascade - The American Center LOT 50

East Park Blvd. Madison, WI SHEET TITLE EXTERIOR ELEVATIONS COLORED LOT 50 SHEET NUMBER A-2.7 PROJECT NUMBER 2155





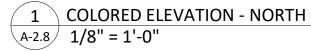

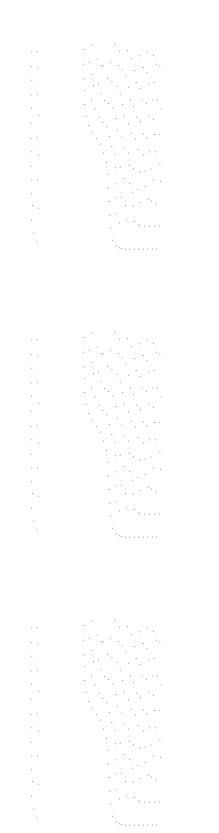





	EXTERIOR MATERIAL SC	CHEDULE	
BUILDING ELEMENT	MANUFACTURER		COLOR
		I	
COMPOSITE LAP 6"	JAMES HARDIE	RICH ESPRESSO	
COMPOSITE LAP 4"	JAMES HARDIE	AGED PEWTER	
COMPOSITE PANEL	JAMES HARDIE	BLUE	
COMPOSITE PANEL	JAMES HARDIE	SILVER	
BRICK VENEER	CLOUD CERAMICS	WINTER BLEND	
CAST STONE	ROCKCAST	CRYSTAL WHITE	
COMPOSITE WINDOWS	ANDERSEN 100	BLACK	· · · · · · · · · · · · · · · · · · ·
ALUMINIUM STOREFRONT	N/A	BLACK	
RAILING & HANDRAILS	SUPERIOR	BLACK	



PROJECT TITLE Cascade - The American Center LOT 50

East Park Blvd. Madison, WI SHEET TITLE EXTERIOR ELEVATIONS COLORED LOT 50 SHEET NUMBER A-2.8 PROJECT NUMBER 2155







LOT 50 & 49 - LOOKING SOUTH



R3











COMPOSITE HORIZONTAL SIDING & TRIM




COMPOSITE METAL PANELS



CAST STONE SILLS & BANDS



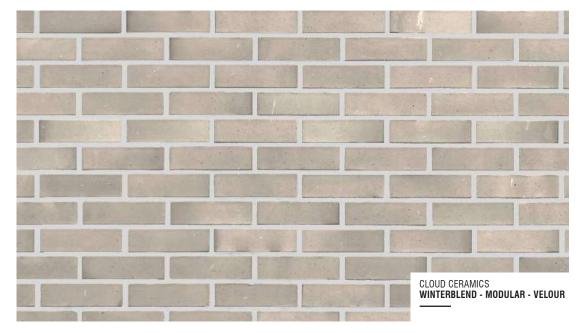



EXTERIOR MATERIAL SCHEDULE				
MARK	BUILDING ELEMENT	MANUFACTURER	COLOR	
1	COMPOSITE LAP 6"	JAMES HARDIE	RICH ESPRESSO	
2	COMPOSITE LAP 4"	JAMES HARDIE	AGED PEWTER	
3	COMPOSITE PANEL	JAMES HARDIE	BLUE	
4	COMPOSITE PANEL	JAMES HARDIE	SILVER	
5	BRICK VENEER	CLOUD CERAMICS	WINTER BLEND	
7	CAST STONE	ROCKCAST	CRYSTAL WHITE	
10	COMPOSITE WINDOWS	ANDERSEN 100	BLACK	
11	ALUMINIUM STOREFRONT	N/A	BLACK	
12	RAILINGS & HANDRAILS	SUPERIOR	BLACK	

BRICK VENEER & SOLDIER COURSE



CASCADE -THE AMERICAN CENTER EASTPARK FIFTH ADDITION

EASTPARK BLVD. MADISON, WI

LOT 49 Material Board

FEBRUARY 27, 2023 KBA PROJECT #2155