GENERAL NOTES:

THE APPLICANT SHALL REPLACE ALL SIDEWALK AND CURB AND GUTTER THAT ABUTS THE PROPERT THAT IS DAMAGED BY THE CONSTRUCTION, OR ANY SIDEWALK AND CURB AND GUTTER WHICH THE CITY ENGINEER DETERMINES NEEDS TO BE REPLACED BECAUSE IT IS NOT AT A DESIRABLE GRADE, REGARDLESS OF WHETHER THE CONDITION EXISTED PRIOR TO BEGINNING CONSTRUCTION.

2. ALL WORK IN THE PUBLIC RIGHT OF WAY SHALL BE PERFORMED BY A CITY-LICENSED CONTRACTOR.

3. ALL DAMAGE TO THE PAVEMENT ON CITY STREETS, AND ADJACENT TO THIS DEVELOPMENT SHALL BE RESTORED IN ACCORDANCE WITH THE CITY OF MADISON'S PAVEMENT PATCHING CRITERIA

4. ALL PROPOSED STREET TREE REMOVALS WITHIN THE RIGHT OF WAY SHALL BE REVIEWED BY CITY FORESTRY BEFORE THE PLAN COMMISSION MEETING. STREET TREE REMOVALS REQUIRE APPROVAL AND A TREE REMOVAL PERMIT ISSUED BY CITY FORESTRY. ANY STREET TREE REMOVALS REQUESTED AFTER THE DEVELOPMENT PLAN IS APPROVED BY THE PLAN COMMISSION OR THE BOARD OF PUBLIC WORKS AND CITY FORESTRY WILL REQUIRE A MINIMUM OF A 72-HOUR REVIEW PERIOD WHICH SHALL INCLUDE THE NOTIFICATION OF THE ALDERPERSON WITHIN WHO'S DISTRICT IS AFFECTED BY THE STREET TREE REMOVAL(S) PRIOR TO A TREE REMOVAL PERMIT BEING ISSUED.

5. AS DEFINED BY THE SECTION 107.13 OF CITY OF MADISON STANDARD SPECIFICATIONS FOR PUBLIC WORKS CONSTRUCTION: NO EXCAVATION IS PERMITTED WITHIN 5 FEET OF THE TRUNK OF THE STREET TREE OR WHEN CUTTING ROOTS OVER 3 INCHES IN DIAMETER. IF EXCAVATION IS NECESSARY THE CONTRACTOR SHALL CONTACT MADISON CITY FORESTRY (266-4816) PRIOR TO EXCAVATION. CITY OF MADISON FORESTRY PERSONNEL SHALL ASSESS THE IMPACT TO THE TREE AND TO ITS ROOT SYSTEM PRIOR TO WORK COMMENCING. TREE PROTECTION SPECIFICATIONS CAN BE FOUND ON THE FOLLOWING WEBSITE:

CITYOFMADISON.COM/BUSINESS/PW/SPECS.CFM

6. CONTRACTOR SHALL TAKE PRECAUTIONS DURING CONSTRUCTION TO NOT DISFIGURE, SCAR, OR IMPAIR THE HEALTH OF ANY STREET TREE. CONTRACTOR SHALL OPERATE EQUIPMENT IN A MANNER AS TO NOT DAMAGE THE BRANCHES OF THE STREET TREE(S). THIS MAY REQUIRE USING SMALLER EQUIPMENT AND LOADING AND UNLOADING MATERIALS IN A DESIGNATED SPACE AWAY FROM TREES ON THE CONSTRUCTION SITE. ANY DAMAGE OR INJURY TO EXISTING STREET TREES (EITHER ABOVE OR BELOW GROUND) SHALL BE REPORTED IMMEDIATELY TO CITY FORESTRY AT 266-4816. PENALTIES AND REMEDIATION SHALL BE REQUIRED.

7. SECTION 107.13(G) OF CITY OF MADISON STANDARD SPECIFICATIONS FOR PUBLIC WORKS CONSTRUCTION ADDRESSES SOIL COMPACTION NEAR STREET TREES AND SHALL BE FOLLOWED BY CONTRACTOR. THE STORAGE OF PARKED VEHICLES, CONSTRUCTION EQUIPMENT, BUILDING MATERIALS, REFUSE, EXCAVATED SPOILS OR DUMPING OF POISONOUS MATERIALS ON OR AROUND TREES AND ROOTS WITHIN FIVE (5) FEET OF THE TREE OR WITHIN THE PROTECTION ZONE IS PROHIBITED.

8. ON THIS PROJECT, STREET TREE PROTECTION ZONE FENCING IS REQUIRED. THE FENCING SHALL BE ERECTED BEFORE THE DEMOLITION, GRADING OR CONSTRUCTION BEGINS. THE FENCE SHALL INCLUDE THE ENTIRE WIDTH OF TERRACE AND, EXTEND AT LEAST 5 FEET ON BOTH SIDES OF THE OUTSIDE EDGE OF THE TREE TRUNK. DO NOT REMOVE THE FENCING TO ALLOW FOR DELIVERIES OR EQUIPMENT ACCESS THROUGH THE TREE PROTECTION ZONE.

9. STREET TREE PRUNING SHALL BE COORDINATED WITH MADISON FORESTRY AT A MINIMUM OF TWO WEEKS PRIOR TO THE START OF CONSTRUCTION FOR THIS PROJECT. ALL PRUNING SHALL FOLLOW THE AMERICAN NATIONAL STANDARDS INSTITUTE (ANSI) A300 - PART I STANDARDS FOR PRUNING.

10. AT LEAST ONE WEEK PRIOR TO STREET TREE PLANTING, CONTRACTOR SHALL CONTACT CITY FORESTRY AT (608) 266-4816 TO SCHEDULE INSPECTION AND APPROVAL OF NURSERY TREE STOCK AND REVIEW PLANTING SPECIFICATIONS WITH THE LANDSCAPER.

II. APPROVAL OF PLANS FOR THIS PROJECT DOES NOT INCLUDE ANY APPROVAL TO PRUNE, REMOVE, OR PLANT TREES IN THE PUBLIC RIGHT-OF-WAY. PERMISSION FOR SUCH ACTIVITIES MUST BE OBTAINED FROM THE CITY FORESTER (266-4816).


12. THE PUBLIC RIGHT-OF-WAY IS THE SOLE JURISDICTION OF THE CITY OF MADISON AND IS SUBJECT TO CHANGE AT ANY TIME. NO ITEMS SHOWN ON THIS SITE PLAN IN THE RIGHT-OF-WAY ARE PERMANENT AND MAY NEED TO BE REMOVED AT THE APPLICANTS EXPENSE UPON NOTIFICATION BY THE CITY.


NEW 48" WIDE EGRESS CONC. PATHWAY -

5' SIDE YARD SETBACK —

EXISTING FENCE-

5' REAR YARD SETBACK -

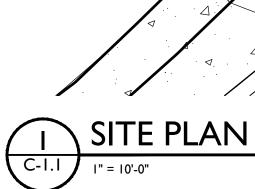

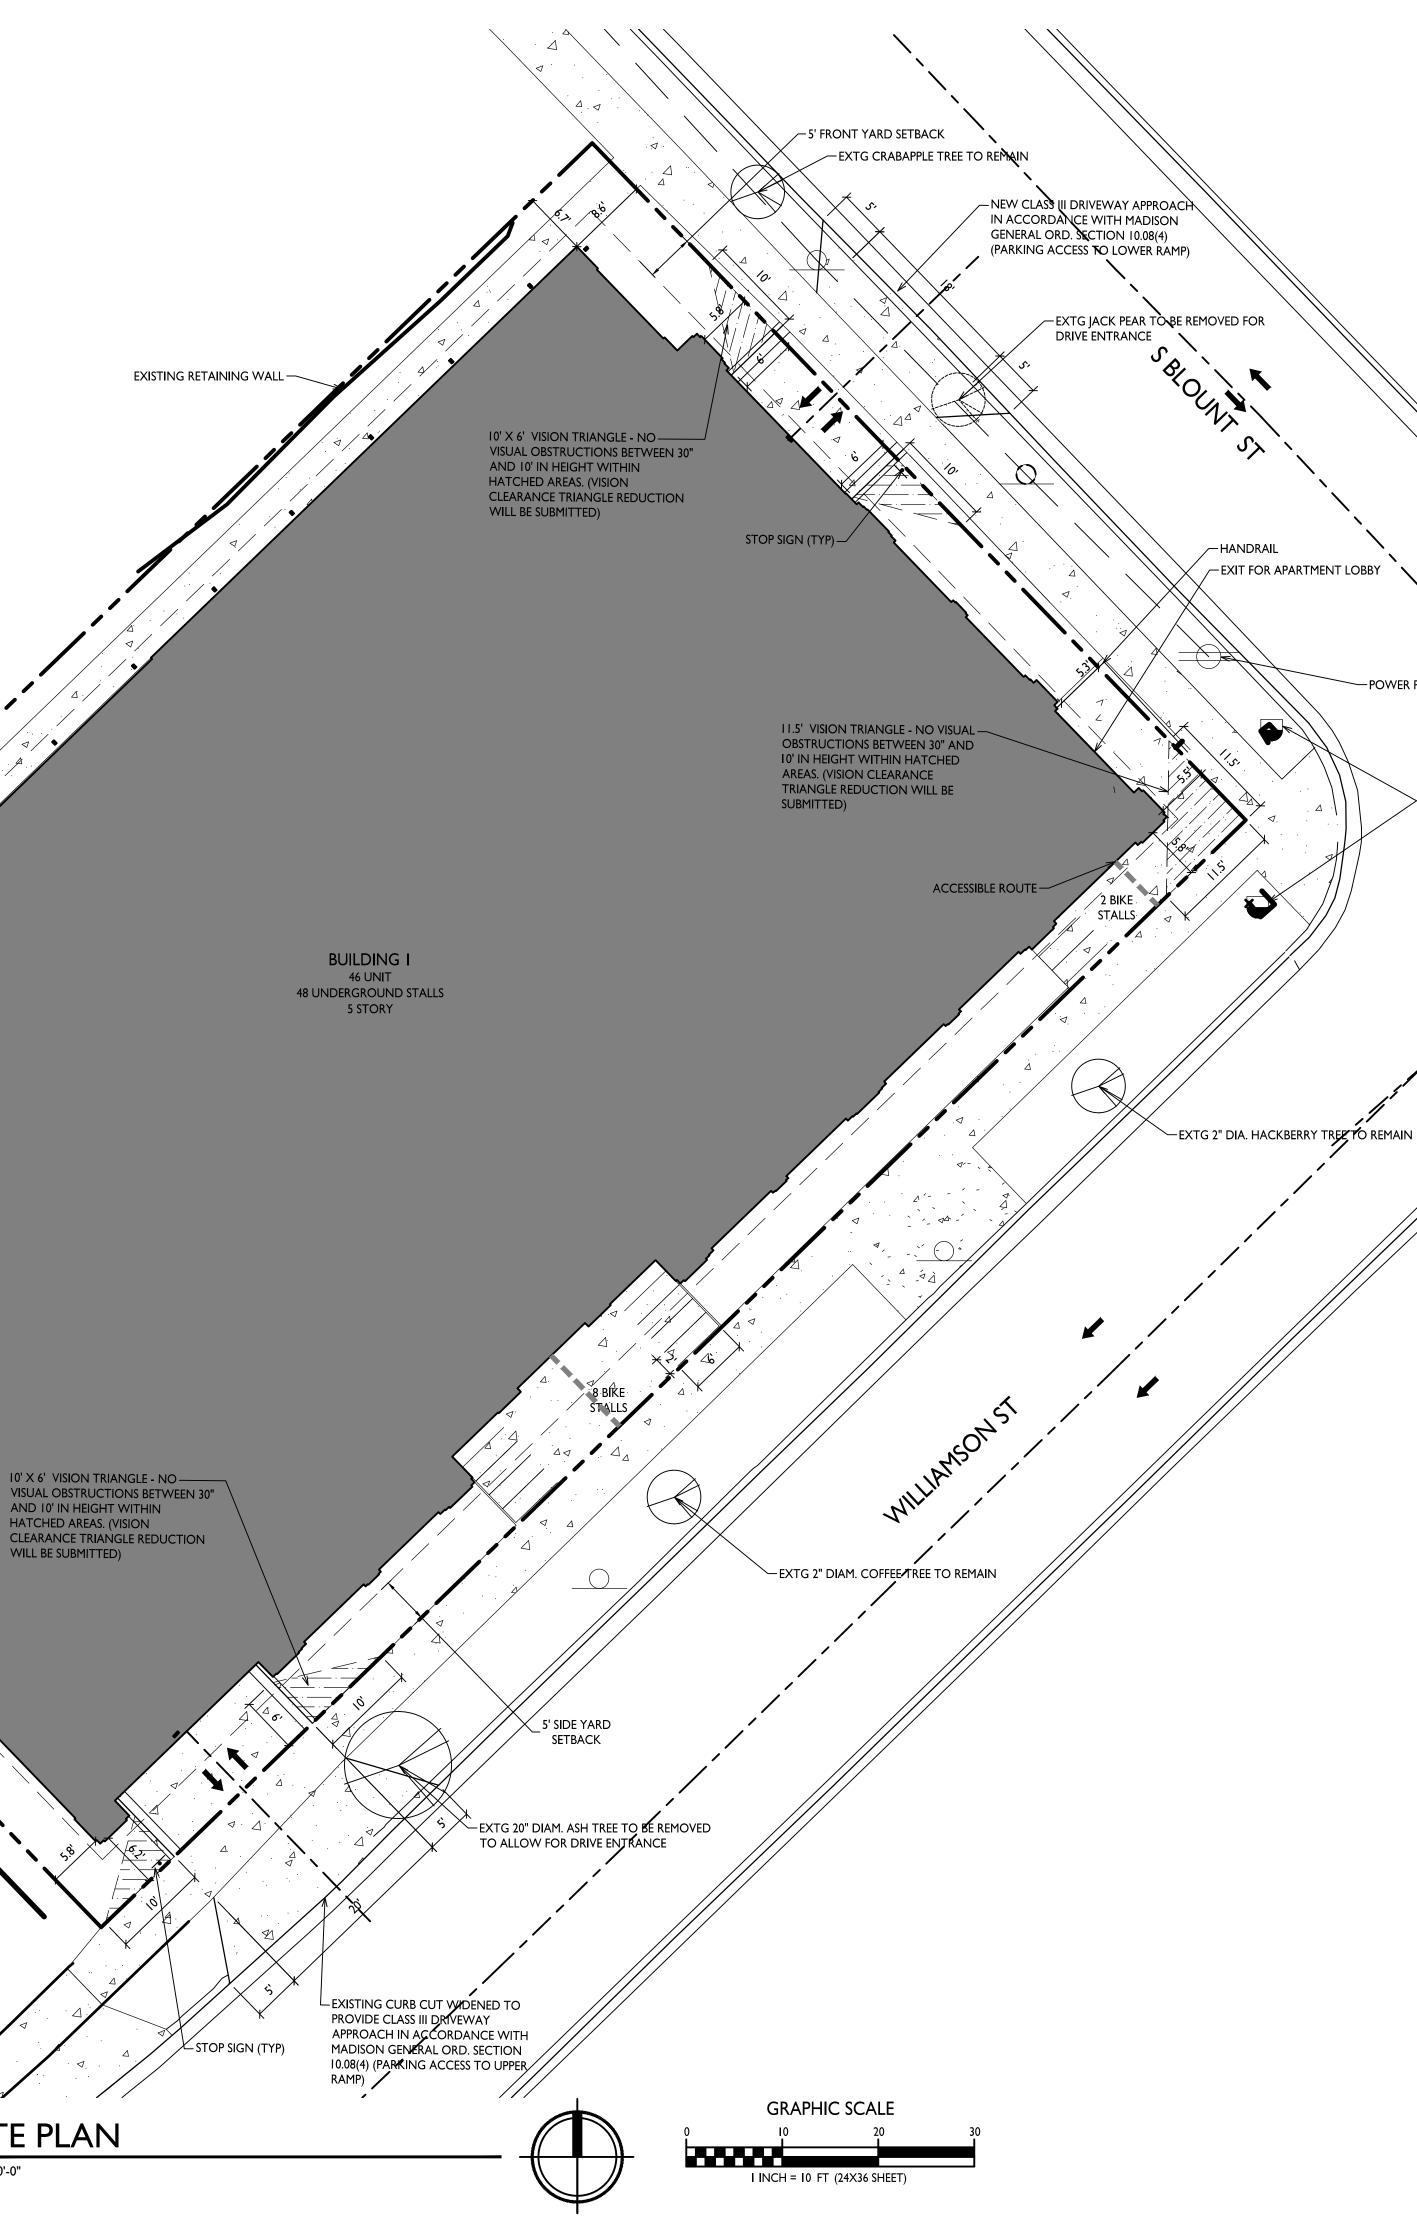

SHEET INDEX	
<u>SITE</u>	
C-I.I	SITE PLAN
C-1.2	SITE LIGHTING
C-1.3	FIRE DEPARTMENT ACCESS
C-1.4	LOT COVERAGE
C-200	EXISTING SITE & DEMO PLAN
C-300	SITE & UTILITY PLAN
C-400	GRADING PLAN
L-1.1	LANDSCAPE PLAN
ARCHITECTURAL	
A-1.0	BASEMENT/LOWER PARKING PLAN
A-I.I	LEVEL I/UPPER PARKING PLAN
A-1.2	LEVEL 2 PLAN
A-1.3	LEVEL 3 PLAN
A-1.4	LEVEL 4 PLAN
A-1.5	LEVEL 5 PLAN
A-1.6	LEVEL 6 PLAN
A-2.I	EXTERIOR ELEVATIONS
A-2.2	EXTERIOR ELEVATIONS
A-2.3	ELEVATIONS COLORED
A-2.4	ELEVATIONS COLORED
A-2.5	EXTERIOR RENDERINGS

-HANDRAIL

-POWER POLE

- TRAFFIC LIGHT POLES

- EXIT FOR APARTMENT LOBBY




ISSUED For LUA & Landmarks Submittal - Feb. 13, 2023


Site Development Data:			
Zoning Densities: Lot Area Dwelling Units Lot Area / D.U.	TE - Traditional Emp 16,279 S.F./0.37 ACF 46 units 354 S.F./D.U.		PROJECT TITLE John Fontain
Density	124 units/Acre PROVIDED	ZONING REQ'D	Realty
Lot Coverage	13,717 S.F. (84.2%)	85% Max.	
Building Height	5 stories/63'-0"	5 Stories/68' Max.	
Commercial Area	2,656 S.F.		
Dwelling Unit Mix:			
Studio One Bedroom	14 23		
Two Bedroom Total Dwelling Units	<u>9</u> 46		
Vehicle Parking Stalls:			
Underground Garage	48		
Bicycle Parking: Long-Term Covered Garag	e 46		
Short-Term Guest - Surface Commercial - Surface	e 5		
Total	<u>5</u> 56		654 Williamson S
			Madison, WI
			SHEET TITLE
			Site Plan
	BIKE RACKS		
	<u>BIKE RACKS</u> INTERIOR & EXTI FLOOR MOUNTE		
	INTERIOR & EXTI FLOOR MOUNTE "INVERTED U" T	D: YPE.	
	INTERIOR & EXTI FLOOR MOUNTE	D: YPE.	Sheet Number
	INTERIOR & EXTI FLOOR MOUNTE "INVERTED U" T MADRAX UX OR DOCK	D: YPE. SARIS BIKE	SHEET NUMBER
	INTERIOR & EXTI FLOOR MOUNTE "INVERTED U" T MADRAX UX OR	D: YPE. SARIS BIKE MOUNTED:	
	INTERIOR & EXTI FLOOR MOUNTE "INVERTED U" T MADRAX UX OR DOCK INTERIOR WALL	D: YPE. SARIS BIKE MOUNTED: CAL RACK	
	INTERIOR & EXTI FLOOR MOUNTE "INVERTED U" T MADRAX UX OR DOCK INTERIOR WALL MADRAX VERTIC	D: YPE. SARIS BIKE MOUNTED: CAL RACK	SHEET NUMBER

LIGHT LEVEL STATISTICS						
DESCRIPTION	SYMBOL	AVG.	MAX.	MIN.	MAX. / MIN.	AVG. / MIN
North Parking Garage Entry Security Lighting	+	2.8 fc	6.2 fc	I.I fc	5.6:I	2.5 : I
South Parking Garage Entry Security Lighting	+	2.6 fc	5.6 fc	0.9 fc	6.2:I	2.9:1
Walkway Egress Lighting	+	I.0 fc	2.2 fc	0.2 fc	11.0:1	5.0:I

LUMINAIRE SCHEDULE


SYMBOL	LABEL	QTY.	MANUF.	CATALOG	DESCRIPTION	FILE	MOUNTING
	A	2	LITHONIA LIGHTING	WPXI LED PI 30K MVOLT	WPXI LED WALLPAC I500lm, 3000K COLOR TEMPERATURE, I20-27 VOLTS	_30K_MVOLT.ies	8'-0" ABOVE GRADE ON BUILDING
	В	11	FC / SSL LIGHTING	FCSL102-120V-4K-SS	EXTERIOR DIE-CAST ALUMINUM STEP LIGH FOR MASONRY APPLICATIONS	F002035FCSL1024K.ies	3'-0" ABOVE GRADE ON BUILDING
			E	KAMPLE LIGHT FI		JTION X CONTOUR = 0.25 FC X CONTOUR = 0.5 FC X CONTOUR = 1.0 FC FIXTURE	

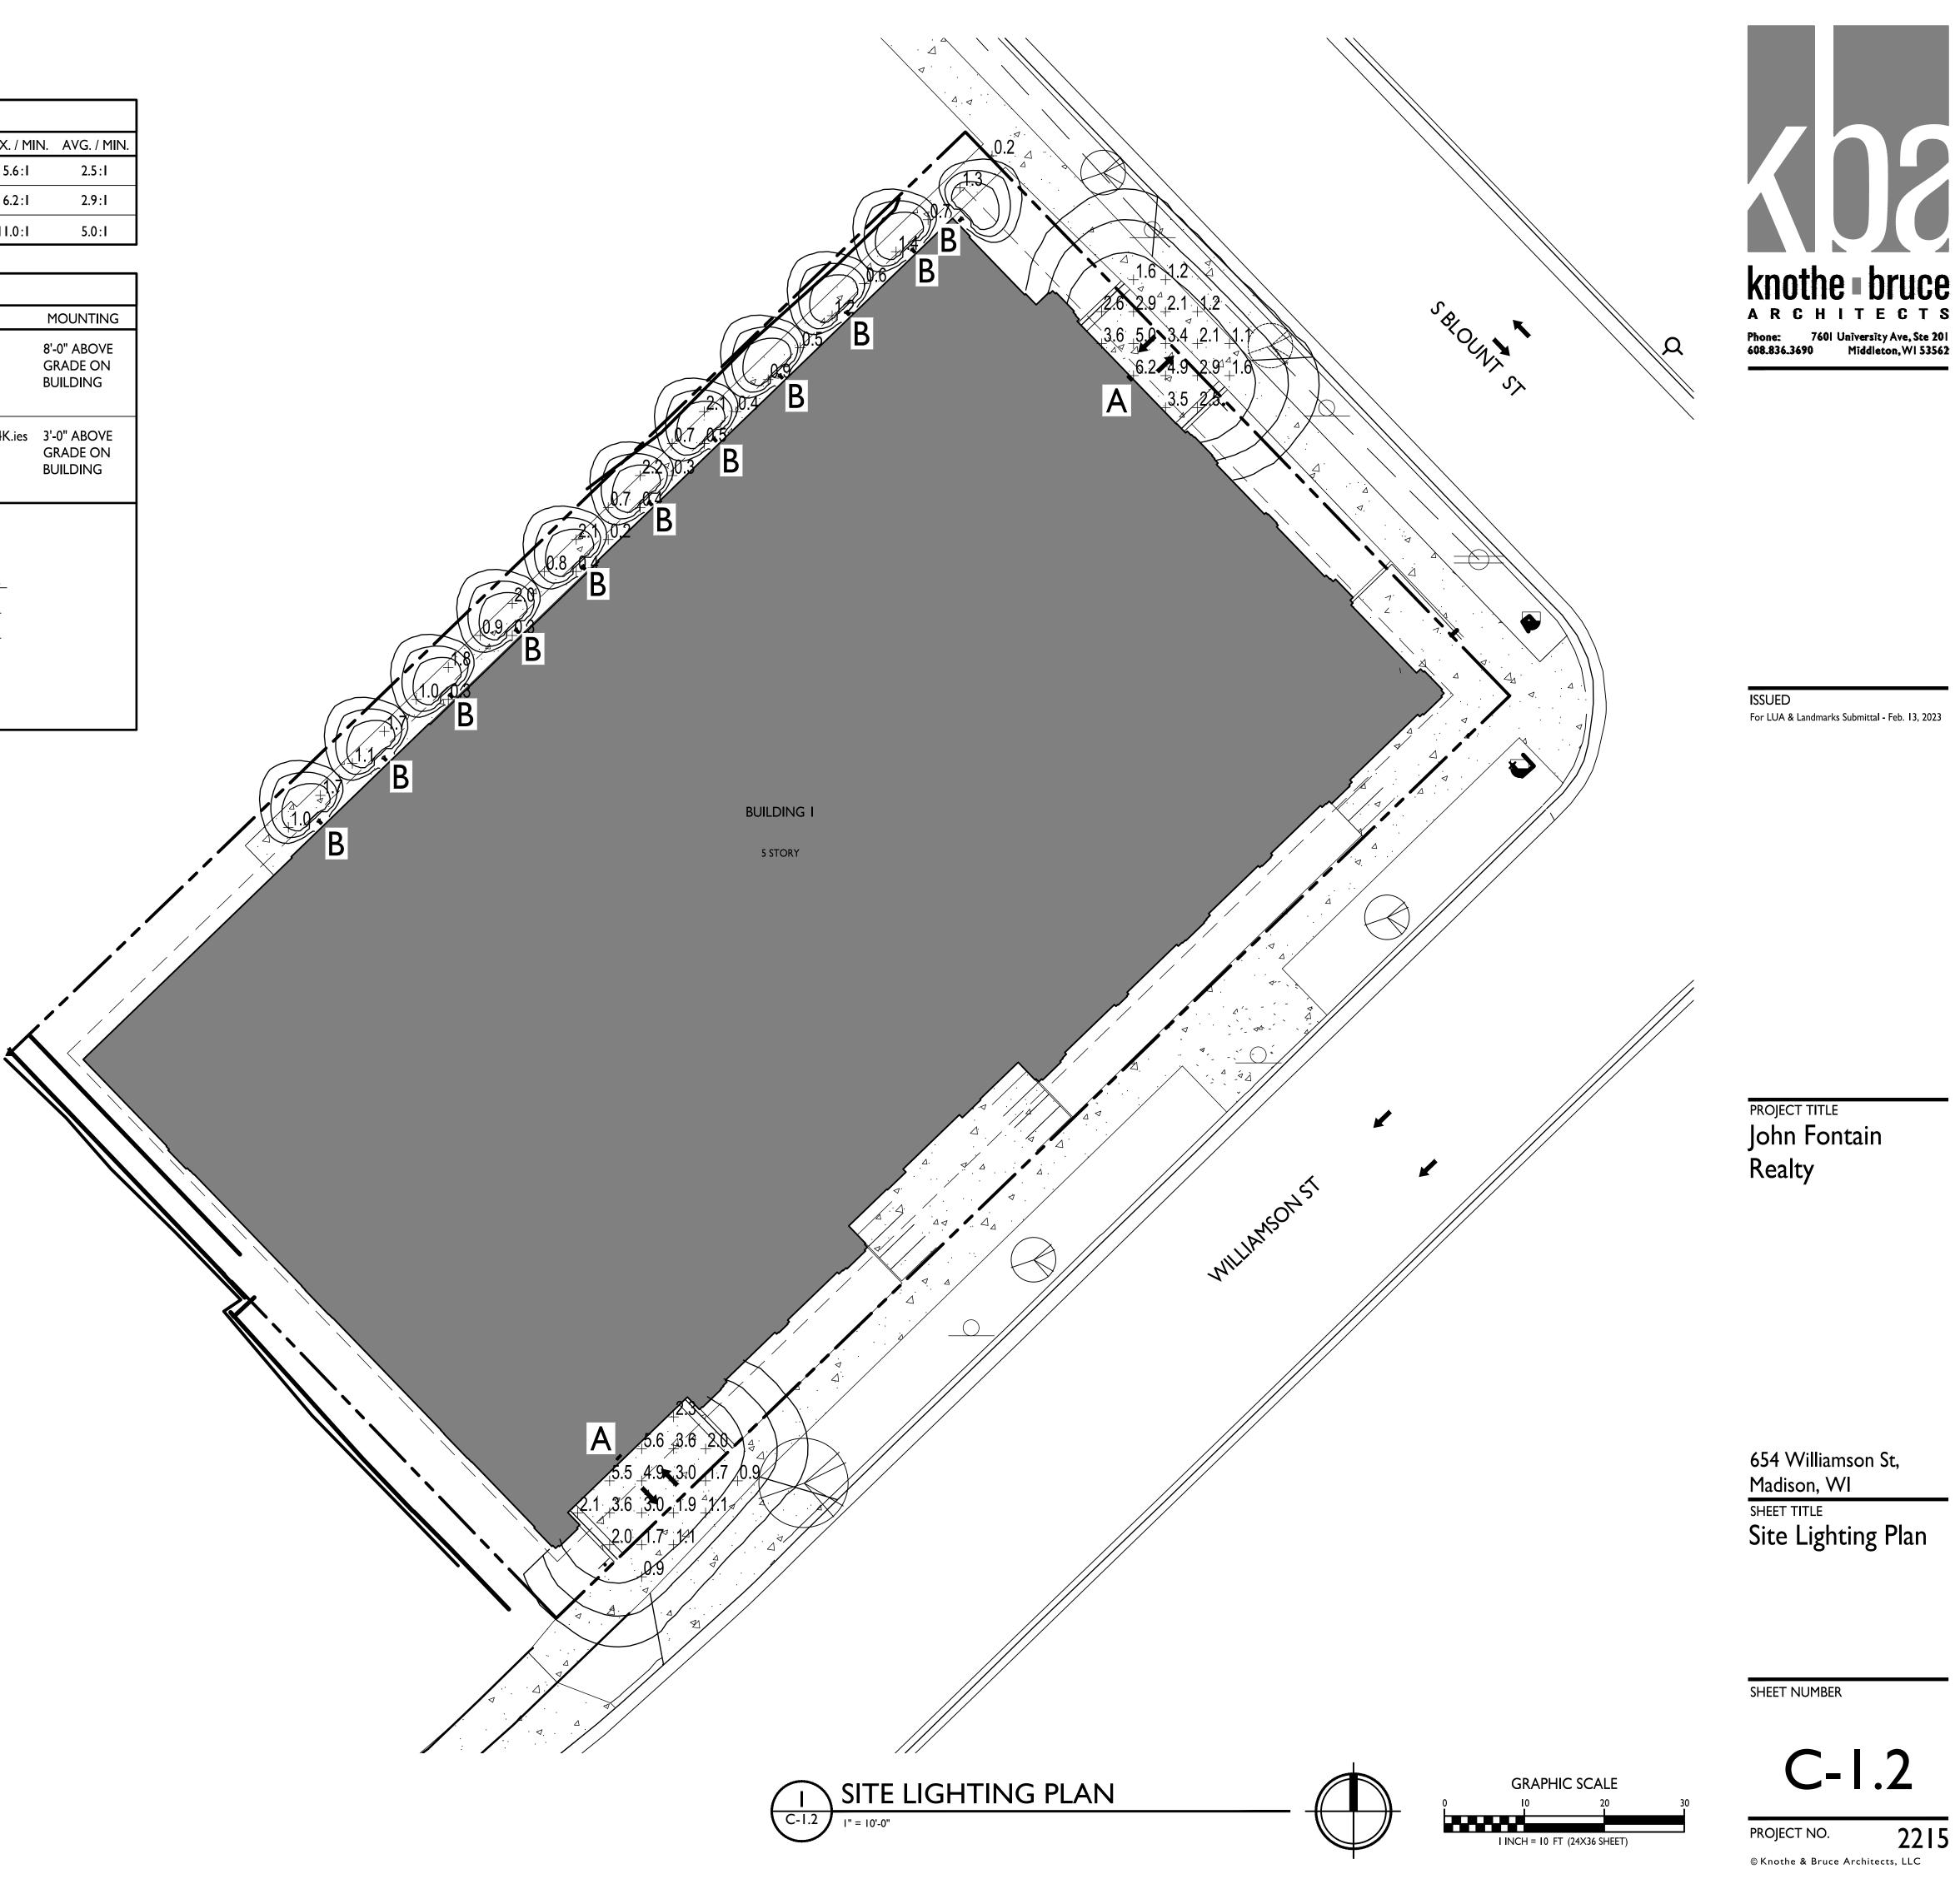

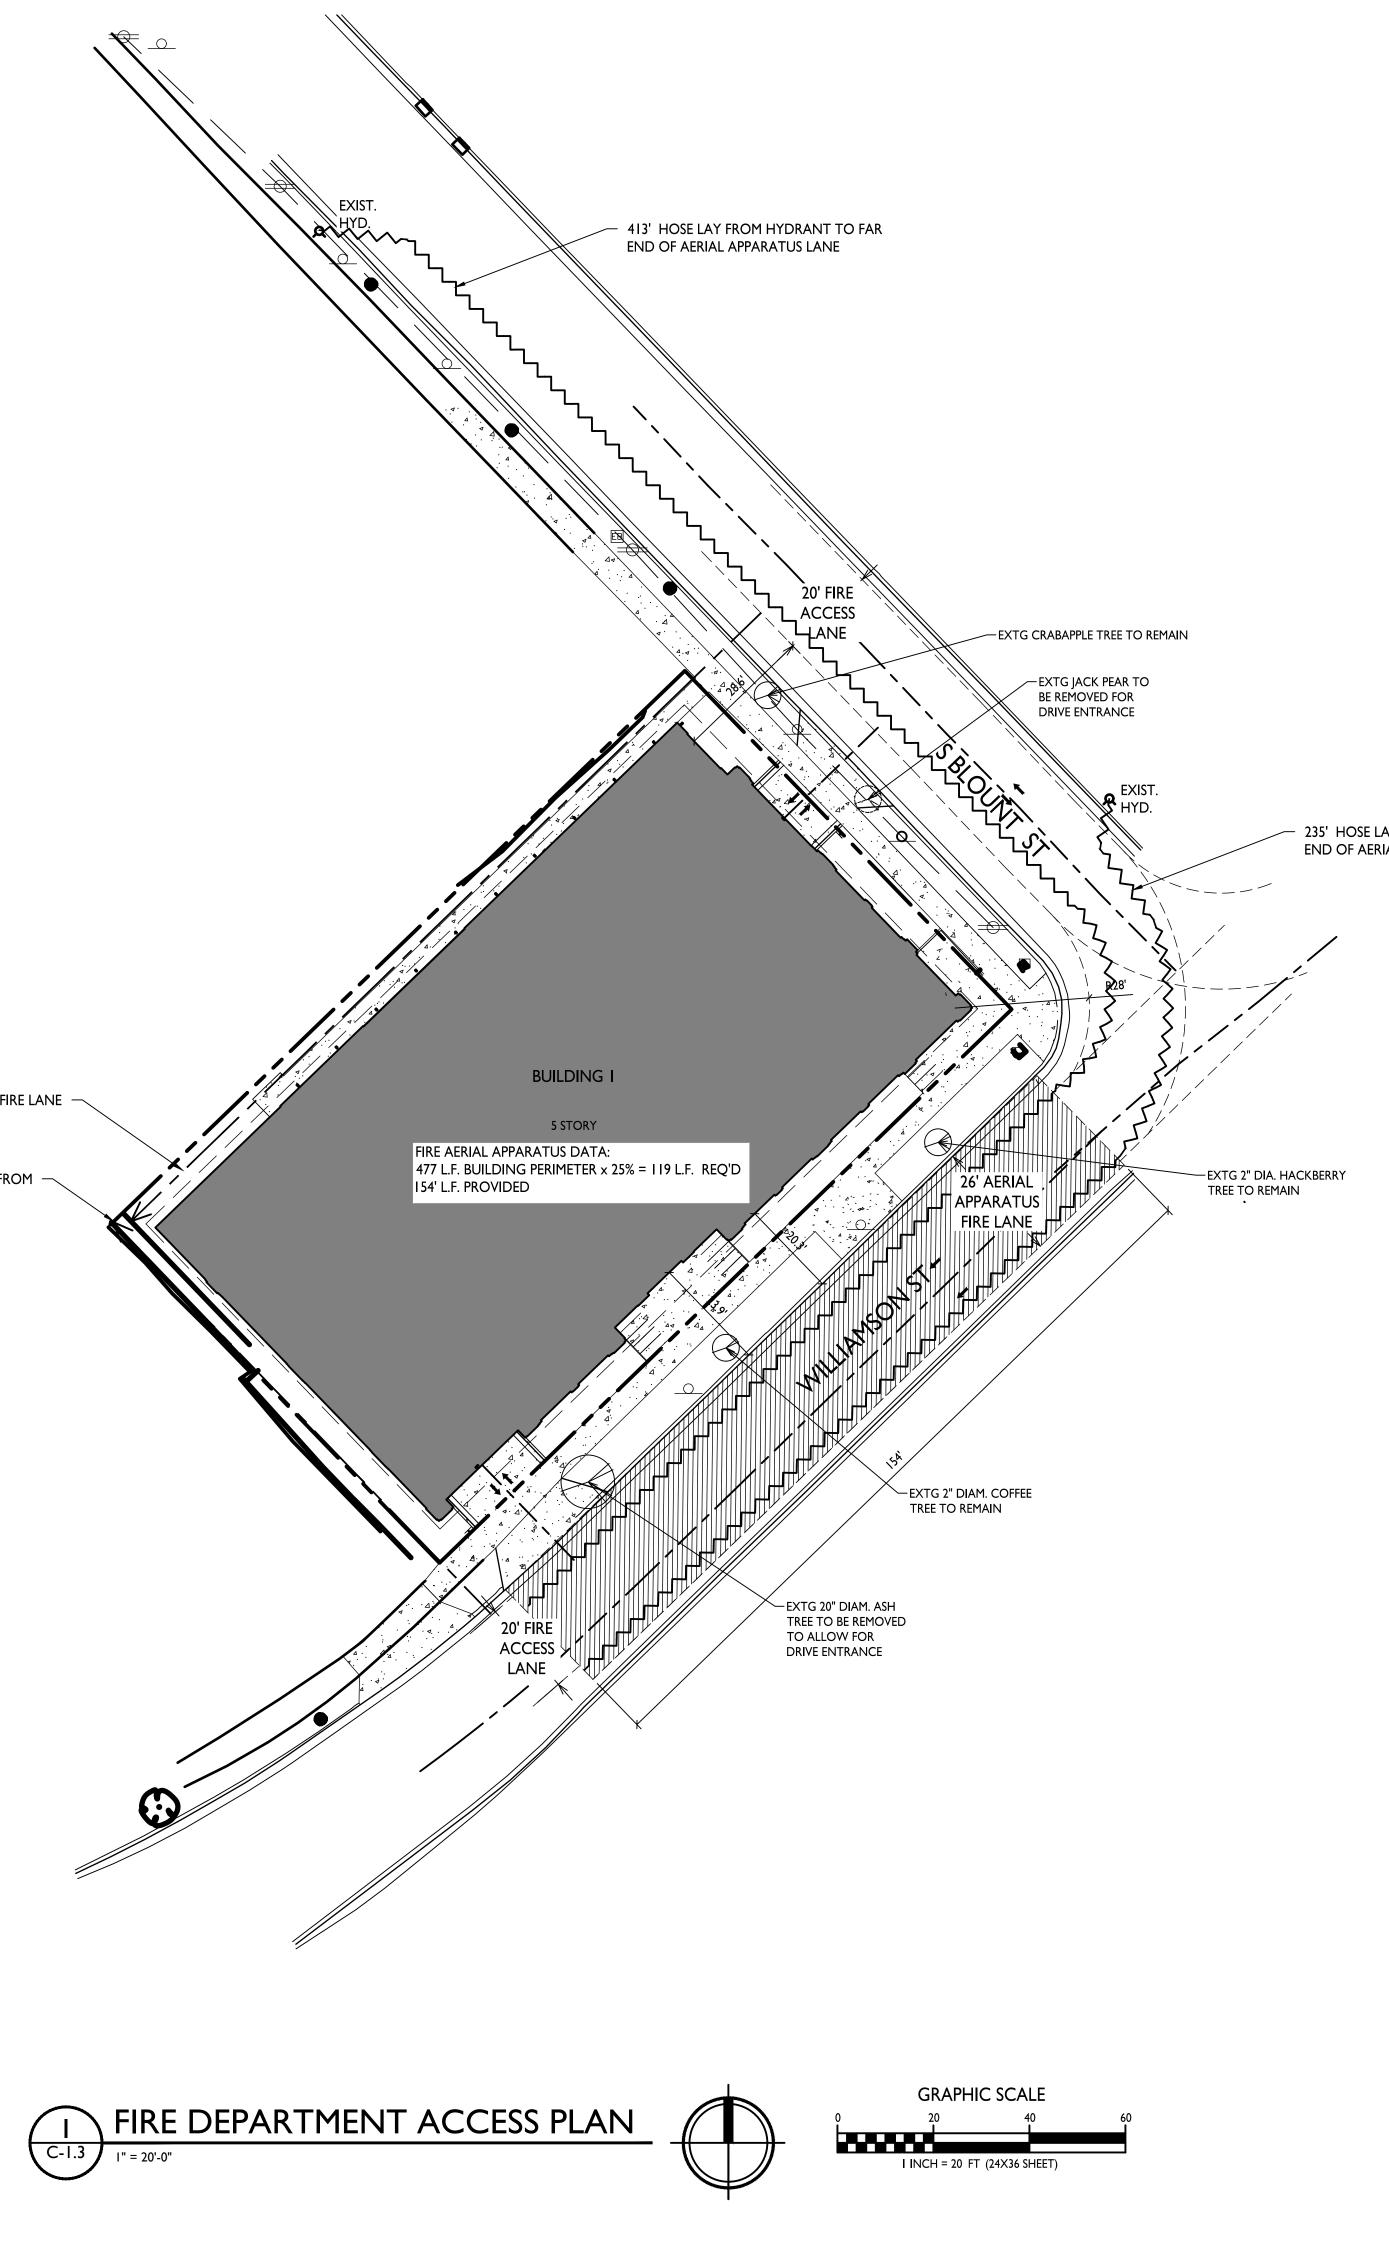

I I 3' HOSE LAY FROM — 20' FIRE LANE

182' HOSE LAY FROM 20' FIRE LANE -

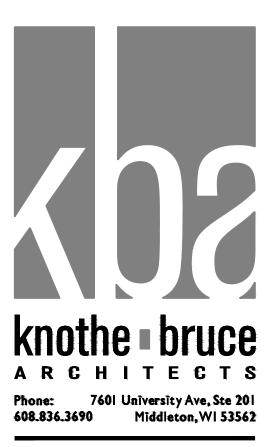

- 235' HOSE LAY FROM HYDRANT TO FAR END OF AERIAL APPARATUS LANE


ISSUED For LUA & Landmarks Submittal - Feb. 13, 2023

project title John Fontain Realty

654 Williamson St, Madison, WI SHEET TITLE Fire Department Access Plan

SHEET NUMBER

C-1.3 PROJECT NO. 2215 © Knothe & Bruce Architects, LLC

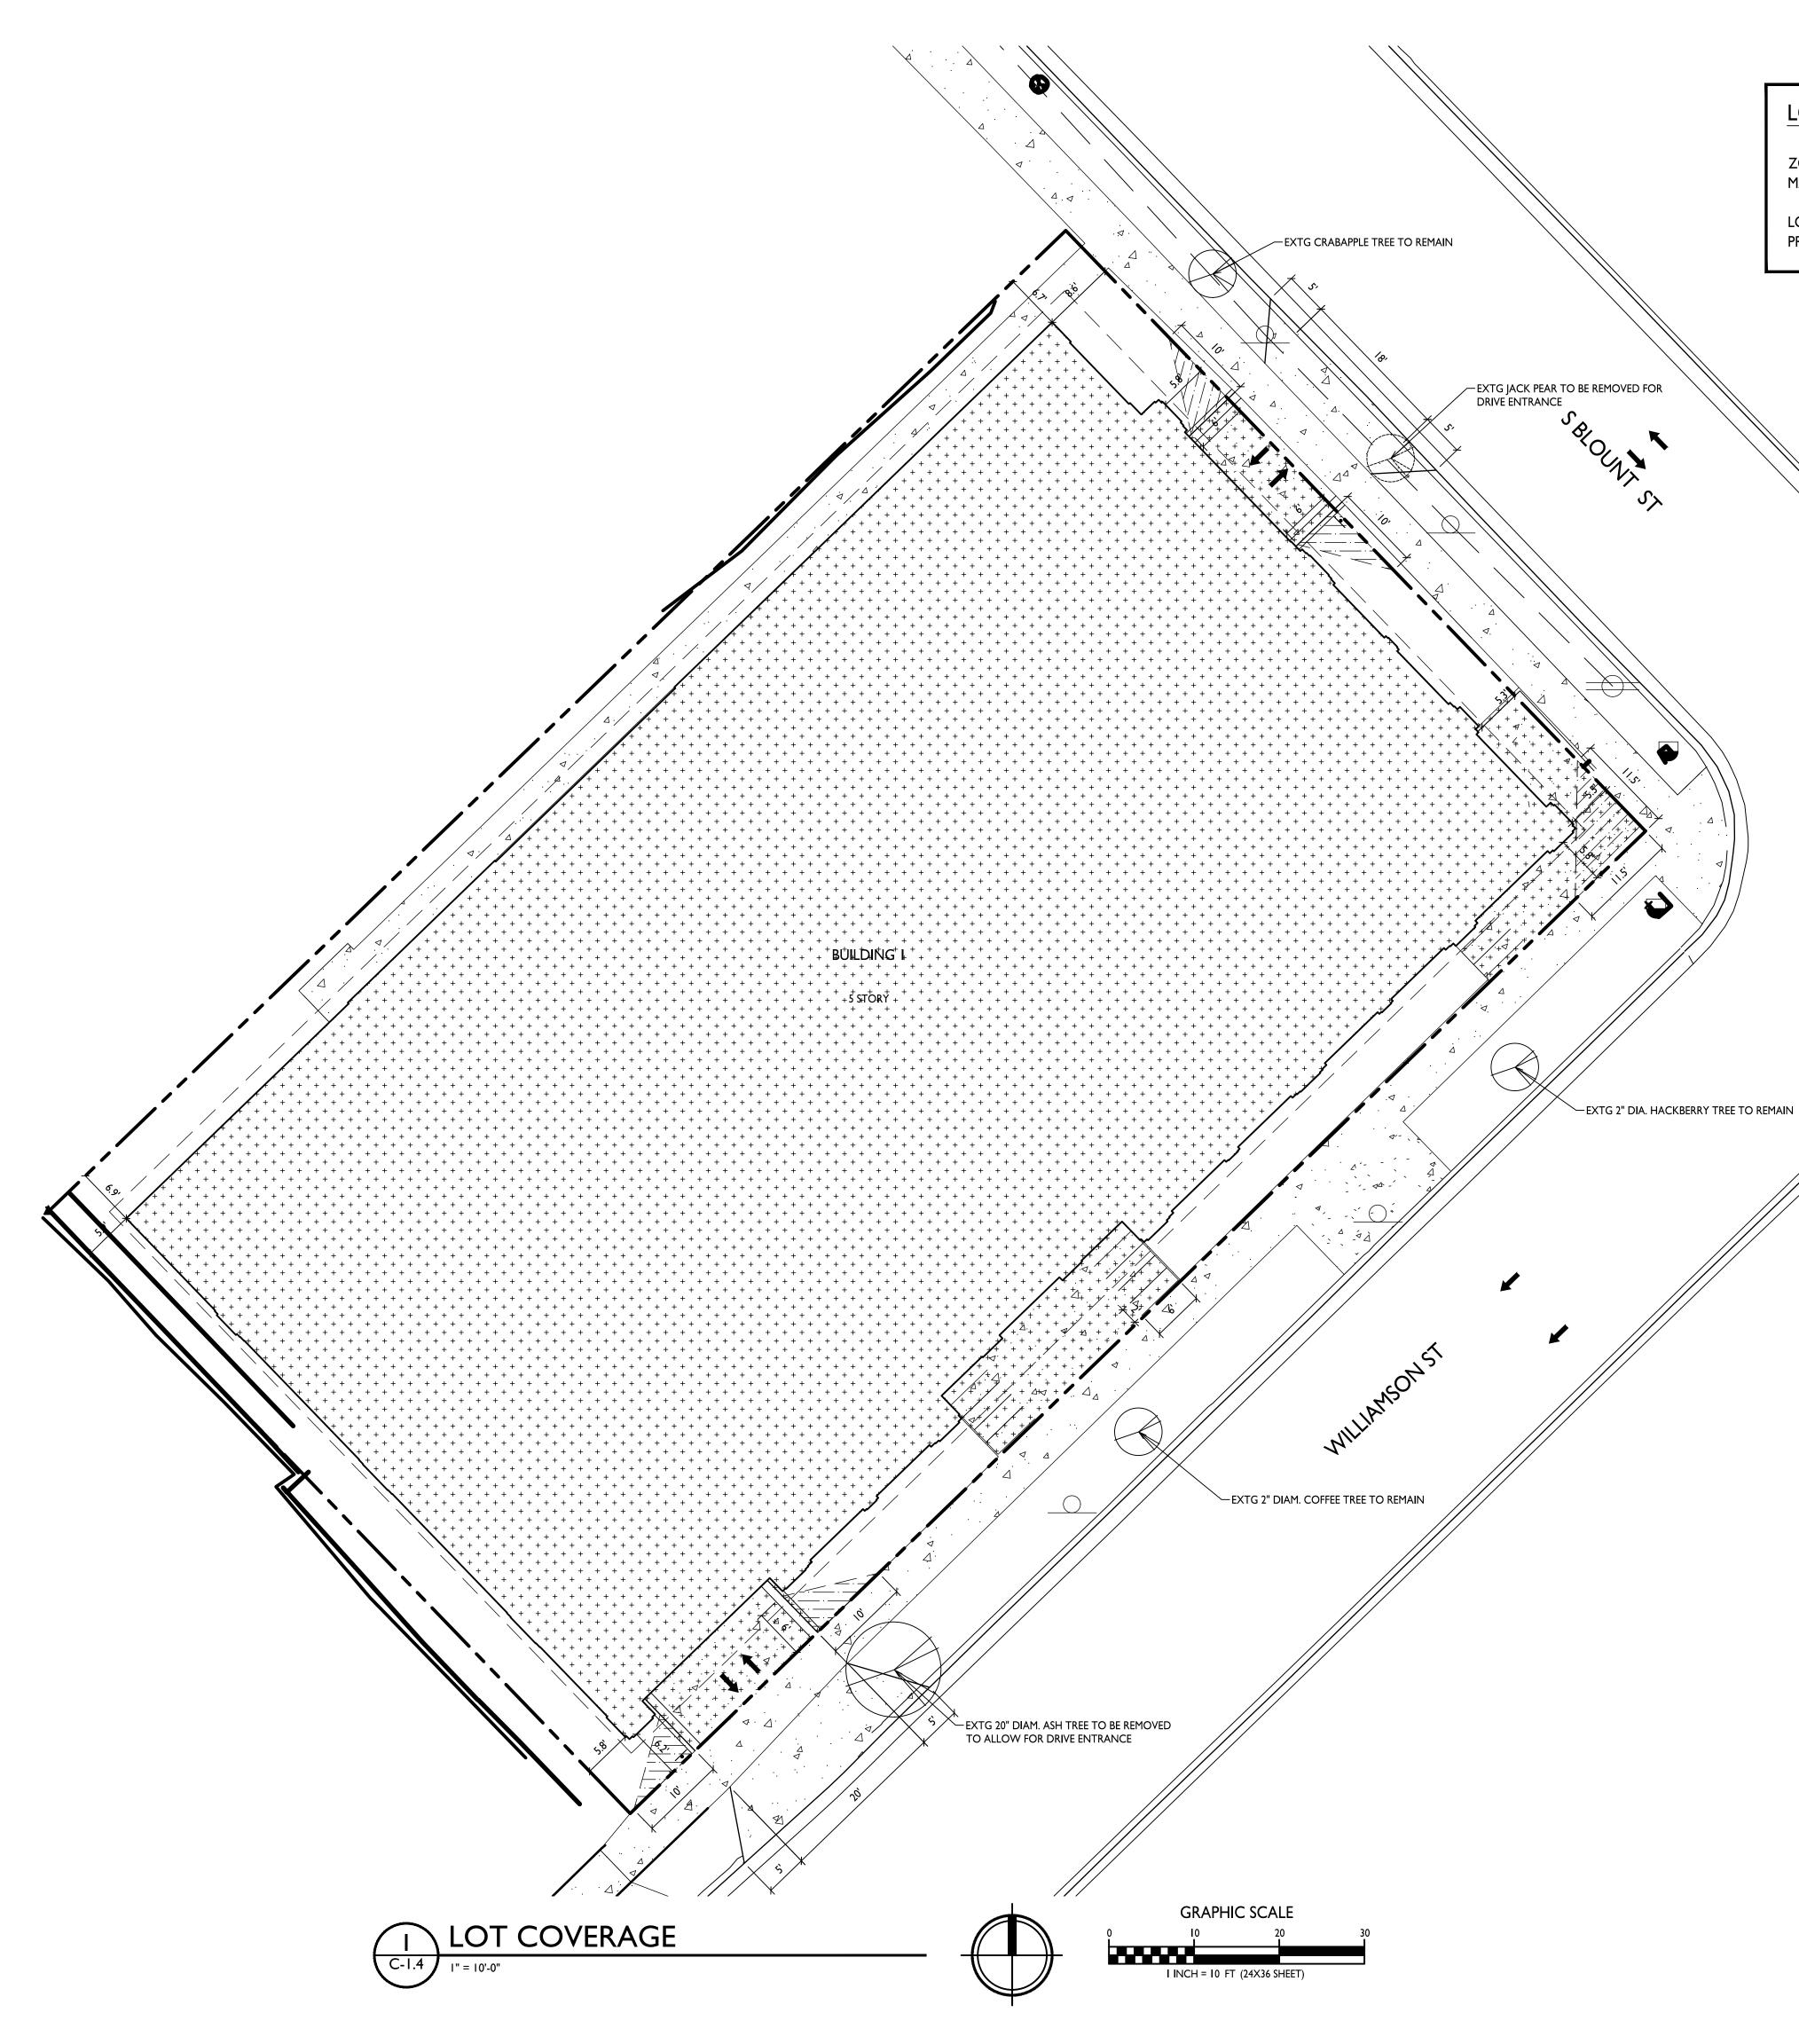

LOT COVERAGE

ZONING TRAD MAXIMUM LOT COVERAGE 85%

16,279 S.F. 13,717 S.F. / 84.2% ARCHITECTS Mone Procession of the second Middleton, WI 53562

lot area Proposed coverage


> ISSUED For LUA & Landmarks Submittal - Feb. 13, 2023


PROJECT TITLE John Fontain Realty

654 Williamson St, Madison, WI SHEET TITLE Lot Coverage


SHEET NUMBER

C-1.4 PROJECT NO. 2215

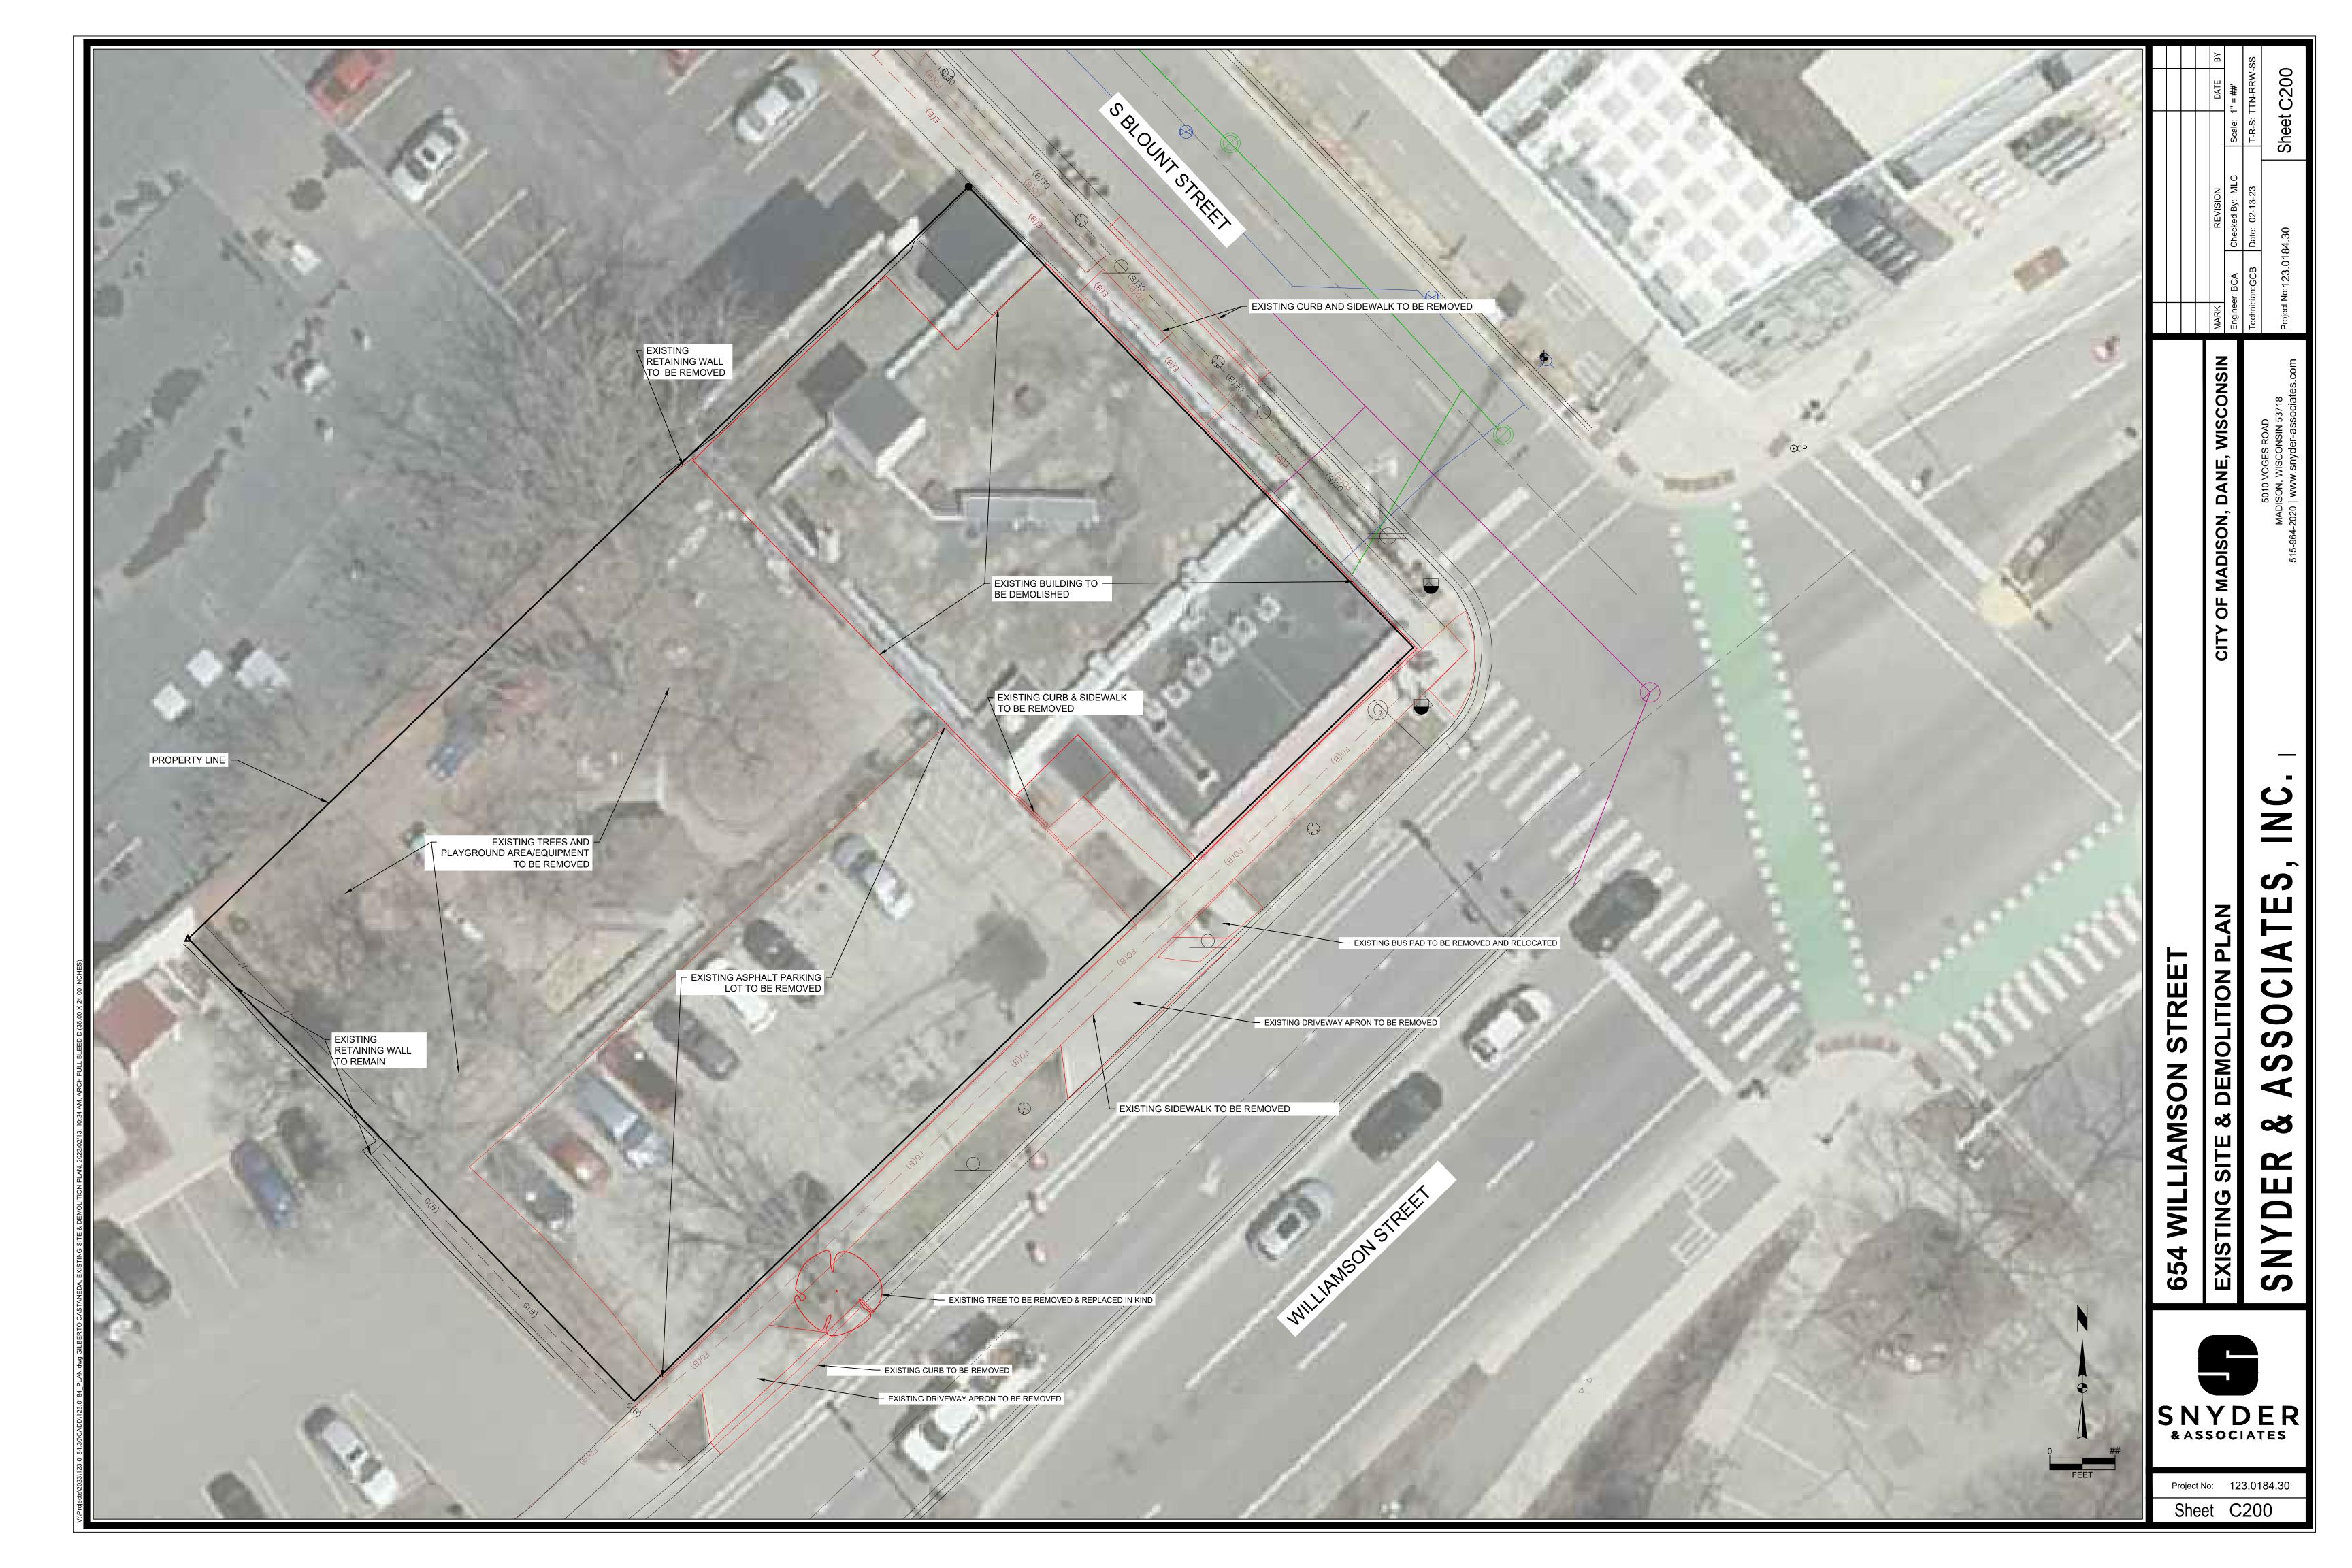

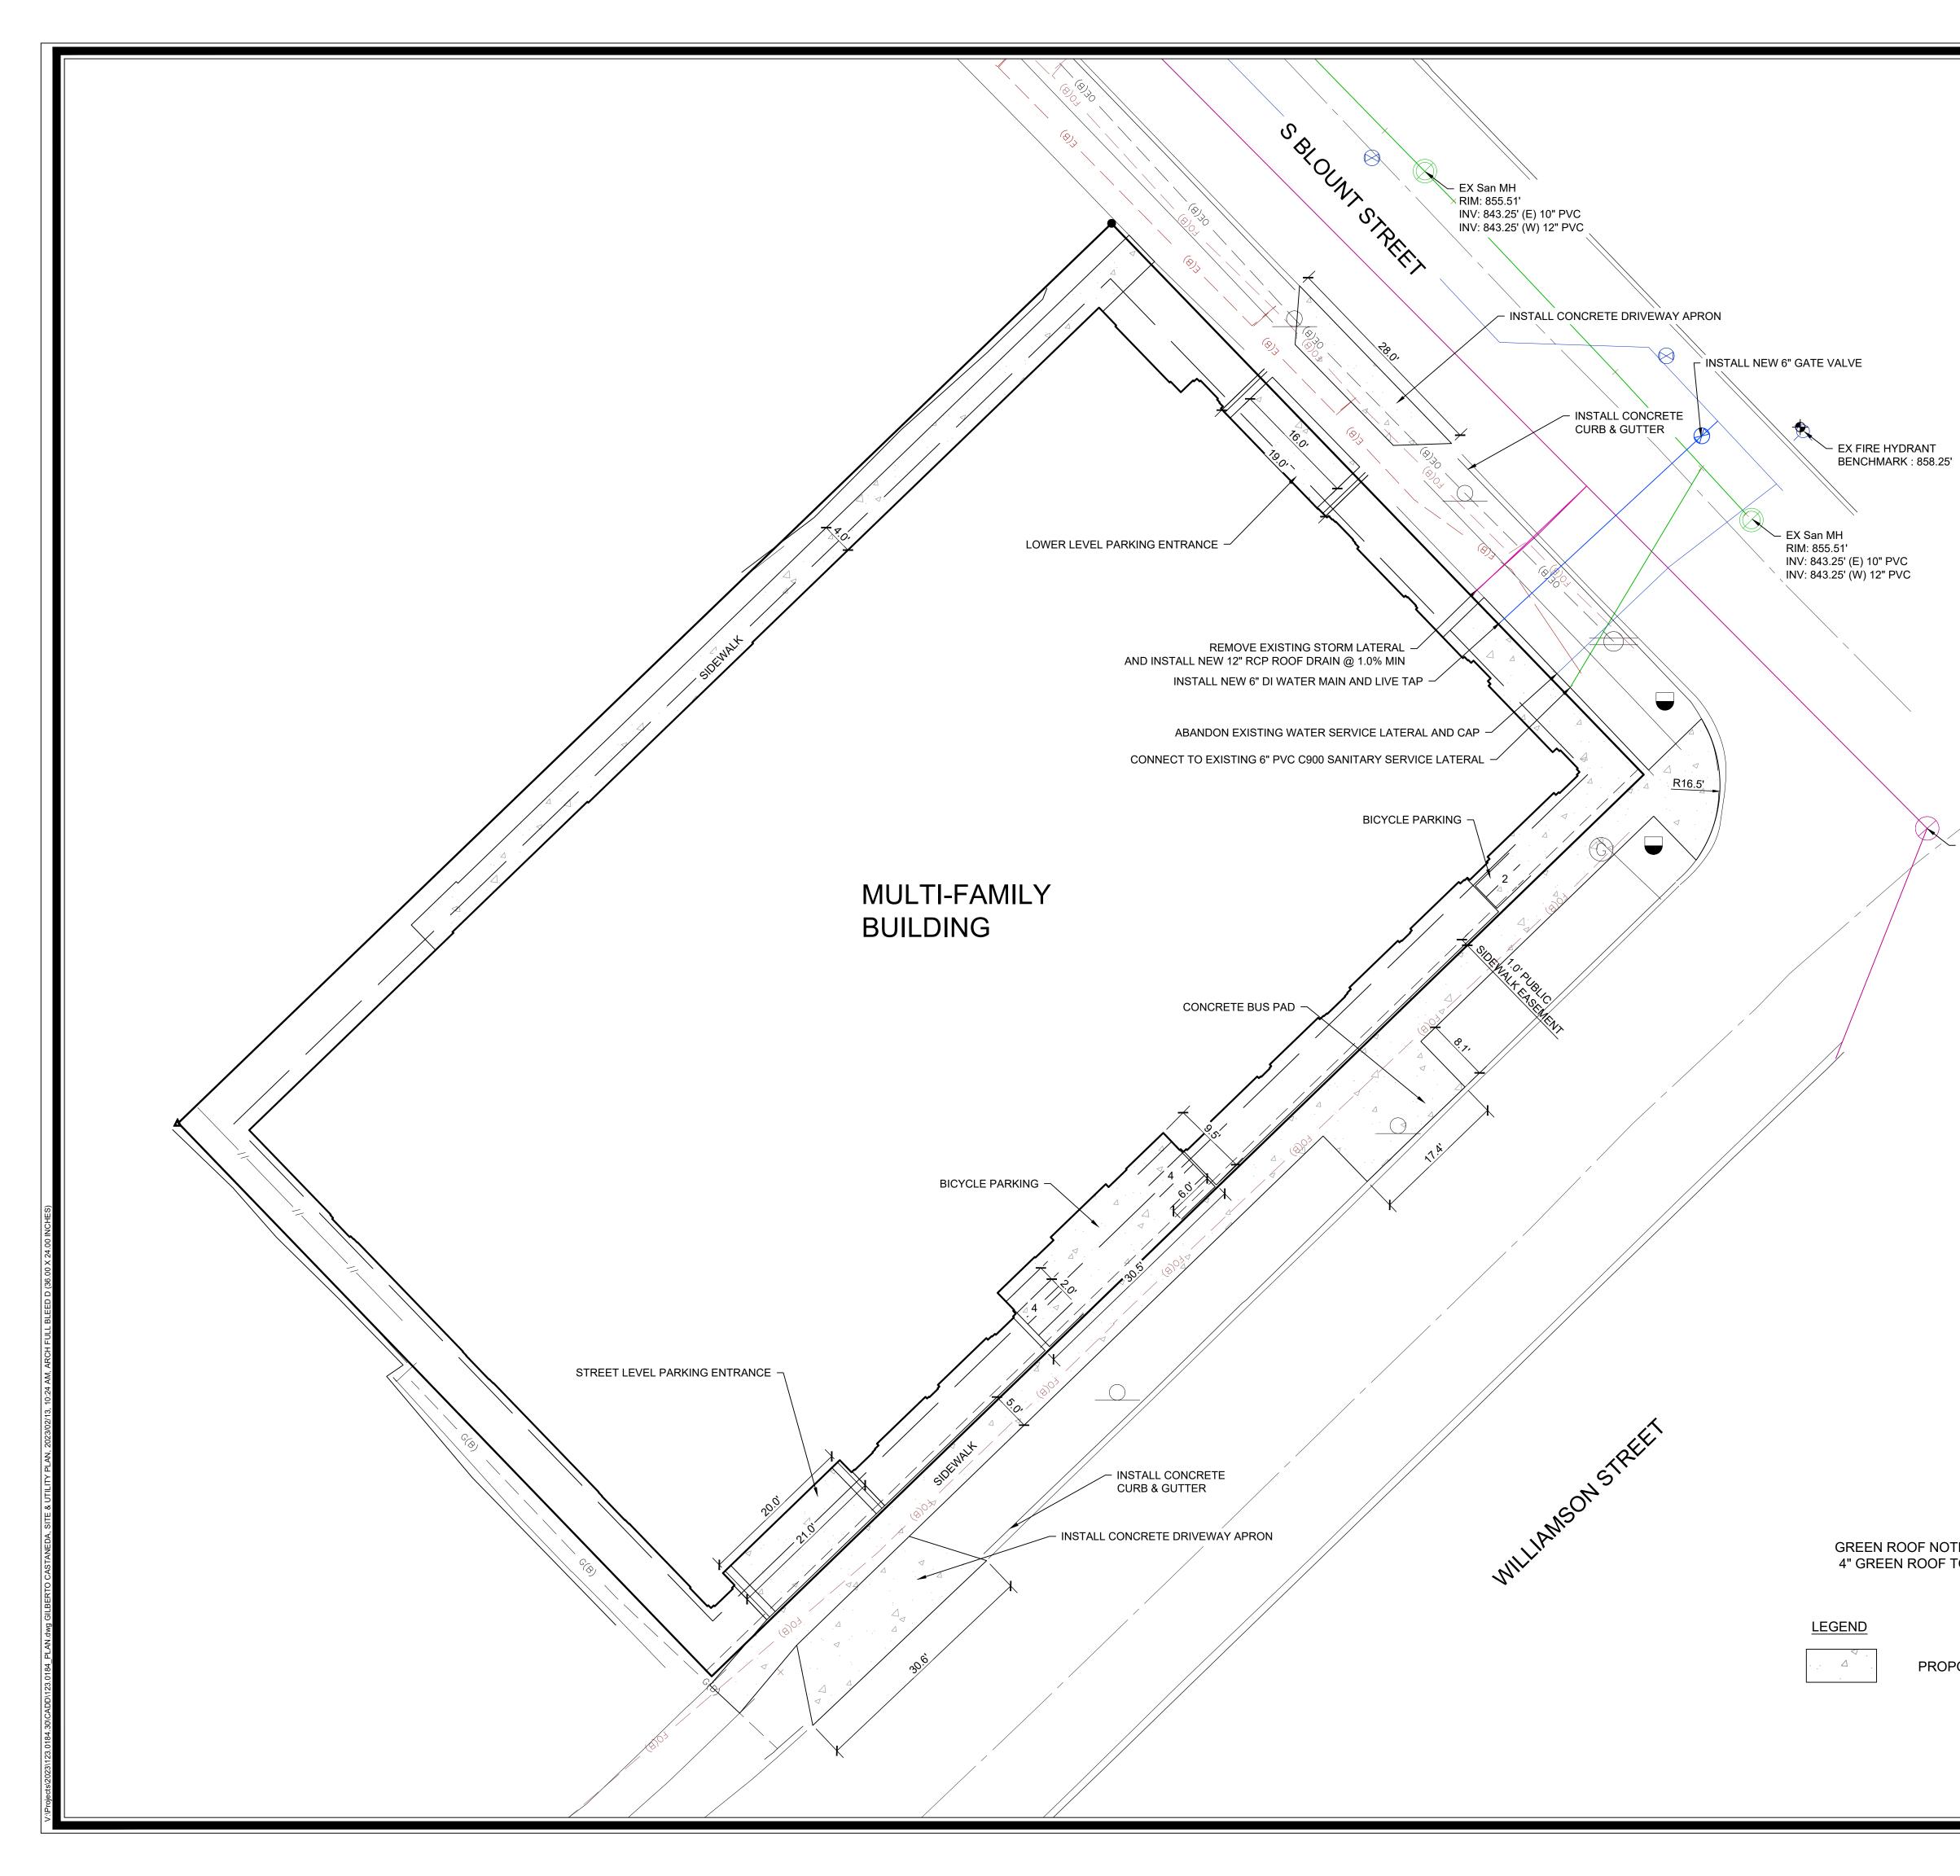

			REVISION DATE BY Checked Bv: MLC Scale: 1" = ##"		84.30 Sheet C300
5 ⁷ CCP			CITY OF MADISON, DANE, WISCONSIN	Technician:GCB	515-964-2020 www.snyder-associates.com
EX AS #5349-003 RIM: 858.07 INV: 853.14 (SW) 10" PVC INV: 843.59 (NE) 8"VCP INV: 843.55 (NE) 8"VCP		654 WILLIAMSON STREET	SITE & UTILITY PLAN		SNYDER & ASSOCIATES, INC.
POSED CONCRETE SIDEWALK OR DRIVEWAY APRON	0 ## FEET	SN & AS Project She	SOC No: 1:	23.01	" E S 84.30

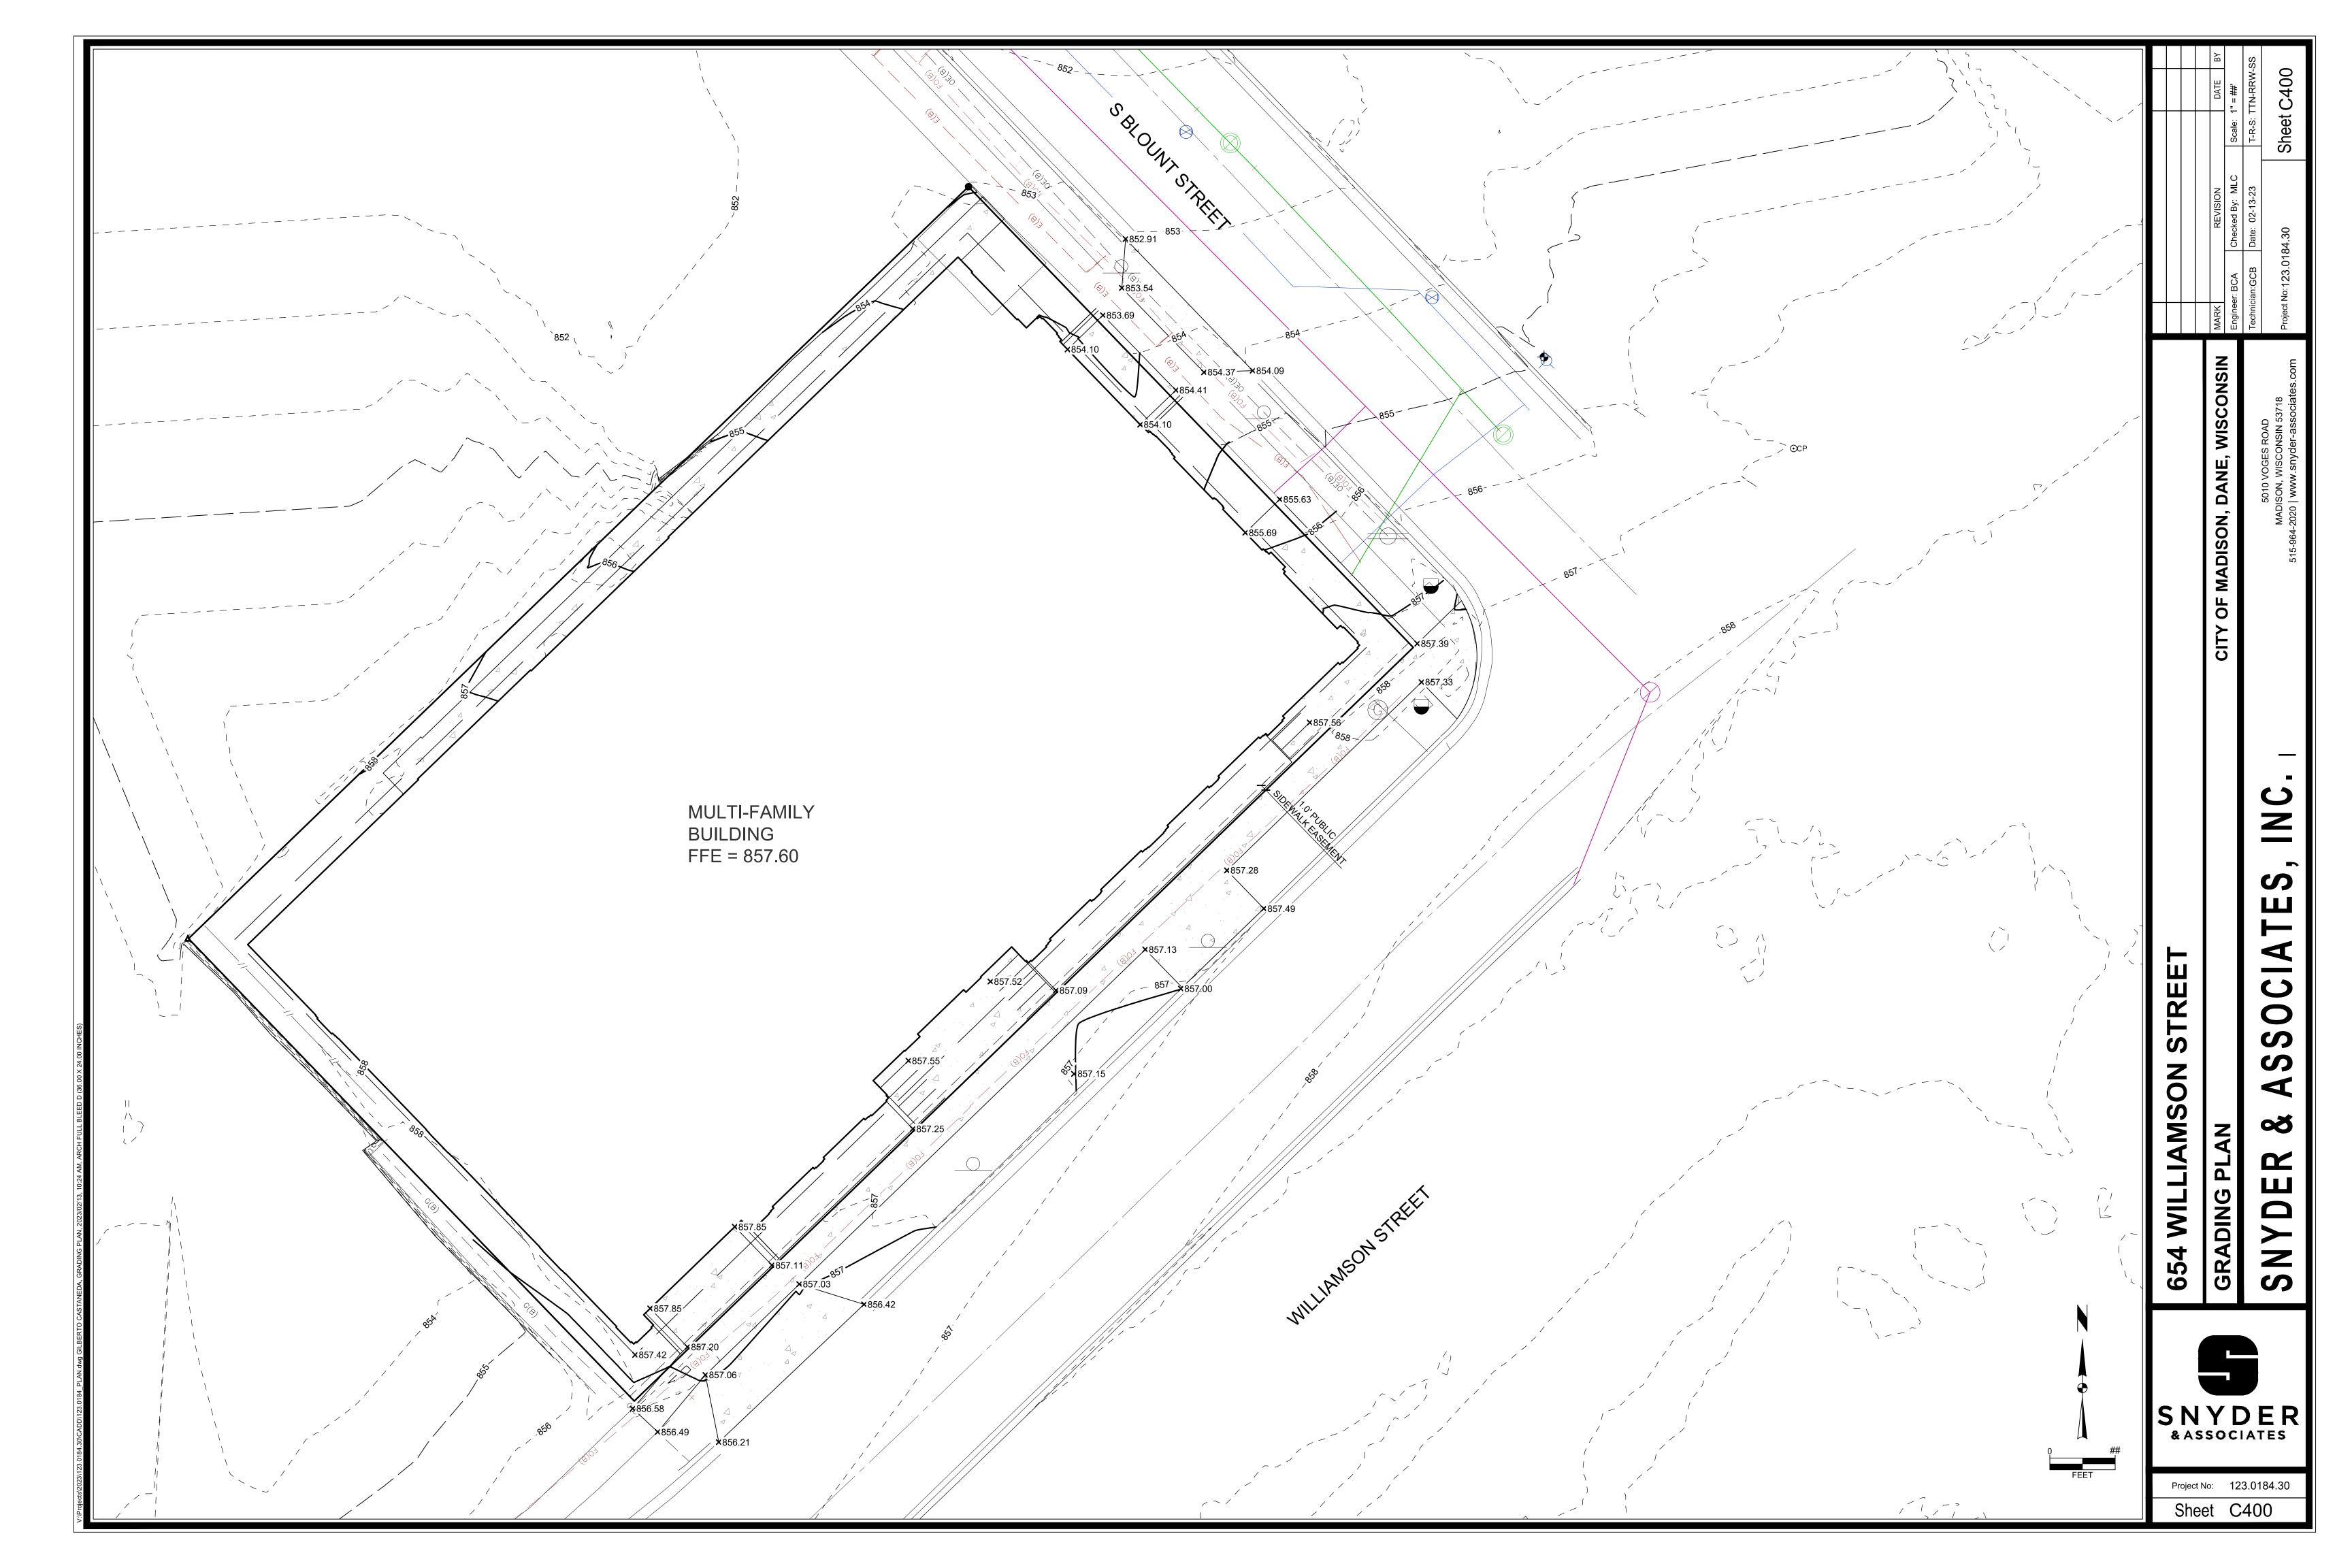

GENERAL NOTES:

I. THE APPLICANT SHALL REPLACE ALL SIDEWALK AND CURB AND GUTTER THAT ABUTS THE PROPERTY THAT IS DAMAGED BY THE CONSTRUCTION, OR ANY SIDEWALK AND CURB AND GUTTER WHICH THE CITY ENGINEER DETERMINES NEEDS TO BE REPLACED BECAUSE IT IS NOT AT A DESIRABLE GRADE, REGARDLESS OF WHETHER THE CONDITION EXISTED PRIOR TO BEGINNING CONSTRUCTION.

2. ALL WORK IN THE PUBLIC RIGHT OF WAY SHALL BE PERFORMED BY A CITY-LICENSED CONTRACTOR.

3. ALL DAMAGE TO THE PAVEMENT ON CITY STREETS, AND ADJACENT TO THIS DEVELOPMENT SHALL BE RESTORED IN ACCORDANCE WITH THE CITY OF MADISON'S PAVEMENT PATCHING CRITERIA.

4. ALL PROPOSED STREET TREE REMOVALS WITHIN THE RIGHT OF WAY SHALL BE REVIEWED BY CITY FORESTRY BEFORE THE PLAN COMMISSION MEETING. STREET TREE REMOVALS REQUIRE APPROVAL AND A TREE REMOVAL PERMIT ISSUED BY CITY FORESTRY. ANY STREET TREE REMOVALS **REQUESTED AFTER THE DEVELOPMENT PLAN IS** APPROVED BY THE PLAN COMMISSION OR THE BOARD OF PUBLIC WORKS AND CITY FORESTRY WILL REQUIRE A MINIMUM OF A 72-HOUR REVIEW PERIOD WHICH SHALL INCLUDE THE NOTIFICATION OF THE ALDERPERSON WITHIN WHO'S DISTRICT IS AFFECTED BY THE STREET TREE REMOVAL(S) PRIOR TO A TREE REMOVAL PERMIT BEING ISSUED.

5. AS DEFINED BY THE SECTION 107.13 OF CITY OF MADISON STANDARD SPECIFICATIONS FOR PUBLIC WORKS CONSTRUCTION: NO EXCAVATION IS PERMITTED WITHIN 5 FEET OF THE TRUNK OF THE STREET TREE OR WHEN CUTTING ROOTS OVER 3 INCHES IN DIAMETER. IF EXCAVATION IS NECESSARY, THE CONTRACTOR SHALL CONTACT MADISON CITY FORESTRY (266-4816) PRIOR TO EXCAVATION. CITY OF MADISON FORESTRY PERSONNEL SHALL ASSESS THE IMPACT TO THE TREE AND TO ITS ROOT SYSTEM PRIOR TO WORK COMMENCING. TREE PROTECTION SPECIFICATIONS CAN BE FOUND ON THE FOLLOWING WEBSITE:

CITYOFMADISON.COM/BUSINESS/PW/SPECS.CFM

6. CONTRACTOR SHALL TAKE PRECAUTIONS DURING CONSTRUCTION TO NOT DISFIGURE, SCAR, OR IMPAIR THE HEALTH OF ANY STREET TREE. CONTRACTOR SHALL OPERATE EQUIPMENT IN A MANNER AS TO NOT DAMAGE THE BRANCHES OF THE STREET TREE(S). THIS MAY REQUIRE USING SMALLER EQUIPMENT AND LOADING AND UNLOADING MATERIALS IN A DESIGNATED SPACE AWAY FROM TREES ON THE CONSTRUCTION SITE. ANY DAMAGE OR INJURY TO EXISTING STREET TREES (EITHER ABOVE OR BELOW GROUND) SHALL BE REPORTED IMMEDIATELY TO CITY FORESTRY AT 266-4816. PENALTIES AND REMEDIATION SHALL BE REQUIRED.

7. SECTION 107.13(G) OF CITY OF MADISON STANDARD SPECIFICATIONS FOR PUBLIC WORKS CONSTRUCTION ADDRESSES SOIL COMPACTION NEAR STREET TREES AND SHALL BE FOLLOWED BY CONTRACTOR. THE STORAGE OF PARKED VEHICLES, CONSTRUCTION EQUIPMENT, BUILDING MATERIALS, REFUSE, EXCAVATED SPOILS OR DUMPING OF POISONOUS MATERIALS ON OR AROUND TREES AND ROOTS WITHIN FIVE (5) FEET OF THE TREE OR WITHIN THE PROTECTION ZONE IS PROHIBITED.

8. ON THIS PROJECT, STREET TREE PROTECTION ZONE FENCING IS REQUIRED. THE FENCING SHALL BE ERECTED BEFORE THE DEMOLITION, GRADING OR CONSTRUCTION BEGINS. THE FENCE SHALL INCLUDE THE ENTIRE WIDTH OF TERRACE AND, EXTEND AT LEAST 5 FEET ON BOTH SIDES OF THE OUTSIDE EDGE OF THE TREE TRUNK. DO NOT REMOVE THE FENCING TO ALLOW FOR DELIVERIES OR EQUIPMENT ACCESS THROUGH THE TREE PROTECTION ZONE.

9. STREET TREE PRUNING SHALL BE COORDINATED WITH MADISON FORESTRY AT A MINIMUM OF TWO WEEKS PRIOR TO THE START OF CONSTRUCTION FOR THIS PROJECT. ALL PRUNING SHALL FOLLOW THE AMERICAN NATIONAL STANDARDS INSTITUTE (ANSI) A300 - PART I STANDARDS FOR PRUNING.


10. AT LEAST ONE WEEK PRIOR TO STREET TREE PLANTING, CONTRACTOR SHALL CONTACT CITY FORESTRY AT (608) 266-4816 TO SCHEDULE INSPECTION AND APPROVAL OF NURSERY TREE STOCK AND REVIEW PLANTING SPECIFICATIONS WITH THE LANDSCAPER.

II. APPROVAL OF PLANS FOR THIS PROJECT DOES NOT INCLUDE ANY APPROVAL TO PRUNE, REMOVE, OR PLANT TREES IN THE PUBLIC RIGHT-OF-WAY. PERMISSION FOR SUCH ACTIVITIES MUST BE OBTAINED FROM THE CITY FORESTER (266-4816).

12. THE PUBLIC RIGHT-OF-WAY IS THE SOLE JURISDICTION OF THE CITY OF MADISON AND IS SUBJECT TO CHANGE AT ANY TIME. NO ITEMS SHOWN ON THIS SITE PLAN IN THE RIGHT-OF-WAY ARE PERMANENT AND MAY NEED TO BE REMOVED AT THE APPLICANTS EXPENSE UPON NOTIFICATION BY THE CITY.

EDGE — BARK MULCH-

-(2) CSA

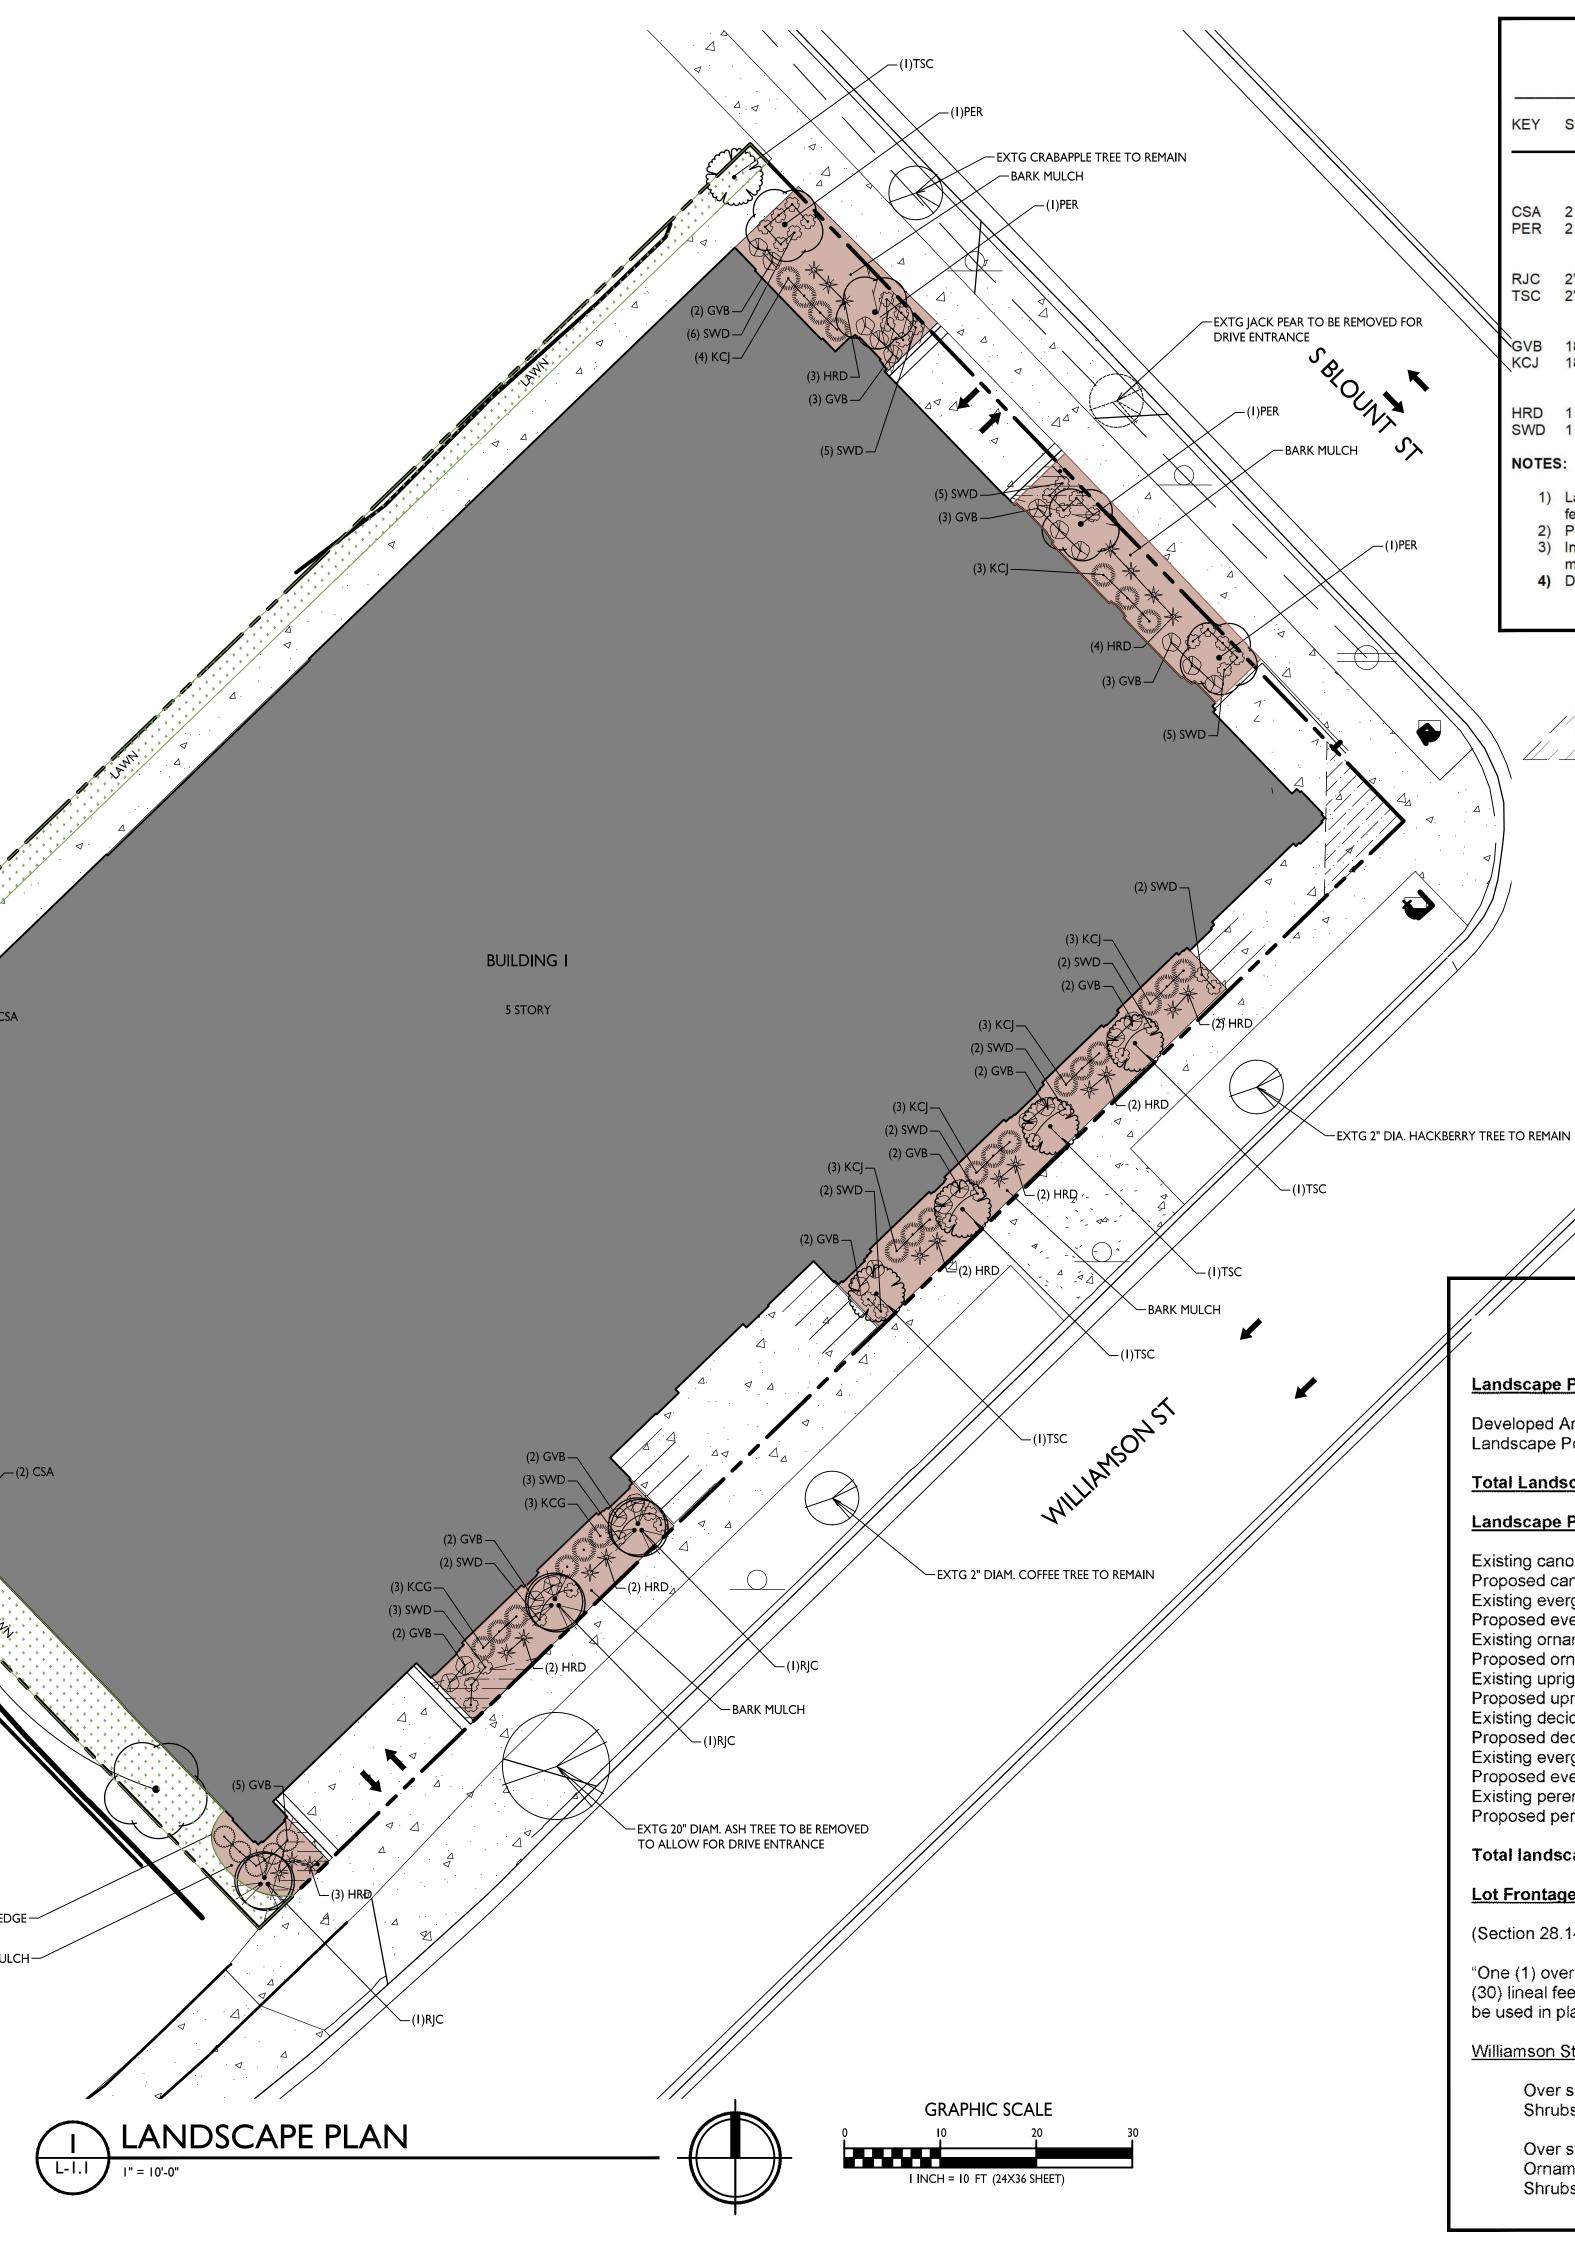

				PLANT LIS 654 Williamson Stree		
	KEY	SIZE	QUAN	COMMON NAME	Botanical Name	ROOT
	CSA PER	2 ½" 2 ½"	(8) 4 4 (8)	<u>Canopy Trees</u> Columnar Swedish Aspen Pyramidal English Oak <u>Ornamental Trees</u>	Populus Tremula 'Erecta" Quercus Robar ''Fastigiata'	BB BB
	RJC TSC	2" 2"	3 5	Red Jade Crab Tina Sargent Crab	Malus 'Red Jade' Tina Malus Sargentii 'Tina'	BB BB
/ //	GVB KCJ	18" 18"	(55) 30 25	Evergreen Shrubs Green Velvet Boxwood Kallay Compact Juniper	Buxus 'Green Velvet' Juniperus C 'Kallay's Compact'	Con Con
	HRD SWD	1 G 1 G	(62) 22 40	<u>Perennials</u> Happy Returns Day Lily Summer Wine Day Lily	Hemerocallis 'Happy Returns' Hemerocallis 'Summer Wine'	Con Con
	NOTES	S:				



1) Lawn areas to receive a minimum of 4" of topsoil, premium bluegrass seed mix, starter

fertilizer, and straw mat mulch. 2) Planting beds to be mulched with shredded hardwood bark spread to a depth of 3".


3) Individual trees and shrub groupings in lawn areas to receive shredded hardwood bark


mulch spread to a depth of 3" 4) Designated planting beds to be separated from lawn areas with 5" black vinyl bed edging.

> VISION TRIANGLE: NO OBSTRUCTIONS BETWEEN THE HEIGHT OF 30" AND 10' WITHIN HATCHED AREAS.

> > ISSUED For LUA & Landmarks Submittal - Feb. 13, 2023

	` <u>APE WORKSHEET</u> Iliamson Street		PROJECT TITLE
Landscape Points Required			John Fontain
Developed Area = Landscape Points: 1,506/300 x 5 =	an an an an an an ann an an ann an an an	1,506 SF <u>25 points</u>	Realty
Total Landscape Points Required		25 points	5
Existing canopy trees – 0 @ 35 = Proposed canopy trees – 8 @ 35 = Existing evergreen trees – 0 @ 35 = Proposed evergreen trees – 0 @ 35 = Existing ornamental trees - 0 @ 15 = Proposed ornamental trees - 8 @ 15 = Existing upright evergreen shrubs – 0 @ Proposed upright evergreen shrubs – 0 @ Existing deciduous shrubs – 0 @ 3 = Proposed deciduous shrubs – 0 @ 3 = Existing evergreen shrubs – 0 @ 4 = Proposed evergreen shrubs – 55 @ 4 = Existing perennials & grasses 0 @ 2 = Proposed perennials & grasses 62 @ 2 Total landscape points supplied = Lot Frontage Landscape Required	@ 10 = **********************************	0 points 280 points 0 points 0 points 120 points 120 points 0 points 0 points 0 points 220 points 124 points 124 points	654 Williamson St, Madison, WI SHEET TITLE Landscape Plan
(Section 28.142(5) Development Fronta "One (1) over-story deciduous tree and (30) lineal feet of lot frontage. Two (2) of be used in place of one (1) over-story d <u>Williamson Street & South Blount Stree</u> Over story trees required 263.9'/ Shrubs required (263.9'/30') x 5 s	five (5) shrubs shall be planted fo rnamental trees or two (2) evergr eciduous tree." <u>t</u> = 30' =8.79	een trees may 263.9 LF <u>9 trees</u> <u>44 shrubs</u>	
Over story trees supplied Ornamental/Evergreen trees sup Shrubs supplied	plied	<u>5 trees</u> <u>8 trees</u> 55 shrubs	PROJECT NO. 2215

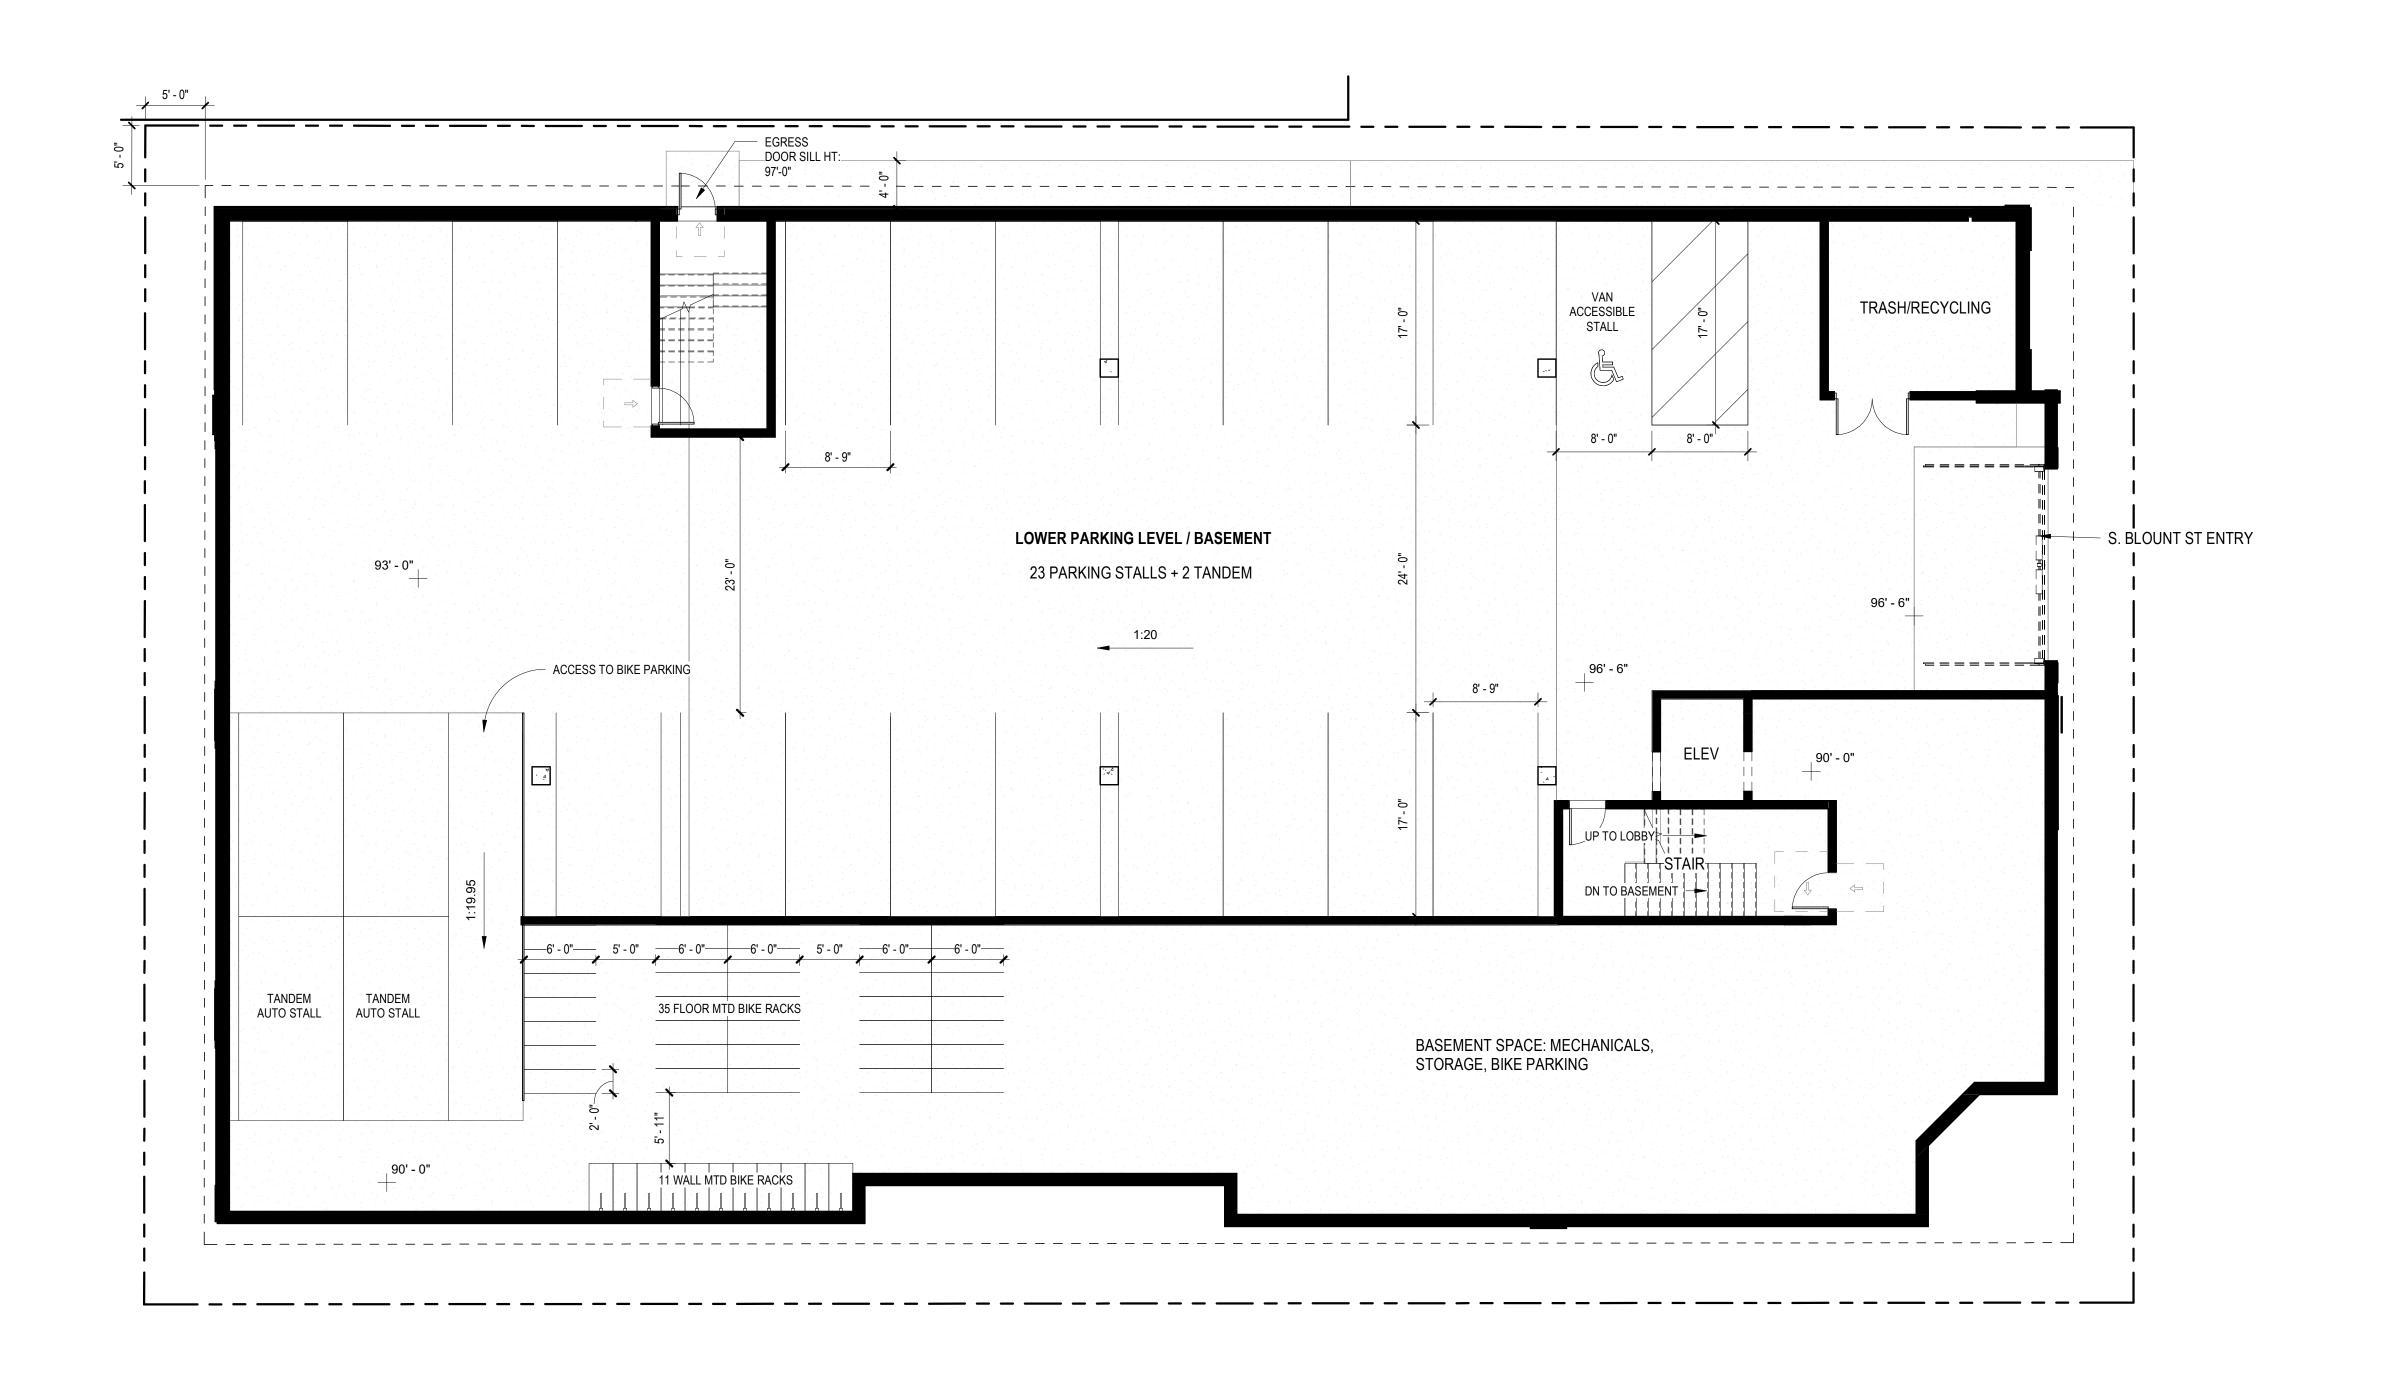

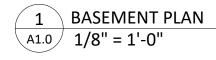



ISSUED



0' 4' 8' 16'

PROJECT TITLE 654 WILLIAMSON

Madison, WI 53703 SHEET TITLE BASEMENT/

LOWER PARKING

654 Williamson St


ST


PROJECT NUMBER 2215 © Knothe & Bruce Architects, LLC

PLAN





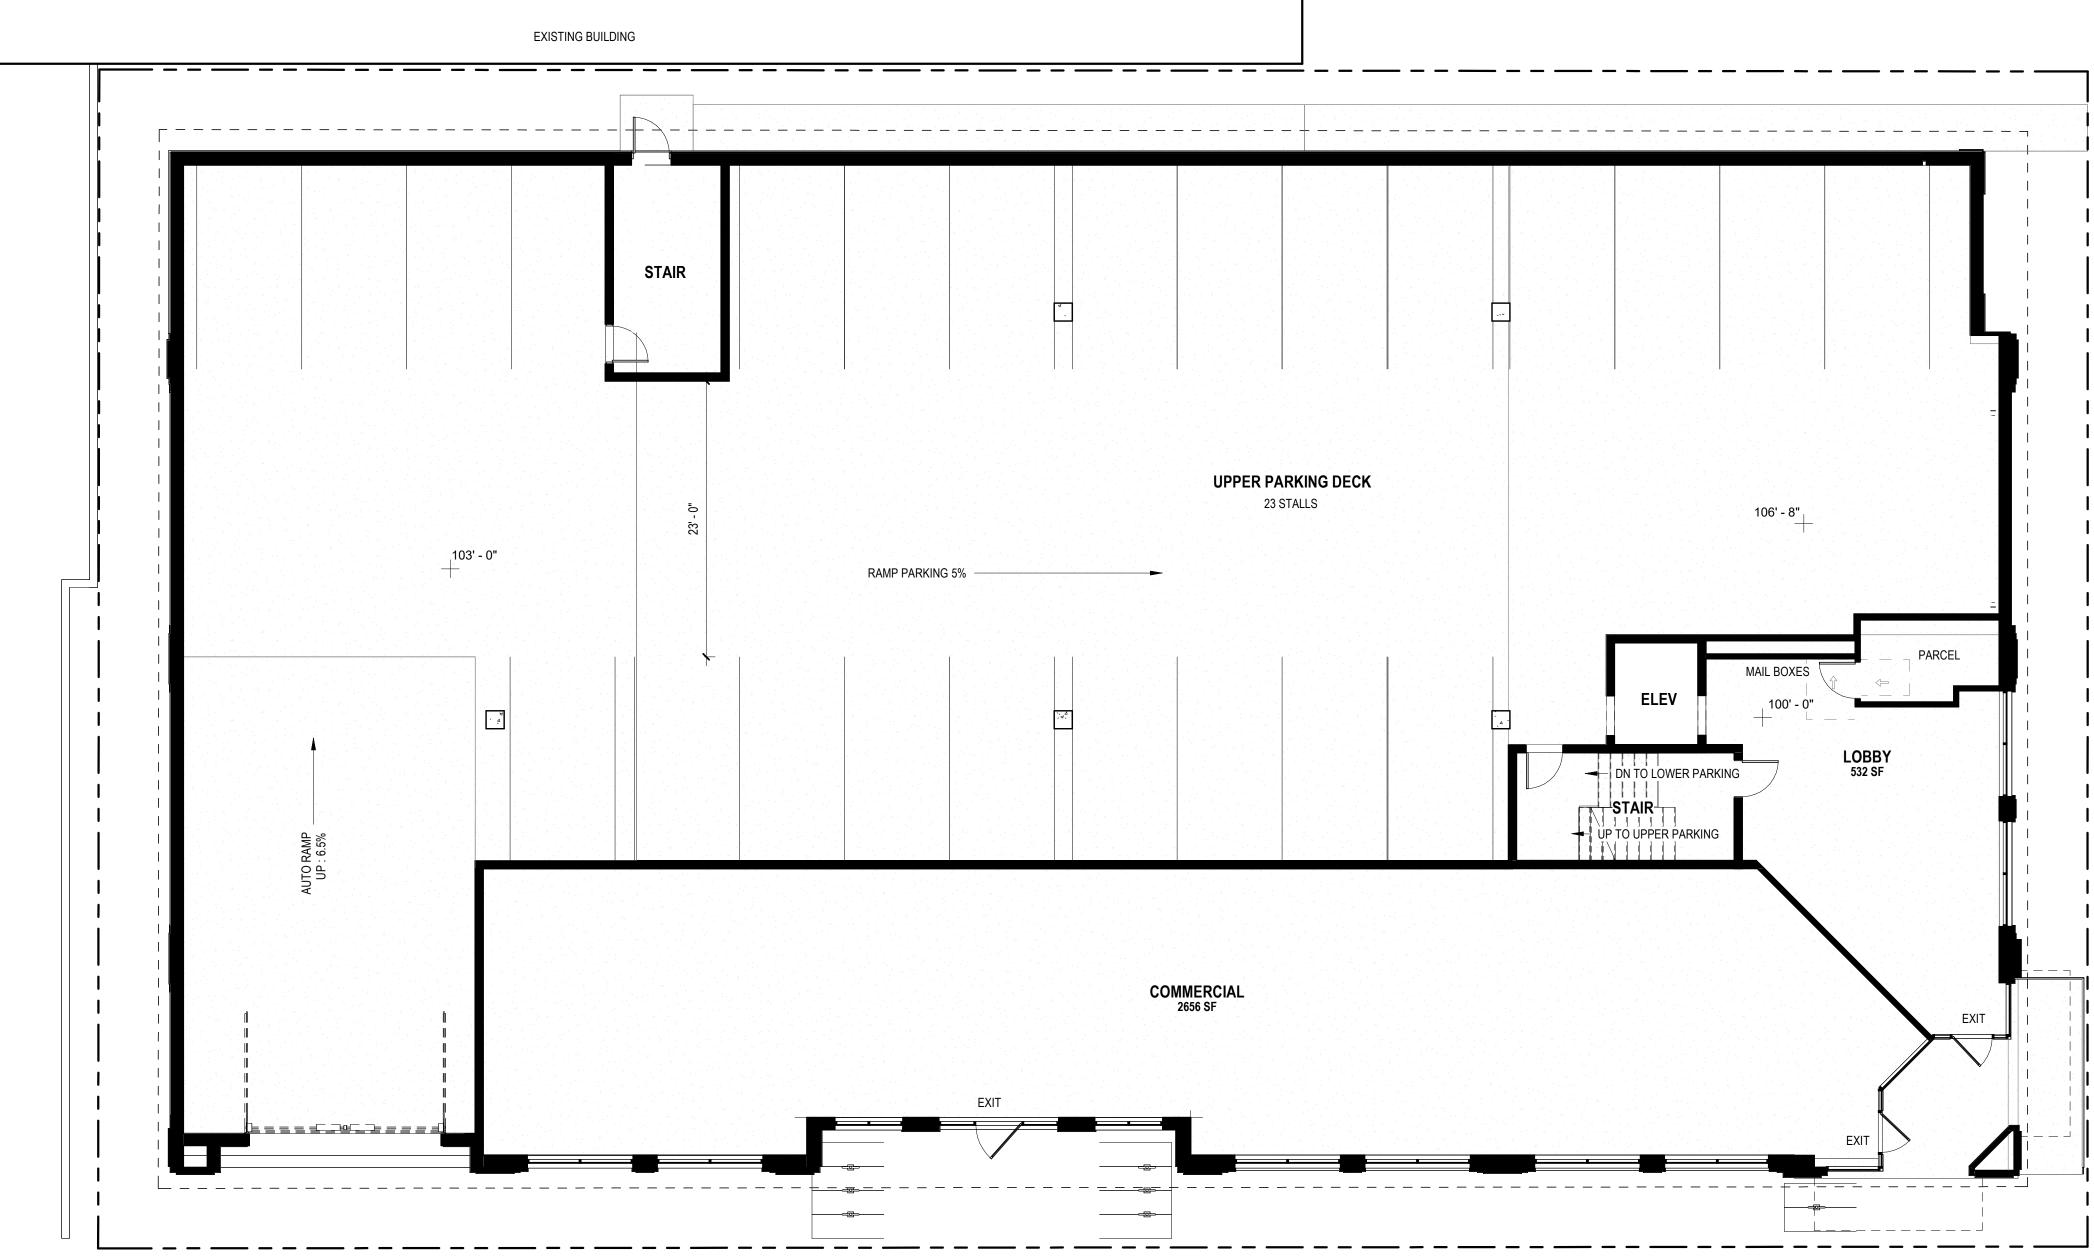

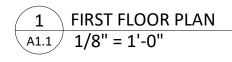



ISSUED





ST

LEVEL 1 /UPPER PARKING FLOOR PLAN


Madison, WI 53703 SHEET TITLE

654 Williamson St

0' 4' 8'

A1.1 PROJECT NUMBER 2215 © Knothe & Bruce Architects, LLC

SHEET NUMBER

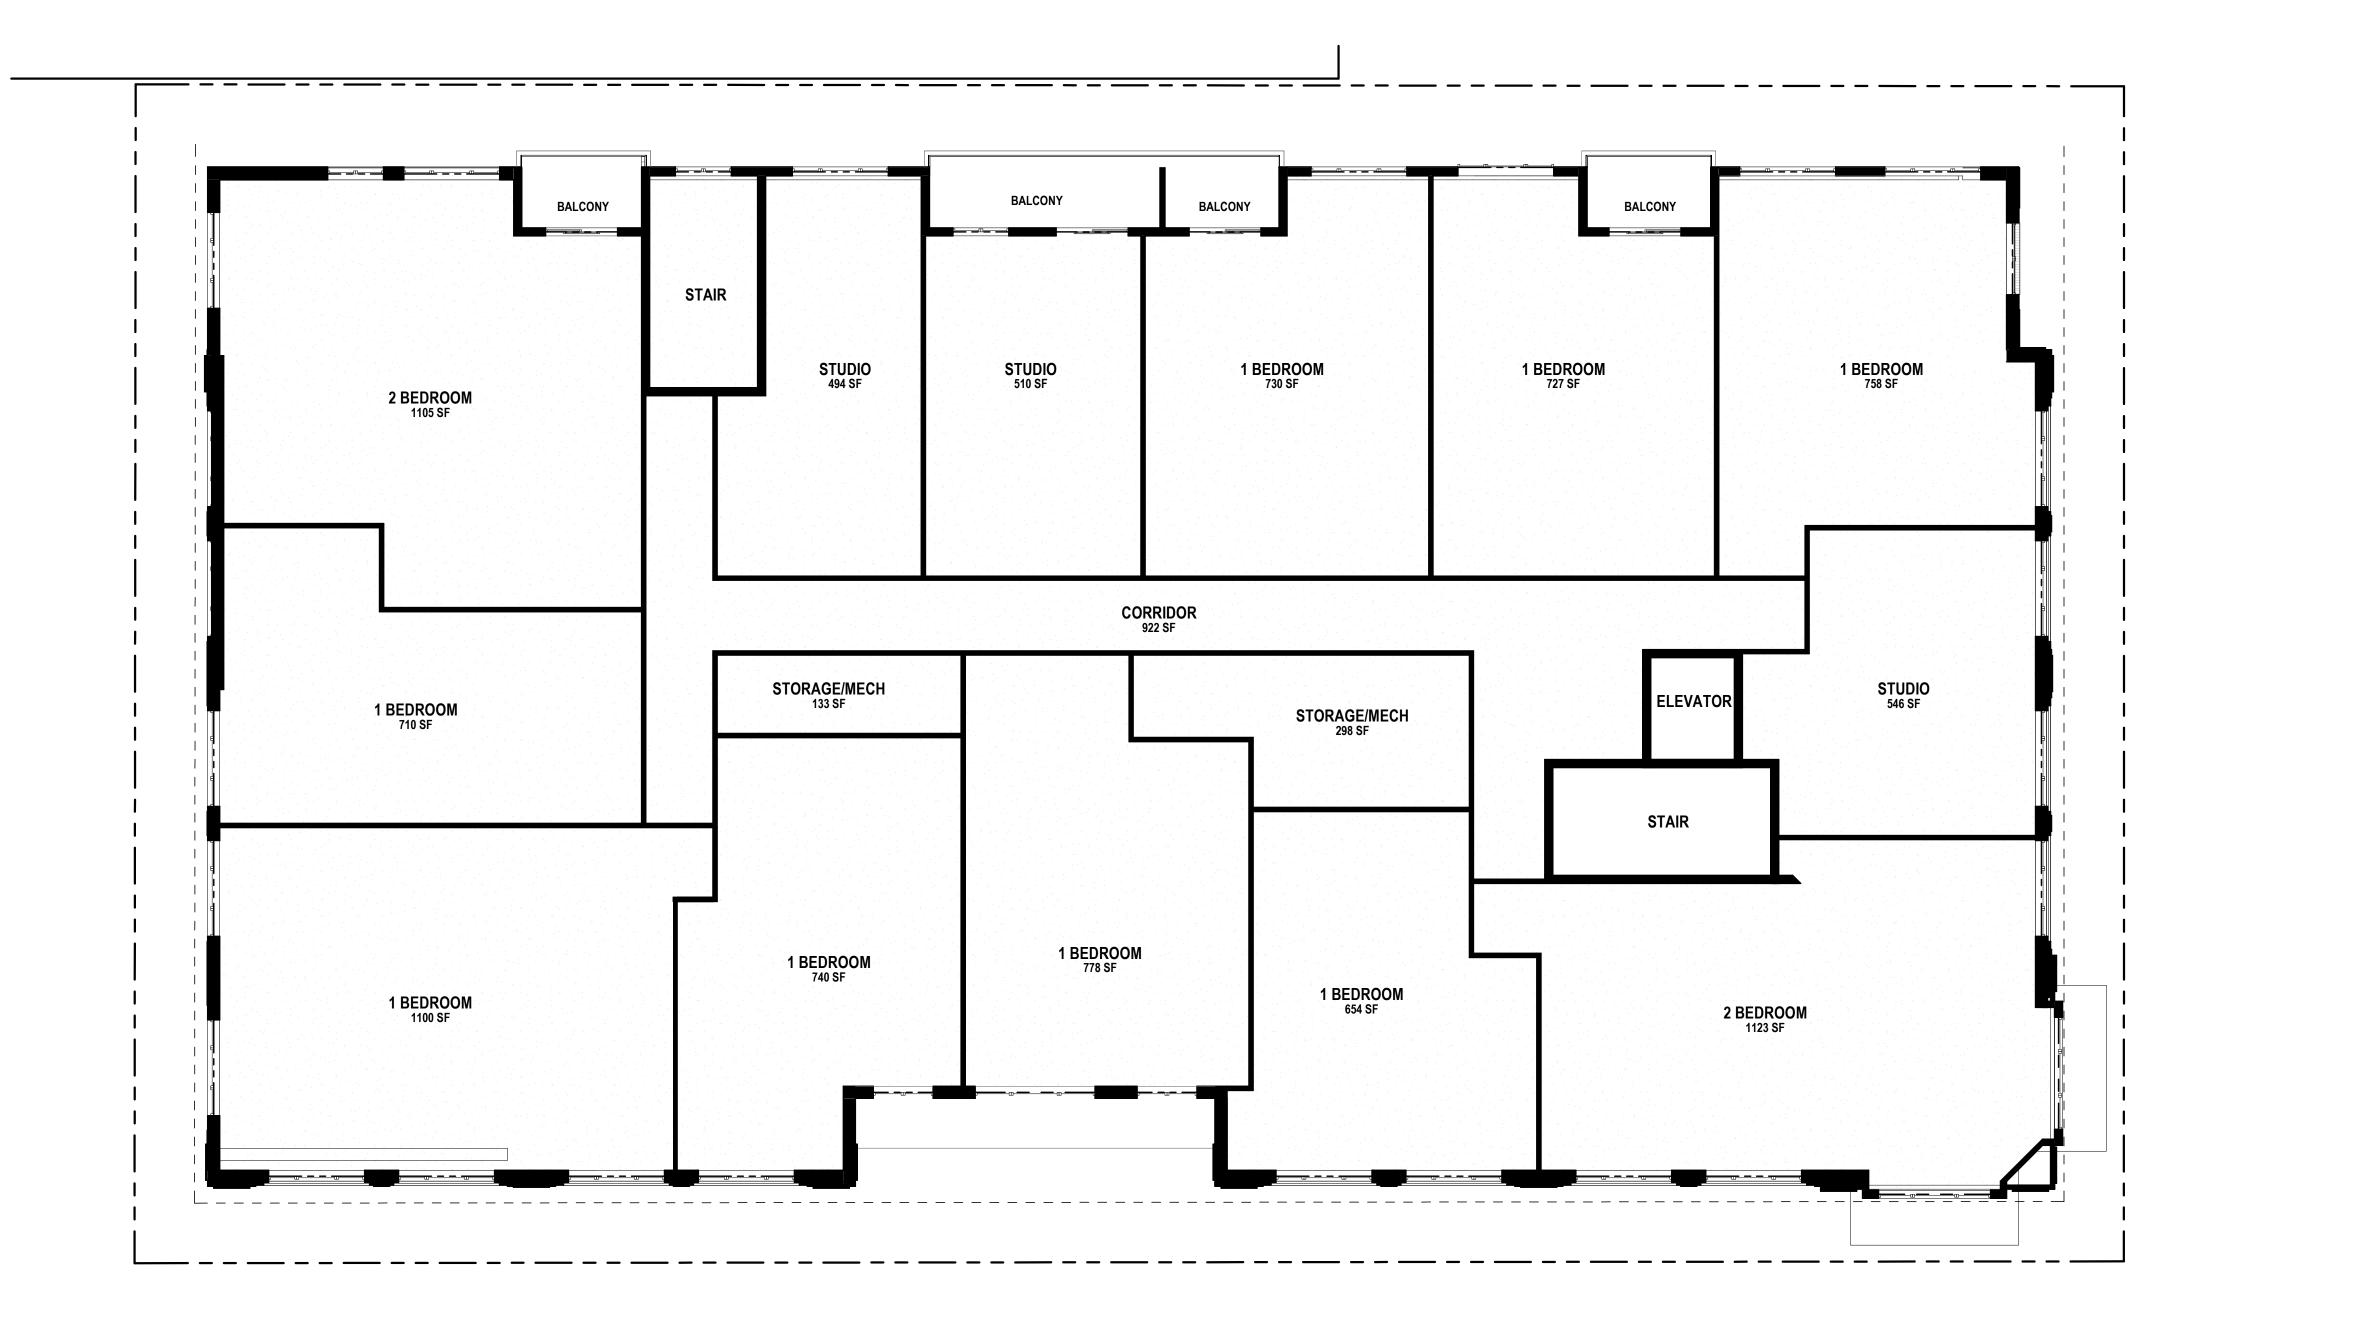



ISSUED



PROJECT TITLE

654 WILLIAMSON


ST

654 Williamson St Madison, WI 53703 SHEET TITLE LEVEL 2 PLAN

SHEET NUMBER A1.2

© Knothe & Bruce Architects, LLC

0' 4' 8' 16' PROJECT NUMBER 2215

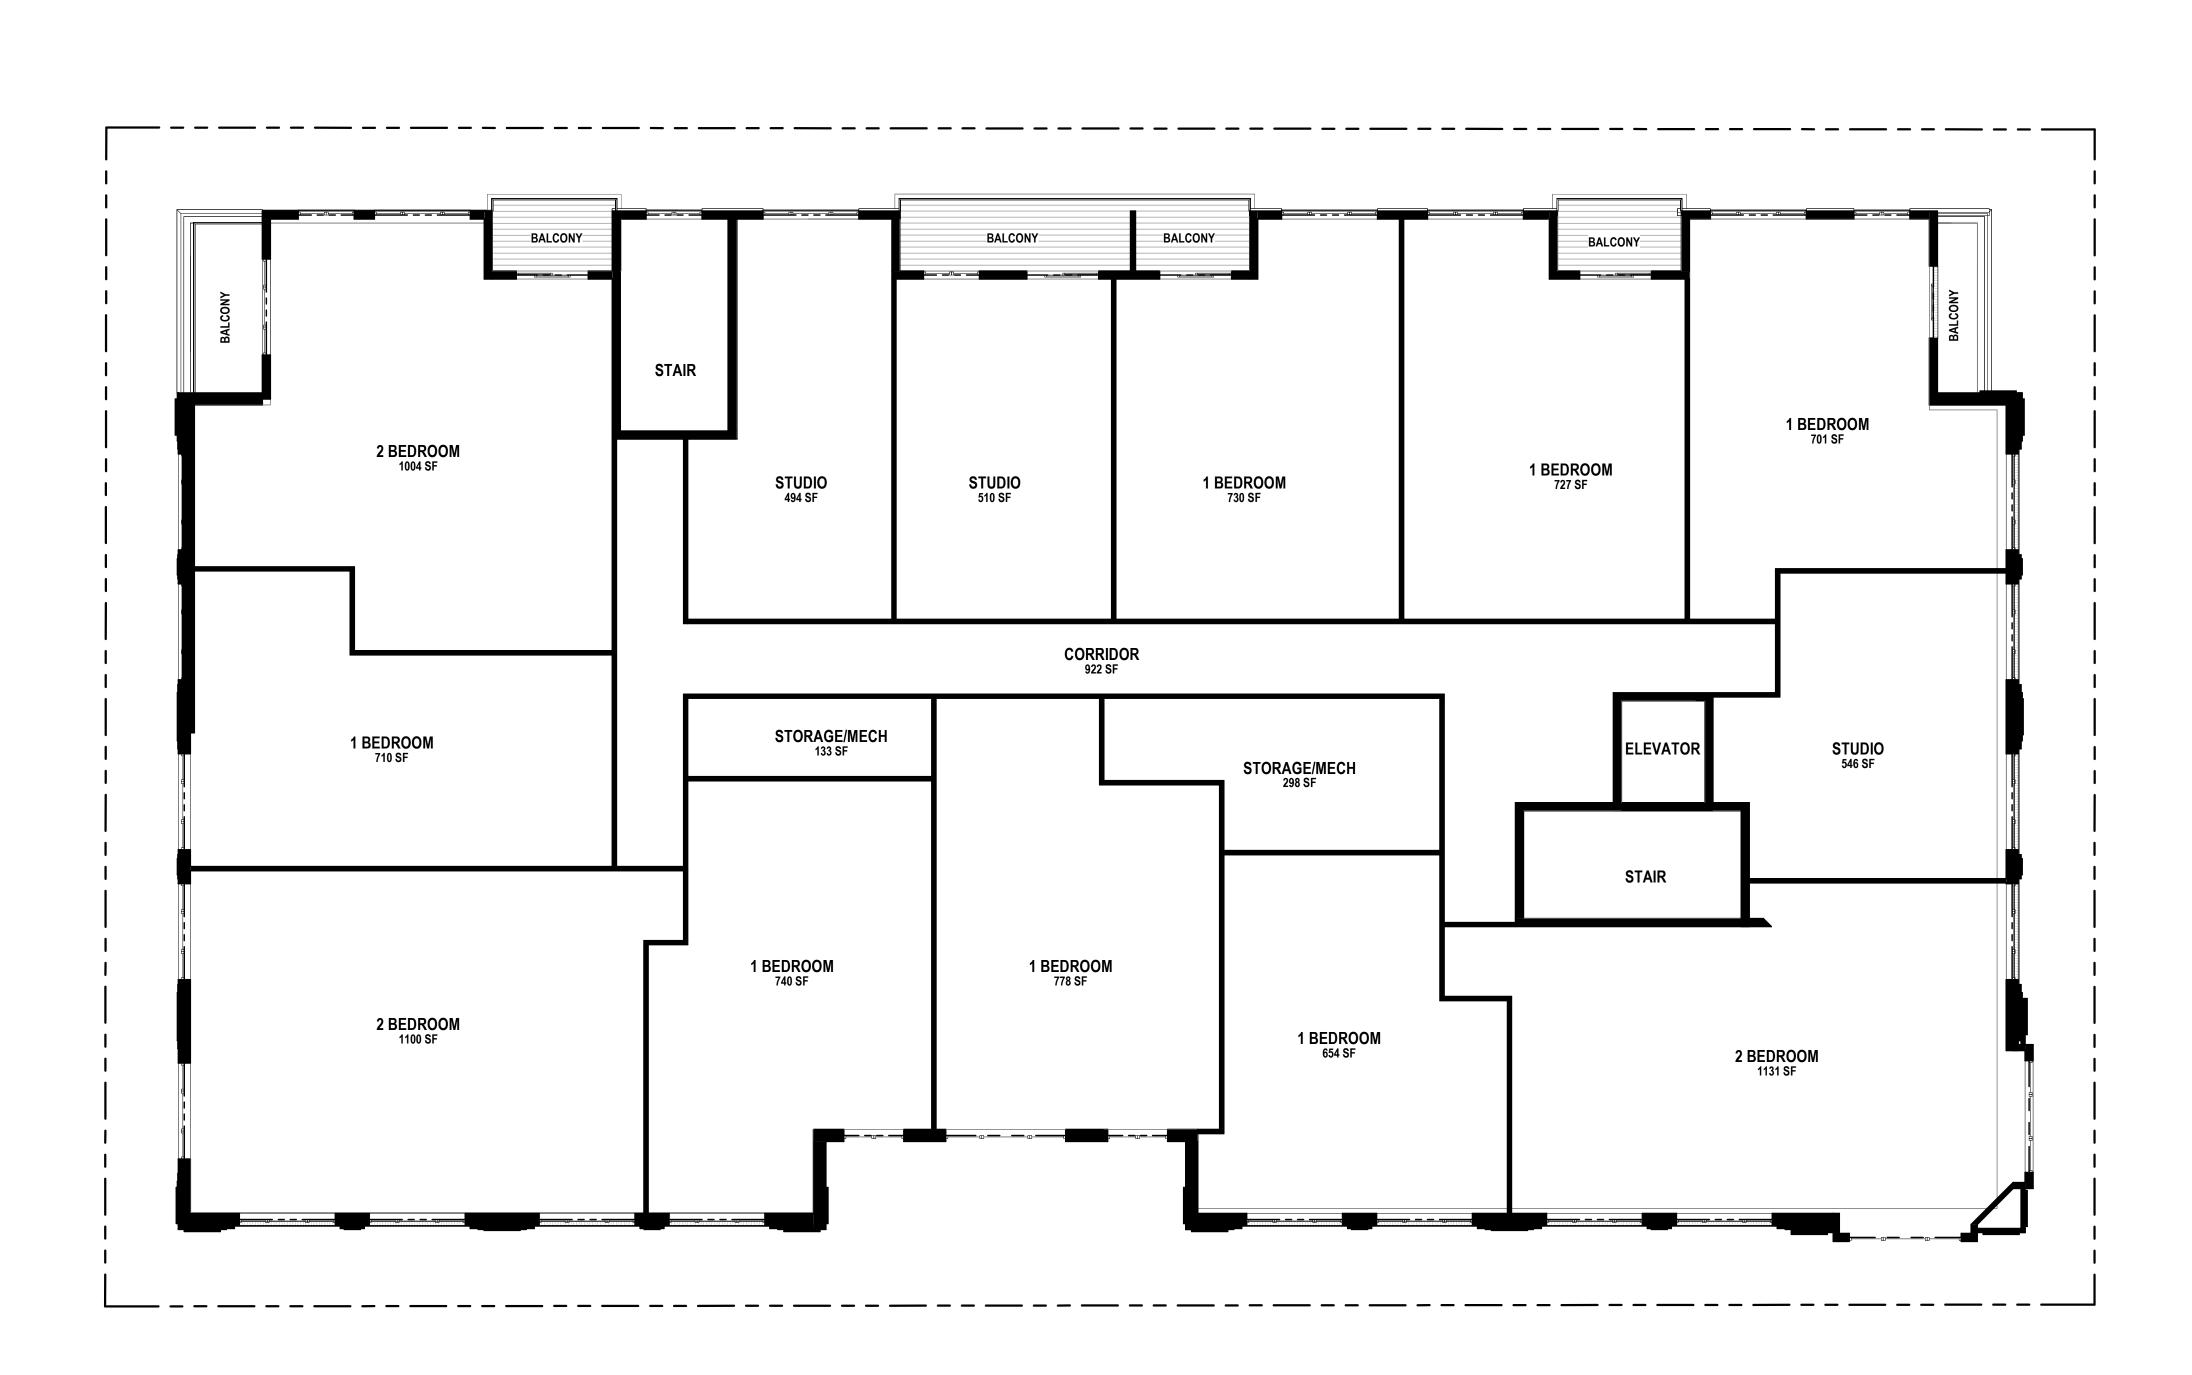



ISSUED




Ζ



654 Williamson St Madison, WI 53703 SHEET TITLE LEVEL 3 PLAN


654 Williamson St Madison, WI 53703




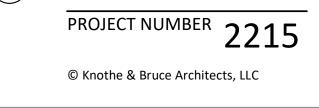

SHEET NUMBER

A1.3

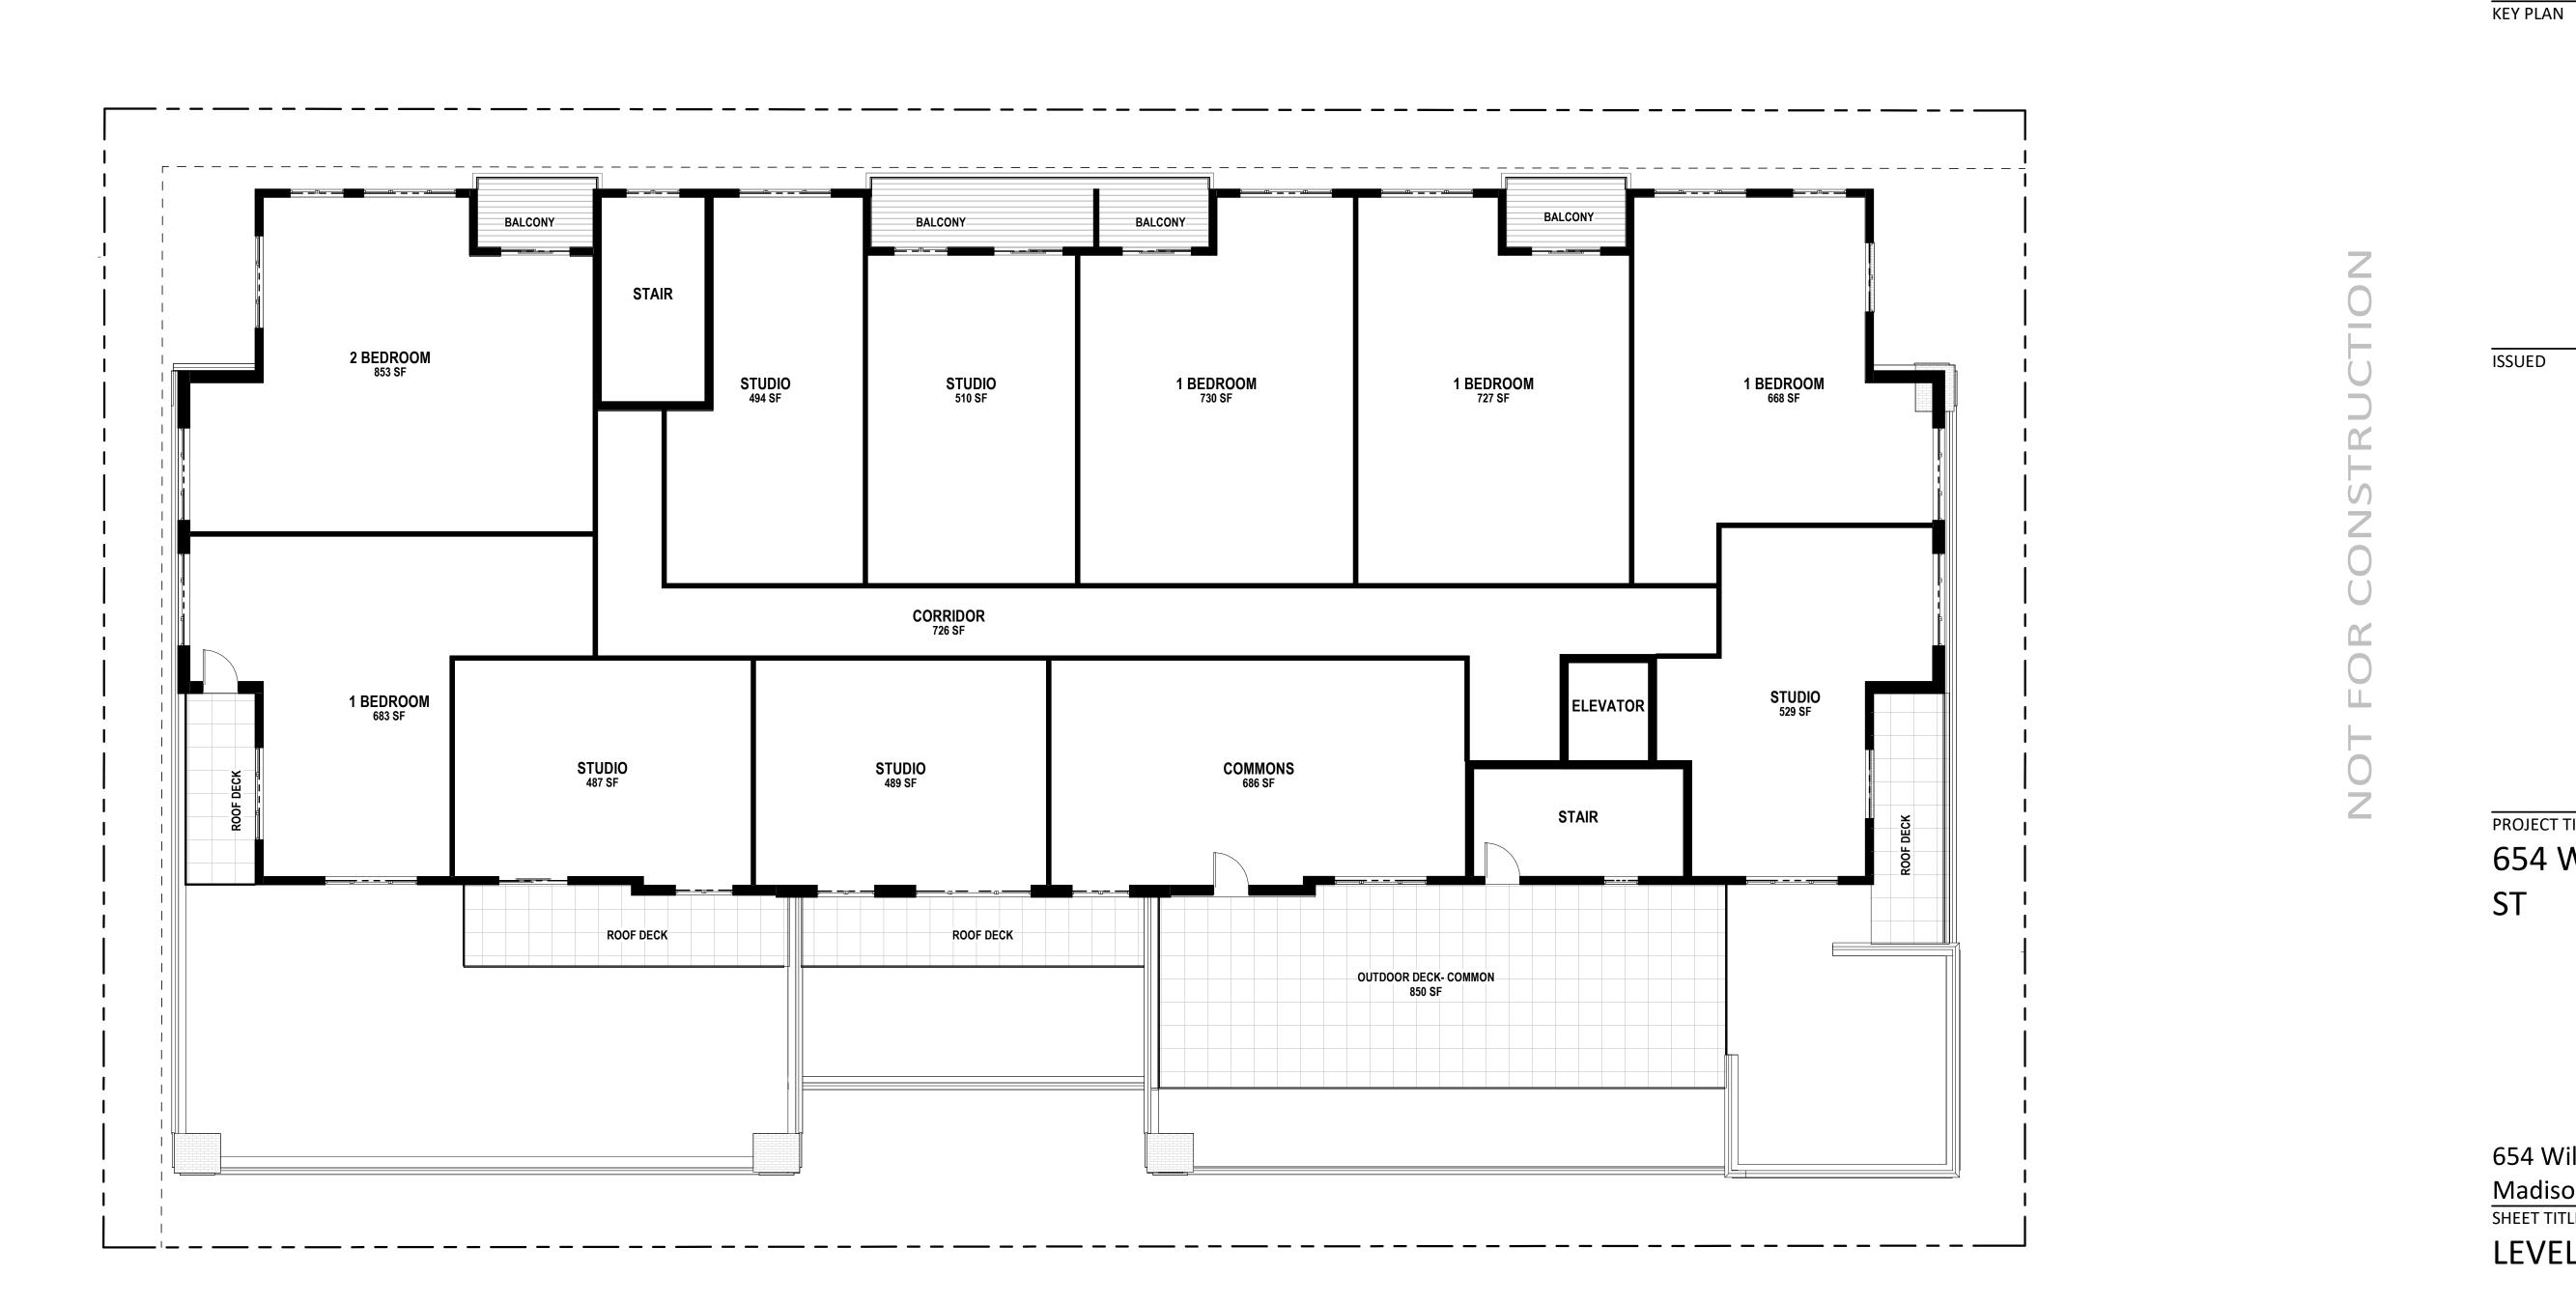

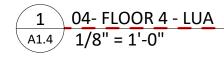



PROJECT TITLE 654 WILLIAMSON ST


Madison, WI 53703 SHEET TITLE LEVEL 4 PLAN


654 Williamson St

A1.4 PROJECT NUMBER 2215 © Knothe & Bruce Architects, LLC

SHEET NUMBER


0' 4' 8' 16'

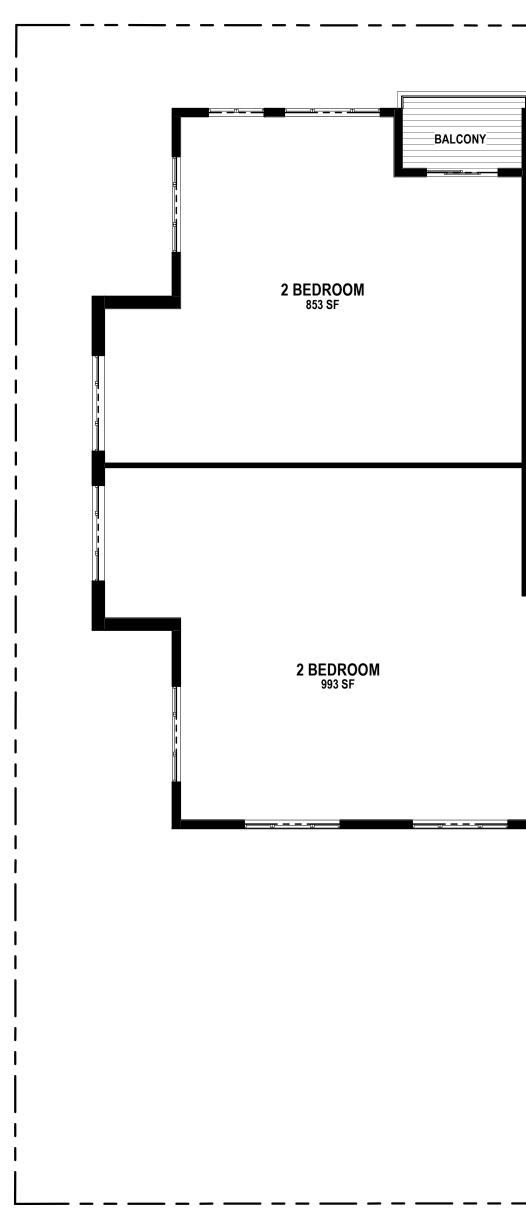

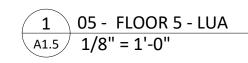

<u> </u>	<u> </u>				
STAIR		BALCONY	BALCONY	BALCONY	1 BEI 67
	STUDIO 494 SF	STUDIO 510 SF	1 BEDROOM 730 SF	1 BEDROOM 727 SF	
	1 BEDRO 678 SF		726 SF 1 BEDROOM 686 SF	ELEVA	FOR



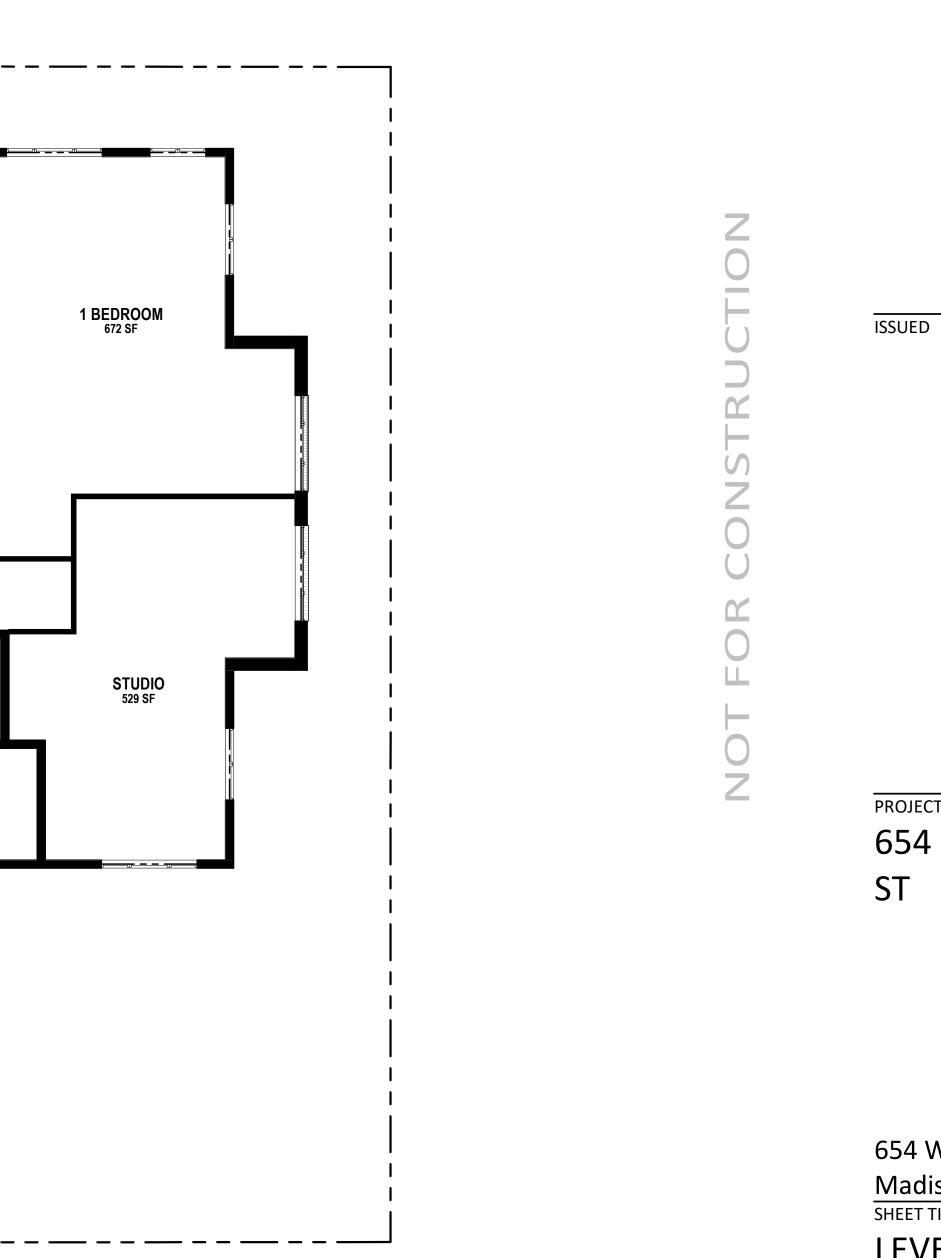

PROJECT TITLE 654 WILLIAMSON ST

Madison, WI 53703 SHEET TITLE LEVEL 5 PLAN

SHEET NUMBER


A1.5


PROJECT NUMBER 2215

© Knothe & Bruce Architects, LLC

0' 4' 8' 16'

654 Williamson St

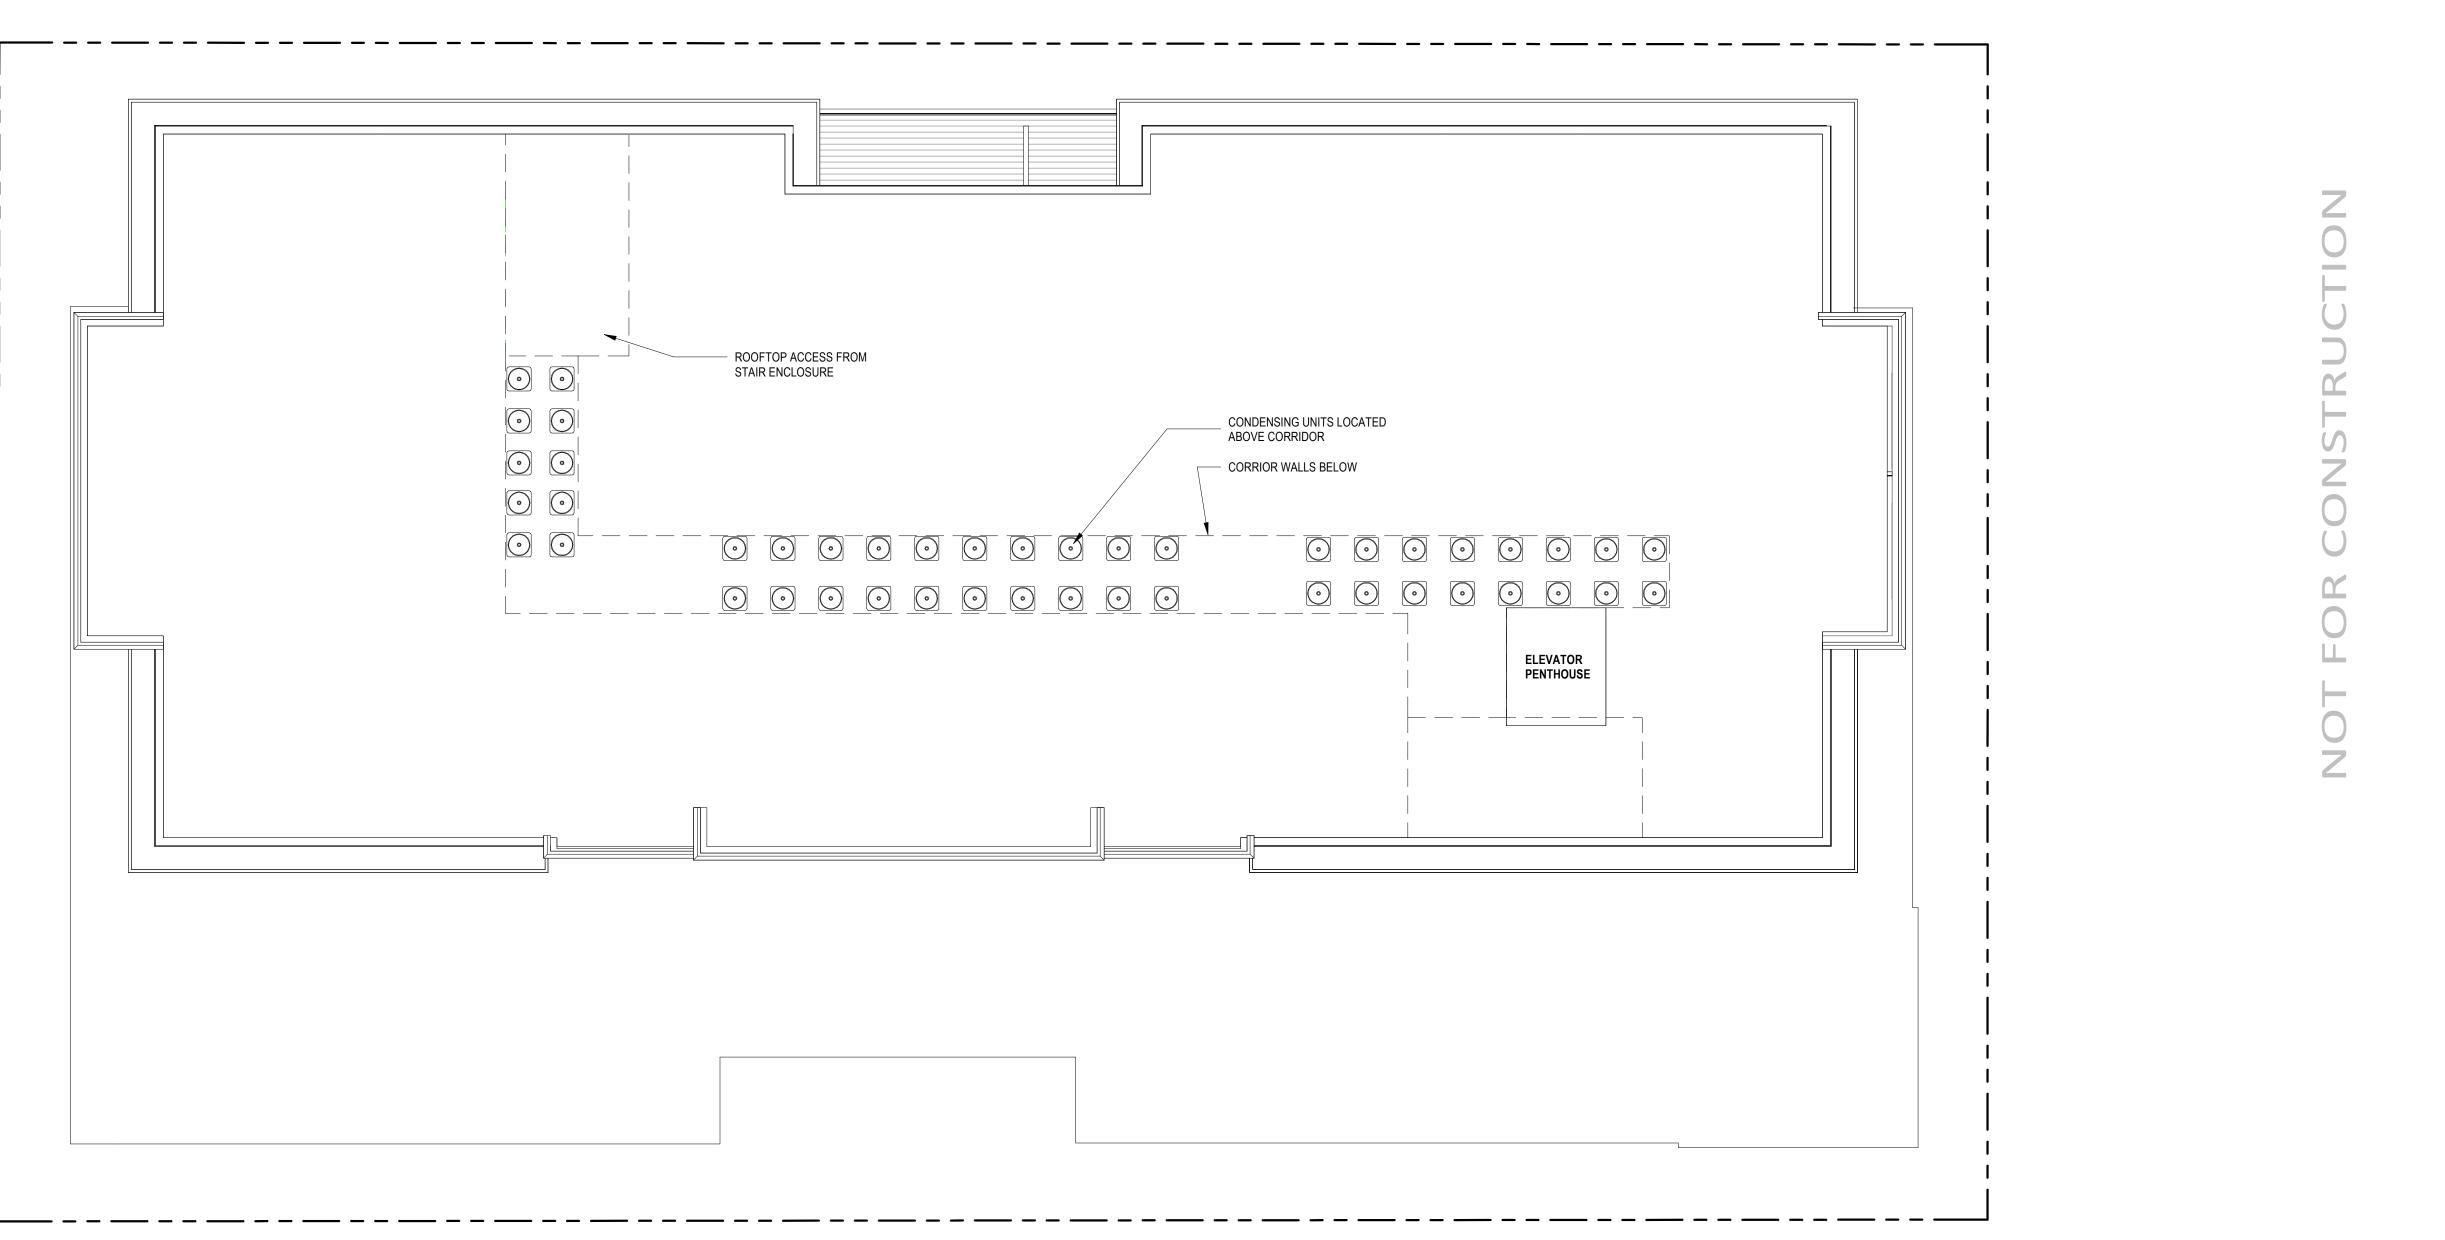

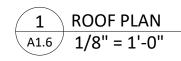



ISSUED

654 WILLIAMSON

PROJECT TITLE

ST

654 Williamson St Madison, WI 53703 SHEET TITLE


ROOF PLAN


0' 4' 8' 16'

SHEET NUMBER

A1.6

PROJECT NUMBER 2215

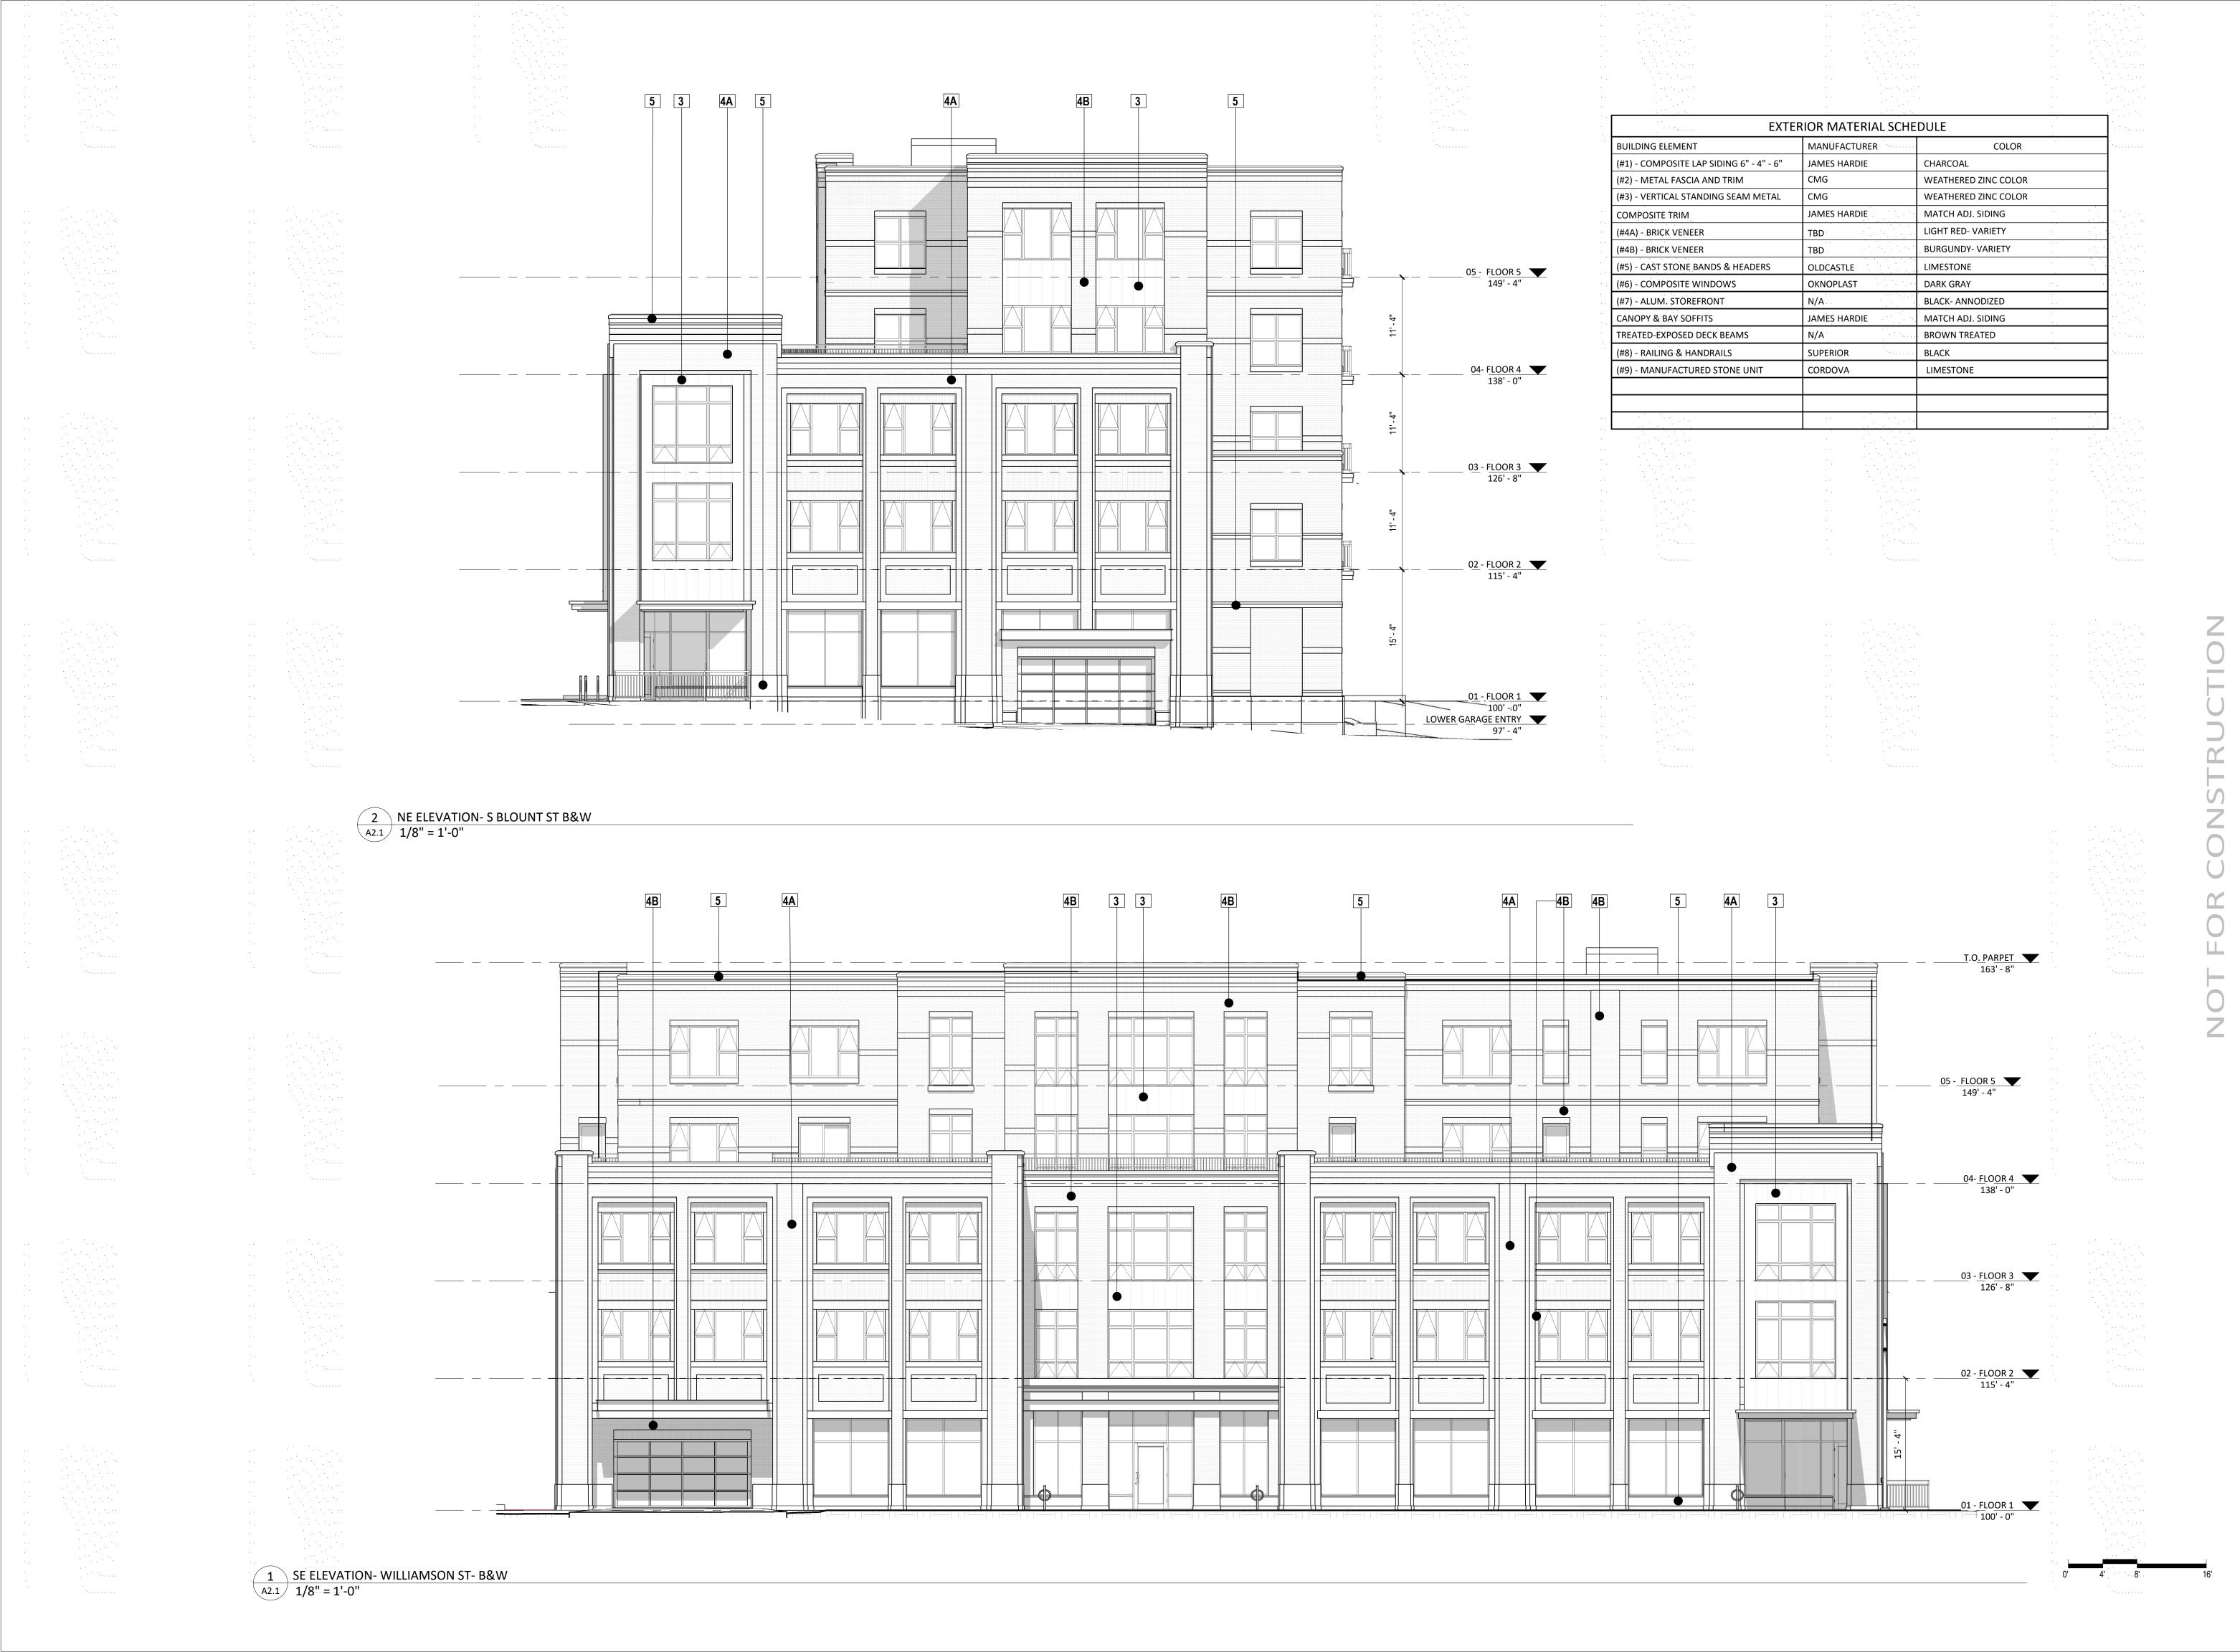

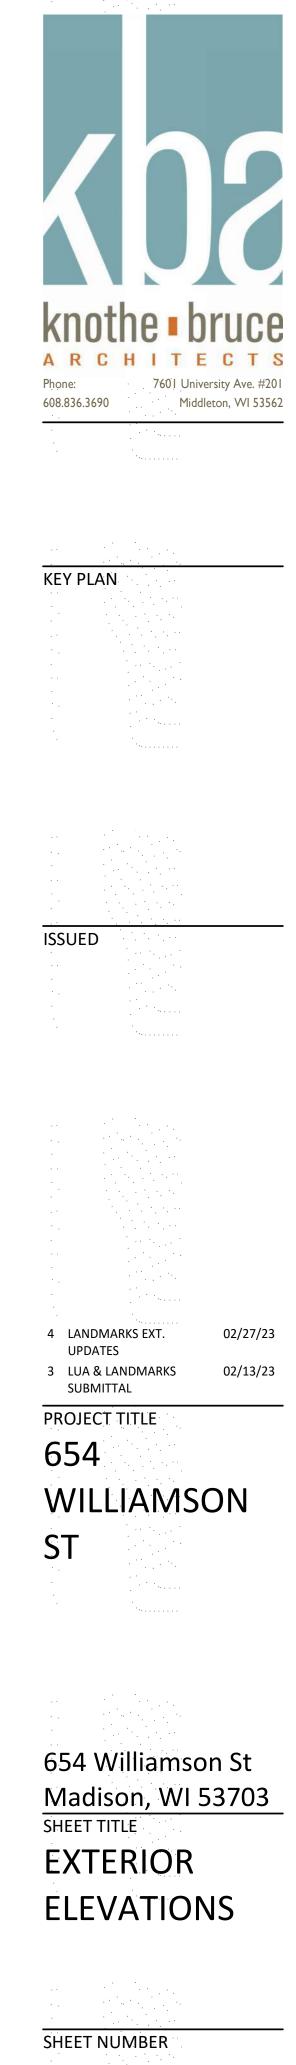

A2.1 PROJECT NUMBER 2215 © Knothe & Bruce Architects, LLC
























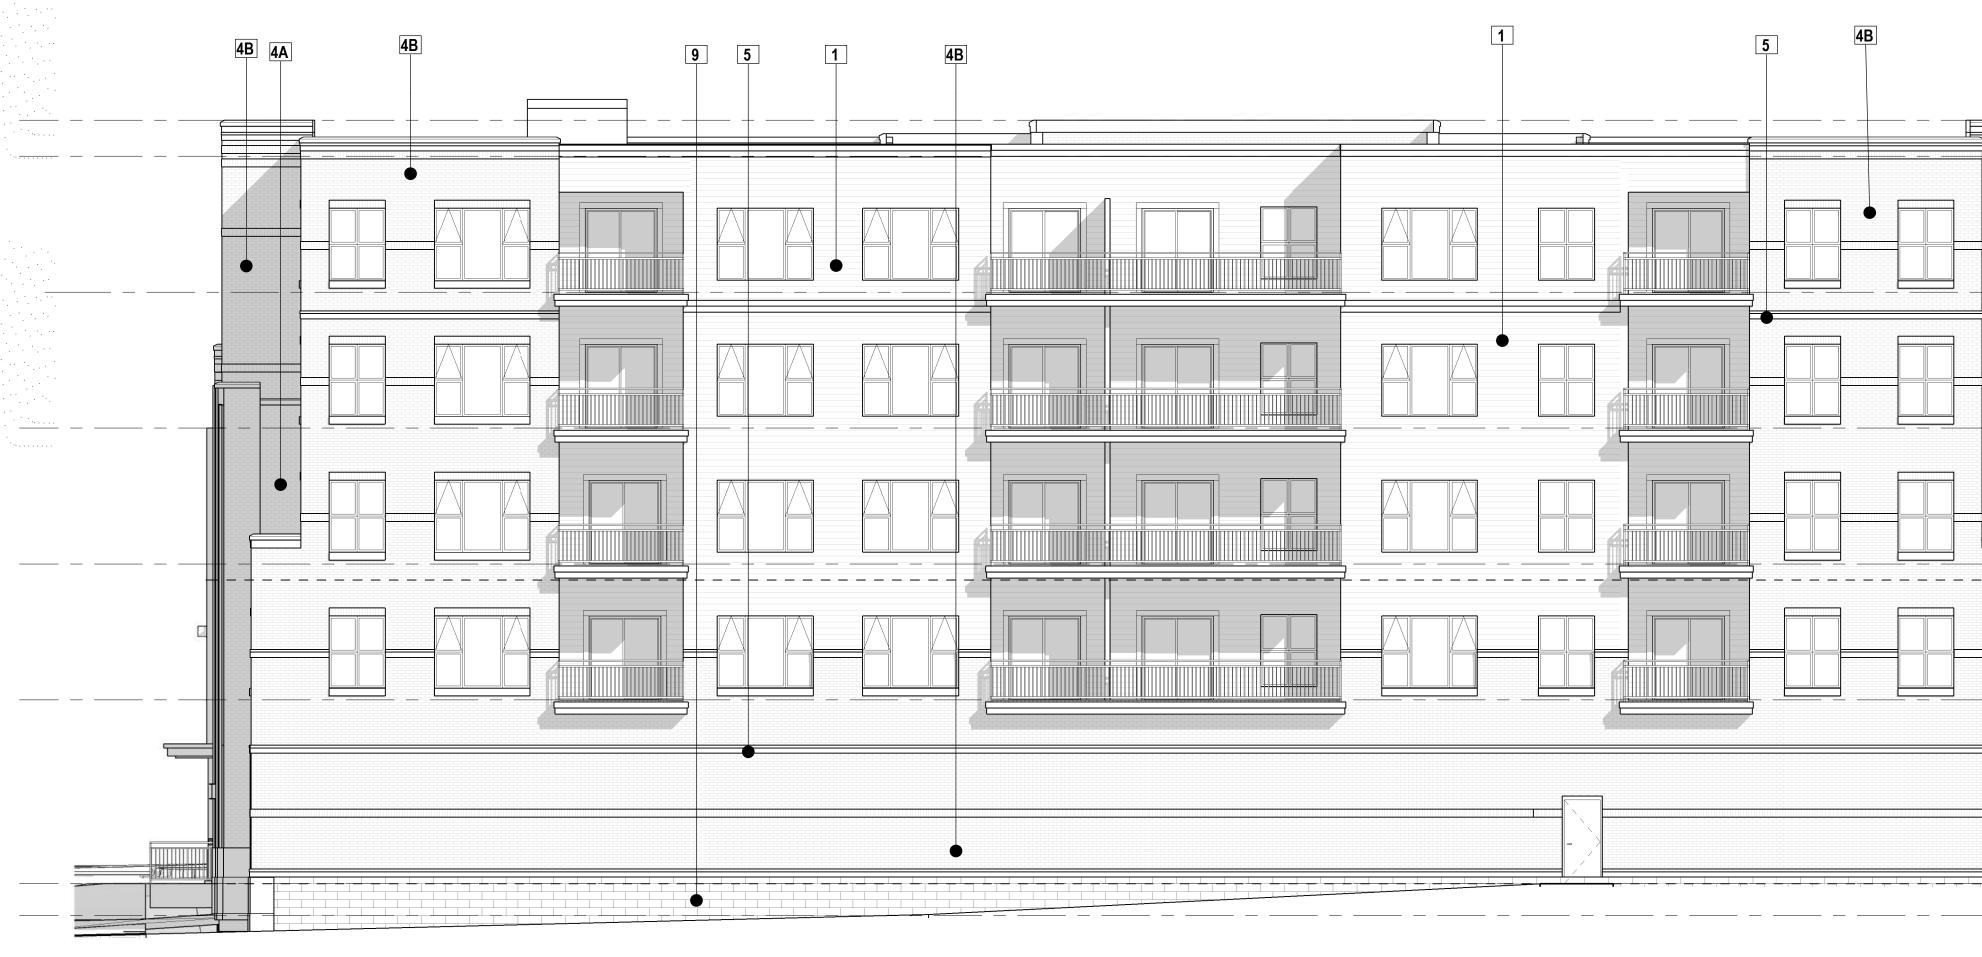


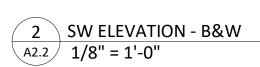

1 NW ELEVATION- B&W A2.2 1/8" = 1'-0"

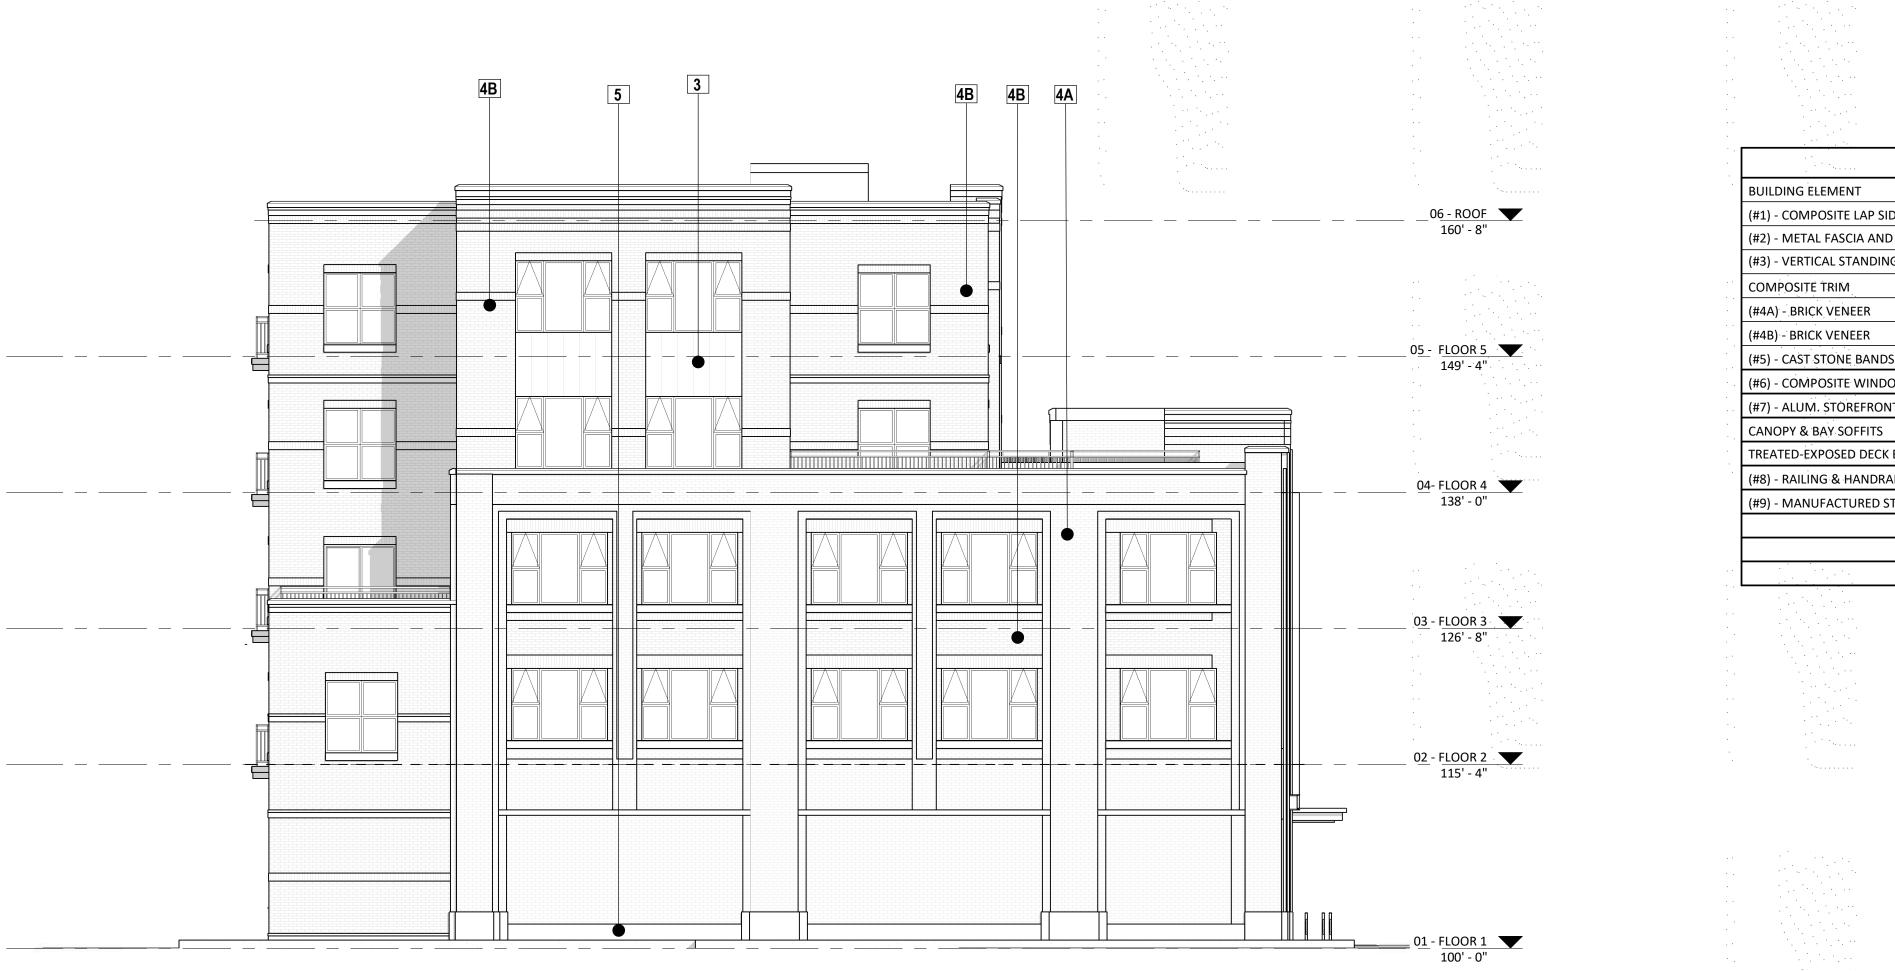

			н 1911 - 1912 - 1912 - 1912 - 1912 - 1912 - 1912 - 1912 - 1912 - 1912 - 1912 - 1912 - 1912 - 1912 - 1912 - 1912 -	
			• .	
			• •	
EXTE	ERIOR MATERIAL SCHE	DULE		
	MANUFACTURER	COLOR		·
DING 6" - 4" - 6"	JAMES HARDIE CMG	CHARCOAL WEATHERED ZINC COLOR		
NG SEAM METAL	CMG	WEATHERED ZINC COLOR		
	JAMES HARDIE	MATCH ADJ. SIDING		
	TBD	LIGHT RED- VARIETY		
DS & HEADERS	TBD OLDCASTLE	BURGUNDY- VARIETY		
DOWS	OKNOPLAST	DARK GRAY	· .	
NT	N/A	BLACK- ANNODIZED		en trans antra par
	JAMES HARDIE	MATCH ADJ. SIDING	• • .	······································
K BEAMS	N/A SUPERIOR	BROWN TREATED		
STONE UNIT	CORDOVA	LIMESTONE		
				· · · · ·
			• .	
			• •	
			•	
	· · · · · · · · · · · · · · · · · · ·			
		•.		
			•	
			•	
			· .	
4B 4A				
			• .	
	T.O. PARPET 🔻	·		
	163' - 8"	<u> </u>	· .	
	0 <u>6</u> - ROOF 160' - 8"	<u></u>		19
		•.	• •	
 ₽	05 - FLOOR 5 🔍	-		
	149' - 4"			
		• •	•	
			· · .	
	<u>0</u> 4- <u>FLOOR 4</u> 138' - 0"	<u>.</u>		, 1997. 1997. 1997.
	<u>03</u> - <u>FLOOR 3</u> 126' - 8"		• .	
	126 - 8		• •	
			• • •	
			• .	
		-	•	
	<u>02</u> - <u>FLOOR 2</u> 115' - 4"	<u>.</u>		
	ана страна с Страна страна страна Страна страна			
			· ·	
		-		
╵╾╕╾┷╸╤╾┷╼╤╌╋	01 - FLOOR 1 100' - 0"			
	LOWER GARAGE ENTRY 97' - 4"	<u></u>	•••	
			0'	4' 8

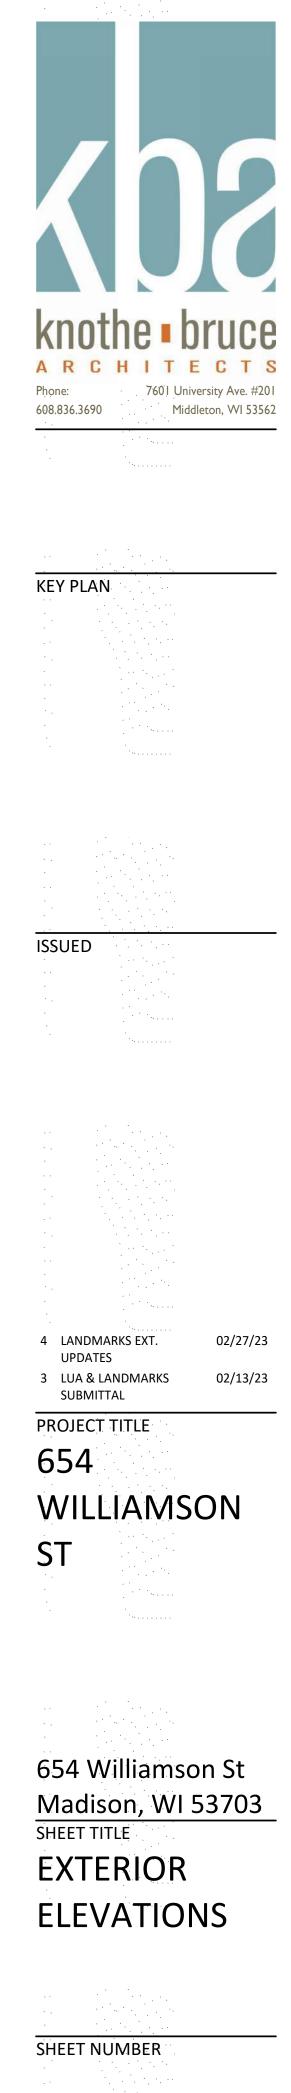

0

Ŷ

-

S

Ζ

0

r

0


0

Ζ

A2.2 PROJECT NUMBER 2215 © Knothe & Bruce Architects, LLC



			•	
			• .	
EXIE				
SIDING 6" - 4" - 6"	JAMES HARDIE	COLOR		
ND TRIM	CMG	WEATHERED ZINC COLOR		
ING SEAM METAL	CMG	WEATHERED ZINC COLOR		
	JAMES HARDIE	MATCH ADJ. SIDING		
	TBD	LIGHT RED- VARIETY	•	
IDS & HEADERS	TBD OLDCASTLE	BURGUNDY- VARIETY	•	
DOWS	OKNOPLAST	DARK GRAY	· .	
ONT	N/A	BLACK- ANNODIZED		
S	JAMES HARDIE	MATCH ADJ. SIDING	•	
CK BEAMS	N/A	BROWN TREATED		
RAILS	SUPERIOR	BLACK		· · · · · · · · · · · · · · · · · · ·
STONE UNIT	CORDOVA	LIMESTONE		
			•	
			* .	
			• •	
			•	
				1991 - 1994 - 1994 - 1994 - 1994 - 1994 - 1994 - 1994 - 1994 - 1994 - 1994 - 1994 - 1994 - 1994 - 1994 - 1994 -
		•	• .	
		· ·		
			· ·	
			•	
			•	
			•	
4A 3				
			•	
				1991 - 1994 -
			•••	
	, ,	<u>05</u> FLOC)R 5 . 🔽	
			- 4"	-
			1 .	
			• •	
		04- FLOC	R 4 🗡	· · · · · · · · · · · · · · · · · · ·
		138'	- 0"	
			• •	
		<u>03 -</u> FLOC 126'	R3 ▼	• · · · · · · · · · · · · · · · · · · ·
		120	U .	
			• .	
			• .	
		<u>02 -</u> FLOC 115'	R 2	• · · · · · · · · · · · · · · · · · · ·
		115	Ŧ	*******
		F		
			•••	
0		01 - FLOC)R 1	•
		100'	- 0"	•
			* . 	
			0'	4' 8'
				· · · · · · · · · · · · · · · · · · ·

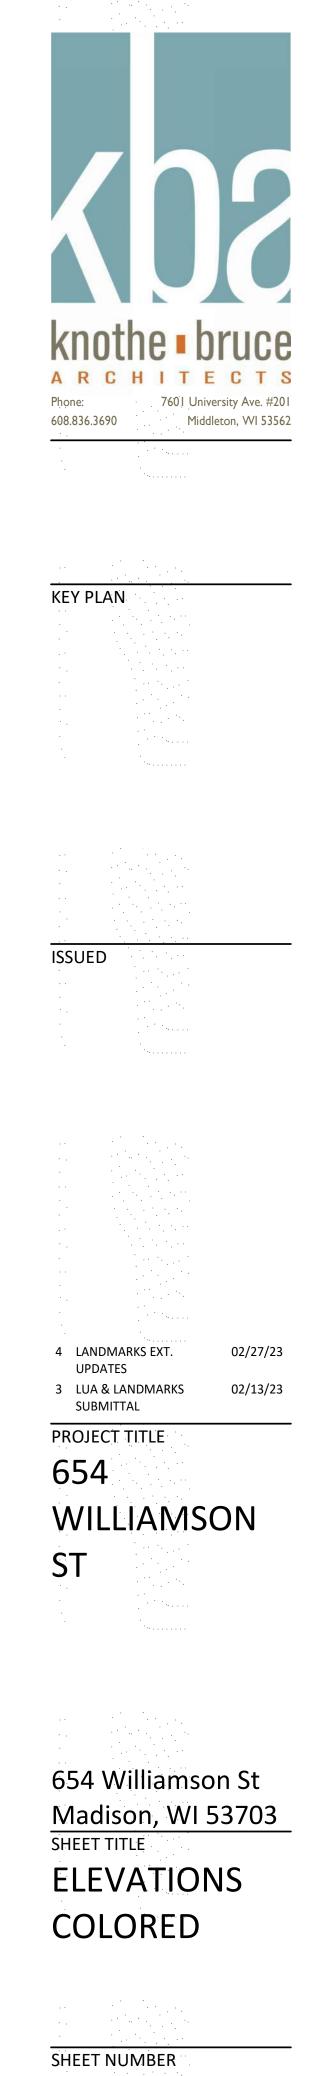

A2.3 PROJECT NUMBER 2215 © Knothe & Bruce Architects, LLC

OT FOR CONSTRUCTI


Ζ

Ζ

0



			· .	
		· .	•••	
EXTE	RIOR MATERIAL SCH	DULE		· · · · · · · · · · · · · · · · · · ·
SIDING 6" - 4" - 6"	JAMES HARDIE	COLOR CHARCOAL		
	CMG	WEATHERED ZINC COLOR		
NG SEAM METAL	CMG	WEATHERED ZINC COLOR		
	JAMES HARDIE TBD	MATCH ADJ. SIDING	· · · · ·	· · · · ·
	TBD	BURGUNDY- VARIETY		
DS & HEADERS	OLDCASTLE	LIMESTONE		
DOWS NT	OKNOPLAST N/A	DARK GRAY BLACK- ANNODIZED	· .	
	JAMES HARDIE	MATCH ADJ. SIDING	• •	
K BEAMS	N/A	BROWN TREATED	•	
	SUPERIOR	BLACK		· · · · · · · · · · · · · · · · · · ·
STONE UNIT	CORDOVA	LIMESTONE		
		· · · ·		
			* .	
		•••		
			· .	
	ана стана стана Стана стана стан			
			• •	
			•	
		· · · · · · · · · · · · · · · · · · ·	• • •	
		· · · · · · · · · · · · · · · · · · ·	•••	
		· .		
			* .	
		•.	•••	
			•	
4B 4A		··· ·	• •	
		•••	••	
		• • •		
	<u>T.O. PARPET</u> 163' - 8"	<u></u>	•	
	0 <u>6</u> - R <u>OOF</u> 160' - 8"	··· <u>/</u>		1. 1. 1. 1. 1. 1.
	160' - 8"			
	an a			
			• •	
	<u>05</u> - <u>FLOOR 5</u> 149' - 4"		· · ·	
		•	•	
		•	•	
		· ·	• .	
	04- FLOOR 4 138' - 0"			
•				1944 - A.A.A.A.A.A.A.A.A.A.A.A.A.A.A.A.A.A.A
	_ • • •			
	03 - FLOOR 3 126' - 8''		• •	
	126' - 8"	· · ·		
			* .	
		· .		
	<u>02</u> - <u>FLOOR 2</u> 115' - 4"	<u> </u>	· .	
		-		
╵╾┑┶╴┯╴╸╸╋	01 - FLOOR 1 100' - 0"	<u> </u>		
	LOWER GARAGE ENTRY 97' - 4"	<u>,</u>	• •	
			0'	4'

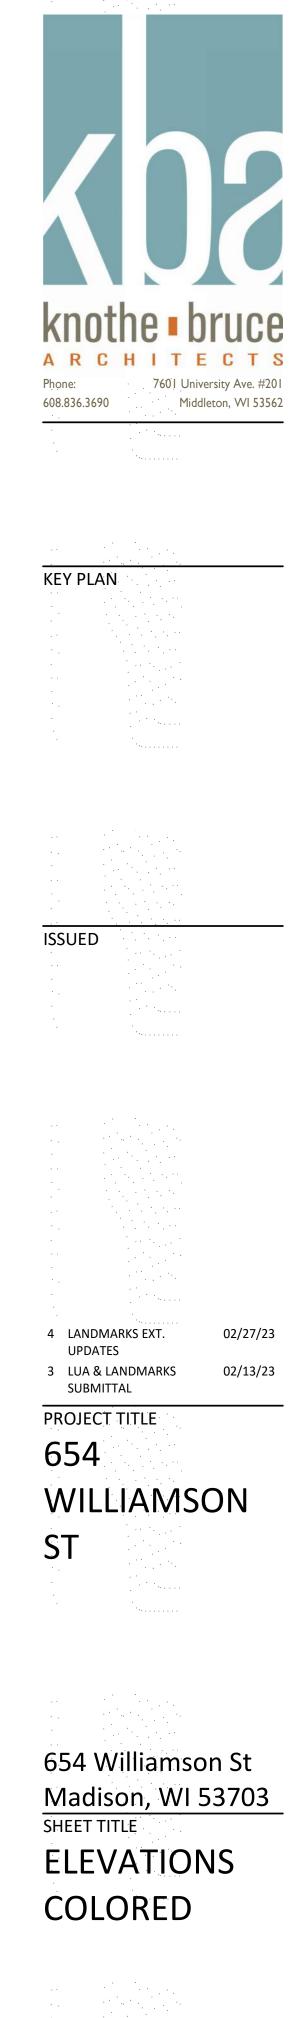

0

-

S 7 0


r

0

С

Ζ

SHEET NUMBER

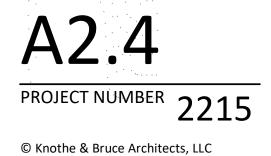



BLOUNT STREET VIEW - LOOKING SOUTH



WILLIAMSON STREET VIEW - LOOKING NORTHEAST





WILLIAMSON STREET VIEW - LOOKING NORTHWEST

WILLIAMSON STREET VIEW - LOOKING WEST

TION \mathbf{O} ĸ S \cup Ŷ 0 0 Z



KEY PLAN

ISSUED 4 LANDMARKS EXT. UPDATES 02/27/23 3 LUA & LANDMARKS SUBMITTAL 02/13/23 PROJECT TITLE 654 WILLIAMSON ST

VIEWS

SHEET NUMBER

A2.5

PROJECT NUMBER 2215

© Knothe & Bruce Architects, LLC

654 Williamson St Madison, WI 53703 SHEET TITLE RENDERED



City of Madison Fire Department

314 W Dayton Street, Madison, WI 53703-2506 Phone: 608-266-4420 • Fax: 608-267-1100 • E-mail: fire@cityofmadison.com

Project Address: 654 Williamson Street

Contact Name & Phone #: Kevin Burow 608-83

608-836-3690

FIRE APPARATUS ACCESS AND FIRE HYDRANT WORKSHEET

 Is the building completely protected by an NFPA 13 or 13R automatic fire sprinkler system? If non-sprinklered, fire lanes extend to within 150-feet of all portions of the exterior wall? If sprinklered, fire lanes are within 250-feet of all portions of the exterior wall? 	Yes Yes Yes	☐ No ☐ No ☐ No	□ N/A X N/A N/A
 2. Is the fire lane constructed of concrete or asphalt, designed to support a minimum load of 85,000 lbs? a) Is the fire lane a minimum unobstructed width of at least 20-feet? b) Is the fire lane unobstructed with a vertical clearance of at least 13½-feet? c) Is the minimum inside turning radius of the fire lane at least 28-feet? d) Is the grade of the fire lane not more than a slope of 8%? e) Is the fire lane posted as fire lane? (Provide detail of signage.) f) Is a roll-able curb used as part of the fire lane? (Provide detail of curb.) g) Is part of a sidewalk used as part of the required fire lane? (Must support +85,000 lbs.) 	 Yes 	□ No □ No □ No □ No □ No ☑ No ☑ No ☑ No	□ N/A □ N/A □ N/A □ N/A □ N/A □ N/A □ N/A
3. Is the fire lane obstructed by security gates or barricades? If yes:a) Is the gate a minimum of 20-feet clear opening?b) Is an approved means of emergency operations installed, key vault, padlock or key switch?	☐ Yes ☐ Yes ☐ Yes	X No No No	N/A N/A N/A
4. Is the Fire lane dead-ended with a length greater than 150-feet? If yes, does the area for turning around fire apparatus comply with IFC D103?	Yes Yes	X No	N/A X N/A
5. Is any portion of the building to be used for high-piled storage in accordance with IFC Chapter 3206.6 If yes, see IFC 3206.6 for further requirements.	Yes	X No	N/A
6. Is any part of the building greater than 30-feet above the grade plane?	X Yes	🗌 No	N/A
 If yes, answer the following questions: a) Is the aerial apparatus fire lane parallel to one entire side of the building and covering at least 25% of the perimeter? b) Is the near edge of the aerial apparatus fire lane between 15' and 30' from the building? c) Are there any overhead power or utility lines located across the aerial apparatus fire lane? d) Are there any tree canopies expected to grow across the aerial fire lane? (Based on mature canopy width of tree species) 	X Yes X Yes Ves Yes	☐ No ☐ No X No X No	□ N/A □ N/A □ N/A □ N/A
 If yes, answer the following questions: a) Is the aerial apparatus fire lane parallel to one entire side of the building and covering at least 25% of the perimeter? b) Is the near edge of the aerial apparatus fire lane between 15' and 30' from the building? c) Are there any overhead power or utility lines located across the aerial apparatus fire lane? d) Are there any tree canopies expected to grow across the aerial fire lane? (Based on mature canopy width of tree species) e) Does the aerial apparatus fire lane have a minimum unobstructed width of 26-feet? 	X Yes X Yes Ves Yes X Yes	□ No □ No ⊠ No ☑ No □ No	 □ N/A □ N/A □ N/A □ N/A □ N/A
 If yes, answer the following questions: a) Is the aerial apparatus fire lane parallel to one entire side of the building and covering at least 25% of the perimeter? b) Is the near edge of the aerial apparatus fire lane between 15' and 30' from the building? c) Are there any overhead power or utility lines located across the aerial apparatus fire lane? d) Are there any tree canopies expected to grow across the aerial fire lane? (Based on mature canopy width of tree species) e) Does the aerial apparatus fire lane have a minimum unobstructed width of 26-feet? f) Is the space between the aerial lane and the building free of trees exceeding 20' in heights? 7. Are all portions of the required fire lanes within 500-feet of at least (2) hydrants?	X Yes X Yes Ves Yes	☐ No ☐ No X No X No	□ N/A □ N/A □ N/A □ N/A
 If yes, answer the following questions: a) Is the aerial apparatus fire lane parallel to one entire side of the building and covering at least 25% of the perimeter? b) Is the near edge of the aerial apparatus fire lane between 15' and 30' from the building? c) Are there any overhead power or utility lines located across the aerial apparatus fire lane? d) Are there any tree canopies expected to grow across the aerial fire lane? (Based on mature canopy width of tree species) e) Does the aerial apparatus fire lane have a minimum unobstructed width of 26-feet? f) Is the space between the aerial lane and the building free of trees exceeding 20' in heights? 7. Are all portions of the required fire lanes within 500-feet of at least (2) hydrants? <i>Note: Distances shall be measured along the path of the hose lay as it comes off the fire apparatus.</i> a) Is the fire lane at least 26' wide for at least 20-feet on each side of the hydrants? b) Is there at least 40' between a hydrant and the building? c) Are the hydrant(s) setback no less than 5-feet nor more than 10-feet from the curb or edge of the	X Yes Yes Yes Yes X Yes X Yes Yes	□ No □ No ☑ No ☑ No □ No ☑ No	□ N/A □ N/A □ N/A □ N/A □ N/A □ N/A
 If yes, answer the following questions: a) Is the aerial apparatus fire lane parallel to one entire side of the building and covering at least 25% of the perimeter? b) Is the near edge of the aerial apparatus fire lane between 15' and 30' from the building? c) Are there any overhead power or utility lines located across the aerial apparatus fire lane? d) Are there any tree canopies expected to grow across the aerial fire lane? (Based on mature canopy width of tree species) e) Does the aerial apparatus fire lane have a minimum unobstructed width of 26-feet? f) Is the space between the aerial lane and the building free of trees exceeding 20' in heights? 7. Are all portions of the required fire lanes within 500-feet of at least (2) hydrants? <i>Note: Distances shall be measured along the path of the hose lay as it comes off the fire apparatus.</i> a) Is there at least 40' between a hydrant and the building? c) Are the hydrant(s) setback no less than 5-feet nor more than 10-feet from the curb or edge of the street or fire lane? d) Are hydrants located in parking lot islands a minimum of 3½-feet from the hydrant to the curb? 	X Yes X Yes Yes Yes X Yes X Yes X Yes X Yes X Yes	□ No □ No ☑ No ☑ No ☑ No ☑ No □ No □ No	 N/A
 If yes, answer the following questions: a) Is the aerial apparatus fire lane parallel to one entire side of the building and covering at least 25% of the perimeter? b) Is the near edge of the aerial apparatus fire lane between 15' and 30' from the building? c) Are there any overhead power or utility lines located across the aerial apparatus fire lane? d) Are there any tree canopies expected to grow across the aerial fire lane? (Based on mature canopy width of tree species) e) Does the aerial apparatus fire lane have a minimum unobstructed width of 26-feet? f) Is the space between the aerial lane and the building free of trees exceeding 20' in heights? 7. Are all portions of the required fire lanes within 500-feet of at least (2) hydrants? <i>Note: Distances shall be measured along the path of the hose lay as it comes off the fire apparatus.</i> a) Is the re at least 26' wide for at least 20-feet on each side of the hydrants? b) Is there at least 40' between a hydrant and the building? c) Are the hydrant(s) setback no less than 5-feet nor more than 10-feet from the curb or edge of the street or fire lane?	X Yes Yes Yes Yes X Yes X Yes X Yes X Yes X Yes X Yes X Yes	□ No □ No ☑ No ☑ No ☑ No ☑ No □ No □ No □ No	 N/A

Attach an additional sheet if further explanation is required for any answers.

This worksheet is based on MGO 34.503 and IFC 2015 Edition Chapter 5 and Appendix D; please see the codes for further information.