URBAN DESIGN COMMISSION APPLICATION



City of Madison **Planning Division** Madison Municipal Building, Suite 017 215 Martin Luther King, Jr. Blvd.



FOR OFFICE USE ONLY: Paid Receipt # Date received Received by _____ Aldermanic District Zoning District Urban Design District ____ Submittal reviewed by Legistar #

P.O. Box 2985 Madison, WI 53701-2985 (608) 266-4635 Complete all sections of this application, including the desired meeting date and the action requested. If you need an interpreter, translator, materials in alternate formats or other accommodations to access these forms, please call the phone number above immediately. 1. Project Information Address: _____ 2. Application Type (check all that apply) and Requested Date UDC meeting date requested _____ Alteration to an existing or previously-approved development New development Informational Final approval Initial approval 3. Project Type Project in an Urban Design District Signage Project in the Downtown Core District (DC), Urban Comprehensive Design Review (CDR) Mixed-Use District (UMX), or Mixed-Use Center District (MXC) Signage Variance (i.e. modification of signage height, Project in the Suburban Employment Center District (SEC), area, and setback) Campus Institutional District (CI), or Employment Campus Signage Exception District (EC) Planned Development (PD) Other General Development Plan (GDP) Please specify Specific Implementation Plan (SIP) Planned Multi-Use Site or Residential Building Complex 4. Applicant, Agent, and Property Owner Information Company _____ Applicant name City/State/Zip _____ Street address Telephone Project contact person _____ Company _____ Street address City/State/Zip _____ Telephone Property owner (if not applicant) Street address City/State/Zip _____

Email

Telephone

Urban Design Commission Application (continued)

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Each submittal must include

fourteen (14) 11" x 17" collated

paper copies. Landscape and

Lighting plans (if required)

must be full-sized and legible.

Please refrain from using

plastic covers or spiral binding.

5. Required Submittal Materials

- ☐ Application Form
- ☐ Letter of Intent
 - If the project is within an Urban Design District, a summary of how the development proposal addresses the district criteria is required
 - For signage applications, a summary of how the proposed signage is consistent with the applicable CDR or Signage Variance review criteria is required.
- Development Plans (Refer to checklist on Page 4 for plan details)
- ☐ Filing fee
- ☐ Electronic Submittal*
- □ Notification to the District Alder

Please provide an email to the District Alder notifying them that you are filing this UDC application. Please send this
as early in the process as possible and provide a copy of that email with the submitted application.

Both the paper copies and electronic copies <u>must</u> be submitted prior to the application deadline before an application will be scheduled for a UDC meeting. Late materials will not be accepted. A completed application form is required for each UDC appearance.

For projects also requiring Plan Commission approval, applicants must also have submitted an accepted application for Plan Commission consideration prior to obtaining any formal action (initial or final approval) from the UDC. All plans must be legible when reduced.

*Electronic copies of all items submitted in hard copy are required. Individual PDF files of each item submitted should be compiled on a CD or flash drive, or submitted via email to udcapplications@cityofmadison.com. The email must include the project address, project name, and applicant name. Electronic submittals via file hosting services (such as Dropbox.com) are not allowed. Applicants who are unable to provide the materials electronically should contact the Planning Division at (608) 266-4635 for assistance.

6. Applicant Declarations

- Prior to submitting this application, the applicant is required to discuss the proposed project with Urban Design Commission staff. This application was discussed with <u>Kevin Firchow</u> on 3/18/2021
- 2. The applicant attests that all required materials are included in this submittal and understands that if any required information is not provided by the application deadline, the application will not be placed on an Urban Design Commission agenda for consideration.

Name of applicant Tyler Krupp	DocuSigned by: Relationship to	property deve	loper	
Authorizing signature of property owner	Eric Halverson	Date	11/28/2022	

7. Application Filing Fees

Fees are required to be paid with the first application for either initial or final approval of a project, unless the project is part of the combined application process involving the Urban Design Commission in conjunction with Plan Commission and/or Common Council consideration. Make checks payable to City Treasurer. Credit cards may be used for application fees of less than \$1,000.

Please consult the schedule below for the appropriate fee for your request:

- ☐ Urban Design Districts: \$350 (per §35.24(6) MGO).
- ☐ Minor Alteration in the Downtown Core District (DC) or Urban Mixed-Use District (UMX): \$150 (per §33.24(6)(b) MGO)
- ☐ Comprehensive Design Review: \$500 (per §31.041(3)(d)(1)(a) MGO)
- ☐ Minor Alteration to a Comprehensive Sign Plan: \$100 (per §31.041(3)(d)(1)(c) MGO)
- □ All other sign requests to the Urban Design Commission, including, but not limited to: appeals from the decisions of the Zoning Administrator, requests for signage variances (i.e. modifications of signage height, area, and setback), and additional sign code approvals: \$300 (per §31.041(3)(d)(2) MGO)
- A filing fee is not required for the following project applications if part of the combined application process involving both Urban Design Commission and Plan Commission:
- Project in the Downtown Core District (DC), Urban Mixed-Use District (UMX), or Mixed-Use Center District (MXC)
- Project in the Suburban Employment Center District (SEC), Campus Institutional District (CI), or Employment Campus District (EC)
- Planned Development (PD): General Development
 Plan (GDP) and/or Specific Implementation Plan (SIP)
- Planned Multi-Use Site or Residential Building Complex

URBAN DESIGN COMMISSION APPROVAL PROCESS



Introduction

The City of Madison's Urban Design Commission (UDC) has been created to:

- Encourage and promote high quality in the design of new buildings, developments, remodeling, and additions so as to maintain and improve the established standards of property values within the City.
- Foster civic pride in the beauty and nobler assets of the City, and in all other ways possible assure a functionally efficient and visually attractive City in the future.

Types of Approvals

There are three types of requests considered by the UDC:

- Informational Presentation. Applicants may, at their discretion, request to make an Informational Presentation to the
 UDC prior to seeking any approvals to obtain early feedback and direction before undertaking detailed design. Applicants
 should provide details on the context of the site, design concept, site and building plans, and other relevant information
 to help the UDC understand the proposal and provide feedback. (Does not apply to CDR's or Signage Variance requests)
- <u>Initial Approval</u>. Applicants may, at their discretion, request initial approval of a proposal by presenting preliminary design information. As part of their review, the Commission will provide feedback on the design information that should be addressed at Final Approval stage.
- <u>Final Approval</u>. Applicants may request Final Approval of a proposal by presenting all final project details. Recommendations or concerns expressed by the UDC in the initial approval must be addressed at this time.

Presentations to the Commission

Primarily, the UDC is interested in the appearance and design quality of projects. Emphasis should be given to the site plan, landscape plan, lighting plan, building elevations, exterior building materials, color scheme, and graphics.

When presenting projects to the UDC, applicants must fill out a registration slip provided in the meeting room and present it to the Secretary. Presentations should generally be limited to 5 minutes or as extended by motion by consent of the Commission. The Commission will withhold questions until the end of the presentation.

Applicants are encouraged to consider the use of various graphic presentation material including a locator map, photographs, renderings/model, scale drawings of the proposal in context with adjacent buildings/uses/signs, etc., as may be deemed appropriate to describe the project and its surroundings. Graphics should be mounted on rigid boards so that they may be easily displayed. Applicants/presenters are responsible for all presentation materials, AV equipment and easels.

URBAN DESIGN DEVELOPMENT PLANS CHECKLIST



The items listed below are minimal application requirements for the type of approval indicated. Please note that the UDC and/or staff may require additional information in order to have a complete understanding of the project.

1. Informa	tional Presentation					
	Locator Map)		Requirem	ents for All Plan Sheets	
	Letter of Intent (If the project is within			1. Title	block	
	an Urban Design District, a summary of how the development proposal addresses			2. Shee	et number	
	the district criteria is required)		Providing additional	3. Nort	th arrow	
	Contextual site information, including	\	information beyond these minimums may generate		e, both written and graphic	
	photographs and layout of adjacent buildings/structures		a greater level of feedback	5. Date	e dimensioned plans, scaled	
	Site Plan		from the Commission.	at 1"	'= 40' or larger	
	Two-dimensional (2D) images of				ns must be legible, including great landscape and lighting	
	proposed buildings or structures.	J		plans (if re		
2. Initial A	pproval					
	Locator Map)		
	Letter of Intent (If the project is within a the development proposal addresses the			of <u>how</u>		
	Contextual site information, including phostructures	otog	raphs and layout of adjacent bu	uildings/	Providing additional information beyond these	
	Site Plan showing location of existing a lanes, bike parking, and existing trees ov			res, bike	minimums may generate a greater level of feedback	
	Landscape Plan and Plant List (<i>must be legible</i>) from the Commission.				_	
	Building Elevations in both black & whi material callouts)	te ar	nd color for all building sides	(include		
	PD text and Letter of Intent (if applicable	·)		J		
3. Final Ap	proval					
All the re	equirements of the Initial Approval (see ab	oove)), <u>plus</u> :			
	Grading Plan					
	Proposed Signage (if applicable)					
	Lighting Plan, including fixture cut sheets and photometrics plan (must be legible)					
	Utility/HVAC equipment location and scr	eeni	ng details (with a rooftop plan	if roof-mou	inted)	
	PD text and Letter of Intent (if applicable	(ټ				
	Samples of the exterior building materia	ls (pr	resented at the UDC meeting)			
4. Compre	nensive Design Review (CDR) and Varia	nce l	Requests (<i>Signage applicatio</i>	ons only)		
	Locator Map		, , , , , , , , , , , , , , , , , , , ,			
	Letter of Intent (a summary of how the prop	osec	d signage is consistent with the CI	DR or Signage	e Variance criteria is required)	
	Contextual site information, including photographs of existing signage both on site and within proximity to the project site					
	Site Plan showing the location of existing signage and proposed signage, dimensioned signage setbacks, sidewalks, driveways, and right-of-ways					
	Proposed signage graphics (fully dimensi	ione	d, scaled drawings, including m	naterials and	d colors, and night view)	
	Perspective renderings (emphasis on ped	destr	rian/automobile scale viewshed	ds)		
	Illustration of the proposed signage that	mee	ets Ch. 31, MGO compared to v	vhat is being	g requested.	
	Graphic of the proposed signage as it relates to what the Ch. 31, MGO would permit					

November 28, 2022

Ms. Heather Stouder
Director, Planning Division
City of Madison Department of Planning & Community & Economic Development
215 Martin Luther King Jr. Blvd., Ste 017
Madison, Wisconsin 53703

knothe • bruce

RE: Letter of Intent

2165 Linden Ave., Madison, WI UDC Submittal KBA Project# 2102

Ms. Heather Stouder,

The following is submitted together with the plans and application for the staff, Urban Design Commission, and Plan Commission's consideration of approval.

Owner: Threshold Development Architect: Knothe & Bruce Architects, LLC

1954 Atwood Ave. 7601 University Avenue, Ste 201

Madison, WI 53704 Middleton, WI 53562

608-233-6000 608-836-3690

Contact: Joe Krupp

Contact: Kevin Burow

kburow@knothebruce.com

Civil: JSD Professional Services, Inc. Landscape JSD Professional Services, Inc. Engineer: 161 Horizon Drive, Ste. 101 Architect: 161 Horizon Drive, Ste. 101

Verona, WI 53593Verona, WI 53593(608) 848-5060(608) 848-5060Contact: Kevin YeskaContact: Kevin YeskaKevin.Yeska@jsdinc.comKevin.Yeska@jsdinc.com

Introduction:

This proposed development is currently zoned as TR-VI (Traditional Residential-Varied District I) and is the current site of the Zion Faith Community Church. The site will need to be rezoned as PD (Planned Development District) and this will provide the opportunity for new construction of much needed residential units that have walkable access to a coffeeshop, barber shop, restaurants, and many other essential, local businesses.

Project Description:

This development proposes a two to three-story, multi-family building with structured underground parking. There will be 32 dwelling units that consist of studios, one-bedrooms, and two-bedroom apartments.

The proposed building has been designed to be in context with the neighboring structures and will serve as a transition from the 4-story mixed use building to the south and the single-family homes to the north. This building has been designed as a two to three-story structure with the third floor set back

Letter of Intent – Land Use 2165 Linden Ave. November 28, 2022 Page 2 of 5

on all street sides of the property such that there are only two-story facades along the sidewalks. The building has also been designed to resemble townhomes built next to each other so that the residential scale and context is further reinforced. This design solution was achieved after much discussion with the stakeholders of this project, as explained in more detail below. The garage access is located along the south side of the building and is utilizing a shared access easement between the neighboring properties to keep all vehicular traffic away from the surrounding neighborhood.

<u>Planned Development Standards</u> Statement of Purpose

We believe the proposed project meets the general intention and specific requirements for a planned development district. While we understand the PD is meant to rarely be used, we believe the particulars of this site and process are uniquely suited for a PD. We were encouraged to pursue a PD by City Officials and neighborhood leaders familiar with the particularities of this site and process.

General intention of PD

The general intention of the PD district is "to provide a voluntary regulatory framework as a means to facilitate the unique development of land in an integrated and innovative fashion, to allow for flexibility in site design, and to encourage development that is sensitive to environmental, cultural, and economic considerations, and that features high-quality architecture and building materials." We believe this proposal meets the standard of being a 'unique development', in multiple ways. The context itself, of a Church vacating land in a manner not anticipated by city planning makes the underlying zoning issues unique. That underlying unanticipated zoning context generated a truly unique consultative process involving neighborhood and City stakeholders. While that process did not generate unanimity or consensus, it did generate the outlines of a compromise than garnered significant support. The PD is being requested partly as a means to be sensitive to the 'environmental and cultural' considerations of respecting that compromise. The PD was thought to be the best way of ensuring that the developers would be narrowly constrained to honor the spirit and outline of the unique and specific compromise(s) that resulted from the neighborhood process.

Lastly, we believe the architecture and materials of this project meet the standard of 'high-quality architecture and building materials' and were arrived at in response to guidance from the neighborhood, Urban Design Commission, and Passive House consultants.

Specific objective(s)

In addition to meeting the general intent of the PD district, our proposal aims to achieve the specific objective(s) (A) of the PD guidelines "Promotion of green building technologies, low-impact development techniques for stormwater management, and other innovative measures that encourage sustainable development." This project will be exemplary in promoting green building

Letter of Intent – Land Use 2165 Linden Ave. November 28, 2022 Page 3 of 5

technologies, low-impact development techniques for stormwater management, and more generally encouraging sustainable development.

We are committed to pursuing passive house net-zero ready standards of construction and building performance on this project. In our assessment, passive house construction and the PHIUS criteria for certification are the current best practice for sustainable building in the United States. Passive house construction can reduce energy use by up to 70-80%. When combined with renewable Photo Voltaic (PV) energy, passive house buildings can attain net-zero energy use. While this building approach and technology has a long history, it's only in the past 5 years that it has become a reality in multifamily housing projects at any scale. It is quickly being incentivized, and becoming the norm, in Massachusetts, New York, and Pennsylvania. We are committed to pursuing passive house net zero ready standards on this project for its own sake, but also as a step towards making passive house construction our baseline for all future projects. We have hired Precipitate passive house consulting to train our entire team, including the contractor and architect for this project, and to expand our capacities for future passive house projects in Madison. This project would be the first attempt in Madison by a for profit developer to achieve passive house standards on a multifamily project. We hope to demonstrate to ourselves, the City, and the broader development community that such standards can be achieved by for profit developers in Madison.

Low impact development techniques for stormwater management

- This project will provide greater improvements over current conditions for stormwater management by the elimination of the surface parking lot and being in full compliance with the new stormwater standards.
- 2. A rain garden will be utilized to visually demonstrate a stormwater management system at the northwest corner of the property, so that the residents and the surrounding neighborhood can see this and enjoy the beauty that it provides.
- 3. The rest of the stormwater management will be accomplished with a green roof system on the 3rd floor level of this building. This too will be visible and enjoyed by the residents of this project.
- 4. Beyond the items listed above, no man-made structures or holding tanks are required, beyond standard piping that ties into the storm sewer system.

City and Neighborhood Input:

We met with the City Staff and the Alder very early on in this process to have a solid understanding of the steps that would need to be taken for this redevelopment to be approved. There were then multiple meetings directly with the immediate neighbors of this property and larger group neighborhood meetings as well, that were spearheaded by Brad Hinkfuss with SASY. These often-included Alder Benford and then Alder Foster was included as well. The project evolved through these discussions and the final resulting design was based on an iterative process arrived at through collaboration with all

Letter of Intent – Land Use 2165 Linden Ave. November 28, 2022 Page 4 of 5

parties. We then presented this project to DAT and received further feedback and that information that has been taken into account with this submittal.

Demolition Standards

The structure to be removed has served the community well but unfortunately given today's environment and the diminishing number of members of the Zion Faith Community, the building is no longer needed to host worship services or provide other uses for this congregation. Zion has merged with Lakeview Moravian Community Church and will be basing their ministries out of that facility and has made the hard decision that this building will no longer be used. The structure itself, while having sentimental value, is not a landmark structure, nor does it have any historical significance for this area. Also, it is not of an uncommon or unusual design or method of construction, and as such should meet the demolition criteria. We believe the demolition standards can be met, and a Re-use and Recycling Plan will be submitted prior to the deconstruction of the existing commercial structure.

Site Development Data:

Densities:

Lot Area	20,597 S.F. / 0.47 acres
Dwelling Units	32 DU
Lot Area / D.U.	644 S.F./D.U.
Density	68 units/acre
Open Space	3,331 S.F.
Open Space / Unit	104 S.F./Unit

Lot Coverage 15,220 S.F. = 74% of total lot

Building Height: 2 to 3 Stories

Dwelling Unit Mix:

Junior One Bedroom	8
One Bedroom	13
Two Bedroom	
Total Dwelling Units	32

Vehicle Parking:

Surface	0 stalls
Enclosed	32 stalls
Total	32 stalls

Bicycle Parking:

Surface Guest	4 stalls
Underground Garage F.M.	24 stalls
Underground Garage W.M.	8 stalls
Total	36 stalls

Letter of Intent – Land Use 2165 Linden Ave. November 28, 2022 Page 5 of 5

Project Schedule:

It is anticipated that the construction on this site will begin in Summer of 2023 with a final completion date of Spring/Summer of 2024.

Thank you for your time reviewing our proposal.

Sincerely,

Kevin Burow, AIA, NCARB, LEED AP

Keni Bun

Managing Manager

Zoning Text

Zion Lutheran Church Redevelopment

2165 Linden Ave.

Legal Description: The lands subject to this planned development shall include those described in Exhibit B (attached).

A. Statement of Purpose: This zoning district is established to allow the construction of residential multi-family housing.


B. Permitted Uses:

- 1. Those uses that are stated as permitted or conditional uses in the Traditional Shopping Street (TSS) zoning district.
- 2. Uses accessory to the permitted or conditional uses listed in the TSS zoning district.
- C. Lot Area: As stated in Exhibit B (attached).
- D. Maximum Building Height: Heights shall be as indicated on the adopted plans and shall be no higher than 3 stories.
- E. Set Backs: Set backs are to be provided as shown on the approved plans.
- F. Landscaping: Site landscaping will be provided as shown on the approved plans.
- G. Accessory Off-Street Parking & Loading: Accessory off-street parking will be provided as shown on the approved plans.
- H. Lighting: Site lighting will be provided as shown on the approved plans.
- I. Signage: Signage will be allowed as per Chapter 31 of the Madison General Ordinances, as compared to the TSS zoning district.

J. Phasing:

- a. This project will be completed in one phase.
- K. Family Definition: The family definition of this Planned Development shall coincide with the definition given in Chapter 28.211 of the Madison General Ordinances for the TSS zoning district.
- L. Alterations: No alteration or revision of this planned development shall be permitted unless approved by the City Plan Commission, however, the Zoning Administrator may issue permits for minor alterations or additions which are approved by the Director of Planning and Development and the alderperson of the district and are compatible with the concept approved by the City Plan Commission.



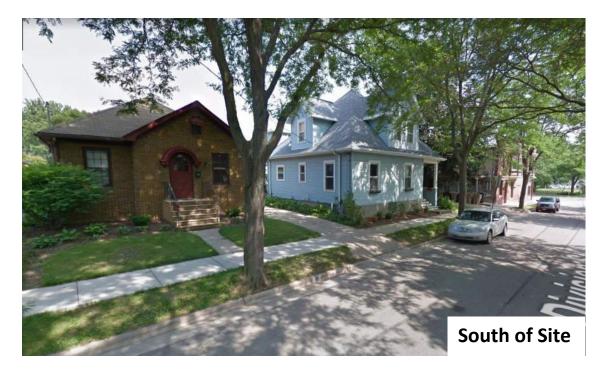








































Specifications

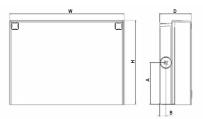

Front View

Side View

Luminaira	Height (H)	Width (W)	Depth (D)	Side Condu	it Location	Weight
Lummaire	neight (n)	wiath (w)	veptii (v)	A	В	weight
WPX1	8.1" (20.6 cm)	11.1" (28.3 cm)	3.2" (8.1 cm)	4.0" (10.3 cm)	0.6" (1.6 cm)	6.1 lbs (2.8kg)
WPX2	9.1" (23.1 cm)	12.3" (31.1 cm)	4.1" (10.5 cm)	4.5" (11.5 cm)	0.7" (1.7 cm)	8.2 lbs (3.7kg)
WPX3	9.5" (24.1 cm)	13.0" (33.0 cm)	5.5" (13.7 cm)	4.7" (12.0 cm)	0.7" (1.7 cm)	11.0 lbs (5.0kg)

Cataloa Numbe Notes Туре

Introduction

The WPX LED wall packs are energy-efficient, costeffective, and aesthetically appealing solutions for both HID wall pack replacement and new construction opportunities. Available in three sizes, the WPX family delivers 1,550 to 9,200 lumens with a wide, uniform distribution.

The WPX full cut-off solutions fully cover the footprint of the HID glass wall packs that they replace, providing a neat installation and an upgraded appearance. Reliable IP66 construction and excellent LED lumen maintenance ensure a long service life. Photocell and emergency egress battery options make WPX ideal for every wall mounted lighting application.

Ordering Information

EXAMPLE: WPX2 LED 40K MVOLT DDBXD

Series		Color Temperature	Voltage	Options	Finish
WPX1 LED P1 WPX1 LED P2 WPX2 LED WPX3 LED	1,550 Lumens, 11W ¹ 2,900 Lumens, 24W 6,000 Lumens, 47W 9,200 Lumens, 69W	30K 3000K 40K 4000K 50K 5000K	MVOLT 120V - 277V 347 347V ³	(blank) None E4WH Emergency battery backup, CEC compliant (4W, 0°C min)² E14WC Emergency battery backup, CEC compliant (14W, -20°C min)² PE Photocell³	DDBXD Dark bronze DWHXD White DBLXD Black Note: For other options, consult factory.

Note: The lumen output and input power shown in the ordering tree are average representations of all configuration options. Specific values are available on request.

- All WPX wall packs come with 6kV surge protection standard, except WPX1 LED P1 package which comes with 2.5kV surge protection standard. Add SPD6KV option to get WPX1 LED P1 with 6kV surge protection.
 Sample nomenclature: WPX1 LED P1 40K MVOLT SPD6KV DDBXD
- 2. Battery pack options only available on WPX1 and WPX2. 3. Battery pack options not available with 347V and PE options.

FEATURES & SPECIFICATIONS

INTENDED USE

The WPX LED wall packs are designed to provide a cost-effective, energy-efficient solution for the one-for-one replacement of existing HID wall packs. The WPX1, WPX2 and WPX3 are ideal for replacing up to 150W, 250W, and 400W HID luminaires respectively. WPX luminaires deliver a uniform, wide distribution.

CONSTRUCTION

WPX feature a die-cast aluminum main body with optimal thermal management that both enhances LED efficacy and extends component life. The luminaires are IP66 rated, and sealed against moisture or environmental contaminants.

ELECTRICAL

Light engine(s) configurations consist of high-efficacy LEDs and LED lumen maintenance of L90/100,000 hours. Color temperature (CCT) options of 3000K, 4000K and 5000K with minimum CRI of 70. Electronic drivers ensure system power factor >90% and THD <20%. All luminaires have 6kV surge protection (Note: WPX1 LÉD P1 package comes with a standard surge protection rating of 2.5kV. It can be ordered with an optional 6kV surge protection). All photocell (PE) operate on MVOLT (120V - 277V) input.

Note: The standard WPX LED wall pack luminaires come with field-adjustable drive current feature. This feature allows tuning the output current of the LED drivers to adjust the lumen output (to dim the luminaire).

WPX can be mounted directly over a standard electrical junction box. Three 1/2 inch conduit ports on three sides allow for surface conduit wiring. A port on the back surface allows poke-through conduit wiring on surfaces that don't have an electrical junction box. Wiring can be made in the integral wiring compartment in all cases. WPX is only recommended for installations with LEDs facing downwards.

LISTINGS

CSA Certified to meet U.S. and Canadian standards. Suitable for wet locations. IP66 Rated. DesignLights Consortium® (DLC) qualified product. Not all versions of this product may be DLC qualified. Please check the DLC Qualified Products List at www. which versions are qualified. International Dark Sky Association (IDA) Fixture Seal of Approval (FSA) is available for all products on this page utilizing 3000K color temperature only.

5-year limited warranty. Complete warranty terms located at:

Note: Actual performance may differ as a result of end-user environment and application. All values are design or typical values, measured under laboratory conditions at 25°C. Specifications subject to change without notice.



Performance Data

Electrical Load

Luminaire	Input Power (W)	120V	208V	240V	277V	347V
WPX1 LED P1	11W	0.09	0.05	0.05	0.04	0.03
WPX1 LED P2	24W	0.20	0.12	0.10	0.09	0.07
WPX2	47W	0.39	0.23	0.20	0.17	0.14
WPX3	69W	0.58	0.33	0.29	0.25	0.20

Projected LED Lumen Maintenance

Data references the extrapolated performance projections in a 25° C ambient, based on 6,000 hours of LED testing (tested per IESNA LM-80-08 and projected per IESNA TM-21-11).

To calculate LLF, use the lumen maintenance factor that corresponds to the desired number of operating hours below. For other lumen maintenance values, contact factory.

Operating Hours	50,000	75,000	100,000
Lumen Maintenance Factor	>0.94	>0.92	>0.90

HID Replacement Guide

Luminaire	Equivalent HID Lamp	WPX Input Power
WPX1 LED P1	100W	11W
WPX1 LED P2	150W	24W
WPX2	250W	47W
WPX3	400W	69W

Lumen Output

Luminaire	Color Temperature	Lumen Output
	3000K	1,537
WPX1 LED P1	4000K	1,568
	5000K	1,602
	3000K	2,748
WPX1 LED P2	4000K	2,912
	5000K	2,954
	3000K	5,719
WPX2	4000K	5,896
	5000K	6,201
	3000K	8,984
WPX3	4000K	9,269
	5000K	9,393

Lumen Ambient Temperature (LAT) Multipliers

Use these factors to determine relative lumen output for average ambient temperatures from 0-50°C (32-122°F).

Ambient	Ambient	Lumen Multiplier
0°C	32°F	1.05
5°C	41°F	1.04
10°C	50°F	1.03
15℃	59°F	1.02
20°C	68°F	1.01
25°C	77°F	1.00
30°C	86°F	0.99
35℃	95°F	0.98
40°C	104°F	0.97

Emergency Egress Battery Packs


The emergency battery backup is integral to the luminaire — no external housing or back box is required. The emergency battery will power the luminaire for a minimum duration of 90 minutes and deliver minimum initial output of 550 lumens. Both battery pack options are CEC compliant.


Battery Type	Minimum Temperature Rating	Power (Watts)	Controls Option	Ordering Example
Standard	0°C	4W	E4WH	WPX2 LED 40K MVOLT E4WH DDBXD
Cold Weather	-20°C	14W	E14WC	WPX2 LED 40K MVOLT E14WC DDBXD


Photometric Diagrams


To see complete photometric reports or download .ies files for this product, visit the Lithonia Lighting WPX LED homepage. Tested in accordance with IESNA LM-79 and LM-80 standards



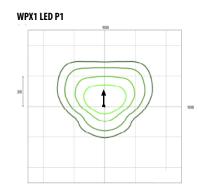

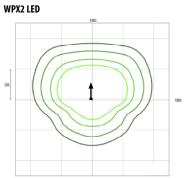

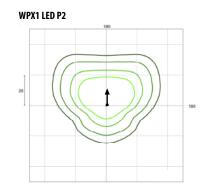

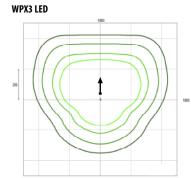

Mounting Height = 12 Feet.



GENERAL NOTES:

I. THE APPLICANT SHALL REPLACE ALL SIDEWALK AND CURB AND GUTTER THAT ABUTS THE PROPERTY THAT IS DAMAGED BY THE CONSTRUCTION, OR ANY SIDEWALK AND CURB AND GUTTER WHICH THE CITY ENGINEER DETERMINES NEEDS TO BE REPLACED BECAUSE IT IS NOT AT A DESIRABLE GRADE REGARDLESS OF WHETHER THE CONDITION EXISTED PRIOR TO BEGINNING CONSTRUCTION.

2. ALL WORK IN THE PUBLIC RIGHT OF WAY SHALL BE PERFORMED BY A CITY-LICENSED CONTRACTOR.

ALL DAMAGE TO THE PAVEMENT ON CITY STREETS, AND ADJACENT TO THIS DEVELOPMENT SHALL BE RESTORED IN ACCORDANCE WITH THE CITY OF MADISON'S PAVEMENT PATCHING CRITERIA.

RENDERINGS

ALL PROPOSED STREET TREE REMOVALS WITHIN THE RIGHT OF WAY SHALL BE REVIEWED BY CITY FORESTRY BEFORE THE PLAN COMMISSION MEETING. STREET TREE REMOVALS REQUIRE APPROVAL AND A TREE REMOVAL PERMIT ESJUED BY CITY FORESTRY. ANY STREET TREE REMOVALS REQUESTED AFTER THE DEVELOPMENT PLAN IS APPROVED BY THE PLAN COMMISSION OR THE BOARD OF PUBLIC WORKS AND CITY COPINISSION OR THE BOARD OF PUBLIC WORKS AND CITT
PORESTRY WILL REQUIRE A MINIMUM OF A Z-HOUR REVIEW
PERIOD WHICH SHALL INCLUDE THE NOTHICATION OF THE
ALDERPERSON WITHIN WHOS DISTRICT IS AFFECTED BY THE
STREET TREE REMOVAL(S) PRIOR TO A TREE REMOVAL PERMIT

5. AS DEFINED BY THE SECTION 107.13 OF CITY OF MADISON STANDARD SPECIFICATIONS FOR PUBLIC WORKS CONSTRUCTION: NO EXCAVATION IS PERMITTED WITHIN 5

FEET OF THE TRUNK OF THE STREET TREE OR WHEN CUTTING ROOTS OVER 3 INCHES IN DIAMETER. IF EXCAVATION IS NECESSARY, THE CONTRACTOR SHALL CONTACT MADISON CITY FORESTRY (264-4816) PRIOR TO EXCAVATION. CITY OF MADISON PORESTRY PERSONNEL SHALL ASSESS THE MPACT TO THE TREE AND TO ITS ROOT SYSTEM PRIOR TO WORK COMMENCING. TREE PROTECTION SPECIFICATIONS CAN BE FOUND ON THE FOLLOWING WEBSITE: CITYOFMADISON.COM/BUSINESS/PW/SPECS.CFM

6. CONTRACTOR SHALL TAKE PRECAUTIONS DURING CONSTRUCTION TO NOT DISFIGURE, SCAR, OR IMPAIR THE HEALTH OF ANY STREET TREE. CONTRACTOR SHALL OPERATE REALINO FAMILS IN A MANNER AS TO NOT DAMAGE THE BRANCHES OF THE STREET TREES, THIS MAY REQUIRE USING SMALLER EQUIPMENT AND LOADING AND UNLOADING MATERIALS IN A DESIGNATED SPACE AWAY FROM TREES ON

THE CONSTRUCTION SITE. ANY DAMAGE OR INJURY TO EXISTING STREET TREES (EITHER ABOVE OR BELOW GROUND) SHALL BE REPORTED IMMEDIATELY TO CITY FORESTRY AT 266-4816. PENALTIES AND REMEDIATION SHALL BE REQUIRED.

SECTION 107.13(G) OF CITY OF MADISON STANDARD 7. SECTION 10/13/G) OF CITY OF MADISON STANDARD SPECIFICATIONS FOR PUBLIC WORKS CONSTRUCTION ADDRESSES SOIL COMPACTION NEAR STREET TREES AND SHALL BE FOLLOWED BY CONTRACTOR. THE STORAGE OF PARKED VEHICLES, CONSTRUCTION EQUIPMENT, BUILDING MATERIALS, REFUSE, EXCAVATED SPOILS OR DUMPING OF POISONOUS AND ADDRESSES AND STANDARD ADDRESSES OF SOURCE OF STANDARD ADDRESSES OF SOURCE OF SOURCE OF SOURCE OF STANDARD ADDRESSES OF SOURCE OF SOU MATERIALS ON OR AROUND TREES AND ROOTS WITHIN FIVE (5) FEET OF THE TREE OR WITHIN THE PROTECTION ZONE IS

8. ON THIS PROJECT, STREET TREE PROTECTION ZONE FENCING IS REQUIRED. THE FENCING SHALL BE ERECTED

BEFORE THE DEMOLITION, GRADING OR CONSTRUCTION BEGINS. THE FENCE SHALL INCLUDE THE ENTIRE WIDTH OF TERRACE AND, EXTEND AT LEAST 5 FEET ON BOTH SIDES OF THE OUTSIDE EDGE OF THE TREE TRUNK. DO NOT REMOVE THE FENCING TO ALLOW FOR DELIVERIES OR EQUIPMENT ACCESS THROUGH THE TREE PROTECTION ZONE.

9 STREET TREE PRUNING SHALL BE COORDINATED WITH 9. STREET INEE PROMING SHALL BE COORDINATED WITH MADISON PORESTRY AT A MINIMUM OF TWO WEEKS PRIOR TO THE START OF CONSTRUCTION FOR THIS PROJECT. ALL PRUNING SHALL FOLLOW THE AMERICAN NATIONAL STANDARDS INSTITUTE (ANSI) A300 - PART I STANDARDS FOR


IO. AT LEAST ONE WEEK PRIOR TO STREET TREE PLANTING, CONTRACTOR SHALL CONTACT CITY FORESTRY AT (608) 266-4816 TO SCHEDULE INSPECTION AND APPROVAL OF

NURSERY TREE STOCK AND REVIEW PLANTING SPECIFICATIONS

II. APPROVAL OF PLANS FOR THIS PROJECT DOES NOT INCLUDE ANY APPROVAL TO PRUNE, REMOVE, OR PLANT TREES IN THE PUBLIC RIGHT-OF-WAY. PERMISSION FOR SUCH ACTIVITIES MUST BE OBTAINED FROM THE CITY FORESTER.

12. THE PUBLIC RIGHT-OF-WAY IS THE SOLE JURISDICTION OF THE CITY OF MADISON AND IS SUBJECT TO CHANGE AT ANY TIME. NO ITEMS SHOWN ON THIS SITE PLAN IN THE RIGHT-OF-WAY ARE PERMANENT AND MAY NEED TO BE REMOVED AT THE APPLICANTS EXPENSE UPON NOTIFICATION



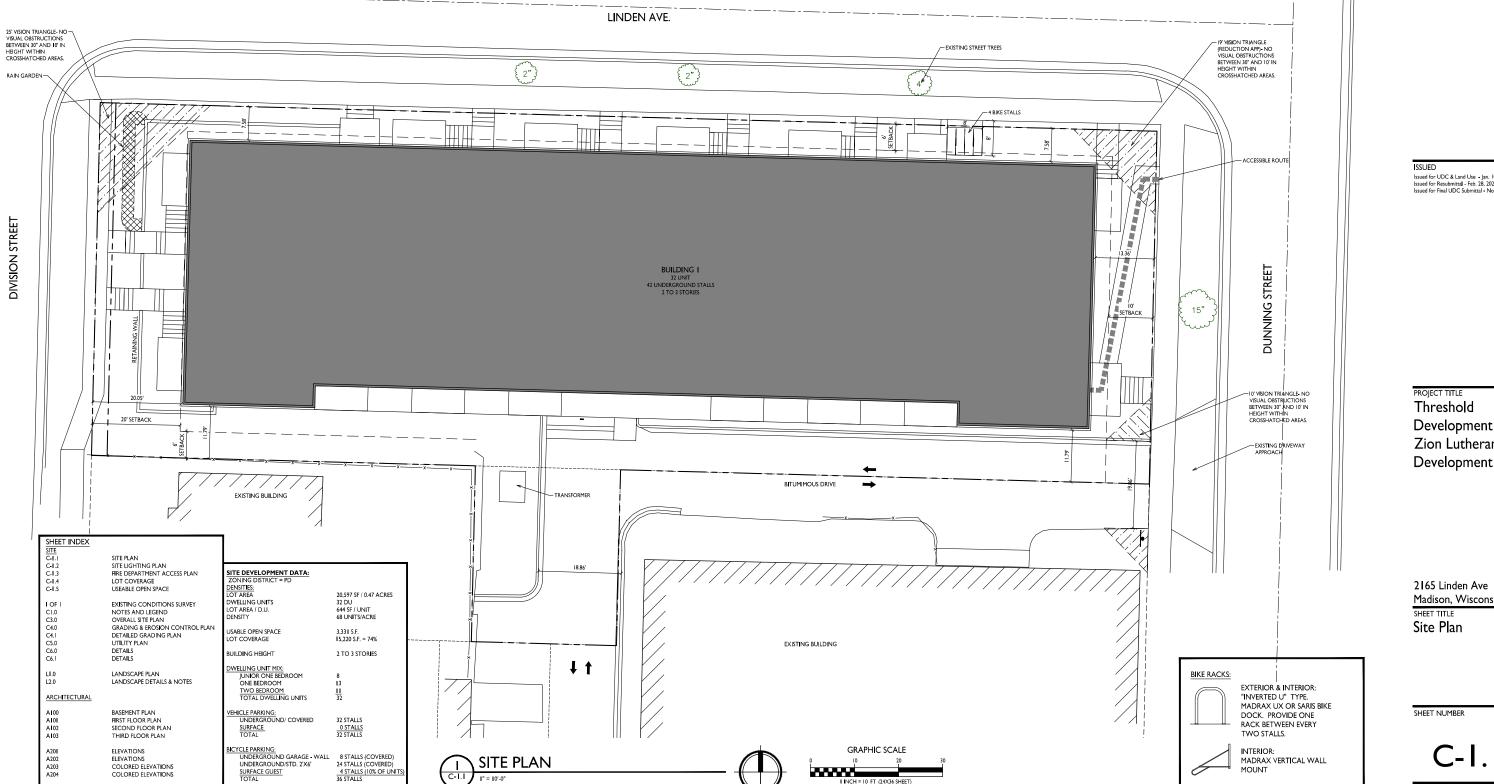


Issued for UDC & Land Use - Jan. 10, 2022 Issued for Resubmittal - Feb. 28, 2022 Issued for Final UDC Submittal - November 28, 2022

Development Zion Lutheran Site

2165 Linden Ave Madison, Wisconsin

2102 © Knothe & Bruce Architects, LLC

LINDEN AVE.

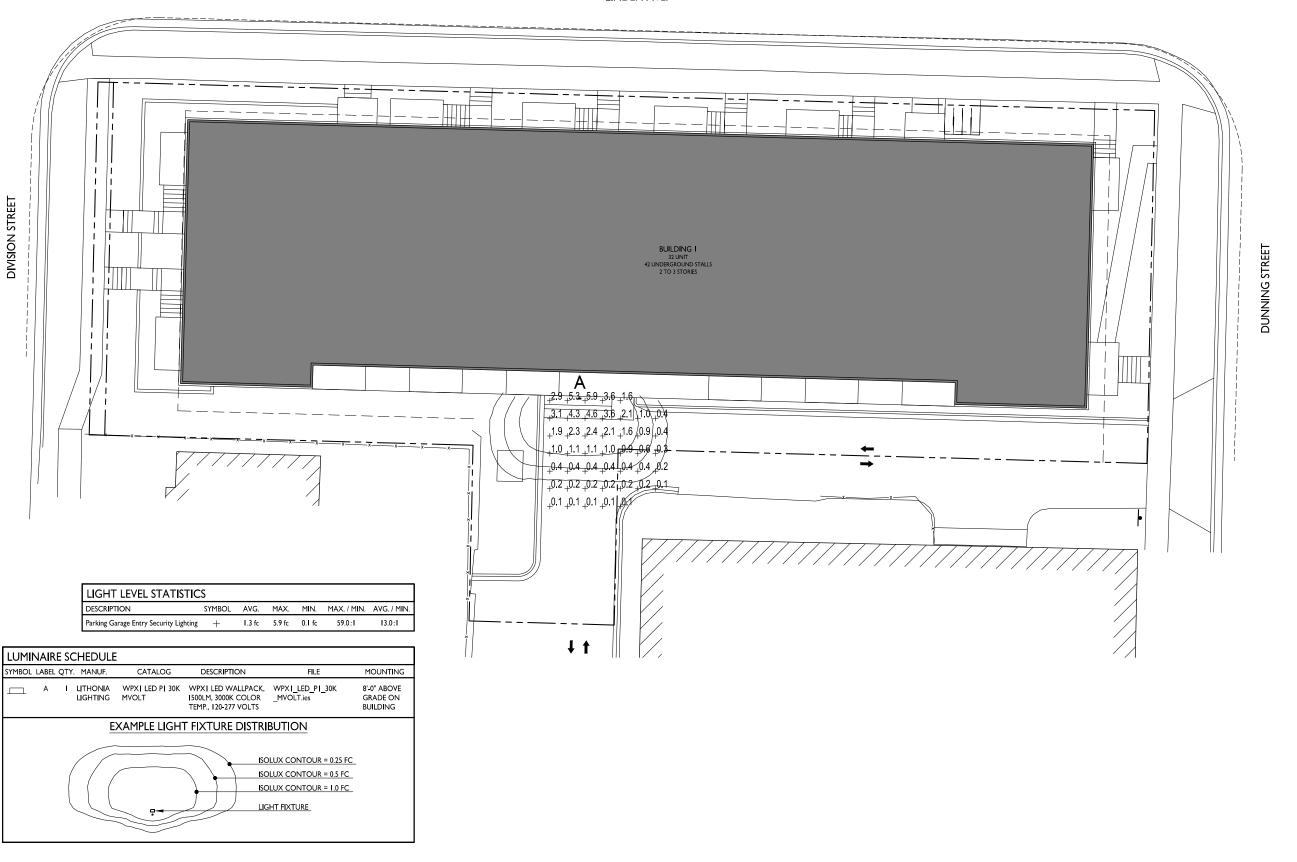

SITE LIGHTING PLAN



Issued for UDC & Land Use - Jan. 10, 2022 Issued for Resubmittal - Feb. 28, 2022 Issued for Final UDC Submittal - November 28, 2022

PROJECT TITLE


Threshold Development Zion Lutheran Site Development

2165 Linden Ave Madison, Wisconsin SHEET TITLE Site Lighting Plan


SHEET NUMBER

GRAPHIC SCALE

2102 © Knothe & Bruce Architects, LLC

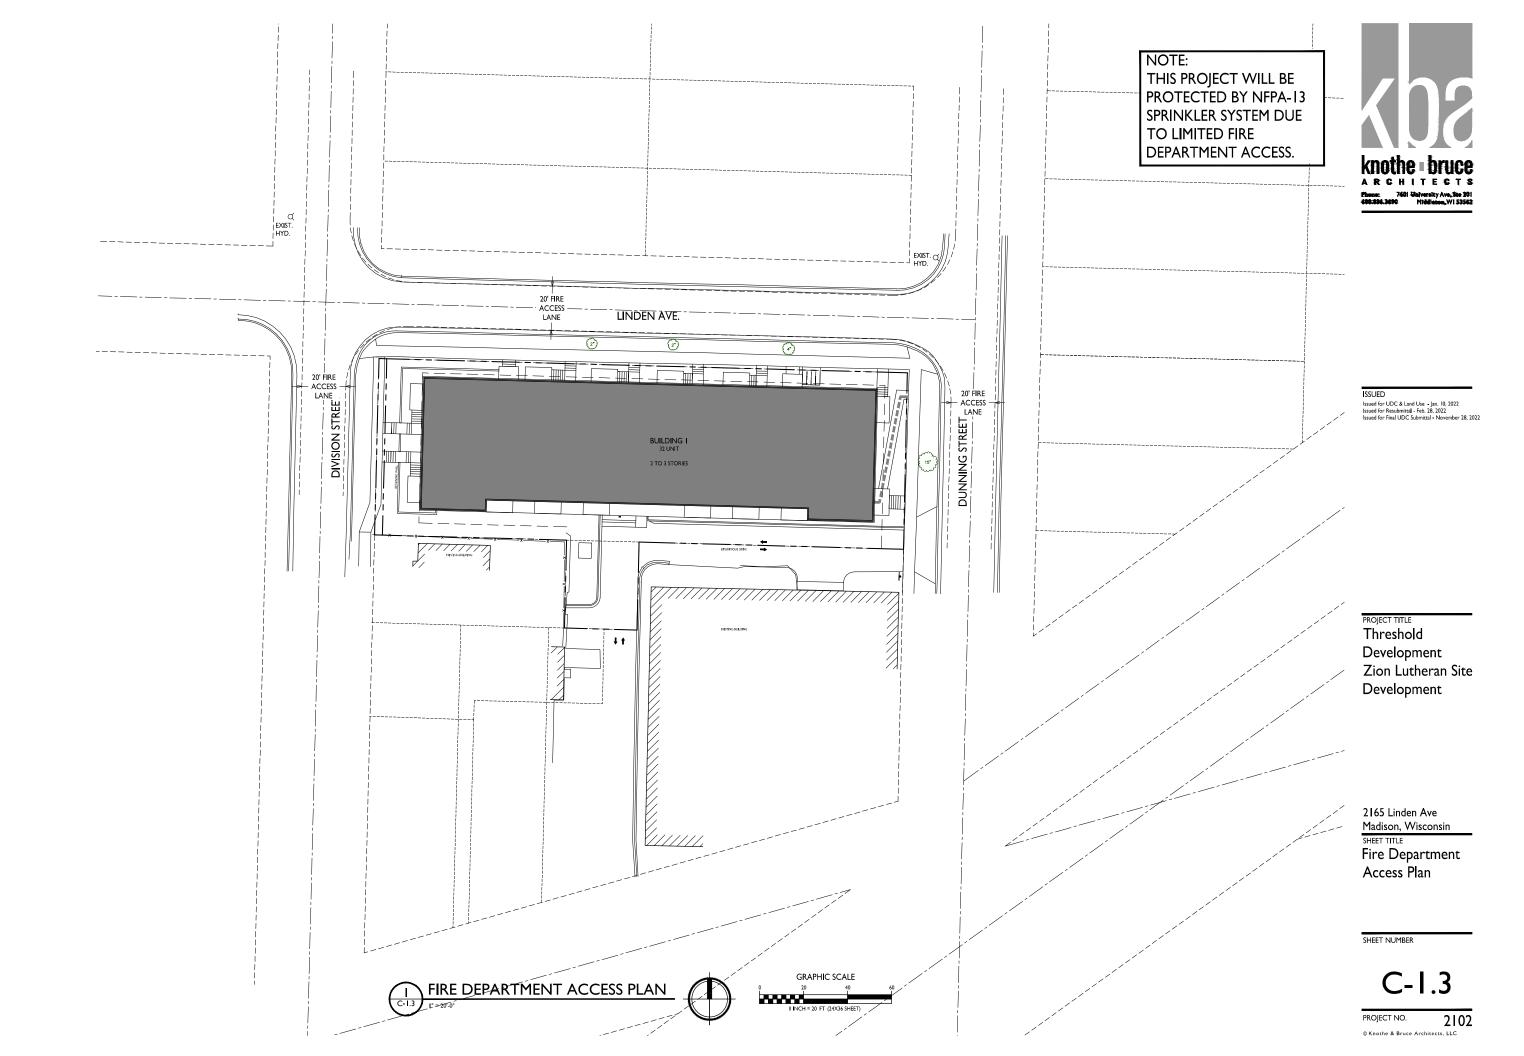



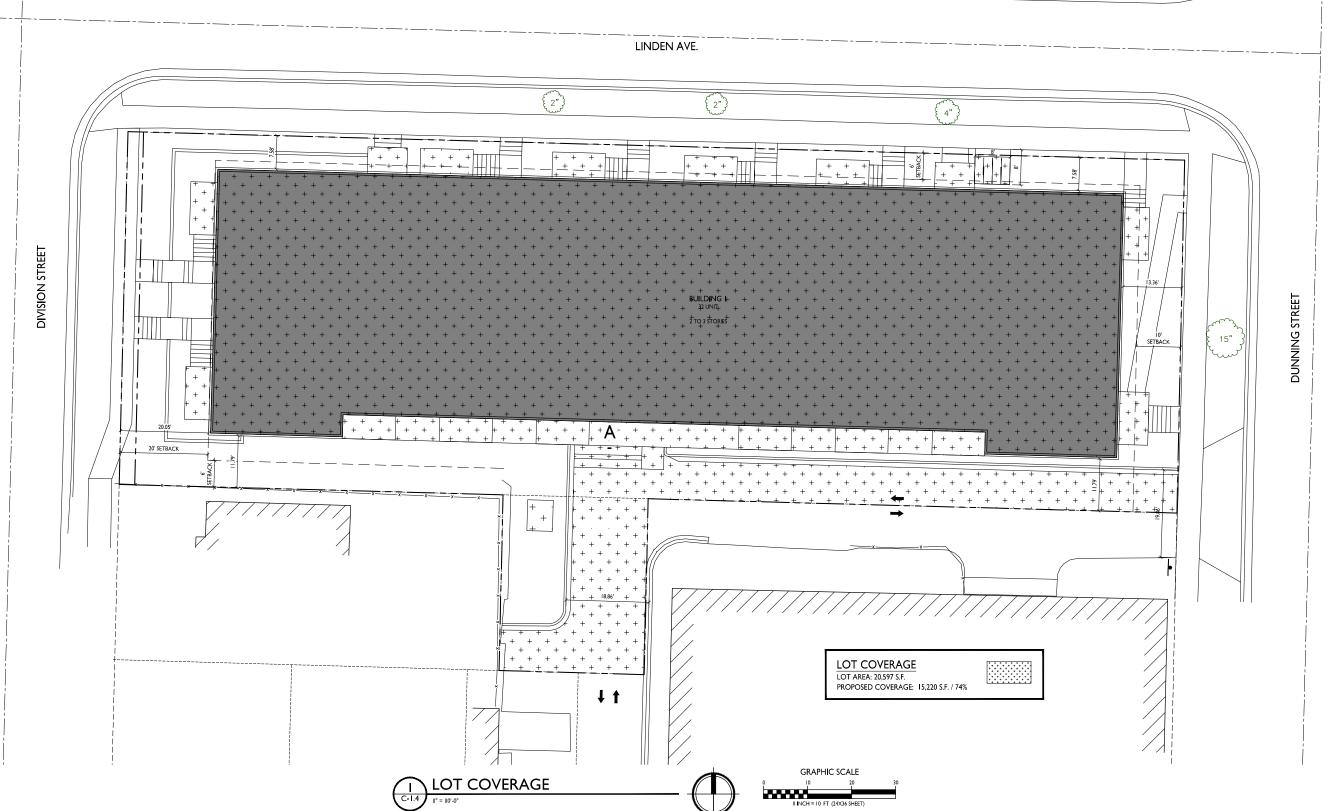

ISSUED

Issued for UDC & Land Use - Jan. 10, 2022

Issued for Resubmittal - Feb. 28, 2022

Issued for Final UDC Submittal - November 28, 2022

PROJECT TITLE
Threshold
Development
Zion Lutheran Site
Development


2165 Linden Ave
Madison, Wisconsin
SHEET TITLE
Lot Coverage

SHEET NUMBER

C-1.4

ROJECT NO. 210



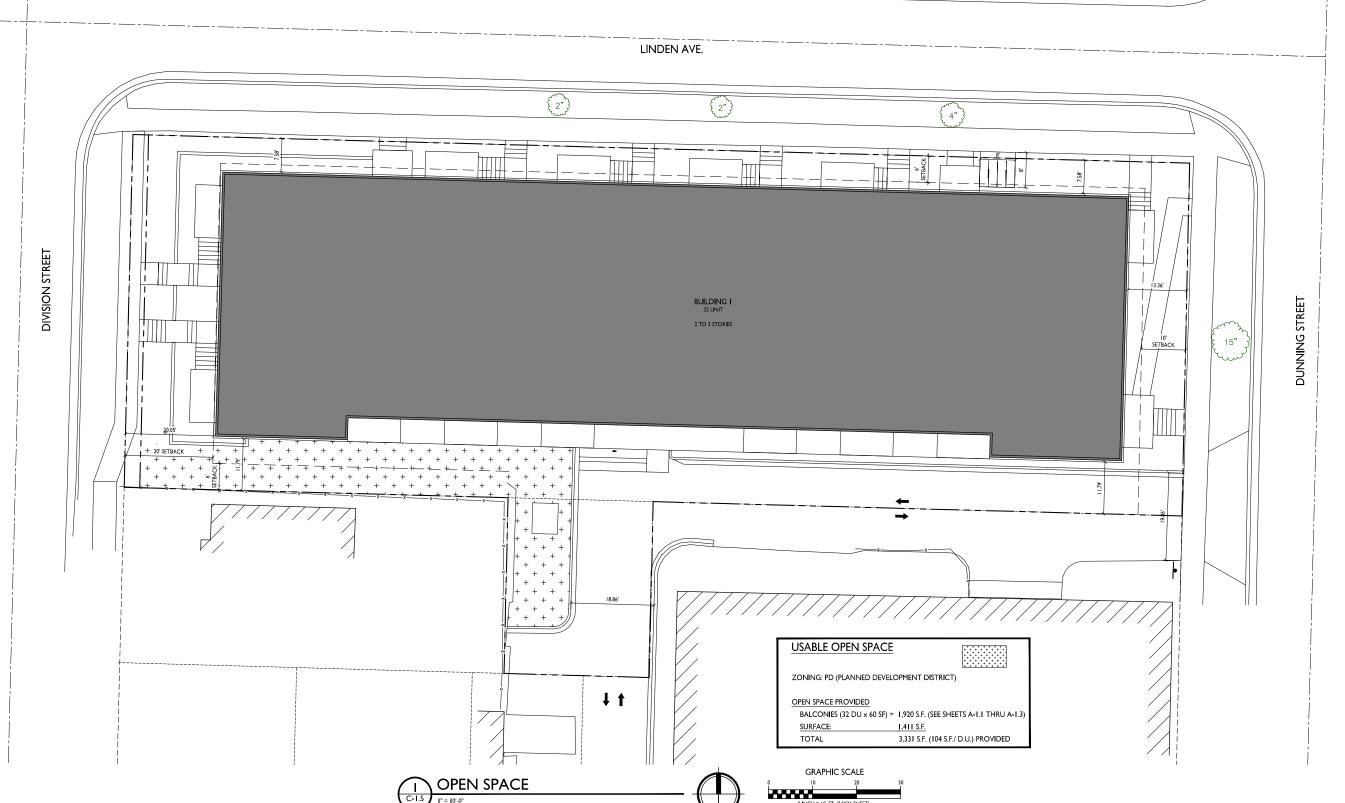

SSUED

ISSUED for UDC & Land Use - Jan. 10, 2022 Issued for Resubmittal - Feb. 28, 2022 Issued for Final UDC Submittal - November 28, 2022


PROJECT TITLE
Threshold
Development
Zion Lutheran Site
Development

2165 Linden Ave
Madison, Wisconsin
SHEET TITLE
Open Space

SHEET NUMBER

C-1.5

PROJECT NO. 210

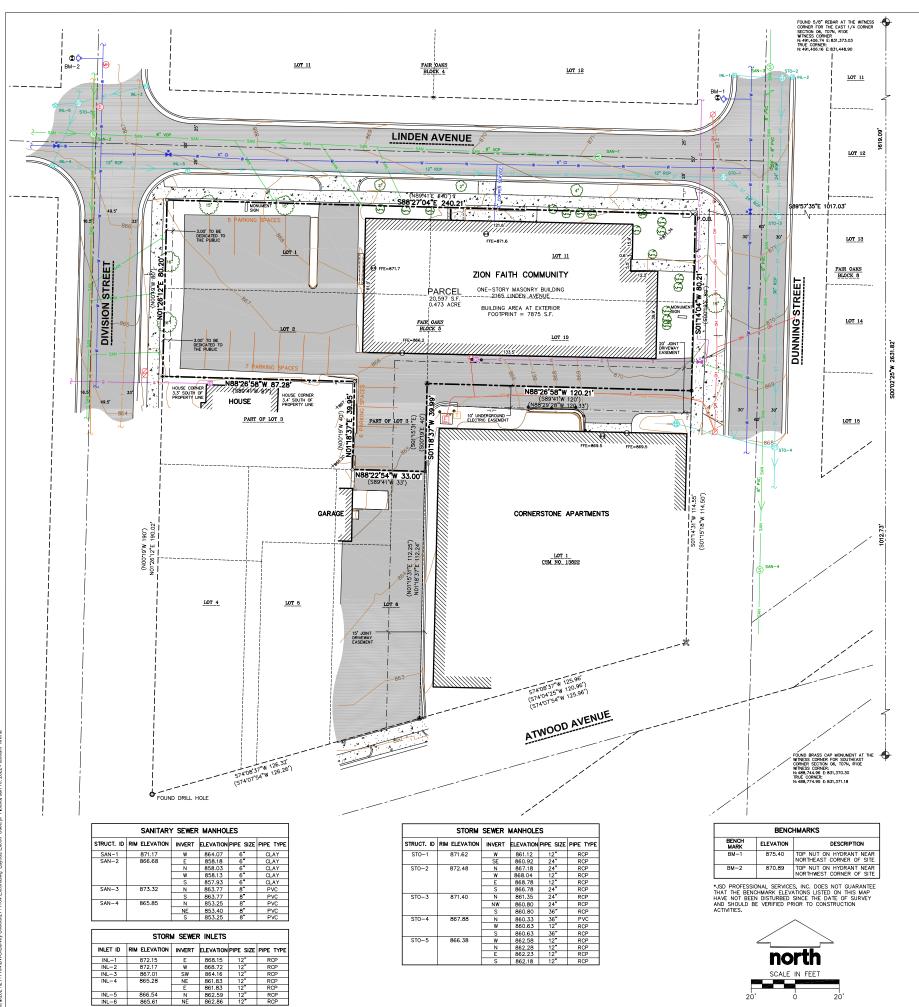


EXISTING CONDITIONS SURVEY

LOTS 1, 2, 10, 11, AND THE EAST 33 FEET OF LOT 3, BLOCK 5, FAIR OAKS, LOCATED IN PART OF THE SOUTHEAST QUARTER OF THE SOUTHEAST QUARTER OF, SECTION 06, TOWNSHIP 07 NORTH, RANGE 10 EAST, CITY OF MADISON, DANE COUNTY, WISCONSIN.



VICINITY MAR (NOT TO SCALE)

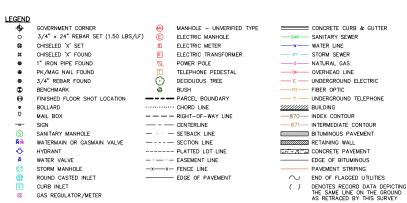

NOTES

- BEARINGS FOR THIS SURVEY AND MAP ARE REFERENCED TO THE WISCONSIN COUNTY COORDINATE SYSTEM, DANE ZONE THE EAST LINE OF SOUTHEAST 1/4 OF SECTION 06, TOWNSHIP 07 NORTH, RANGE 10 EAST, S00"02"25"W.
- 3. ELEVATIONS ARE BASED ON THE NORTH AMERICAN VERTICAL DATUM OF 1988 (NAVD88)
- 5. SUBSURFACE UTILITIES AND FEATURES SHOWN ON THIS MAP HAVE BEEN APPROXIMATED BY LOCATING SURFICIAL FEATURES AND APPURTENANCES, LOCATING DIGGERS HOTLING FIELD MARKINGS AND BY REFERENCE TO UTILITY RECORDS AND MAPS. DIGGER'S HOTLINE LOCATE TOKET NO. 20215010021, 20215010220, 20215010223, AND 20215010225 WITH A CLEAR DATE OF DECEMBER 15, 2021, PRINT TICKET NO. 202151010212, 20215010218, 2021501023, AND 20215010232 WITH A CLEAR DATE OF DECEMBER 20, 2021.
- 6. UTILITY COMPANIES CONTACTED THRU DIGGERS HOTLINE: CITY OF MADISON MAE (ELECTRIC AND GAS) CHARTER COMMUNICATIONS AT&T DISTRIBUTION AT&T TRANSMISSIONS

- BEFORE EXCAVATION, APPROPRIATE UTILITY COMPANIES SHOULD BE CONTACTED. FOR EXACT LOCATION OF UNDERGROUND UTILITIES, CONTACT DIGGERS HOTLINE, AT 1.800.242.8511.
- 8. JSD PROFESSIONAL SERVICES, INC. DOES NOT GUARANTEE THAT THE BENCHMARKS SHOWN ON THIS MAP HAVE NOT BEEN DISTURBED SINCE THE DATE OF THIS SURVEY AND SHOULD BE VERIFIED BEFORE BEING UTILIZED.
- 9. ROADWAY UTILITY RECORD DRAWINGS WERE REQUESTED FROM THE CITY OF MADISON. THE UTILITIES SHOWN REPRESENT FIELD LOCATED UTILITIES IN COMBINATION WITH THE SUPPLIED CITY RECORDS.

LEGAL DESCRIPTION

LOTS 1, 2, 10, 11 AND EAST 33 FEET OF LOT 3, BLOCK 5, FAIR OAKS, RECORDED IN VOLUME 2 OF PLATS, ON PAGE 37 AS DOCUMENT NUMBER 243077, CITY OF MADISON, DANE COUNTY, WISCONSIN.

TAX KEY NO: 251/0710-064-1101-2

SURVEYOR'S CERTIFICATE

I, JOHN KREBS, WISCONSIN PROFESSIONAL LAND SURVEYOR NO. S-1878, HEREBY CERTIFY THAT UNDER THE DIRECTION OF THRESHOLD DEVELOPMENT THIS SURVEY AND MAP HAS BEEN PREPARED AND COMPLES WITH WISCONSIN ADMINISTRATIVE CODE A-E7 AND IS CORRECT TO THE BEST OF MY KNOWLEDGE AND BELIEF IN ACCORDANCE WITH THE INFORMATION PROVIDED.

JOHN KREBS, S-1878 WISCONSIN PROFESSIONAL LAND SURVEYOR







CREATE THE VISION TELL THE STORY

isdinc.com

MADISON REGIONAL OFFICE 161 HORIZON DRIVE, SUITE 101 VERONA, WISCONSIN 53 P. 608.848.5060

THRESHOLD **DEVELOPMENT**

1954 ATWOOD AVENUE MADISON, WI, 53704

2165 LINDEN AVENUE REDEVELOPMENT

2165 LINDEN AVENUE MADISON, DANE COUNTY WISCONSIN, 53704

# Date:	Description:	
1	-	
1 2 3 4 5 6 7 8		
2		
6		
9		
10		
12		
13		
14		
15		
Prepared By:	CMI	
Reviewed By		12/200

EXISTING CONDITIONS SURVEY

1 OF 1

BK 12/29/2

- REFER TO THE EXISTING CONDITIONS SURVEY FOR EXISTING CONDITIONS NOTES AND LEGENDS.
- ALL WORK IN THE ROW AND/OR PUBLIC EASEMENTS SHALL BE IN ACCORDANCE WITH THE STANDARD SPECIFICATIONS FOR SEWER & WATER CONSTRUCTION IN WISCONSIN AND MUNICIPAL REQUIREMENTS.
- EXISTING GRADE SPOT ELEVATIONS SHOWN FOR INFORMATIONAL PURPOSES. DURING CONSTRUCTION MATCH EXISTING GRADES AT CONSTRUCTION LIMITS.
- . NO SITE GRADING OUTSIDE OR DOWNSLOPE OF PROPOSED SILT FENCE LOCATION. NO LAND DISTURBANCE BEYOND PROPERTY LINES.
- JSD SHALL BE HELD HARMLESS AND DOES NOT WARRANT ANY DEVIATIONS BY THE OWNER/CONTRACTOR FROM THE APPROVED CONSTRUCTION PLANS THAT MAY RESULT IN DISCIPLINARY ACTIONS BY ANY OR ALL REGULATORY AGENCIES.

- THIS PLAN INDICATES ITEMS ON THE PROPERTY INTENDED FOR DEMOLITION BASED ON THE CURRENT SITE DESIGN THAT HAVE BEEN IDENTIFIED BY A REASONABLE OBSERVATION OF THE EXISTING CONDITIONS THROUGH FILED SURVEY RECONNAISSANCE, "DIGGER'S HOTLINE" LOCATION, AND GENERAL "STANDARD OF CARE". THERE MAY BE ADDITIONAL ITEMS THAT CAN NOT BE IDENTIFIED BY A REASONABLE ABOVE GROUND OBSERVATION, OF WHICH THE ENGINEER WOULD HAVE NO KNOWLEDGE OR MAY BE A PART OF ANOTHER DESIGN DISCIPLIE. IT IS THE CONTRACTOR'S/BIDDER'S RESPONSIBILITY TO REVEW THE PLANS, INSPECT THE SITE AND PROVIDE THEIR OWN DUE DILICENCE TO INCLUDE IN THEIR BID WHAT ADDITIONAL ITEMS, IN THEIR OPINION, MAY BE NECESSARY FOR DEMOLITION. ANY ADDITIONAL ITEMS, IN THEIR OPINION, MAY BE NECESSARY FOR DEMOLITION. ANY ADDITIONAL ITEMS IDENTIFIED BY THE CONTRACTOR GIBDER SHALL BE IDENTIFIED IN THE BID INTENDED TO THE ENGINEER OF RECORD. JSD TAKES NO RESPONSIBILITY FOR ITEMS ON THE PROPERTY THAT COULD NOT BE LOCATED BY A REASONABLE OBSERVATION OF THE PROPERTY OR OF WHICH THEY WOULD HAVE NO KNOWLEDGE.
- CONTRACTOR SHALL KEEP ALL STREETS AND PRIVATE DRIVES FREE AND CLEAR OF ALL CONSTRUCTION RELATED DIRT, DUST AND DEBRIS.
- ALL LIGHT POLES TO BE REMOVED SHALL BE REMOVED IN THEIR ENTIRETY, INCLUDING BASE AND ALL APPURTENANCES. SALVAGE FOR RELOCATION. COORDINATE RELOCATION AND/OR ABANDOMMENT OF ALL ELECTRIC LINES WITH ELECTRICAL ENGINEER AND OWNER PRIOR TO DEMOLITION.
- ABANDONED/REMOVED ITEMS SHALL BE DISPOSED OF OFF SITE UNLESS OTHERWISE
- CONTRACTOR TO REPLACE ALL SIDEWALK AND CURB AND GUTTER ABUTTING THE PROPERTIES, WHICH IS DAMAGED BY THE CONSTRUCTION, OR ANY SIDEWALK AND CURB AND GUTTER THAT THE CITY ENSINEER DETERMINES NEEDS TO BE REPLACED BECAUSE IT IS NOT AT A DESIRABLE GRADE REGARDLESS OF WHETHER THE CONDITION EXISTED PRIOR TO BEGINNING CONSTRUCTION.
- PRIOR TO CONSTRUCTION, THE CONTRACTOR IS RESPONSIBLE FOR:

 1. EXAMINE ALL SITE CONDITIONS RELATIVE TO THE CONDITIONS INDICATED ON THE ENGINEERING DRAWINGS. ANY DISCREPANCIES ARE TO BE REPORTED IMMEDIATELY TO THE ENGINEER AND RESOLVED PRIOR TO THE START OF CONSTRUCTION.

- 7.3. NOTIFYING ALL UTILITIES PRIOR TO THE REMOVAL OF ANY UNDERGROUND UTILITIES.
- ANY SANITARY SEWER, SANITARY SEWER SERVICES, WATER MAIN, WATER SERVICES, STORM SEWER, OR OTHER UTILITIES, WHICH ARE DAMAGED BY THE CONTRACTORS, SHALL BE REPAIRED TO THE OWNER'S SATISFACTION AT THE CONTRACTOR'S EXPENSE.
- CONTRACTOR IS RESPONSIBLE FOR SITE SAFETY DURING THE CONSTRUCTION OF THESE IMPROVEMENTS.
- CONTRACTOR TO COORDINATE PRIVATE UTILITY REMOVAL / ABANDONMENT AND NECESSARY RELOCATION WITH RESPECTIVE UTILITY COMPANY. COORDINATION REQUIRED PRIOR TO CONSTRUCTION.
- ALL DEMOLITION SHALL BE IN ACCORDANCE WITH THE APPROVED MUNICIPALITY RECYCLING PLAN.
- ANY CONTAMINATED SOILS SHALL BE REMOVED IN ACCORDANCE WITH FEDERAL AND STATE REGULATIONS TO AN APPROVED LANDFILL.
- 13. ALL EXISTING UTILITIES TO BE FIELD LOCATED AND FLAGGED BY CONTRACTOR.
- EXISTING FIBER OPTIC LINE TO BE CLEARLY MARKED PRIOR TO ANY EXCAVATION. CONTRACTOR TO NOTIFY ENGINEER IMMEDIATELY IF ANY DISCREPANCIES OCCUR IN THE LOCATION SHOWN OR PROPOSED IMPROVEMENTS IMPACTING EXISTING FIBER OPTIC LINE LOCATION.
- 15. SEWER ABANDONMENT SHALL BE IN ACCORDANCE WITH SECTION 3.2.24, OF THE STANDARD SPECIFICATIONS FOR WATER AND SEWER CONSTRUCTION IN WISCONSIN, LATEST ADDITION, AND THE CITY OF MADISON SPECIFICATIONS. WATER ABANDONMENT SHALL BE IN ACCORDANCE WITH SECTION 4.14.0 OF THE STANDARD SPECIFICATIONS FOR WATER AND SEWER CONSTRUCTION IN WISCONSIN, LATEST ADDITION, AND THE CITY OF MADISON SPECIFICATIONS.
- ALL PERMETER EROSION CONTROL DEMCES SHALL BE INSTALLED PRIOR TO THE START OF DEMOLITION ACTIVITIES. CONTRACTOR SHALL KEEP ALL STREETS AND PARMENT FREE AND CLEAR OF ALL CONSTRUCTION RELATED DIRT, DUST AND DEPRIS.
- BUILDING REMOVALS SHALL BE BY A QUALIFIED CONTRACTOR. CONTRACTOR TO FOLLOW ALL DEMOLITION REGULATIONS, DISCONNECT ALL UTILITIES, OBTAIN ALL APPLICABLE PERMITS AND DISPOSE OF ALL BUILDING MATERIALS IN APPROPRIATE LANDRILLS, DEMOLISHED MATERIALS, SHALL NOT BE BURIED ON SITE. IF ENCOUNTERED, ANY CONTAMINATED SOILS SHALL NOT BE BURIED ON SITE. IF ENCOUNTERED, APPROPRIATE STATE AND FEDERAL REGULATIONS.
- CONTRACTOR TO REMOVE EXISTING UTILITY PIPE OR PROVIDE PIPE BACK-FILLING AFTER REMOVAL OF EXISTING UTILITIES WITHIN BUILDING FOOTPRINT USING "LOW DENSITY CONCRETE/FLOWABLE FILL".
- RESTORATION OF THE EXISTING ROADWAY RIGHT-OF-WAYS ARE CONSIDERED INCIDENTAL AND SHOULD BE PART OF THE COST OF THE UNDERGROUND IMPROVEMENTS, DEMOLITION AND REMOVAL. THIS INCLUDES CURB & GUTTER, SIDEWALK, TOPSOIL, SEEDING AND MULCHING.

CONSTRUCTION SEQUENCING

- INSTALL PERIMETER SILT FENCE, INLET PROTECTION AND TEMPORARY CONSTRUCTION ENTRANCE.
- STRIP AND STOCKPILE TOPSOIL, INSTALL SILT FENCE AROUND PERIMETER OF STOCKPILE.
- CONDUCT ROUGH GRADING EFFORTS AND INSTALL CHECK DAMS WITHIN DRAINAGE DITCHES AS NEEDED. INSTALL UTILITY PIPING AND STRUCTURES, IMMEDIATELY INSTALL INLET PROTECTION.
- COMPLETE FINAL GRADING, INSTALLATION OF GRAVEL BASE COURSES, PLACEMENT OF CURBS, PAVEMENTS, WALKS, ETC.
- PLACE TOPSOIL AND IMMEDIATELY STABILIZE DISTURBED AREAS WITH EROSION CONTROL MEASURES AS INDICATED ON PLANS.
- EROSION CONTROLS SHALL NOT BE REMOVED UNTIL SITE IS FULLY STABILIZED OR 70% VEGETATIVE COVER IS ESTABLISHED.
- CONTRACTOR MAY MODIFY SEQUENCING AFTER ITEM NO. 1 AS NEEDED TO COMPLETE CONSTRUCTION IF EROSION CONTROLS ARE MAINTAINED IN ACCORDANCE WITH THE CONSTRUCTION SITE EROSION CONTROL REQUIREMENTS.

PAVING NOTES

GENERAL

- PAVING SHALL CONFORM TO "STATE OF WISCONSIN STANDARD SPECIFICATIONS FOR HIGHWAY STRUCTURE CONSTRUCTION, LATEST EDITION, AND APPLICABLE THE CITY OF MADISON
- 1.2. ALL PAVING DIMENSIONS ARE TO FACE OF CURB UNLESS SPECIFIED OTHERWISE.
- 1.3. SURFACE PREPARATION NOTIFY ENGINEER/OWNER OF UNSATISFACTORY CONDITIONS. DO NOT BEGIN PAVING WORK UNTIL DEFICIENT SUBBASE AREAS HAVE BEEN CORRECTED AND ARE READY TO RECEIVE PAVING.
- 1.4. ANY REQUIRED REPLACEMENT OF PUBLIC CURB AND GUTTER SHALL MATCH EXISTING AND MEET MUNICIPALITY REQUIREMENTS.
- 2. ASPHALTIC CONCRETE PAVING SPECIFICATIONS
- CODES AND STANDARDS THE PLACING, CONSTRUCTION AND COMPOSITION OF THE ASPHALTIC BASE COURSE AND ASPHALTIC CONCRETE SURFACE COURSE SHALL BE IN ACCORDANCE WITH THE REQUIREMENTS OF SECTIONS 450, 455, 460 AND 465 OF THE STATE OF WISCONSIN STANDARD SPECIFICATIONS FOR HIGHWAY AND STRUCTURE CONSTRUCTION, CURRENT EDITION. HEREAFTER, THIS PUBLICATION MILL BE REFERRED TO AS STATE HIGHWAY SPECIFICATIVAY SPECIFICATION.
- 2.2. WEATHER LIMITATIONS APPLY TACK COATS WHEN AMBIENT TEMPERATURE IS ABOVE 50° F (10° C) AND WHEN TEMPERATURE HAS NOT BEEN BELOW 35° F (1° C) FOR 12 HOURS IMMEDIATELY PRIOR TO APPLICATION DO NOT APPLY WHEN BASE IS WET OR CONTAINS EXCESS OF WOISTURE. CONSTRUCT ASPHALTIC CONCRETE SURFACE COURSE WHEN ATMOSPHERIC TEMPERATURE IS ABOVE 40° F (4° C) AND WHEN BASE IS DRY AND WHEN WEATHER IS NOT RAINY. BASE COURSE MAY BE PLACED WHEN AIM TEMPERATURE IS ABOVE 30° F (-1° C).
- 2.3. GRADE CONTROL ESTABLISH AND MAINTAIN REQUIRED LINES AND ELEVATIONS FOR EACH COURSE DURING CONSTRUCTION.
- 2.4. CRUSHED AGGREGATE BASE COURSE THE TOP LAYER OF BASE COURSE SHALL CONFORM TO SECTIONS 301 AND 305, STATE HIGHWAY SPECIFICATIONS.
- BINDER COURSE AGGREGATE THE AGGREGATE FOR THE BINDER COURSE SHALL CONFORM TO SECTIONS 460 AND 315, STATE HIGHWAY SPECIFICATIONS.
- 2.6. SURFACE COURSE AGGREGATE THE AGGREGATE FOR THE SURFACE COURSE SHALL CONFORM TO SECTIONS 460 AND 465, STATE HIGHWAY SPECIFICATIONS.
- ASPHALTIC MATERIALS THE ASPHALTIC MATERIALS SHALL CONFORM TO SECTION 455 AND 460, STATE HIGHWAY SPECIFICATIONS.
- 3. CONCRETE PAVING SPECIFICATIONS
- CONCRETE PAVING SHALL BE IN ACCORDANCE WITH THE REQUIREMENTS OF SECTIONS 415 AND 416 OF THE STATE HIGHWAY SPECIFICATIONS.
- CONCRETE PAVEMENT SHALL BE REINFORCED WITH NOVOMESH 950 (OR EQUAL) FIBER REINFORCEMENT AT A RATE OF 5 LBS/CUBIC YARD.
- 3.3. CURING COMPOUNDS SHALL CONFORM TO SECTION 415 OF THE STATE HIGHWAY SPECIFICATIONS.
- 3.4. CONTRACTOR SHALL PROVIDE CONTROL JOINTS AND CONSTRUCTION JOINTS OF ONE-QUARTER CONCRETE THICKNESS AT AN EQUAL RATIO OF LENGTH TO WIDTH WHEREVER POSSIBLE WITH A MAXIMUM LENGTH BETWEEN JOINTS OF 8 ON CENTER.
- 3.5. CONTRACTOR SHALL PROVIDE EXPANSION JOINTS IN SIDEWALKS AT A MAXIMUM 24' ON CENTER.
- 3.6. EXTERIOR CONCRETE SURFACES SHALL BE BROOM FINISHED.
- 3.7. ALL CONCRETE SURFACES TO BE SEALED WITH TYPE TK-26UV CONCRETE SEALANT.

GRADING AND SEEDING NOTES

- PROPOSED GRADES SHOWN ARE FINISHED GRADES. CONTRACTOR SHALL VERIFY ALL GRADES, SURE ALL AREAS DRAIN PROPERLY AND SHALL REPORT ANY DISCREPANCIES TO THE ENGINEER
- CONTRACTOR SHALL ASSUME SOLE RESPONSIBILITY FOR COMPUTATIONS OF ALL GRADING QUANTITIES. WHILE JSD PROFESSIONAL SERVICES, INC. ATTEMPTS TO PROVIDE A COST EFFECTIVE APPROACH TO BALANCE BARTHWORK, GRADING BESIGN IS BASED ON MANY FACTORS, INCLUMING SAFETY AESTHERICS, AND COMMON ENGINEERING STANDARDS OF CARE. THEREFORE, NO GUARANTEE CAN BE MADE FOR A BALANCED SITE ABLANCED SITE.
- PARKING LOT AND DRIVEWAY ELEVATIONS ARE PAVEMENT GRADES, NOT TOP OF CURB GRADES, UNLESS OTHERWISE NOTED.
- CONTRACTOR SHALL PROVIDE NOTICE TO THE MUNICIPALITY IN ADVANCE OF ANY SOIL DISTURBING ACTIVITIES, IN ACCORDANCE WITH MUNICIPAL REQUIREMENTS.
- ALL DISTURBED AREAS SHALL BE SODDED AND/OR SEEDED AND MULCHED IMMEDIATELY FOLLOWING GRADING ACTIVITIES. SOD/SEED MIX TO BE IN ACCORDANCE WITH LANDSCAPE PLAN.
- CONTRACTOR SHALL CHISEL—PLOW OR DEEP TILL WITH DOUBLE TINES ALL STORMWATER MANAGEMENT FACILITIES JUST PRIOR TO SODDING AND/OR SEEDING AND MULCHING TO PROMOTE INFILTRATION.
- CONTRACTOR SHALL WATER ALL NEWLY SODDED/SEEDED AREAS DURING THE SUMMER MONTHS WHENEVER THERE IS A 7 DAY LAPSE WITH NO SIGNIFICANT RAINFALL.
- CONTRACTOR TO DEEP TILL ALL COMPACTED PERVIOUS SURFACES PRIOR TO SODDING AND/OR SEEDING AND MULCHING.
- ALL SLOPES 20% OR GREATER SHALL BE TEMPORARY SEEDED, MULCHED, OR OTHER MEANS OF COVER PLACED ON THEM WITHIN 2 WEEKS OF DISTURBANCE.
- 1. ALL EXPOSED SOIL AREAS THAT WILL NOT BE BROUGHT TO FINAL GRADE OR ON WHICH LAND DISTURBING ACTIVITIES WILL NOT BE PERFORMED FOR A PERIOD GREATER THAN 30 DAYS AND REQUIRE VEDESTATIVE COVER FOR LESS THAN 1 YEAR, REQUIRE TEMPORARY SEEDING FOR EROSION CONTROL. SEEDING FOR EROSION CONTROL SHALL BE IN ACCORDANCE WITH WIDNR TECHNICAL STANDARD 1059 AND THE CITY OF MADISON ORDINANCE.

FORESTRY NOTES

- 1. ALL PROPOSED STREET TREE REMOVALS WITHIN THE RIGHT OF WAY SHALL BE REVIEWED BY CITY FORESTRY BEFORE THE PLAN COMMISSION MEETING. STREET TREE REMOVALS REQUIRE APPROVALS REQUIRE APPROVALS REQUIRE THE AND A TREE REMOVAL PRINT ISSUED BY CITY FORESTRY. ANY STREET TREE REMOVALS REQUISTED AFTER THE DEVELOPMENT PLAN IS APPROVED BY THE PLAN COMMISSION OR THE BOARD OF PUBLIC WORKS AND CITY FORESTRY WILL REQUIRE A MINIMUM OF A 72-HOUR REVIEW PERIOD WHICH SHALL INCLIDE THE NOTIFICATION OF THE ALDERPERSON WITHIN WHO'S DISTRICT IS AFFECTED BY THE STREET TREE REMOVAL(S) PRIOR TO A TREE REMOVAL PERMIT BEING ISSUED.
- 2.AS DEFINED BY THE SECTION 107.13 OF CITY OF MADISON STANDARD SPECIFICATIONS FOR PUBLIC WORKS CONSTRUCTIONS: NO EXCAVATION IS PERMITTED WITHIN 5 FEET OF THE TRUNK OF THE STREET REED OR WHEN OUTTING ROOTS OVER 3 INCHES IN DIAMETER. IF EXCAVATION IS NECESSARY, THE CONTRACTOR SHALL CONTACT MADISON CITY FORESTRY (266—4816) PRIOR TO EXCAVATION. CITY OF MADISON FORESTRY PERSONNEL SHALL ASSESS THE IMPACT TO THE TREE AND TO ITS ROOT SYSTEM PRIOR TO WORK COMMENCING. TREE PROTECTION SPECIFICATIONS CAN BE FOUND ON THE FOLLOWING WEBSITE. HTTDS: //MAW.GITYOFFLANDARD.OR JUSTISSES AND X50FES FOR THIS SECTION. WEBSITE: HTTPS://WWW.CITYOFMADISON.COM/BUSINESS/PW/SPECS.CFM
- A.CONTRACTOR SHALL TAKE PRECAUTIONS DURING CONSTRUCTION TO NOT DISFIGURE, SCAR, OR IMPAIR THE HEALTH OF ANY STREET TREE. CONTRACTOR SHALL OPERATE EQUIPMENT IN A MANNER AS TO NOT DAMAGE THE BRANNERS OF THE STREET TREE(S). THIS MAY REQUIPMENT SHOW SHALL SHALL
- 4.SECTION 107.13(G) OF CITY OF MADISON STANDARD SPECIFICATIONS FOR PUBLIC WORKS CONSTRUCTION ADDRESSES SOIL COMPACTION NEAR STREET TREES AND SHALL BE FOLLOWED BY CONTRACTOR. THE STORAGE OF PARKED VEHICLES, CONSTRUCTION EQUIPMENT, BUILDING MATERI REFUSE, EXCAVATED SPOILS OR DUMPING OF POISONOUS MATERIALS ON OR AROUND TREES AND ROOTS WITHIN FIVE (6) FEET OF THE TREE OR WITHIN THE PROTECTION ZONE IS PROHIBITED.
- 5.ON THIS PROJECT, STREET TREE PROTECTION ZONE FENCING IS REQUIRED. THE FENCING SHALL BE ERECTED BEFORE THE DEMOLITION, GRADING OR CONSTRUCTION BEGINS. THE FENCE SHALL INCLUDE THE ENTIRE WIDTH OF TERRACE AND, EXTEND AT LEAST 5 FEET ON BOTH SIDES OF THE OUTSIDE EDGE OF THE TREE TRUNK. DO NOT REMOVE THE FENCING TO ALLOW FOR DELIVERIES OR EQUIPMENT ACCESS THROUGH THE TREE PROTECTION ZONE.
- 6.STREET TREE PRUNING SHALL BE COORDINATED WITH MADISON FORESTRY AT A MINIMUM OF TWO WEEKS PRIOR TO THE START OF CONSTRUCTION FOR THIS PROJECT. ALL PRUNING SHALL FOLLOW THE AMERICAN NATIONAL STANDARDS INSTITUTE (ANS) A500 PART I STANDARDS FOR PRUNING.
- 7.AT LEAST ONE WEEK PRIOR TO STREET TREE PLANTING, CONTRACTOR SHALL CONTACT CITY FORESTRY AT (608) 266-4816 TO SCHEDULE INSPECTION AND APPROVAL OF NURSERY TREE STOCK AND REVIEW PLANTING SPECIFICATIONS WITH THE LANDSCAPER.

UTILITY NOTES

- ALL EXISTING UTILITIES ARE SHOWN FOR INFORMATIONAL PURPOSES ONLY AND ARE NOT GUARANTEED TO BE ACCURATE OR ALL INCLUSIVE. THE CONTRACTOR IS RESPONSIBLE FOR MAKING HIS OWN DETERMINATION AS TO THE TYPE AND LOCATIONS OF UNDERROROUND UTILITIES AS MAY BE NECESSARY TO AVOID DAMAGE THERETO. CONTRACTOR/OWNER SHALL CALL "DIGGER'S HOTLINE" PRIOR TO ANY CONSTRUCTION.
- PRIOR TO CONSTRUCTION. THE PRIME CONTRACTOR IS RESPONSIBLE FOR:
 AMINING ALL SITE CONDITIONS RELATIVE TO THE CONDITIONS INDICATED
 ON THE CONDITIONS RELATIVE TO THE CONDITIONS INDICATED ON THE ENGINEERING
 DRAWINGS. ANY DISCREPANCIES ARE TO BE REPORTED TO THE ENGINEER AND RESOLVED PRIOR TO
 THE START OF CONSTRUCTION.

 OBTAINING ALL PERMITS INCLUDING PERMIT COSTS, TAP FEES, METER DEPOSITS, BONDS, AND
 ALL OTHER FEES REQUIRED FOR PROPOSED WORK TO GETAIN OCCUPANCY.

 VERFITMING ALL ELEVATIONS, LOCATIONS AND SIZES OF SANITARY, WATER AND STORM LATERALS
 AND CHECK ALL UTILITY CROSSINGS FOR CONFLICTS. NOTIFY PROMISER OF ANY
 DISCREPANCE ALL UTILITY CROSSINGS FOR CONFLICTS. NOTIFY PROMISER OF ANY
 DISCREPANCE ALL UTILITY CROSSINGS FOR CONFLICTS.

 NOTIFYING THE DESIGN ENGINEER AND MUNICIPALITY 48 HOURS PRIOR TO THE START OF
 CONSTRUCTION TO ARRANGE FOR APPROPRIATE CONSTRUCTION GENERAL TO
 THE PROPOSED DEVELOPMENT AND FOR PROPORTING ANY ERRORS OR DISCREPANCIES
 BETWEEN THESE PLANS AND PLANS PREPARED BY OTHERS.
- 3. ALL UTILITY WORK SHALL BE DONE IN ACCORDANCE WITH THE STANDARD SPECIFICATIONS FOR SEWER AND WATER CONSTRUCTION IN WISCONSIN AND ALL STATE AND LOCAL CODES AND SPECIFICATIONS. IT IS THE CONTRACTORS RESPONSIBILITY TO DETERMINE WHICH SPECIFICATIONS AND CODES APPLY, AND TO COORDINATE ALL CONSTRUCTION ACTIVITIES WITH THE APPROPRIATE LOCAL AND STATE AUTHORITIES.
- 4. SPECIFICATIONS SHALL COMPLY WITH THE THE CITY OF MADISON SPECIAL PROVISIONS.
- LENGTHS OF ALL UTILITIES ARE TO CENTER OF STRUCTURES OR FITTINGS AND MAY VARY SLIGHTLY FROM PLAN. LENGTHS SHALL BE VERIFIED IN THE FIELD DURING CONSTRUCTION.
- 6. CONTRACTOR IS RESPONSIBLE FOR SITE SAFETY DURING THE CONSTRUCTION OF IMPROVEMENTS.
- CONTRACTOR SHALL ADJUST AND/OR RECONSTRUCT ALL UTILITY COVERS (SUCH AS MANHOLE COVERS, VALVE BOX COVERS, ETC.) TO MATCH THE FINISHED GRADES OF THE AREAS EFFECTED BY THE CONSTRUCTION.
- THE PRIME CONTRACTOR IS RESPONSIBLE FOR COORDINATING ALL CONSTRUCTION WITH OTHER CONTRACTORS INVOLVED WITH CONSTRUCTION OF THE PROPOSED DEVELOPMENT AND FOR REPORTING ANY ERRORS OR DISCREPANCIES BETWEEN THESE PLANS AND PLANS PREPARED BY OTHERS.
- 10. ANY SANITARY SEWER, SANITARY SEWER SERVICES, WATER MAIN, WATER SERVICES, STORM SEWER, OR OTHER UTILITIES, WHICH ARE DAWAGED BY THE CONTRACTORS, SHALL BE REPAIRED TO THE OWNER'S SATISFACTION AT THE CONTRACTOR'S SEPENSE.
- THE CONTRACTOR IS RESPONSIBLE FOR PROVIDING THE ENGINEER WITH AS-BUILT CONDITIONS OF THE DESIGNATED IMPROVEMENTS IN ORDER THAT THE APPROPRIATE DRAWNOS CAN BE PREPARED, IF REQUIRED. ANY CHANGES TO THE DRAWNOS OR ADDITIONAL ITEMS MUST BE REPORTED TO THE ENGINEER AS WORK PROGRESSES.

PIPE — REINFORCED CONCRETE PIPE (RCP) SHALL MEET THE REQUIREMENTS OF ASTM CLASS III (MINIMUM) C-76 WITH RUBBER GASKET JOINTS CONFORMING TO ASTM C-443. HIGH DENSITY DUAL—WALL POLYETHYLERE CORRUGATED PIPE SHALL BE AS MANUFACTURED BY ADS OR EQUAL WITH WATER TIGHT JOINTS, AND SHALL MEET THE REQUIREMENTS OF AASHTO DESIGNATION M-294 TYPE

INLETS – INLETS SHALL BE CONSTRUCTED IN ACCORDANCE WITH FILE. NO. 28 OF THE "STANDARD SPECIFICATIONS", OR APPROVED EQUAL WITH A $1-8^{\circ}$ X $2^{\circ}-6^{\circ}$ MAXMMUM OPENING. CURB FRAME & GRATE SHALL BE NEEMAH 7-3067 WITH TYPE I GRATE, OR EQUAL.

BACKFILL AND BEDDING — STORM SEWER SHALL BE CONSTRUCTED WITH GRAVEL BACKFILL AND CLASS 18 BEDDING IN ALL PAWED AREAS AND TO A POINT 5 FEET BEYOND THE EDGE OF PAWEMENT. TRENCHES RUNNING PARALLEL TO AND LESS THAN 5 FEET FROM THE EDGE OF PAWEMENT SHALL ALSO REQUIRE GRAVEL BACKFILL LANDSCAPED AREAS MAY BE BACKFILLED WITH EXCAVATED MATERIAL IN CONFORMANCE WITH SECTION 8.43.5 OF THE "STANDARD SPECHFICATIONS".

MANHOLE FRAMES AND COVERS - MANHOLE FRAMES AND COVERS SHALL BE NEENAH R-1642 WITH TYPE "B" SELF SEALING LIDS, NON-ROCKING OR EQUAL.

FIELD TILE CONNECTION — ALL FIELD TILE ENCOUNTERED DURING CONSTRUCTION SHALL BE INCLUDED IN THE UNIT PRICE(S) FOR STORM SEWER. TILE LINES CROSSED BY THE TRENCH SHALL BE REPLACED WITH THE SAME MARKENLA B. THE STORM SEWER.

PIPE — DUCTILE IRON PIPE SHALL BE CLASS 52 CONFORMING TO AWWA C151 AND CHAPTER 8.18.0 OF THE "STANDARD SPECIFICATIONS". POLYNINYL CHLORIDE (PVC) PIPE SHALL MEET THE REQUIREMENTS OF AWWA STANDARD C-900, CLASS 150, DR-18, WITH CAST IRON 0.D. AND INTEGRAL ELASTOMERIC BELL AND SPICOT JOINTS. NON-METALLIC WAITER MAINS SHALL BE INSTALLED WITH BLUE INSULATION TRACER WIRE AND CONFORM WITH SPS 382.20(11)(h).

VALVES AND VALVE BOXES — GATE VALVES SHALL BE AWWA GATE VALVES MEETING THE REQUIREMENTS OF AWWA C-500 AND CHAPTER 8.27.0 OF THE "STANDARD SPECIFICATIONS", GATE VALVES AND VALVE BOXES SHALL CONFORM TO LOCAL PLUMBING ORDINANCES.

OF THE STANDARD SPECIFICATIONS". GRAVEL BACKFILL IS REQUIRED IN ALL PAVED AREAS AND TO A POINT 5 FEET BEYOND THE EDGE OF PAVEMENT. TRENCHES RUNNING PARALLEL TO AND LESS THAN 5 FEET FROM THE EDGE OF PAVEMENT THE RECHES RUNNING PARALLEL TO AND LESS THAN 5 FEET FROM THE EDGE OF PAVEMENT SHALL ALSO REQUIRE GRAVEL BACKFILL LANDACEAPED AREAS MAY BE BACKFILLOW WITH EXCAVATED MATERIAL IN CONFORMANCE WITH SECTION 8.45.5 OF THE STANDARD SCHIEDATION.

14. SANITARY SEWER SPECIFICATIONS -

PIPE — SANITARY SEWER PIPE MATERIAL SHALL BE POLYVINYL CHLORIDE (PVC) MEETING REQUIREMENTS OF ASTM D 3034, SDR-35, WITH INTEGRAL BELL TYPE FLEXIBLE ELASTOMERIC JOINTS, MEETING THE REQUIREMENTS OF ASTM D-3212.

BEDDING AND COVER MATERIAL — BEDDING AND COVER MATERIAL SHALL CONFORM TO THE APPROPRIATE SECTIONS OF THE "STANDARD SPECIFICATION" WITH THE FOLLOWING MODIFICATION: "COVER MATERIAL SHALL BE THE SAME AS USED FOR BEDDING AND SHALL CONFORM TO SECTION 8.43.2 (A), BEDDING AND COVER MATERIAL SHALL BE PLACED IN A MINIMUM OF THREE SEPARATE LIFTS, OR AS REQUIRED TO INSURE ADEQUIRE COMPACTING OF THESE MATERIALS, WITH ONE LIFT OF BEDDING MATERIAL EXPLORED AT THE SPRINGLINE OF THE PIPE. THE CONTRACTOR SHALL TAKE CASE TO COMPLETELY WORK BEDDING MATERIAL UNDER THE HAUNCH OF THE PIPE TO PROVIDE ADEQUATE SIDE SUPPORT."

"STANDARD SPECIFICATIONS." GRAVEL BACKFILL IS REQUIRED IN ALL PAYED AREAS AND TO A POINT 5 FEET BEYOND THE EDGE OF PAYEMENT. TRENCHES RUNNING PARALLEL TO AND LESS THAN 5 FEET FROM THE EDGE OF PAYEMENT SHALL ALSO REQUIRE GRAVEL BACKFILL LANDSCAPED AREAS MAY BE BACKFILLED WITH EXCAVATED MATERIAL IN CONFORMANCE WITH SECTION 8.43.5 OF THE "STANDARD SPECIFICATIONS."

15. WATERMAIN AND SANITARY SEWER SHALL BE INSULATED WHEREVER THE DEPTH OF COVER IS LESS THAN 6 FEET. INSULATION AND INSTALLATION OF INSULATION SHALL BE CONFORMING WITH CHAPTER 4.17.0 "INSULATION" OF THE STANDARD SPECIFICATIONS FOR SEWER AND WATER CONSTRUCTION IN WISCONSIN 6TH EDITION UPDATED WITH ITS LATEST ADDENDUM (TYP.).

EROSION CONTROL NOTES

- CONTRACTOR IS RESPONSIBLE TO NOTIFY ENGINEER OF RECORD AND OFFICIALS OF ANY CHANGES TO
 THE EROSION CONTROL AND STORMWATER MANAGEMENT PLANS. ENGINEER OF RECORD AND
 APPROPRIATE CITY OF MADISON OFFICIALS MUST APPROVE ANY CHANGES PRIOR TO DEVIATION FROM
 THE APPROVED PLANS.
- ALL EROSION CONTROL MEASURES SHALL BE CONSTRUCTED AND MAINTAINED BY THE CONTRACTOR IN ACCORDANCE WITH THE WISCONSIN DEPARTMENT OF NATURAL RESOURCES (WDMR) TECHNICAL STANDARDS (REFERRED TO AS BIM'S) AND CITY OF MADISON ORDINANCE. IT IS THE CONTRACTOR'S BUILDING OVERHANG RESPONSIBILITY TO OBTAIN A COPY OF THESE STANDARDS. CONTRACTOR SHALL BE RESPONSIBLE FOR ANY ADDITIONAL EROSION CONTROL MEASURES WHICH MAY BE NECESSARY TO MEET BUILDING SETBACK LINE UNFORESEEN FIELD CONDITIONS.
- INSTALL PERIMETER EROSION CONTROL MEASURES (SUCH AS CONSTRUCTION ENTRANCES, SILT FENCE AND EXISTING INLET PROTECTION) PRIOR TO ANY SITE WORK, INCLUDING GRADING OR DISTURBANCE
 OF EXISTING SURFACE COVER, AS FOWN ON PLAN. MODIFICATIONS TO THE APPROVED EROSION

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- 4. ADDITIONAL EROSION CONTROL MEASURES, AS REQUESTED BY STATE INSPECTORS, LOCAL INSPECTORS, COUNTY INSPECTORS AND/OR ENGINEER OF RECORD SHALL BE INSTALLED WITHIN 24 HOURS OF REQUEST.

 HEAVY DUTY ASPHALT PAVEMENT
- INSPECTIONS AND MAINTENANCE OF ALL EROSION CONTROL MEASURES SHALL BE ROLLTINE (ONCE PER INSPECTIONS AND MAINTENANCE OF ALL EROSION CONTROL MEASURES SHALL BE ROUTINE (ONCE PER WEEK MINIMUM) TO ENSURE PROPER FUNCTION OF EROSION CONTROL MEASURES ARE TO BE IN MORKING ORDER AT THE END OF EACH WORK DAY.

 HEAVY DUTY CONCRETE PAVEMENT ONLY THE PROPER FUNCTION OF THE PACH WORK DAY.
- ALL EROSION AND SEDIMENT CONTROL ITEMS SHALL BE INSPECTED WITHIN 24 HOURS OF ALL RAIN EVENTS EXCEEDING 0.5 INCHES. ANY DAMAGED EROSION CONTROL MEASURES SHALL BE REPAIRED OR REPLACED IMMEDIATELY UPON INSPECTION. CONSTRUCTION ENTRANCES SHALL BE INSTALLED AT ALL LOCATIONS OF VEHICLE INGRESS/EGRESS POINTS. ADDITIONAL LOCATIONS OTHER THAN AS SHOWN ON THE PLANS MUST BE PRIOR APPROVED BY THE MUNICIPALITY. CONSTRUCTION ENTRANCES SHALL BE 50' LONG AND NO LESS THAN 12' THICK BY USE OF 3" CLEAR STONE. CONSTRUCTION ENTRANCES SHALL BE MAINTAINED BY THE CONTRACTOR IN A CONDITION WHICH WILL PREVENT THE TRACKING OF MUD OR DRY SEDMENT ONTO ADJACENT PUBLIC STREETS AFTER EACH WORKING DAY OR MORE FREQUENTLY AS REQUIRED.
- 8. PAVED SURFACES ADJACENT TO CONSTRUCTION SITE VEHICLE ACCESS SHALL BE SWEPT AND/OR SCRAPED TO REMOVE ACCUMULATED SOIL, DIRT AND/OR DUST AFTER THE END OF EACH WORK DAY SAND AS REQUESTED BY THE CITY OF MADISON.
- INLET PROTECTION SHALL BE IMMEDIATELY FITTED AT THE INLET OF ALL INSTALLED STORM SEWER AND

 WATERMAIN
 SILT FENCE SHALL BE IMMEDIATELY FITTED AT ALL INSTALLED CULVERT INLETS TO PREVENT SEDIMENT
 DEPOSITION WITHIN STORM SEWER SYSTEMS.
- D. INSTALL EROSION CONTROLS ON THE DOWNSTREAM SIDE OF STOCKPILES. IF STOCKPILE REMAINS UNDISTURBED FOR MORE THAN SEVEN (7) DAYS, TEMPORARY SEEDING AND STABILIZATION IN ACCORDANCE WITH BEST MANAGEMENT PRACTICES IS REQUIRED. IF DISTURBANCE OCCURS BETWEEN NOVEMBER 15TH AND MAY 15TH, THE MULCHING SHALL BE PERFORMED BY HYDRO-MULCHING WITH A
- 11. DITCH CHECKS AND APPLICABLE EROSION NETTING/MATTING SHALL BE INSTALLED IMMEDIATELY AFTER COMPLETION OF GRADING EFFORTS WITHIN DITCHES/SWALES TO PREVENT SOIL TRANSPORTATION.
- 12. EROSION CONTROL FOR UTILITY CONSTRUCTION (STORM SEWER, SANITARY SEWER, WATER MAIN, ETC.):

 A. PLACE EXCAVATED TRENCH MATERIAL ON THE HIGH SIDE OF THE TRENCH.

 B. BACKFILL, COMPACT. AND STABLUZE THE TRENCH IMMEDIATELY AFTER PIPE CONSTRUCTION.

 C. DISCHARGE TRENCH WATER INTO A SEDIMENTATION BASIN OR FILTERING TANK IN ACCORDANCE WITH THE DEWATERING TECHNICAL STANDARD NO. 1061 PRIOR TO RELEASE INTO THE STORM SEWER, RECEIVING STREAM, OR DRAINAGE DITCH.
- 13. ALL SLOPES 4:1 OR GREATER SHALL BE STABILIZED WITH CLASS I, TYPE B EROSION MATTING OR APPLICATION OF A WISCONSIN DEPARTMENT OF TRANSPORTATION (WISDOT) APPROVED POLYMER SOIL STABILIZATION TREATMENT OR A COMBINATION THEREOF, AS REQUIRED WITHIN 7 DAYS OF REACHING FINAL GRADE AND/OR AS SOON AS CONDITIONS ALLOW. DRAINAGE SWALES SHALL BE STABILIZED WITH CLASS II, TYPE B EROSION MATTING, EROSION MATTING AND/OR NETTING USED DONSTE SHALL BE WISTALLED IN ACCORDANCE WITH MANUFACTURER'S GUIDELINES AND WONR TECHNICAL STANDARDS 1052 AND 1053.
- 14. CONTRACTOR SHALL TAKE ALL NECESSARY STEPS TO CONTROL DUST ARISING FROM CONSTRUCTION
 OPERATIONS. REFER TO WIDNR TECHNICAL STANDARD 1068.
- 15. EROSION CONTROL MEASURES SHALL NOT BE REMOVED UNTIL ALL LAND DISTURBING CONSTRUCTION ACTIVITY AT THE SITE HAS BEEN COMPLETED AND THAT A UNIFORM PERENNIAL VEGETATIVE COVER HAS BEEN ESTABLISHED WITH A DENSITY OF AT LEAST 70% FOR UNPAYED AREA AND AREAS NOT COVERED BY PERMANENT STRUCTURES OR THAT EMPLOY EQUIVALENT PERMANENT STABILIZATION MEASURES.

- STABILIZATION PRACTICES:

 STABILIZATION MEASURES SHALL BE INITIATED AS SOON AS PRACTICABLE IN PORTIONS OF THE SITE WHERE CONSTRUCTION ACTIVITIES HAVE TEMPORARILY OR PERMANENTLY CEASED. NO MORE THAN SEVEN (7) DAYS SHALL PASS AFTER THE CONSTRUCTION ACTIVITY IN THAT PORTION OF THE SITE HAS CEASED UNLESS:

 THE INITIATION STABILIZATION MEASURES BY THE SEVENTH (7) DAY AFTER CONSTRUCTION ACTIVITY HAS CEASED IS PRECULDED BY SNOW COVER. IN THAT EVENT, STABILIZATION SHALL BE INITIATED AS SOON AS PRACTICABLE.

 CONSTRUCTION ACTIVITY OF AS PRACTICABLE.

 CONSTRUCTION ACTIVITY CHASED, (I.E. THE TOTAL TIME PERIOD THAT THE CONSTRUCTION ACTIVITY IS EMPORABLY CEASED.)

 ACTIVITY IS EMPORABLY CEASED IS LESS THAN FOURTEEN (14) DAYS. IN THAT EVENT. STABILIZATION MEASURES ON THAT THE CONSTRUCTION THAT PORTION OF THE SITE BY THE SEVENTH (7) DAY AFTER CONSTRUCTION ACTIVITY HAS TEMPORABLY CEASED IS LESS THAN FOURTEEN (14) DAYS. IN THAT EVENT. STABILIZATION MEASURES SHALL BETERMINED BASED ON THAT PORTION OF THE SITE STABILIZATION MEASURES.

 STABILIZATION MEASURES SHALLE DETERMINED BASED ON SITE CONDITIONS AT THE TIME ACCEPTABLE STABILIZATION MEASURES:

 PERMANENT SEEDING; MAY CONSIST OF SPRING DATS(100LBS/ACRE) AND/OR WHEAT OR CEPETALLE ENGLIFICATION.

 TEMPORARY SEEDING; MAY CONSIST OF SPRING DATS(100LBS/ACRE) AND/OR WHEAT OR CEPETALLE EROSION MATTING

 SODDING

- STORMWATER FACILITIES CONSTRUCTION NOTES ENGINEER SHALL BE NOTIFIED PRIOR TO INSTALLATION OF STORMWATER MANAGEMENT FACILITIES. CONSTRUCTION OF STORMWATER MANAGEMENT FACILITIES SHALL BE OBSERVED AND DOCUMENTED BY
- THE ENGINEER, OR AN OWNER'S REPRESENTATIVE STORMWATER MANAGEMENT FACILITIES SHALL BE INSTALLED AFTER SUBSTANTIAL COMPLETION OF FINAL SITE GRADING AND SOILS HAVE BEEN STABILIZED.
- AREAS USED FOR TEMPORARY SEDIMENT BASINS SHALL BE REMOVED IN THEIR ENTIRETY AFTER CONSTRUCTION OF STORMWATER MANAGEMENT FACILITIES.
- CONSTRUCTION TRAFFIC, HEAVY EQUIPMENT AND SOIL STOCKPILES SHALL NOT BE PLACED IN AREAS WHERE PROPOSED STORMWATER MANAGEMENT FACILITIES ARE LOCATED. NATIVE SOIL INFILTRATION RATES BELOW STORMWATER FACILITIES SHALL BE VERIFIED BY THE OWNER'S GEOTECHNICAL ENGINEER PRIOR INSTALLATION OF FACILITIES. NATIVE SOIL INFILTRATION RATES SHALL BE EQUAL TO OR GREATER THAN DESIGN INFILTRATION RATE.
- NATIVE SOILS SHALL BE BLENDED A MINIMUM OF TWO FEET PRIOR TO INSTALLATION OF STORMWATER INFILTRATION FACILITIES TO BREAKUP ANY LOWER PERMEABILITY SEAMS THAT MAY BE PRESENT.

LEGEND

EDGE OF PAVEMENT

CONCRETE PAVEMENT

- - 959 - -BIKE RACK

SAWCUT EXISTING PAVEMENT SANITARY SEWER

CONSTRUCTION ENTRANCE

> SPOT ELEVATION
>
> FP — EDGE OF PAVEMENT
> FG — FINISH GRADE
> EC — EDGE OF CONCRETE
> BOC — BACK OF CURB
> MATCH — MATCH EXISTING GRADE
> HP — HIGH POINT
> SW — SIDEWALK FG: XXX.XX

> > INLET PROTECTION

DEMOLITION - REMOVAL OF ASPHALT SURFACES

TREE REMOVAL SHRUB REMOVAL



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MADISON REGIONAL OFFICE 161 HORIZON DRIVE, SUITE 101

VERONA, WISCONSIN P. 608.848.5060

DEVELOPMENT GROUP

1952 ATWOOD AVENUE MADISON, WISCONSIN 53704

DEMOLITION - REMOVAL OF BUILDINGS/STRUCTURE DEMOLITION - REMOVAL OF UTILITIES

PROTECT EXISTING TREE

MADISON, DANE COUNTY

#_	Date:	Description:
1	01,10,2022	LAND USE SUBMITTAL
2	02,25,2022	LAND USE RESUBMITTAL
2 3 4 5		
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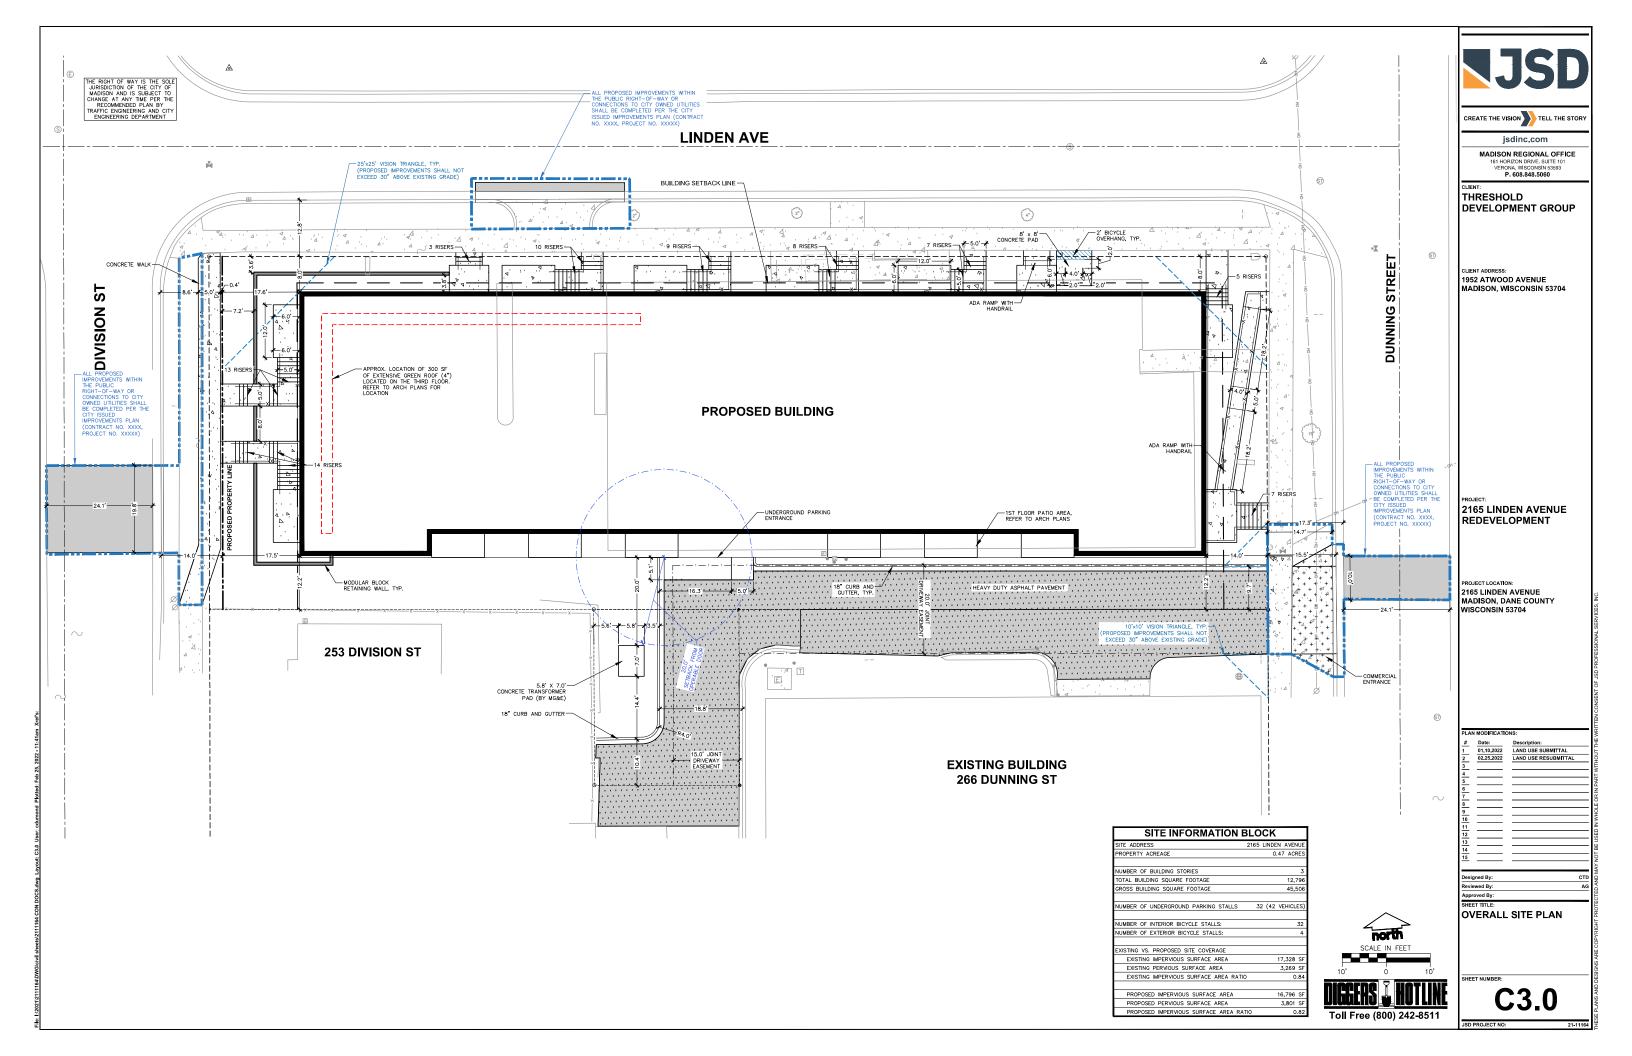
THRESHOLD


2165 LINDEN AVENUE REDEVELOPMENT


ROJECT LOCATION 2165 LINDEN AVENUE


proved By:


NOTES AND LEGEND




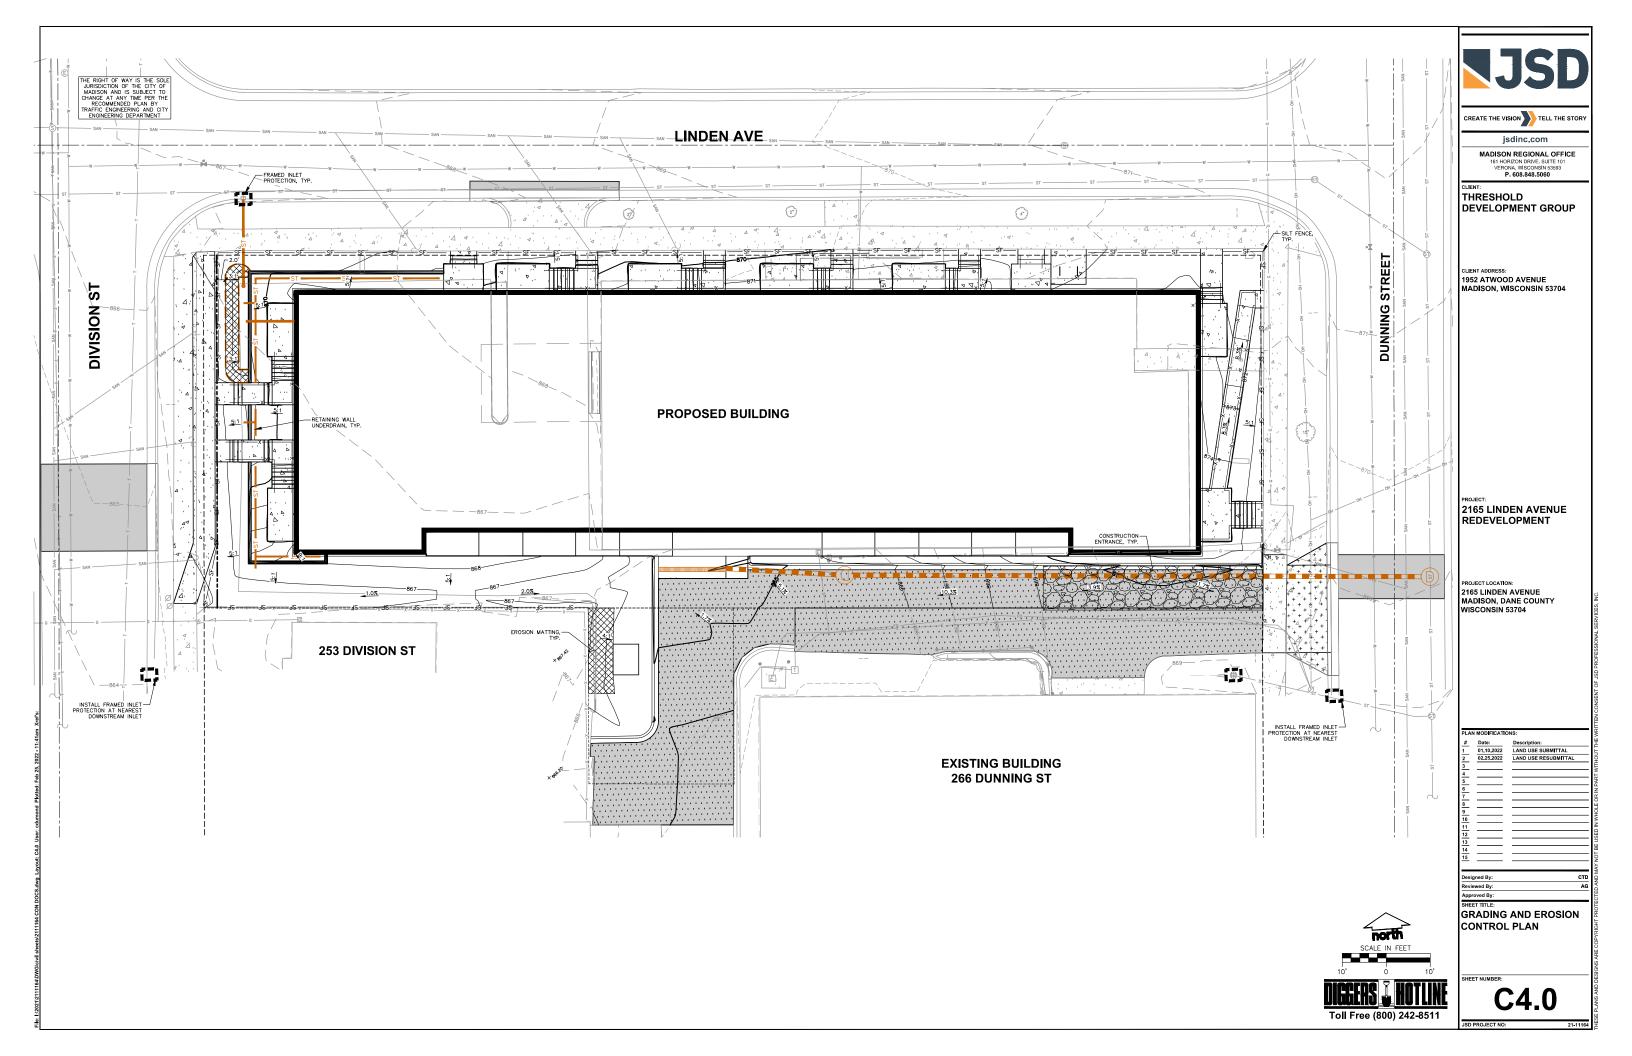


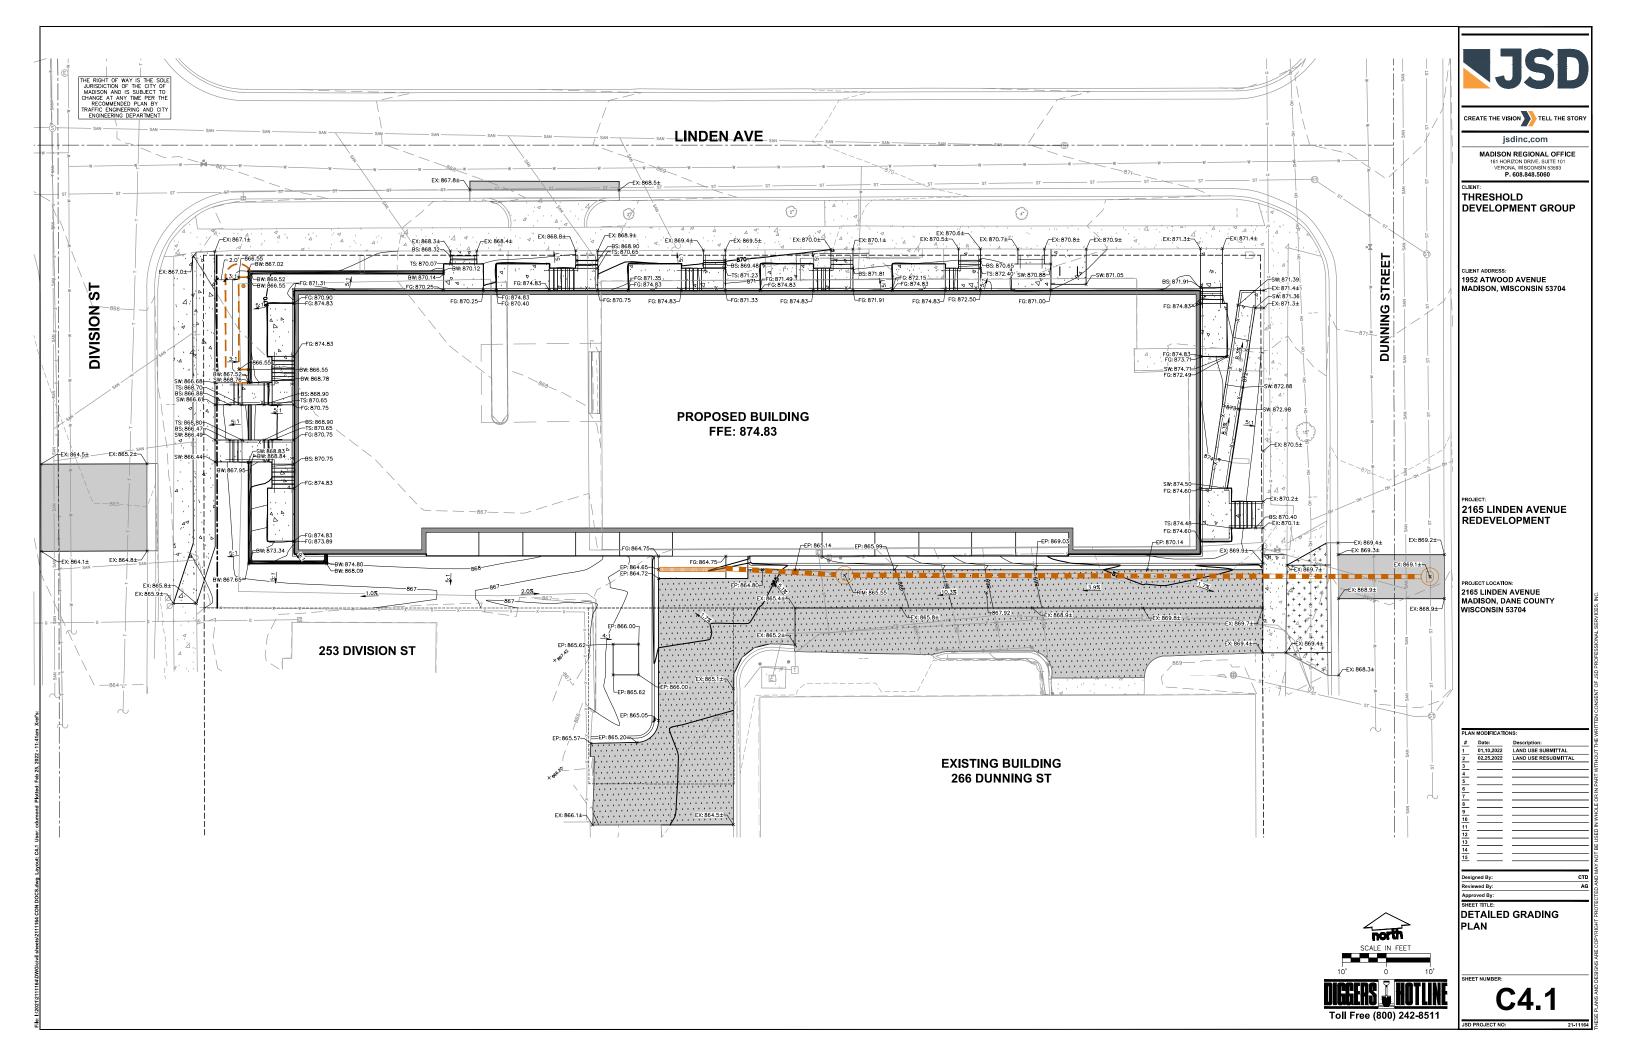

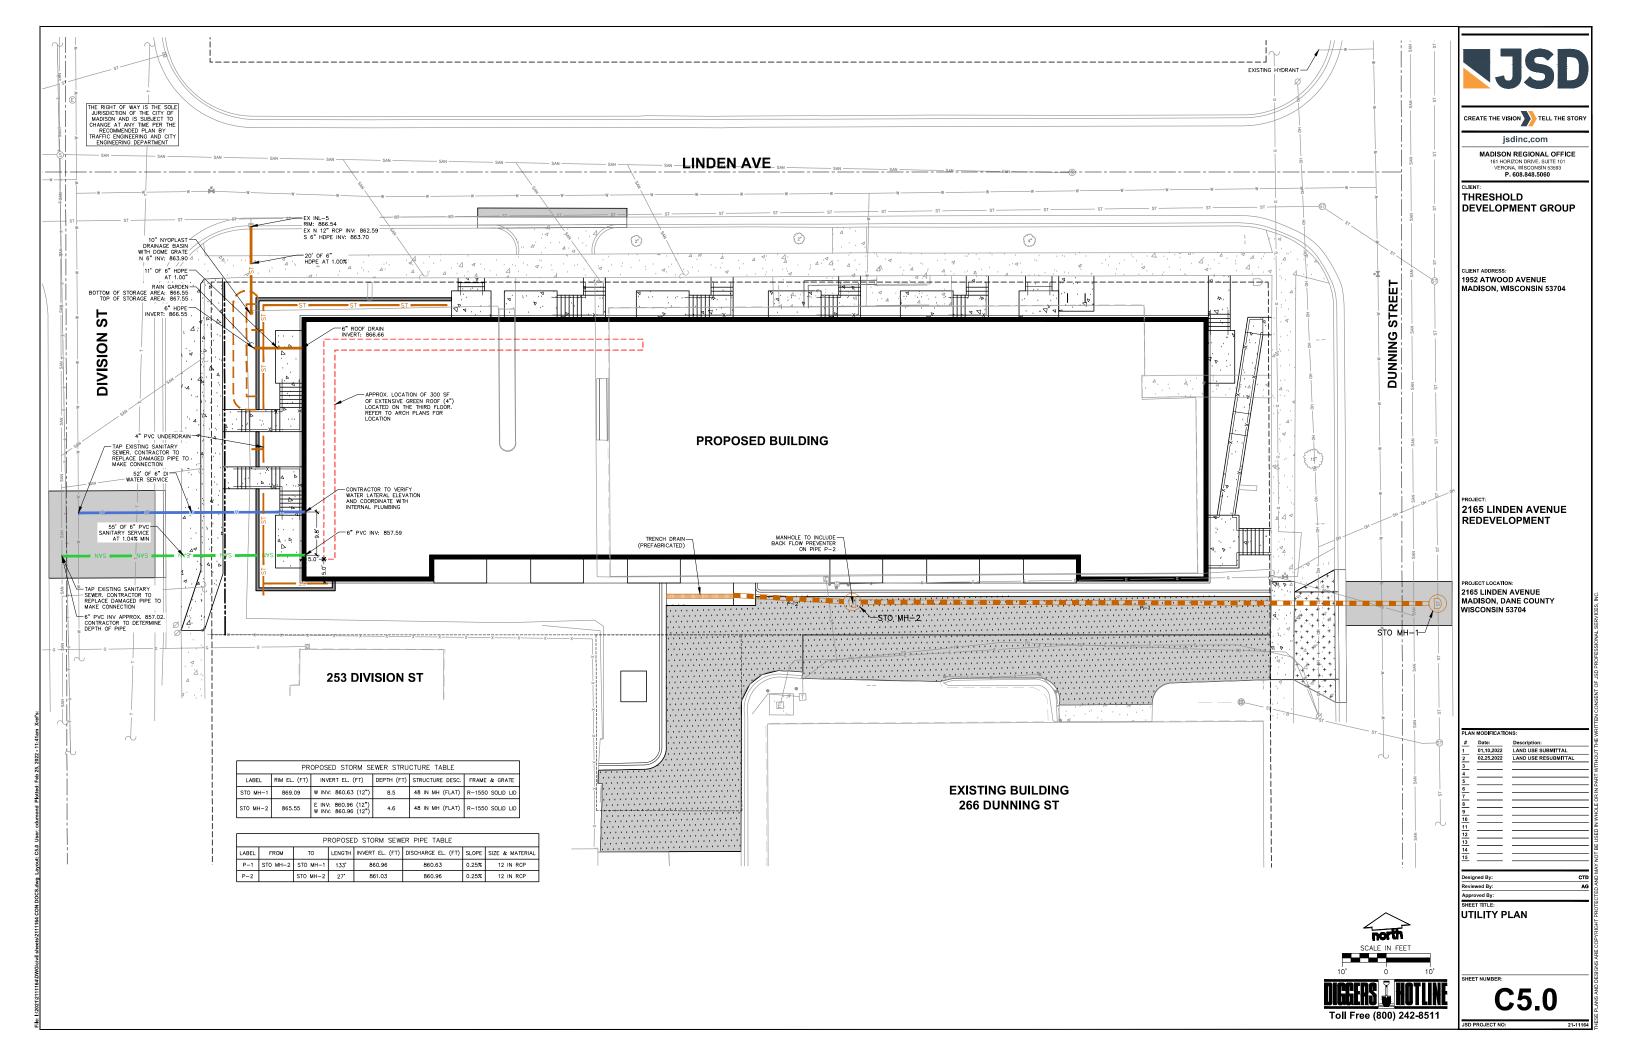

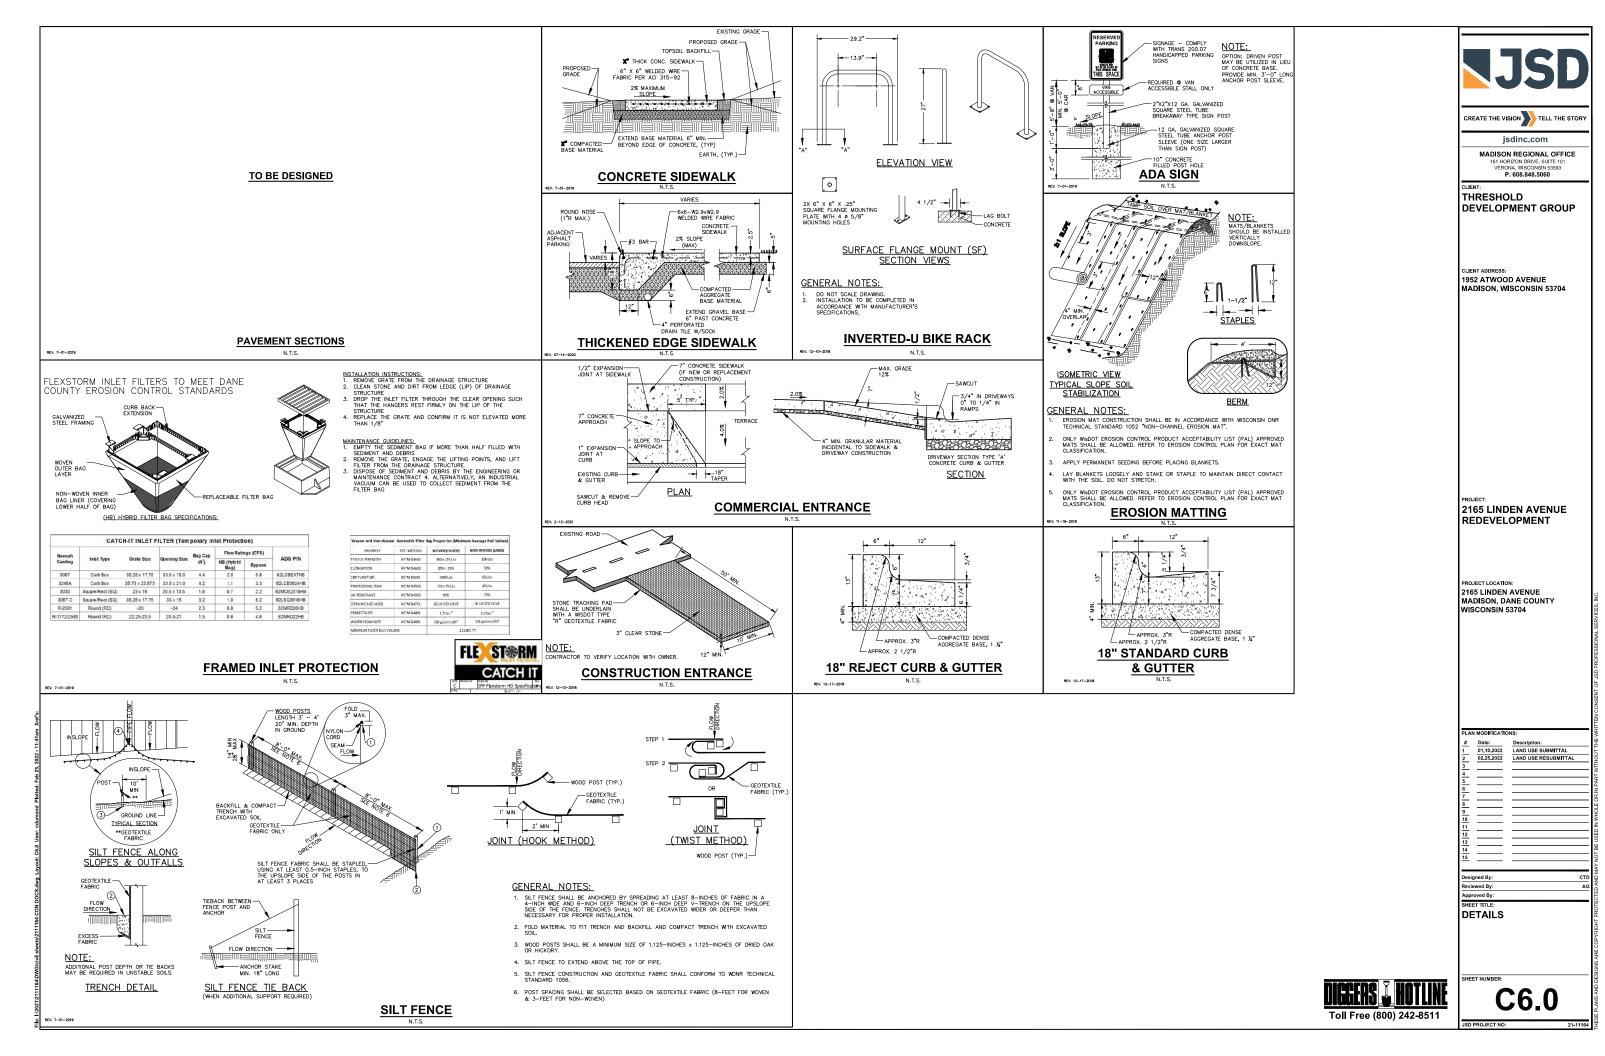

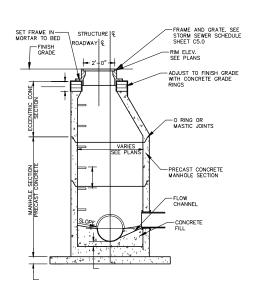


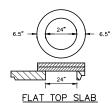


GENERAL NOTES:

- MANHOLE CONSTRUCTION TO MEET REQUIREMENTS OF ASTM C478.
- PROVIDE FLAT TOP SLAB FOR MANHOLES 5' OR LESS IN DEPTH. FLAT TOP SLABS TO BE IN-BELL TYPE.
- 3. JOINTS SHALL BE WATERTIGHT. USE BUTYL RUBBER GASKET.
- 4. USE MORTAR FOR PIPE CONNECTIONS.
- ECCENTRIC CONE SECTION OF MANHOLE TO BE SET OUTSIDE OF VEHICULAR WHEEL PATH NEAR Q ROADWAY.

STORM MANHOLE

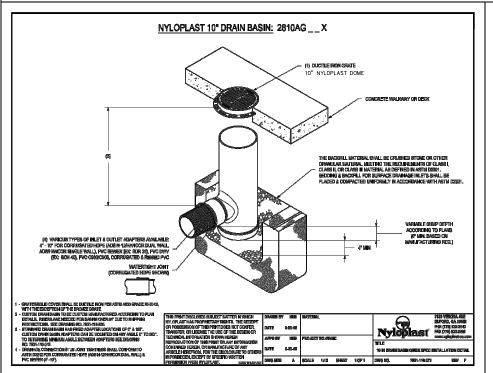

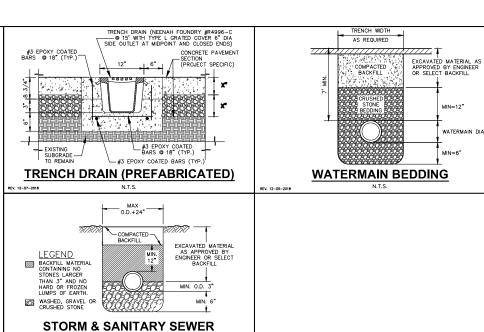

BEDDING

WATERMAIN DIA.

. MIN=6"

CREATE THE VISION TELL THE STORY isdinc.com MADISON REGIONAL OFFICE 161 HORIZON DRIVE, SUITE 101 VERONA, WISCONSIN 53 P. 608.848.5060 THRESHOLD DEVELOPMENT GROUP CLIENT ADDRESS:
1952 ATWOOD AVENUE MADISON, WISCONSIN 53704 2165 LINDEN AVENUE REDEVELOPMENT PROJECT LOCATION: 2165 LINDEN AVENUE MADISON, DANE COUNTY WISCONSIN 53704

 Date:
 Description:

 01.10.2022
 LAND USE SUBMITTAL


 02.25.2022
 LAND USE RESUBMITTAL

Approved By: SHEET TITLE:

DETAILS

C6.1

Toll Free (800) 242-8511

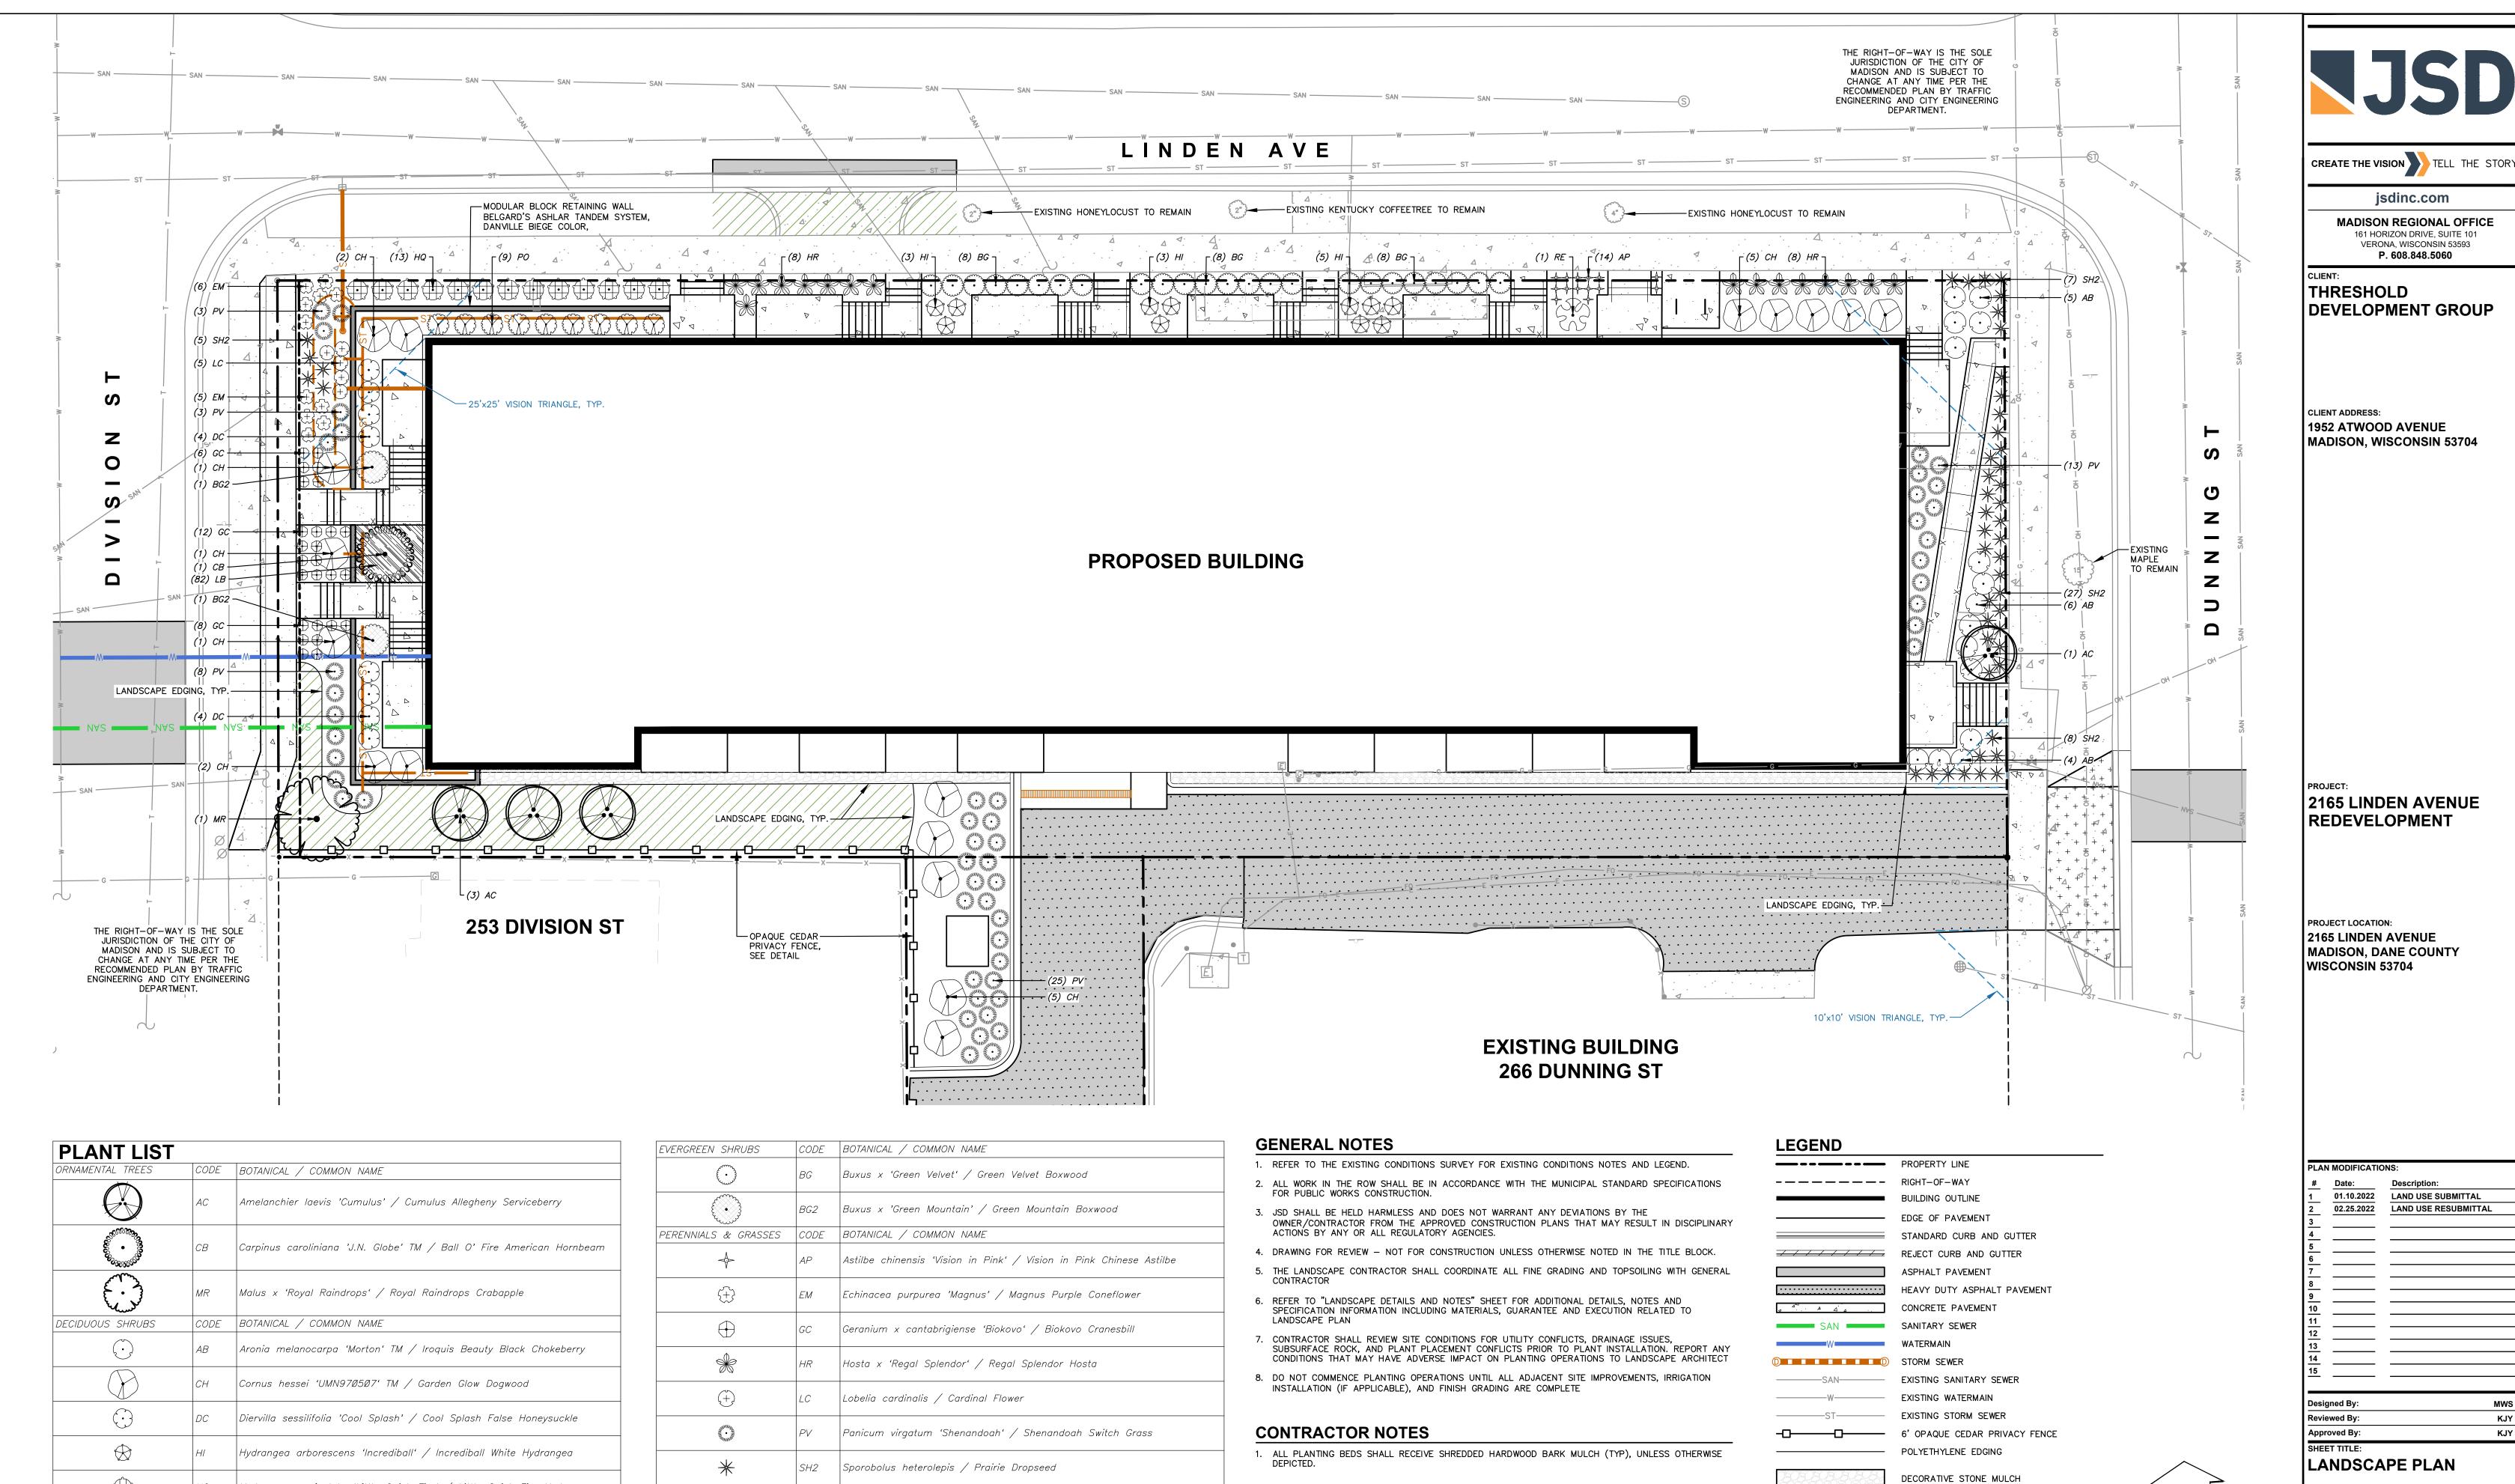

Hydrangea paniculata 'Little Quick Fire' / Little Quick Fire Hydrangea

Physocarpus opulifolius 'Little Devil' TM / Dwarf Ninebark

Rhododendron x 'P.J.M.' / PJM Rhododendron

GROUND COVERS

| CODE | BOTANICAL / COMMON NAME

Liriope muscari 'Big Blue' / Big Blue Lilyturf

MADISON REGIONAL OFFICE 161 HORIZON DRIVE, SUITE 101

DEVELOPMENT GROUP

MADISON, WISCONSIN 53704


2165 LINDEN AVENUE

LAND USE RESUBMITTAL

SEED - BLUEGRASS

Toll Free (800) 242-8511

COMPREHENSIVE PLANT SCHEDULE					
ORNAMENTAL TREES	CODE	BOTANICAL / COMMON NAME	CONT	SIZE	QTY
	AC	Amelanchier laevis 'Cumulus' / Cumulus Allegheny Serviceberry	B & B	Min. 5' tall	4
E . S. S	СВ	Carpinus caroliniana 'J.N. Globe' TM / Ball O' Fire American Hornbeam	B & B	Min. 4' Ht.	1
	MR	Malus x 'Royal Raindrops' / Royal Raindrops Crabapple	B & B	1.5"Cal	1
DECIDUOUS SHRUBS	CODE	BOTANICAL / COMMON NAME	CONT	SIZE	QTY
€°.	AB	Aronia melanocarpa 'Morton' TM / Iroquis Beauty Black Chokeberry	#3	Min. 12"-24"	15
	СН	Cornus hessei 'UMN970507' TM / Garden Glow Dogwood	B & B	Min. 36" tall	17
\odot	DC	Diervilla sessilifolia 'Cool Splash' / Cool Splash False Honeysuckle	B & B	Min. 18-24" Ht.	8
\otimes	НІ	Hydrangea arborescens 'Incrediball' / Incrediball White Hydrangea	#3	Min. 12"-24"	1 1
	HQ	Hydrangea paniculata 'Little Quick Fire' / Little Quick Fire Hydrangea	#3	Min. 12"-24"	13
	PO	Physocarpus opulifolius 'Little Devil' TM / Dwarf Ninebark	#3	Min. 12"-24"	9
	RE	Rhododendron x 'P.J.M.' / PJM Rhododendron	B & B	Min. 18-24" Ht.	1
EVERGREEN SHRUBS	CODE	BOTANICAL / COMMON NAME	CONT	SIZE	QTY
(· · · · · · · · · · · · · · · · · · ·	BG	Buxus x 'Green Velvet' / Green Velvet Boxwood	3 gal	Min. 12"-24"	24
	BG2	Buxus x 'Green Mountain' / Green Mountain Boxwood	B & B	Min. 36" Ht.	2
PERENNIALS & GRASSES	CODE	BOTANICAL / COMMON NAME	CONT	SIZE	QTY
\rightarrow	AP	Astilbe chinensis 'Vision in Pink' / Vision in Pink Chinese Astilbe	#1	Min. 8"-18"	14
(+)	ЕМ	Echinacea purpurea 'Magnus' / Magnus Purple Coneflower	#1	Min. 8"-18"	1 1
\bigoplus	GC	Geranium x cantabrigiense 'Biokovo' / Biokovo Cranesbill	#1	Min. 8"-18"	26
*	HR	Hosta x 'Regal Splendor' / Regal Splendor Hosta	#1	Min. 8"-18"	16
(+)	LC	Lobelia cardinalis / Cardinal Flower	#1	Min. 8"-18"	5
William Particular	PV	Panicum virgatum 'Shenandoah' / Shenandoah Switch Grass	#1	Min. 8"-18"	52
*	SH2	Sporobolus heterolepis / Prairie Dropseed	#1	Min. 8"-18"	48
GROUND COVERS	CODE	BOTANICAL / COMMON NAME	CONT	SPACING	QTY
	LB	Liriope muscari 'Big Blue' / Big Blue Lilyturf	4" plug	12"	78 sf

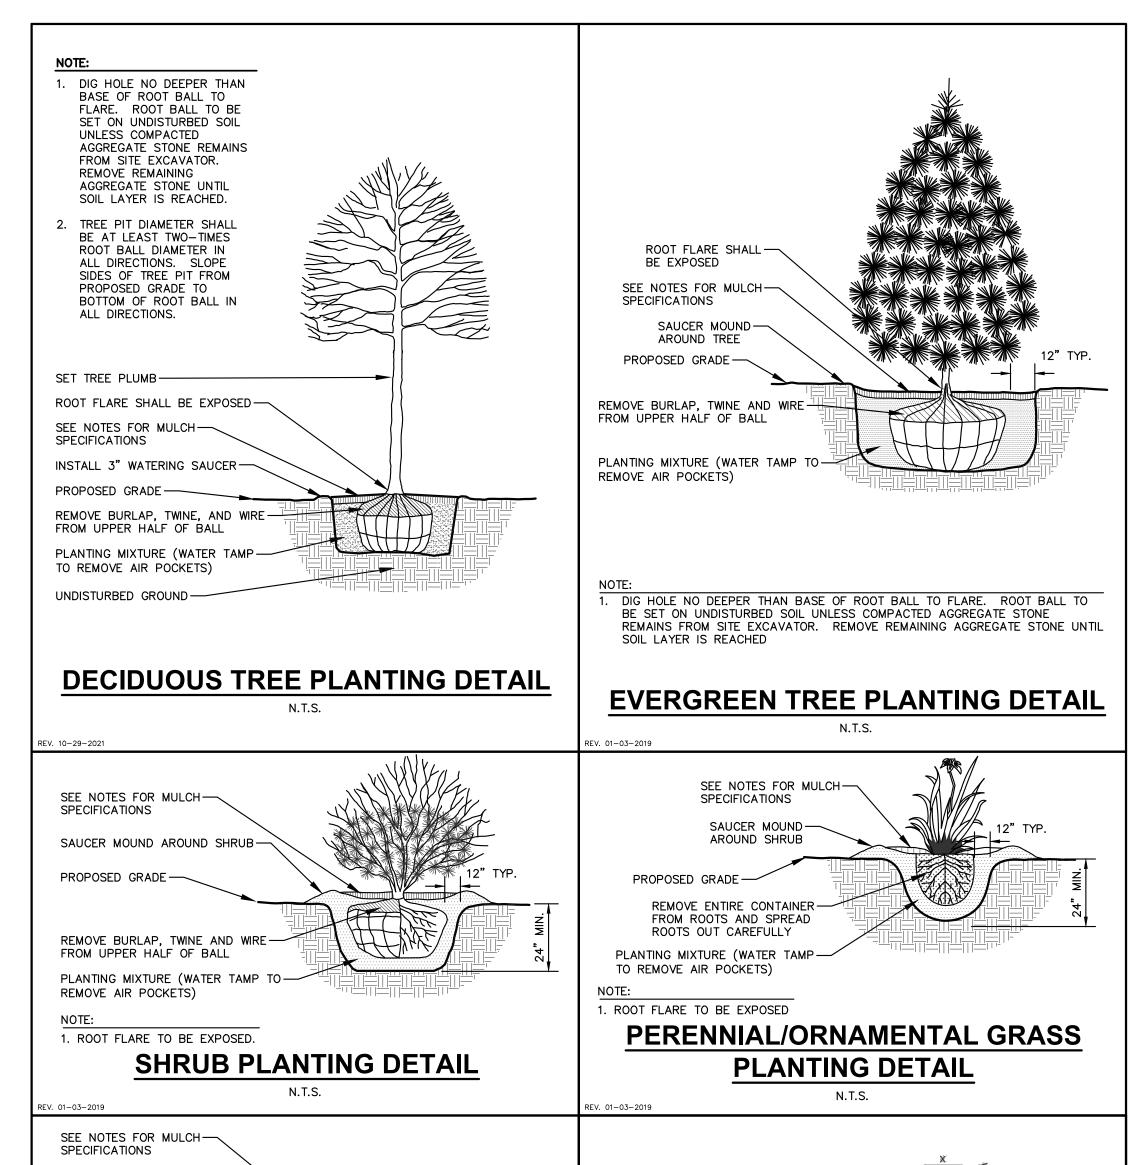

LANDSCAPE CALCULATIONS AND DISTRIBUTIONS Required landscaped areas shall be calculated based upon the total developed area of the property. Developed area is defined as that area within a single contiguous boundary which is made up of structures, parking driveways and decking/leading facilities, but excluding the area

of an	y building footprint at grade, land designated for ope	structures, parking, driveways and docking/loading facilities, but excluding the area in space uses such as athletic fields, and undeveloped land area on the same cape points depending on the size of the lot and Zoning District.
(A)	For all lots except those described in (B) and (C) be square feet of developed area.	elow, five (5) landscape points shall be provided for each three hundred (300)
	Total square footage of developed area:	<u>6,456 SF</u>
	Total landscape points required:	108 POINTS
(B) —		rovided at five (5) points per three hundred (300) square feet for the first e hundred (100) square feet for all additional acres.
	-Total square footage of developed area:	
	Five (5) acres =	
	First five (5) developed acres =	
	Remainder of developed area:	
	-Total landscape points required	
(C)	For the Industrial – Limited (IL) and Industrial – Geper one hundred (100) square feet of developed ar	
	-Total square footage of developed area:	
	-Total landscape points required:	

			CREDITS / EXISTING LANDSCAPING		NEW / PROPOSED LANDSCAPING	
PLANT TYPE/ELEMENT	MINIMUM INSTALLATION SIZE	POINTS	QUANTITY	POINTS ACHIEVED	QUANTITY	POINTS ACHIEVED
OVERSTORY DECIDUOUS TREE	2.5" CAL MIN.	35	0	0	0	0
TALL EVERGREEN TREE	5-6' TALL MIN.	35	0	0	0	0
ORNAMENTAL TREE	1.5" CAL MIN.	15	0	0	6	90
UPRIGHT EVERGREEN SHRUB	3-4' TALL, MIN.	10	0	0	0	0
SHRUB, DECIDUOUS	#3 CONT., MIN. 12"-24"	3	0	0	74	222
SHRUB, EVERGREEN	#3 CONT., MIN. 12"-24"	4	0	0	26	104
ORNAMENTAL GRASS & PERENNIAL	#1 CONT., MIN. 8"-18"	2	0	0	172	344
ORNAMENTAL / DECORATIVE FENCING OR WALL	4 POINTS / 10 LF	.4	0	0	0	0
EXISTING SIGNIFICANT SPECIMAN TREE	14 POINTS / CAL. (MAXIMUM 200 POINTS PER TREE)	14	0	0	0	0
LANDSCAPE FURNITURE	5 POINTS PER SEAT (WITHIN PUBLICALLY ACCESSIBLE DEVELOPED AREA. CANNOT COMPRISE MORE THAN 5% OF TOTAL REQUIRED POINTS)	5	0	0	0	0
		SUBTOTAL		0		760

PROPOSED GRADE -


8" - 10" LONG

REV. 01-03-2019

5" POLYETHYLENE EDGING-

3/8" GALVANIZED STEEL SPIKE-

POLYETHYLENE LANDSCAPE EDGING

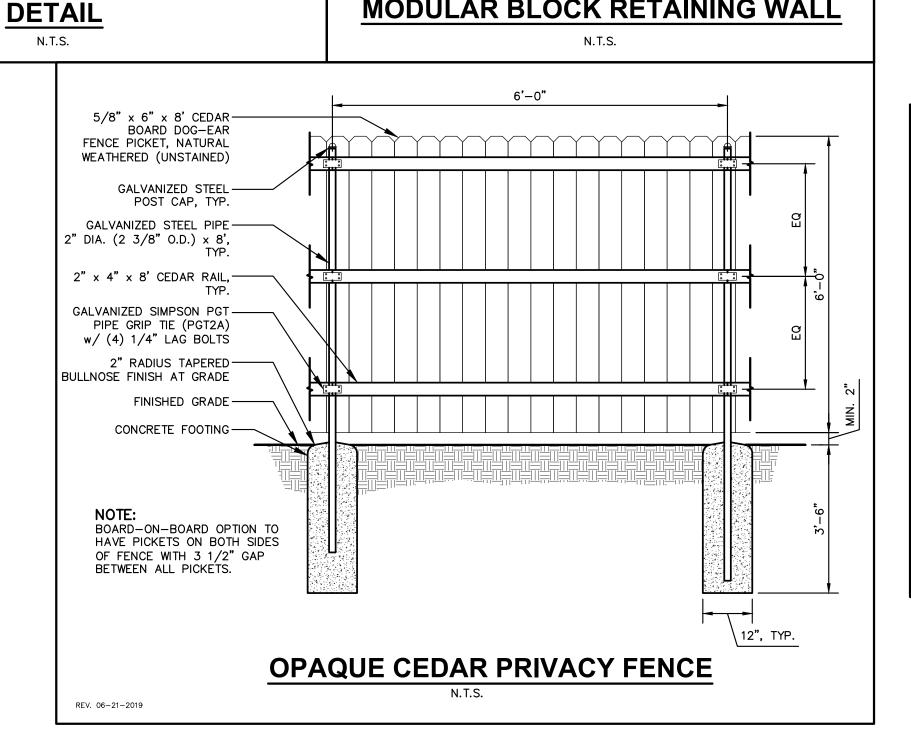

TANDEM® UNIT — 🗀

2'-0" --

MODULAR BLOCK RETAINING WALL

12" (MIN) OF FREE

- 4"Ø MIN DRAIN PIPE

(ELEVATION VARIES)

- 6" MINIMUM COMPACTED

DRAINING AGGREGATE

FILL AREA BETWEEN -

FACING UNITS WITH

AGGREGATE

GENERAL NOTES

- GENERAL: ALL WORK IN THE R-O-W AND PUBLIC EASEMENTS SHALL BE IN ACCORDANCE WITH LOCAL MUNICIPAL REQUIREMENTS. JSD SHALL BE HELD HARMLESS AND DOES NOT WARRANT ANY DEVIATIONS BY THE OWNER/CONTRACTOR FROM THE APPROVED CONSTRUCTION PLANS THAT MAY RESULT IN DISCIPLINARY ACTIONS BY ANY OR ALL REGULATORY AGENCIES. LOCATE ALL UTILITIES PRIOR TO CONSTRUCTION. THE CONTRACTOR IS RESPONSIBLE FOR REPAIRING ANY DAMAGE DONE TO UTILITIES. CONTRACTOR MUST CALL 1-800-242-8511 FOR UTILITY LOCATIONS AT LEAST THREE DAYS PRIOR TO DIGGING. HAND DIG AND INSTALL ALL PLANTS THAT ARE NEAR EXISTING UTILITIES. PROTECT PREVIOUSLY INSTALLED WORK OF OTHER TRADES. CONTRACTOR IS RESPONSIBLE FOR STAKING THE PLANT MATERIALS FOR REVIEW BY OWNER PRIOR TO DIGGING AND PLACEMENT AND SHALL COORDINATE ALL FINE GRADING AND RESTORATION WITH THE GRADING CONTRACTOR.
- DELIVERY AND HANDLING: DO NOT DELIVER MORE PLANT MATERIALS THAN CAN BE PLANTED IN ONE DAY, UNLESS ADEQUATE, APPROPRIATE AND SECURE STORAGE IS PROVIDED AND APPROVED BY OWNER'S REPRESENTATIVE. AT ALL TIMES, PROTECT ALL PLANT MATERIALS FROM WIND AND DIRECT SUN. DELIVER PLANTS WITH LEGIBLE IDENTIFICATION LABELS. PROTECT PLANTS DURING DELIVERY AND DO NOT PRUNE PRIOR TO DELIVERY. ALL TREES AND SHRUBS SHALL BE PLANTED ON THE DAY OF DELIVERY; IF THIS IS NOT POSSIBLE, PROTECT THE PLANT MATERIALS NOT PLANTED BY STORING THEM IN A SHADED, SECURE AREA, PROTECTING THE ROOT MASS WITH WET SOIL, MULCH, HAY OR OTHER SUITABLE MEDIUM. CONTRACTOR TO KEEP ALL PLANT MATERIALS ADEQUATELY WATERED TO PREVENT ROOT DESICCATION. DO NOT REMOVE CONTAINER GROWN STOCK FROM CONTAINERS BEFORE TIME OF PLANTING. DO NOT PICK UP CONTAINER OR BALLED PLANTS BY STEM OR ROOTS. ALL PLANTS SHALL BE LIFTED AND HANDLED FROM THE BOTTOM OF THE CONTAINER OR BALL. PERFORM ACTUAL PLANTING ONLY WHEN WEATHER AND SOIL CONDITIONS ARE SUITABLE IN ACCORDANCE WITH LOCALLY ACCEPTED BEST HORTICULTURAL PRACTICES.
- MATERIALS PLANTS: ALL PLANTS SHALL CONFORM TO THE LATEST VERSION OF THE AMERICAN STANDARD FOR NURSERY STOCK ANSI Z60.1. PLANTS SHALL BE TRUE TO SPECIES AND VARIETY SPECIFIED AND NURSERY GROWN IN ACCORDANCE WITH GOOD HORTICULTURAL PRACTICES UNDER CLIMATIC CONDITIONS SIMILAR TO THOSE IN THE LOCALITY OF THE PROJECT FOR AT LEAST 2 YEARS. PLANTS SHALL BE FRESHLY DUG (DURING THE MOST RECENT FAVORABLE HARVEST SEASON). PLANTS SHALL BE SO TRAINED IN DEVELOPMENT AND APPEARANCE AS TO BE UNQUESTIONABLY SUPERIOR IN FORM. COMPACTNESS, AND SYMMETRY. PLANTS SHALL BE SOUND, HEALTHY, VIGOROUS, WELL BRANCHED AND DENSELY FOLIATED WHEN IN LEAF, AND FREE OF DISEASE AND INSECTS (ADULT EGGS, PUPAE OR LARVAE). THEY SHALL HAVE HEALTHY, WELL-DEVELOPED ROOT SYSTEMS AND SHALL BE FREE FROM PHYSICAL DAMAGE OR OTHER CONDITIONS THAT WOULD PREVENT THRIVING GROWTH OR PREMATURE MORTALITY. PLANTS SHALL BE OF THE HIGHEST QUALITY, POSSESS TYPICAL GROWTH HABITS AND FORM FOR THEIR SPECIES AND BE FREE OF INJURY. PARKWAY TREES AND PARKING LOT TREES SHALL HAVE A MINIMUM BRANCHING HEIGHT OF SIX (6) FEET ABOVE THE GROUND TO ALLOW ADEQUATE VISUAL AND PHYSICAL
- 4. PRUNING: THE CONTRACTOR SHALL PRUNE ALL TREES AND REPAIR ANY INJURIES THAT OCCURRED DURING THE PLANTING PROCESS. DOUBLE LEADERS, DEAD BRANCHES, AND LIMBS DAMAGED OR BROKEN DURING THE PLANTING PROCESS. SHALL BE PRUNED. THIS SHALL BE THE ONLY PRUNING ALLOWED AT PLANTING. PRUNING SHALL CONFORM TO THE LATEST VERSION OF THE AMERICAN STANDARD FOR TREE CARE OPERATIONS, ANSI A300. PRUNE TREES IN ACCORDANCE WITH NAA GUIDELINES. DO NOT TOP TREES. PRUNE SHRUBS ACCORDING TO STANDARD HORTICULTURAL PRACTICES. ON CUTS OVER 3/4" IN DIAMETER AND BRUISES OR SCARS ON BARK, TRACE THE INJURED CAMBIUM LAYER BACK TO LIVING TISSUE AND REMOVE. SMOOTH AND SHAPE WOUNDS SO AS NOT TO RETAIN WATER. TREAT THE AREA WITH AN APPROVED INCONSPICUOUS LATEX BASED ANTISEPTIC TREE PAINT, IF PRUNING OCCURS "IN SEASON". DO NOT PRUNE ANY OAK TREES DURING THE MONTHS FROM APRIL TO
- CLEANUP: THE WORK AREA SHALL BE KEPT SAFE AND NEAT AT ALL TIMES. DISPOSED OF EXCESS SOIL. REMOVE ALL CUTTINGS AND WASTE MATERIALS. SOIL AND BRANCHES. BIND AND WRAP THESE MATERIALS, ANY REJECTED PLANTS, AND ANY OTHER DEBRIS RESULTING FROM ALL PLANTING TASKS AND PROMPTLY CLEAN UP AND REMOVE FROM THE PROJECT SITE. UNDER NO CIRCUMSTANCES SHALL THE ACCUMULATION OF SOIL, BRANCHES OR OTHER DEBRIS BE ALLOWED UPON A PUBLIC PROPERTY IN SUCH A MANNER AS TO RESULT IN A PUBLIC SAFETY HAZARD OR DAMAGE. LIKEWISE, UNDER NO CIRCUMSTANCES SHALL ANY DEBRIS OR INCIDENTAL MATERIALS BE ALLOWED UPON ADJACENT PRIVATE PROPERTY.
- ANY SUBSTITUTIONS IN PLANT TYPE, LOCATION, OR SIZE SHALL BE APPROVED BY LANDSCAPE ARCHITECT PRIOR TO INSTALLATION.
- 7. CONTRACTOR TO VERIFY PLANT MATERIAL QUANTITIES AND SQUARE FOOTAGES. QUANTITIES SHOWN ON PLAN TAKE PRECEDENCE OVER THOSE ON SCHEDULE.

LANDSCAPE MATERIAL NOTES

- . MATERIALS PLANTING MIXTURE: ALL HOLES EXCAVATED FOR TREES, SHRUBS, PERENNIALS AND ORNAMENTAL GRASSES SHALL BE BACKFILLED WITH TWO (2) PARTS TOPSOIL, ONE (1) PART SAND AND ONE (1) PART COMPOST. SOIL MIXTURE SHALL BE WELL BLENDED PRIOR TO INSTALLATION.
- 2. MATERIALS TOPSOIL: TOPSOIL TO BE CLEAN, FRIABLE LOAM FROM A LOCAL SOURCE, FREE FROM STONES OR DEBRIS OVER 3/4" IN DIAMETER, AND FREE FROM TOXINS OR OTHER DELETERIOUS MATERIALS. TOPSOIL SHALL HAVE A pH VALUE BETWEEN 6 AND 7. TOPSOIL AND PLANTING SOIL SHALL BE TESTED TO ENSURE CONFORMANCE WITH THESE SPECIFICATIONS AND SHALL BE AMENDED TO MEET THESE SPECIFICATIONS. PROVIDE TEST RESULTS TO OWNER'S REPRESENTATIVE PRIOR TO PLACEMENT. DO NOT PLACE FROZEN OR MUDDY TOPSOIL. APPLY SOIL AMENDMENTS TO ALL LANDSCAPE AREAS PER SOIL TEST.
- 3. MATERIALS STONE MULCH: ALL PLANTING AREAS LABELED ON PLAN SHALL RECEIVE 1-1/2" HERITAGE STONE MULCH SPREAD TO A MINIMUM AND CONSISTENT DEPTH OF 3-INCHES. STONE MULCH AREAS SHALL RECEIVE WOVEN WEED BARRIER FABRIC. NO PLASTIC/IMPERVIOUS BARRIERS WILL BE PERMITTED. EXAMPLE:
- 4. MATERIALS SHREDDED HARDWOOD BARK MULCH: ALL PLANTING AREAS LABELED ON PLAN SHALL RECEIVE CERTIFIED WEED FREE SHREDDED HARDWOOD BARK MULCH (COLOR: BROWN) INSTALLED TO A MINIMUM AND CONSISTENT DEPTH OF 3-INCHES. SHREDDED HARDWOOD BARK MULCH SIZE & COLOR TO BE APPROVED BY OWNER'S REPRESENTATIVE PRIOR TO INSTALLATION. FERTILIZER SHALL BE IN ACCORDANCE WITH APPLICABLE LOCAL, COUNTY AND STATE REQUIREMENTS. SHREDDED HARDWOOD BARK MULCH AREAS SHALL NOT RECEIVE WOVEN WEED BARRIER FABRIC.
- 5. MATERIALS TREE & SHRUB RINGS: ALL TREES AND/OR SHRUBS PLANTED IN SEEDED LAWN AREAS TO BE INSTALLED WITH A MINIMUM 4' DIAMETER SHREDDED HARDWOOD BARK MULCH TREE RING SPREAD TO A CONSISTENT DEPTH OF 3-INCHES. ALL TREE RINGS SHOULD BE INSTALLED WITH A 5" DEPTH SHOVEL CUT EDGE, ANGLED 45 DEGREES INTO SOIL AT A 5' DIAMETER ABOUT THE CENTER OF THE TREE PLANTING. A PRE-EMERGENT GRANULAR HERBICIDE WEED-PREVENTER SHOULD BE MIXED WITH MULCH USED TO INSTALL TREE RING AS WELL AS TOPICALLY APPLIED TO COMPLETED INSTALLATION OF TREE RING.
- 6. MATERIALS POLYETHYLENE EDGING: EDGING SHALL BE 5" DEEP, POLYETHYLENE EDGING. OWNER'S REPRESENTATIVE SHALL APPROVE PRODUCT SPECIFICATION PROVIDED BY LANDSCAPE CONTRACTOR.
- 6. MATERIALS TREE PROTECTION: ALL TREES TO BE INSTALLED WITH LDPE TREE GUARDS AS MANUFACTURED BY A.M. LEONARD HORTICULTURAL TOOL & SUPPLY CO., OR APPROVED EQUAL.
- 7. MATERIALS TURFGRASS SEED: DISTURBED LAWN AREAS LABELED ON PLAN AS SUCH, SHALL RECEIVE 6" OF TOPSOIL AND EARTH CARPET'S "MADISON PARKS" GRASS SEED, OR EQUIVALENT AS APPROVED BY THE OWNER'S REPRESENTATIVE, INSTALLED PER MANUFACTURER'S RECOMMENDATIONS. IN ADDITION TO TURFGRASS SEED, ANNUAL RYE SHALL BE APPLIED TO ALL DISTURBED AREAS AT A RATE OF 1 1/2 LBS PER 1000 SQUARE FEET. FERTILIZE AND MULCH PER MANUFACTURER'S RECOMMENDATIONS. MULCH SHALL BE CERTIFIED NOXIOUS WEED SEED-FREE

CONTRACTOR AND OWNER RESPONSIBILITY NOTES

- 1. GUARANTEE: THE CONTRACTOR SHALL GUARANTEE ALL PLANTS THROUGH ONE (1) YEAR AFTER ACCEPTANCE BY THE OWNER'S REPRESENTATIVE. PLANTS SHALL BE ALIVE AND IN HEALTHY AND FLOURISHING CONDITION AT THE END OF THE GUARANTEE PERIOD. THE CONTRACTOR SHALL REPLACE (AT NO COST TO OWNER) ANY PLANTS THAT ARE DEAD OR NOT IN A VIGOROUS THRIVING CONDITION. REPLACEMENT PLANTS SHALL BE OF THE SAME KIND AND SIZE AS ORIGINALLY SPECIFIED UNLESS OTHERWISE DIRECTED BY OWNER'S REPRESENTATIVE. RESTORE BEDS AS NECESSARY FOLLOWING PLANT REPLACEMENT, INCLUDING BUT NOT LIMITED TO BEDDING, EDGING, MULCH, ETC. REPLACE PLANTS DAMAGED AT TIME OF PLANTING. REPAIR AREAS DISTURBED IN ANY WAY DURING PLANT REPLACEMENT AT NO COST TO OWNER. CONTRACTOR SHALL PROVIDE A ONE (1)-YEAR STRAIGHTENING GUARANTEE FOR ALL TREES.
- 2. CONTRACTOR IS RESPONSIBLE FOR STAKING THE PLANT MATERIALS FOR REVIEW BY OWNER'S REPRESENTATIVE PRIOR TO DIGGING AND PLACEMENT AND SHALL COORDINATE ALL FINE GRADING AND RESTORATION WITH THE GRADING CONTRACTOR.
- 3. MAINTENANCE: (CONTRACTOR) FOR ALL PLANTINGS, SEEDED AND/OR SODDED LAWN AREAS: THE CONTRACTOR SHALL MAINTAIN ALL PLANTINGS AND LAWN AREAS FOR A MINIMUM TIME PERIOD OF 60 DAYS, UNTIL FINAL ACCEPTANCE BY OWNER'S REPRESENTATIVE. THE CONTRACTOR IS RESPONSIBLE FOR ADEQUATELY WATERING PLANTS AND LAWN/TURFGRASS DURING THIS 60 DAY ESTABLISHMENT PERIOD. CONTRACTOR IS RESPONSIBLE FOR THE ESTABLISHMENT OF HEALTHY VIGOROUS PLANT MATERIALS AND LAWN/TURFGRASS GROWTH. CONTRACTOR IS ALSO RESPONSIBLE FOR ANY PRUNING OF PLANT MATERIALS. AND SHAPING AND/OR REPLACEMENT OR SUPPLEMENT OF DEFICIENT SHREDDED HARDWOOD BARK MULCH DURING THIS PERIOD. LONG TERM PLANT MATERIALS AND LAWN/TURFGRASS MAINTENANCE AND ANY PROGRAM FOR SUCH IS THE RESPONSIBILITY OF THE OWNER. ALL PLANTINGS AND LAWN/TURFGRASS AREAS SHALL BE MAINTAINED IN A MANICURED CONDITION UNTIL THE TIME WHEN THE OWNER'S ACCEPTANCE IS GIVEN.
- MAINTENANCE: (OWNER) THE OWNER IS RESPONSIBLE FOR THE CONTINUED MAINTENANCE, REPAIR AND REPLACEMENT OF ALL LANDSCAPING MATERIALS AND WEED BARRIER FABRIC AS NECESSARY FOLLOWING THE ONE (1) YEAR CONTRACTOR GUARANTEE PERIOD.

Toll Free (800) 242-8511



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THRESHOLD **DEVELOPMENT GROUP**

LIENT ADDRESS: 1952 ATWOOD AVENUE **MADISON, WISCONSIN 53704**

2165 LINDEN AVENUE REDEVELOPMENT

PROJECT LOCATION: **2165 LINDEN AVENUE** MADISON, DANE COUNTY WISCONSIN 53704

#_	Date:	Description:
1	01.10.2022	LAND USE SUBMITTAL
2	02.25.2022	LAND USE RESUBMITTAL
3		
4		
5		
6		
7		
8		
9		
10		
11		
12		
13		
14		
15		

esigned By: eviewed By pproved By:

LANDSCAPE DETAILS & **NOTES**

JSD PROJECT NO:

B **(9)**



ISSUED
Issued for UDC & Land Use - Jan. 10, 2022
Issued for Resubmittal - Feb. 28, 2022
Issued for Final UDC Submittal - Nov. 28, 2022

PROJECT TITLE

Phone: 608.836.3690 TRUE NORTH

KEY PLAN

Threshold Development Zion Lutheran Site Development

2165 Lindin Ave $\frac{\text{Madison, Wisconsin}}{\text{SHEET TITLE}}$

BASEMENT FLOOR PLAN

SHEET NUMBER

A100 PROJECT NUMBER 2102

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1 BEDROOM UNIT 105 708 SF(NSF) 60 200 <u>T</u> JUNIOR 1 BEDROOM UNIT 106 620 SF(NSF) JUNIOR 1 BEDROOM UNIT 104 619 SF(NSF) 80 SF(NSF) 203 SF(NSF) 99 SF(NSF)

1 FIRST FLOOR PLAN 1/8" = 1'-0"

KEY PLAN ISSUED
Issued for UDC & Land Use - Jan. 10, 2022
Issued for Resubmittal - Feb. 28, 2022
Issued for Final UDC Submittal - Nov. 28, 2022

PROJECT TITLE

Phone: 608.836.3690 TRUE NORTH

Threshold Development Zion Lutheran Site Development

2165 Lindin Ave $\frac{\text{Madison, Wisconsin}}{\text{SHEET TITLE}}$

FIRST FLOOR PLAN

SHEET NUMBER

A101 PROJECT NUMBER 2102

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2 BEDROOM BILEVEL 208 710 SF(NSF) 2 BEDROOM BILEVEL 206 710 SF(NSF) 2 BEDROOM BILEVEL 210 708 SF(NSF) 204 708 SF(NSF) 202 916 SF(NSF) CORRIDOR CORR-2 1017 SF(NSF) 60 600 8-9 T 1 BEDROOM 211 734 SF(NSF) JUNIOR 1 BEDROOM 205 619 SF(NSF) 1 BEDROOM 209 705 SF(NSF) JUNIOR 1 BEDROOM JUNIOR 1 BEDROOM 1 BEDROOM 201 656 SF(NSF) 1 BEDROOM 213 690 SF(NSF)

Phone: 608.836.3690 TRUE NORTH KEY PLAN ISSUED
Issued for UDC & Land Use - Jan. 10, 2022
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PROJECT TITLE

Threshold Development Zion Lutheran Site Development

2165 Lindin Ave $\frac{\text{Madison, Wisconsin}}{\text{SHEET TITLE}}$

SECOND FLOOR PLAN

SHEET NUMBER

A102 PROJECT NUMBER 2102

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1 SECOND FLOOR PLAN 1/8" = 1'-0"

Phone: 608.836.3690 TRUE NORTH

KEY PLAN

PROJECT TITLE

Threshold
Development
Zion Lutheran
Site Development

ISSUED
Issued for UDC & Land Use - Jan. 10, 2022
Issued for Resubmittal - Feb. 28, 2022
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2165 Lindin Ave
Madison, Wisconsin


THIRD FLOOR
PLAN

SHEET NUMBER

A103
PROJECT NUMBER 2102

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1 THIRD FLOOR PLAN
1/8" = 1'-0"

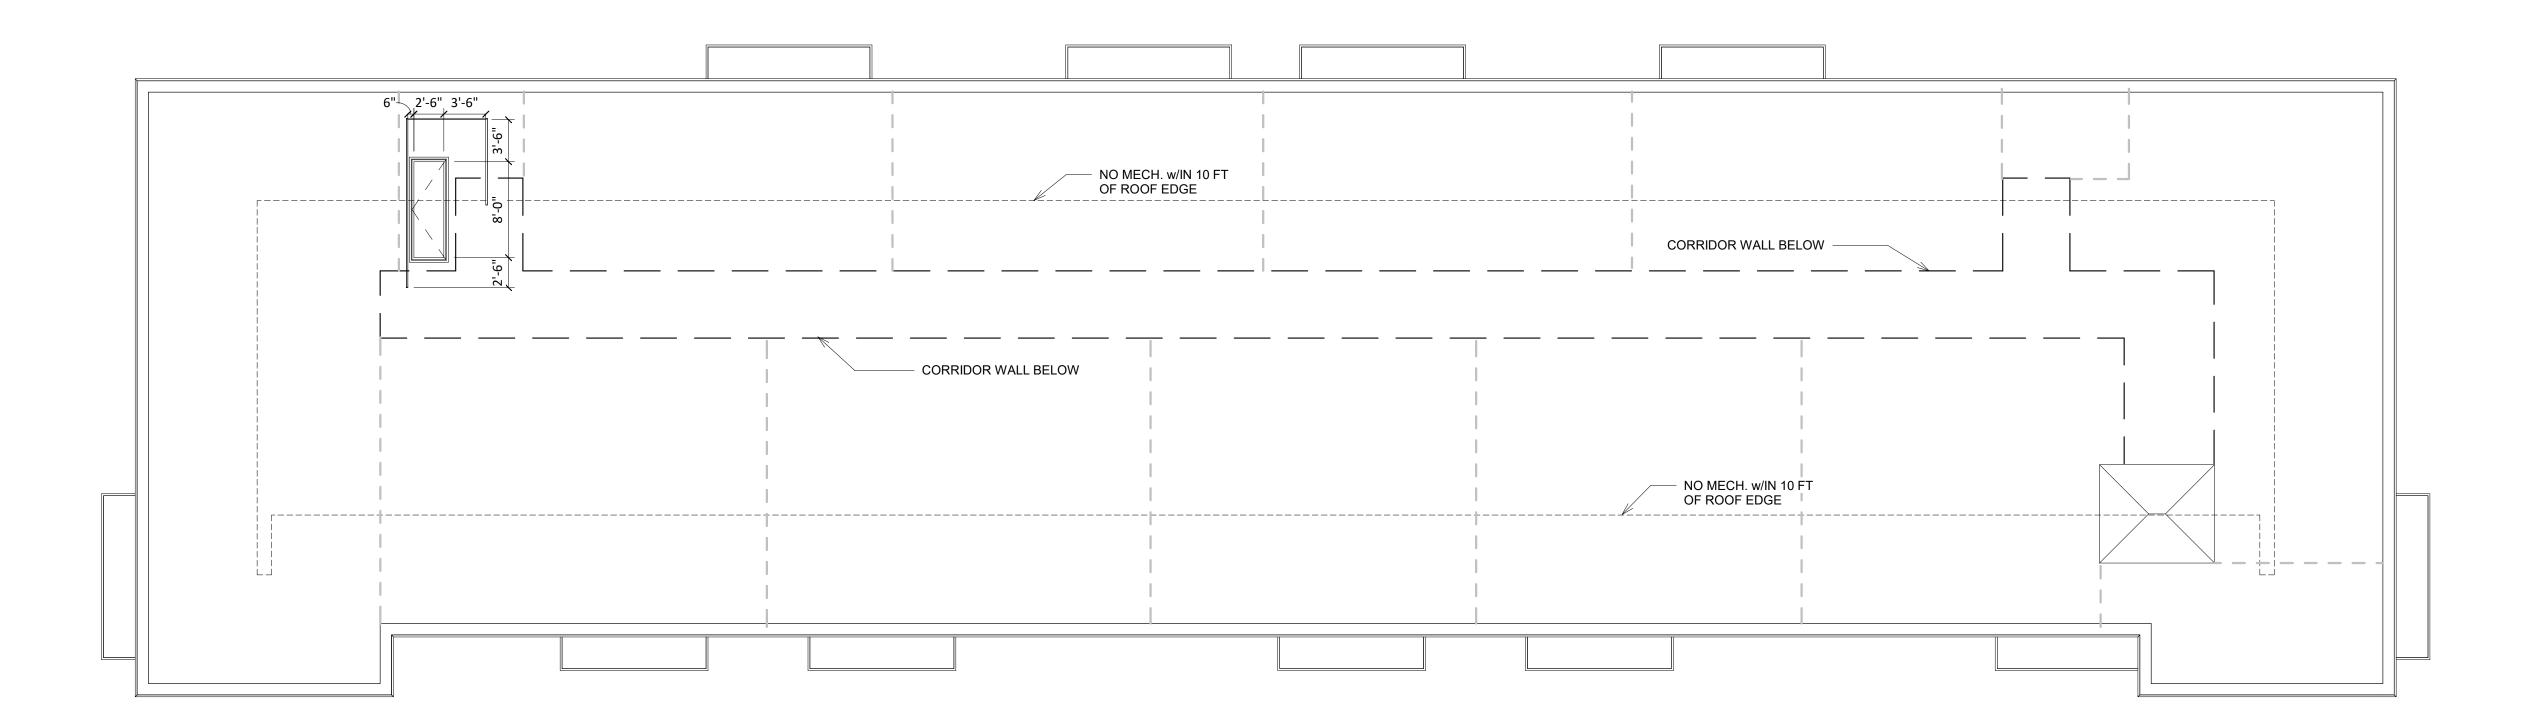

Issued for UDC & Land Use - Jan. 10, 2022 Issued for Resubmittal - Feb. 28, 2022 Issued for Final UDC Submittal - Nov. 28, 2022 Site Development

PROJECT TITLE Threshold Development Zion Lutheran

7601 University Ave. #201

608.836.3690 Middleton, WI 53562

TRUE NORTH

KEY PLAN

2165 Lindin Ave Madison, Wisconsin
SHEET TITLE **ROOF PLAN**

SHEET NUMBER

A104 PROJECT NUMBER 2102 © Knothe & Bruce Architects, LLC

1 ROOF PLAN A104 1/8" = 1'-0"



4 EXTERIOR MATERIAL SCHEDULE **BUILDING ELEMENT** MANUFACTURER COLOR TBD TBD **RESAWN TIMBER** CERRO VERTICAL WOOD SIDING ACCOYA HORIZONTAL WOOD SIDING **RESAWN TIMBER** RAILAY ACCOYA LIGHT MIST JAMES HARDIE COMPOSITE LAP SIDING COMPOSITE LAP SIDING JAMES HARDIE **NIGHT GRAY** ANDERSEN 100 BLACK COMPOSITE WINDOWS N/A BLACK ALUMINUM STOREFRONT N/A TBD INSUL. METAL DOORS & FRAMES N/A BLACK RAILINGS & HANDRAILS

2 ELEVATION - EAST A201 1/8" = 1'-0"



ISSUED

Issued for UDC & Land Use - Jan. 10, 2022 Issued for Resubmittal - Feb. 28, 2022 Issued for Final UDC Submittal - Nov. 28, 2022

PROJECT TITLE Threshold Development Zion Lutheran

Site Development

THIRD FLOOR 122'-3 3/4"

SECOND FLOOR 111'-1 7/8"

FIRST FLOOR 100'-0"

BASEMENT 90'-8"

2165 Lindin Ave Madison, Wisconsin SHEET TITLE

EXTERIOR ELEVATIONS

SHEET NUMBER

A201

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PROJECT NUMBER 2102



EXTERIOR MATERIAL SCHEDULE

MANUFACTURER

TBD RESAWN TIMBER

ACCOYA

RESAWN TIMBER

ACCOYA

JAMES HARDIE

JAMES HARDIE

ANDERSEN 100

N/A

N/A

N/A

COLOR

TBD

CERRO

RAILAY

LIGHT MIST

NIGHT GRAY

BLACK

BLACK

TBD

BLACK

BUILDING ELEMENT

VERTICAL WOOD SIDING

HORIZONTAL WOOD SIDING

COMPOSITE LAP SIDING

COMPOSITE LAP SIDING

COMPOSITE WINDOWS

ALUMINUM STOREFRONT

INSUL. METAL DOORS & FRAMES

RAILINGS & HANDRAILS





ISSUED Issued for UDC & Land Use - Jan. 10, 2022 Issued for Resubmittal - Feb. 28, 2022

PROJECT TITLE Threshold Development Zion Lutheran Site Development

2165 Lindin Ave Madison, Wisconsin SHEET TITLE **EXTERIOR ELEVATIONS**

SHEET NUMBER

A202 PROJECT NUMBER 2102

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1 ELEVATION - NORTH COLOR A203 1/8" = 1'-0"

· .	EXTERIOR MATERIAL SCHEDULE				
MARK	BUILDING ELEMENT	MANUFACTURER		COLOR	
* .		· .			• .
		TBD		TBD	
1	VERTICAL WOOD SIDING	RESAWN TIMBER ACCOYA	***************************************	CERRO	·
2	HORIZONTAL WOOD SIDING	RESAWN TIMBER ACCOYA		RAILAY	
3	COMPOSITE LAP SIDING	JAMES HARDIE		LIGHT MIST	
4	COMPOSITE LAP SIDING	JAMES HARDIE		NIGHT GRAY	
8 .	COMPOSITE WINDOWS	ANDERSEN 100		BLACK	
9	ALUMINUM STOREFRONT	N/A		BLACK	
10	INSUL METAL DOORS & FRAMES	N/A		TBD	
12	RAILINGS & HANDRAILS	N/A	e la facta de	BLACK	



2 ELEVATION - EAST COLOR A203 1/8" = 1'-0"



Issued for UDC & Land Use - Jan. 10, 2022 Issued for Resubmittal - Feb. 28, 2022 Issued for Final UDC Submittal - Nov. 28, 2022

PROJECT TITLE Threshold Development Zion Lutheran Site Development

2165 Lindin Ave Madison, Wisconsin SHEET TITLE **EXTERIOR ELEVATIONS**

SHEET NUMBER

COLOR

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A204 1/8" = 1'-0"

ISSUED

608.836.3690

Middleton, WI 53562

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Threshold
Development
Zion Lutheran
Site Development

2165 Lindin Ave

Madison, Wisconsin

SHEET TITLE

EXTERIOR

EXTERIOR
ELEVATIONS
COLOR

SHEET NUMBER

A204
PROJECT NUMBER 2102

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EXTERIOR MATERIAL SCHEDULE MARK COLOR **BUILDING ELEMENT** MANUFACTURER TBD TBD CERRO VERTICAL WOOD SIDING **RESAWN TIMBER** ACCOYA HORIZONTAL WOOD SIDING **RESAWN TIMBER** RAILAY ACCOYA JAMES HARDIE LIGHT MIST COMPOSITE LAP SIDING JAMES HARDIE **NIGHT GRAY** COMPOSITE LAP SIDING ANDERSEN 100 BLACK COMPOSITE WINDOWS N/A BLACK ALUMINUM STOREFRONT N/A TBD INSUL. METAL DOORS & FRAMES N/A BLACK RAILINGS & HANDRAILS

A204 1/8" = 1'-0"







































VERTICAL WOOD SIDING & TRIM HORIZONTAL WOOD SIDING & TRIM

COMPOSITE LAP SIDING & TRIM



RAILINGS & WINDOWS ALUM. STOREFRONT

EXTERIOR MATERIAL SCHEDULE				
BUILDING ELEMENT	MANUFACTURER	COLOR		
VERTICAL WOOD SIDING	RESAWN TIMBER ACCOYA	CERRO		
HORIZONTAL WOOD SIDING	RESAWN TIMBER ACCOYA	RAILAY		
COMPOSITE LAP SIDING	JAMES HARDIE	LIGHT MIST		
COMPOSITE LAP SIDING	JAMES HARDIE	NIGHT GRAY		
COMPOSITE WINDOWS	ANDERSEN 100	BLACK		
ALUMINUM STOREFRONT	N/A	BLACK		
INSUL. METAL DOORS & FRAMES	N/A	TBD		
RAILINGS & HANDRAILS	N/A	BLACK		

THRESHOLD DEVELOPMENT ZION LUTHERAN

2165 LINDEN AVE MADISON, WI JANUARY 3, 2023 KBA PROJECT 2102