#### **URBAN DESIGN COMMISSION APPLICATION**



City of Madison Planning Division Madison Municipal Building, Suite 017 215 Martin Luther King, Jr. Blvd. P.O. Box 2985 Madison, WI 53701-2985 (608) 266-4635



Complete all sections of this application, including the desired meeting date and the action requested.

If you need an interpreter, translator, materials in alternate formats or other accommodations to access these forms, please call the phone number above immediately.

FOR OFFICE USE ONLY:	
Paid	Receipt #
Date received	
Received by	
Aldermanic District	
Zoning District	
Urban Design District	
73349 Legistar #	

1. Project Information						
Address:						
Title:						
2. Application Type (check all the	ast apply) and Paguastad Date					
		e e				
UDC meeting date requested						
New development	_	r previously-approved development				
Informational	Initial approval	Final approval				
3. Project Type						
Project in an Urban Design	District	Signage				
Project in the Downtown Co		Comprehensive Design Review (CDR)				
, , ,	Mixed-Use Center District (MXC)	Signage Variance (i.e. modification of signage height,				
	ployment Center District (SEC), at (CI), or Employment Campus	area, and setback)				
District (EC)	(o.)) orp.o,our oupus	Signage Exception				
Planned Development (PD)		Other				
General Development	, ,	Please specify				
Specific Implementation	on Plan (SIP)					
Planned Multi-Use Site or R	esidential Building Complex					
4. Applicant, Agent, and Proper	ty Owner Information					
Applicant name		Company				
Street address		City/State/Zip				
Telephone		- :				
Project contact person		Company				
Street address		and the second				
Telephone		Email				
Property owner (if not applica	int)					
Street address		City/State/Zip				
Telephone		Email				
M.\ DI ANNUALC DIVICION\ COMMISCIONIC & COMMITTEES	CALIDRAN DESIGN COMMISSION APPLICATION	ECRRIARY 2020 PAGE 1 OF				

		· ·	
5.	Req	uired Submittal Materials	
	M	Application Form	)
	V	Letter of Intent	Each submittal must include fourteen (14) 11" x 17" collated
		<ul> <li>If the project is within an Urban Design District, a sudevelopment proposal addresses the district criteria is</li> </ul>	immary of now the
		<ul> <li>For signage applications, a summary of how the propost tent with the applicable CDR or Signage Variance review</li> </ul>	sed signage is consis-
	V	<b>Development Plans</b> (Refer to checklist on Page 4 for plan	details) plastic covers or spiral binding.
		Filing fee	)
	V	Electronic Submittal*	
	V/	Notification to the District Alder	
		<ul> <li>Please provide an email to the District Alder notifying to as early in the process as possible and provide a copy of</li> </ul>	them that you are filing this UDC application. Please send this of that email with the submitted application.
	Both sche	the paper copies and electronic copies <u>must</u> be submitted duled for a UDC meeting. Late materials will not be accepted. A	prior to the application deadline before an application will be completed application form is required for each UDC appearance.
		projects also requiring Plan Commission approval, applicants mus ideration prior to obtaining any formal action (initial or final ap	st also have submitted an accepted application for Plan Commission proval) from the UDC. All plans must be legible when reduced.
	com proje not e	piled on a CD or flash drive, or submitted via email to <u>udco</u> ect address, project name, and applicant name. Electronic	uired. Individual PDF files of each item submitted should be applications@cityofmadison.com. The email must include the submittals via file hosting services (such as Dropbox.com) are ls electronically should contact the Planning Division at (608)
6.	App	licant Declarations	
	<ol> <li>2.</li> </ol>	Commission staff. This application was discussed with 10/26/2022	quired to discuss the proposed project with Urban Design h Jessica Vaughn on n this submittal and understands that if any required information
	۷.		will not be placed on an Urban Design Commission agenda for
Na	me o	of applicant Matthew Wachter	Relationship to property Owner, Community Development Authority
		izing signature of property owner	Date 10-27-2012
7.	Арр	lication Filing Fees	
	of th	ne combined application process involving the Urban Desi	ninitial or final approval of a project, unless the project is part gn Commission in conjunction with Plan Commission and/or reasurer. Credit cards may be used for application fees of less
	Plea	se consult the schedule below for the appropriate fee for y	our request:
		Urban Design Districts: \$350 (per §35.24(6) MGO).	A filing fee is not required for the following project
		Minor Alteration in the Downtown Core District (DC) or Urban Mixed-Use District (UMX): \$150 (per §33.24(6)(b) MGO)	applications if part of the combined application process involving both Urban Design Commission and Plan Commission:
		Comprehensive Design Review: \$500 (per §31.041(3)(d)(1)(a) MGO)	<ul> <li>Project in the Downtown Core District (DC), Urban Mixed-Use District (UMX), or Mixed-Use Center District (MXC)</li> </ul>
		Minor Alteration to a Comprehensive Sign Plan: \$100 (per §31.041(3)(d)(1)(c) MGO)	<ul> <li>Project in the Suburban Employment Center District (SEC), Campus Institutional District (CI), or</li> </ul>
	П	All other sign requests to the Urban Design	Employment Campus District (EC)

All other sign requests to the Urban Design Commission, including, but not limited to: appeals

from the decisions of the Zoning Administrator,

requests for signage variances (i.e. modifications of signage height, area, and setback), and additional sign

code approvals: \$300 (per §31.041(3)(d)(2) MGO)

Planned Development (PD): General Development

Plan (GDP) and/or Specific Implementation Plan (SIP)

Planned Multi-Use Site or Residential Building Complex

#### **URBAN DESIGN COMMISSION APPROVAL PROCESS**



#### Introduction

The City of Madison's Urban Design Commission (UDC) has been created to:

- Encourage and promote high quality in the design of new buildings, developments, remodeling, and additions so as to maintain and improve the established standards of property values within the City.
- Foster civic pride in the beauty and nobler assets of the City, and in all other ways possible assure a functionally efficient and visually attractive City in the future.

#### **Types of Approvals**

There are three types of requests considered by the UDC:

- Informational Presentation. Applicants may, at their discretion, request to make an Informational Presentation to the
  UDC prior to seeking any approvals to obtain early feedback and direction before undertaking detailed design. Applicants
  should provide details on the context of the site, design concept, site and building plans, and other relevant information
  to help the UDC understand the proposal and provide feedback. (Does not apply to CDR's or Signage Variance requests)
- <u>Initial Approval</u>. Applicants may, at their discretion, request initial approval of a proposal by presenting preliminary design information. As part of their review, the Commission will provide feedback on the design information that should be addressed at Final Approval stage.
- <u>Final Approval</u>. Applicants may request Final Approval of a proposal by presenting all final project details. Recommendations or concerns expressed by the UDC in the initial approval must be addressed at this time.

#### **Presentations to the Commission**

Primarily, the UDC is interested in the appearance and design quality of projects. Emphasis should be given to the site plan, landscape plan, lighting plan, building elevations, exterior building materials, color scheme, and graphics.

When presenting projects to the UDC, applicants must fill out a registration slip provided in the meeting room and present it to the Secretary. Presentations should generally be limited to 5 minutes or as extended by motion by consent of the Commission. The Commission will withhold questions until the end of the presentation.

Applicants are encouraged to consider the use of various graphic presentation material including a locator map, photographs, renderings/model, scale drawings of the proposal in context with adjacent buildings/uses/signs, etc., as may be deemed appropriate to describe the project and its surroundings. Graphics should be mounted on rigid boards so that they may be easily displayed. Applicants/presenters are responsible for all presentation materials, AV equipment and easels.

#### **URBAN DESIGN DEVELOPMENT PLANS CHECKLIST**



The items listed below are minimal application requirements for the type of approval indicated. Please note that the UDC and/or staff may require additional information in order to have a complete understanding of the project.

1. Informa	tional Presentation					
	Locator Map  Letter of Intent (If the project is within an Urban Design District, a summary of how the development proposal addresses the district criteria is required)  Contextual site information, including photographs and layout of adjacent buildings/structures  Site Plan  Two-dimensional (2D) images of proposed buildings or structures.	Providing additional information beyond these minimums may generate a greater level of feedback from the Commission.	<ol> <li>Requirements for All Plan Sheets</li> <li>Title block</li> <li>Sheet number</li> <li>North arrow</li> <li>Scale, both written and graphic</li> <li>Date</li> <li>Fully dimensioned plans, scaled at 1"= 40' or larger</li> <li>** All plans must be legible, including the full-sized landscape and lighting plans (if required)</li> </ol>			
2. Initial Ap	pproval					
•	Locator Map  Letter of Intent (If the project is within a the development proposal addresses the		ry of <u>how</u>			
X X	<ul> <li>Contextual site information, including photographs and layout of adjacent buildings/ structures</li> <li>Site Plan showing location of existing and proposed buildings, walks, drives, bike</li> </ul>					
×	lanes, bike parking, and existing trees ove Landscape Plan and Plant List ( <i>must be leg</i>	a greater level of feedback from the Commission.				
	Building Elevations in both black & white material callouts)  BD tout and Letter of Intent (if applicable)	-	s (include			
	PD text and Letter of Intent (if applicable)		J			
3. Final Ap	proval					
	Grading Plan Proposed Signage (if applicable) Lighting Plan, including fixture cut sheets Utility/HVAC equipment location and scre PD text and Letter of Intent (if applicable) Samples of the exterior building materials	and photometrics plan ( <i>must be</i> eening details (with a rooftop pla	n if roof-mounted)			
4. Comprel	nensive Design Review (CDR) and Varian	ce Requests ( <u>Signage applicat</u>	ions only)			
_ 	Locator Map  Letter of Intent (a summary of <u>how</u> the proportion of the proportion of the proportion of the properties of the project site	notographs of existing signage b	oth on site and within proximity to the			
	Site Plan showing the location of existing s driveways, and right-of-ways Proposed signage graphics (fully dimension					

☐ Perspective renderings (emphasis on pedestrian/automobile scale viewsheds)

☐ Graphic of the proposed signage as it relates to what the Ch. 31, MGO would permit

☐ Illustration of the proposed signage that meets Ch. 31, MGO compared to what is being requested.



To: Jessica Vaughn

Secretary of the Urban Design Commission
Department of Planning & Community & Economic Development
Planning Division
Madison Municipal Building, Suite LL-100
215 Martin Luther King, Jr. Blvd.
Madison, Wisconsin 53701-2985

Date: October 31, 2022

### Re: Urban Design Commission Letter of Intent for the CDA Village on Park – Parking Structure & Site Improvements

This project is to propose a parking structure and site improvements for The Village on Park development for the Community Development Authority. We are formally submitting our Development Plans in our Land Use Application and for Intitial and Final Approval by the Urban Design Commision. The project site is located at 2300 South Park Street in Madison, Wisconsin.

The design includes the following: A 6.5 level parking structure with 295 parking stalls for the Village on Park tenants with a modified central parking area. Site improvements include the transformation of an existing drive into a vibrant community greenspace.

#### ARCHITECTURAL DESIGN

In response to the input received from the Urban Design Commission Informational presentation on September 21, 2022, we have incorporated more color into the proposed design. The architectural design expression of the Northeast stair and elevator tower reflects that of the existing Village on Park building, utilizing the same palette of materials and colors: Brick, clear anodized aluminum storefront, blue metal panel accents, grey structural steel canopies and buff colored split face concrete block that matches the color of the EIFS on the existing building. A brick knee wall extends around the base of the parking structure creating a plinth that reflects the brick piers on the existing building. Vertical 12' wide perforated aluminum screen panels accented with a terracotta/copper colored trim frame rhythmically punctuate each column bay of the east and south facades.

Public art installations add interest and color to the southeast corner of the building and the interior of the glazed northeast stair tower. A blue blade sign on the south façade accentuates the south façade and compositionally resolves the step in the massing of the building at this location.

The southwest corner of the structure is anchored by a stair tower clad in split face concrete block and clear anodized aluminum storefront glazing and accented by horizontal bands of exposed cast in place concrete floor structure. Per the Urban Design Commission's recommendation, all floors of the West façade up to the roof are now screened by horizontal perforated aluminum screen panels to mitigate the effects of car headlights on the neighboring houses to the west.



#### SITE AND LANDSCAPE DESIGN

The site is intended to be revitalized with a vibrant Village Green plaza east of the Villager Mall, in addition to extensive foundation plantings south and east of the 6-story parking structure. The Village Green will link pedestrians north and south between uses, while visually and physically drawing users into the development from Park Street. The Village Green program elements were carefully selected to "energize" the space. Colored concrete walkways, dynamic seat elements, lighting and extensive softscape plantings will brighten the space for its users. A 24' wide pedestrian crossing aligns with the Villager Mall atrium and will be made safe by colored, sandblasted concrete, security bollards, signage and pavement jointing. Additionally, plantings that provide seasonal color and interest in this urban microclimate have been selected. The Village Green and parking structure foundation plantings will not receive irrigation and is assumed to be heavily salted; therefore, xeriscape plantings are proposed. Extensive underground stormwater management improvements will be added to meet the City's "redevelopment" standards. The system will function independent of the underground infrastructure installed at the Urban League and Parking Lot Build Back projects. Due to budgetary concerns and construction market, the previously proposed pergolas have been removed from the project, but replaced with numerous trees to offer seasonal shade over the space.

#### CONFORMANCE TO URBAN DESIGN DISTRICT No. 7 CRITERIA

- The proposed design contributes to the goal of improving the appearance and function of Park Street. The process of engaging the neighborhood and community in the creation of the public art on this project is helping Park Street to evolve as a distinctive place that builds on the strengths of its culturally diverse businesses and neighborhoods.
- The building setback is 10', in conformance with the District's setback requirement of one (1) to ten (10) feet from the front property line.
- This project is an addition to the existing Village on Park building that helps bring the building closer to the street and minimizes any "gap" in the street wall.
- All visible sides of the building have been designed with details that complement the front facade.
   Side facades that are visible from the primary street has received complementary design attention.
- Entrance canopies and landscaping at the street level create a more comfortable pedestrian scale and character.
- Mechanical/electrical equipment and dumpsters are screened with screen enclosures and/or landscaping.
- Variation to the building face design is achieved with the incorporation of vertical 12' wide perforated aluminum screen panels accented with a terracotta/copper colored trim frame rhythmically punctuate each column bay of the east and south facades.
- The facades are designed to create a visual distinction between the upper and lower floors of the building, by being composed to create a "base, shaft and capital".
- Roofs are flat, not sloped.
- A positive visual termination at the top of the building should be provided with a cast in place concrete
  parapet around the entire top floor and metal roof fascias at the top of the stair towers that match the
  tower elements on the existing Village on Park Building.
- The parking structure addition complements the character of the adjoining existing Village on Park building in terms of architectural design expression, material and color.
- The building entrance at the base of the NE Stair Tower is designed as the focal point of the front facade.



• The exterior materials: Brick, metal, glass and split face concrete block are durable, high-quality materials and appropriate for external use.

#### **BUILDING HEIGHT**

This project is 6 stories and 64' high. While the height of the building is well within the zoning code's height limit of 78', the zoning code requires conditional approval for any building above 5 stories.

The Planning Division's September 21, 2022 Staff Report for the Urban Design Commission states: "Based on the submitted height information, it appears that at the building's tallest point, the structure would be approximately 60 feet in height, which is less than the maximum height in feet for a five story building (78 feet) per the Zoning Code. Staff believes that the height could be found to conform to the underlying UDD standards, and could be found consistent with the guidelines that allow up to six-story buildings. Staff further notes that the advisory guideline requiring a third floor stepback has not been required on other projects, including the adjacent "Hub" office building."

We wish to request that the structure as designed be approved, because the building, being a parking structure, has floor-to-floor heights of 9' which is significantly less than the typical floor-to-floor of 14' for a commercial building. The project team made the decision to utilize a cast in place flat plate structure in lieu of a precast double tee or 60' span post tensioned structure so that we could reduce the floor-to-floor heights by 2', thereby significantly lowering the overall height of the building (5 floors @ 2' each = 10' reduction).

Hence, because of the small floor-to-floor heights of the building, we believe that the building as designed (64' high, 6 stories @ 9' floor-to-floor) meets the intent of the zoning code's heigh requirements.

Thank you in advance for your time.

Pear BH Tan

Sincerely,

Strang, Inc.

Peter Tan, AIA Design Architect



# COMMUNITY DEVELOPMENT AUTHORITY OF THE CITY OF MADISON

2300 SOUTH PARK STREET, MADISON WI 53713

PROJECT DESCRIPTION: NEW PARKING GARAGE FOR THE VILLAGE ON PARK STREET

CITY CONTRACT NUMBER XXXX / MUNIS NUMBER XXXX


**UDC SUBMITTAL 10-31-2022** 









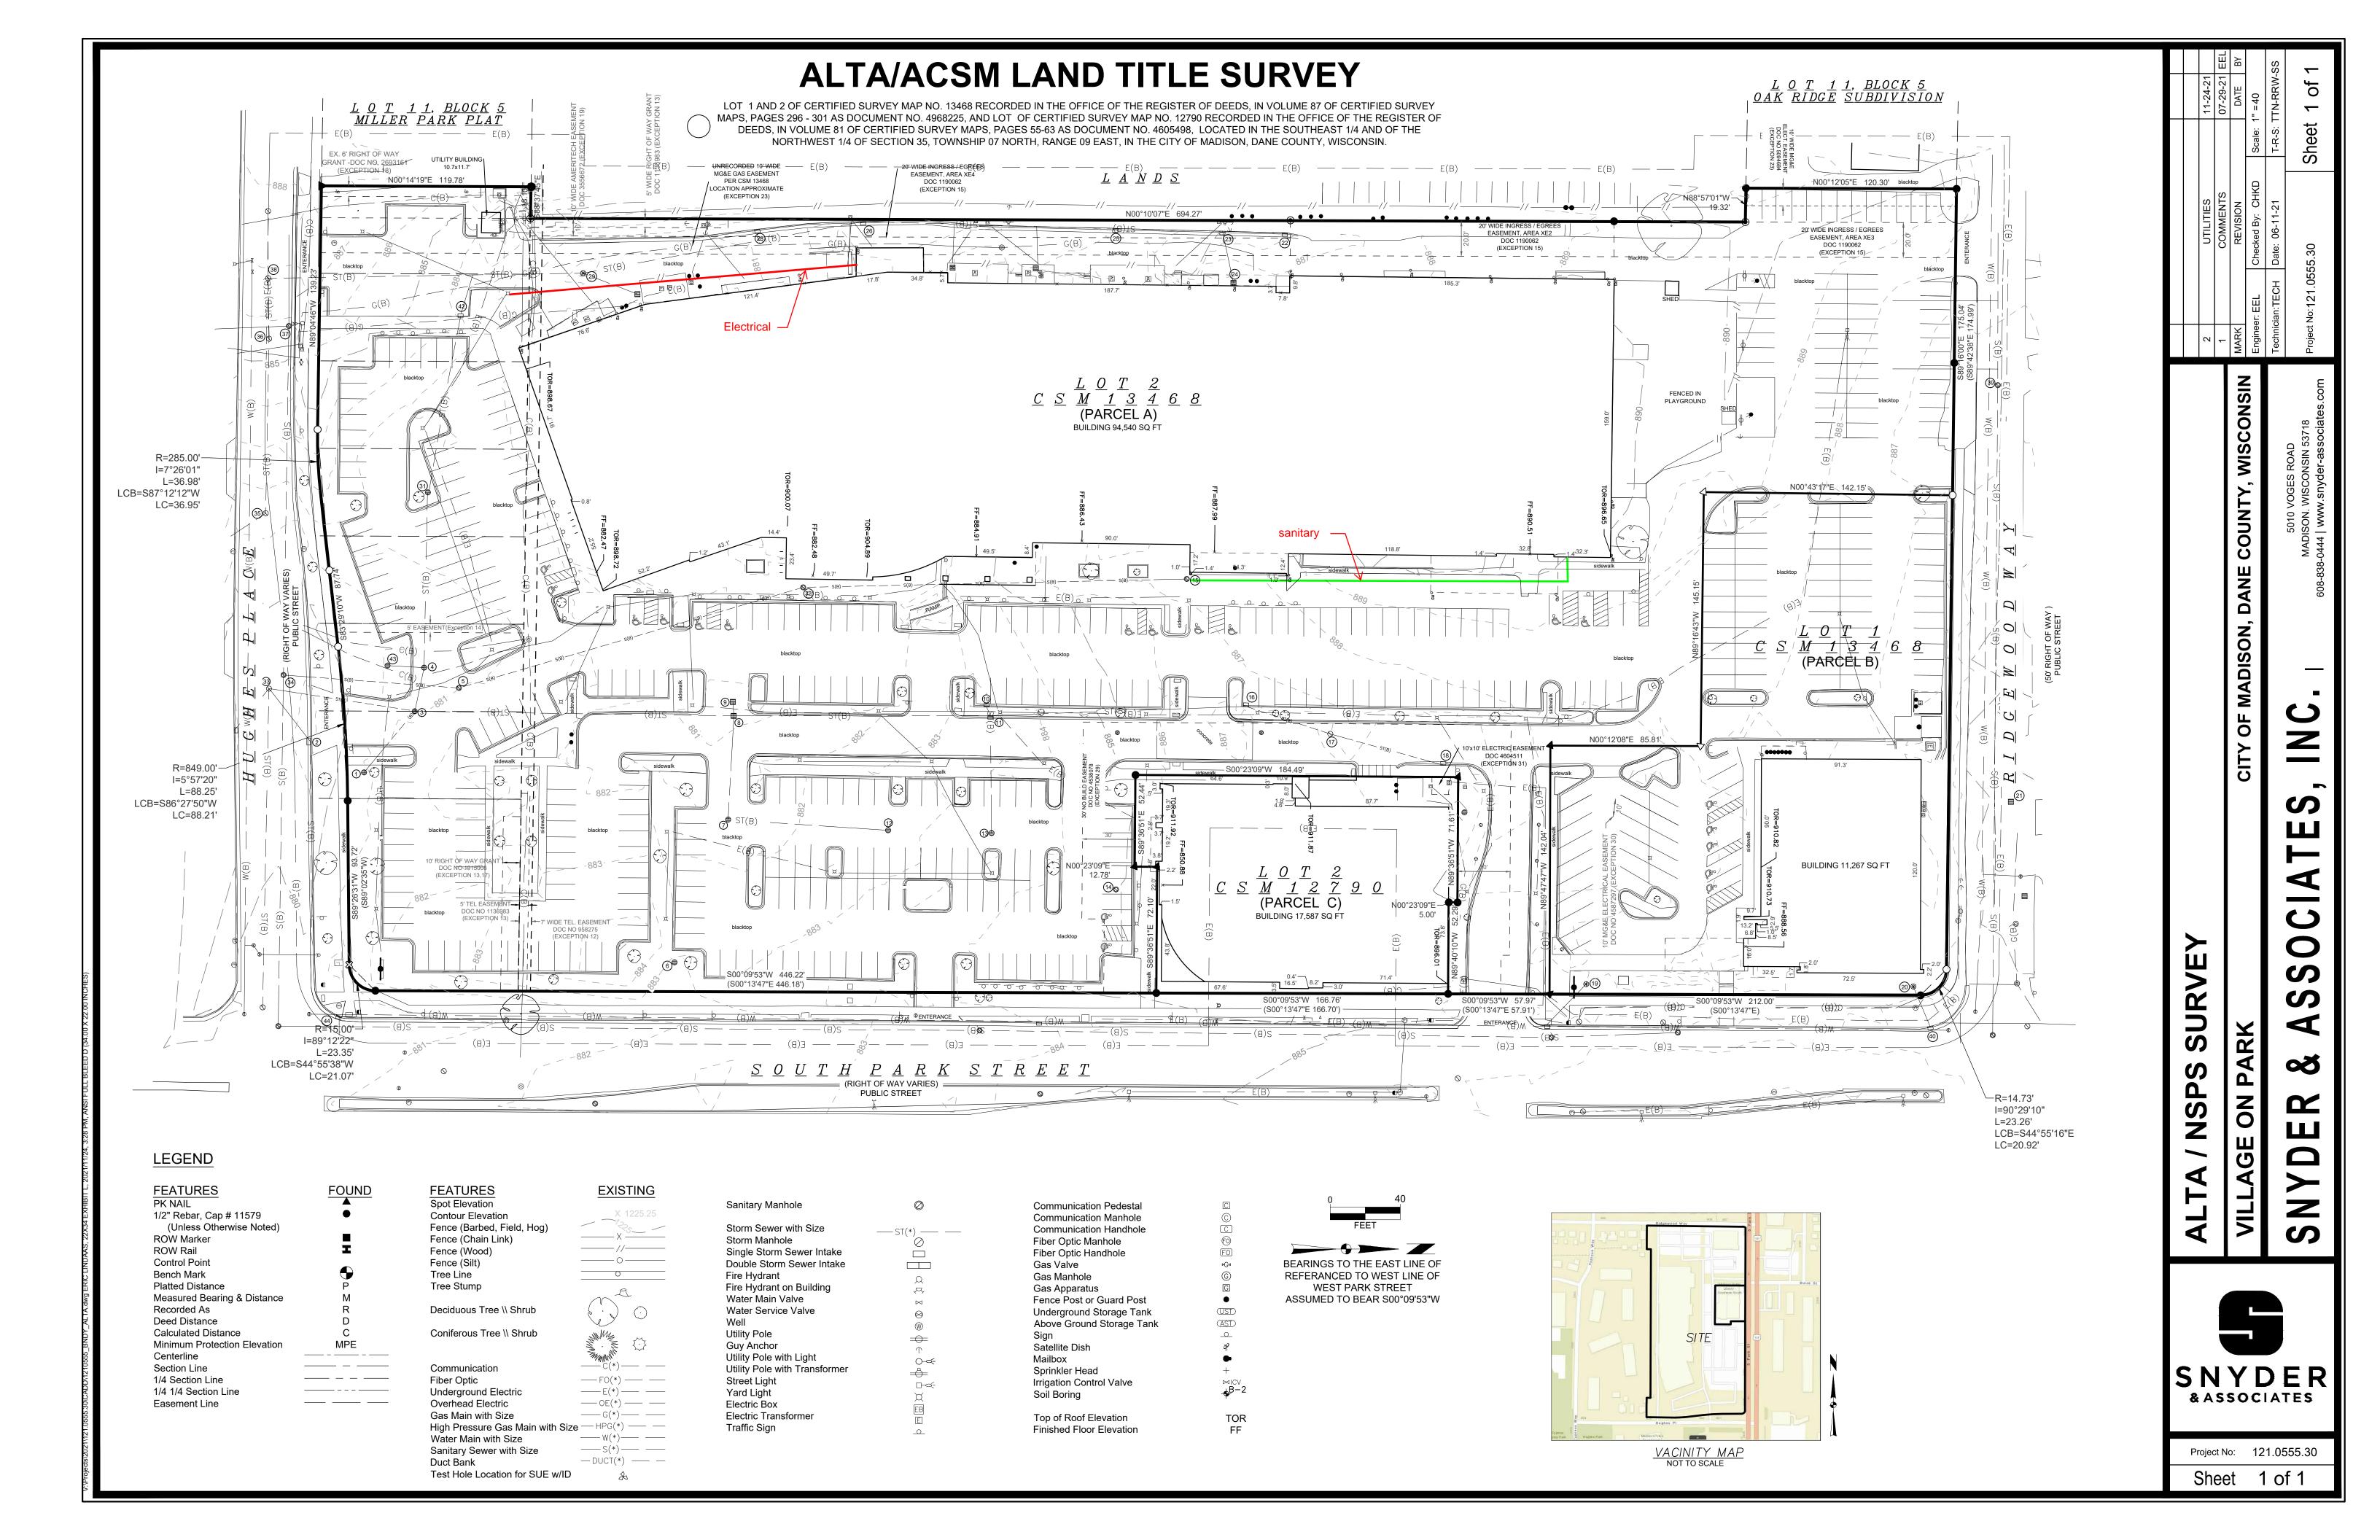

# **ALTA/ACSM LAND TITLE SURVEY**

LOT 1 AND 2 OF CERTIFIED SURVEY MAP NO. 13468 RECORDED IN THE OFFICE OF THE REGISTER OF DEEDS, IN VOLUME 87 OF CERTIFIED SURVEY MAPS, PAGES 296 - 301 AS DOCUMENT NO. 4968225, AND LOT OF CERTIFIED SURVEY MAP NO. 12790 RECORDED IN THE OFFICE OF THE REGISTER OF DEEDS, IN VOLUME 81 OF CERTIFIED SURVEY MAPS, PAGES 55-63 AS DOCUMENT NO. 4605498. LOCATED IN THE SOUTHEAST 1/4 AND OF THE NORTHWEST 1/4 OF SECTION 35, TOWNSHIP 07 NORTH, RANGE 09 EAST, IN THE CITY OF MADISON, DANE COUNTY, WISCONSIN

#### SURVEYOR CERTIFICATION

To: The City of Madison, its successors and assigns First American Title Insurance Company:

This is to certify that this map or plat and the survey on which it is based were made in accordance with the 2021 Minimum Standard Detail Requirements for ALTA/NSPS Land Title Surveys, jointly established and adopted by ALTA and NSPS, and includes Item 1, 2, 4, 7(a), 7(b)(1), 7(c) 8, and 11, of Table A thereof. The field work was completed on June 29th, 2021.

Snyder & Associates, Inc. 5010 Voges Road

LINDAAS Madison, WI 53718 S-2919 608-838-0444 McFARLAND elindaas@snyder-associates.com WI

#### TITLE INFORMATION:

LEGAL DESCRIPTION AS DESCRIBED IN COMMITMENT NO.: NCS-1071790-MAD, COMMITMENT DATE: JUNE 10. 2021 @ 7:30 AM. ISSUED BY FIRST AMERICAN TITLE INSURANCE COMPANY:

#### PARCEL A:

LOT TWO (2) OF CERTIFIED SURVEY MAP NO. 13468 RECORDED IN THE OFFICE OF THE REGISTER OF DEEDS FOR DANE COUNTY, WISCONSIN ON MARCH 08, 2013, IN VOLUME 87 OF CERTIFIED SURVEY MAPS, PAGES 296 - 301 AS DOCUMENT NO. 4968225, BEING ALL OF LOT 1, CERTIFIED SURVEY MAP NO. 12790, LOCATED IN THE SOUTHEAST 1/4 AND NORTHEAST 1/4 OF THE NORTHWEST 1/4 OF SECTION 35, TOWNSHIP 07 NORTH, RANGE 09 EAST, IN THE CITY OF MADISON, DANE COUNTY, WISCONSIN.

FOR INFORMATIONAL PURPOSES ONLY: PROPERTY ADDRESS: 2300 SOUTH PARK STREET, MADISON WI 53713 TAX PARCEL NO. 251/0709-352-0406-9

#### PARCEL B:

LOT ONE (1) OF CERTIFIED SURVEY MAP NO. 13468 RECORDED IN THE OFFICE OF THE REGISTER OF DEEDS FOR DANE COUNTY, WISCONSIN ON MARCH 08, 2013, IN VOLUME 87 OF CERTIFIED SURVEY MAPS, PAGES 296 - 301 AS DOCUMENT NO. 4968225, BEING ALL OF LOT 1, CERTIFIED SURVEY MAP NO. 12790, LOCATED IN THE SOUTHEAST 1/4 AND NORTHEAST 1/4 OF THE NORTHWEST 1/4 OF SECTION 35, TOWNSHIP 07 NORTH, RANGE 09 EAST, IN THE CITY OF MADISON, DANE COUNTY, WISCONSIN.

#### FOR INFORMATIONAL PURPOSES ONLY: PROPERTY ADDRESS: 2202 SOUTH PARK STREET, MADISON WI 53713 TAX PARCEL NO. 251/0709-352-0408-5

#### PARCEL C:

UNIT ONE (1), TOGETHER WITH SAID UNIT'S UNDIVIDED INTEREST IN THE COMMON ELEMENTS AND THE EXCLUSIVE USE OF THE LIMITED COMMON ELEMENTS APPURTENANT TO SAID UNIT, ALL IN SOUTH MADISON COMMUNITY CONDOMINIUM, A CONDOMINIUM DECLARED AND EXISTING UNDER AND BY VIRTUE OF THE CONDOMINIUM OWNERSHIP ACT OF THE STATE OF WISCONSIN, BY A DECLARATION RECORDED IN THE OFFICE OF THE REGISTER OF DEEDS FOR DANE COUNTY, WISCONSIN, ON MARCH 05, 2010, AS DOCUMENT NO. 4639192; SAID CONDOMINIUM BEING LOCATED IN THE CITY OF MADISON, COUNTY OF DANE, STATE OF WISCONSIN.

#### FOR INFORMATIONAL PURPOSES ONLY:

PROPERTY ADDRESS: 2222 SOUTH PARK STREET, MADISON WI 53713 TAX PARCEL NOS. 251/0709-352-1201-2 AND 251/0709-352-0407-7 (NOTATION PARCEL)

## TABLE A:

- 2. ADDRESS OF SURVEYED PROPERTY: 2202, 2206, 2210, 2222, 2226, 2230, 2234, 2238, 2300, 2302, 2304, 2306, 2308, 2312, 2328 South Park Street, Madison, WI 53713
- 4. GROSS LAND AREA PARCEL A (LOT 2 CSM 13468)- 338,051 SQUARE FEET (7.76 ACRES) PARCEL B (LOT 1 CSM 13468)- 52,827 SQUARE FEET (1.21 ACRES) PARCEL C (LOT 2 CSM 12790)- 21,736 SQUARE FEET (0.50 ACRES) TOTAL 412,614 SQUARE FEET (9.47 ACRES)

#### 7(a), (b)1, (c). BUILDING DIMENSIONS: As labeled on Survey

- 8. SUBSTANTIAL FEATURES OBSERVED: As mapped on survey.
- 11. <u>UTILITIES:</u>

Utilities shown hereon marked from a Diggers Hotline Ticket Nos. 20212209288, 20212209319, 20212209400, 212122209416, 20212209442, 20212209459 Dated 05-28-2021. (Surveyors note- Utilities shown hereon we surveyed by the above described field markings and prints, and maps provided by the City of Madison.)

#### TITLE EXCEPTIONS:

The policy to be issued will contain exceptions to the following matters unless the same are disposed of to the satisfaction of the Company as described in title commitment file no.: NCS-1071790, Commitment Date: June 10, 2021 @ 7:30 AM, issued by First American Title Insurance Company:

Exceptions 1-11, 20-22, 34, 38-39, 42-61 do not apply to this survey or are not plottable.

- 12. Easement granted to Wisconsin Telephone Company and conditions as set forth in instrument recorded May 23, 1958 in Volume 319 of Misc., Page 138 as Document Number 958275. (As shown of map)
- 13. Utility Easement to Wisconsin Telephone Company, dated June 25, 1965, recorded/filed July 22, 1965 in Volume 429 of Misc., Page 553 as Document No. 1136983. (As shown on map)

Conveyance of Rights in Land by Madison Gas and Electric Company, a Wisconsin corporation recorded on April 21,

- 14. Easement granted to Wisconsin Telephone Company and conditions as set forth in instrument recorded July 22, 1965 in Volume 429 of Misc., Page 555 as Document Number 1136984. (As shown on map)
- 15. Non-exclusive easements for ingress and egress and use of North Wall and South Wall as set forth in Warranty Deed recorded July 19, 1967 in Volume 468 of Misc., Page 201 as Document Number 1190062, subject to Declaration of Release of Existing Cross Access Easement recorded November 7, 2008 as Document Number 4480413.
- 16. Easement granted to the City of Madison and conditions as set forth in instrument recorded September 14, 1982 in Volume 3846, Records Page 13 as Document Number 1751859. (Not located in this survey, easement located in South Park Street right of way)
- 17. Right of Way Grant to Madison Gas and Electric Company and conditions as set forth in instrument recorded December 26, 1985 in Volume 7629 of Records, Page 32 as Document Number 1915008. (As shown on map)

Conveyance of Rights in Land by Madison Gas and Electric Company, a Wisconsin corporation recorded on April 21, 2011 as Document No. 4759165.

Partial Release of Easement recorded November 18, 2010 as Document No. 4716000.

- 18. Right of Way Grant recorded August 3, 1995 in Volume 30446, Records Page 53 as Document Number 2693161.
- 19. Easement granted to Ameritech General and conditions as set forth in instrument recorded September 30, 2002 as Document Number 3556672. (As shown on map)
- 23. Unrecorded easements of 5 feet and 10 feet wide to MG&E as shown on Exhibit "B" of Declaration of Release of Existing Cross Access Easement recorded November 07, 2008 in the Office of the Register of Deeds for Dane County, Wisconsin as Document No. 4480413 and on Certified Survey Map No. 13468 and Certified Survey Map No. 12790. (As shown on map. Location approximate, location not defined on CSM. (Affects Parcels A and B)

Partial Release as set forth on Grant of Underground Electric Line Easements and Release of Underground Electric and Partial Release of Overhead Electric Line and Pole Easement recorded August 28, 2014 as Document No. 5094684.

24. Notes as disclosed by Certified Survey Map No. 12600, recorded on December 18, 2008 as Document No. 4487383; as corrected by Affidavit of Correction recorded on January 09, 2009 as Document No. 4492149. (Affidavit of Correction does not affect this survey)

(Affects Parcels A and C)

- 25. Declaration of Conditions and Covenants for the Certified Survey Map No. 12600 recorded January 12, 2009 as Document No. 4492666. (Declaration affects surveyed property but is not a survey matter) (Affects Parcels A. B and C)
- 26. Declaration of Conditions and Covenants for the Certified Survey Map No. 12600 recorded January 12, 2009 as Document No. 4492669. (Declaration affects surveyed property but is not a survey matter)

(Affects Parcels A, B and C)

27. Declaration of Conditions, Covenants and Restrictions for Maintenance of Stormwater Management Measures recorded March 26, 2009 as Document No. 4523135. (Affects surveyed property, not plottable refer to document)

(Affects Parcels A and C)

Partial Release of Declaration recorded March 11, 2013 as Document No. 4968443. (Affects Parcel B)

28. Terms, conditions, restrictions and provisions relating to the use and maintenance of the Operation and Easement Agreement recorded on April 01, 2009, as Document No. 4525865. (Affects Parcels, is not plottable)

(Affects Parcels A, B and C)

- Modification and/or amendment by instrument: First Amendment to Operation and Easement Agreement Recording Information: March 11, 2013 as Document No. 4968445
- 29. Declaration Establishing a No-Build Easement Area recorded on April 28, 2009 as Document No. 4538078.

(Affects Parcels A and C)

- Modification and/or amendment by instrument: First Amendment to Declaration Establishing a No- Build Recording Information: November 08, 2012 as Document No. 4931073
- 30. Underground Electric Easement granted to Madison Gas and Electric Company and conditions as set forth in instrument recorded August 19, 2009 as Document Number 4587297; as corrected by Affidavit of Correction recorded September 2, 2009 as Document Number 4591782. (As shown on map)
- 31. Utility Easement to Madison Gas and Electric Company, a Wisconsin corporation, dated May 04, 2009, recorded/filed October 21, 2009 as Document No. 4604511. (As shown on map)

(Affects Parcel C)

32. Notes as disclosed by Certified Survey Map No. 12790 recorded October 26, 2009 in Volume 81 of Certified Survey Maps. Page 55 as Document No. 4605498 as corrected by Affidavit of Correction recorded December 30, 2009 as Document No. 4623128. (Affects surveyed property, not plottable refer to document)

(Affects Parcels A and C)

(Affects surveyed property, not plottable refer to document)

- 33. Covenants. conditions, restrictions, easements, limitations, reservations, terms, lien rights, provisions and charges, including, but not limited to, the use of, and the rights of others in and to the use of the limited common elements, contained in Declaration of Condominium of South Madison Community Condominium, recorded March 05, 2010, as Document No. 4639192, and any and all subsequent amendments thereto.
  - Statutory Reserve Account Statement South Madison Community Condominium recorded March 11, 2010 as

(Affects Parcel C)

35. Notes as disclosed by Certified Survey Map No. 13468 recorded on March 08, 2013 in Volume 87 of Certified Survey Maps, Page 296 as Document No. 4968225. (Not plottable refer to document)

(Affects Parcels A and B)

36. Terms, conditions, restrictions and provisions relating to the use and maintenance of the Perpetual Subsurface Parking Easement Agreement recorded on March 11, 2013, as Document No. 4968446.

(Affects Parcels A and B)

37. Declaration of Conditions and Covenants for Certified Survey Map No. 13468 recorded March 11, 2013 as Document

(Affects Parcel B)

40. Declaration of Conditions, Covenants and Restrictions for Maintenance of Stormwater Management Measures recorded November 12, 2013 as Document No. 5037380.

41. Utility Easement to Madison Gas and Electric Company, a Wisconsin corporation, dated August 25, 2014, recorded/filed August 28, 2014 as Document No. 5094684.

				ORM SEWER			
No	Туре	RIM ELEV	IE	IE	IE	IE	Notes
1	Inlet	880.70	NW=876.60' 6" HDPE	E=876.57' 6" HDPE			
2	Rectangular Inlet	878.69	W=876.72' 8" PVC	E=876.72' 8" PVC	S=876.28' 12" RCP		
3	Inlet	880.82	W=875.24' HDPE	N=875.18' RCP	SE=875.58' HDPE	S=875.39' RCP	
4	Inlet	880.62	Could not measure.				
6	Inlet	882.70	Could not measure.				
7	Inlet	881.03	N=877.77 12"RCP	W= 877.47 12"RCP	BOT. MH =874.21		
8	Rectangular Inlet	880.81	S=876.52' RCP	W=877.61' 8" PVC	N=876.50' RCP	E=876.37' 12" RCP	
9	Rectangular Inlet	880.64	Could not measure.	0 7 7 0	KOF	12 RCF	
100	Curb Inlet		NE=878.94' 6" PVC				
10	Curb Inlet		S=877.30' 18" RCP	NW= Could not measure. 6" PVC	N= Could not measure. 8" PVC	E= Could not measure. RCP	
12	Inlet	882.32	SW=879.02' RCP				
13	Inlet	883.21	W=878.79' to flange invert. 12" RCP with 16" Flange				
16	Curb Inlet	886.97	N= 880.57' 8" PVC	S= 880.77' 8" PVC			
17	Stand Pipe	885.90	Center= 1" 8" PVC	1 70			Below manhole grate is a vertically orient PVC pipe centered in structure.
18	Curb Inlet		Could not measure.				
19	Beehive	886.94	SE= 884.89' 8" HDPE				
20	Beehive	886.98	NW= 885.23' 6" HDPE	NE= 884.03' 12" PVC	SW= 884.38' 8" PVC		
2	???Culvert???	884.26	Could not measure.				
22	Curb Inlet		S= 882.09' 15" HDPE			Part 1	
23	Curb Inlet		N= 880.86' 15" HDPE	S= 880.82' 15" HDPE	E= 880.86' 14" RCP		
29	Rectangular Inlet	885.77	W= 882.30' 12" PVC				
23	Curb Inlet	entre entre como de entre como entre entre como esta entre e	N= 879.95' 15" HDPE	S= 879.38' 24" HDPE			
29	Curb Inlet		N= 875.38' 24" HDPE	S= 874.97' 30" HDPE			
<b>29</b>	Curb Inlet		E= 876.03' 12" PVC	TIDIC			
29	Inlet	880.64	Center= 873.78'	N= Could not	S= Could not		
39	Inlet	881.23	NW= 876.23' 18" HDPE	measure. E= 876.16' 18" HDPE	measure. SW= 876.34' 6" HDPE		
33	Manhole	879.40	Center= 875.24'	N= 875.48'	E= 875.28', 30" RCP		Field verify, pipes are recessed in manho
35)	Manhole	881.40	Center= 873.98'	W= Could not measure. 42" RCP	W= Could not measure. 42" RCP	S= Could not measure.	
36	Manhole	885.62	Center= 871.41'	W= Could not measure 42" RCP	E= Could not measure. 42" RCP		
38	Manhole	886.90	Center= 873.35'	NW= Could not measure. 36"	W= Could not measure. 24"	E= Could not measure. 42" RCP	
40	Curb Inlet	885.70	SW= 882.95' 12" HDPE	E= 882.90' 15" RCP		1.01	Concrete buildup in bottom of structure
42	Curb Inlet	884.04	NE=876.89' 6" HDPE	SE=876.56' 15" HDPE			
43	Inlet	879.83	S=876.10' 6" HPDE	N=876.14' 15"			
44)	Curb Inlet	880.67	E=877.84' 12" RCP	HDPE			

			SANITARY	SEWER			
No	Туре	RIM ELEV	IE	IE	IE	IE	Notes
5	Manhole	881.10	N=871.68'	S=871.57'			
14)	Manhole		Could not measure.			· ·	Could not remove lid.
15)	Manhole	886.83	S=873.25'	N= could not measure, pipe plugged	NW= could not measure.		
32	Manhole	882.38	Center= 872.83'	S=872.53'	N=872.44'		,
34)	Manhole	879.30	N=871.46'	E=871.16' 8" VP	W=871.24' 8" VP		
37	Manhole	885.93	Center=876.44'	E= 876.4 8" Clay	W= 876.40 8" Clay		
39	Manhole	886.52	Center=877.32'	E= Could not measure.	W= Could not measure.		

COUNTY, WISCONSIN

DANE


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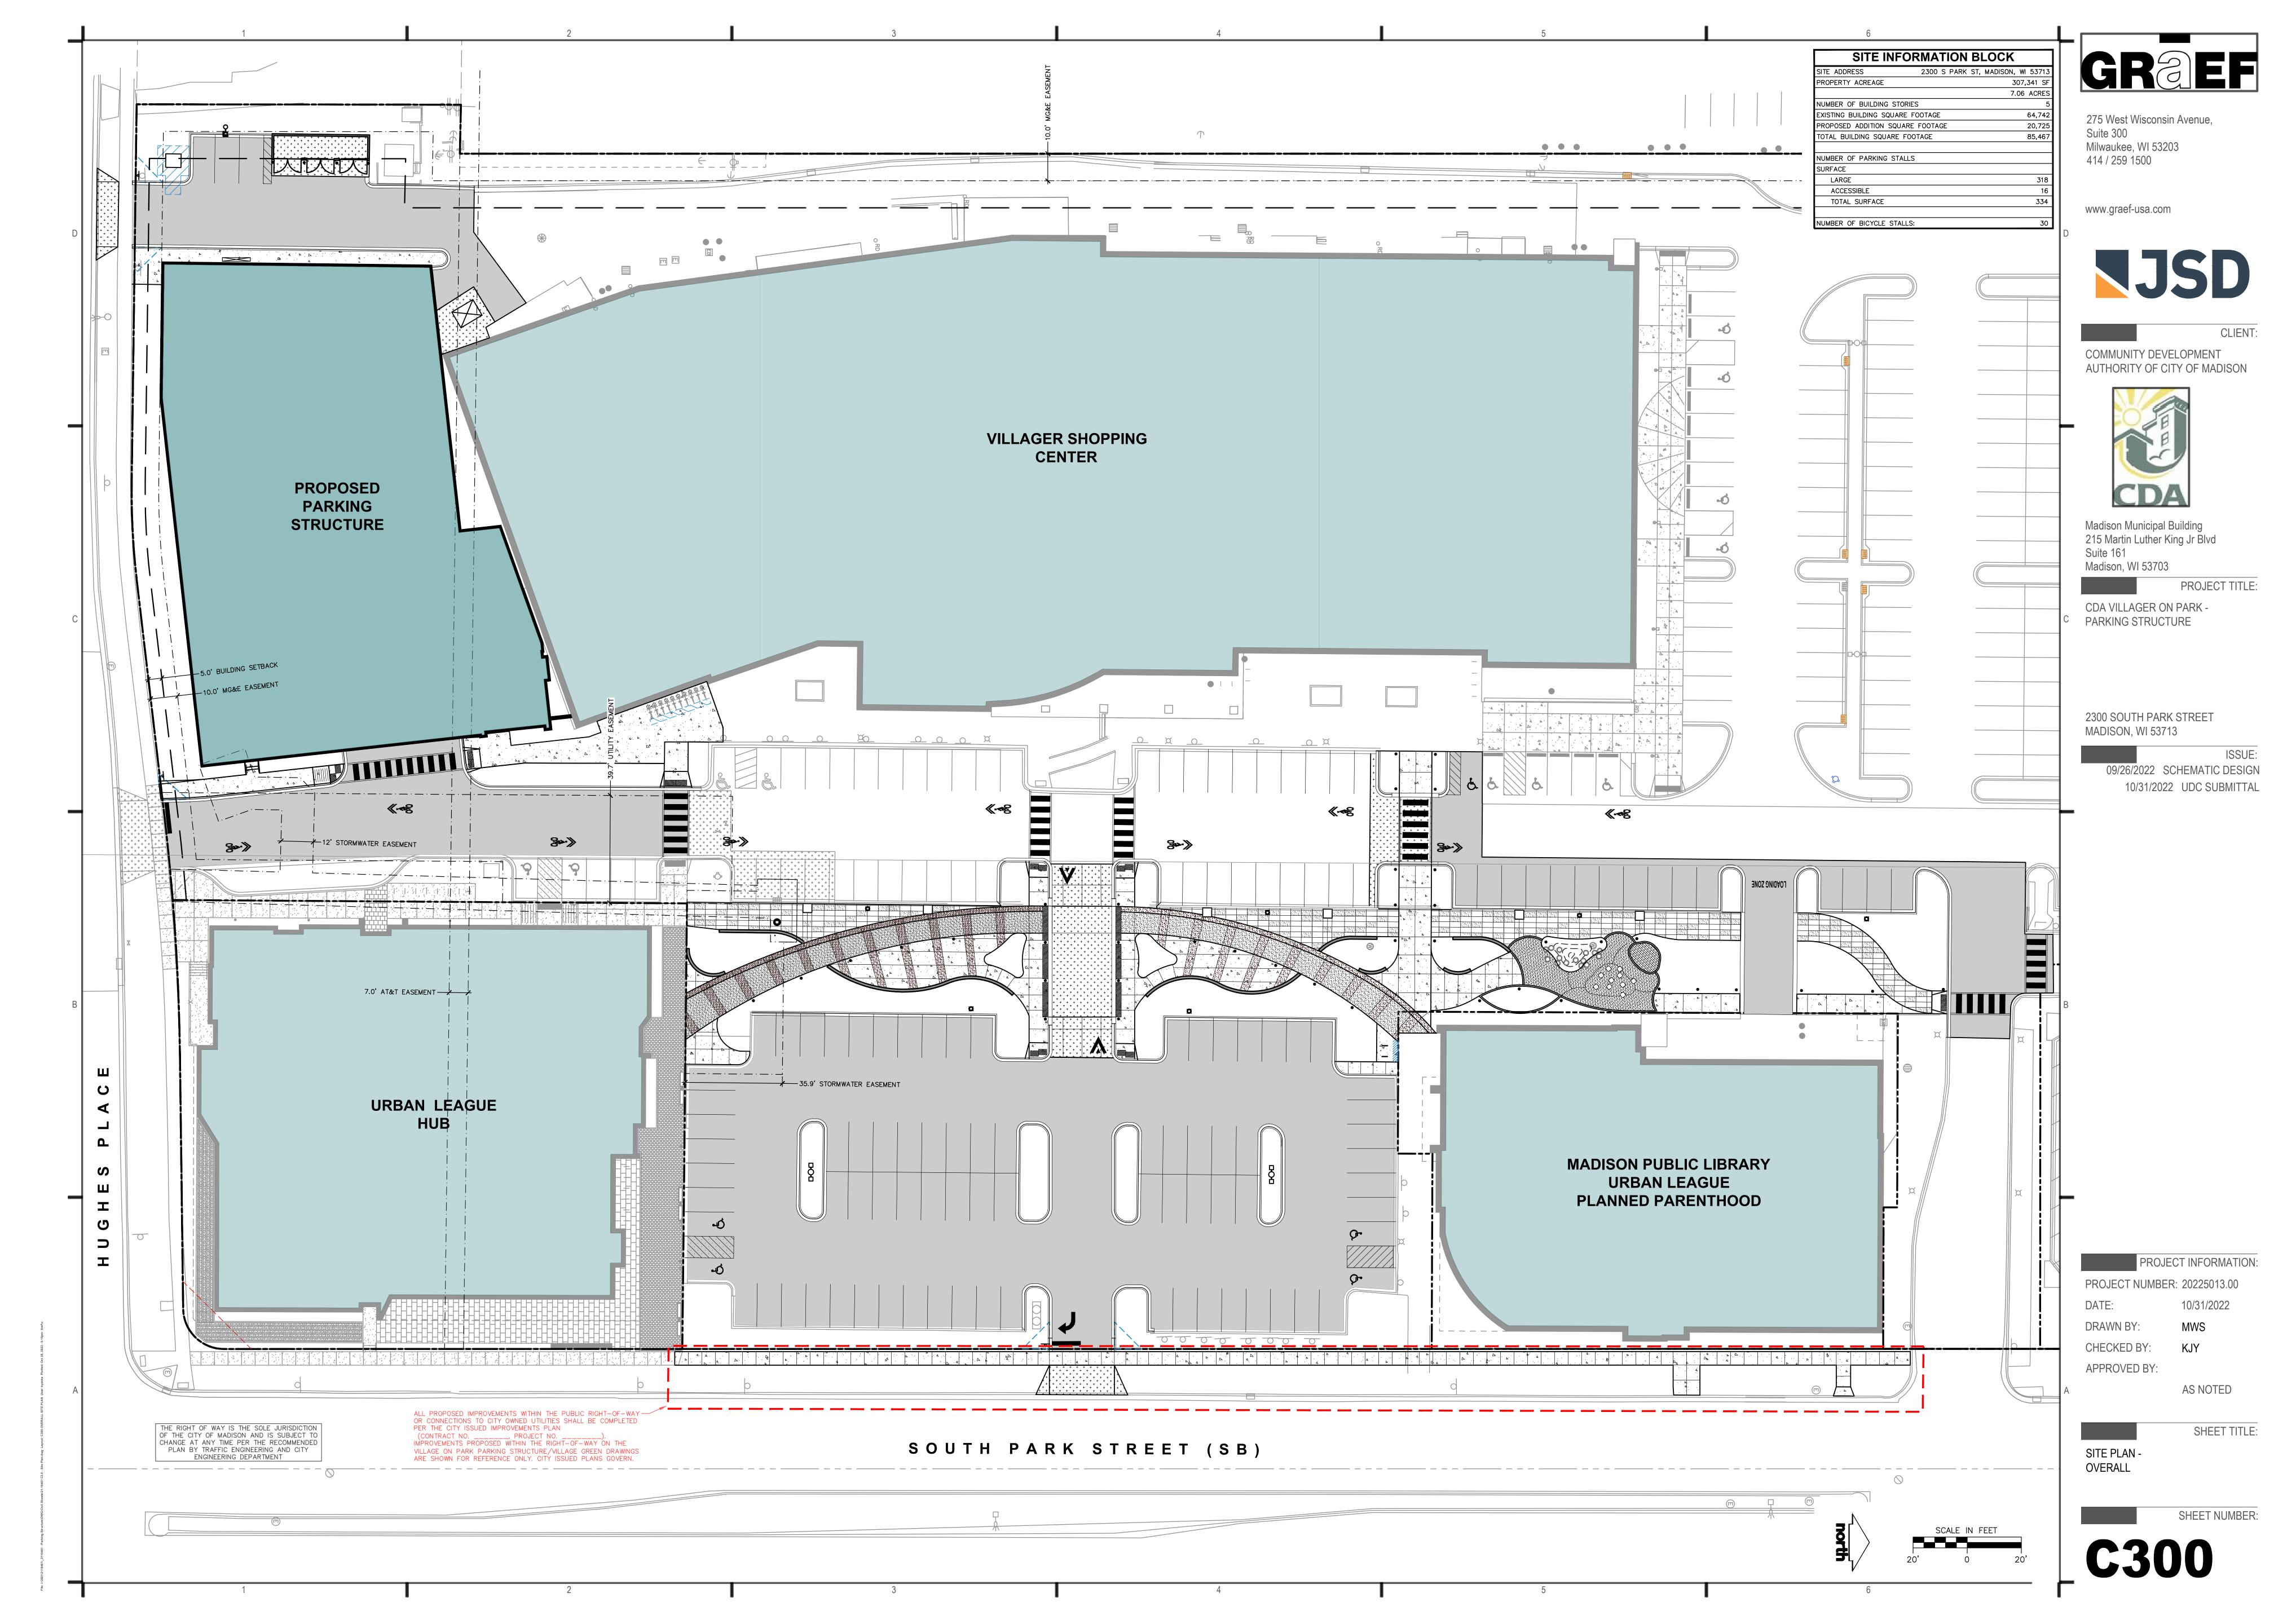
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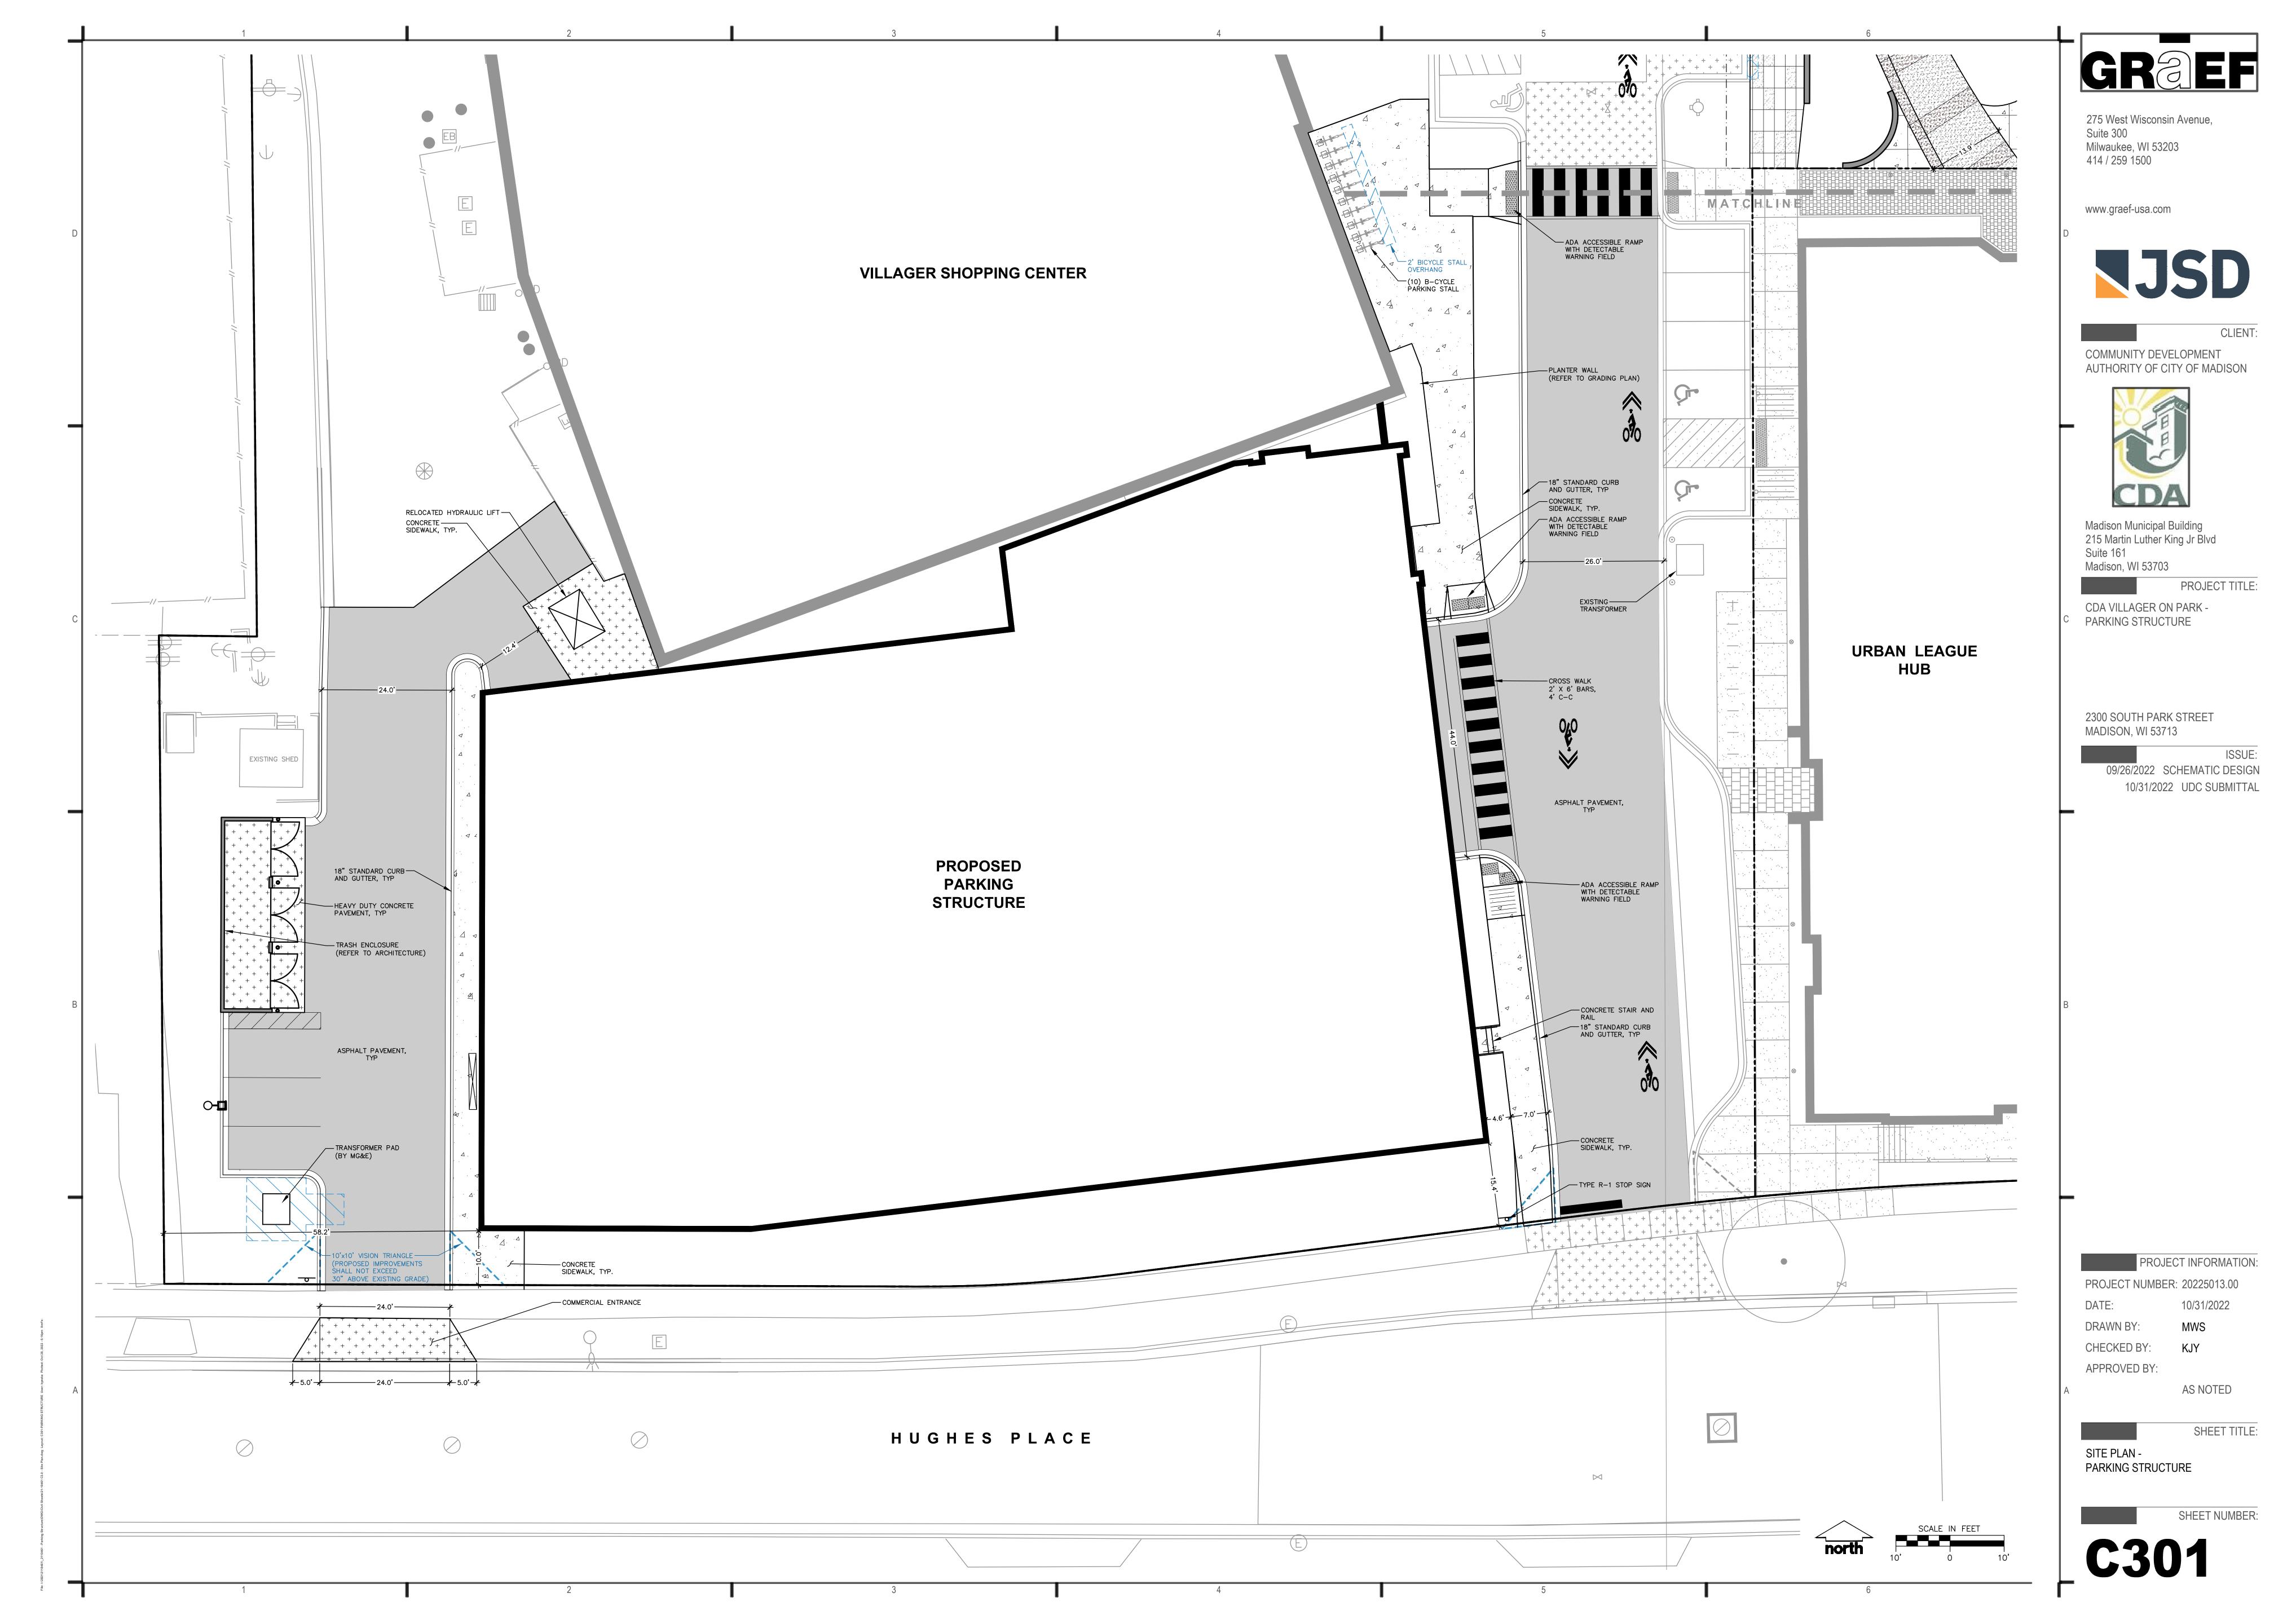
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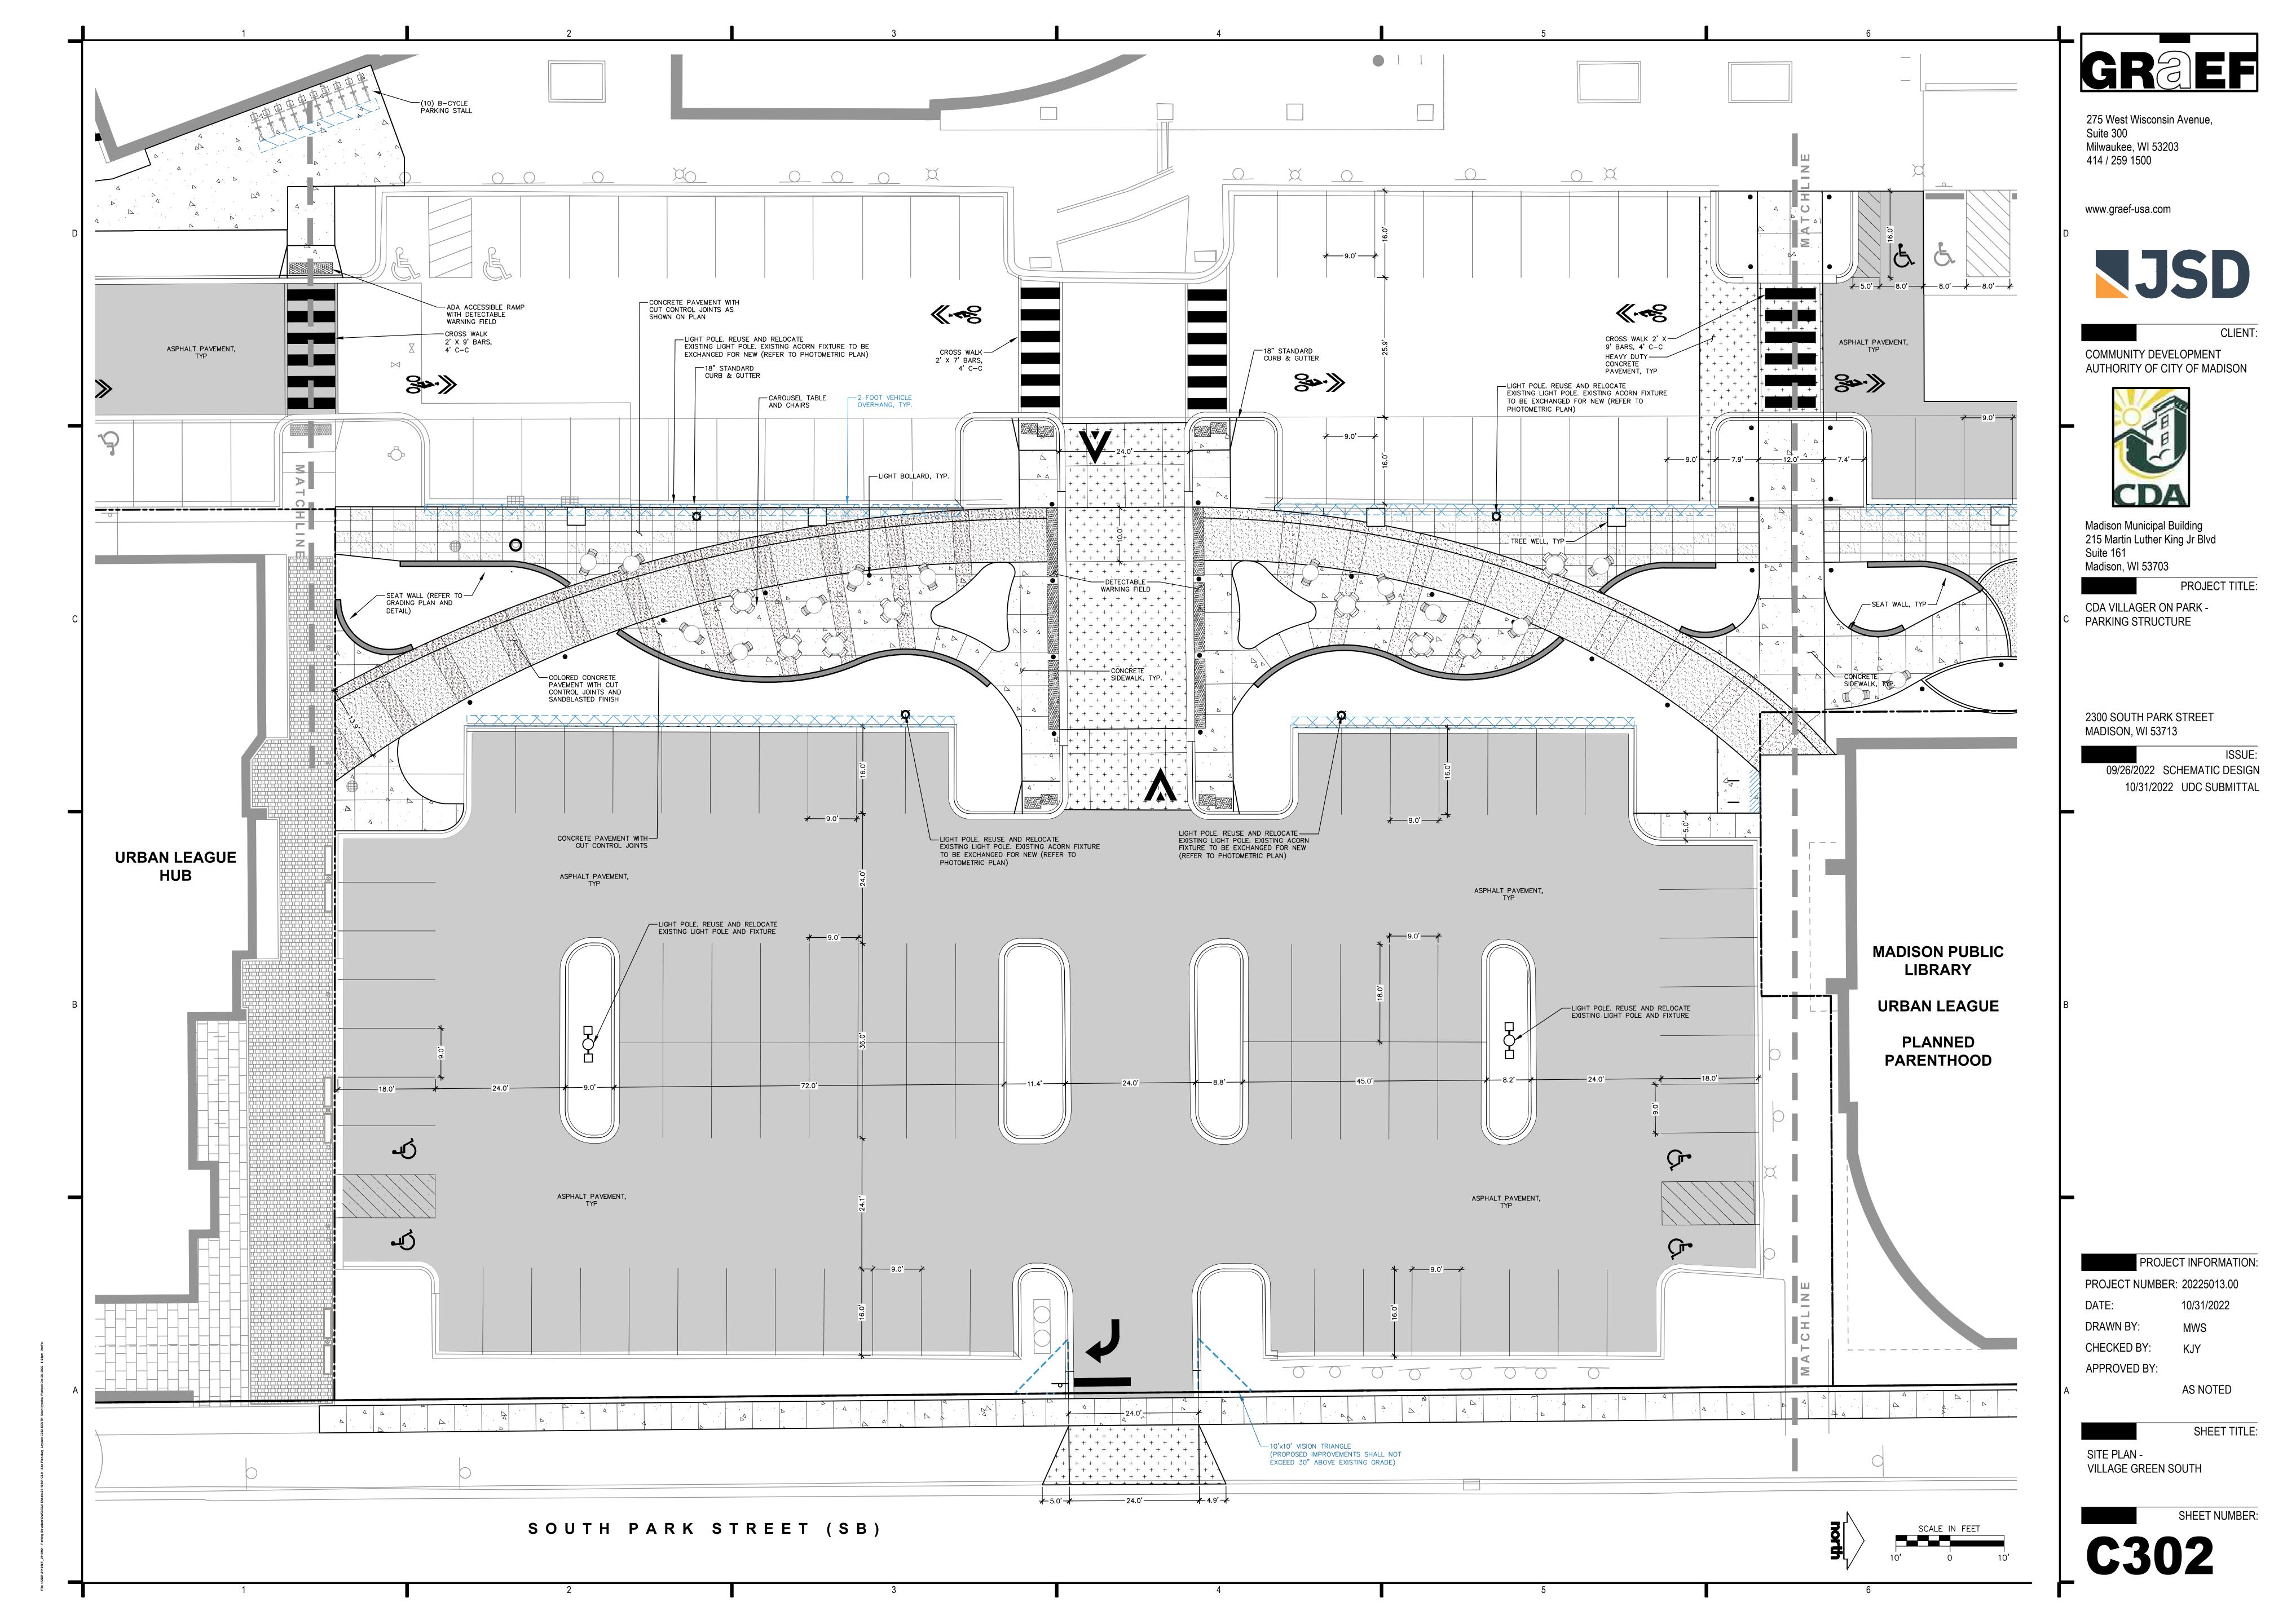
& ASSOCIATES


Sheet 1 of 1







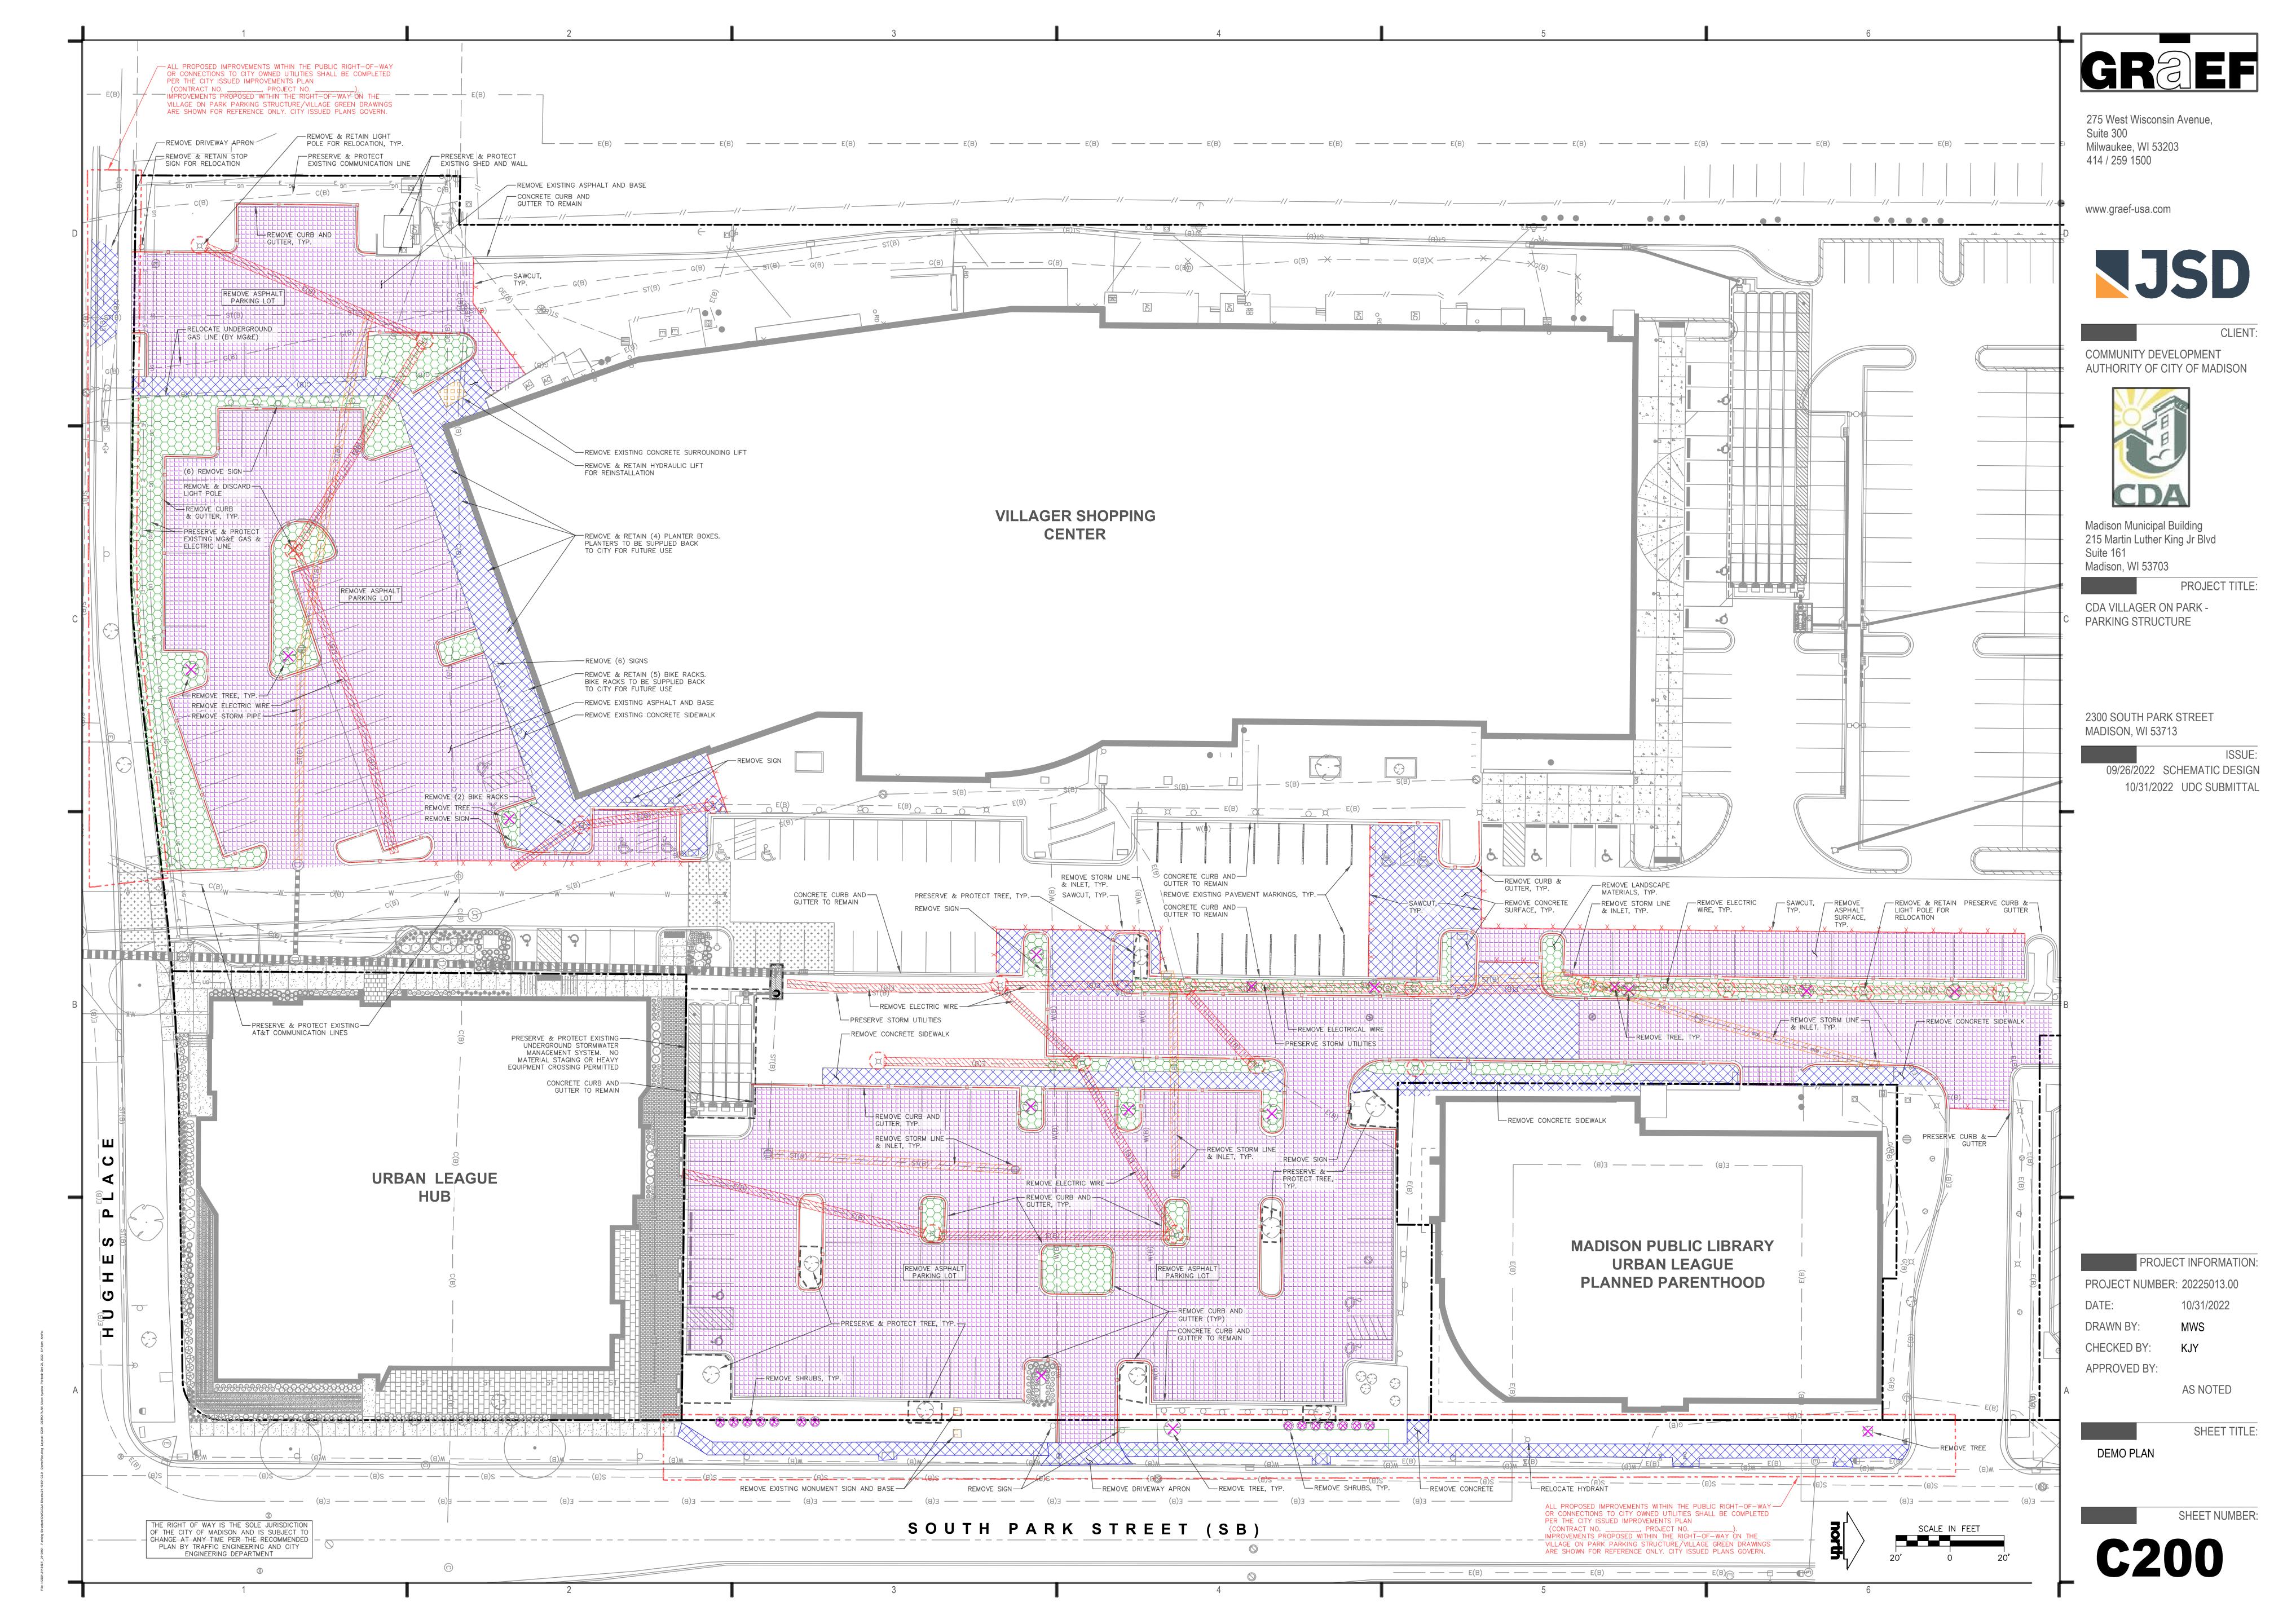

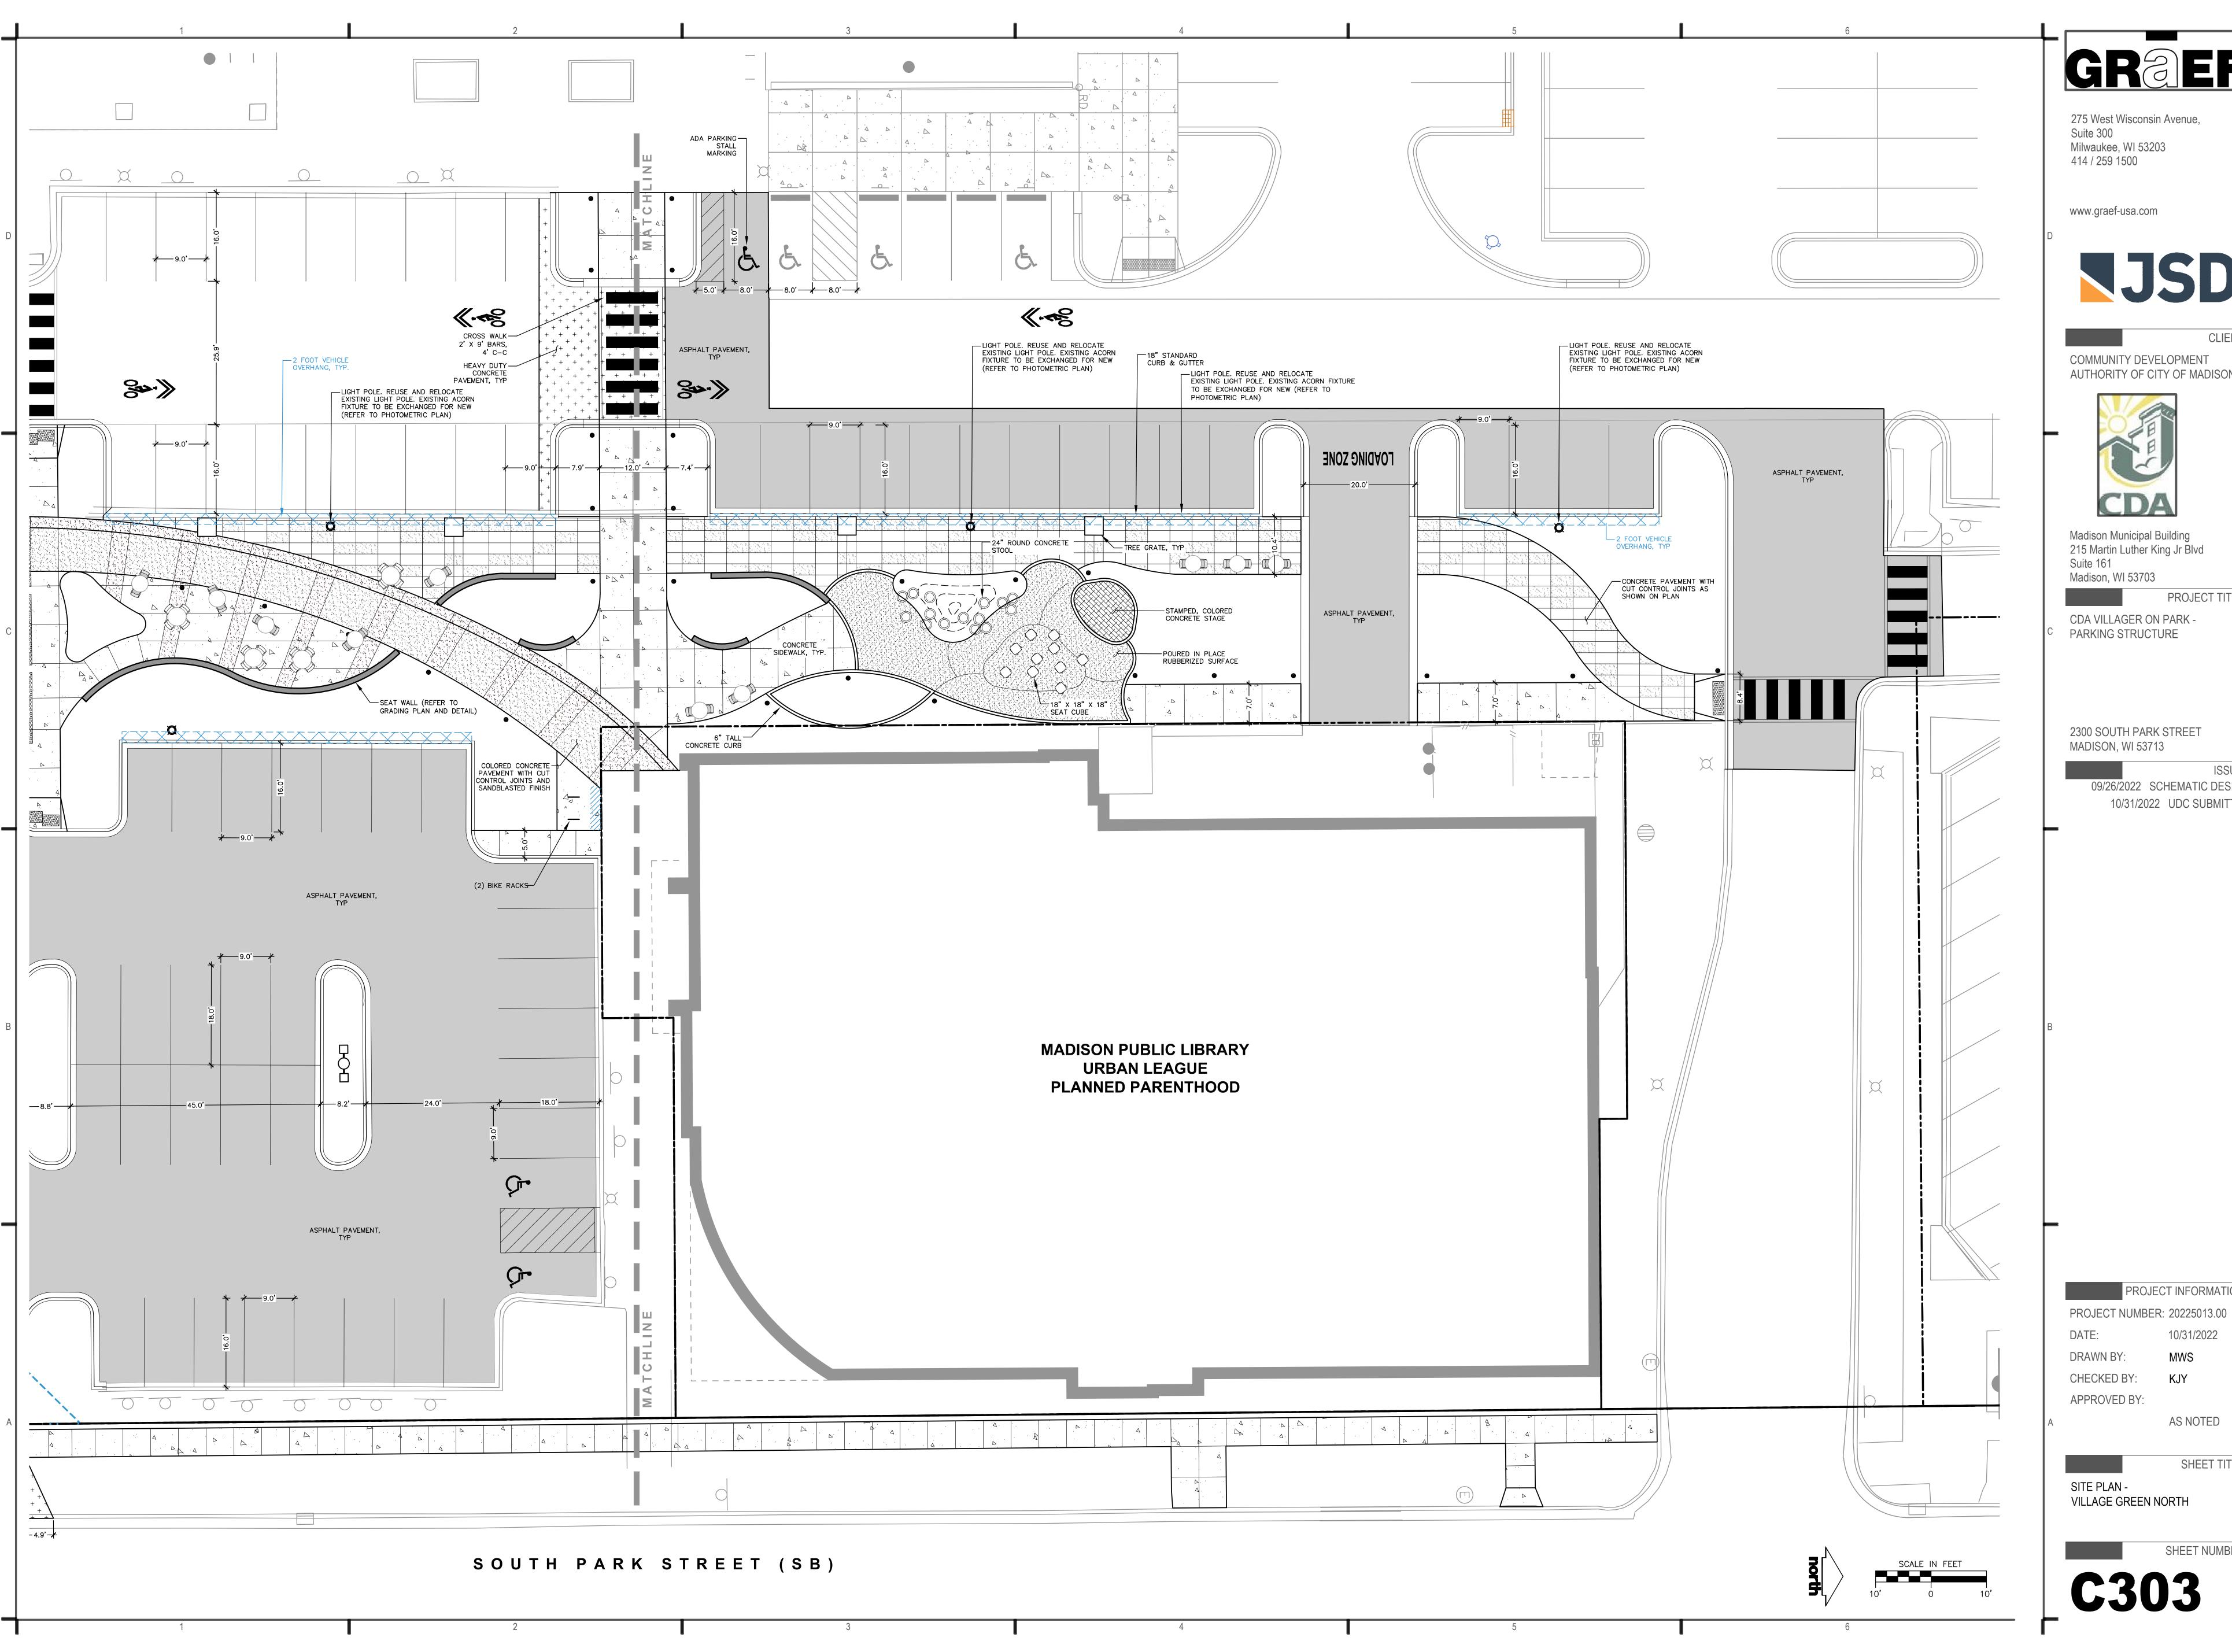

275 West Wisconsin Avenue, Milwaukee, WI 53203



CLIENT:

COMMUNITY DEVELOPMENT AUTHORITY OF CITY OF MADISON



Madison Municipal Building 215 Martin Luther King Jr Blvd

PROJECT TITLE:

CDA VILLAGER ON PARK -PARKING STRUCTURE

2300 SOUTH PARK STREET MADISON, WI 53713

> 09/26/2022 SCHEMATIC DESIGN 10/31/2022 UDC SUBMITTAL

PROJECT INFORMATION:

10/31/2022


CHECKED BY:

APPROVED BY:

AS NOTED

SHEET TITLE:

VILLAGE GREEN NORTH

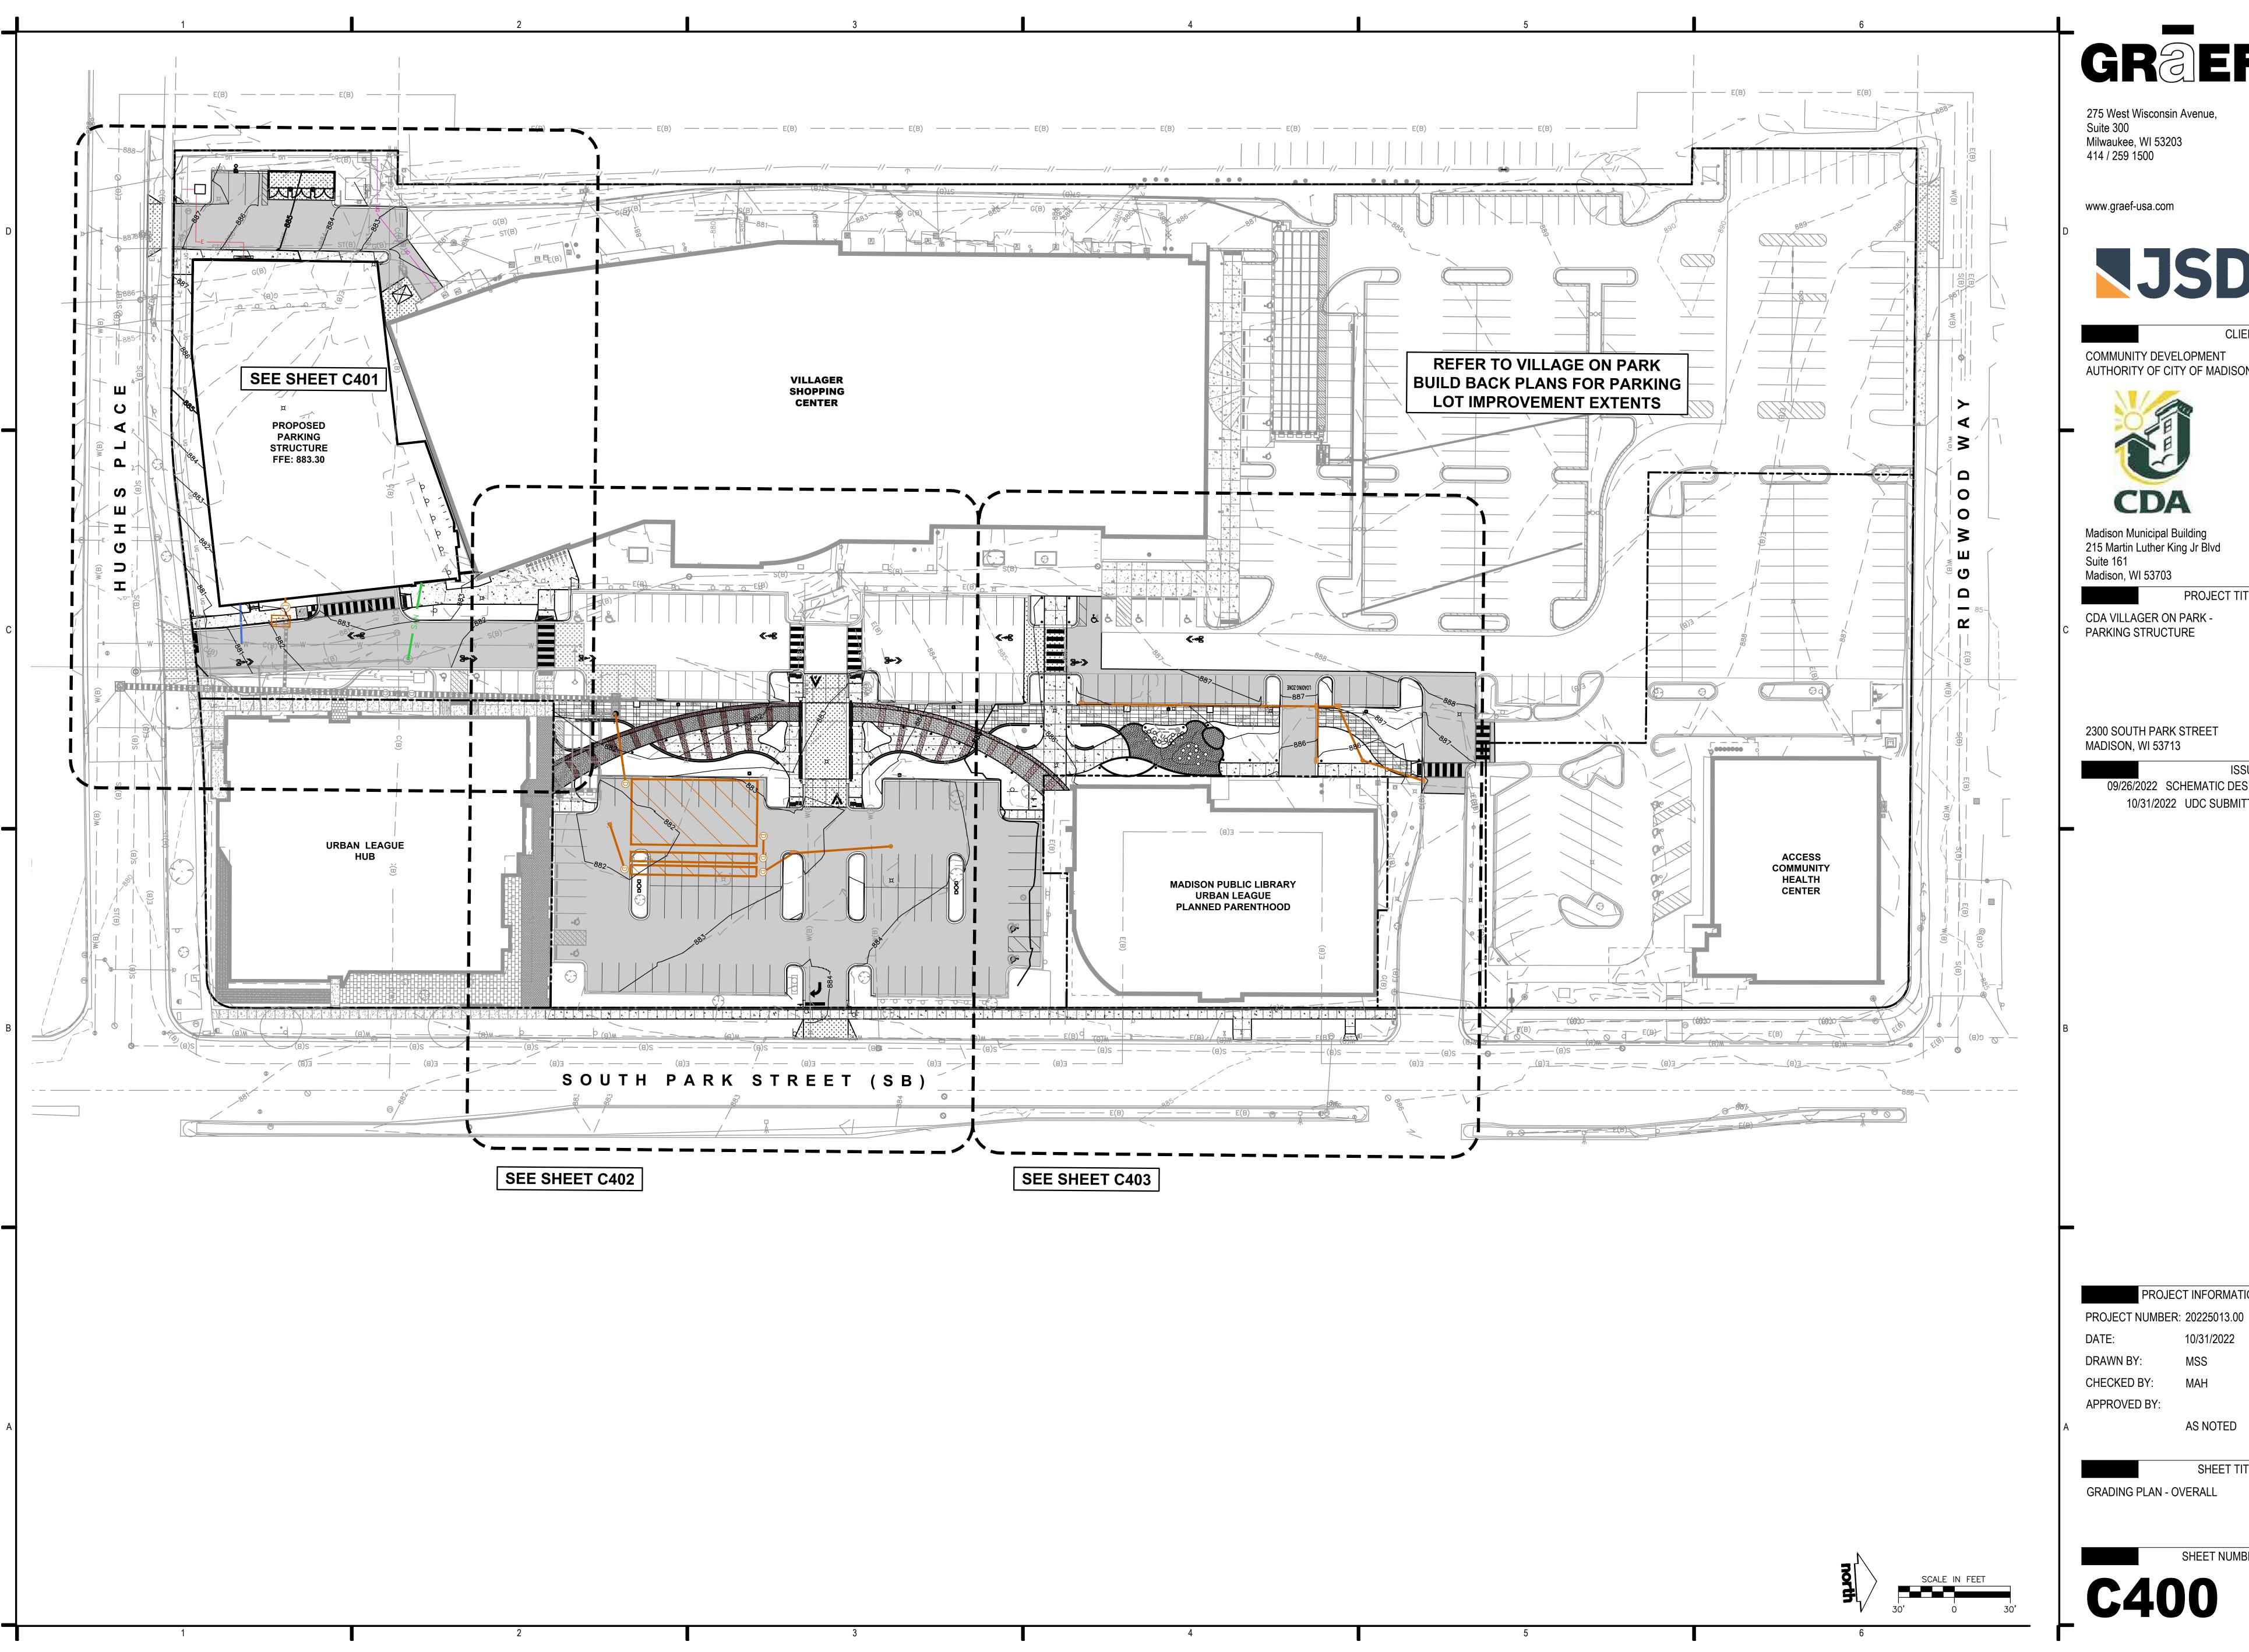

275 West Wisconsin Avenue, Milwaukee, WI 53203



CLIENT:

COMMUNITY DEVELOPMENT AUTHORITY OF CITY OF MADISON



Madison Municipal Building 215 Martin Luther King Jr Blvd

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2300 SOUTH PARK STREET

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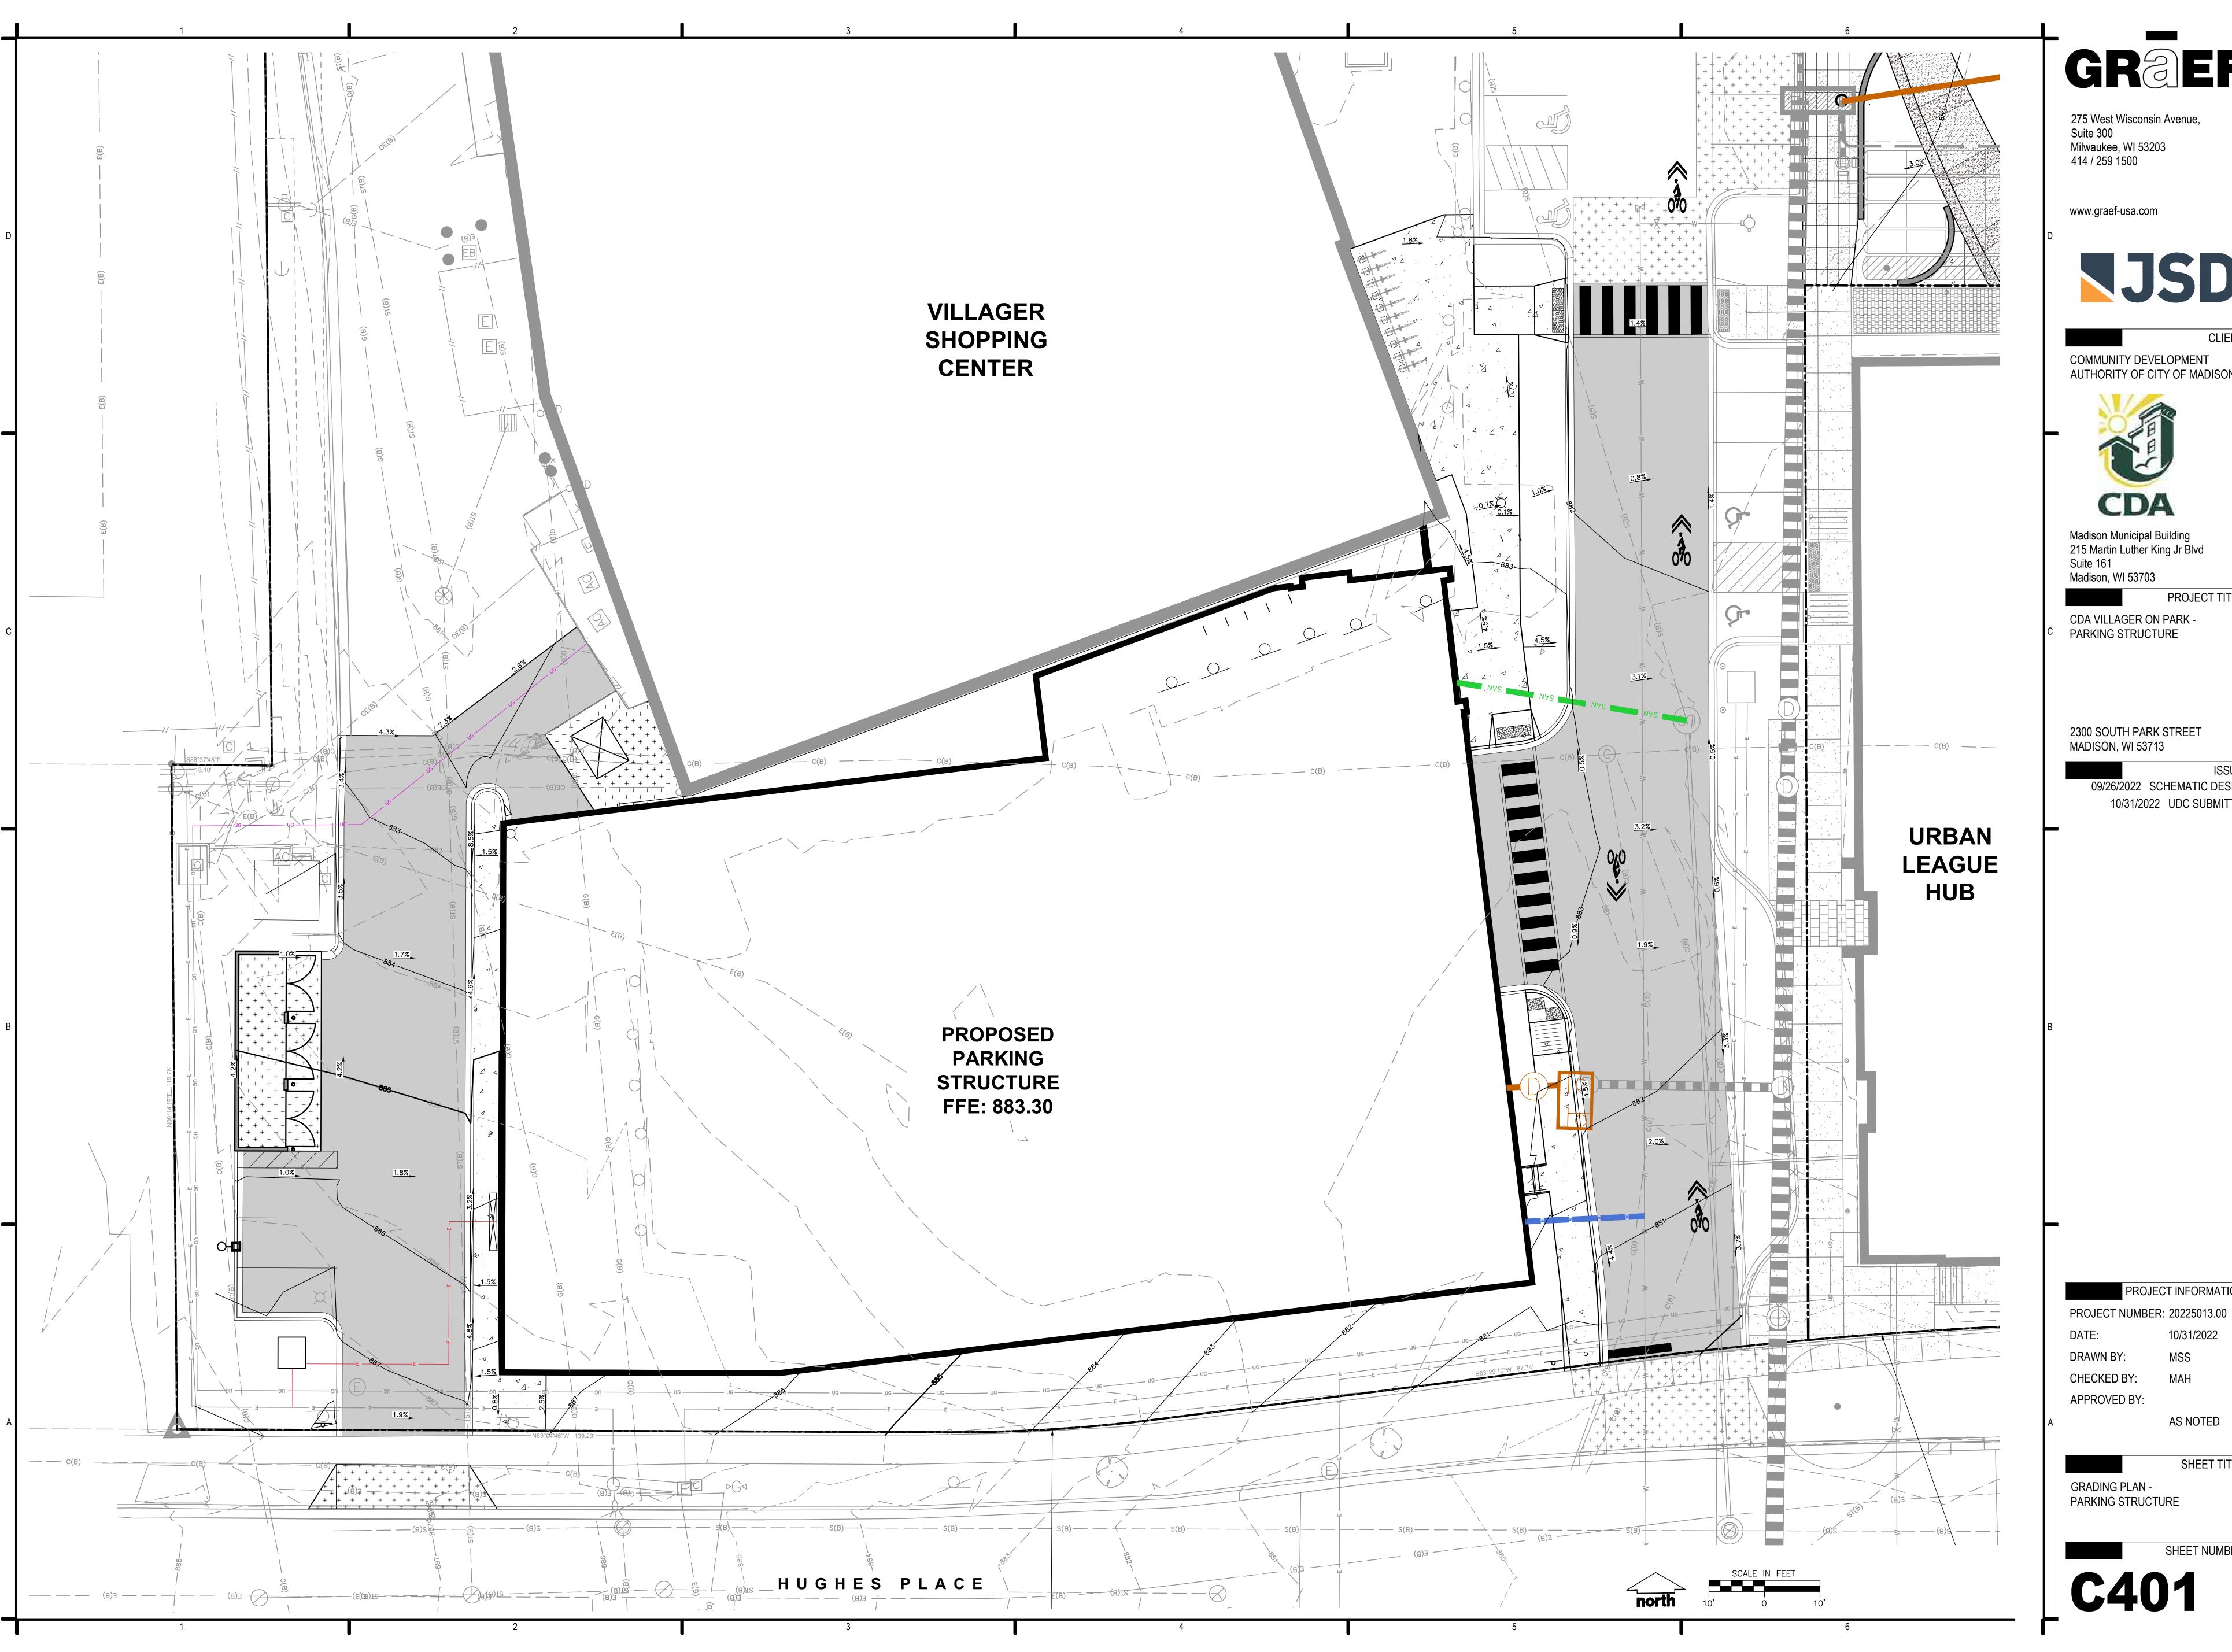
PROJECT INFORMATION:

10/31/2022

SHEET TITLE:

AS NOTED

GRADING PLAN - OVERALL



275 West Wisconsin Avenue, Suite 300 Milwaukee, WI 53203 414 / 259 1500

www.graef-usa.com



CLIENT:

COMMUNITY DEVELOPMENT AUTHORITY OF CITY OF MADISON



Madison Municipal Building 215 Martin Luther King Jr Blvd Suite 161

Madison, WI 53703

PROJECT TITLE:

CDA VILLAGER ON PARK -PARKING STRUCTURE

2300 SOUTH PARK STREET MADISON, WI 53713

09/26/2022 SCHEMATIC DESIGN 10/31/2022 UDC SUBMITTAL

PROJECT INFORMATION:

10/31/2022


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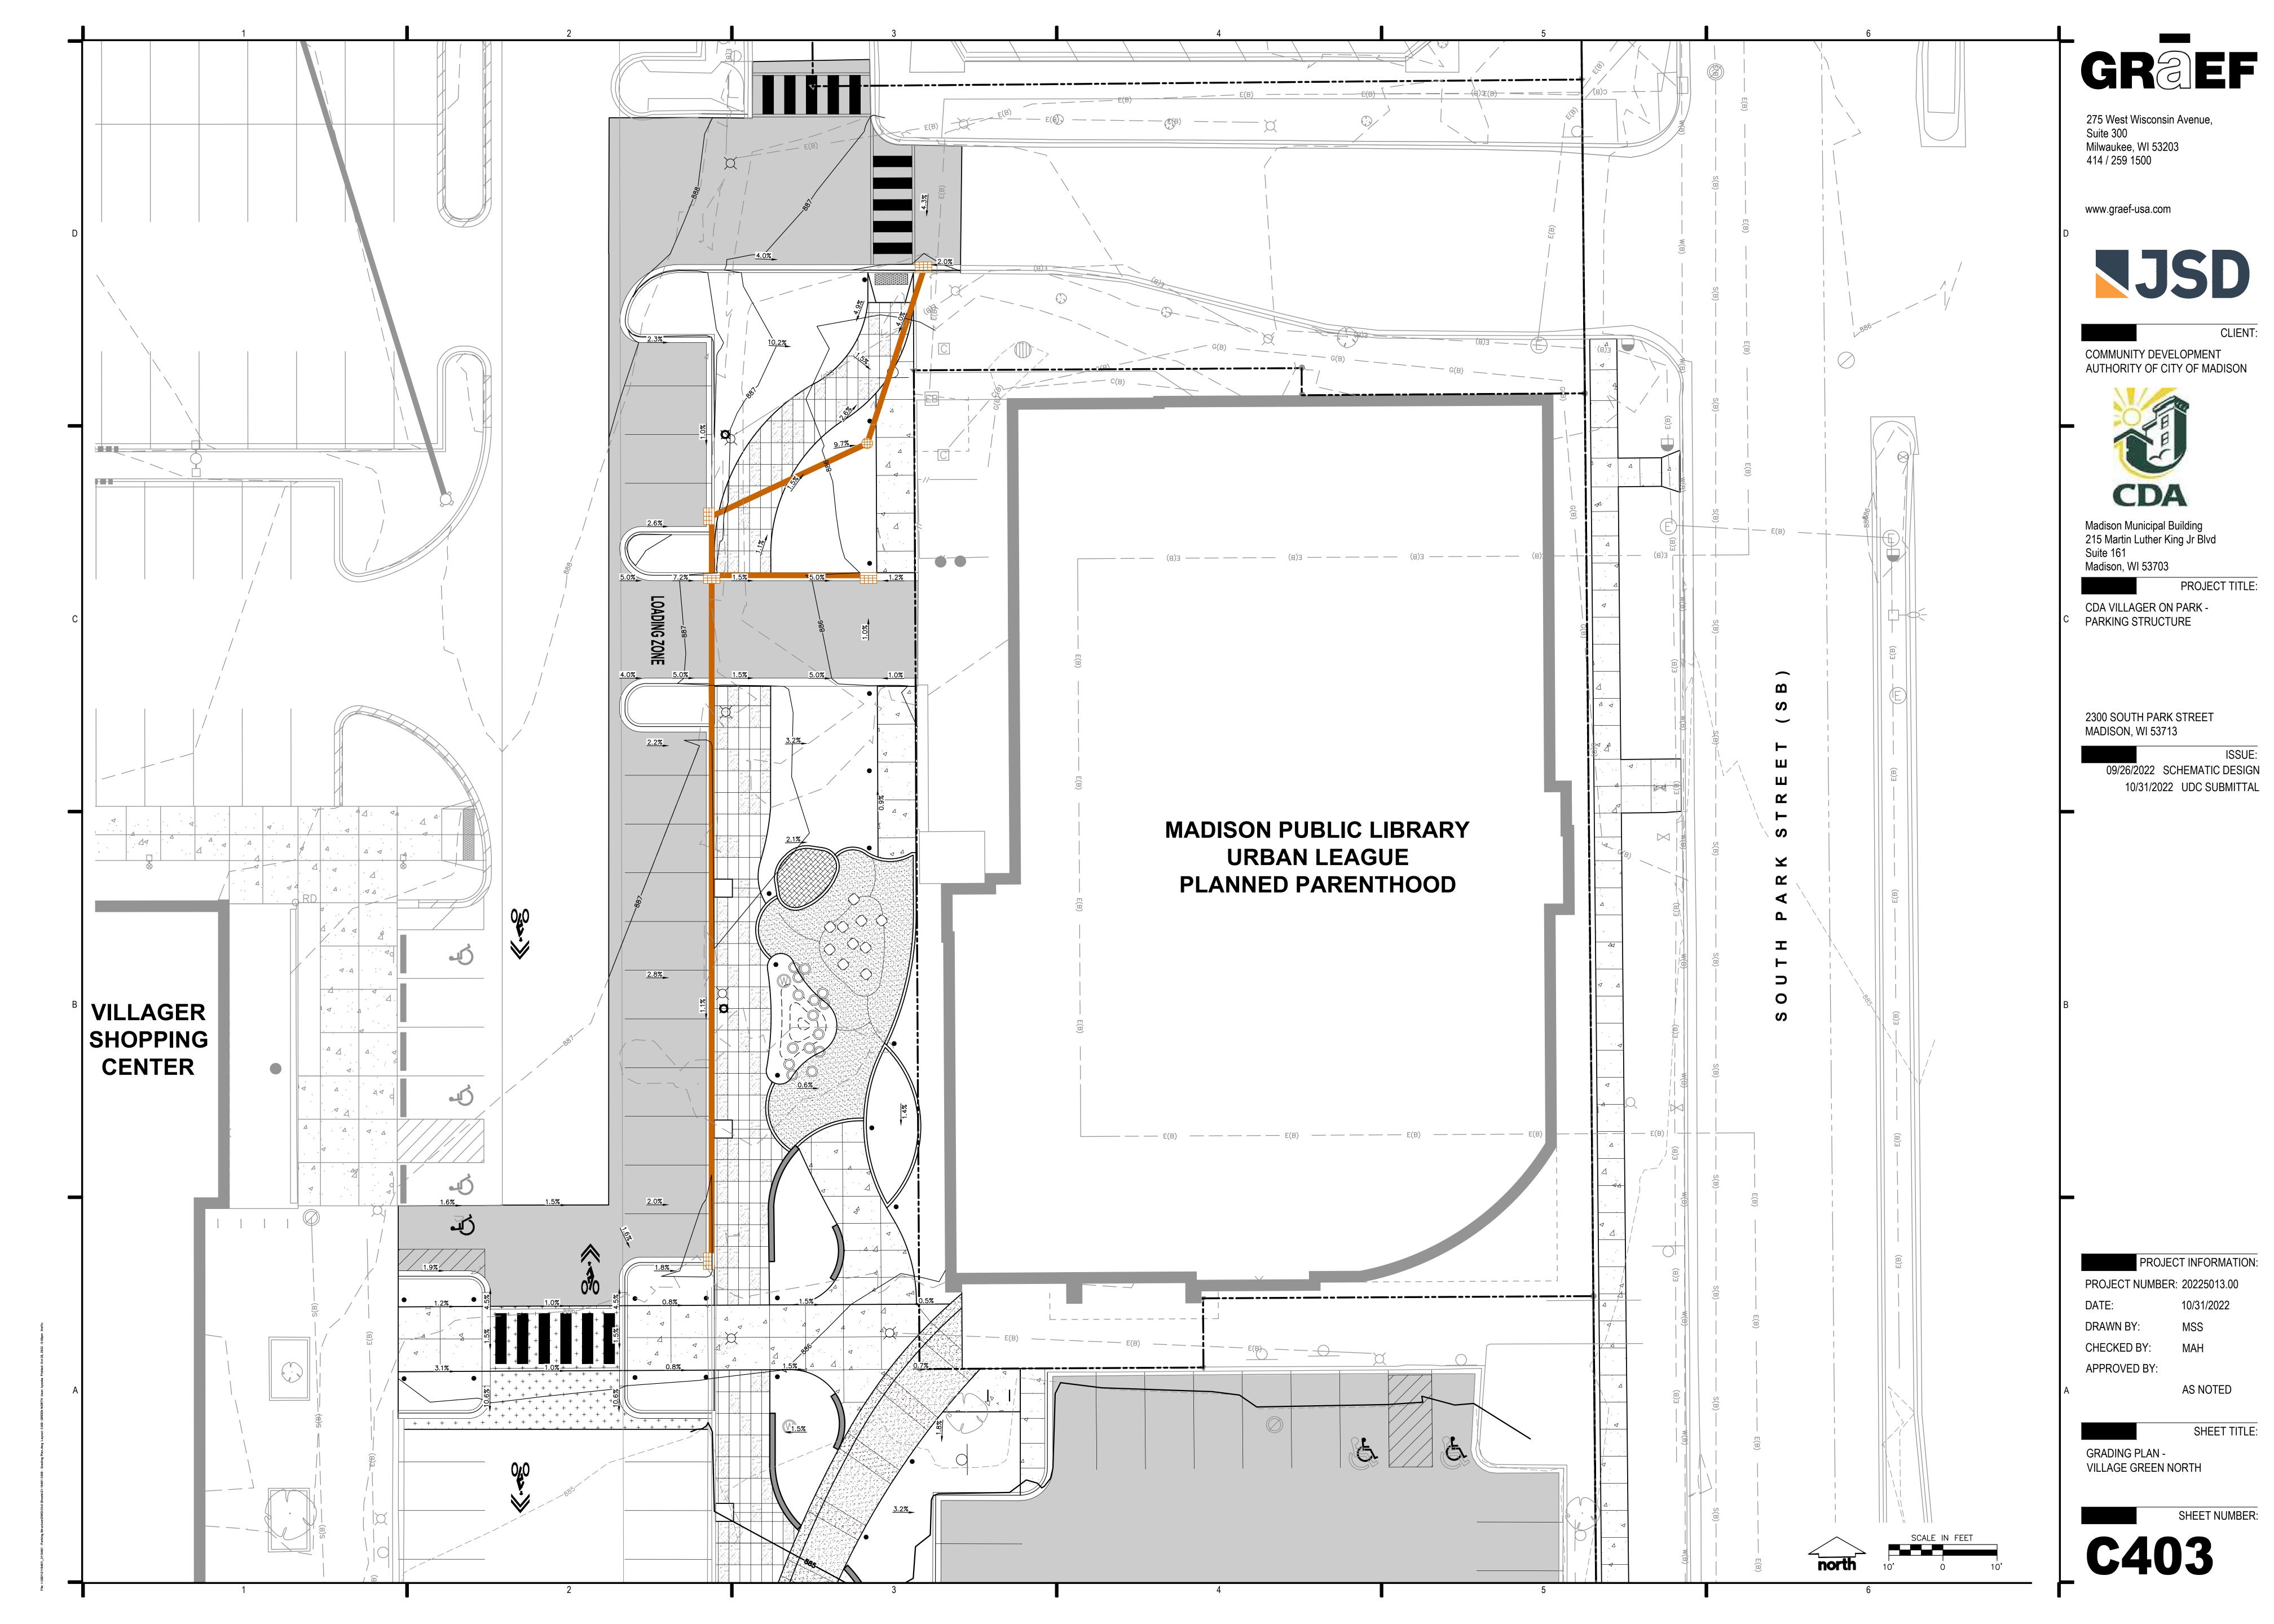
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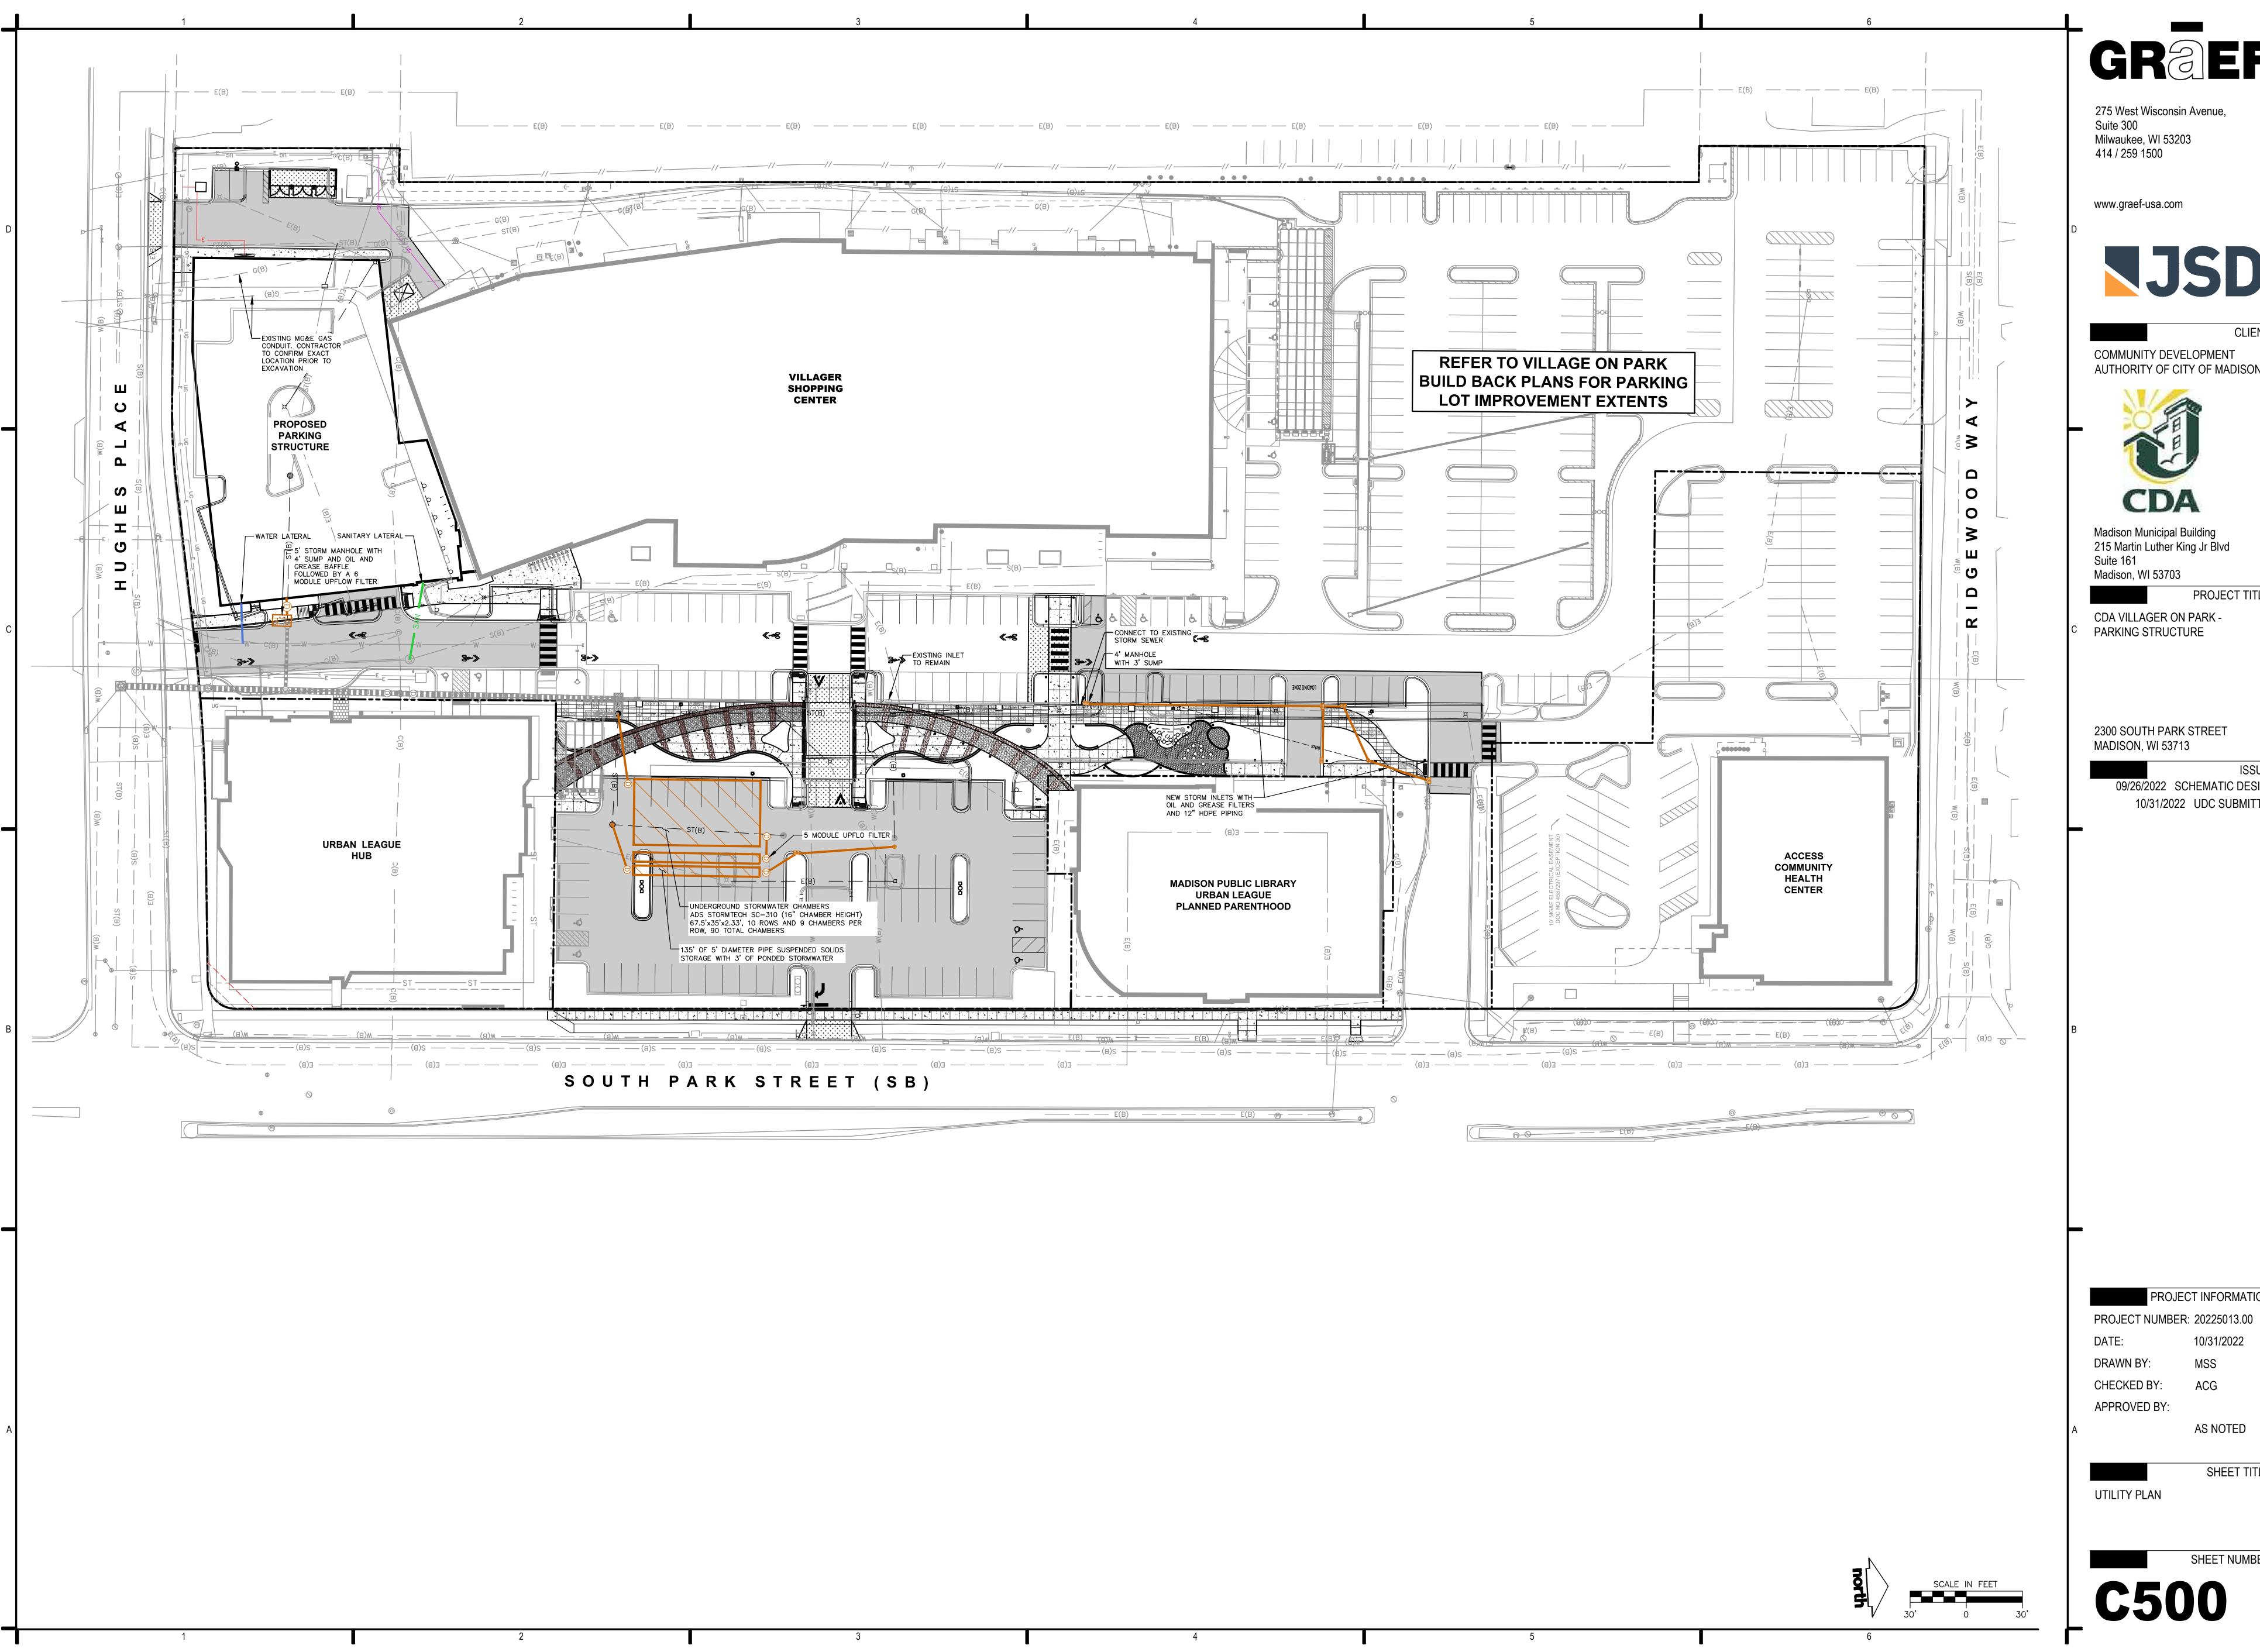
AS NOTED

SHEET TITLE:

**GRADING PLAN -**PARKING STRUCTURE





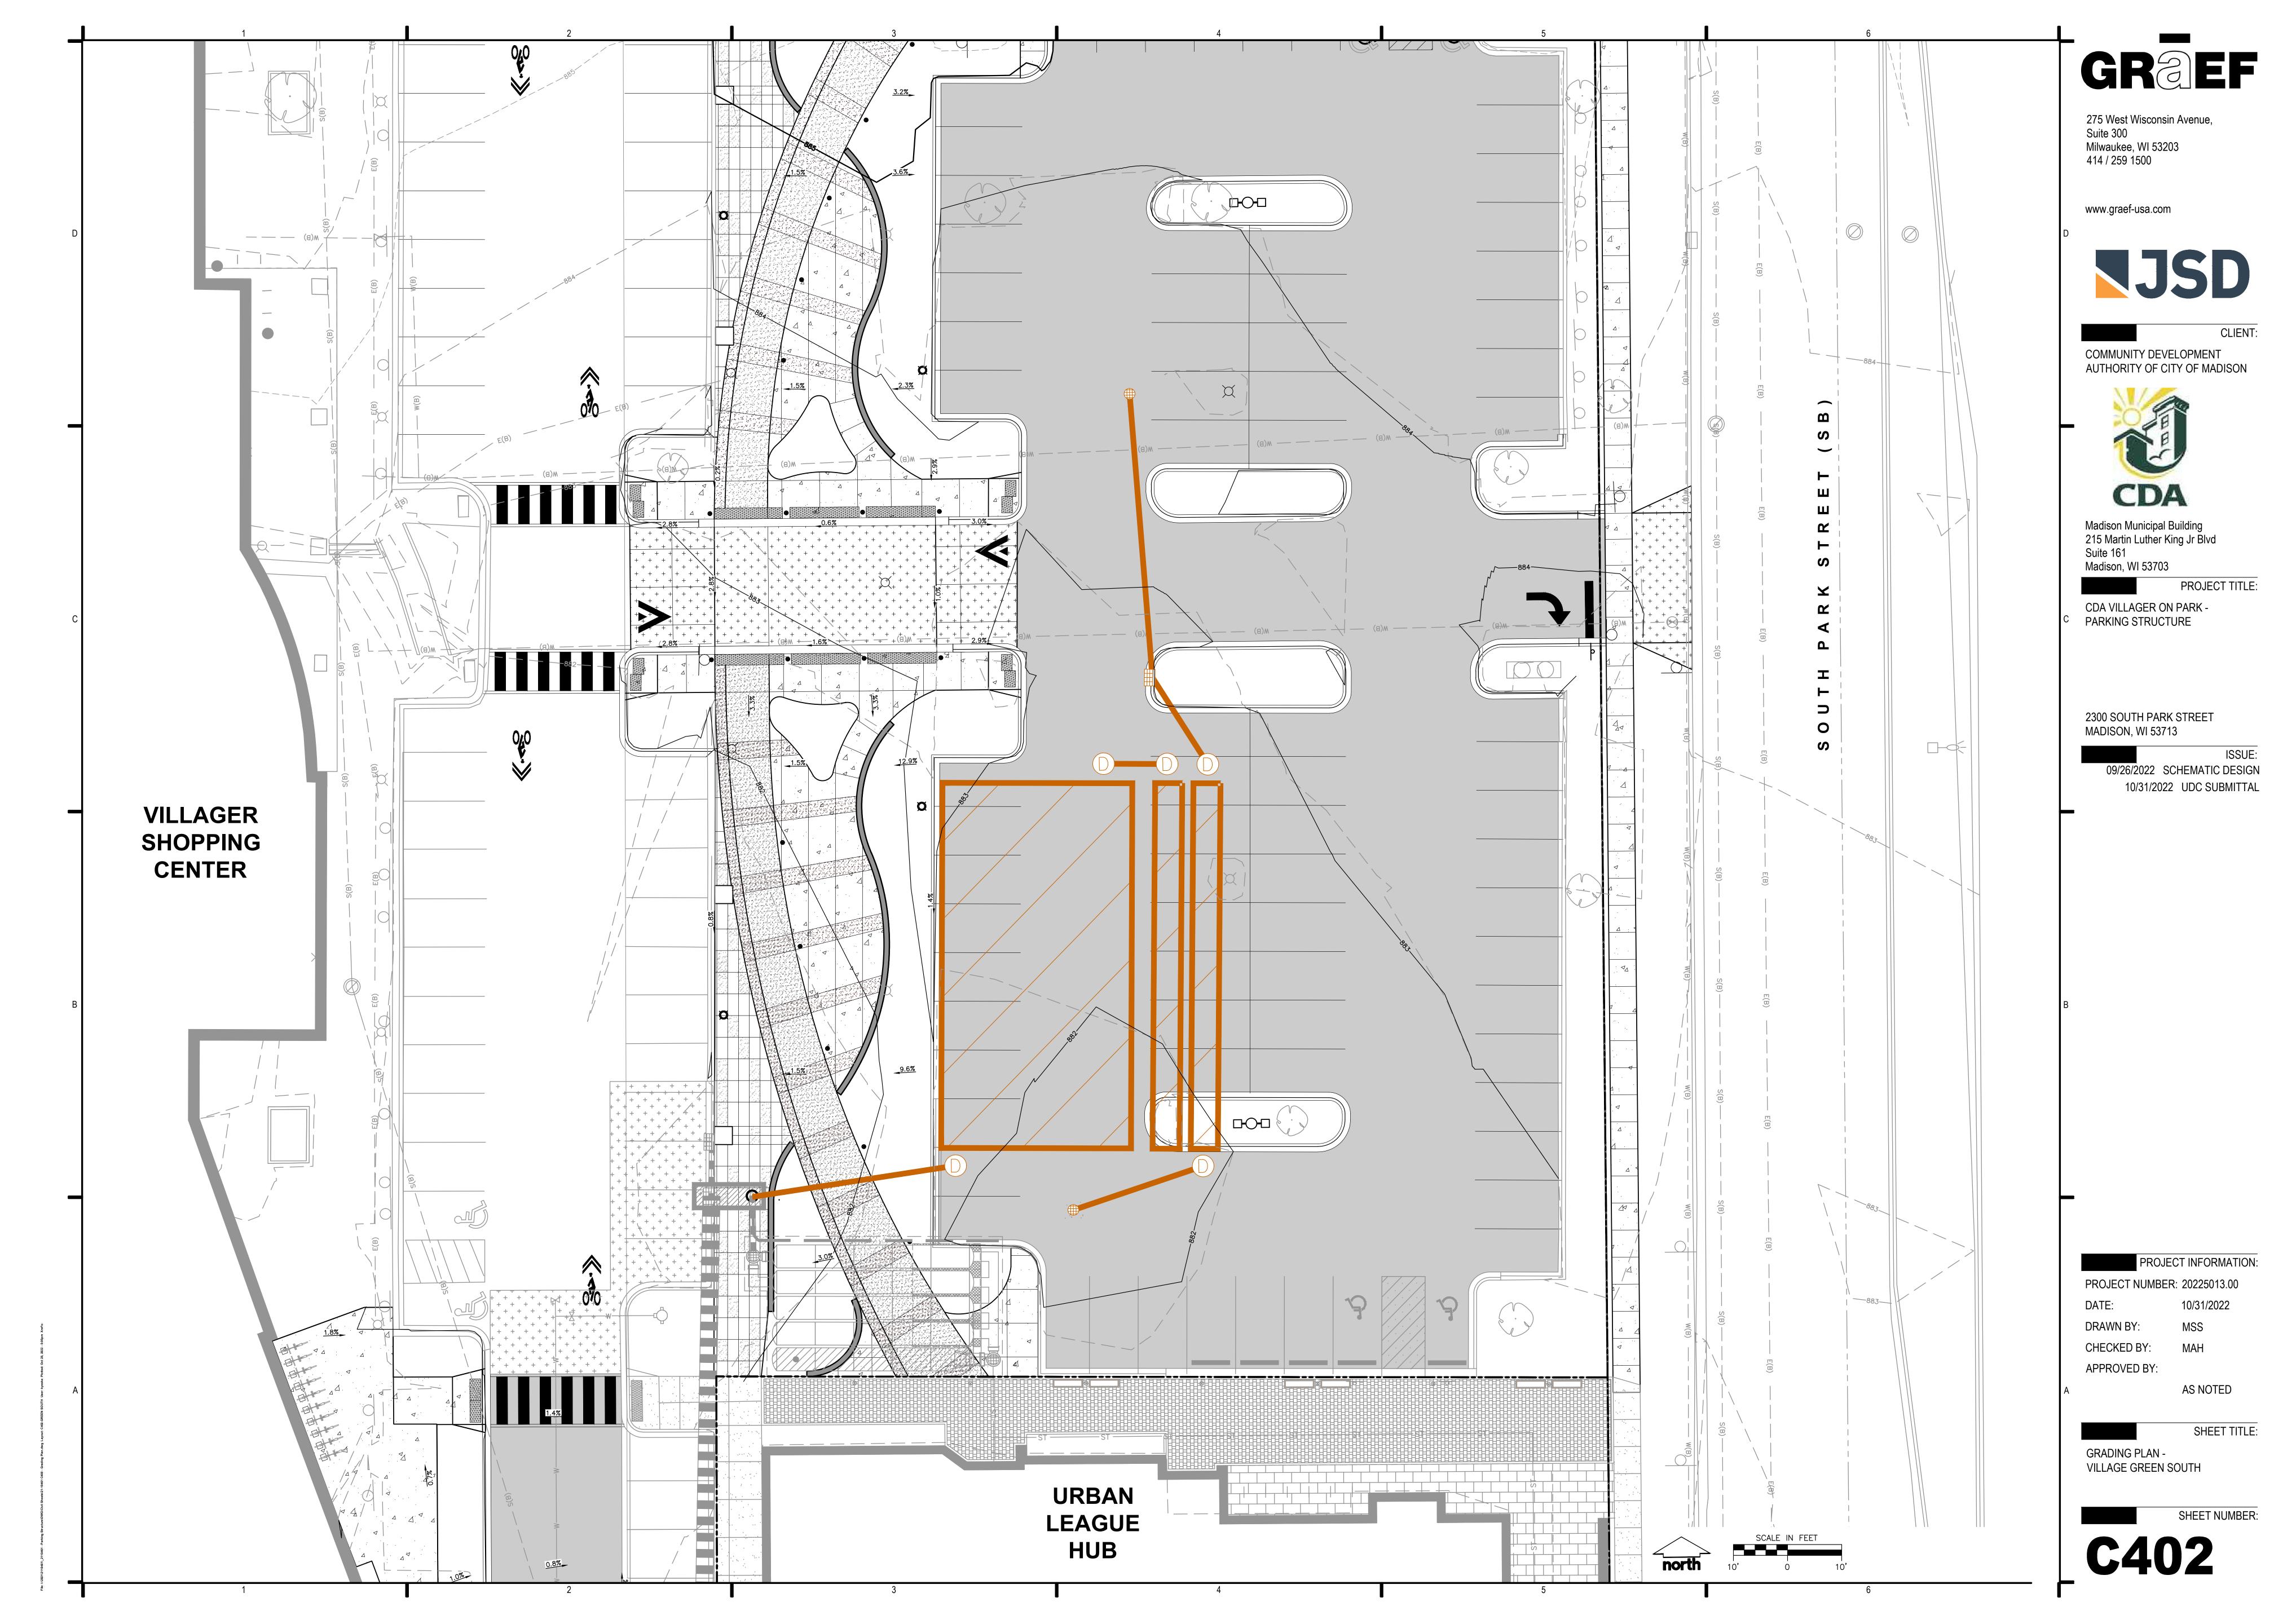

275 West Wisconsin Avenue, Milwaukee, WI 53203



CLIENT:

COMMUNITY DEVELOPMENT **AUTHORITY OF CITY OF MADISON** 



Madison Municipal Building 215 Martin Luther King Jr Blvd

PROJECT TITLE:

CDA VILLAGER ON PARK -PARKING STRUCTURE

2300 SOUTH PARK STREET MADISON, WI 53713


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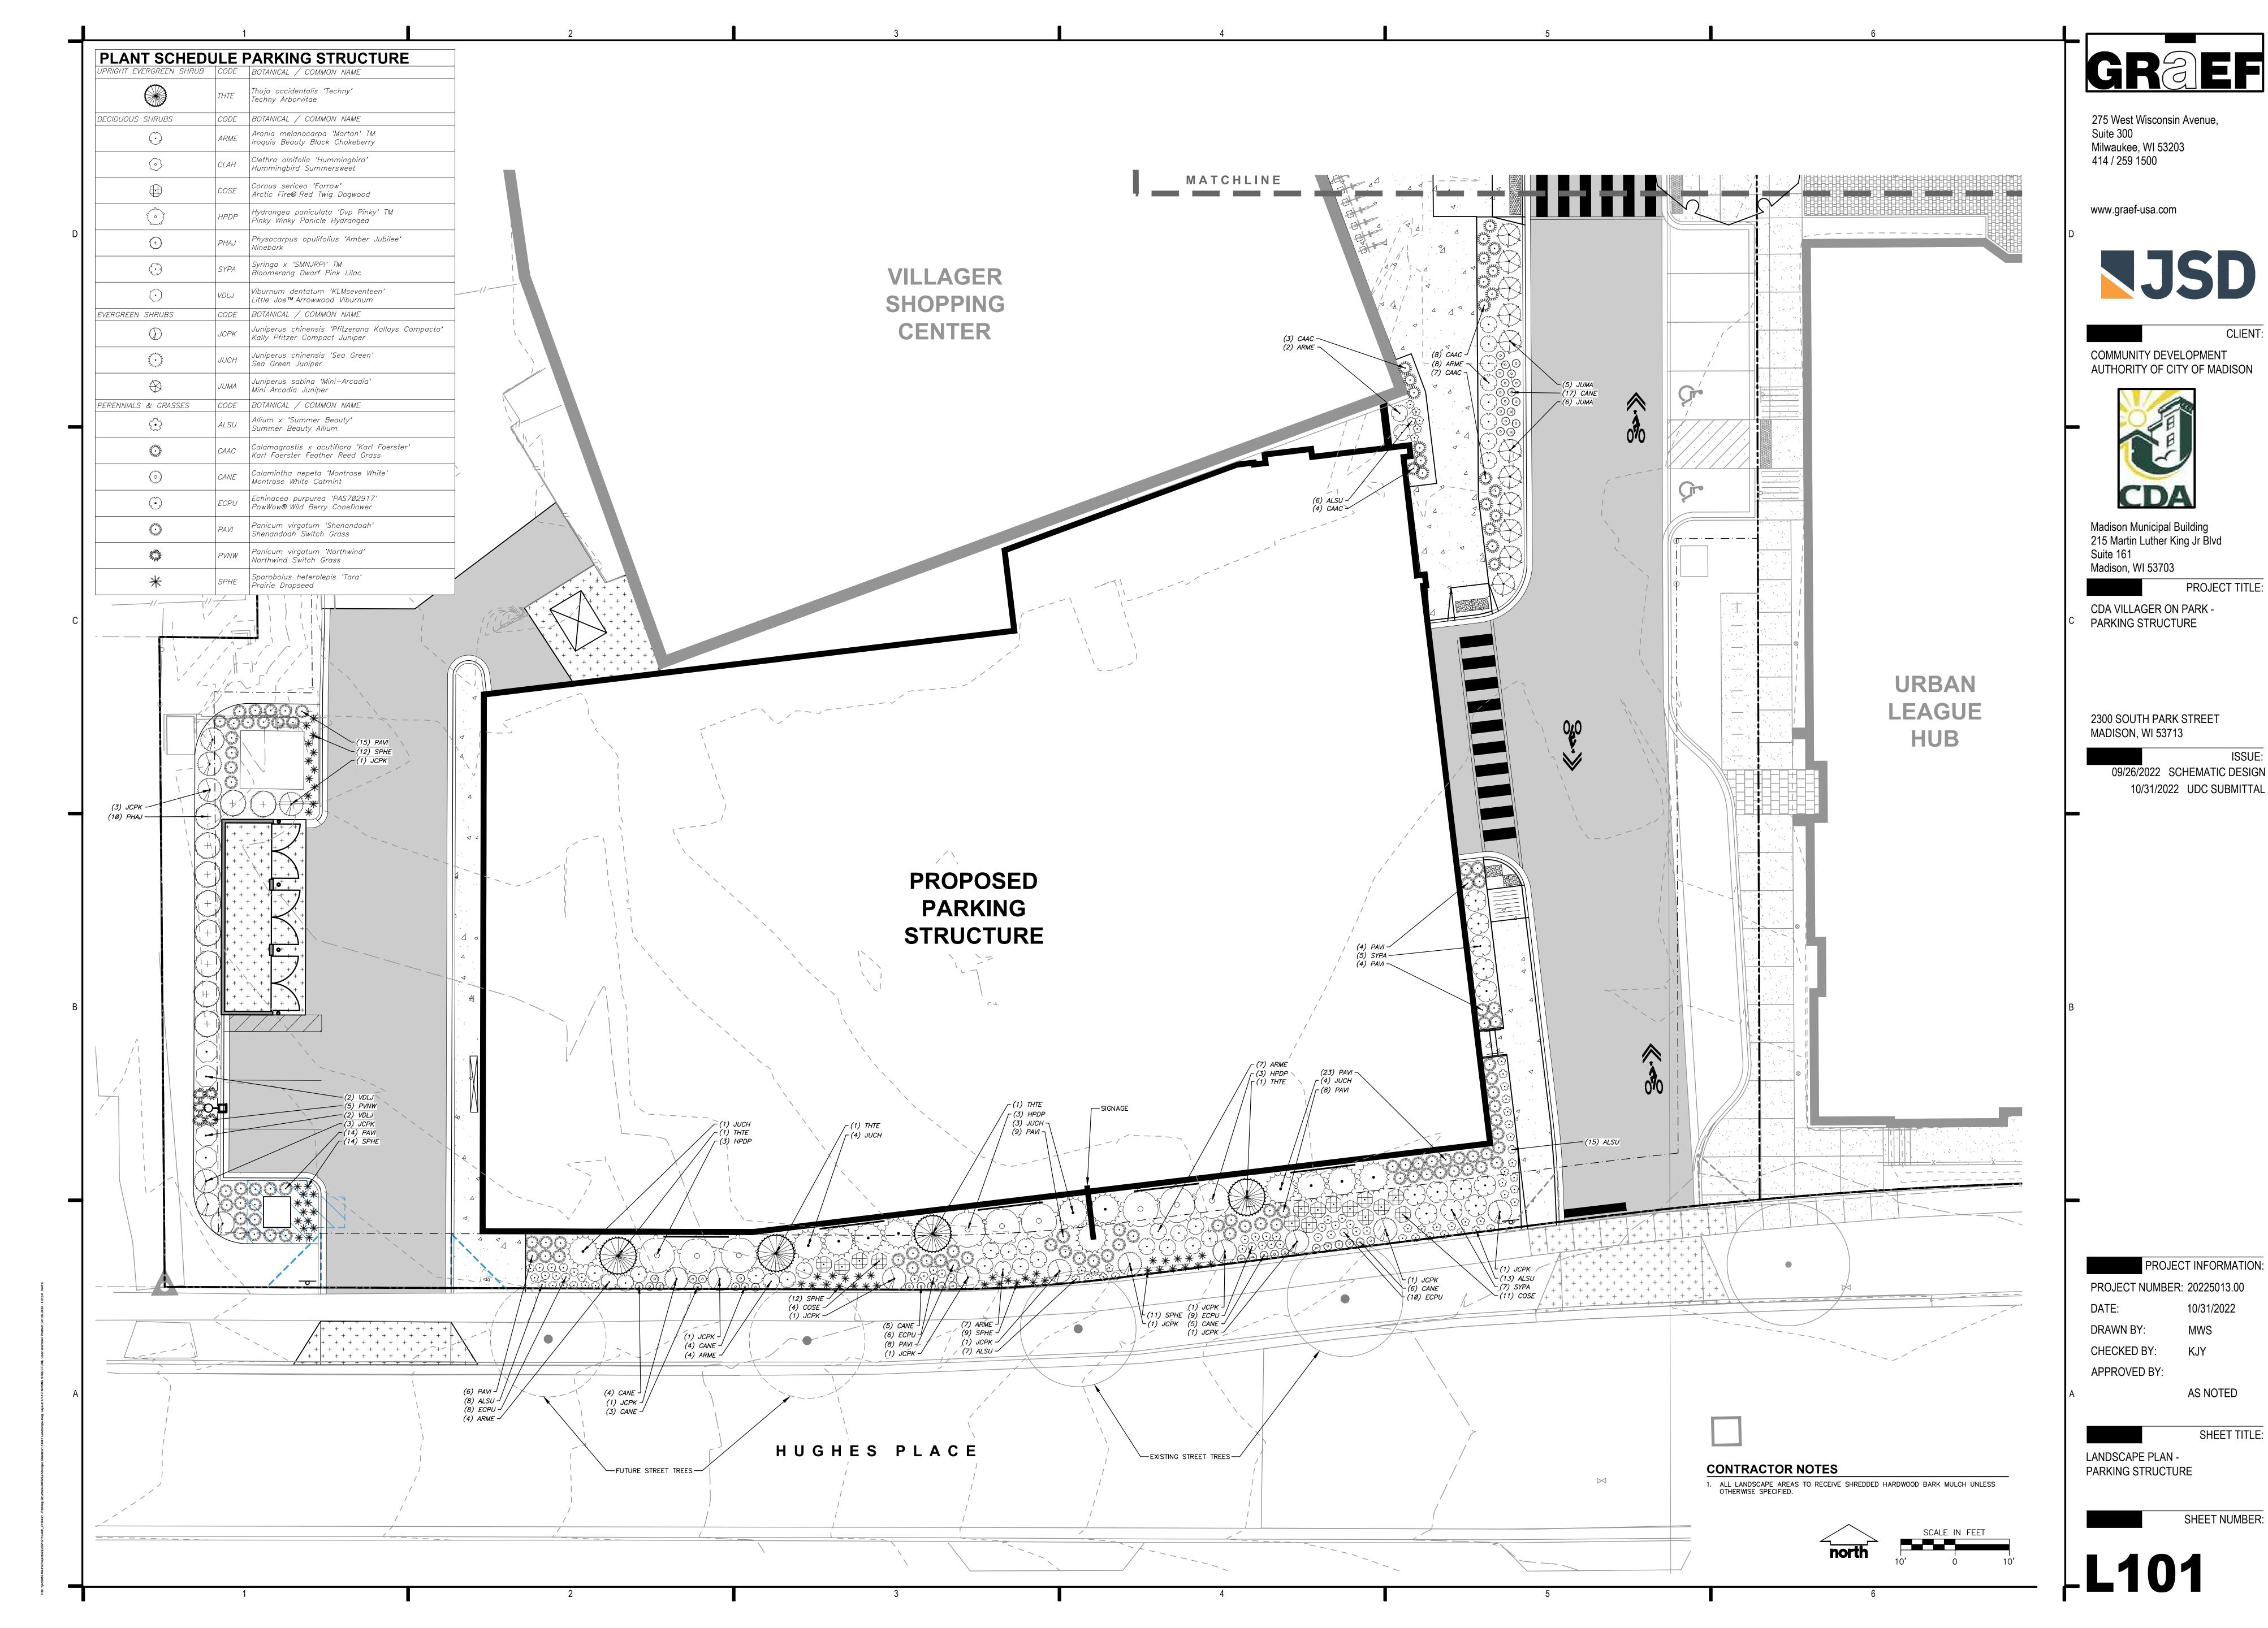
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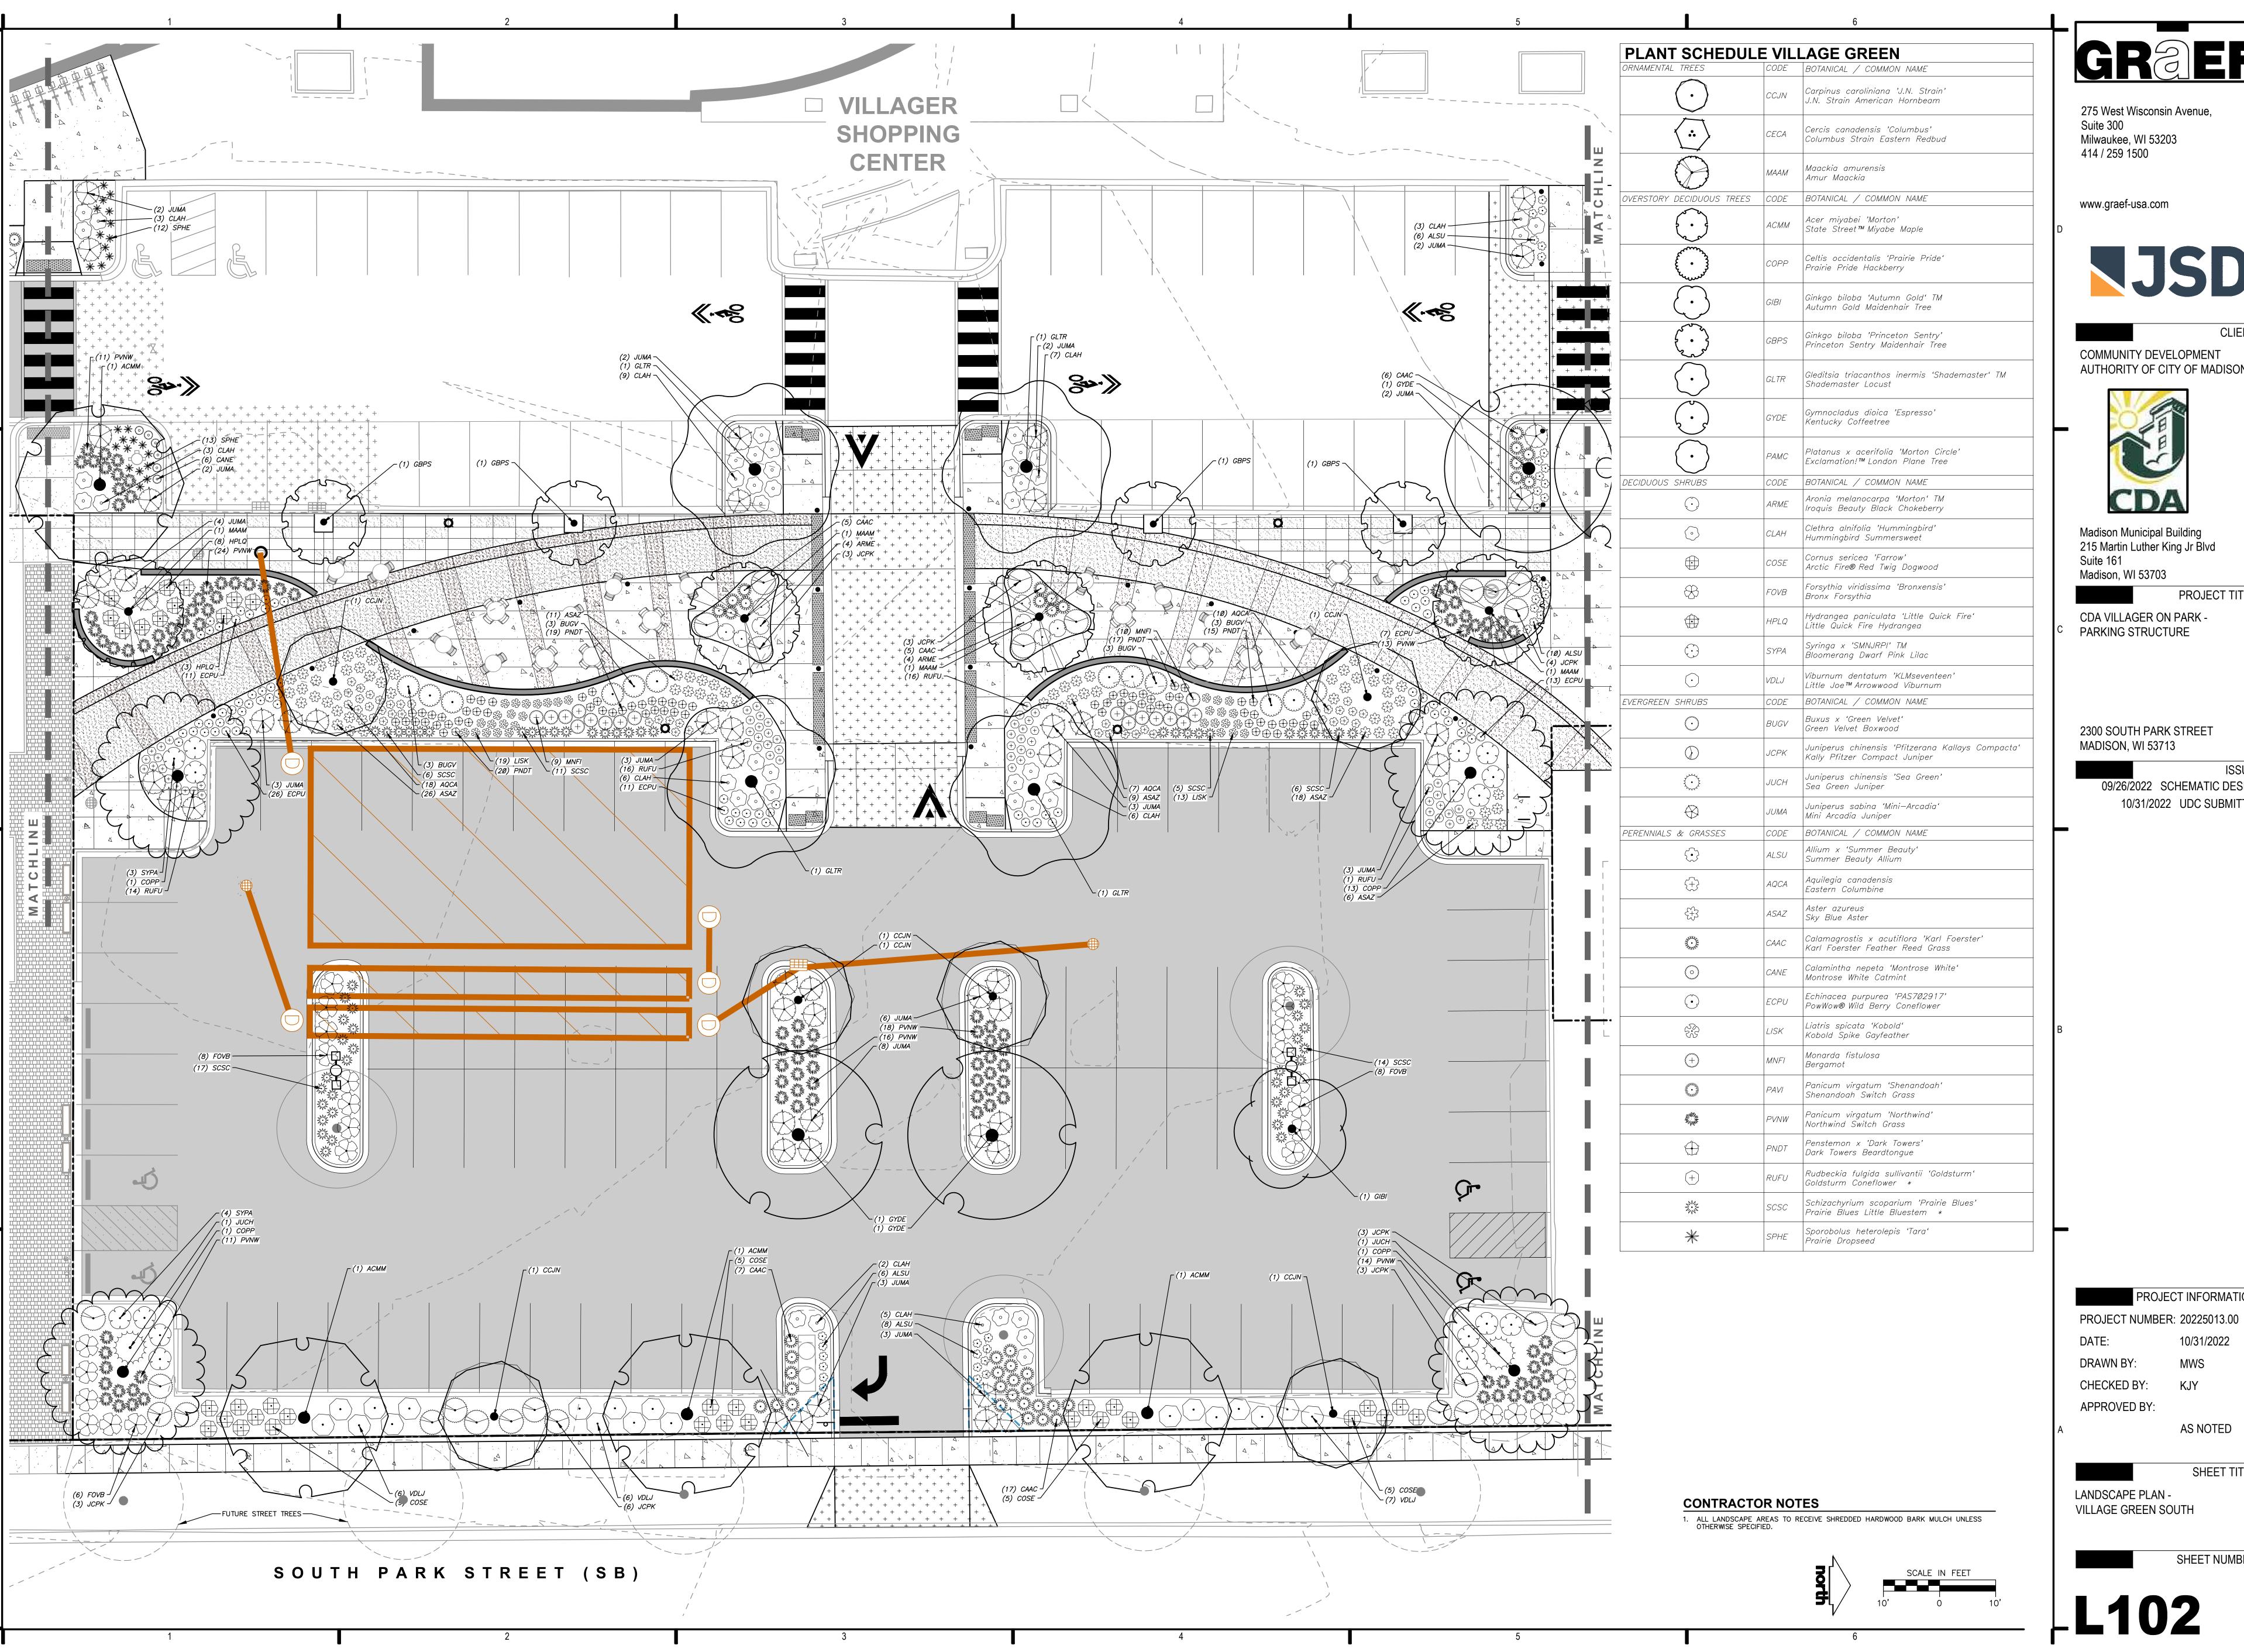
10/31/2022

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Madison Municipal Building 215 Martin Luther King Jr Blvd Suite 161

PROJECT TITLE:

CDA VILLAGER ON PARK -PARKING STRUCTURE

2300 SOUTH PARK STREET

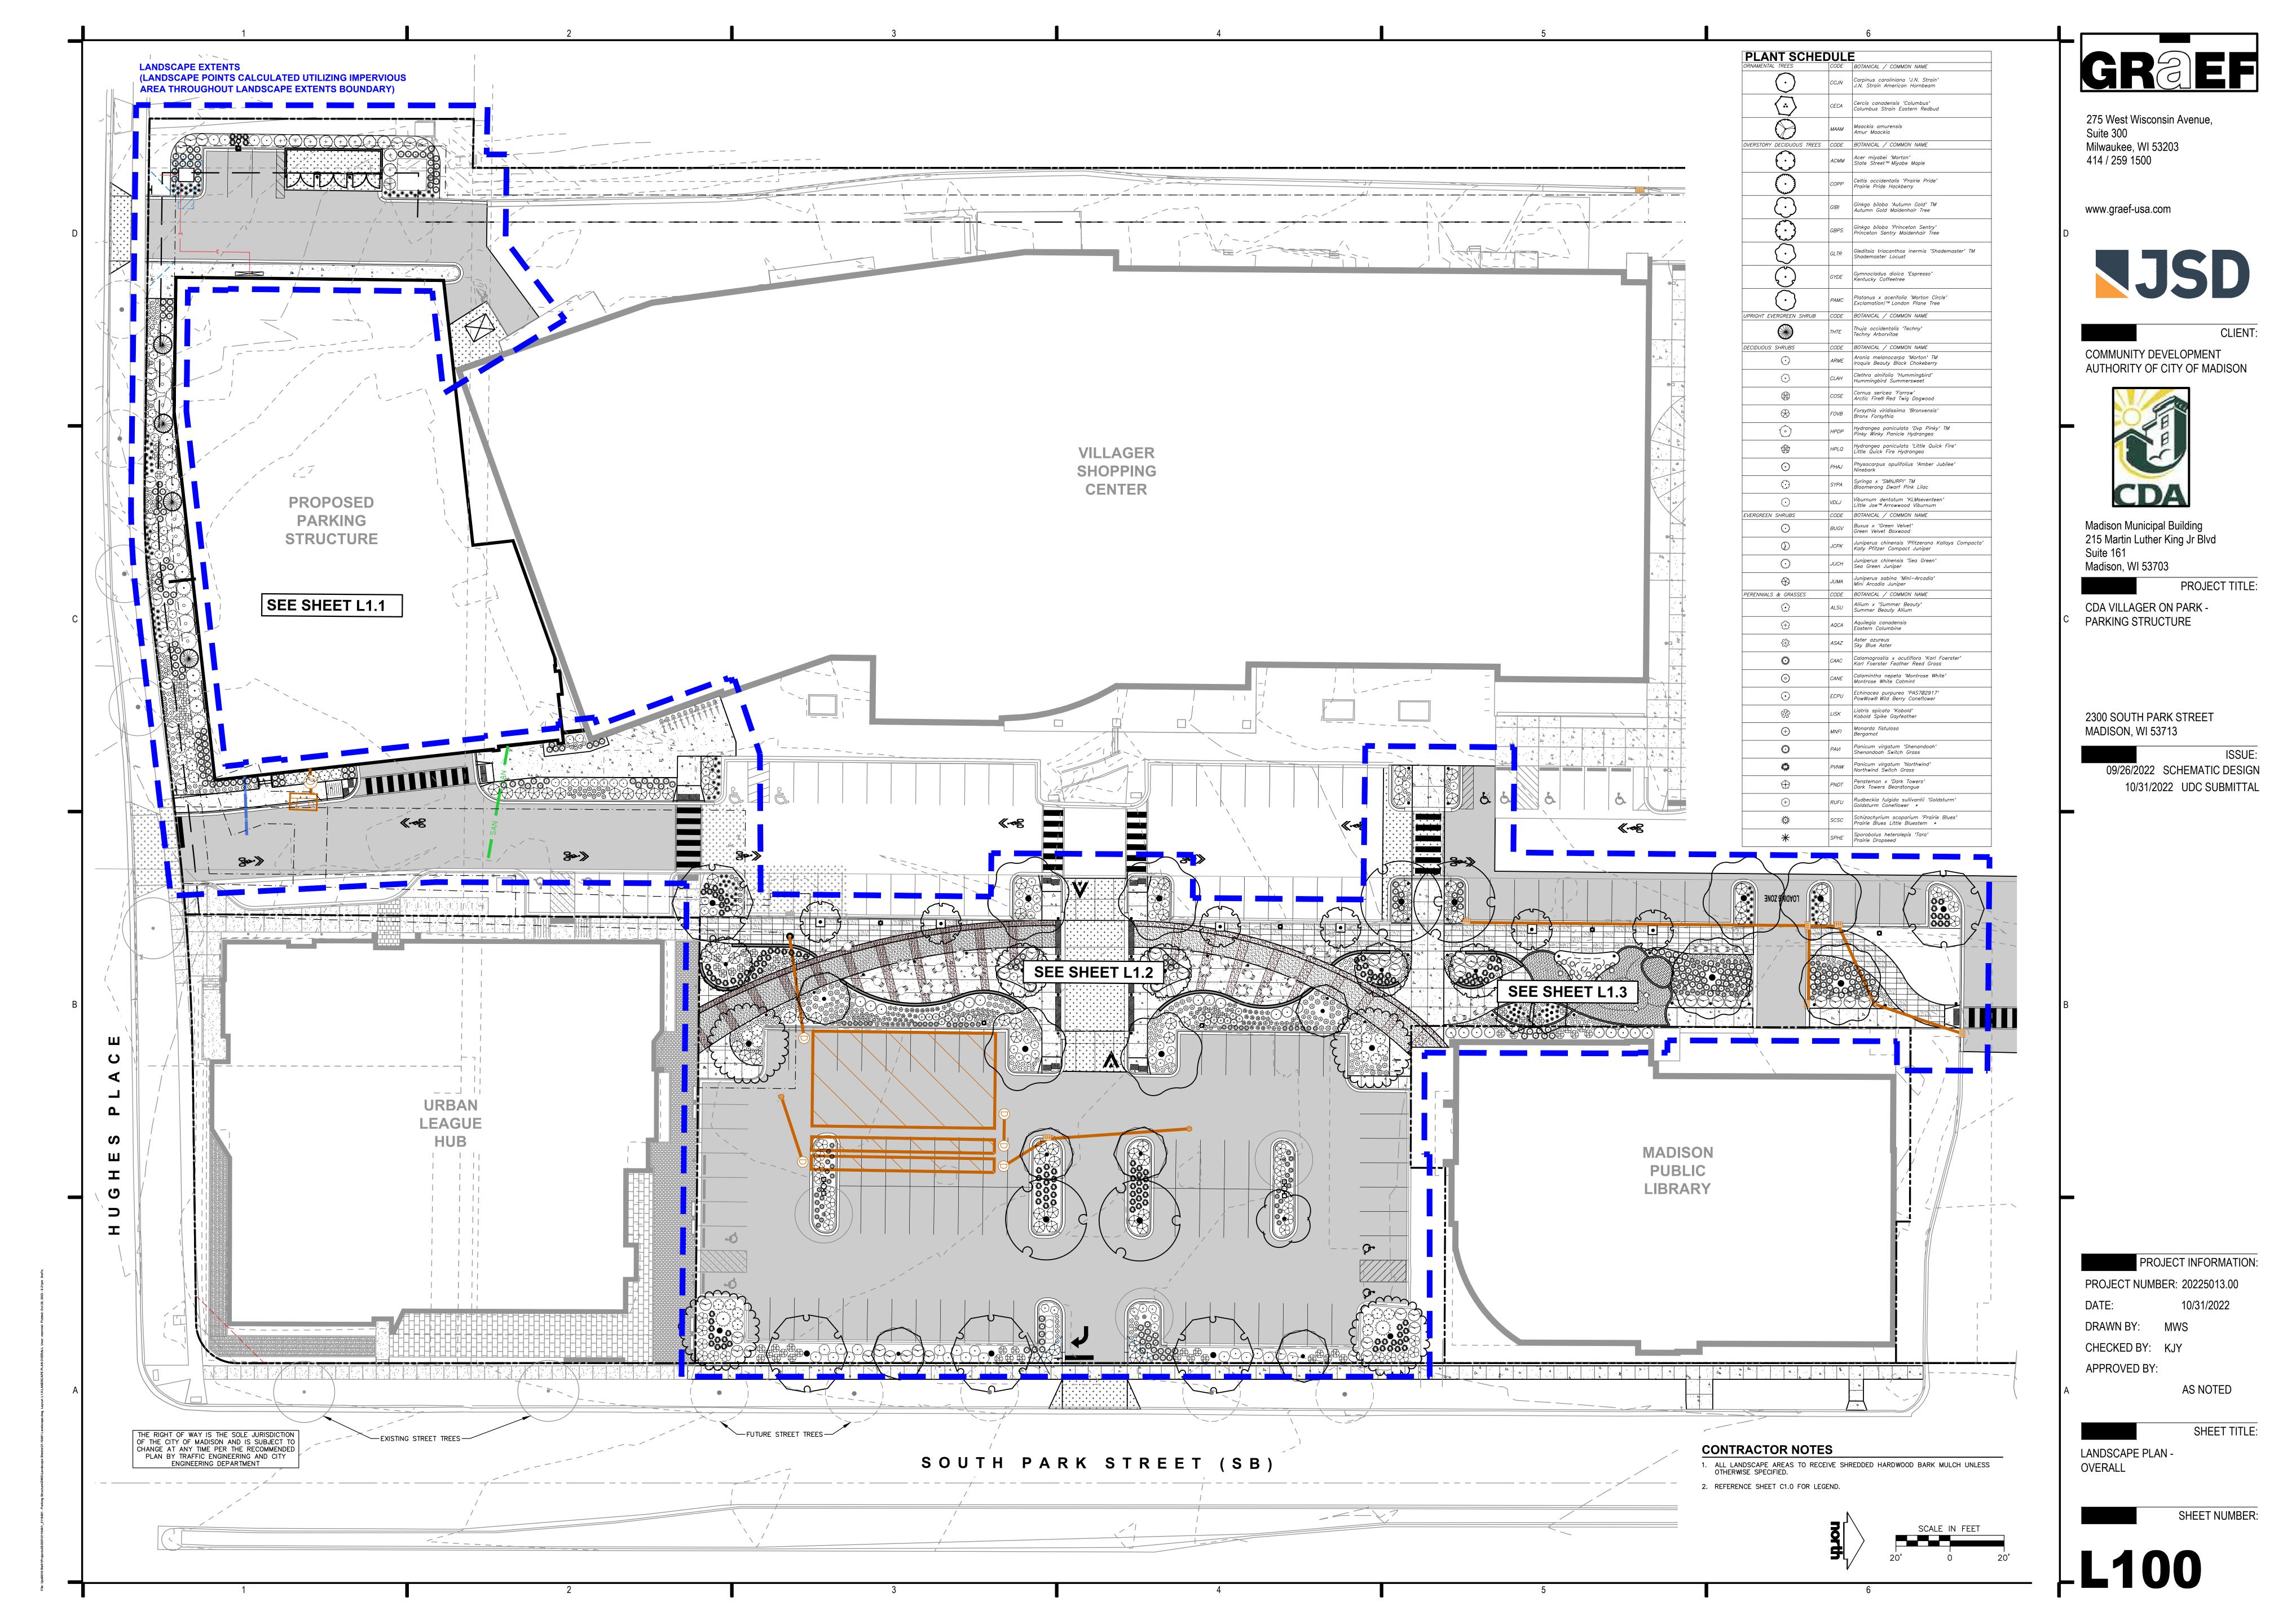09/26/2022 SCHEMATIC DESIGN 10/31/2022 UDC SUBMITTAL

PROJECT INFORMATION:

10/31/2022


CHECKED BY:

APPROVED BY:

AS NOTED

SHEET TITLE:

VILLAGE GREEN SOUTH

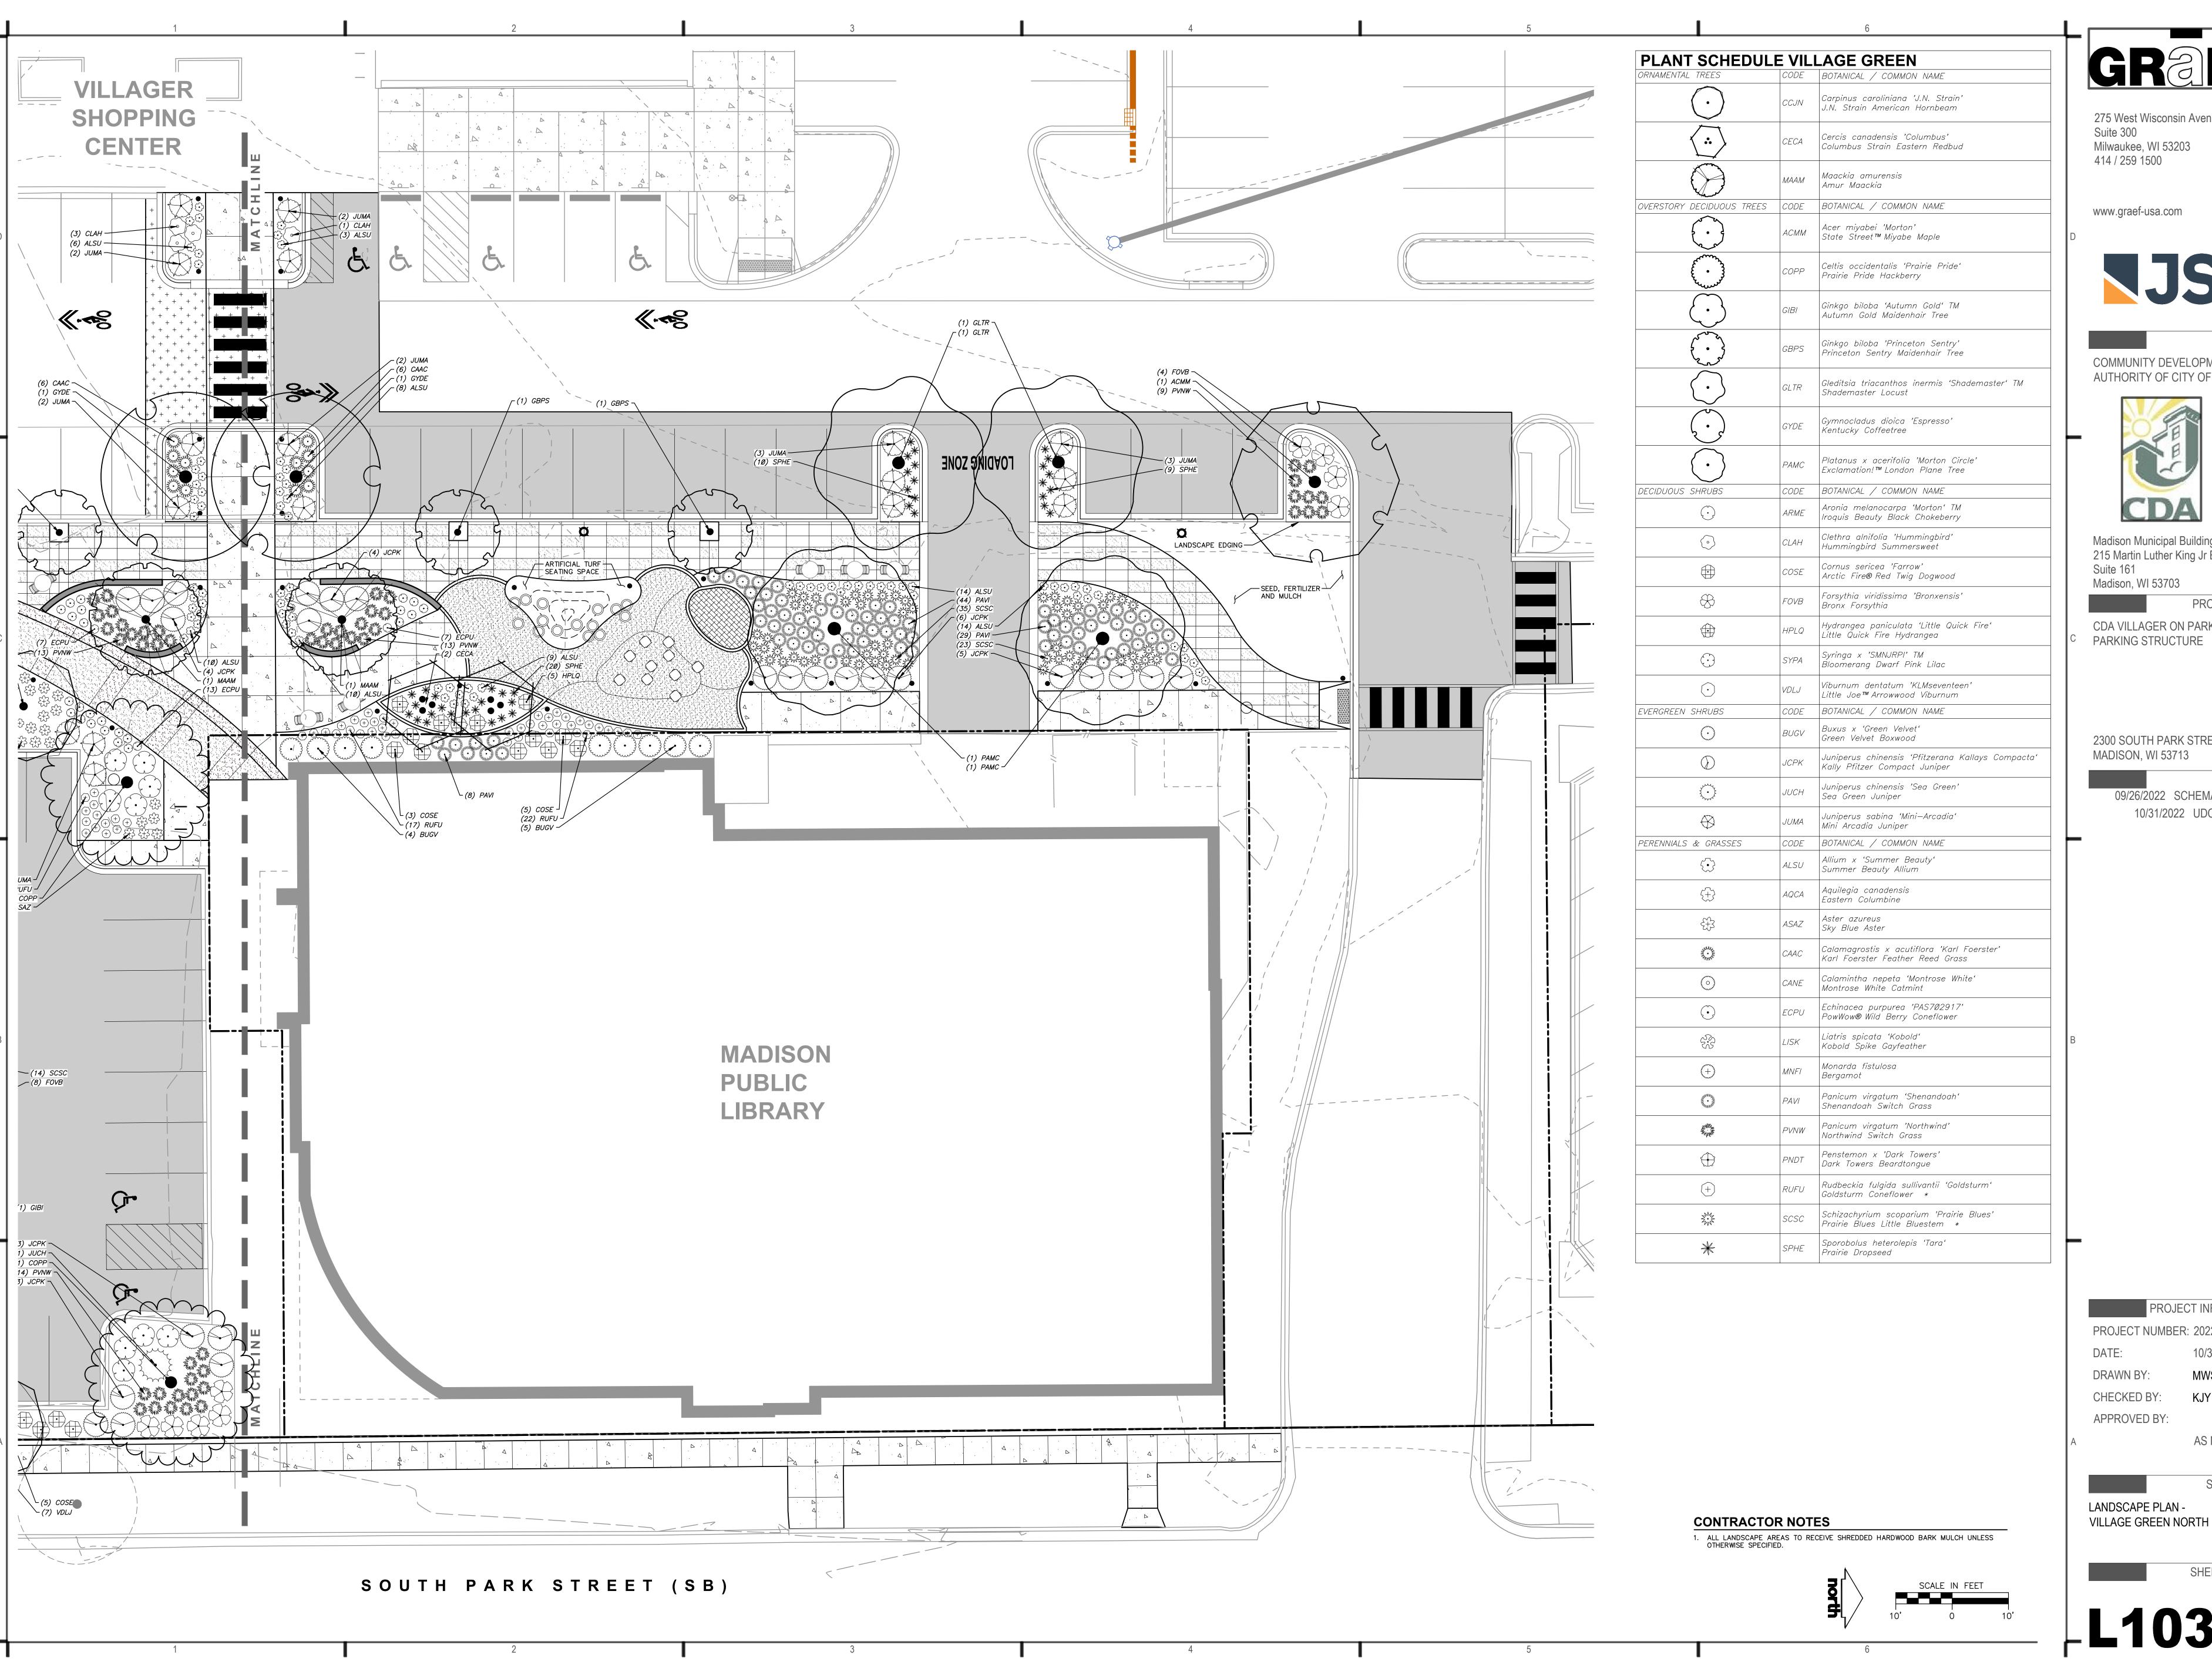

275 West Wisconsin Avenue, Suite 300 Milwaukee, WI 53203



CLIENT:

COMMUNITY DEVELOPMENT AUTHORITY OF CITY OF MADISON



Madison Municipal Building 215 Martin Luther King Jr Blvd

Madison, WI 53703 PROJECT TITLE:

CDA VILLAGER ON PARK -PARKING STRUCTURE

2300 SOUTH PARK STREET

09/26/2022 SCHEMATIC DESIGN 10/31/2022 UDC SUBMITTAL

PROJECT INFORMATION: PROJECT NUMBER: 20225013.00


10/31/2022

CHECKED BY:

APPROVED BY:

AS NOTED

SHEET TITLE: LANDSCAPE PLAN -

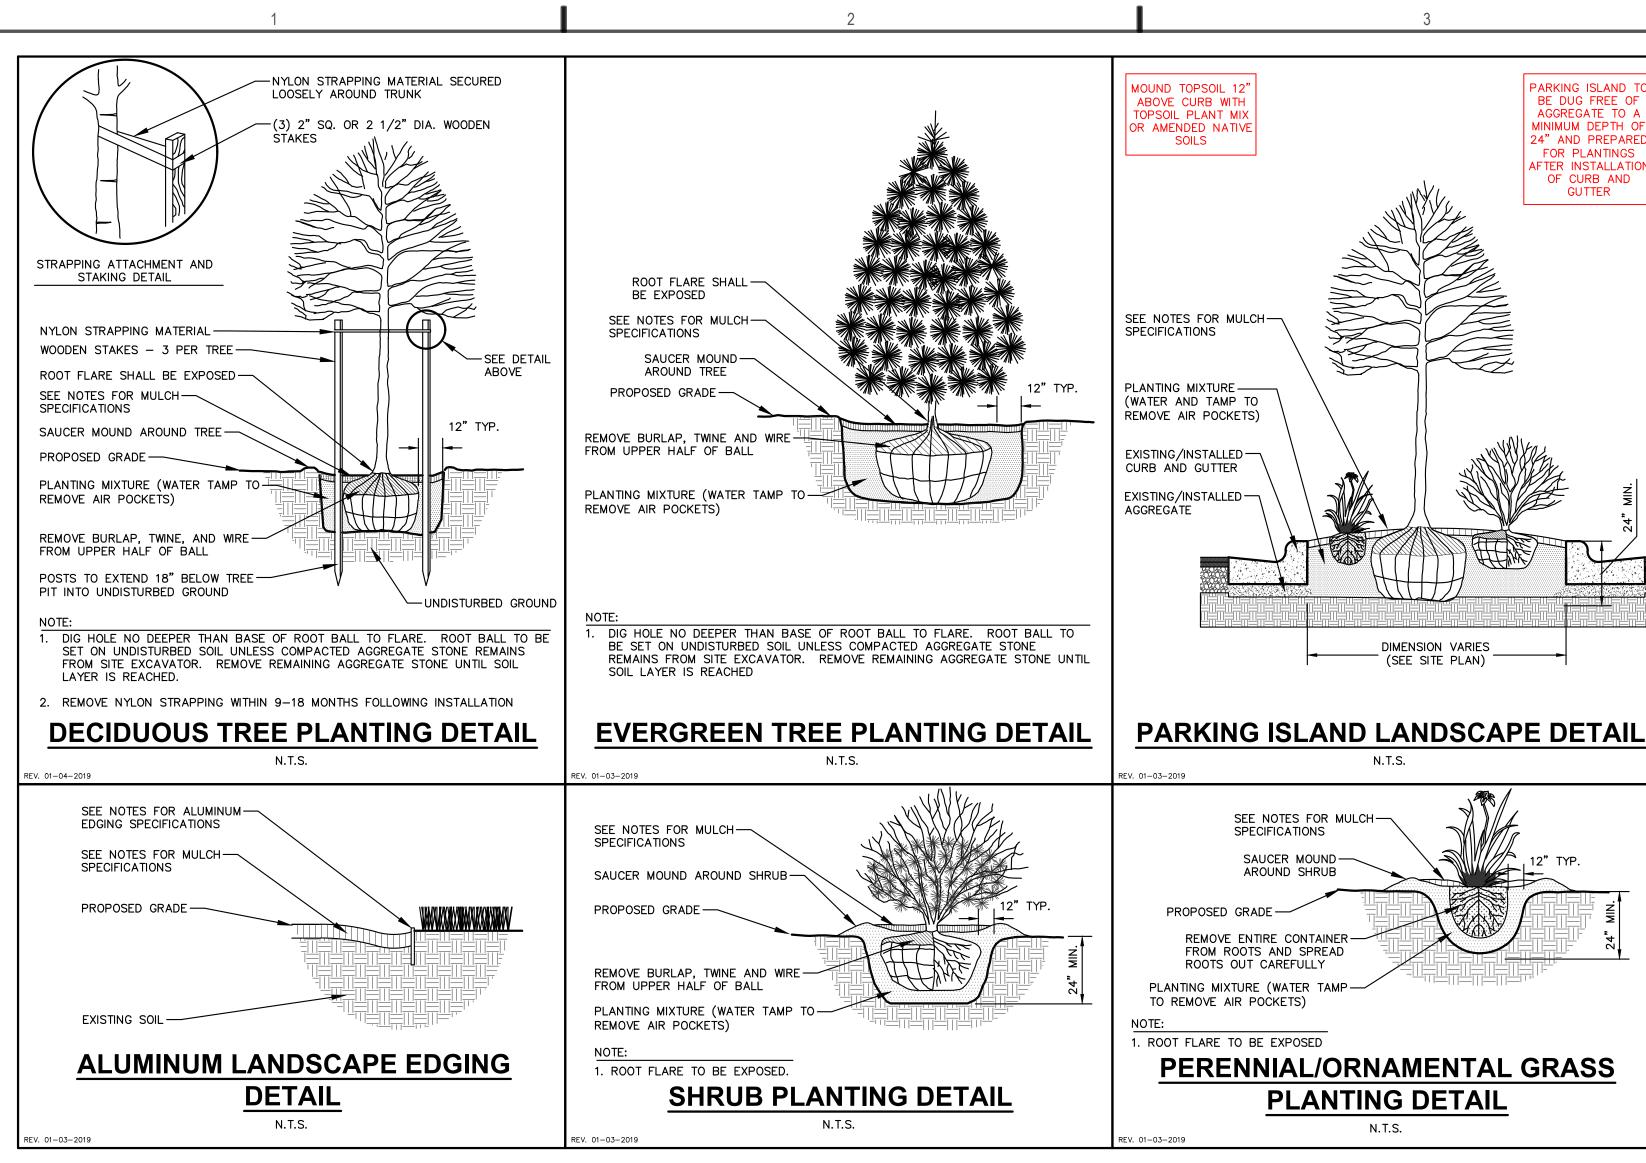

#### LANDSCAPE CALCULATIONS AND DISTRIBUTIONS Required landscaped areas shall be calculated based upon the total developed area of the property. Developed area is defined as that area within a single contiguous boundary which is made up of structures, parking, driveways and docking/loading facilities, but excluding the area of any building footprint at grade, land designated for open space uses such as athletic fields, and undeveloped land area on the same zoning lot. There are three methods for calculating landscape points depending on the size of the lot and Zoning District. (A) For all lots except those described in (B) and (C) below, five (5) landscape points shall be provided for each three hundred (300) square feet of developed area. Total square footage of developed area: 80,544 Square Feet Total landscape points required: \_\_1,342 Points\_\_\_\_ (B) For lots larger than five (5) acres, points shall be provided at five (5) points per three hundred (300) square feet for the first Five (5) developed acres, and one (1) point per one hundred (100) square feet for all additional acres. Total square footage of developed area: Five (5) acres =

First five (5) developed acres = Remainder of developed area: Total landscape points required

Total landscape points required:

(C) For the Industrial – Limited (IL) and Industrial – General (IG) districts, one (1) point shall be provided per one hundred (100) square feet of developed area. Total square footage of developed area:

	MINIMUM INSTALLATION SIZE	POINTS	CREDITS / EXISTING LANDSCAPING		NEW / PROPOSED LANDSCAPING	
PLANT TYPE/ELEMENT			QUANTITY	POINTS ACHIEVED	QUANTITY	POINTS ACHIEVED
OVERSTORY DECIDUOUS TREE	2.5" CAL MIN.	35	0	0	28	980
TALL EVERGREEN TREE	5-6' TALL MIN.	35	0	0	0	0
ORNAMENTAL TREE	1.5" CAL MIN.	15	0	0	13	195
UPRIGHT EVERGREEN SHRUB	3-4' TALL, MIN.	10	0	0	4	40
SHRUB, DECIDUOUS	#3 CONT., MIN. 12"-24"	3	0	0	249	747
SHRUB, EVERGREEN	#3 CONT., MIN. 12"-24"	4	0	0	165	660
ORNAMENTAL GRASS & PERENNIAL	#1 CONT., MIN. 8"-18"	2	0	0	1253	2506
ORNAMENTAL / DECORATIVE FENCING OR WALL	4 POINTS / 10 LF	.4	0	0	0	0
EXISTING SIGNIFICANT SPECIMAN TREE	14 POINTS / CAL. (MAXIMUM 200 POINTS PER TREE)	14	0	0	0	0
LANDSCAPE FURNITURE	5 POINTS PER SEAT (WITHIN PUBLICALLY ACCESSIBLE DEVELOPED AREA. CANNOT COMPRISE MORE THAN 5% OF TOTAL REQUIRED POINTS)	5	0	0	0	0
		SUBTOTAL		0		5,128
	TOTAL NUMBER OF POIN	ITS PROVIDED		5,1	128	

land a		Princeton Sentry Maidenhair Tree			
$\overline{}$	GLTR	Gleditsia triacanthos inermis 'Shademaster' TM Shademaster Locust	B & B	2.5"Cal	6
(·)	GYDE	Gymnocladus dioica 'Espresso' Kentucky Coffeetree	B & B	2"Cal	4
$\overline{(\cdot)}$	PAMC	Platanus x acerifolia 'Morton Circle' Exclamation!™ London Plane Tree	B & B	2"Cal	2
UPRIGHT EVERGREEN SHRUB	CODE	BOTANICAL / COMMON NAME	CONT	SIZE	QTY
	THTE	Thuja occidentalis 'Techny' Techny Arborvitae	B & B	Min. 5' Ht.	4
DECIDUOUS SHRUBS	CODE	BOTANICAL / COMMON NAME	CONT	SIZE	QTY
$\odot$	ARME	Aronia melanocarpa 'Morton' TM Iroquis Beauty Black Chokeberry	#3	Min. 12"-24"	40
	CLAH	Clethra alnifolia 'Hummingbird' Hummingbird Summersweet	#5	Min. 24"-36"	45
	COSE	Cornus sericea 'Farrow' Arctic Fire® Red Twig Dogwood	B & B	Min. 12"-24"	47
	FOVB	Forsythia viridissima 'Bronxensis' Bronx Forsythia	#3	Min. 24" wide	31
	HPDP	Hydrangea paniculata 'Dvp Pinky' TM Pinky Winky Panicle Hydrangea	B & B	Min. 24" Ht.	9
	HPLQ	Hydrangea paniculata 'Little Quick Fire' Little Quick Fire Hydrangea	#3	Min. 12"-24"	16
+	PHAJ	Physocarpus opulifolius 'Amber Jubilee' Ninebark	B & B	Min. 24" Ht.	10
$\odot$	SYPA	Syringa x 'SMNJRPI' TM Bloomerang Dwarf Pink Lilac	B & B	Min. 24" Ht.	28
$\odot$	VDLJ	Viburnum dentatum 'KLMseventeen' Little Joe™ Arrowwood Viburnum	#5	Min. 24"-36"	23
EVERGREEN SHRUBS	CODE	BOTANICAL / COMMON NAME	CONT	SIZE	QTY
$\odot$	BUGV	Buxus x 'Green Velvet' Green Velvet Boxwood	#3	Min. 24" tall	21
$\bigcirc$	JCPK	Juniperus chinensis 'Pfitzerana Kallays Compacta' Kally Pfitzer Compact Juniper	B & B	Min. 12" Wide	58
3	JUCH	Juniperus chinensis 'Sea Green' Sea Green Juniper	B & B	Min. 24" wide	14
$\otimes$	JUMA	Juniperus sabina 'Mini—Arcadia' Mini Arcadia Juniper	#3	Min. 12" Wide	72
PERENNIALS & GRASSES	CODE	BOTANICAL / COMMON NAME	CONT	SIZE	QTY
<b>₹</b>	ALSU	Allium x 'Summer Beauty' Summer Beauty Allium	#1	Min. 8"-18"	145
<del>(+)</del>	AQCA	Aquilegia canadensis Eastern Columbine	#1	Min 8"-18"	41
££3	ASAZ	Aster azureus Sky Blue Aster	#1	Min 8"-18"	70
anner.	CAAC	Calamagrostis x acutiflora 'Karl Foerster' Karl Foerster Feather Reed Grass	#1	Min. 8"-18"	68
(0)	CANE	Calamintha nepeta 'Montrose White' Montrose White Catmint	#1	Min. 8"-18"	50
(•)	ECPU	Echinacea purpurea 'PAS7Ø2917' PowWow® Wild Berry Coneflower	#1	Min 8"-18"	114
S.Y.S	LISK	Liatris spicata 'Kobold' Kobold Spike Gayfeather	#1	Min. 8"-18"	32
(+)	MNFI	Monarda fistulosa Bergamot	#1	Min 8"-18"	19
	PAVI	Panicum virgatum 'Shenandoah' Shenandoah Switch Grass	#1	Min. 8"-18"	172
Solving States	PVNW	Panicum virgatum 'Northwind' Northwind Switch Grass	#1	Min 8"-18"	134
	PNDT	Penstemon x 'Dark Towers' Dark Towers Beardtongue	#1	Min 8"-18"	71
+	RUFU	Rudbeckia fulgida sullivantii 'Goldsturm' Goldsturm Coneflower *	#1	Min. 8"-18"	98
ž.	SCSC	Schizachyrium scoparium 'Prairie Blues' Prairie Blues Little Bluestem *	#1	Min. 8"-18"	117
*	SPHE	Sporobolus heterolepis 'Tara' Prairie Dropseed	#1	Min. 8"-18"	122

PLANT SCHEDULE

••

CODE BOTANICAL / COMMON NAME

Maackia amurensis

Acer miyabei 'Morton'

Prairie Pride Hackberry

State Street™ Miyabe Maple

Celtis occidentalis 'Prairie Pride'

Ginkgo biloba 'Autumn Gold' TM

inkgo biloba 'Princeton Sentry'

Princeton Sentry Maidenhair Tree

Autumn Gold Maidenhair Tree

Amur Maackia

OVERSTORY DECIDUOUS TREES CODE BOTANICAL / COMMON NAME

Carpinus caroliniana 'J.N. Strain'

Columbus Strain Eastern Redbud

J.N. Strain American Hornbeam

Cercis canadensis 'Columbus'

B & B | 1.5"Cal

B & B | 2"Cal

| B & B | 2"Cal

B & B 2.5"Cal

B & B | 2.5"Cal

SIZE

CONT

B & B | 2" Cal (Multi-Stem)

ORNAMENTAL TREES

- GUARANTEE: THE CONTRACTOR SHALL GUARANTEE ALL PLANTS THROUGH ONE (1) YEAR AFTER ACCEPTANCE BY THE OWNER'S REPRESENTATIVE. PLANTS SHALL BE ALIVE AND IN HEALTHY AND FLOURISHING CONDITION AT THE END OF THE GUARANTEE PERIOD. THE CONTRACTOR SHALL REPLACE (AT NO COST TO OWNER) ANY PLANTS THAT ARE DEAD OR NOT IN A VIGOROUS THRIVING CONDITION. REPLACEMENT PLANTS SHALL BE OF THE SAME KIND AND SIZE AS ORIGINALLY SPECIFIED UNLESS OTHERWISE DIRECTED BY OWNER'S REPRESENTATIVE. RESTORE BEDS AS NECESSARY FOLLOWING PLANT REPLACEMENT, INCLUDING BUT NOT LIMITED TO BEDDING, EDGING, MULCH, ETC. REPLACE PLANTS DAMAGED AT TIME OF PLANTING. REPAIR AREAS DISTURBED IN ANY WAY DURING PLANT REPLACEMENT AT NO COST TO OWNER. CONTRACTOR SHALL PROVIDE A ONE (1)-YEAR STRAIGHTENING GUARANTEE FOR ALL TREES.
- CONTRACTOR IS RESPONSIBLE FOR STAKING THE PLANT MATERIALS FOR REVIEW BY OWNER'S REPRESENTATIVE PRIOR TO DIGGING AND PLACEMENT AND SHALL COORDINATE ALL FINE GRADING AND RESTORATION WITH THE GRADING CONTRACTOR.
- MAINTENANCE: (CONTRACTOR) FOR ALL PLANTINGS, SEEDED AND/OR SODDED LAWN AREAS: THE CONTRACTOR SHALL MAINTAIN ALL PLANTINGS AND LAWN AREAS FOR A MINIMUM TIME PERIOD OF 60 DAYS, UNTIL FINAL ACCEPTANCE BY OWNER'S REPRESENTATIVE. THE CONTRACTOR IS RESPONSIBLE FOR ADEQUATELY WATERING PLANTS AND LAWN/TURFGRASS DURING THIS 60 DAY ESTABLISHMENT PERIOD. CONTRACTOR IS RESPONSIBLE FOR THE ESTABLISHMENT OF HEALTHY VIGOROUS PLANT MATERIALS AND LAWN/TURFGRASS GROWTH. CONTRACTOR IS ALSO RESPONSIBLE FOR ANY PRUNING OF PLANT MATERIALS, AND SHAPING AND/OR REPLACEMENT OR SUPPLEMENT OF DEFICIENT SHREDDED HARDWOOD BARK MULCH DURING THIS PERIOD. LONG TERM PLANT MATERIALS AND LAWN/TURFGRASS MAINTENANCE AND ANY PROGRAM FOR SUCH IS THE RESPONSIBILITY OF THE OWNER. ALL PLANTINGS AND LAWN/TURFGRASS AREAS SHALL BE MAINTAINED IN A MANICURED CONDITION UNTIL THE TIME WHEN THE OWNER'S ACCEPTANCE IS GIVEN.

MAINTENANCE: (OWNER) THE OWNER IS RESPONSIBLE FOR THE CONTINUED MAINTENANCE, REPAIR AND REPLACEMENT OF ALL LANDSCAPING MATERIALS AND WEED BARRIER FABRIC AS NECESSARY FOLLOWING THE ONE (1) YEAR CONTRACTOR GUARANTEE PERIOD. **GENERAL NOTES** 

GENERAL: ALL WORK IN THE R-O-W AND PUBLIC EASEMENTS SHALL BE IN ACCORDANCE WITH LOCAL MUNICIPAL REQUIREMENTS. JSD SHALL BE HELD HARMLESS AND DOES NOT WARRANT ANY DEVIATIONS BY THE OWNER/CONTRACTOR FROM THE APPROVED CONSTRUCTION PLANS THAT MAY RESULT IN DISCIPLINARY ACTIONS BY ANY OR ALL REGULATORY AGENCIES. LOCATE ALL UTILITIES PRIOR TO CONSTRUCTION. THE CONTRACTOR IS RESPONSIBLE FOR REPAIRING ANY DAMAGE DONE TO UTILITIES. CONTRACTOR MUST CALL 1-800-242-8511 FOR UTILITY LOCATIONS AT LEAST THREE DAYS PRIOR TO DIGGING. HAND DIG AND INSTALL ALL PLANTS THAT ARE NEAR EXISTING UTILITIES. PROTECT PREVIOUSLY INSTALLED WORK OF OTHER TRADES. CONTRACTOR IS RESPONSIBLE FOR STAKING THE PLANT MATERIALS FOR REVIEW BY OWNER PRIOR TO DIGGING AND PLACEMENT AND SHALL COORDINATE ALL FINE GRADING AND RESTORATION WITH THE GRADING CONTRACTOR.

2. DELIVERY AND HANDLING: DO NOT DELIVER MORE PLANT MATERIALS THAN CAN BE PLANTED IN ONE DAY, UNLESS ADEQUATE, APPROPRIATE AND SECURE STORAGE IS PROVIDED AND APPROVED BY OWNER'S REPRESENTATIVE. AT ALL TIMES, PROTECT ALL PLANT MATERIALS FROM WIND AND DIRECT SUN. DELIVER PLANTS WITH LEGIBLE IDENTIFICATION LABELS. PROTECT PLANTS DURING DELIVERY AND DO NOT PRUNE PRIOR TO DELIVERY. ALL TREES AND SHRUBS SHALL BE PLANTED ON THE DAY OF DELIVERY; IF THIS IS NOT POSSIBLE, PROTECT THE PLANT MATERIALS NOT PLANTED BY STORING THEM IN A SHADED, SECURE AREA, PROTECTING THE ROOT MASS WITH WET SOIL, MULCH, HAY OR OTHER SUITABLE MEDIUM. CONTRACTOR TO KEEP ALL PLANT MATERIALS ADEQUATELY WATERED TO PREVENT ROOT DESICCATION. DO NOT REMOVE CONTAINER GROWN STOCK FROM CONTAINERS BEFORE TIME OF PLANTING. DO NOT PICK UP CONTAINER OR BALLED PLANTS BY STEM OR ROOTS. ALL PLANTS SHALL BE LIFTED AND HANDLED FROM THE BOTTOM OF THE CONTAINER OR BALL. PERFORM ACTUAL PLANTING ONLY WHEN WEATHER AND SOIL CONDITIONS ARE SUITABLE IN ACCORDANCE WITH

LOCALLY ACCEPTED BEST HORTICULTURAL PRACTICES.

MATERIALS - PLANTS: ALL PLANTS SHALL CONFORM TO THE LATEST VERSION OF THE AMERICAN STANDARD FOR NURSERY STOCK ANSI Z60.1. PLANTS SHALL BE TRUE TO SPECIES AND VARIETY SPECIFIED AND NURSERY GROWN IN ACCORDANCE WITH GOOD HORTICULTURAL PRACTICES UNDER CLIMATIC CONDITIONS SIMILAR TO THOSE IN THE LOCALITY OF THE PROJECT FOR AT LEAST 2 YEARS. PLANTS SHALL BE FRESHLY DUG (DURING THE MOST RECENT FAVORABLE HARVEST SEASON). PLANTS SHALL BE SO TRAINED IN DEVELOPMENT AND APPEARANCE AS TO BE UNQUESTIONABLY SUPERIOR IN FORM, COMPACTNESS, AND SYMMETRY. PLANTS SHALL BE SOUND, HEALTHY, VIGOROUS, WELL BRANCHED AND DENSELY FOLIATED WHEN IN LEAF, AND FREE OF DISEASE AND INSECTS (ADULT EGGS, PUPAE OR LARVAE). THEY SHALL HAVE HEALTHY, WELL-DEVELOPED ROOT SYSTEMS AND SHALL BE FREE FROM PHYSICAL DAMAGE OR OTHER CONDITIONS THAT WOULD PREVENT THRIVING GROWTH OR PREMATURE MORTALITY. PLANTS SHALL BE OF THE HIGHEST QUALITY, POSSESS TYPICAL GROWTH HABITS AND FORM FOR THEIR SPECIES AND BE FREE OF INJURY. PARKWAY TREES AND PARKING LOT TREES SHALL HAVE A MINIMUM BRANCHING HEIGHT OF SIX (6) FEET ABOVE THE GROUND TO ALLOW ADEQUATE VISUAL AND PHYSICAL CLEARANCE.

4. PRUNING: THE CONTRACTOR SHALL PRUNE ALL TREES AND REPAIR ANY INJURIES THAT OCCURRED DURING THE PLANTING PROCESS, DOUBLE LEADERS, DEAD BRANCHES, AND LIMBS DAMAGED OR BROKEN DURING THE PLANTING PROCESS. SHALL BE PRUNED. THIS SHALL BE THE ONLY PRUNING ALLOWED AT PLANTING. PRUNING SHALL CONFORM TO THE LATEST VERSION OF THE AMERICAN STANDARD FOR TREE CARE OPERATIONS, ANSI A300. PRUNE TREES IN ACCORDANCE WITH NAA GUIDELINES. DO NOT TOP TREES. PRUNE SHRUBS ACCORDING TO STANDARD HORTICULTURAL PRACTICES. ON CUTS OVER 3/4" IN DIAMETER AND BRUISES OR SCARS ON BARK, TRACE THE INJURED CAMBIUM LAYER BACK TO LIVING TISSUE AND REMOVE. SMOOTH AND SHAPE WOUNDS SO

AS NOT TO RETAIN WATER. TREAT THE AREA WITH AN APPROVED INCONSPICUOUS LATEX BASED ANTISEPTIC TREE PAINT, IF PRUNING OCCURS "IN SEASON". DO NOT PRUNE ANY OAK TREES DURING THE MONTHS FROM APRIL TO OCTOBER. 5. CLEANUP: THE WORK AREA SHALL BE KEPT SAFE AND NEAT AT ALL TIMES. DISPOSED OF EXCESS SOIL. REMOVE ALL CUTTINGS AND WASTE MATERIALS. SOIL AND BRANCHES. BIND AND WRAP THESE MATERIALS, ANY REJECTED PLANTS, AND ANY OTHER DEBRIS RESULTING FROM ALL PLANTING TASKS AND PROMPTLY CLEAN UP AND REMOVE FROM THE PROJECT SITE. UNDER NO CIRCUMSTANCES SHALL THE ACCUMULATION OF SOIL, BRANCHES OR OTHER DEBRIS BE ALLOWED UPON A PUBLIC

PROPERTY IN SUCH A MANNER AS TO RESULT IN A PUBLIC SAFETY HAZARD OR DAMAGE. LIKEWISE,

UNDER NO CIRCUMSTANCES SHALL ANY DEBRIS OR INCIDENTAL MATERIALS BE ALLOWED UPON

ADJACENT PRIVATE PROPERTY 6. ANY SUBSTITUTIONS IN PLANT TYPE, LOCATION, OR SIZE SHALL BE APPROVED BY LANDSCAPE

7. CONTRACTOR TO VERIFY PLANT MATERIAL QUANTITIES AND SQUARE FOOTAGES. QUANTITIES SHOWN ON PLAN TAKE PRECEDENCE OVER THOSE ON SCHEDULE.

#### LANDSCAPE MATERIAL NOTES

ARCHITECT PRIOR TO INSTALLATION.

1. MATERIALS - PLANTING MIXTURE: ALL HOLES EXCAVATED FOR TREES, SHRUBS, PERENNIALS AND ORNAMENTAL GRASSES SHALL BE BACKFILLED WITH TWO (2) PARTS TOPSOIL, ONE (1) PART SAND AND ONE (1) PART COMPOST. SOIL MIXTURE SHALL BE WELL BLENDED PRIOR TO INSTALLATION.

2. MATERIALS - TOPSOIL: TOPSOIL TO BE CLEAN, FRIABLE LOAM FROM A LOCAL SOURCE, FREE FROM STONES OR DEBRIS OVER 3/4" IN DIAMETER. AND FREE FROM TOXINS OR OTHER DELETERIOUS MATERIALS. TOPSOIL SHALL HAVE A pH VALUE BETWEEN 6 AND 7. TOPSOIL AND PLANTING SOIL SHALL BE TESTED TO ENSURE CONFORMANCE WITH THESE SPECIFICATIONS AND SHALL BE AMENDED TO MEET THESE SPECIFICATIONS. PROVIDE TEST RESULTS TO OWNER'S REPRESENTATIVE PRIOR TO PLACEMENT. DO NOT PLACE FROZEN OR MUDDY TOPSOIL. APPLY SOIL AMENDMENTS TO ALL LANDSCAPE AREAS PER SOIL TEST.

3. MATERIALS - SHREDDED HARDWOOD BARK MULCH: ALL PLANTING AREAS LABELED ON PLAN SHALL RECEIVE CERTIFIED WEED FREE SHREDDED HARDWOOD BARK MULCH INSTALLED TO A MINIMUM AND CONSISTENT DEPTH OF 3-INCHES. SHREDDED HARDWOOD BARK MULCH SIZE & COLOR TO BE APPROVED BY OWNER'S REPRESENTATIVE PRIOR TO INSTALLATION. FERTILIZER SHALL BE IN ACCORDANCE WITH APPLICABLE LOCAL, COUNTY AND STATE REQUIREMENTS. SHREDDED HARDWOOD BARK MULCH AREAS SHALL NOT RECEIVE WOVEN WEED BARRIER FABRIC.

4. MATERIALS - TREE & SHRUB RINGS: ALL TREES AND/OR SHRUBS PLANTED IN SEEDED LAWN AREAS TO BE INSTALLED WITH A MINIMUM 4' DIAMETER SHREDDED HARDWOOD BARK MULCH TREE RING SPREAD TO A CONSISTENT DEPTH OF 3-INCHES. ALL TREE RINGS SHOULD BE INSTALLED WITH A 5" DEPTH SHOVEL CUT EDGE, ANGLED 45 DEGREES INTO SOIL AT A 5' DIAMETER ABOUT THE CENTER OF THE TREE PLANTING. A PRE-EMERGENT GRANULAR HERBICIDE WEED-PREVENTER SHOULD BE MIXED WITH MULCH USED TO INSTALL TREE RING AS WELL AS TOPICALLY APPLIED TO COMPLETED INSTALLATION OF TREE RING.

5. MATERIALS - ALUMINUM EDGING: EDGING SHALL BE 1/8" X 4", ALUMINUM EDGING, MILL FINISH. OWNER'S REPRESENTATIVE SHALL APPROVE PRODUCT SPECIFICATION PROVIDED BY LANDSCAPE

## SEEDING, SODDING, & POND VEGETATION NOTES

1. MATERIALS - TURFGRASS SEED: DISTURBED LAWN AREAS LABELED ON PLAN AS SUCH, SHALL RECEIVE 6" OF TOPSOIL AND EARTH CARPET'S "MADISON PARKS" GRASS SEED, OR EQUIVALENT AS APPROVED BY THE OWNER'S REPRESENTATIVE, INSTALLED PER MANUFACTURER'S RECOMMENDATIONS. IN ADDITION TO TURFGRASS SEED, ANNUAL RYE SHALL BE APPLIED TO ALL DISTURBED AREAS AT A RATE OF 1 1/2 LBS PER 1000 SQUARE FEET. FERTILIZE AND MULCH PER MANUFACTURER'S RECOMMENDATIONS. MULCH SHALL BE CERTIFIED NOXIOUS WEED SEED-FREE

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414 / 259 1500



CLIENT:

COMMUNITY DEVELOPMENT **AUTHORITY OF CITY OF MADISON** 



Madison Municipal Building 215 Martin Luther King Jr Blvd Suite 161 Madison, WI 53703

PROJECT TITLE:

CDA VILLAGER ON PARK PARKING STRUCTURE

2300 SOUTH PARK STREET MADISON, WI 53713

> 09/26/2022 SCHEMATIC DESIGN 10/31/2022 UDC SUBMITTAL


ROJECT INFORMATION:

PROJECT NUMBER: 20225013.00

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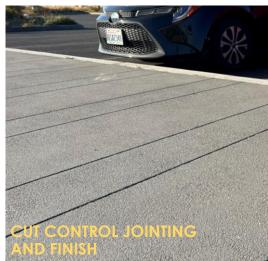
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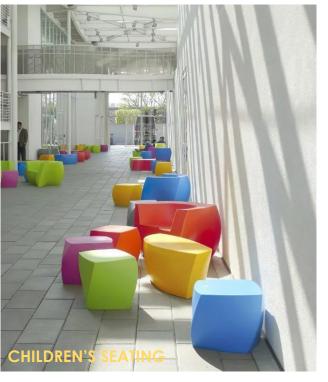
LANDSCAPE DETAILS & NOTES



# **SITE ELEMENTS**

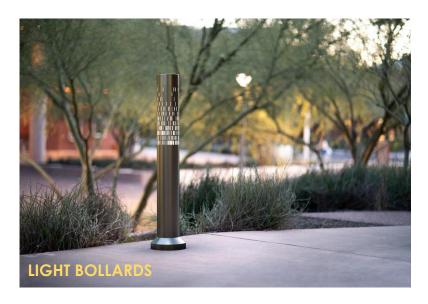











VILLAGE GREEN - LAND USE/UDC INITIAL FINAL
























VILLAGE GREEN – LAND USE/UDC INITIAL FINAL



# VILLAGE ON PARK - PARKING STRUCTURE

UDC INITIAL / FINAL

# 0.5 CONTEXTUAL SITE INFORMATION: PHOTOGRAPHS & LAYOUT OF ADJACENT BUILDINGS & STRUCTURES

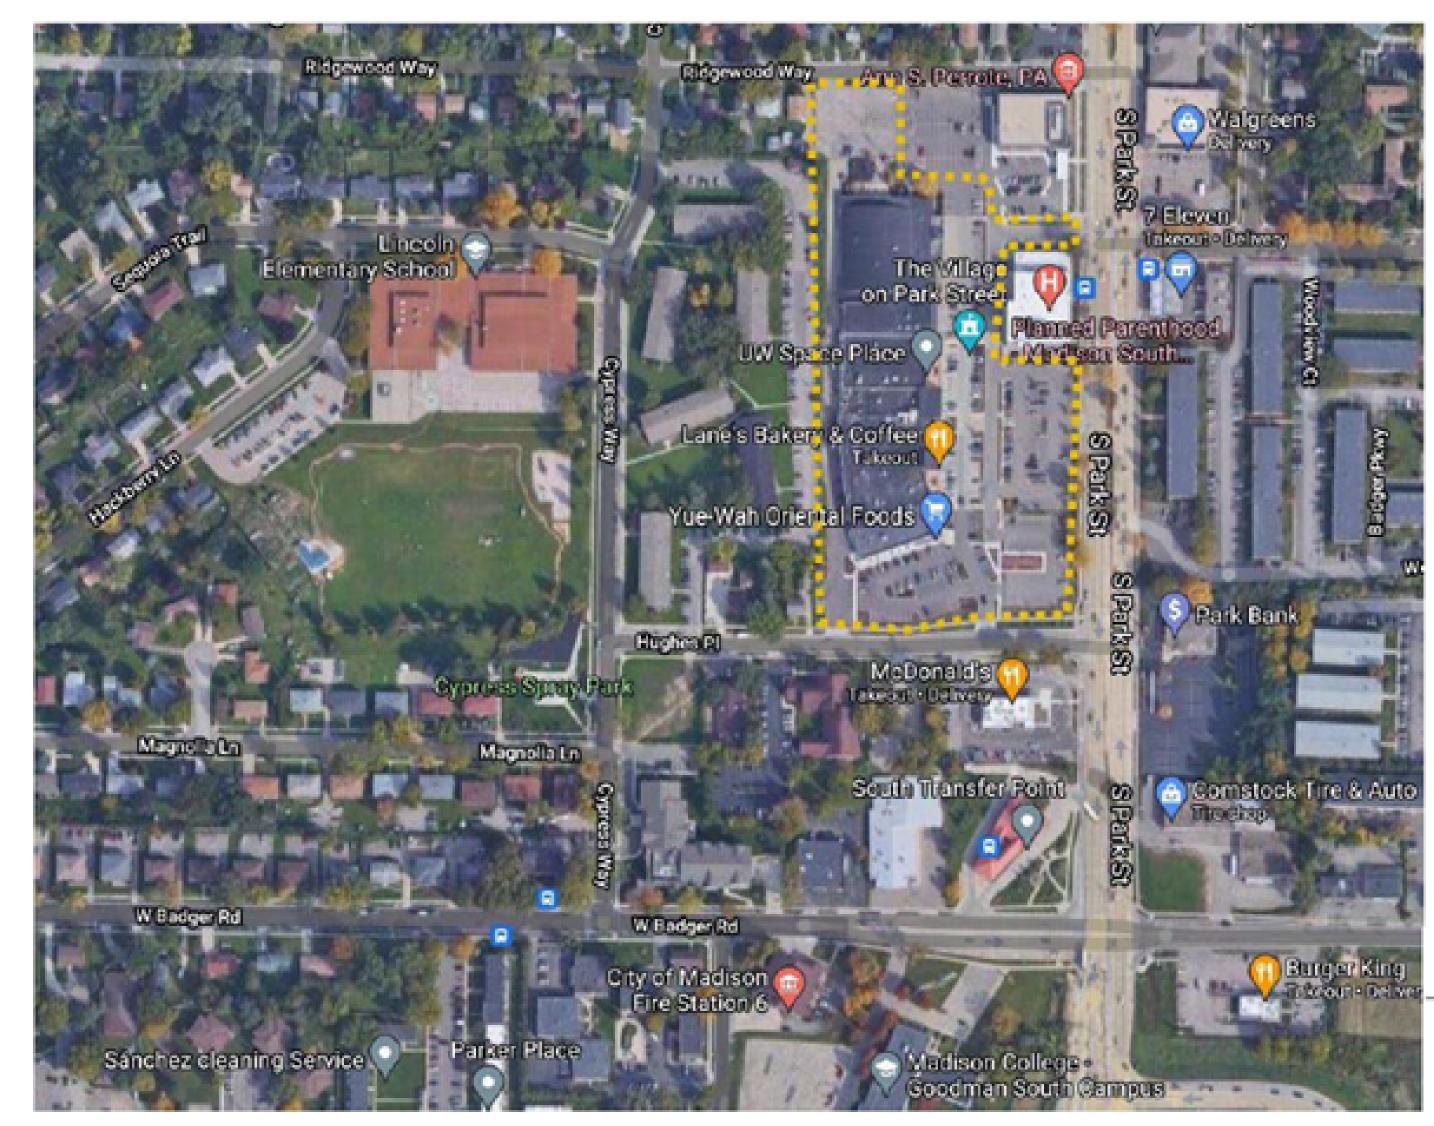



VILLAGE ON PARK - ATRIUM BUILDING









VIEW ON SITE LOOKING SOUTH



VIEW ON PARK STREET LOOKING WEST




VIEW AT PARK STREET AND HUGHES PLACE LOOKING NORTHWEST




VIEW ON HUGHES PLACE LOOKING NORTH



VIEW ON HUGHES PLACE LOOKING NORTHEAST

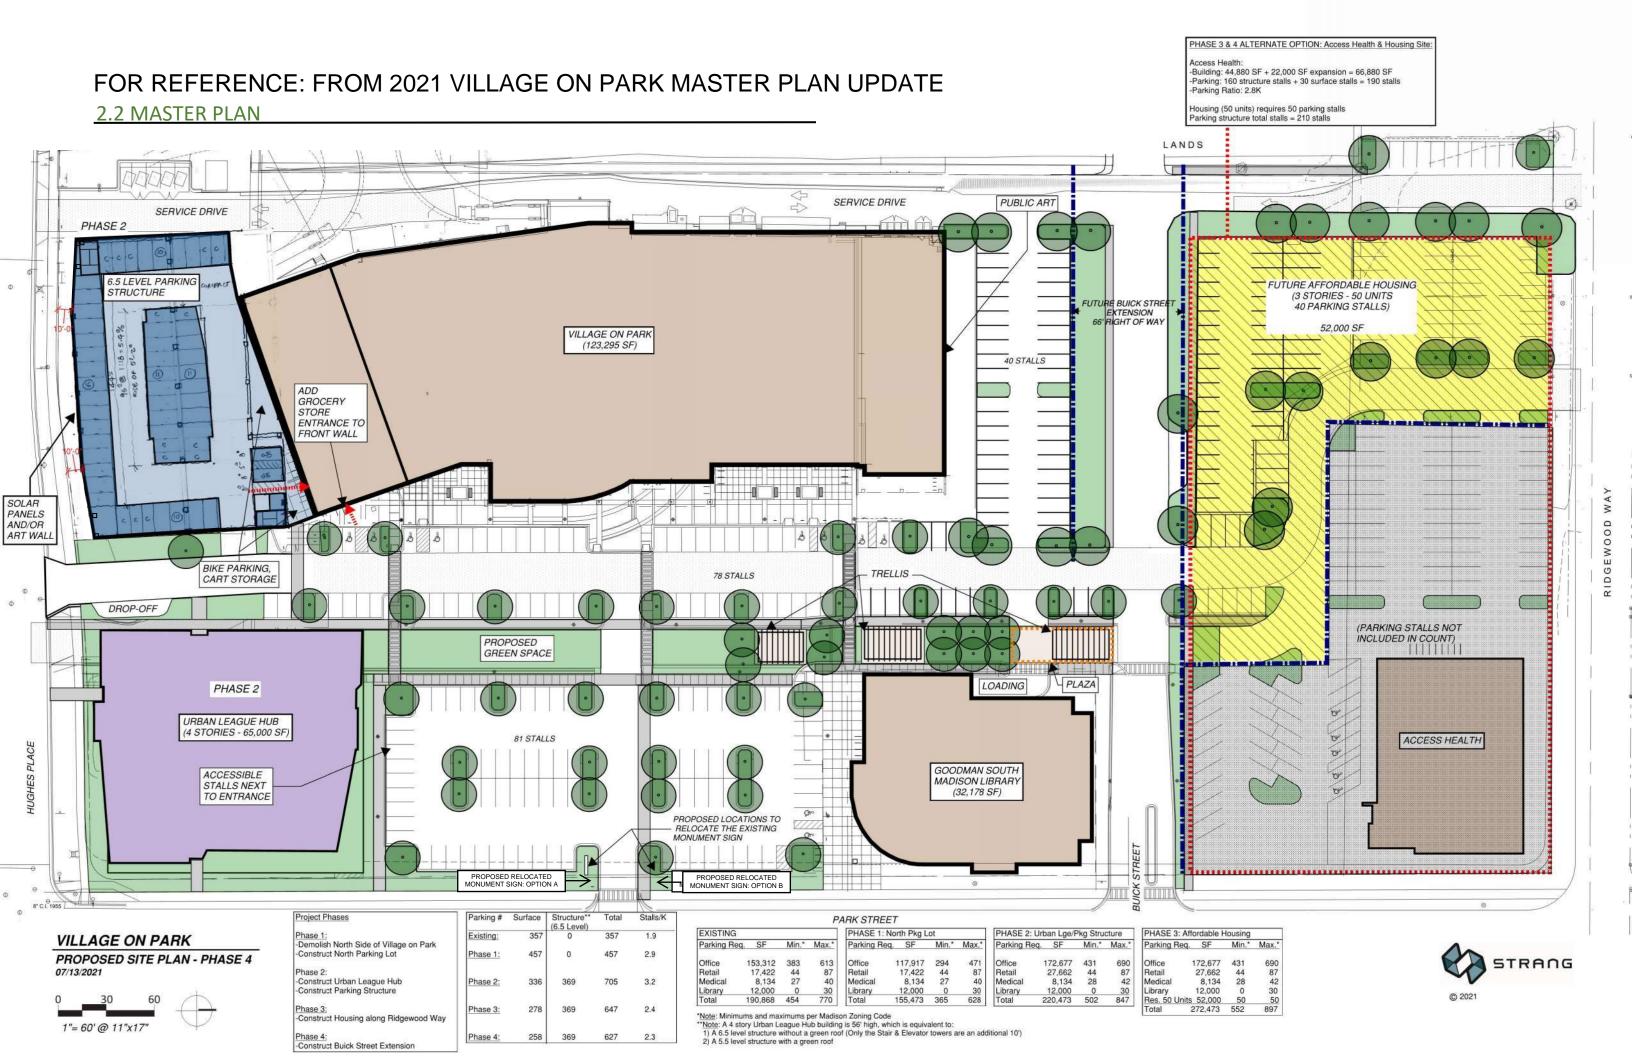

#### 2.3 CONCEPTUAL BUILDING MASSING

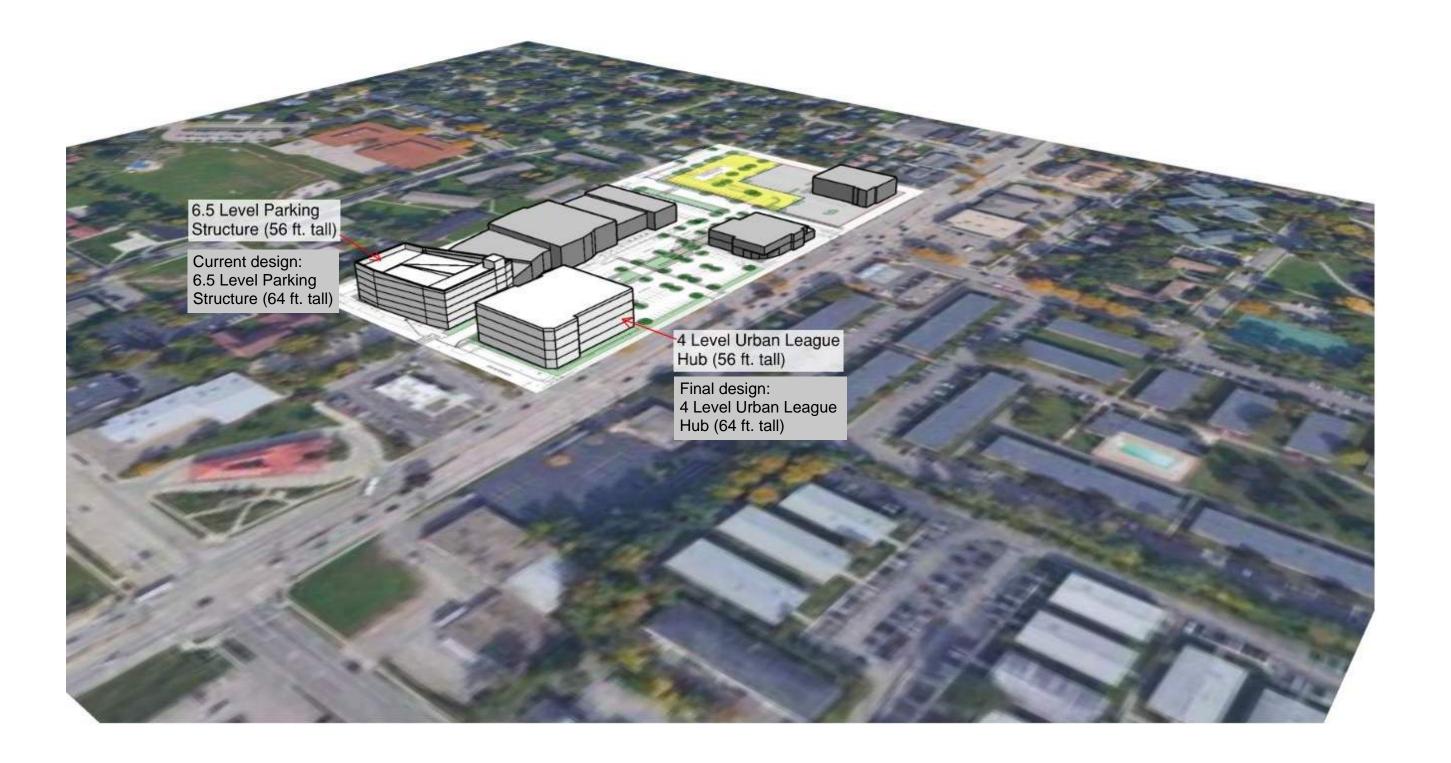





NE PERSPECTIVE

SCALE: 12" = 1'-0"

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MADISON MUNICIPAL BUILDING 215 MARTIN LUTHER KING JR BLVD SUITE 161 MADISON, WI 53703

PROJECT TITLE:

CDA VILLAGER ON PARK -PARKING STRUCTURE

2300 SOUTH PARK STREET MADISON, WI 53713

10/31/22 UDC SUBMITTAL

PROJECT NUMBER: 20225013.00 09/26/2022

CHECKED BY: Approver

AS NOTED SCALE:

SHEET TITLE: EXTERIOR RENDERINGS





SE PERSPECTIVE

A451 SCALE: 12" = 1'-0"

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SHEET TITLE:

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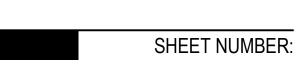
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CHECKED BY: CHK by
APPROVED BY: Approver

APPROVED BY: Approver SCALE: AS NOTED

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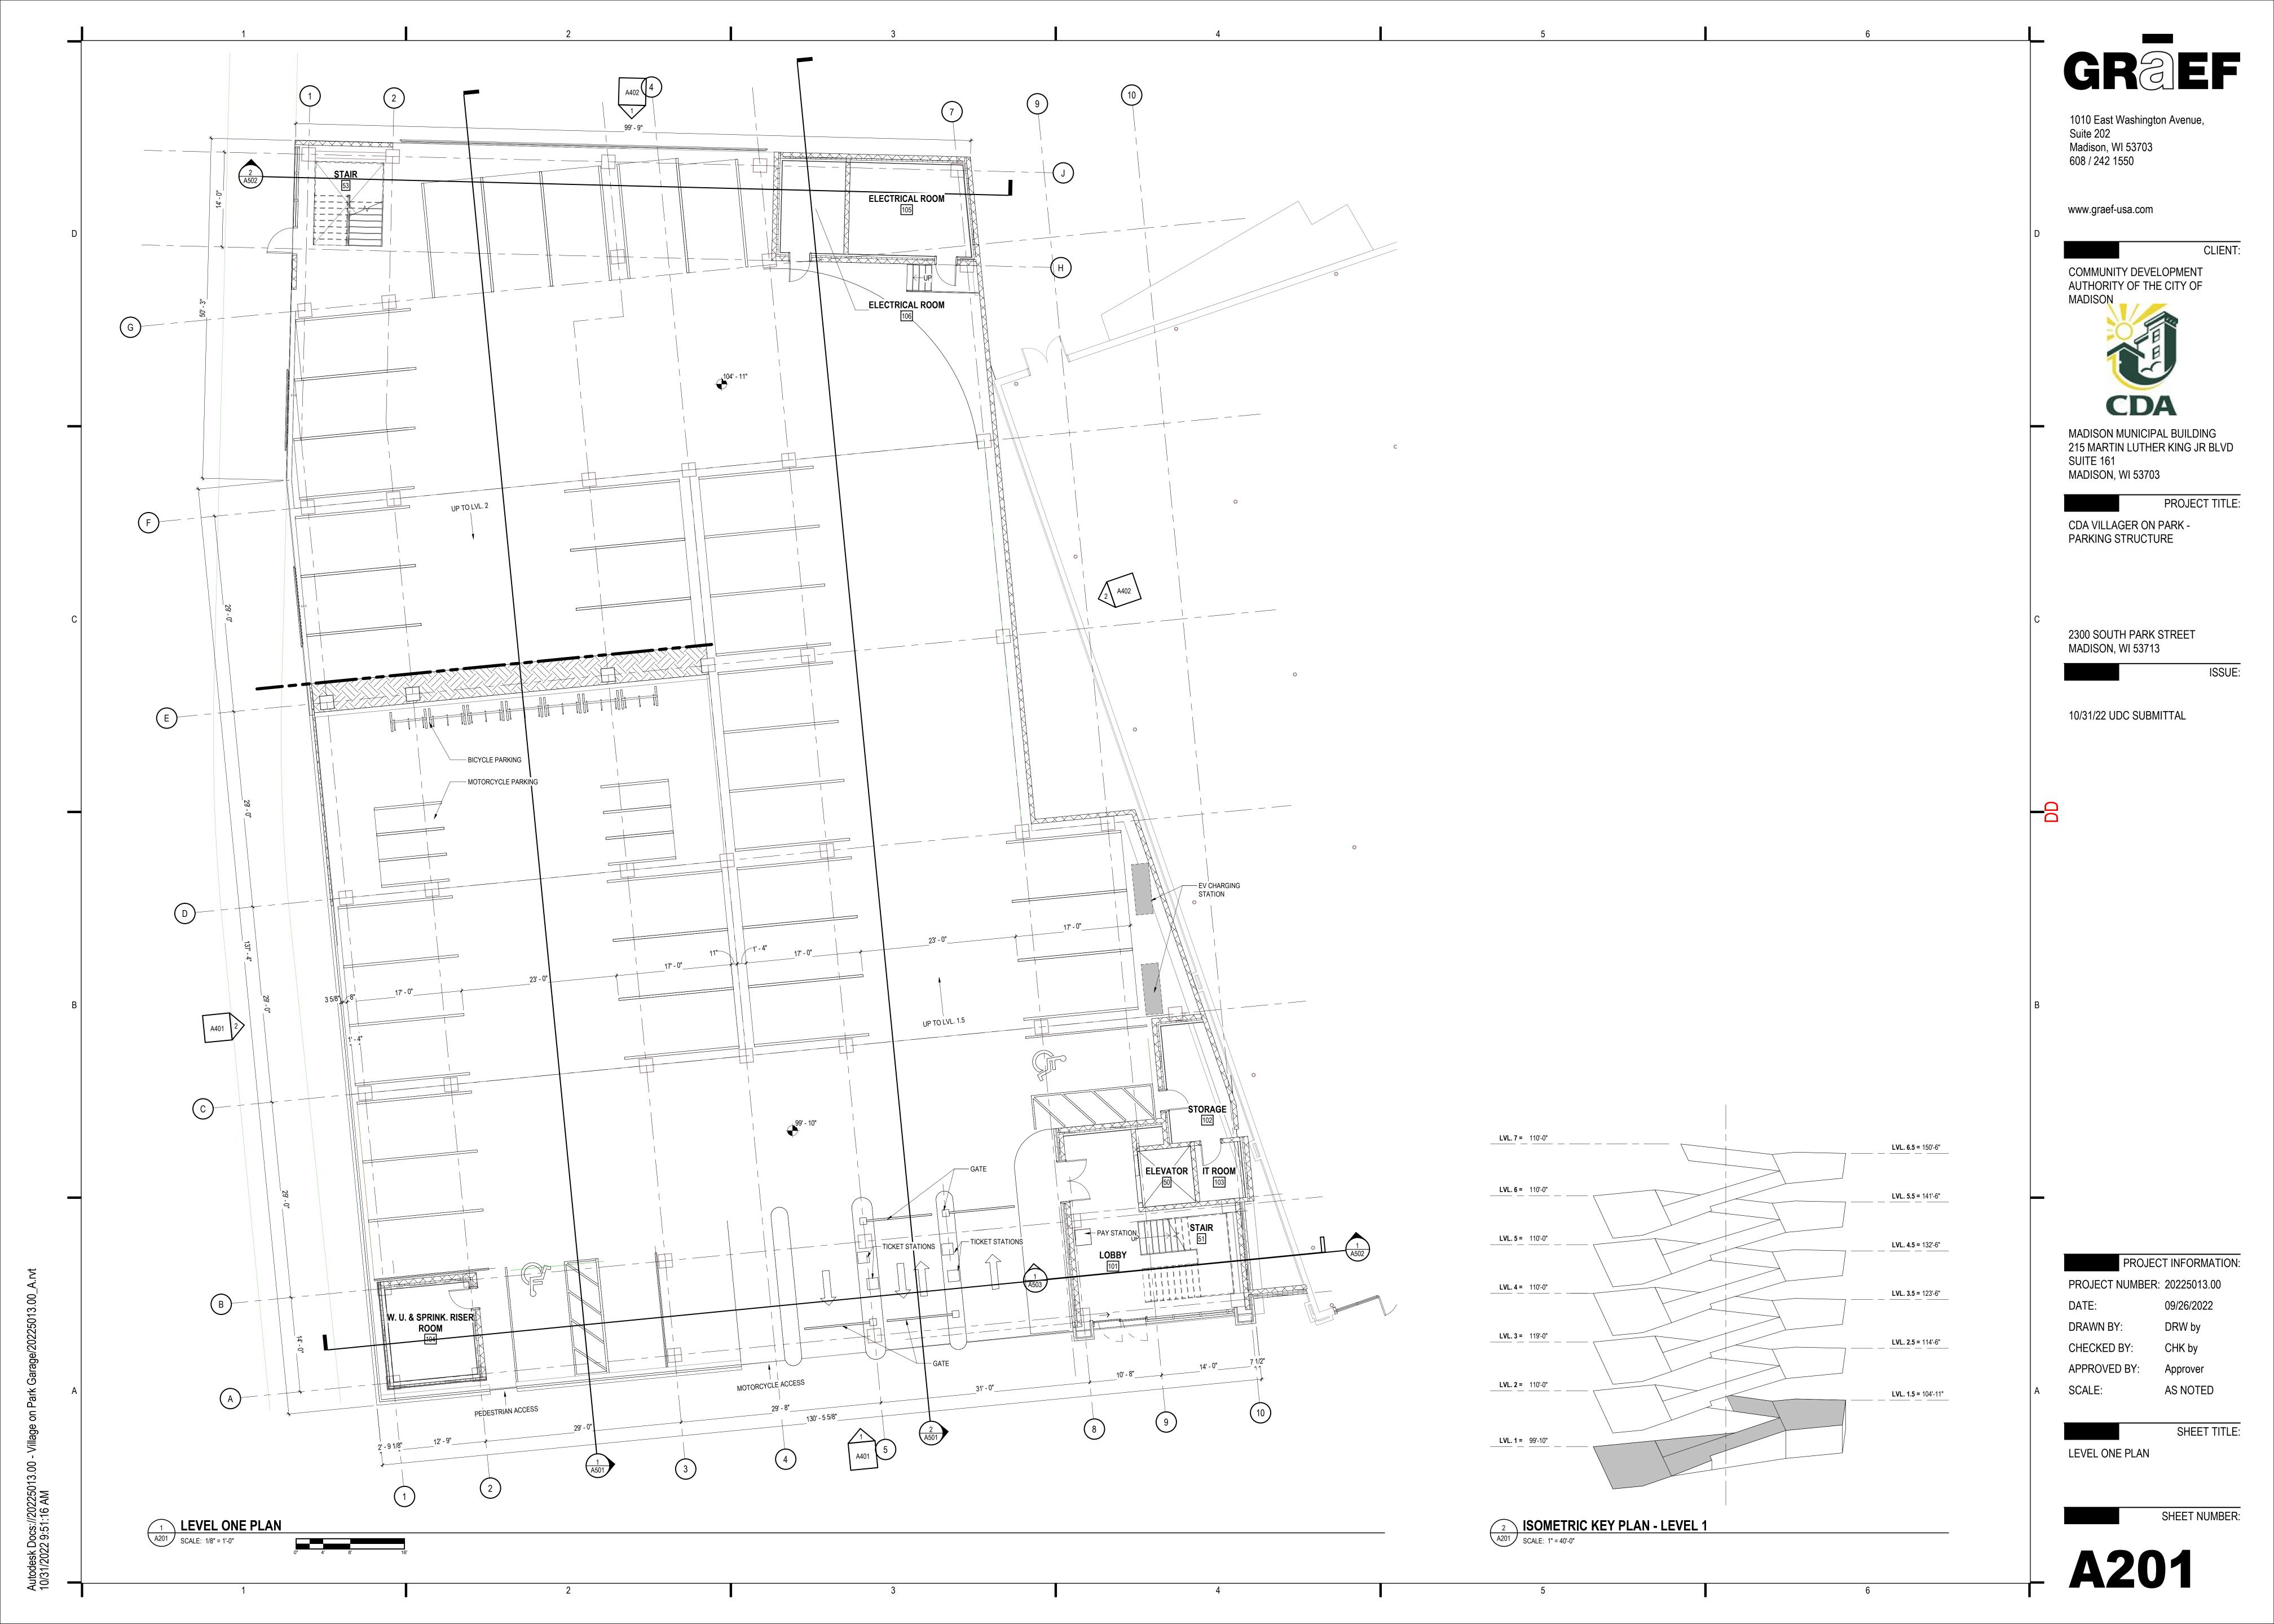
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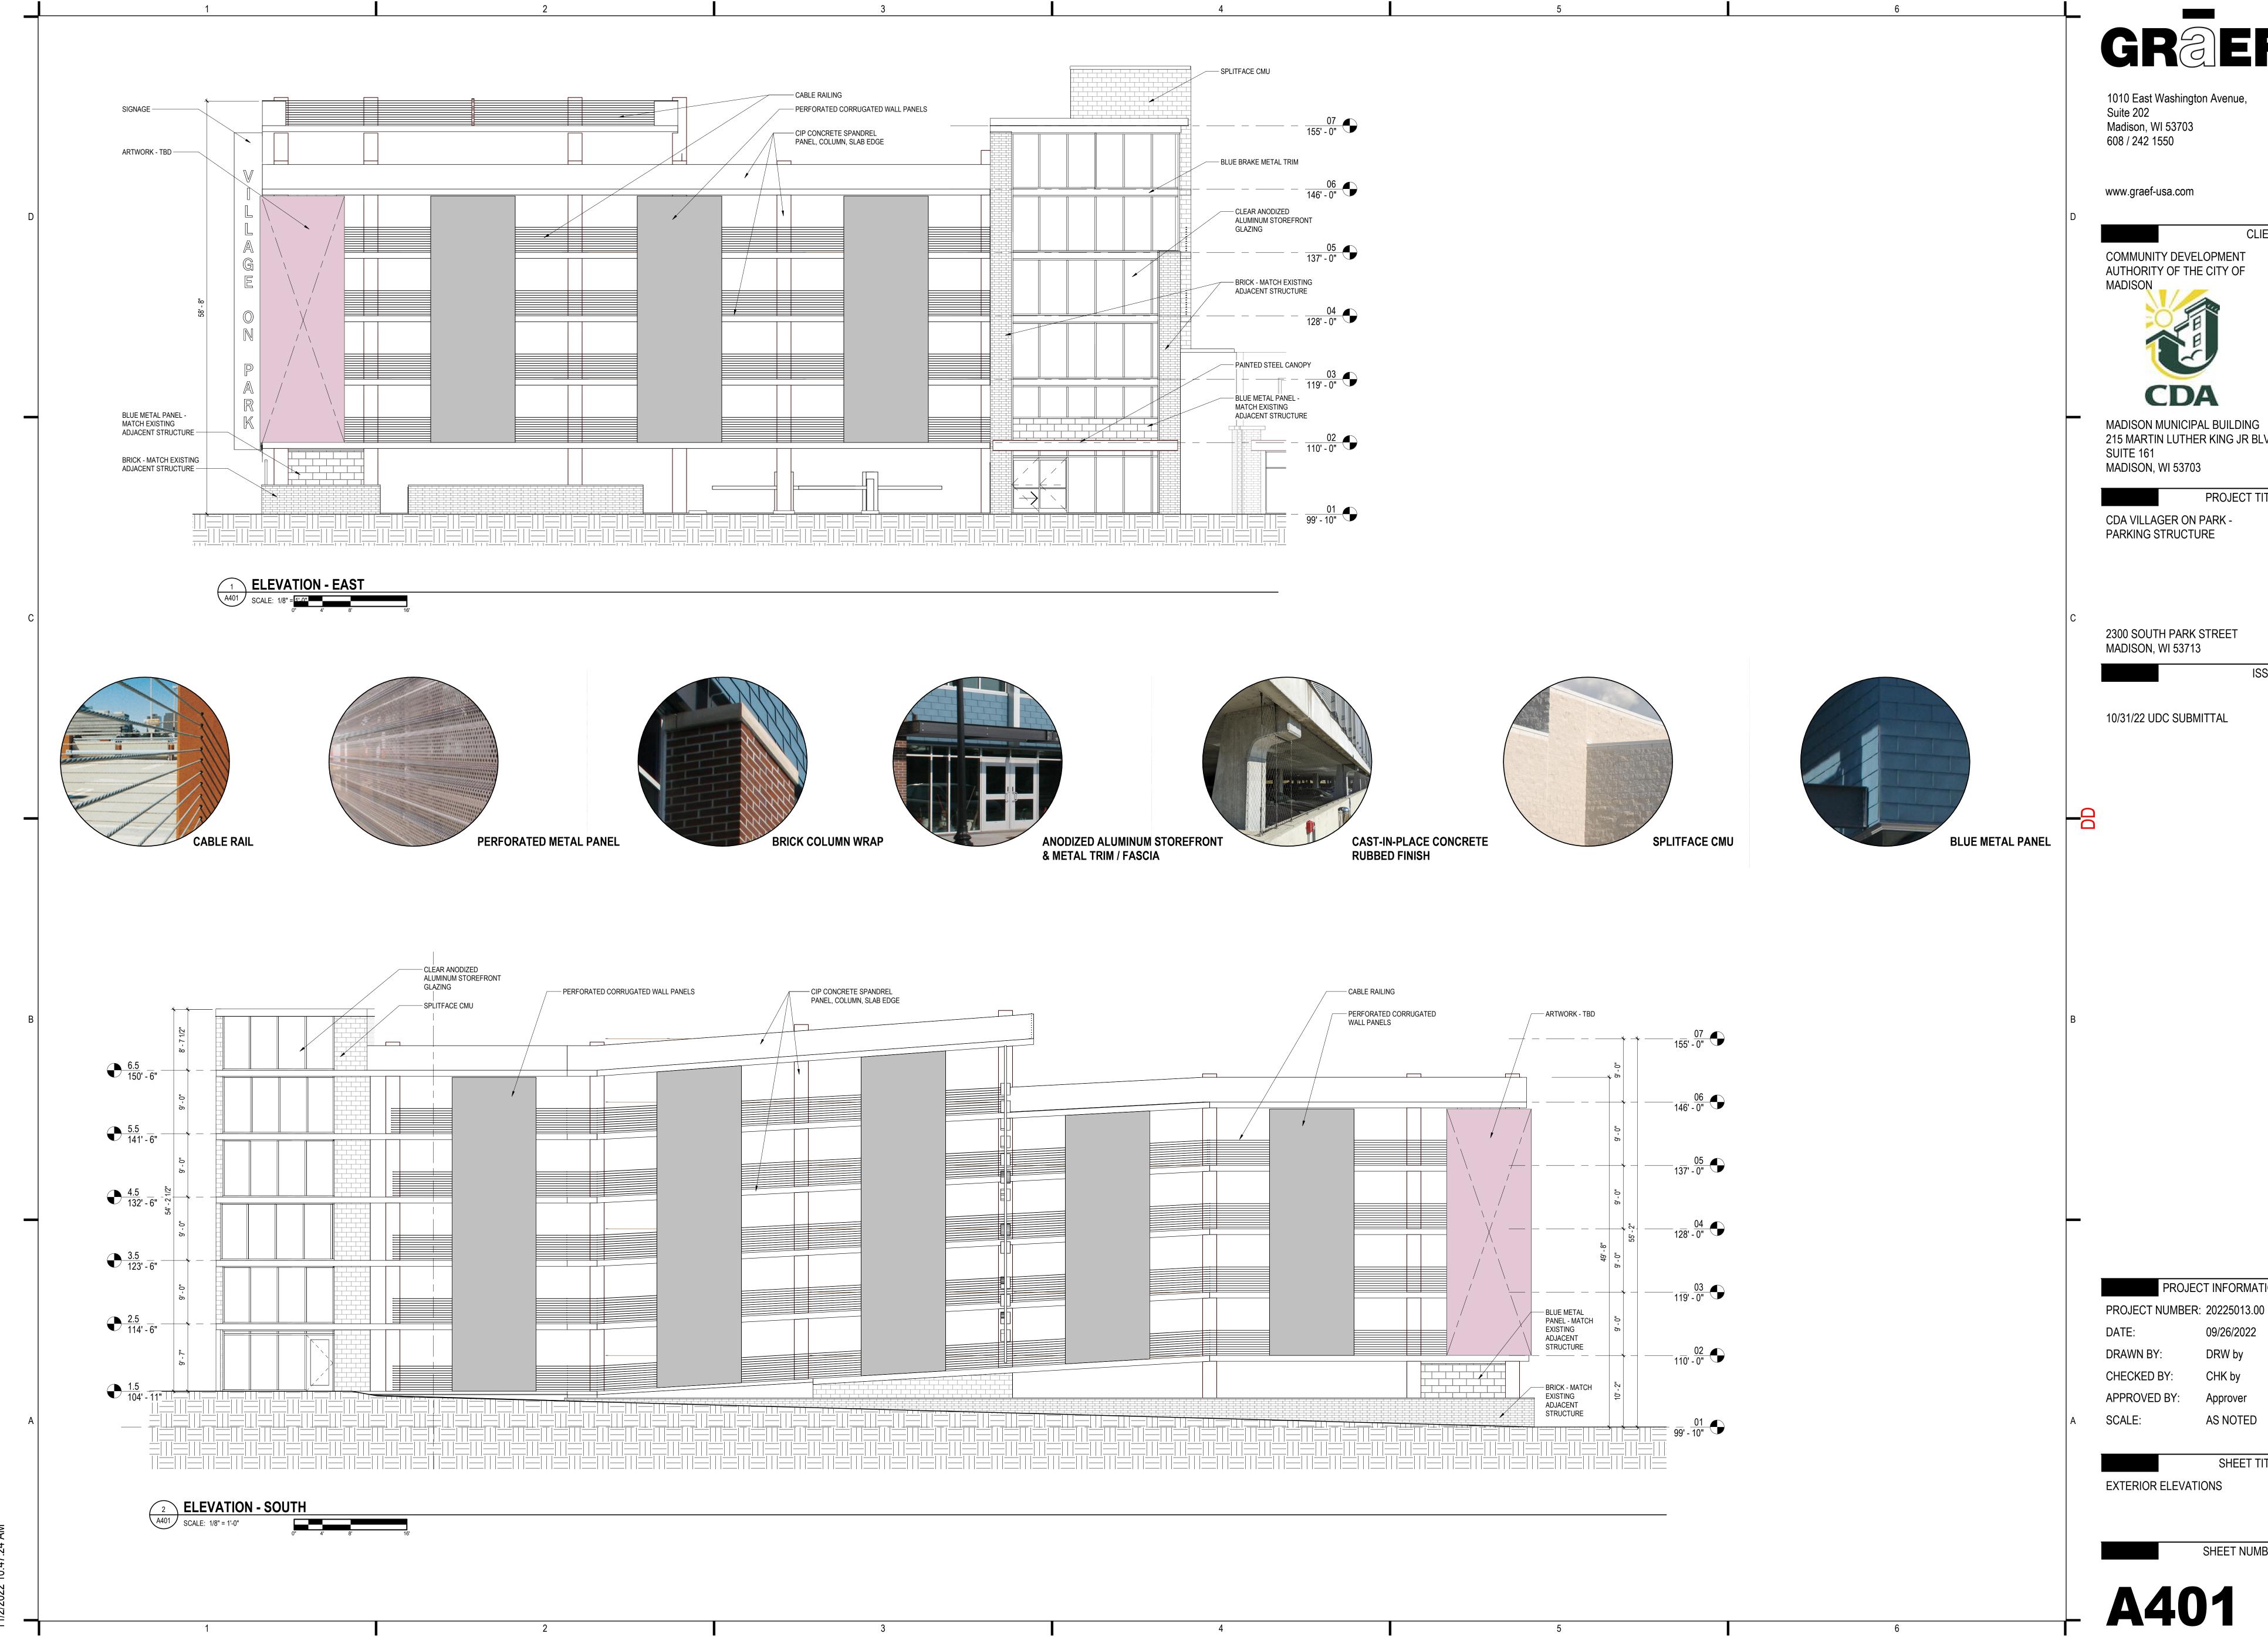


**A452** 

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A452 SCALE: 12" = 1'-0"





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PROJECT TITLE:

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2300 SOUTH PARK STREET


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PROJECT INFORMATION:

09/26/2022


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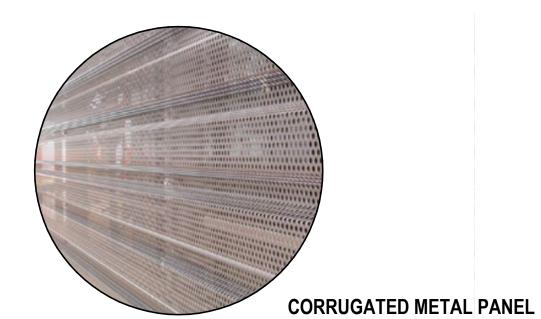
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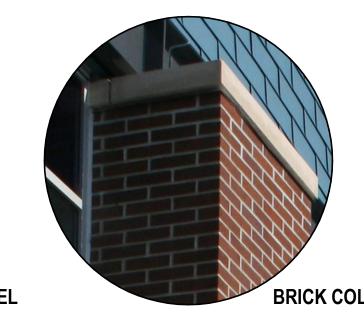





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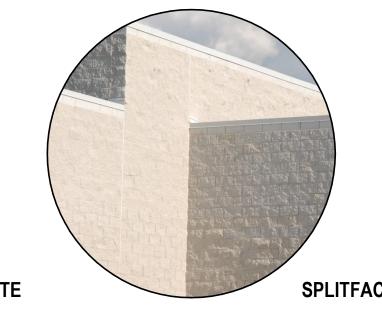


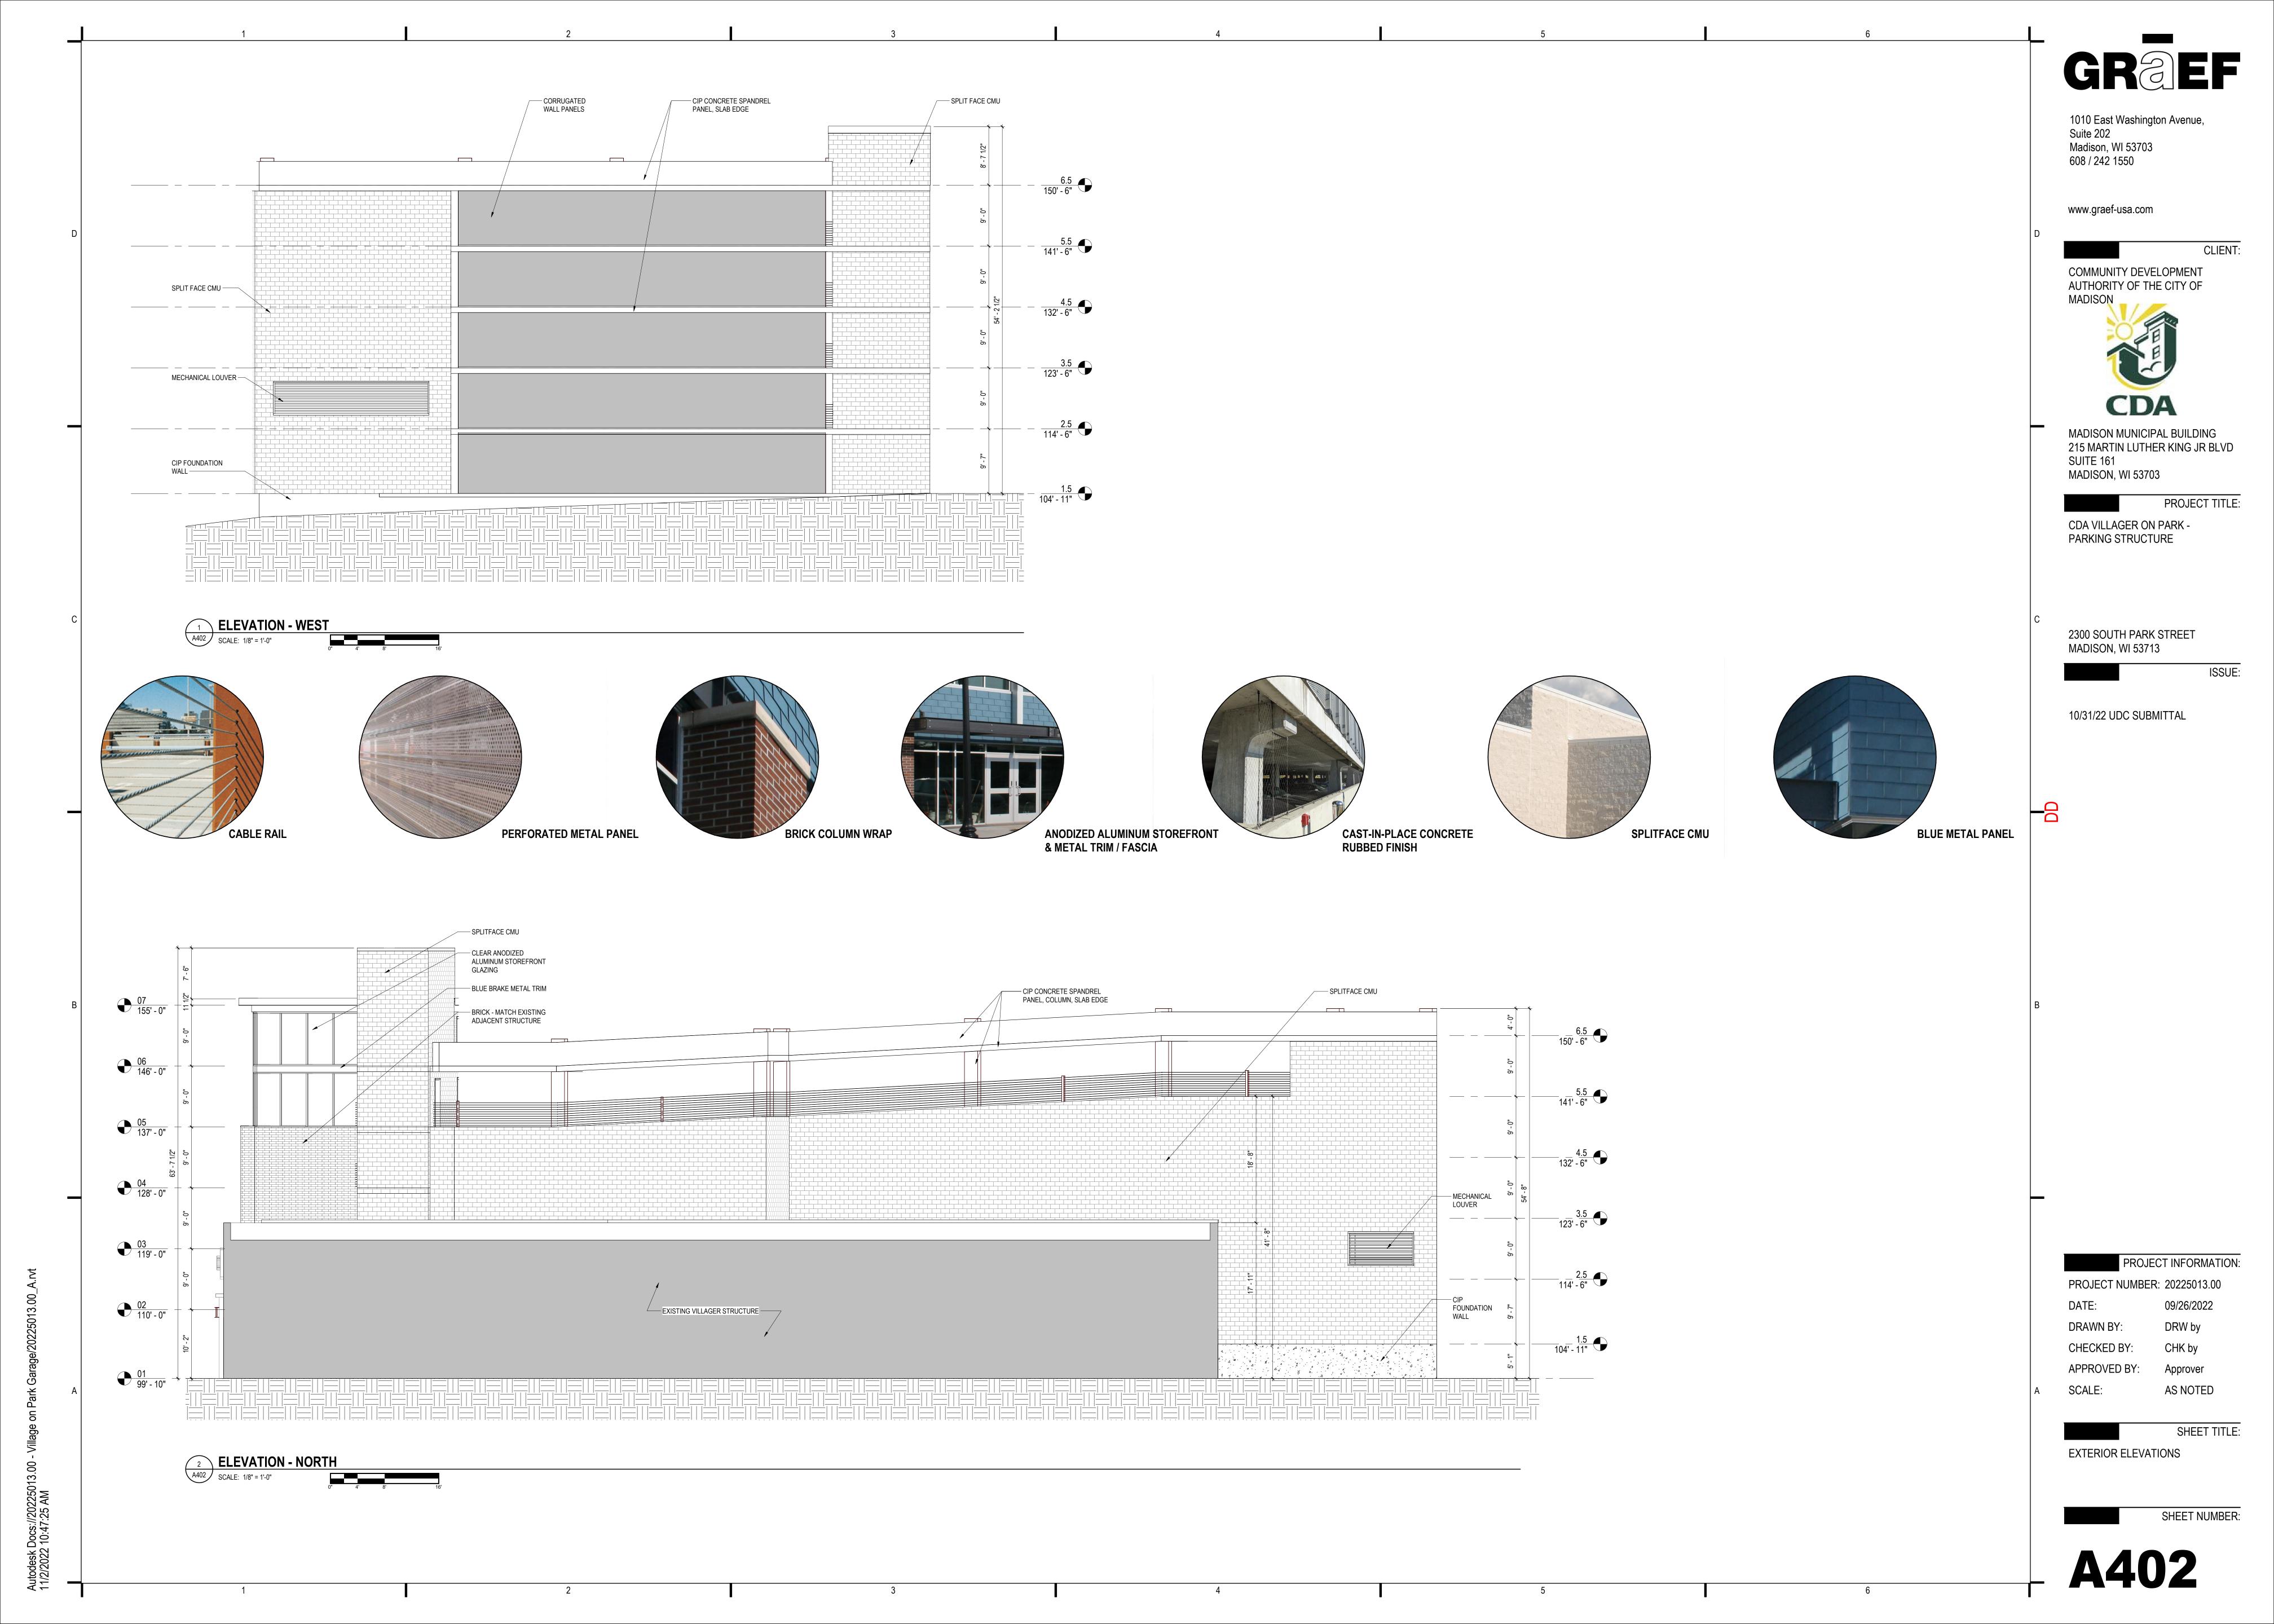





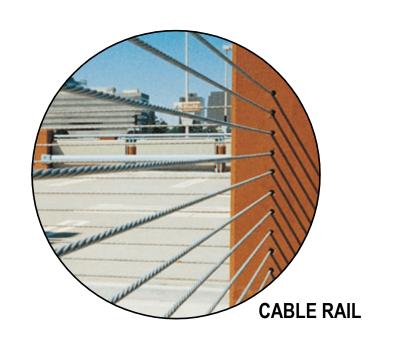



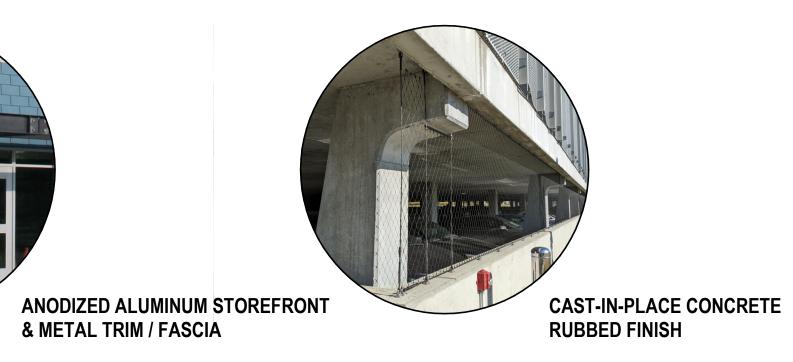

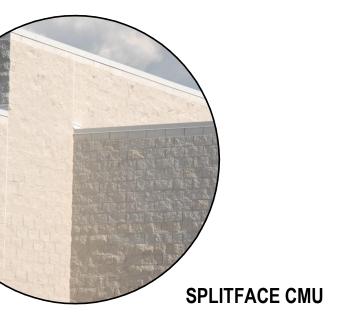

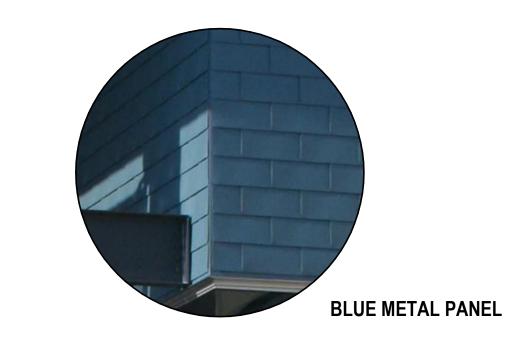

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PROJECT TITLE:

CDA VILLAGER ON PARK -PARKING STRUCTURE

2300 SOUTH PARK STREET MADISON, WI 53713

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**COLOR ORTHOGRAPHIC ELEVATION - SOUTH** 

PROJECT INFORMATION:

PROJECT NUMBER: 20225013.00 09/26/2022 CHECKED BY:

Approver AS NOTED SCALE:


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**EXTERIOR ELEVATIONS - COLOR** RENDERING




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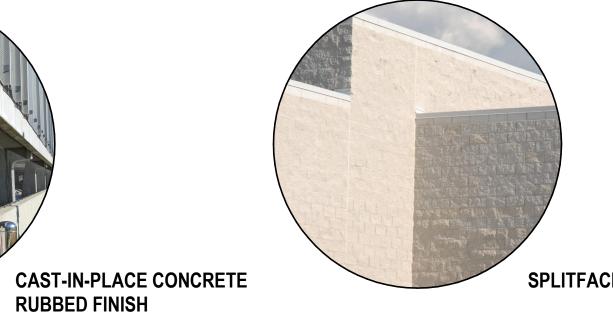








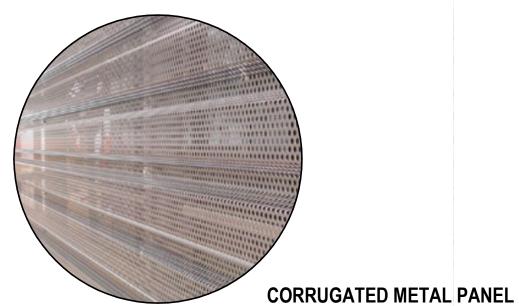



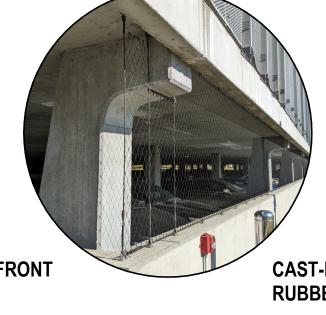

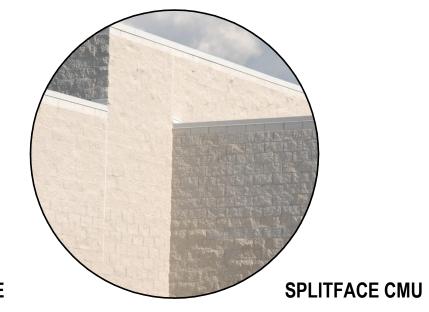

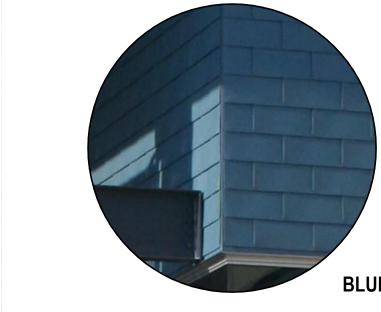

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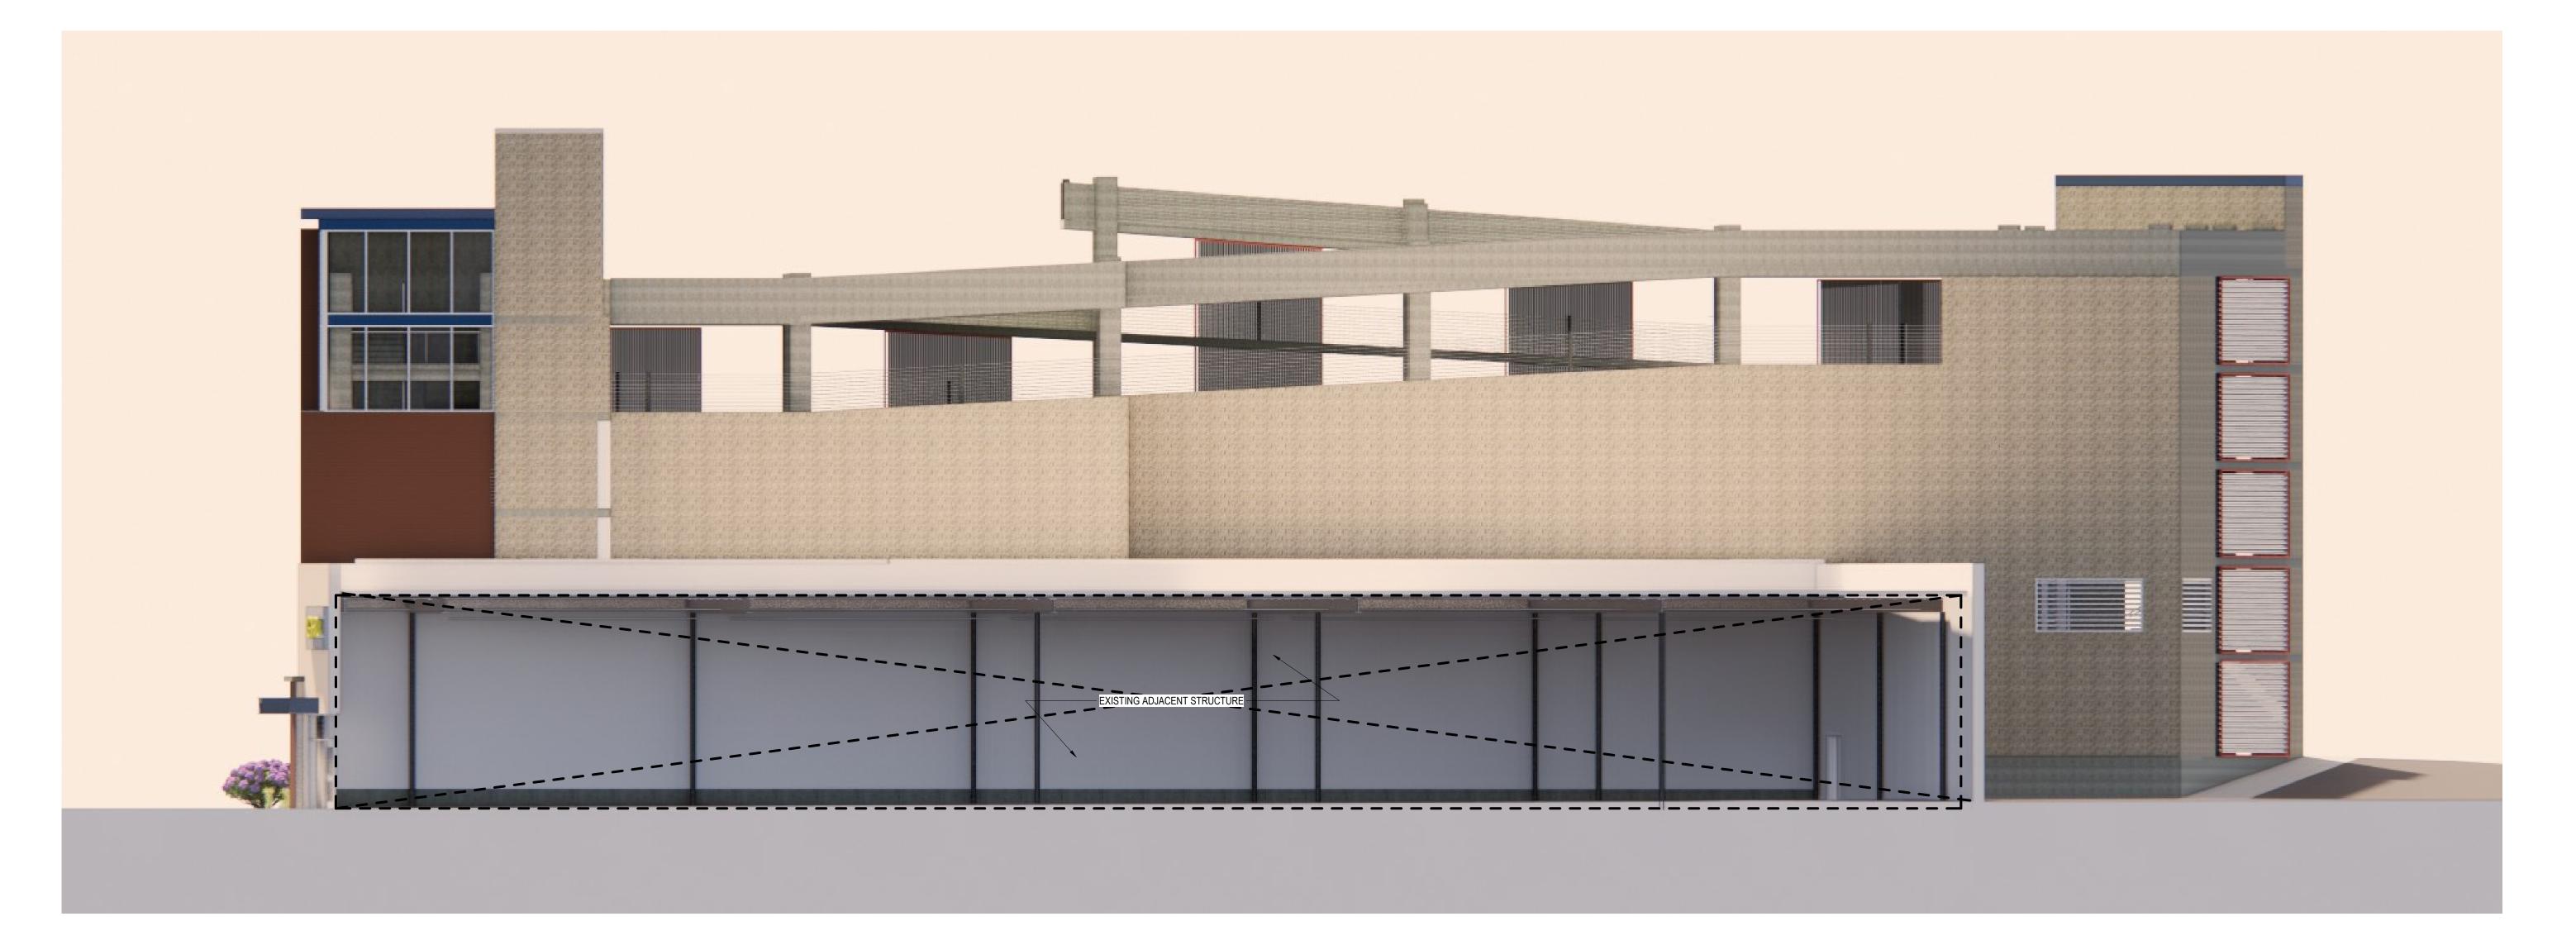
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**COLOR ORTHOGRAPHIC ELEVATION - NORTH** 

PROJECT NUMBER: 20225013.00

**EXTERIOR ELEVATIONS - COLOR** 

CHECKED BY:

RENDERING

SCALE:

09/26/2022

AS NOTED

SHEET TITLE:

