GENERAL NOTES:

I. THE APPLICANT SHALL REPLACE ALL SIDEWALK AND CURB AND GUTTER THAT ABUTS THE PROPERTY THAT IS DAMAGED BY THE CONSTRUCTION, OR ANY SIDEWALK AND CURB AND GUTTER WHICH THE CITY BECAUSE IT IS NOT AT A DESIRABLE GRADE, REGARDLESS OF WHETHER THE CONDITION EXISTED PRIOR TO BEGINNING CONSTRUCTION.

2.ALL WORK IN THE PUBLIC RIGHT OF WAY SHALL BE PERFORMED BY A CITY-LICENSED CONTRACTOR.

3. ALL DAMAGE TO THE PAVEMENT ON CITY STREETS, AND ADJACENT TO THIS DEVELOPMENT SHALL BE RESTORED IN ACCORDANCE WITH THE CITY OF MADISON'S PAVEMENT PATCHING CRITERIA.

4. ALL PROPOSED STREET TREE REMOVALS WITHIN THE RIGHT OF WAY SHALL BE REVIEWED BY CITY FORESTRY BEFORE THE PLAN COMMISSION MEETING. STREET TREE REMOVALS REQUIRE APPROVAL AND A TREE REMOVAL PERMIT ISSUED BY CITY FORESTRY. ANY STREET TREE REMOVALS REQUESTED AFTER THE DEVELOPMENT PLAN IS APPROVED BY THE PLAN COMMISSION OR THE BOARD OF PUBLIC WORKS AND CITY FORESTRY WILL REQUIRE A MINIMUM OF A 72-HOUR REVIEW

PERIOD WHICH SHALL INCLUDE THE NOTIFICATION OF THE ALDERPERSON WITHIN WHO'S DISTRICT IS AFFECTED BY THE STREET TREE REMOVAL(S) PRIOR TO A TREE REMOVAL PERMIT BEING ISSUED.

5.AS DEFINED BY THE SECTION 107.13 OF CITY ENGINEER DETERMINES NEEDS TO BE REPLACED OF MADISON STANDARD SPECIFICATIONS FOR PUBLIC WORKS CONSTRUCTION: NO EXCAVATION IS PERMITTED WITHIN 5 FEET OF THE TRUNK OF THE STREET TREE OR WHEN CUTTING ROOTS OVER 3 INCHES IN DIAMETER. IF EXCAVATION IS NECESSARY, THE CONTRACTOR SHALL CONTACT MADISON CITY FORESTRY (266-4816) PRIOR TO EXCAVATION. CITY OF MADISON FORESTRY PERSONNEL SHALL ASSESS THE IMPACT TO THE TREE AND TO ITS ROOT SYSTEM PRIOR TO WORK COMMENCING. TREE PROTECTION SPECIFICATIONS CAN BE FOUND ON THE FOLLOWING WEBSITE:

HTTPS://WWW.CITYOFMADISON.COM /BUSINESS/PW/SPECS.CFM

6.CONTRACTOR SHALL TAKE PRECAUTIONS DURING CONSTRUCTION TO NOT DISFIGURE, SCAR, OR IMPAIR THE HEALTH OF ANY STREET TREE. CONTRACTOR SHALL OPERATE **EQUIPMENT IN A MANNER AS TO NOT** DAMAGE THE BRANCHES OF THE STREET TREE(S). THIS MAY REQUIRE USING SMALLER EQUIPMENT AND LOADING AND UNLOADING MATERIALS IN A DESIGNATED SPACE AWAY FROM TREES ON THE CONSTRUCTION SITE.

ANY DAMAGE OR INJURY TO EXISTING STREET TREES (EITHER ABOVE OR BELOW GROUND) SHALL BE REPORTED IMMEDIATELY TO CITY FORESTRY AT 266-4816. PENALTIES AND REMEDIATION SHALL BE REQUIRED.

7.SECTION 107.13(G) OF CITY OF MADISON STANDARD SPECIFICATIONS FOR PUBLIC WORKS CONSTRUCTION ADDRESSES SOIL COMPACTION NEAR STREET TREES AND SHALL BE FOLLOWED BY CONTRACTOR. THE STORAGE OF PARKED VEHICLES, CONSTRUCTION EQUIPMENT, BUILDING MATERIALS, REFUSE, EXCAVATED SPOILS OR DUMPING OF POISONOUS MATERIALS ON OR AROUND TREES AND ROOTS WITHIN FIVE (5) FEET OF THE TREE OR WITHIN THE PROTECTION ZONE IS PROHIBITED.

8.ON THIS PROJECT, STREET TREE PROTECTION ZONE FENCING IS REQUIRED. THE FENCING SHALL BE ERECTED BEFORE THE DEMOLITION GRADING OR CONSTRUCTION BEGINS. THE FENCE SHALL INCLUDE THE ENTIRE WIDTH OF TERRACE AND, EXTEND AT LEAST 5 FEET ON BOTH SIDES OF THE OUTSIDE EDGE OF THE TREE TRUNK. DO NOT REMOVE THE FENCING TO ALLOW FOR DELIVERIES OR EQUIPMENT ACCESS THROUGH THE TREE PROTECTION ZONE.

9.STREET TREE PRUNING SHALL BE COORDINATED WITH MADISON FORESTRY AT A MINIMUM OF TWO WEEKS PRIOR TO THE

START OF CONSTRUCTION FOR THIS PROJECT. ALL PRUNING SHALL FOLLOW THE AMERICAN NATIONAL STANDARDS INSTITUTE (ANSI) A300 - PART I STANDARDS FOR PRUNING.

10. APPROVAL OF PLANS FOR THIS PROJECT DOES NOT INCLUDE ANY APPROVAL TO PRUNE, REMOVE, OR PLANT TREES IN THE PUBLIC RIGHT-OF-WAY. PERMISSION FOR SUCH ACTIVITIES MUST BE OBTAINED FROM THE CITY FORESTER (266-4816).

JURISDICTION OF THE CITY OF MADISON AND IS SUBJECT TO CHANGE AT ANY TIME. NO ITEMS SHOWN ON THIS SITE PLAN IN THE RIGHT-OF-WAY ARE PERMANENT AND MAY NEED TO BE REMOVED AT THE APPLICANTS EXPENSE UPON NOTIFICATION BY THE CITY.

ZONING: SR-V2 SUBURBAN RESIDENTIAL - VARIED DISTRICT DENSITIES LOT AREA

> DWELLING UNITS LOT AREA / D.U. DENSITY LOT COVERAGE USABLE OPEN SPACE **BUILDING HEIGHT**

SITE DEVELOPMENT DATA:

TOTAL FLOOR AREA

FLOOR AREA RATIO

DWELLING UNIT MIX:

THREE BEDROOM

VEHICLE PARKING:

GARAGE STALLS

BIKE PARKING

SHORT-TERM GUEST/SURFACE

LONG -TERM COVERED/GARAGE

TOTAL

SURFACE STALLS

96,385 S.F./2.2 ACRES

320 S.F./2+ BDRM MIN.

3 STORIES = 40' MAX.

44 BIKE STALLS

54,148 S.F. (56%)

27,101 S.F./1,355 S.F./2+ BDRM

BLDG 4

2 STORIES = 32'-7" APPROX.

20 UNITS

4,819 S.F./UNIT

9 UNITS/ACRE

REQUIRED

60% MAX.

47,971 S.F.

11. THE PUBLIC RIGHT-OF-WAY IS THE SOLE

C-100 SITE PLAN C-200 LIGHTING PLAN C-300 FIRE DEPARTMENT ACCESS C-400 LOT COVERAGE C-500 USABLE OPEN SPACE COVER SHEET C-1.0 CONTRACT LIMITS C-I.I PROPOSED SITE PLAN C-2.0 MASTER GRADING & PAVING PLAN C-2.1 EROSION CONTROL PLAN C-3.0 OVERALL UTILITY PLAN C-4.0 CONSTRUCTION NOTES & DETAILS C-4.1 CONSTRUCTION NOTES & DETAILS LANDSCAPE PLANTING & LANDSCAPE RESTORATION PLAN LIOI PLANTING ENLARGEMENTS L102 PLANTING ENLARGEMENTS L103 PLANTING ENLARGEMENTS

> PLANT IMAGES **ARCHITECTURAL BUILDING** #1

40 STALLS

40 STALLS 80 STALLS

A-I.I-I FIRST FLOOR PLAN A-I.2-I SECOND FLOOR PLAN A-2.1-1 **ELEVATIONS** A-2.2-I **ELEVATIONS - COLOR BUILDING #2-4** A-1.1-2 FIRST FLOOR PLAN A-1.2-2 SECOND FLOOR PLAN A-2.I-2 ELEVATIONS

A-2.2-2 ELEVATIONS - COLOR BUILDING #5 A-1.1-5 FIRST FLOOR PLAN A-I.2-5 SECOND FLOOR PLAN A-2.1-5 **ELEVATIONS** A-2.2-5 ELEVATIONS - COLOR

MATERIAL BOARD I MATERIAL BOARD 2

RENDERINGS

ISSUED

ARCHITECTS

Phone: 7601 University Ave, Ste 201


608.836.3690 Middleton, WI 53562


Paragon Place at

304 Lakota Way Madison, Wisconsin

C-100

PROJECT NO. 2214

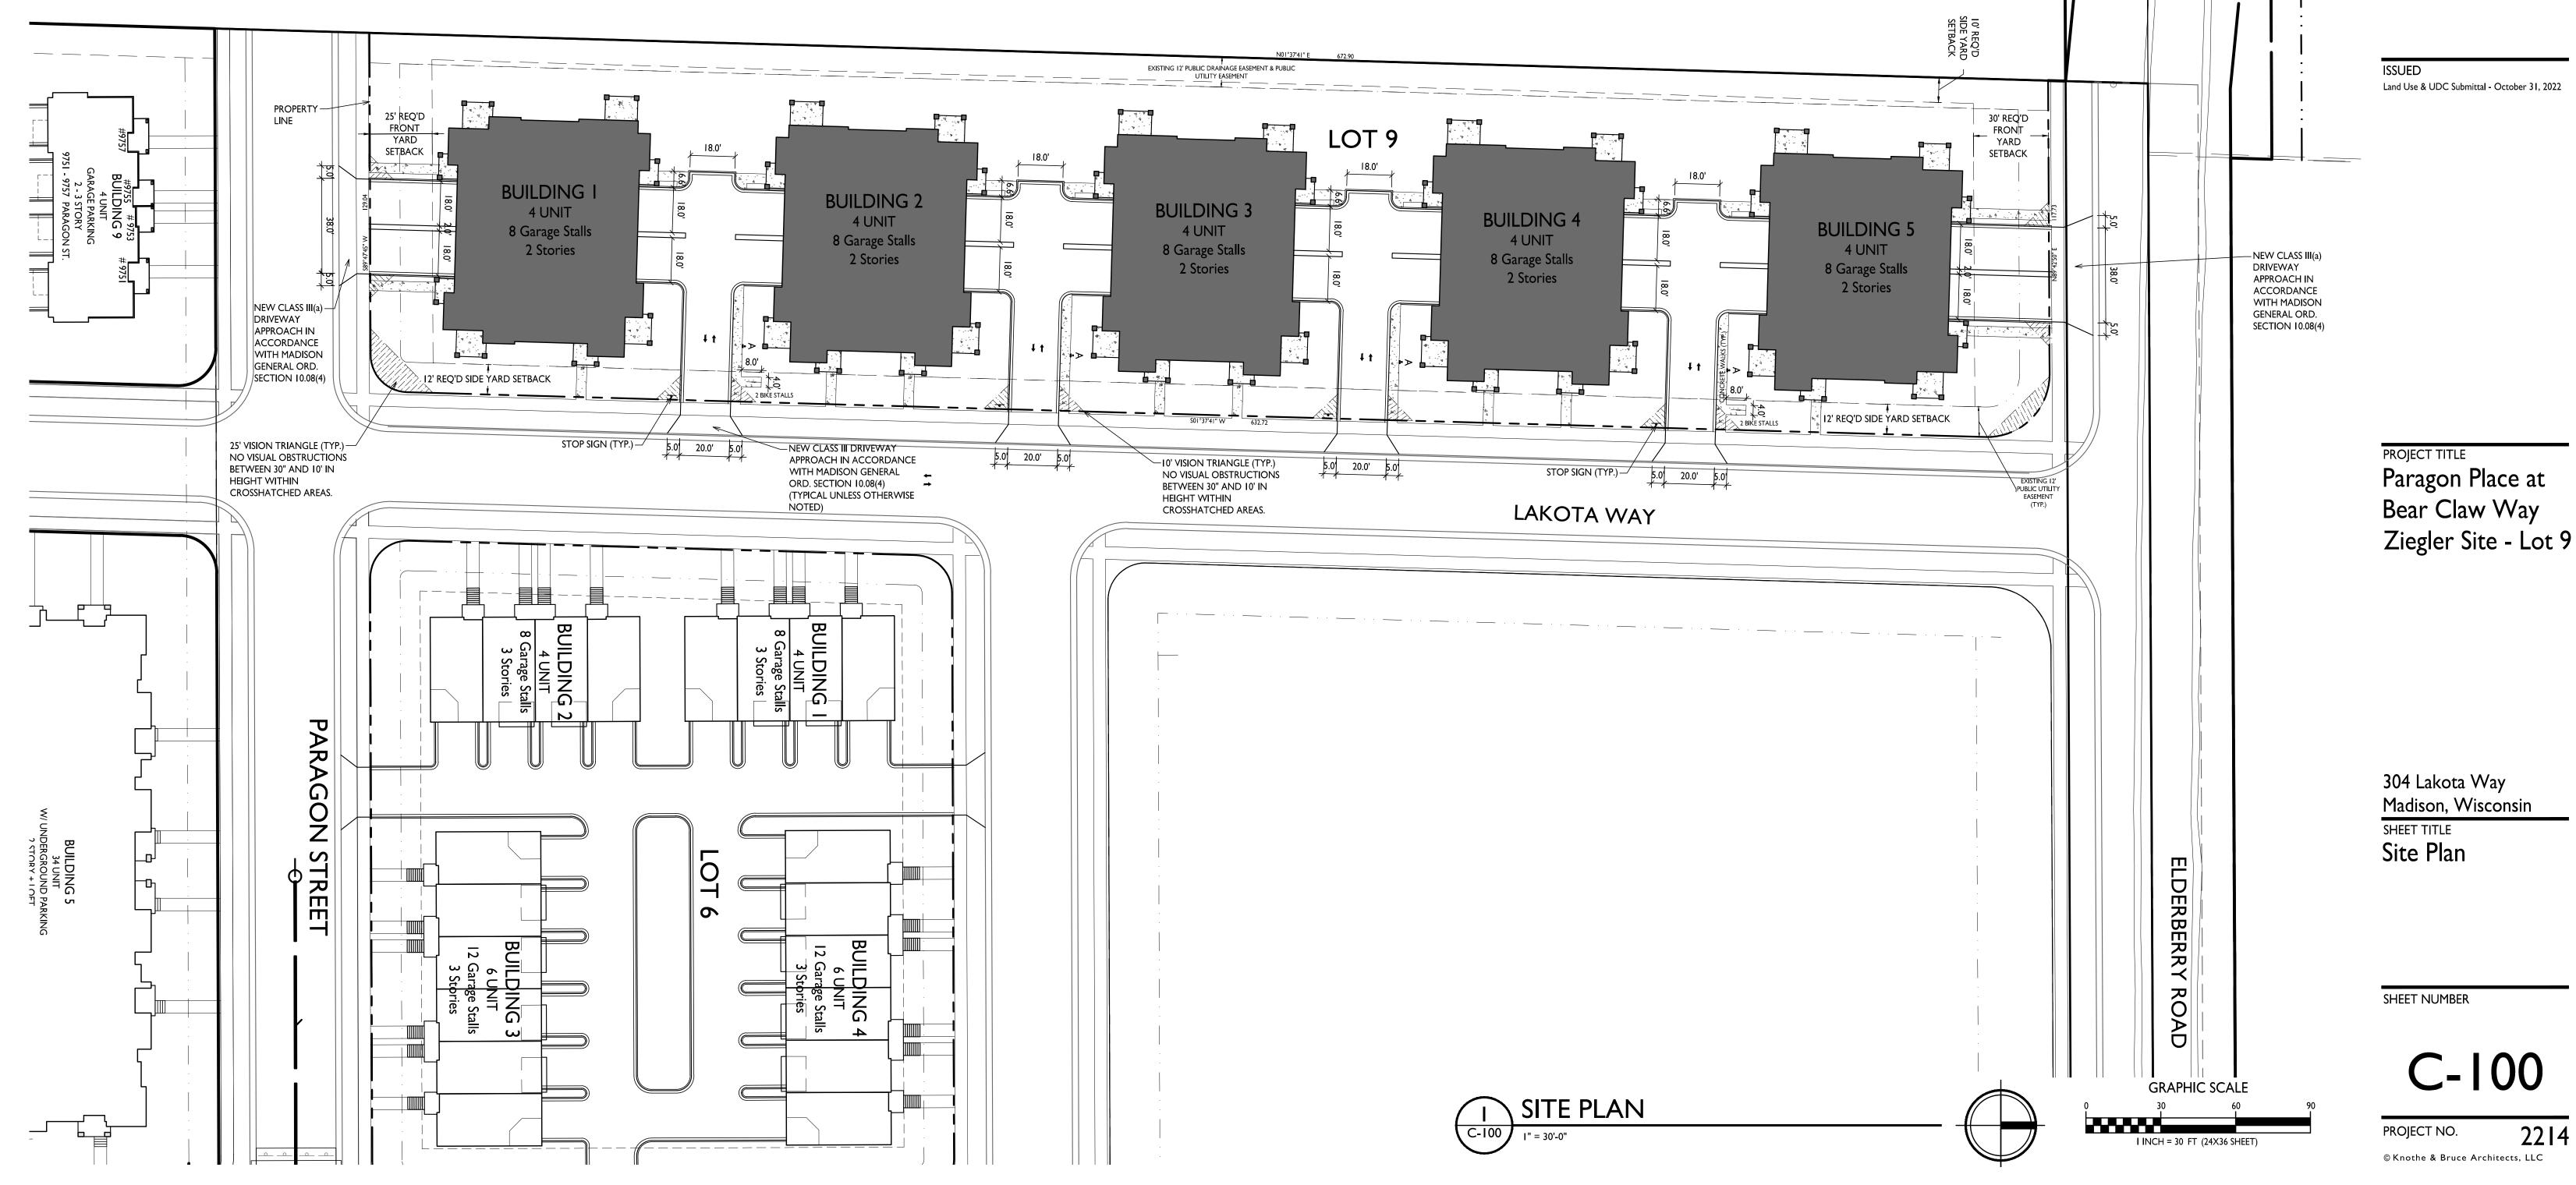

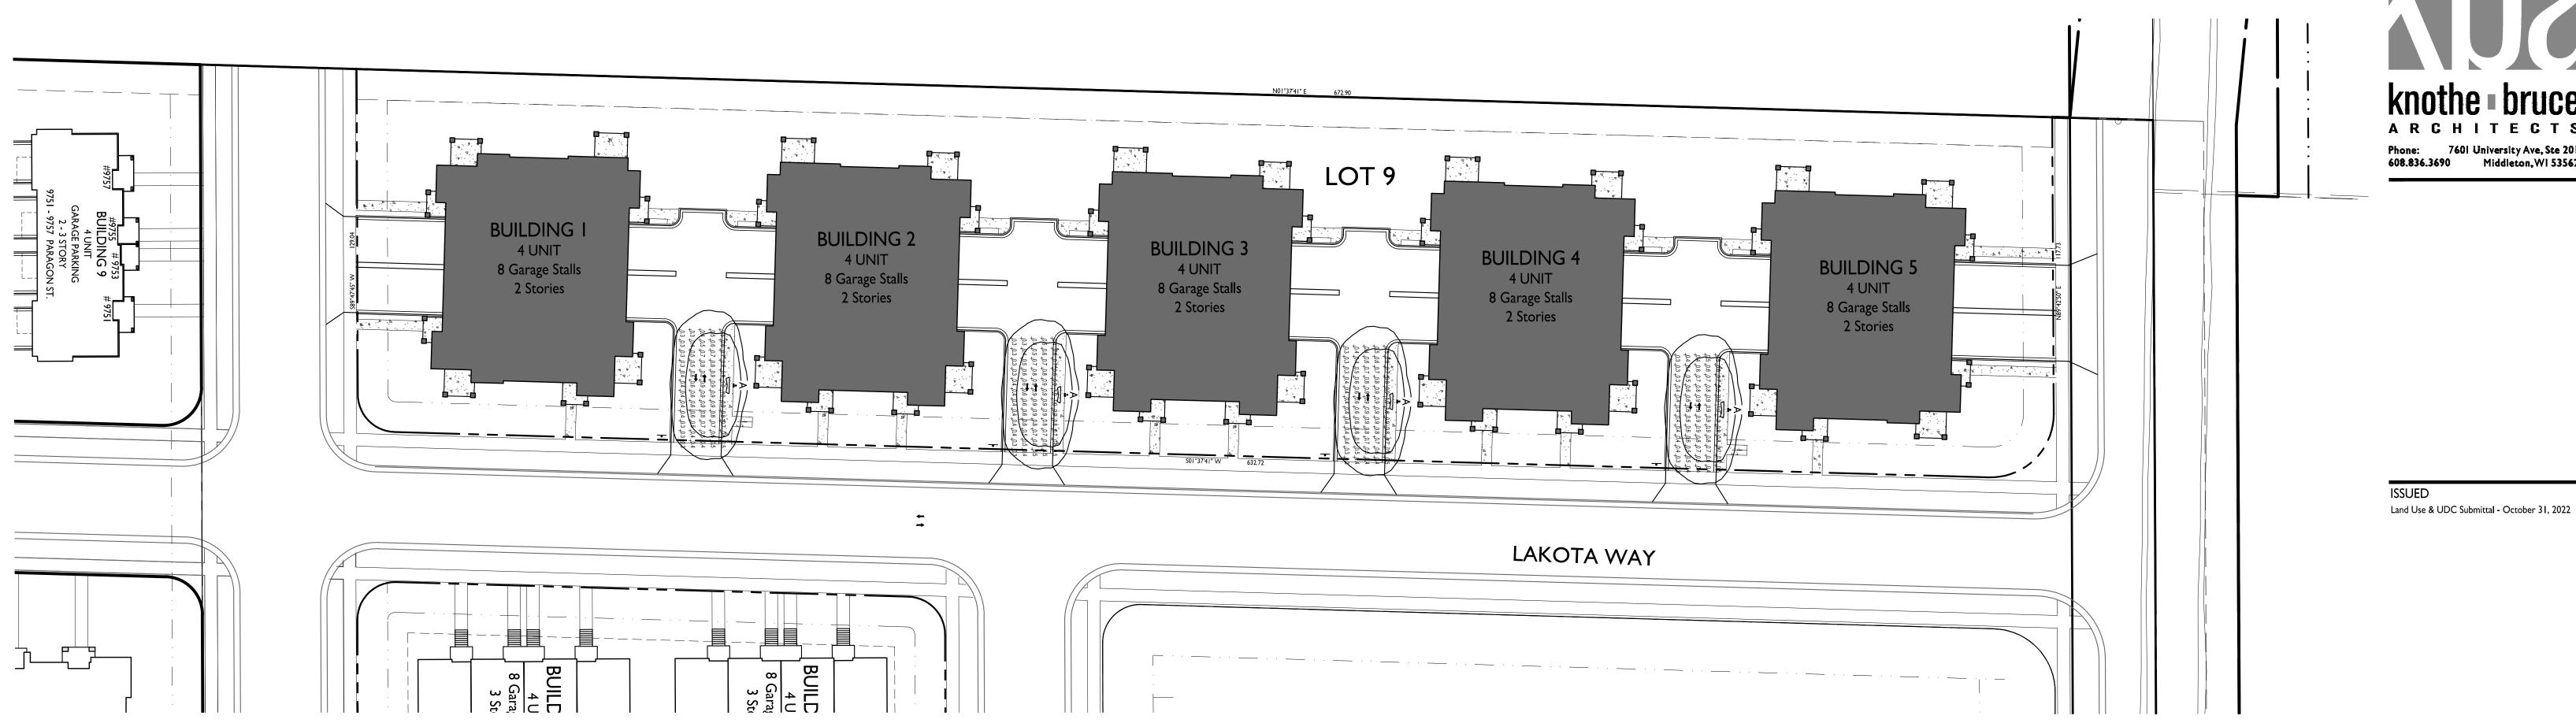



LIGHT LEVEL STATISTICS						
DESCRIPTION	SYMBOL	AVG.	MAX.	MIN.	MAX. / MIN.	AVG. / MIN
Drive Aisle Between Buildings #1 & #2	+	0.6 fc	1.0 fc	0.3 fc	3.3:1	2.0:I
Drive Aisle Between Buildings #2 & #3	+	0.6 fc	I.0 fc	0.3 fc	3.3:1	2.0:I
Drive Aisle Between Buildings #3 & #4	+	0.6 fc	I.0 fc	0.3 fc	3.3:1	2.0:I
Drive Aisle Between Buildings #4 & #5	+	0.6 fc	1.0 fc	0.3 fc	3.3:1	2.0:1

PROJECT TITLE
Paragon Place at
Bear Claw Way
Ziegler Site - Lot 9

LUMINAIRE SCHEDULE						
SYMBOL LABE	L QTY. MANUF.	CATALOG	DESCRIPTION	FILE	MOUNTING	
A	4 LITHONIA LIGHTING	DSXWPM LED 10C 350 30K T2S MVOLT HS	DSXWPM LED WITH (I) I0 LED LIGHT ENGINE, TYPE T2S OPTIC, 3000K AT 350mA, WITH HOUSE SIDE SHIELD	DSXWPM_LED_10C _350_30K_T2S _MVOLT_HS.ies	16'-0" POLE ON FLUSH CONC. BASE	
	E	(AMPLE LIGHT FI)	ISOLUX CO	ONTOUR = 0.25 FC ONTOUR = 0.5 FC ONTOUR = 1.0 FC		

304 Lakota Way Madison, Wisconsin SHEET TITLE
Site Lighting Plan

SHEET NUMBER


C-200

PROJECT NO. 2214 © Knothe & Bruce Architects, LLC


SITE LIGHTING PLAN


C-200


I" = 30'-0"

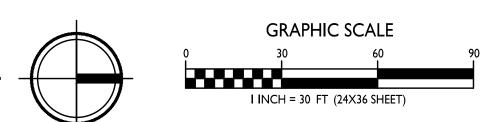



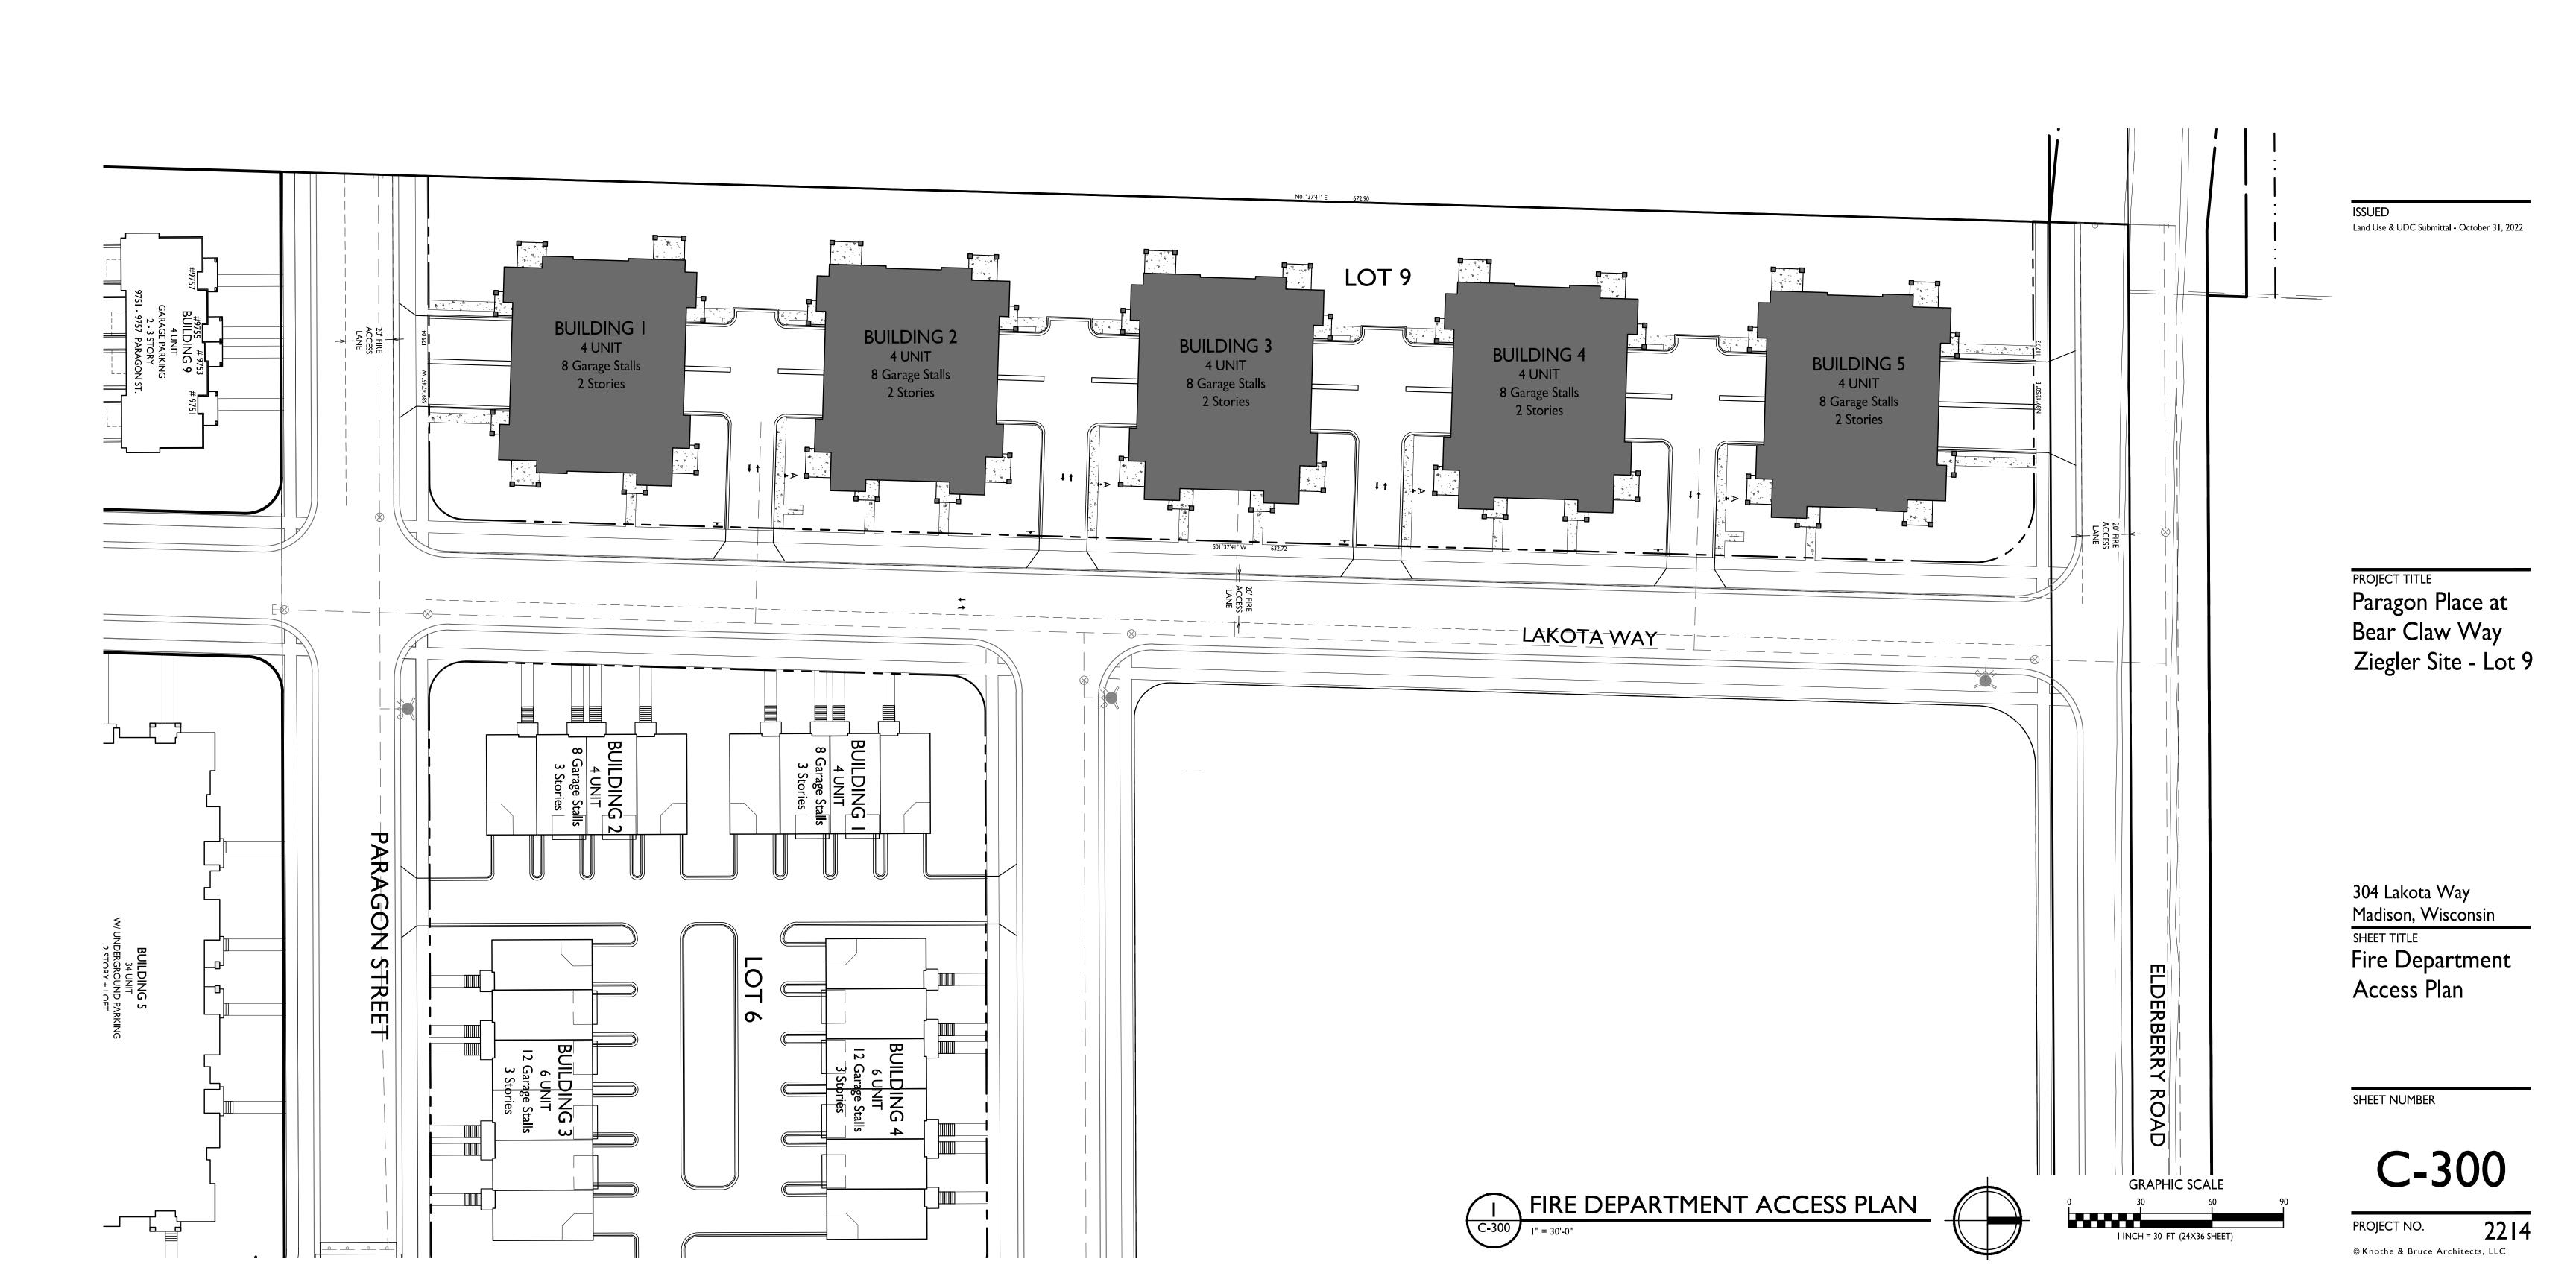

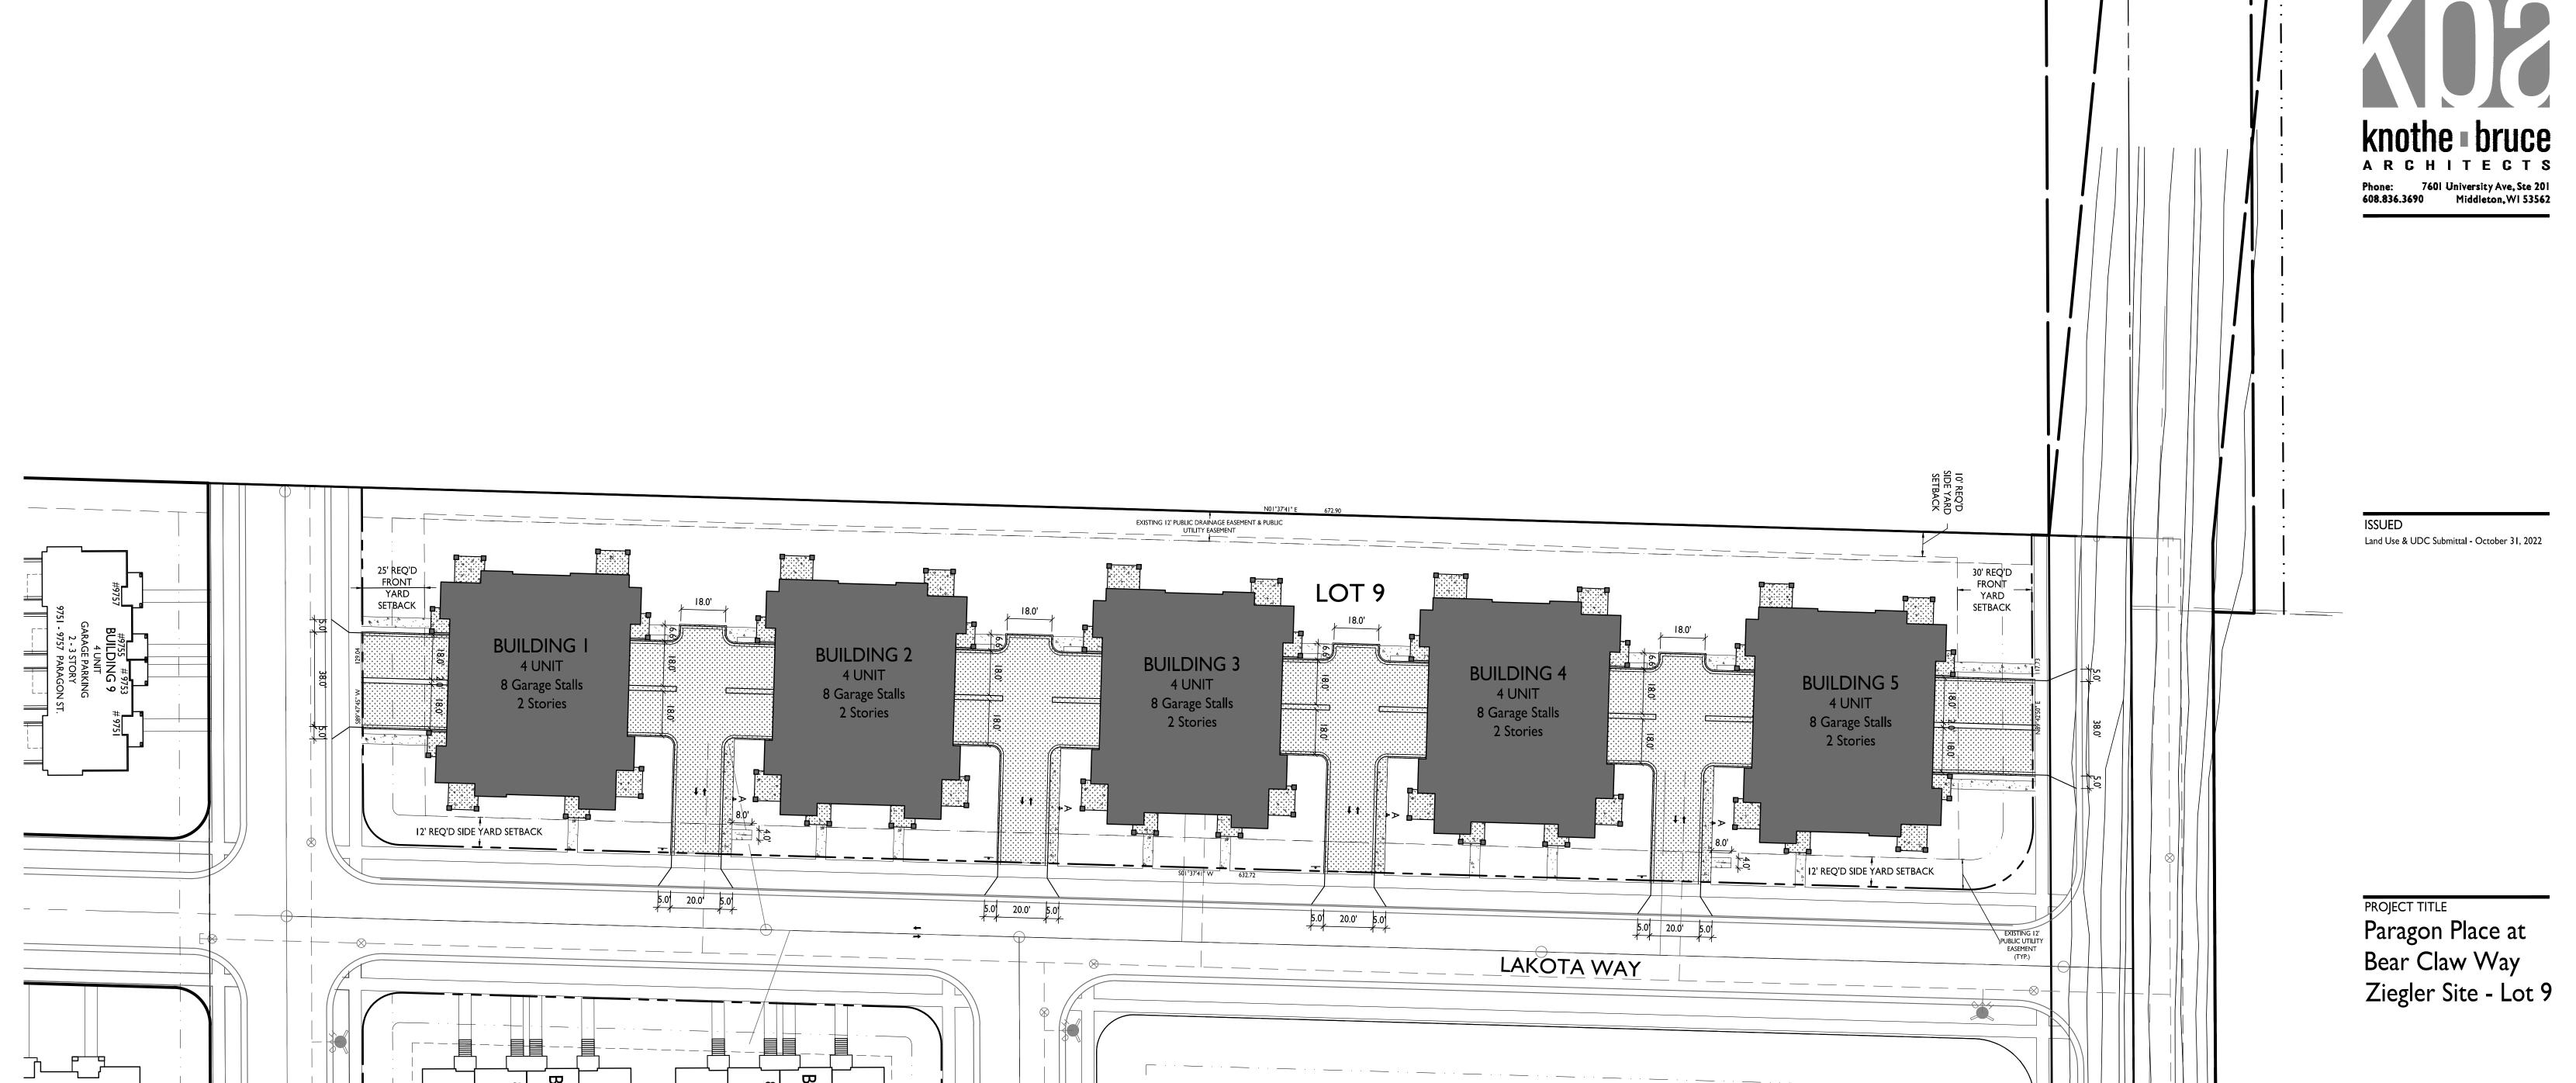

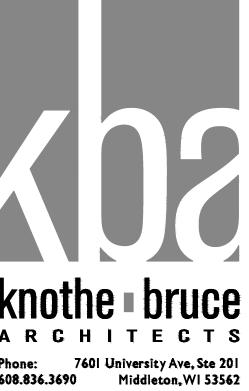

304 Lakota Way Madison, Wisconsin SHEET TITLE Lot Coverage

LOT COVERAGE

ZONING: SR-V2 SUBURBAN RESIDENTIAL - VARIED DISTRICT TOTAL LOT AREA 96,385 S.F. MAX. ALLOWED 57,831 S.F. (60%)


PROPOSED LOT COVERAGE


SHEET NUMBER 54,148 S.F. (56%)

C-400

PROJECT NO. 2214 © Knothe & Bruce Architects, LLC



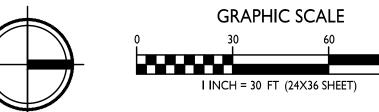

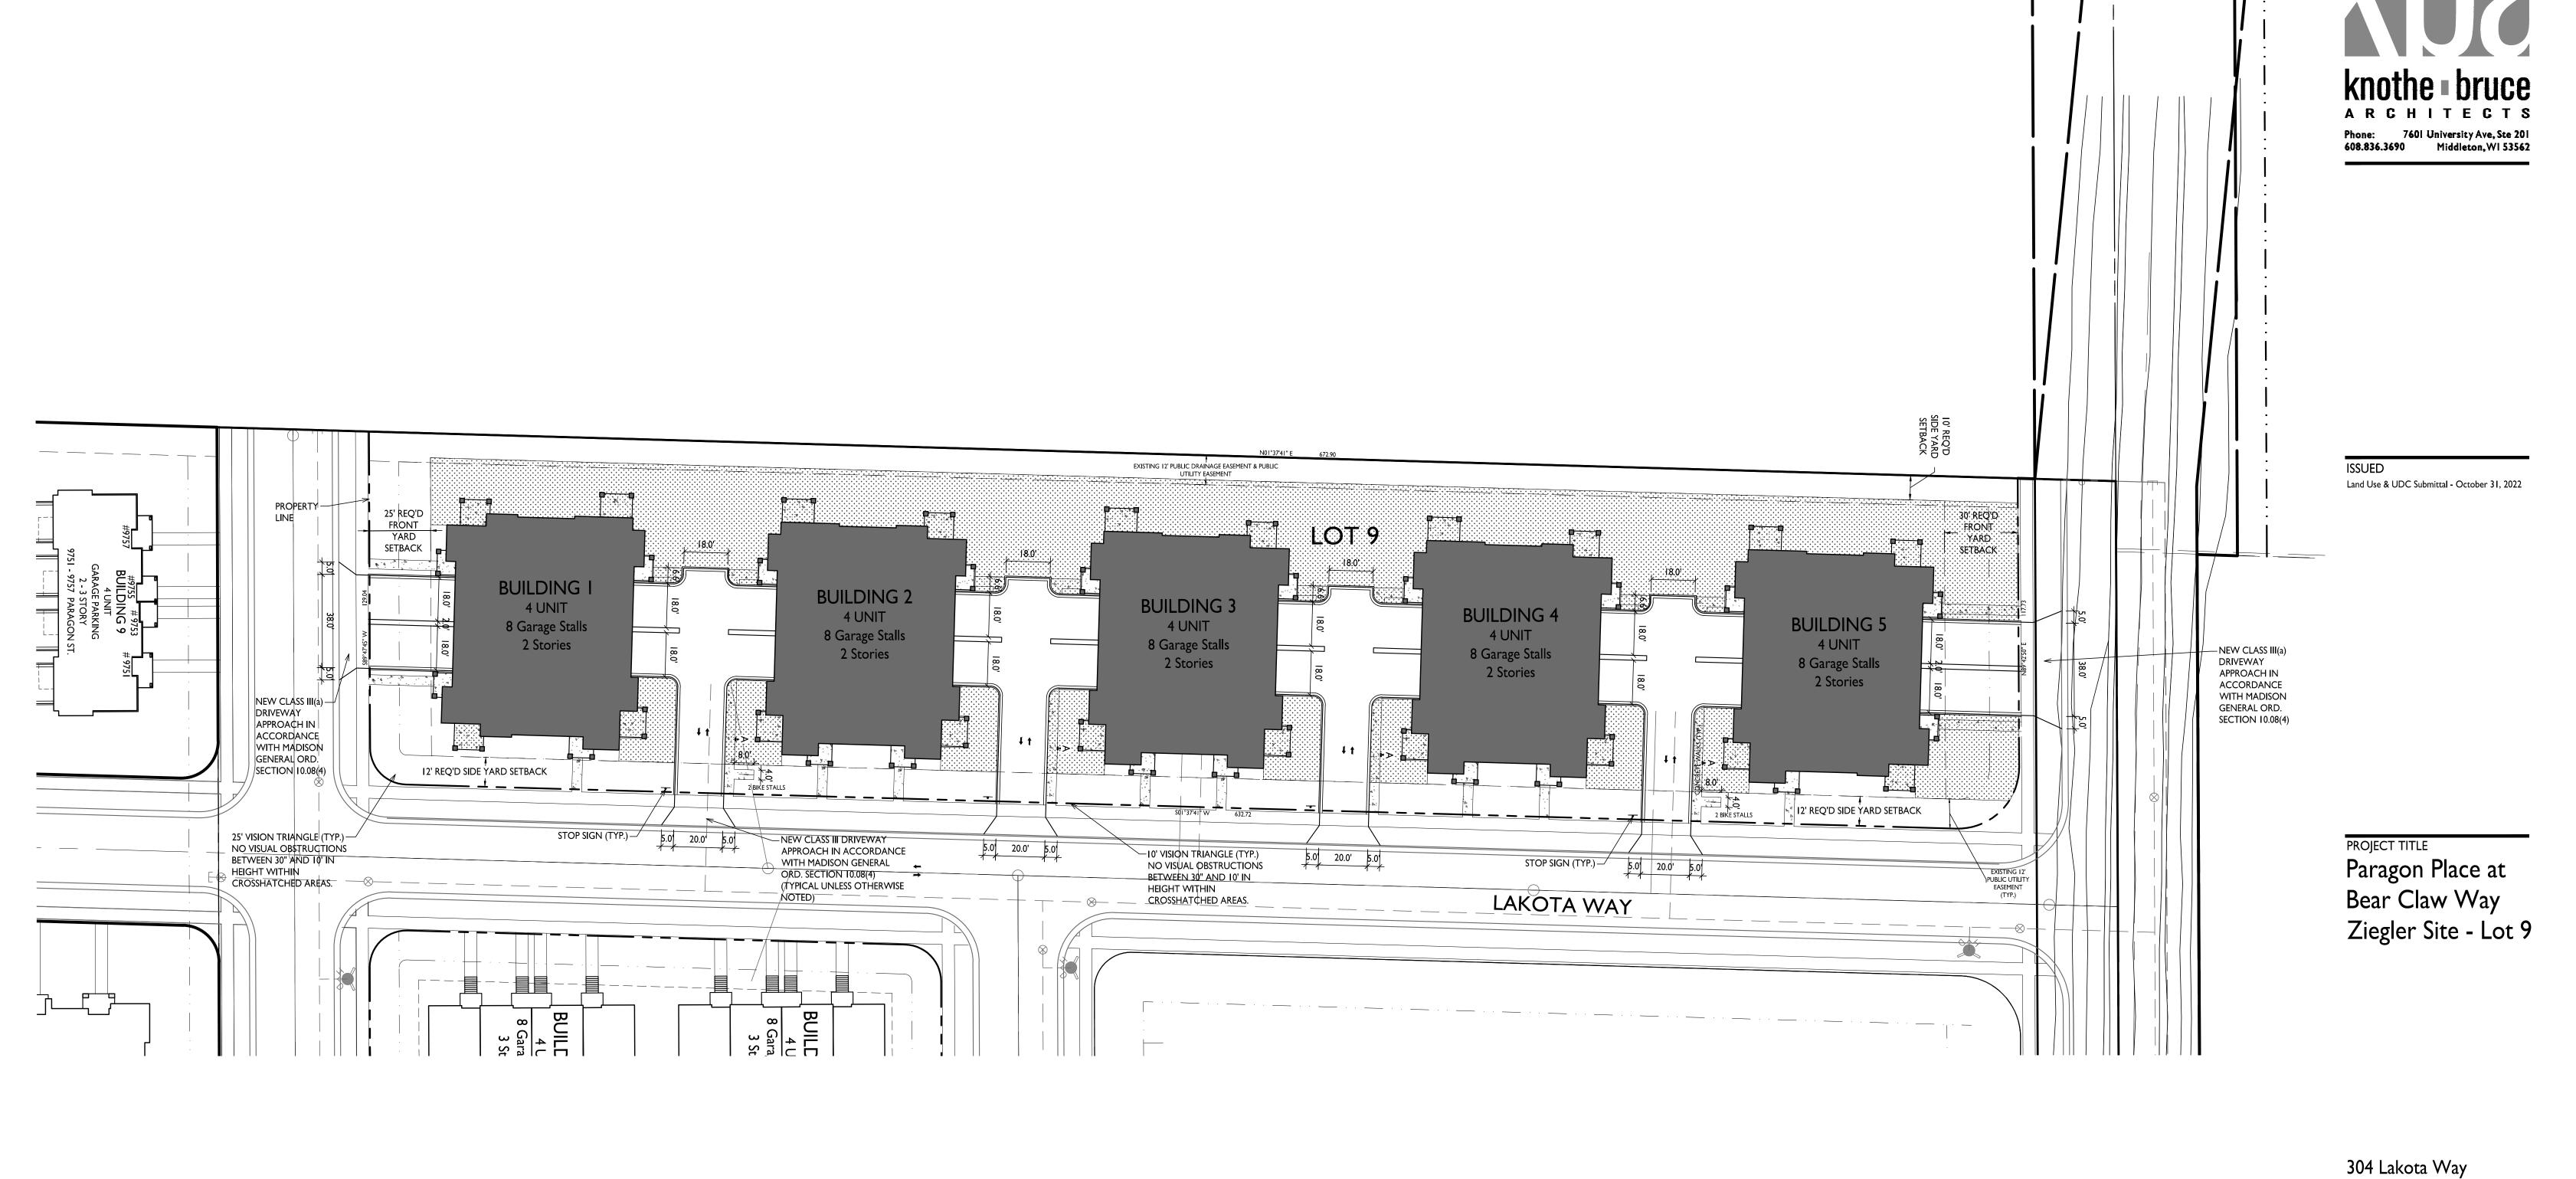

Madison, Wisconsin

SHEET TITLE

Usable Open

Space

SHEET NUMBER

PROJECT NO.

C-500

© Knothe & Bruce Architects, LLC

2214

USABLE OPEN SPACE

I" = 30'-0"

GRAPHIC SCALE

0 30 60

I INCH = 30 FT (24X36 SHEET)

ZONING: SR-V2 SUBURBAN RESIDENTIAL - VARIED DISTRICT

320 S.F./ 2+ BEDROOM

27,101 S.F. PROVIDED (1,355 S.F./2+ BDRM)

6,400 S.F. REQUIRED

2,309 S.F.

24,792 S.F.

USABLE OPEN SPACE

OPEN SPACE REQUIREMENT

DWELLING UNITS


OPEN SPACE PROVIDED

BALCONIES

SURFACE


GENERAL NOTES

- 1. THE LATEST EDITIONS OF THE FOLLOWING DOCUMENTS AND ANY SUPPLEMENTS THERETO SHALL GOVERN ALL CONSTRUCTION ITEMS ON THIS PLAN UNLESS OTHERWISE NOTED.
- -STANDARD SPECIFICATIONS FOR SEWER AND WATER CONSTRUCTION IN WISCONSIN, 6TH EDITION (SSSWCW)
- -THE WISCONSIN D.O.T. STANDARD SPECIFICATIONS FOR HIGHWAY AND STRUCTURE
- CONSTRUCTION, LATEST EDITION -WDNR STORMWATER RUNOFF TECHNICAL STANDARDS.
- -WISDOT PAL APPROVED EROSION CONTROL MEASURES LIST, LATEST EDITION. -CITY OF MADISON DEVELOPMENT STANDARDS, LATEST EDITION.
- 2. THE CONTRACTOR SHALL TAKE ALL MEASURES NECESSARY TO MINIMIZE EROSION. WATER POLLUTION AND SILTATION CAUSED BY CONSTRUCTION OF THIS PROJECT. EROSION CONTROL MEASURES SHALL BE IN ACCORDANCE WITH WISCONSIN DEPARTMENT OF NATURAL RESOURCES TECHNICAL STANDARDS.
- 3. EROSION CONTROL PLAN: PRIOR TO BEGINNING WORK, AN APPROVED EROSION CONTROL PLAN WILL BE PROVIDED BY THE ENGINEER. THE CONTRACTOR IS RESPONSIBLE FOR PROPERLY IMPLEMENTING THE APPROVED PLAN.
- 4. THE CONTRACTOR SHALL FIELD VERIFY THE ELEVATIONS OF THE BENCHMARKS PRIOR TO COMMENCING WORK. THE CONTRACTOR SHALL ALSO FIELD VERIFY LOCATION, ELEVATION AND SIZE OF EXISTING UTILITIES, AND VERIFY FLOOR, CURB OR PAVEMENT ELEVATIONS WHERE MATCHING INTO EXISTING WORK. THE CONTRACTOR SHALL FIELD VERIFY HORIZONTAL CONTROL BY REFERENCING SHOWN COORDINATES TO KNOWN PROPERTY LINES. NOTIFY ENGINEER OF DISCREPANCIES IN EITHER VERTICAL OR HORIZONTAL CONTROL PRIOR TO PROCEEDING WITH WORK.
- 5. THE CONTRACTOR SHALL VERIFY THE EXACT LOCATION OF ALL UNDERGROUND UTILITIES PRIOR TO BEGINNING CONSTRUCTION (CALL DIGGERS HOTLINE AT 800-242-8511). COST OF REPLACEMENT OR REPAIR OF EXISTING UTILITIES DAMAGED AS A RESULT OF THE CONTRACTOR'S OPERATION SHALL BE THE CONTRACTOR'S RESPONSIBILITY
- 6. EXISTING UTILITY INFORMATION IS SHOWN FROM SURVEY WORK, FIELD OBSERVATIONS, AVAILABLE PUBLIC RECORDS, AND AS-BUILT DRAWINGS. EXACT LOCATIONS AND ELEVATIONS OF UTILITIES SHALL BE DETERMINED PRIOR TO INSTALLING NEW WORK. EXCAVATE TEST PITS AS REQUIRED.
- 7. PROPERTY CORNERS SHALL BE CAREFULLY PROTECTED UNTIL THEY HAVE BEEN REFERENCED BY A PROFESSIONAL LAND SURVEYOR. PROPERTY MONUMENTS DISTURBED BY THE CONTRACTOR'S OPERATIONS SHALL BE REPLACED AT THE CONTRACTOR'S EXPENSE.
- 8. ENGINEER SHALL BE NOTIFIED 48 HOURS IN ADVANCE OF PERFORMING ANY
- 9. ALL TRENCHING SHALL BE PERFORMED ACCORDING TO OSHA STANDARDS.
- 10. ALL ITEMS SHALL INCLUDE ALL THE NECESSARY MATERIALS AND LABOR TO COMPLETE THE ITEM IN PLACE.
- 11. THE CONTRACTOR SHALL CLEAN ALL ADJACENT STREETS OF ANY SEDIMENT OR DEBRIS BY SWEEPING BEFORE THE END OF THE WORKING DAY.
- 12. THE RIGHT-OF-WAY IS THE SOLE JURISDICTION OF THE CITY OF MADISON AND IS SUBJECT TO CHANGE AT ANY TIME PER THE RECOMMENDATION/PLAN OF TRAFFIC ENGINEERING AND CITY ENGINEERING

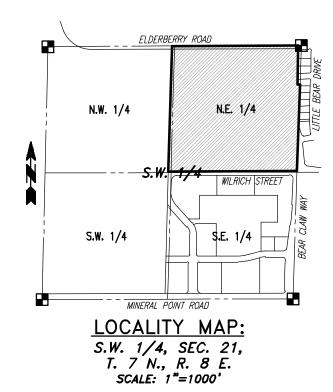

PARAGON PLACE AT BEAR CLAW WAY LOT 9 SITE DEVELOPMENT PLANS

CITY OF MADISON, WISCONSIN

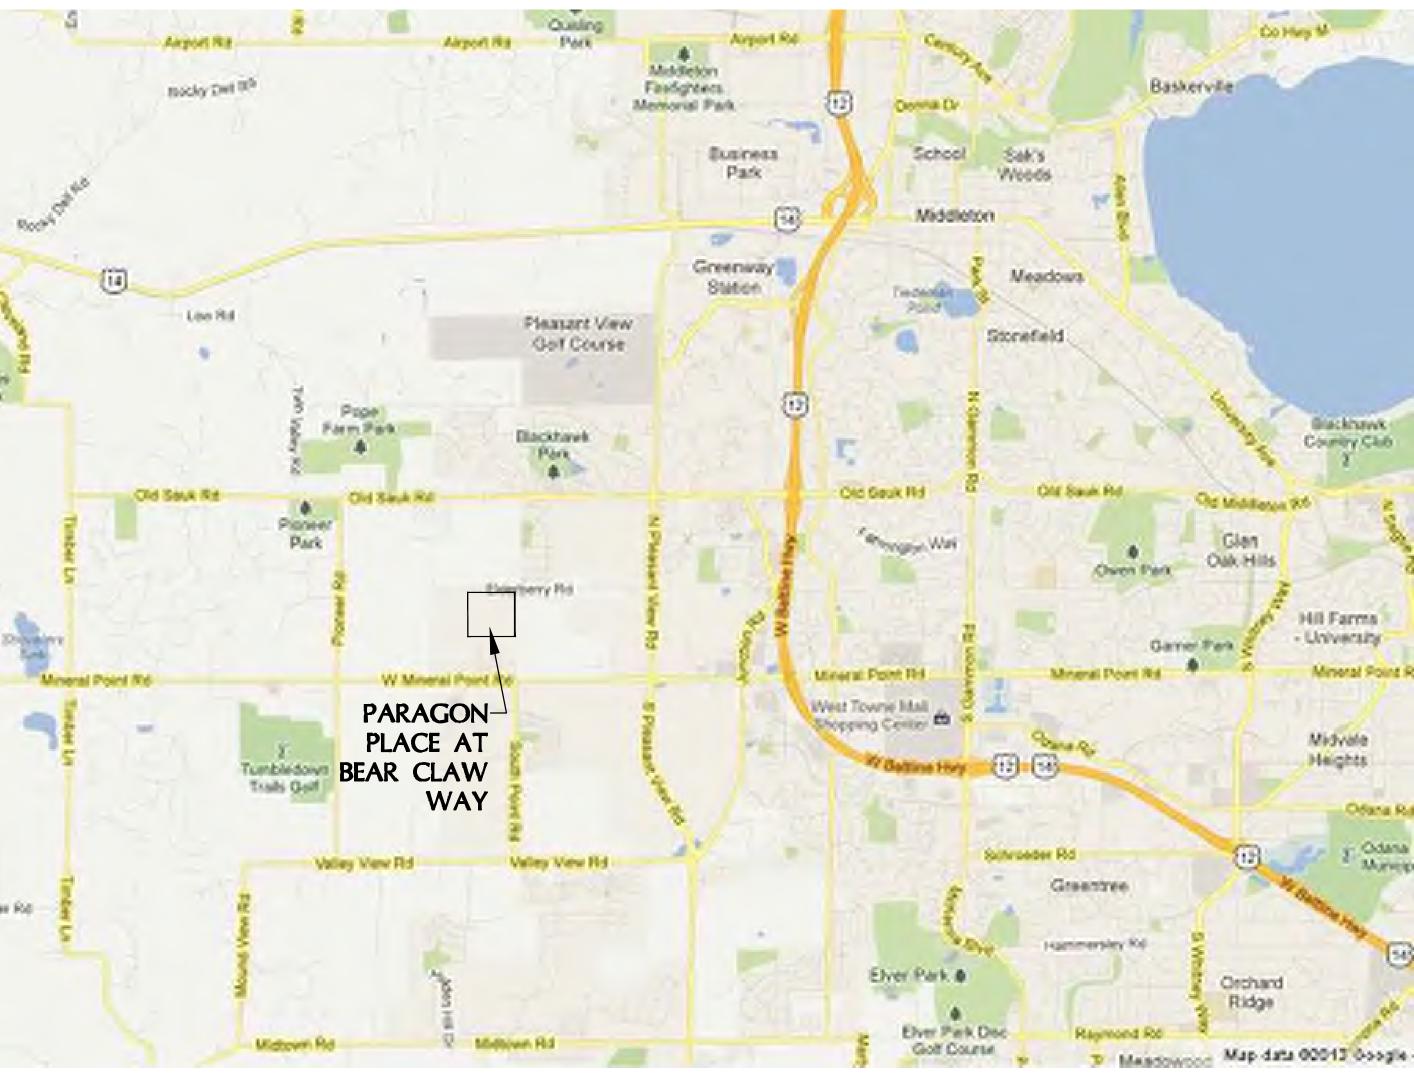


PRELIMINARY SET


NOT FOR CONSTRUCTION

VICINITY MAP NOT TO SCALE

SHEET INDEX

CIVIL		
C0.0	_	COVER SHEET
C1.0	_	CONTRACT LIMITS PLAN
C1.1	_	PROPOSED SITE PLAN
C2.0	_	MASTER GRADING AND PAVING PLAN
C2.1	_	EROSION CONTROL PLAN
C3.0	_	OVERALL UTILITY PLAN
C4.0-4.1	_	CONSTRUCTION NOTES & DETAILS

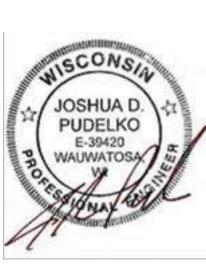

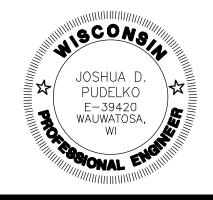



PARAGON PLACE

EMAIL: jpudelko@trioeng.com

760| University Ave. Ste 20| 608.836.3690 Middleton, WI 53562

PARAGON LOT 9

PROJE **REVISION HISTORY** DATE | DESCRIPTION 10/26/2022 INITIAL SUBMITTAL

DATE: OCTOBER 26, 2022

JOB NUMBER: 12041

DESCRIPTION:


COVER SHEET


SHEET

CO.0

CONTRACTOR IS REQUIRED TO CONTACT DIGGERS HOTLINE TOLL FREE TO OBTAIN LOCATION OF UNDERGROUND UTILITIES PRIOR TO COMMENCING THE WORK. WISCONSIN STATUTE 182.0715 REQUIRES MIN. OF 3 WORK DAYS NOTICE BEFORE YOU EXCAVATE. **CALL DIGGERS HOTLINE 1-800-242-8511**

EXISTING UNDERGROUND UTILITY INFORMATION WAS OBTAINED FROM AVAILABLE RECORDS. THE ENGINEER MAKES NO GUARANTEE AS TO THE ACCURACY OF THIS INFORMATION. VERIFICATION TO THE SATISFACTION OF THE CONTRACTOR OF ALL UNDERGROUND UTILITIES, WHETHER OR NOT SHOWN ON THE PLANS, SHALL BE ASSUMED AS A CONDITION OF THE CONTRACT. THE CONTRACTOR SHALL NOTIFY THE ENGINEER OF ANY DISCREPANCIES BETWEEN LOCATION OF UTILITIES IN THE FIELD AND LOCATIONS SHOWN ON THE PLANS.

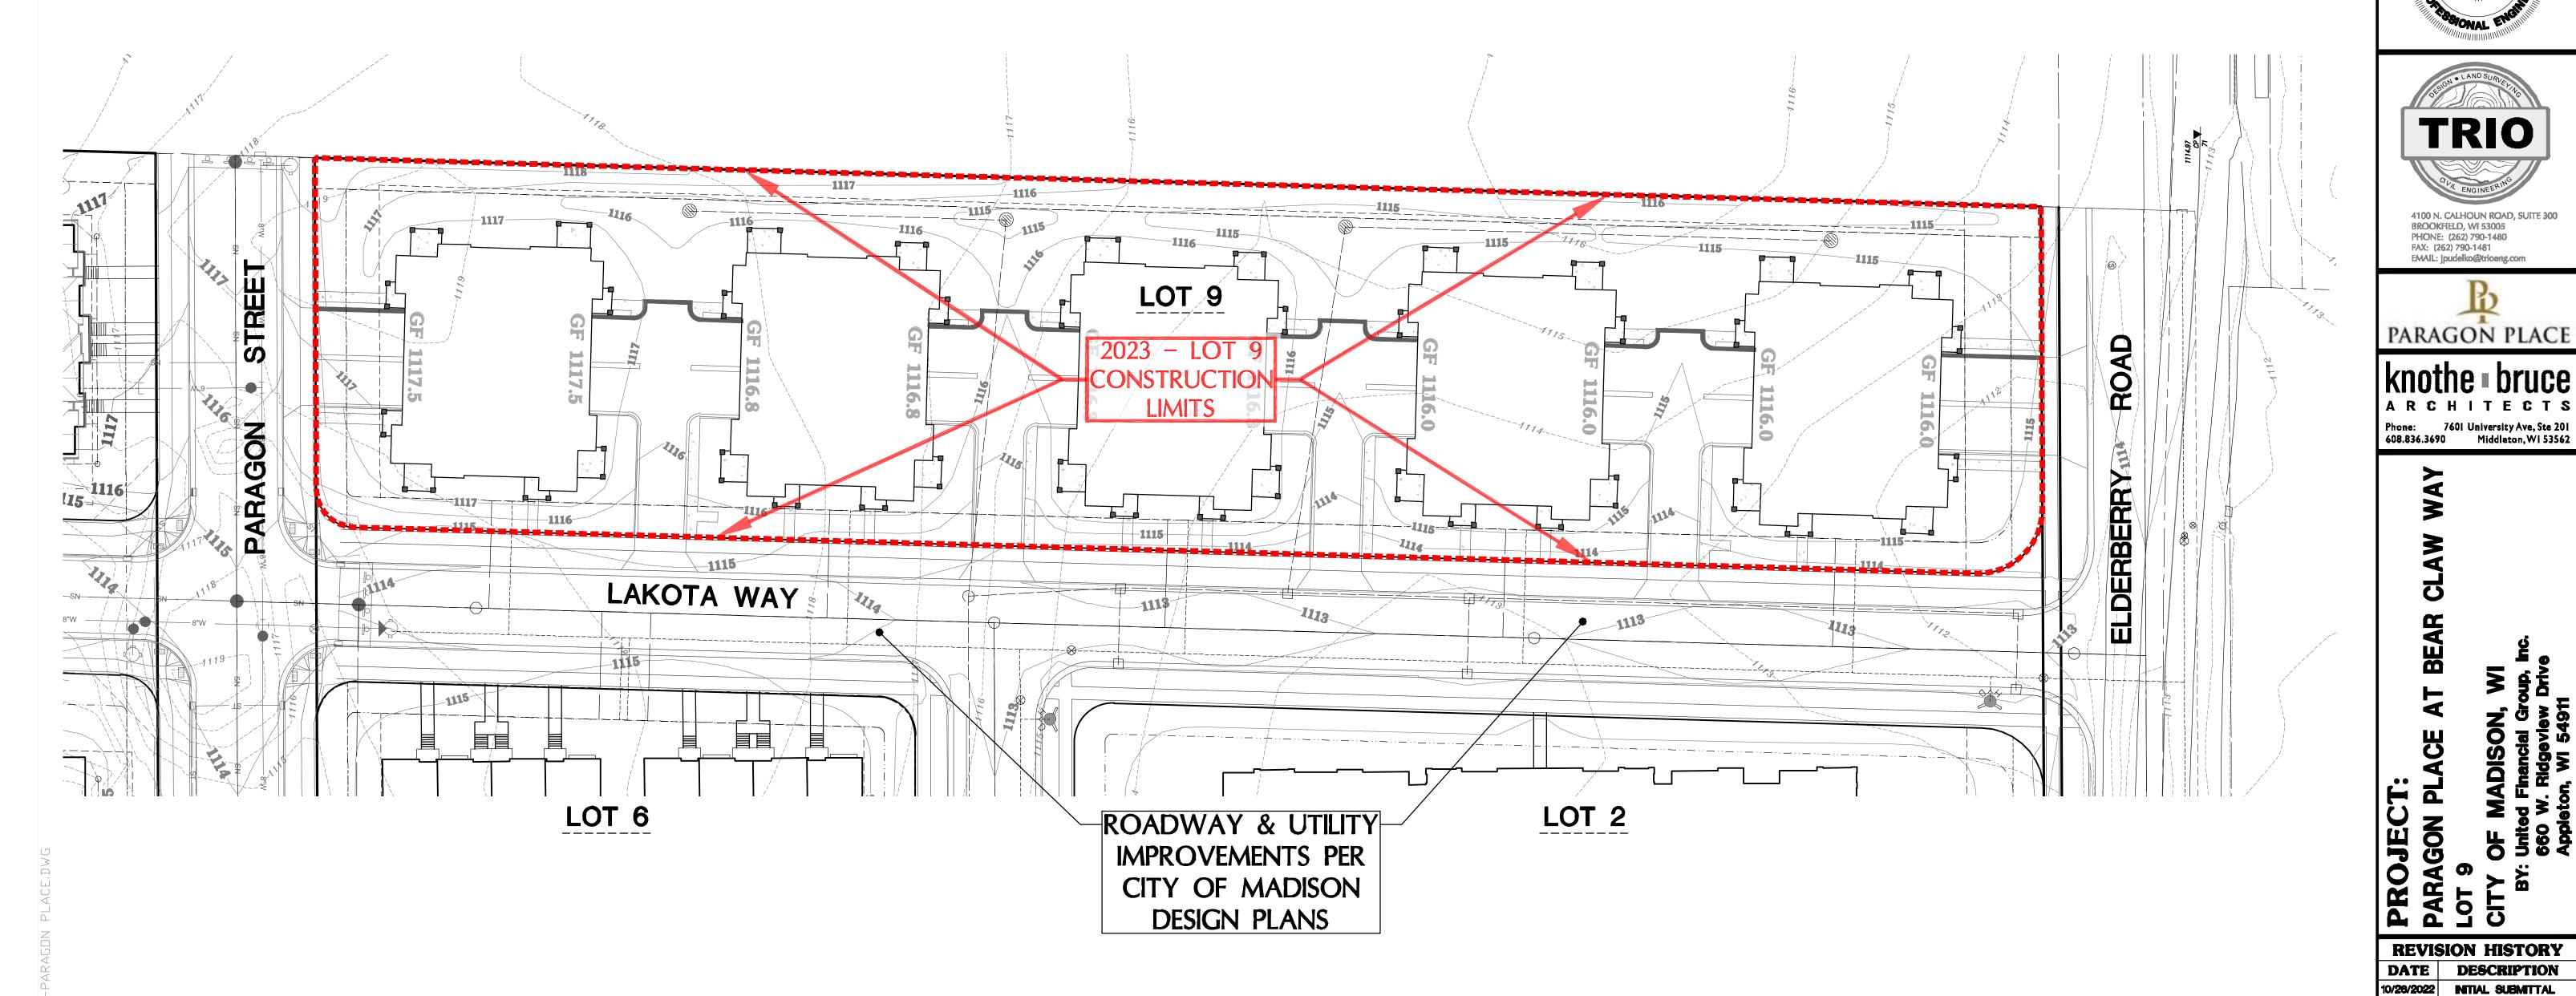


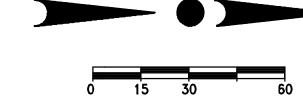

Scale: 1" = 60' (11"X17")

PUBLIC IMPROVEMENTS NOTE:
THE RIGHT OF WAY IS THE SOLE JURISDICTION OF THE CITY OF MADISON AND IS SUBJECT TO CHANGE AT ANY TIME PER THE RECOMMENDATION/PLAN OF TRAFFIC ENGINEERING AND CITY ENGINEERING

DIVISIONS.

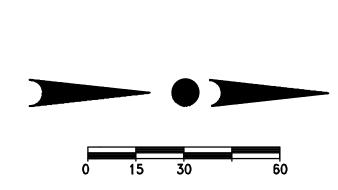

Scale: 1" = 30' (22"X34")

DESCRIPTION:

DATE:

CONTRACT LIMITS PLAN


OCTOBER 26, 2022

12041

JOB NUMBER:

SHEET

C1.0

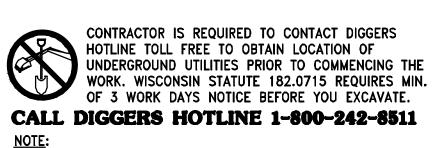

NOTE: EXISTING UNDERGROUND UTILITY INFORMATION WAS OBTAINED FROM AVAILABLE RECORDS. THE ENGINEER MAKES NO GUARANTEE AS TO THE ACCURACY OF THIS INFORMATION. VERIFICATION TO THE SATISFACTION OF THE CONTRACTOR OF ALL UNDERGROUND UTILITIES, WHETHER OR NOT SHOWN ON THE PLANS, SHALL BE ASSUMED AS A CONDITION OF THE CONTRACT. THE CONTRACTOR SHALL NOTIFY THE ENGINEER OF ANY DISCREPANCIES BETWEEN LOCATION OF UTILITIES IN THE FIELD AND LOCATIONS SHOWN ON THE PLANS.

- EXISTING SANITARY SEWER
- EXISTING SANITARY MANHOLE
- W - EXISTING WATER MAIN
- EXISTING HYDRANT
- EXISTING STORM SEWER
- EXISTING STORM MANHOLE
- EXISTING STORM INLET
- PROPOSED SANITARY SEWER
- PROPOSED SANITARY MANHOLE
- PROPOSED WATER MAIN
- PROPOSED WATER VALVE
- PROPOSED STORM SEWER
- PROPOSED STORM SEWER
- PROPOSED STORM SEWER
- PROPOSED STORM MANHOLE

- PROPOSED STORM INLET

- PROPOSED STORM END SECTION

LEGEND:


0 15 30 60

Scale: 1" = 30' (22"X34")

Scale: 1" = 60' (11"X17")

PUBLIC IMPROVEMENTS NOTE

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PHONE: (262) 790-1480 FAX: (262) 790-1481 EMAIL: jpudelko@trioeng.com

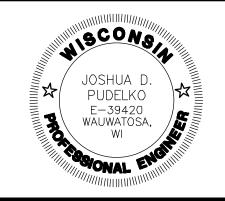knothe | bruce

Phone: 7601 University Ave, Ste 201 608.836.3690 Middleton, WI 53562

PLACE AT BEAR CLAW W/ADISON, WI
Financial Group, Inc.
Ridgeview Drive

REVISION HISTORY
DATE DESCRIPTION
10/26/2022 NITIAL SUBMITTAL

DATE:OCTOBER 26, 2022

JOB NUMBER: 12041

DESCRIPTION:

SITE PLAN

SHEET

C1.1

CONTRACTOR IS REQUIRED TO CONTACT DIGGERS
HOTLINE TOLL FREE TO OBTAIN LOCATION OF
UNDERGROUND UTILITIES PRIOR TO COMMENCING THE
WORK. WISCONSIN STATUTE 182.0715 REQUIRES MIN.
OF 3 WORK DAYS NOTICE BEFORE YOU EXCAVATE.

CALL DIGGERS HOTLINE 1-800-242-8511


EXISTING UNDERGROUND UTILITY INFORMATION WAS OBTAINED FROM AVAILABLE RECORDS. THE ENGINEER MAKES NO GUARANTEE AS TO THE ACCURACY OF THIS INFORMATION. VERIFICATION TO THE SATISFACTION OF THE CONTRACTOR OF ALL UNDERGROUND UTILITIES, WHETHER OR NOT SHOWN ON THE PLANS, SHALL BE ASSUMED AS A CONDITION OF THE CONTRACT. THE CONTRACTOR SHALL NOTIFY THE ENGINEER OF ANY DISCREPANCIES BETWEEN LOCATION OF UTILITIES IN THE FIELD AND LOCATIONS SHOWN ON THE PLANS.

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CALL DIGGERS HOTLINE 1-800-242-8511

NOTE:
EXISTING UNDERGROUND UTILITY INFORMATION WAS OBTAINED FROM AVAILABLE RECORDS. THE ENGINEER MAKES NO GUARANTEE AS TO THE ACCURACY OF THIS INFORMATION. VERIFICATION TO THE SATISFACTION OF THE CONTRACTOR OF ALL UNDERGROUND UTILITIES, WHETHER OR NOT SHOWN ON THE PLANS, SHALL BE ASSUMED AS A CONDITION OF THE CONTRACT. THE CONTRACTOR SHALL NOTIFY THE ENGINEER OF ANY DISCREPANCIES BETWEEN LOCATION OF UTILITIES IN THE FIELD AND LOCATIONS SHOWN ON THE PLANS.

LEGEND: --1 1 1 0 ----- **– EXISTING CONTOUR —1110** — — PROPOSED CONTOUR PROPOSED GARAGE FLOOR PROPOSED FLOW ARROW ■ PROPOSED SPOT ELEVATION

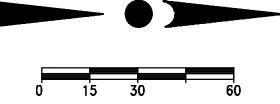

Scale: 1" = 30' (22"X34")

Scale: 1" = 60' (11"X17")

PUBLIC IMPROVEMENTS NOTE: THE RIGHT OF WAY IS THE SOLE JURISDICTION OF THE CITY OF MADISON AND IS SUBJECT TO CHANGE AT ANY TIME PER THE RECOMMENDATION/PLAN OF TRAFFIC ENGINEERING AND CITY ENGINEERING DIVISIONS.





EMAIL: jpudelko@trioeng.com PARAGON PLACE

FAX: (262) 790-1481

Phone: 760| University Ave, Ste 20| 608.836.3690 Middleton, WI 53562

PROJEC
PARAGON
LOT 9
CITY OF N

REVISION HISTORY DATE DESCRIPTION 10/26/2022 INITIAL SUBMITTAL

DATE: OCTOBER 26, 2022


JOB NUMBER: 12041

DESCRIPTION:

MASTER GRADING & PAVING PLAN

SHEET

C2.0

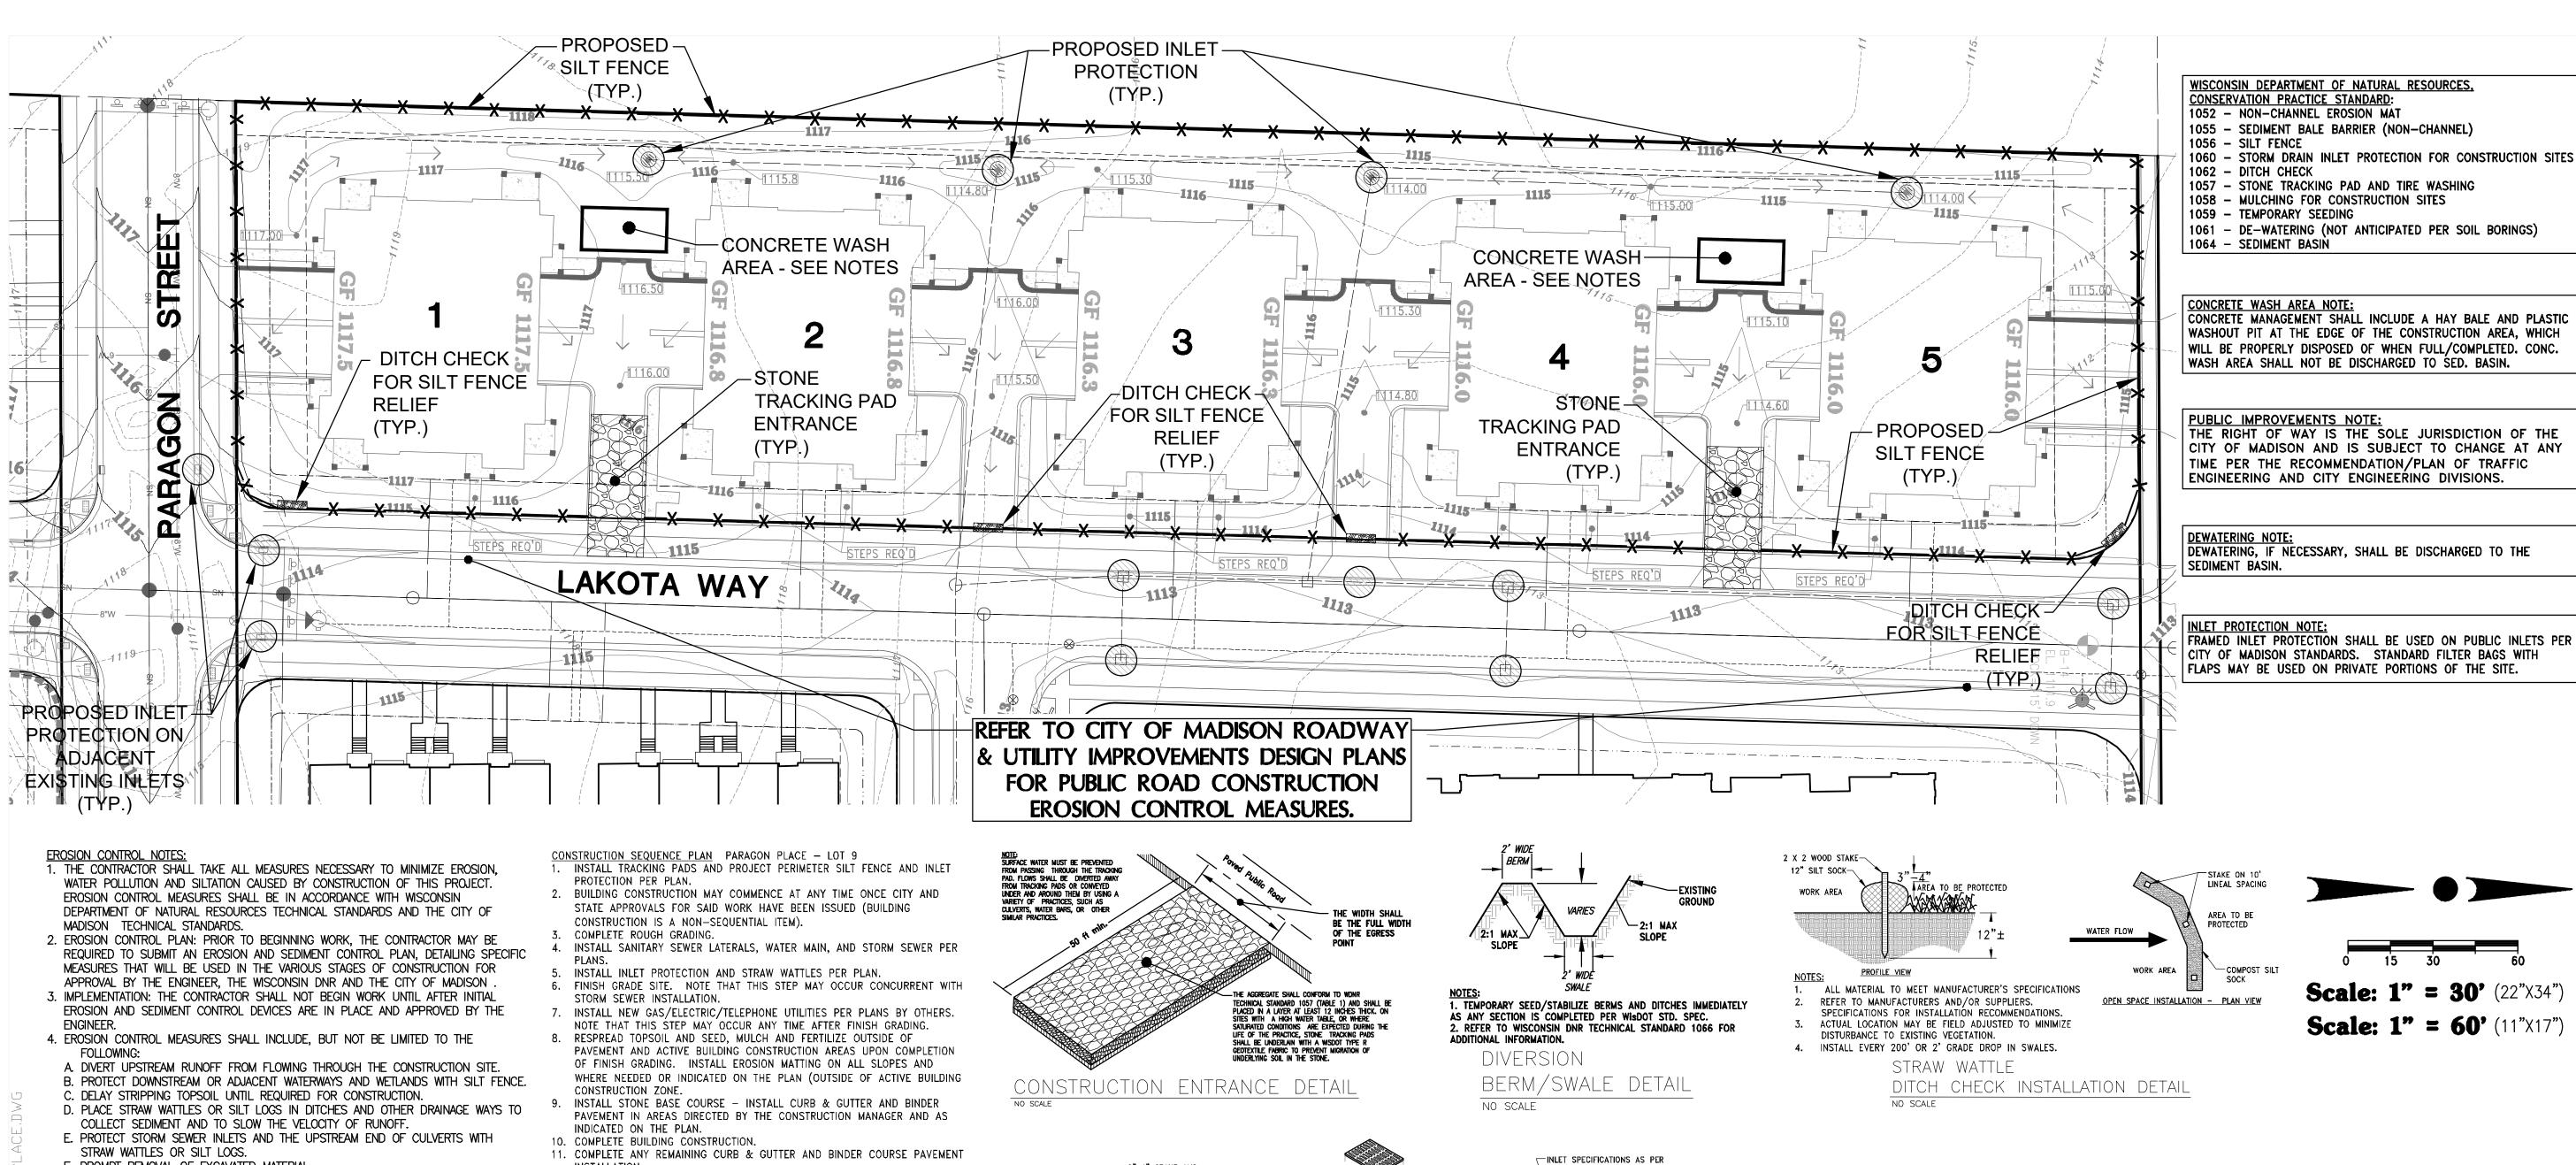

F. PROMPT REMOVAL OF EXCAVATED MATERIAL

G. PROPER STORAGE OF BACKFILL AND BEDDING MATERIALS INCLUDING PLACING SILT FENCE OR EROSION CONTROL BALES ON THE DOWNSLOPE SIDES OF SPOIL PILES. H. CONSTRUCTION OF TRACKING PAD TO CONSTRUCTION SITE TO PREVENT SEDIMENT FROM BEING TRACKED ONTO ROADWAYS.

I. PROMPT (SAME DAY) CLEANUP OF MATERIAL TRACKED ONTO ADJACENT STREETS.

J. TIMELY RESTORATION OF DAMAGE SURFACE AREAS. K. ALL AREAS THAT WILL REMAIN DISTURBED AFTER OCTOBER 15, MUST BE TEMPORARY SEEDED AS OF THAT DATE.

5. TEMPORARY EROSION CONTROL MEASURES.

A. THE CONTRACTOR SHALL CONSTRUCT TEMPORARY EROSION CONTROL MEASURES, WHERE EROSION IS LIKELY TO BE A PROBLEM, PRIOR TO BEGINNING WORK ON THOSE SECTION(S) OF THE PROJECT. TEMPORARY EROSION CONTROL MEASURES SHALL BE MAINTAÍNED UNTIL AFTER PERMANENT EROSION CONTROL, SUCH AS SEEDING OR SODDING, HAS BEEN ESTABLISHED.

B. IN THE EVENT THE PERMANENT EROSION CONTROL MEASURES ARE NOT FULLY IMPLEMENTED IN CURRENT CONSTRUCTION SEASON, THE CONTRACTOR SHALL BE RESPONSIBLE FOR MAINTAINING ALL NECESSARY TEMPORARY EROSION CONTROL MEASURES UNTIL AFTER PERMANENT MEASURES HAVE BEEN COMPLETED IN THE FOLLOWING YEAR.

6. ALL EXPOSED SOIL AREAS NOT DISTURBED FOR UP TO SEVEN DAYS MUST BE IMMEDIATELY RESTORED WITH SEED AND MULCH.

7. TRENCH DEWATERING SHALL BE IN ACCORDANCE WITH WDNR AND THE CITY OF MADISON TECHNICAL STANDARDS.

A. ALL PUMPED EFFLUENT FROM DEWATERING OPERATIONS (TRENCH DEWATERING OR OTHERWISE) SHALL BE DISCHARGED TO A GEOTEXTILE FILTER BAG CONFORMING TO WDNR CONSERVATION PRACTICE STANDARD 1061. THE GEOTEXTILE FILTER BAG SHALL BE PLACED ON VEGETATED/STABILIZED GROUND AND DISCHARGE TO A SEDIMENT BASIN OR TRAP. SHOULD NO BASIN EXIST, THE GEOTEXTILE BAG SHALL BE PLACED ON FILTER FABRIC AND SURROUNDED BY A SEDIMENT BALE BARRIER CONFORMING TO CONSERVATION PRACTICE STANDARD 1055. THE FILTER FABRIC SHALL BE BROUGHT UP THE SIDES AND OVER THE TOP OF THE HAY BALES AND SECURED. DISCHARGE SHALL NOT BE ALLOWED TO FLOW OVER UNPROTECTED GROUND. IN NO CASE SHALL PUMPED WATER BE DIVERTED OUTSIDE THE PROJECT LIMITS PRIOR TO SEDIMENT REMOVAL.

8. INSTALL SILT FENCE IN ACCORDANCE WITH WDNR TECHNICAL STANDARD DETAILS 9. ALL RIP RAP AT PIPE OUTLETS SHALL BE 3'x5' MEDIUM RIP RAP OVER TYPE HR FABRIC PER WDOT SPECIFICATIONS UNLESS OTHERWISE DESIGNATED.

10. EROSION CONTROL INSPECTION AND MAINTENANCE A. INSPECT EROSION CONTROL MEASURES WEEKLY AND AFTER SITE RECEIVES 0.5" OF RAIN IN A 24-HOUR PERIOD DURING CONSTRUCTION.

B. REPAIR OR REPLACE EROSION CONTROLS THAT ARE DAMAGED OR FAILING. 11. ALL AREAS TO BE SEEDED AND MULCHED SHALL USE WDOT SEED MIXTURE NO. 20. MULCH SHALL APPLIED PER WDOT SPECIFICATIONS USING METHOD B FOR PLACEMENT.

INSTALLATION 12. INSTALL SIDEWALK AS INDICATED ON THE PLAN, PER CONSTRUCTION

MANAGER'S SCHEDULE AND DIRECTION. 13. RESPREAD TOPSOIL AND SEED, MULCH AND FERTILIZE BUILDING CONSTRUCTION ZONE AREA. INSTALL LANDSCAPING PER LANDSCAPE PLAN AND CONSTRUCTION MANAGER'S SCHEDULE/DIRECTION.

14. REMOVE PERIMETER SILT FENCE ONCE THE AREA IS SUBSTANTIALLY STABILIZED/VEGETATED - ANTICIPATED TO BE CONCURRENT WITH COMPLETION OF FINAL LANDSCAPING.

TEMPORARY

DEWATERING GEOTEXTILE BAG

1. IF DEWATERING IS REQUIRED, A GEOTEXTILE DEWATERING BAG MEETING THE SPECIFICATIONS IN THE TABLE TO THE RIGHT SHALL BE UTILIZED AS STATED ON THE EROSION CONTROL PLAN.

REFER TO WDNR TECHNICAL STANDARDS 1061 AND MANUFACTURERS REQUIREMENTS FOR INSTALLATION AND MAINTENANCE REQUIREMENTS. CONTRACTOR MAY USE THRACE-LINQ, INC 275EX

GEOTEXTILE BAG, OR FUNCTIONAL EQUIVALENT TO MEET TECHNICAL STANDARD REQUIREMENTS. CONTRACTOR MAY INSTALL HAY BALES AROUND DEWATERING BAG FOR STABILIZATION AS DICTATED

BY SITE CONDITIONS. MAX FLOW RATE SHALL NOT EXCEED 100GPM

Property	Test Method	Type I Value
Maximum Apparent Opening Sizes	ASTM D-4751	0.212 mm
Grab Tensile Strength	ASTM D-4632	200 lbs.
Mullen Burst	ASTM D-3786	350 psi
Permeability	ASTM D-4491	0.28 cm/sec
Fabric	Nominal Representative Weight	8 oz


DIRECTION OF RUNOFF WATER GRATED INLET BURIED FABRIC, MIN. 6" DEPTH -2"x4" STAKE AND CROSS BRACING GEOTEXTILE FABRIC.


INLET PROTECTION, TYPE A

GEOTEXTILE FABRIC.-

INLET WITH OR-

GENERAL NOTES:

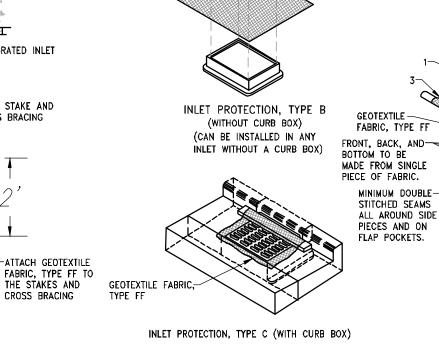

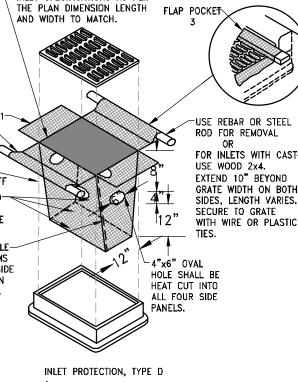

(CAN BE INSTALLED IN ANY INLET TYPE WITH OR WITHOUT A CURB BOX AS PER NOTE 2)

~2"x4" STAKE AND

MANUFACTURED ALTERNATIVES APPROVED AND LISTED ON THE DEPARTMENT'S EROSION CONTROL PRODUCT ACCEPTABILITY LIST MAY BE SUBSTITUTED.

CROSS BRACING

WHEN REMOVING OR MAINTAINING INLET PROTECTION, CARE SHALL BE TAKEN SO THAT THE SEDIMENT TRAPPED ON THE GEOTEXTILE FABRIC DOES NOT FALL INTO THE INLET. ANY MATERIAL FALLING INTO THE INLET SHALL BE REMOVED IMMEDIATELY.

1. FINISHED SIZE, INCLUDING FLAP POCKETS WHERE REQUIRED, SHALL EXTEND A MINIMUM OF 10" AROUND THE PERIMETER TO FACILITATE MAINTENANCE OR

2. FOR INLET PROTECTION, TYPE C (WITH CURB BOX). AN ADDITIONAL 18" OF FABRIC IS WRAPPED AROUND THE WOOD AND SECURED WITH STAPLES. THE WOOD SHALL NOT BLOCK THE ENTIRE HEIGHT OF THE CURB BOX OPENING.

3. FLAP POCKETS SHALL BE LARGE ENOUGH TO ACCEPT WOOD 2X4.

<u> INSTALLATION NOTES:</u>

-GEOTEXTILE

FABRIC, TYPE FF


TYPE B & C

TRIM EXCESS FABRIC IN THE FLOW LINE TO WITHIN 3" OF THE GRATE, THE CONTRACTOR SHALL DEMONSTRATE A METHOD OF MAINTENANCE, USING A SEWN FLAP, HAND HOLDS OT OTHER METHOD TO PREVENT ACCUMULATED SEDIMENT FROM ENTERING THE INLET.

DO NOT INSTALL INLET PROTECTION TYPE D IN INLETS SHALLOWER THAN 30", MEASURED FROM THE BOTTOM OF THE INLET TO THE TOP OF THE GRATE.

TRIM EXCESS FABRIC IN THE FLOW LINE TO WITHIN 3" OF THE GRATE.

THE INSTALLED BAG SHALL HAVE A MINIMUM SIDE CLEARANCE, BETWEEN THE INLET WALLS AND THE BAG, MEASURED AT THE BOTTOM OF THE OVERFLOW HOLES, OF 3". WHERE NECESSARY THE CONTRACTOR SHALL CINCH THE BAG, USING PLASTIC ZIP TIES, TO ACHIEVE THE 3" CLEARANCE. THE TIES SHALL BE PLACED AT A MAXIMUM OF 4" FROM THE BOTTOM OF THE BAG.

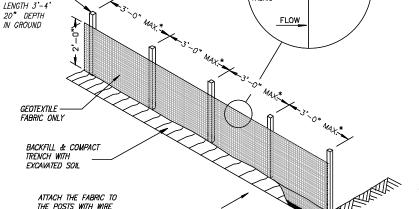

SILT FENCE

NOTE: ADDITIONAL POST DEPTH OR TIE BACKS

STAPLES OR WOODEN LATH AND NAILS

FLOW DIRECTION -

ANCHOR STAKE


SILT FENCE TIE BACK

(WHEN ADDITIONAL SUPPORT REQUIRED)

TIEBACK BETWEEN FENCE

WOOD POSTS-

MAY BE REQUIRED IN UNSTABLE SOILS

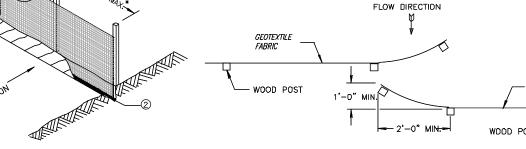

* NOTE: 8'-0" POST SPACING ALLOWED IF A WOVEN GEOTEXTILE FABRIC IS USED

FLOW DIRECTION (2)

JOINING TWO LENGTHS OF SILT FENCE

HOOK METHOD

FLOW DIRECTION

TWIST METHOD

GENERAL NOTES

1 HORIZONTAL BRACE REQUIRED WITH 2" X 4" WOODEN FRAME OR EQUIVALENT AT TOP OF POSTS.


TRENCH SHALL BE A MINIMUM OF 4" WIDE & 6" DEEP TO BURY AND ANCHOR THE GEOTEXTILE FABRIC. FOLD MATERIAL TO FIT TRENCH AND BACKFILL & COMPACT TRENCH WITH EXCAVATED SOIL.

(3) CONSTRUCT SILT FENCE FROM A CONTINUOUS ROLL IF POSSIBLE BY CUTTING LENGTHS TO AVOID JOINTS. IF A JOINT IS NECESSARY USE ONE OF THE

FOLLOWING TWO METHODS; A) OVERLAP THE END POSTS AND TWIST, OR

 $\ensuremath{\mathfrak{J}}$ wood posts shall be a minimum size of 1?" x 1?" of dak or hickory. 4 SILT FENCE TO EXTEND ACROSS THE TOP OF THE PIPE.

ROTATE, AT LEAST 180 DECREES, B) HOOK THE END OF EACH SILT FENCE This drawing based on Wisconsin Department of Transportation Standard Detail Drawing 8 E 9-6.

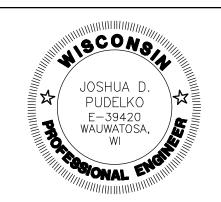



4100 N. CALHOUN ROAD, SUITE 300 **BROOKFIELD, WI 53005** PHONE: (262) 790-1480 FAX: (262) 790-1481 EMAIL: jpudelko@trioeng.com

PARAGON PLACE

knothe • bruce ARCHITECTS

608.836.3690 Middleton, WI 53562

PARAGON OT 9 Ō

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	. <u> </u>					
REVI	REVISION HISTORY					
DATE	DESCRIPTION					
10/26/2022	INITIAL SUBMITTAL					

DATE: OCTOBER 26, 2022

JOB NUMBER: 12041

DESCRIPTION:

EROSION CONTROL PLAN


SHEET


CONTRACTOR IS REQUIRED TO CONTACT DIGGERS HOTLINE TOLL FREE TO OBTAIN LOCATION OF UNDERGROUND UTILITIES PRIOR TO COMMENCING THE WORK. WISCONSIN STATUTE 182.0715 REQUIRES MIN. OF 3 WORK DAYS NOTICE BEFORE YOU EXCAVATE.

CALL DIGGERS HOTLINE 1-800-242-8511

NOTE:
EXISTING UNDERGROUND UTILITY INFORMATION WAS OBTAINED FROM AVAILABLE RECORDS. THE ENGINEER MAKES NO GUARANTEE AS TO THE ACCURACY OF THIS INFORMATION. VERIFICATION TO THE SATISFACTION OF THE CONTRACTOR OF ALL UNDERGROUND UTILITIES, WHETHER OR NOT SHOWN ON THE PLANS, SHALL BE ASSUMED AS A CONDITION OF THE CONTRACT. THE CONTRACTOR SHALL NOTIFY THE ENGINEER OF ANY DISCREPANCIES BETWEEN LOCATION OF UTILITIES IN THE FIELD AND LOCATIONS SHOWN ON THE PLANS.

	- EXISTING SANTIARY MANHULE
	W—————————————————————————————————————
	- EXISTING HYDRANT
	ST ————————————————————————————————————
	○ − EXISTING STORM MANHOLE
	☐ — EXISTING STORM INLET
	PROPOSED SANITARY SEWER
	O - PROPOSED SANITARY MANHOLE
	PROPOSED WATER MAIN
	- PROPOSED HYDRANT
	⊗ − PROPOSED WATER VALVE
PUBLIC IMPROVEMENTS NOTE:	
THE RIGHT OF WAY IS THE SOLE JURISDICTION OF	○ − PROPOSED STORM MANHOLE
THE CITY OF MADISON AND IS SUBJECT TO CHANGE	□ − PROPOSED STORM INLET
AT ANY TIME PER THE RECOMMENDATION/PLAN OF	- PROPOSED STORM END SECTION
TRAFFIC ENGINEERING AND CITY ENGINEERING	
DIVISIONS.	

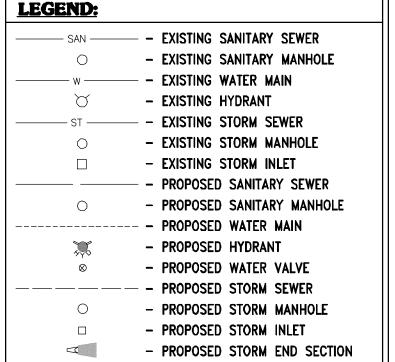

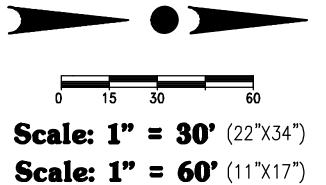

JOSHUA D.
PUDELKO
E-39420
WAUWATOSA,



FAX: (262) 790-1481 EMAIL: jpudelko@trioeng.com

PARAGON PLACE

Phone: 760| University Ave, Ste 20| 608.836.3690 Middleton, WI 53562

PROJEC PARAGON OT 9

<u> </u>					
REVISION HISTORY					
DESCRIPTION					
INITIAL SUBMITTAL					

DATE: OCTOBER 26, 2022

JOB NUMBER: 12041


DESCRIPTION:

UTILITY **PLAN**


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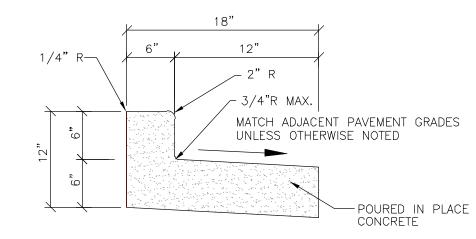





INTEGRAL SIDEWALK & BARRIER CURB (WHERE SIDEWALK ADJOINS DRIVEWAYS/PARKING AREAS) NO SCALE

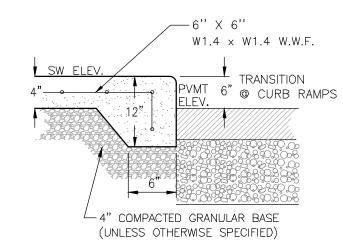



18" CONCRETE CURB & GUTTER NO SCALE

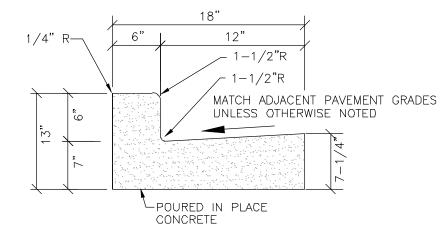


18" REJECT CURB & GUTTER DETAIL

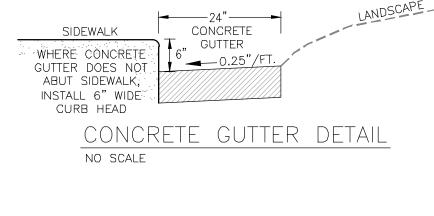

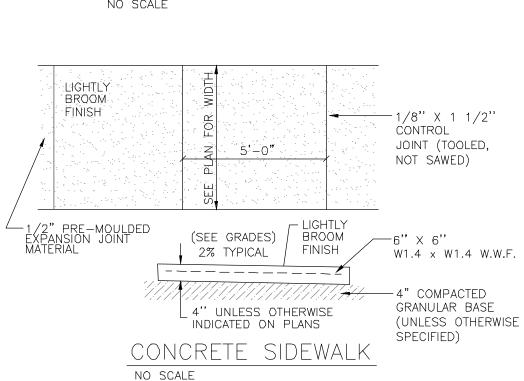


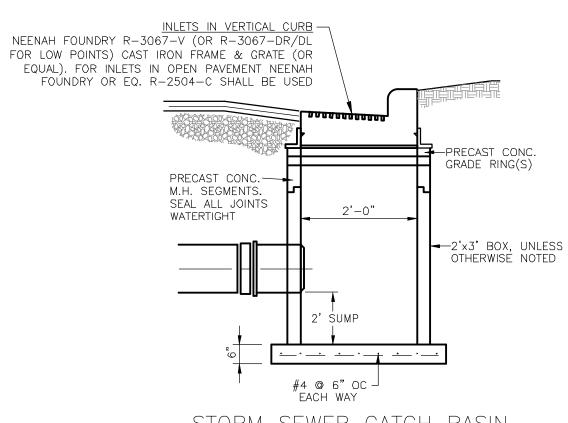

STORM SEWER CATCH BASIN NO SCALE

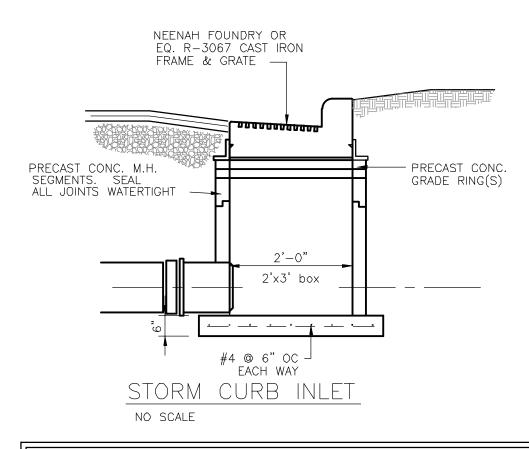

PARKING LOT STORM INLET NOTE: PROPOSED STORM SEWER INLETS WITHIN THE PARKING LOT SHALL HAVE AN OIL AND GREASE FILTER INSTALLED PER MANUFACTURER'S SPECIFICATIONS. ACCEPTABLE PRODUCTS INCLUDE FleXstorm Inlet Filters BY INLET & PIPE PROTECTION, INC.; FloGard+Plus® CATCH BASIN INSERT FILTER BY KRISTAR ENTERPRISES, INC.; Catch—All HR—1 Inlet and Catch Basin Filtration Device BY MARATHON MATERIALS, INC.; OR APPROVED EQUAL.

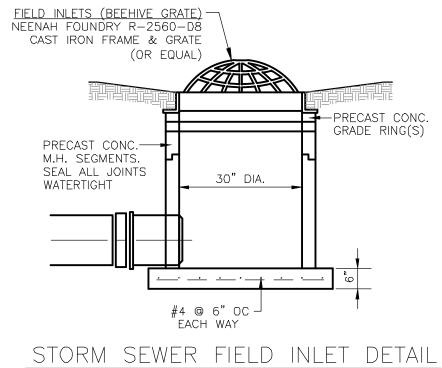

DESCRIPTION: CONSTRUCTION

DETAILS

OCTOBER 26, 2022

12041

JOB NUMBER:

WISCONS

JOSHUA D.

E-39420 WAUWATOSA,

4100 N. CALHOUN ROAD, SUITE 300

PARAGON PLACE

ARCHITECTS

Phone: 760| University Ave, Ste 20|

608.836.3690 Middleton, WI 53562

WAY

CLAW

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ACE

PROJEC

DATE:

PARAGON LOT 9 CITY OF N

REVISION HISTORY DATE DESCRIPTION 10/26/2022 INITIAL SUBMITTAL


BROOKFIELD, WI 53005 PHONE: (262) 790-1480 FAX: (262) 790-1481 EMAIL: jpudelko@trioeng.com

PUDELKO X

SHEET


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9-PARAGON PLACE, DWG
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STANDARD CURB RAMP DETAILS

NO SCALE

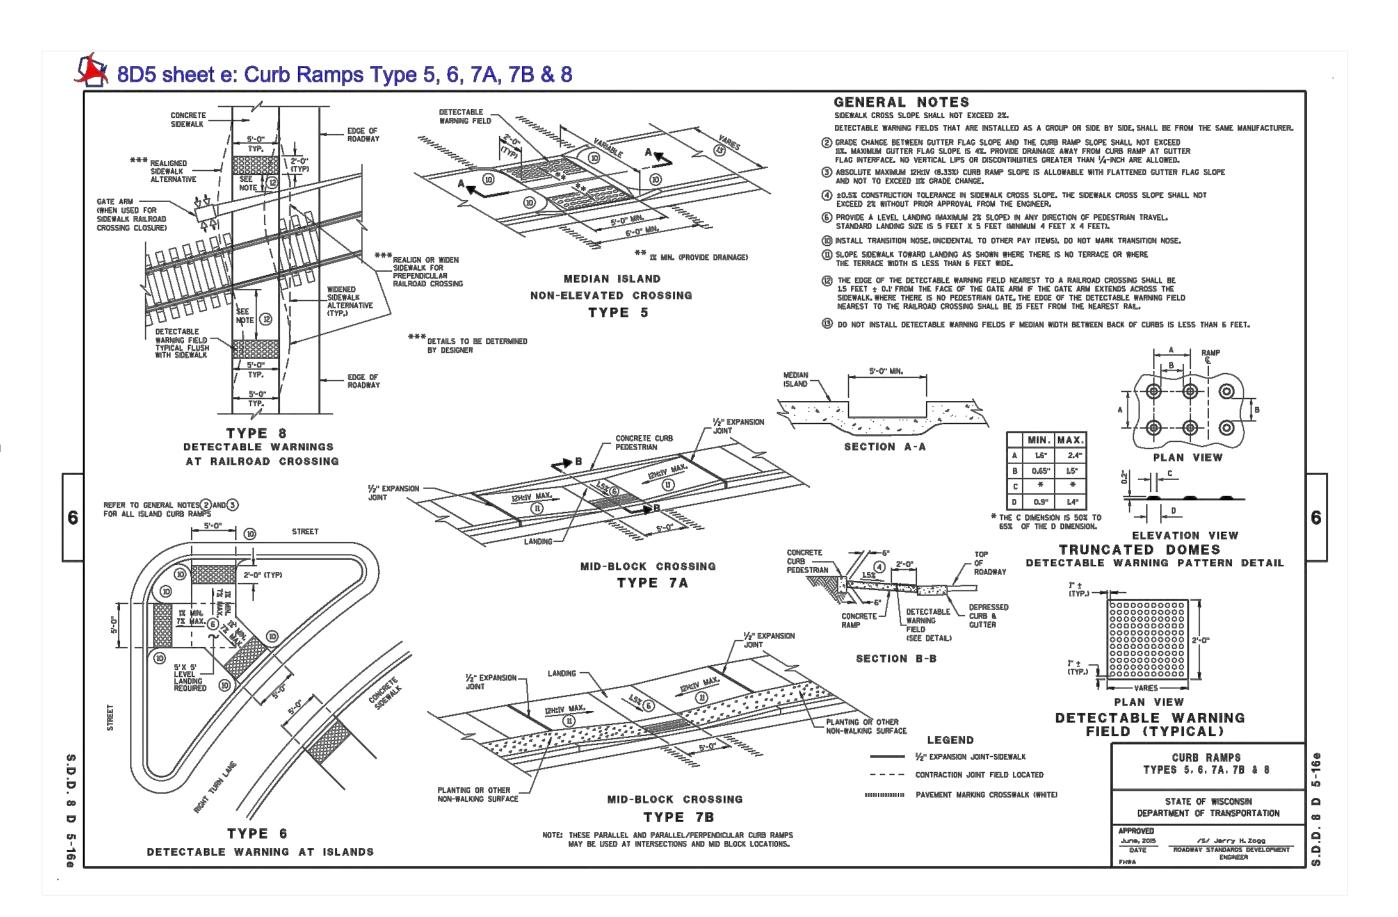

BIKE PARKING RACK DETAIL (EXTERIOR)

NO SCALE

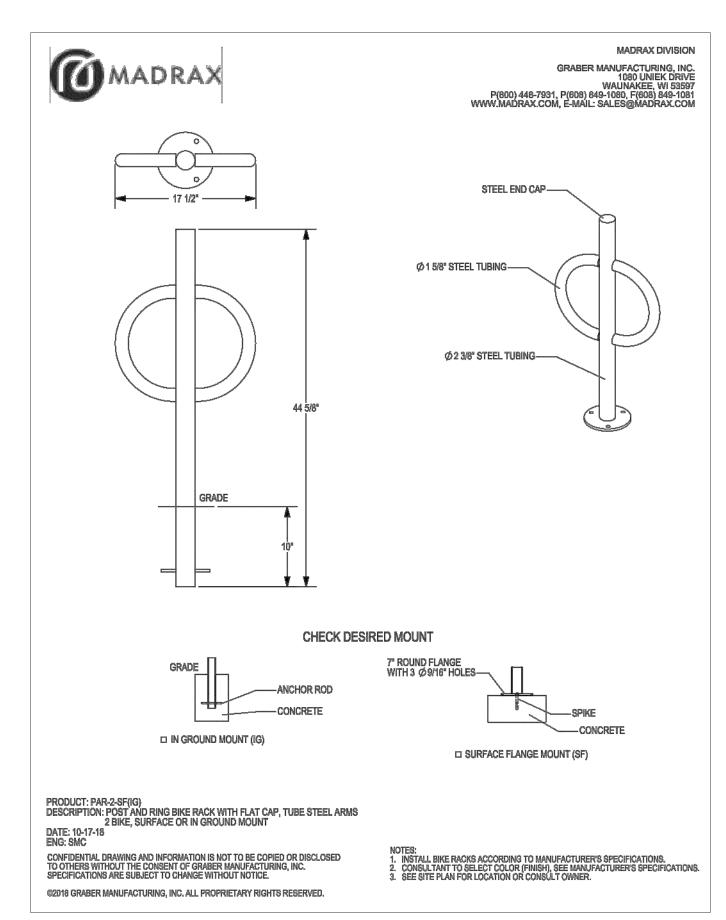



B
PARAGON PLACE
knothe • bruce

A R C H I T E C T S

Phone: 760| University Ave, Ste 20|
608.836.3690 Middleton, WI 53562

CLAW WAY

CITY OF MADISON, W
BY: United Financial Group
660 W. Ridgeview Dri

PROJE	LOT 9 CITY OF BY: Unite 660 Appl
REVI	SION HISTORY
DATE	DESCRIPTION
10/26/2022	INITIAL SUBMITTAL

DATE:OCTOBER 26, 2022

JOB NUMBER: 12041

DESCRIPTION:

CONSTRUCTION
DETAILS

SHEET

C4.1

PLANT LIST- TREES

SCALE: 1"=30'-0"

FLANT LIST-	11/	LO			
EVERGREEN TREES	CODE	BOTANICAL / COMMON NAME	CONT.	SIZE	<u>QTY</u>
	AC	Abies concolor / Concolor Fir	B&B	6` HT (MIN.)	2
80 + 80 A A A A A A A A A A A A A A A A A A	JV	Juniperus virginiana 'J.N. Select Green' / Emerald Feather™ Eastern Redcedar	B&B	6` HT (MIN.)	4
	PG	Picea glauca var. densata / Black Hills Spruce	B&B	6` HT (MIN.)	3
	PS	Pinus strobus / White Pine	B&B	6` HT (MIN.)	3
	TH	Thuja occidentalis 'Holmstrup' / Holmstrup Arborvitae	B&B	6` HT (MIN.)	18
	TG	Thuja x 'Green Giant' / Green Giant Arborvitae	B&B	6` HT (MIN.)	4
ORNAMENTAL TREES	CODE	BOTANICAL / COMMON NAME	CONT.	SIZE	QTY
+ &	AL	Amelanchier laevis `Spring Flurry` / Spring Flurry Serviceberry	B&B	2"Cal	3
	AR	Amelanchier x grandiflora `Robin Hill` / Robin Hill Serviceberry	B&B	6` HT. MULTI-STEM	4
	CJ	Carpinus caroliniana 'J.N. Select A' / Fire King™ American Hornbeam	B&B	2"Cal	3
	CC	Cercis canadensis / Eastern Redbud	B&B	2"Cal	2
+ }	MS	Magnolia stellata `Royal Star` / Royal Star Magnolia	B&B	2"Cal	2
	MR	Malus x 'Royal Raindrops' / Royal Raindrops Crabapple	B&B	2"Cal	4
SHADE TREES	CODE	BOTANICAL / COMMON NAME	CONT.	SIZE	QTY
	AF	Acer x freemanii `Sienna` / Sienna Glen Maple	B&B	3"Cal	4
	CO	Celtis occidentalis `Chicagoland` / Common Hackberry	B&B	3"Cal	3
	GD	Gymnocladus dioica `Espresso` / Espresso Coffeetree	B&B	3"Cal	4
	QC	Quercus muehlenbergii / Chinkapin Oak	B&B	3"Cal	3

NOTES

October 31, 2022

Developed Lots

Lakota Way

Total Developed Area

Development Frontage -

Total LF of Street Frontage

Between Bldg./Parking &

Overstory Deciduous Tree

Ornamental/Decorative Fence

Development Frontage -

Total LF of Street Frontage

Overstory Deciduous Tree

Omamental/Decorative Fence

Omamental Tree

Shrub, deciduous

Between Bldg./Parking &

Omamental Tree

Evergreen Tree

Shrub, deciduous

Shrub, evergreen

Ornamental Grass

or Wall (4 pts/10 LF)

Paragon Street

- 1. IT IS THE CONTRACTOR'S RESPONSIBILITY TO FIELD VERIFY SURVEY INFORMATION AND SITE CONDITIONS PRIOR TO START OF CONSTRUCTION AND REPORT ANY DISCREPANCIES. CONTRACTOR SHALL CONTACT DIGGER'S HOTLINE TO LOCATE ALL PUBLIC AND PRIVATE UTILITIES PRIOR TO THE START OF CONSTRUCTION. ANY DAMAGE CAUSED TO EXISTING UTILITIES, EITHER SHOWN OR NOT SHALL BE REPAIRED AND PAID FOR AT THE CONTRACTOR'S EXPENSE.
- 2. CONTRACTOR SHALL PROTECT BENCHMARKS. 3. ALL EXISTING PLANT MATERIAL IS SHOWN AT EXISTING, APPROXIMATED SIZE PER CITY OF MADISON STANDARDS

LANDSCAPE POINTS

City of Madison Landscape Worksheet

Suburban Residential - Varied District 2 (SR-V2)

Paragon Place at Bear Claw Way (Ziegler Site - Lot 9)

4. ALL WRAPPINGS, WIRE BASKETS, BURLAP, AND OTHER

LF

Point Value

15

Point Value

672

Minimum Open

Space Required

(SF)

119

Proposed

63,970 320/2+ bedrooms

Landscape Units

Required

213

Existing

Existing

Landscape Points Required

Landscape Points Provided

Overstory Tree Req. (or x2 for

Orn./Evrgrn. Tree Sub.)

Development Frontage Points Total

Overstory Tree Req. (or x2 for

Orn./Evrgrn. Tree Sub.)

Landscape Points

Subtotal

Shrubs Required

Points Achieved

180

238

Shrubs Required

Points Achieved

- MISCELLANEOUS MATERIAL SHALL BE COMPLETELY REMOVED FROM

Point Value

N/A

Overstory Tree Req. (or x2 for

Orn./Evrgrn. Tree Sub.)

Development Frontage Points Total

Proposed

Existing

Existing

General Site Plantings Total

TOTAL LANDSCAPE POINTS

Shrubs Required

Points Achieved

230

290

1163

- ALL SHRUB AND TREE ROOT BALLS PRIOR TO INSTALLATION. ANY LAWN OR LANDSCAPED AREAS OUTSIDE OF THE CONSTRUCTION BOUNDARY THAT ARE DISTURBED SHALL BE RE-SEEDED AND/OR REPAIRED WITH ORIGINAL MATERIALS AND TO PRE-DISTURBANCE STANDARDS AT NO COST TO THE OWNER OR CITY.
- CONTRACTOR IS RESPONSIBLE FOR WATERING AND MAINTENANCE OF PLANT MATERIAL - SEE SPECIFICATIONS FOR MORE INFORMATION.
- 7. CONTRACTOR SHALL CONTACT CITY FORESTRY AT (608) 266-4816 TO SCHEDULE INSPECTION AND APPROVAL OF NURSERY TREE STOCK AND REVIEW PLANTING SPECIFICATIONS WITH THE LANDSCAPER AT

Development Frontage -

Total LF of Street Frontage

Overstory Deciduous Tree

Omamental/Decorative Fence

Between Bldg./Parking &

Elderberry Road

Element

Omamental Tree

Omamental Grass

or Wall (4 pts/10 LF)

Interior Parking Lots

Overstory Deciduous Tree

Ornamental/Decorative Fence

Omamental Tree

Shrub, deciduous Shrub, evergreen

Omamental Grass

or Wall (4 pts/10 LF)

General Site, Foundation, Screening

Total Parking Lot Area

Element

Evergreen Tree hrub, deciduous Shrub, evergreen

- LEAST ON WEEK PRIOR TO STREET TREE PLANTING. 8. TREES SHOWN IN THE CITY TERRACE ARE FOR INFORMATION ONLY. FINAL QUANTITY, LOCATION, AND SPECIES TO BE DETERMINED BY
- **CITY FORESTRY** CONTRACTOR WILL BE REQUIRED TO SUBMIT TOPSOIL TEST RESULTS PER SECTION 32 91 13 PRIOR TO PLACEMENT OF SOIL MATERIALS ON THIS PROJECT.

LEGEND

		SHOVEL-CUT EDGING
Shrubs Required		BLUEGRASS SOD
16		DECORATIVE COBBLES
112		SHREDDED BARK MULCH
Points Achieved		ACCENT BOULDERS
70	- 0	
15		PROPERTY LINE
45		
56		PROPERTY SETBACK
18		
58		POTENTIAL STREET TREE,
0		SEE NOTE 8.
262		
, m x m		




knothe • bruce

ARCHITECTS

608.836.3690 Middleton, WI 53562

760 University Ave, Ste 201

ISSUED Issued for Land Use - October 31, 2022

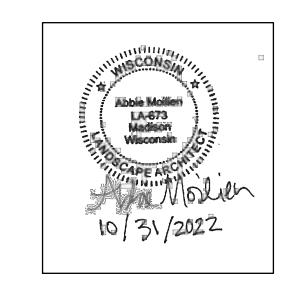


PROJECT TITLE Paragon Place at Bear Claw Way Ziegler Site - Lot 9

304 Lakota Way Madison, Wisconsin

SHEET TITLE Planting and Landscape Restoration Plan

SHEET NUMBER

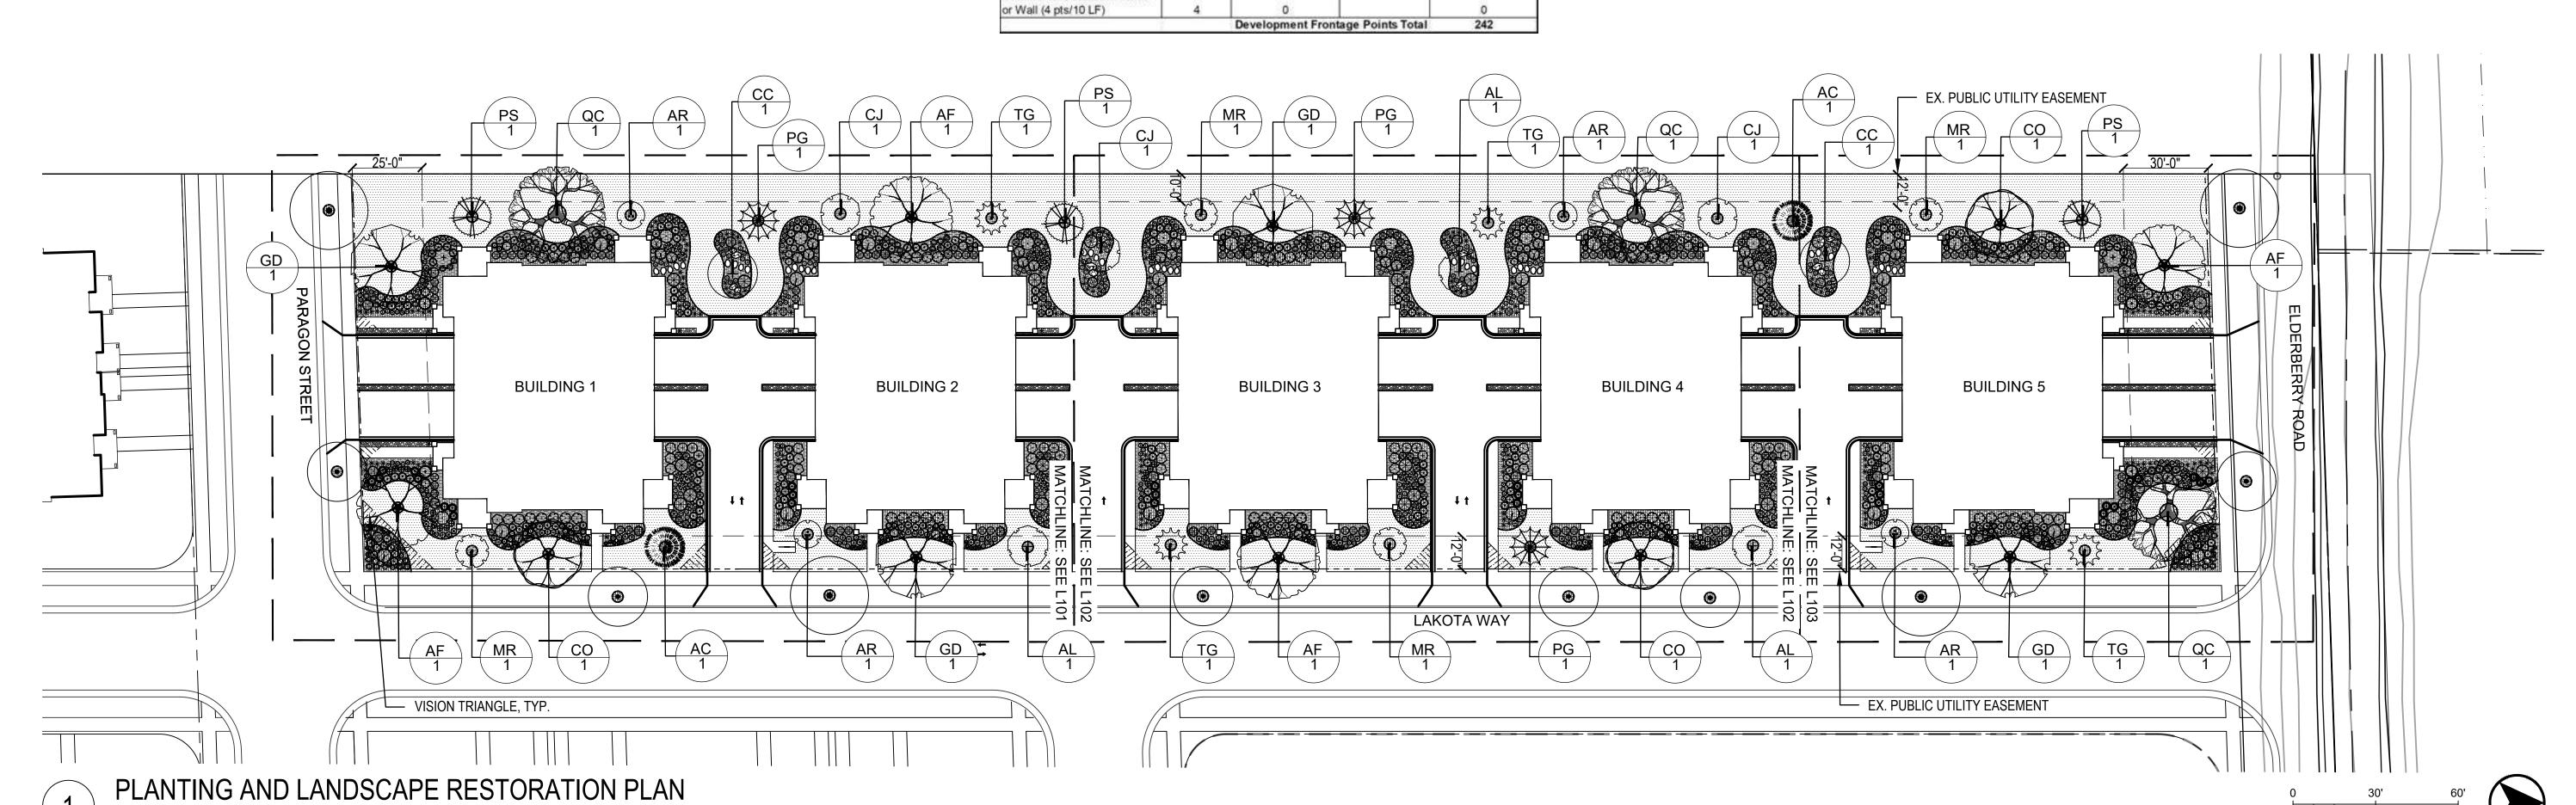

NOTES

- 1. IT IS THE CONTRACTOR'S RESPONSIBILITY TO FIELD VERIFY SURVEY 4. ALL WRAPPINGS, WIRE BASKETS, BURLAP, AND OTHER INFORMATION AND SITE CONDITIONS PRIOR TO START OF CONSTRUCTION AND REPORT ANY DISCREPANCIES. CONTRACTOR SHALL CONTACT DIGGER'S HOTLINE TO LOCATE ALL PUBLIC AND PRIVATE UTILITIES PRIOR TO THE START OF CONSTRUCTION. ANY DAMAGE CAUSED TO EXISTING UTILITIES, EITHER SHOWN OR NOT, SHALL BE REPAIRED AND PAID FOR AT THE CONTRACTOR'S EXPENSE.
- 2. CONTRACTOR SHALL PROTECT BENCHMARKS.
- 3. ALL EXISTING PLANT MATERIAL IS SHOWN AT EXISTING, APPROXIMATED SIZE PER CITY OF MADISON STANDARDS
- MISCELLANEOUS MATERIAL SHALL BE COMPLETELY REMOVED FROM ALL SHRUB AND TREE ROOT BALLS PRIOR TO INSTALLATION.
- ANY LAWN OR LANDSCAPED AREAS OUTSIDE OF THE CONSTRUCTION 8. BOUNDARY THAT ARE DISTURBED SHALL BE RE-SEEDED AND/OR REPAIRED WITH ORIGINAL MATERIALS AND TO PRE-DISTURBANCE STANDARDS AT NO COST TO THE OWNER OR CITY
- 6. CONTRACTOR IS RESPONSIBLE FOR WATERING AND MAINTENANCE OF PLANT MATERIAL - SEE SPECIFICATIONS FOR MORE INFORMATION.
- 7. CONTRACTOR SHALL CONTACT CITY FORESTRY AT (608) 266-4816 TO
- SCHEDULE INSPECTION AND APPROVAL OF NURSERY TREE STOCK AND REVIEW PLANTING SPECIFICATIONS WITH THE LANDSCAPER AT LEAST ON WEEK PRIOR TO STREET TREE PLANTING.
- TREES SHOWN IN THE CITY TERRACE ARE FOR INFORMATION ONLY. FINAL QUANTITY, LOCATION, AND SPECIES TO BE DETERMINED BY CITY FORESTRY.
- 9. CONTRACTOR WILL BE REQUIRED TO SUBMIT TOPSOIL TEST RESULTS PER SECTION 32 91 13 PRIOR TO PLACEMENT OF SOIL MATERIALS ON THIS PROJECT.

LEGEND

---- SHOVEL-CUT EDGING **BLUEGRASS SOD**

DECORATIVE COBBLES

SHREDDED BARK MULCH

ACCENT BOULDERS

—--- PROPERTY LINE

--- PROPERTY SETBACK


SEE NOTE 8.

POTENTIAL STREET TREE,





ISSUED Issued for Land Use - October 31, 2022

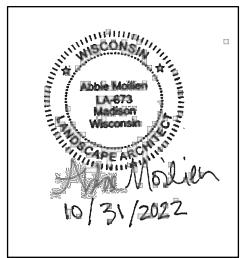


PROJECT TITLE Paragon Place at Bear Claw Way Ziegler Site - Lot 9

304 Lakota Way Madison, Wisconsin

SHEET TITLE Planting Enlargements

SHEET NUMBER

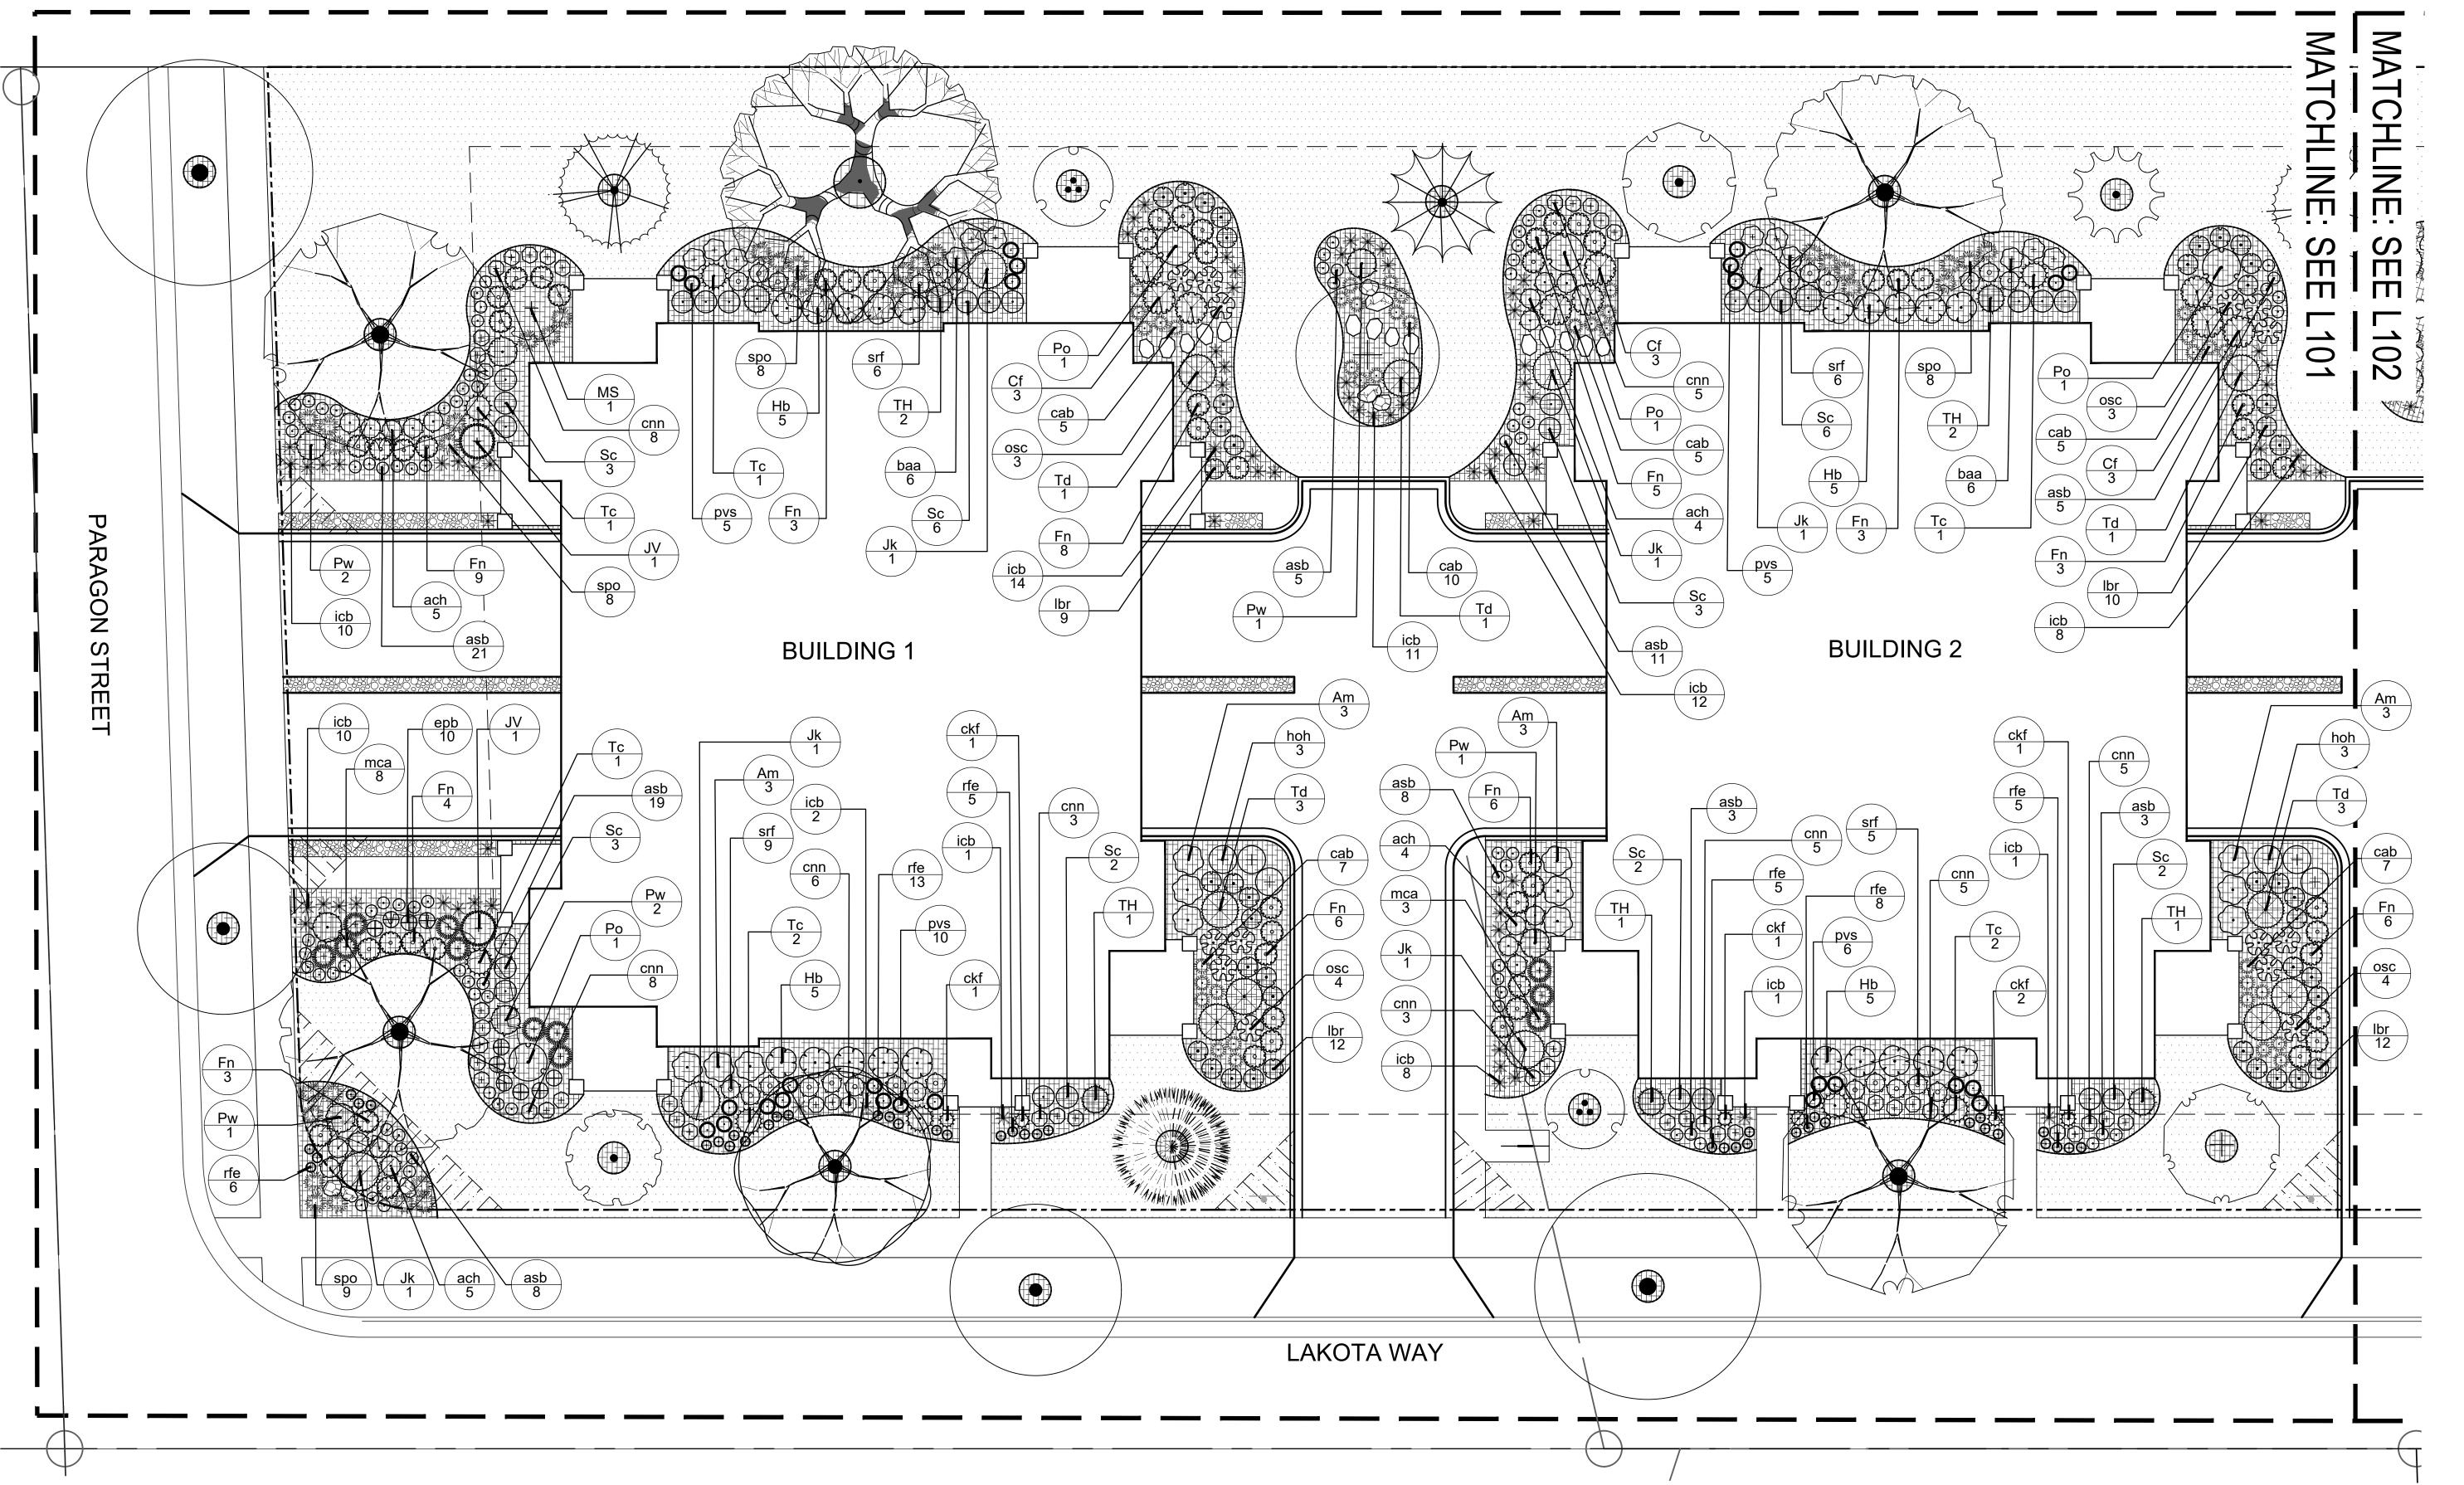

NOTES

- 1. IT IS THE CONTRACTOR'S RESPONSIBILITY TO FIELD VERIFY SURVEY INFORMATION AND SITE CONDITIONS PRIOR TO START OF CONSTRUCTION AND REPORT ANY DISCREPANCIES. CONTRACTOR SHALL CONTACT DIGGER'S HOTLINE TO LOCATE ALL PUBLIC AND PRIVATE UTILITIES PRIOR TO THE START OF CONSTRUCTION. ANY DAMAGE CAUSED TO EXISTING UTILITIES, EITHER SHOWN OR NOT, SHALL BE REPAIRED AND PAID FOR AT THE CONTRACTOR'S EXPENSE.
- 2. CONTRACTOR SHALL PROTECT BENCHMARKS.
- 3. ALL EXISTING PLANT MATERIAL IS SHOWN AT EXISTING, APPROXIMATED SIZE PER CITY OF MADISON STANDARDS
- ALL WRAPPINGS, WIRE BASKETS, BURLAP, AND OTHER MISCELLANEOUS MATERIAL SHALL BE COMPLETELY REMOVED FROM ALL SHRUB AND TREE ROOT BALLS PRIOR TO INSTALLATION.
- ANY LAWN OR LANDSCAPED AREAS OUTSIDE OF THE CONSTRUCTION 8. BOUNDARY THAT ARE DISTURBED SHALL BE RE-SEEDED AND/OR STANDARDS AT NO COST TO THE OWNER OR CITY
- 6. CONTRACTOR IS RESPONSIBLE FOR WATERING AND MAINTENANCE OF PLANT MATERIAL - SEE SPECIFICATIONS FOR MORE INFORMATION.
- 7. CONTRACTOR SHALL CONTACT CITY FORESTRY AT (608) 266-4816 TO
- SCHEDULE INSPECTION AND APPROVAL OF NURSERY TREE STOCK AND REVIEW PLANTING SPECIFICATIONS WITH THE LANDSCAPER AT LEAST ON WEEK PRIOR TO STREET TREE PLANTING.
- TREES SHOWN IN THE CITY TERRACE ARE FOR INFORMATION ONLY. FINAL QUANTITY, LOCATION, AND SPECIES TO BE DETERMINED BY CITY FORESTRY
- 9. CONTRACTOR WILL BE REQUIRED TO SUBMIT TOPSOIL TEST RESULTS PER SECTION 32 91 13 PRIOR TO PLACEMENT OF SOIL MATERIALS ON THIS PROJECT.

LEGEND

---- SHOVEL-CUT EDGING **BLUEGRASS SOD**

DECORATIVE COBBLES

SHREDDED BARK MULCH


ACCENT BOULDERS —--- PROPERTY LINE

--- PROPERTY SETBACK POTENTIAL STREET TREE, SEE NOTE 8.





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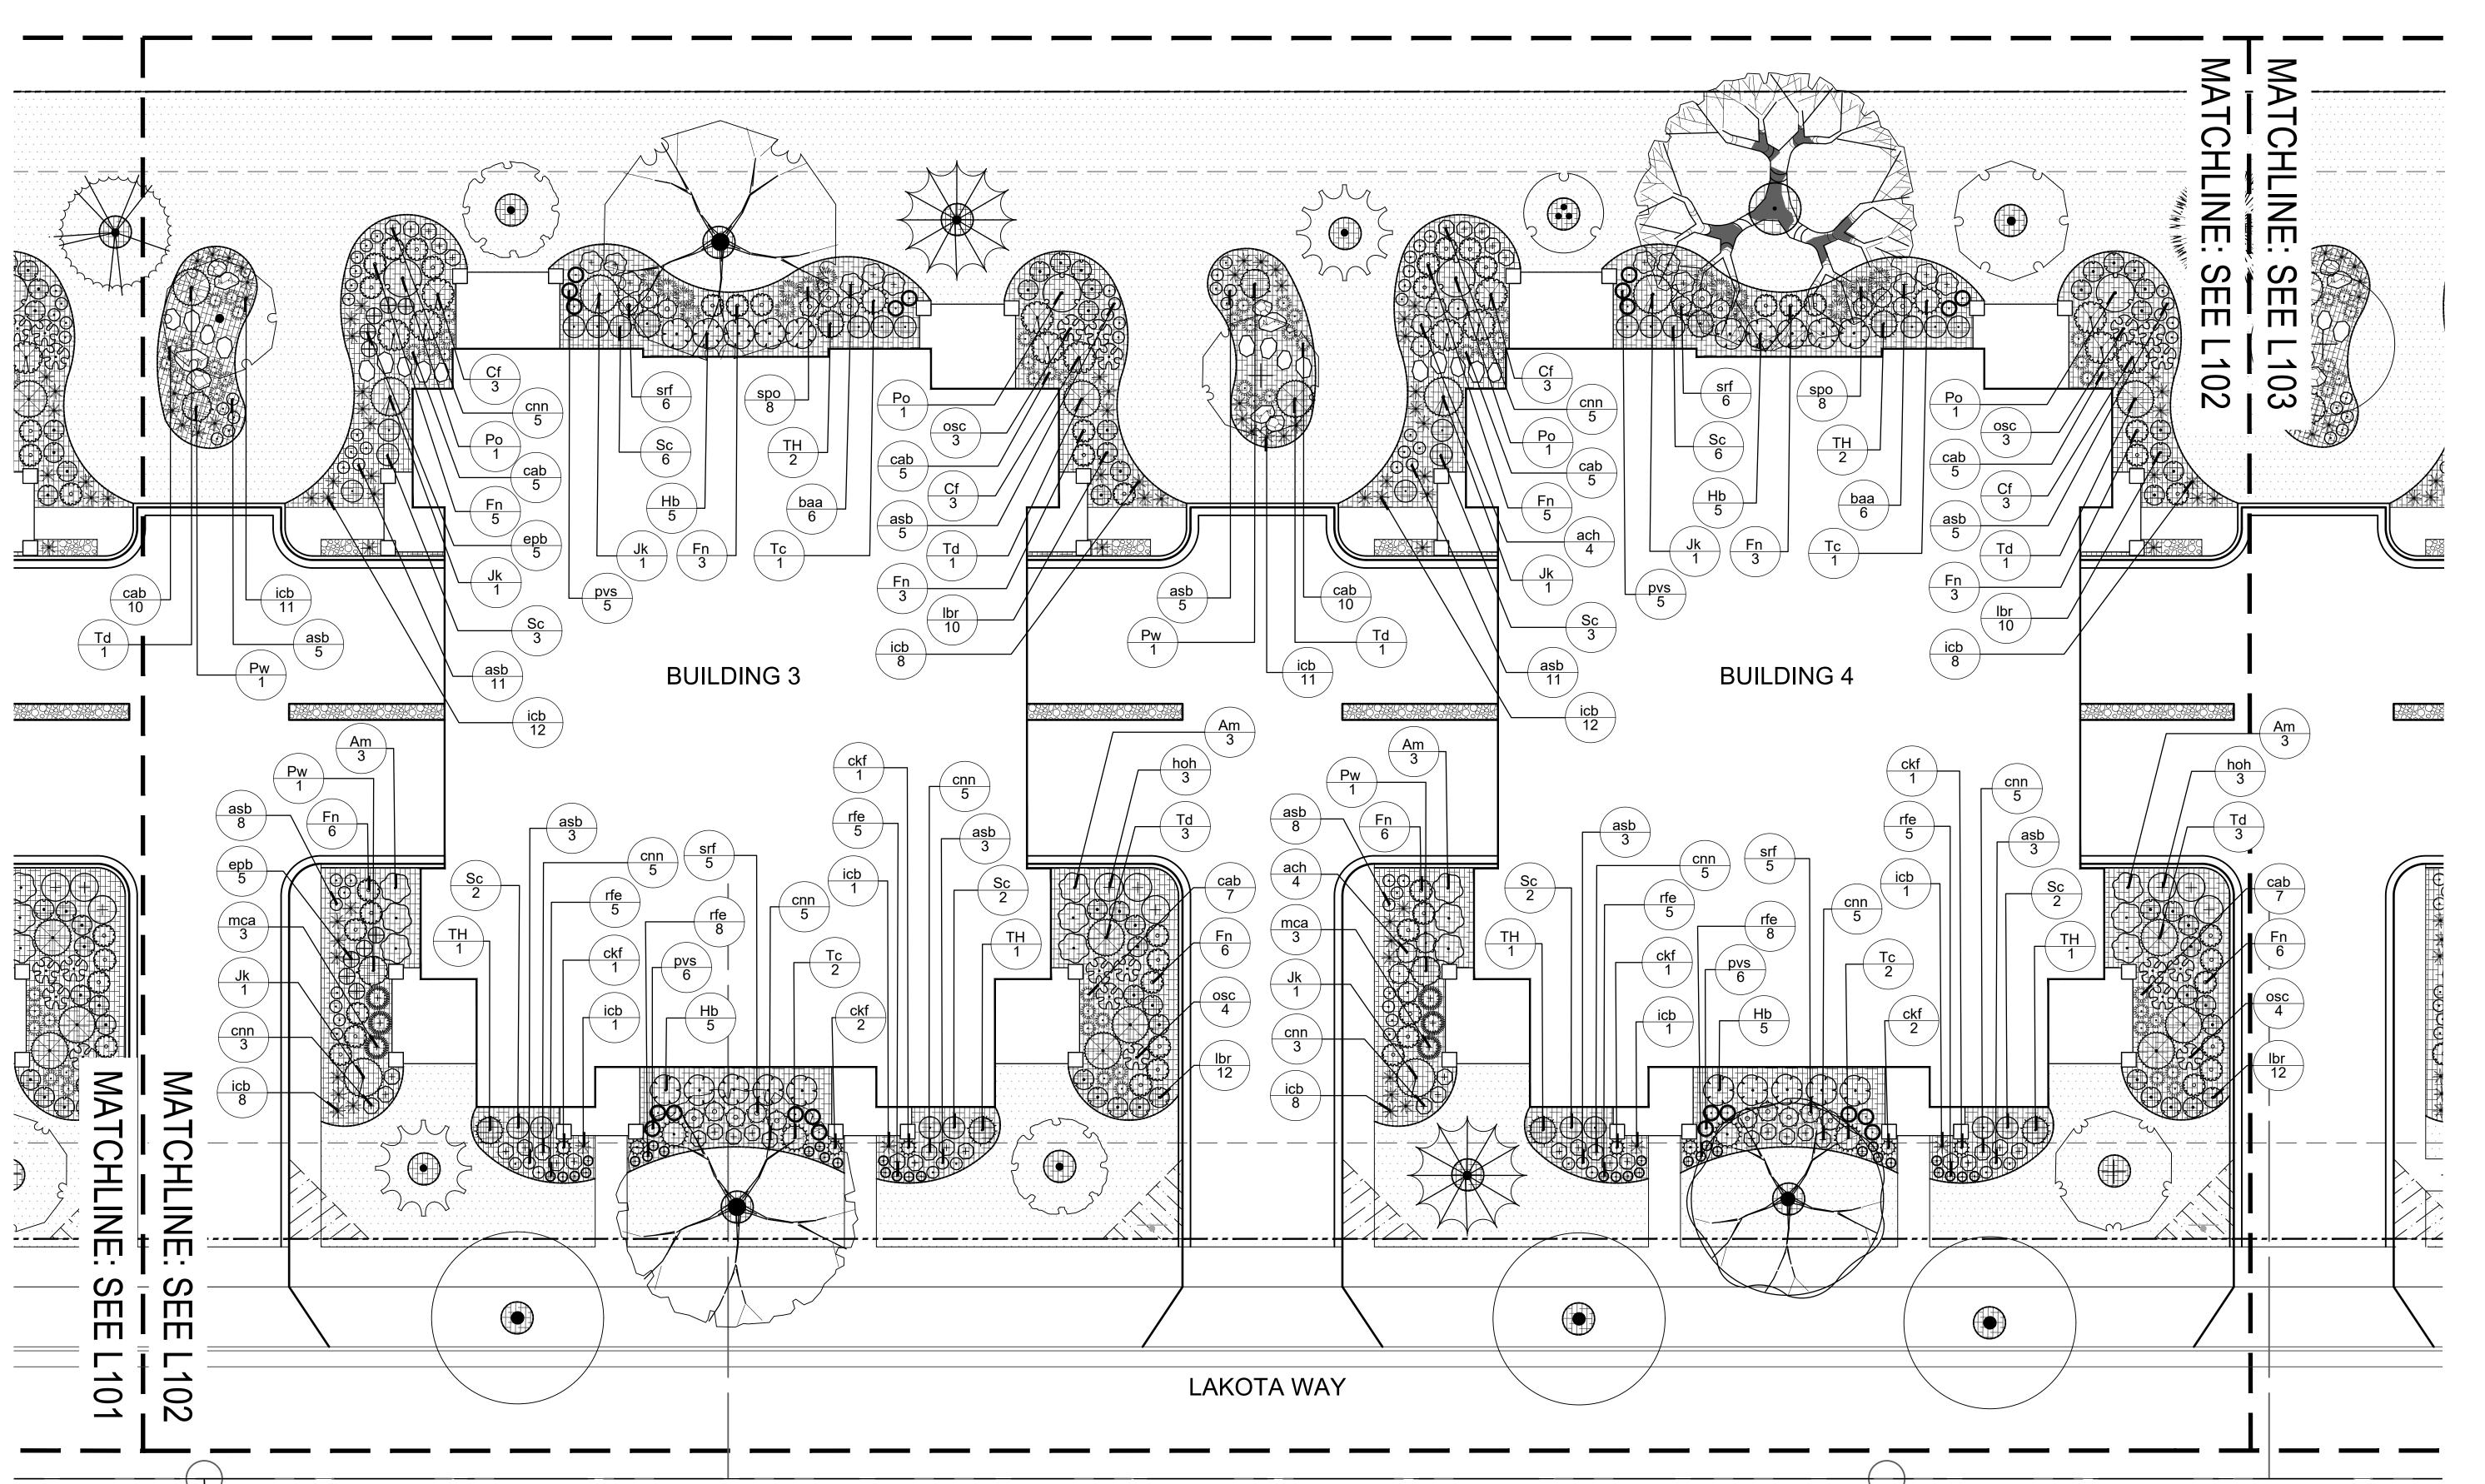


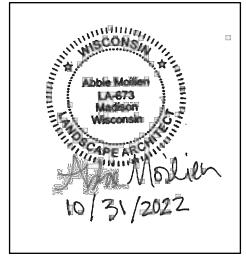PROJECT TITLE Paragon Place at Bear Claw Way Ziegler Site - Lot 9

304 Lakota Way Madison, Wisconsin

SHEET TITLE Planting Enlargements

SHEET NUMBER



NOTES

- 1. IT IS THE CONTRACTOR'S RESPONSIBILITY TO FIELD VERIFY SURVEY INFORMATION AND SITE CONDITIONS PRIOR TO START OF CONSTRUCTION AND REPORT ANY DISCREPANCIES. CONTRACTOR SHALL CONTACT DIGGER'S HOTLINE TO LOCATE ALL PUBLIC AND PRIVATE UTILITIES PRIOR TO THE START OF CONSTRUCTION. ANY DAMAGE CAUSED TO EXISTING UTILITIES, EITHER SHOWN OR NOT, SHALL BE REPAIRED AND PAID FOR AT THE CONTRACTOR'S EXPENSE.
- 2. CONTRACTOR SHALL PROTECT BENCHMARKS
- 3. ALL EXISTING PLANT MATERIAL IS SHOWN AT EXISTING,
- ALL WRAPPINGS, WIRE BASKETS, BURLAP, AND OTHER MISCELLANEOUS MATERIAL SHALL BE COMPLETELY REMOVED FROM ALL SHRUB AND TREE ROOT BALLS PRIOR TO INSTALLATION.
- ANY LAWN OR LANDSCAPED AREAS OUTSIDE OF THE CONSTRUCTION 8. BOUNDARY THAT ARE DISTURBED SHALL BE RE-SEEDED AND/OR REPAIRED WITH ORIGINAL MATERIALS AND TO PRE-DISTURBANCE STANDARDS AT NO COST TO THE OWNER OR CITY
- 6. CONTRACTOR IS RESPONSIBLE FOR WATERING AND MAINTENANCE OF PLANT MATERIAL - SEE SPECIFICATIONS FOR MORE INFORMATION.
- SCHEDULE INSPECTION AND APPROVAL OF NURSERY TREE STOCK AND REVIEW PLANTING SPECIFICATIONS WITH THE LANDSCAPER AT LEAST ON WEEK PRIOR TO STREET TREE PLANTING. TREES SHOWN IN THE CITY TERRACE ARE FOR INFORMATION ONLY.
- FINAL QUANTITY, LOCATION, AND SPECIES TO BE DETERMINED BY CITY FORESTRY.
- 9. CONTRACTOR WILL BE REQUIRED TO SUBMIT TOPSOIL TEST RESULTS PER SECTION 32 91 13 PRIOR TO PLACEMENT OF SOIL MATERIALS ON THIS PROJECT.

LEGEND

---- SHOVEL-CUT EDGING

BLUEGRASS SOD

DECORATIVE COBBLES SHREDDED BARK MULCH ACCENT BOULDERS

—--- PROPERTY LINE


--- PROPERTY SETBACK POTENTIAL STREET TREE,

SEE NOTE 8.





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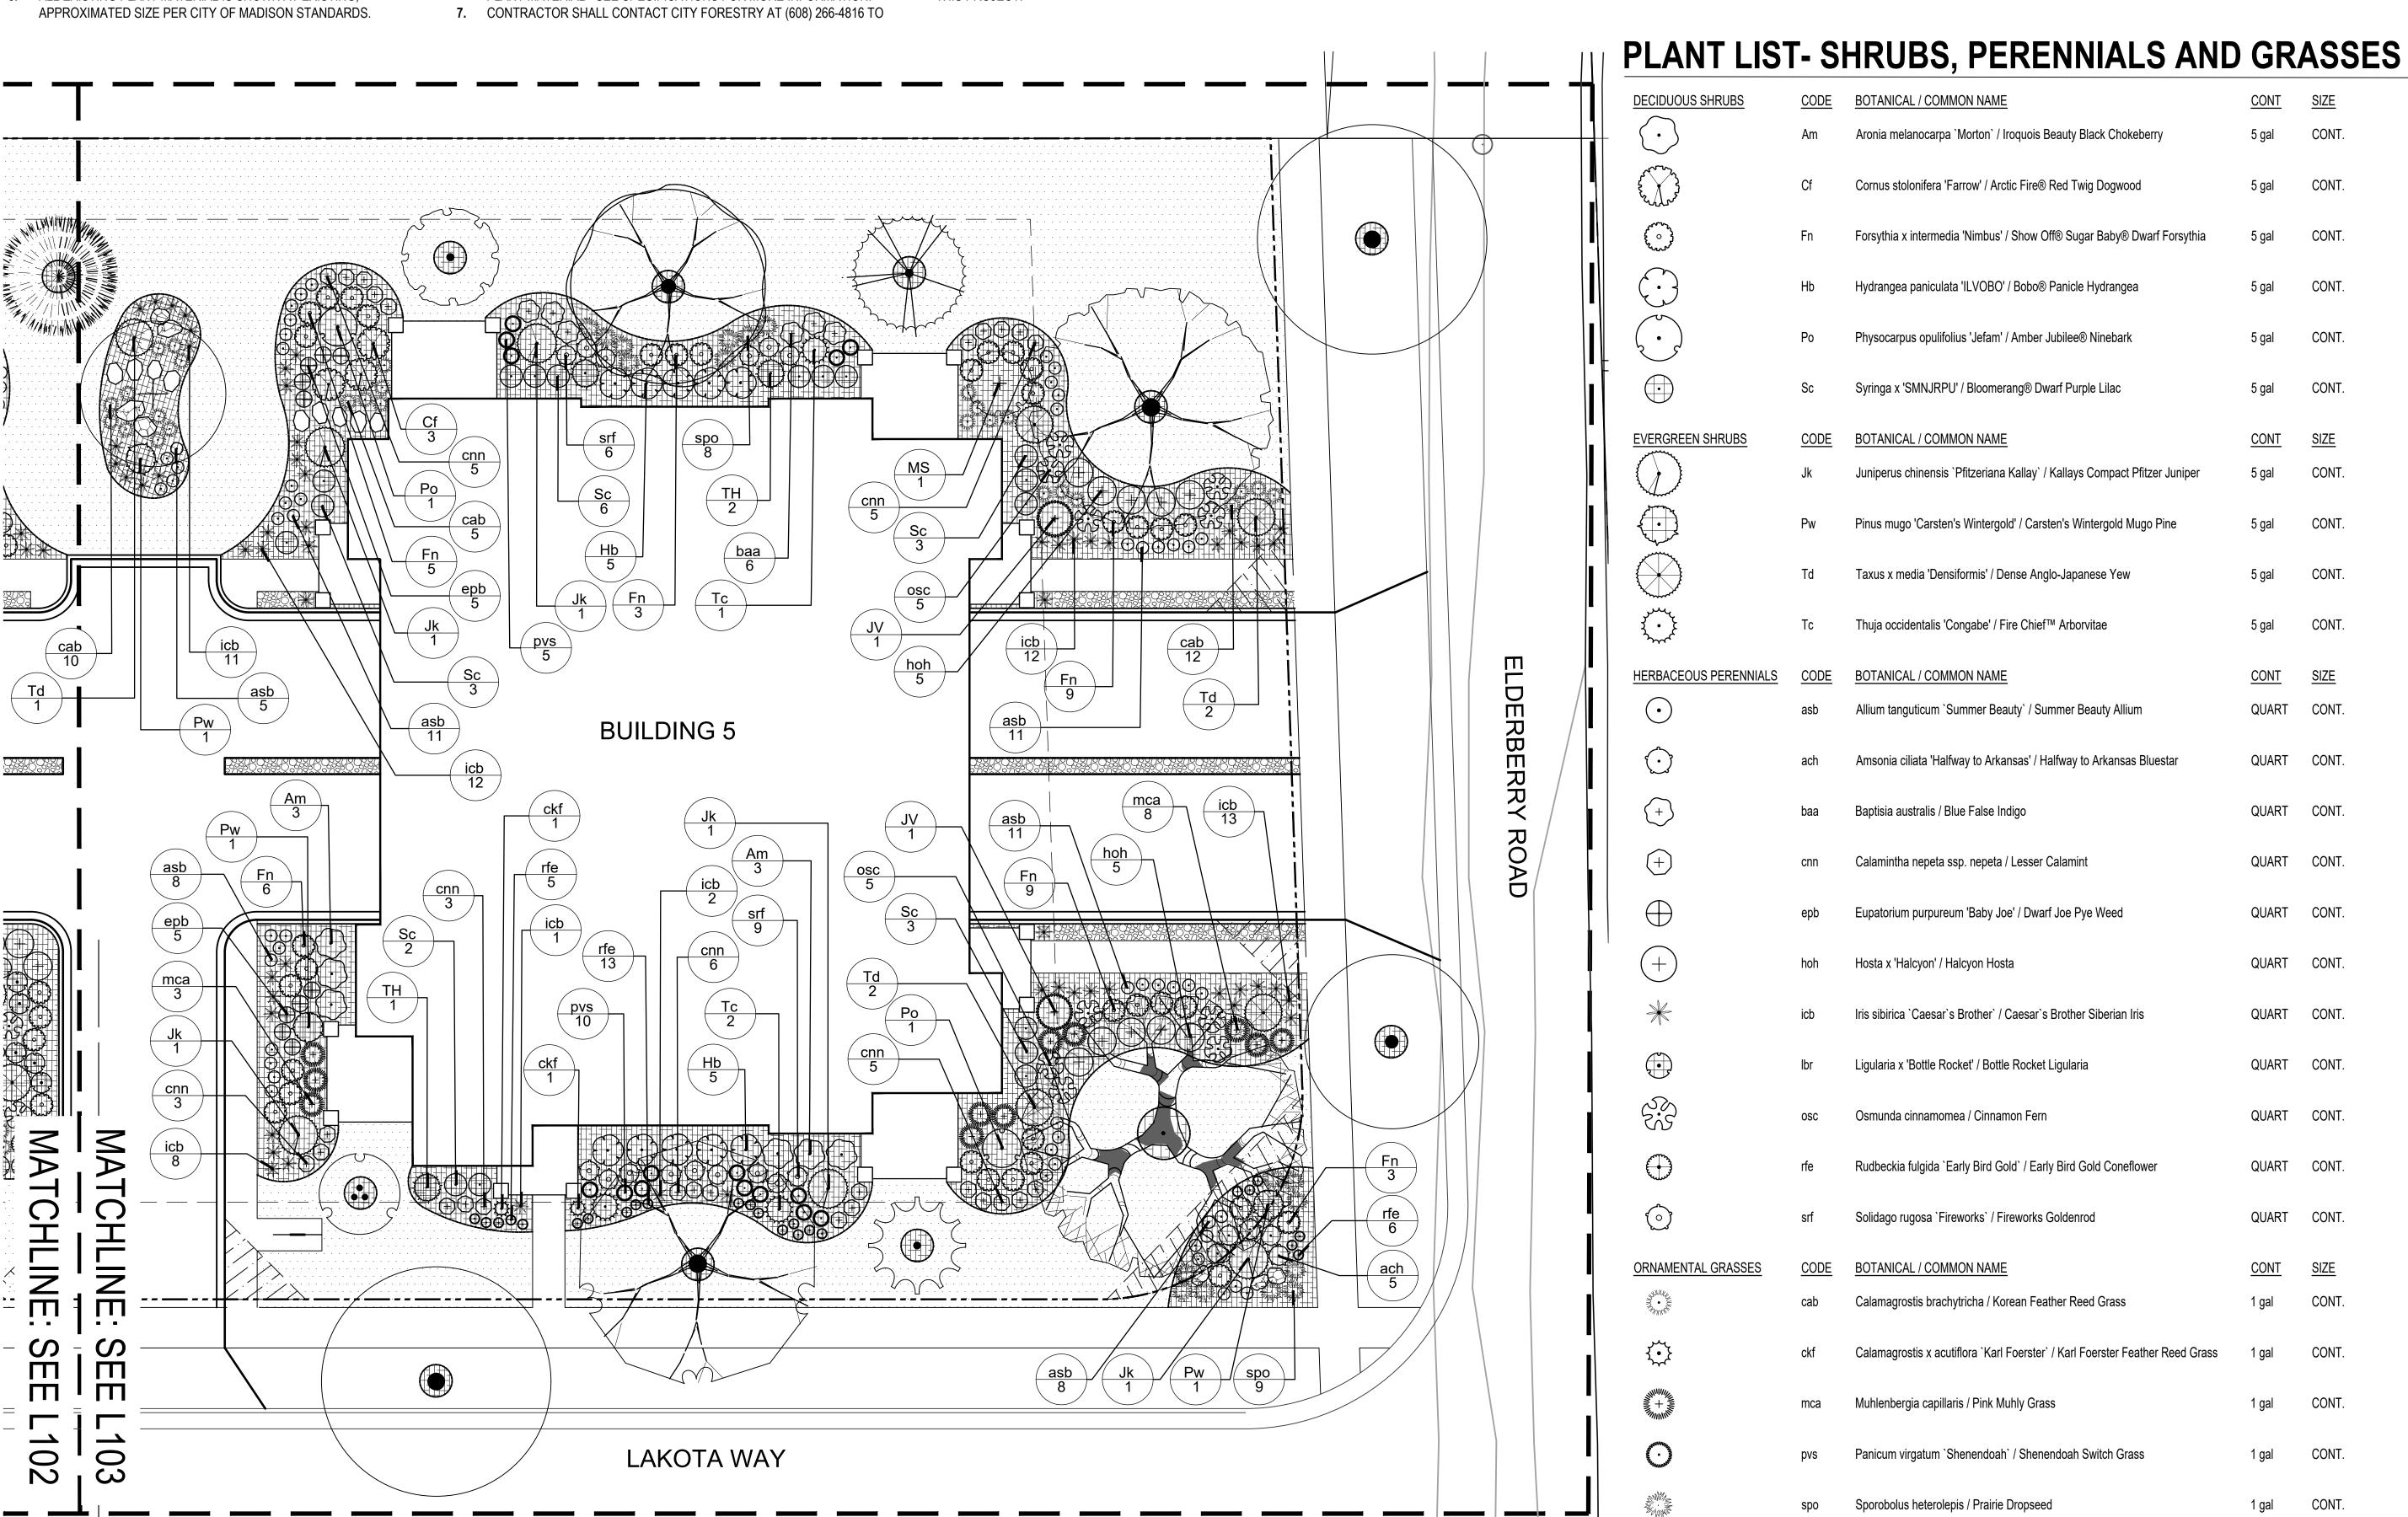
Paragon Place at Bear Claw Way Ziegler Site - Lot 9

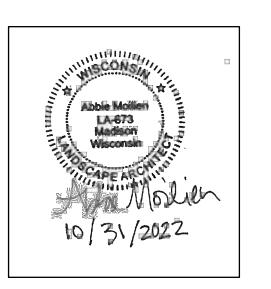219

304 Lakota Way Madison, Wisconsin

SHEET TITLE Planting Enlargements

SHEET NUMBER



ORNAMENTAL TREES



Amelanchier laevis 'Spring Flurry' / Spring Flurry Serviceberry



Amelanchier x grandiflora 'Robin Hill' / Robin Hill Serviceberry



Carpinus caroliniana 'J.N. Select A' / Fire King Musclewood



Cercis canadensis / Eastern Royal Star Magnolia Redbud



Magnolia stellata 'Royal Star' / Malus 'JFS-KW5' / Royal Raindrops Crabapple



Acer x freemanii 'Sienna' / Sienna Glenn Maple

SHADE TREES



Celtis occidentalis 'Chicagoland' / Chicagoland Hackberry



Gymnocladus dioica 'Espresso-JFS' / Espresso Kentucky Coffeetree



Quercus muehlenbergii Chinkapin Oak

EVERGREEN TREES



Abies concolor / Concolor Fir



Juniperus virginiana 'J.N. Select Green TM / Emerald Feather Juniper



Picea glauca 'Densata' / Black Hills Spruce



Pinus strobus / Eastern White



Thuja occidentalis 'Holmstrup' / Holmstrup Arborvitae



Thuja x 'Green Giant' / Green Giant Arborvitae

EVERGREEN SHRUBS



DECIDUOUS SHRUBS

Aronia melanocarpa 'Morton' / Iroquois Beauty Black Chokeberry



Cornus stolonifera 'Farrow' / Arctic Fire Red Twig Dogwood



Forsythia x intermedia 'NIMBUS' / Show Off Sugar Baby Forsythia



Hydrangea paniculata 'ILVOBO' TM / Bobo Panicle Hydrangea



Physocarpus opulifolius 'Jefam' TM / Amber Jubilee Ninebark



Syringa x 'SMSJBP7' / Bloomerang Purple Lilac



Juniperus chinensis 'Pfitzeriana Pinus mugo 'Carsten's Kallay' / Kallays Compact Pfitzer Juniper



Wintergold' / Wintergold Mugo



Taxus × media 'Densiformis' / Anglo-Japanese Yew



Thuja occidentalis 'Congabe' / Fire Chief Arborvitae

HERBACEOUS PERENNIALS



Allium 'Summer Beauty' / Summer Beauty Ornamental Onion



Iris sibirica 'Caesar's Brother' / Caesar's Brother Siberian Iris



Amsonia ciliata 'Halfway to Arkansas' / Halfway to Arkansas Bluestar

Ligularia x 'Bottle Rocket' /

Bottle Rocket Leopard Plant



Osmundastrum cinnamomeum / Cinnamon Fern



Calamintha nepeta subsp. nepeta / Lesser Calamint

Rudbeckia fulgida 'Early Bird

Gold' / Early Bird Gold Black-

Eyed-Susan



Eupatorium purpureum 'Baby Joe' / Dwarf Joe-Pye-Weed

Solidago rugosa 'Fireworks' /

Fireworks Goldenrod



Hosta x 'Halcyon' / Halcyon Hosta



Korean Feather Reed Grass



Calamagrostis x acutifolia 'Karl Foerster' / Karl Foerster Feather Reed Grass




Muhlenbergia capillaris / Pink Muhly Grass



Panicum virgatum 'Shenandoah' / Shenandoah Switch Grass



Sporobolus heterolepis / Prairie Dropseed

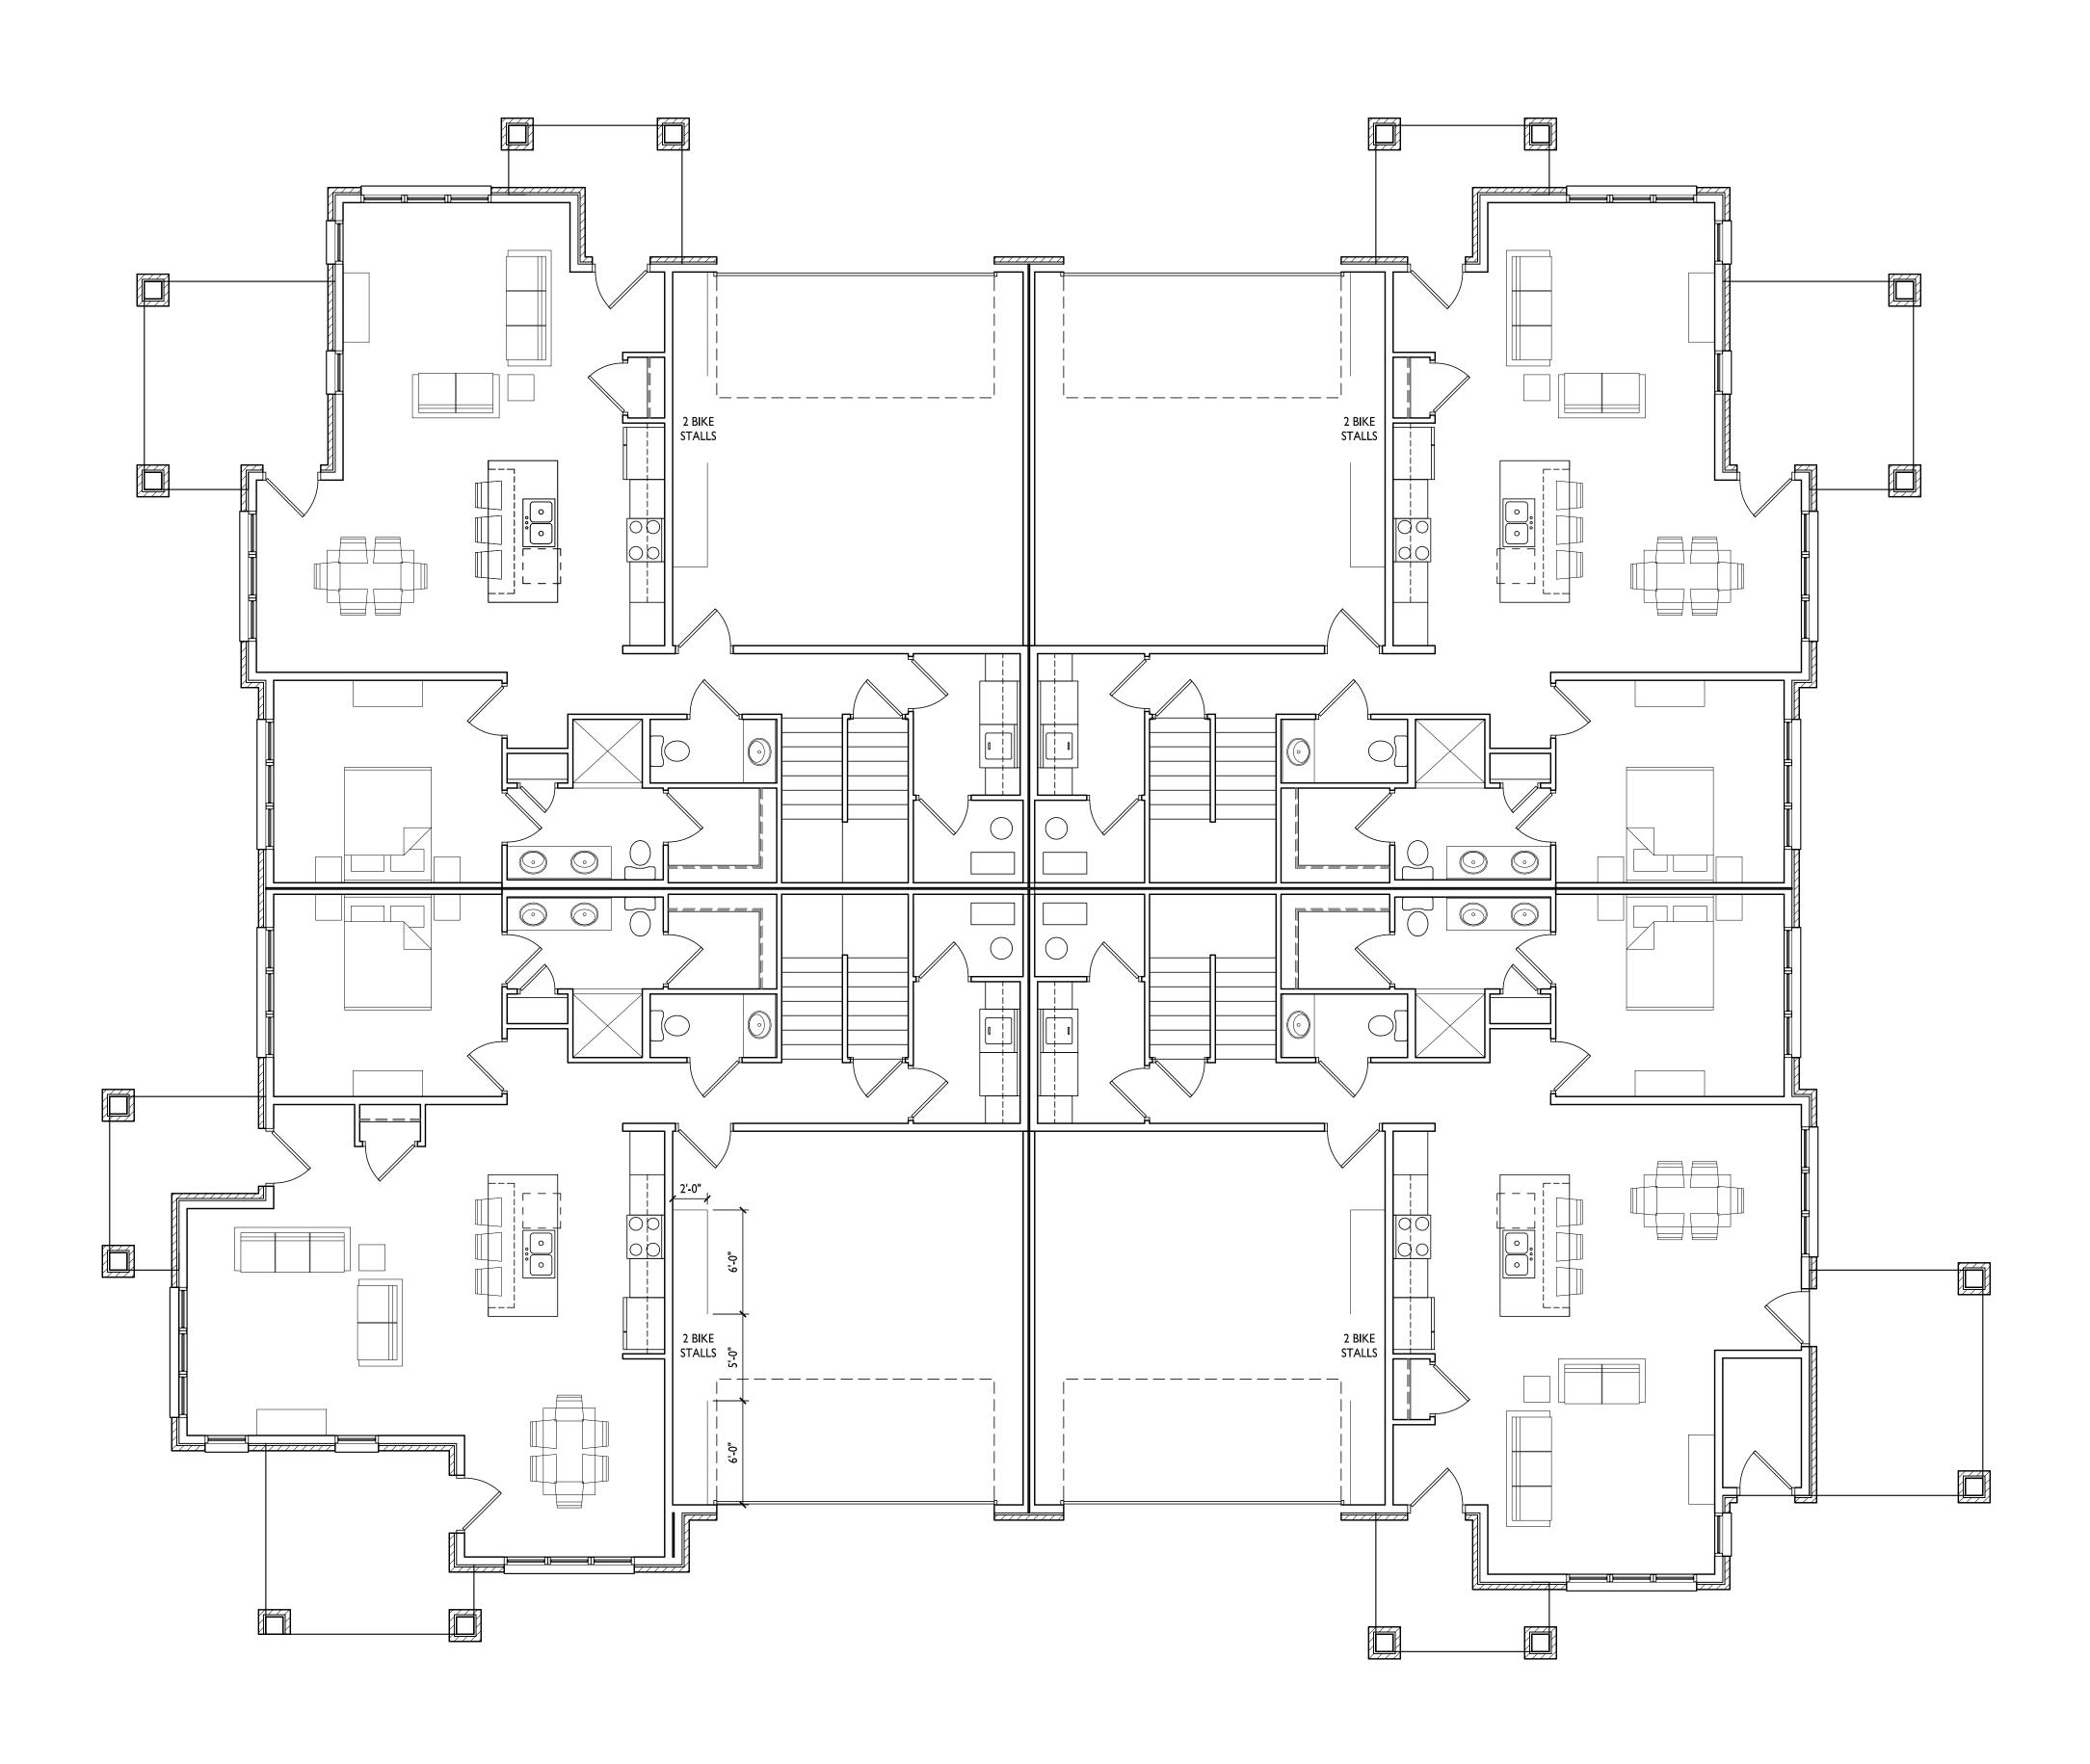





Land Use & UDC Submittal - October 31, 2022

PROJECT TITLE


Paragon Place at Bear Claw Way Ziegler Site - Lot 9

304 Lakota Way Madison, Wisconsin Building #1
First Floor Plan

SHEET NUMBER

A-1.1-1

PROJECT NO.

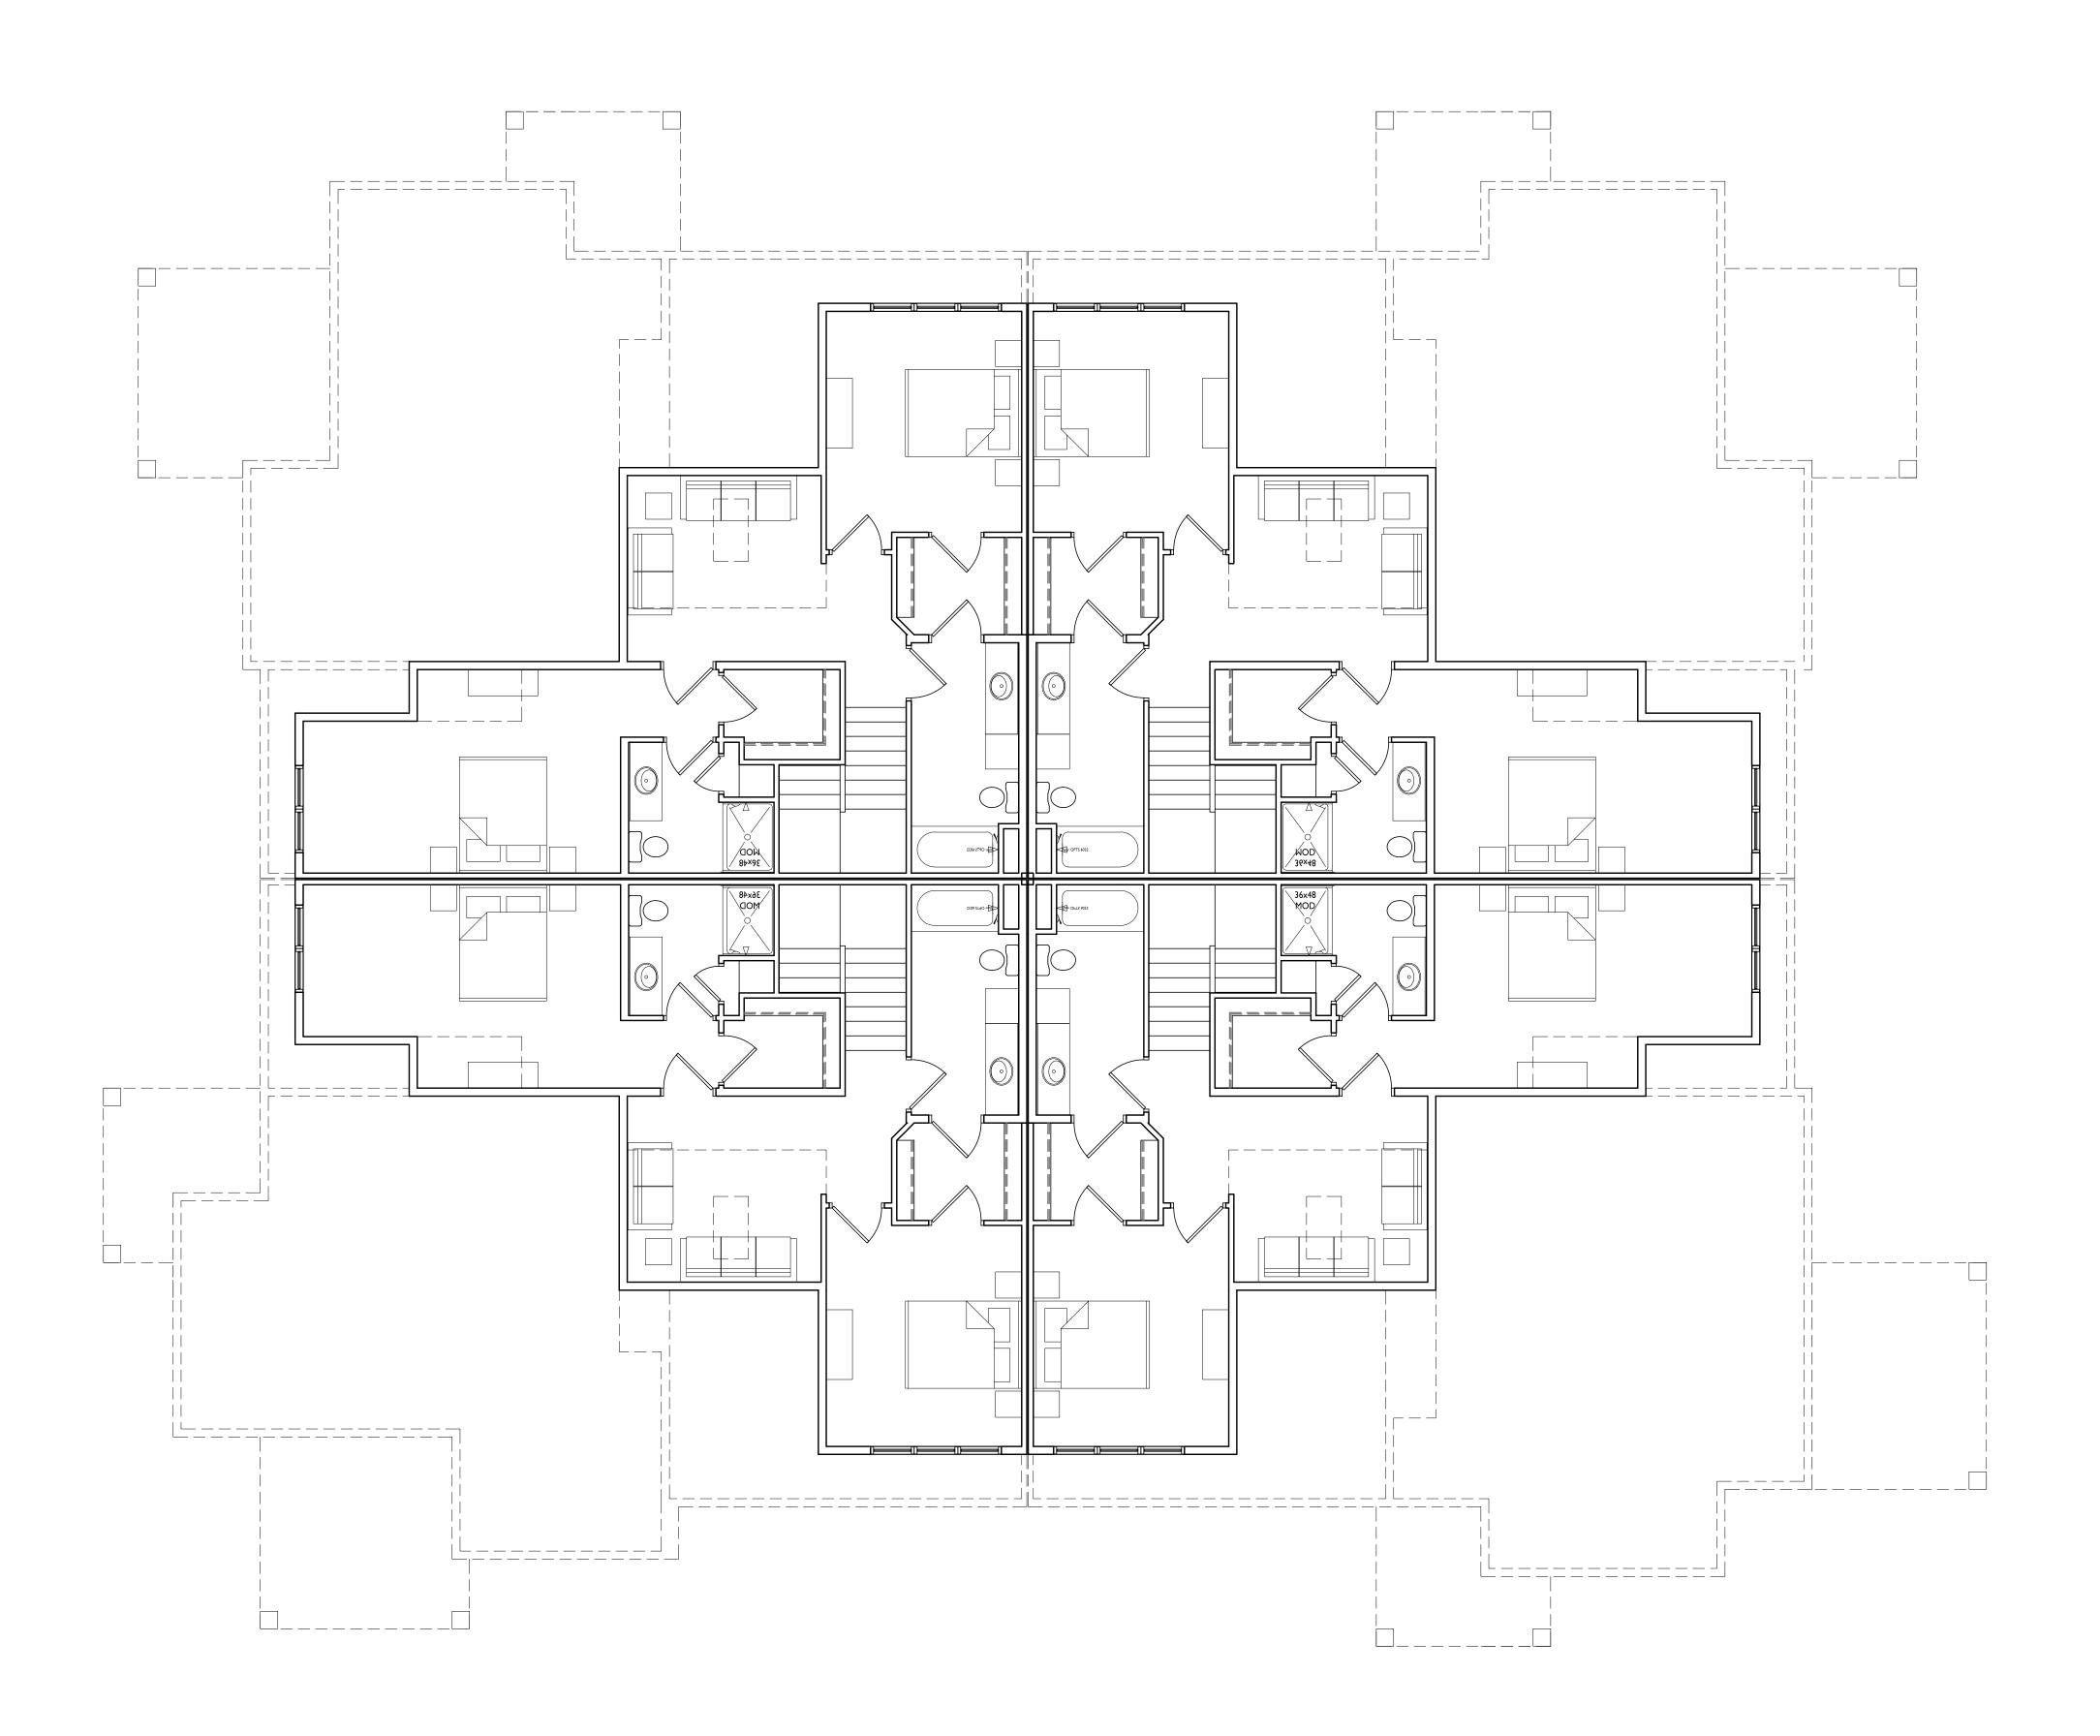





Land Use & UDC Submittal - October 31, 2022

PROJECT TITLE Paragon Place at Bear Claw Way Ziegler Site - Lot 9

304 Lakota Way Madison, Wisconsin SHEET TITLE Building #1 Second Floor Plan

SHEET NUMBER

A-1.2-1

PROJECT NO.



PROJECT TITLE Paragon Place at Bear Claw Way Ziegler Site - Lot 9 BLDG #1

Middleton, WI 53562

Lakota Way Madison, Wisconsin SHEET TITLE

EXTERIOR ELEVATIONS

SHEET NUMBER

A-2.1-1

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---1/8" = 1 '--0"-----0' 1/2" 1"

MANUFACTURER BUILDING ELEMENT COLOR (#1) - BRICK VENEER WALNUT INTERSTATE BRICK PEWTER (#2) - BRICK VENEER INTERSTATE BRICK PEARL GRAY (#3) - COMPOSITE SIDING JAMES HARDIE MATCH ADJ. SIDING COLOR COMPOSITE TRIM JAMES HARDIE CRYSTAL WHITE (#4) - CAST STONE BANDS & SILLS ROCKCAST (#5) - COMPOSITE WINDOWS ANDERSEN 100 (#6) - INSULATED METAL DOORS/FRAMES COLOR TO MATCH ADJ. TRIM/SIDING **CANOPY & BAY SOFFITS** BLACK SUPERIOR (#7) - RAILINGS & HANDRAILS

EXTERIOR MATERIAL SCHEDULE



PROJECT TITLE Paragon Place at Bear Claw Way Ziegler Site - Lot 9 BLDG #1

> Lakota Way Madison, Wisconsin SHEET TITLE

Middleton, WI 53562

EXTERIOR ELEVATIONS -COLORED


SHEET NUMBER

© Knothe & Bruce Architects, LLC

PROJECT NUMBER 2214

16' 0' 4' 8' _1/8" = 1 '--0" 0' 1/2" 1"

EXTERIOR MATERIAL SCHEDULE MANUFACTURER COLOR BUILDING ELEMENT WALNUT (#1) - BRICK VENEER INTERSTATE BRICK (#2) - BRICK VENEER PEWTER INTERSTATE BRICK PEARL GRAY (#3) - COMPOSITE SIDING JAMES HARDIE MATCH ADJ. SIDING COLOR COMPOSITE TRIM JAMES HARDIE (#4) - CAST STONE BANDS & SILLS CRYSTAL WHITE **ROCKCAST** (#5) - COMPOSITE WINDOWS ANDERSEN 100 BLACK N/A (#6) - INSULATED METAL DOORS/FRAMES COLOR TO MATCH ADJ. TRIM/SIDING **CANOPY & BAY SOFFITS** (#7) - RAILINGS & HANDRAILS BLACK SUPERIOR

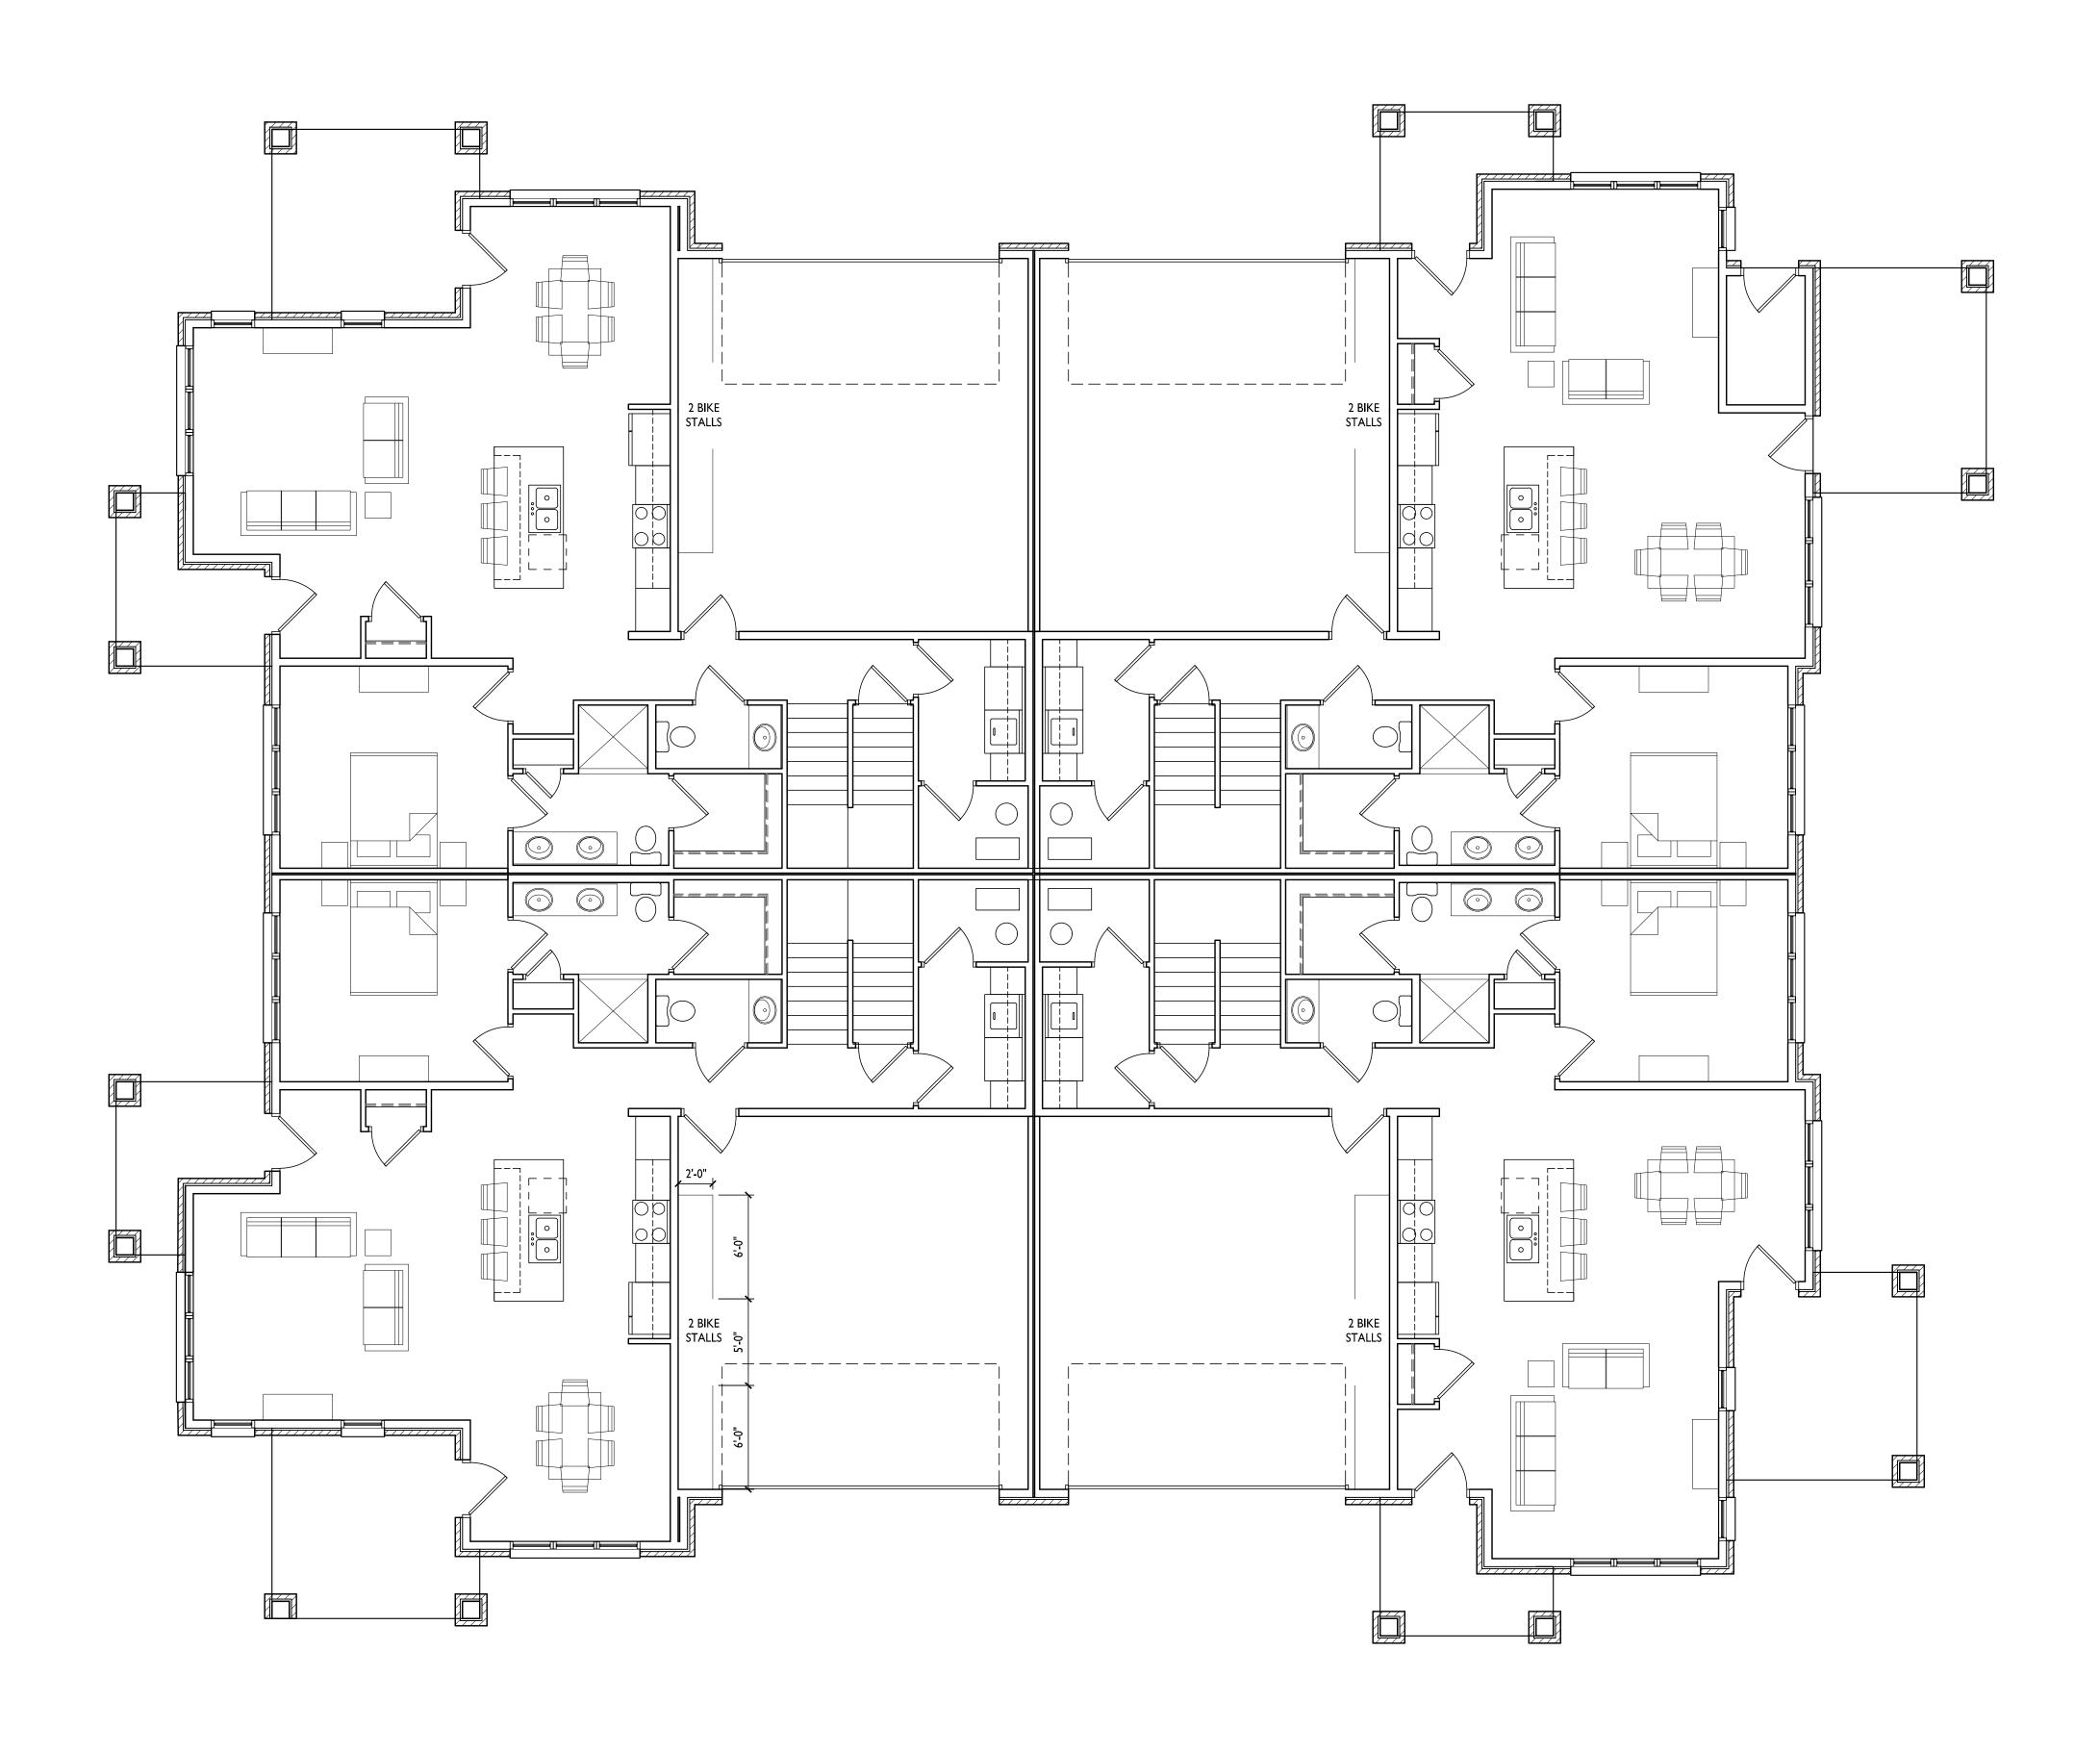





ISSUED

Land Use & UDC Submittal - October 31, 2022

PROJECT TITLE
Paragon Place at
Bear Claw Way
Ziegler Site - Lot 9


304 Lakota Way
Madison, Wisconsin

SHEET TITLE
Building #2, 3 & 4
First Floor Plan

SHEET NUMBER

A-1.1-2

PROJECT NO. 22 14
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Land Use & UDC Submittal - October 31, 2022

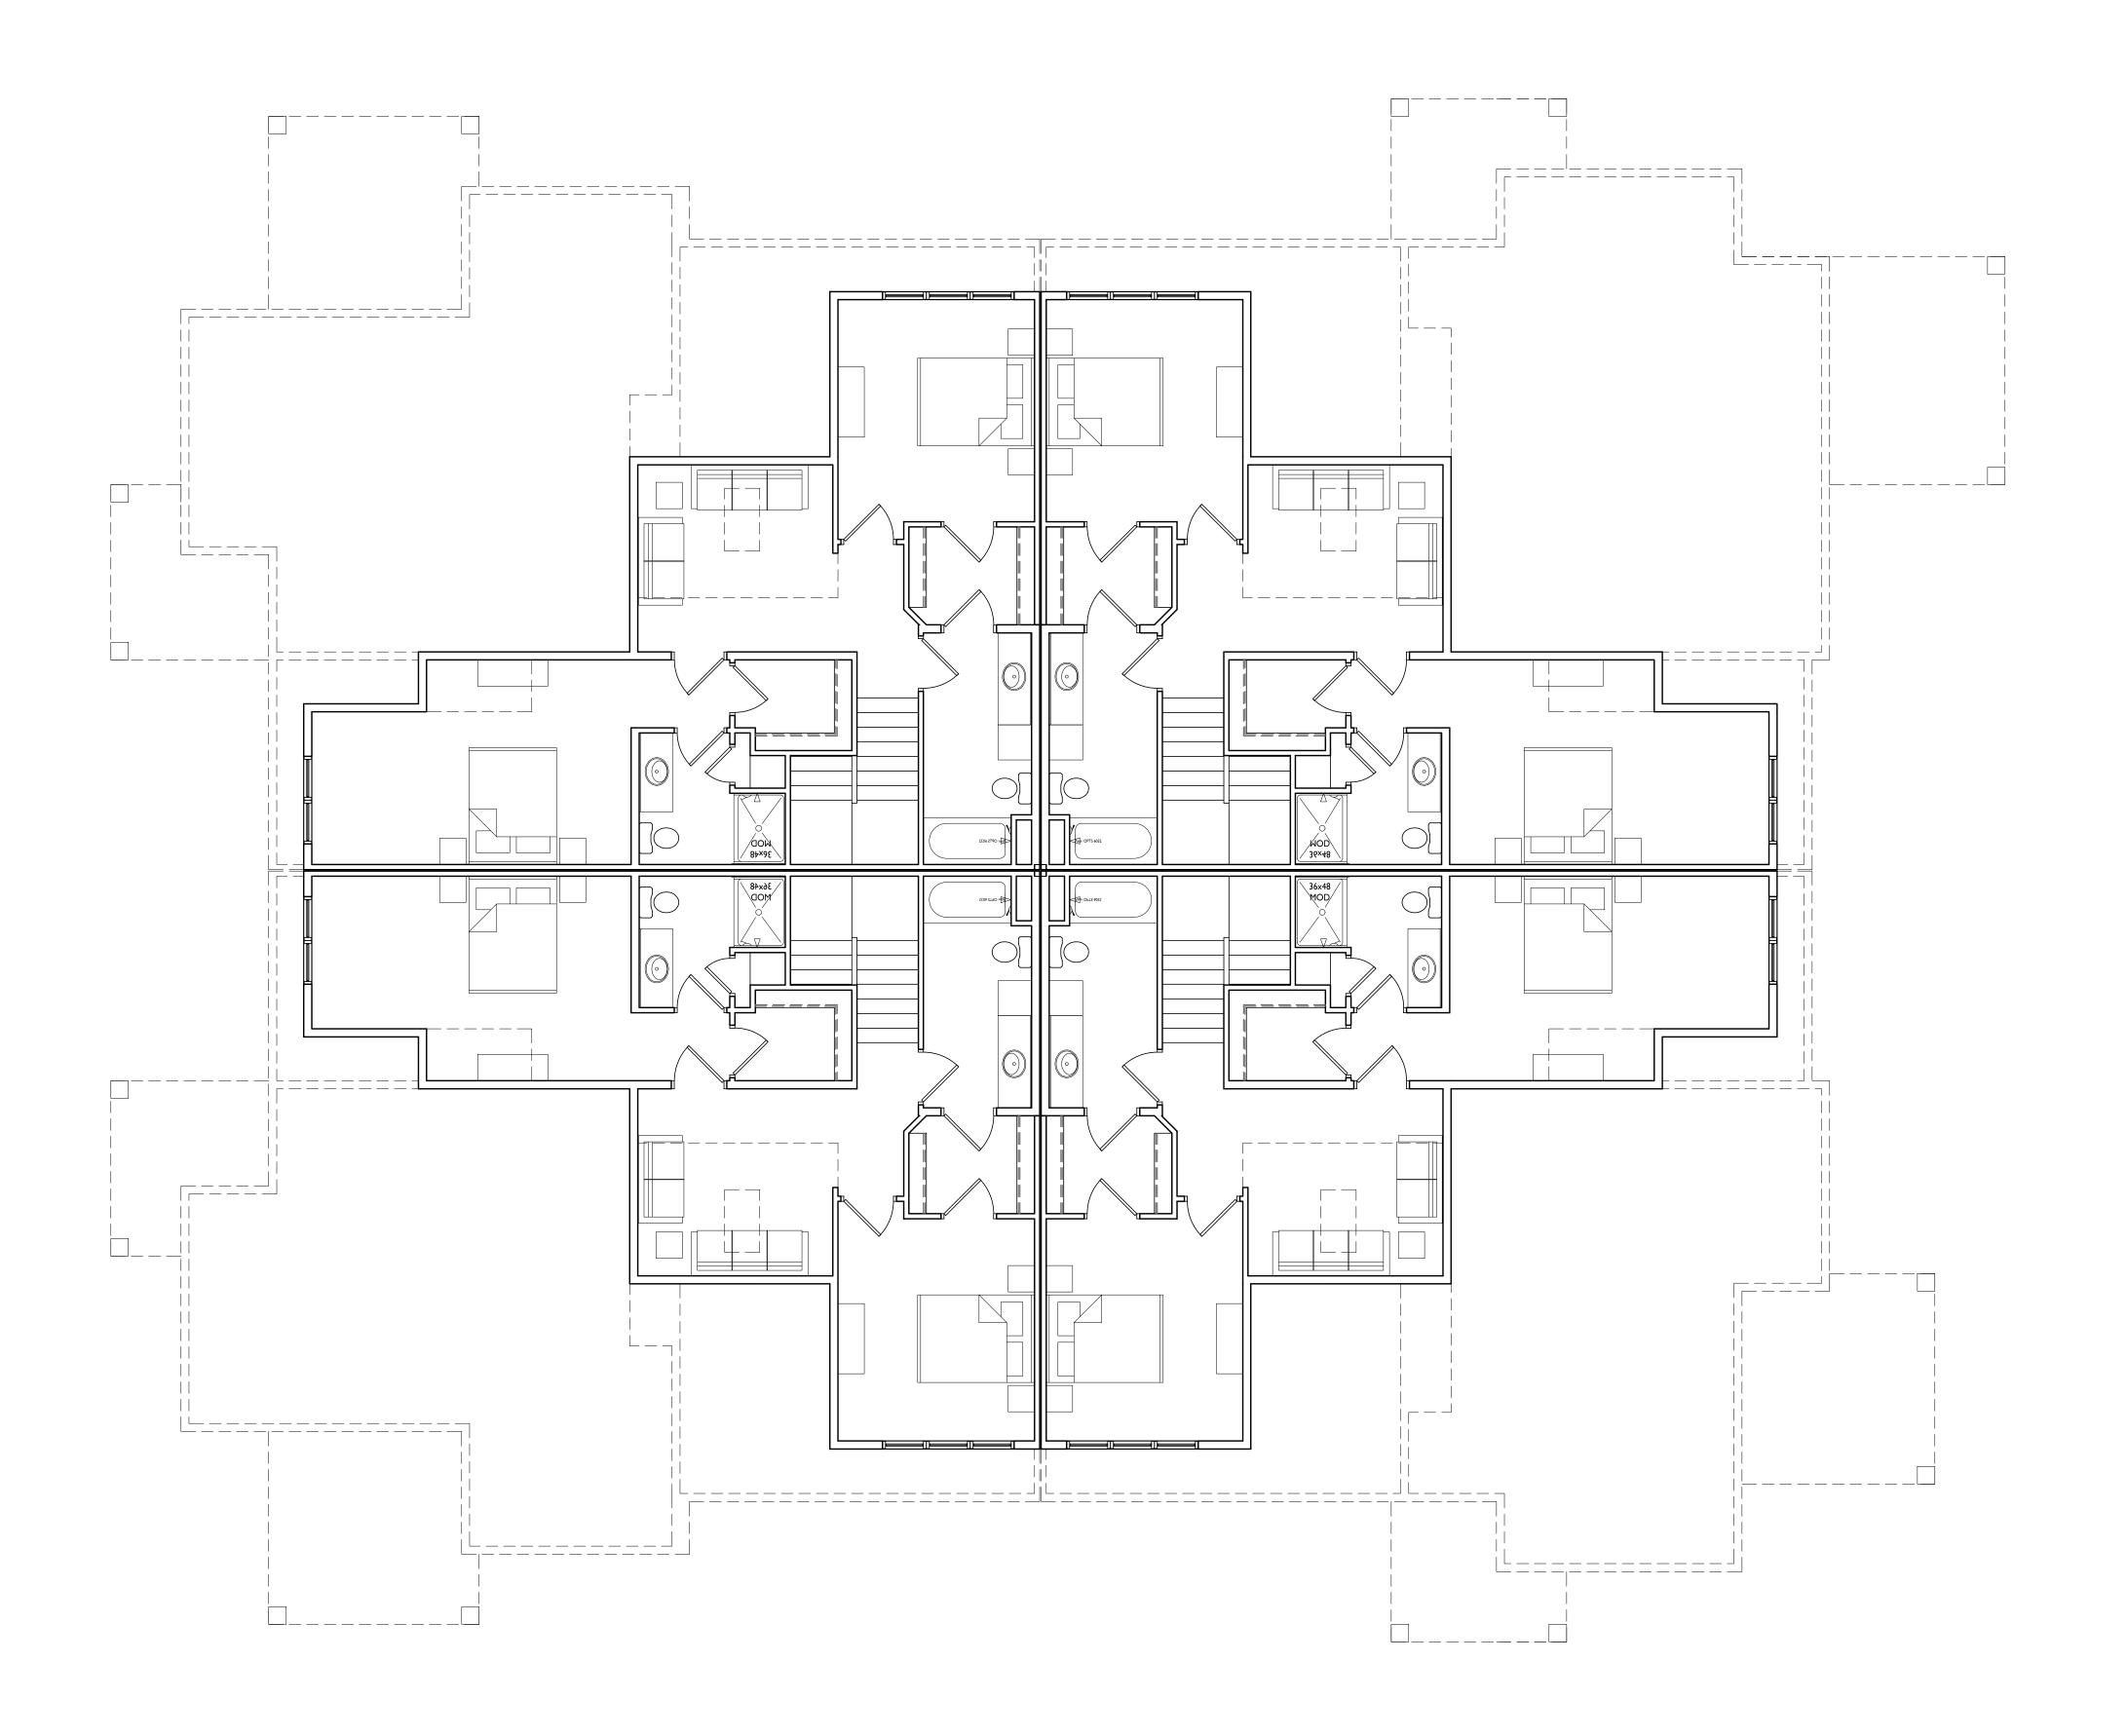
PROJECT TITLE
Paragon Place at
Bear Claw Way
Ziegler Site - Lot 9

304 Lakota Way
Madison, Wisconsin
SHEET TITLE
Building #2, 3 & 4
Second Floor Plan

SHEET NUMBER

A-1.2-2

PROJECT NO. **2214**

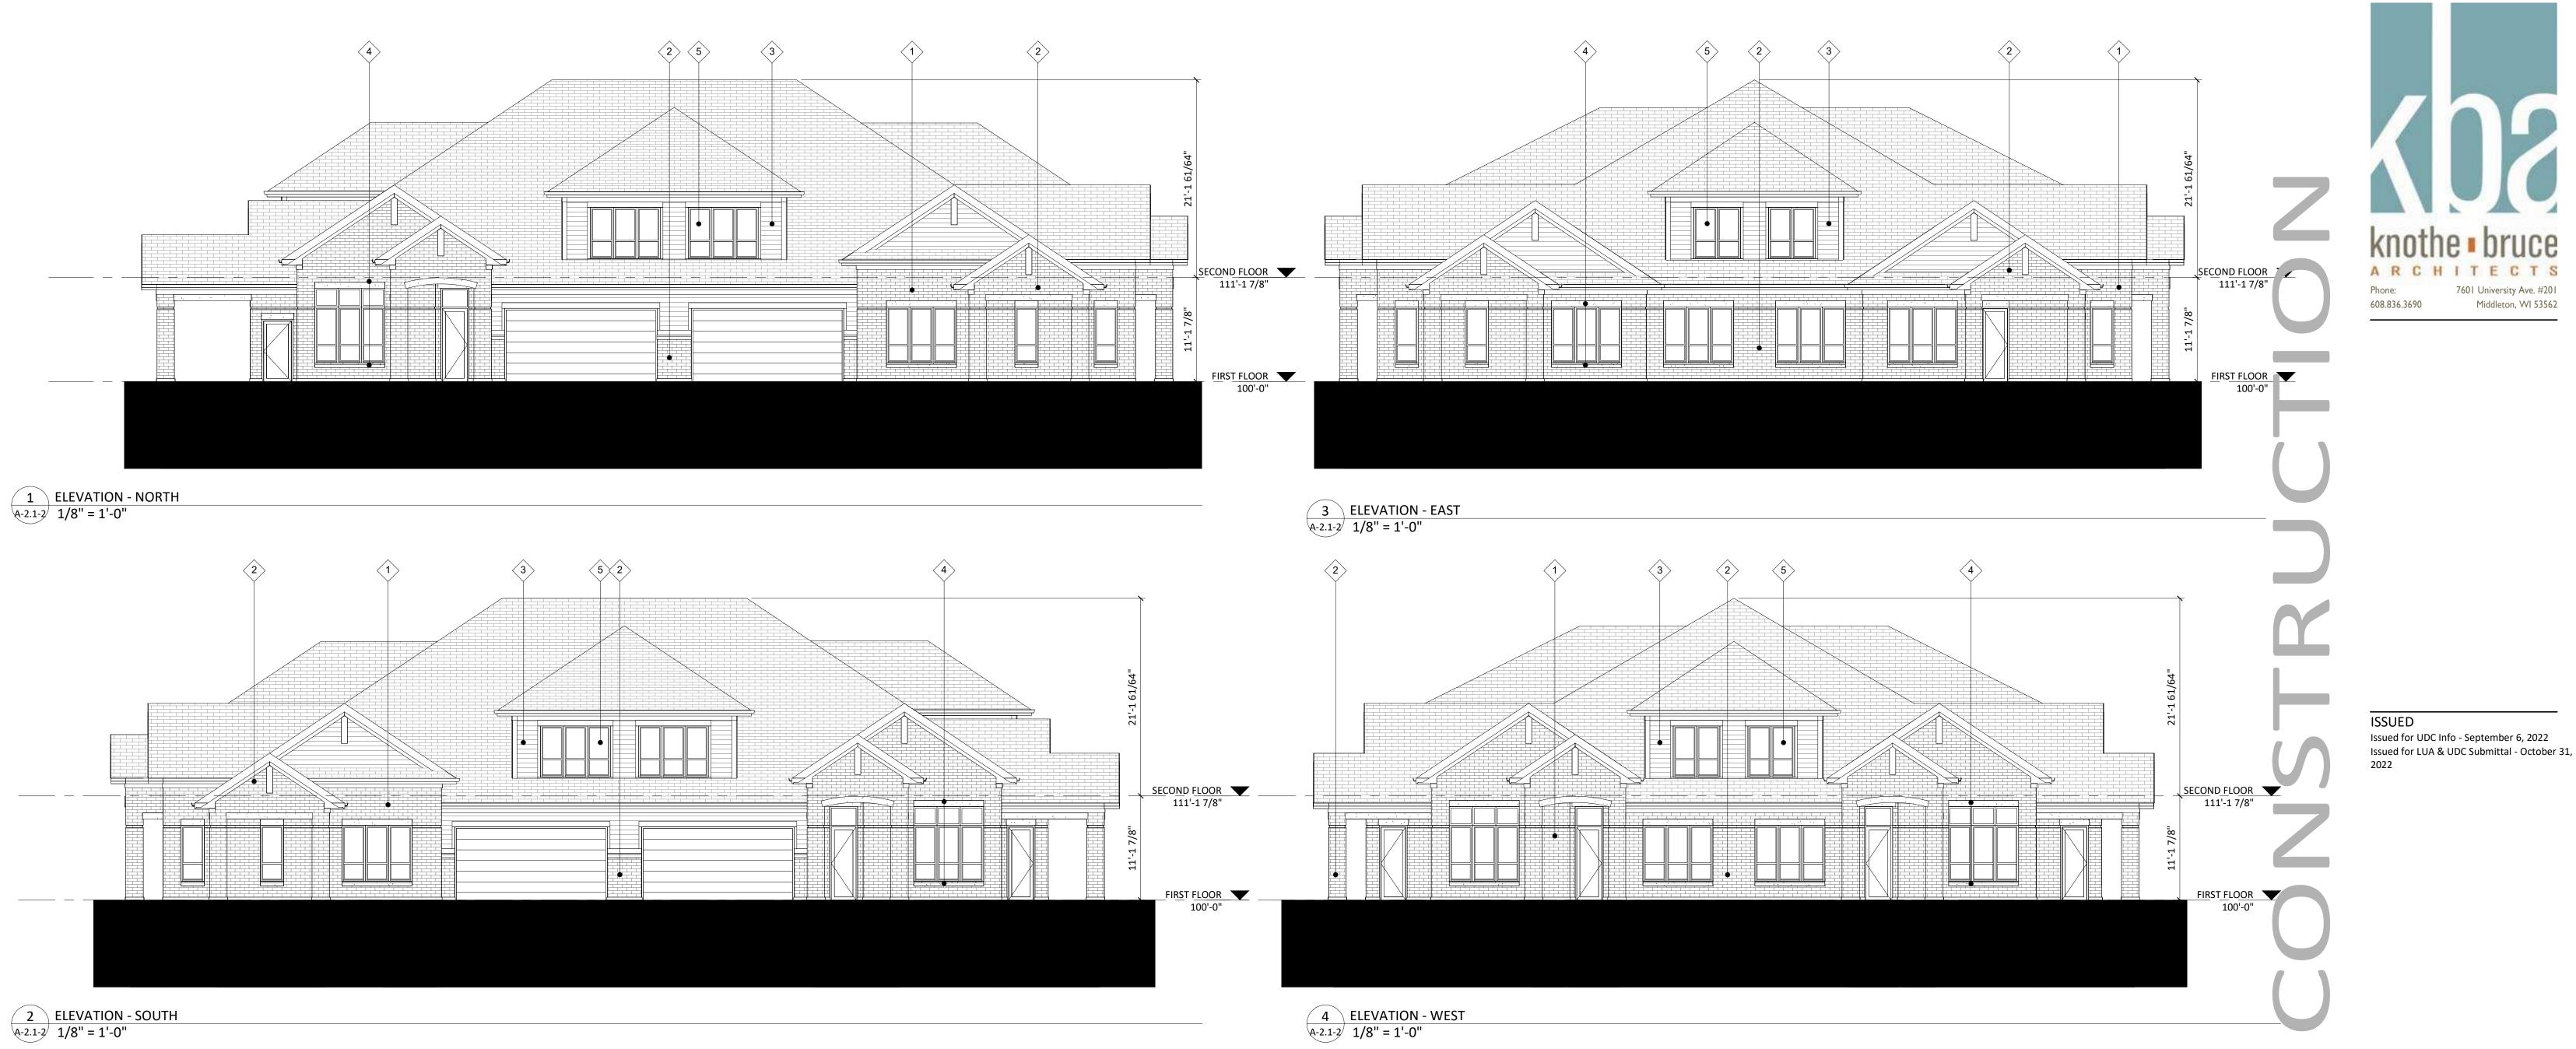

PROJECT TITLE Paragon Place at Bear Claw Way Ziegler Site - Lot 9 BLDG #2-3-4

Middleton, WI 53562

Lakota Way Madison, Wisconsin SHEET TITLE **EXTERIOR ELEVATIONS**

SHEET NUMBER

A-2.1-2

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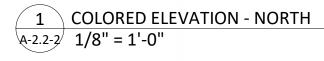
---1/8" = 1 '--0"---- 0' 1/2" 1"

EXTERIOR MATERIAL SCHEDULE **BUILDING ELEMENT** MANUFACTURER COLOR MOCHA INTERSTATE BRICK (#1) - BRICK VENEER ASH (#2) - BRICK VENEER INTERSTATE BRICK (#3) - COMPOSITE SIDING JAMES HARDIE PEARL GRAY MATCH ADJ. SIDING COLOR COMPOSITE TRIM JAMES HARDIE ROCKCAST CRYSTAL WHITE (#4) - CAST STONE BANDS & SILLS (#5) - COMPOSITE WINDOWS ANDERSEN 100 BLACK (#6) - INSULATED METAL DOORS/FRAMES BLACK COLOR TO MATCH ADJ. TRIM/SIDING CANOPY & BAY SOFFITS BLACK (#7) - RAILINGS & HANDRAILS SUPERIOR






2 COLORED ELEVATION - EAST A-2.2-2 1/8" = 1'-0"





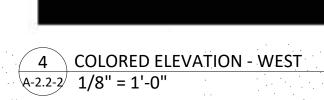



EXTER	IOR MATERIAL SCHEDUL	E
IILDING ELEMENT	MANUFACTURER	COLOR
L) - BRICK VENEER	INTERSTATE BRICK	МОСНА
2) - BRICK VENEER	INTERSTATE BRICK	ASH
B) - COMPOSITE SIDING	JAMES HARDIE	PEARL GRAY
MPOSITE TRIM	JAMES HARDIE	MATCH ADJ. SIDING COLOR
1) - CAST STONE BANDS & SILLS	ROCKCAST	CRYSTAL WHITE
5) - COMPOSITE WINDOWS	ANDERSEN 100	BLACK
5) - INSULATED METAL DOORS/FRAMES	N/A	BLACK
NOPY & BAY SOFFITS	TBD	COLOR TO MATCH ADJ. TRIM/SIDING
7) - RAILINGS & HANDRAILS	SUPERIOR	BLACK

RCHITECT

Phone: 760 | University Ave. #20
608.836.3690 Middleton, WI 5356

ISSUED

Issued for UDC Info - September 6, 2022
Issued for LUA & UDC Submittal - October 31, 2022

PROJECT TITLE
Paragon Place at
Bear Claw Way
Ziegler Site - Lot 9
BLDG #2-3-4

Lakota Way

Madison, Wisconsin

SHEET TITLE

EXTERIOR


ELEVATIONS -


SHEET NUMBER

COLORED

A-2.2-2

PROJECT NUMBER 2214

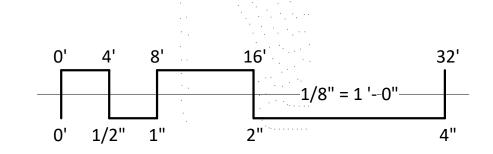

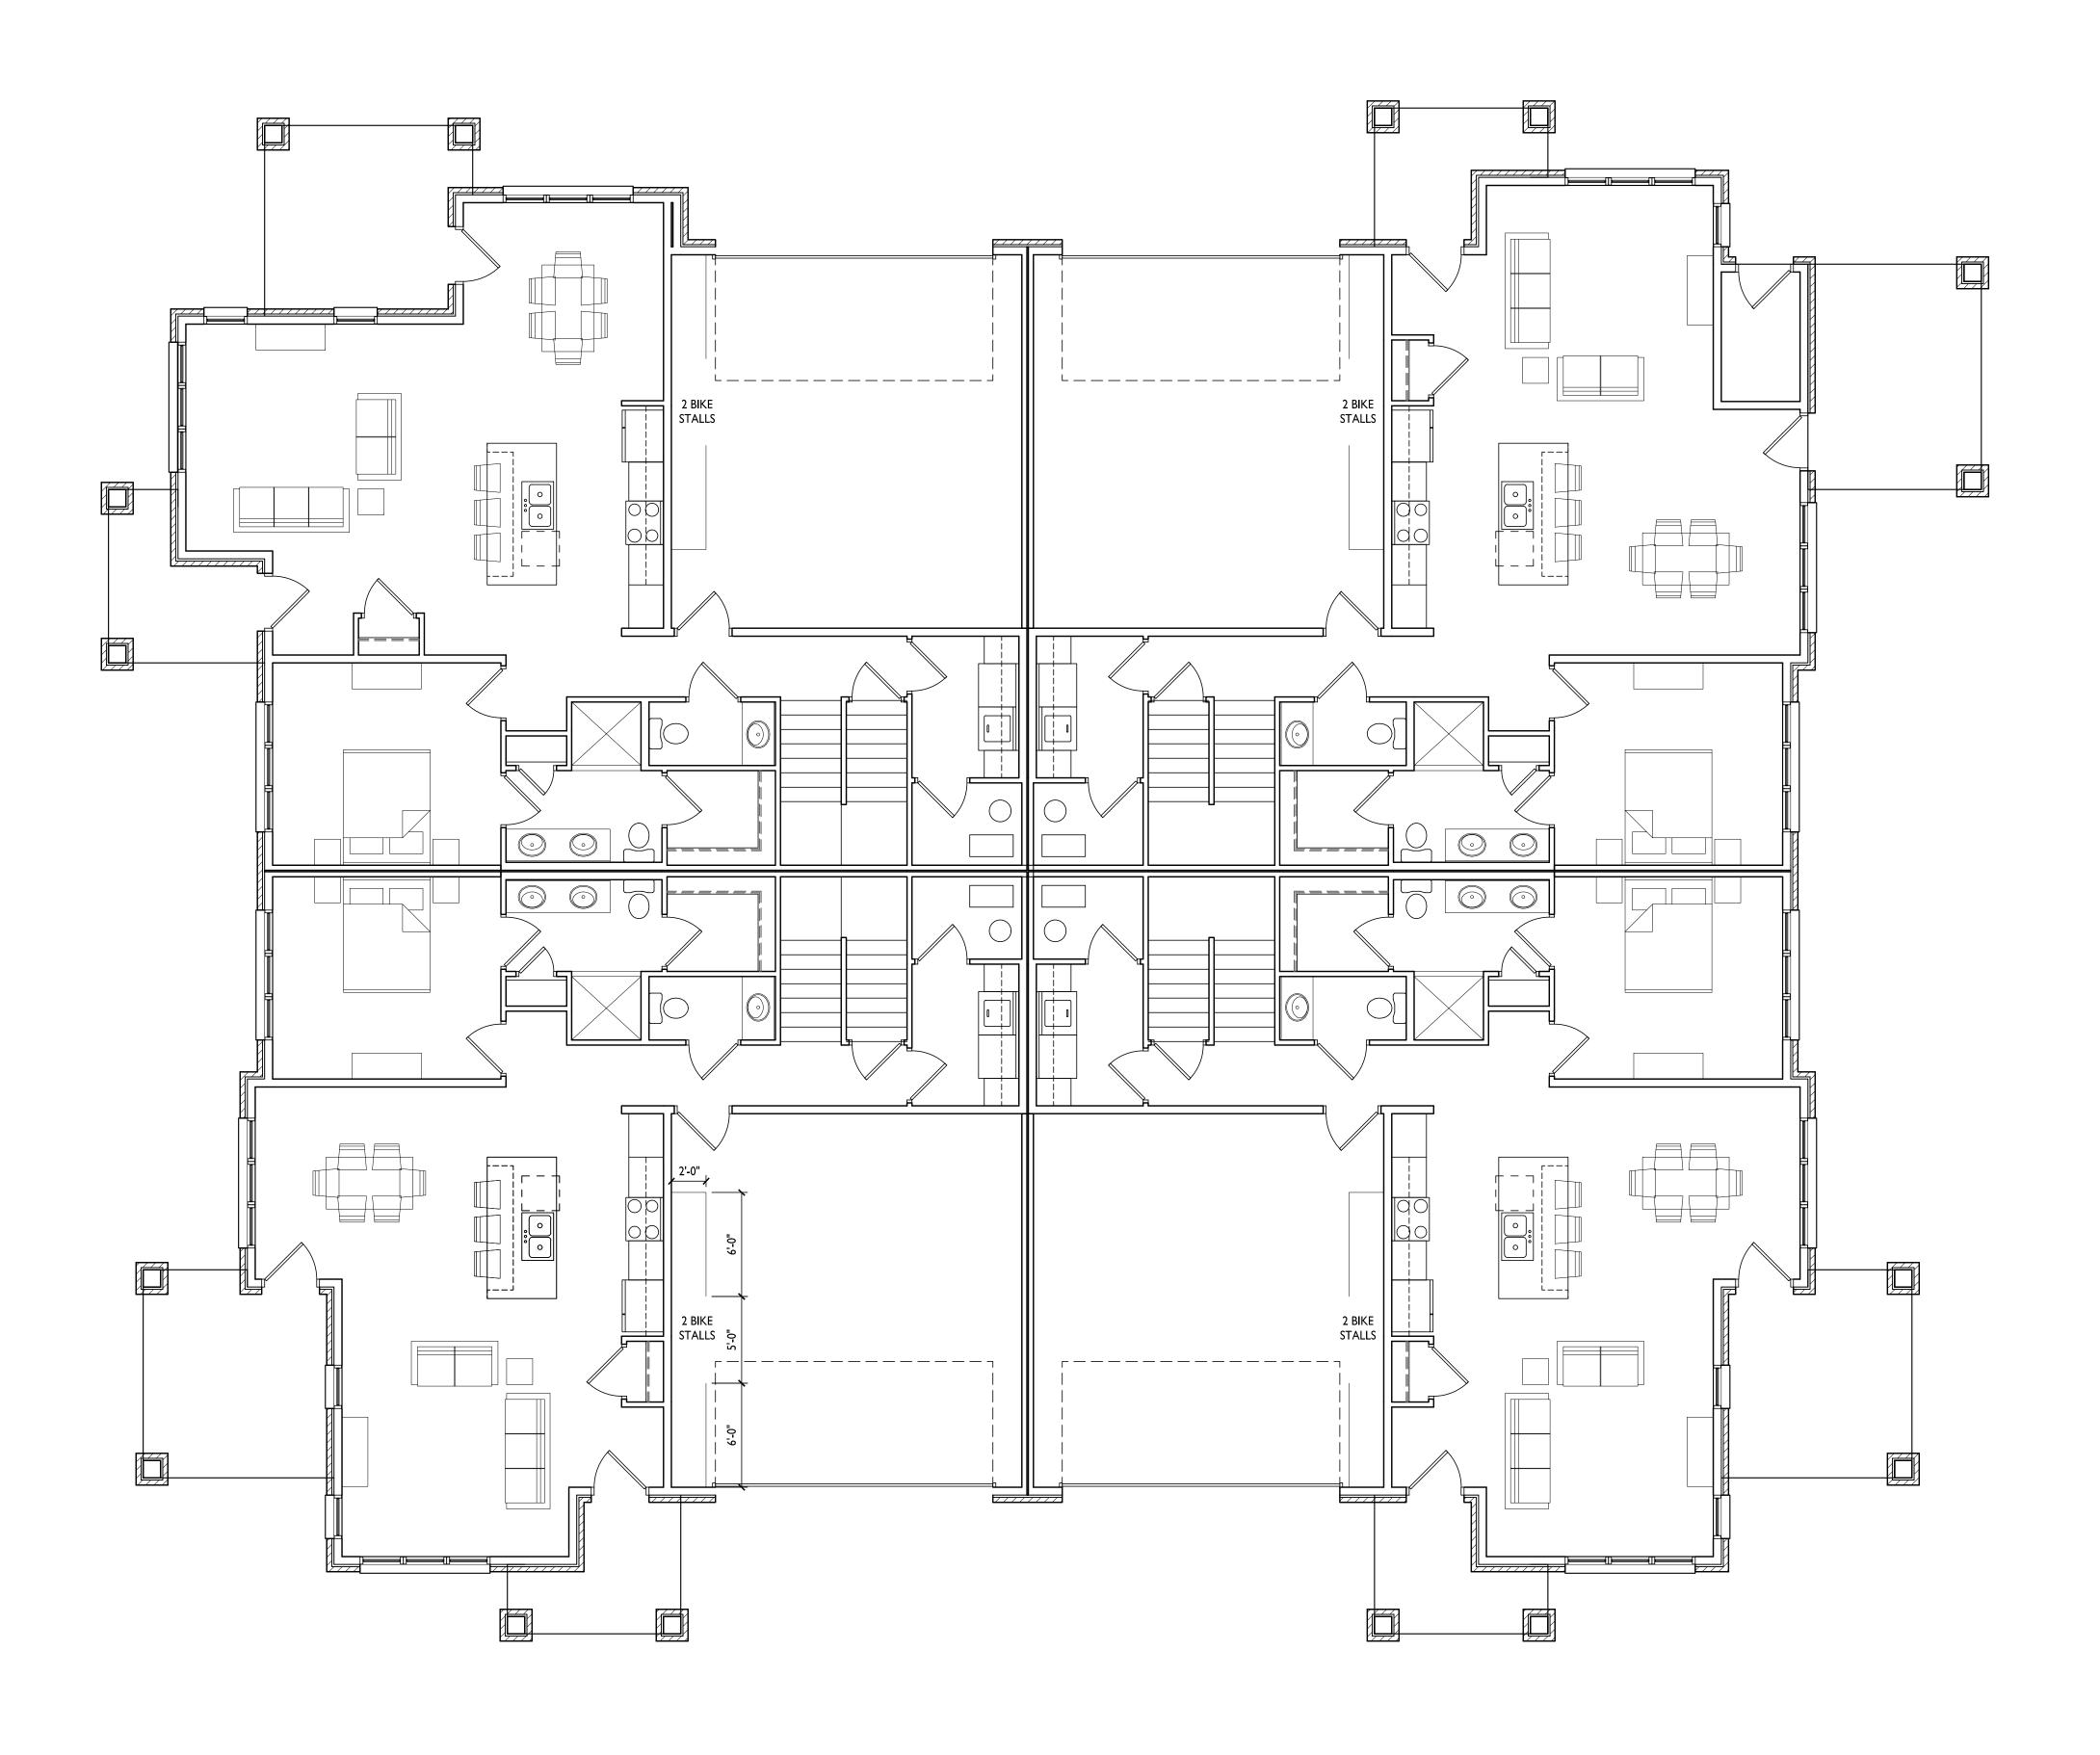





Land Use & UDC Submittal - October 31, 2022

PROJECT TITLE


Paragon Place at Bear Claw Way Ziegler Site - Lot 9

304 Lakota Way Madison, Wisconsin Building #5
First Floor Plan

SHEET NUMBER

A-1.1-5

PROJECT NO.

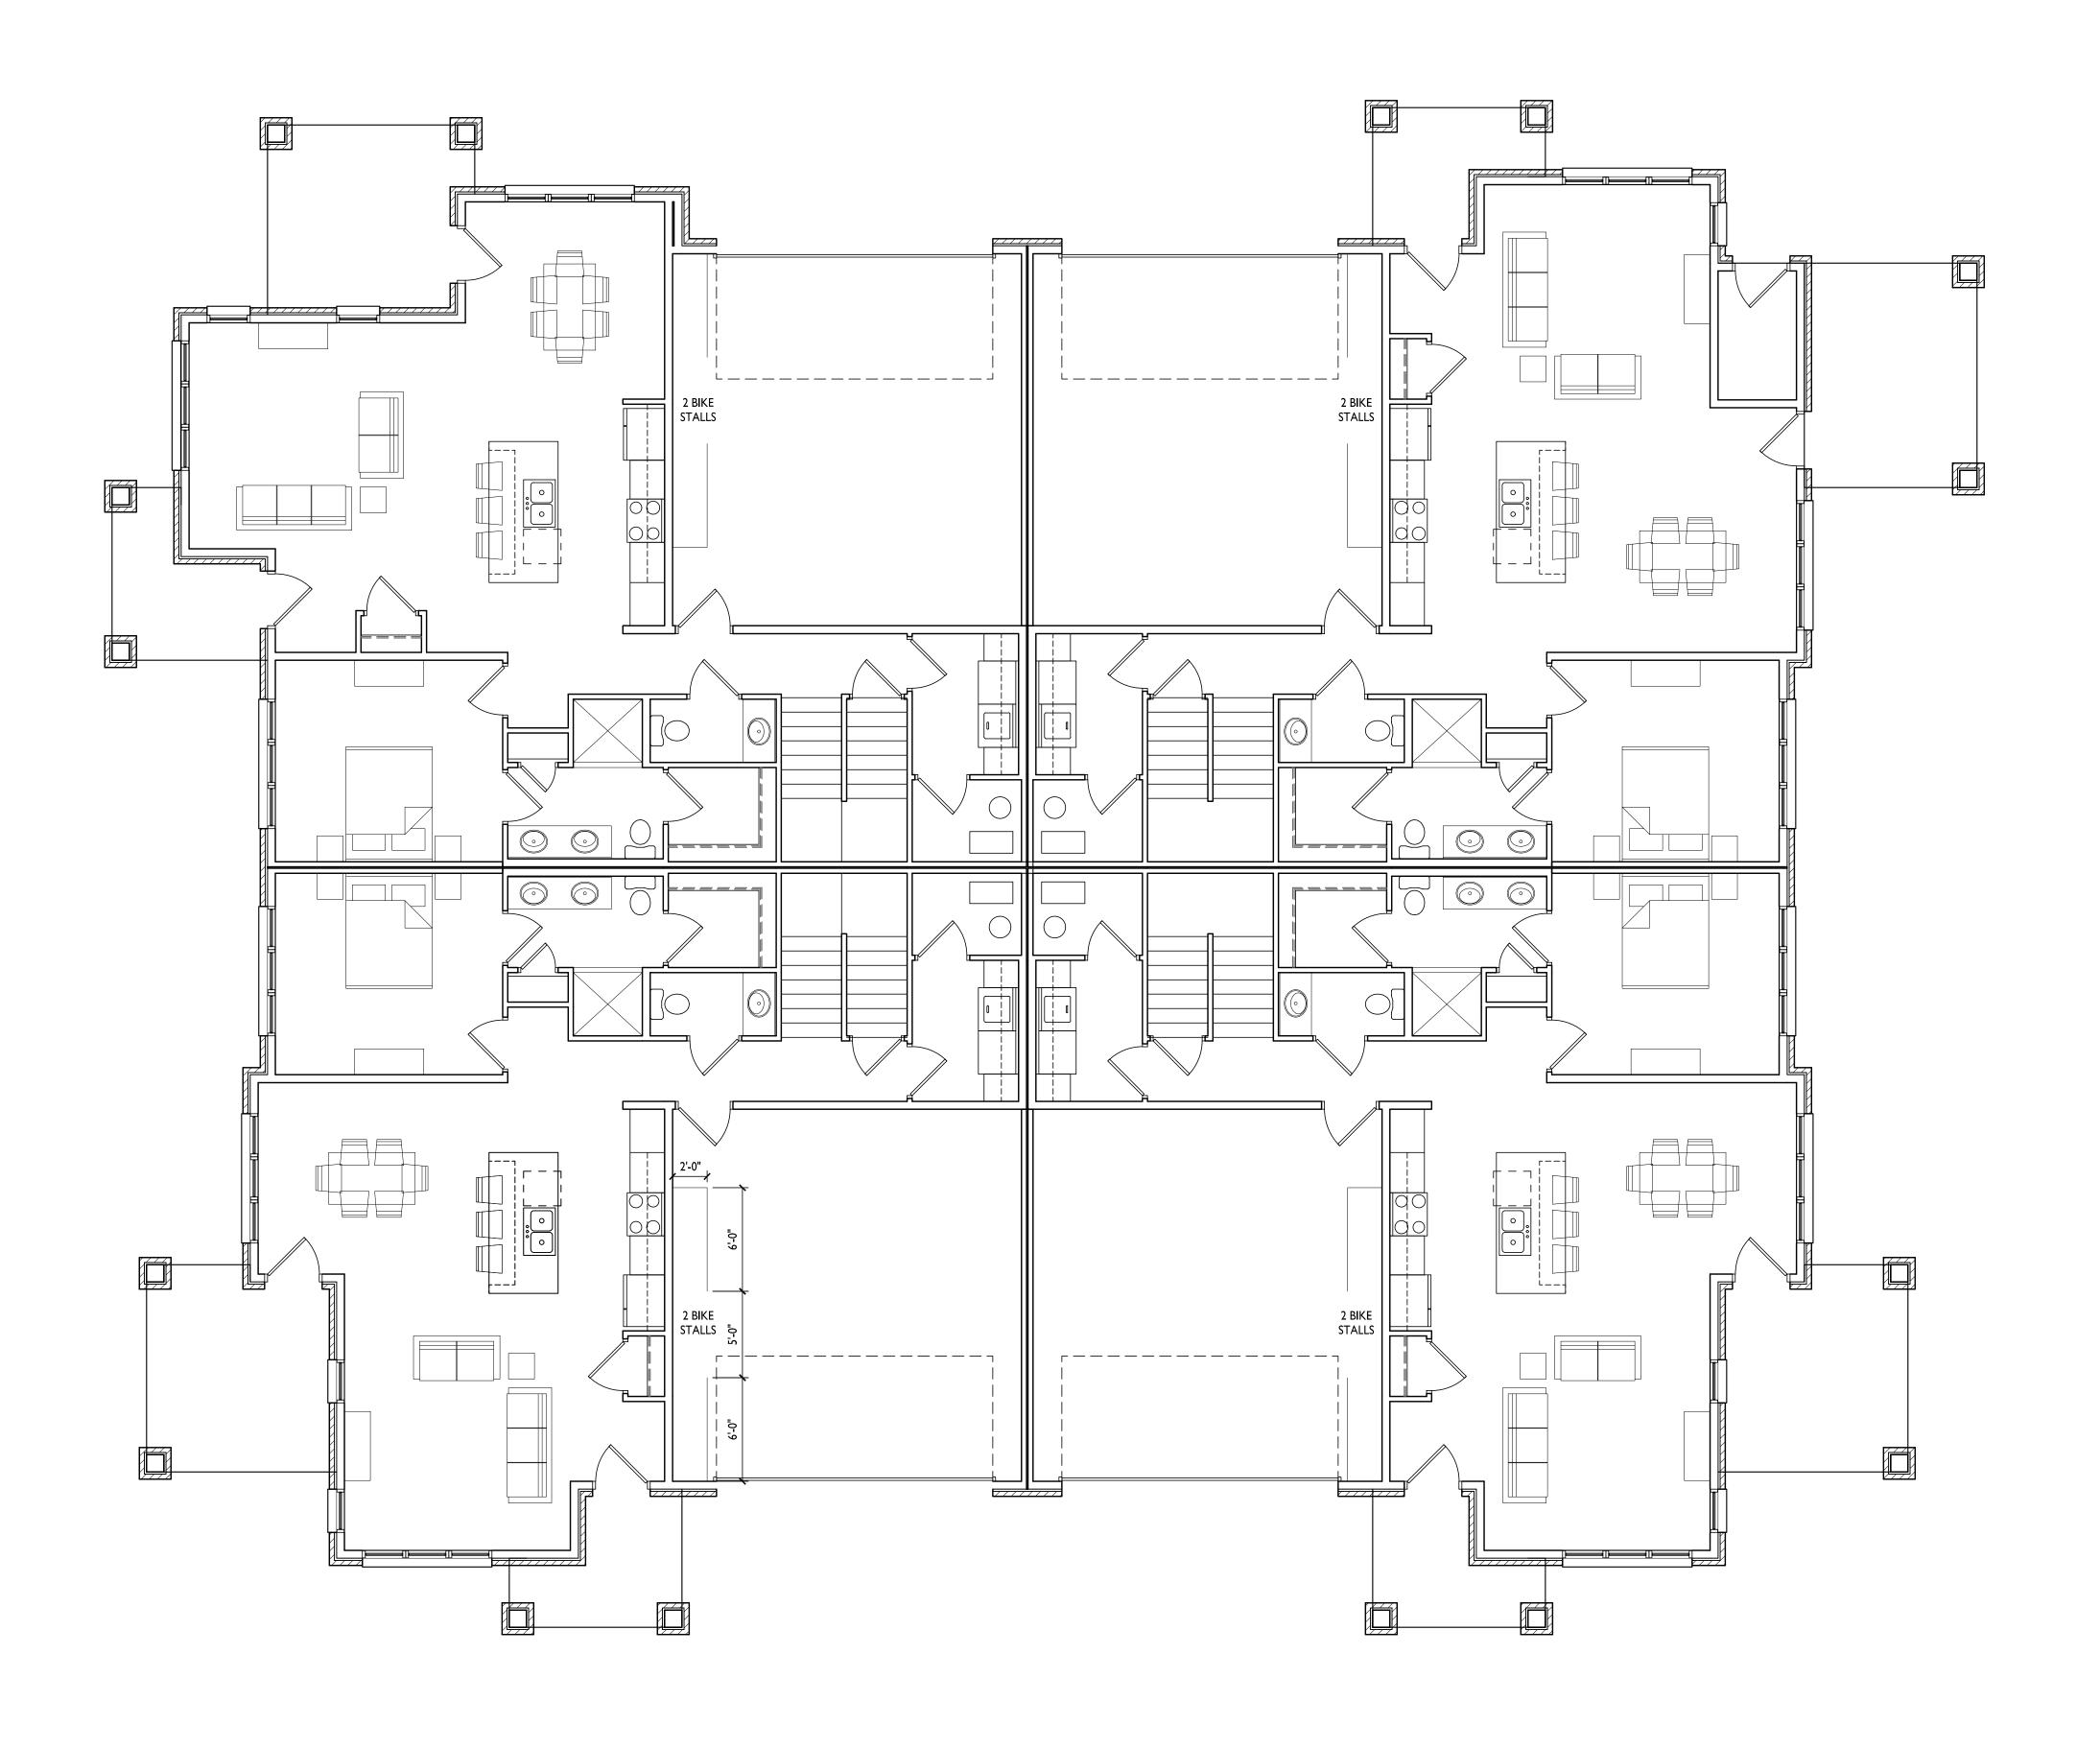





Issued for LUA & UDC Submittal - October 31, 2022


PROJECT TITLE Paragon Place at Bear Claw Way Ziegler Site - Lot 9

304 Lakota Way Madison, Wisconsin SHEET TITLE
Building #5
Second Floor Plan

SHEET NUMBER

A-1.2-5

PROJECT NO.

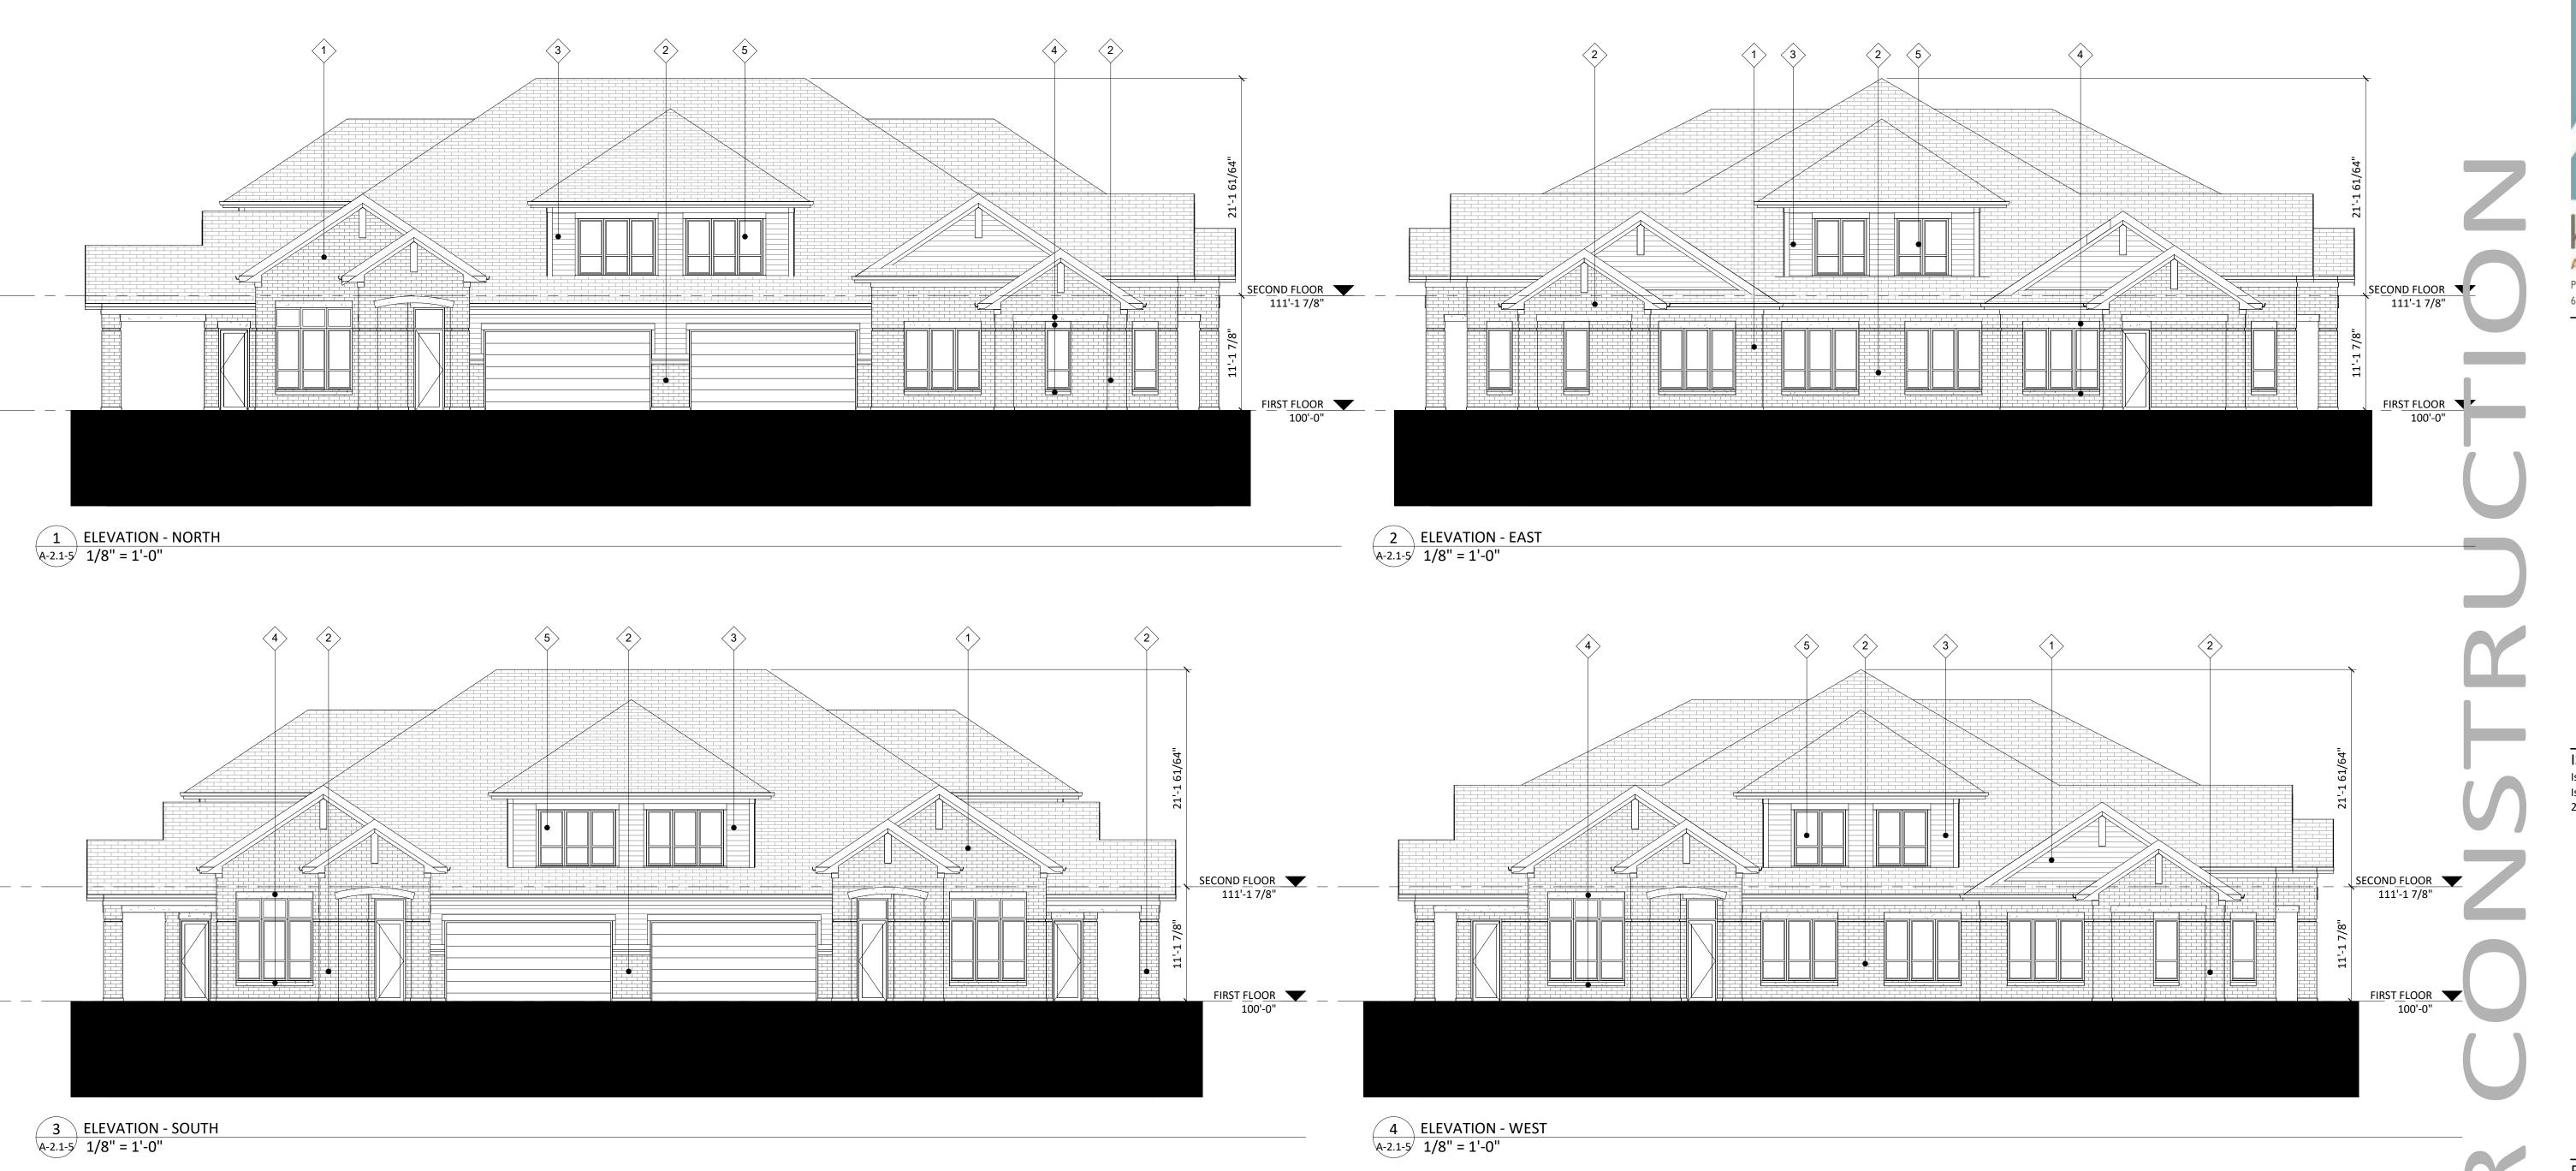



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Issued for UDC Info - September 6, 2022 Issued for LUA & UDC Submittal - October 31,

PROJECT TITLE Bear Claw Way

Paragon Place at Ziegler Site - Lot 9 BLDG #5

Lakota Way Madison, Wisconsin SHEET TITLE **EXTERIOR**

ELEVATIONS

SHEET NUMBER

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____1/8" = 1 '--0" 0' 1/2" 1"

	(#1) - BRICK VENEER	INTERSTATE BRICK	WALNUT	
	(#2) - BRICK VENEER	INTERSTATE BRICK	PEWTER	
	(#3) - COMPOSITE SIDING	JAMES HARDIE	PEARL GRAY	7
	COMPOSITE TRIM	JAMES HARDIE	MATCH ADJ. SIDING COLOR	
	(#4) - CAST STONE BANDS & SILLS	ROCKCAST	CRYSTAL WHITE	
	(#5) - COMPOSITE WINDOWS	ANDERSEN 100	BLACK	7
	(#6) - ALUM. STOREFRONT	N/A	BLACK	7
	(#7) - INSULATED METAL DOORS/FRAMES	N/A	BLACK	
	CANOPY & BAY SOFFITS	TBD	COLOR TO MATCH ADJ. TRIM/SIDING	
'	(#8) - TENSION ROD DECK ASSEMBLY	N/A	BLACK	
	(#9) - RAILINGS & HANDRAILS	SUPERIOR	BLACK	
	TREATED-EXPOSED DECK BEAMS	N/A	BROWN TREATED	

EXTERIOR MATERIAL SCHEDULE

MANUFACTURER

COLOR

BUILDING ELEMENT







2 COLORED ELEVATION - EAST A-2.2-5 1/8" = 1'-0"

SECOND FLOOR 111'-1 7/8"

3 COLORED ELEVATION - SOUTH A-2.2-5 1/8" = 1'-0"

BUILDING ELEMENT

(#1) - BRICK VENEER

(#2) - BRICK VENEER

COMPOSITE TRIM

(#3) - COMPOSITE SIDING

(#4) - CAST STONE BANDS & SILLS

(#7) - INSULATED METAL DOORS/FRAMES

(#8) - TENSION ROD DECK ASSEMBLY

(#5) - COMPOSITE WINDOWS

(#6) - ALUM. STOREFRONT

CANOPY & BAY SOFFITS

(#9) - RAILINGS & HANDRAILS

TREATED-EXPOSED DECK BEAMS

EXTERIOR MATERIAL SCHEDULE

MANUFACTURER

INTERSTATE BRICK

INTERSTATE BRICK

JAMES HARDIE

JAMES HARDIE

ANDERSEN 100

ROCKCAST

SUPERIOR

N/A

COLOR

WALNUT PEWTER

PEARL GRAY

BLACK

BLACK

BLACK

BLACK

BLACK

BROWN TREATED

CRYSTAL WHITE

MATCH ADJ. SIDING COLOR

COLOR TO MATCH ADJ. TRIM/SIDING

4 COLORED ELEVATION - WEST A-2.2-5 1/8" = 1'-0"

PROJECT TITLE Paragon Place at Bear Claw Way

Ziegler Site - Lot 9

Issued for UDC Info - September 6, 2022 Issued for LUA & UDC Submittal - October 31,

Lakota Way

Madison, Wisconsin SHEET TITLE **EXTERIOR ELEVATIONS -**

BLDG #5

COLORED

SHEET NUMBER

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—1/8" = 1 '--0"— 0' 1/2" 1"





















