
# Dane County Jail Consolidation South Tower Addition & Public Safety Building Renovation

Dane County Public Works Project No.: 318025

Mead & Hunt Project No.: 4215400-161957.01

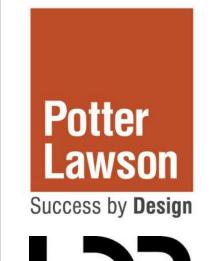



October 31, 2022 Land Use Application


D)MO #	Dunastin u Title	DW0 #	Durantia a Title
DWG#	Drawing Title	DWG#	Drawing Title
GENERAL		ARCHITEC <sup>*</sup>	TURAI
LU-CD	COVER DRAWING	LU-A001	CONTEXT PHOTOS - EXISTING CONDITIONS
		LU-A002	ILLUSTRATIVE SITE PLAN
CIVIL		LU-A003	AERIAL VIEWS
C001	EXISTING CONDITIONS	LU-A004	BUILDING PERSPECTIVES
C002	ENLARGED EXISTING CONDITIONS - AREA A	LU-A005	BUILDING PERSPECTIVES
C003	ENLARGED EXISTING CONDITIONS - AREA B	LU-A101	FLOOR PLANS
C101	ENLARGED DEMOLITION PLAN - AREA A	LU-A102	FLOOR PLANS
C102	ENLARGED DEMOLITION PLAN - AREA B	LU-A103	FLOOR PLANS
C201	OVERALL SITE PLAN	LU-A104	FLOOR PLANS
C202	ENLARGED SITE PLAN - AREA A	LU-A105	FLOOR PLANS
C203	ENLARGED SITE PLAN - AREA B	LU-A201	BUILDING ELEVATION - NORTH
C301	ENLARGED GRADING PLAN - AREA A	LU-A202	BUILDING ELEVATION - EAST
C302	ENLARGED GRADING PLAN -	LU-A203	BUILDING ELEVATION - SOUTH
	SUB-BASEMENT 2 - AREA B	LU-A204	BUILDING ELEVATION - WEST
C401	UTILITIES PLAN	LU-A205	BUILDING ELEVATION - NORTH COLOR
C402	UTILITIES PLAN	LU-A206	BUILDING ELEVATION - EAST COLOR
C501	OVERALL FIRE ACCESS EXHIBIT	LU-A207	BUILDING ELEVATION - SOUTH COLOR
C901	VEHICLE TURNING RADIUS EXHIBITS	LU-A208	BUILDING ELEVATION - WEST COLOR


115 W. Doty Street

Madison, WI 53703

DWG#	Drawing Title
ELECTRICA	L
ES-1	SITE LIGHTING
ES-2	SITE LIGHTING PHOTOMETRIC PLAN WILSON STREET ENTRANCE
ES-3	SITE LIGHTING SUBMITTAL (FIXTURES)



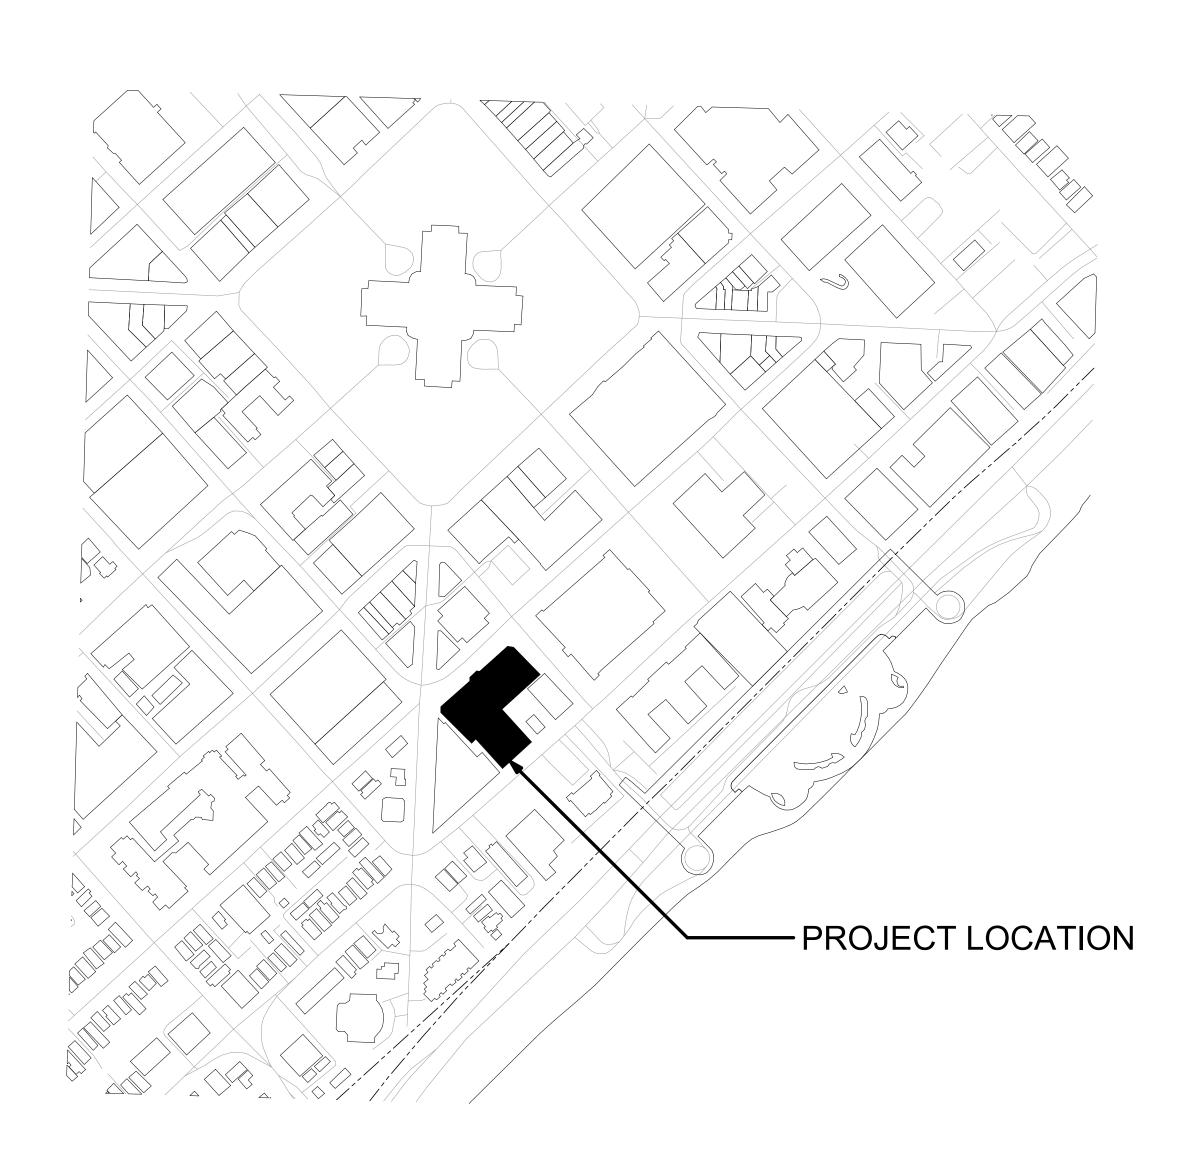

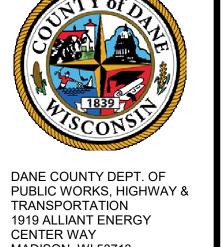

10/31/2022 LAND USE APPLICATION

NOT FOR CONSTRUCTION

CHECKED BY: JDH


SHEET CONTENTS **COVER DRAWING** 

LU-CD

View of Dane County Courthouse along West Wilson Street



Context View from John Nolen Drive

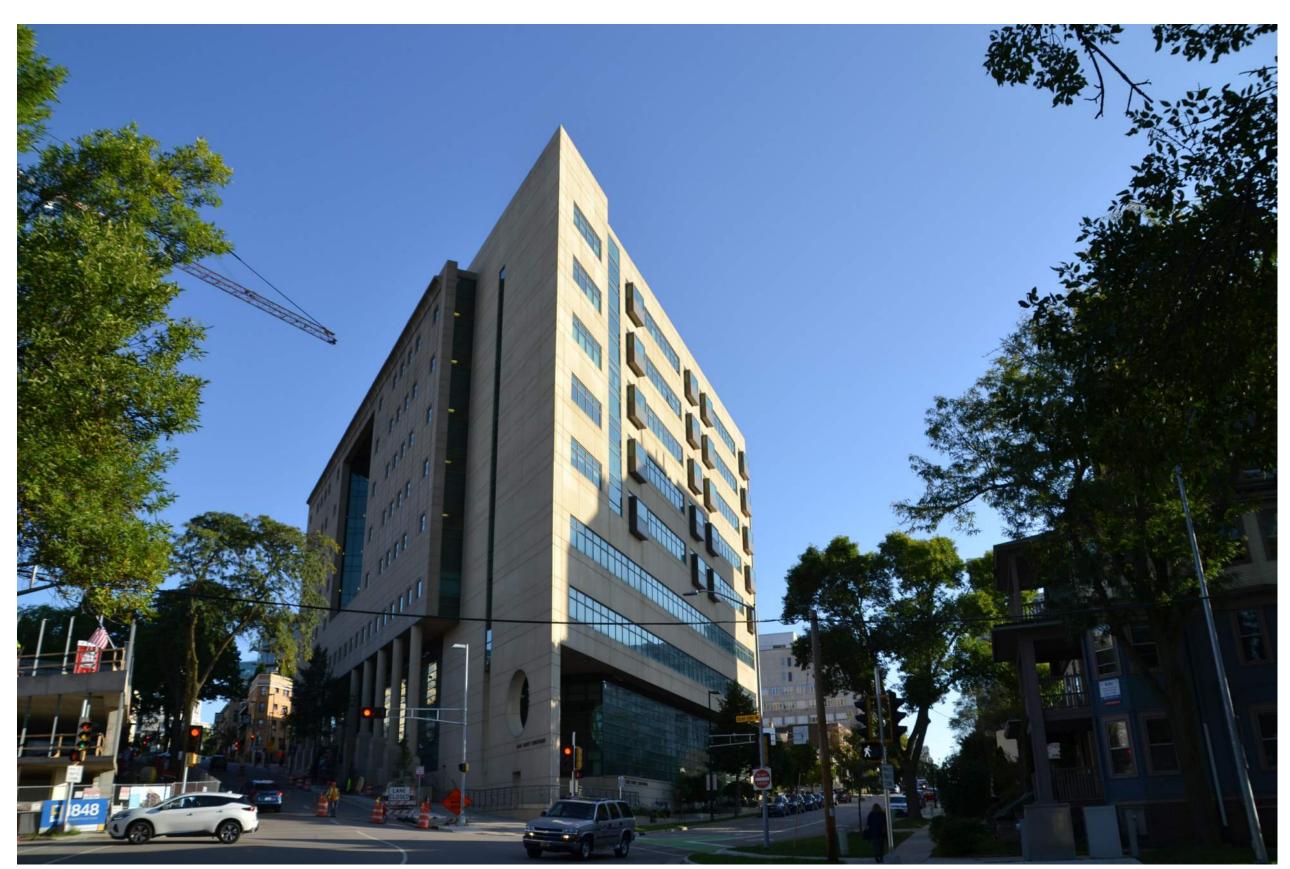

Dane County Courthouse




View of 111 West Wilson (Left) and 131 West Wilson (Right)



View of Public Safety Building from West Wilson Street



View of 112 West Wilson Street

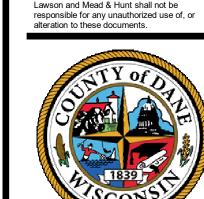

DANE COUNTY DEPT. OF PUBLIC WORKS, HIGHWAY & TRANSPORTATION 1919 ALLIANT ENERGY

PROJECT NO. 318025

10/31/2022 LAND USE APPLICATION

NOT FOR CONSTRUCTION

DESIGNED BY: N/A DRAWN BY: N/A CHECKED BY: N/A


SHEET CONTENTS
CONTEXT PHOTOS EXISTING
CONDITIONS

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CHECKED BY: JDH SHEET CONTENTS


BUILDING PERSPECTIVES



VIEW FROM FAIRCHILD

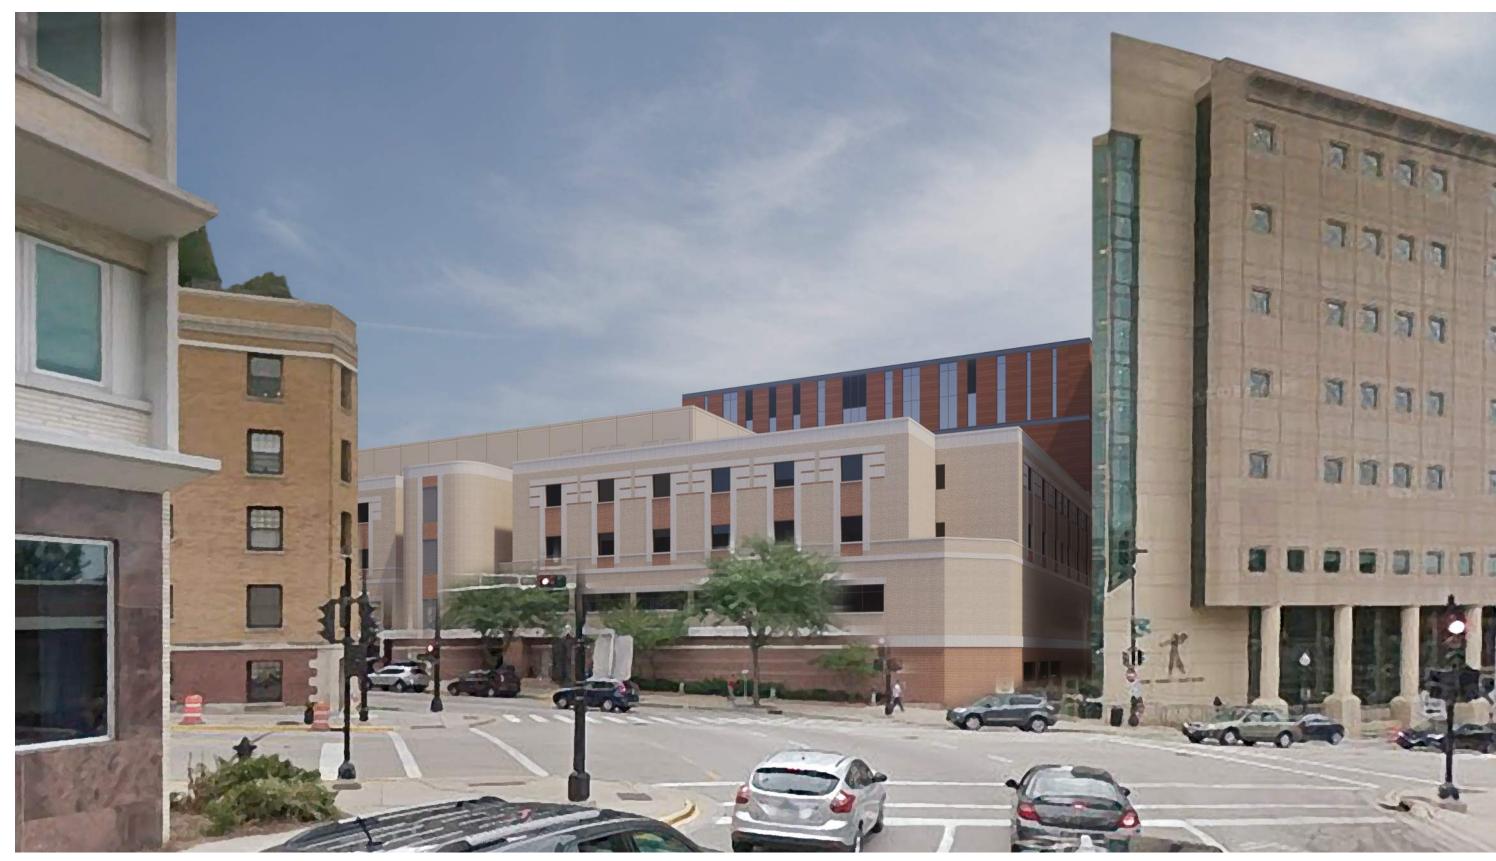


SOUTH ELEVATION

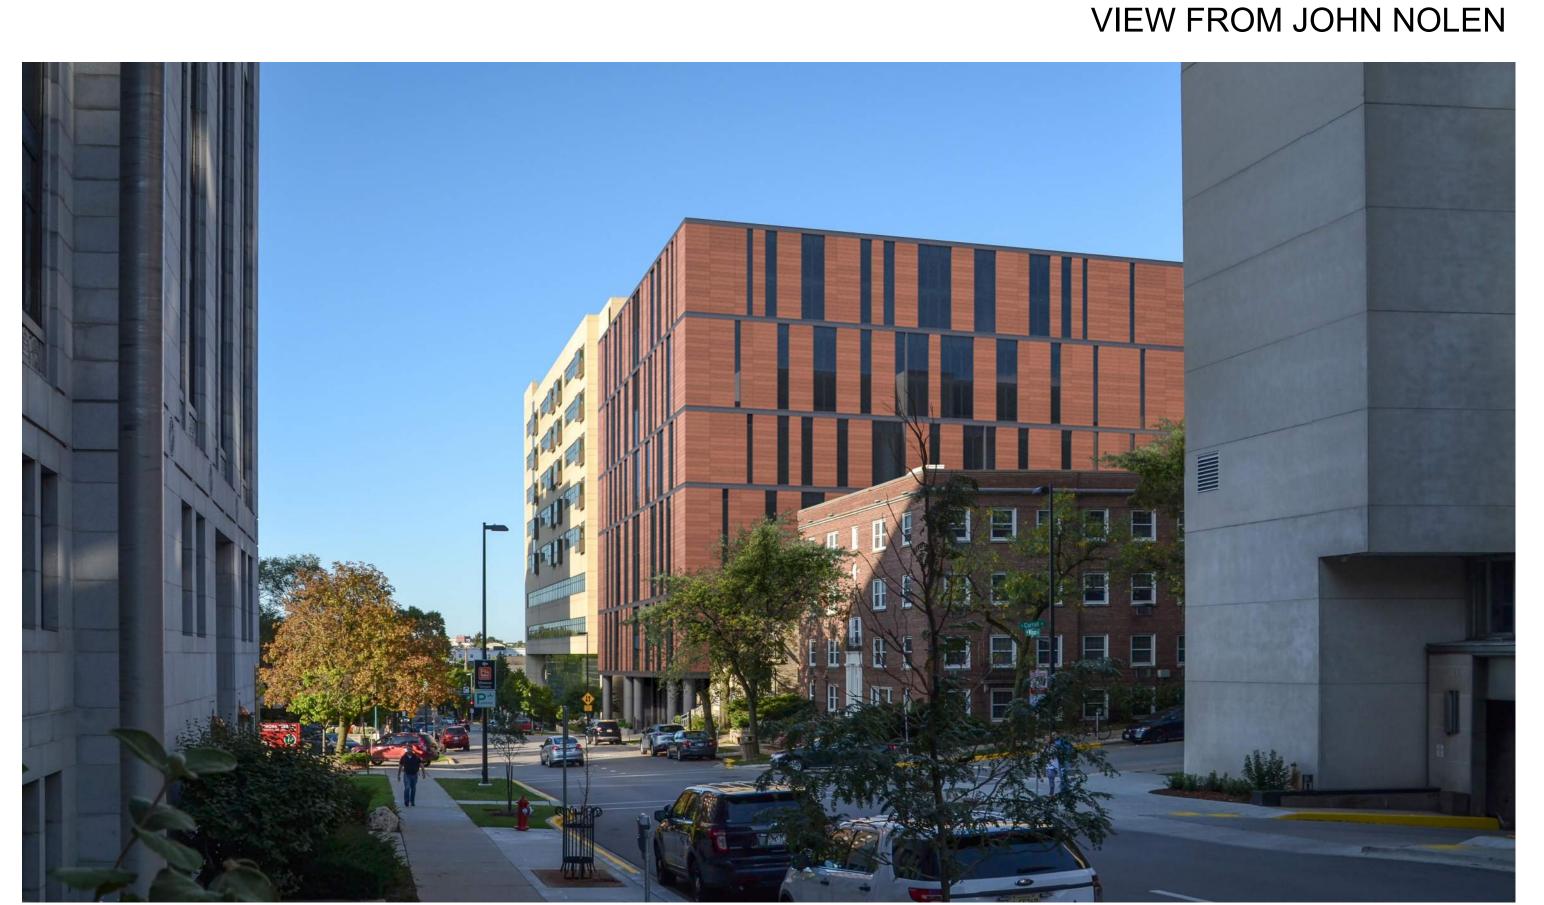

VIEW FROM DOHS



FACADE DETAIL

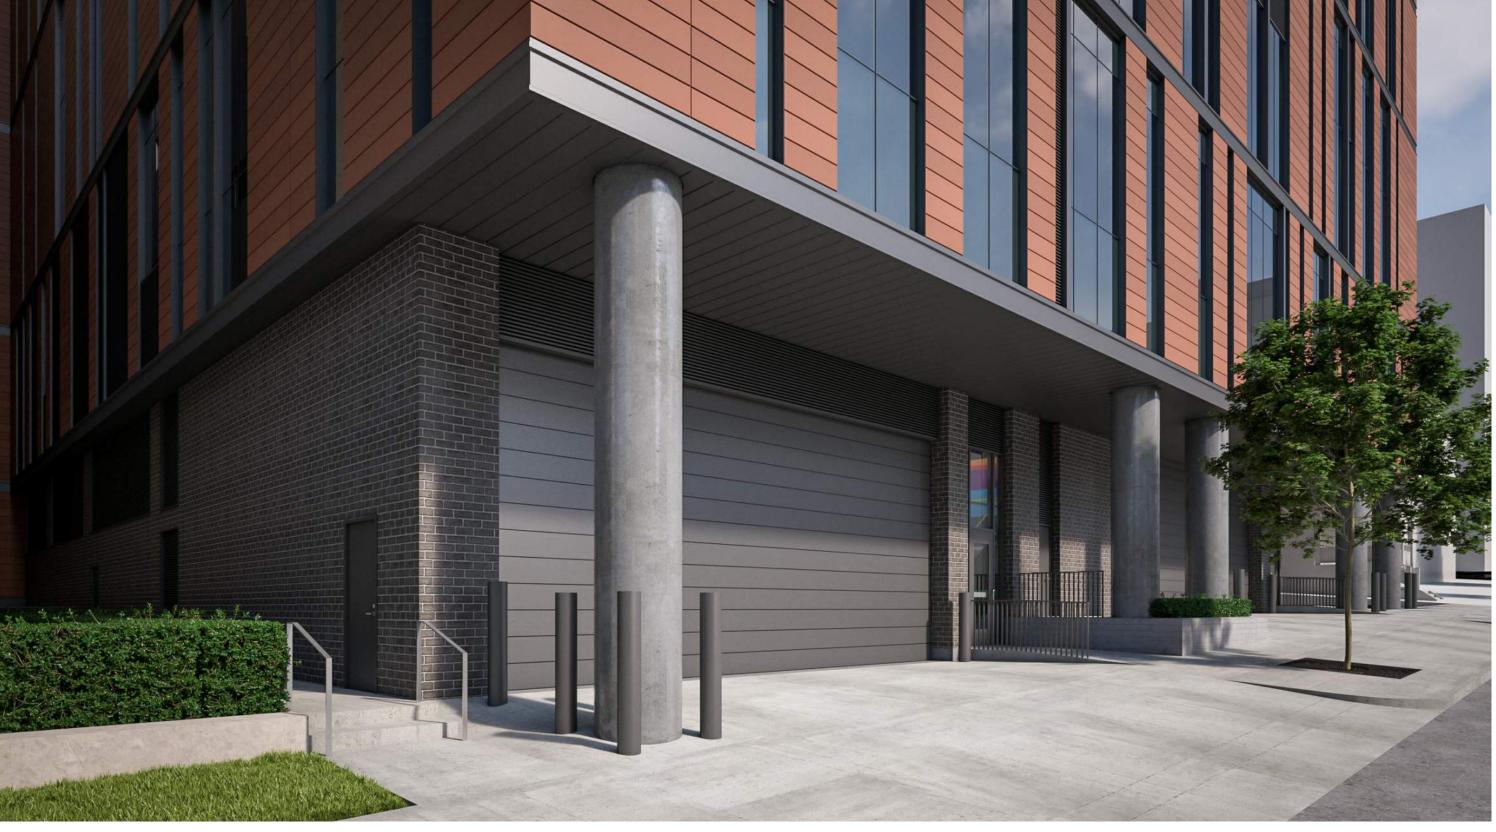

EAST STREET LEVEL WEST





STREET LEVEL EAST AT DUSK




STREET LEVEL WEST AT DUSK



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PROJECT NO. 318025

e County Jail Consolidation Tower Addition & Public Safety Jing Renovation

10/31/2022 LAND USE APPLICATION

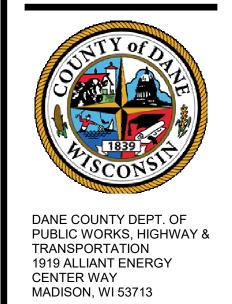NOT FOR CONSTRUCTION

M&H NO.: 4215400-161957.01

DATE: 10/31/2022


DESIGNED BY: JDH

DRAWN BY: EML

CHECKED BY: JDH

SHEET CONTENTS
BUILDING
PERSPECTIVES


SHEET NO.:

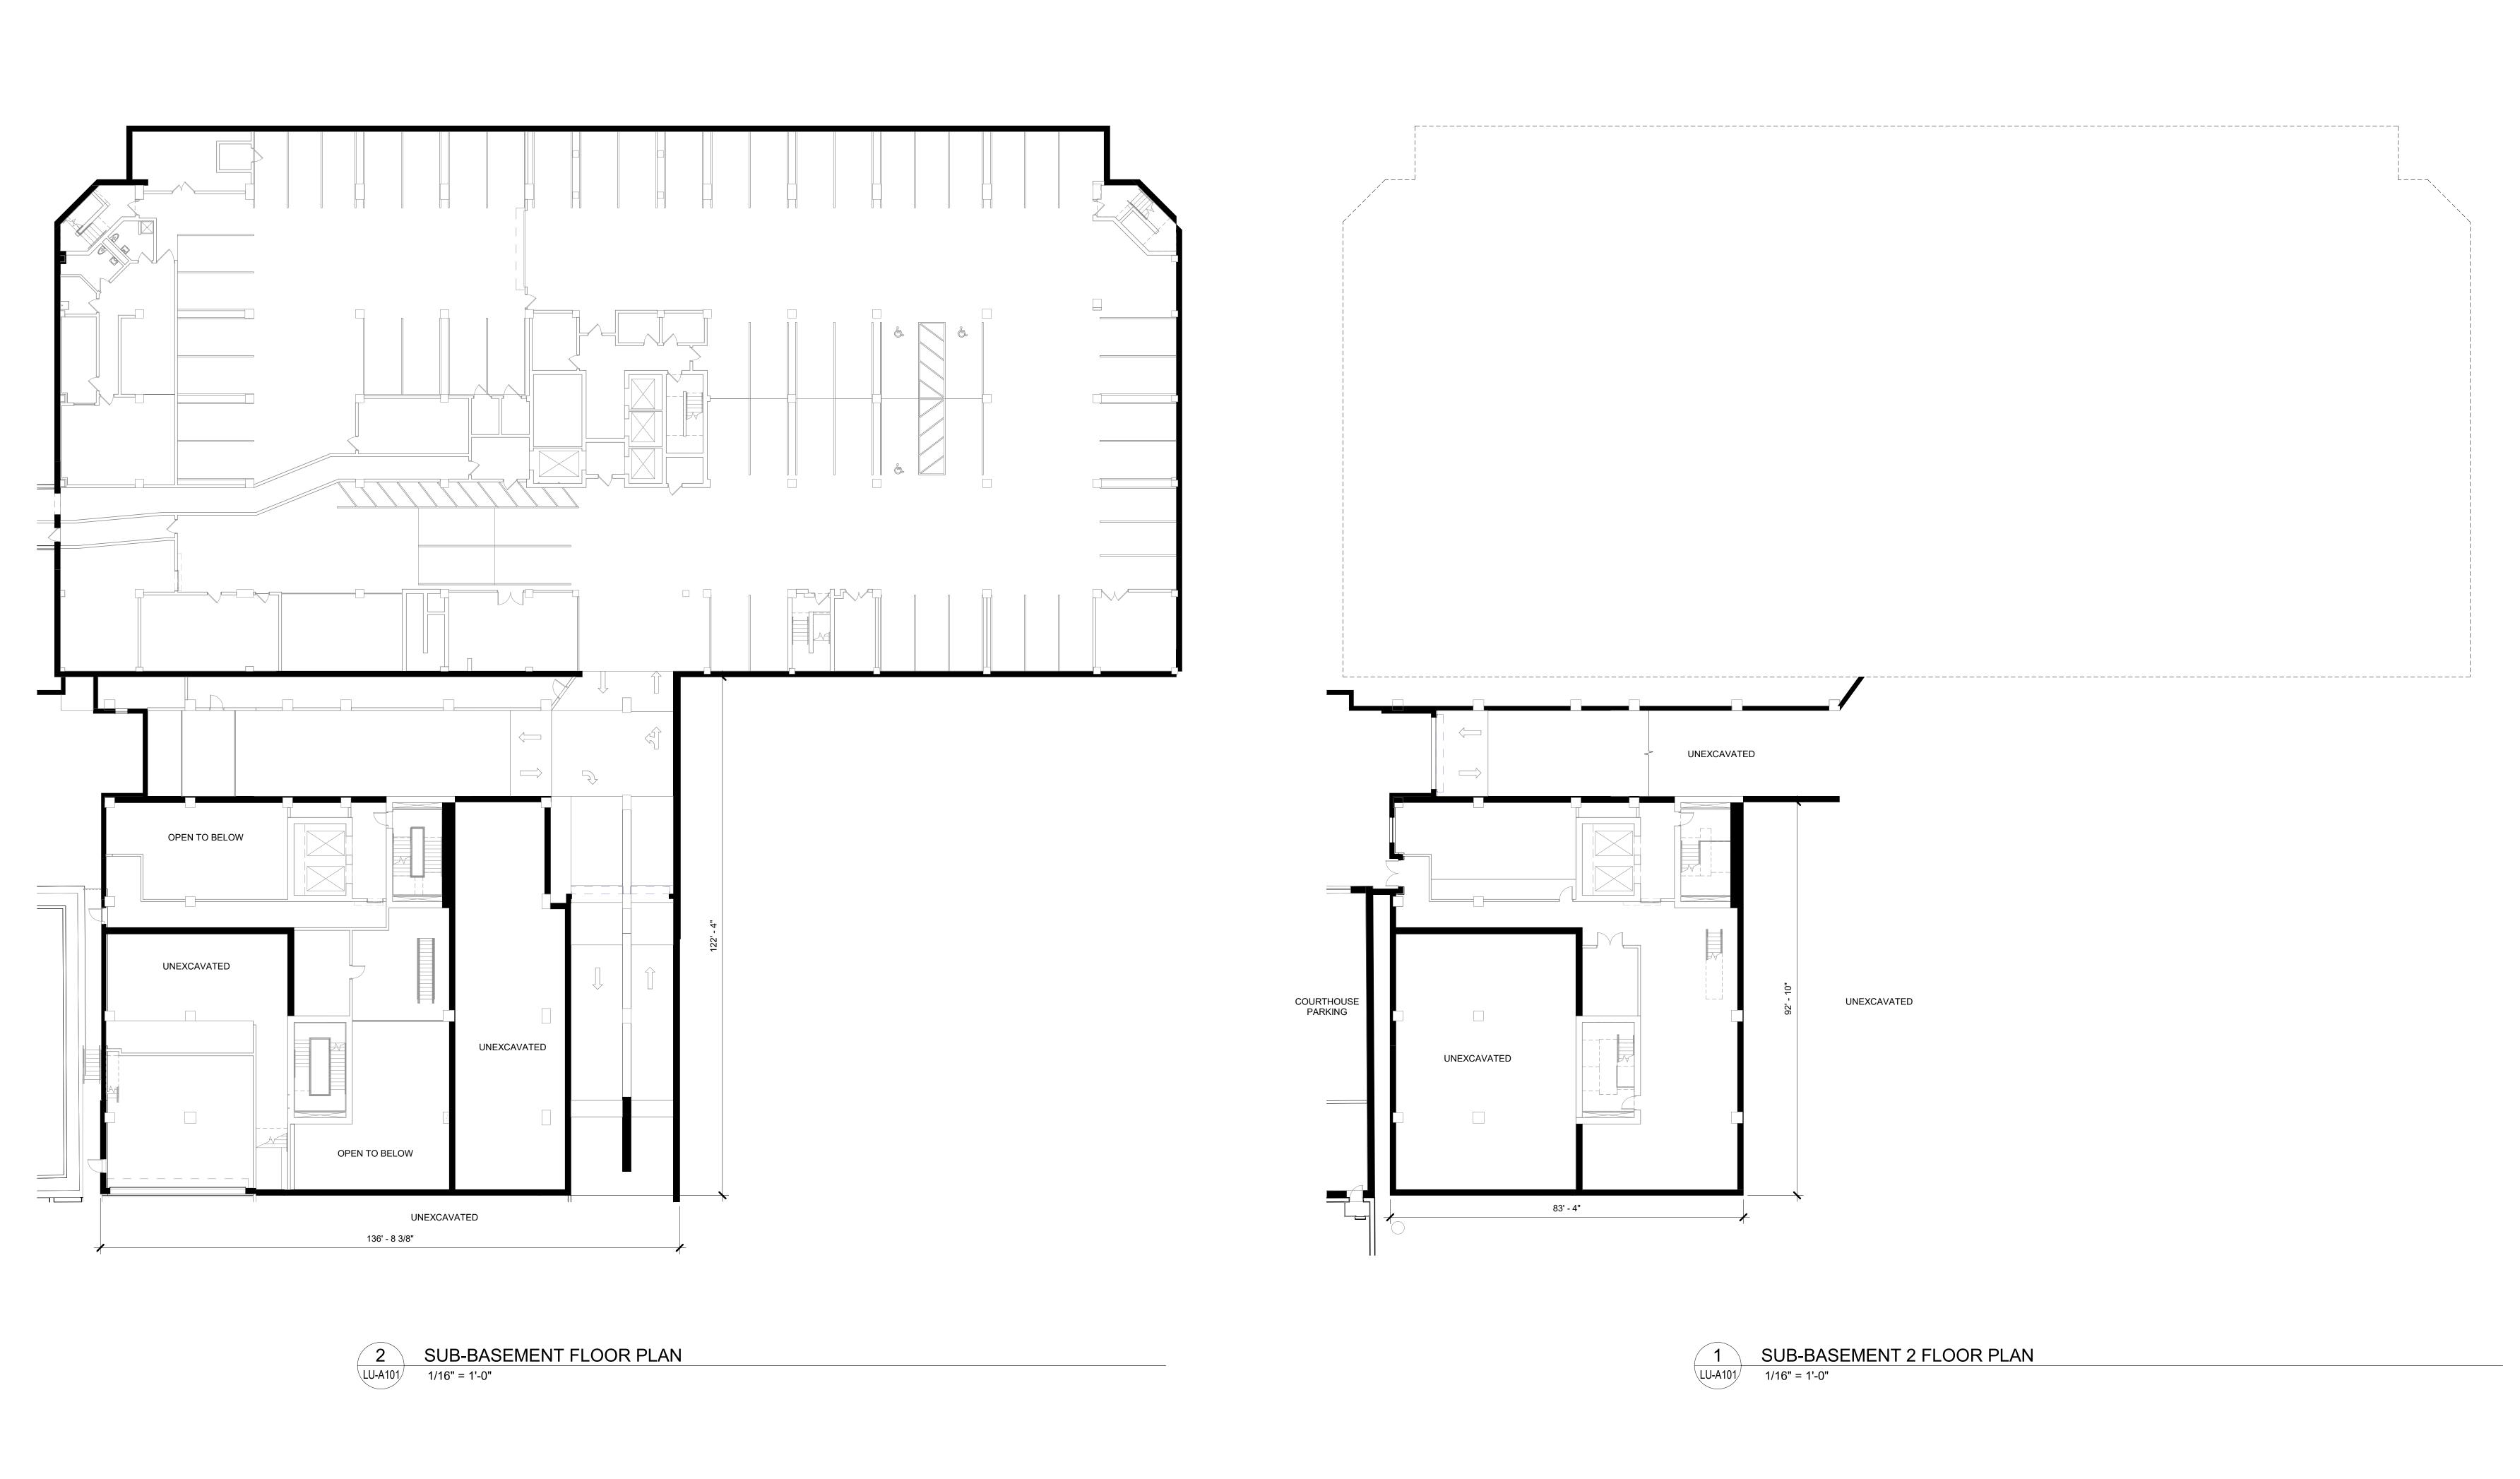

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CENTER WAY MADISON, WI 53713 PROJECT NO. 318025

ounty Jail Consolidation Tower Addition & Public S y Renovation Dane Co South To Building 115 W. Doty S Madison, WI 5

10/31/2022 LAND USE APPLICATION

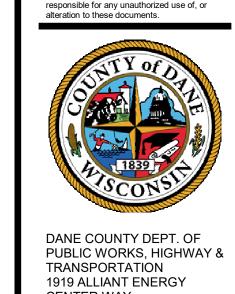NOT FOR CONSTRUCTION


0' 8' 16' 32'

KEY PLAN

PROJECT NORTH

M&H NO.: 4215400-161957.01 DATE: 10/31/2022 DESIGNED BY: Designer
DRAWN BY: Author

CHECKED BY: Checker DO NOT SCALE DRAWINGS
SHEET CONTENTS
FLOOR PLANS

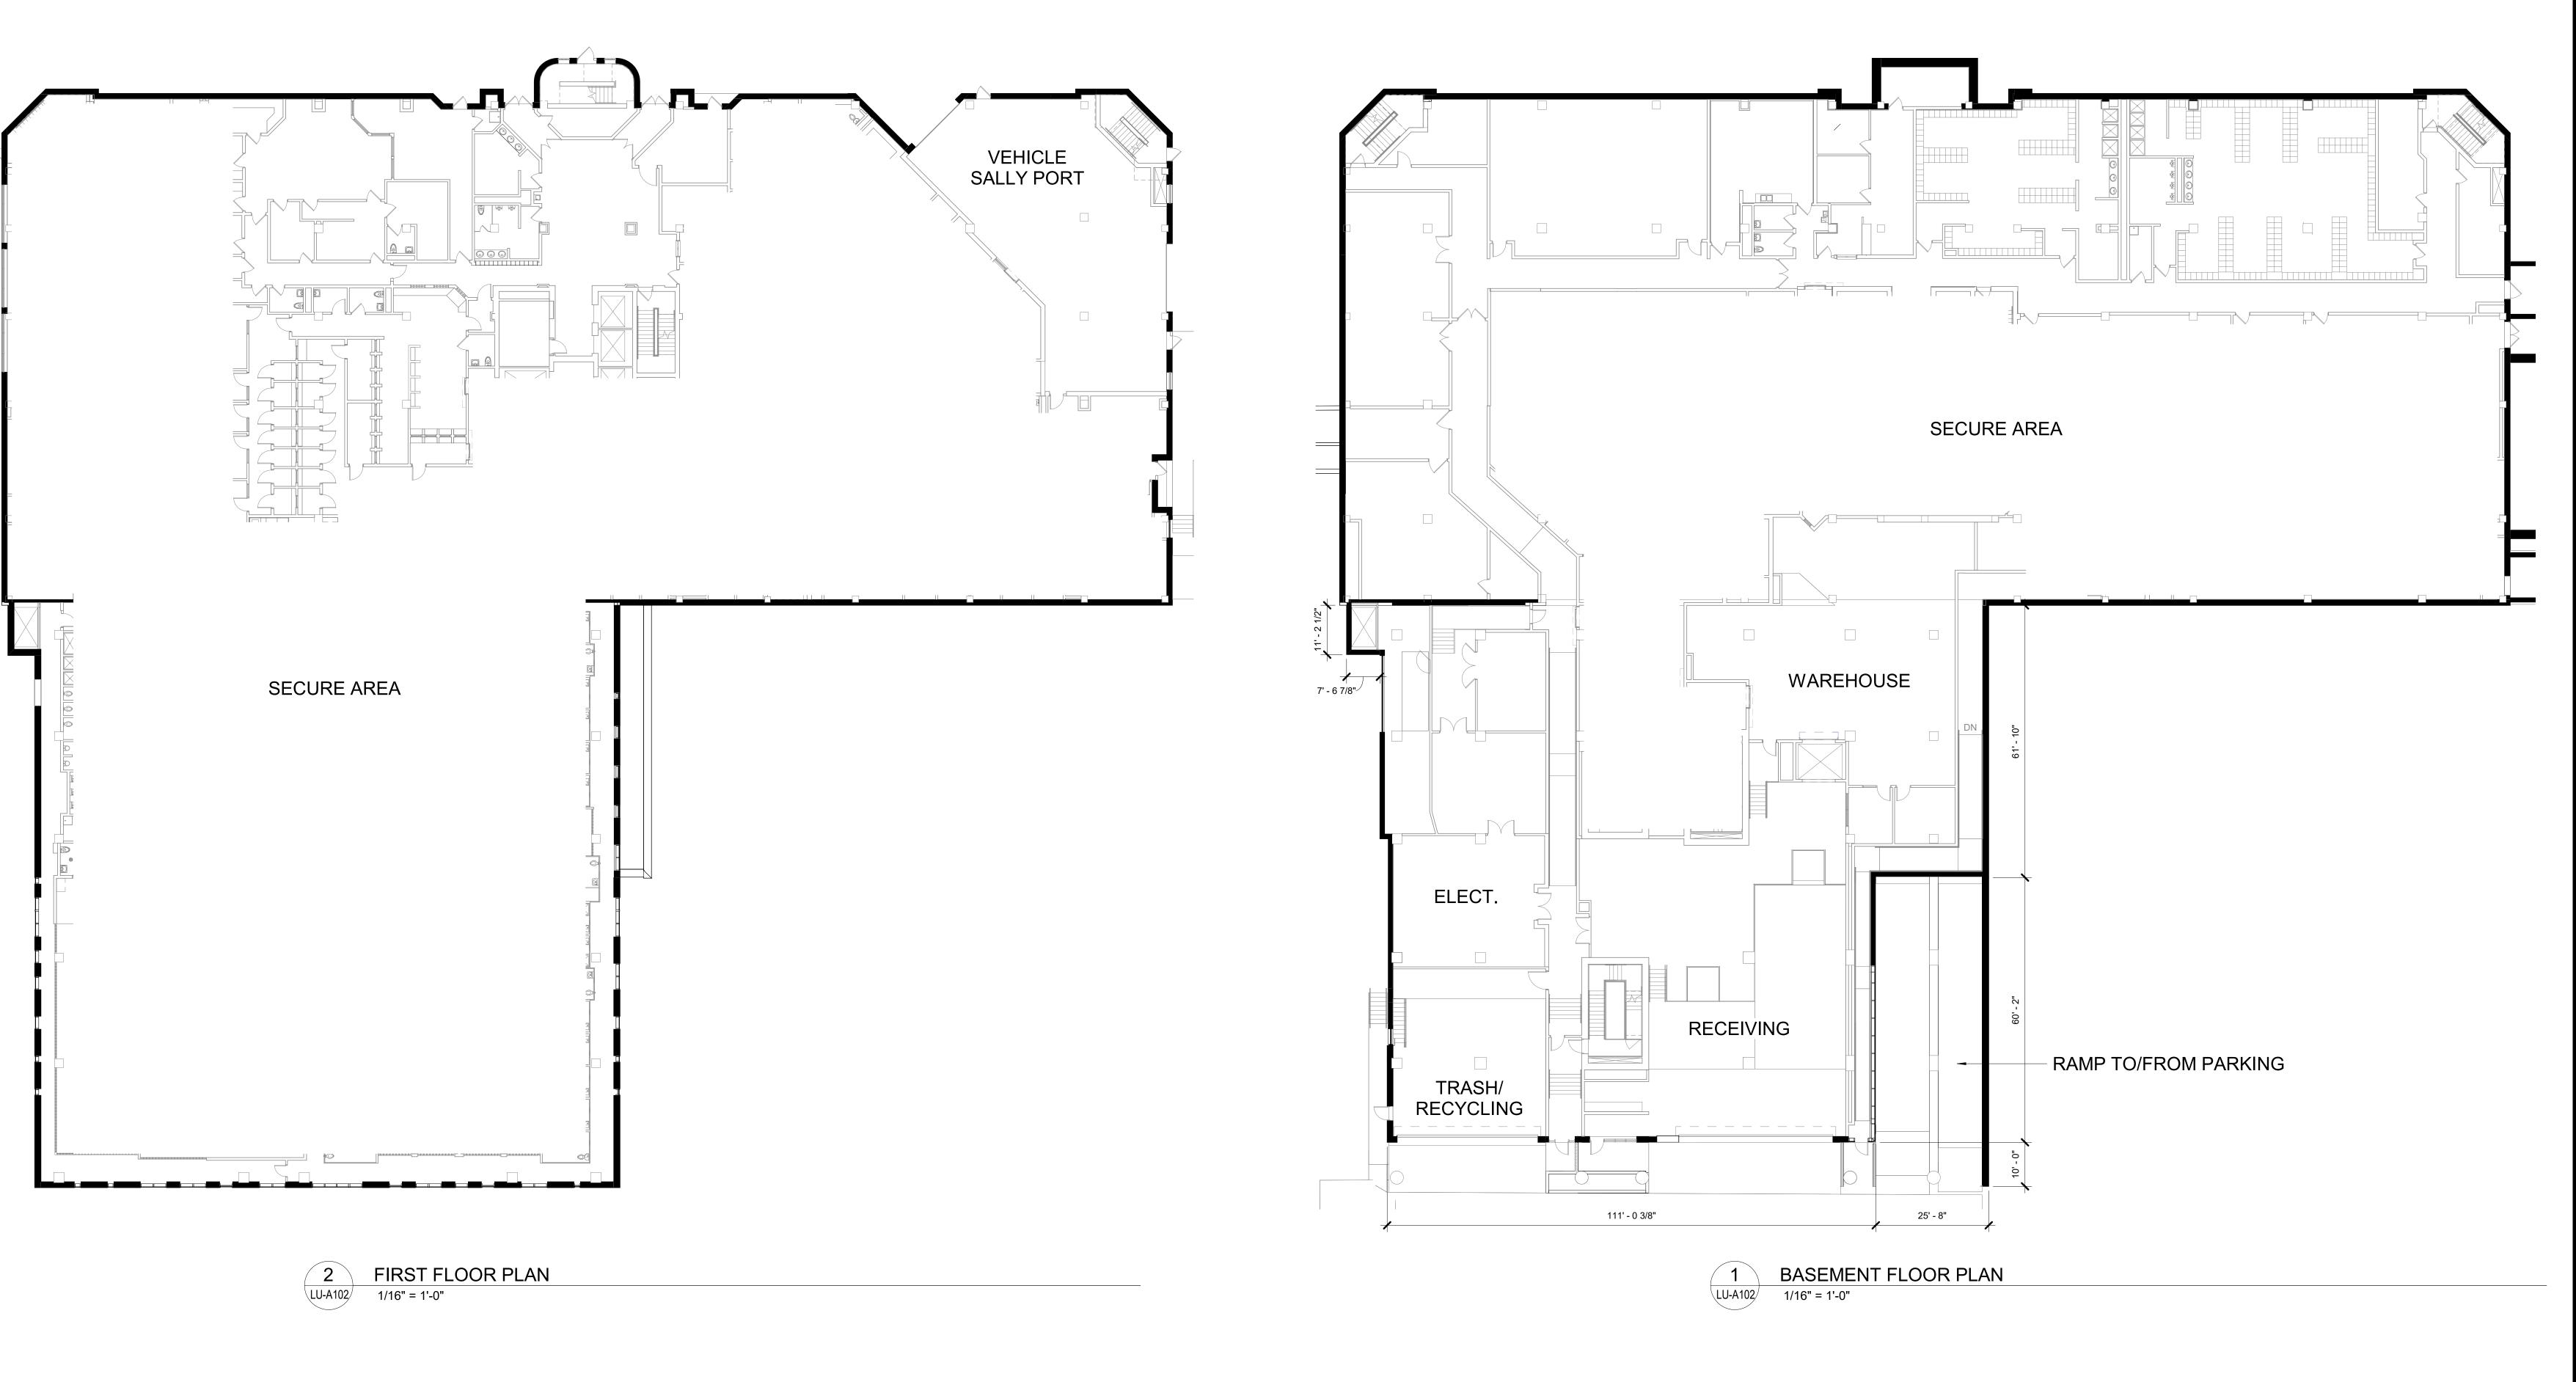

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CENTER WAY MADISON, WI 53713

PROJECT NO. 318025

ounty Jail Consolidation Tower Addition & Public S Renovation

10/31/2022 LAND USE APPLICATION


NOT FOR CONSTRUCTION

0' 8' 16' 32'

PROJECT NORTH

M&H NO.: 4215400-161957.01 DATE: 10/31/2022 DESIGNED BY: Designer
DRAWN BY: Author CHECKED BY: Checker

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SHEET CONTENTS
FLOOR PLANS

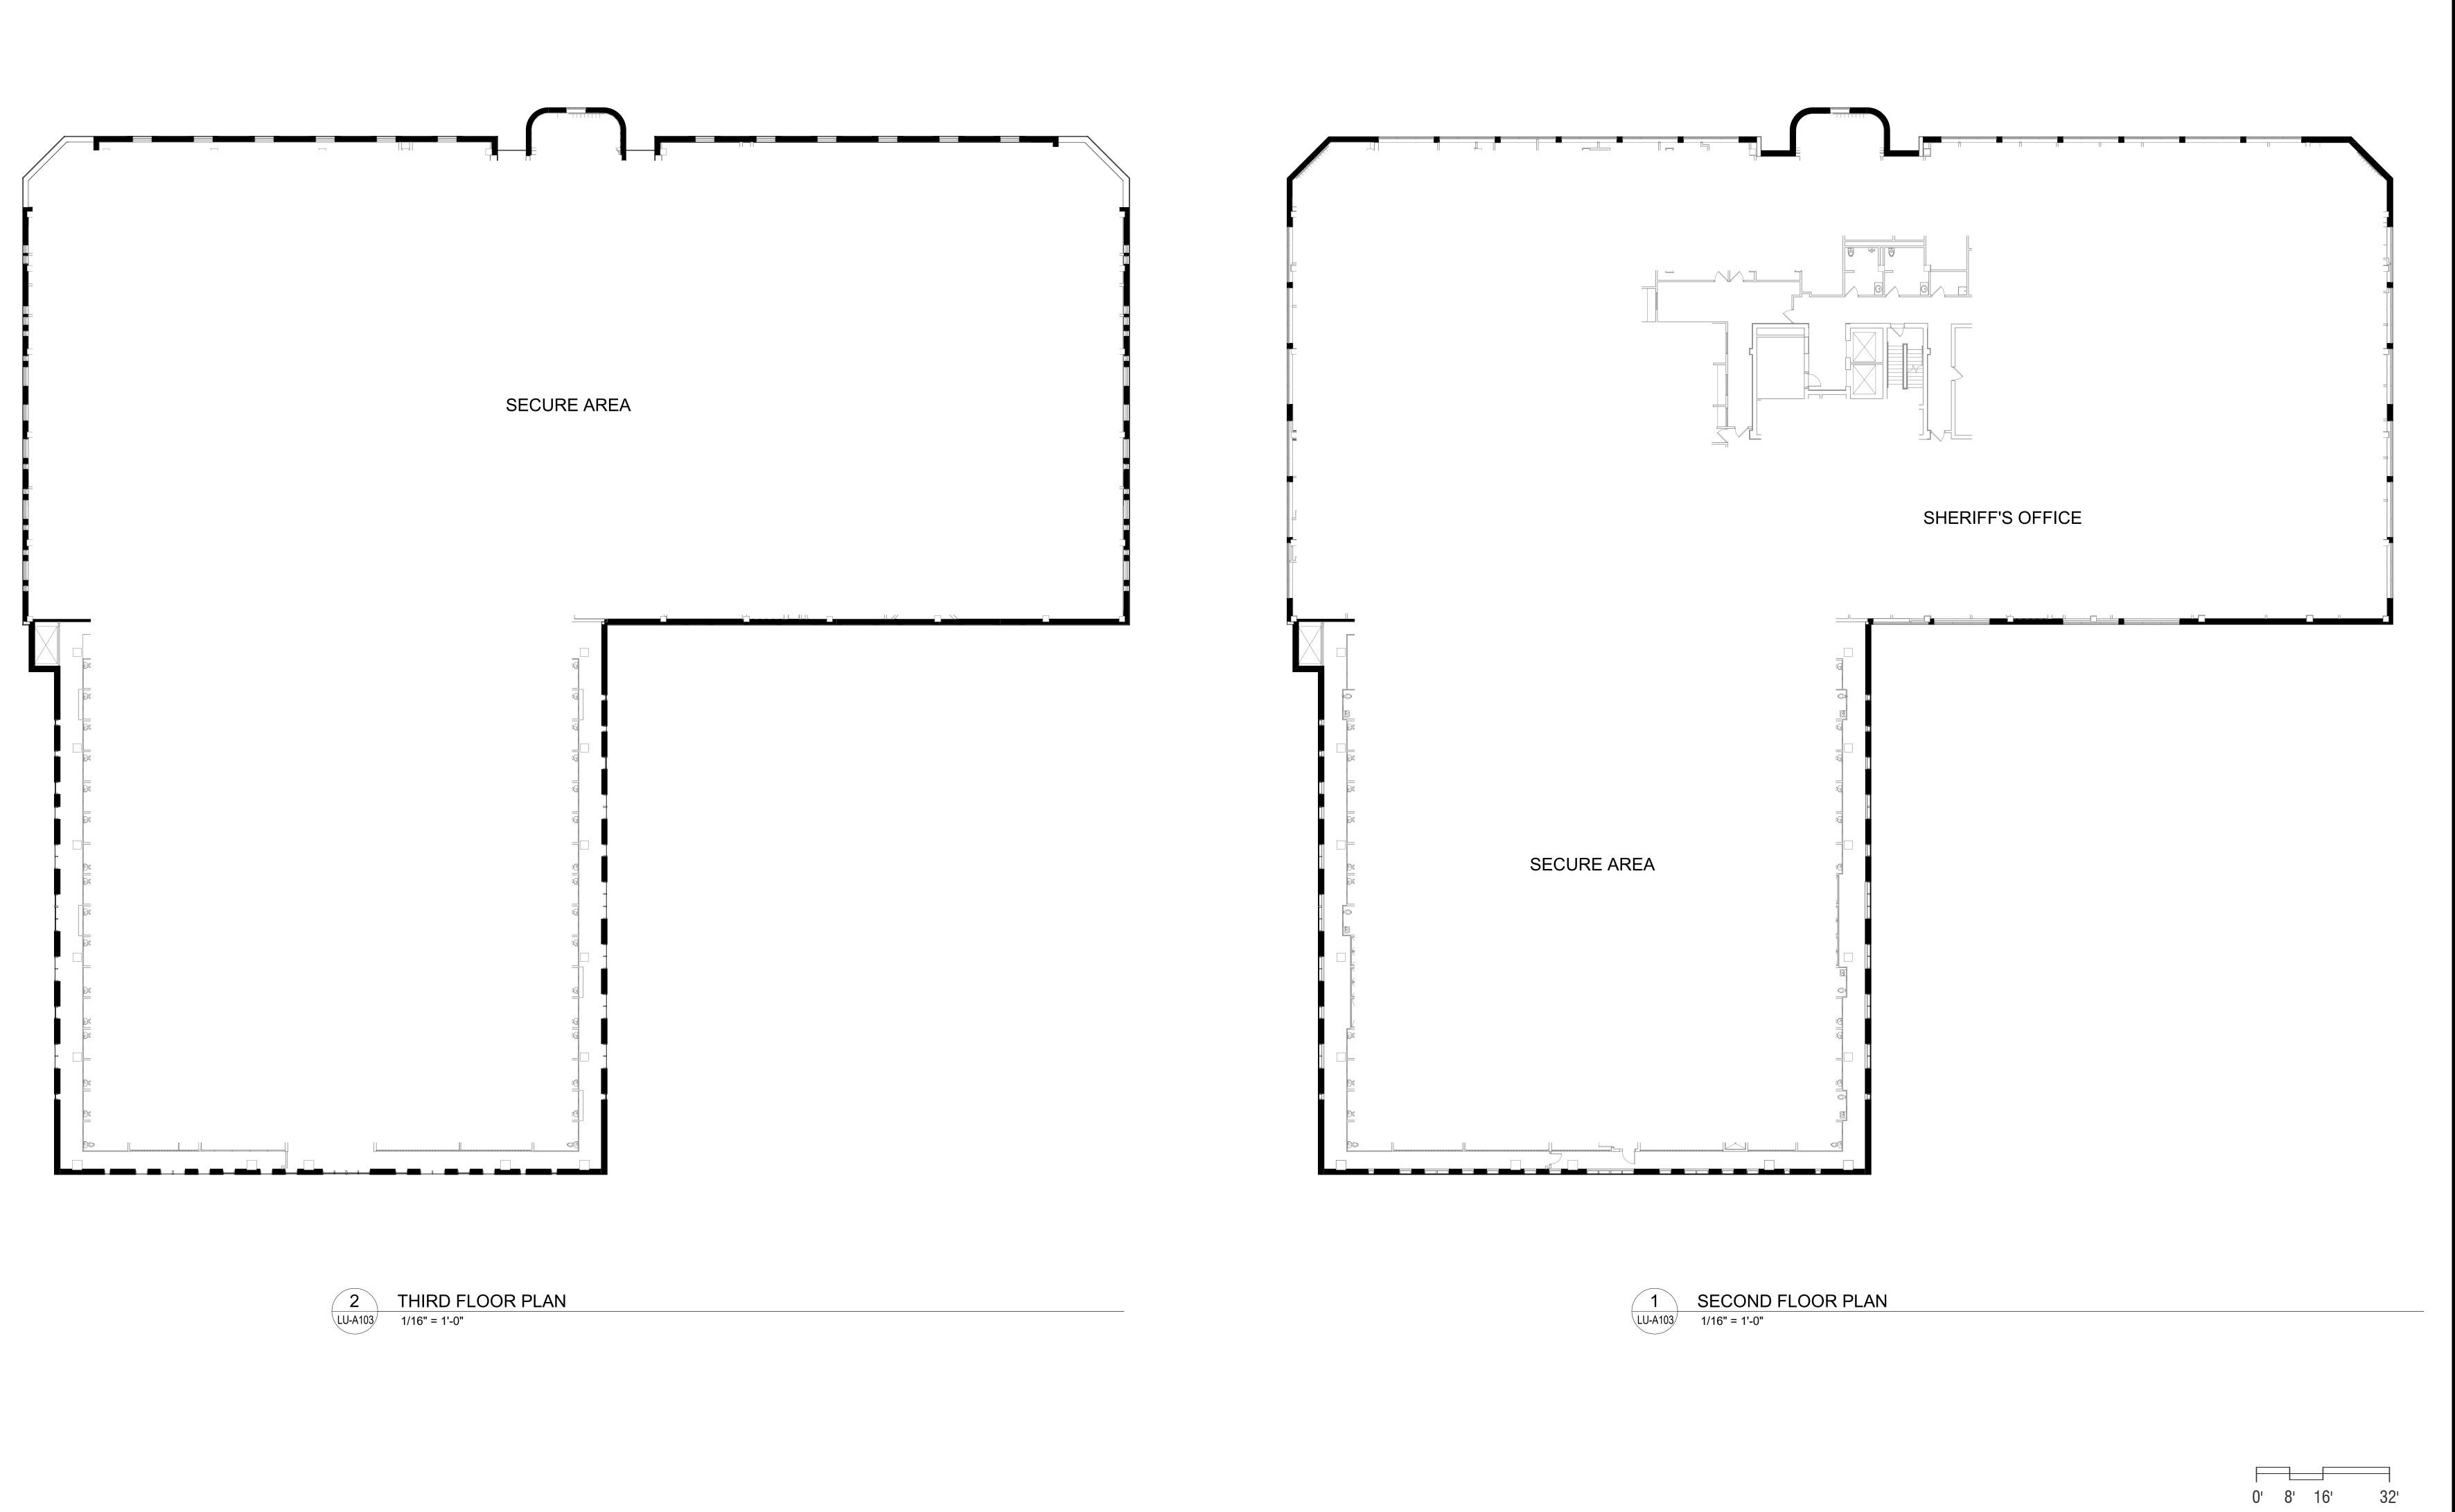

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DANE COUNTY DEPT. OF PUBLIC WORKS, HIGHWAY & TRANSPORTATION 1919 ALLIANT ENERGY CENTER WAY MADISON, WI 53713

PROJECT NO. 318025


10/31/2022 LAND USE APPLICATION

NOT FOR CONSTRUCTION

M&H NO.: 4215400-161957.01 DATE: 10/31/2022 DESIGNED BY: Designer
DRAWN BY: Author

CHECKED BY: Checker DO NOT SCALE DRAWINGS
SHEET CONTENTS
FLOOR PLANS

PROJECT NORTH

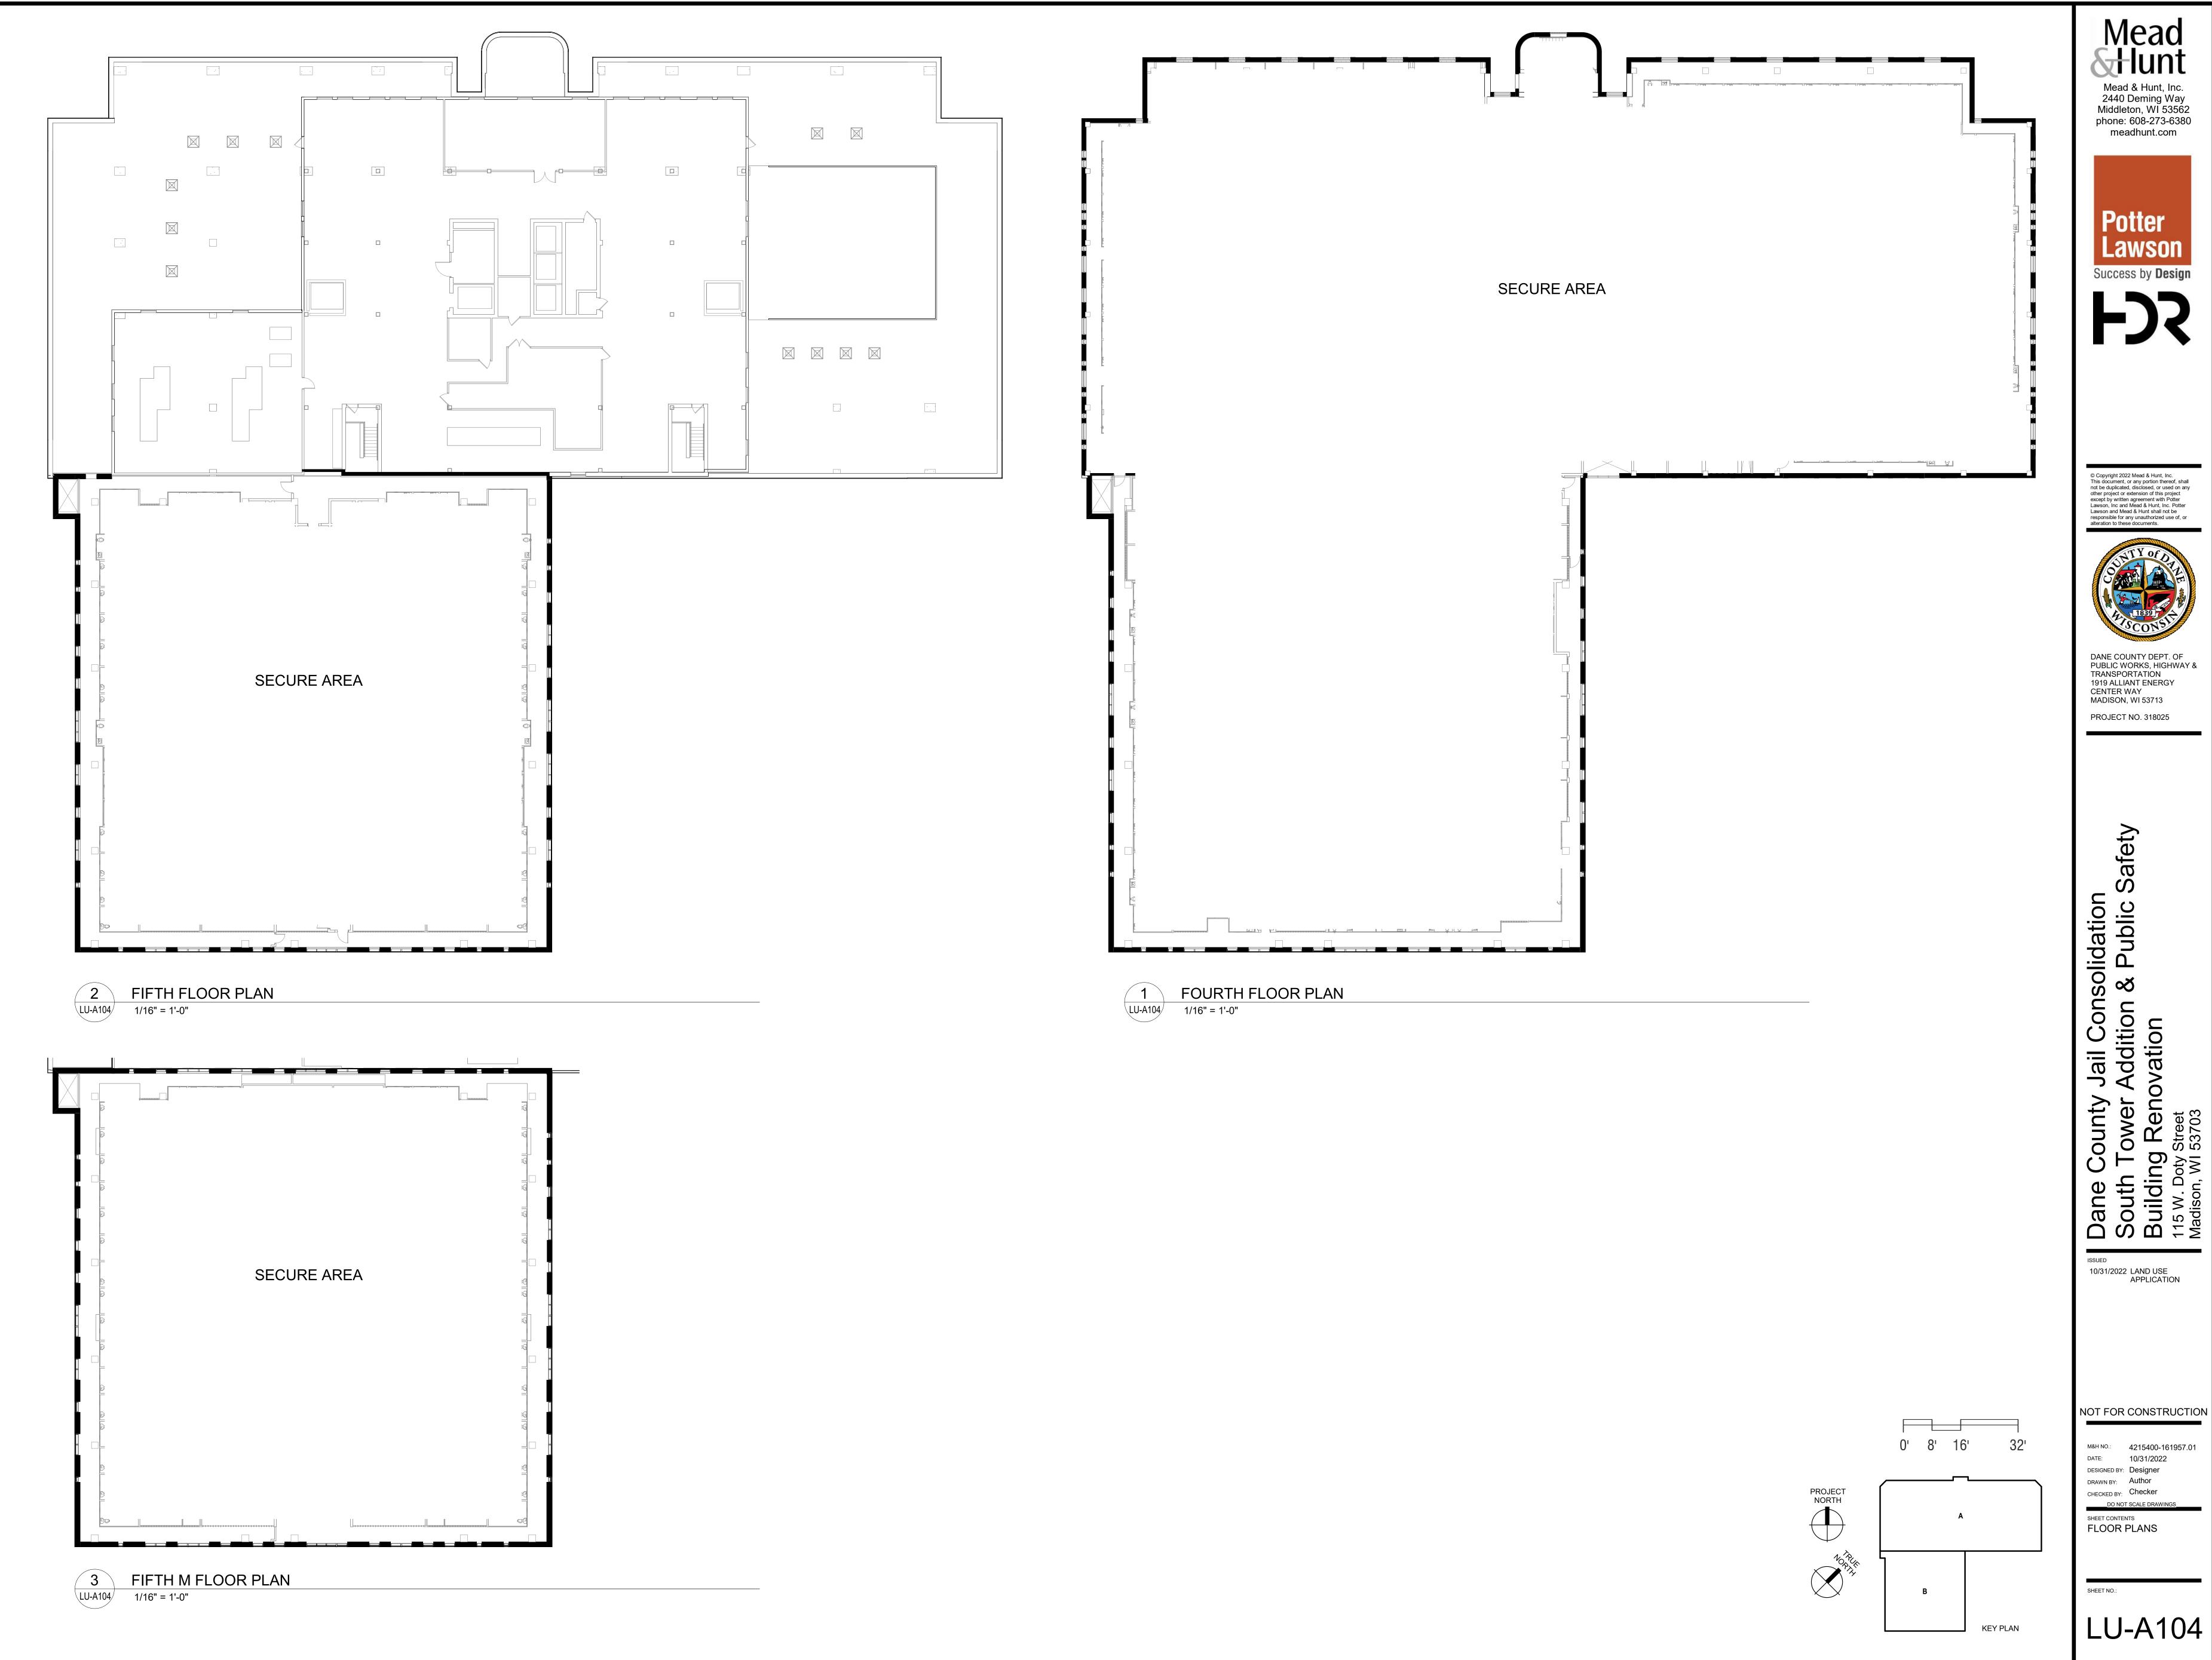

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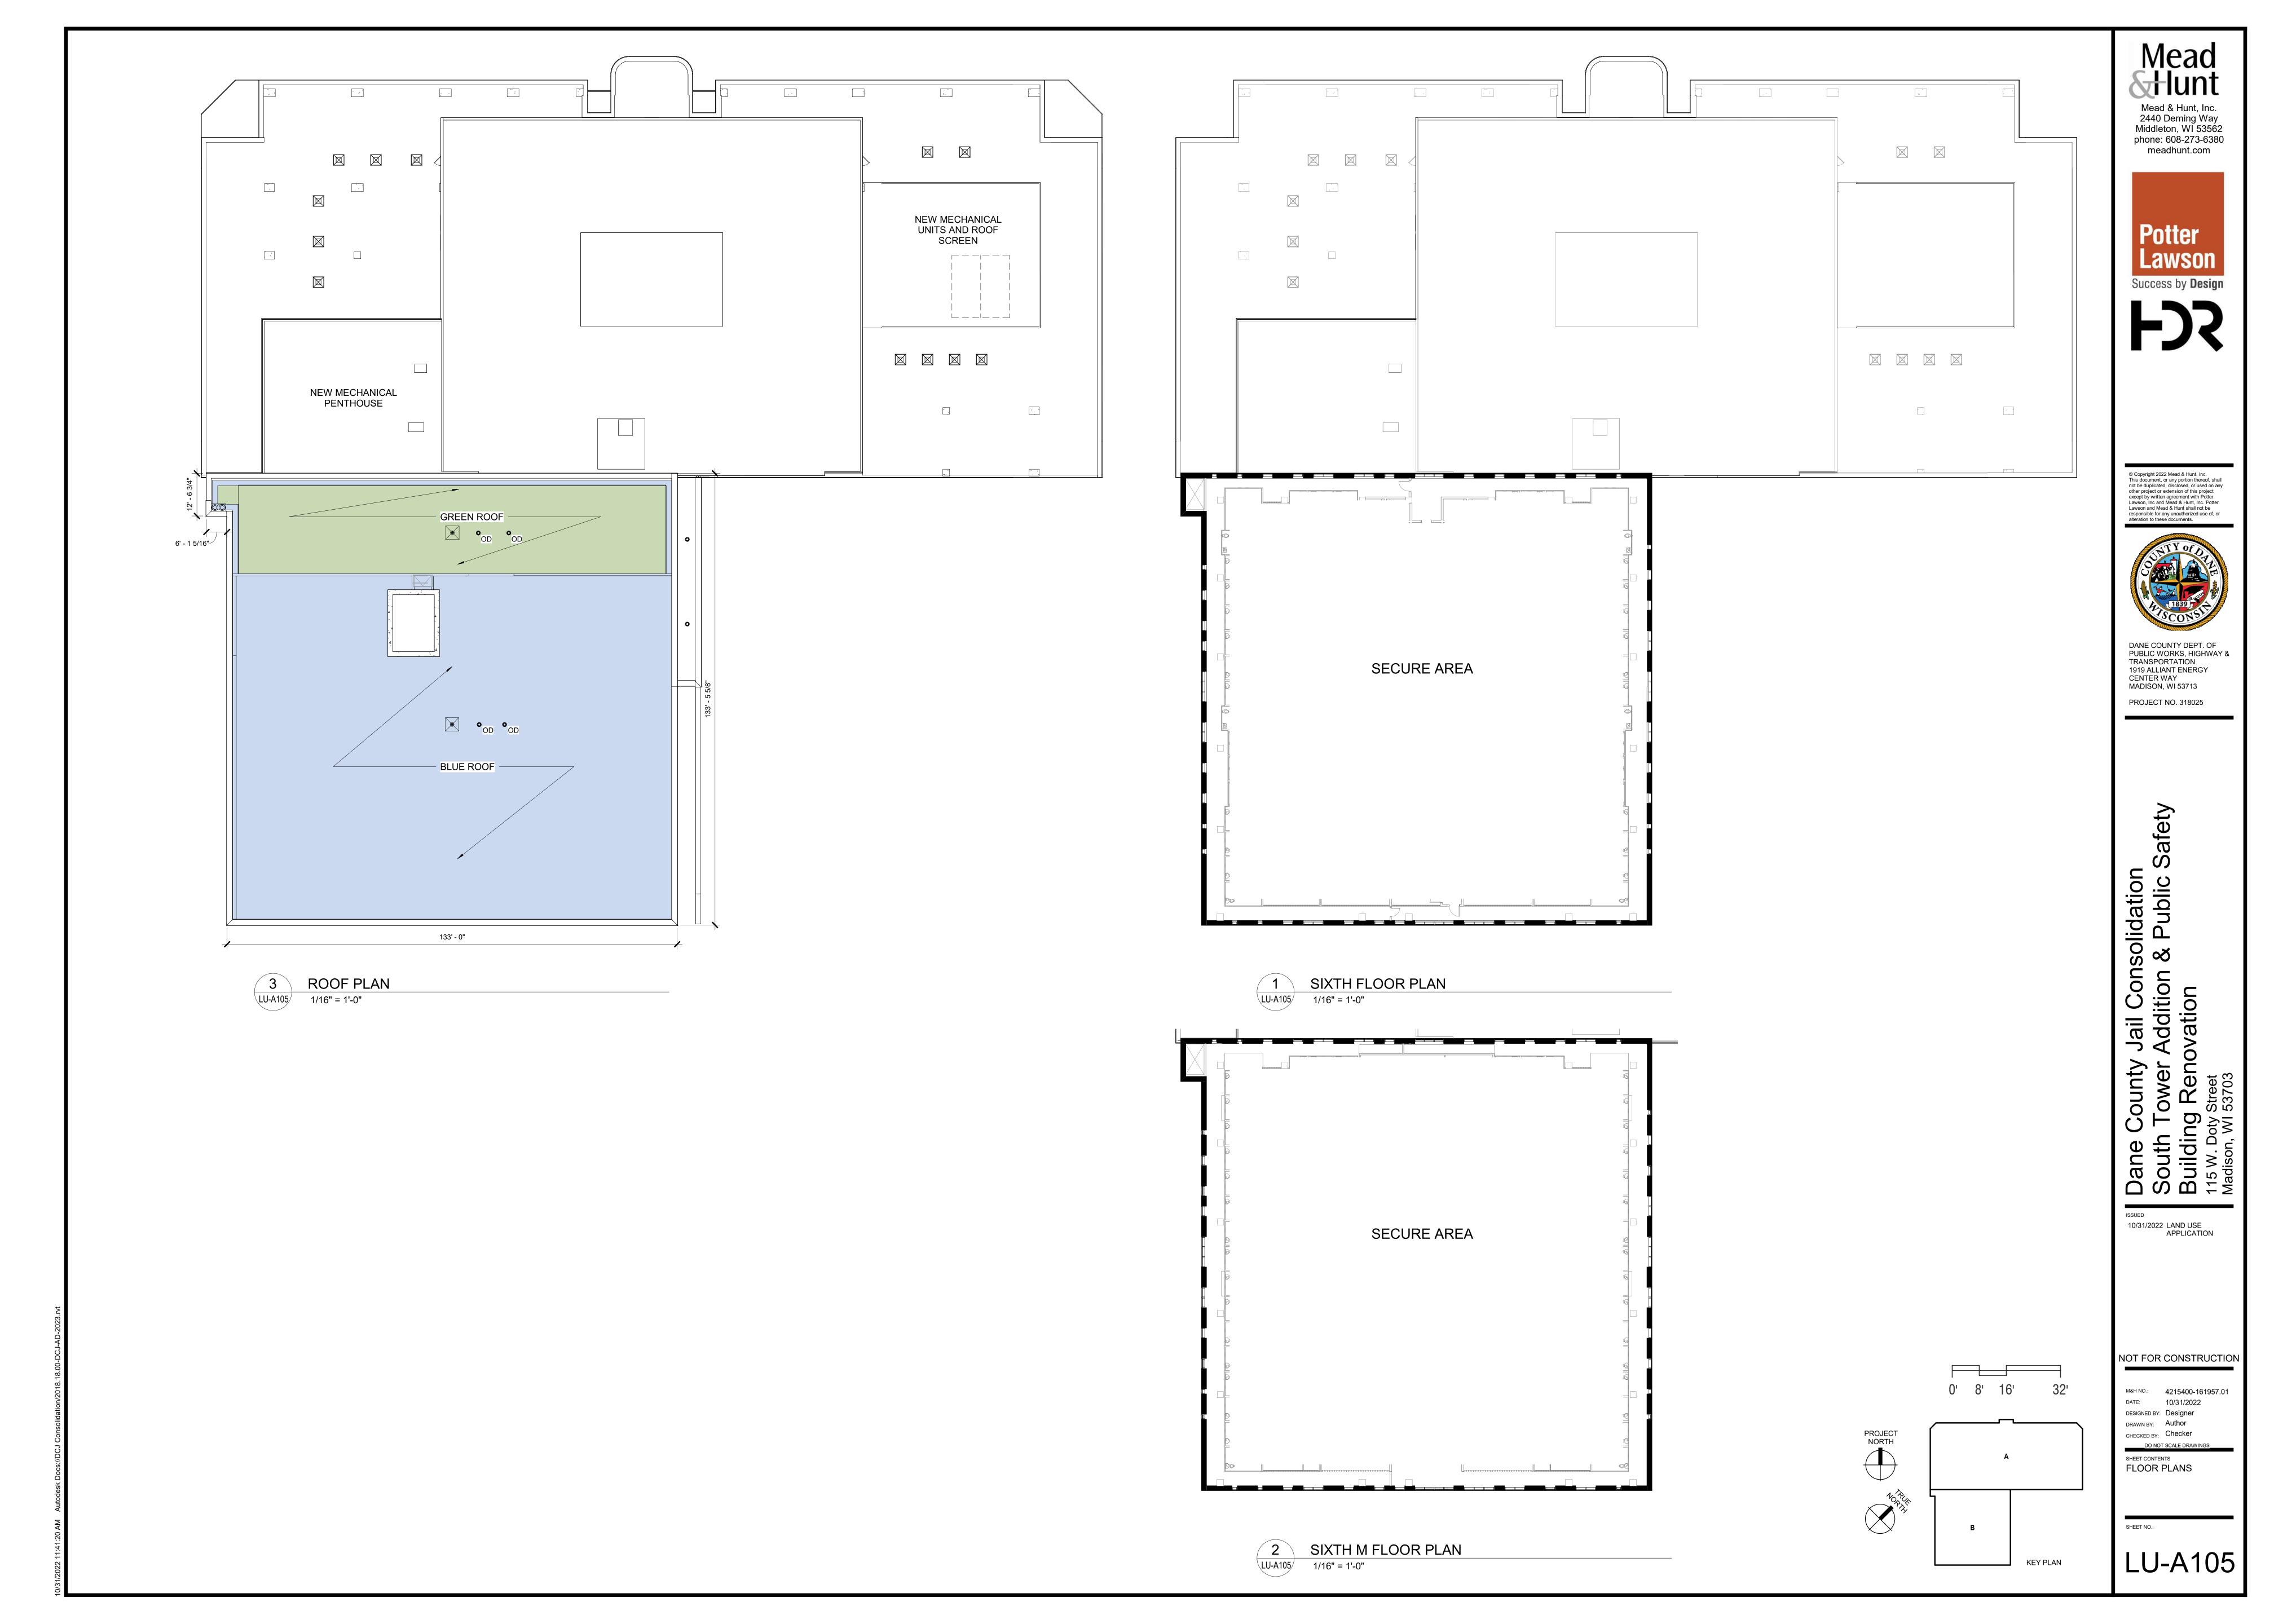
CENTER WAY MADISON, WI 53713


PROJECT NO. 318025

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M&H NO.: 4215400-161957.01 DATE: 10/31/2022 DESIGNED BY: Designer
DRAWN BY: Author

CHECKED BY: Checker






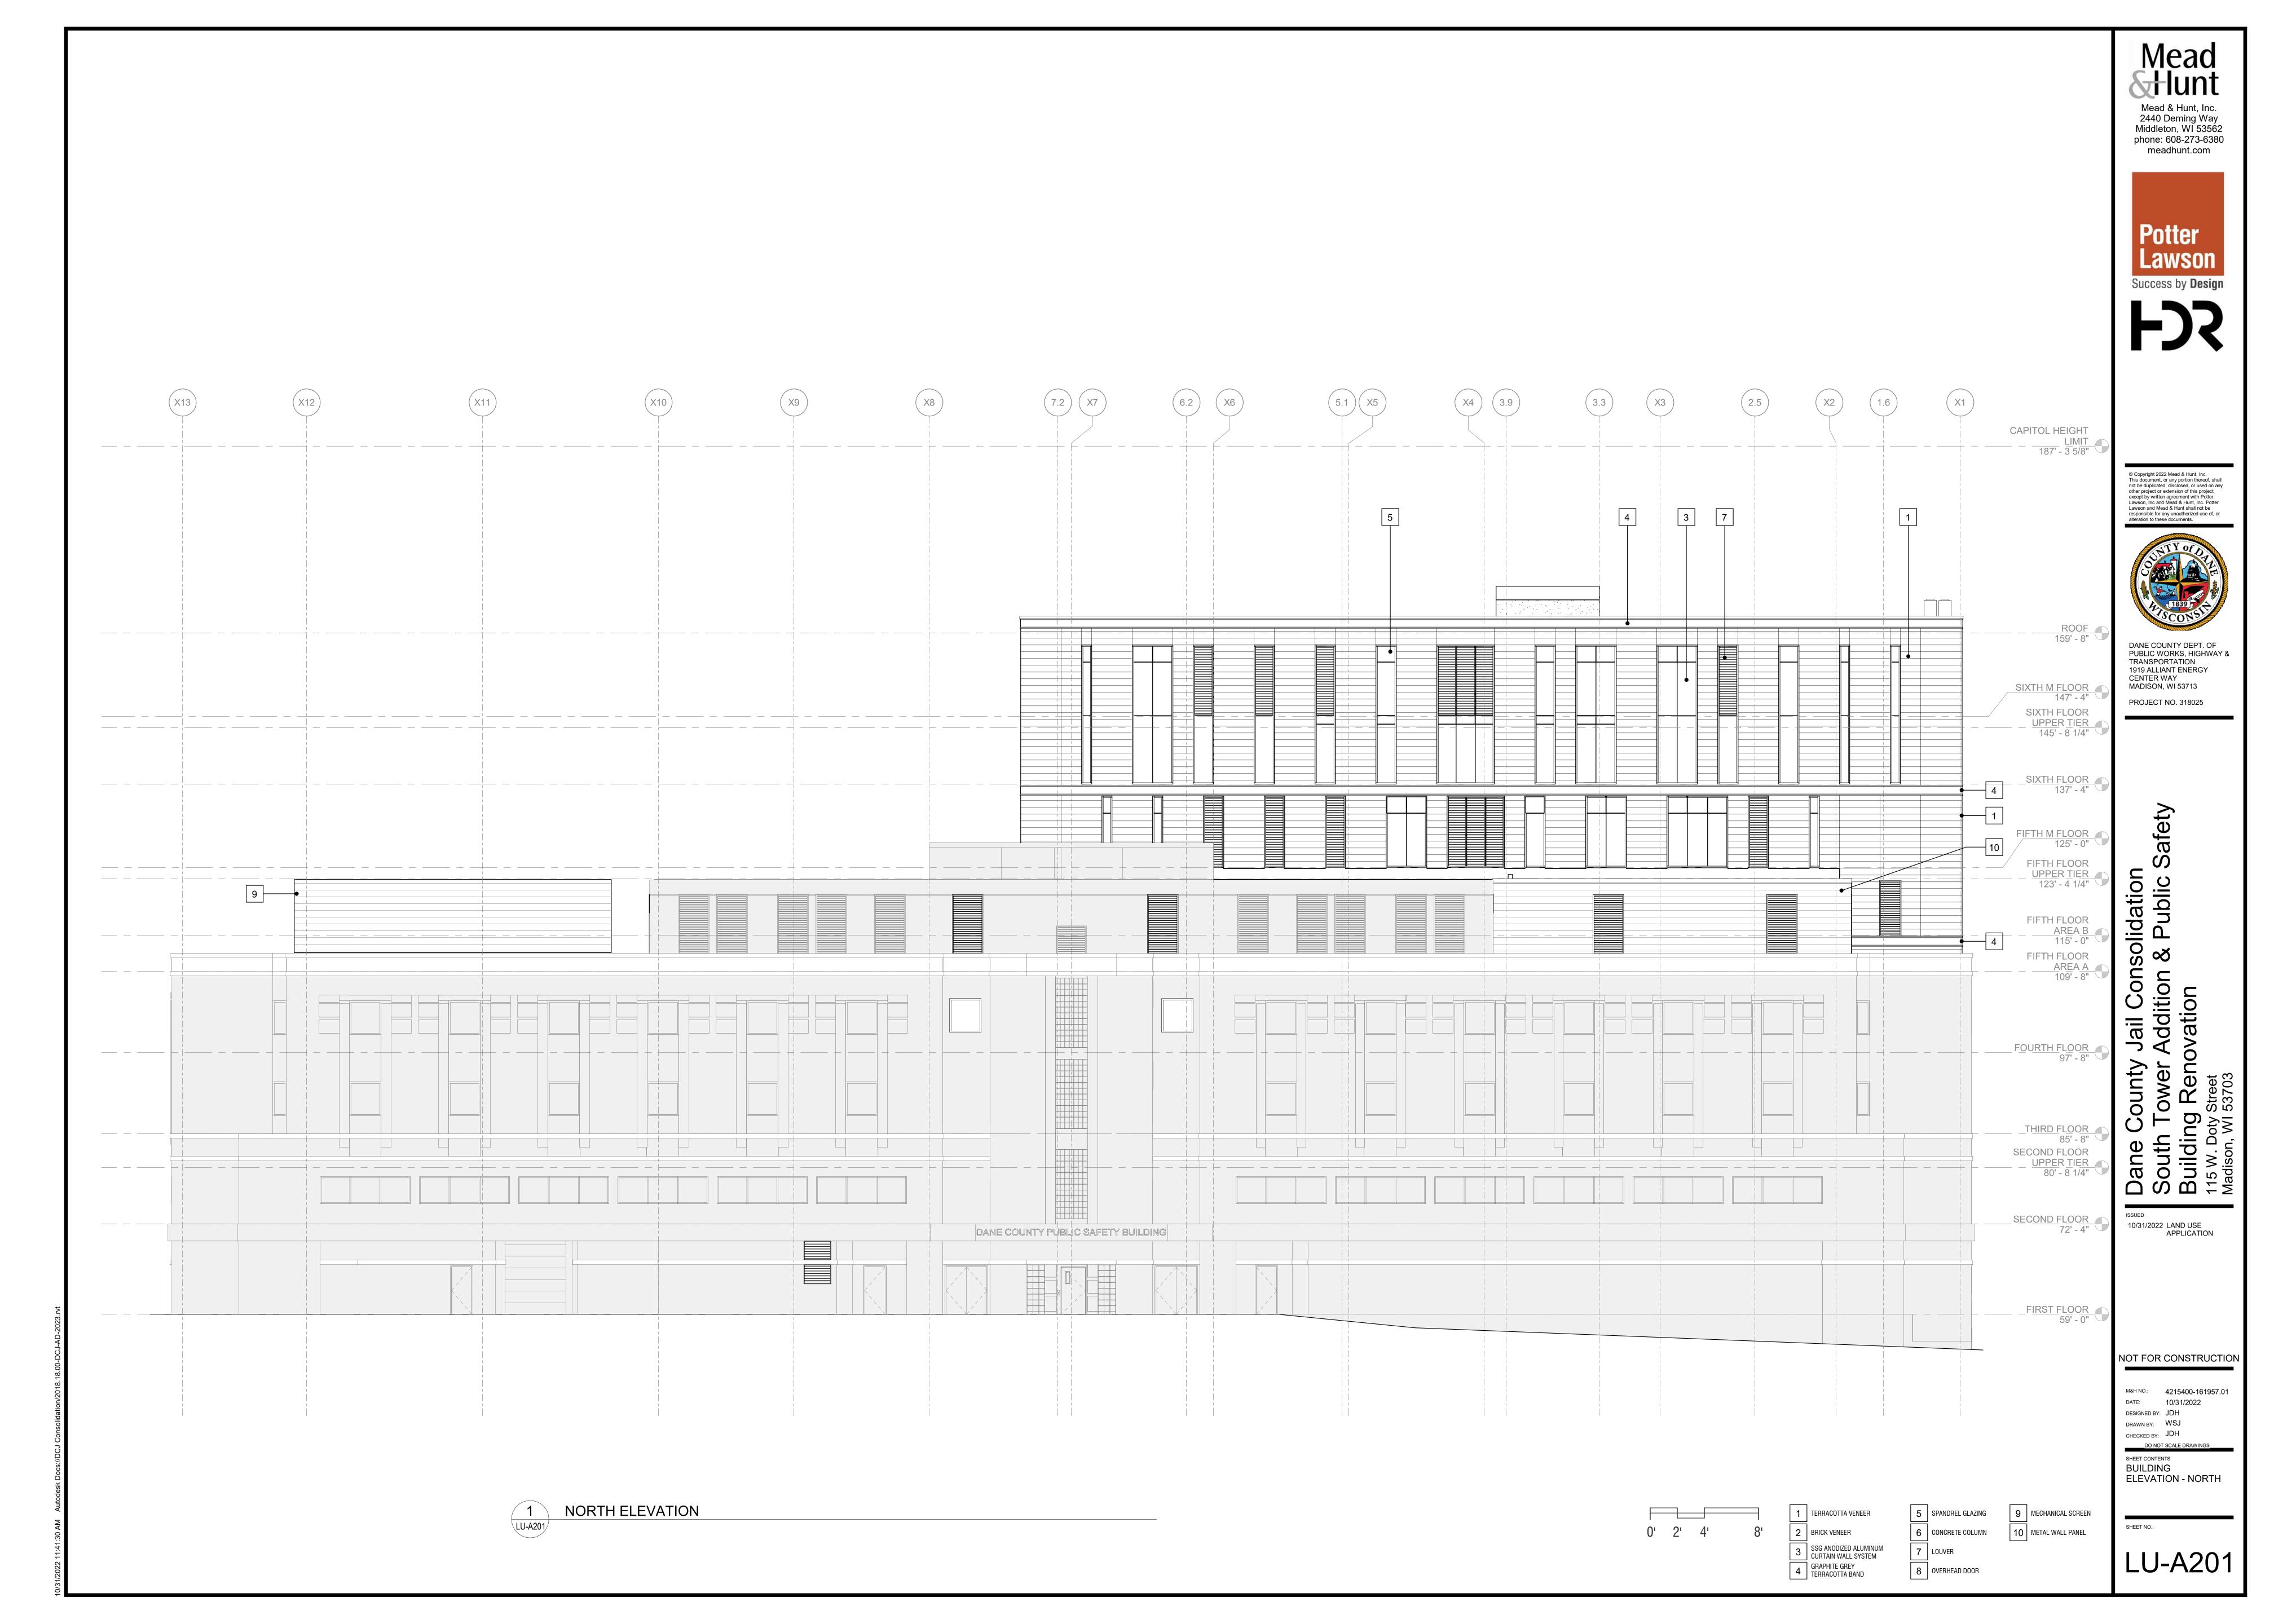








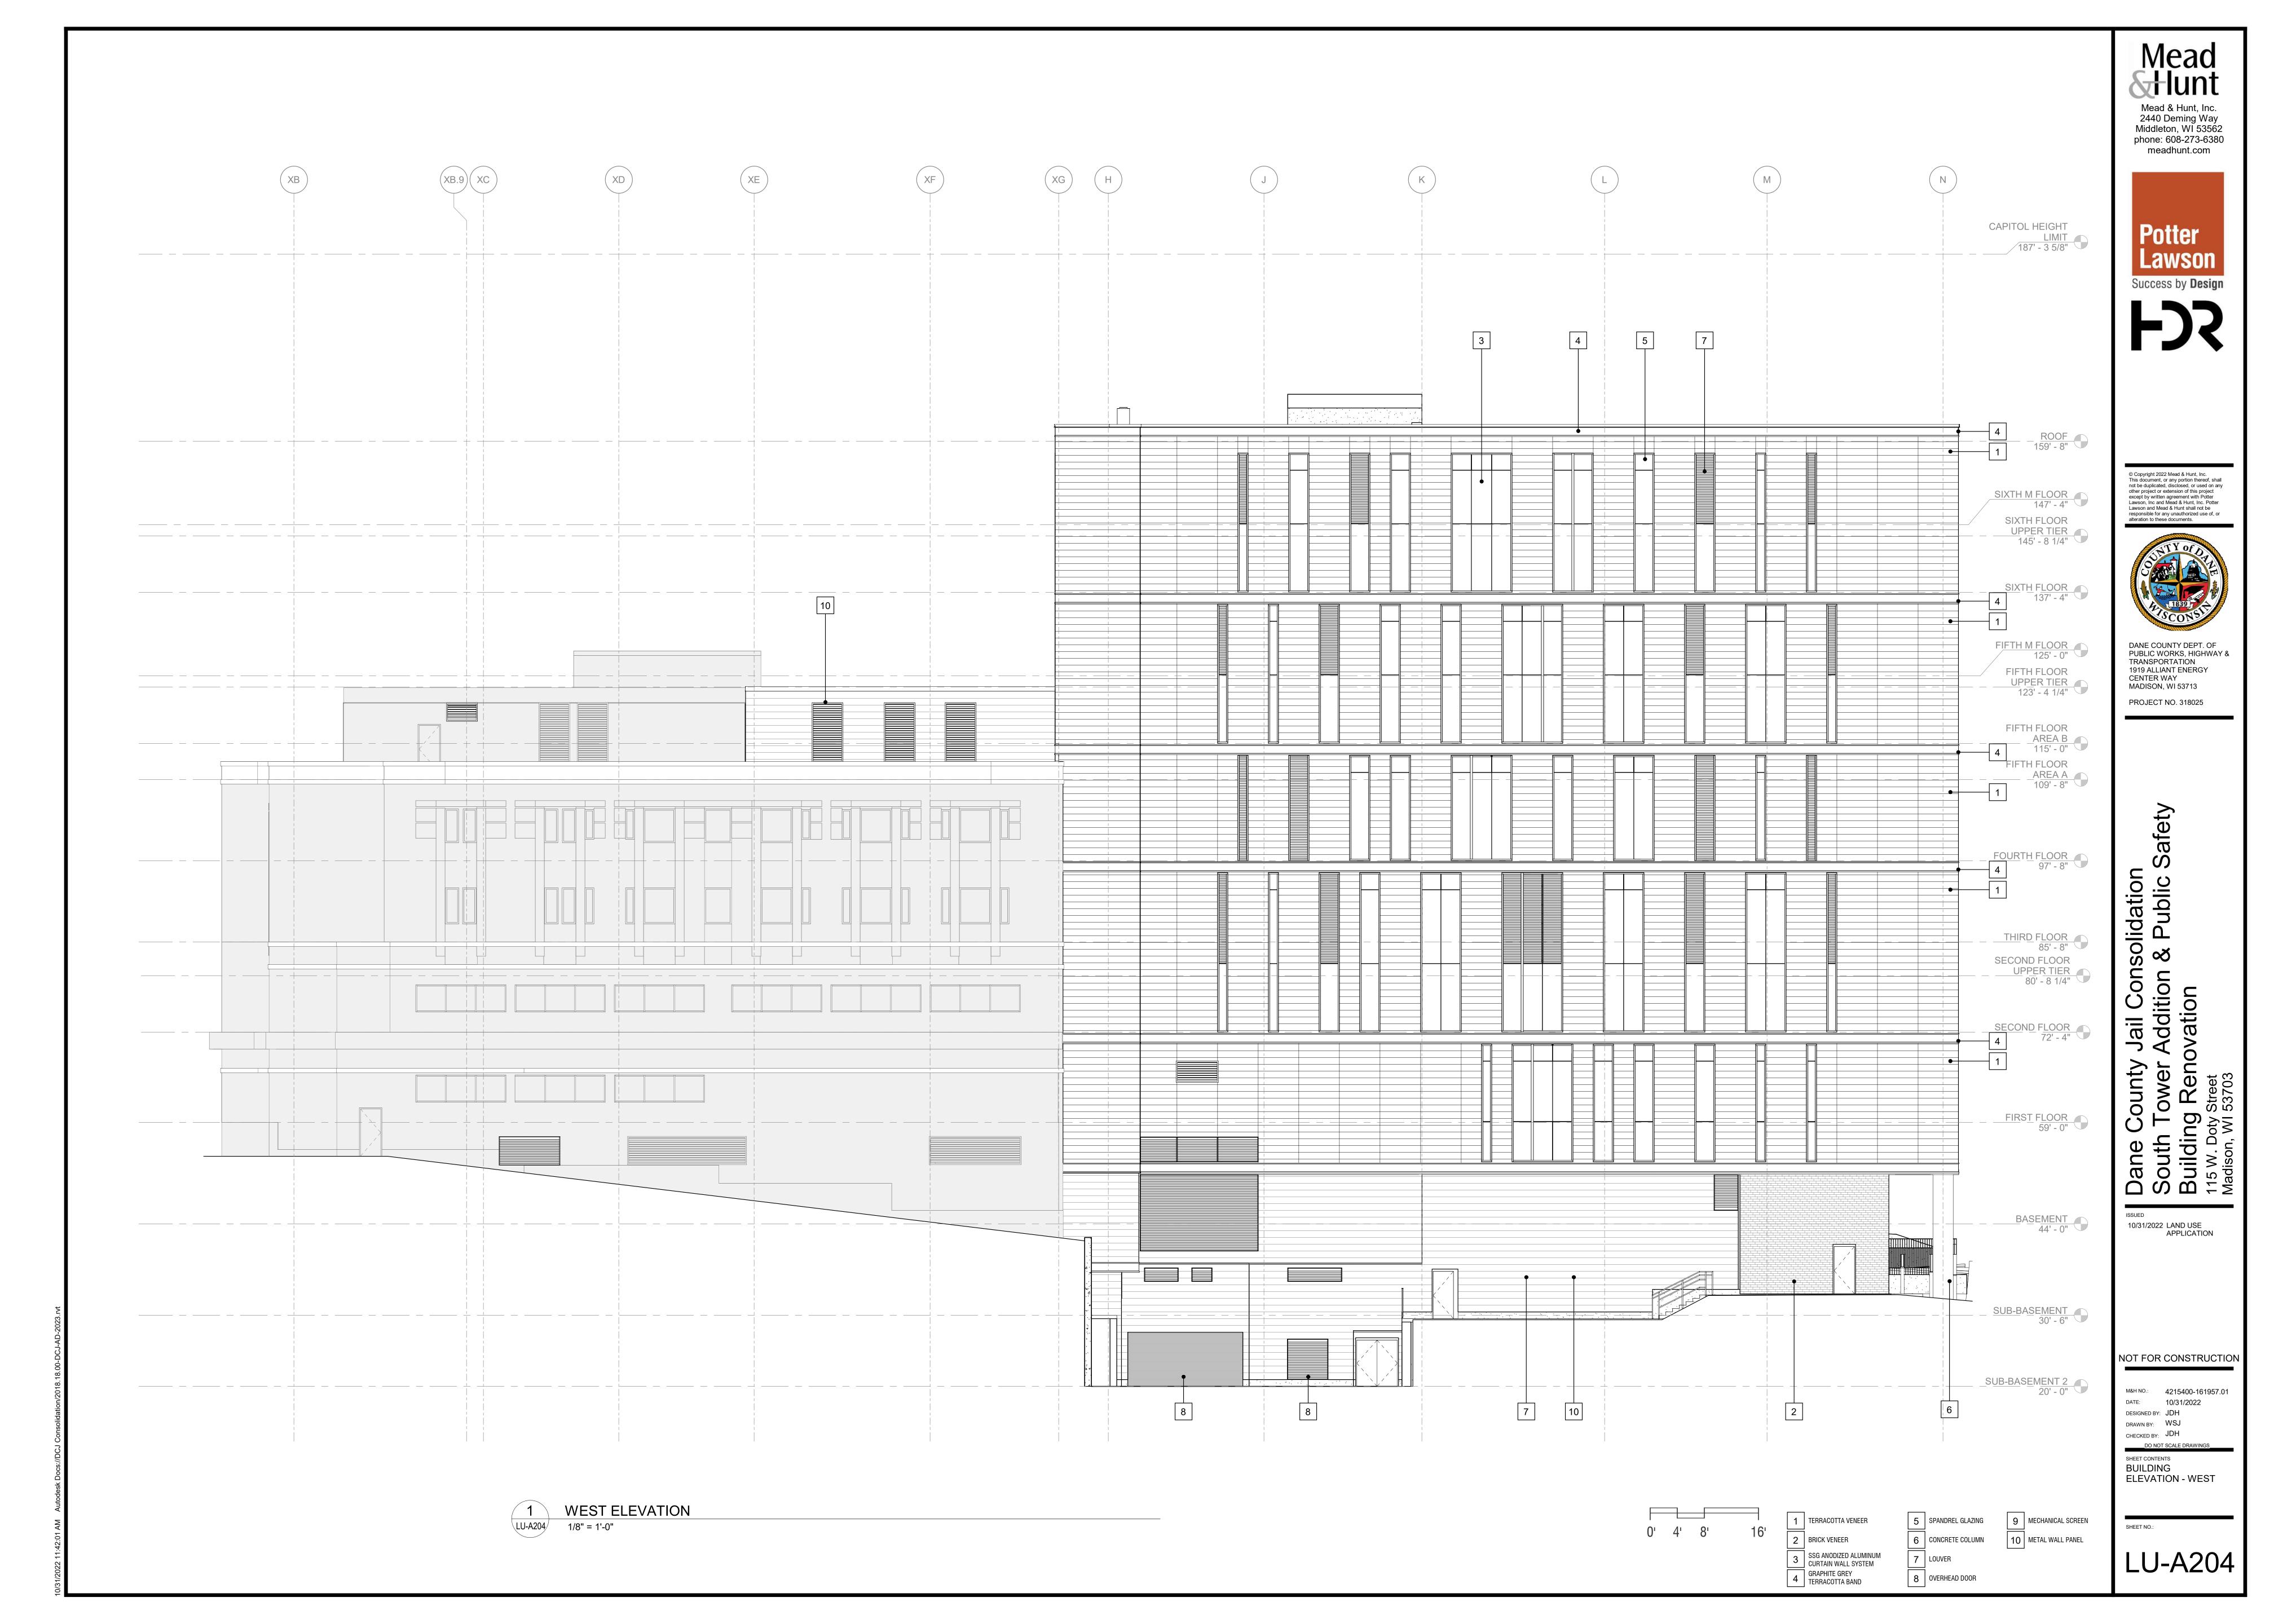





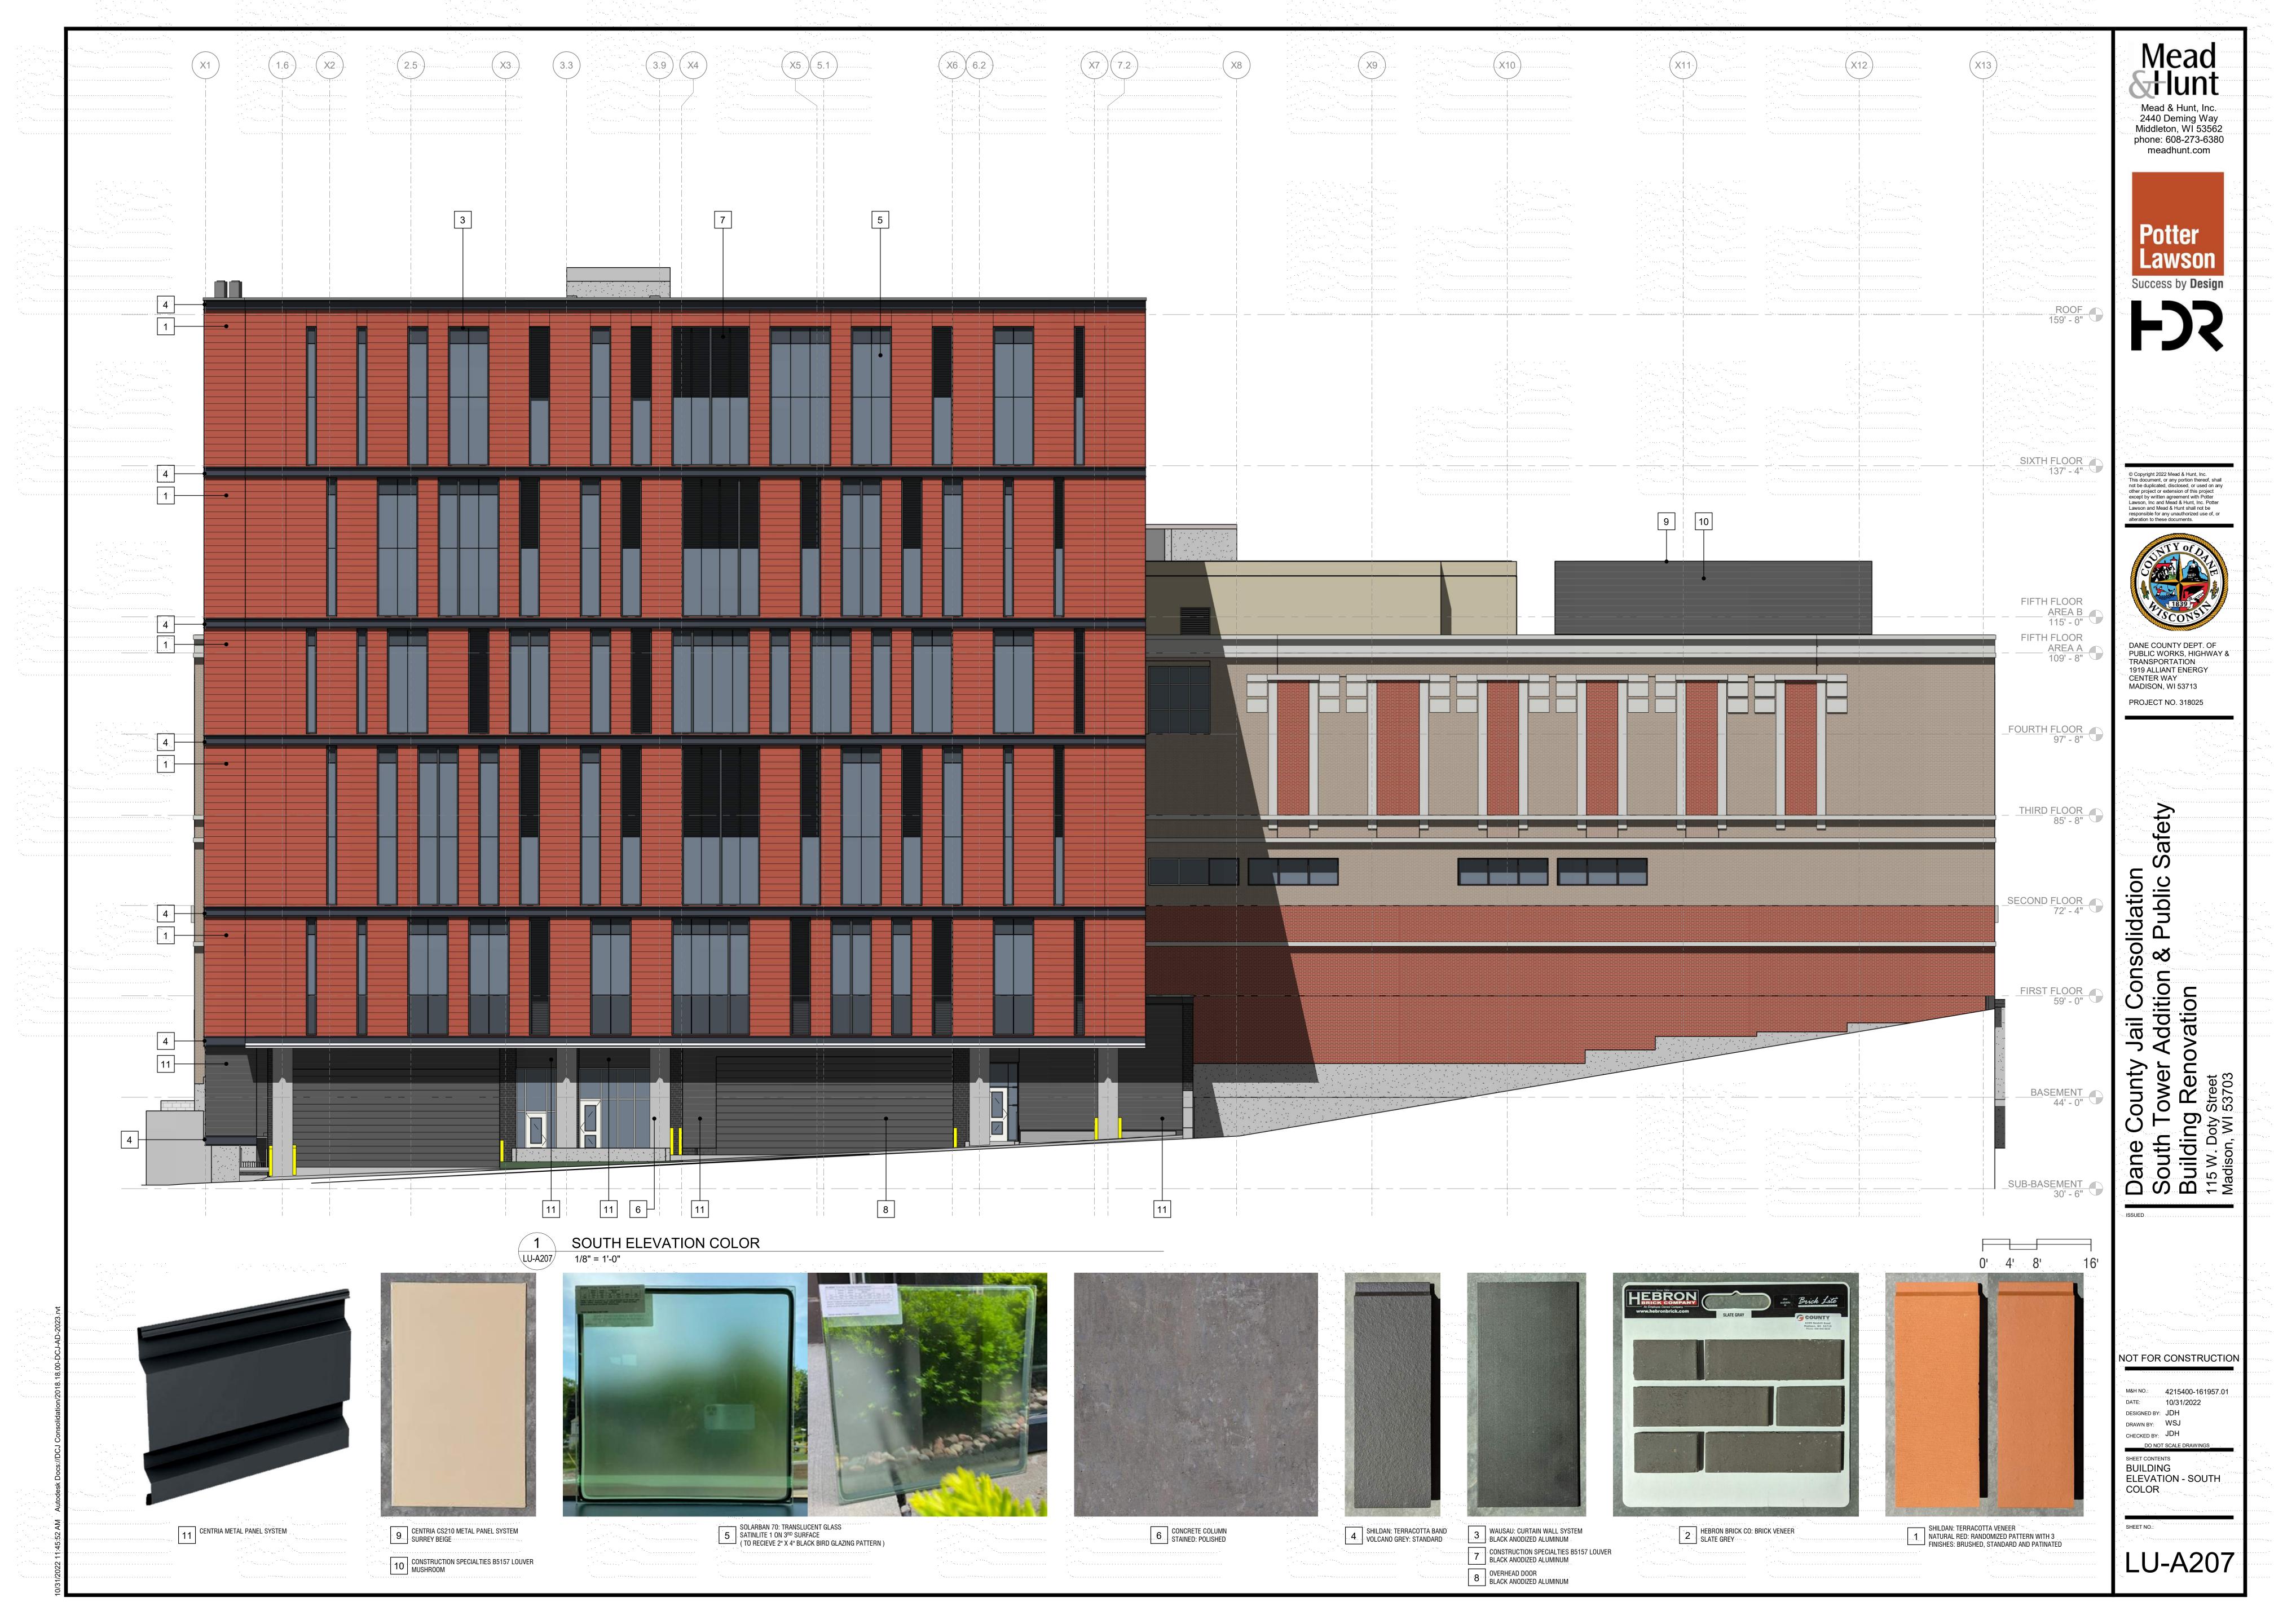




# Dane County Jail Consolidation South Tower Addition & Public Safety Building Renovation

Dane County Public Works Project No.: 318025

Mead & Hunt Project No.: 4215400-161957.01



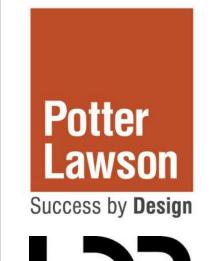

October 31, 2022 Land Use Application


D)MO #	Dunastin u Title	DW0 #	Durantia a Title
DWG#	Drawing Title	DWG#	Drawing Title
GENERAL		ARCHITEC <sup>*</sup>	TURAI
LU-CD	COVER DRAWING	LU-A001	CONTEXT PHOTOS - EXISTING CONDITIONS
		LU-A002	ILLUSTRATIVE SITE PLAN
CIVIL		LU-A003	AERIAL VIEWS
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C003	ENLARGED EXISTING CONDITIONS - AREA B	LU-A101	FLOOR PLANS
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C203	ENLARGED SITE PLAN - AREA B	LU-A201	BUILDING ELEVATION - NORTH
C301	ENLARGED GRADING PLAN - AREA A	LU-A202	BUILDING ELEVATION - EAST
C302	ENLARGED GRADING PLAN -	LU-A203	BUILDING ELEVATION - SOUTH
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C401	UTILITIES PLAN	LU-A205	BUILDING ELEVATION - NORTH COLOR
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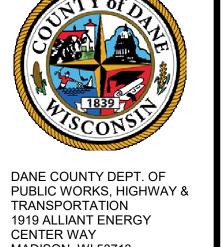
115 W. Doty Street

Madison, WI 53703

DWG#	Drawing Title
ELECTRICA	L
ES-1	SITE LIGHTING
ES-2	SITE LIGHTING PHOTOMETRIC PLAN WILSON STREET ENTRANCE
ES-3	SITE LIGHTING SUBMITTAL (FIXTURES)





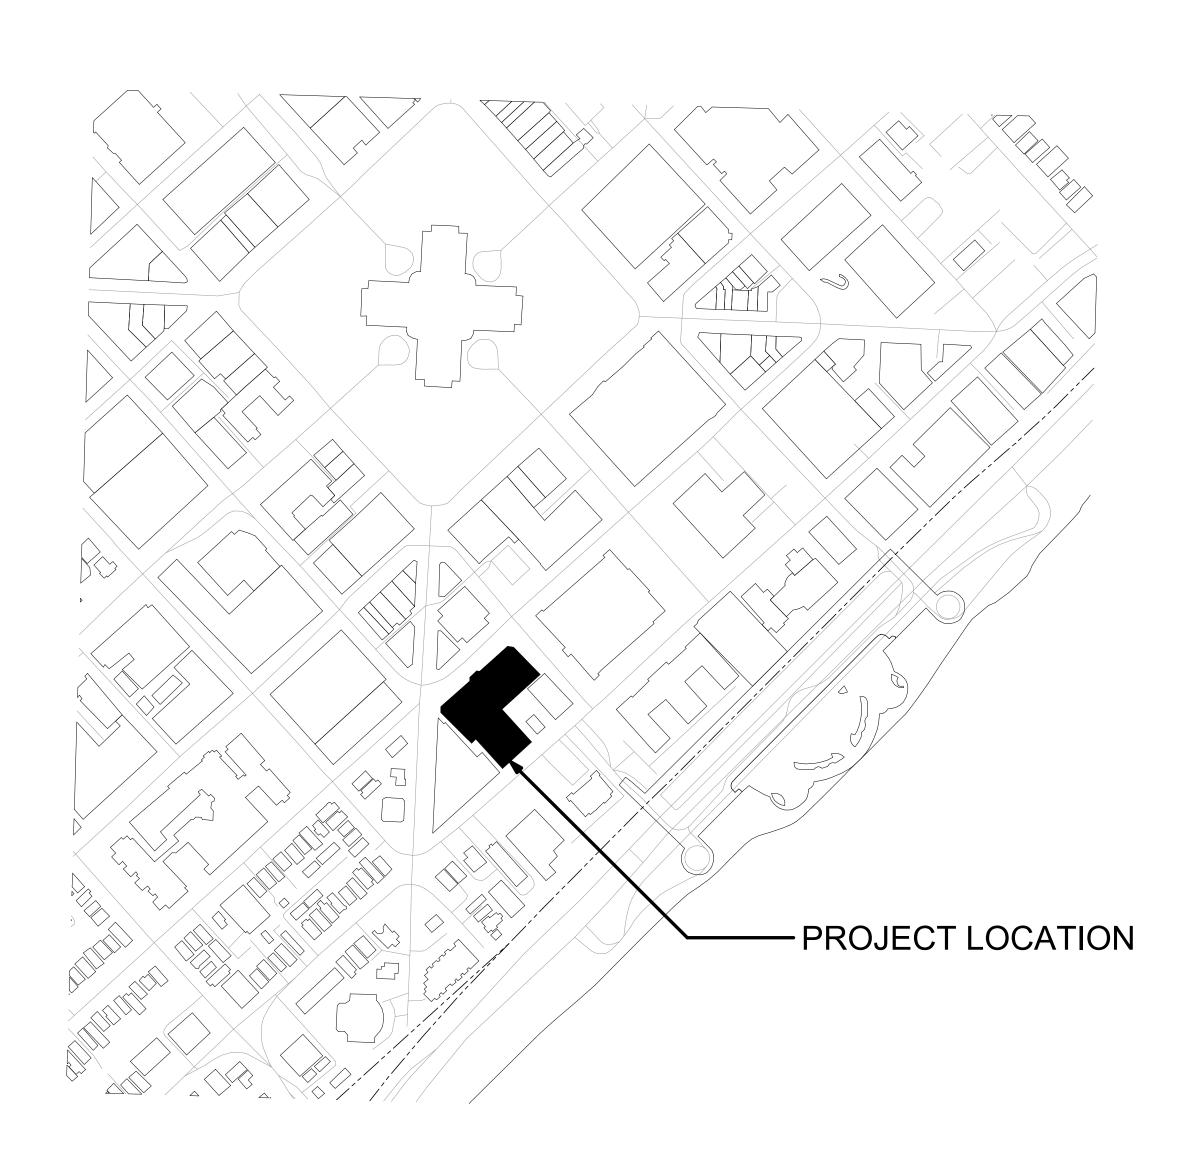

10/31/2022 LAND USE APPLICATION

NOT FOR CONSTRUCTION

CHECKED BY: JDH

SHEET CONTENTS **COVER DRAWING** 

LU-CD

SEE LEGEND ON "BOUNDARY, TOPOGRAPHIC AND UTILITY SURVEY" DATED 05/28/20 PREPARED BY JSD PROFESSIONAL SERVICES, INC., PROVIDED IN THIS PLAN SET.

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PUBLIC WORKS, HIGHWAY & 1919 ALLIANT ENERGY **CENTER WAY** MADISON, WI 53713

PROJECT NO. 318025

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S T E E

NOT FOR CONSTRUCTION

M&H NO.: 4215400-161957.01 DATE: 04/07/2022 DESIGNED BY: BRB DRAWN BY: RH

DO NOT SCALE DRAWINGS SHEET CONTENTS OVERALL EXISTING

CONDITIONS

CHECKED BY: RJ

C001

TO OBTAIN LOCATIONS OF

PARTICIPTANTS

UNDERGROUND FACILITIES BEFORE YOU DIG IN

CALL DIGGERS HOTLINE 1-800-242-8511 TOLL FREE

WIS STATUTE 182.0175(1974) REQUIRES MIN. 3 WORK DAYS NOTICE BEFORE YOU EXCAVATE

RIOUS UTILITY COMPANIES. BEFORE THE START ANY EXCAVATION, A COMPLETE LOCATE OF AL ILITIES WITHIN THE CONSTRUCTION AREA SHOULI

- CONFORM TO CITY OF MADISON STANDARD SPECIFICATIONS FOR PUBLIC WORKS CONSTRUCTION (LATEST EDITION).
- ALL CONSTRUCTION WORK SHALL BE DONE IN ACCORDANCE WITH APPLICABLE FEDERAL AND LOCAL LAWS, CODES, AND ORDINANCES.
- 4. THE LOCATIONS OF COVERED SLABS, ASPHALT CONCRETE PAVEMENTS, PIPES, UNDERGROUND STRUCTURES, OR OTHER UTILITIES SHOWN ON THESE PLANS ARE BASED ON VISIBLE FEATURES ON THE GROUND OR AVAILABLE DRAWINGS PROVIDED BY OTHERS; THEREFORE, THEY
- RESTORE TO ORIGINAL CONDITION EXISTING ASPHALT CONCRETE PAVEMENT, CEMENTITIOUS CONCRETE PAVEMENT, CONCRETE WALKS, LANDSCAPED AREAS, AND OTHER STRUCTURES THAT ARE DISTURBED OR DAMAGED DURING CONSTRUCTION
- PROTECT EXISTING UTILITIES, VALVE BOXES, AND MANHOLES, WHETHER SHOWN OR NOT SHOWN ON THE PLANS, AFFECTED BY TRENCHING WORK. IF DISTURBED, RESTORE TO ORIGINAL CONDITION
- VERIFY THE LOCATIONS, SIZES, AND MATERIALS OF PROPOSED CONNECTIONS TO EXISTING UTILITIES. EXERCISE EXTREME CAUTION DURING EXCAVATION ACTIVITIES IN THESE LOCATIONS.
- CONDUCT CONSTRUCTION OPERATIONS WITH MINIMAL INTERFERENCE TO ROADS, DRIVEWAYS, PARKING AREAS, SIDEWALKS, AND OTHER PEDESTRIAN AND VEHICULAR FACILITIES. PROVIDE CONTINUOUS TRAFFIC FLOW IN ALL DIRECTIONS AT ALL TIMES.
- REVIEW THE PLANS AND NOTIFY THE ARCHITECT/ENGINEER IMMEDIATELY IF ANY DISCREPANCIES ARE FOUND BEFORE PROCEEDING WITH
- 10. COORDINATE AND OBTAIN CLEARANCES AND PERMITS FROM THE CITY OF MADISON DEPARTMENT OF PUBLIC WORKS PRIOR TO EXCAVATION
- 11. PROTECT EXISTING SURVEY MONUMENTS. REPORT DAMAGED SURVEY MONUMENTS. RESTORE AND REPAIR DISTURBED SURVEY MONUMENTS.
- 12. MINIMIZE DISRUPTION OF UTILITY SERVICES. THE OWNER SHALL APPROVE IN ADVANCE ANY SERVICE INTERRUPTIONS AND THE REMOVAL OF EXISTING UTILITY LINES. PROVIDE WRITTEN NOTIFICATION TO OWNER 72 HOURS IN ADVANCE OF INTERRUPTIONS OF SERVICE. MAXIMUM UTILITY OUTAGE FOR ANY ONE (1) INTERRUPTION SHALL NOT EXCEED FOUR (4) HOURS PER DAY.
- 13. RESTORE UNPAVED AREAS DISTURBED DURING CONSTRUCTION BY SODDING.
- 14. PROVIDE TEMPORARY CONNECTION TO EXISTING LINES AS REQUIRED TO MINIMIZE UTILITY SERVICE INTERRUPTIONS BEFORE THE REMOVAL OF ANY PORTION OF EXISTING LINES.
- 15. PROVIDE TEMPORARY ACCESS PROTECTION FOR EQUIPMENT, TRUCKS OR OTHER CONSTRUCTION VEHICLES TO PREVENT ANY DAMAGE TO EXISTING AND/OR NEWLY INSTALLED CONCRETE SIDEWALKS, CURBS, AND PAVING.
- 16. ENSURE POSITIVE DRAINAGE AWAY FROM ALL STRUCTURES AND AVOID PONDING CONDITIONS ANYWHERE ON SITE. DIRECT STORM WATER TO STORM WATER CONVEYANCE STRUCTURES.
- 17. DUE TO VARIATIONS AND CONSTRAINTS, DETERMINE EACH UTILITY TIE IN LAYOUT BY ITS ACTUAL FIELD CONDITIONS. CHANGES TO THE DESIGN CONFIGURATION REQUIRE APPROVAL OF THE ARCHITECT/ENGINEER AND DOCUMENTATION ON THE AS-BUILT DRAWINGS.
- 18. EXERCISE EXTREME CAUTION IN EXCAVATING AREAS THAT ARE KNOWN TO HAVE UNDERGROUND UTILITIES. HAND EXCAVATE WITHIN 3 FEE
- 19. PROVIDE SHORING FOR TRENCH EXCAVATION WORK THAT EXCEEDS 4 FEET IN DEPTH
- 20. PRESERVE AND PROTECT ALL EXISTING TREES AND PLANT MATERIALS NOT IDENTIFIED ON THE PLANS FOR REMOVAL OR RELOCATION. IF PROPOSED IMPROVEMENTS MAY NEGATIVELY AFFECT THE MAJOR ROOT SYSTEMS, OBTAIN APPROVAL OF THE ARCHITECT/ENGINEER TO REMOVE OR RELOCATE THE EXISTING TREE OR PLANT MATERIAL
- 21. THE EXISTING COMMUNICATIONS VAULT AND DUCT BANK IS TO BE REMOVED AND PROPERLY DISPOSED.
- 22. THE NEWLY CONSTRUCTED VAULT AND DUCT BANK IS TO BE PROTECTED AT ALL TIMES. THE CONTRACTOR IS RESPONSIBLE FOR THE SUPPORT AND PROTECTION OF THE NEWLY CONSTRUCTED FIBER OPTIC CABLES AND OR DUCTS FOR THE DURATION OF THE PROJECT. ANY COSTS ASSOCIATED WITH THE DAMAGE AND REPAIR OF THE NEWLY CONSTRUCTED FIBER OPTIC CABLES AND VAULT ARE THE RESPONSIBILITY OF THE CONTRACTOR.
- THE RIGHT-OF-WAY IS THE SOLE JURISDICTION OF THE CITY OF MADISON AND IS SUBJECT TO CHANGE AT ANY TIME PER THE RECOMMENDATION/PLAN OF TRAFFIC ENGINEERING AND CITY ENGINEERING DEPARTMENTS
- 24. CONTRACTOR SHALL PREPARE AND SUBMIT A TRAFFIC CONTROL PLAN TO CITY OF MADISON TRAFFIC ENGINEERING. CONTRACTOR SHALL RESPONSIBLE FOR FEES ASSOCIATED WITH THE TEMPORARY LOSS OF PARKING SPACES DURING CONSTRUCTION. IN MARCH 2021, THE FEE WAS \$18/STALL/DAY

AT&T

316 W. WASHINGTON AVE.

MADISON, WI 53703

1" = 20'

**OVERALL EXISTING CONDITIONS** 

## **UTILITY COORDINATION INFORMATION:**

CONTRACTOR SHALL COORDINATE WITH ALL PRIVATE AND PUBLIC UTILITIES TO ASCERTAIN EACH UTILITY'S DESIRED DEMOLITION AND RELAY.

GAS & ELECTRIC: INTERNET & COMMUNICATIONS:

WATER:

523 E. MAIN ST.

MADISON, WI

MADISON WATER UTILITY

MADISON GAS & ELECTRIC CENTURYLINK 133 S. BLAIR ST. 10 E. DOTY ST. MADISON, WI MADISON, WI

CHARTER COMMUNICATIONS ADMINISTRATION

2701 DANIELS STREET MADISON, WI


PUBLIC WORKS (ROADS, SIDEWALK, TERRACE, LANDSCAPING, SANITARY, STORM):

CITY OF MADISON DEPARTMENT OF PUBLIC WORKS 211 S. CARROLL ST.


MADISON, WI 53703

### **GENERAL NOTES:**

- 1. CONTRACTOR SHALL CONTACT DIGGERS HOTLINE PRIOR TO DOING ANY EXCAVATION.
- 2. DESIGN AND CONSTRUCTION SHALL BE IN ACCORDANCE WITH ALL LOCAL AND STATE BUILDING CODES AND ORDINANCES AND GENERAL DESIGN STANDARDS.
- 3. CONTRACTOR SHALL BE RESPONSIBLE FOR ANY WATER DAMAGE THAT OCCURS IN THE VAULT OR IN AREAS ADJACENT TO THE VAULT REGARDLESS OF THE CAUSE OF THE WATER INFILTRATION.
- 4. CONTRACTOR SHALL OBTAIN A STREET EXCAVATION PERMIT PRIOR TO DOING ANY REPAIR WORK THAT INVOLVES EXCAVATION WITHIN THE PUBLIC RIGHT
- CONTRACTOR SHALL BE RESPONSIBLE TO REPAIR ANY DAMAGES TO THE VAULT INCLUDING DAMAGE TO ANY WATER PROOFING MEMBRANES OR OTHER FEATURES REGARDLESS OF WHO CAUSED THE DAMAGE.
- CONTRACTOR SHALL PROVIDE A SIGNED AND SEALED PLAT OF SURVEY AND LEGAL DESCRIPTION BY A PROFESSIONAL LAND SURVEYOR COMPLIANT WITH CHAPTER A-E 7 OF THE WISCONSIN ADMINISTRATIVE CODE SHOWING THE IMPROVEMENTS WITH A FULLY DIMENSIONED AND LEGALLY DESCRIBED PERIMETRICAL BOUNDARY OF THE ENCROACHMENT AREA REFERENCED TO THE DANE COUNTY COORDINATE SYSTEM TIED TO A QUARTER SECTION LINE AS REQUIRED BY CHAPTER 236 OF THE WISCONSIN STATUTES. THE MAP AND LEGAL DESCRIPTION SHALL ALSO DEFINE AND DESCRIBE THE THREE DIMENSIONAL LOCATION OF THE UPPER AND LOWER LIMITS OF THE IMPROVEMENTS. ALL VERTICAL LOCATIONS SHALL BE REFERENCED TO THE NAVD 88 (91) DATUM.

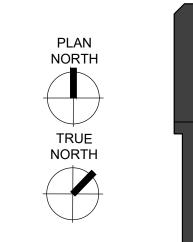

KEY PLAN

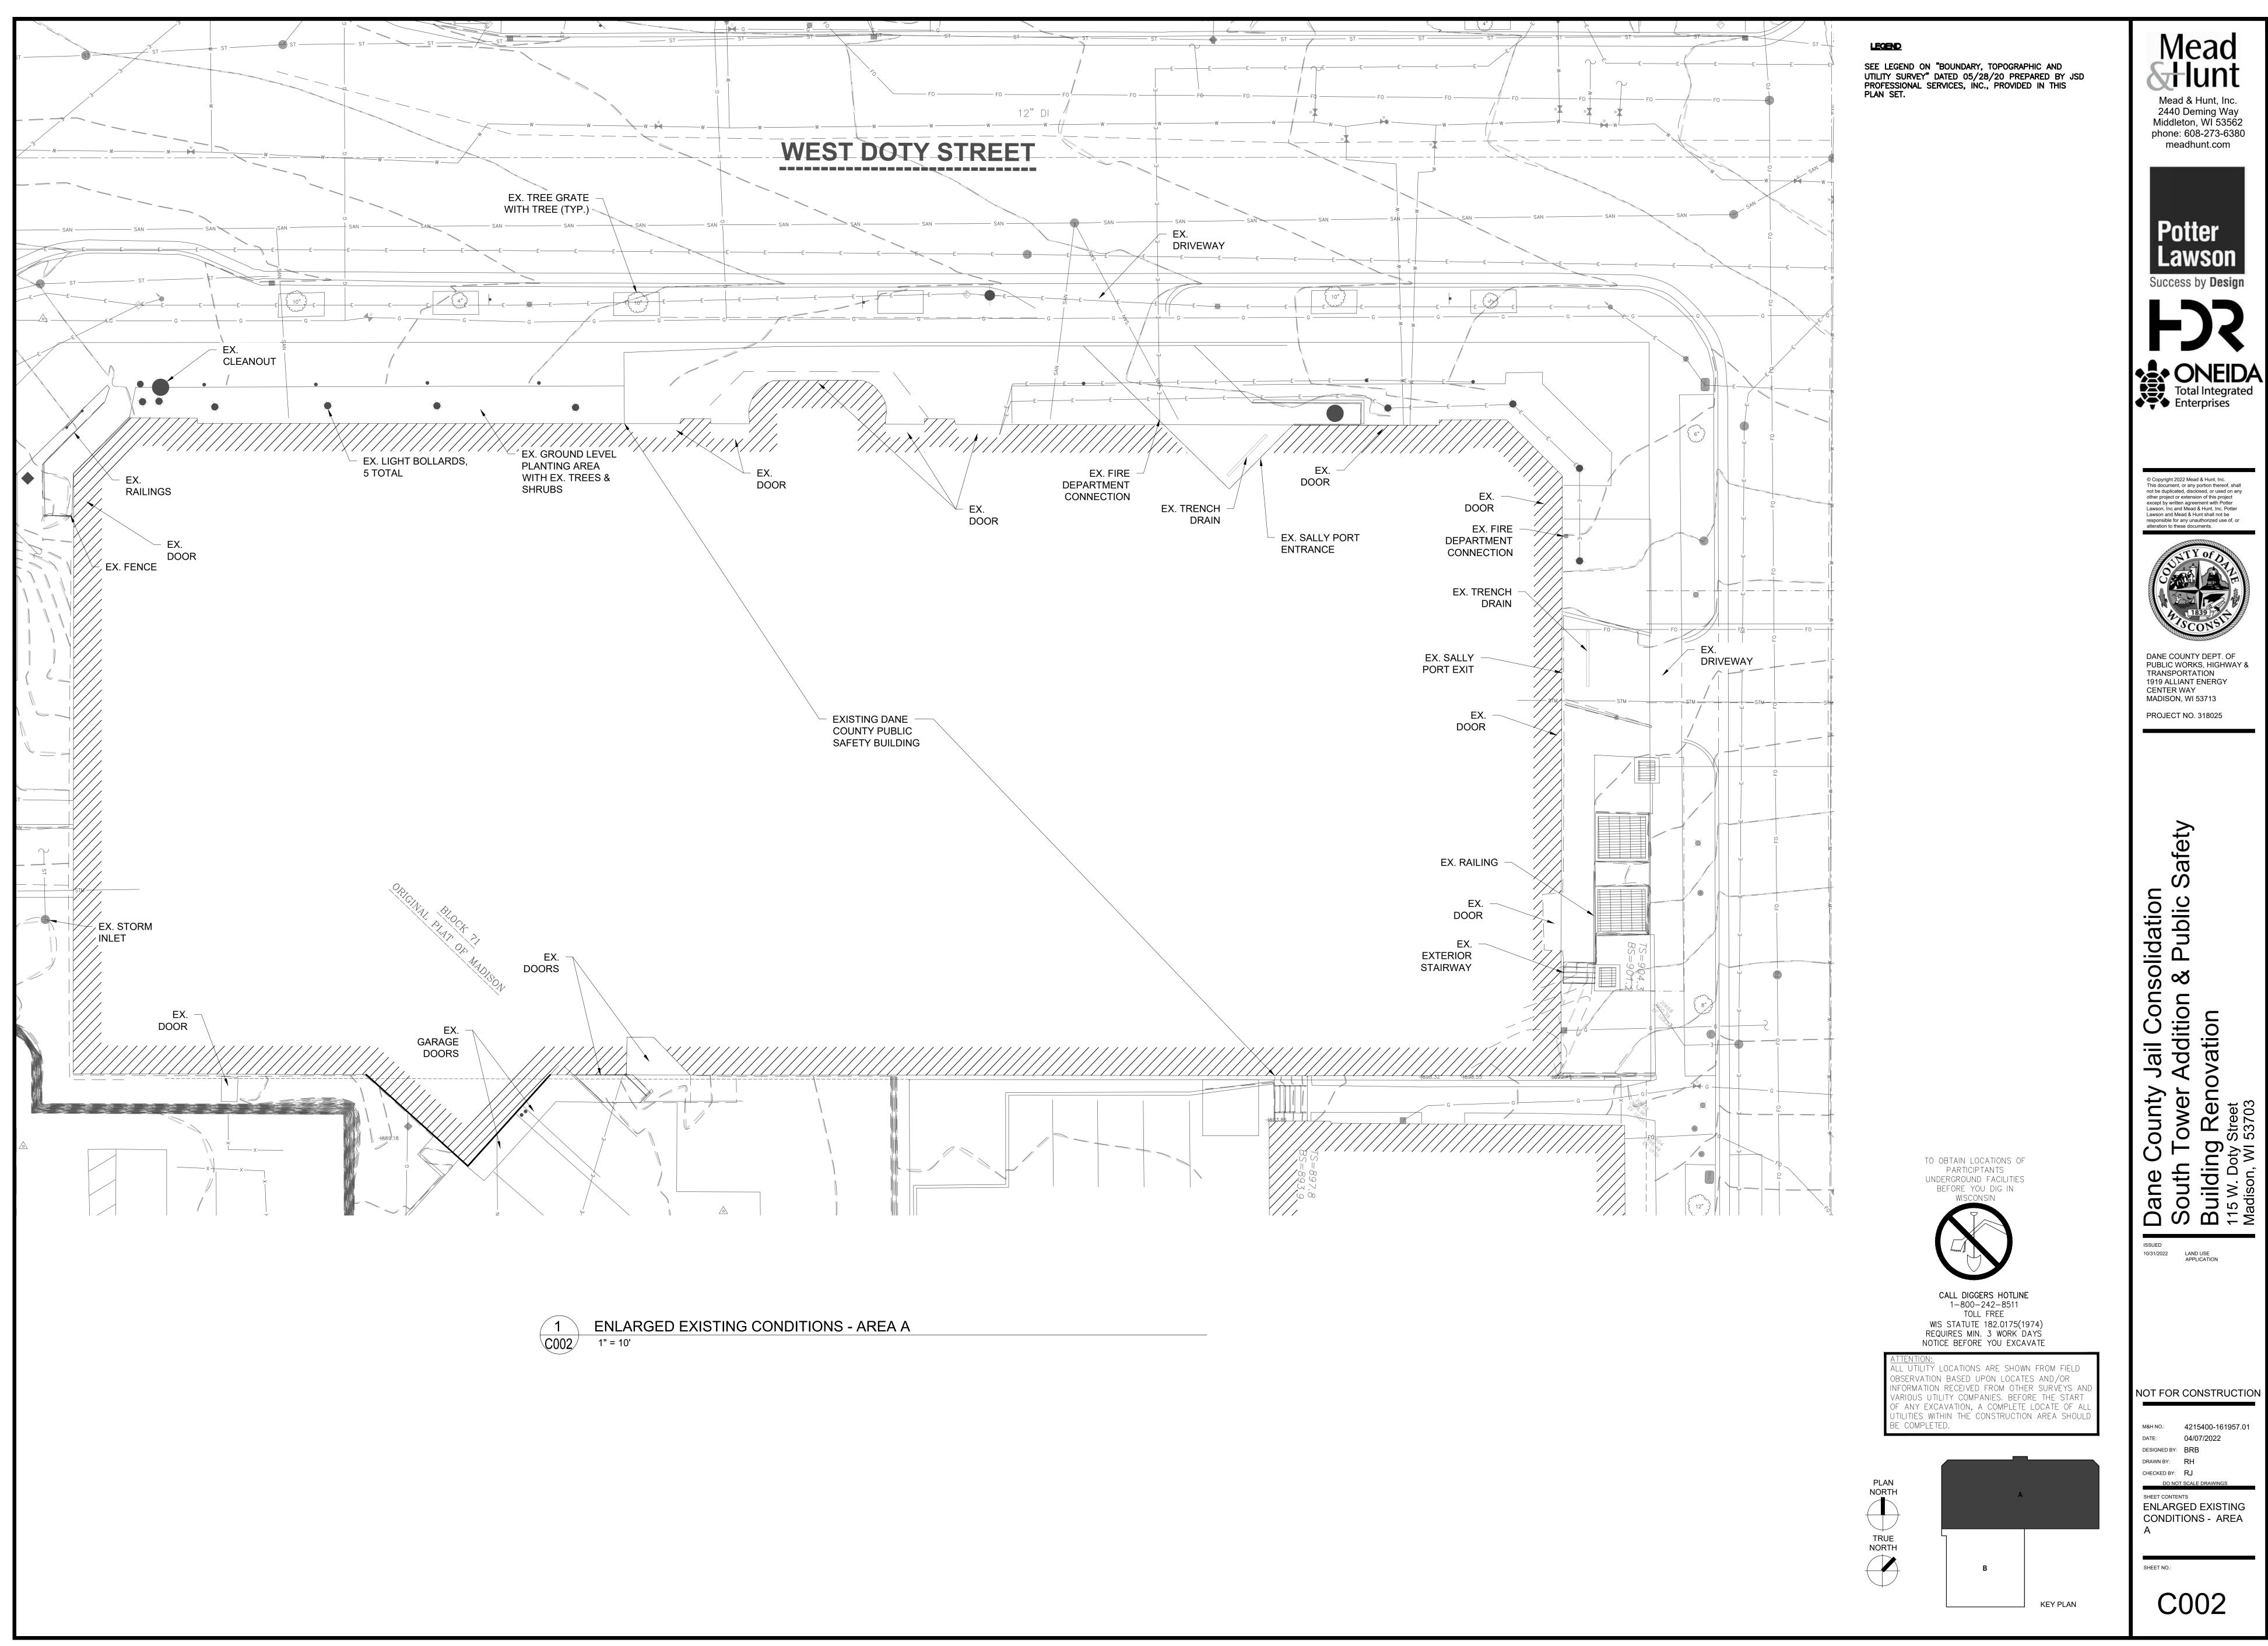

SEE LEGEND ON "BOUNDARY, TOPOGRAPHIC AND UTILITY SURVEY" DATED 05/28/20 PREPARED BY JSD PROFESSIONAL SERVICES, INC., PROVIDED IN THIS PLAN SET.

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DANE COUNTY DEPT. OF PUBLIC WORKS, HIGHWAY & TRANSPORTATION 1919 ALLIANT ENERGY CENTER WAY MADISON, WI 53713

PROJECT NO. 318025

Dane County Jail Consolidation
South Tower Addition & Public Sa
Building Renovation
Madison, WI 53703

TO OBTAIN LOCATIONS OF
PARTICIPTANTS
UNDERGROUND FACILITIES
BEFORE YOU DIG IN
WISCONSIN

CALL DIGGERS HOTLINE

1-800-242-8511

TOLL FREE

WIS STATUTE 182.0175(1974)

REQUIRES MIN. 3 WORK DAYS

NOTICE BEFORE YOU EXCAVATE

L UTILITY LOCATIONS ARE SHOWN FROM FIELD OBSERVATION BASED UPON LOCATES AND/OR

VARIOUS UTILITY COMPANIES. BEFORE THE START OF ANY EXCAVATION, A COMPLETE LOCATE OF ALL UTILITIES WITHIN THE CONSTRUCTION AREA SHOULD

**KEY PLAN** 

BE COMPLETED.

NORTH

TRUE NORTH


LAND USE APPLICATION

NOT FOR CONSTRUCTION M&H NO.: 4215400-161957.01

DATE: 04/07/2022 DESIGNED BY: BRB DRAWN BY: RH CHECKED BY: RJ DO NOT SCALE DRAWINGS

SHEET CONTENTS **ENLARGED EXISTING** CONDITIONS - AREA B

ENLARGED EXISTING CONDITIONS - AREA B

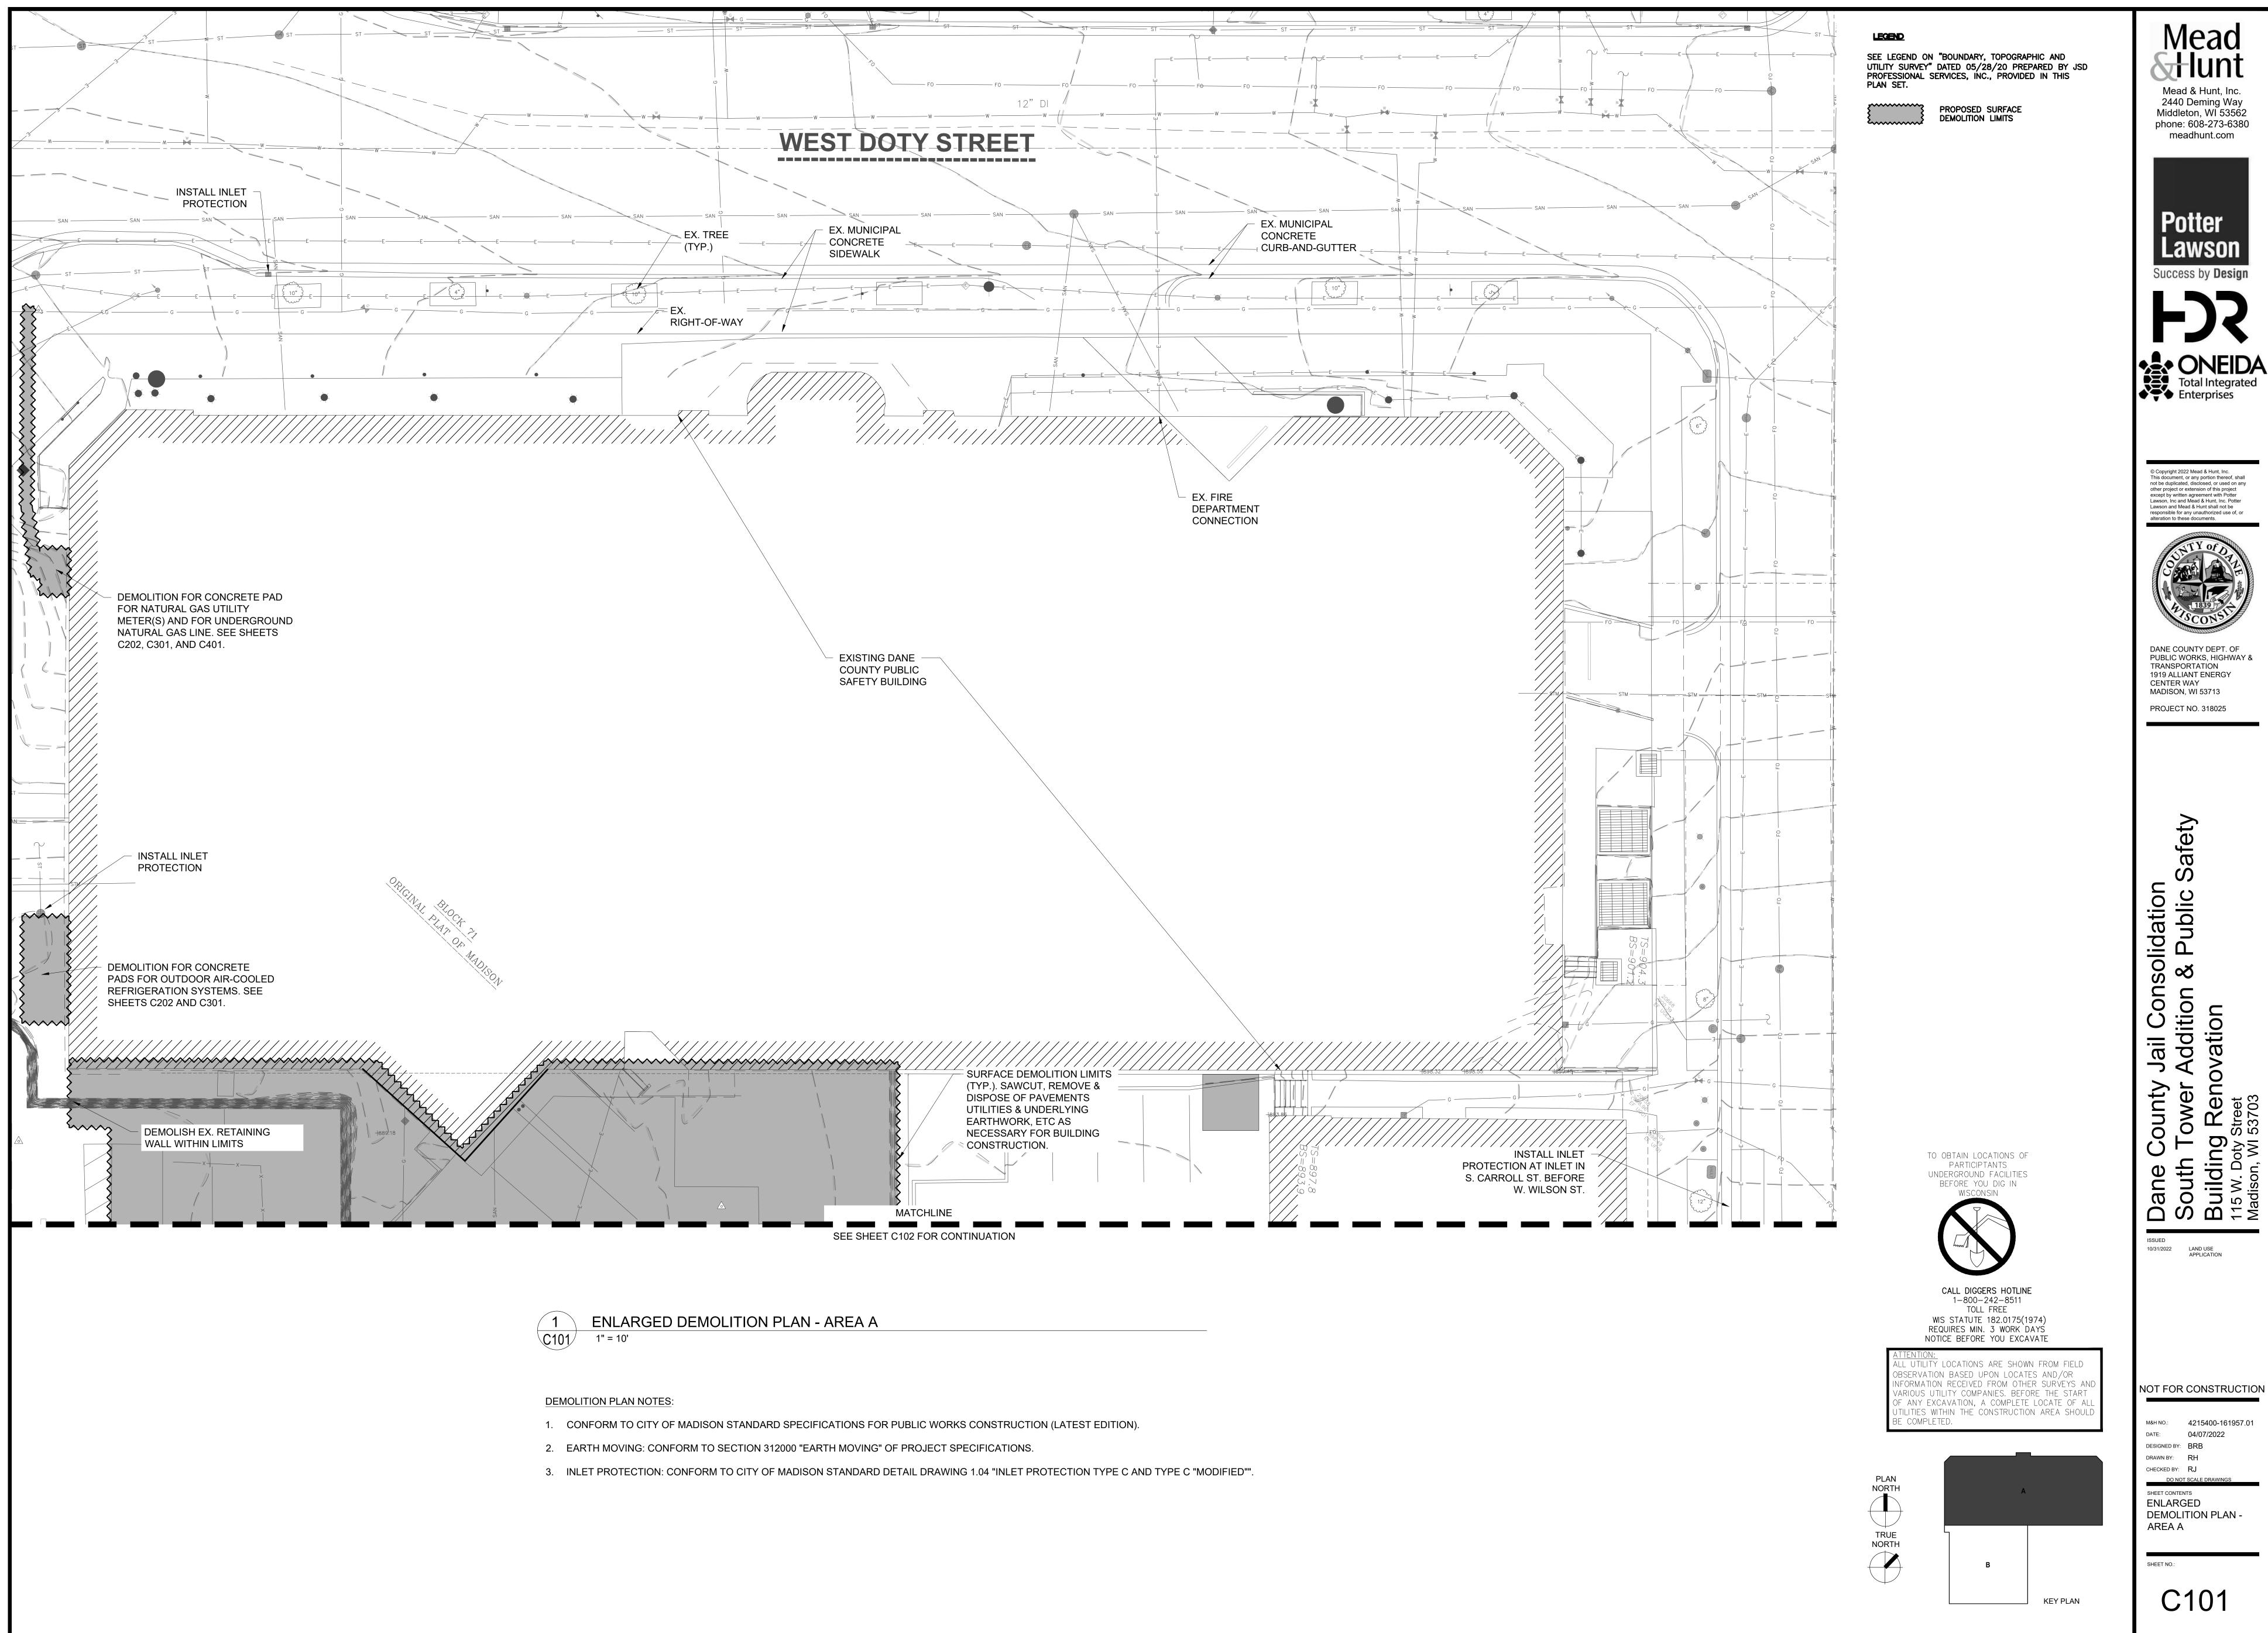



#### **DEMOLITION PLAN NOTES:**

- 1. CONFORM TO CITY OF MADISON STANDARD SPECIFICATIONS FOR PUBLIC WORKS CONSTRUCTION (LATEST EDITION).
- 2. EARTH MOVING: CONFORM TO SECTION 312000 "EARTH MOVING" OF PROJECT SPECIFICATIONS.
- 3. INLET PROTECTION: CONFORM TO CITY OF MADISON STANDARD DETAIL DRAWING 1.04 "INLET PROTECTION TYPE C AND TYPE C "MODIFIED"".

SEE LEGEND ON "BOUNDARY, TOPOGRAPHIC AND UTILITY SURVEY" DATED 05/28/20 PREPARED BY JSD PROFESSIONAL SERVICES, INC., PROVIDED IN THIS PLAN SET.



PROPOSED SURFACE DEMOLITION LIMITS

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PUBLIC WORKS, HIGHWAY & TRANSPORTATION 1919 ALLIANT ENERGY **CENTER WAY** MADISON, WI 53713

PROJECT NO. 318025

/ Jail Consolidation <sup>-</sup> Addition & Public S ovation


Dane Co South Tc Building

LAND USE APPLICATION

NOT FOR CONSTRUCTION

M&H NO.: 4215400-161957.01 DATE: 04/07/2022 DESIGNED BY: BRB DRAWN BY: RH CHECKED BY: RJ DO NOT SCALE DRAWINGS

SHEET CONTENTS **ENLARGED DEMOLITION PLAN -**AREA B

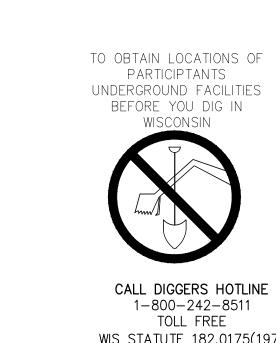

CALL DIGGERS HOTLINE

1-800-242-8511


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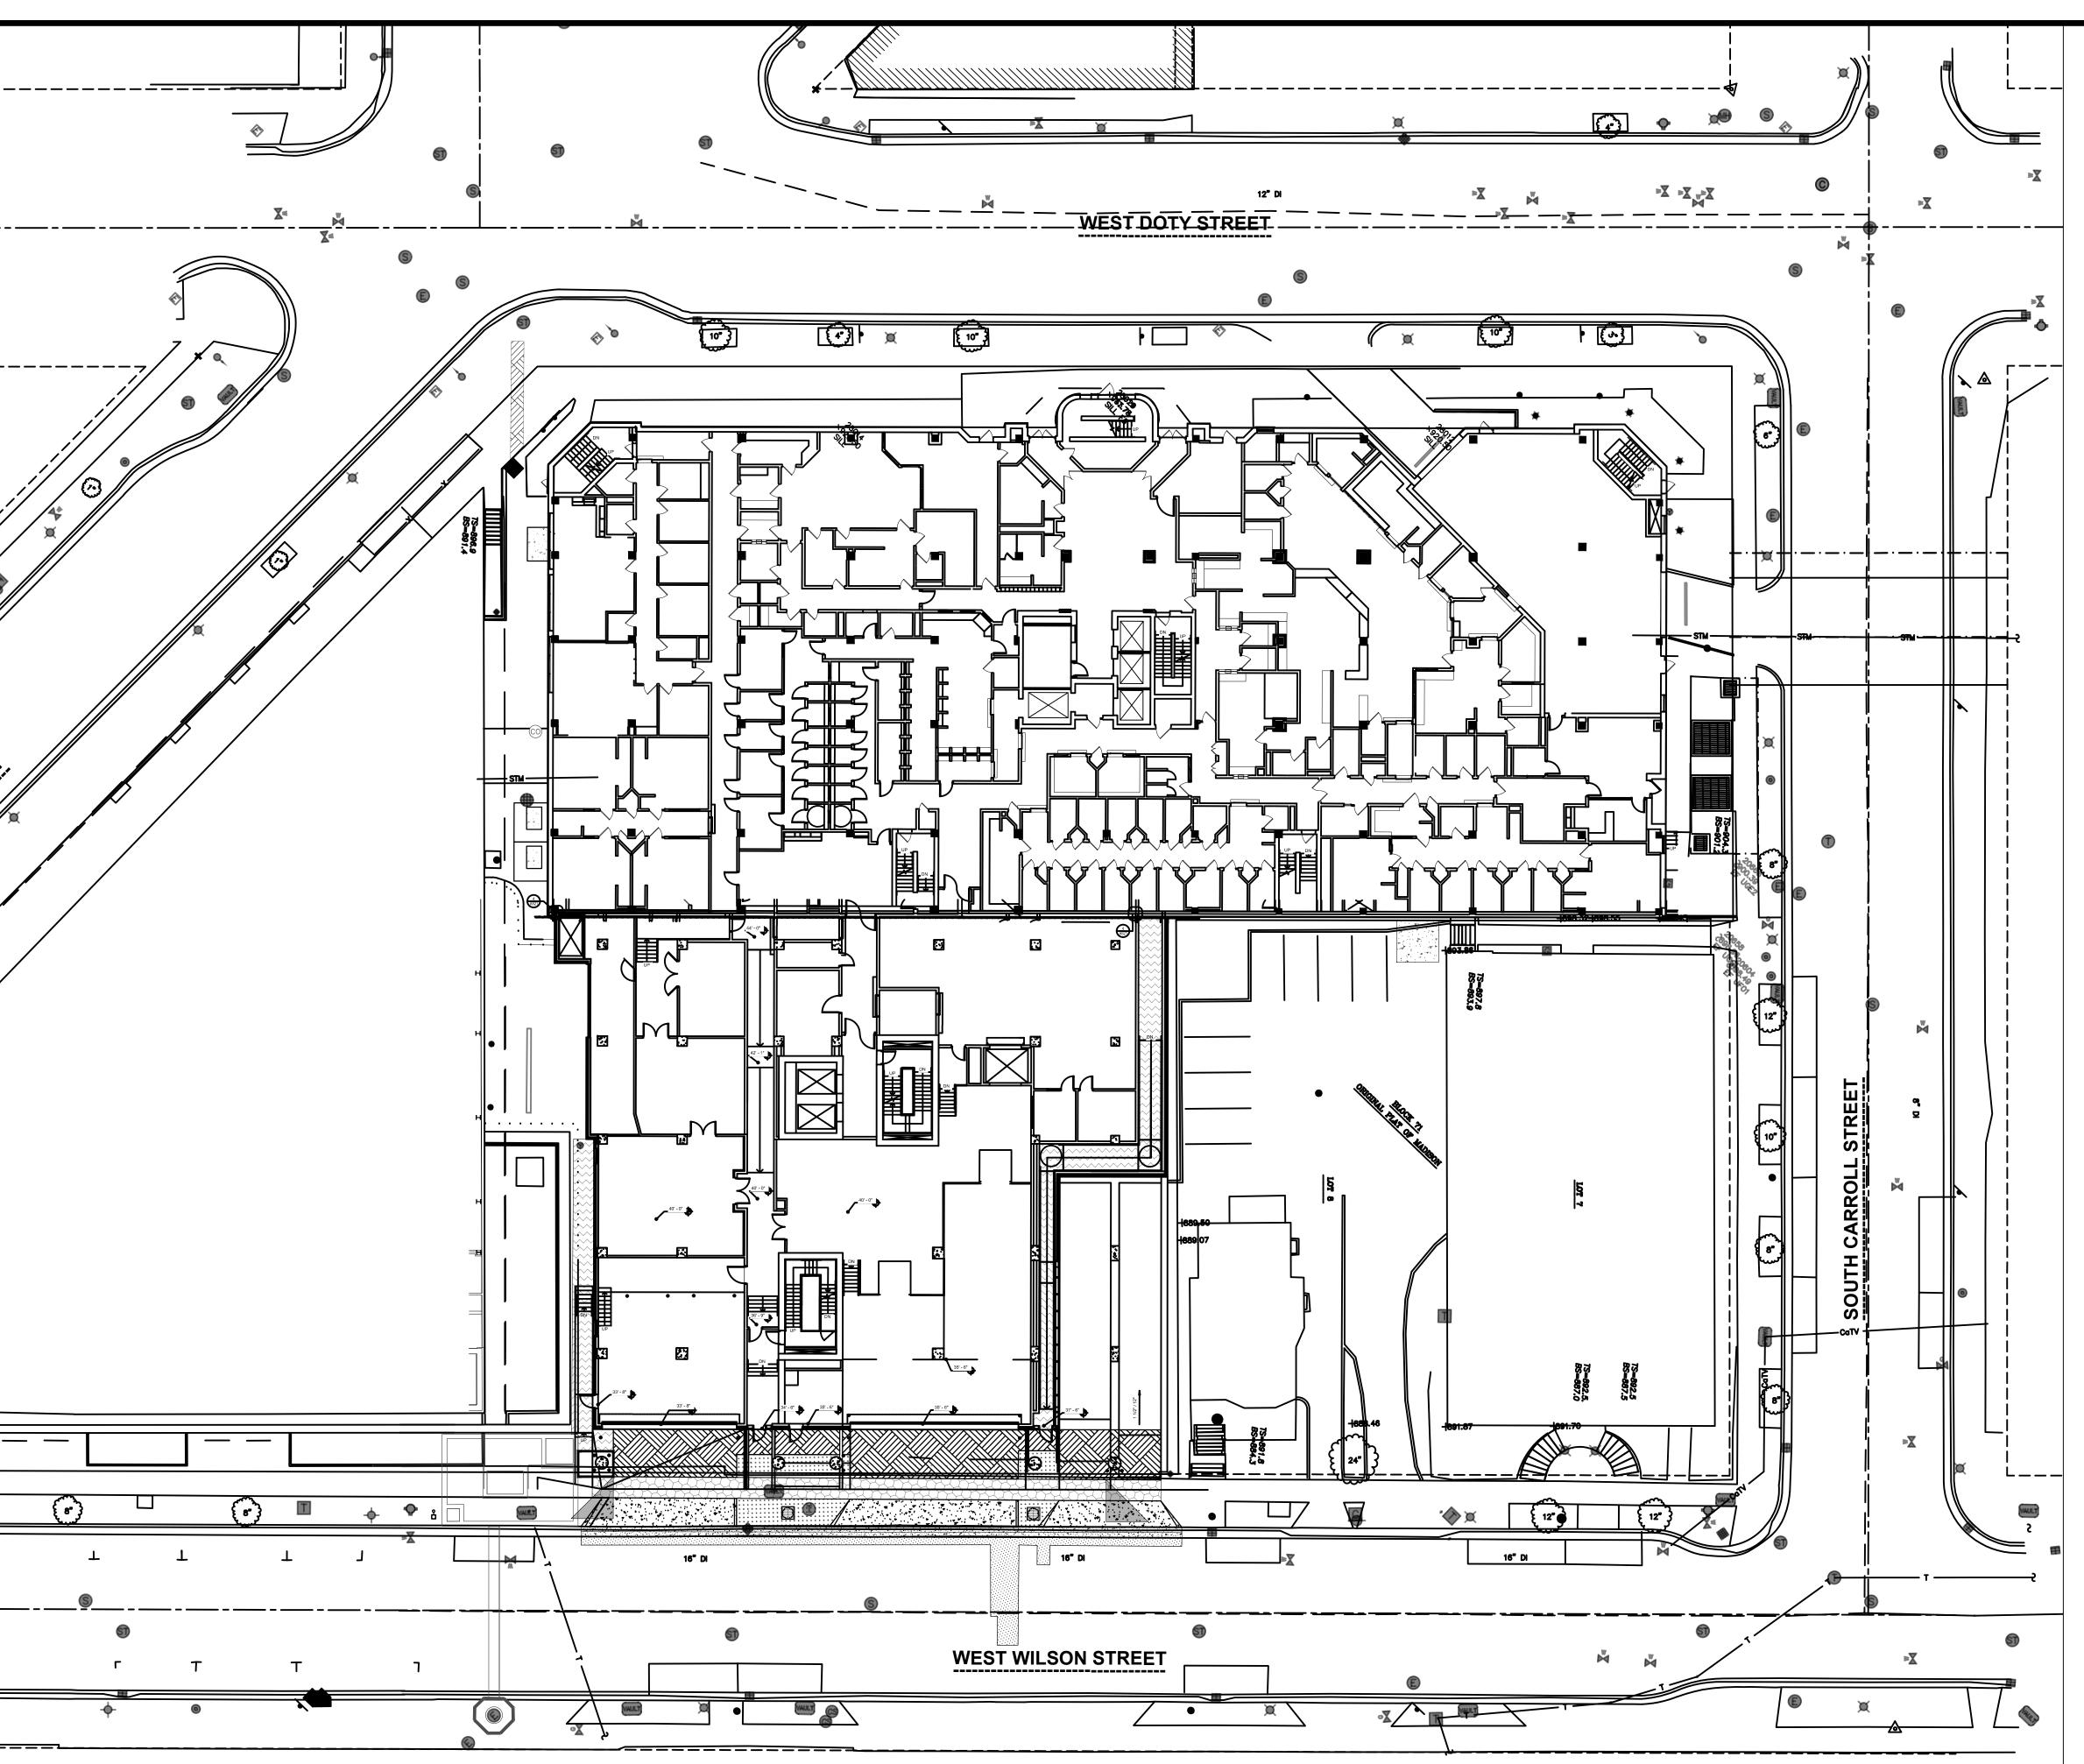
WIS STATUTE 182.0175(1974)

REQUIRES MIN. 3 WORK DAYS

NOTICE BEFORE YOU EXCAVATE

L UTILITY LOCATIONS ARE SHOWN FROM FIELD OBSERVATION BASED UPON LOCATES AND/OR VARIOUS UTILITY COMPANIES. BEFORE THE START OF ANY EXCAVATION, A COMPLETE LOCATE OF ALL UTILITIES WITHIN THE CONSTRUCTION AREA SHOULD BE COMPLETED.



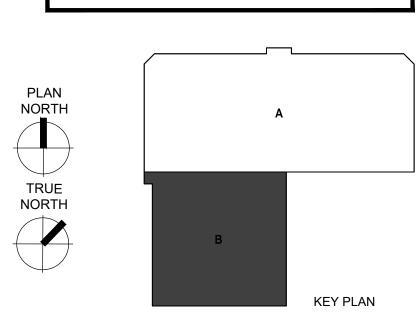

PUBLIC WORKS (ROADS, SIDEWALK, TERRACE, LANDSCAPING, SANITARY, STORM)

CITY OF MADISON DEPARTMENT OF PUBLIC WORKS

211 S. CARROLL ST.

MADISON, WI 53703

## 1" = 20'

OVERALL SITE PLAN

## **UTILITY COORDINATION INFORMATION:**

CONTRACTOR SHALL COORDINATE WITH ALL PRIVATE AND PUBLIC UTILITIES TO ASCERTAIN EACH UTILITY'S DESIRED DEMOLITION AND RELAY

GAS & ELECTRIC:

133 S. BLAIR ST.

MADISON, WI

WATER:

MADISON GAS & ELECTRIC

**INTERNET & COMMUNICATIONS:** 

CENTURYLINK 10 E. DOTY ST.

MADISON, WI

MADISON WATER UTILITY

MADISON, WI

523 E. MAIN ST.

CHARTER COMMUNICATIONS ADMINISTRATION

2701 DANIELS STREET

MADISON, WI

AT&T

316 W. WASHINGTON AVE. MADISON, WI 53703

### **GENERAL NOTES:**

- CONTRACTOR SHALL CONTACT DIGGERS HOTLINE PRIOR TO DOING ANY EXCAVATION.
- 2. DESIGN AND CONSTRUCTION SHALL BE IN ACCORDANCE WITH ALL LOCAL AND STATE BUILDING CODES AND ORDINANCES AND GENERAL DESIGN STANDARDS.
- CONTRACTOR SHALL BE RESPONSIBLE FOR ANY WATER DAMAGE THAT OCCURS IN THE VAULT OR IN AREAS ADJACENT TO THE VAULT REGARDLESS OF THE CAUSE OF THE WATER INFILTRATION.
- 4. CONTRACTOR SHALL OBTAIN A STREET EXCAVATION PERMIT PRIOR TO DOING ANY REPAIR WORK THAT INVOLVES EXCAVATION WITHIN THE PUBLIC RIGHT OF
- CONTRACTOR SHALL BE RESPONSIBLE TO REPAIR ANY DAMAGES TO THE VAULT INCLUDING DAMAGE TO ANY WATER PROOFING MEMBRANES OR OTHER FEATURES REGARDLESS OF WHO CAUSED THE DAMAGE.
- CONTRACTOR SHALL PROVIDE A SIGNED AND SEALED PLAT OF SURVEY AND LEGAL DESCRIPTION BY A PROFESSIONAL LAND SURVEYOR COMPLIANT WITH CHAPTER A-E 7 OF THE WISCONSIN ADMINISTRATIVE CODE SHOWING THE IMPROVEMENTS WITH A FULLY DIMENSIONED AND LEGALLY DESCRIBED PERIMETRICAL BOUNDARY OF THE ENCROACHMENT AREA REFERENCED TO THE DANE COUNTY COORDINATE SYSTEM TIED TO A QUARTER SECTION LINE AS REQUIRED BY CHAPTER 236 OF THE WISCONSIN STATUTES. THE MAP AND LEGAL DESCRIPTION SHALL ALSO DEFINE AND DESCRIBE THE THREE DIMENSIONAL LOCATION OF THE UPPER AND LOWER LIMITS OF THE IMPROVEMENTS. ALL VERTICAL LOCATIONS SHALL BE REFERENCED TO THE NAVD 88 (91) DATUM.

### CIVIL NOTES (SHEETS C201-C203, C301-302, & C402)

- "BOUNDARY, TOPOGRAPHIC AND UTILITY SURVEY" DATED 05/28/20 PREPARED BY JSD PROFESSIONAL SERVICES, INC.
- CONFORM TO CITY OF MADISON STANDARD SPECIFICATIONS FOR PUBLIC WORKS CONSTRUCTION (LATEST EDITION).
- ALL CONSTRUCTION WORK SHALL BE DONE IN ACCORDANCE WITH
- APPLICABLE FEDERAL AND LOCAL LAWS, CODES, AND ORDINANCES. THE LOCATIONS OF COVERED SLABS, ASPHALT CONCRETE PAVEMENTS
- PIPES, UNDERGROUND STRUCTURES, OR OTHER UTILITIES SHOWN ON THESE PLANS ARE BASED ON VISIBLE FEATURES ON THE GROUND OR AVAILABLE DRAWINGS PROVIDED BY OTHERS; THEREFORE, THEY ARE APPROXIMATE. VERIFY THE TYPE OF MATERIALS, EXACT LOCATION, SIZE AND DEPTH OF ALL UTILITIES PRIOR TO THE START OF WORK.
- RESTORE TO ORIGINAL CONDITION EXISTING ASPHALT CONCRETE PAVEMENT, CEMENTITIOUS CONCRETE PAVEMENT, CONCRETE WALKS, LANDSCAPED AREAS, AND OTHER STRUCTURES THAT ARE DISTURBED OR DAMAGED DURING CONSTRUCTION.
- PROTECT EXISTING UTILITIES, VALVE BOXES, AND MANHOLES, WHETHER SHOWN OR NOT SHOWN ON THE PLANS, AFFECTED BY TRENCHING WORK. IF DISTURBED, RESTORE TO ORIGINAL CONDITION.
- 7. VERIFY THE LOCATIONS, SIZES, AND MATERIALS OF PROPOSED CONNECTIONS TO EXISTING UTILITIES. EXERCISE EXTREME CAUTION DURING EXCAVATION ACTIVITIES IN THESE LOCATIONS.
- CONDUCT CONSTRUCTION OPERATIONS WITH MINIMAL INTERFERENCE TO ROADS, DRIVEWAYS, PARKING AREAS, SIDEWALKS, AND OTHER PEDESTRIAN AND VEHICULAR FACILITIES. PROVIDE CONTINUOUS TRAFFIC FLOW IN ALL DIRECTIONS AT ALL TIMES.
- REVIEW THE PLANS AND NOTIFY THE ARCHITECT/ENGINEER IMMEDIATELY IF ANY DISCREPANCIES ARE FOUND BEFORE PROCEEDING WITH THE WORK.
- 10. COORDINATE AND OBTAIN CLEARANCES AND PERMITS FROM THE CITY OF MADISON DEPARTMENT OF PUBLIC WORKS PRIOR TO EXCAVATION ACTIVITIES.
- 11. PROTECT EXISTING SURVEY MONUMENTS. REPORT DAMAGED SURVEY MONUMENTS. RESTORE AND REPAIR DISTURBED SURVEY MONUMENTS.
- 12. MINIMIZE DISRUPTION OF UTILITY SERVICES. THE OWNER SHALL APPROVE IN ADVANCE ANY SERVICE INTERRUPTIONS AND THE REMOVAL OF EXISTING UTILITY LINES. PROVIDE WRITTEN NOTIFICATION TO OWNER 72 HOURS IN ADVANCE OF INTERRUPTIONS OF SERVICE. MAXIMUM UTILITY OUTAGE FOR ANY ONE (1) INTERRUPTION SHALL NOT EXCEED FOUR (4) HOURS PER DAY.
- 13. RESTORE UNPAVED AREAS DISTURBED DURING CONSTRUCTION BY SODDING
- 14. PROVIDE TEMPORARY CONNECTION TO EXISTING LINES AS REQUIRED TO MINIMIZE UTILITY SERVICE INTERRUPTIONS BEFORE THE REMOVAL OF ANY PORTION OF EXISTING LINES.
- PROVIDE TEMPORARY ACCESS PROTECTION FOR EQUIPMENT, TRUCKS OR OTHER CONSTRUCTION VEHICLES TO PREVENT ANY DAMAGE TO EXISTING AND/OR NEWLY INSTALLED CONCRETE SIDEWALKS, CURBS, AND PAVING.
- 16. ENSURE POSITIVE DRAINAGE AWAY FROM ALL STRUCTURES AND AVOID PONDING CONDITIONS ANYWHERE ON SITE. DIRECT STORM WATER TO STORM WATER CONVEYANCE STRUCTURES.
- 17. DUE TO VARIATIONS AND CONSTRAINTS, DETERMINE EACH UTILITY TIE IN LAYOUT BY ITS ACTUAL FIELD CONDITIONS. CHANGES TO THE DESIGN CONFIGURATION REQUIRE APPROVAL OF THE ARCHITECT/ENGINEER AND DOCUMENTATION ON THE AS-BUILT DRAWINGS.
- 18. EXERCISE EXTREME CAUTION IN EXCAVATING AREAS THAT ARE KNOWN TO HAVE UNDERGROUND UTILITIES. HAND EXCAVATE WITHIN 3 FEET OF ANY EXISTING UTILITIES. IN CASES WHERE THE DEPTH OR ELEVATION ARE NOT INDICATED ON THE PLANS, PROCEED WITH CAUTION.
- 19. PROVIDE SHORING FOR TRENCH EXCAVATION WORK THAT EXCEEDS 4 FEET IN DEPTH
- 20. PRESERVE AND PROTECT ALL EXISTING TREES AND PLANT MATERIALS NOT IDENTIFIED ON THE PLANS FOR REMOVAL OR RELOCATION. IF PROPOSED IMPROVEMENTS MAY NEGATIVELY AFFECT THE MAJOR ROOT SYSTEMS OBTAIN APPROVAL OF THE ARCHITECT/ENGINEER TO REMOVE OR RELOCATE THE EXISTING TREE OR PLANT MATERIAL.
- THE EXISTING COMMUNICATIONS VAULT AND DUCT BANK IS TO BE REMOVED AND PROPERLY DISPOSED.
- 22. THE NEWLY CONSTRUCTED VAULT AND DUCT BANK IS TO BE PROTECTED AT ALL TIMES. THE CONTRACTOR IS RESPONSIBLE FOR THE SUPPORT AND PROTECTION OF THE NEWLY CONSTRUCTED FIBER OPTIC CABLES AND OR DUCTS FOR THE DURATION OF THE PROJECT. ANY COSTS ASSOCIATED WITH THE DAMAGE AND REPAIR OF THE NEWLY CONSTRUCTED FIBER OPTIC CABLES AND VAULT ARE THE RESPONSIBILITY OF THE CONTRACTOR.
- 23. THE RIGHT-OF-WAY IS THE SOLE JURISDICTION OF THE CITY OF MADISON AND IS SUBJECT TO CHANGE AT ANY TIME PER THE RECOMMENDATION/PLAN OF TRAFFIC ENGINEERING AND CITY ENGINEERING DEPARTMENTS.
- 24. CONTRACTOR SHALL PREPARE AND SUBMIT A TRAFFIC CONTROL PLAN TO CITY OF MADISON TRAFFIC ENGINEERING. CONTRACTOR SHALL BE RESPONSIBLE FOR FEES ASSOCIATED WITH THE TEMPORARY LOSS OF PARKING SPACES DURING CONSTRUCTION. IN MARCH 2021, THE FEE WAS \$18/STALL/DAY.

#### **LEGEND**

SEE LEGEND ON "BOUNDARY, TOPOGRAPHIC AND UTILITY SURVEY" DATED 05/28/20 PREPARED BY JSD

PROFESSIONAL PLAN SET, FOR		., PROVIDED	
EXISTING	PROPOSED	)	
—— W ——	<u> </u>	WATER	PIP

SANITARY PIPE STORM PIPE ELECTRICAL CONDUIT

WATER VALVE

SANITARY CLEANOUT ROOF DRAIN CONNECTION

**HYDRANT** LIGHT POLE

> PROPOSED MUNICIPAL CONCRETE SIDEWALK (DETAIL 2/C203 AND MADISON SDD 4.02) PROPOSED MUNICIPAL CONCRETE DRIVEWAY

> > (DETAIL 3/C203 AND

MADISON SDD 3.02)

(DETAIL 4/C203)

PROPOSED MUNICIPAL

LIGHT POLE

PROPOSED PERMEABLE CONCRETE DRIVEWAY **PAVEMENT** 

PROPOSED CONCRETE SIDEWALK PAVEMENT (DETAIL 5/C203)

> **CONCRETE** CURB-AND-GUTTER,

PROPOSED TREE TRENCH PROPOSED ASPHALT

ROADWAY PAVEMENT PROPOSED TURF

Mead Mead & Hunt, Inc 2440 Deming Way Middleton, WI 53562 phone: 608-273-6380

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DANE COUNTY DEPT. OF

TRANSPORTATION

MADISON, WI 53713

PROJECT NO. 318025

**CENTER WAY** 

1919 ALLIANT ENERGY


PUBLIC WORKS, HIGHWAY &

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uildi 5 W. E S T E

LAND USE APPLICATION

'ARIOUS UTILITY COMPANIES. BEFORE THE START DF ANY EXCAVATION, A COMPLETE LOCATE OF ALL LITIES WITHIN THE CONSTRUCTION AREA SHOUL

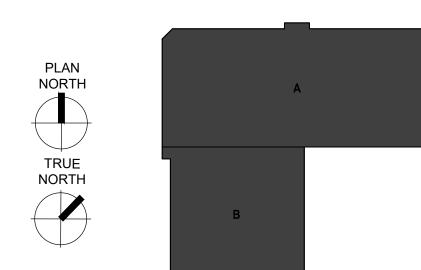

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TO OBTAIN LOCATIONS OF

PARTICIPTANTS UNDERGROUND FACILITIES

BEFORE YOU DIG IN

CALL DIGGERS HOTLINE

1-800-242-8511

WIS STATUTE 182.0175(1974) REQUIRES MIN. 3 WORK DAYS

NOTICE BEFORE YOU EXCAVATE


NOT FOR CONSTRUCTION

M&H NO.: 4215400-161957.01

04/07/2022 DATE: DESIGNED BY: BRB DRAWN BY: RH CHECKED BY: RJ DO NOT SCALE DRAWINGS

SHEET CONTENTS OVERALL SITE PLAN

KEY PLAN

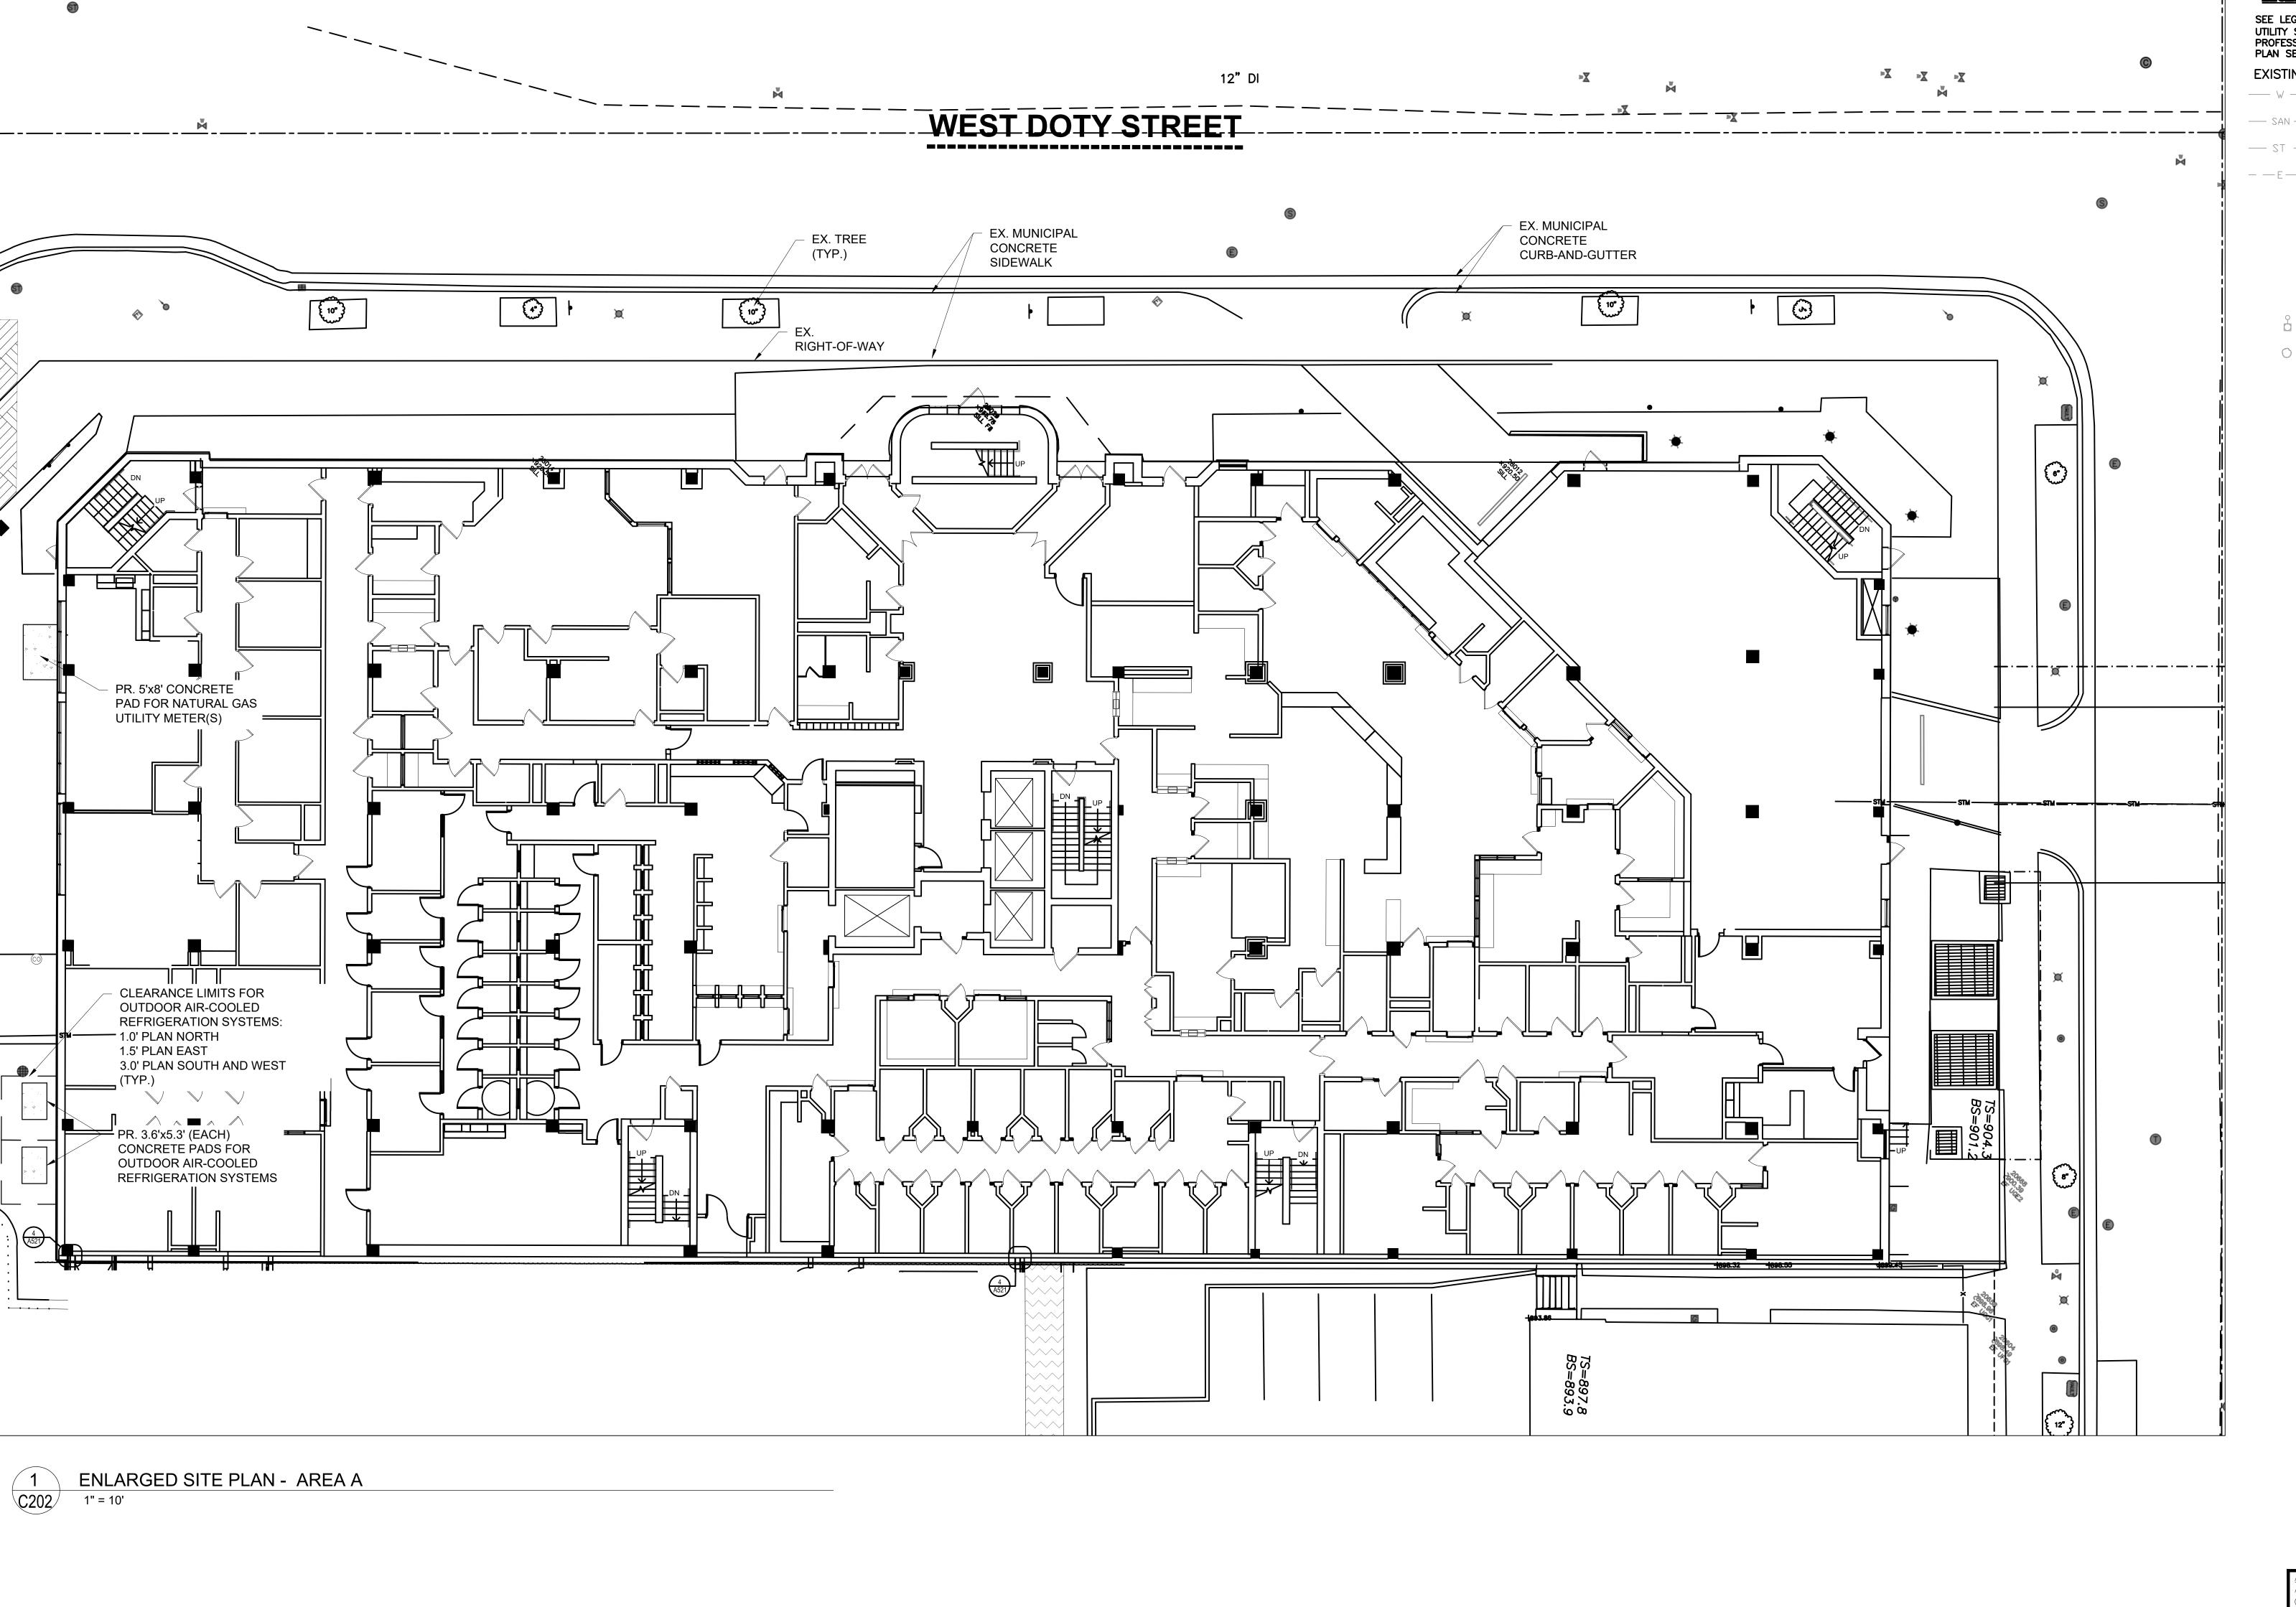

#### SITE AND GRADING PLAN NOTES:

- 1. CONFORM TO CITY OF MADISON STANDARD SPECIFICATIONS FOR PUBLIC WORKS CONSTRUCTION (LATEST EDITION).
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- DRIVEWAYS: CONFORM TO CITY OF MADISON STANDARD DETAIL DRAWING 3.02 "MADISON STANDARD CURB CUT DETAILS" AND STANDARD DETAIL DRAWING 3.09 "MADISON STANDARD COMMERCIAL DRIVE DETAILS." CONFORM TO COMMERCIAL DETAIL AND TO DRIVEWAY SECTION TYPE "A" CONCRETE CURB & GUTTER DETAIL IN DRAWING 3.02.
- 7. ALL PAVEMENT WORK IN THE PUBLIC ROW WILL BE DESIGNED BY THE CITY OF MADISON ENGINEERING DEPARTMENT.

#### <u>LEGEND</u>

SEE LEGEND ON "BOUNDARY, TOPOGRAPHIC AND UTILITY SURVEY" DATED 05/28/20 PREPARED BY JSD

ROFESSIONAL LAN SET, FOR	SERVICES,	INC.,	PROVIDED	
XISTING	PROPOS	SED		
— W ——	— v -		WATER	Ρ

SANITARY PIPE — ST — STORM PIPE ELECTRICAL CONDUIT

WATER VALVE

SANITARY CLEANOUT ROOF DRAIN

CONNECTION **HYDRANT** LIGHT POLE LIGHT POLE

> PROPOSED MUNICIPAL CONCRETE SIDEWALK (DETAIL 2/C203 AND MADISON SDD 4.02) PROPOSED MUNICIPAL CONCRETE DRIVEWAY (DETAIL 3/C203 AND MADISON SDD 3.02)

PROPOSED PERMEABLE CONCRETE DRIVEWAY **PAVEMENT** 

(DETAIL 4/C203) PROPOSED CONCRETE SIDEWALK PAVEMENT (DETAIL 5/C203)

> PROPOSED MUNICIPAL CONCRETE CURB-AND-GUTTER,

PROPOSED TREE TRENCH

TO OBTAIN LOCATIONS OF PARTICIPTANTS UNDERGROUND FACILITIES

BEFORE YOU DIG IN

CALL DIGGERS HOTLINE
1-800-242-8511
TOLL FREE
WIS STATUTE 182.0175(1974)
REQUIRES MIN. 3 WORK DAYS

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TLITIES WITHIN THE CONSTRUCTION AREA SHOUL

**KEY PLAN** 

BE COMPLETED.

PLAN

TRUE NORTH

PROPOSED ASPHALT ROADWAY PAVEMENT PROPOSED TURF

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PUBLIC WORKS, HIGHWAY & TRANSPORTATION 1919 ALLIANT ENERGY CENTER WAY MADISON, WI 53713

PROJECT NO. 318025


/ Jail Consolidation <sup>-</sup> Addition & Public S ovation Dane Cour South Tow Building Re 115 W. Doty Stree Madison, WI 5370


LAND USE APPLICATION

NOT FOR CONSTRUCTION

M&H NO.: 4215400-161957.01 DATE: 04/07/2022 DESIGNED BY: BRB DRAWN BY: RH CHECKED BY: RJ DO NOT SCALE DRAWINGS

SHEET CONTENTS **ENLARGED SITE** PLAN - AREA A

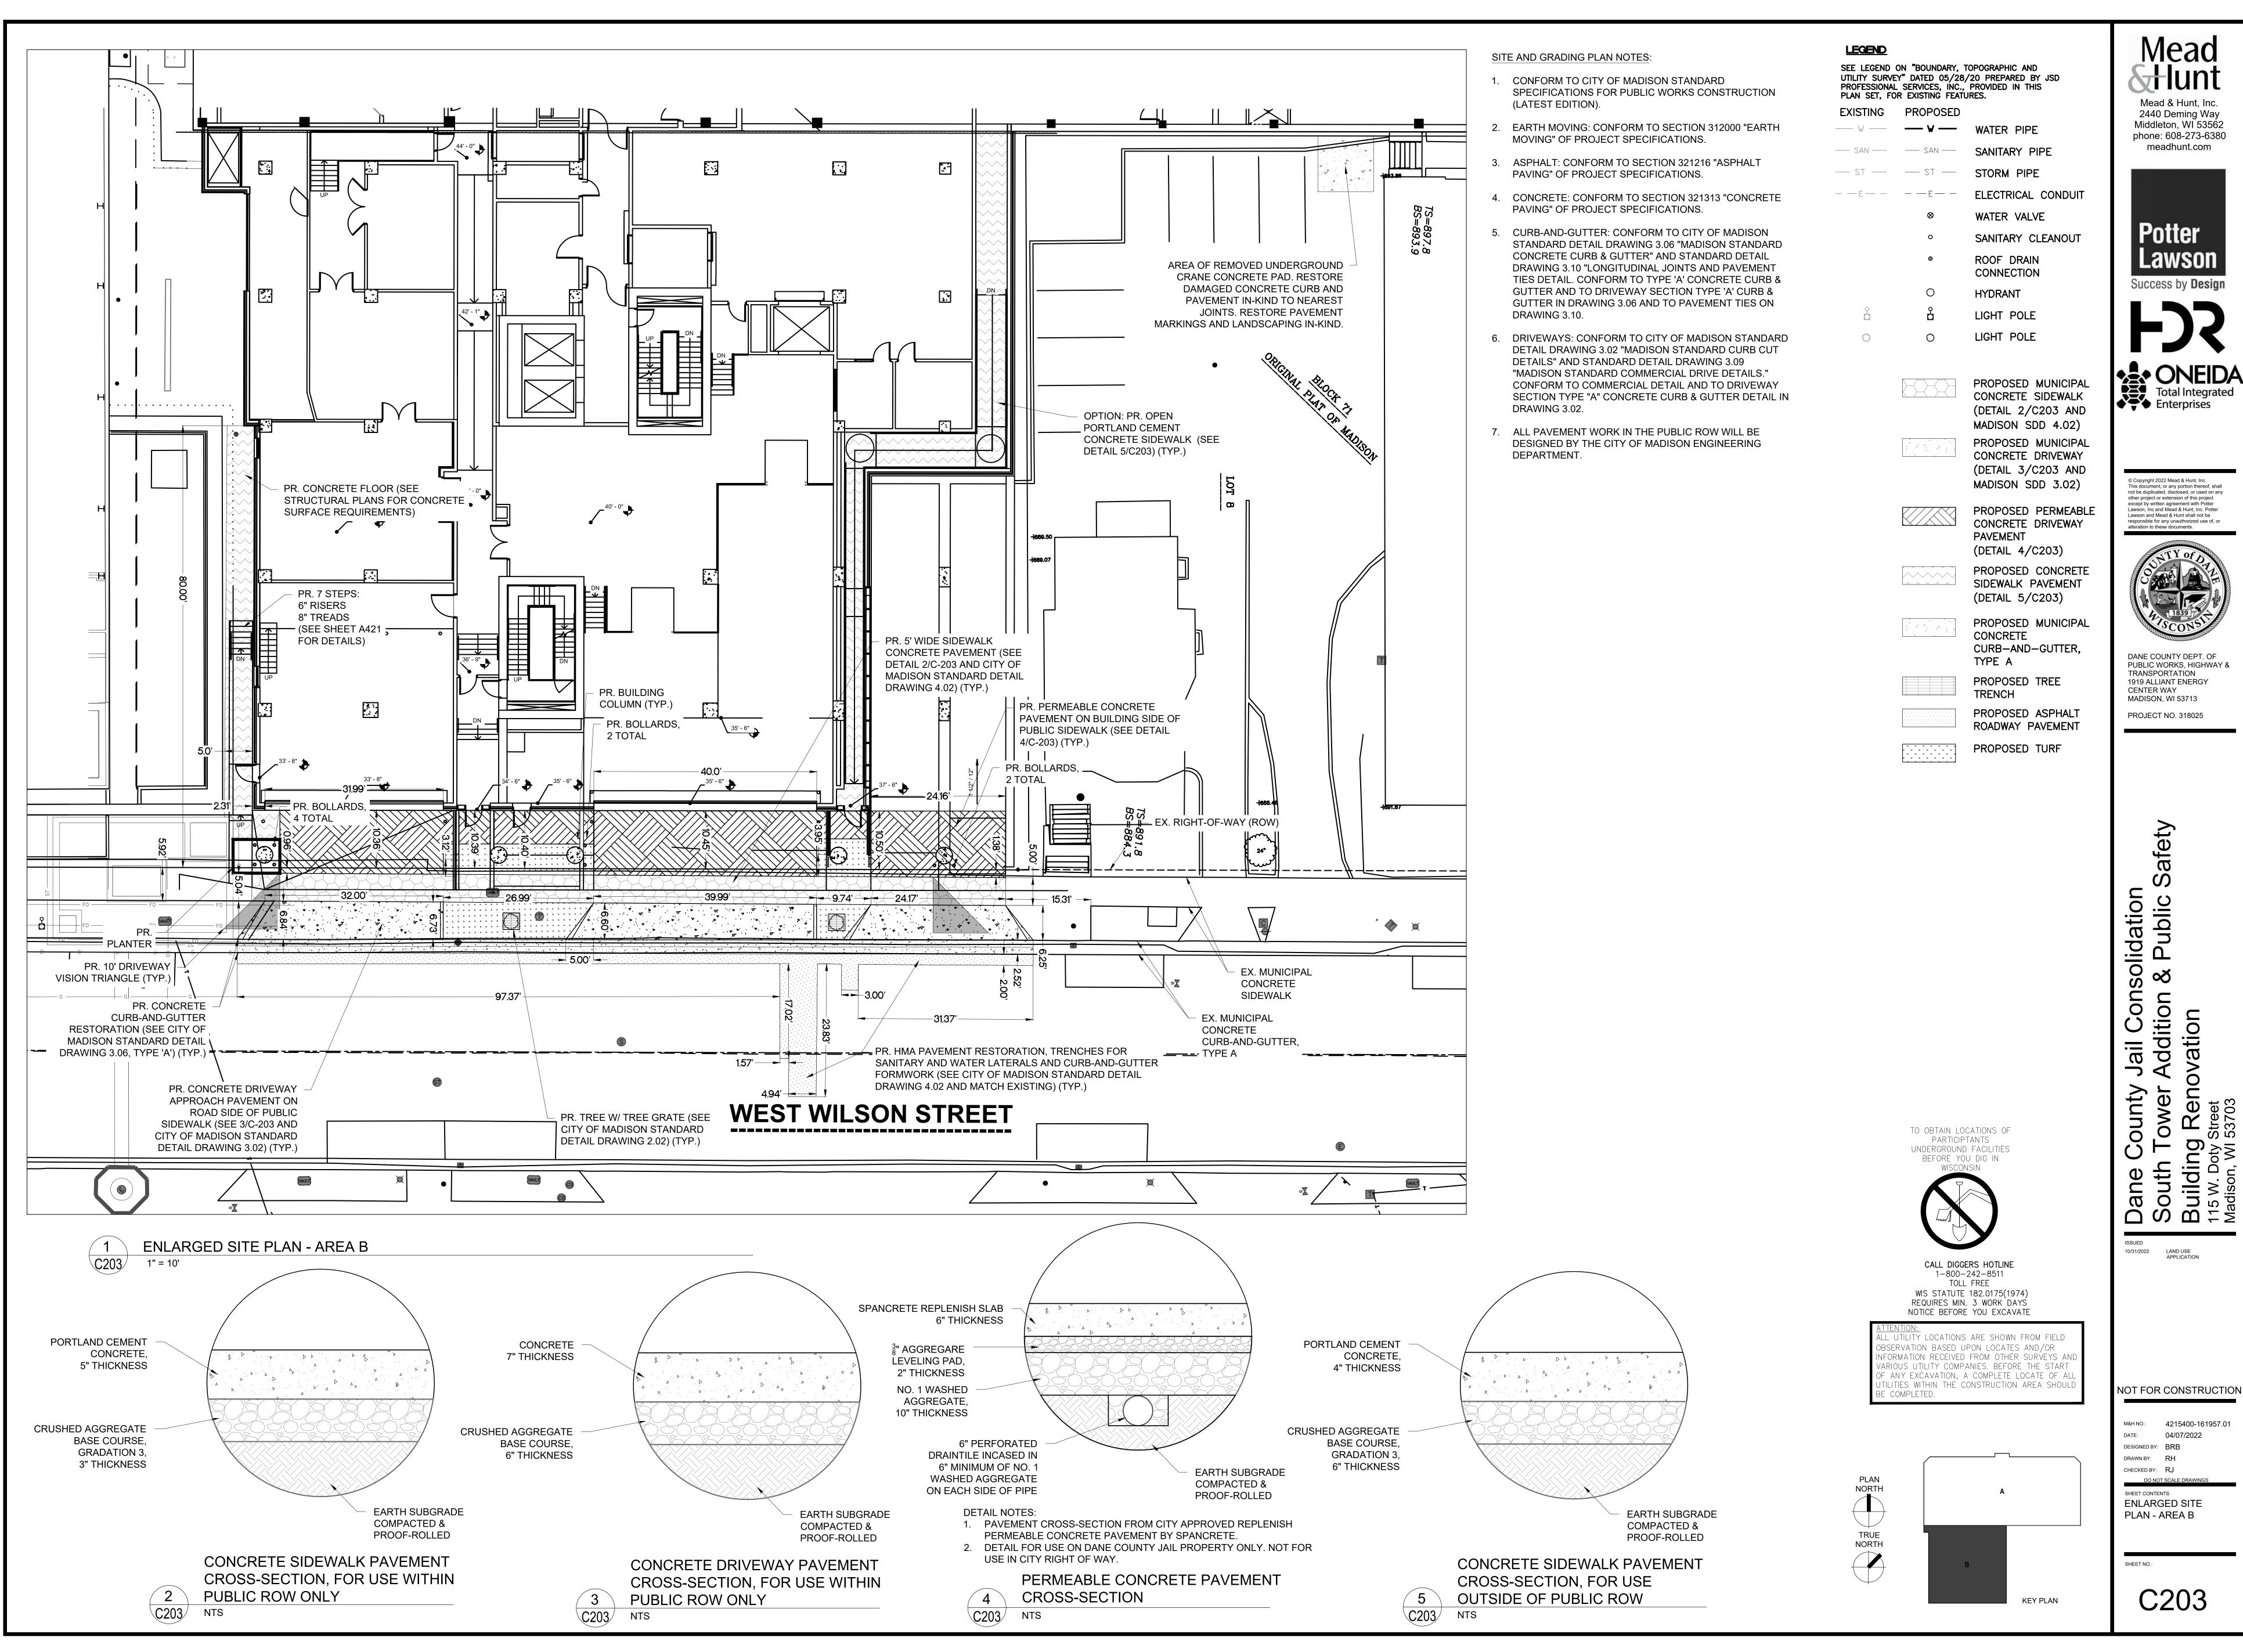

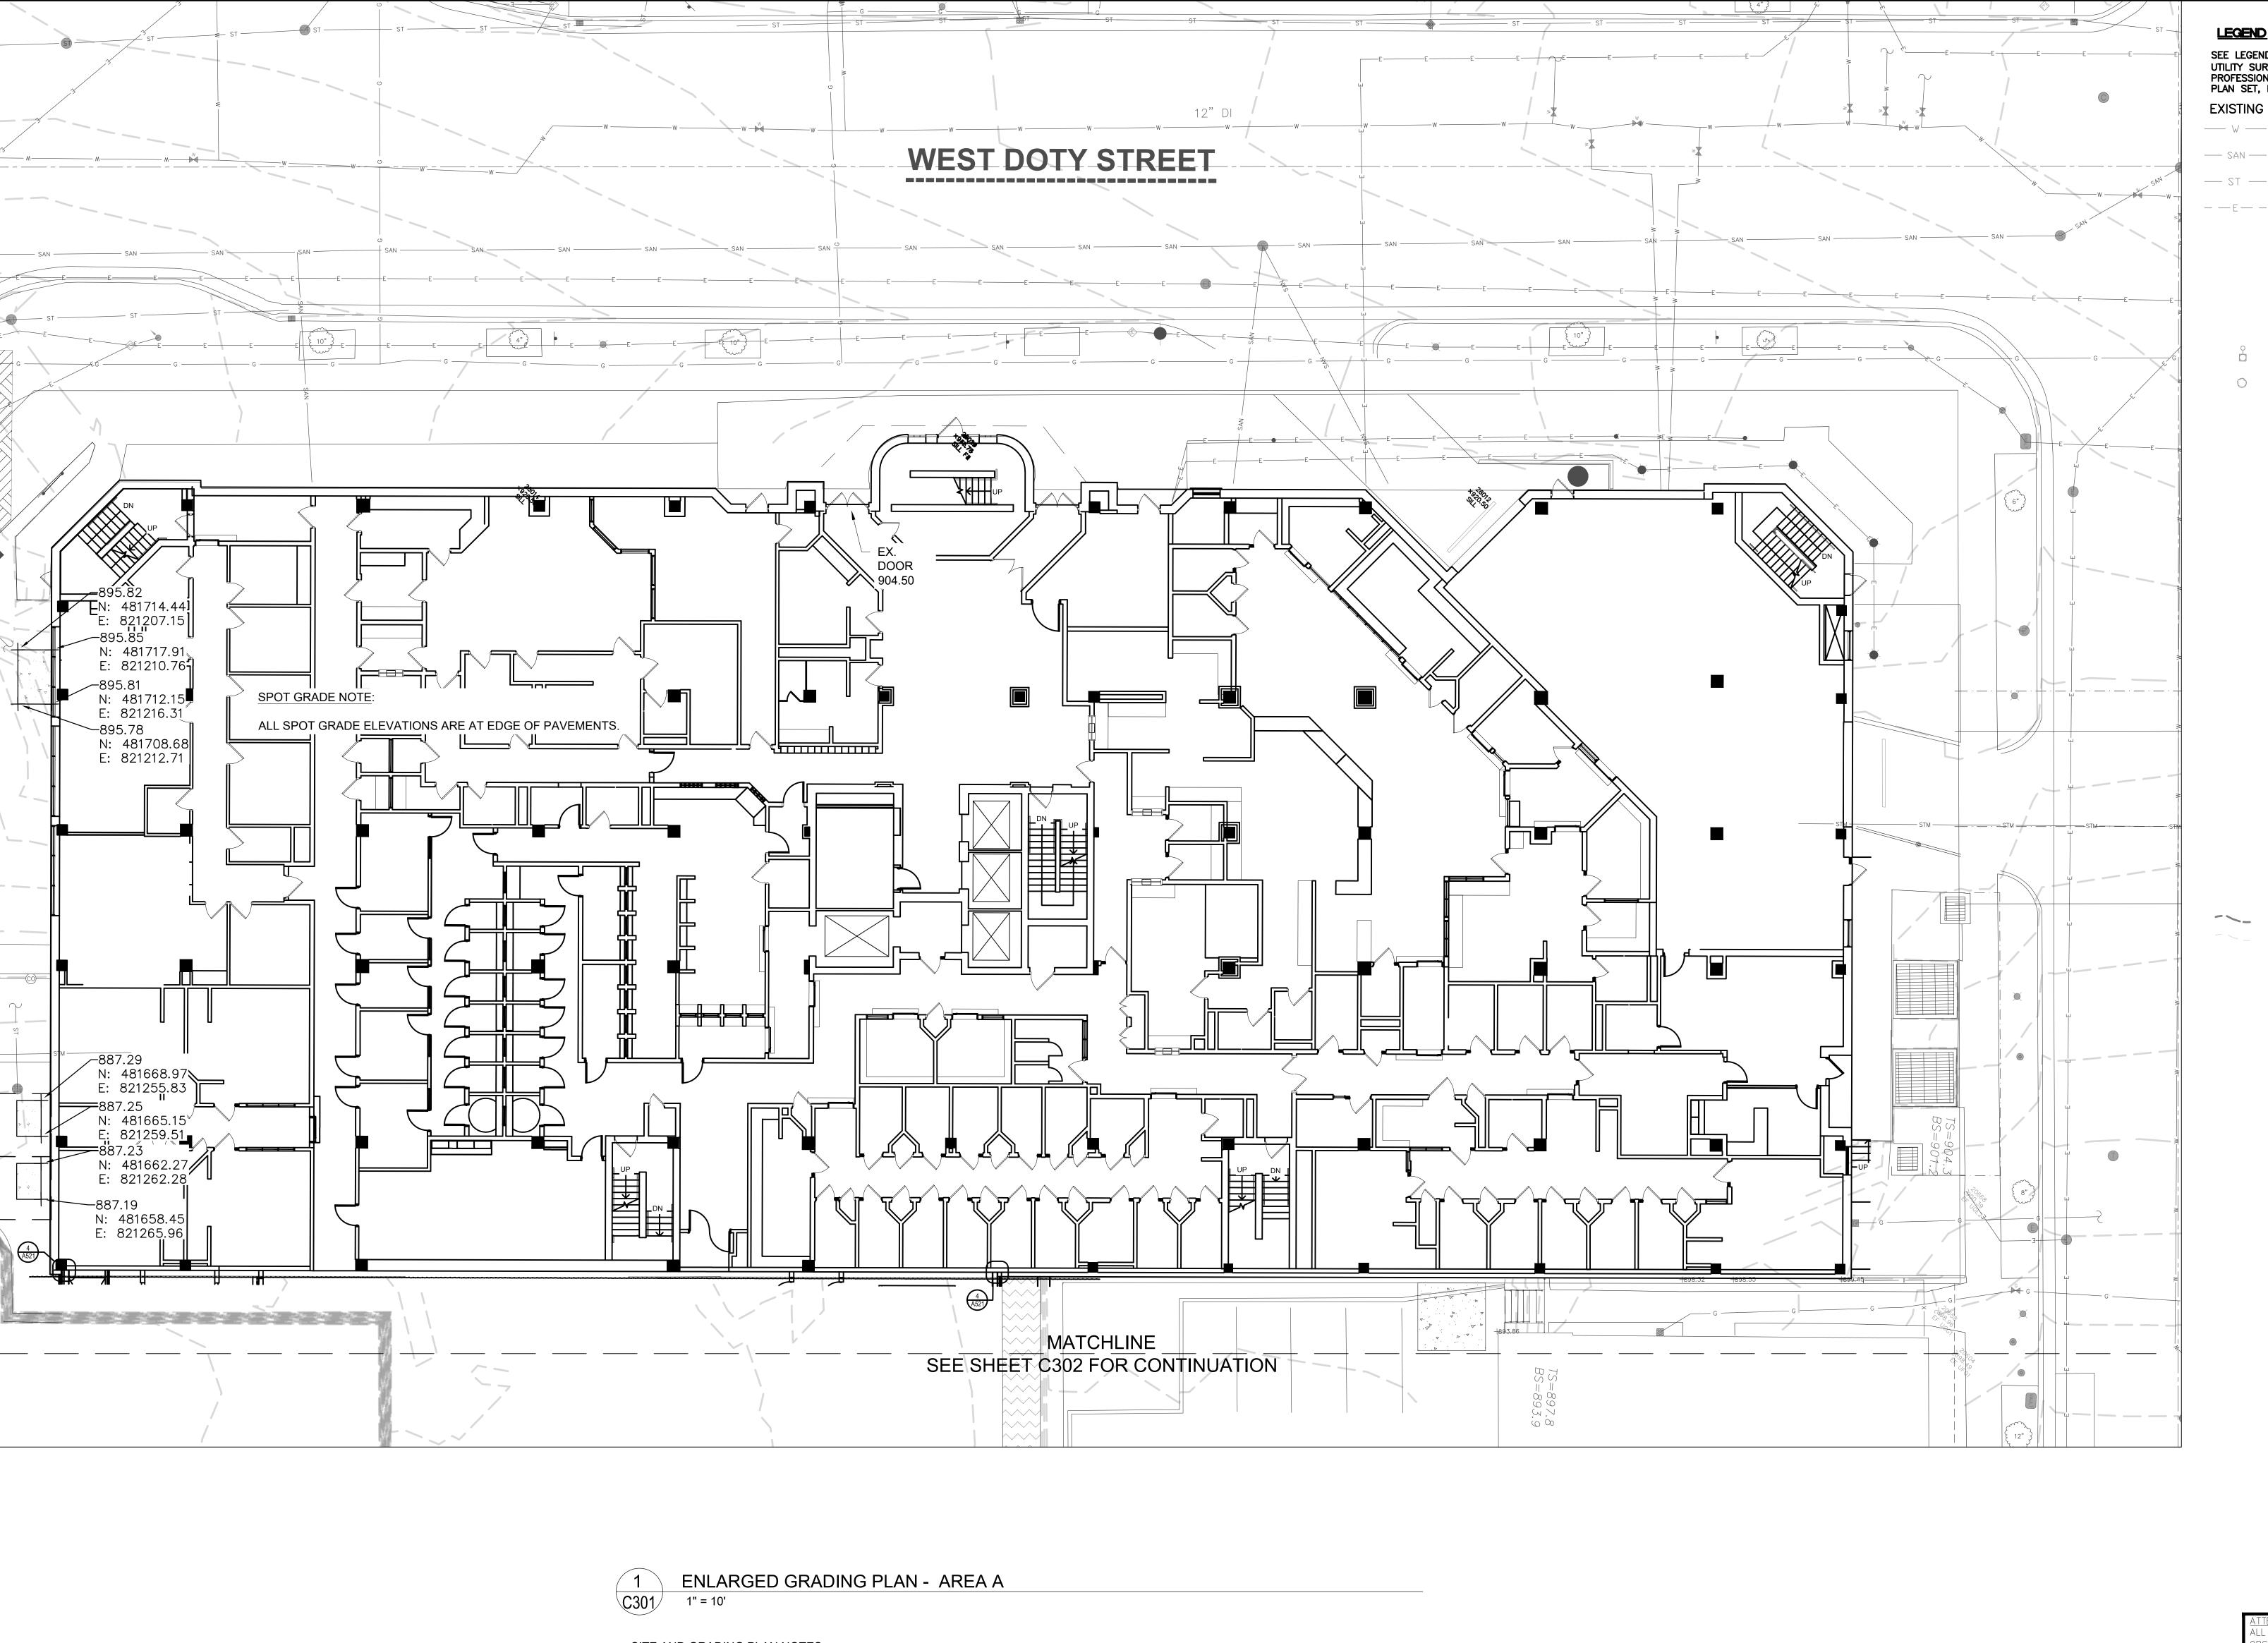

#### SITE AND GRADING PLAN NOTES:

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SEE LEGEND ON "BOUNDARY, TOPOGRAPHIC AND UTILITY SURVEY" DATED 05/28/20 PREPARED BY JSD

PROFESSIONAL SERVICES, INC., PROVIDED IN THIS PLAN SET, FOR EXISTING FEATURES.

— ₩ — WATER PIPE SANITARY PIPE STORM PIPE

ELECTRICAL CONDUIT WATER VALVE

SANITARY CLEANOUT ROOF DRAIN CONNECTION

**HYDRANT** LIGHT POLE LIGHT POLE

> PROPOSED MUNICIPAL CONCRETE SIDEWALK (DETAIL 2/C203 AND MADISON SDD 4.02) PROPOSED MUNICIPAL CONCRETE DRIVEWAY (DETAIL 3/C203 AND

PROPOSED PERMEABLE CONCRETE DRIVEWAY **PAVEMENT** 

(DETAIL 4/C203)

MADISON SDD 3.02)

PROPOSED CONCRETE SIDEWALK PAVEMENT (DETAIL 5/C203)

PROPOSED MUNICIPAL CONCRETE CURB-AND-GUTTER,

PROPOSED TREE TRENCH PROPOSED ASPHALT ROADWAY PAVEMENT PROPOSED TURF

MAJOR CONTOUR

GRADE ELEVATION WITH NORTHING & EASTING XXX.XX (M) PROPOSED SPOT


GRADE ELEVATION

TO OBTAIN LOCATIONS OF PARTICIPTANTS UNDERGROUND FACILITIES BEFORE YOU DIG IN



CALL DIGGERS HOTLINE 1-800-242-8511 TOLL FREE WIS STATUTE 182.0175(1974)
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DANE COUNTY DEPT. OF PUBLIC WORKS, HIGHWAY & TRANSPORTATION 1919 ALLIANT ENERGY CENTER WAY MADISON, WI 53713

PROJECT NO. 318025

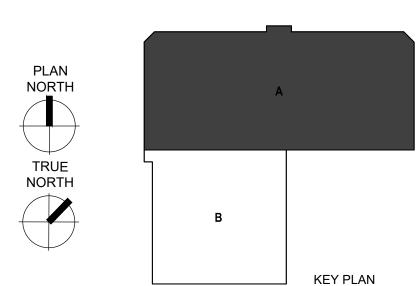MINOR CONTOUR PROPOSED SPOT

(MATCH EXISTING) WITH NORTHING & EASTING


/ Jail Consolidation - Addition & Public S ovation Dane Co South Tc Building

LAND USE APPLICATION

NOT FOR CONSTRUCTION

M&H NO.: 4215400-161957.01 DATE: 04/07/2022 DESIGNED BY: BRB DRAWN BY: RH CHECKED BY: RJ

DO NOT SCALE DRAWINGS SHEET CONTENTS ENLARGED GRADING PLAN - AREA A

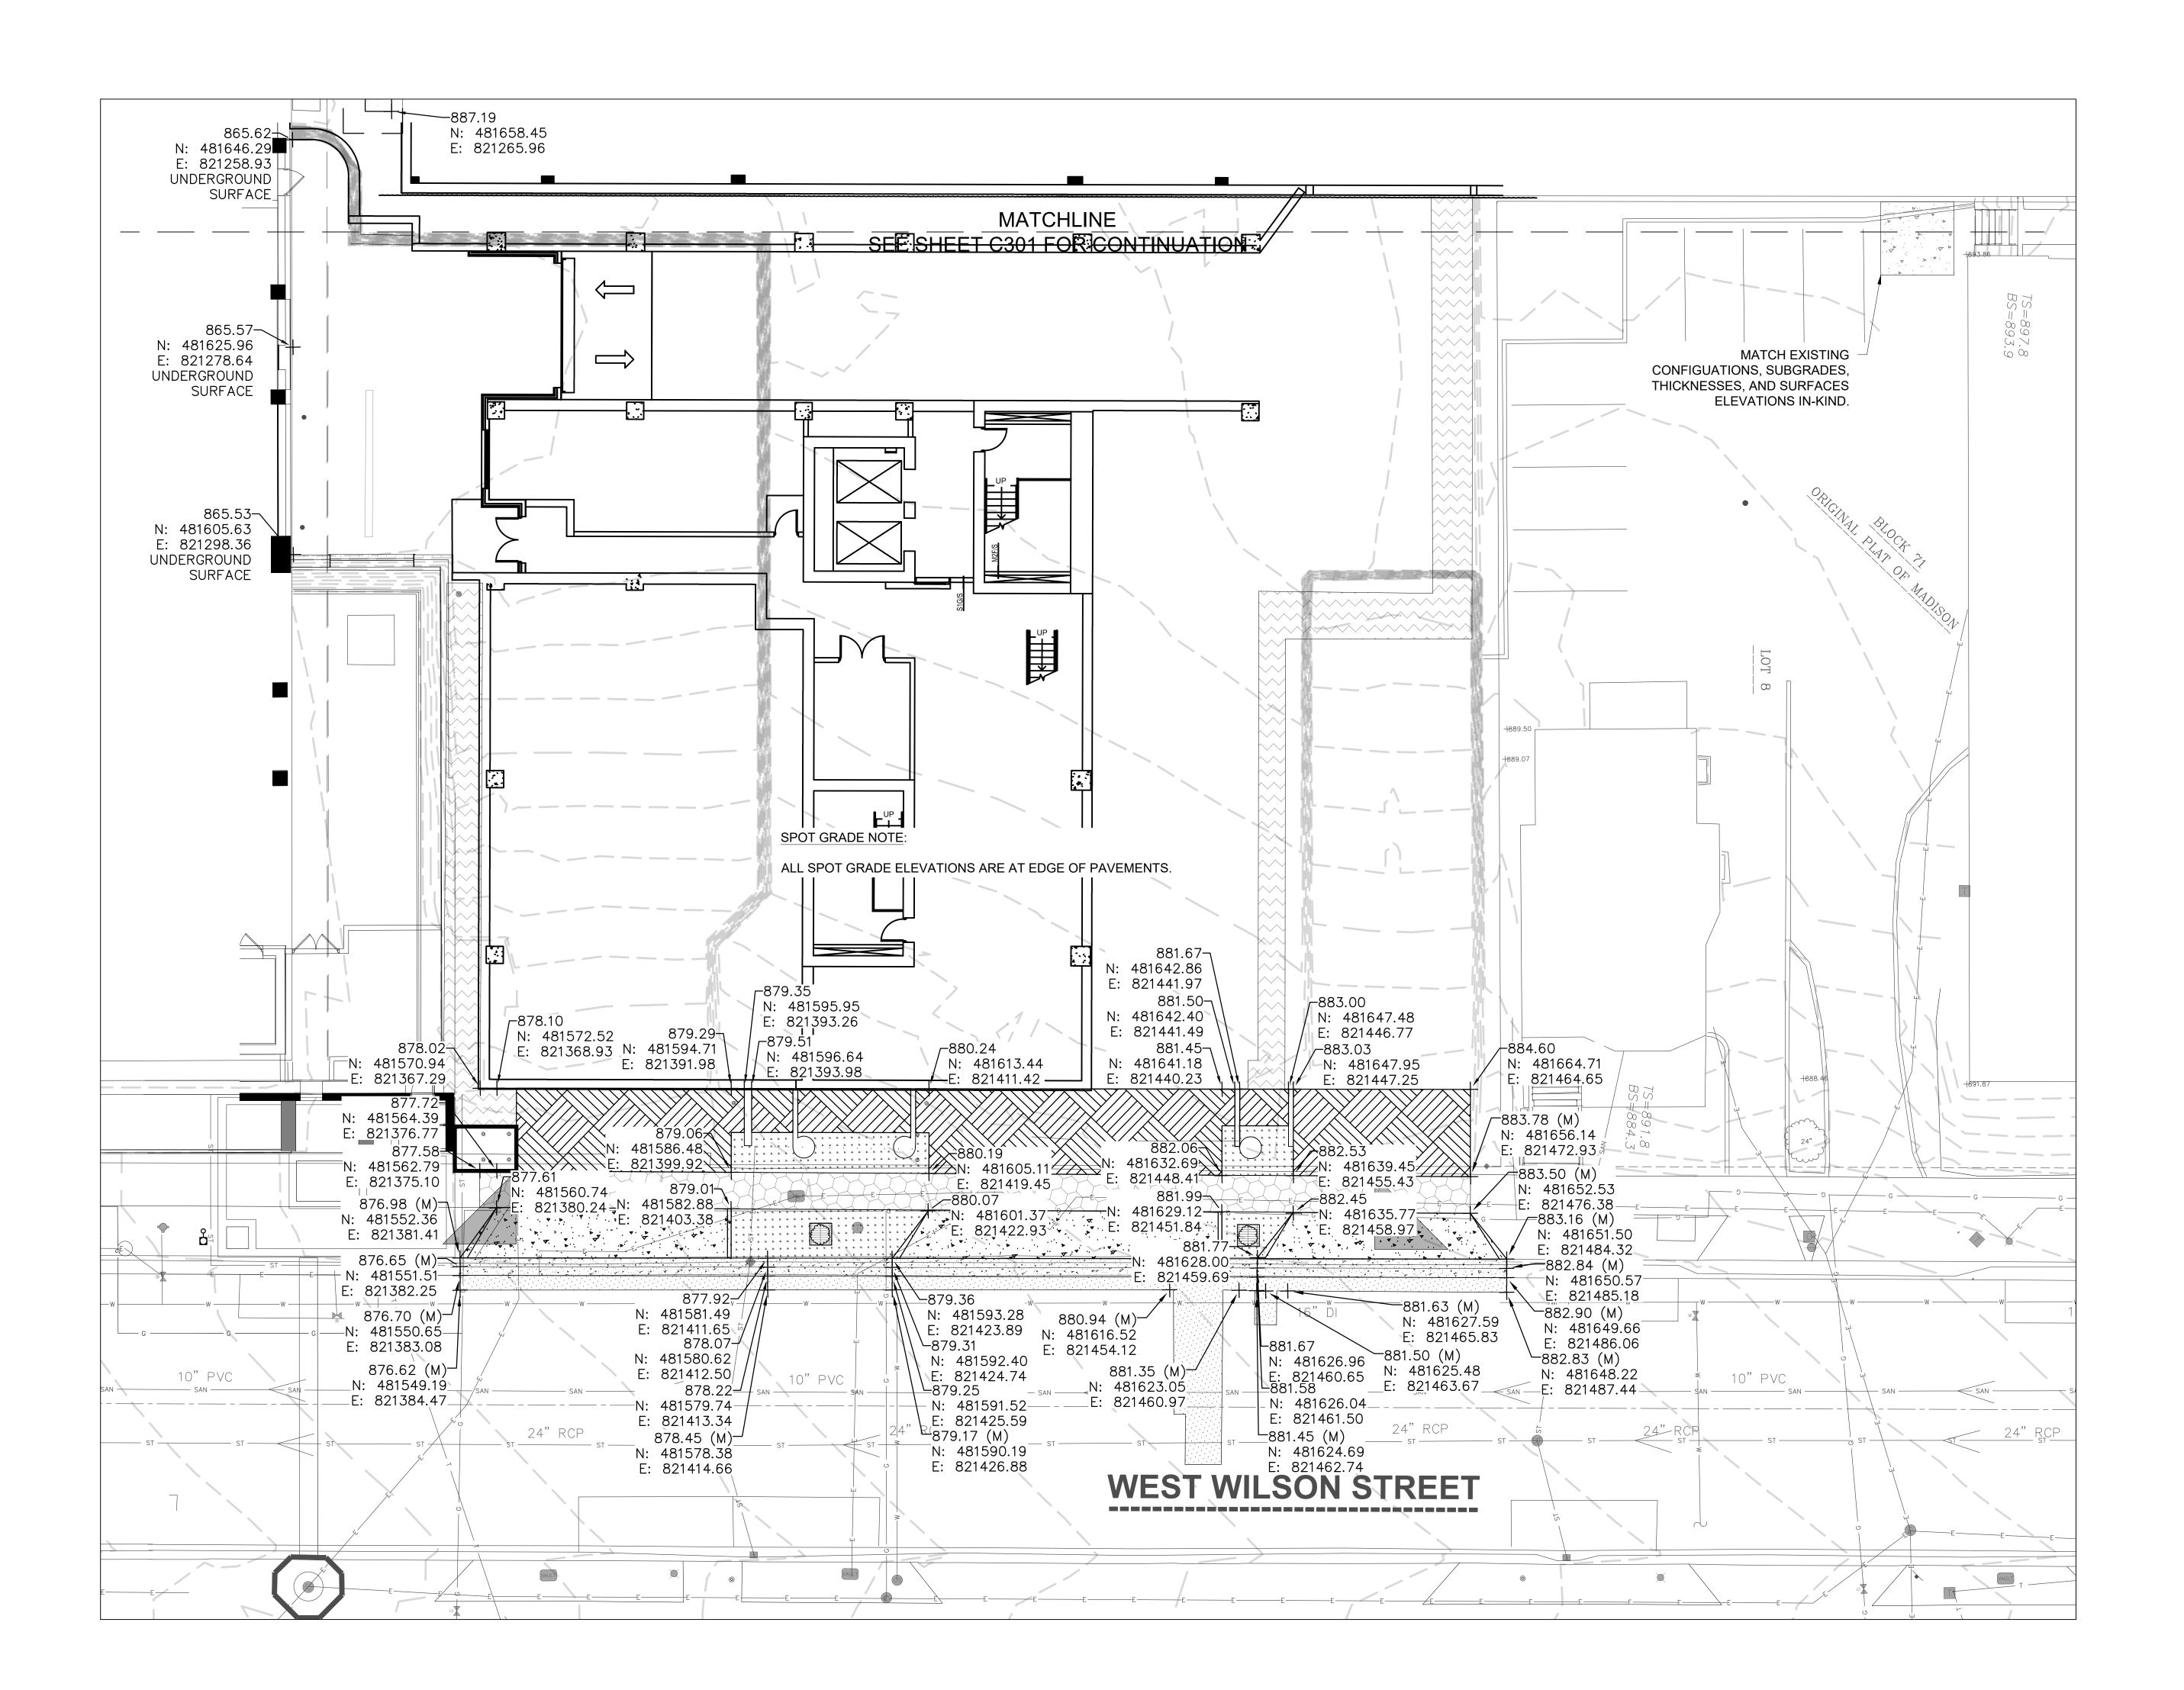

#### ENLARGED GRADING PLAN - SUB-BASEMENT 2 - AREA B C302 1" = 10'

#### SITE AND GRADING PLAN NOTES:

- 1. CONFORM TO CITY OF MADISON STANDARD SPECIFICATIONS FOR PUBLIC WORKS CONSTRUCTION (LATEST EDITION).
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#### **LEGEND**

SEE LEGEND ON "BOUNDARY, TOPOGRAPHIC AND UTILITY SURVEY" DATED 05/28/20 PREPARED BY JSD PROFESSIONAL SERVICES, INC., PROVIDED IN THIS

PLAN SET,	•	•	
<b>EXISTING</b>	PROPOS	SED	

WATER PIPE — **v** — SANITARY PIPE STORM PIPE ELECTRICAL CONDUIT

> WATER VALVE SANITARY CLEANOUT

ROOF DRAIN CONNECTION **HYDRANT** LIGHT POLE

> PROPOSED MUNICIPAL CONCRETE SIDEWALK (DETAIL 2/C203 AND MADISON SDD 4.02) PROPOSED MUNICIPAL CONCRETE DRIVEWAY (DETAIL 3/C203 AND

> > MADISON SDD 3.02)

LIGHT POLE

PROPOSED PERMEABLE CONCRETE DRIVEWAY **PAVEMENT** (DETAIL 4/C203)

PROPOSED CONCRETE SIDEWALK PAVEMENT (DETAIL 5/C203)

PROPOSED MUNICIPAL CONCRETE CURB-AND-GUTTER,

PROPOSED ASPHALT ROADWAY PAVEMENT PROPOSED TURF

PROPOSED TREE

TRENCH

MAJOR CONTOUR

PROPOSED SPOT XXX.XX (M) PROPOSED SPOT

GRADE ELEVATION

Mead Mead & Hunt, Inc. 2440 Deming Way Middleton, WI 53562 phone: 608-273-6380 meadhunt.com





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DANE COUNTY DEPT. OF PUBLIC WORKS, HIGHWAY & TRANSPORTATION 1919 ALLIANT ENERGY **CENTER WAY** MADISON, WI 53713

PROJECT NO. 318025

MINOR CONTOUR GRADE ELEVATION WITH NORTHING & EASTING


(MATCH EXISTING) WITH NORTHING & EASTING

/ Jail Consolidation - Addition & Public S ovation Dane Co South To Building TO OBTAIN LOCATIONS OF PARTICIPTANTS UNDERGROUND FACILITIES BEFORE YOU DIG IN

CALL DIGGERS HOTLINE 1-800-242-8511 TOLL FREE WIS STATUTE 182.0175(1974) REQUIRES MIN. 3 WORK DAYS NOTICE BEFORE YOU EXCAVATE

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NOT FOR CONSTRUCTION


LAND USE APPLICATION

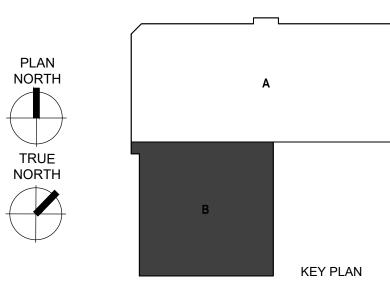M&H NO.: 4215400-161957.01 DATE: 04/07/2022 DESIGNED BY: BRB DRAWN BY: RH CHECKED BY: RJ

SHEET CONTENTS ENLARGED GRADING SUB-BASEMENT 2 -AREA B

DO NOT SCALE DRAWINGS

SHEET NO.:

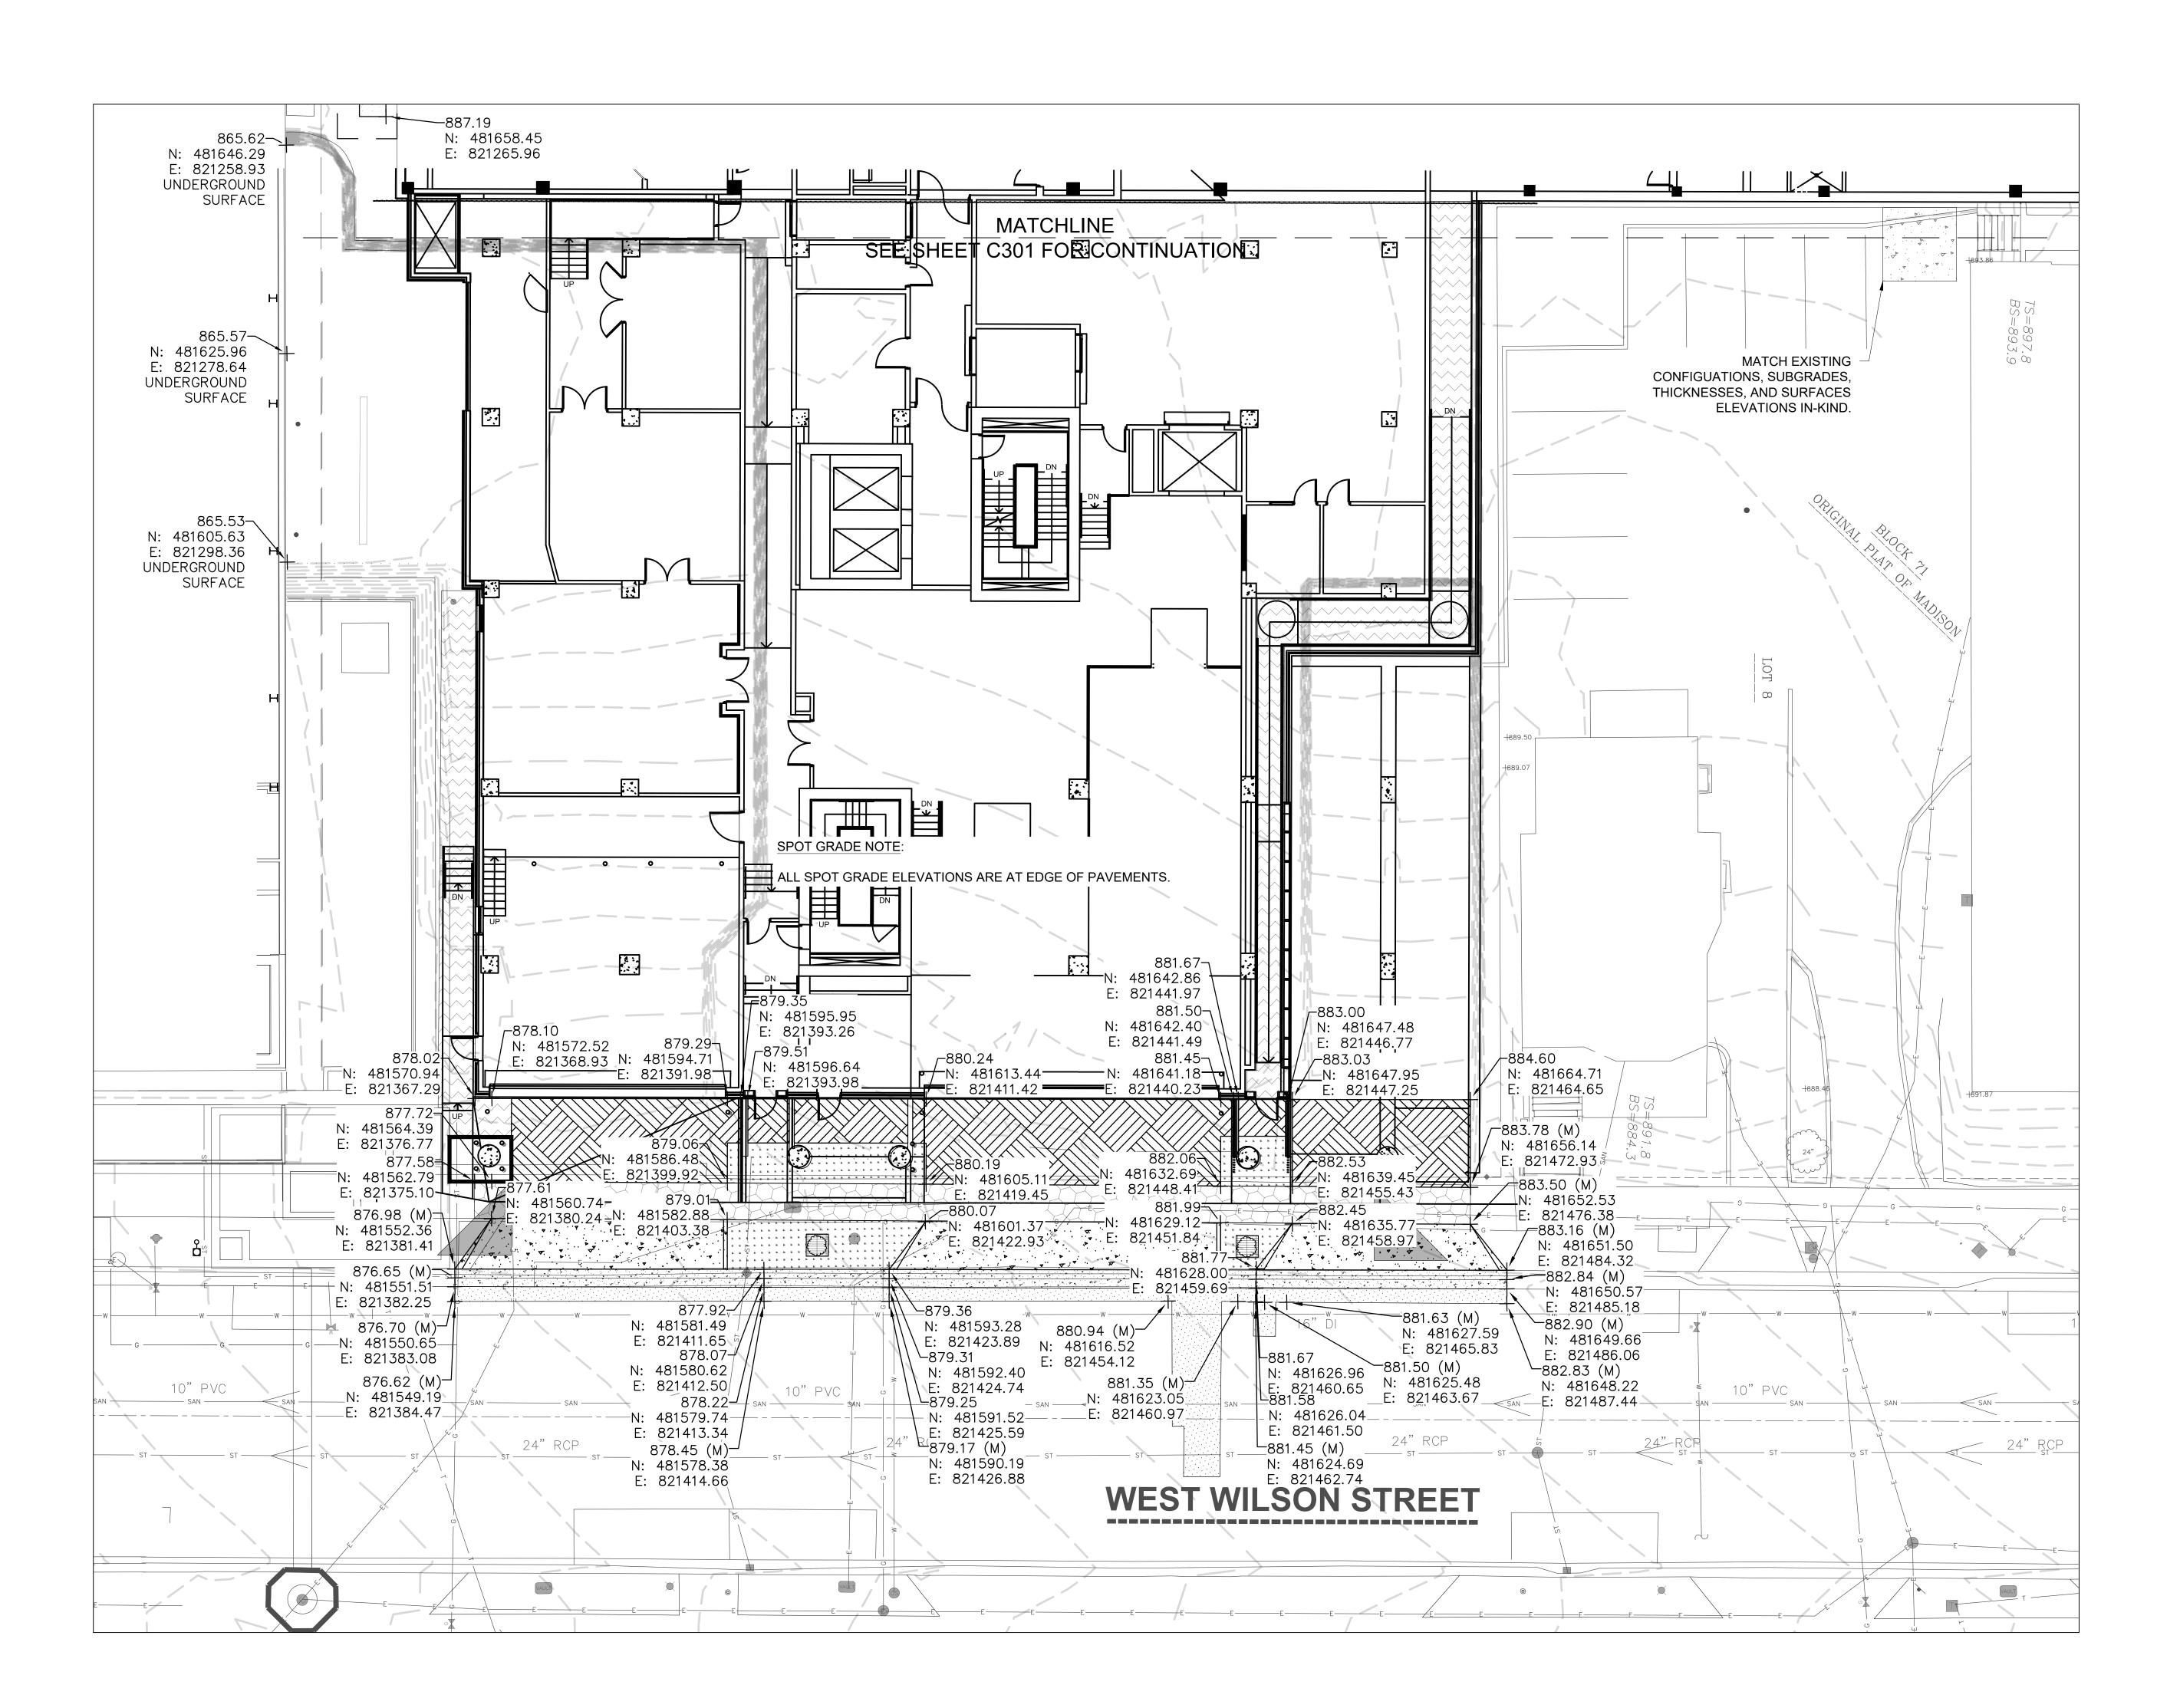



#### SITE AND GRADING PLAN NOTES:

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- 4. CONCRETE: CONFORM TO SECTION 321313 "CONCRETE PAVING" OF PROJECT SPECIFICATIONS.
- 5. CURB-AND-GUTTER: CONFORM TO CITY OF MADISON STANDARD DETAIL DRAWING 3.06 "MADISON STANDARD CONCRETE CURB & GUTTER" AND STANDARD DETAIL DRAWING 3.10 "LONGITUDINAL JOINTS AND PAVEMENT TIES DETAIL. CONFORM TO TYPE 'A' CONCRETE CURB & GUTTER AND TO DRIVEWAY SECTION TYPE 'A' CURB & GUTTER IN DRAWING 3.06 AND TO PAVEMENT TIES ON DRAWING 3.10.
- 6. DRIVEWAYS: CONFORM TO CITY OF MADISON STANDARD DETAIL DRAWING 3.02 "MADISON STANDARD CURB CUT DETAILS" AND STANDARD DETAIL DRAWING 3.09 "MADISON STANDARD COMMERCIAL DRIVE DETAILS." CONFORM TO COMMERCIAL DETAIL AND TO DRIVEWAY SECTION TYPE "A" CONCRETE CURB & GUTTER DETAIL IN DRAWING 3.02.

#### **LEGEND**

SEE LEGEND ON "BOUNDARY, TOPOGRAPHIC AND UTILITY SURVEY" DATED 05/28/20 PREPARED BY JSD PROFESSIONAL SERVICES, INC., PROVIDED IN THIS

PLAN SET, FOR EXISTING FEATURES. PROPOSED

─ V ─ WATER PIPE SANITARY PIPE — ZT — — ZT — STORM PIPE

ELECTRICAL CONDUIT WATER VALVE

SANITARY CLEANOUT ROOF DRAIN CONNECTION

**HYDRANT** LIGHT POLE LIGHT POLE

> PROPOSED MUNICIPAL CONCRETE SIDEWALK (DETAIL 2/C203 AND MADISON SDD 4.02) PROPOSED MUNICIPAL

CONCRETE DRIVEWAY (DETAIL 3/C203 AND MADISON SDD 3.02) PROPOSED PERMEABLE

CONCRETE DRIVEWAY

(DETAIL 5/C203)

**PAVEMENT** (DETAIL 4/C203) PROPOSED CONCRETE SIDEWALK PAVEMENT

PROPOSED MUNICIPAL CONCRETE CURB-AND-GUTTER.

PROPOSED TREE TRENCH PROPOSED ASPHALT ROADWAY PAVEMENT

PROPOSED TURF

PROPOSED SPOT GRADE ELEVATION WITH NORTHING & EASTING

GRADE ELEVATION (MATCH EXISTING) WITH NORTHING & EASTING

Mead

Mead & Hunt, Inc. 2440 Deming Way Middleton, WI 53562 phone: 608-273-6380 meadhunt.com



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DANE COUNTY DEPT. OF PUBLIC WORKS, HIGHWAY & TRANSPORTATION 1919 ALLIANT ENERGY **CENTER WAY** MADISON, WI 53713

PROJECT NO. 318025

MAJOR CONTOUR MINOR CONTOUR

XXX.XX (M) PROPOSED SPOT

/ Jail Consolidation - Addition & Public S ovation Dane Co South To Building


LAND USE APPLICATION

NOT FOR CONSTRUCTION

M&H NO.: 4215400-161957.01 DATE: 04/07/2022 DESIGNED BY: BRB DRAWN BY: RH CHECKED BY: RJ


DO NOT SCALE DRAWINGS SHEET CONTENTS **GRADING PLAN -**SUB-BASEMENT -


AREA B

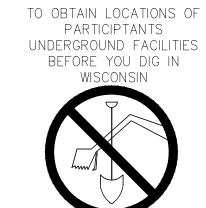

CALL DIGGERS HOTLINE 1-800-242-8511 TOLL FREE WIS STATUTE 182.0175(1974) REQUIRES MIN. 3 WORK DAYS NOTICE BEFORE YOU EXCAVATE

L UTILITY LOCATIONS ARE SHOWN FROM FIELD DBSERVATION BASED UPON LOCATES AND/OR VARIOUS UTILITY COMPANIES. BEFORE THE START OF ANY EXCAVATION, A COMPLETE LOCATE OF ALL UTILITIES WITHIN THE CONSTRUCTION AREA SHOULD BE COMPLETED.

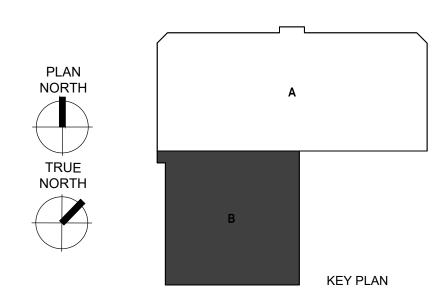

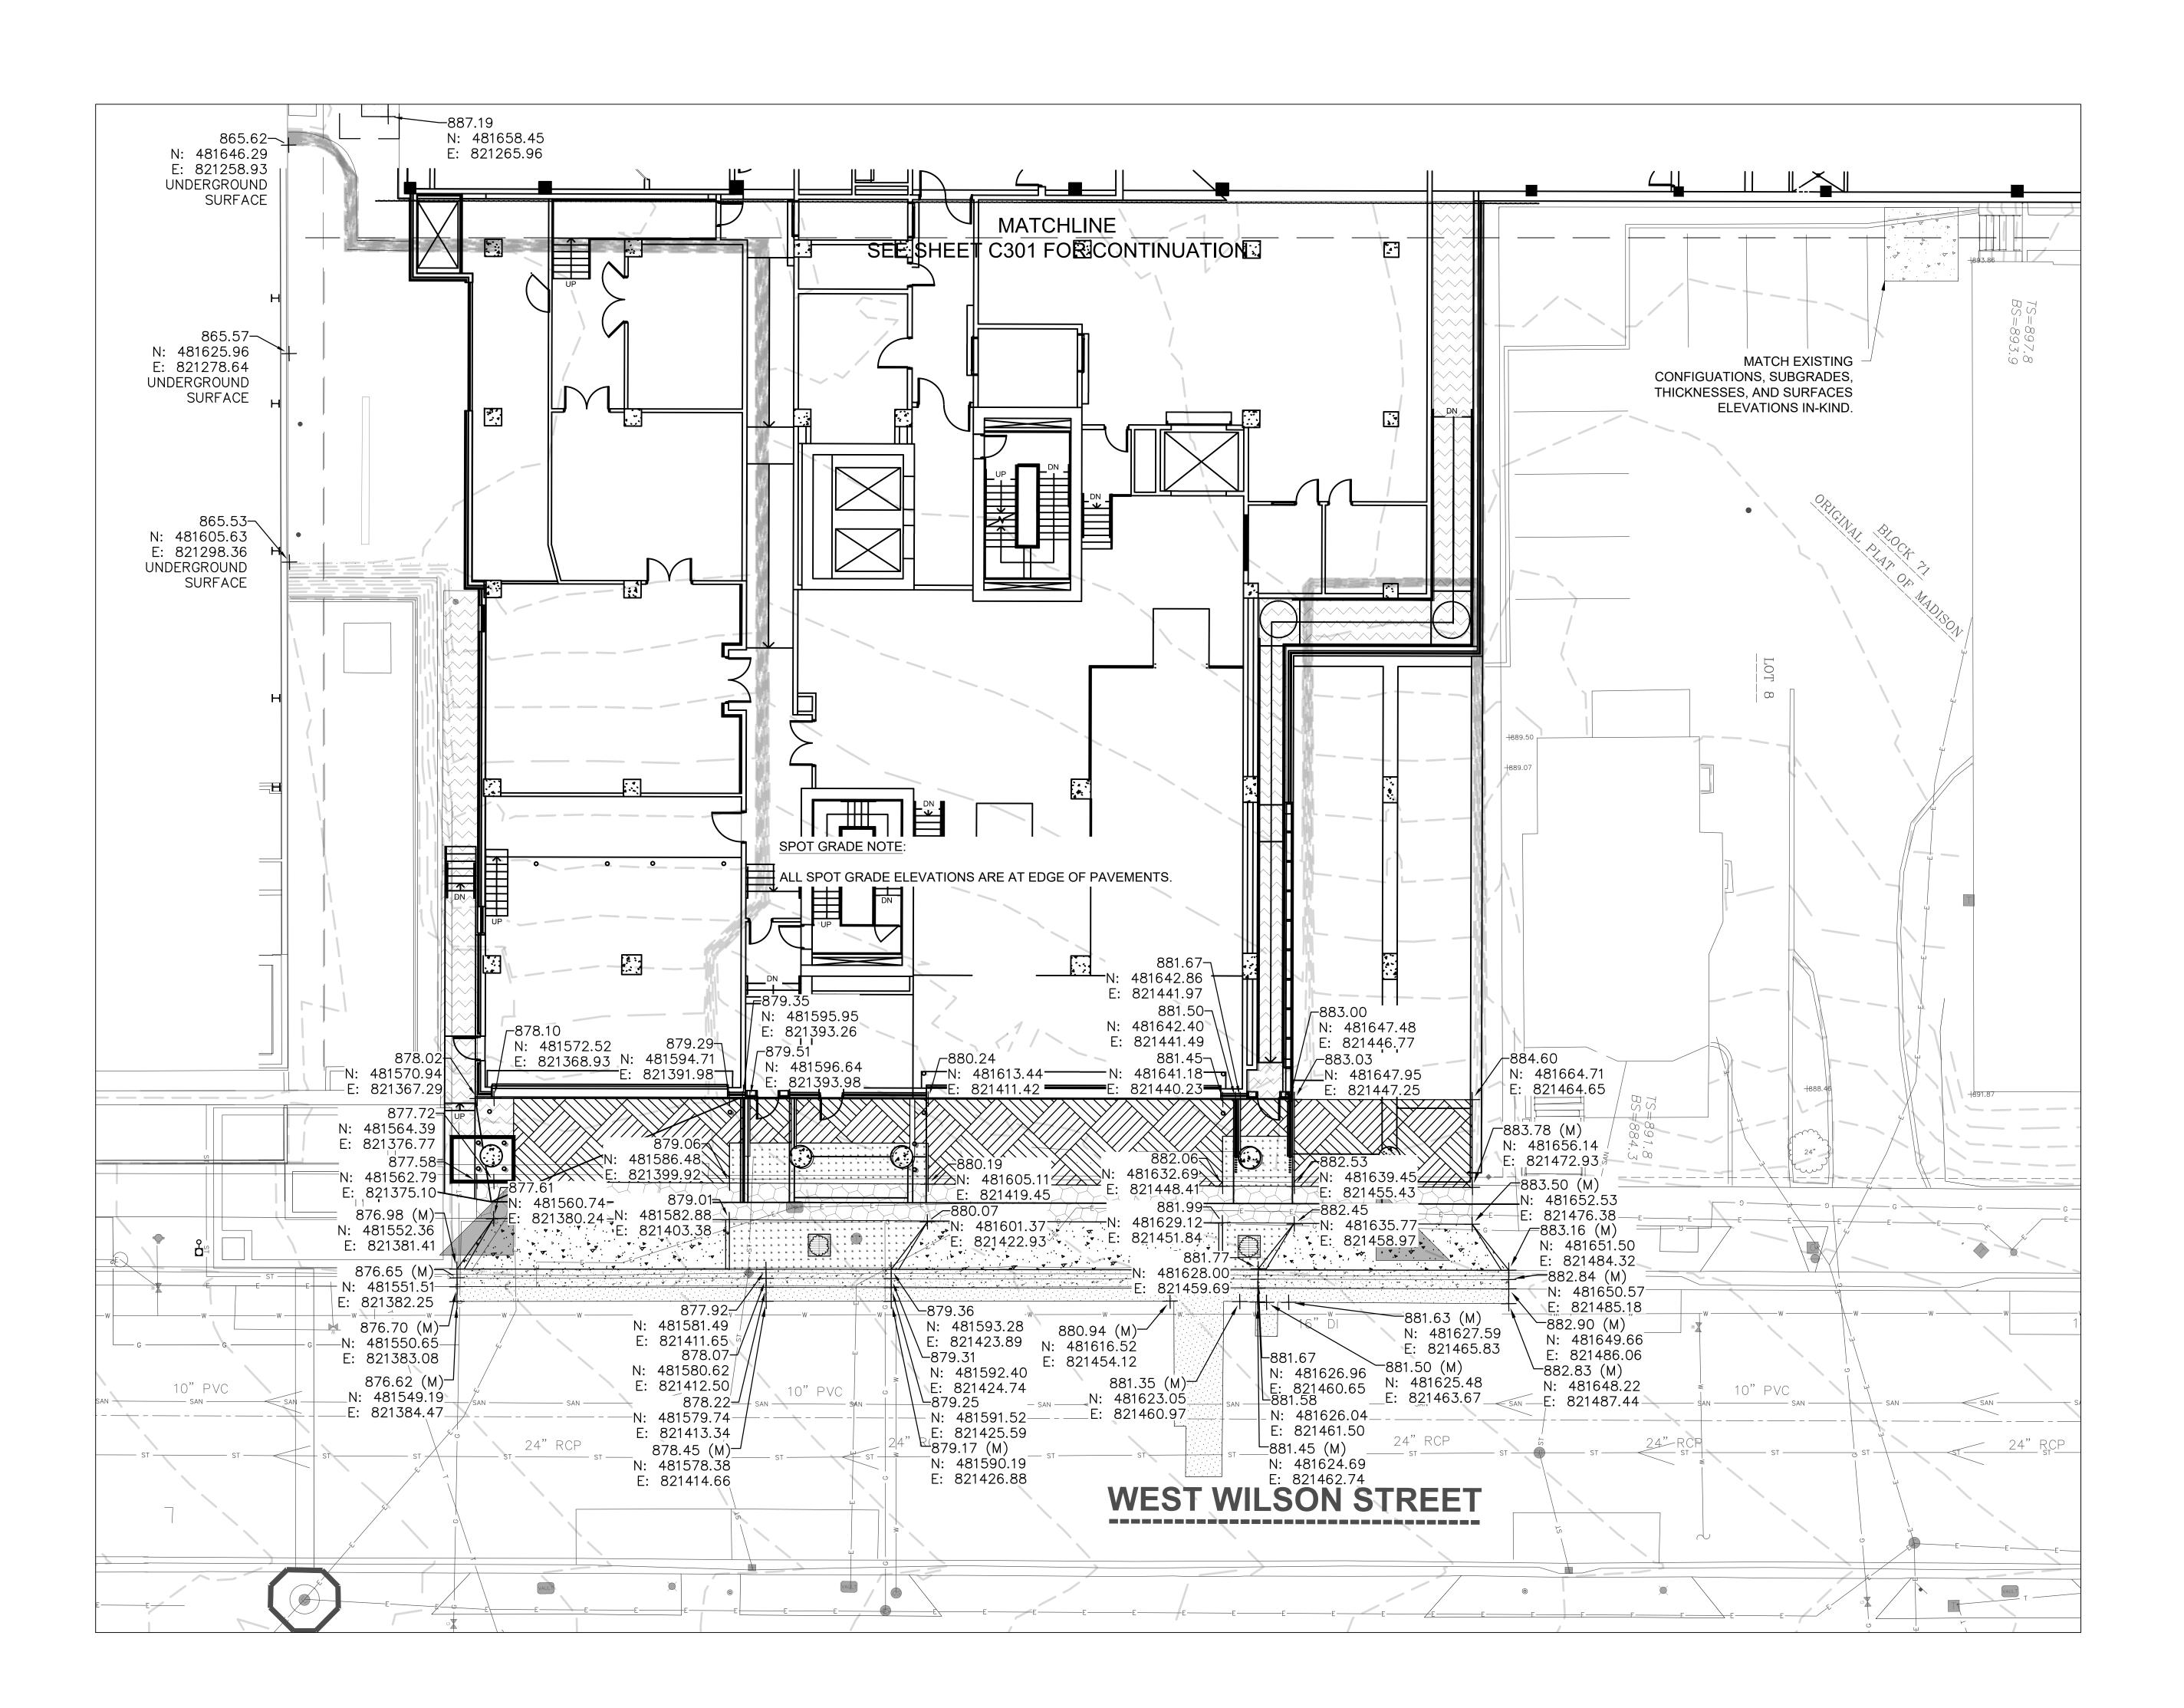



#### SITE AND GRADING PLAN NOTES:

- 1. CONFORM TO CITY OF MADISON STANDARD SPECIFICATIONS FOR PUBLIC WORKS CONSTRUCTION (LATEST EDITION).
- 2. EARTH MOVING: CONFORM TO SECTION 312000 "EARTH MOVING" OF PROJECT SPECIFICATIONS.
- 3. ASPHALT: CONFORM TO SECTION 321216 "ASPHALT PAVING" OF PROJECT SPECIFICATIONS.
- 4. CONCRETE: CONFORM TO SECTION 321313 "CONCRETE PAVING" OF PROJECT SPECIFICATIONS.
- 5. CURB-AND-GUTTER: CONFORM TO CITY OF MADISON STANDARD DETAIL DRAWING 3.06 "MADISON STANDARD CONCRETE CURB & GUTTER" AND STANDARD DETAIL DRAWING 3.10 "LONGITUDINAL JOINTS AND PAVEMENT TIES DETAIL. CONFORM TO TYPE 'A' CONCRETE CURB & GUTTER AND TO DRIVEWAY SECTION TYPE 'A' CURB & GUTTER IN DRAWING 3.06 AND TO PAVEMENT TIES ON DRAWING 3.10.
- 6. DRIVEWAYS: CONFORM TO CITY OF MADISON STANDARD DETAIL DRAWING 3.02 "MADISON STANDARD CURB CUT DETAILS" AND STANDARD DETAIL DRAWING 3.09 "MADISON STANDARD COMMERCIAL DRIVE DETAILS." CONFORM TO COMMERCIAL DETAIL AND TO DRIVEWAY SECTION TYPE "A" CONCRETE CURB & GUTTER DETAIL IN DRAWING 3.02.

#### **LEGEND**

SEE LEGEND ON "BOUNDARY, TOPOGRAPHIC AND UTILITY SURVEY" DATED 05/28/20 PREPARED BY JSD PROFESSIONAL SERVICES, INC., PROVIDED IN THIS PLAN SET, FOR EXISTING FEATURES.

PLAN	SEI,	FOR	EXISTING	FEATU
EXIS	TING		PROPOS	SED

WATER PIPE SANITARY PIPE — TZ — TZ — STORM PIPE

ELECTRICAL CONDUIT WATER VALVE

SANITARY CLEANOUT ROOF DRAIN CONNECTION **HYDRANT** 

LIGHT POLE LIGHT POLE

> PROPOSED MUNICIPAL CONCRETE SIDEWALK (DETAIL 2/C203 AND MADISON SDD 4.02) PROPOSED MUNICIPAL CONCRETE DRIVEWAY

MADISON SDD 3.02) PROPOSED PERMEABLE CONCRETE DRIVEWAY

**PAVEMENT** 

(DETAIL 3/C203 AND

(DETAIL 4/C203) PROPOSED CONCRETE SIDEWALK PAVEMENT (DETAIL 5/C203)

PROPOSED MUNICIPAL CONCRETE CURB-AND-GUTTER,

PROPOSED TREE

TRENCH PROPOSED ASPHALT ROADWAY PAVEMENT PROPOSED TURF

> MAJOR CONTOUR MINOR CONTOUR

GRADE ELEVATION WITH NORTHING & EASTING XXX.XX (M) PROPOSED SPOT GRADE ELEVATION

Mead Mead & Hunt, Inc. 2440 Deming Way

Middleton, WI 53562 phone: 608-273-6380 meadhunt.com

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DANE COUNTY DEPT. OF PUBLIC WORKS, HIGHWAY &

TRANSPORTATION 1919 ALLIANT ENERGY **CENTER WAY** MADISON, WI 53713 PROJECT NO. 318025

PROPOSED SPOT

(MATCH EXISTING) WITH

NORTHING & EASTING

/ Jail Consolidation - Addition & Public S ovation Dane Co South To Building

LAND USE APPLICATION

NOT FOR CONSTRUCTION

M&H NO.: 4215400-161957.01 DATE: 04/07/2022 DESIGNED BY: BRB DRAWN BY: RH

SHEET CONTENTS **GRADING PLAN -**BASEMENT - AREA B


DO NOT SCALE DRAWINGS


CHECKED BY: RJ

TO OBTAIN LOCATIONS OF PARTICIPTANTS UNDERGROUND FACILITIES BEFORE YOU DIG IN

CALL DIGGERS HOTLINE 1-800-242-8511 TOLL FREE WIS STATUTE 182.0175(1974) REQUIRES MIN. 3 WORK DAYS NOTICE BEFORE YOU EXCAVATE

L UTILITY LOCATIONS ARE SHOWN FROM FIELD OBSERVATION BASED UPON LOCATES AND/OR VARIOUS UTILITY COMPANIES. BEFORE THE START OF ANY EXCAVATION, A COMPLETE LOCATE OF ALL UTILITIES WITHIN THE CONSTRUCTION AREA SHOULD BE COMPLETED.

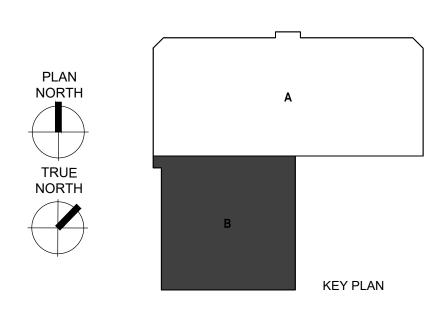

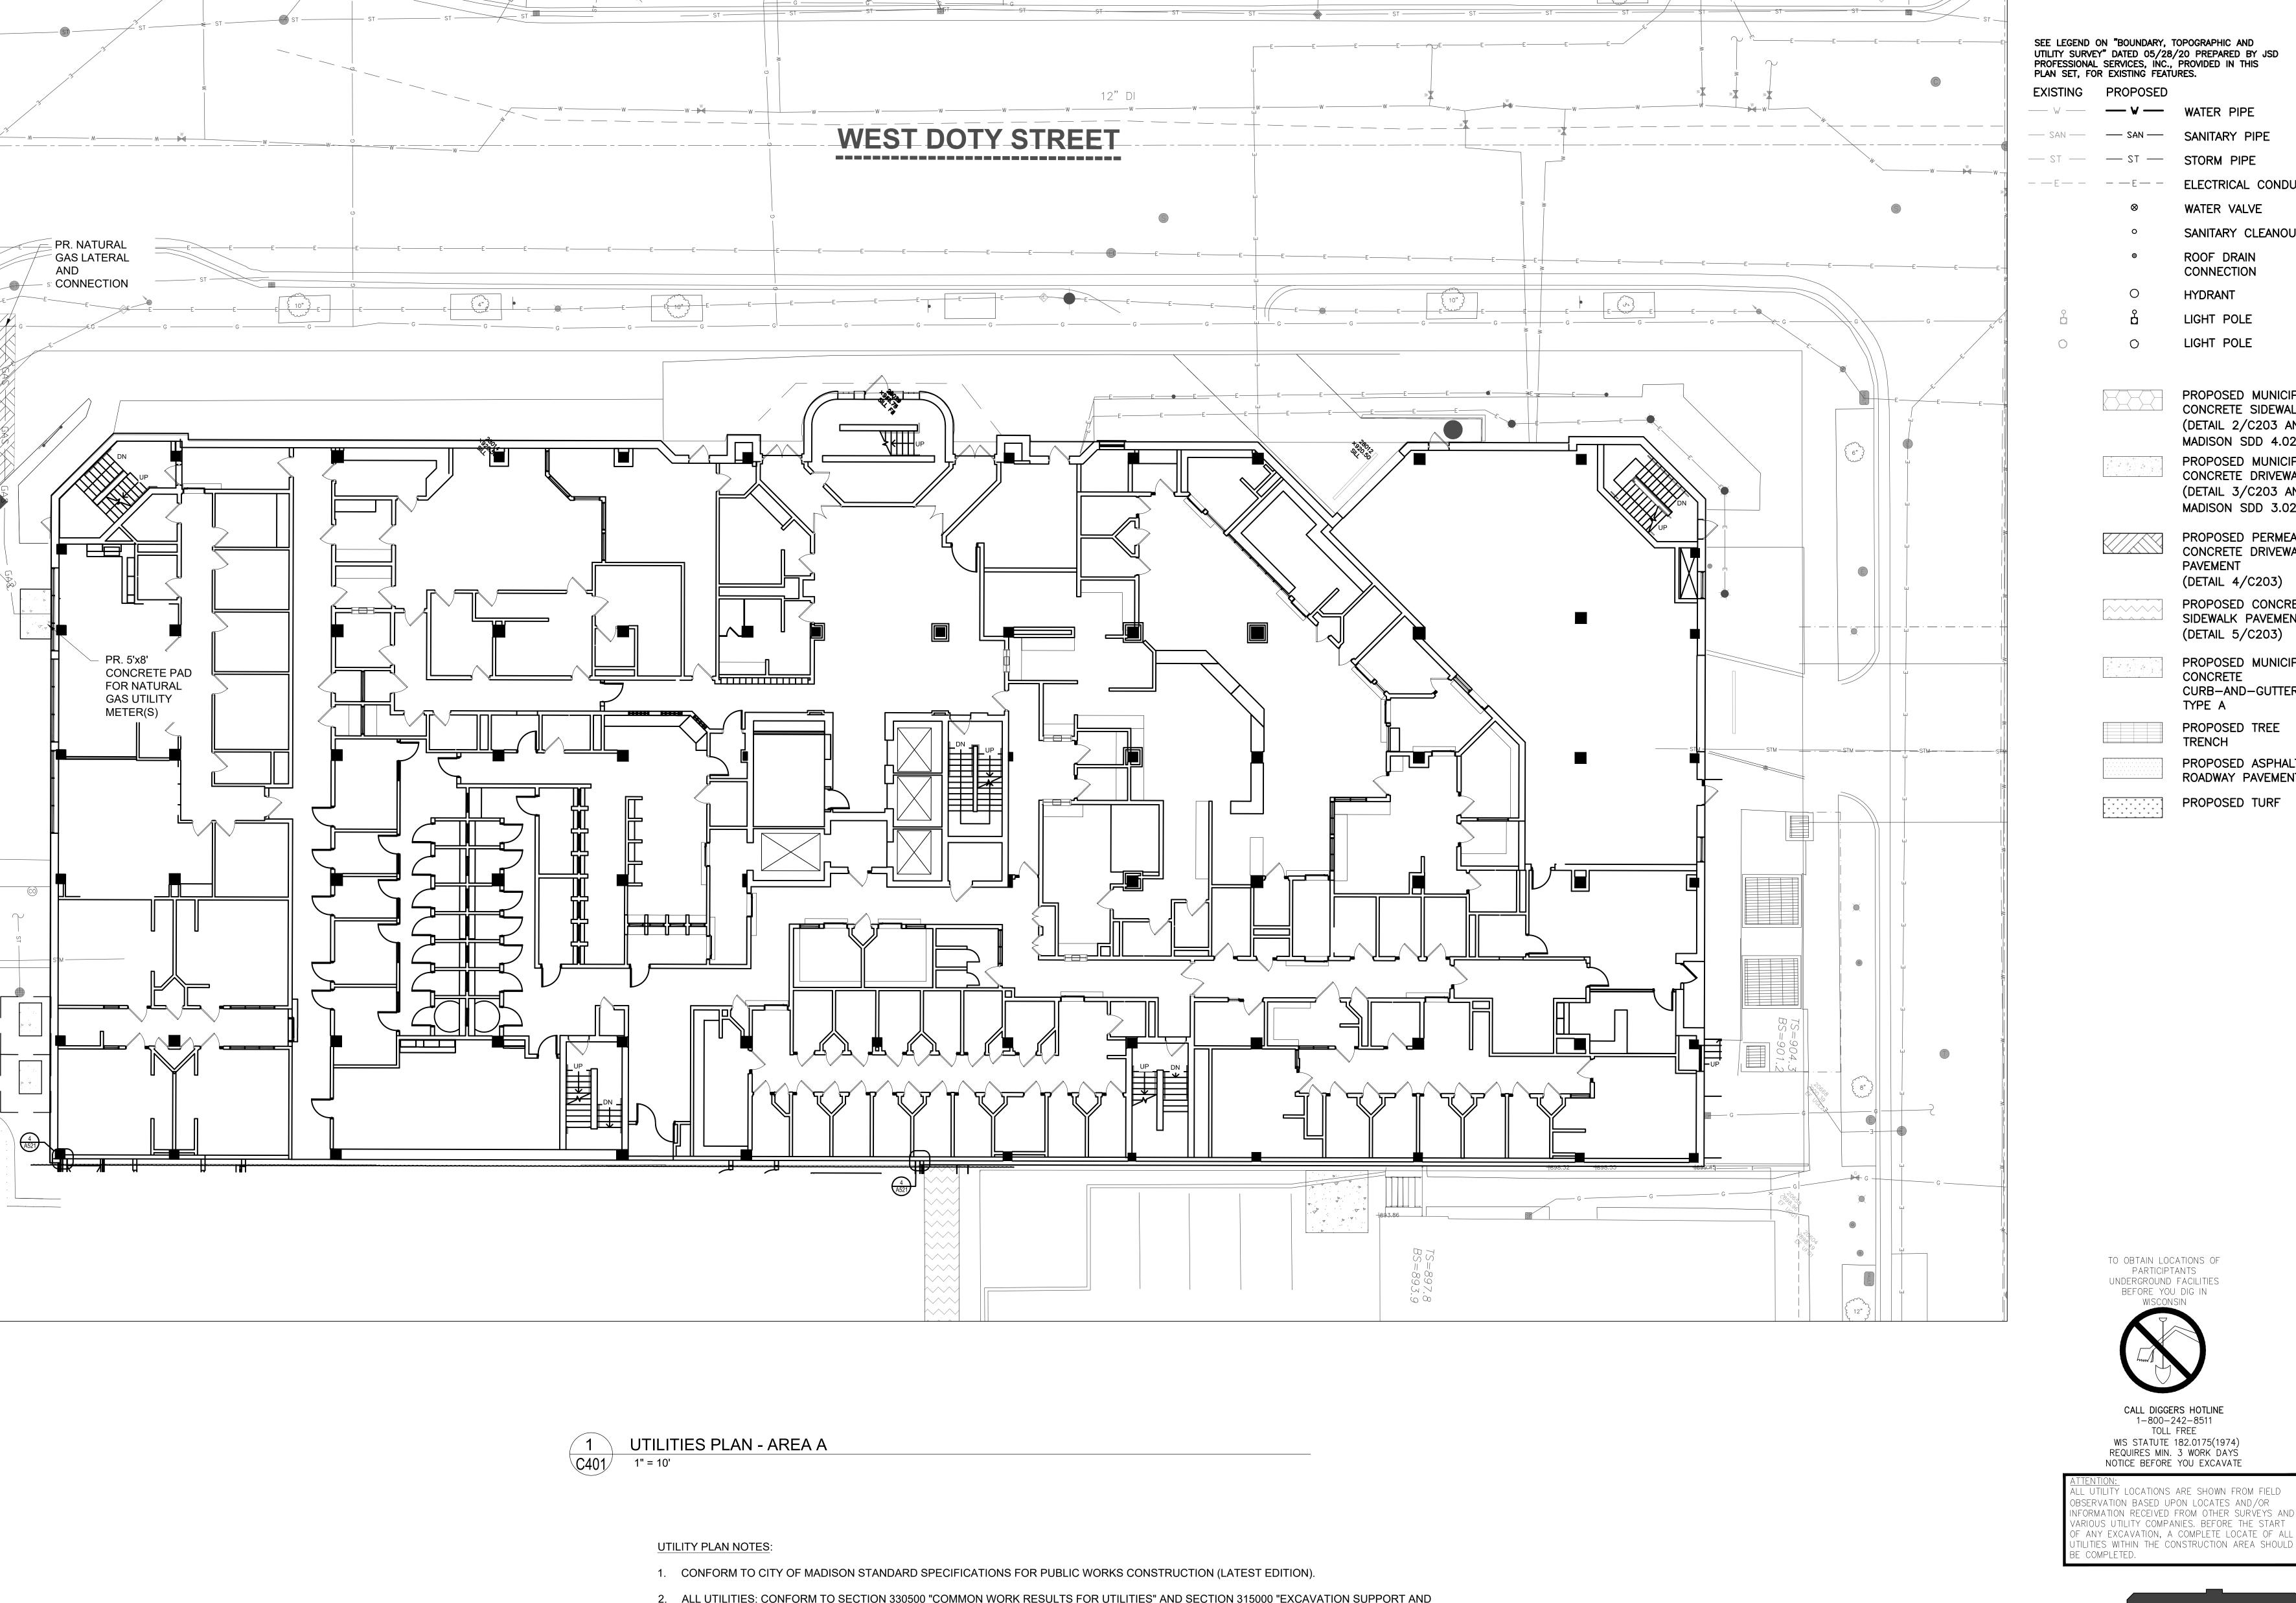

SEE LEGEND ON "BOUNDARY, TOPOGRAPHIC AND UTILITY SURVEY" DATED 05/28/20 PREPARED BY JSD PROFESSIONAL SERVICES, INC., PROVIDED IN THIS PLAN SET, FOR EXISTING FEATURES.

─ ¥ ─ WATER PIPE SANITARY PIPE

ELECTRICAL CONDUIT WATER VALVE

Mead

Mead & Hunt, Inc. 2440 Deming Way Middleton, WI 53562

phone: 608-273-6380 meadhunt.com

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DANE COUNTY DEPT. OF PUBLIC WORKS, HIGHWAY &

TRANSPORTATION

1919 ALLIANT ENERGY CENTER WAY MADISON, WI 53713

PROJECT NO. 318025

SANITARY CLEANOUT ROOF DRAIN CONNECTION

HYDRANT LIGHT POLE LIGHT POLE

> PROPOSED MUNICIPAL CONCRETE SIDEWALK (DETAIL 2/C203 AND MADISON SDD 4.02) PROPOSED MUNICIPAL CONCRETE DRIVEWAY (DETAIL 3/C203 AND

PROPOSED PERMEABLE CONCRETE DRIVEWAY **PAVEMENT** (DETAIL 4/C203)

MADISON SDD 3.02)

PROPOSED MUNICIPAL

PROPOSED CONCRETE SIDEWALK PAVEMENT (DETAIL 5/C203)

> CONCRETE CURB-AND-GUTTER,

PROPOSED TREE TRENCH

PLAN

NORTH

TRUE NORTH

PROPOSED ASPHALT ROADWAY PAVEMENT

PROPOSED TURF

Dane County Jail Consolidation
South Tower Addition & Public Sa
Building Renovation
Madison, WI 53703

LAND USE APPLICATION


NOT FOR CONSTRUCTION

M&H NO.: 4215400-161957.01 DATE: 04/07/2022 DESIGNED BY: BRB DRAWN BY: RH CHECKED BY: RJ DO NOT SCALE DRAWINGS

SHEET CONTENTS **UTILITIES PLAN -**AREA A

**KEY PLAN** 

- 2. ALL UTILITIES: CONFORM TO SECTION 330500 "COMMON WORK RESULTS FOR UTILITIES" AND SECTION 315000 "EXCAVATION SUPPORT AND
- PROTECTION" OF PROJECT SPECIFICATIONS.
- 3. SANITARY: CONFORM TO SECTION 221313 "FACILITY SANITARY SEWERS" OF PROJECT SPECIFICATIONS.
- 4. WATER: CONFORM TO SECTION 221113 "FACILITY WATER DISTRIBUTION PIPING" OF PROJECT SPECIFICATIONS.
- 5. STORM: CONFORM TO SECTION 334200 "STORMWATER CONVEYANCE" OF PROJECT SPECIFICATIONS.

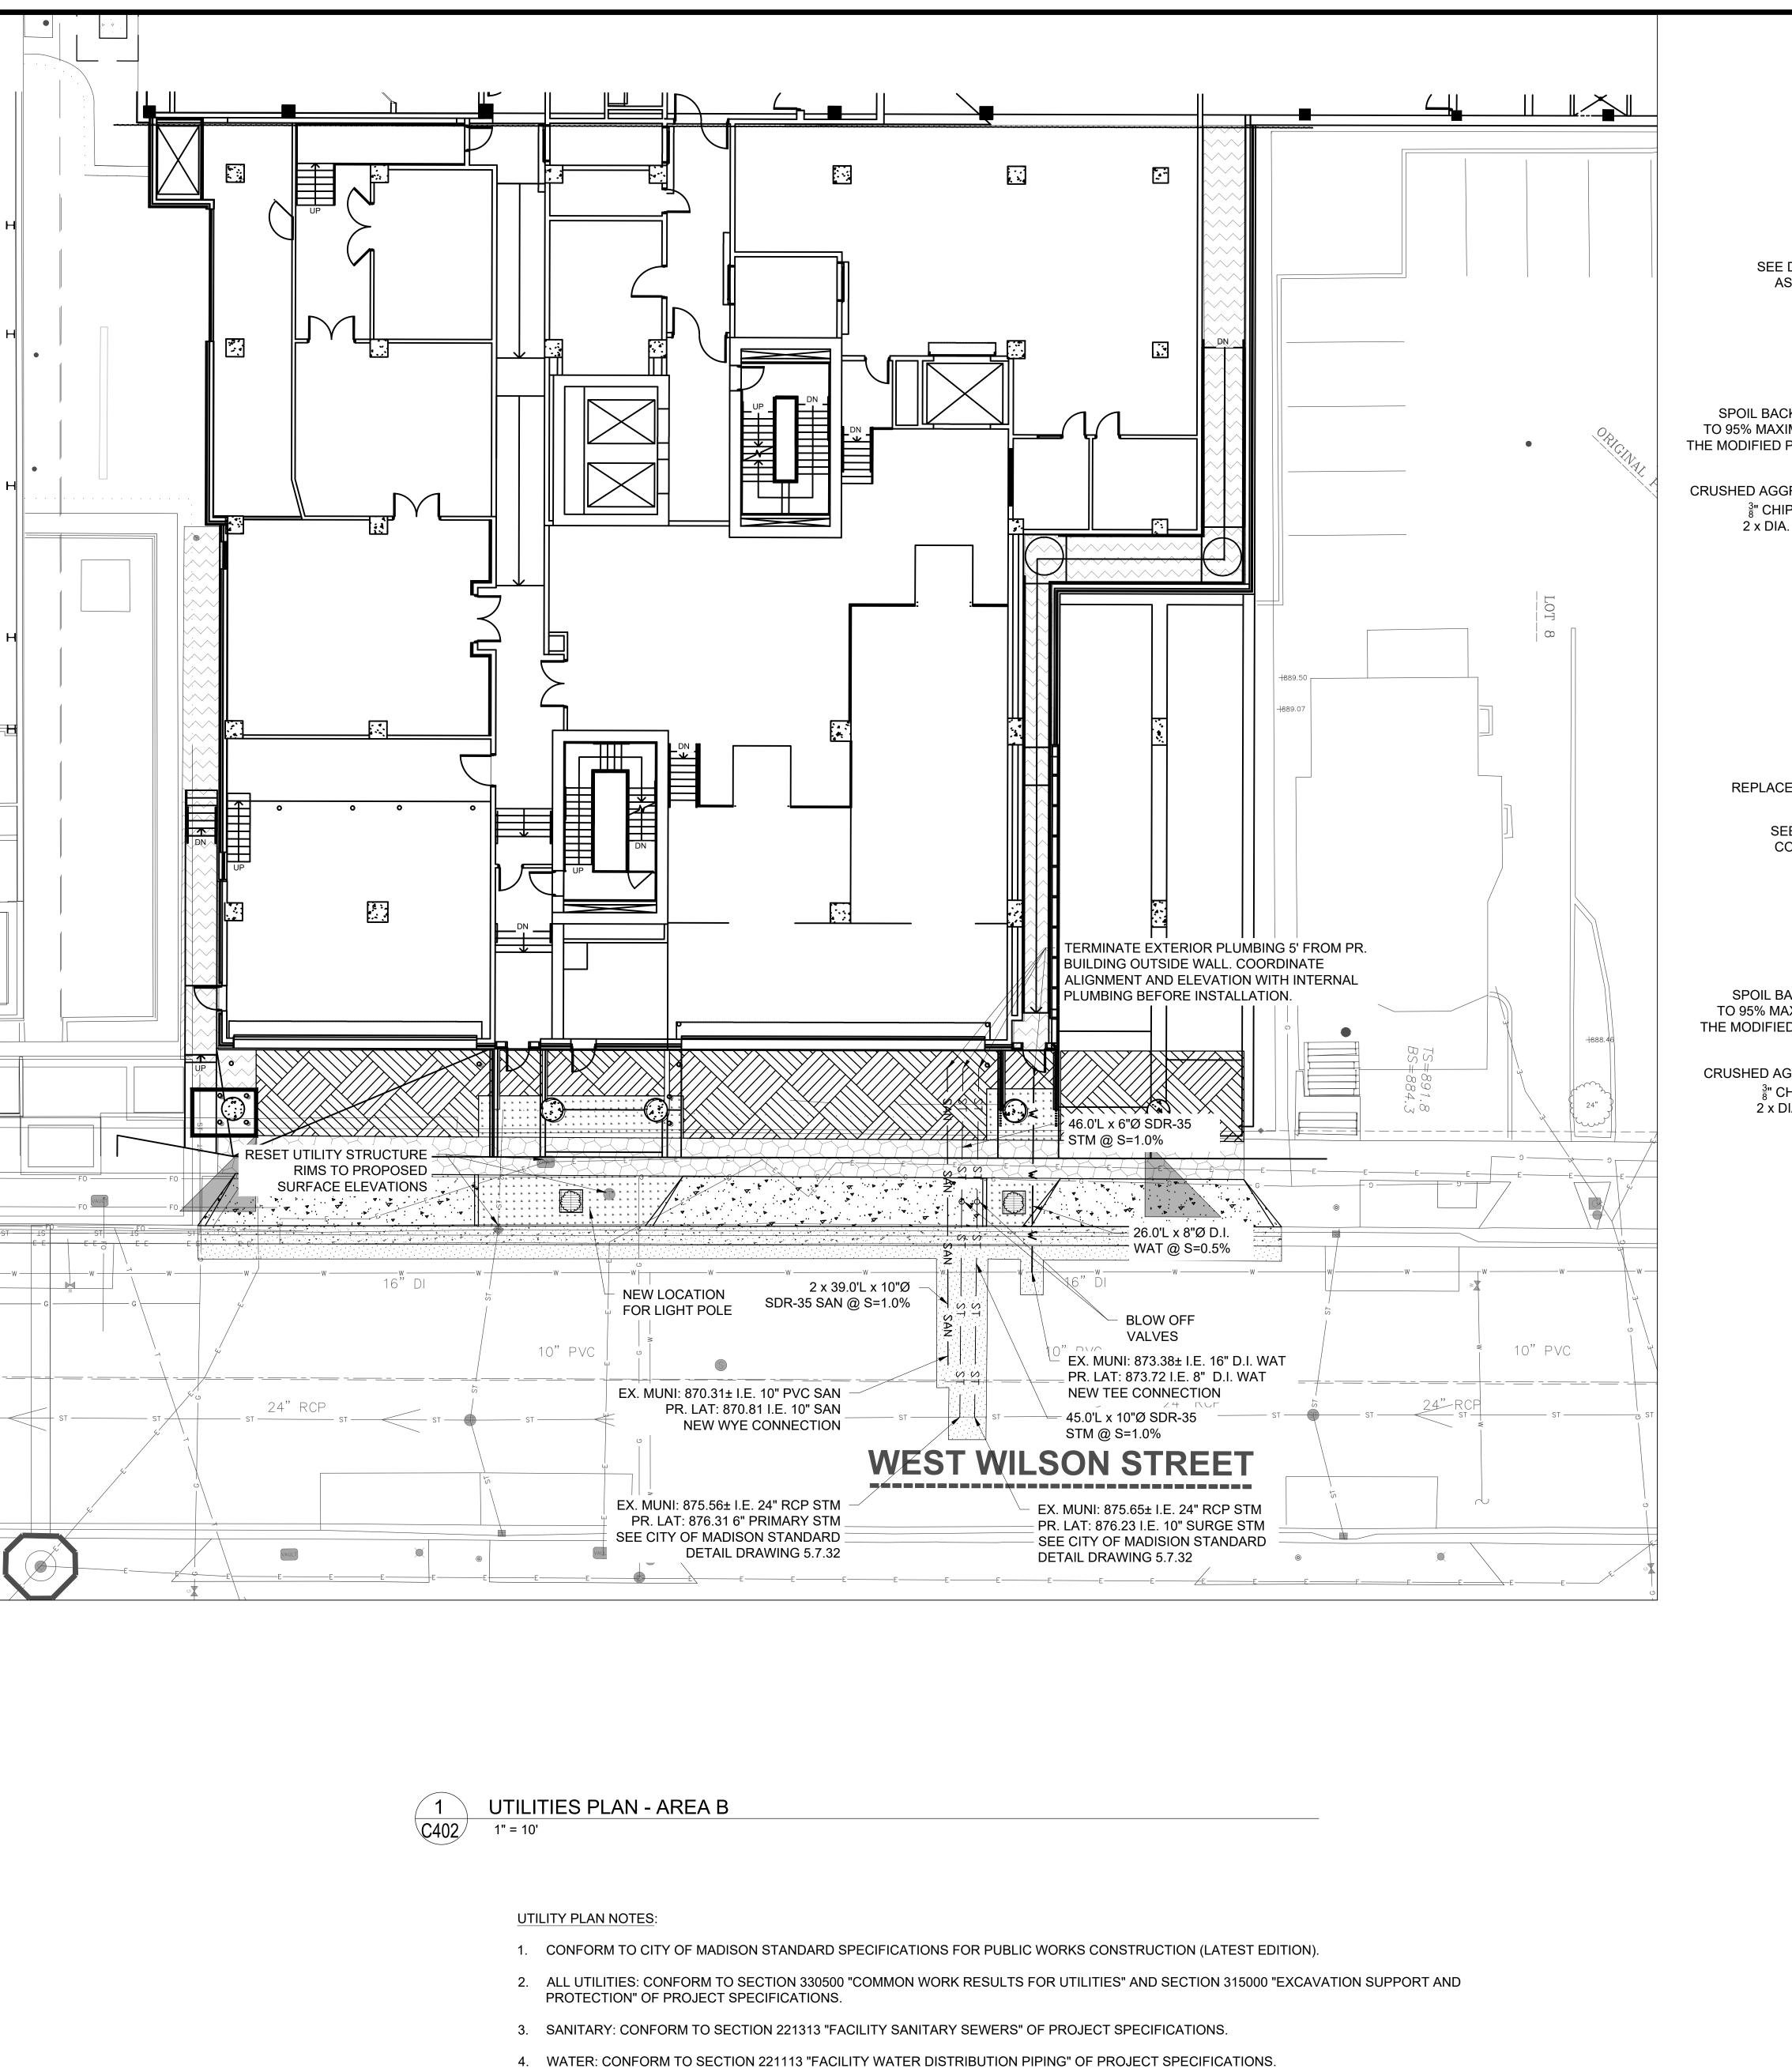

SEE DETAIL 2/C203 FOR ASPHALT PAVEMENT **CROSS-SECTION** WARNING AND **IDENTIFICATION** SPOIL BACKFILL COMPACTED TO 95% MAXIMUM DENSITY PER THE MODIFIED PROCTOR TESTING CRUSHED AGGREGATE COVER. CRUSHED AGGREGATE BEDDING, ર્ટ્ટ" CHIP STONE OR SAND, 1 x DIA. THICKNESS (MIN.)  $\frac{3}{8}$ " CHIP STONE OR SAND, 2 x DIA. THICKNESS (MIN.) EXISTING SUBGRADE COMPACTED TO 95% MAXIMUM DENSITY PER

UTILITY TRENCH SECTION,

ASPHALT PAVEMENT CONDITION

C402 NTS

SEE DETAIL 3/C203 FOR CONCRETE PAVEMENT CROSS-SECTION

SPOIL BACKFILL COMPACTED TO 95% MAXIMUM DENSITY PER THE MODIFIED PROCTOR TESTING

CRUSHED AGGREGATE BEDDING,

3" CHIP STONE OR SAND,

2 x DIA. THICKNESS (MIN.)

WARNING AND IDENTIFICATION TAPE

CRUSHED AGGREGATE COVER,

3" CHIP STONE OR SAND,

1 x DIA. THICKNESS (MIN.)

UTILITY

UTILITY TRENCH SECTION,
CONCRETE PAVEMENT CONDITION
NTS

SEE LEGEND ON "BOUNDARY, TOPOGRAPHIC AND UTILITY SURVEY" DATED 05/28/20 PREPARED BY JSD PROFESSIONAL SERVICES, INC., PROVIDED IN THIS PLAN SET, FOR EXISTING FEATURES.

PROFESSIONAL SERVICES, INC., PROVIDED IN THIS PLAN SET, FOR EXISTING FEATURES.

EXISTING PROPOSED

WATER PIPE

SAN — SAN — SANITARY PIPE

ST — ST — ST — STORM PIPE

ELECTRICAL CONDUITWATER VALVESANITARY CLEANOUT

Mead

Mead & Hunt, Inc. 2440 Deming Way

Middleton, WI 53562

phone: 608-273-6380

meadhunt.com

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DANE COUNTY DEPT. OF PUBLIC WORKS, HIGHWAY &

TRANSPORTATION

1919 ALLIANT ENERGY CENTER WAY MADISON, WI 53713

PROJECT NO. 318025

ROOF DRAIN CONNECTION
 HYDRANT

LIGHT POLE

LIGHT POLE

PROPOSED MUNICIPAL CONCRETE SIDEWALK (DETAIL 2/C203 AND MADISON SDD 4.02)

PROPOSED MUNICIPAL CONCRETE DRIVEWAY (DETAIL 3/C203 AND

MADISON SDD 3.02)

PROPOSED PERMEABLE
CONCRETE DRIVEWAY
PAVEMENT
(DETAIL 4/C203)

PROPOSED CONCRETE SIDEWALK PAVEMENT (DETAIL 5/C203)

PROPOSED MUNICIPAL CONCRETE CURB-AND-GUTTER, TYPE A

PROPOSED TREE
TRENCH
PROPOSED ASPHALT
ROADWAY PAVEMENT

ROADWAY PAVEMENT

PROPOSED TURF

EXISTING SUBGRADE COMPACTED TO 95% MAXIMUM DENSITY PER

THE MODIFIED PROCTOR TESTING

THE MODIFIED PROCTOR TESTING ECTION,

IENT CONDITION

Dane County Jail Consolidation South Tower Addition & Public S Building Renovation Madison, WI 53703

BEFORE YOU DIG IN
WISCONSIN

ISSUED
10/31/2022 LAND USE
APPLICATION

WIS STATUTE 182.0175(1974)
REQUIRES MIN. 3 WORK DAYS
NOTICE BEFORE YOU EXCAVATE


ON:

ILITY LOCATIONS ARE SHOWN FROM FIEL

ALL UTILITY LOCATIONS ARE SHOWN FROM FIELD OBSERVATION BASED UPON LOCATES AND/OR INFORMATION RECEIVED FROM OTHER SURVEYS AND VARIOUS UTILITY COMPANIES. BEFORE THE START OF ANY EXCAVATION, A COMPLETE LOCATE OF ALL UTILITIES WITHIN THE CONSTRUCTION AREA SHOULD BE COMPLETED.

CALL DIGGERS HOTLINE 1-800-242-8511

TO OBTAIN LOCATIONS OF PARTICIPTANTS
UNDERGROUND FACILITIES

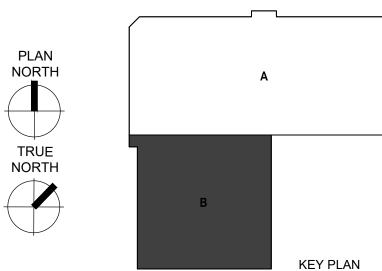

M&H NO.: 4215400-161957.01

DATE: 04/07/2022

DESIGNED BY: BRB

DRAWN BY: RH

CHECKED BY: RJ

DO NOT SCALE DRAWINGS

SHEET CONTENTS


UTILITIES PLAN

SHEET NO.:

C402

NOT FOR CONSTRUCTION

- 5. STORM: CONFORM TO SECTION 334200 "STORMWATER CONVEYANCE" OF PROJECT SPECIFICATIONS.
- 6. CONTRACTOR TO OBTAIN MARKER BALLS FROM THE CITY AND EMBED THEM IN THE CONCRETE NEAR THE BUILDING PENETRATIONS.

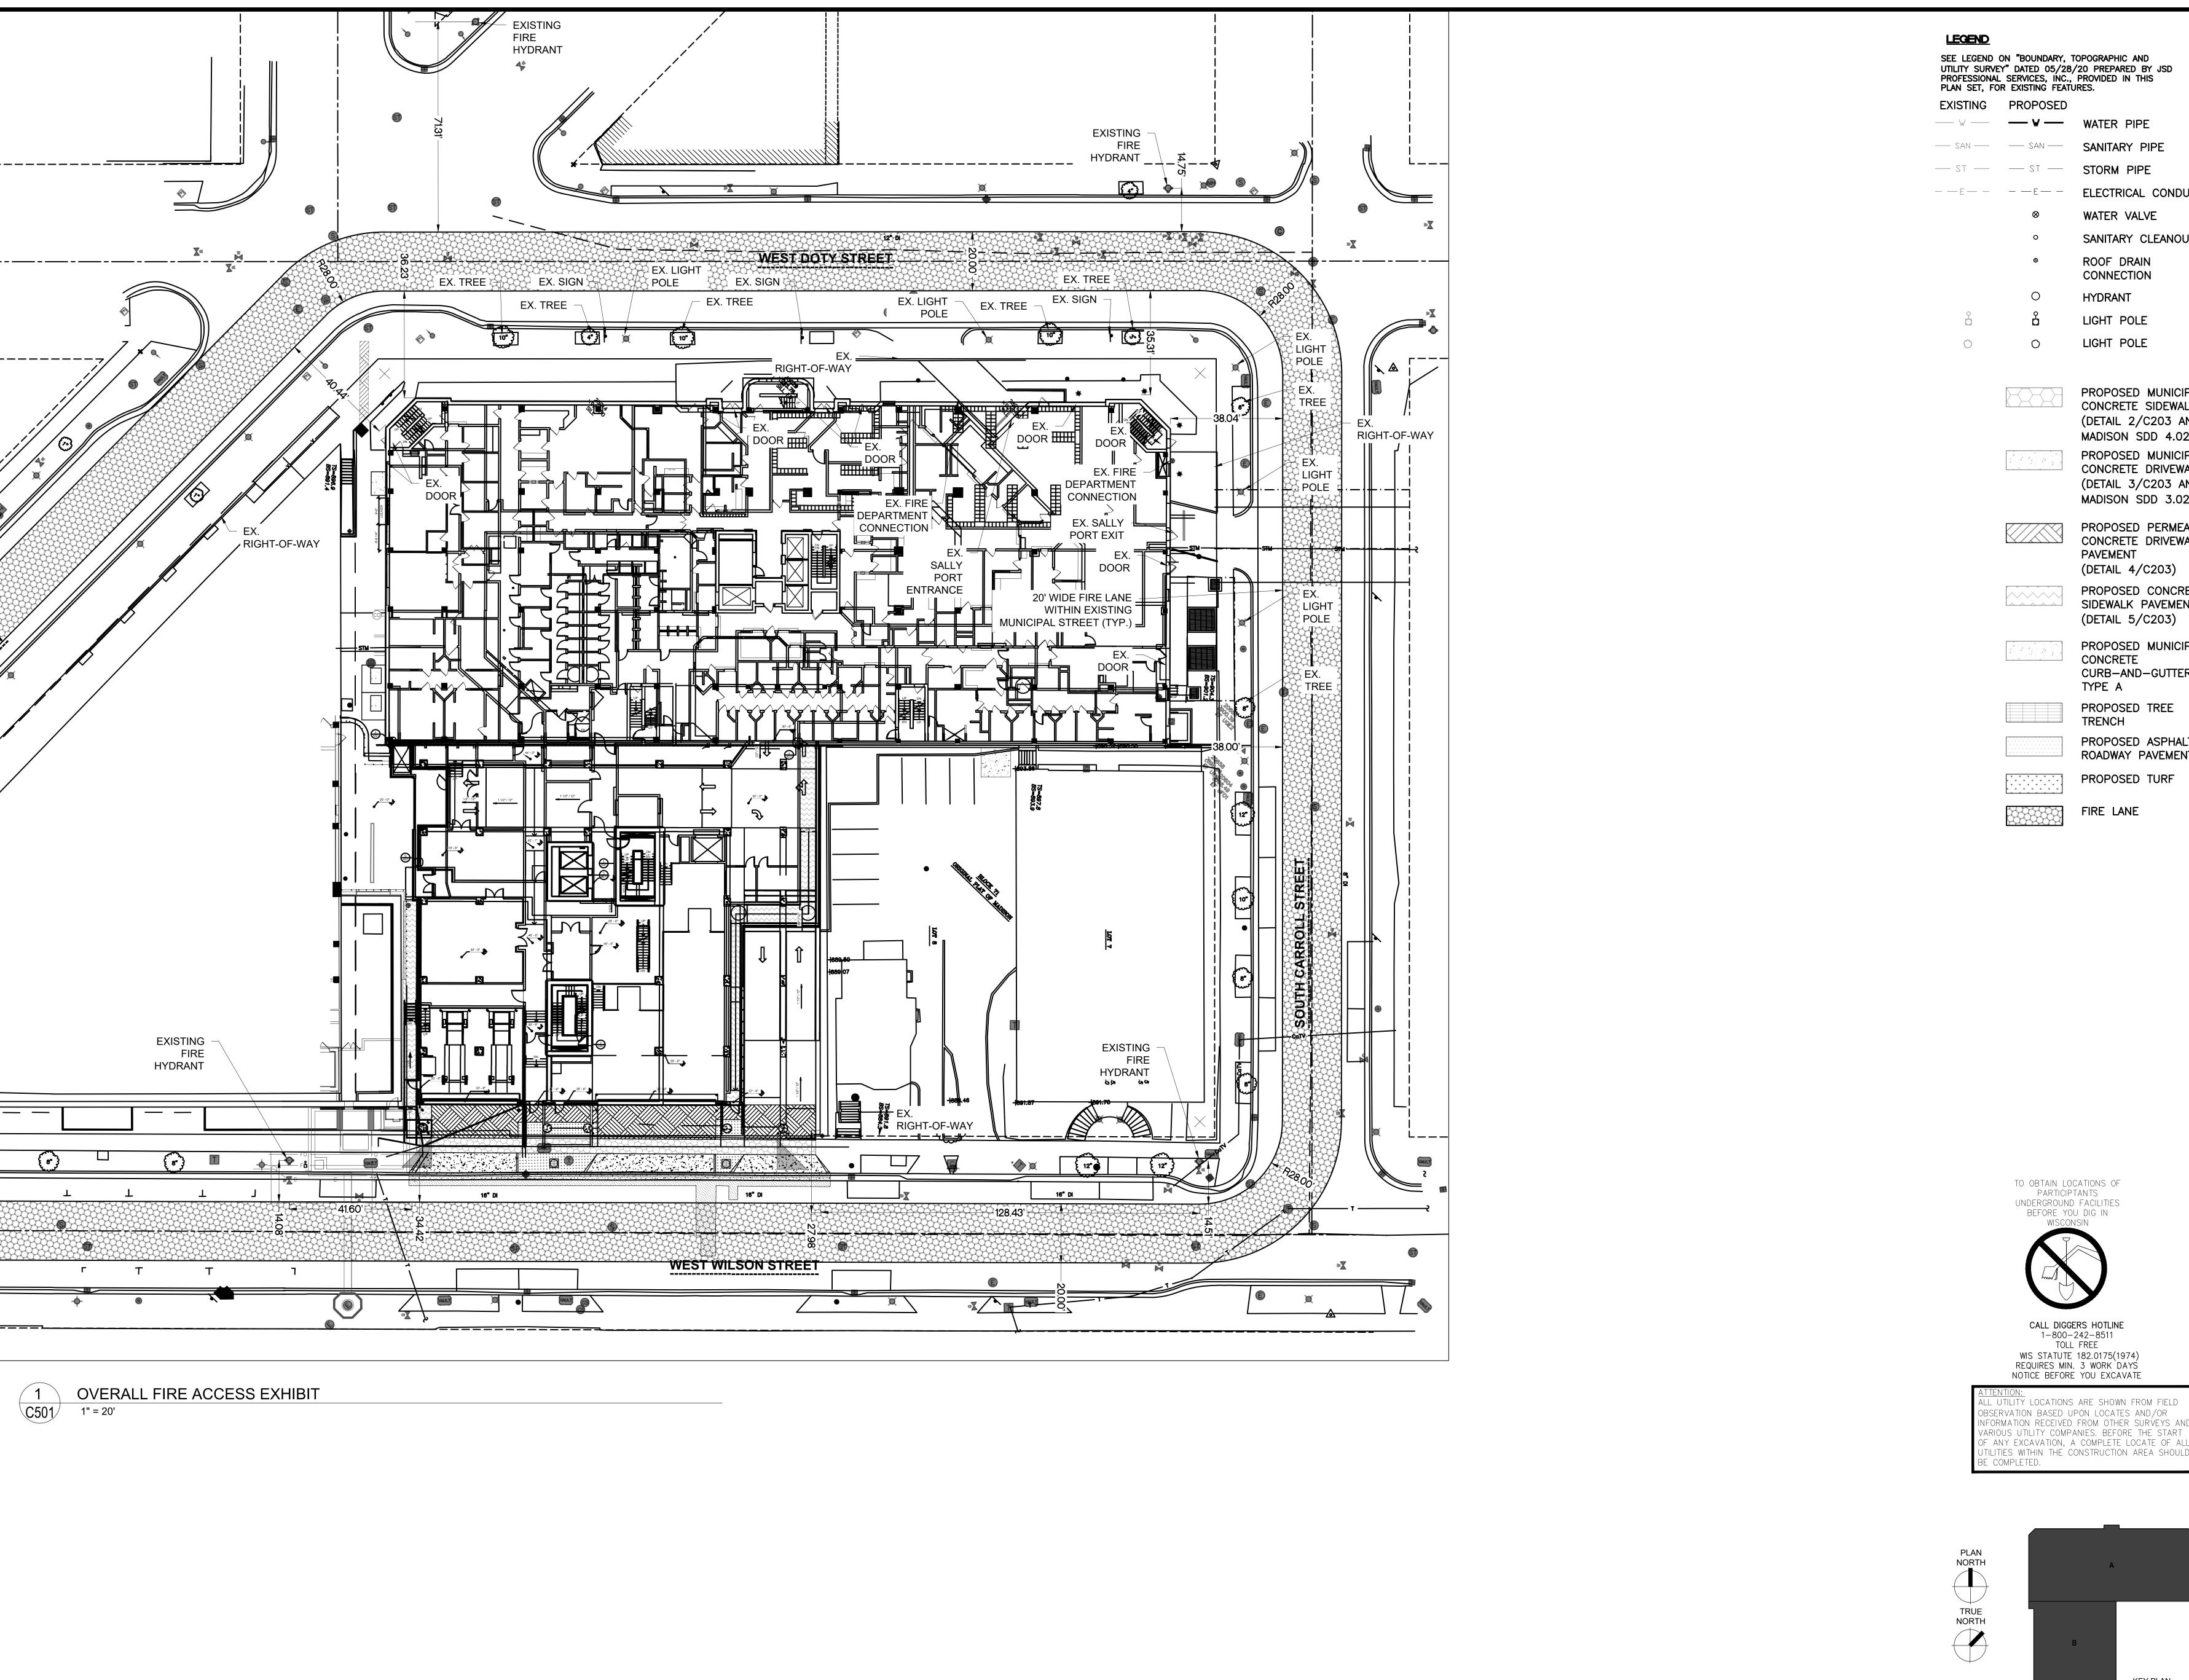

SEE LEGEND ON "BOUNDARY, TOPOGRAPHIC AND UTILITY SURVEY" DATED 05/28/20 PREPARED BY JSD PROFESSIONAL SERVICES, INC., PROVIDED IN THIS

— V — WATER PIPE — ST — STORM PIPE --E-- --E--

ELECTRICAL CONDUIT

SANITARY PIPE

WATER VALVE

SANITARY CLEANOUT ROOF DRAIN CONNECTION

LIGHT POLE LIGHT POLE

PROPOSED MUNICIPAL CONCRETE SIDEWALK (DETAIL 2/C203 AND MADISON SDD 4.02) PROPOSED MUNICIPAL CONCRETE DRIVEWAY (DETAIL 3/C203 AND MADISON SDD 3.02)


PROPOSED PERMEABLE CONCRETE DRIVEWAY **PAVEMENT** (DETAIL 4/C203)

PROPOSED CONCRETE SIDEWALK PAVEMENT (DETAIL 5/C203)

PROPOSED MUNICIPAL CONCRETE CURB-AND-GUTTER,

PROPOSED TREE TRENCH

PROPOSED ASPHALT ROADWAY PAVEMENT

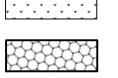

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DANE COUNTY DEPT. OF PUBLIC WORKS, HIGHWAY & TRANSPORTATION 1919 ALLIANT ENERGY CENTER WAY MADISON, WI 53713

PROJECT NO. 318025

PROPOSED TURF

FIRE LANE

/ Jail Consolidation <sup>-</sup> Addition & Public S ovation Dane Cour South Tow Building Re 115 W. Doty Stree Madison, WI 5370


LAND USE APPLICATION


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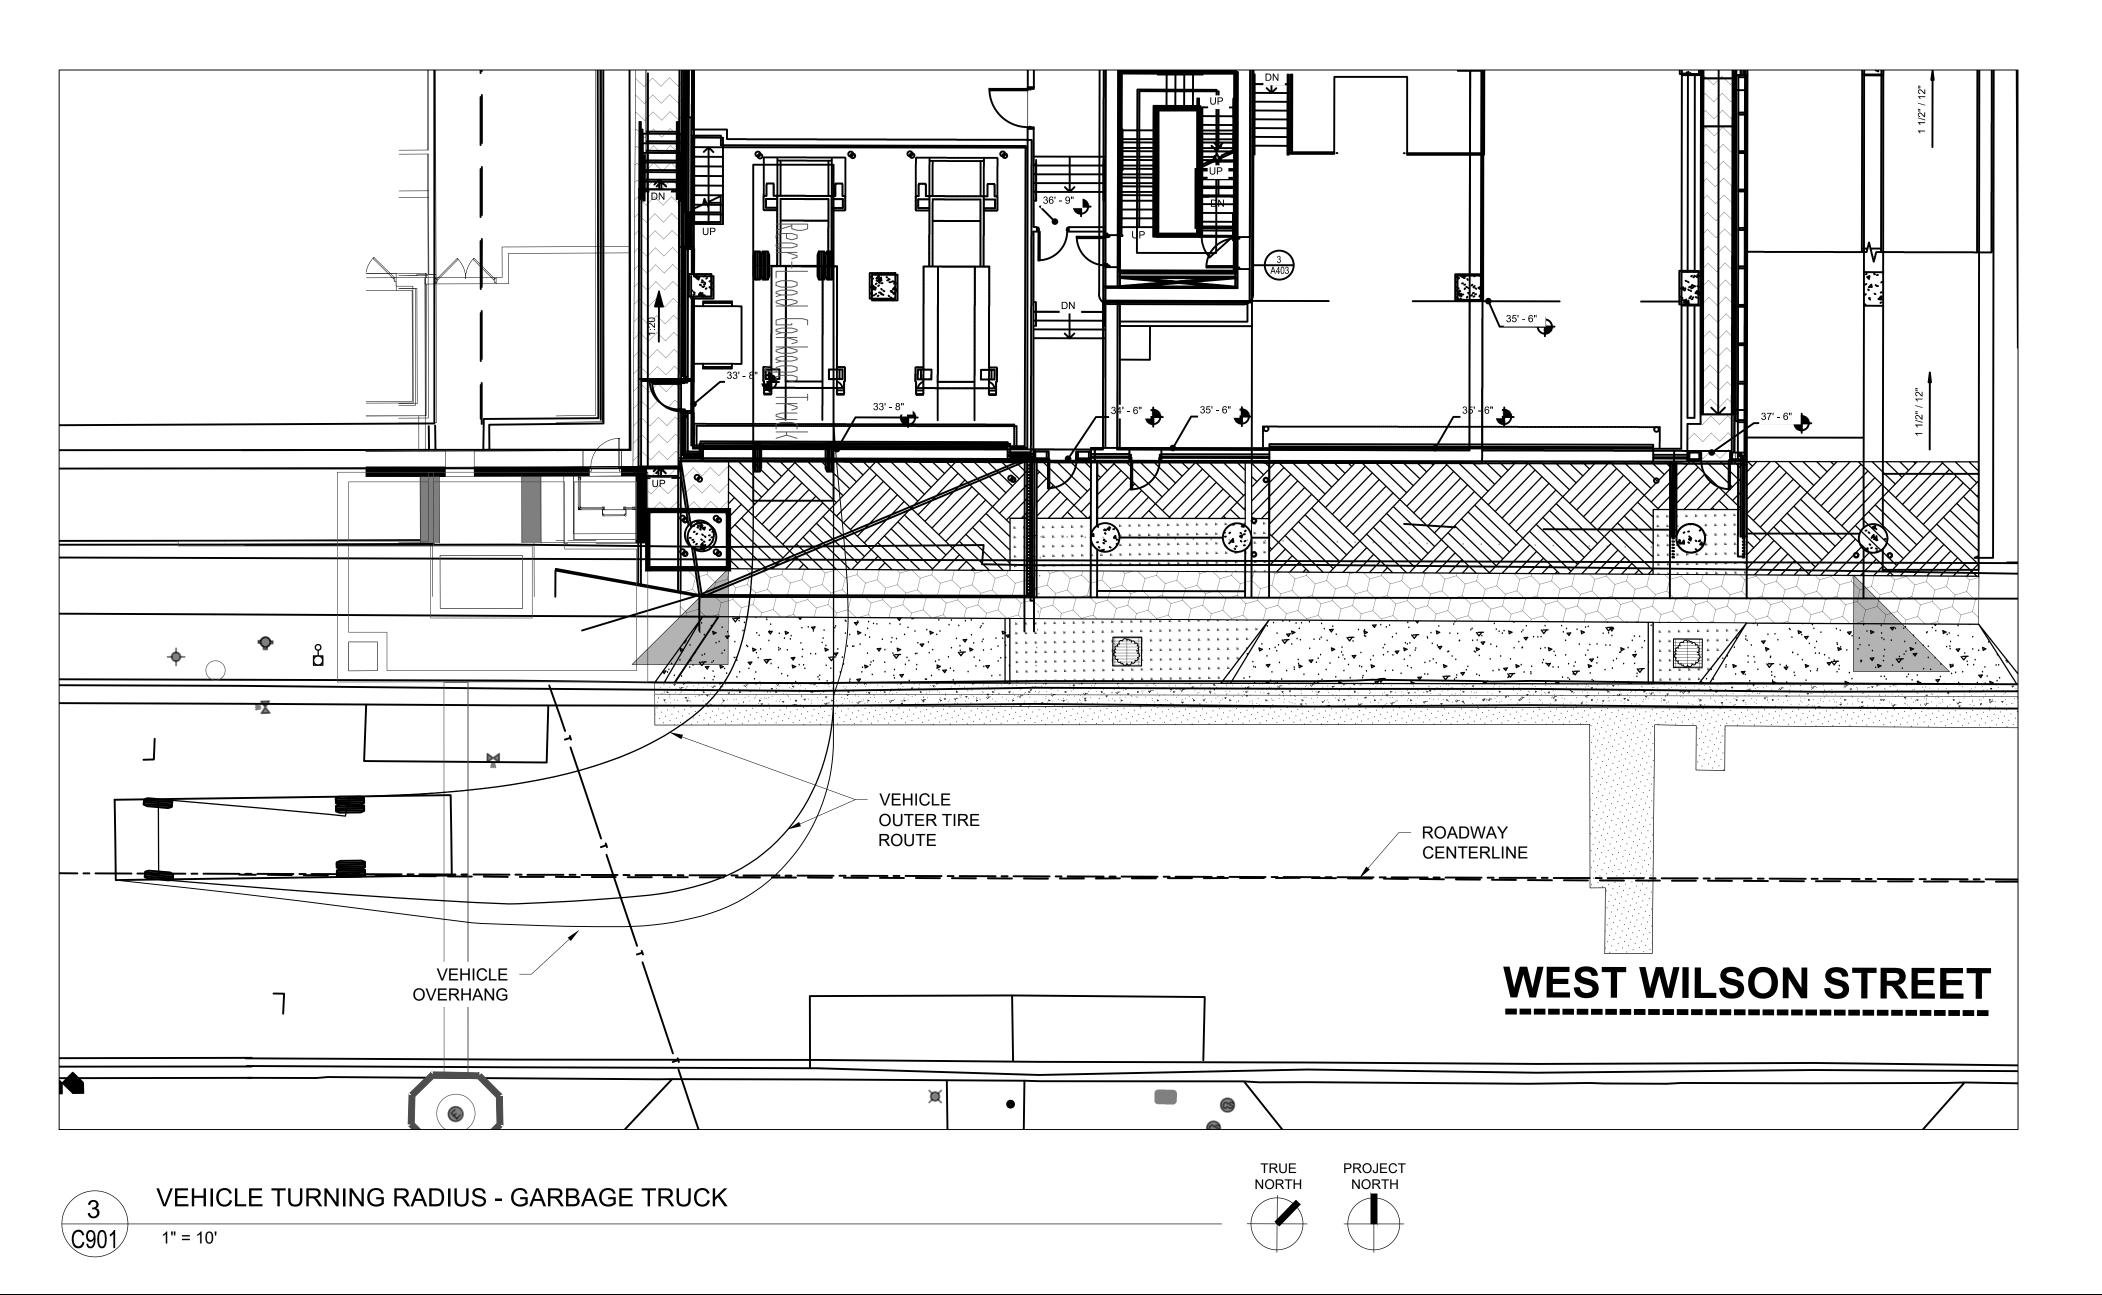
M&H NO.: 4215400-161957.01 DATE: 04/07/2022 DESIGNED BY: BRB DRAWN BY: RH CHECKED BY: RJ


DO NOT SCALE DRAWINGS SHEET CONTENTS OVERALL FIRE ACCESS EXHIBIT

KEY PLAN



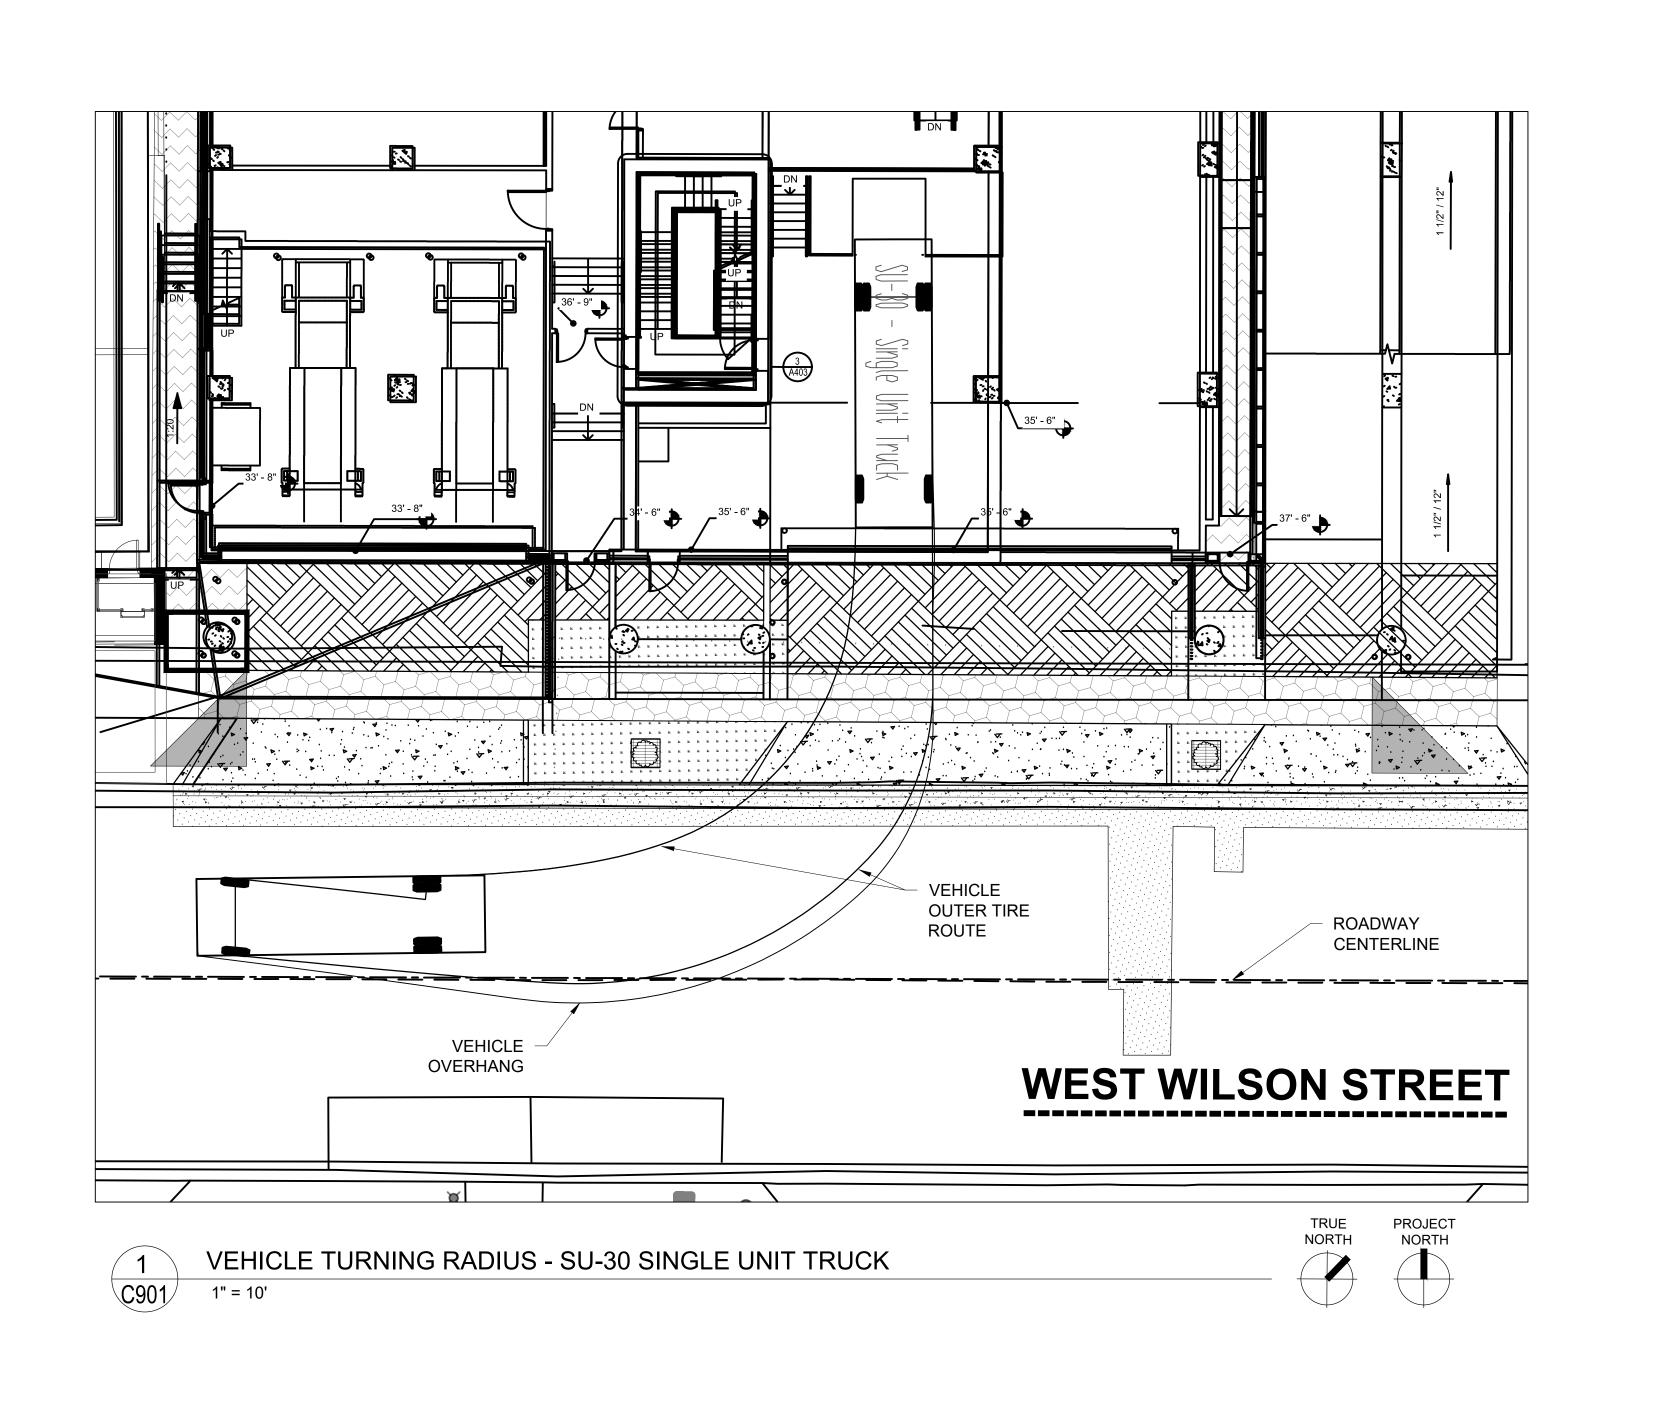

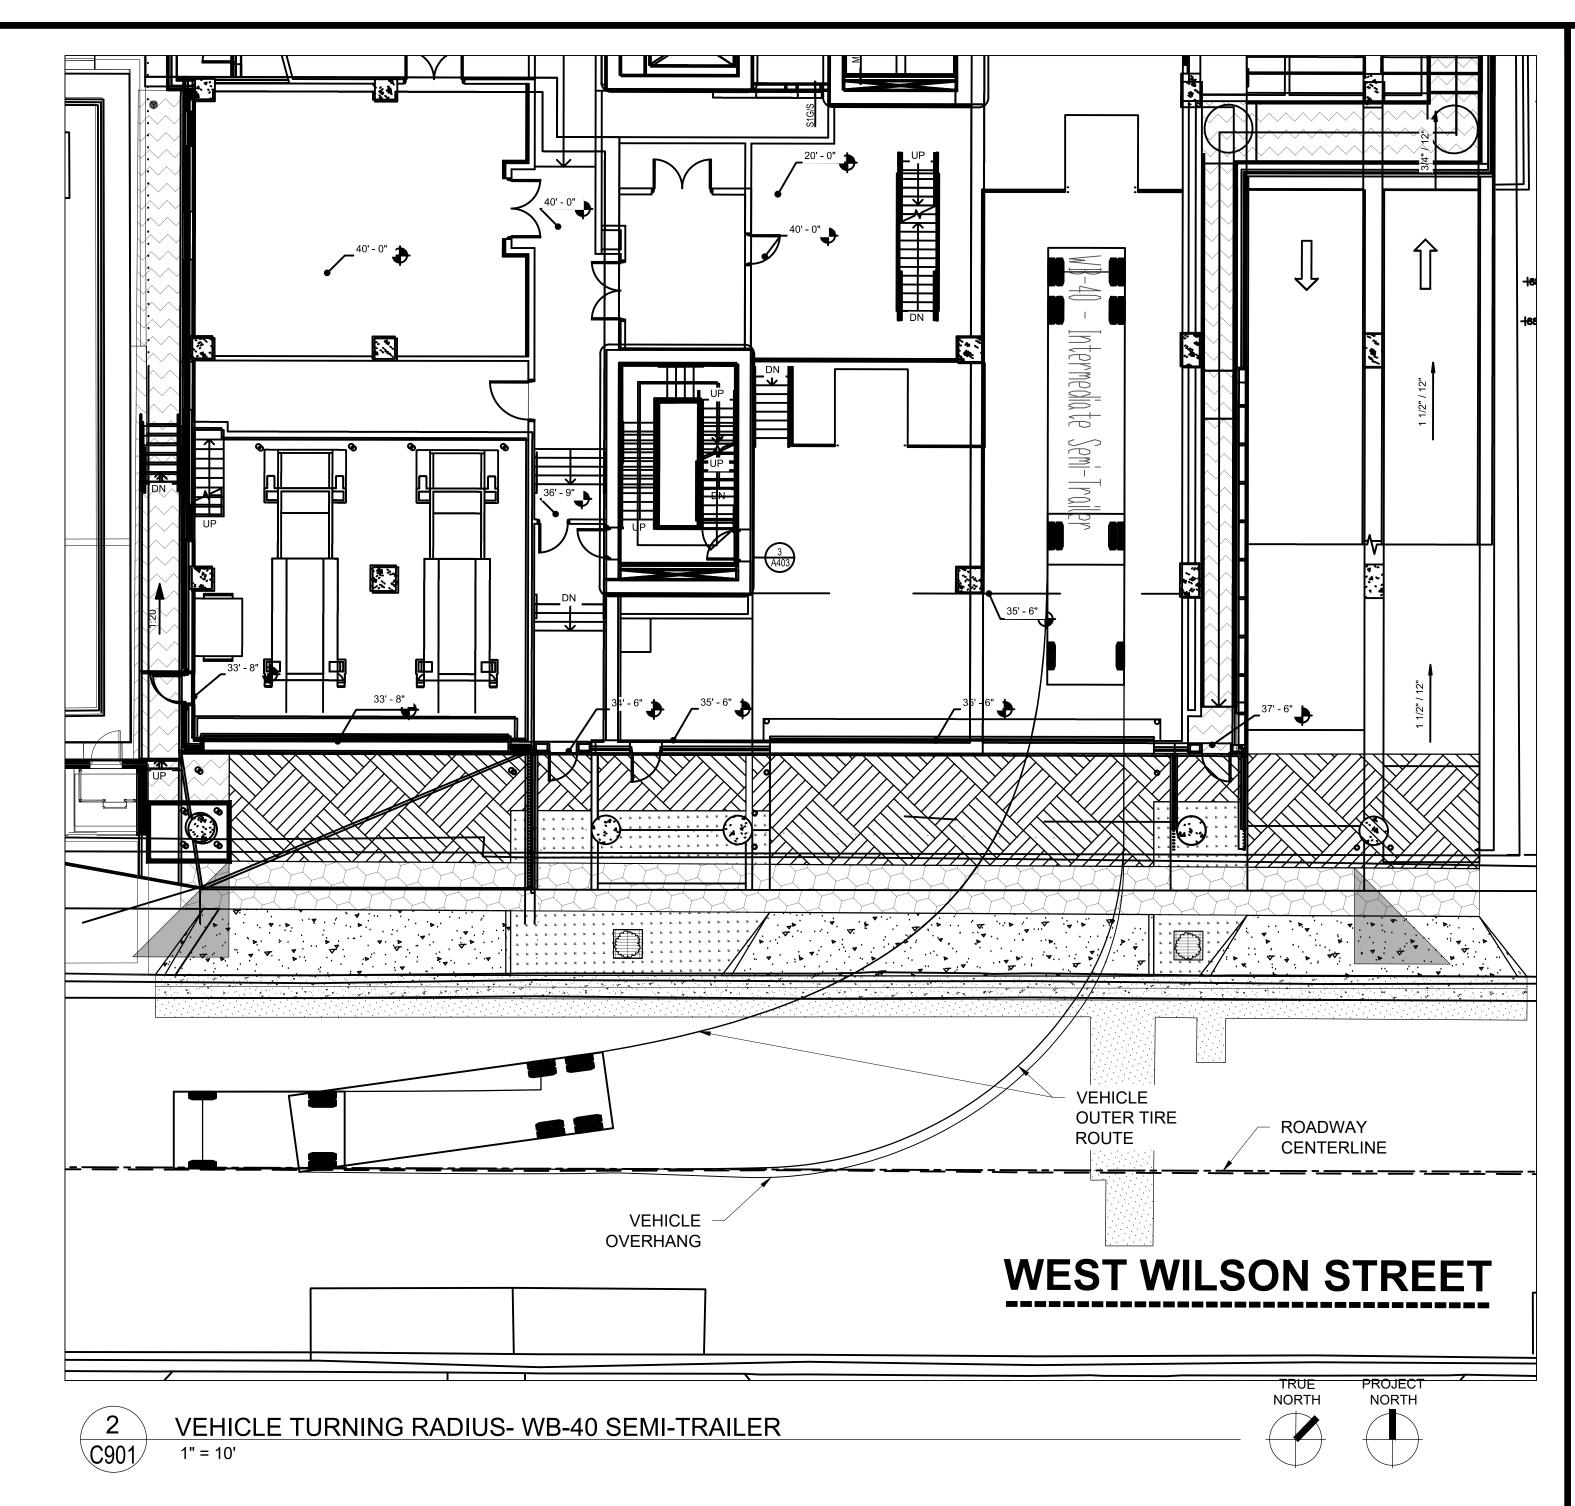

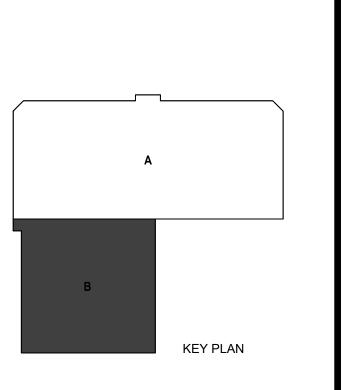

PLAN

TRUE NORTH

NORTH

Building Renovation
Madison, WI 53703

Dane County Jail Consolidation
South Tower Addition & Public Safety
Huilding Renovation
Madison, WI 53703

DANE COUNTY DEPT. OF PUBLIC WORKS, HIGHWAY &

TRANSPORTATION 1919 ALLIANT ENERGY

CENTER WAY MADISON, WI 53713

PROJECT NO. 318025

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LAND USE APPLICATION

NOT FOR CONSTRUCTION


M&H NO.: 4215400-161957.01 DATE: 04/07/2022 DESIGNED BY: BRB

CHECKED BY: RJ DO NOT SCALE DRAWINGS

SHEET CONTENTS VEHICLE TURNING RADIUS EXHIBITS

DRAWN BY: RH

C901

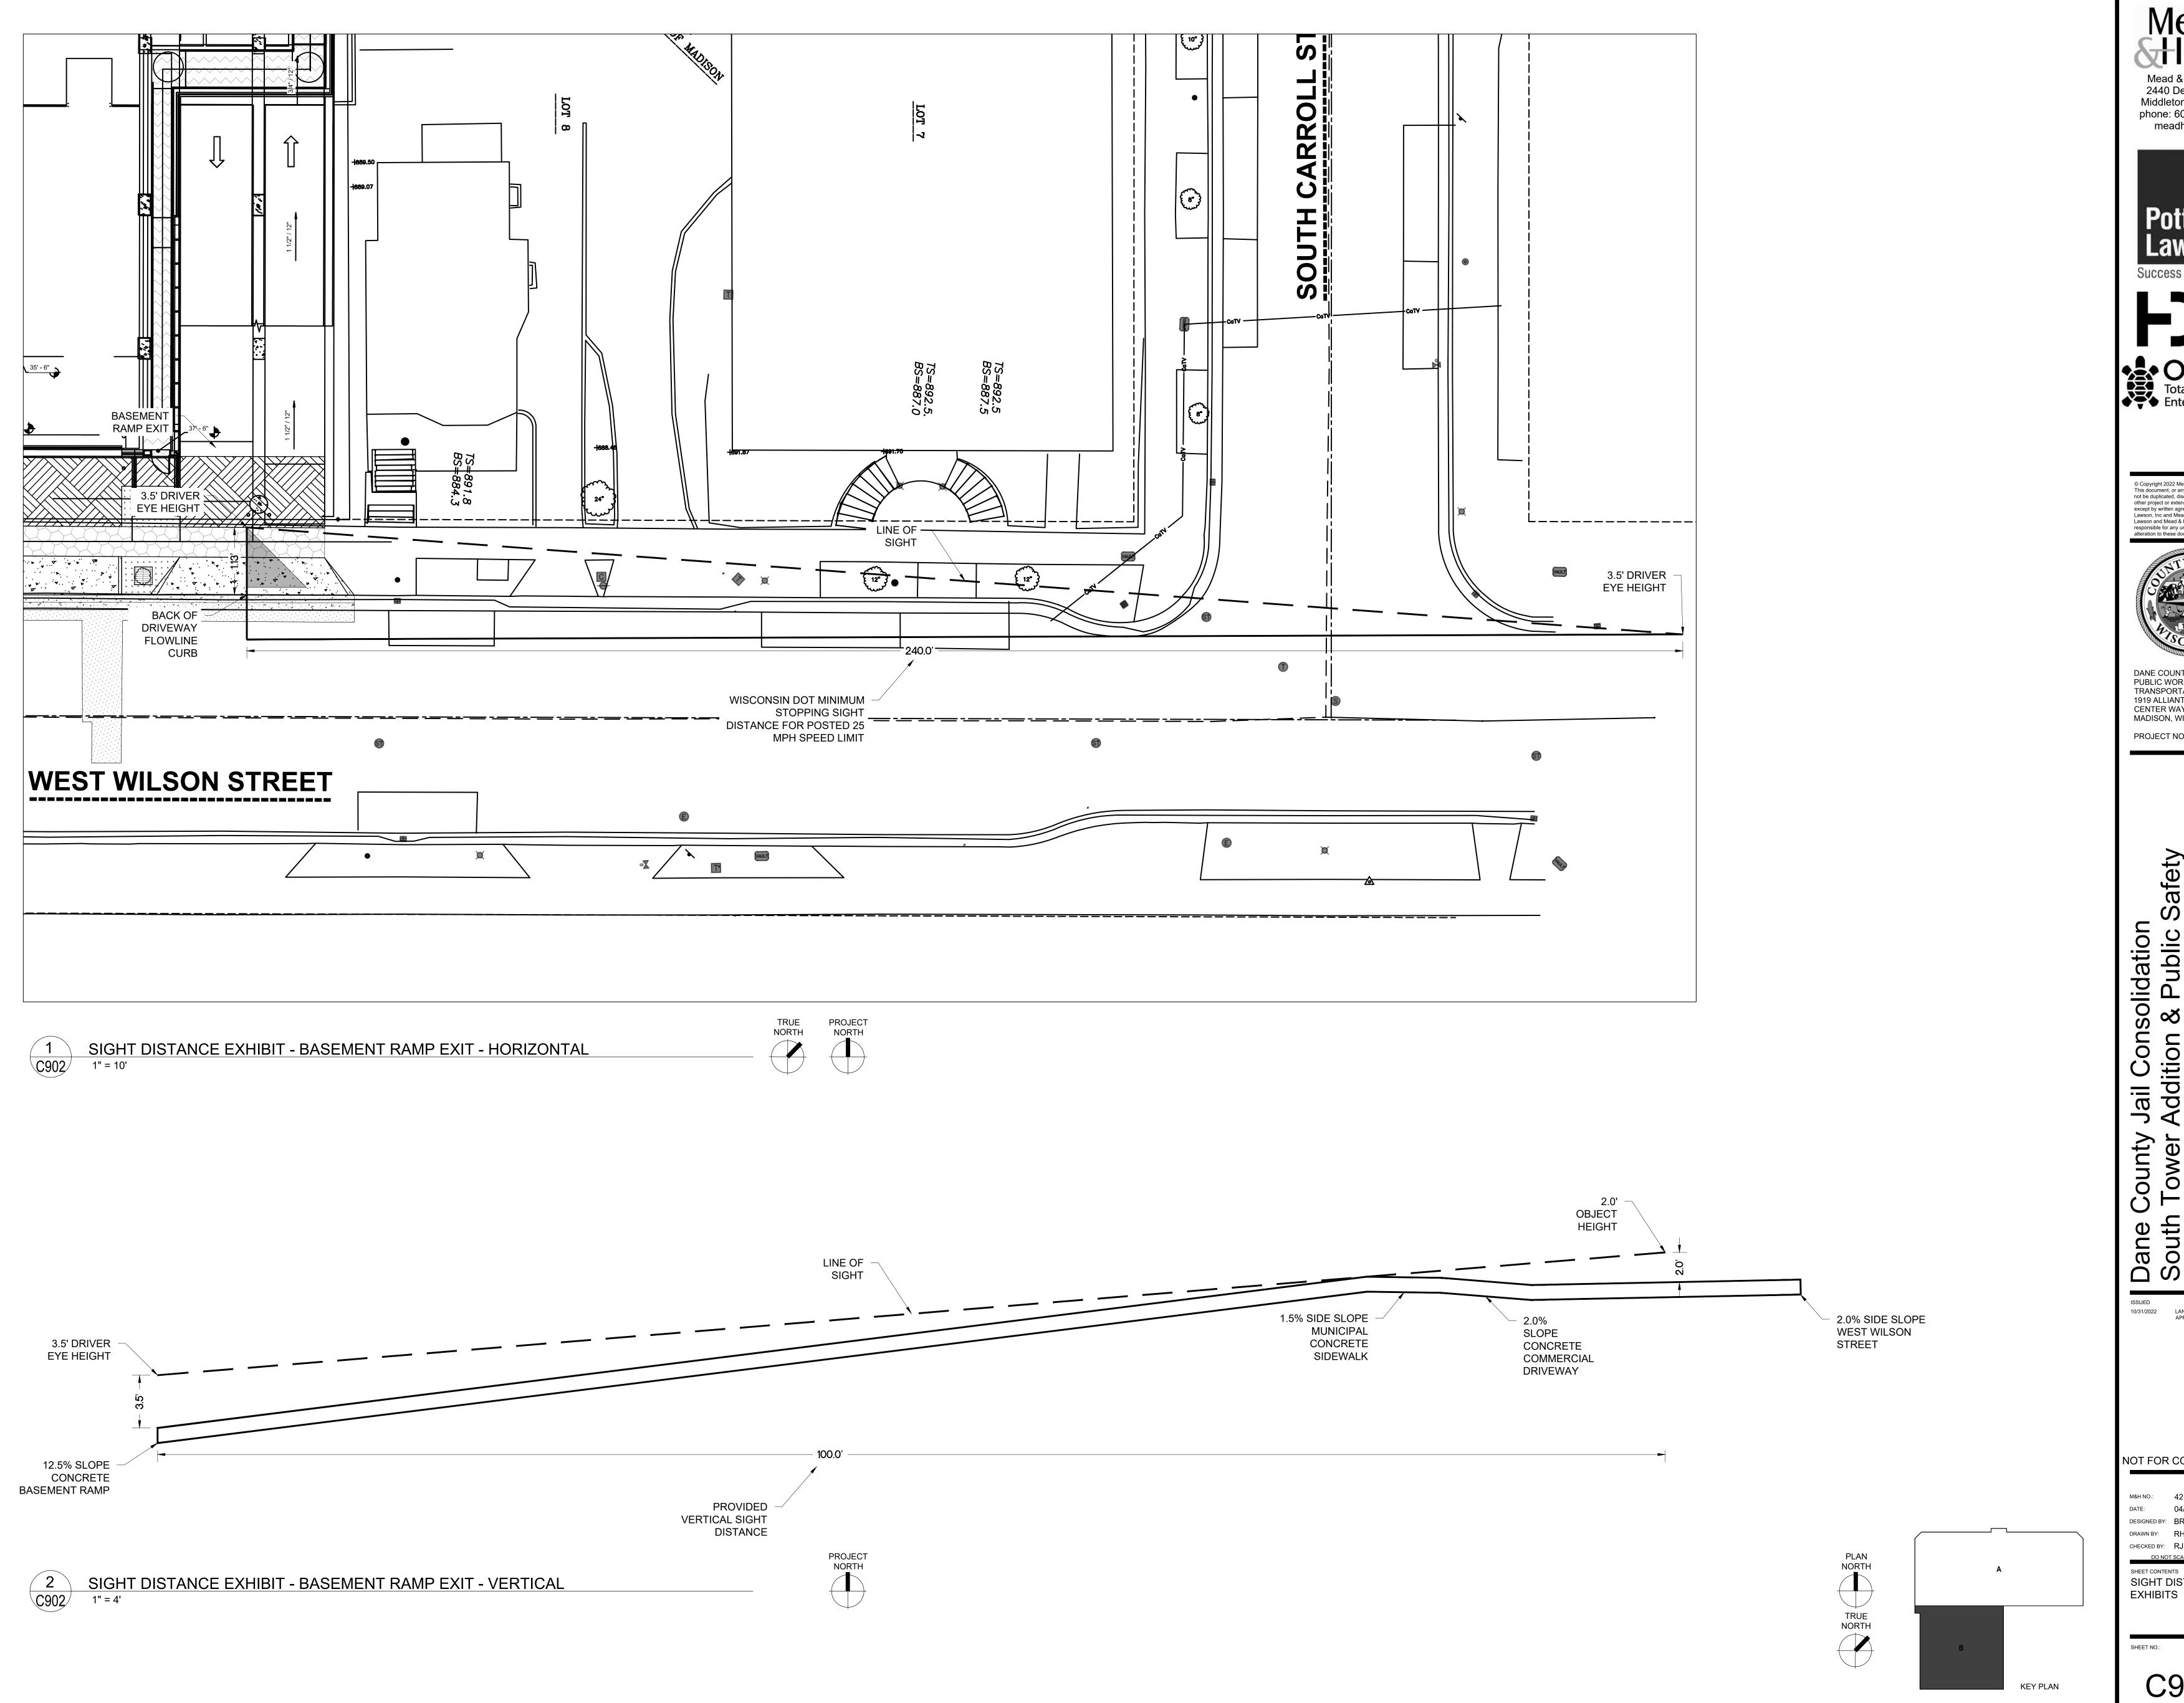


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DANE COUNTY DEPT. OF PUBLIC WORKS, HIGHWAY & TRANSPORTATION 1919 ALLIANT ENERGY CENTER WAY MADISON, WI 53713

PROJECT NO. 318025

Dane County Jail Consolidation
South Tower Addition & Public Sa
Building Renovation
Madison, WI 53703

LAND USE APPLICATION

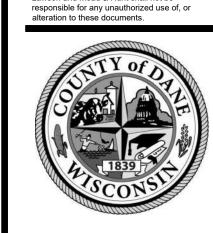NOT FOR CONSTRUCTION

M&H NO.: 4215400-161957.01 DESIGNED BY: BRB DRAWN BY: RH CHECKED BY: RJ

SHEET CONTENTS SIGHT DISTANCE


C902



WILLIAMSON SURVEYING AND ASSOCIATES, LLC
NOA T. PRIEVE & CHRIS W. ADAMS, PROFESSIONAL LAND SURVEYORS

NOA T. PRIEVE & WEST MAIN STREET, WAUNAKEE, WISCONSIN, 53597 PHDNE: 608-255-5705

Located in the NW and SW 1/4's of the NW 1/4 of Section 24, T7N, R9E, City of Madison, Dane County, Wisconsin. Including all of Lots 1, 2, 3, 4, 5, 6, 9, 10, 11, 12, 13 and 14 of Block 71, Original Plat of Madison, Vol. A, Page 3

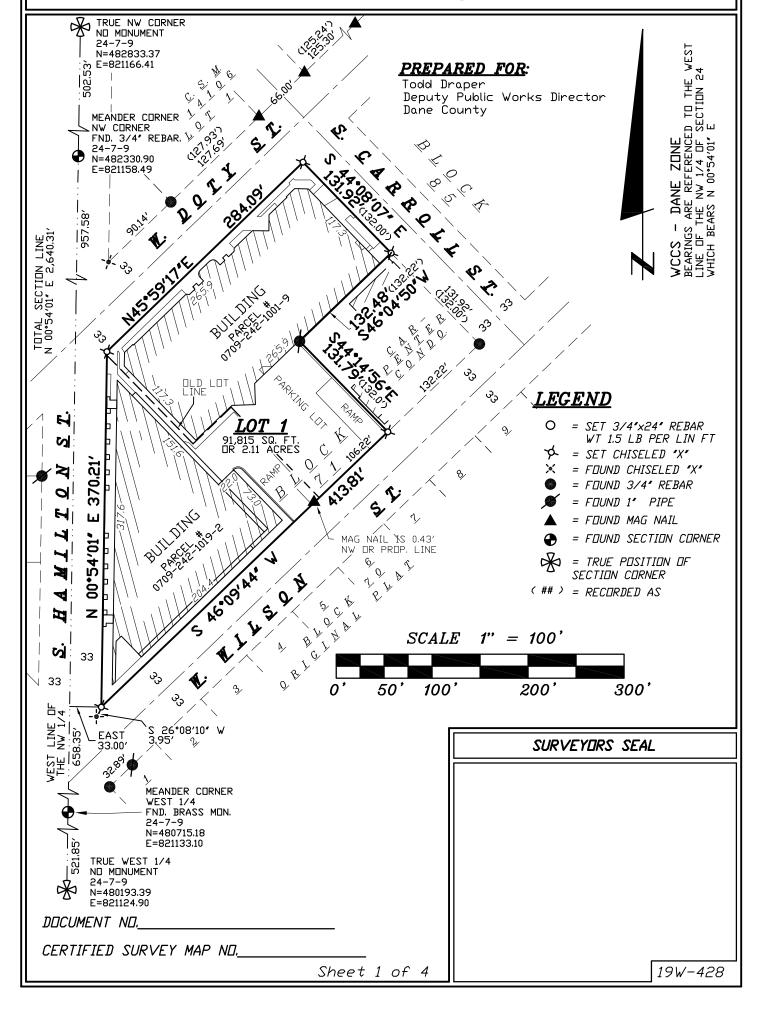




WILLIAMSON SURVEYING AND ASSOCIATES, LLC
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NOA T. PRIEVE & C A WEST MAIN STREET, WAUNAKEE, WISCONSIN, 53597 PHONE: 608-255-5705

Located in the NW and SW 1/4's of the NW 1/4 of Section 24, T7N, R9E, City of Madison, Dane County, Wisconsin. Including all of Lots 1, 2, 3, 4, 5, 6, 9, 10, 11, 12, 13 and 14 of Block 71, Original Plat of Madison, Vol. A, Page 3



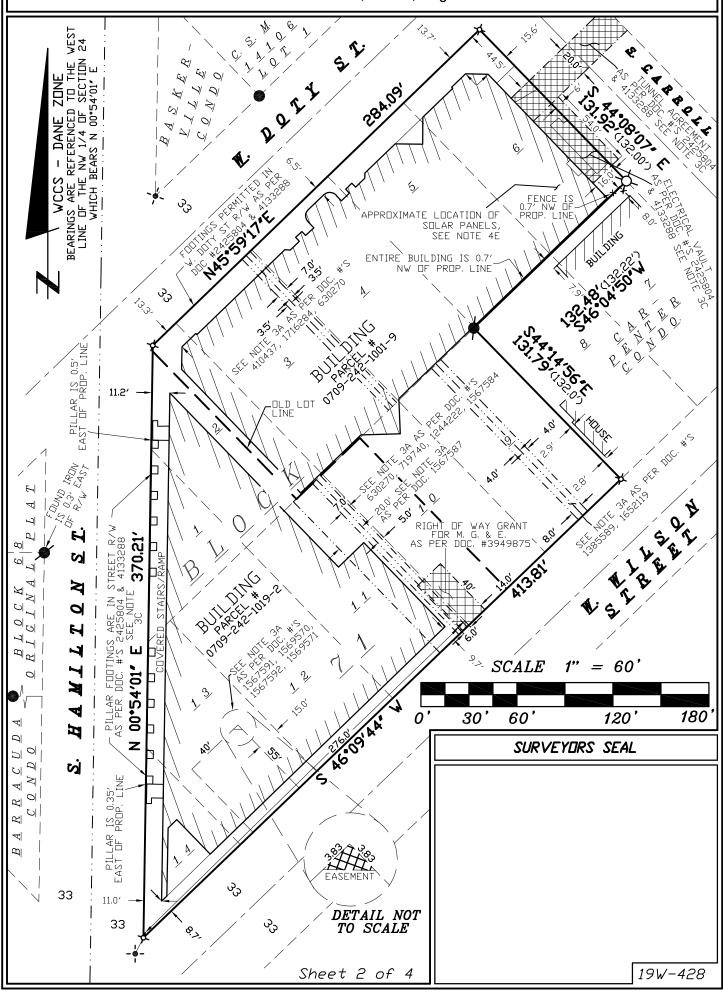

# CERTIFIED SURVEY MAP WILLIAMSON SURVEYING AND ASSOCIATES, LLC

NOA T. PRIEVE & CHRIS W. ADAMS, PROFESSIONAL LAND SURVEYORS
104 A WEST MAIN STREET, WAUNAKEE, WISCONSIN, 53597 PHONE: 608-255-5705

Located in the NW and SW 1/4's of the NW 1/4 of Section 24, T7N, R9E, City of Madison, Dane County, Wisconsin. Including all of Lots 1, 2, 3, 4, 5, 6, 9, 10, 11, 12, 13 and 14 of Block 71, Original Plat of Madison, Vol. A, Page 3

#### SURVEYOR'S CERTIFICATE

I, Chris W. Adams, Registered Land Surveyor hereby certify that in full compliance with the provisions of Chapter 236.34 Wisconsin Statutes, the subdivision regulations of City of Madison, and by the direction of the owners listed below, I have surveyed and mapped a correct representation of all of the exterior boundaries of the land surveyed, being part of the NW and SW 1/4's of the NW 1/4 of Section 24, T7N, R9E, City of Madison, Dane County, Wisconsin. Including all of Lots 1, 2, 3, 4, 5, 6, 9, 10, 11, 12, 13 and 14 of Block 71, Original Plat of Madison, Vol. A, Page 3, more particularly described as follows:

Commencing at the Meander Corner for the West 1/4 Corner of said Section 24 being N  $00^{\circ}54'01''$  E, 521.85 feet of the True West  $\frac{1}{4}$  corner; thence N  $00^{\circ}54'01''$  E along the west line of the NW 1/4 of said Section 24, 658.35 feet; thence due East, 33.00 feet to the east right of way line of South Hamilton Street and also the point of beginning.

Thence N 00°54′01″ E along said east right of way line, 370.21 feet to the southeast right of way line of West Doty Street; thence N 45°59′17″ E along said southeast right of way line, 284.09 feet to the southwest right of way line of South Carroll Street; thence S 44°08′07″ E along said southwest right of way line, 131.92 feet; thence S 46°04′50″ W, 132.48 feet; thence S 44°14′56″ E, 131.79 feet to the northwest right of way line of West Wilson Street; thence S 46°09′44″ W along said northwest right of way line, 413.81 feet to the point of beginning. The above described parcel contains 91,815 square feet or 2.11 acres.

arcer corruiris 71,013 square reet or i	11 WC1 E3,	
Date		
		Chris W. Adams S-2748 Professional Land Surveyor
OWNERS' CERTIFICATE:		
As owner, I hereby certify that I cau surveyed, divided, mapped and dedicate certify that this certified survey map approval.	d as represented (	ribed on this certified survey map to be on the certified survey map. I also submitted to the City of Madison for
As owner, I also certify that this Cer any of the leasehold or possessory in hereon.		
WITNESS the hand seal of said owners	thisday	of,20
	Brockmeyer - Dire	ector of Administration for Dane County
TATE OF WISCONSIN) ANE COUNTY)		
Personally came before me this ireg Brockmeyer to me known to be th executed the foregoing instrument and	e person who	, 20 the above named
he same.	acimo inte dige	SURVEYORS SEAL
County, Wisconsin.		
My commission expires		
Notary Public		
Print Name	Sheet 3 of 4	19W-428



# CERTIFIED SURVEY MAP

WILLIAMSON SURVEYING AND ASSOCIATES, LLC
NOA T. PRIEVE & CHRIS W. ADAMS, PROFESSIONAL LAND SURVEYORS
104 A WEST MAIN STREET, WAUNAKEE, WISCONSIN, 53597 PHONE: 608-255-5705

Located in the NW and SW 1/4's of the NW 1/4 of Section 24, T7N, R9E, City of Madison, Dane County, Wisconsin. Including all of Lots 1, 2, 3, 4, 5, 6, 9, 10, 11, 12, 13 and 14 of Block 71, Original Plat of Madison, Vol. A, Page 3

CITY OF MADISON COMMON COUNCIL:
Resolved that this Certified Survey Map located in the City of Madison was hereby approved by Enactment number, File ID Number, adopted on the day of, 20, and that said enactment further provided for the acceptance of those lands dedicated and rights conveyed by said Certified Survey Map to the City of Madison for public use.
Dated this day of, 20
Maribeth Witzel-Behl - City Clerk City of Madison, Dane County  CITY OF MADISON PLAN COMMISSION:
Approved for recording per Secretary, Madison Planning Commission action of day of, 20
By: Da te:
Secretary Plan Commission Matthew Wachter
NOTES:
1.) WETLANDS AND FLOOD PLAIN, IF PRESENT, HAVE NOT BEEN DELINEATED OR SHOWN.
2.) ALL SECTION TIES FOR THE MEANDER CORNERS OF THE NW CORNER AND THE WEST 1/4 WERE FOUND AND CHECKED.
3.) THIS SURVEY WAS MAPPED ACCORDING TO TWO 60 YEAR TITLE REPORTS DONE BY PREFERRED TITLE, FILE #'S 120010099 & 120010122.
A.) DOC. #'S 1385589, 1652119, 410437, 1716284, 630270, 719740, 1567587, 1567591, 1569570, 1567592, 1569571 ARE NULL AND VOID DUE TO THE COMBINATION OF LOTS. (DOCTRINE OF TITLE MERGER) (AS SHOWN ON MAP)
B.) ZONING DECLARATIONS ARE RECORDED AS DOC. #'S 2382515, 2390411, 3689110, (AFFECTS SUBJECT PROPERTY BUT IS BLANKET IN NATURE)
C.) THESE PROPERTIES ARE SUBJECT TO AN AGREEMENT RECORDED IN VOL. 21320 OF RECORDS, PAGE 54, AS #2425804; AMENDED AS #4133288. (AS SHOWN ON MAP)
D.) ALL OF LOTS 3, 4, 5, 6, 9 AND NE 22 FT OF LOT 2, BLOCK 71, PRITCHETTE PLAT IS SUBJECT TO PLANS RECORDED AS #4405050. (THE PURPOSE IS FOR A 50' RADIO TOWER) (PLANS ARE ILLEGIBLE)
E.) ALL OF LOTS 3, 4, 5, 6, 9 AND NE 22 FT OF LOT 2, BLOCK 71, PRITCHETTE PLAT IS SUBJECT TO PLANS RECORDED AS #4727797. (THE PURPOSE IS FOR SOLAR PANELS) (APPROXIMATE LOCATION IS SHOWN ON MAP)
G.) ALL OF LOTS 2, 11, 12, 13, 14 AND SW 44 FT OF LOT 2, BLOCK 71, PRITCHETTE PLAT IS SUBJECT TO A RIGHT OF WAY GRANT UNDERGROUND ELECTRIC TO MADISON GAS AND ELECTRIC COMPANY RECORDED AS DOC. #3949875. (AS SHOWN ON MAP)
REGISTER OF DEEDS:
Received for recording this day of
, 20 at o'clockM. and recorded in Volume of Dane County Certified Surveys on pages through
Kristi Chlebowski Register of Deeds
D□CUMENT N□
CERTIFIED SURVEY MAP NO

Sheet 4 of 4

19W-428



Oneida Total Integrated Enterprises, LLC 1033 North Mayfair Road, Suite 200 Milwaukee, WI 53226 P (414) 257-4200 F (414) 257-2492 www.otie.com

March 27, 2020


**RE:** Tax Key No.: 251/0709-242-1001-9:

**Dane County Jail Consolidation Project:** 

Storm Water Management Plan Hydrology Concept Report

This report demonstrates that this project's proposed blue and green roof combination will satisfy City of Madison storm water management requirements.

Exhibit A displayed below presents the proposed project area represented within a red polygon. The proposed project will demolish the existing paved parking lot and construct a new eight-story County detention center, making it a redevelopment project.

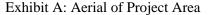



The City of Madison has incorporated new storm water management requirements that require the use of green infrastructure that captures the first ½-inch of rainfall and reduces peak runoff rates and volumes. Specifically, the following reductions are required:

- Reduce peak runoff rates from the site by 15% compared to existing conditions during a 10-year design storm
- Reduce runoff volumes from the site by 5% compared to existing conditions during a 10-year design storm.

OTIE performed a hydrology analysis using Hydraflow software. Technical Release 55 (TR-55) "Urban Hydrology for Small Watersheds" developed by the United State Department of Agriculture (USDA), Natural Resources Conservation Service (NRCS) methodology was used to perform this analysis.

Tax Key No.: 251/0709-242-1001-9: Dane County Jail Consolidation Project: Storm Water Management Plan Hydrology Concept Report March 27, 2020 Page 2

Table B displayed below presents a summary of the hydrology analysis results. One single 6-in diameter roof drain was used to accomplish these results.

Table B: Hydrology Analysis Summary

	Existing	Proposed	Reduction
Area, impervious	18,000 s.f. (0.425 ac)	14,500 s.f. (0.345 ac)	19.4%
Area, pervious	None	3,500 s.f. (0.080 ac) Green roof	N/A
Peak flow, 10-year design storm	2.612 cfs	2.077 cfs	20.5% > 15% required
Volume, 10-year design storm	6,038 c.f.	5,570 c.f.	7.75% > 5% required

These results demonstrate that the proposed blue and green roof combination will satisfy City of Madison storm water management requirements;

Please contact Mr. Brionne R. Bischke, P.E. at 414.607.6757 or <u>bbischke@otie.com</u> if you have any questions or require further clarification.

Respectfully,

**Oneida Total Integrated Enterprises** 


Brionne R. Bischke, P.E. Project Civil Engineer

**Enclosure:** 

Storm Water Management Plan Hydrology Report

Hydrograph Return Period Recap	2
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Try drog raph 140. 7, 110301 von, 11001 Drain (oin)	31
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# **Watershed Model Schematic**

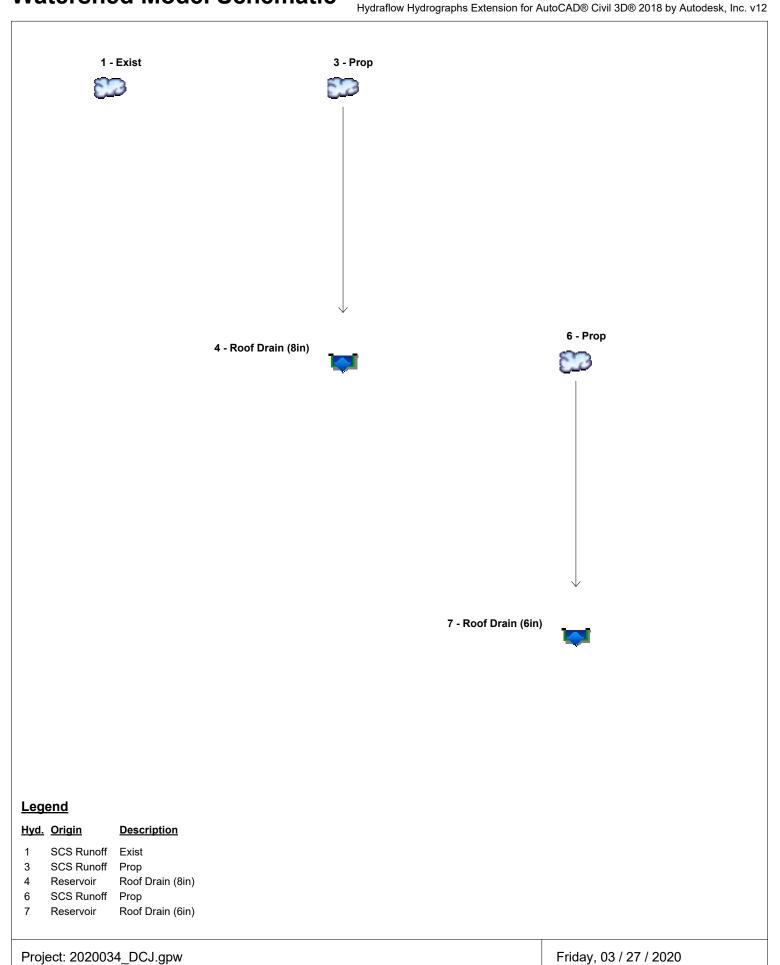

# Hydrograph Return Period Recap Hydraflow Hydrographs Extension for AutoCAD® Civil 3D® 2018 by Autodesk, Inc. v12

		Inflow	Peak Outflow (cfs)							Hydrograph	
lo.	type (origin)	hyd(s)	1-yr	2-yr	3-yr	5-yr	10-yr	25-yr	50-yr	100-yr	Description
1	SCS Runoff			1.814			2.612			4.259	Exist
3	SCS Runoff			1.724			2.551			4.244	Prop
4	Reservoir	3		1.559			2.349			3.975	Roof Drain (8in)
6	SCS Runoff			1.724			2.551			4.244	Prop
7	Reservoir	6		1.344			2.077			2.846	Roof Drain (6in)

Proj. file: 2020034\_DCJ.gpw

Friday, 03 / 27 / 2020

# Hydrograph Summary Report Hydraflow Hydrographs Extension for AutoCAD® Civil 3D® 2018 by Autodesk, Inc. v12

łyd. No.	Hydrograph type (origin)	Peak flow (cfs)	Time interval (min)	Time to Peak (min)	Hyd. volume (cuft)	Inflow hyd(s)	Maximum elevation (ft)	Total strge used (cuft)	Hydrograph Description
1	SCS Runoff	1.814	1	727	4,119				Exist
3	SCS Runoff	1.724	1	727	3,660				Prop
4	Reservoir	1.559	1	729	3,660	3	100.09	340	Roof Drain (8in)
6	SCS Runoff	1.724	1	727	3,660				Prop
7	Reservoir	1.344	1	730	3,660	6	100.14	544	Roof Drain (6in)
202	20034_DCJ.g	pw			Return	Period: 2 Ye	ear	Friday, 03	/ 27 / 2020

Hydraflow Hydrographs Extension for AutoCAD® Civil 3D® 2018 by Autodesk, Inc. v12

Friday, 03 / 27 / 2020


## Hyd. No. 1

**Exist** 

Hydrograph type= SCS RunoffPeak discharge= 1.814 cfsStorm frequency= 2 yrsTime to peak= 727 minTime interval= 1 minHyd. volume= 4,119 cuftDrainage area= 0.425 acCurve number= 98

Drainage area = 0.425 acCurve number = 98 Hydraulic length Basin Slope = 4.0 % = 100 ftTime of conc. (Tc) Tc method = User  $= 6.00 \, \text{min}$ Total precip. = 2.82 inDistribution = Custom

Storm duration = Q:\2020 Projects\2020034 - Mathabet funtabane County 48th Consolidation\02 Des

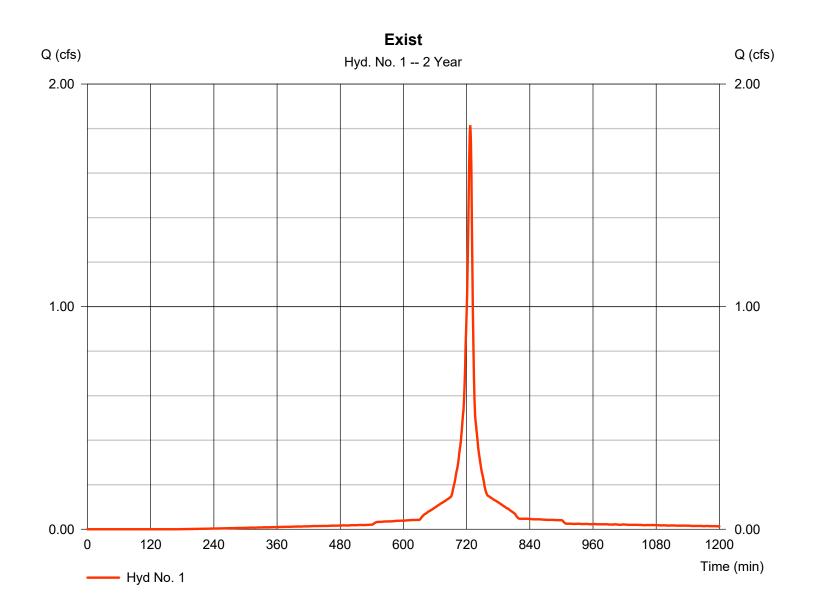


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Friday, 03 / 27 / 2020

## Hyd. No. 1

**Exist** 

Storm Frequency = 2 yrs Time interval = 1 min
Total precip. = 2.8200 in Distribution = Custom

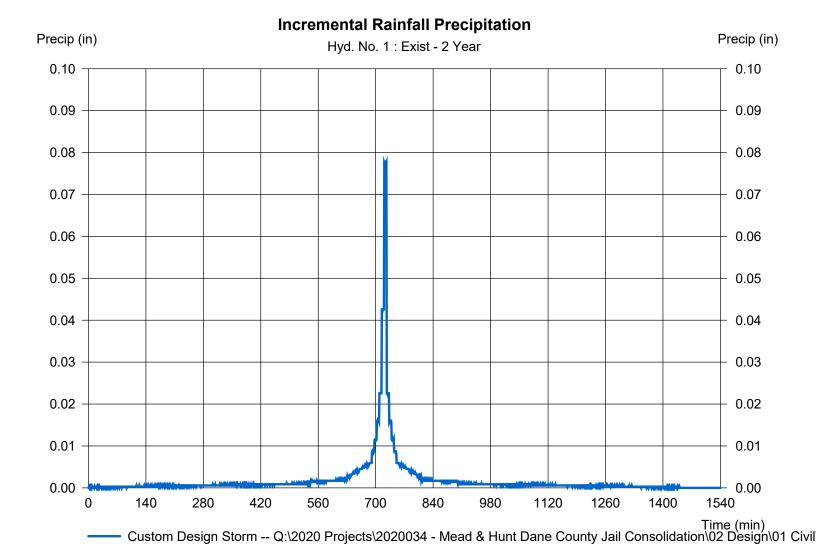

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Friday, 03 / 27 / 2020

## Hyd. No. 3


Prop

Hydrograph type= SCS RunoffPeak discharge= 1.724 cfsStorm frequency= 2 yrsTime to peak= 727 minTime interval= 1 minHyd. volume= 3,660 cuftDrainage area= 0.430 acCurve number= 95\*

Drainage area= 0.430 acCurve number=  $95^*$ Basin Slope= 0.0%Hydraulic length= 0.0%To method= UserTime of conc. (Tc)= 0.00% minTotal precip.= 0.00%Distribution= 0.00%

Storm duration = Q:\2020 Projects\2020034 - Math definitor and County Add Consolidation\02 Des

<sup>\*</sup> Composite (Area/CN) = [(0.350 x 98) + (0.080 x 80)] / 0.430

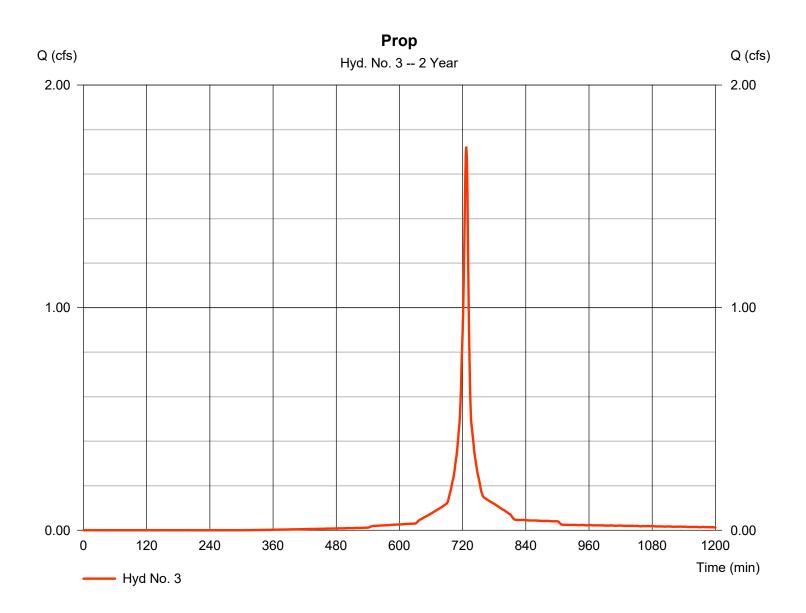


Hydraflow Hydrographs Extension for AutoCAD® Civil 3D® 2018 by Autodesk, Inc. v12

Friday, 03 / 27 / 2020

## Hyd. No. 3

Prop

Storm Frequency = 2 yrs Time interval = 1 min
Total precip. = 2.8200 in Distribution = Custom

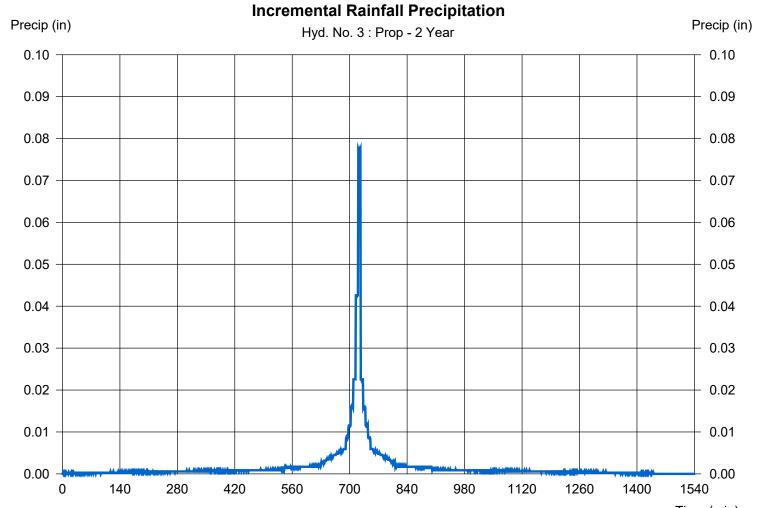

Time (min) —— Custom Design Storm -- Q:\2020 Projects\2020034 - Mead & Hunt Dane County Jail Consolidation\02 Design\01 Civil

Hydraflow Hydrographs Extension for AutoCAD® Civil 3D® 2018 by Autodesk, Inc. v12


Friday, 03 / 27 / 2020

## Hyd. No. 4

Roof Drain (8in)

Hydrograph type = Reservoir Peak discharge = 1.559 cfsStorm frequency = 2 yrsTime to peak = 729 min Time interval = 1 min Hyd. volume = 3,660 cuftMax. Elevation = 3 - Prop Inflow hyd. No. = 100.09 ftReservoir name = Roof Drain (8in) Max. Storage = 340 cuft

Storage Indication method used.

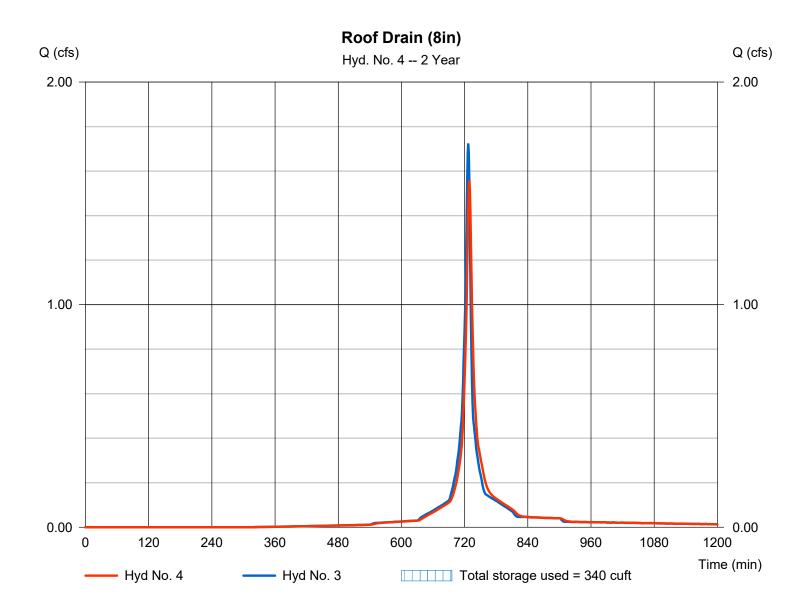

Hydraflow Hydrographs Extension for AutoCAD® Civil 3D® 2018 by Autodesk, Inc. v12

Friday, 03 / 27 / 2020

#### Pond No. 1 - Roof Drain (8in)

#### **Pond Data**


Contours -User-defined contour areas. Conic method used for volume calculation. Begining Elevation = 100.00 ft

#### Stage / Storage Table

Stage (ft)	Elevation (ft)	Contour area (sqft)	Incr. Storage (cuft)	Total storage (cuft)
0.00	100.00	4,000	0	0
0.33	100.33	4,000	1,320	1,320
1.00	101.00	4,000	2,680	4,000

Culvert / Orif	fice Structur		Weir Structures							
	[A]	[B]	[C]	[PrfRsr]			[A]	[B]	[C]	[D]
Rise (in)	= 8.00	Inactive	Inactive	Inactive	Crest Len (ft)	=	2.07	Inactive	Inactive	Inactive
Span (in)	= 8.00	0.00	0.00	0.00	Crest El. (ft)	=	100.00	0.00	0.00	0.00
No. Barrels	= 1	0	0	0	Weir Coeff.	=	3.33	3.33	3.33	3.33
Invert El. (ft)	= 95.00	0.00	0.00	0.00	Weir Type	=	1			
Length (ft)	= 100.00	0.00	0.00	0.00	Multi-Stage	=	Yes	No	No	No
Slope (%)	= 0.05	0.00	0.00	n/a						
N-Value	= .013	.013	.013	n/a						
Orifice Coeff.	= 0.60	0.60	0.60	0.60	Exfil.(in/hr)	=	0.000 (by	Wet area)		
Multi-Stage	= n/a	No	No	No	TW Elev. (ft)	=	0.00			

Note: Culvert/Orifice outflows are analyzed under inlet (ic) and outlet (oc) control. Weir risers checked for orifice conditions (ic) and submergence (s).

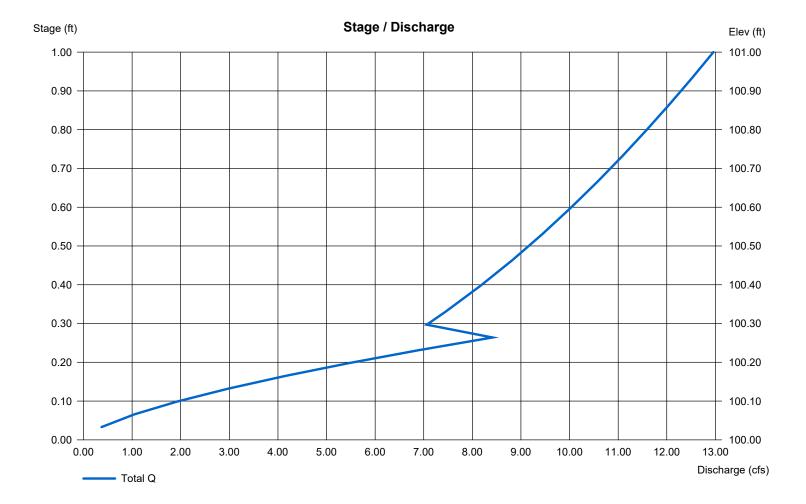

Hydraflow Hydrographs Extension for AutoCAD® Civil 3D® 2018 by Autodesk, Inc. v12

Friday, 03 / 27 / 2020


## Hyd. No. 6

Prop

Hydrograph type= SCS RunoffPeak discharge= 1.724 cfsStorm frequency= 2 yrsTime to peak= 727 minTime interval= 1 minHyd. volume= 3,660 cuftDrainage area= 0.430 acCurve number= 95\*

Storm duration = Q:\2020 Projects\2020034 - Math definitor and County Add Consolidation\02 Des

<sup>\*</sup> Composite (Area/CN) = [(0.350 x 98) + (0.080 x 80)] / 0.430

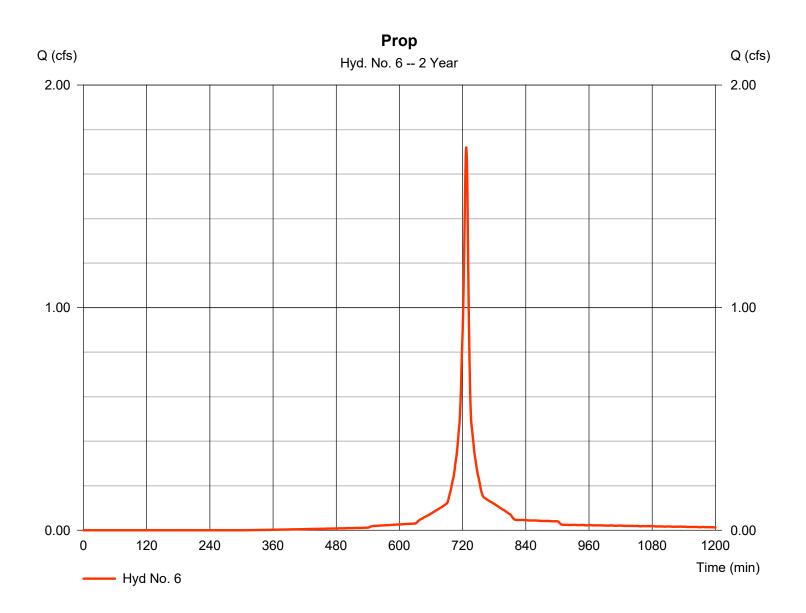


Hydraflow Hydrographs Extension for AutoCAD® Civil 3D® 2018 by Autodesk, Inc. v12

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## Hyd. No. 6

Prop

Storm Frequency = 2 yrs Time interval = 1 min
Total precip. = 2.8200 in Distribution = Custom

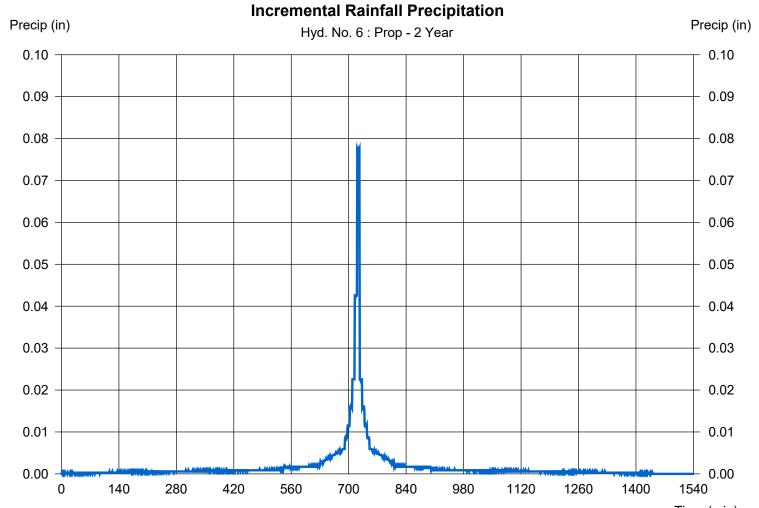

Time (min) —— Custom Design Storm -- Q:\2020 Projects\2020034 - Mead & Hunt Dane County Jail Consolidation\02 Design\01 Civil

Hydraflow Hydrographs Extension for AutoCAD® Civil 3D® 2018 by Autodesk, Inc. v12


Friday, 03 / 27 / 2020

## Hyd. No. 7

Roof Drain (6in)

= 1.344 cfsHydrograph type = Reservoir Peak discharge Storm frequency = 2 yrsTime to peak = 730 min Time interval = 1 min Hyd. volume = 3,660 cuftMax. Elevation Inflow hyd. No. = 6 - Prop = 100.14 ftReservoir name = Roof Drain (6in) Max. Storage = 544 cuft

Storage Indication method used.

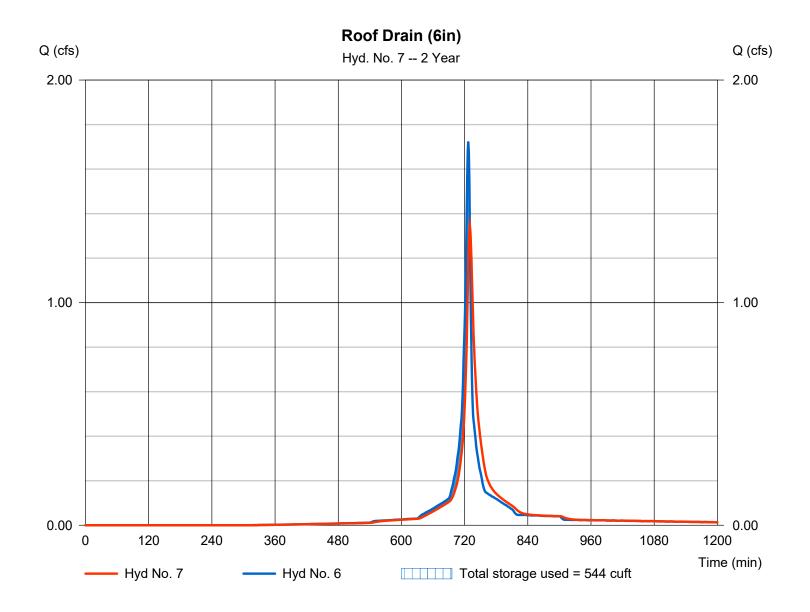

Hydraflow Hydrographs Extension for AutoCAD® Civil 3D® 2018 by Autodesk, Inc. v12

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#### Pond No. 2 - Roof Drain (6in)

#### **Pond Data**


Contours -User-defined contour areas. Conic method used for volume calculation. Begining Elevation = 100.00 ft

#### Stage / Storage Table

Elevation (ft)	Contour area (sqft)	Incr. Storage (cuft)	Total storage (cuft)
100.00	4,000	0	0
100.33	4,000	1,320	1,320
101.00	4,000	2,680	4,000
	100.00 100.33	100.00 4,000 100.33 4,000	100.00 4,000 0 100.33 4,000 1,320

Culvert / Ori	fice Structur	Weir Structures								
	[A]	[B]	[C]	[PrfRsr]			[A]	[B]	[C]	[D]
Rise (in)	= 6.00	Inactive	Inactive	Inactive	Crest Len (ft)	=	1.57	Inactive	Inactive	Inactive
Span (in)	= 6.00	0.00	0.00	0.00	Crest El. (ft)	=	100.00	0.00	0.00	0.00
No. Barrels	= 1	0	0	0	Weir Coeff.	=	3.33	3.33	3.33	3.33
Invert El. (ft)	= 95.00	0.00	0.00	0.00	Weir Type	=	1			
Length (ft)	= 100.00	0.00	0.00	0.00	Multi-Stage	=	Yes	No	No	No
Slope (%)	= 0.05	0.00	0.00	n/a						
N-Value	= .013	.013	.013	n/a						
Orifice Coeff.	= 0.60	0.60	0.60	0.60	Exfil.(in/hr)	=	0.000 (by	Wet area)		
Multi-Stage	= n/a	No	No	No	TW Elev. (ft)	=	0.00			

Note: Culvert/Orifice outflows are analyzed under inlet (ic) and outlet (oc) control. Weir risers checked for orifice conditions (ic) and submergence (s).

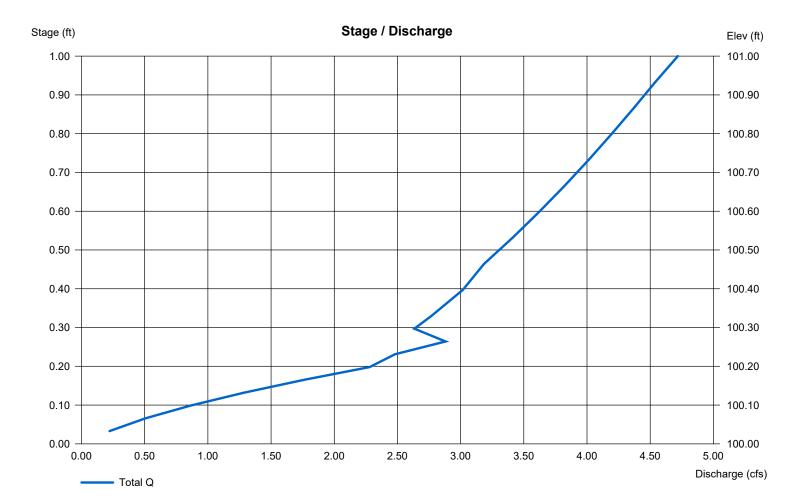

# Hydrograph Summary Report Hydraflow Hydrographs Extension for AutoCAD® Civil 3D® 2018 by Autodesk, Inc. v12

yd. o.	Hydrograph type (origin)	Peak flow (cfs)	Time interval (min)	Time to Peak (min)	Hyd. volume (cuft)	Inflow hyd(s)	Maximum elevation (ft)	Total strge used (cuft)	Hydrograph Description
1	SCS Runoff	2.612	1	727	6,038				Exist
3	SCS Runoff	2.551	1	727	5,571				Prop
4	Reservoir	2.349	1	729	5,570	3	100.11	449	Roof Drain (8in)
3	SCS Runoff	2.551	1	727	5,571				Prop
7	Reservoir	2.077	1	730	5,570	6	100.19	740	Roof Drain (6in)
	 20034_DCJ.g				Return				/ 27 / 2020

Hydraflow Hydrographs Extension for AutoCAD® Civil 3D® 2018 by Autodesk, Inc. v12

Friday, 03 / 27 / 2020


#### Hyd. No. 1

**Exist** 

Hydrograph type= SCS RunoffPeak discharge= 2.612 cfsStorm frequency= 10 yrsTime to peak= 727 minTime interval= 1 minHyd. volume= 6,038 cuft

Drainage area Curve number = 0.425 ac= 98 Hydraulic length Basin Slope = 4.0 % = 100 ftTime of conc. (Tc) Tc method = User  $= 6.00 \, \text{min}$ Distribution Total precip. = 4.03 in= Custom

Storm duration = Q:\2020 Projects\2020034 - Mestina & funt do an e Country Asia Consolidation\02 Des

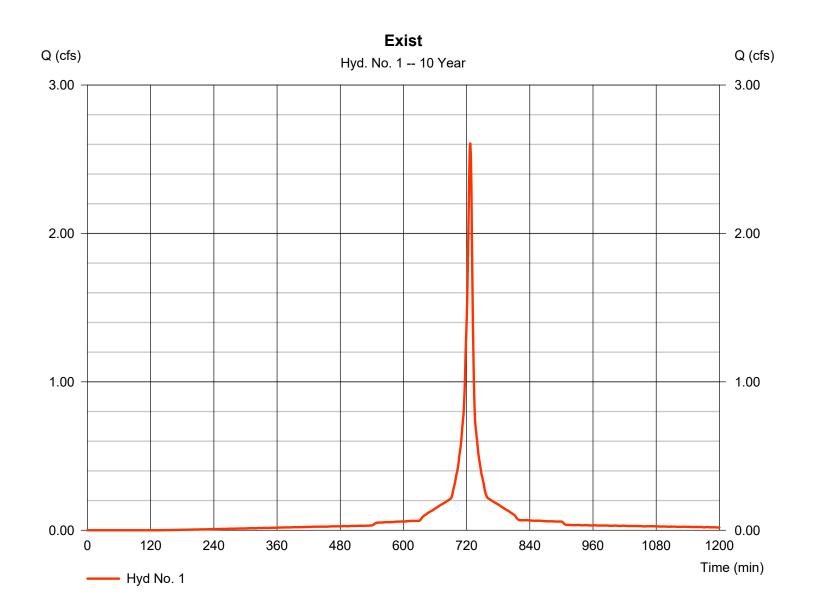


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## Hyd. No. 1

**Exist** 

Storm Frequency = 10 yrs Time interval = 1 min
Total precip. = 4.0300 in Distribution = Custom



Hydraflow Hydrographs Extension for AutoCAD® Civil 3D® 2018 by Autodesk, Inc. v12

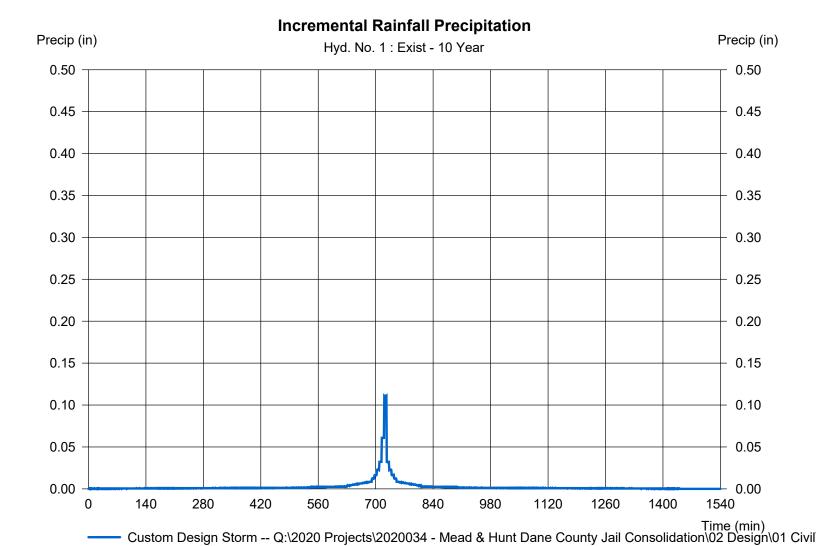Friday, 03 / 27 / 2020

## Hyd. No. 3


Prop

Hydrograph type= SCS RunoffPeak discharge= 2.551 cfsStorm frequency= 10 yrsTime to peak= 727 minTime interval= 1 minHyd. volume= 5,571 cuftDrainage area= 0.430 asCurve number= 0.65\*

Drainage area Curve number = 0.430 ac= 95\* Hydraulic length Basin Slope = 0.0 %= 0 ftTime of conc. (Tc) Tc method = User  $= 6.00 \, \text{min}$ Total precip. = 4.03 inDistribution = Custom

Storm duration = Q:\2020 Projects\2020034 - Math definitor and County Add Consolidation\02 Des

<sup>\*</sup> Composite (Area/CN) = [(0.350 x 98) + (0.080 x 80)] / 0.430

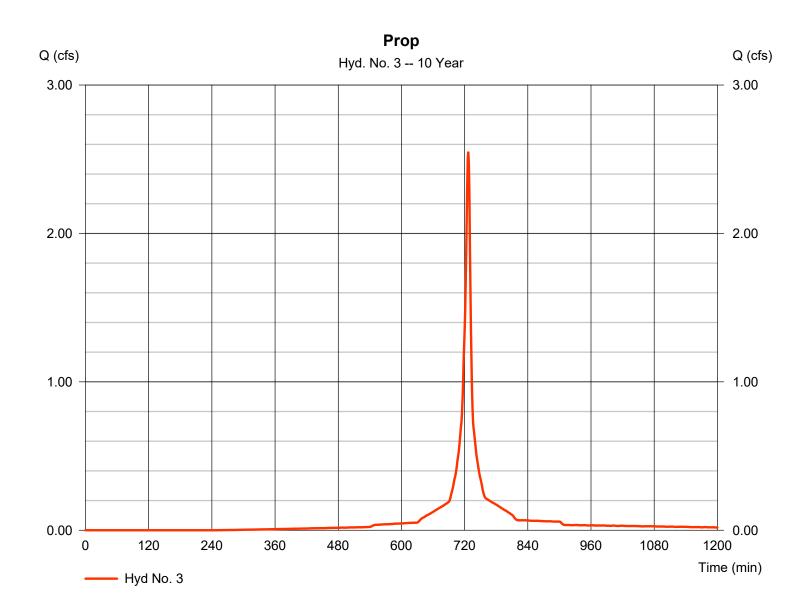


Hydraflow Hydrographs Extension for AutoCAD® Civil 3D® 2018 by Autodesk, Inc. v12

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## Hyd. No. 3

Prop

Storm Frequency = 10 yrs Time interval = 1 min
Total precip. = 4.0300 in Distribution = Custom

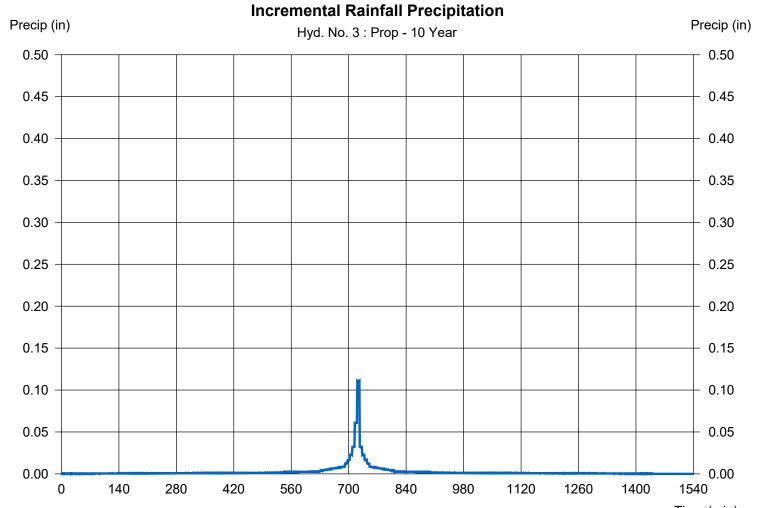

Time (min)
Custom Design Storm -- Q:\2020 Projects\2020034 - Mead & Hunt Dane County Jail Consolidation\02 Design\01 Civil

Hydraflow Hydrographs Extension for AutoCAD® Civil 3D® 2018 by Autodesk, Inc. v12


Friday, 03 / 27 / 2020

## Hyd. No. 4

Roof Drain (8in)

Hydrograph type = Reservoir Peak discharge = 2.349 cfsStorm frequency = 10 yrsTime to peak = 729 min Time interval = 1 min Hyd. volume = 5,570 cuftMax. Elevation Inflow hyd. No. = 3 - Prop  $= 100.11 \, \text{ft}$ Reservoir name = Roof Drain (8in) Max. Storage = 449 cuft

Storage Indication method used.

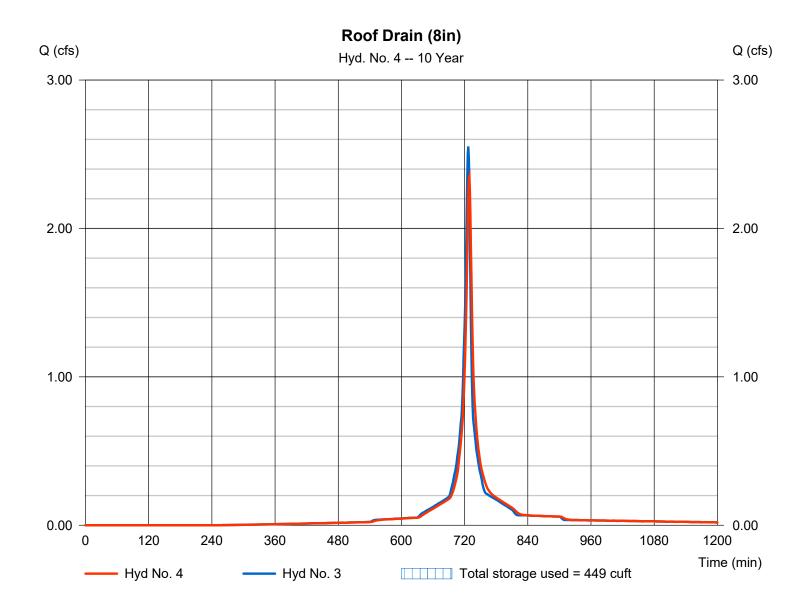

Hydraflow Hydrographs Extension for AutoCAD® Civil 3D® 2018 by Autodesk, Inc. v12

Friday, 03 / 27 / 2020


## Hyd. No. 6

Prop

Hydrograph type = SCS Runoff Peak discharge = 2.551 cfsStorm frequency Time to peak = 10 yrs= 727 min Time interval = 1 min Hyd. volume = 5,571 cuftDrainage area Curve number = 0.430 ac= 95\*

Basin Slope = 0.0 % Hydraulic length = 0 ft
Tc method = User Time of conc. (Tc) = 6.00 min
Total precip. = 4.03 in Distribution = Custom

<sup>\*</sup> Composite (Area/CN) = [(0.350 x 98) + (0.080 x 80)] / 0.430

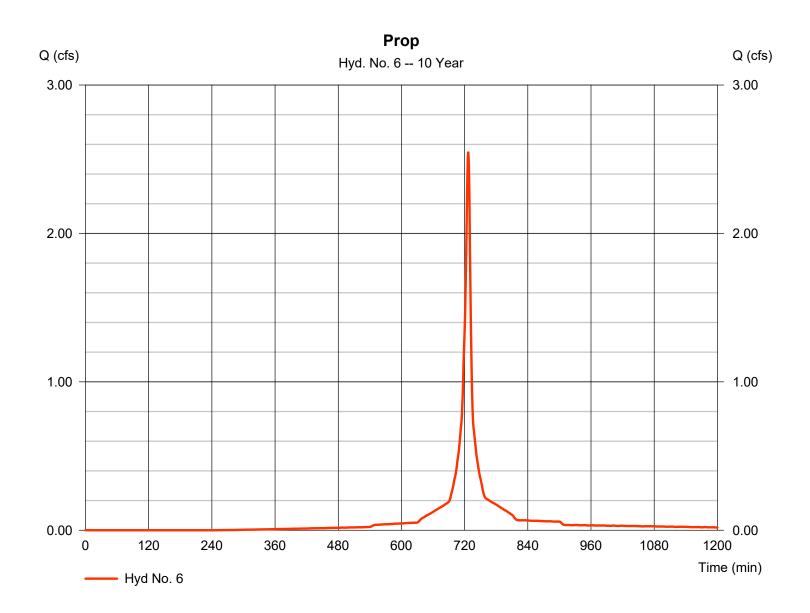


Hydraflow Hydrographs Extension for AutoCAD® Civil 3D® 2018 by Autodesk, Inc. v12

Friday, 03 / 27 / 2020

## Hyd. No. 6

Prop

Storm Frequency = 10 yrs Time interval = 1 min
Total precip. = 4.0300 in Distribution = Custom

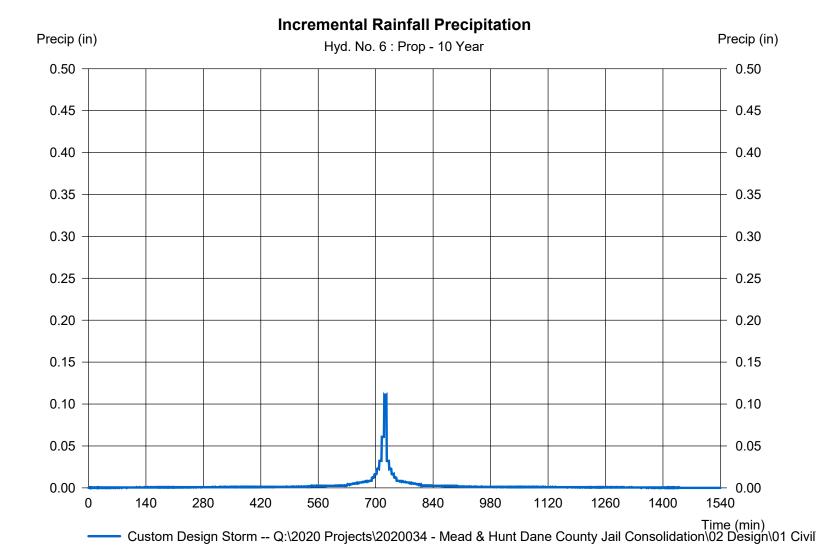

Hydraflow Hydrographs Extension for AutoCAD® Civil 3D® 2018 by Autodesk, Inc. v12


Friday, 03 / 27 / 2020

## Hyd. No. 7

Roof Drain (6in)

Hydrograph type = Reservoir Peak discharge = 2.077 cfsStorm frequency = 10 yrsTime to peak = 730 min Time interval = 1 min Hyd. volume = 5,570 cuftMax. Elevation Inflow hyd. No. = 6 - Prop = 100.19 ftReservoir name = Roof Drain (6in) Max. Storage = 740 cuft

Storage Indication method used.

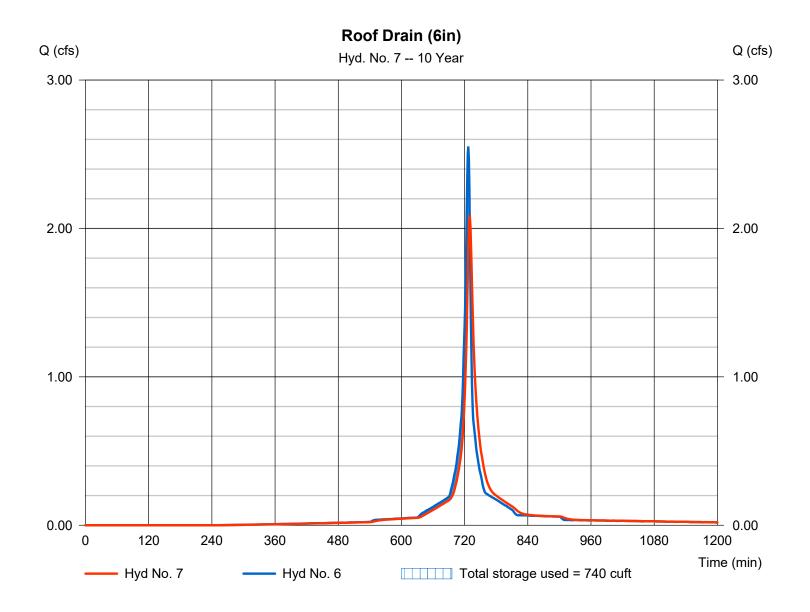

# Hydrograph Summary Report Hydraflow Hydrographs Extension for AutoCAD® Civil 3D® 2018 by Autodesk, Inc. v12

yd. o.	Hydrograph type (origin)	Peak flow (cfs)	Time interval (min)	Time to Peak (min)	Hyd. volume (cuft)	Inflow hyd(s)	Maximum elevation (ft)	Total strge used (cuft)	Hydrograph Description
1	SCS Runoff	4.259	1	727	10,025				Exist
3	SCS Runoff	4.244	1	727	9,575				Prop
4	Reservoir	3.975	1	728	9,574	3	100.16	640	Roof Drain (8in)
6	SCS Runoff	4.244	1	727	9,575				Prop
7	Reservoir	2.846	1	727	9,574	6	100.32	1,291	Roof Drain (6in)
:02	∟ 20034_DCJ.g	pw			Return I	Period: 100	Year	Friday, 03	/ 27 / 2020

Hydraflow Hydrographs Extension for AutoCAD® Civil 3D® 2018 by Autodesk, Inc. v12

Friday, 03 / 27 / 2020


#### Hyd. No. 1

**Exist** 

Hydrograph type= SCS RunoffPeak discharge= 4.259 cfsStorm frequency= 100 yrsTime to peak= 727 minTime interval= 1 minHyd. volume= 10,025 cuft

Drainage area Curve number = 98 = 0.425 acBasin Slope = 4.0 % Hydraulic length = 100 ftTime of conc. (Tc) Tc method = User  $= 6.00 \, \text{min}$ Total precip. = 6.54 inDistribution = Custom

Storm duration = Q:\2020 Projects\2020034 - Mestased funt@ane County stall\*Consolidation\02 Des

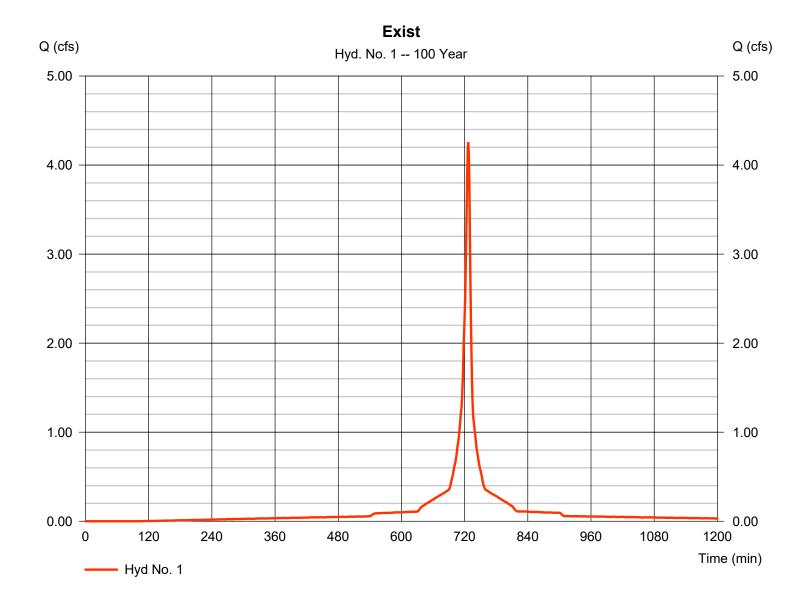


Hydraflow Hydrographs Extension for AutoCAD® Civil 3D® 2018 by Autodesk, Inc. v12

Friday, 03 / 27 / 2020

## Hyd. No. 1

**Exist** 

Storm Frequency = 100 yrs Time interval = 1 min
Total precip. = 6.5400 in Distribution = Custom

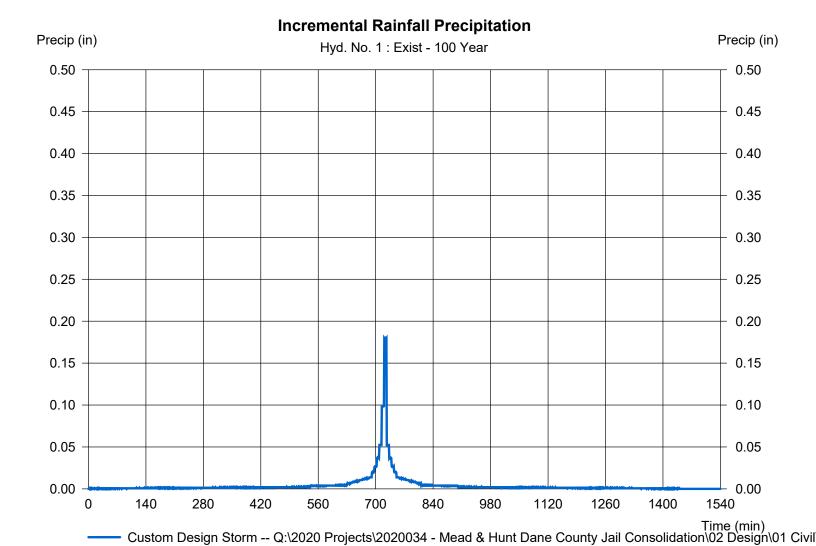

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Friday, 03 / 27 / 2020


## Hyd. No. 3

Prop

Hydrograph type= SCS RunoffPeak discharge= 4.244 cfsStorm frequency= 100 yrsTime to peak= 727 minTime interval= 1 minHyd. volume= 9,575 cuft

Drainage area Curve number = 0.430 ac= 95\* Basin Slope Hydraulic length = 0.0 %= 0 ftTc method Time of conc. (Tc) = User  $= 6.00 \, \text{min}$ Total precip. Distribution = Custom = 6.54 in

<sup>\*</sup> Composite (Area/CN) = [(0.350 x 98) + (0.080 x 80)] / 0.430

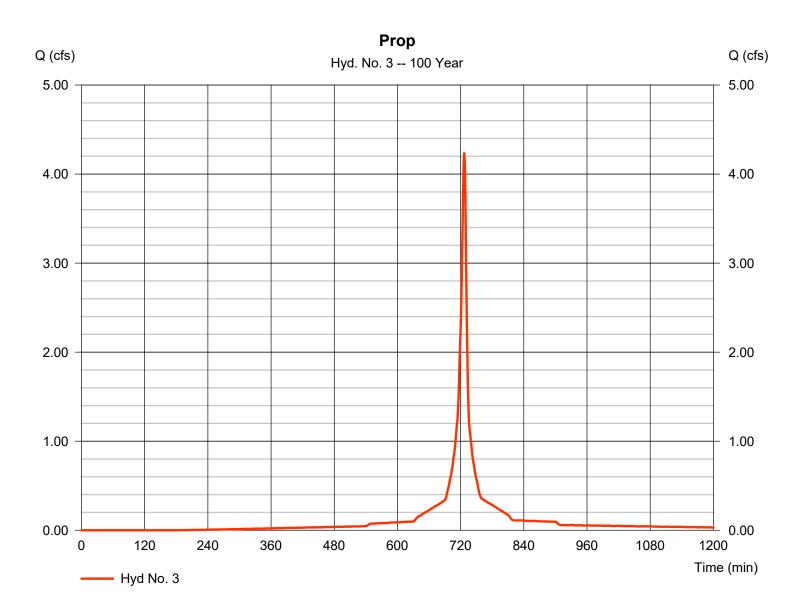


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Friday, 03 / 27 / 2020

## Hyd. No. 3

Prop

Storm Frequency = 100 yrs Time interval = 1 min
Total precip. = 6.5400 in Distribution = Custom

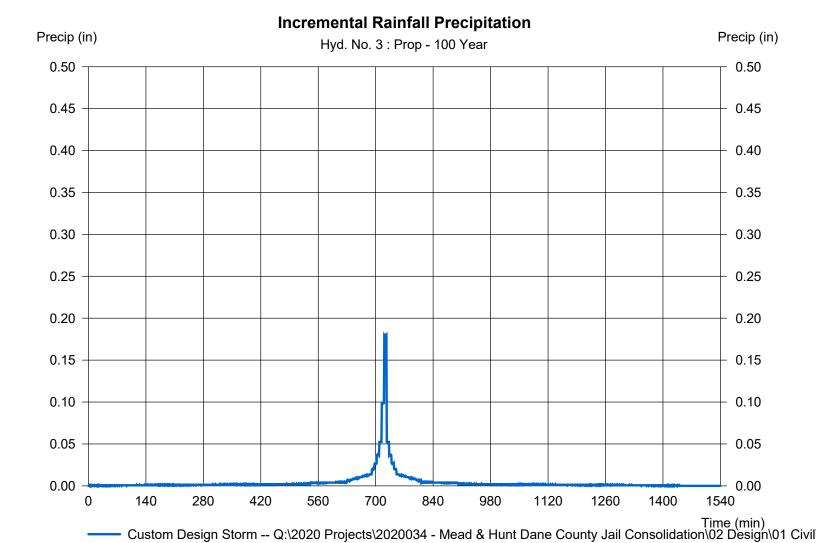

Hydraflow Hydrographs Extension for AutoCAD® Civil 3D® 2018 by Autodesk, Inc. v12


Friday, 03 / 27 / 2020

## Hyd. No. 4

Roof Drain (8in)

Hydrograph type = Reservoir Peak discharge = 3.975 cfsStorm frequency Time to peak = 728 min = 100 yrsTime interval = 1 min Hyd. volume = 9,574 cuftMax. Elevation Inflow hyd. No. = 3 - Prop  $= 100.16 \, \text{ft}$ Reservoir name = Roof Drain (8in) Max. Storage = 640 cuft

Storage Indication method used.

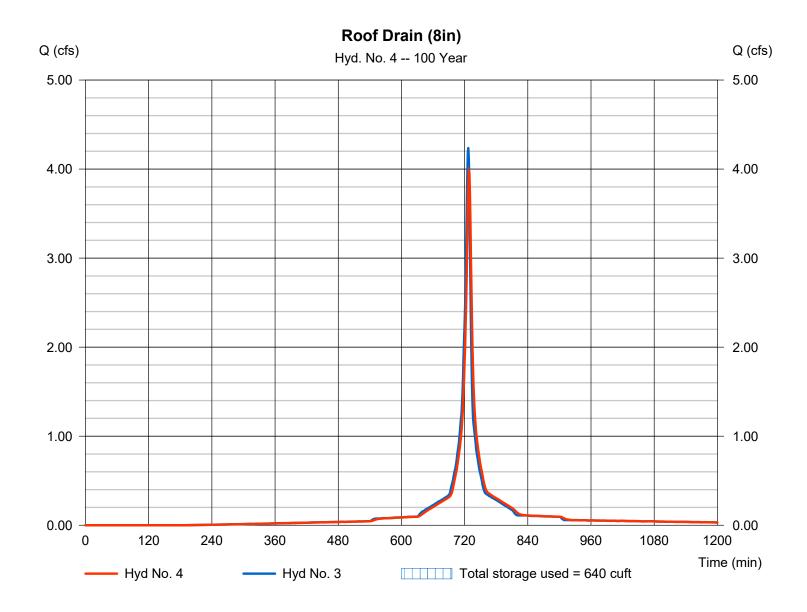

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Friday, 03 / 27 / 2020


## Hyd. No. 6

Prop

Hydrograph type= SCS RunoffPeak discharge= 4.244 cfsStorm frequency= 100 yrsTime to peak= 727 minTime interval= 1 minHyd. volume= 9,575 cuftDrainage area= 0.430 asCurve number= 0.65\*

Curve number Drainage area = 0.430 ac= 95\* Basin Slope Hydraulic length = 0.0 %= 0 ftTc method Time of conc. (Tc) = User  $= 6.00 \, \text{min}$ Total precip. Distribution = Custom = 6.54 in

<sup>\*</sup> Composite (Area/CN) = [(0.350 x 98) + (0.080 x 80)] / 0.430

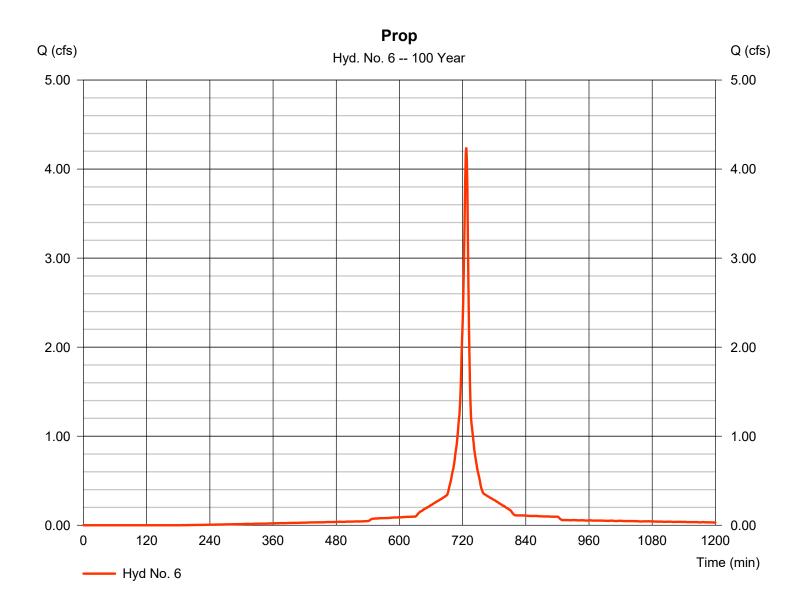


Hydraflow Hydrographs Extension for AutoCAD® Civil 3D® 2018 by Autodesk, Inc. v12

Friday, 03 / 27 / 2020

## Hyd. No. 6

Prop

Storm Frequency = 100 yrs Time interval = 1 min
Total precip. = 6.5400 in Distribution = Custom

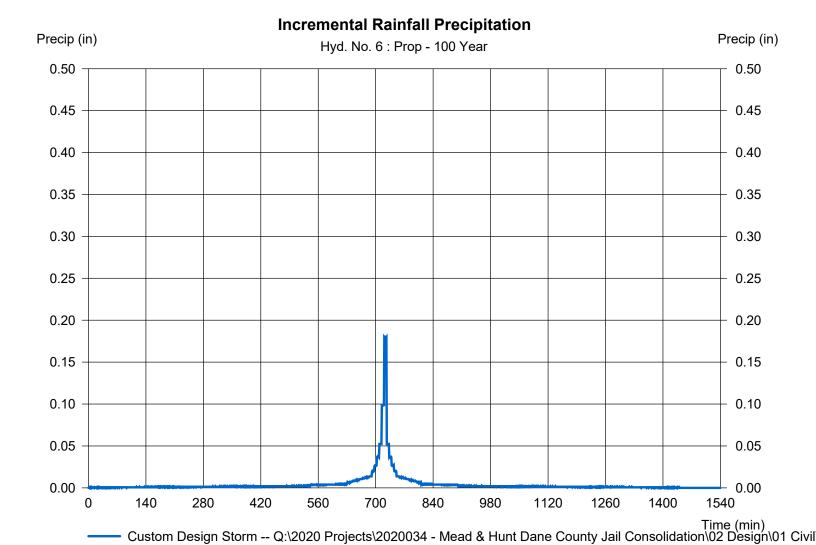

Hydraflow Hydrographs Extension for AutoCAD® Civil 3D® 2018 by Autodesk, Inc. v12


Friday, 03 / 27 / 2020

## Hyd. No. 7

Roof Drain (6in)

Hydrograph type = Reservoir Peak discharge = 2.846 cfsStorm frequency Time to peak = 727 min = 100 yrsTime interval = 1 min Hyd. volume = 9,574 cuftMax. Elevation Inflow hyd. No. = 6 - Prop = 100.32 ftReservoir name = Roof Drain (6in) Max. Storage = 1,291 cuft

Storage Indication method used.

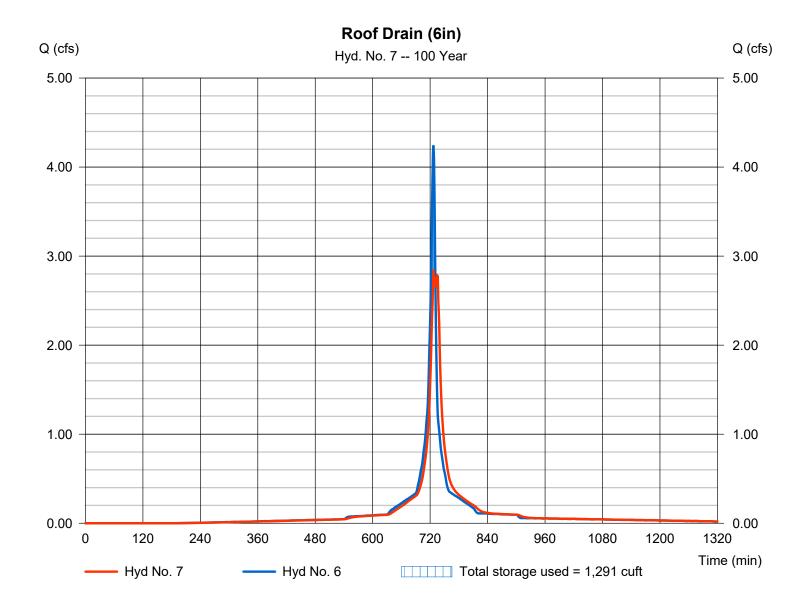

# **Hydraflow Rainfall Report**

Hydraflow Hydrographs Extension for AutoCAD® Civil 3D® 2018 by Autodesk, Inc. v12

Friday, 03 / 27 / 2020

Return Period	Intensity-Duration-Frequency Equation Coefficients (FHA)								
(Yrs)	В	D	E	(N/A)					
1	0.0000	0.0000	0.0000						
2	69.8703	13.1000	0.8658						
3	0.0000	0.0000	0.0000						
5	79.2597	14.6000	0.8369						
10	88.2351	15.5000	0.8279						
25	102.6072	16.5000	0.8217						
50	114.8193	17.2000	0.8199						
100	127.1596	17.8000	0.8186						

File name: SampleFHA.idf

#### Intensity = B / (Tc + D)^E

Return Period (Yrs)	Intensity Values (in/hr)											
	5 min	10	15	20	25	30	35	40	45	50	55	60
1	0.00	0.00	0.00	0.00	0.00	0.00	0.00	0.00	0.00	0.00	0.00	0.00
2	5.69	4.61	3.89	3.38	2.99	2.69	2.44	2.24	2.07	1.93	1.81	1.70
3	0.00	0.00	0.00	0.00	0.00	0.00	0.00	0.00	0.00	0.00	0.00	0.00
5	6.57	5.43	4.65	4.08	3.65	3.30	3.02	2.79	2.59	2.42	2.27	2.15
10	7.24	6.04	5.21	4.59	4.12	3.74	3.43	3.17	2.95	2.77	2.60	2.46
25	8.25	6.95	6.03	5.34	4.80	4.38	4.02	3.73	3.48	3.26	3.07	2.91
50	9.04	7.65	6.66	5.92	5.34	4.87	4.49	4.16	3.88	3.65	3.44	3.25
100	9.83	8.36	7.30	6.50	5.87	5.36	4.94	4.59	4.29	4.03	3.80	3.60

Tc = time in minutes. Values may exceed 60.


17L1S Peninsula SP Construct New Dump Station\02 Design\06 Storm Water Management\Hydrology\Waukesha.pcp

	Rainfall Precipitation Table (in)								
Storm Distribution	1-yr	2-yr	3-yr	5-yr	10-yr	25-yr	50-yr	100-yr	
SCS 24-hour	2.47	2.82	0.00	3.45	4.03	4.93	5.70	6.54	
SCS 6-Hr	0.00	0.00	0.00	0.00	0.00	0.00	0.00	0.00	
Huff-1st	0.00	0.00	0.00	0.00	0.00	0.00	0.00	0.00	
Huff-2nd	0.00	0.00	0.00	0.00	0.00	0.00	0.00	0.00	
Huff-3rd	0.00	0.00	0.00	0.00	0.00	0.00	0.00	0.00	
Huff-4th	0.00	0.00	0.00	0.00	0.00	0.00	0.00	0.00	
Huff-Indy	0.00	0.00	0.00	0.00	0.00	0.00	0.00	0.00	
Custom	2.47	2.82	0.00	3.45	4.03	4.93	5.70	6.54	

#### NOAA Atlas 14, Volume 8, Version 2 MADISON DANE CO AP Station ID: 47-4961



Location name: Madison, Wisconsin, USA\*
Latitude: 43.1406°, Longitude: -89.3453°

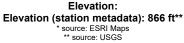



#### POINT PRECIPITATION FREQUENCY ESTIMATES

Sanja Perica, Deborah Martin, Sandra Pavlovic, Ishani Roy, Michael St. Laurent, Carl Trypaluk, Dale Unruh, Michael Yekta, Geoffery Bonnin

NOAA, National Weather Service, Silver Spring, Maryland

PF tabular | PF graphical | Maps & aerials

#### PF tabular

PDS-based point precipitation frequency estimates with 90% confidence intervals (in inches) <sup>1</sup>										
Duration	Average recurrence interval (years)									
Duration	1	2	5	10	25	50	100	200	500	1000
5-min	<b>0.368</b> (0.322-0.431)	<b>0.420</b> (0.367-0.492)	<b>0.508</b> (0.442-0.596)	<b>0.585</b> (0.506-0.689)	<b>0.698</b> (0.586-0.848)	<b>0.789</b> (0.647-0.968)	<b>0.885</b> (0.700-1.11)	<b>0.986</b> (0.748-1.26)	<b>1.13</b> (0.821-1.47)	<b>1.24</b> (0.876-1.63)
10-min	<b>0.539</b> (0.471-0.631)	<b>0.615</b> (0.537-0.720)	<b>0.744</b> (0.647-0.873)	<b>0.857</b> (0.742-1.01)	<b>1.02</b> (0.859-1.24)	<b>1.16</b> (0.947-1.42)	<b>1.30</b> (1.02-1.62)	<b>1.44</b> (1.10-1.85)	<b>1.65</b> (1.20-2.15)	<b>1.81</b> (1.28-2.39)
15-min	<b>0.658</b> (0.575-0.770)	<b>0.750</b> (0.654-0.878)	<b>0.907</b> (0.789-1.07)	<b>1.05</b> (0.904-1.23)	<b>1.25</b> (1.05-1.52)	<b>1.41</b> (1.16-1.73)	<b>1.58</b> (1.25-1.98)	<b>1.76</b> (1.34-2.25)	<b>2.01</b> (1.47-2.63)	<b>2.21</b> (1.57-2.91)
30-min	<b>0.929</b> (0.812-1.09)	<b>1.06</b> (0.925-1.24)	<b>1.28</b> (1.12-1.51)	<b>1.48</b> (1.28-1.74)	<b>1.77</b> (1.48-2.15)	<b>2.00</b> (1.64-2.45)	<b>2.24</b> (1.77-2.80)	<b>2.49</b> (1.89-3.18)	<b>2.84</b> (2.07-3.71)	<b>3.12</b> (2.21-4.11)
60-min	<b>1.18</b> (1.03-1.38)	<b>1.37</b> (1.19-1.60)	<b>1.68</b> (1.47-1.98)	<b>1.96</b> (1.70-2.31)	<b>2.36</b> (1.98-2.87)	<b>2.69</b> (2.20-3.30)	<b>3.03</b> (2.40-3.79)	<b>3.39</b> (2.57-4.33)	<b>3.88</b> (2.83-5.07)	<b>4.27</b> (3.03-5.63)
2-hr	<b>1.43</b> (1.26-1.66)	<b>1.67</b> (1.47-1.94)	<b>2.08</b> (1.82-2.43)	<b>2.44</b> (2.12-2.85)	<b>2.96</b> (2.50-3.57)	<b>3.38</b> (2.79-4.12)	<b>3.82</b> (3.04-4.75)	<b>4.28</b> (3.27-5.43)	<b>4.92</b> (3.61-6.38)	<b>5.43</b> (3.87-7.10)
3-hr	<b>1.57</b> (1.39-1.82)	<b>1.85</b> (1.63-2.14)	<b>2.32</b> (2.04-2.69)	<b>2.74</b> (2.39-3.19)	<b>3.34</b> (2.84-4.03)	<b>3.84</b> (3.17-4.66)	<b>4.35</b> (3.48-5.39)	<b>4.90</b> (3.76-6.20)	<b>5.66</b> (4.17-7.32)	<b>6.27</b> (4.49-8.17)
6-hr	<b>1.85</b> (1.64-2.12)	<b>2.15</b> (1.91-2.48)	<b>2.70</b> (2.38-3.11)	<b>3.18</b> (2.79-3.68)	<b>3.91</b> (3.35-4.69)	<b>4.51</b> (3.76-5.46)	<b>5.15</b> (4.15-6.36)	<b>5.84</b> (4.52-7.36)	<b>6.82</b> (5.07-8.78)	<b>7.60</b> (5.48-9.84)
12-hr	<b>2.17</b> (1.93-2.47)	<b>2.47</b> (2.20-2.82)	<b>3.03</b> (2.69-3.46)	<b>3.55</b> (3.13-4.07)	<b>4.34</b> (3.76-5.21)	<b>5.03</b> (4.23-6.07)	<b>5.77</b> (4.69-7.09)	<b>6.58</b> (5.13-8.27)	<b>7.75</b> (5.81-9.94)	<b>8.70</b> (6.33-11.2)
24-hr	<b>2.47</b> (2.22-2.80)	<b>2.82</b> (2.52-3.19)	<b>3.45</b> (3.08-3.91)	<b>4.03</b> (3.58-4.59)	<b>4.93</b> (4.29-5.87)	<b>5.70</b> (4.83-6.83)	<b>6.54</b> (5.35-7.98)	<b>7.45</b> (5.85-9.28)	<b>8.76</b> (6.61-11.1)	<b>9.82</b> (7.19-12.6)
2-day	<b>2.77</b> (2.49-3.11)	<b>3.23</b> (2.90-3.63)	<b>4.03</b> (3.62-4.54)	<b>4.74</b> (4.24-5.36)	<b>5.80</b> (5.05-6.81)	<b>6.67</b> (5.67-7.90)	<b>7.60</b> (6.24-9.17)	<b>8.59</b> (6.77-10.6)	<b>9.97</b> (7.56-12.6)	<b>11.1</b> (8.16-14.1)
3-day	<b>3.03</b> (2.74-3.39)	<b>3.51</b> (3.17-3.93)	<b>4.35</b> (3.92-4.88)	<b>5.09</b> (4.56-5.73)	<b>6.19</b> (5.41-7.23)	<b>7.10</b> (6.05-8.36)	<b>8.06</b> (6.64-9.68)	<b>9.08</b> (7.19-11.1)	<b>10.5</b> (8.01-13.2)	<b>11.7</b> (8.64-14.8)
4-day	<b>3.28</b> (2.97-3.65)	<b>3.76</b> (3.40-4.19)	<b>4.61</b> (4.16-5.15)	<b>5.36</b> (4.81-6.02)	<b>6.48</b> (5.68-7.55)	<b>7.41</b> (6.33-8.70)	<b>8.39</b> (6.94-10.1)	<b>9.45</b> (7.50-11.6)	<b>10.9</b> (8.35-13.7)	<b>12.1</b> (9.00-15.3)
7-day	<b>3.88</b> (3.54-4.31)	<b>4.41</b> (4.01-4.89)	<b>5.32</b> (4.83-5.91)	<b>6.13</b> (5.53-6.84)	<b>7.33</b> (6.45-8.47)	<b>8.32</b> (7.15-9.71)	<b>9.37</b> (7.78-11.1)	<b>10.5</b> (8.37-12.8)	<b>12.1</b> (9.27-15.0)	<b>13.3</b> (9.95-16.7)
10-day	<b>4.43</b> (4.05-4.89)	<b>5.00</b> (4.57-5.53)	<b>5.99</b> (5.45-6.63)	<b>6.86</b> (6.21-7.62)	<b>8.13</b> (7.16-9.33)	<b>9.16</b> (7.89-10.6)	<b>10.3</b> (8.54-12.1)	<b>11.4</b> (9.13-13.8)	<b>13.0</b> (10.0-16.1)	<b>14.3</b> (10.7-17.8)
20-day	<b>6.07</b> (5.58-6.65)	<b>6.79</b> (6.23-7.44)	<b>7.99</b> (7.31-8.78)	<b>9.01</b> (8.20-9.93)	<b>10.4</b> (9.21-11.8)	<b>11.6</b> (9.98-13.2)	<b>12.7</b> (10.6-14.8)	<b>13.9</b> (11.2-16.6)	<b>15.5</b> (12.0-18.9)	<b>16.7</b> (12.6-20.7)
30-day	<b>7.48</b> (6.90-8.16)	<b>8.35</b> (7.69-9.11)	<b>9.76</b> (8.96-10.7)	<b>10.9</b> (9.96-12.0)	<b>12.5</b> (11.0-14.0)	<b>13.7</b> (11.8-15.5)	<b>14.9</b> (12.5-17.2)	<b>16.1</b> (12.9-19.1)	<b>17.6</b> (13.7-21.4)	<b>18.8</b> (14.2-23.2)
45-day	<b>9.32</b> (8.62-10.1)	<b>10.4</b> (9.61-11.3)	<b>12.1</b> (11.1-13.2)	<b>13.5</b> (12.3-14.7)	<b>15.2</b> (13.5-17.0)	<b>16.6</b> (14.4-18.7)	<b>17.8</b> (15.0-20.5)	<b>19.0</b> (15.4-22.4)	<b>20.6</b> (16.0-24.8)	<b>21.6</b> (16.5-26.6)
60-day	<b>10.9</b> (10.1-11.8)	<b>12.2</b> (11.3-13.2)	<b>14.2</b> (13.1-15.4)	<b>15.7</b> (14.4-17.1)	<b>17.7</b> (15.7-19.6)	<b>19.1</b> (16.6-21.5)	<b>20.5</b> (17.2-23.4)	<b>21.7</b> (17.6-25.5)	<b>23.2</b> (18.1-27.9)	<b>24.3</b> (18.6-29.8)


<sup>&</sup>lt;sup>1</sup> Precipitation frequency (PF) estimates in this table are based on frequency analysis of partial duration series (PDS).

Numbers in parenthesis are PF estimates at lower and upper bounds of the 90% confidence interval. The probability that precipitation frequency estimates (for a given duration and average recurrence interval) will be greater than the upper bound (or less than the lower bound) is 5%. Estimates at upper bounds are not checked against probable maximum precipitation (PMP) estimates and may be higher than currently valid PMP values.
Please refer to NOAA Atlas 14 document for more information.

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PF graphical

PDS-based depth-duration-frequency (DDF) curves Latitude: 43.1406°, Longitude: -89.3453°

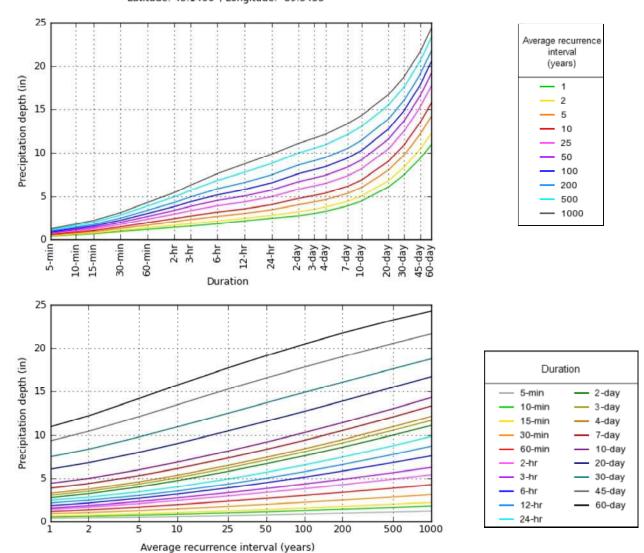



NOAA Atlas 14, Volume 8, Version 2


Created (GMT): Mon Jan 6 14:56:43 2020

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#### Maps & aerials



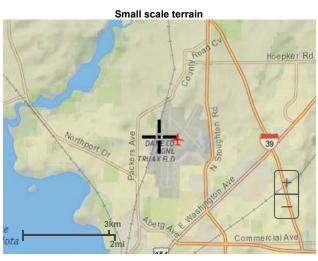

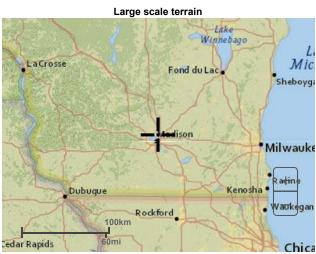

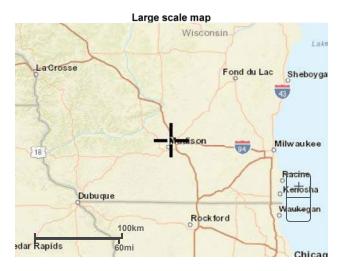

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US Department of Commerce
National Oceanic and Atmospheric Administration
National Weather Service
National Water Center
1325 East West Highway
Silver Spring, MD 20910
Questions?: HDSC.Questions@noaa.gov

<u>Disclaimer</u>

City of Madison is working on updates to our stormwater management ordinances that will enact runoff rate control requirements on <u>redevelopment</u>. I do want to stress that these are DRAFT at this point and have not been approved by the Common Council.

The following is the current language/requirements and other parameters that are being proposed for runoff rate control with redevelopment:

If the redevelopment requires a SWMP (4,000 SF of disturbance) and has proposed impervious cover that exceeds 80% of the existing site impervious cover, the site shall meet the following criteria:

- 1) Reduce peak runoff rates from the site by 15% compared to existing conditions during a 10-year design storm.
- 2) Reduce runoff volumes from the site by 5% comparted to existing conditions during a 10-year design storm.
- 3) The required rate and volume reductions shall be completed, using green infrastructure that captures at least the first 1/2 inch of rainfall over the total site impervious area. (Additional green or non-green BMPs may be used for volumes beyond the first 1/2 inch of rainfall if needed.)
- 4) The following guidance shall be used in interpreting this code:
  - a. Green Infrastructure includes, but is not limited to, the following practices: rainwater harvesting/reuse, rain gardens, bioretention systems, infiltration basins, planters that are connected to roof drainage, bioswales, permeable pavement, green roofs, and rain barrels.
  - b. An intensive greenroof with a media depth of 12" or more shall be considered to result in no runoff during a 10-year design storm and this reduction may be used to offset volumes and rates for the remainder of the site.
  - c. An extensive greenroof with media depth of a minimum of 4" shall be considered to be pervious for the purpose of meeting the lot coverage described above.
  - d. Pervious pavement designed and modeled to comply with the Wisconsin WDNR's guidance for post construction stormwater practices, and accounting for anticipated groundwater and proposed underdrains, shall be considered to be pervious for the purposes of meeting the percent lot coverage described above.

There are no proposed changes to the TSS removal standards in the current ordinance.