

City of Madison Fire Department

314 W Dayton Street, Madison, WI 53703-2506

Phone: 608-266-4420 • Fax: 608-267-1100 • E-mail: fire@cityofmadison.com

Project Address: 6706 &	6714 Odana Road
Contact Name & Phone #:	Kevin Burow, Knothe & Bruce Architects, 608-836-3690

FIRE APPARATUS ACCESS AND FIRE HYDRANT WORKSHEET

1. Is the building completely protected by an NFPA 13 or 13R automatic fire sprinkler system? If non-sprinklered, fire lanes extend to within 150-feet of all portions of the exterior wall? If sprinklered, fire lanes are within 250-feet of all portions of the exterior wall?	X Yes Yes Yes	☐ No ☐ No ☒ No	N/A N/A N/A
2. Is the fire lane constructed of concrete or asphalt, designed to support a minimum load of 85,000 lbs? a) Is the fire lane a minimum unobstructed width of at least 20-feet? b) Is the fire lane unobstructed with a vertical clearance of at least 13½-feet? c) Is the minimum inside turning radius of the fire lane at least 28-feet? d) Is the grade of the fire lane not more than a slope of 8%? e) Is the fire lane posted as fire lane? (Provide detail of signage.) f) Is a roll-able curb used as part of the fire lane? (Provide detail of curb.) g) Is part of a sidewalk used as part of the required fire lane? (Must support +85,000 lbs.)	X Yes X Yes X Yes X Yes X Yes X Yes Yes Yes Yes Yes	☐ No	 N/A N/A N/A N/A N/A N/A N/A N/A N/A
3. Is the fire lane obstructed by security gates or barricades? If yes: a) Is the gate a minimum of 20-feet clear opening? b) Is an approved means of emergency operations installed, key vault, padlock or key switch?	☐ Yes ☐ Yes ☐ Yes	No No No	N/A N/A N/A N/A
4. Is the Fire lane dead-ended with a length greater than 150-feet? If yes, does the area for turning around fire apparatus comply with IFC D103?	Yes Yes	X No No	□ N/A ▼ N/A
5. Is any portion of the building to be used for high-piled storage in accordance with IFC Chapter 3206.6 If yes, see IFC 3206.6 for further requirements.	Yes	X No	□ N/A
6. Is any part of the building greater than 30-feet above the grade plane?	X Yes	☐ No	□ N/A
If yes, answer the following questions: a) Is the aerial apparatus fire lane parallel to one entire side of the building and covering at least 25% of the perimeter? b) Is the near edge of the aerial apparatus fire lane between 15' and 30' from the building? c) Are there any overhead power or utility lines located across the aerial apparatus fire lane? d) Are there any tree canopies expected to grow across the aerial fire lane? (Based on mature	X Yes X Yes Yes Yes Yes	No No No No No No No	 N/A N/A N/A N/A N/A
If yes, answer the following questions: a) Is the aerial apparatus fire lane parallel to one entire side of the building and covering at least 25% of the perimeter? b) Is the near edge of the aerial apparatus fire lane between 15' and 30' from the building? c) Are there any overhead power or utility lines located across the aerial apparatus fire lane?	X Yes X Yes Yes	□ No □ No □ No	□ N/A □ N/A □ N/A
If yes, answer the following questions: a) Is the aerial apparatus fire lane parallel to one entire side of the building and covering at least 25% of the perimeter? b) Is the near edge of the aerial apparatus fire lane between 15' and 30' from the building? c) Are there any overhead power or utility lines located across the aerial apparatus fire lane? d) Are there any tree canopies expected to grow across the aerial fire lane? (Based on mature canopy width of tree species) e) Does the aerial apparatus fire lane have a minimum unobstructed width of 26-feet?	X Yes X Yes Yes Yes Yes Yes	NoNoNoNoNoNo	 N/A N/A N/A N/A N/A
If yes, answer the following questions: a) Is the aerial apparatus fire lane parallel to one entire side of the building and covering at least 25% of the perimeter? b) Is the near edge of the aerial apparatus fire lane between 15' and 30' from the building? c) Are there any overhead power or utility lines located across the aerial apparatus fire lane? d) Are there any tree canopies expected to grow across the aerial fire lane? (Based on mature canopy width of tree species) e) Does the aerial apparatus fire lane have a minimum unobstructed width of 26-feet? f) Is the space between the aerial lane and the building free of trees exceeding 20' in heights?	X Yes X Yes Yes Yes X Yes X Yes X Yes X Yes X Yes	☐ No ☐ No ☑ No ☑ No ☑ No ☐ No ☐ No ☐ No	 N/A N/A N/A N/A N/A N/A N/A

Attach an additional sheet if further explanation is required for any answers.

This worksheet is based on MGO 34.503 and IFC 2015 Edition Chapter 5 and Appendix D; please see the codes for further information.

GENERAL NOTES

THE APPLICANT SHALL REPLACE ALL SIDEWALK AND CURB AND GUTTER THAT ABUTS THE PROPERTY THAT IS DAMAGED BY THE CONSTRUCTION, OR ANY SIDEWALK AND CURB AND GUTTER WHICH THE CITY ENGINEER DETERMINES NEEDS TO BE REPLACED BECAUSE IT IS NOT AT A DESIRABLE GRADE, REGARDLESS OF WHETHER THE CONDITION EXISTED PRIOR TO BEGINNING CONSTRUCTION.

2. ALL WORK IN THE PUBLIC RIGHT OF WAY SHALL BE PERFORMED BY A CITY-LICENSED CONTRACTOR.

3. ALL DAMAGE TO THE PAVEMENT ON CITY STREETS, AND ADJACENT TO THIS DEVELOPMENT SHALL BE RESTORED IN ACCORDANCE WITH THE CITY OF MADISON'S PAVEMENT PATCHING CRITERIA.

4. ALL PROPOSED STREET TREE REMOVALS WITHIN THE RIGHT OF WAY SHALL BE REVIEWED BY CITY FORESTRY BEFORE THE PLAN COMMISSION MEETING. STREET TREE REMOVALS REQUIRE APPROVAL AND A TREE REMOVAL PERMIT ISSUED BY CITY FORESTRY. ANY STREET TREE REMOVALS REQUESTED AFTER THE DEVELOPMENT PLAN IS APPROVED BY THE PLAN COMMISSION OR THE BOARD OF PUBLIC WORKS AND CITY FORESTRY WILL REQUIRE A MINIMUM OF A 72-HOUR REVIEW PERIOD WHICH SHALL INCLUDE THE NOTIFICATION OF THE ALDERPERSON WITHIN WHO'S DISTRICT IS AFFECTED BY THE STREET TREE REMOVAL(S) PRIOR TO A TREE REMOVAL PERMIT BEING ISSUED.

5. AS DEFINED BY THE SECTION 107.13 OF CITY OF MADISON STANDARD SPECIFICATIONS FOR PUBLIC WORKS CONSTRUCTION: NO EXCAVATION IS PERMITTED WITHIN 5 FEET OF THE TRUNK OF THE STREET TREE OR WHEN CUTTING ROOTS OVER 3 INCHES IN DIAMETER. IF EXCAVATION IS NECESSARY THE CONTRACTOR SHALL CONTACT MADISON CITY FORESTRY (266-4816) PRIOR TO EXCAVATION. CITY OF MADISON FORESTRY PERSONNEL SHALL ASSESS THE IMPACT TO THE TREE AND TO ITS ROOT SYSTEM PRIOR TO WORK COMMENCING. TREE PROTECTION SPECIFICATIONS CAN BE FOUND ON THE FOLLOWING WEBSITE:

CITYOFMADISON.COM/BUSINESS/PW/SPECS.CFM

6. CONTRACTOR SHALL TAKE PRECAUTIONS DURING CONSTRUCTION TO NOT DISFIGURE, SCAR OR IMPAIR THE HEALTH OF ANY STREET TREE. CONTRACTOR SHALL OPERATE EQUIPMENT IN A MANNER AS TO NOT DAMAGE THE BRANCHES OF THE STREET TREE(S). THIS MAY REQUIRE USING SMALLER EQUIPMENT AND LOADING AND UNLOADING MATERIALS IN A DESIGNATED SPACE AWAY FROM TREES ON THE CONSTRUCTION SITE. ANY DAMAGE OR INJURY TO EXISTING STREET TREES (EITHER ABOVE OR BELOW GROUND) SHALL BE REPORTED IMMEDIATELY TO CITY FORESTRY AT 266-4816. PENALTIES AND REMEDIATION SHALL BE REQUIRED.

SECTION 107.13(G) OF CITY OF MADISON STANDARD SPECIFICATIONS FOR PUBLIC WORKS CONSTRUCTION ADDRESSES SOIL COMPACTION NEAR STREET TREES AND SHALL BE FOLLOWED BY CONTRACTOR. THE STORAGE OF PARKED VEHICLES, CONSTRUCTION EQUIPMENT, BUILDING MATERIALS, REFUSE, EXCAVATED SPOILS OR DUMPING OF POISONOUS MATERIALS ON OR AROUND TREES AND ROOTS WITHIN FIVE (5) FEET OF THE TREE OR WITHIN THE PROTECTION ZONE IS PROHIBITED.


8. ON THIS PROJECT, STREET TREE PROTECTION ZONE FENCING IS REQUIRED. THE FENCING SHALL BE ERECTED BEFORE THE DEMOLITION, GRADING OR CONSTRUCTION BEGINS. THE FENCE SHALL INCLUDE THE ENTIRE WIDTH OF TERRACE AND, EXTEND AT LEAST 5 FEET ON BOTH SIDES OF THE OUTSIDE EDGE OF THE TREE TRUNK. DO NOT REMOVE THE FENCING TO ALLOW FOR DELIVERIES OR EQUIPMENT ACCESS THROUGH THE TREE PROTECTION ZONE.

9. STREET TREE PRUNING SHALL BE COORDINATED WITH MADISON FORESTRY AT A MINIMUM OF TWO WEEKS PRIOR TO THE START OF CONSTRUCTION FOR THIS PROJECT. ALL PRUNING SHALL FOLLOW THE AMERICAN NATIONAL STANDARDS INSTITUTE (ANSI) A300 - PART I STANDARDS FOR PRUNING.


10. AT LEAST ONE WEEK PRIOR TO STREET TREE PLANTING, CONTRACTOR SHALL CONTACT CITY FORESTRY AT (608) 266-4816 TO SCHEDULE INSPECTION AND APPROVAL OF NURSERY TREE STOCK AND REVIEW PLANTING SPECIFICATIONS WITH THE LANDSCAPER.

II. APPROVAL OF PLANS FOR THIS PROJECT DOES NOT INCLUDE ANY APPROVAL TO PRUNE, REMOVE, OR PLANT TREES IN THE PUBLIC RIGHT-OF-WAY. PERMISSION FOR SUCH ACTIVITIES MUST BE OBTAINED FROM THE CITY FORESTER (266-4816).

12. THE PUBLIC RIGHT-OF-WAY IS THE SOLE JURISDICTION OF THE CITY OF MADISON AND IS SUBJECT TO CHANGE AT ANY TIME. NO ITEMS SHOWN ON THIS SITE PLAN IN THE RIGHT-OF-WAY ARE PERMANENT AND MAY NEED TO BE REMOVED AT THE APPLICANTS EXPENSE UPON NOTIFICATION BY THE CITY.

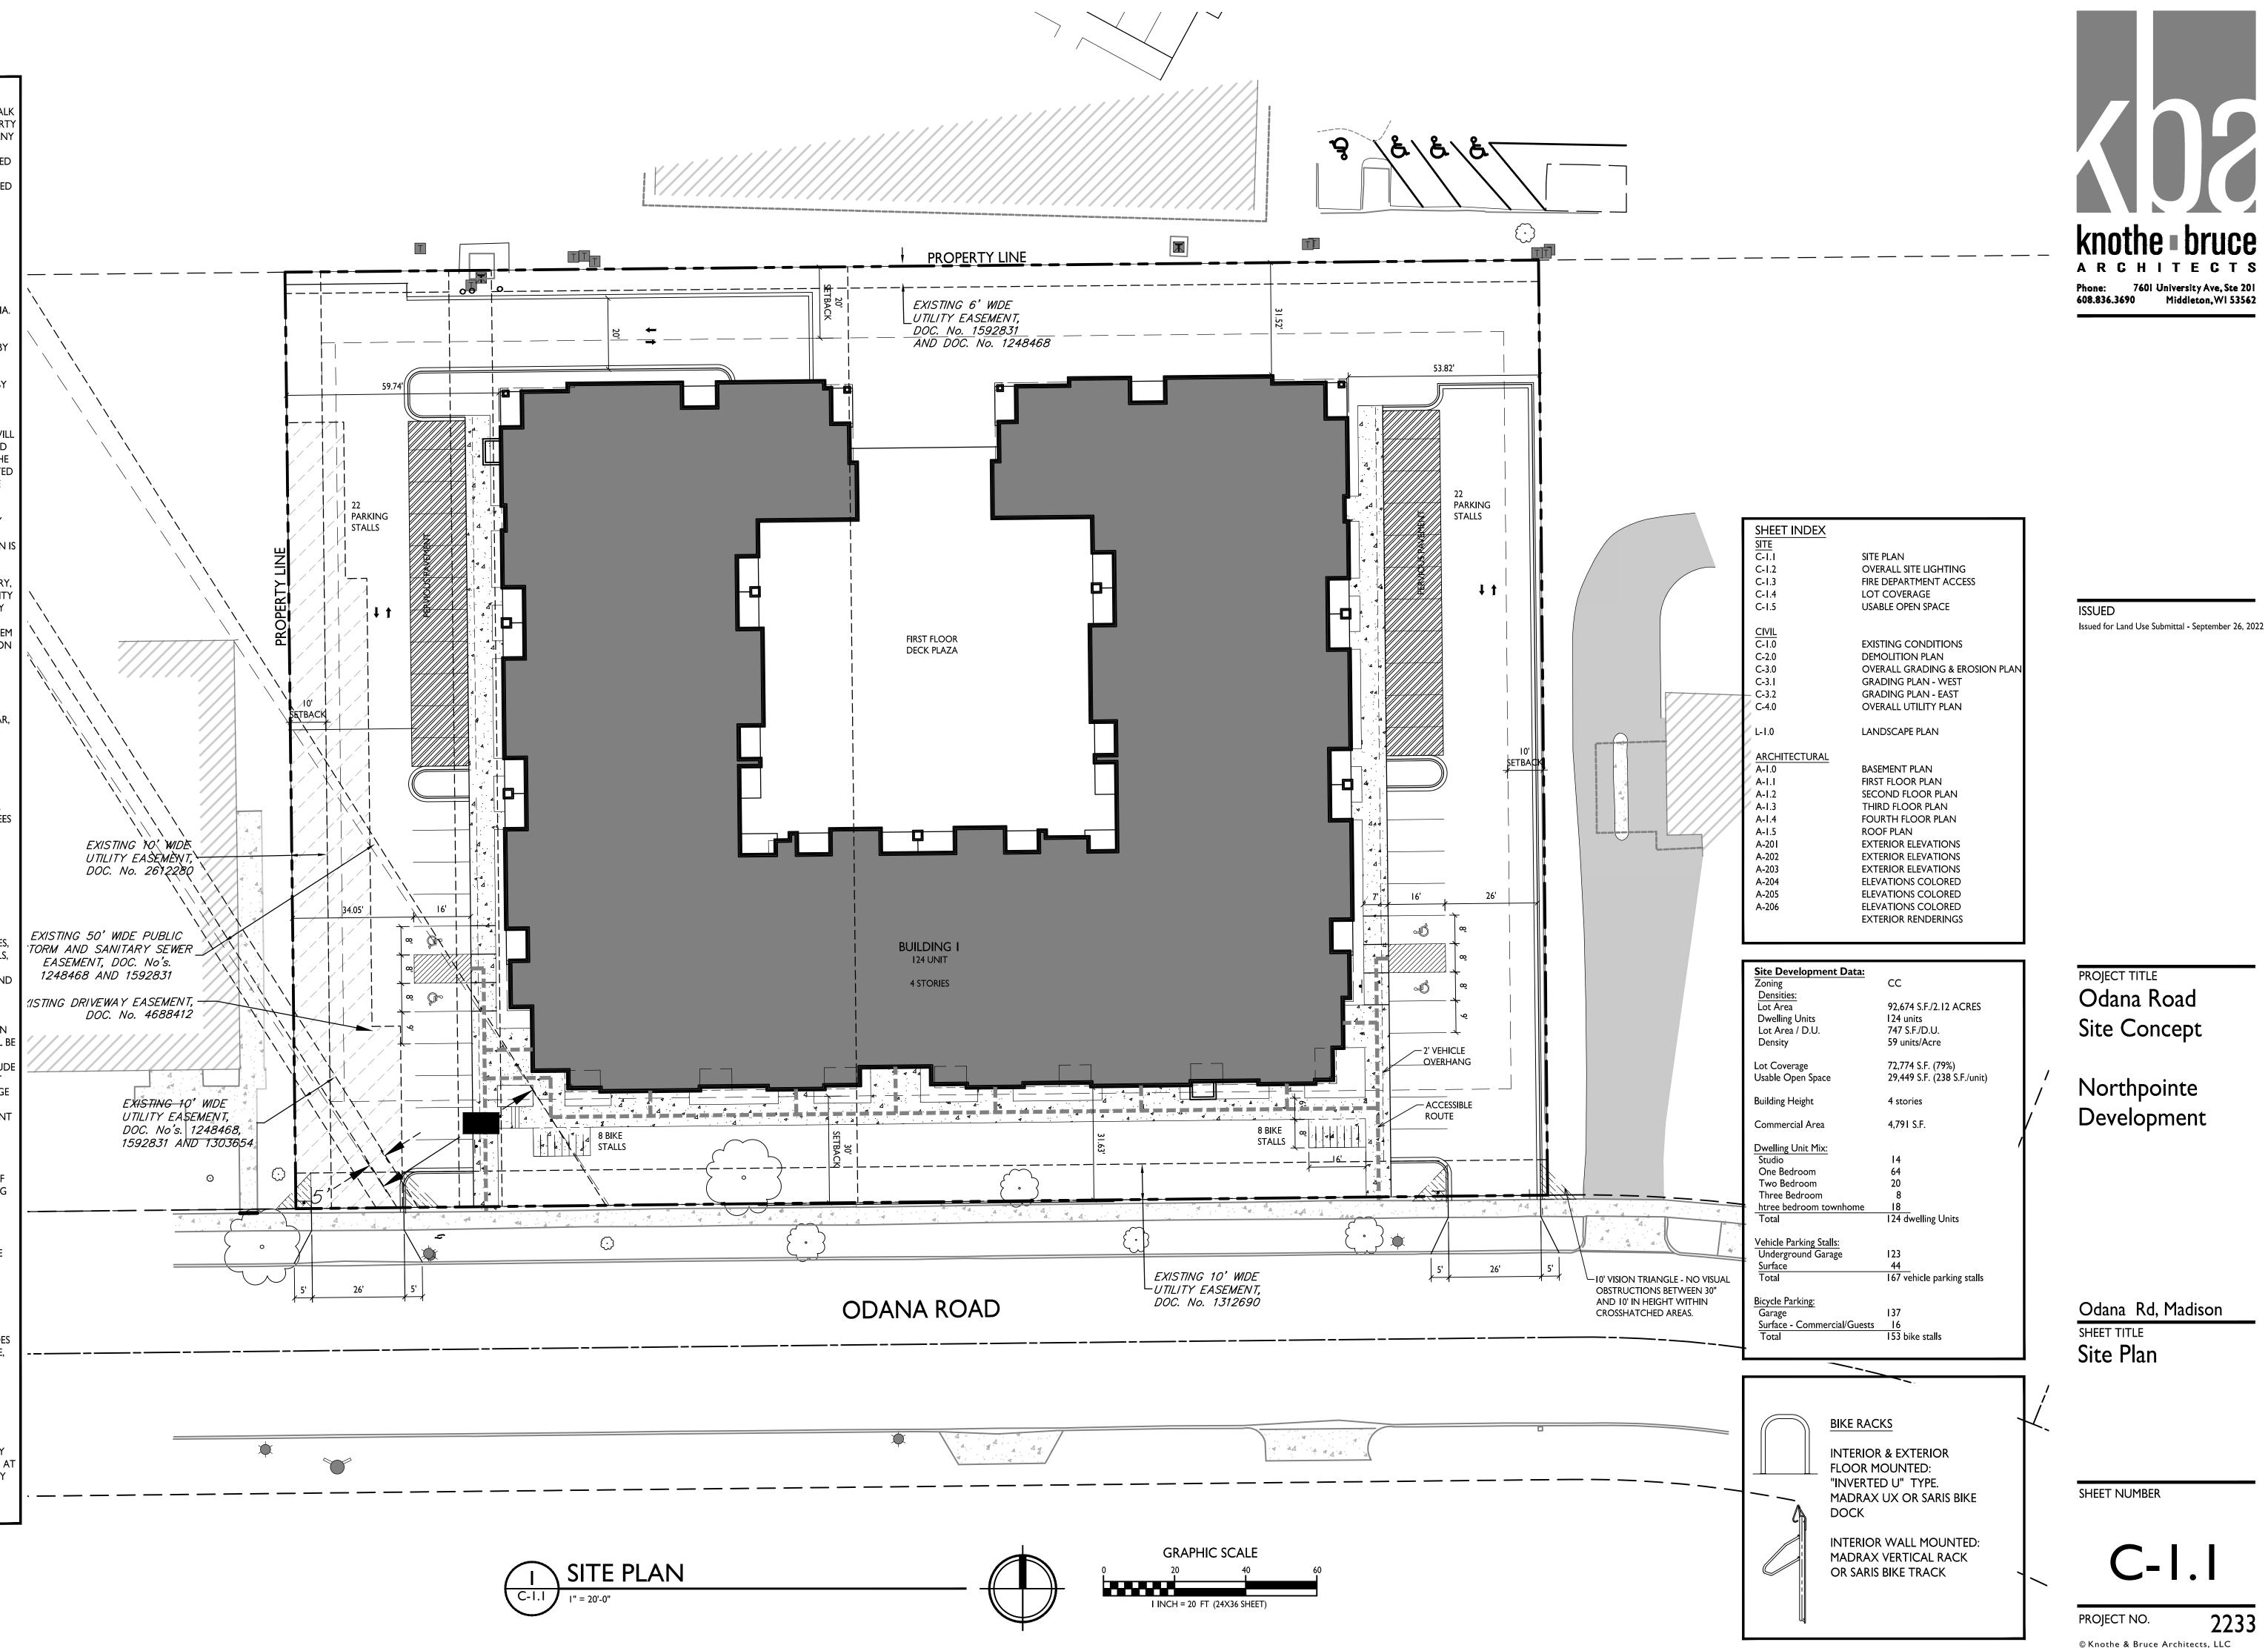

7601 University Ave, Ste 201

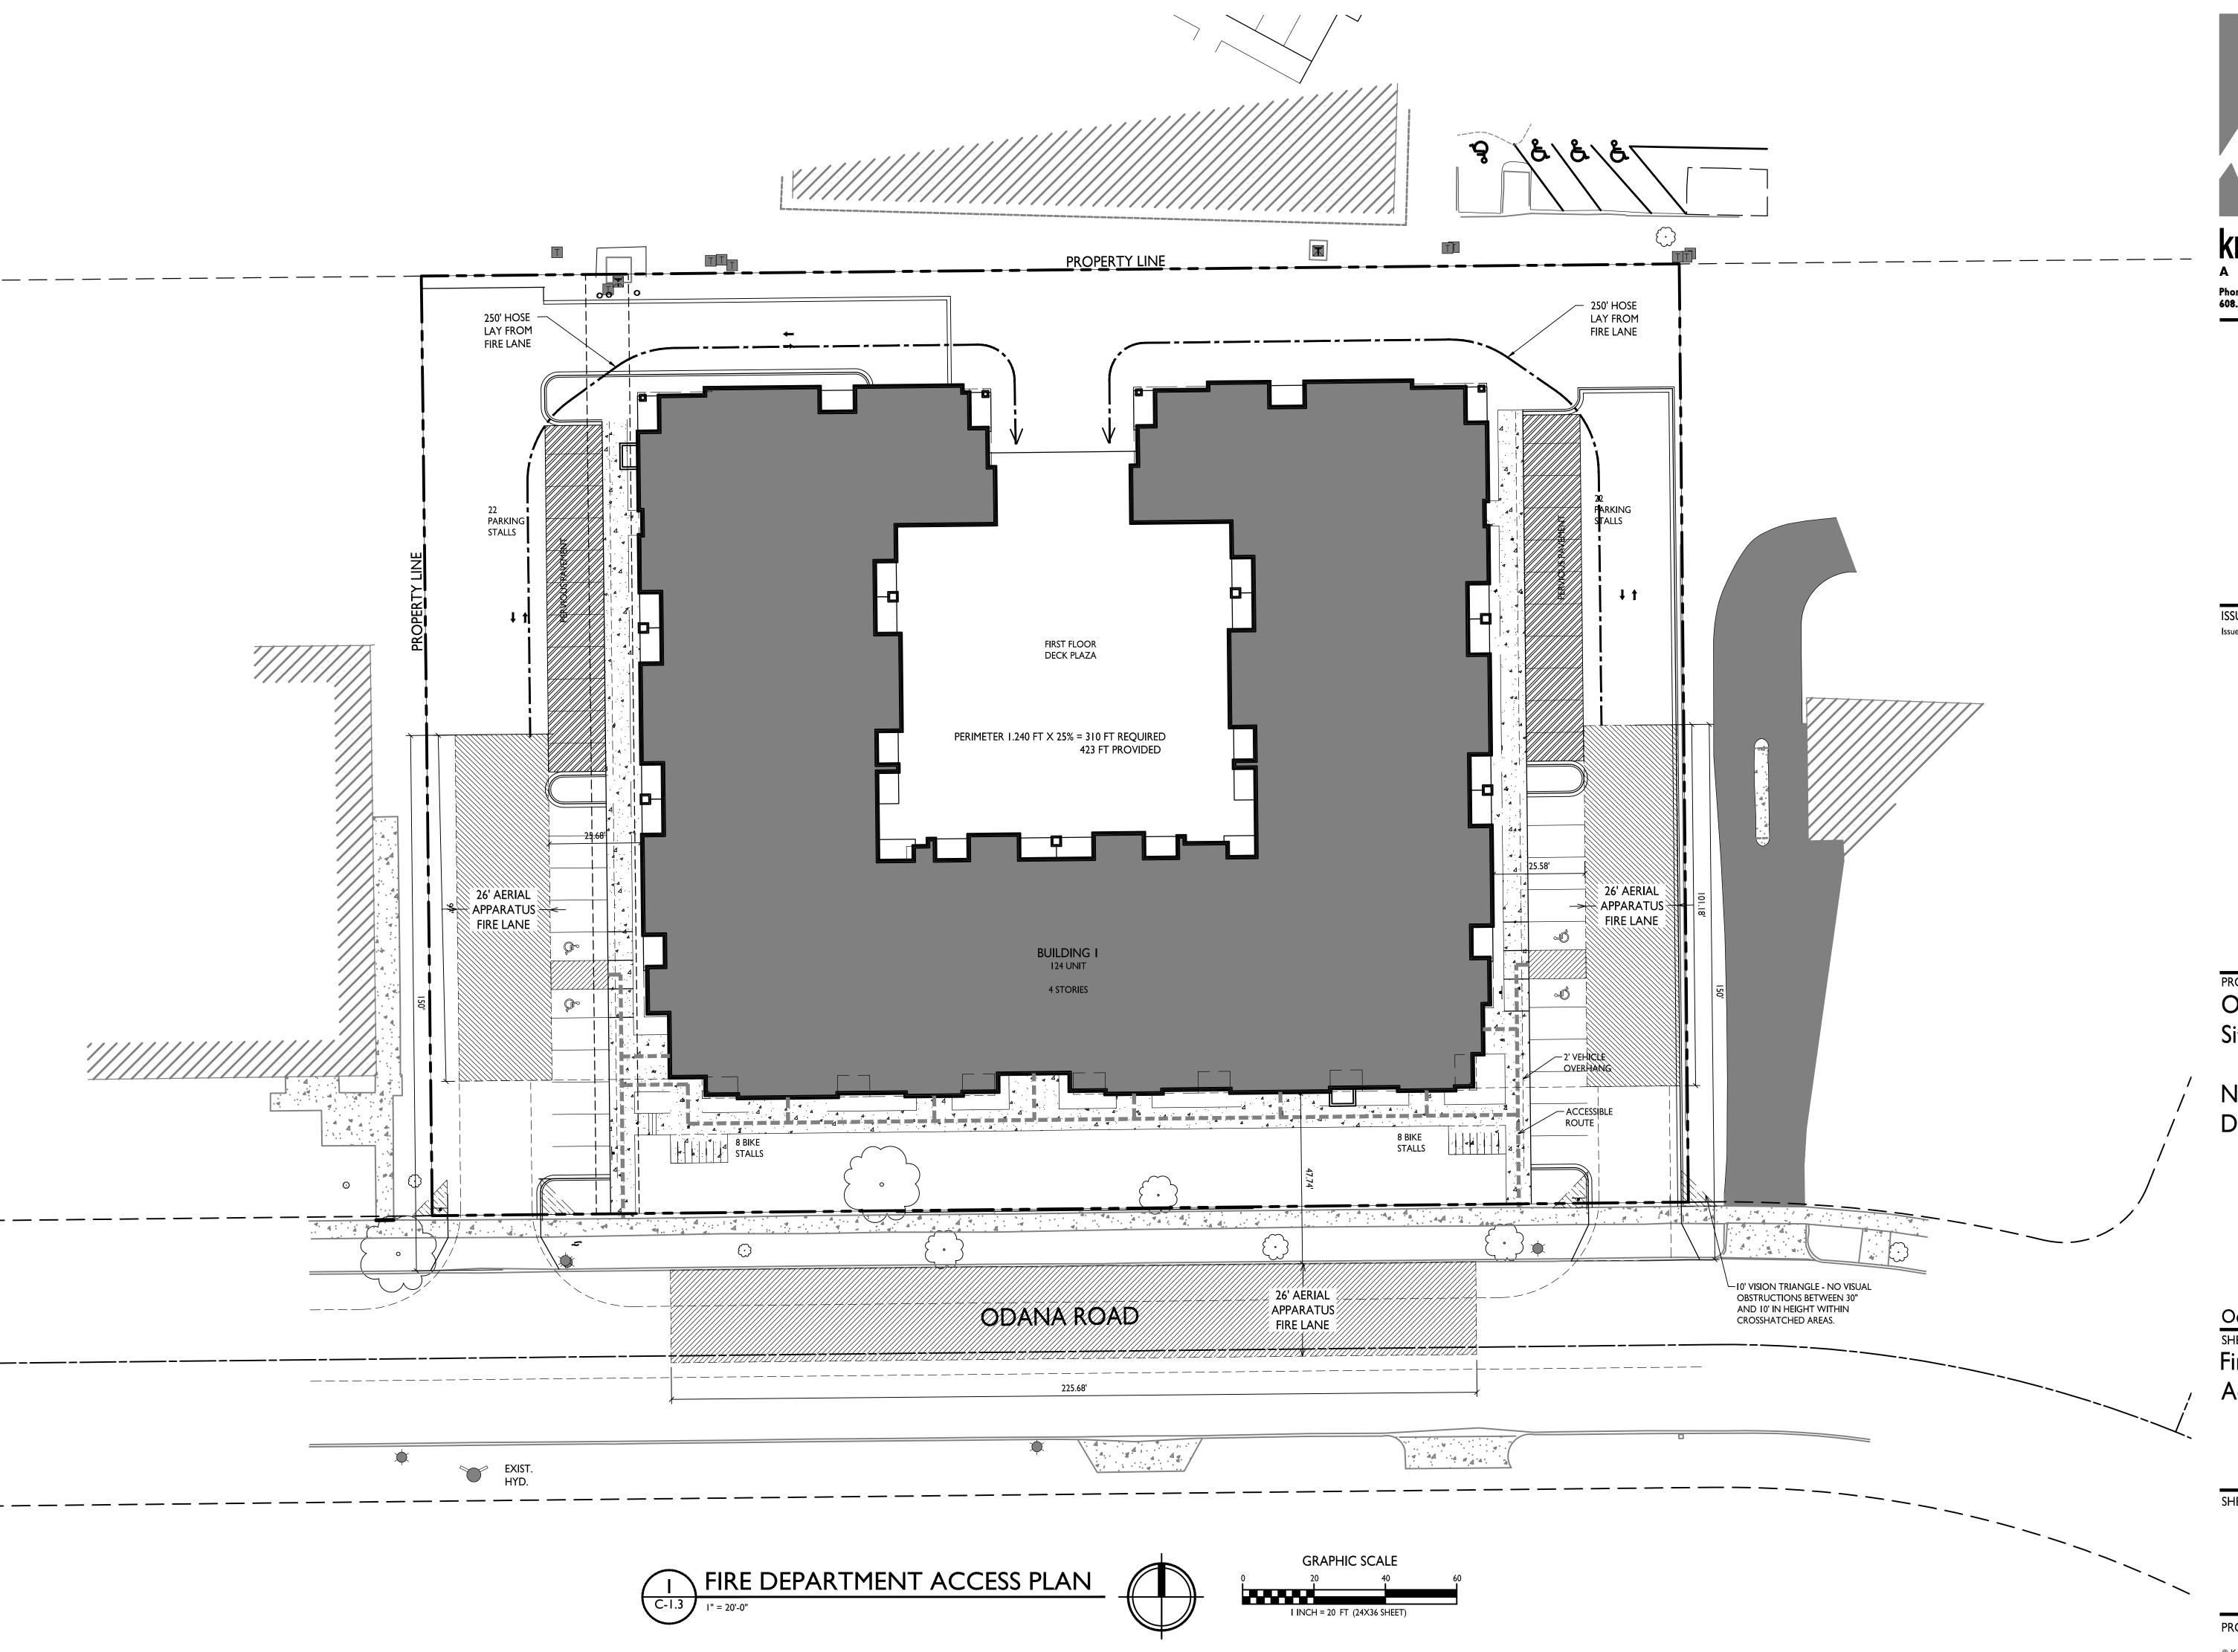

Knothe bruce
ARCHITECTS

Phone: 7601 University Ave, Ste 201
608.836.3690 Middleton, WI 53562

ISSUED
Issued for Land Use Submittal - September 26, 2022

PROJECT TITLE
Odana Road
Site Concept

Northpointe Development

Odana Rd, Madison

SHEET TITLE

Fire Department


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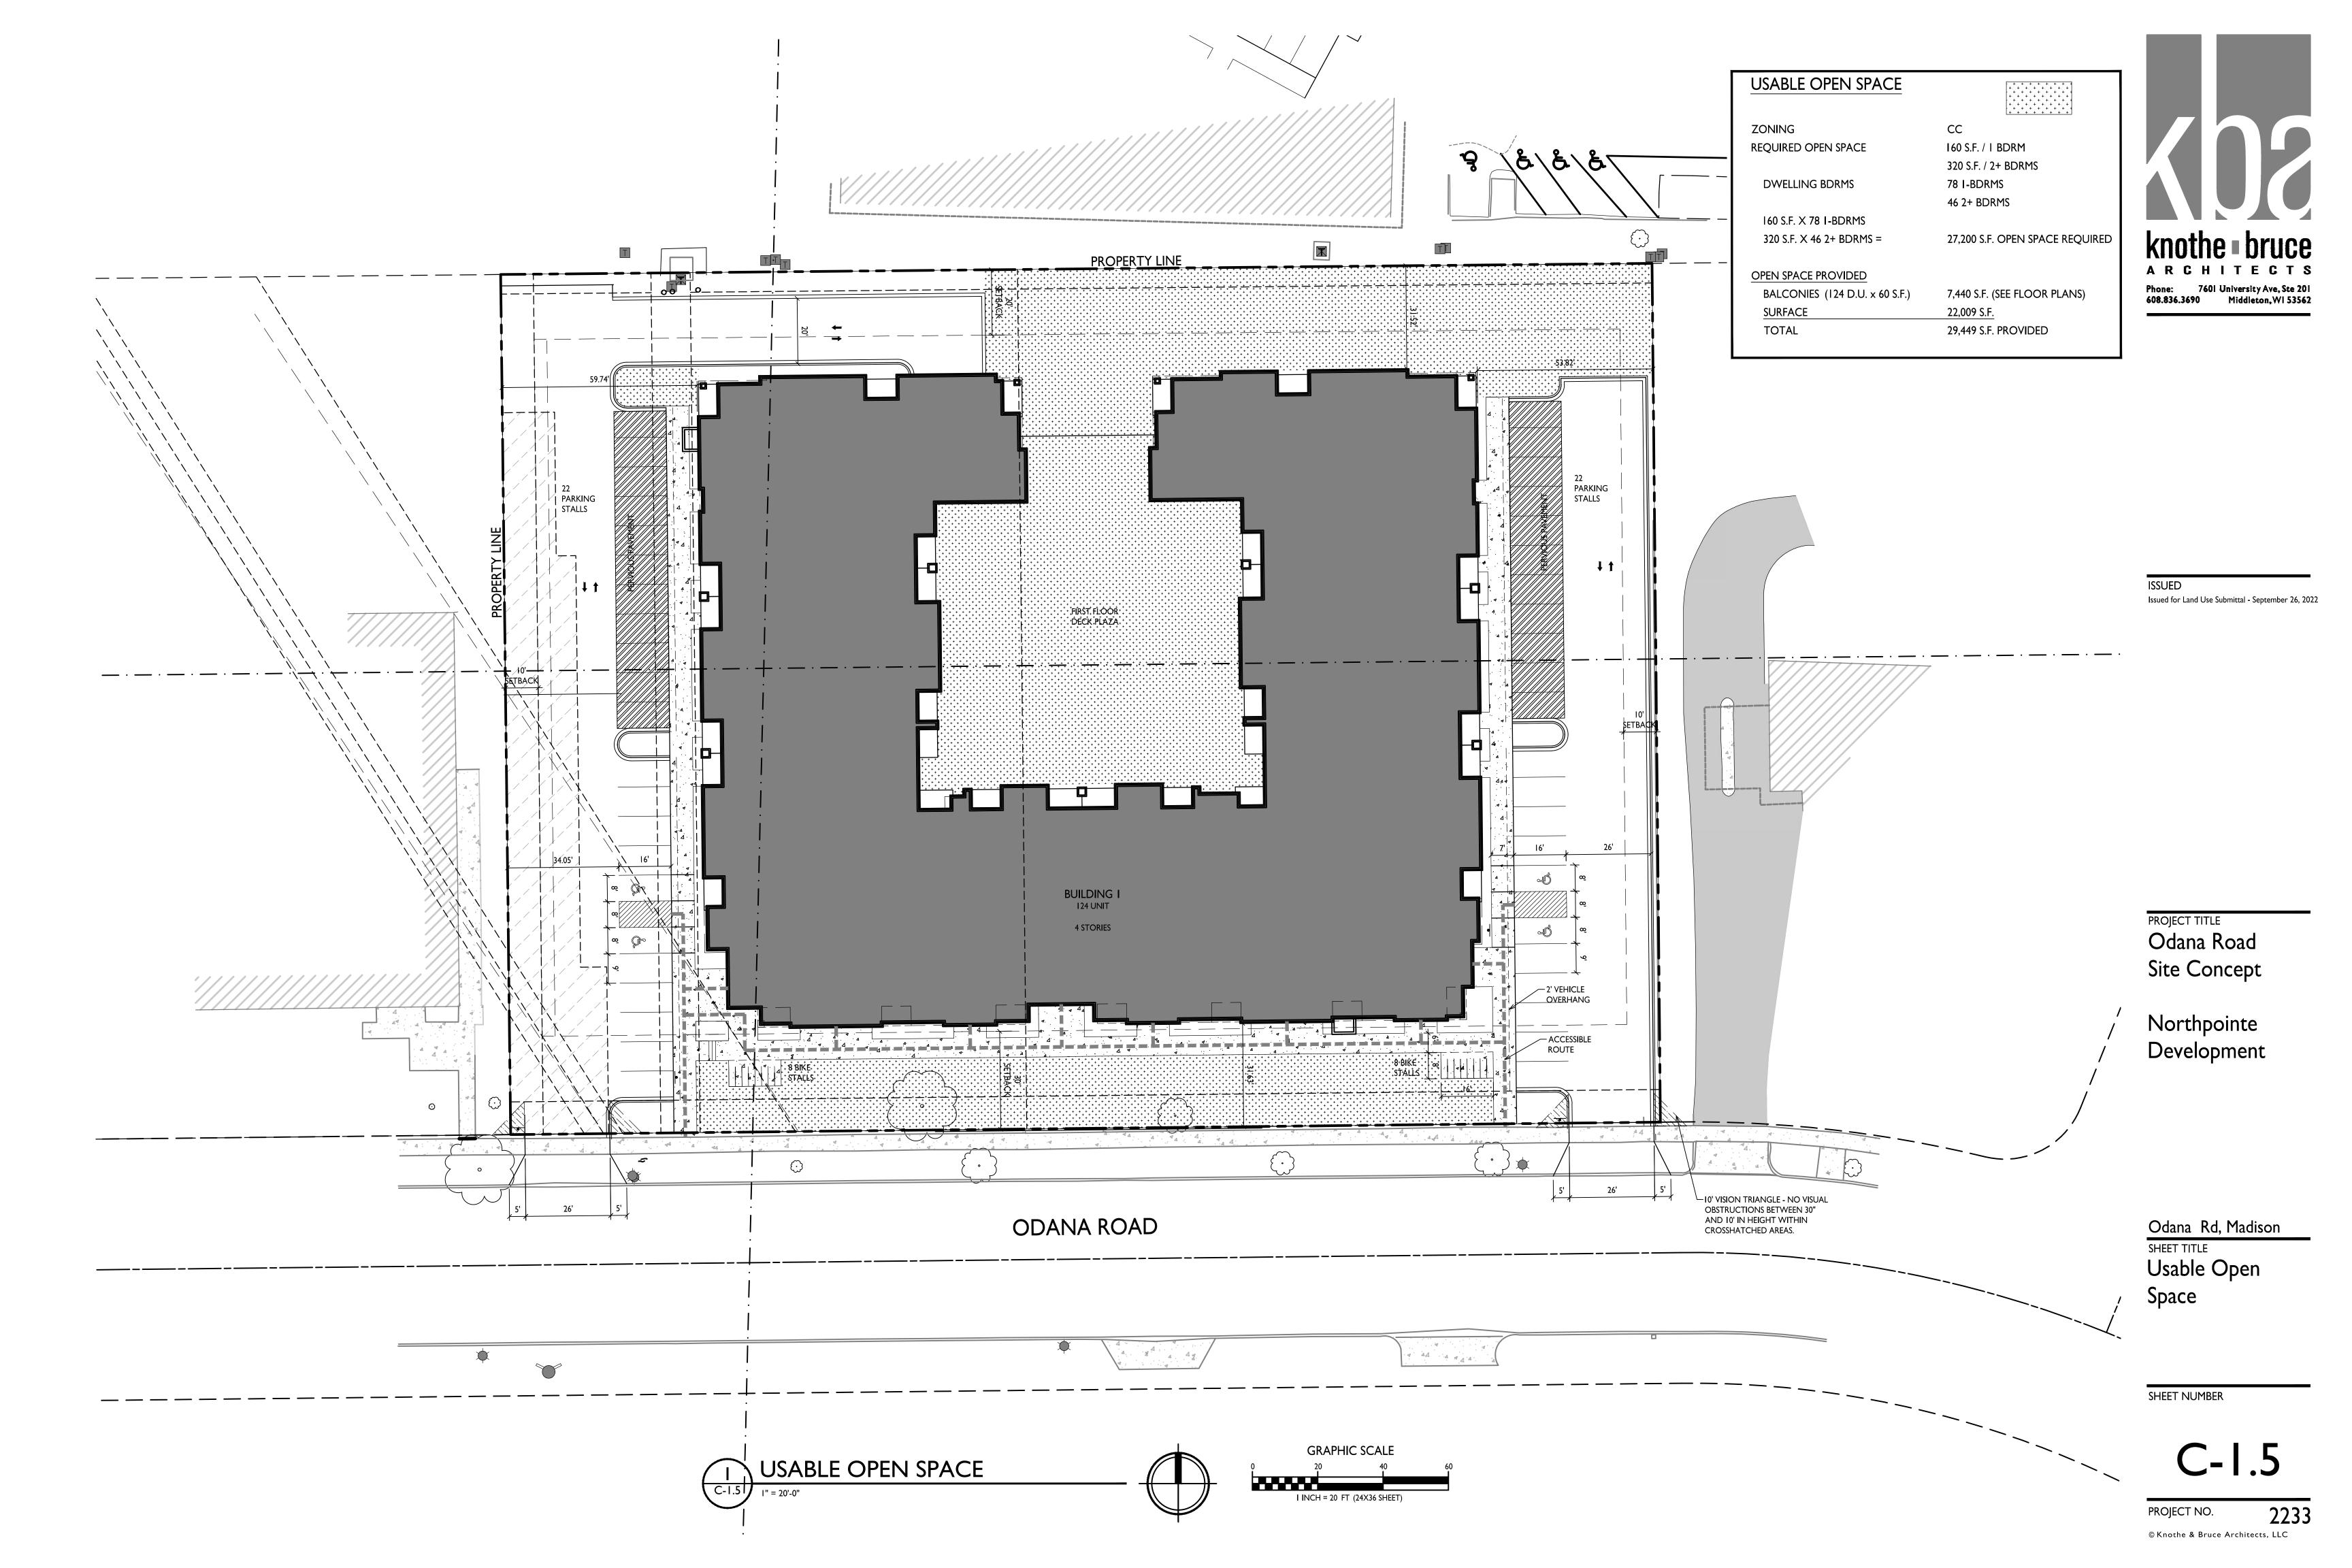
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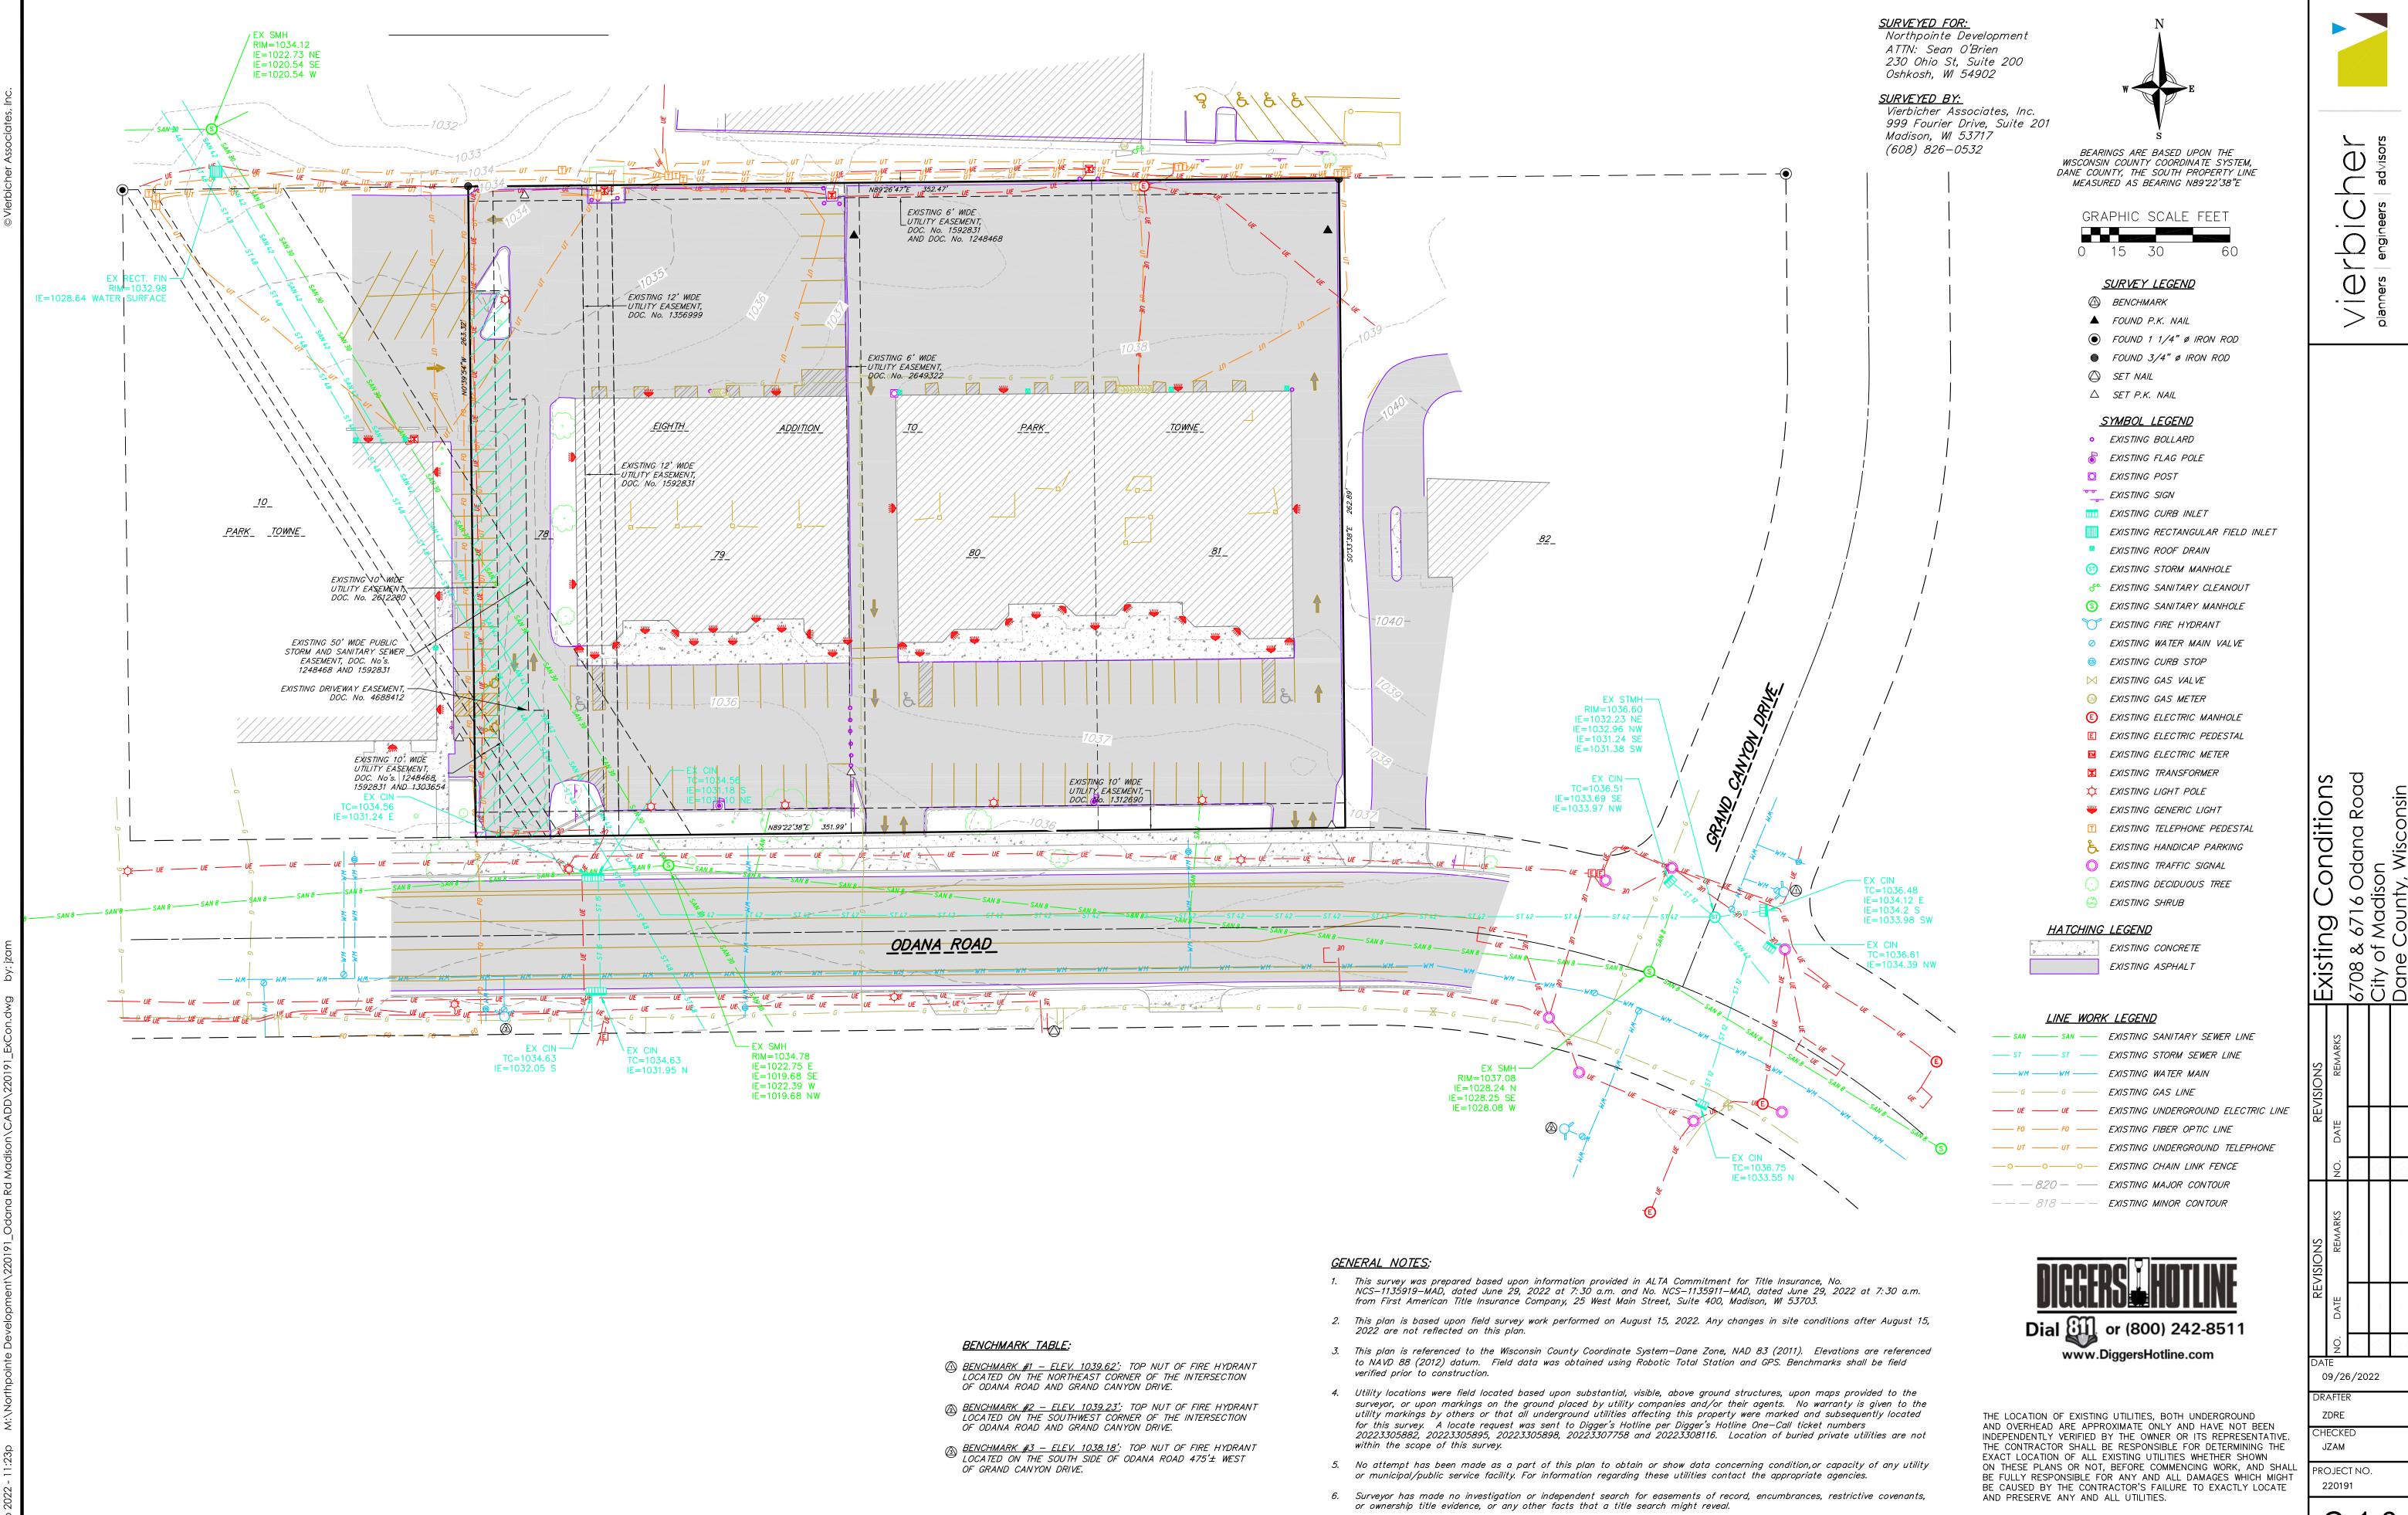
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PROJECT NO.

PROJECT NO. 22.







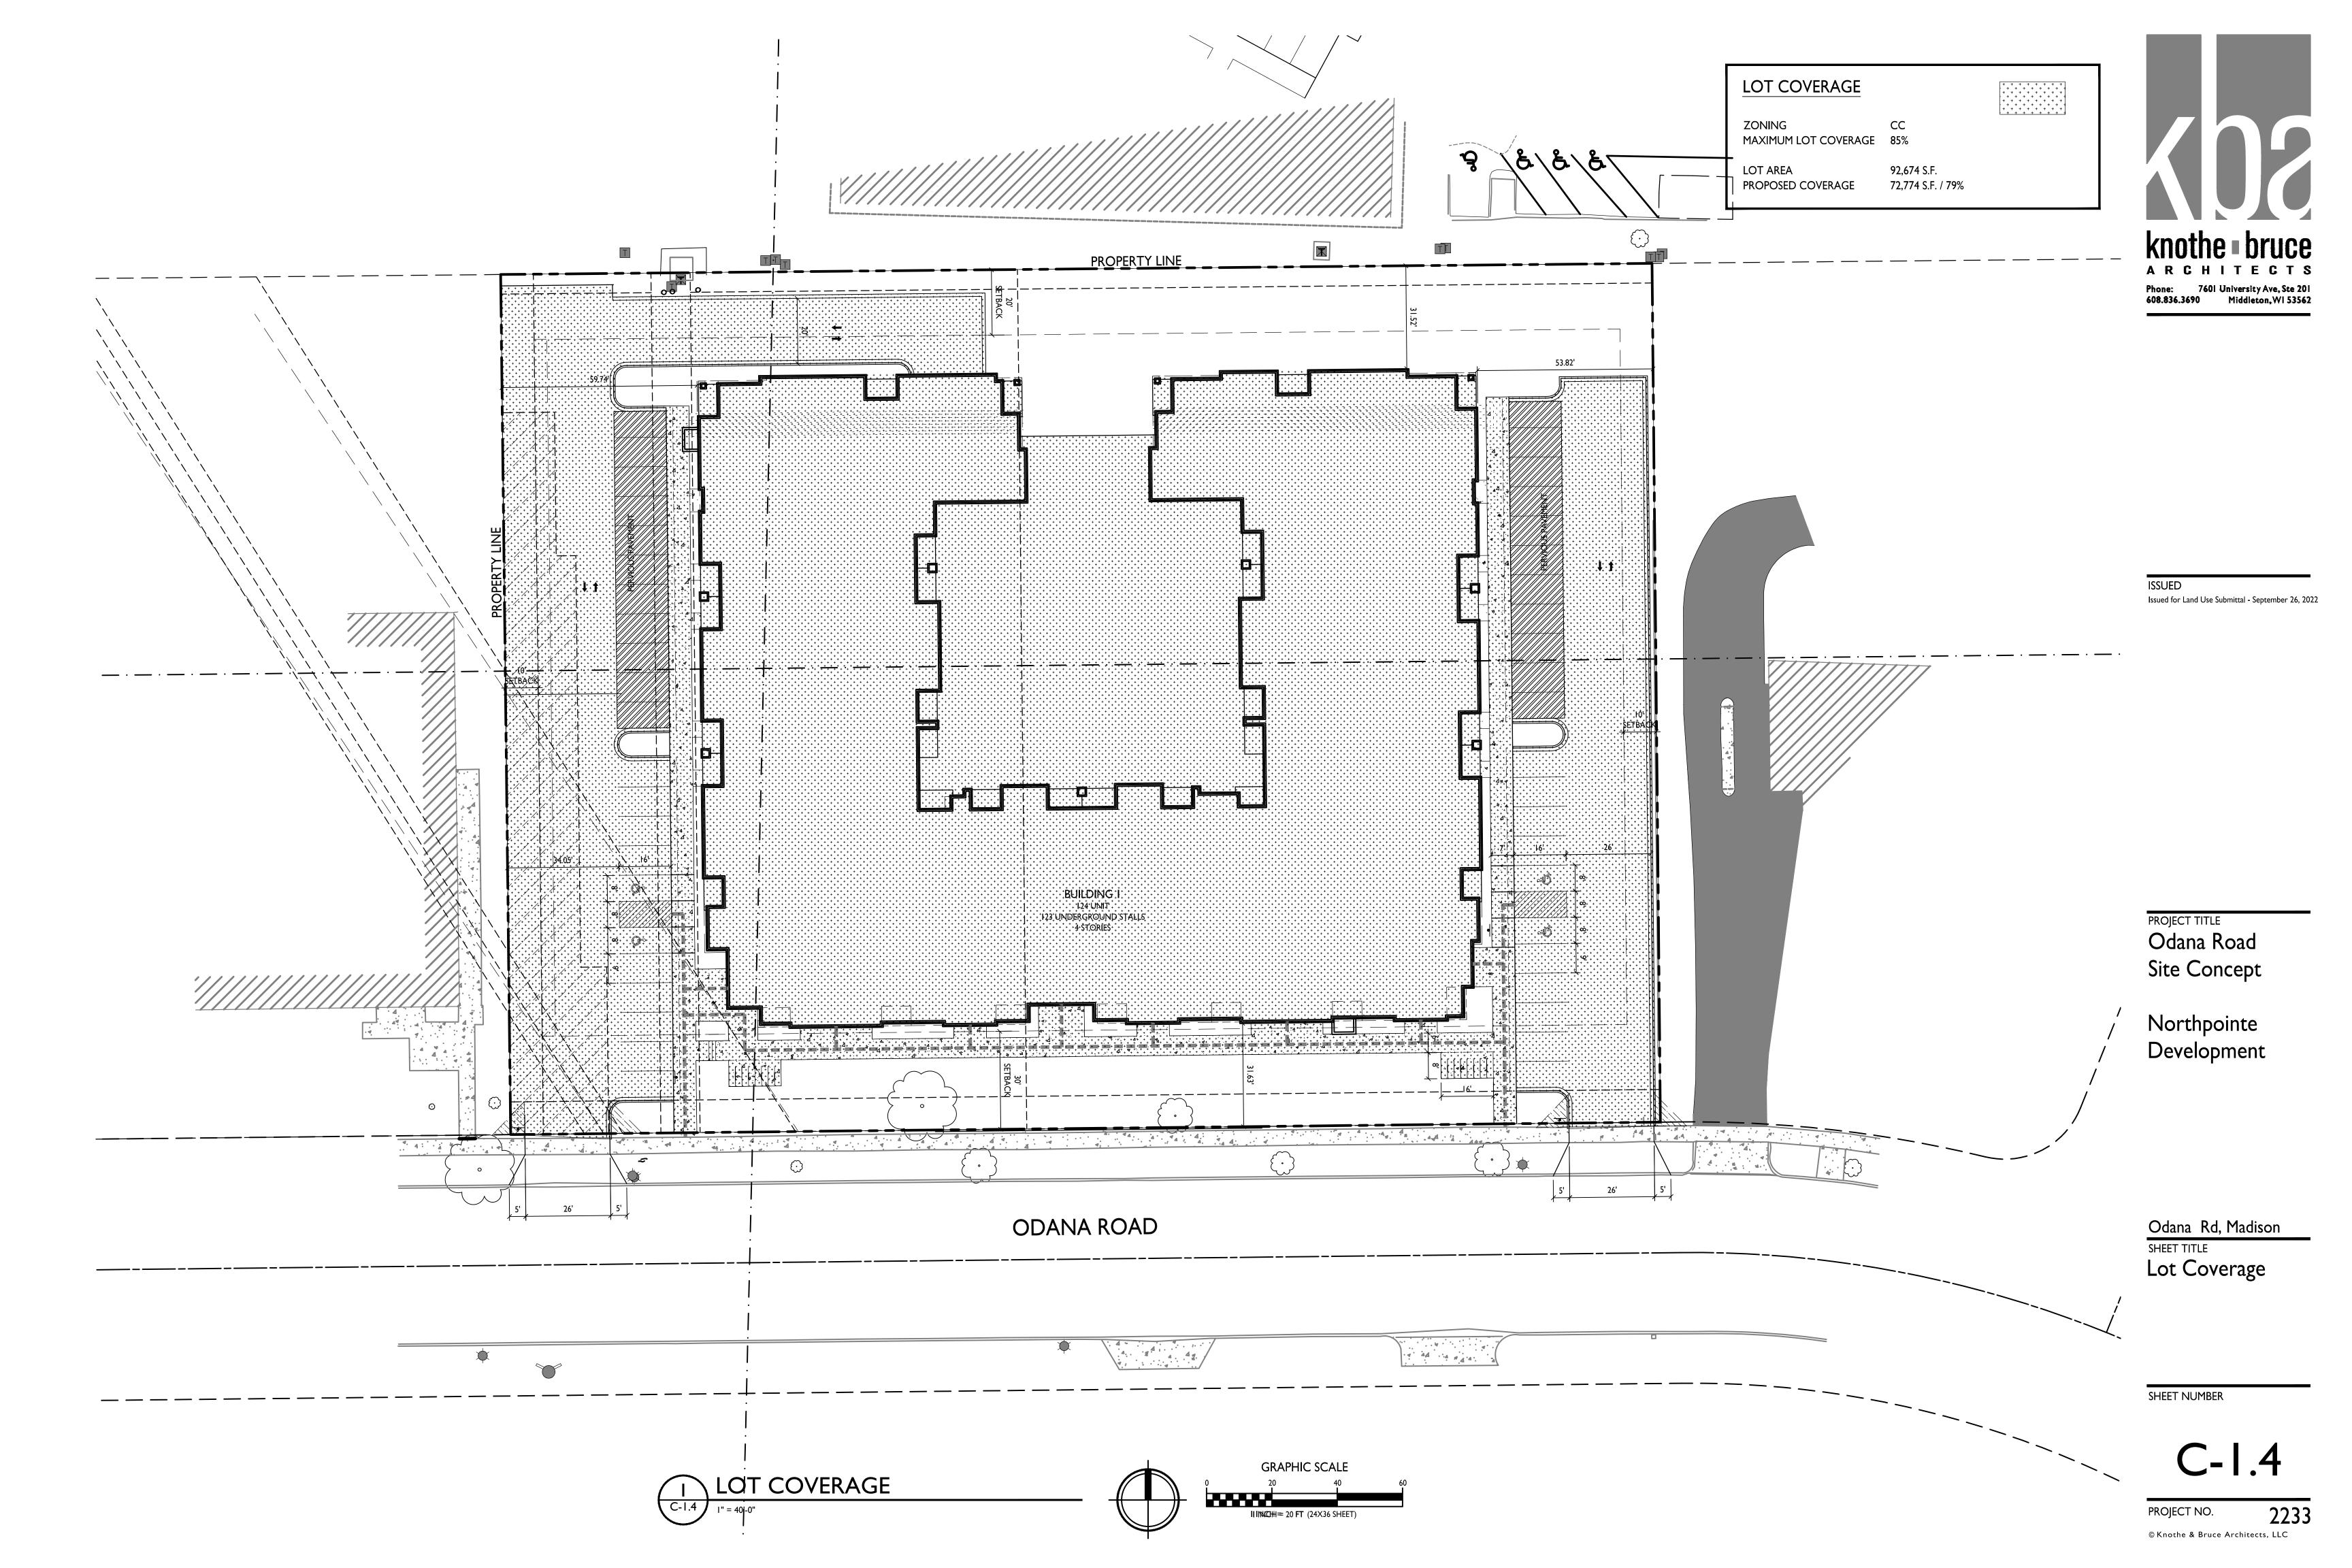



CALL DIGGER'S HOTLINE 1-800-242-8511


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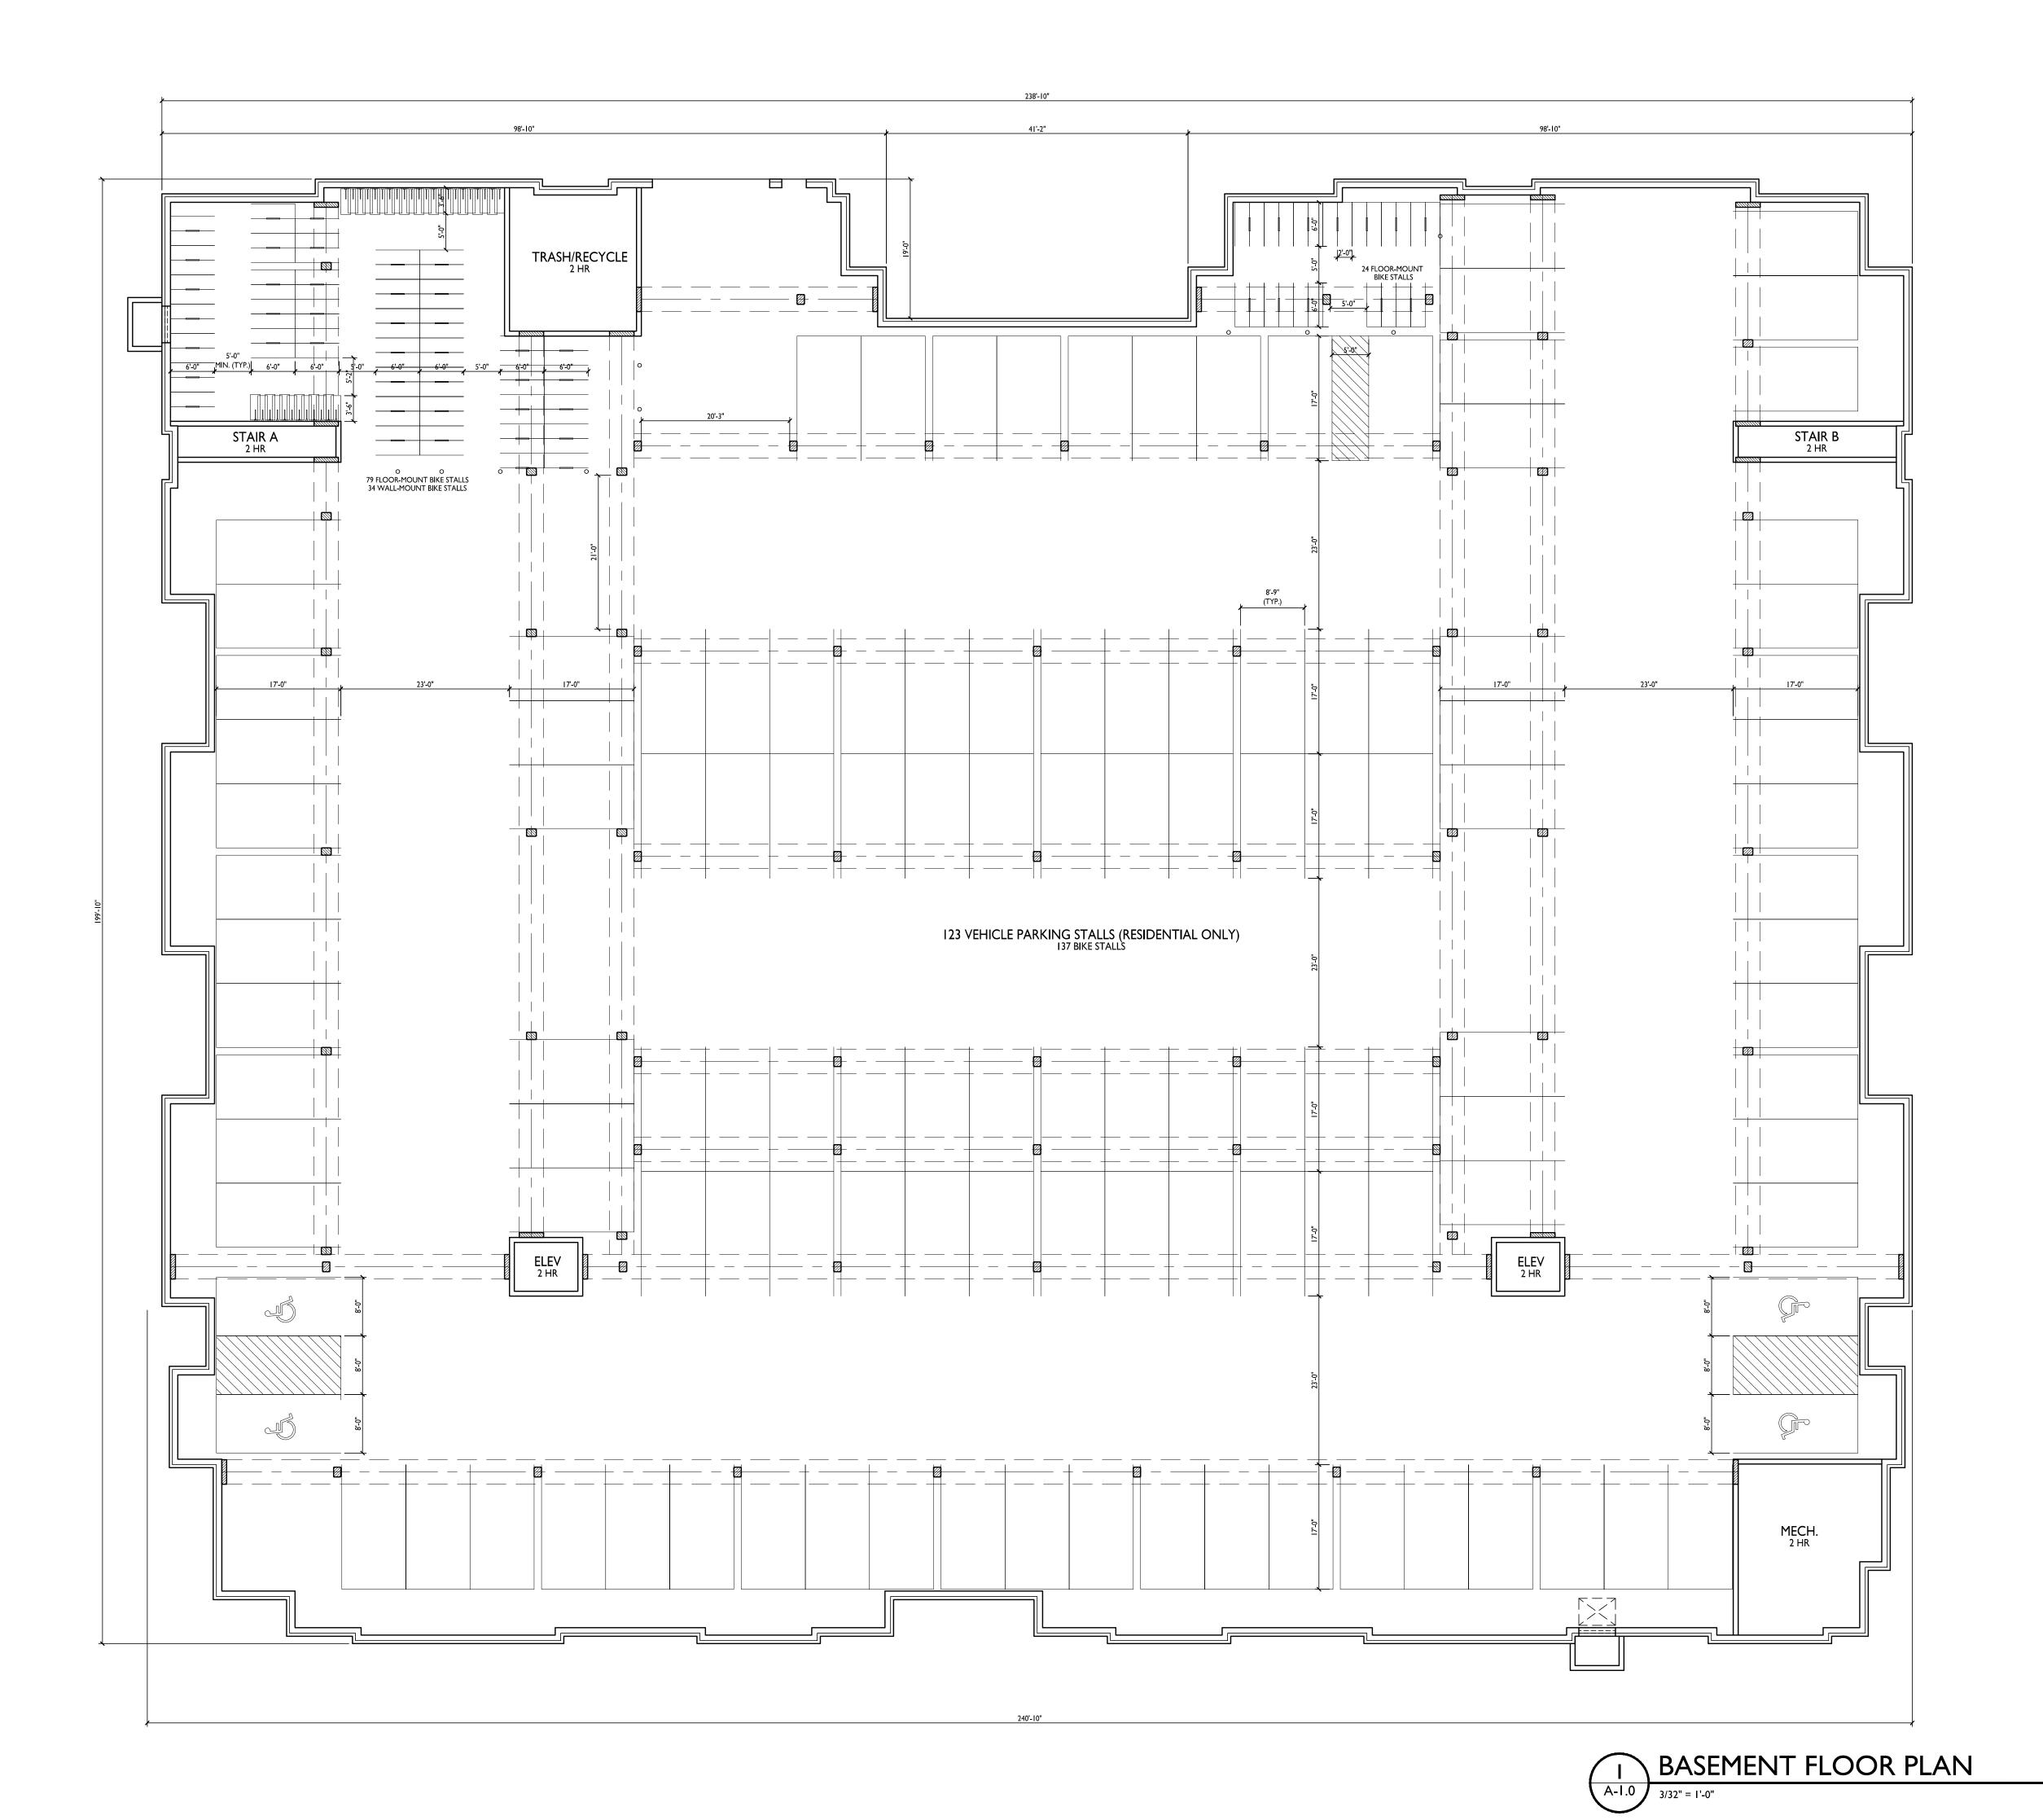


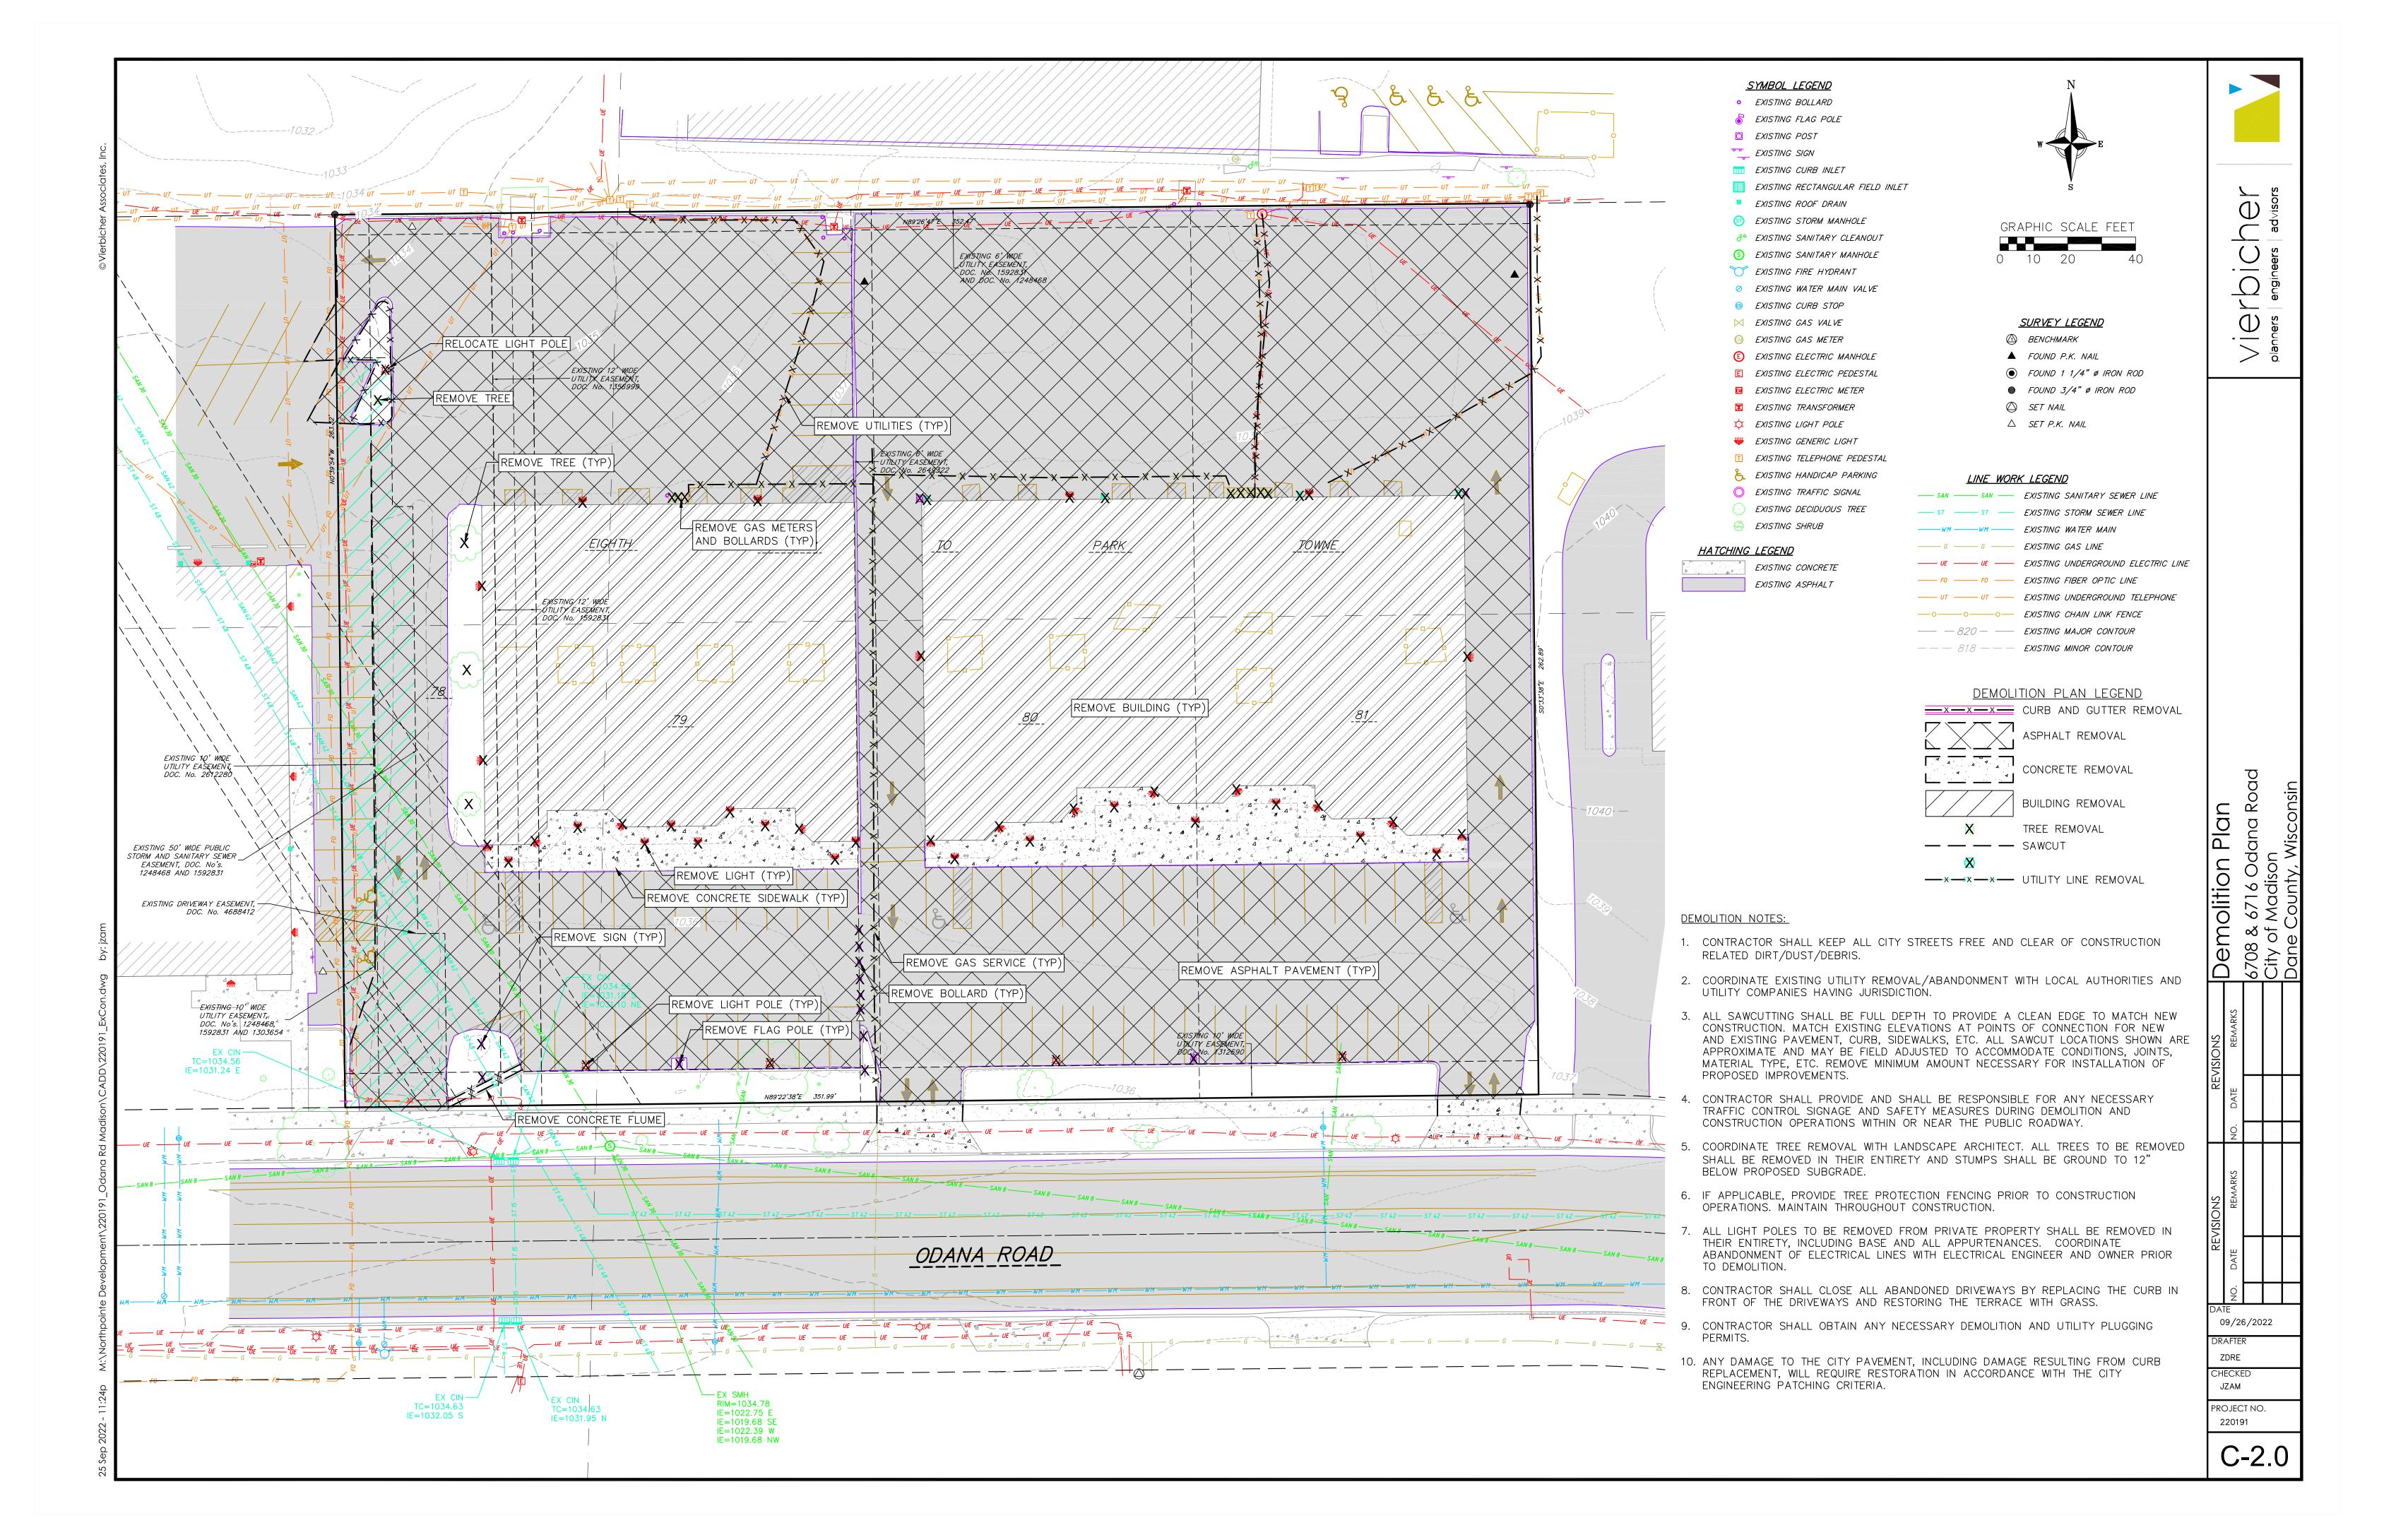

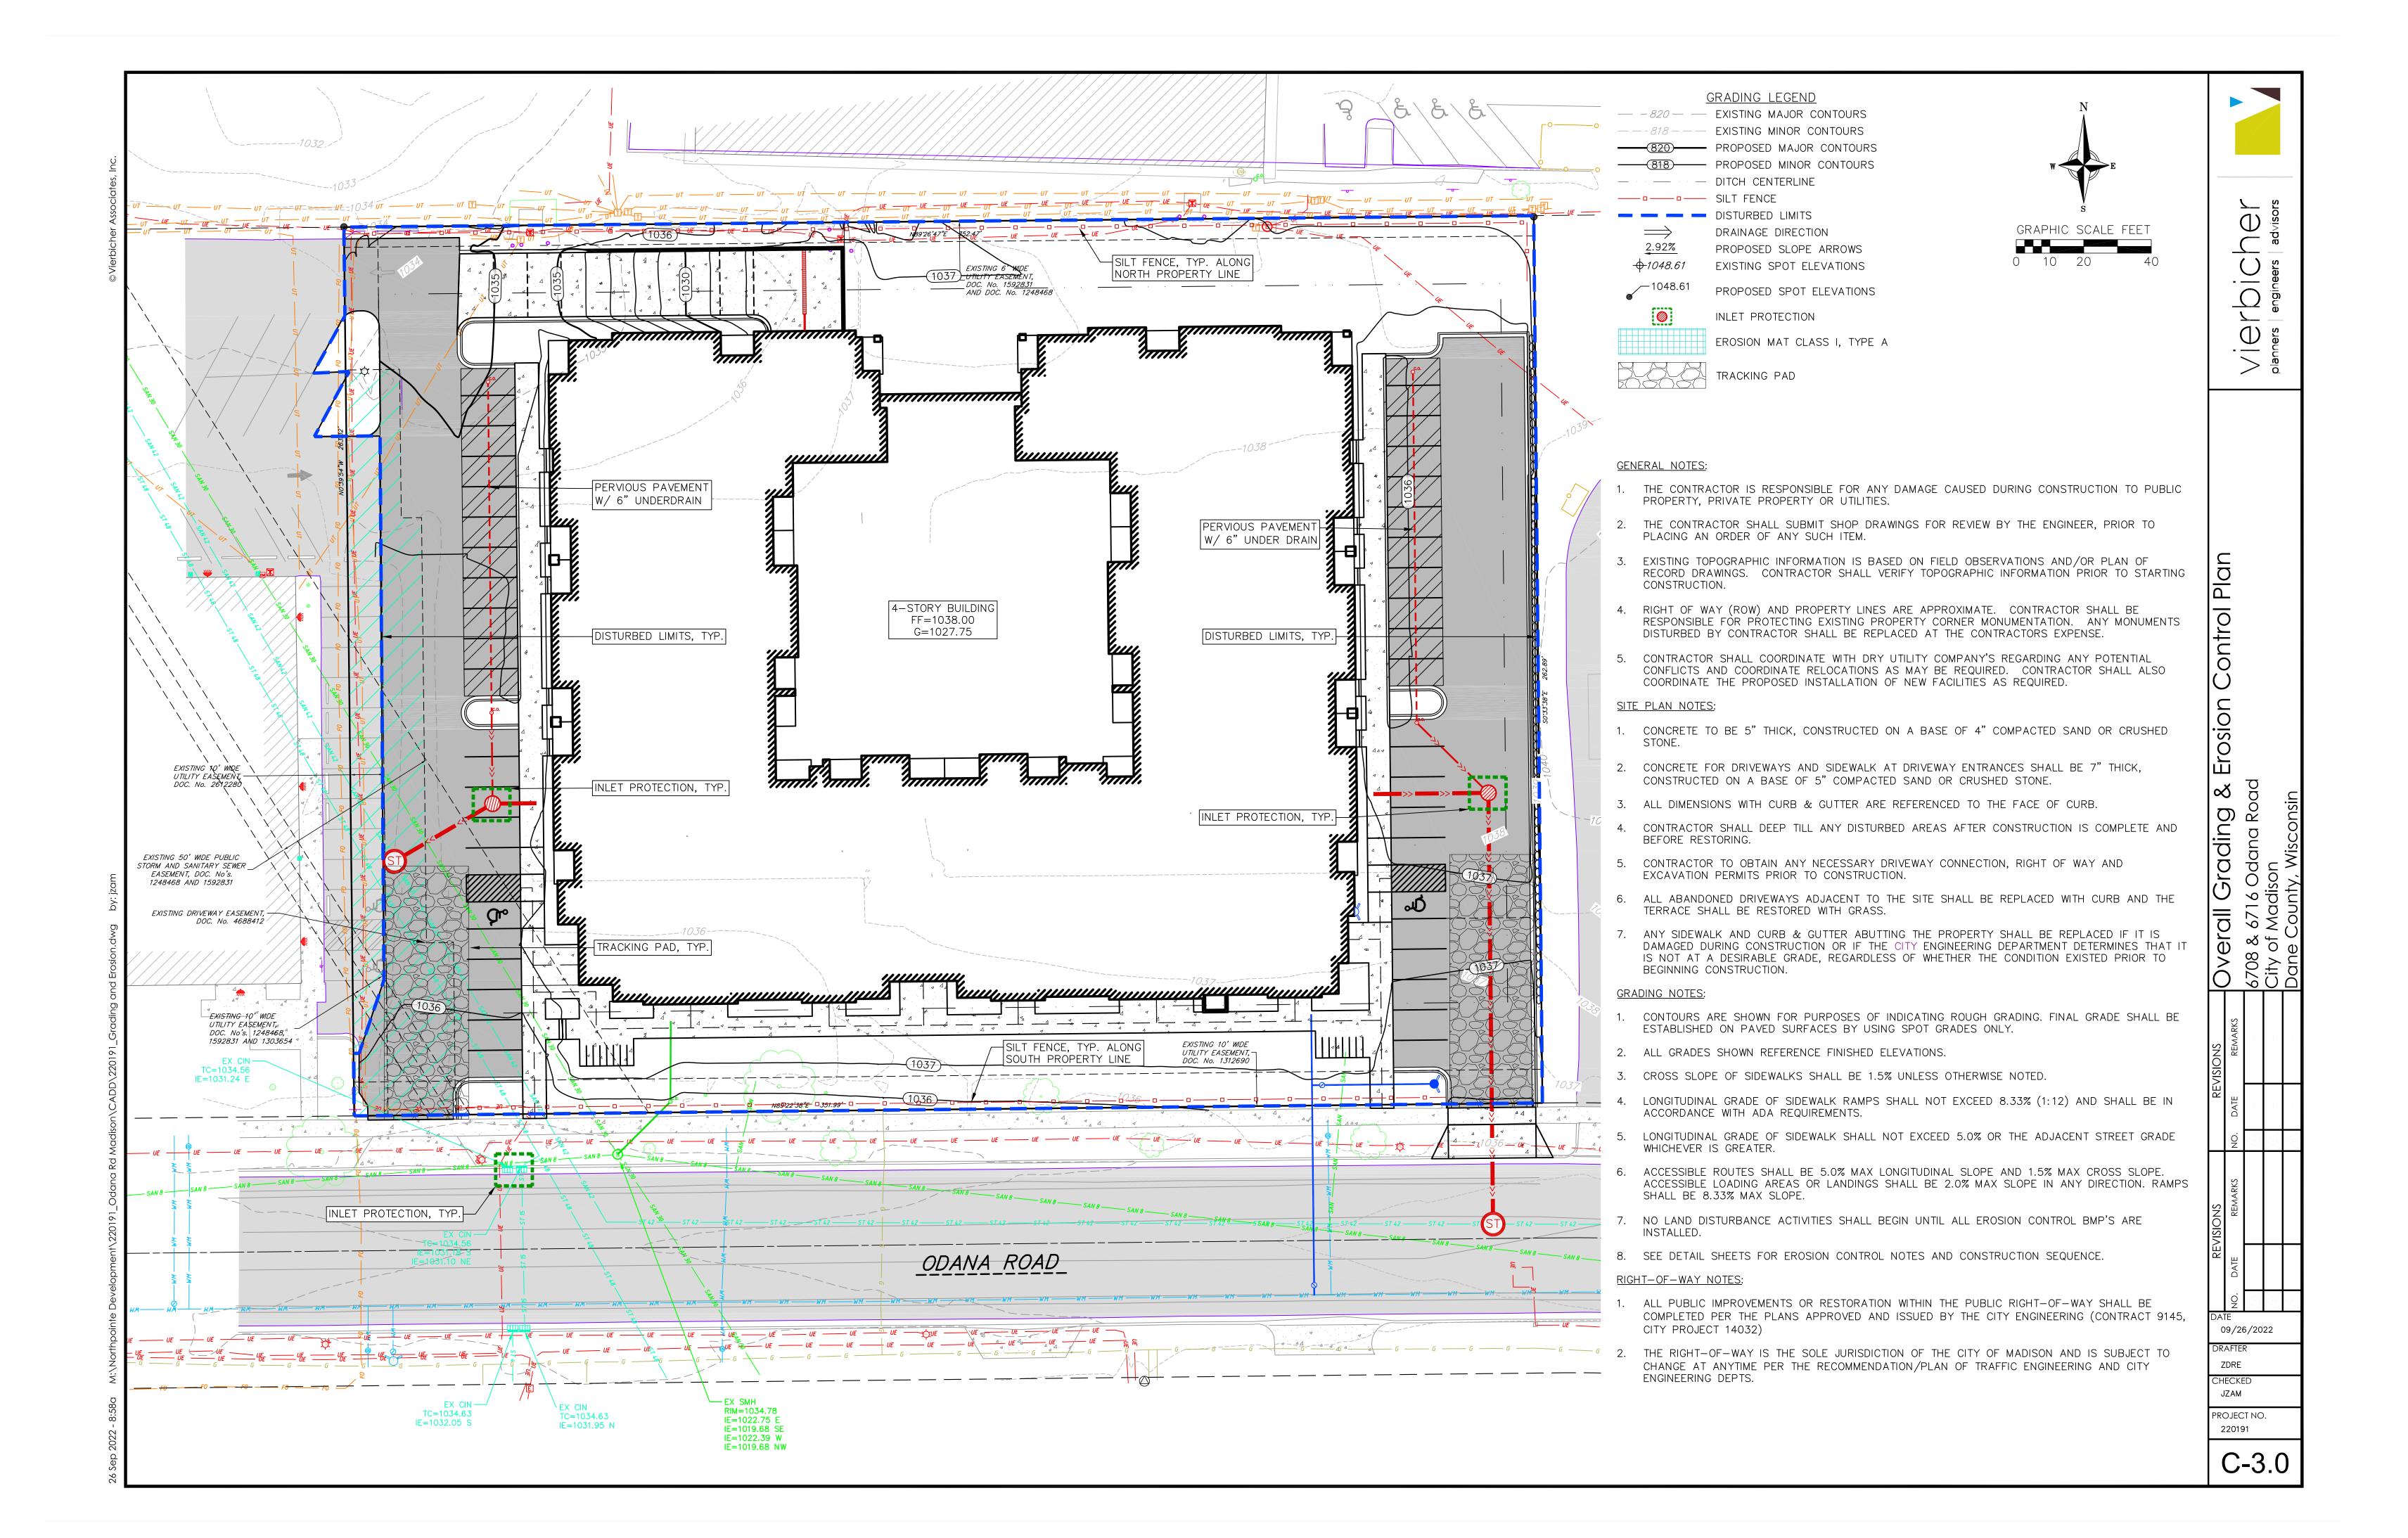

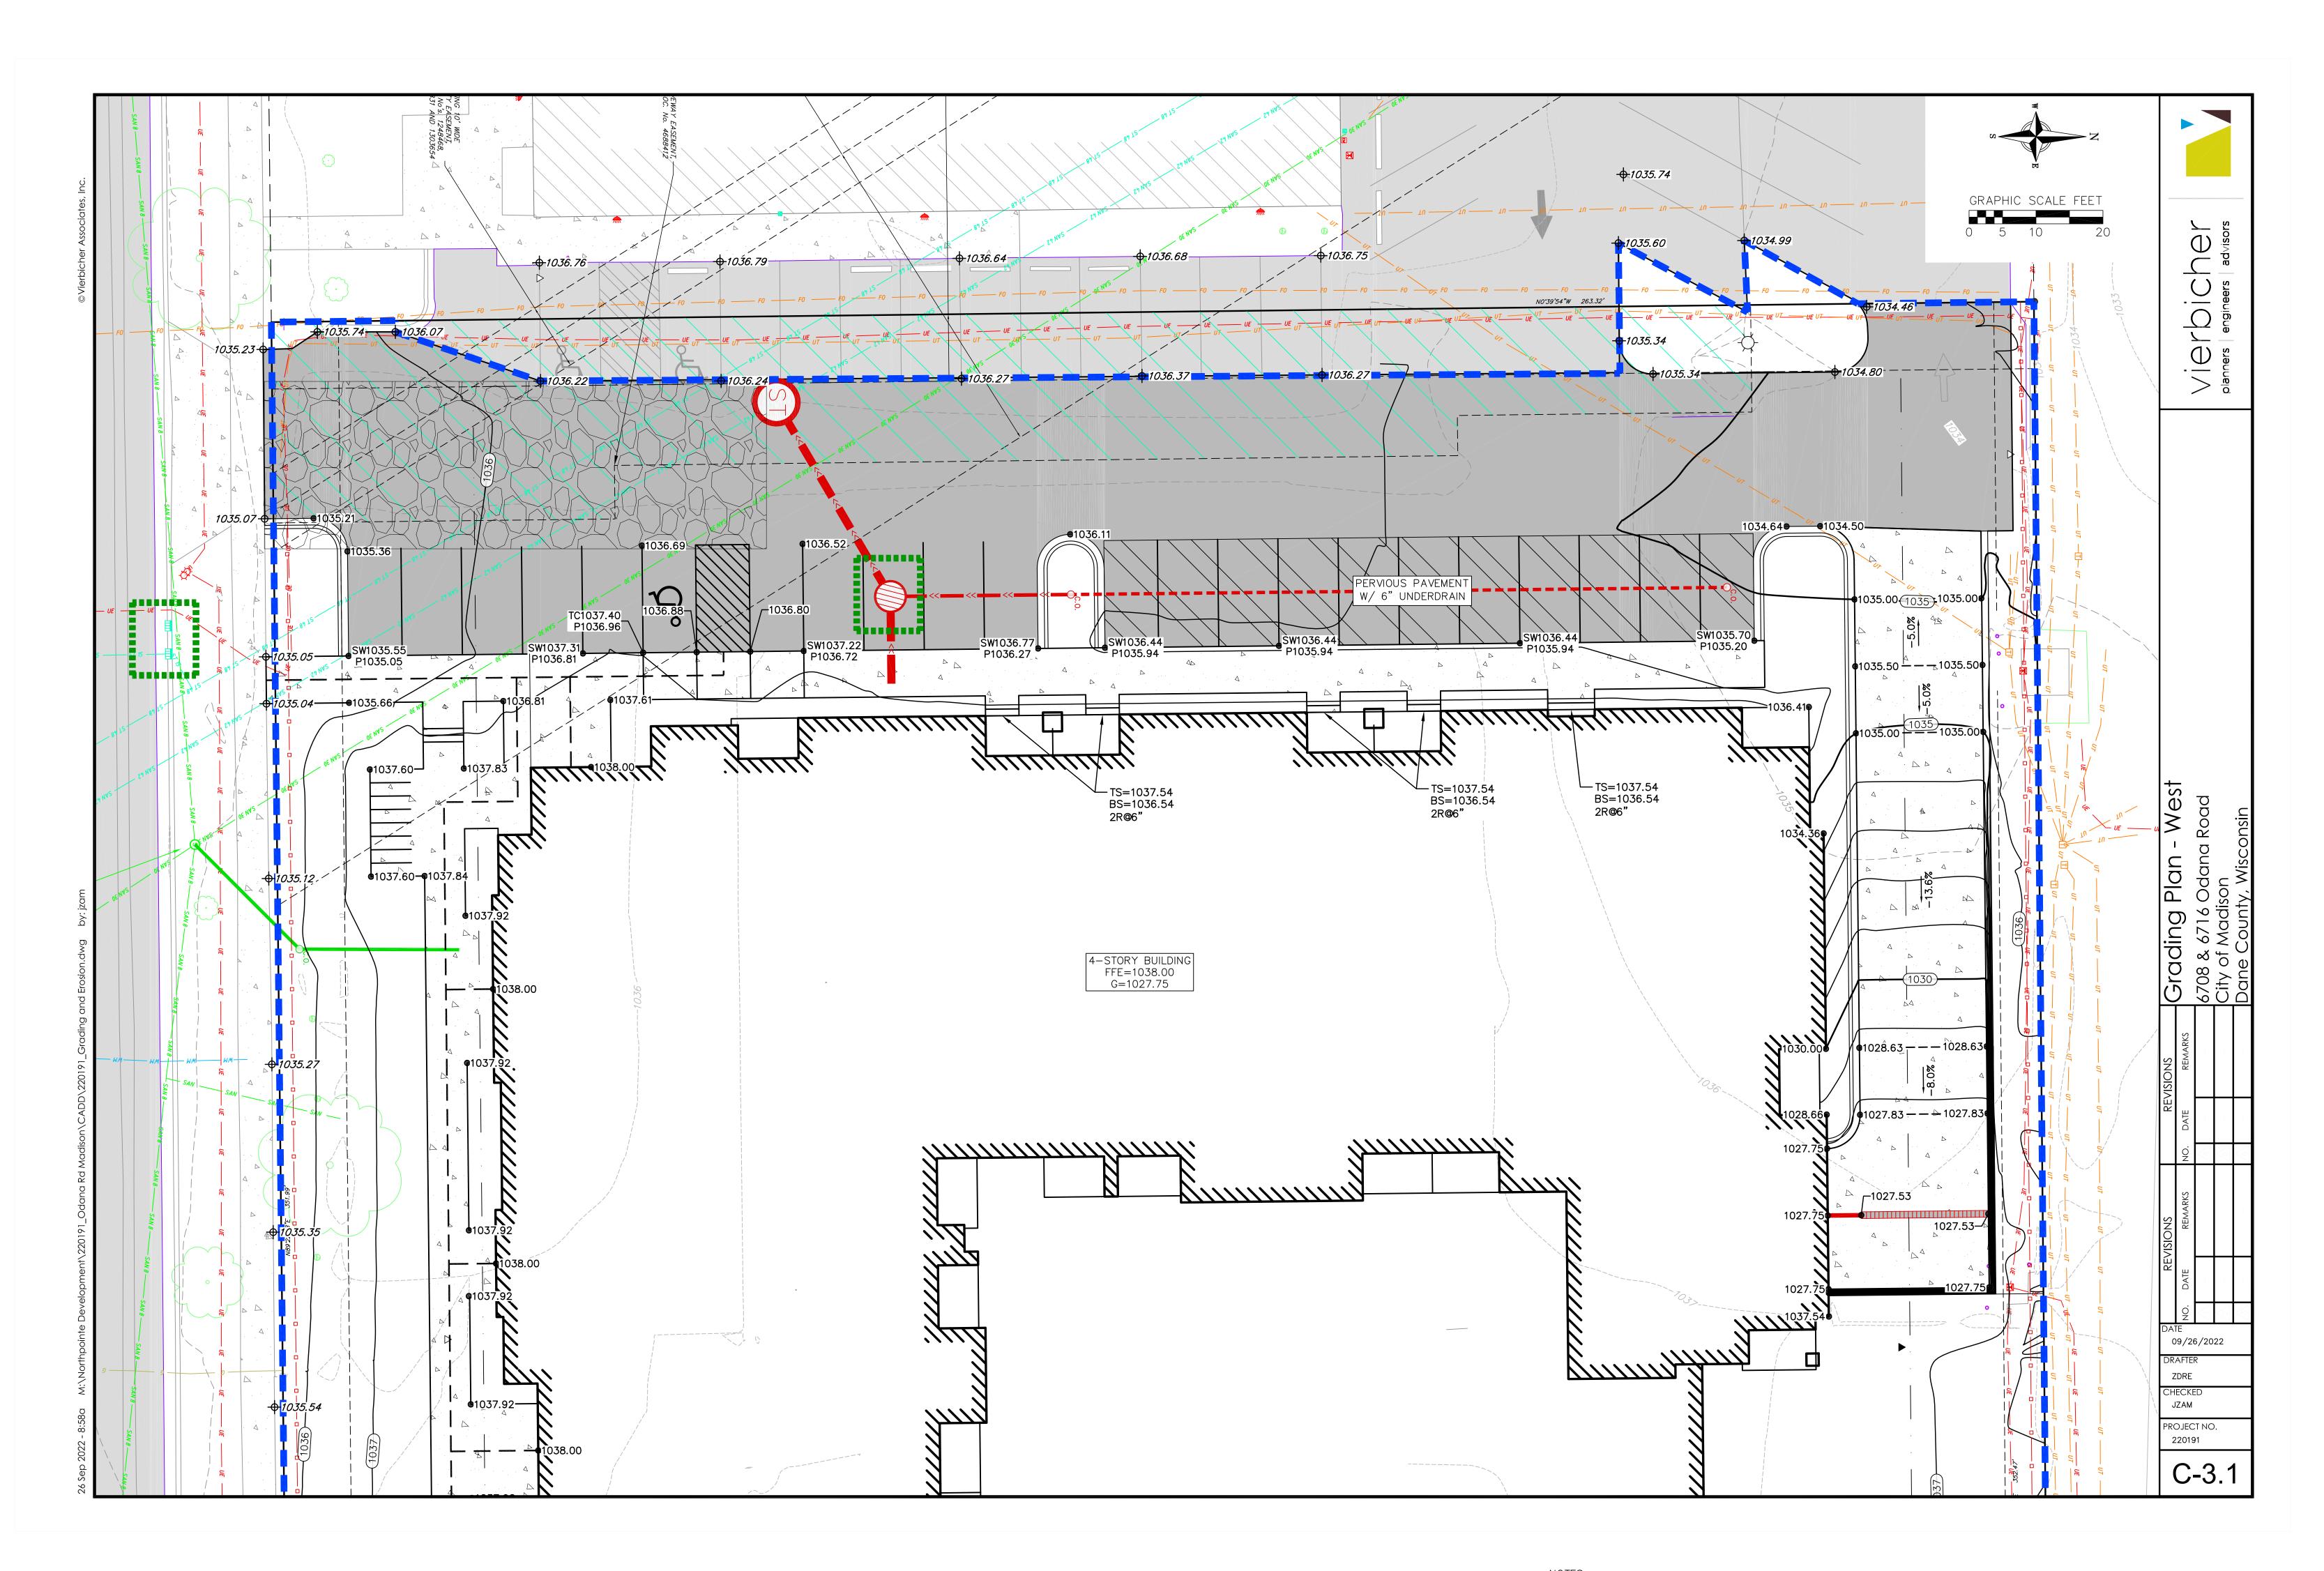

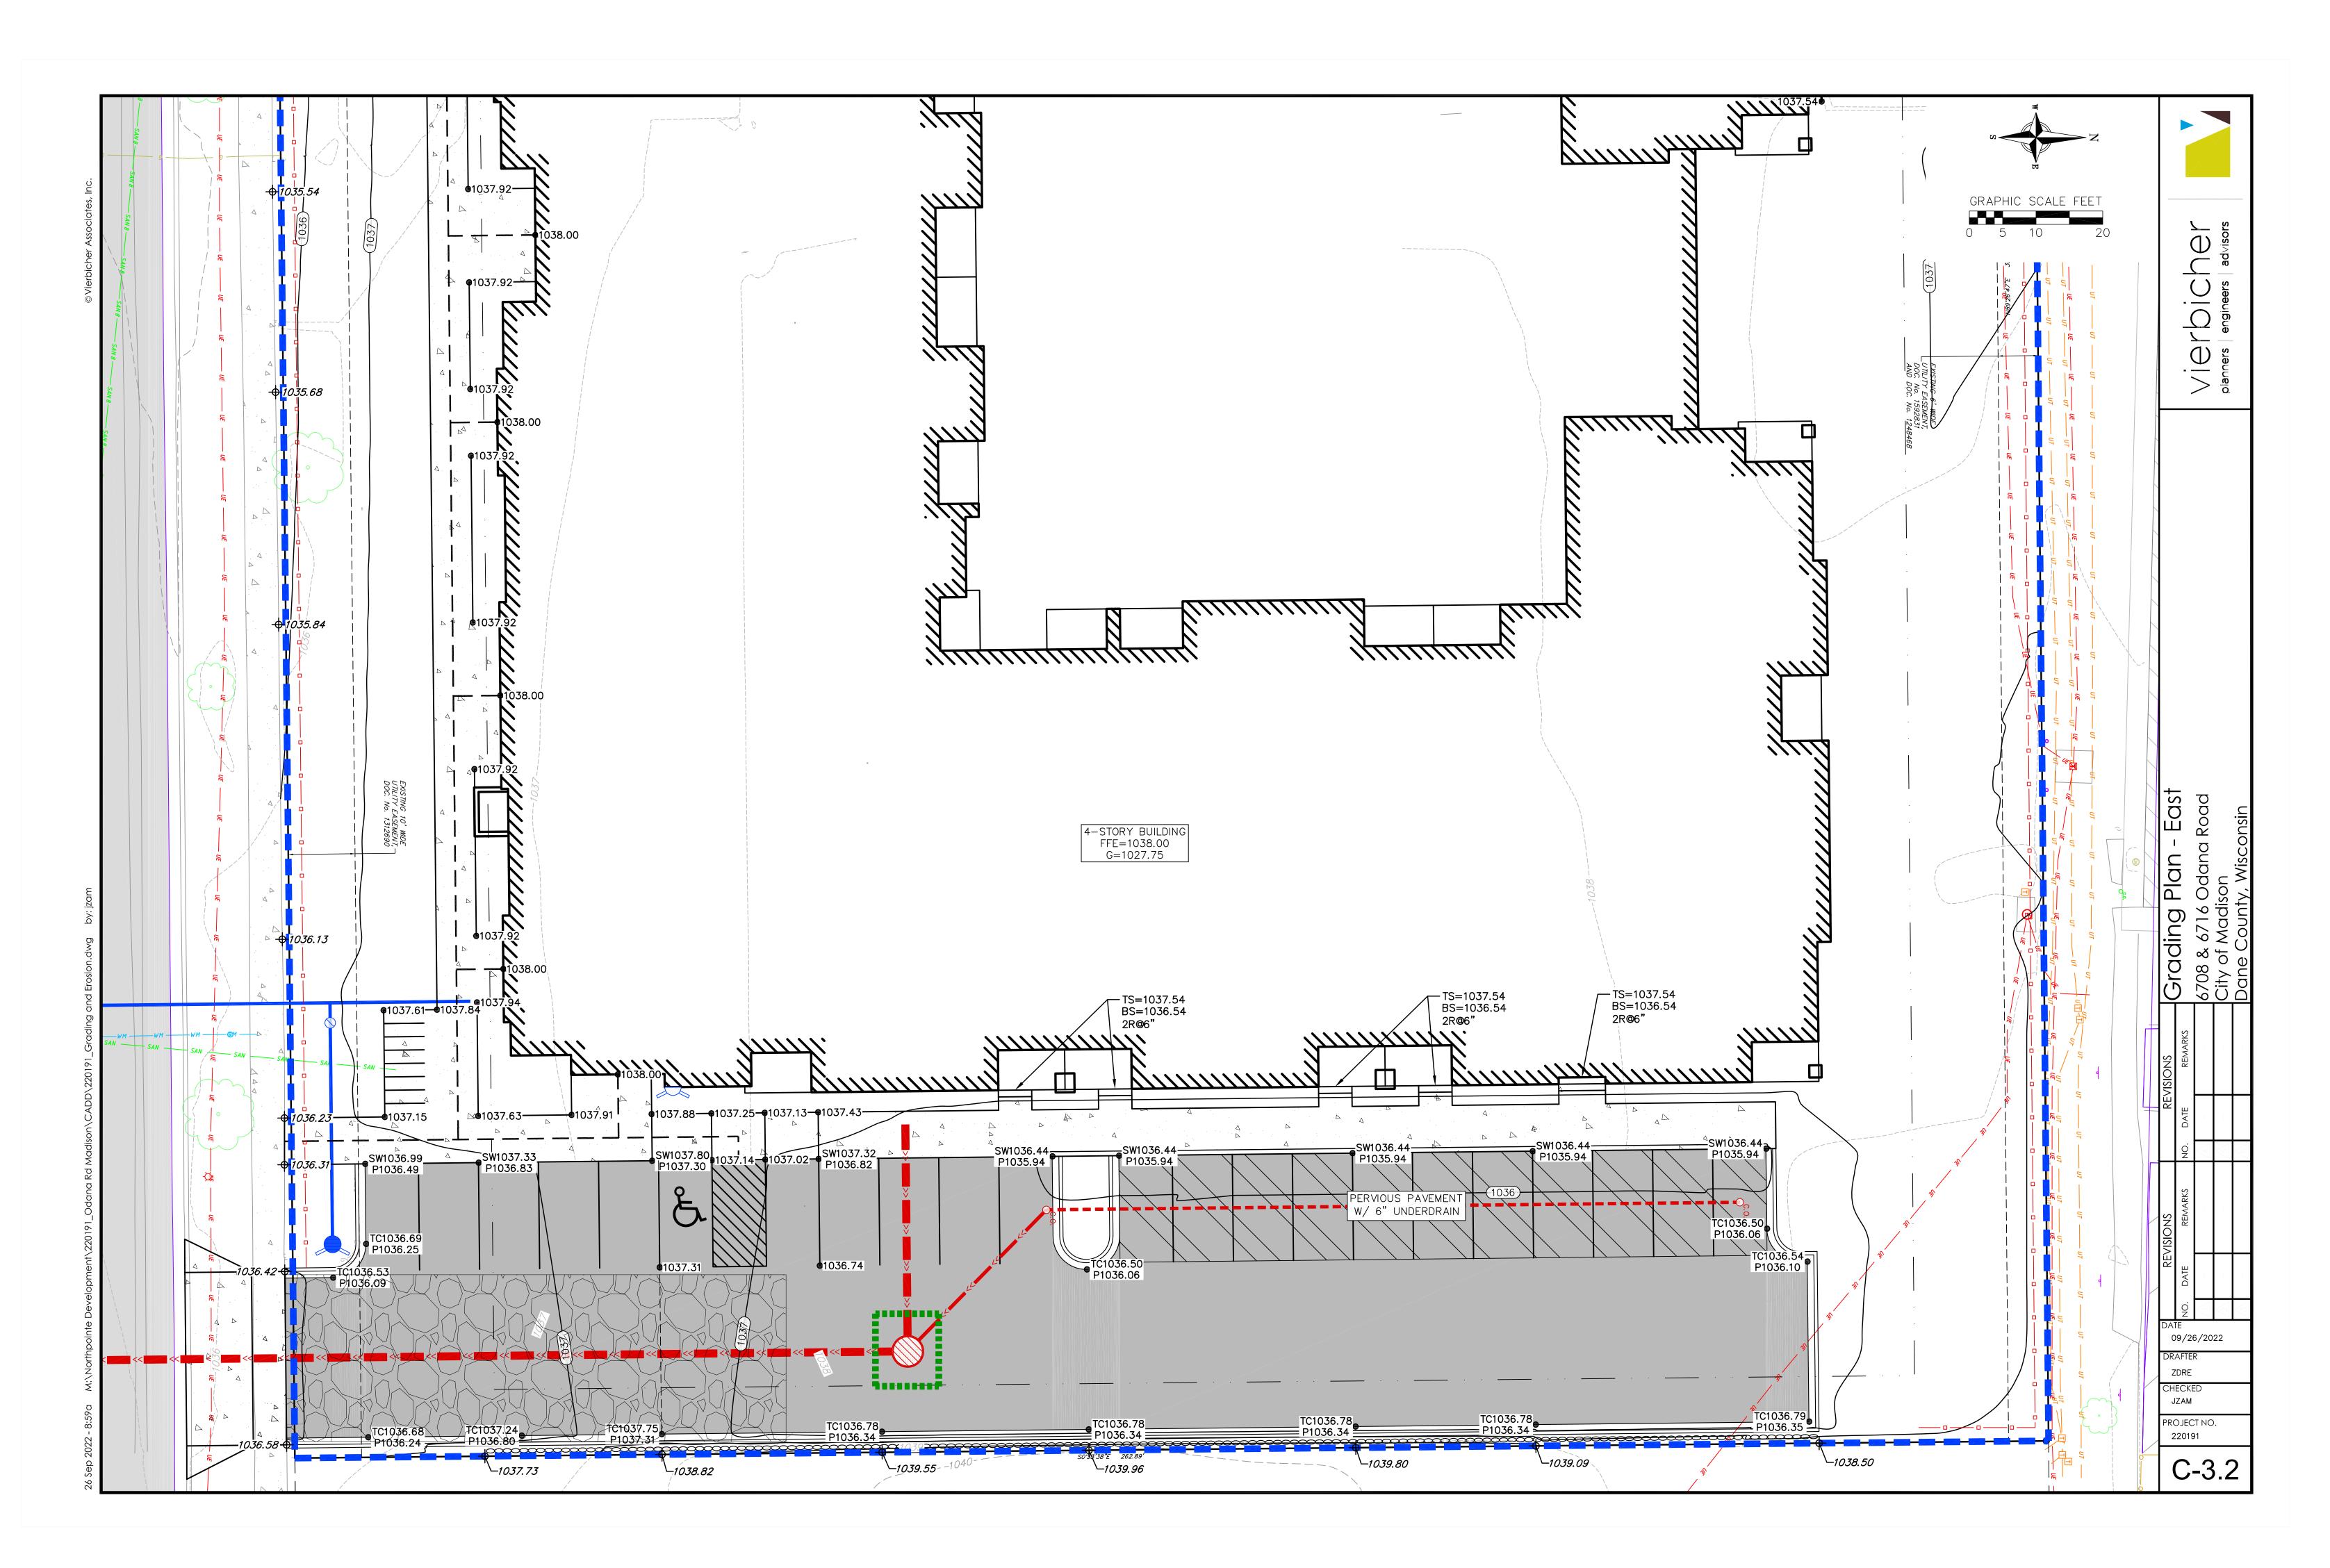

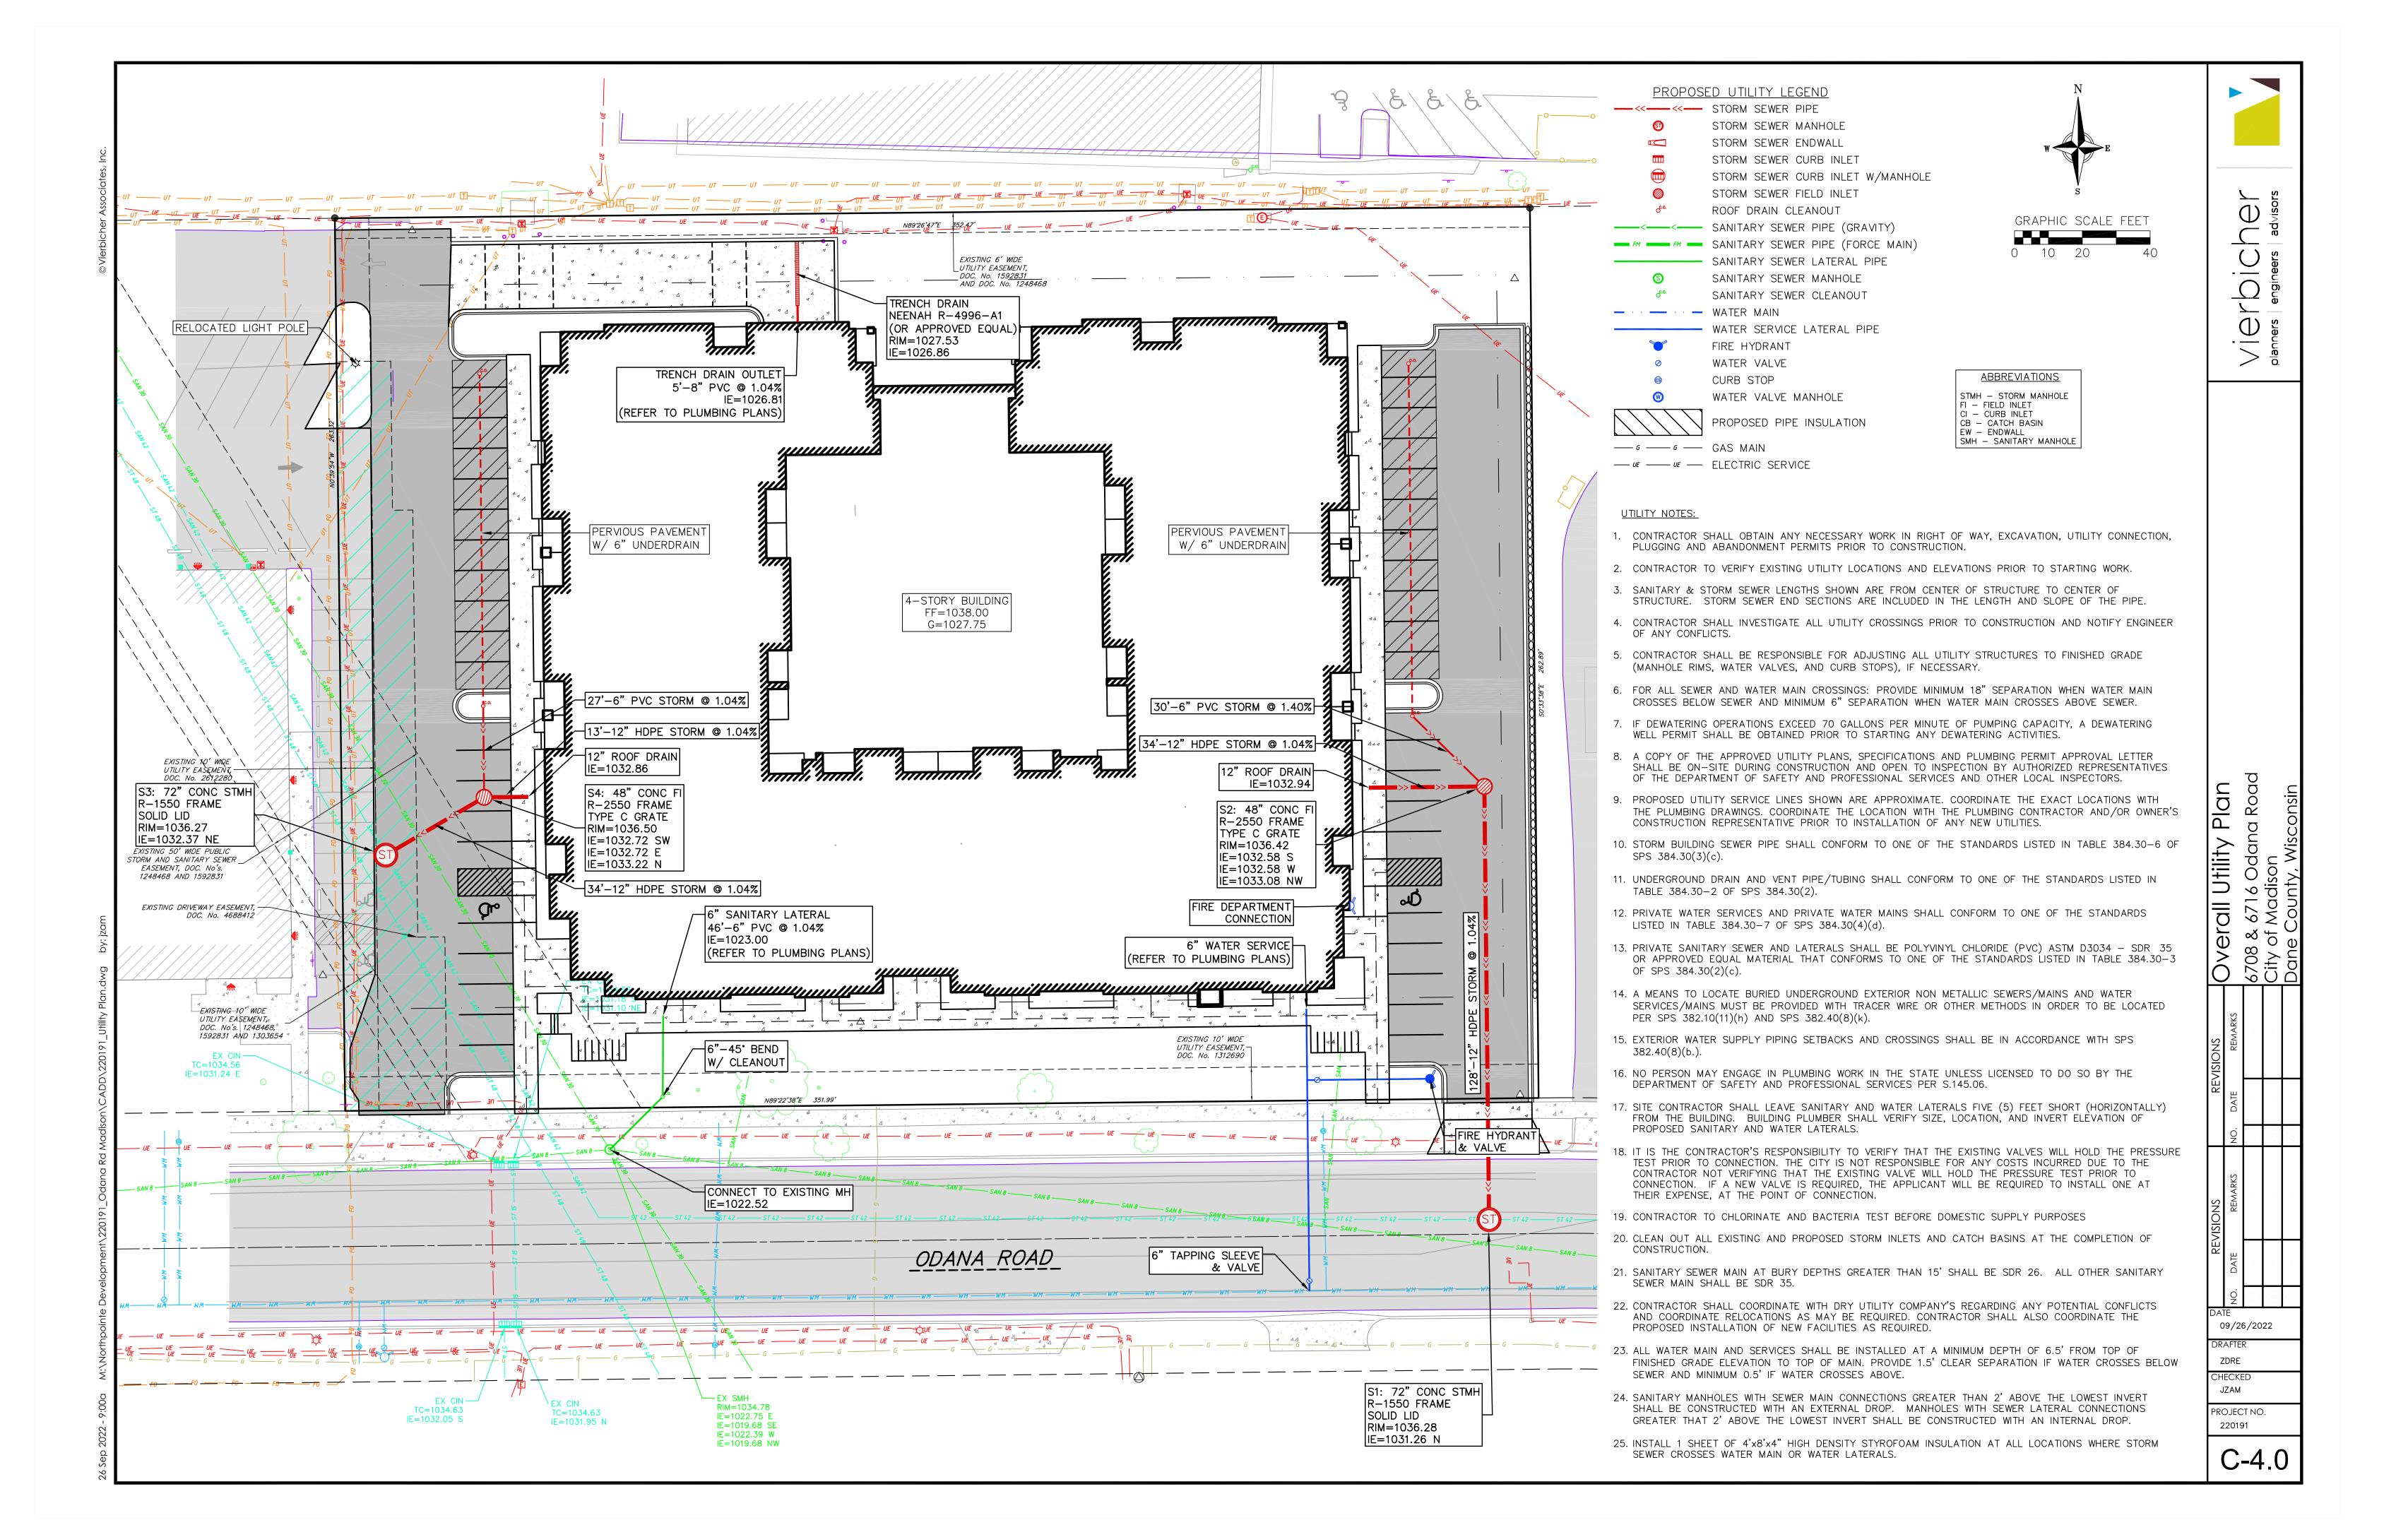



PROJECT TITLE Odana Road Site Concept


Northpointe Development

Odana Rd, Madison SHEET TITLE Basement Floor Plan

SHEET NUMBER

A-1.0

PROJECT NO.

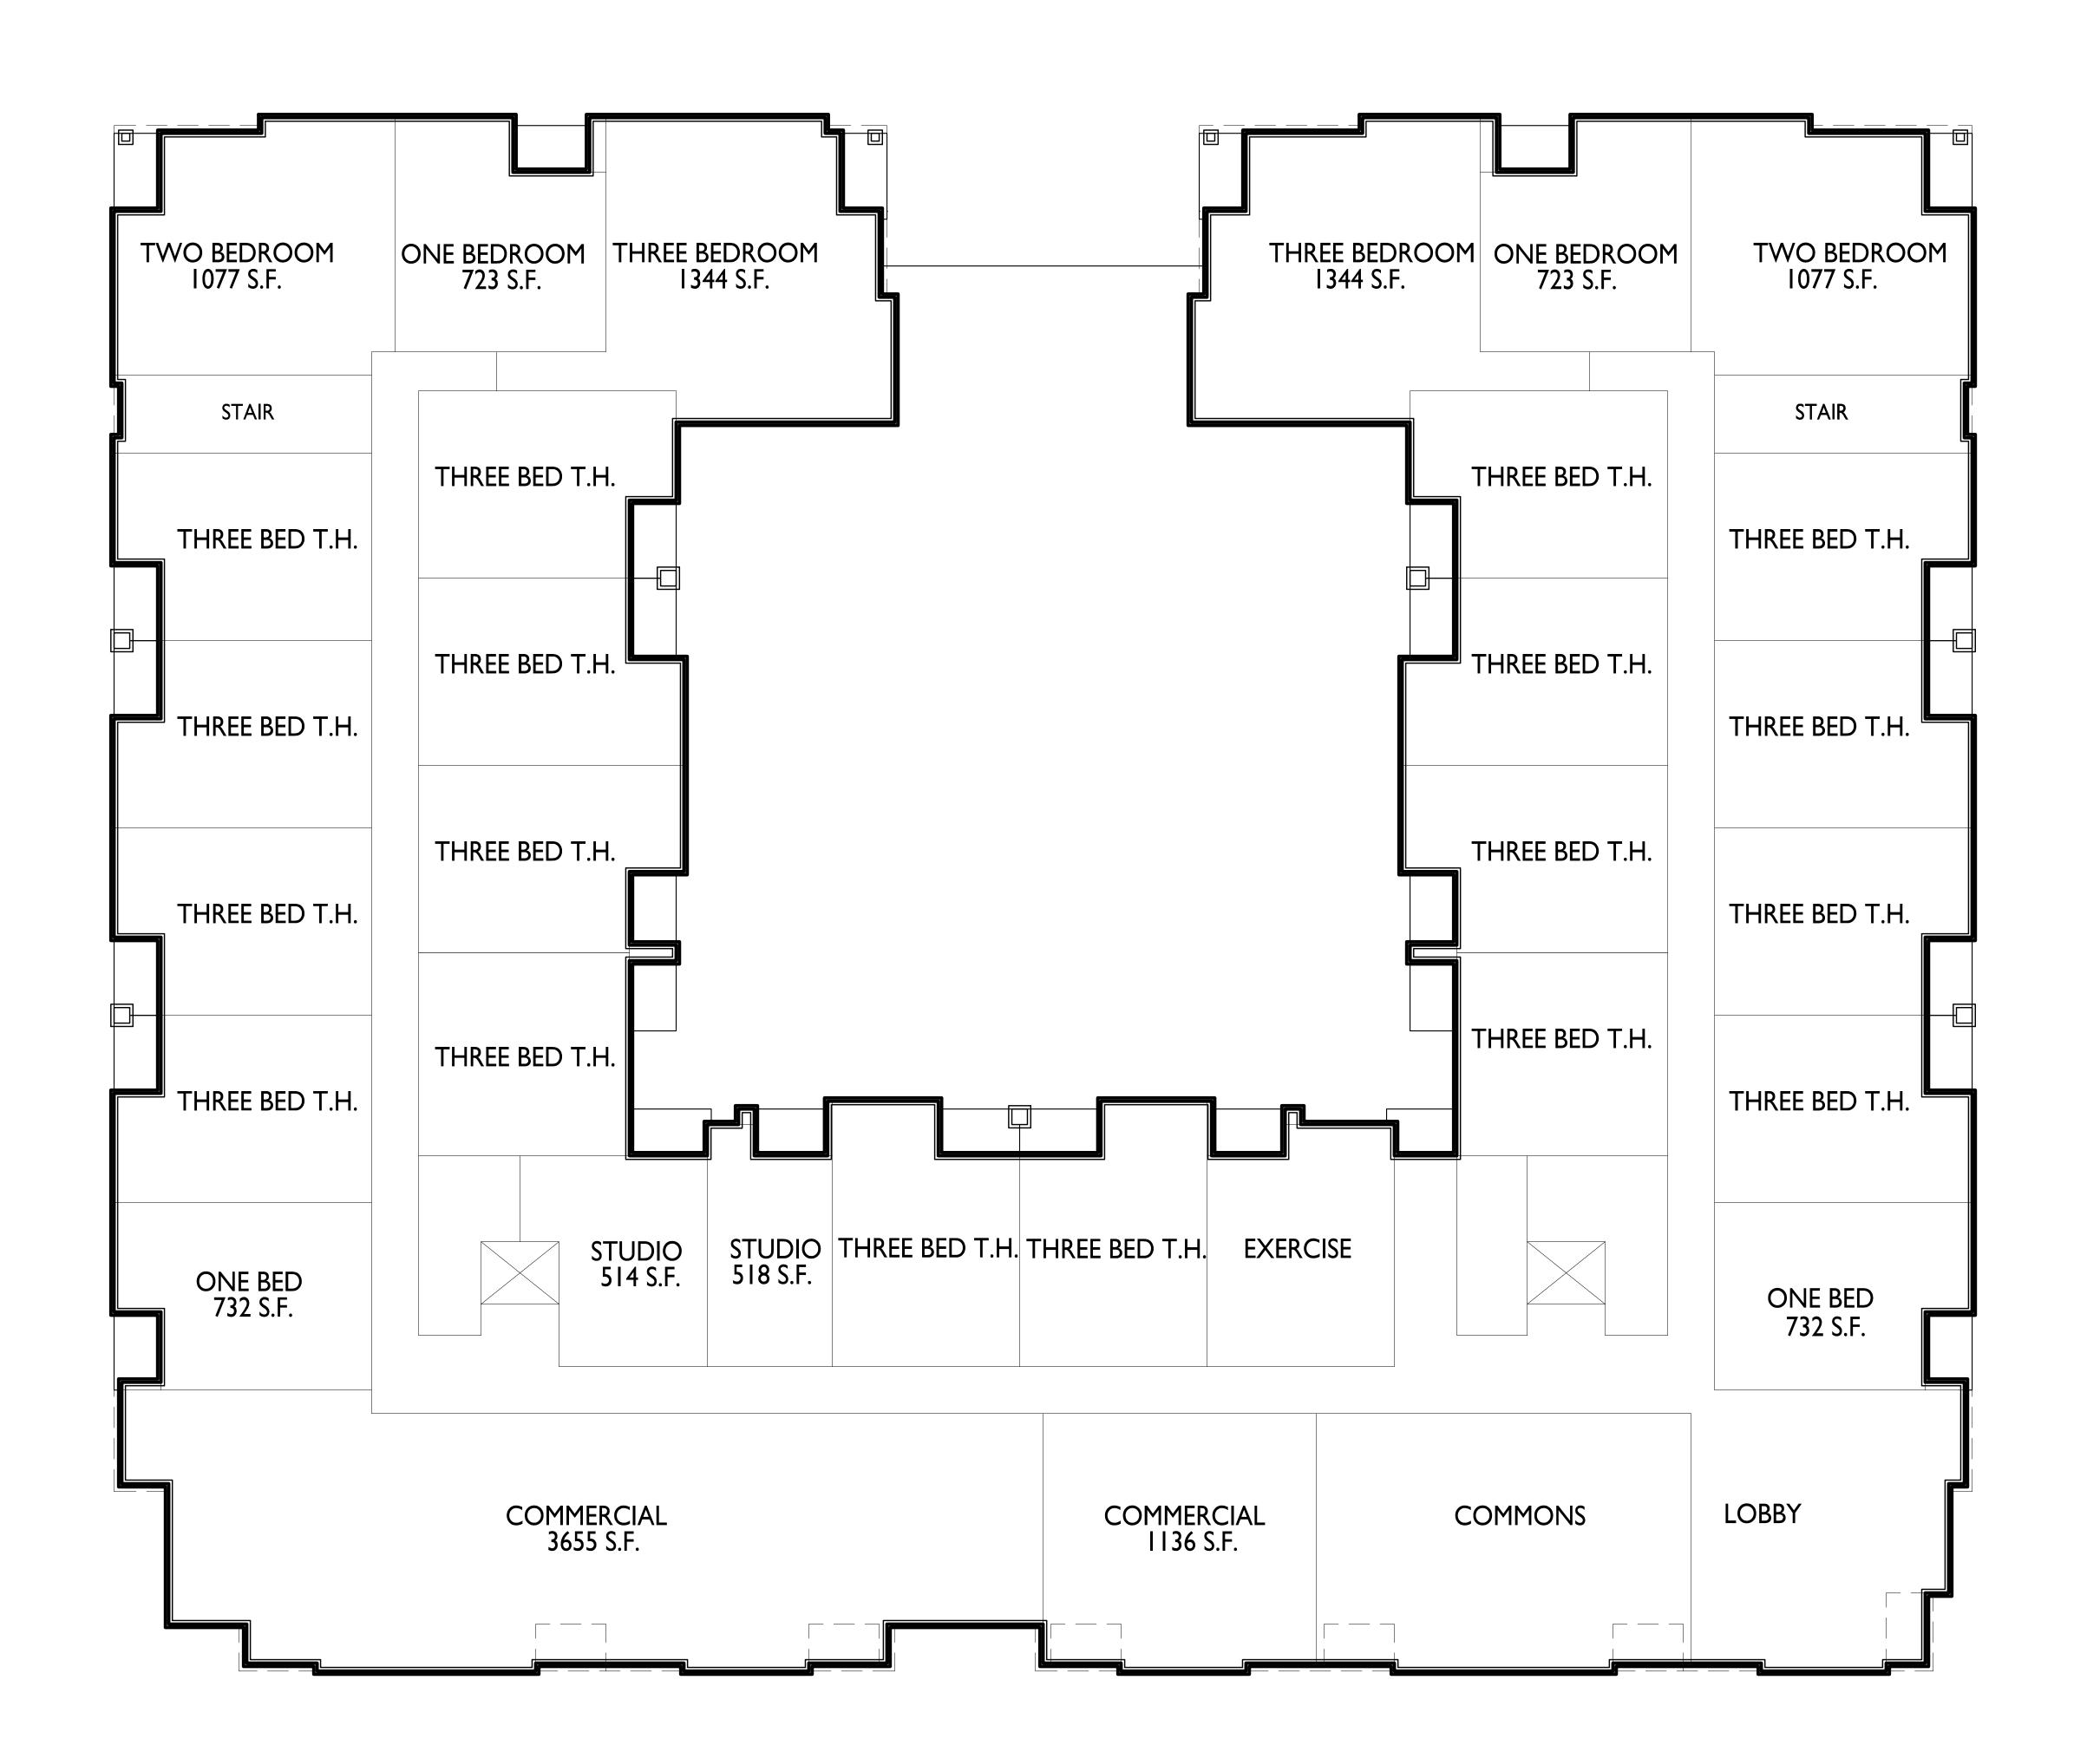



PROJECT TITLE

Odana Road

Site Concept

Northpointe Development

Odana Rd, Madison
SHEET TITLE


First Floor Plan


SHEET NUMBER





PROJECT NO. 2233
© Knothe & Bruce Architects, LLC

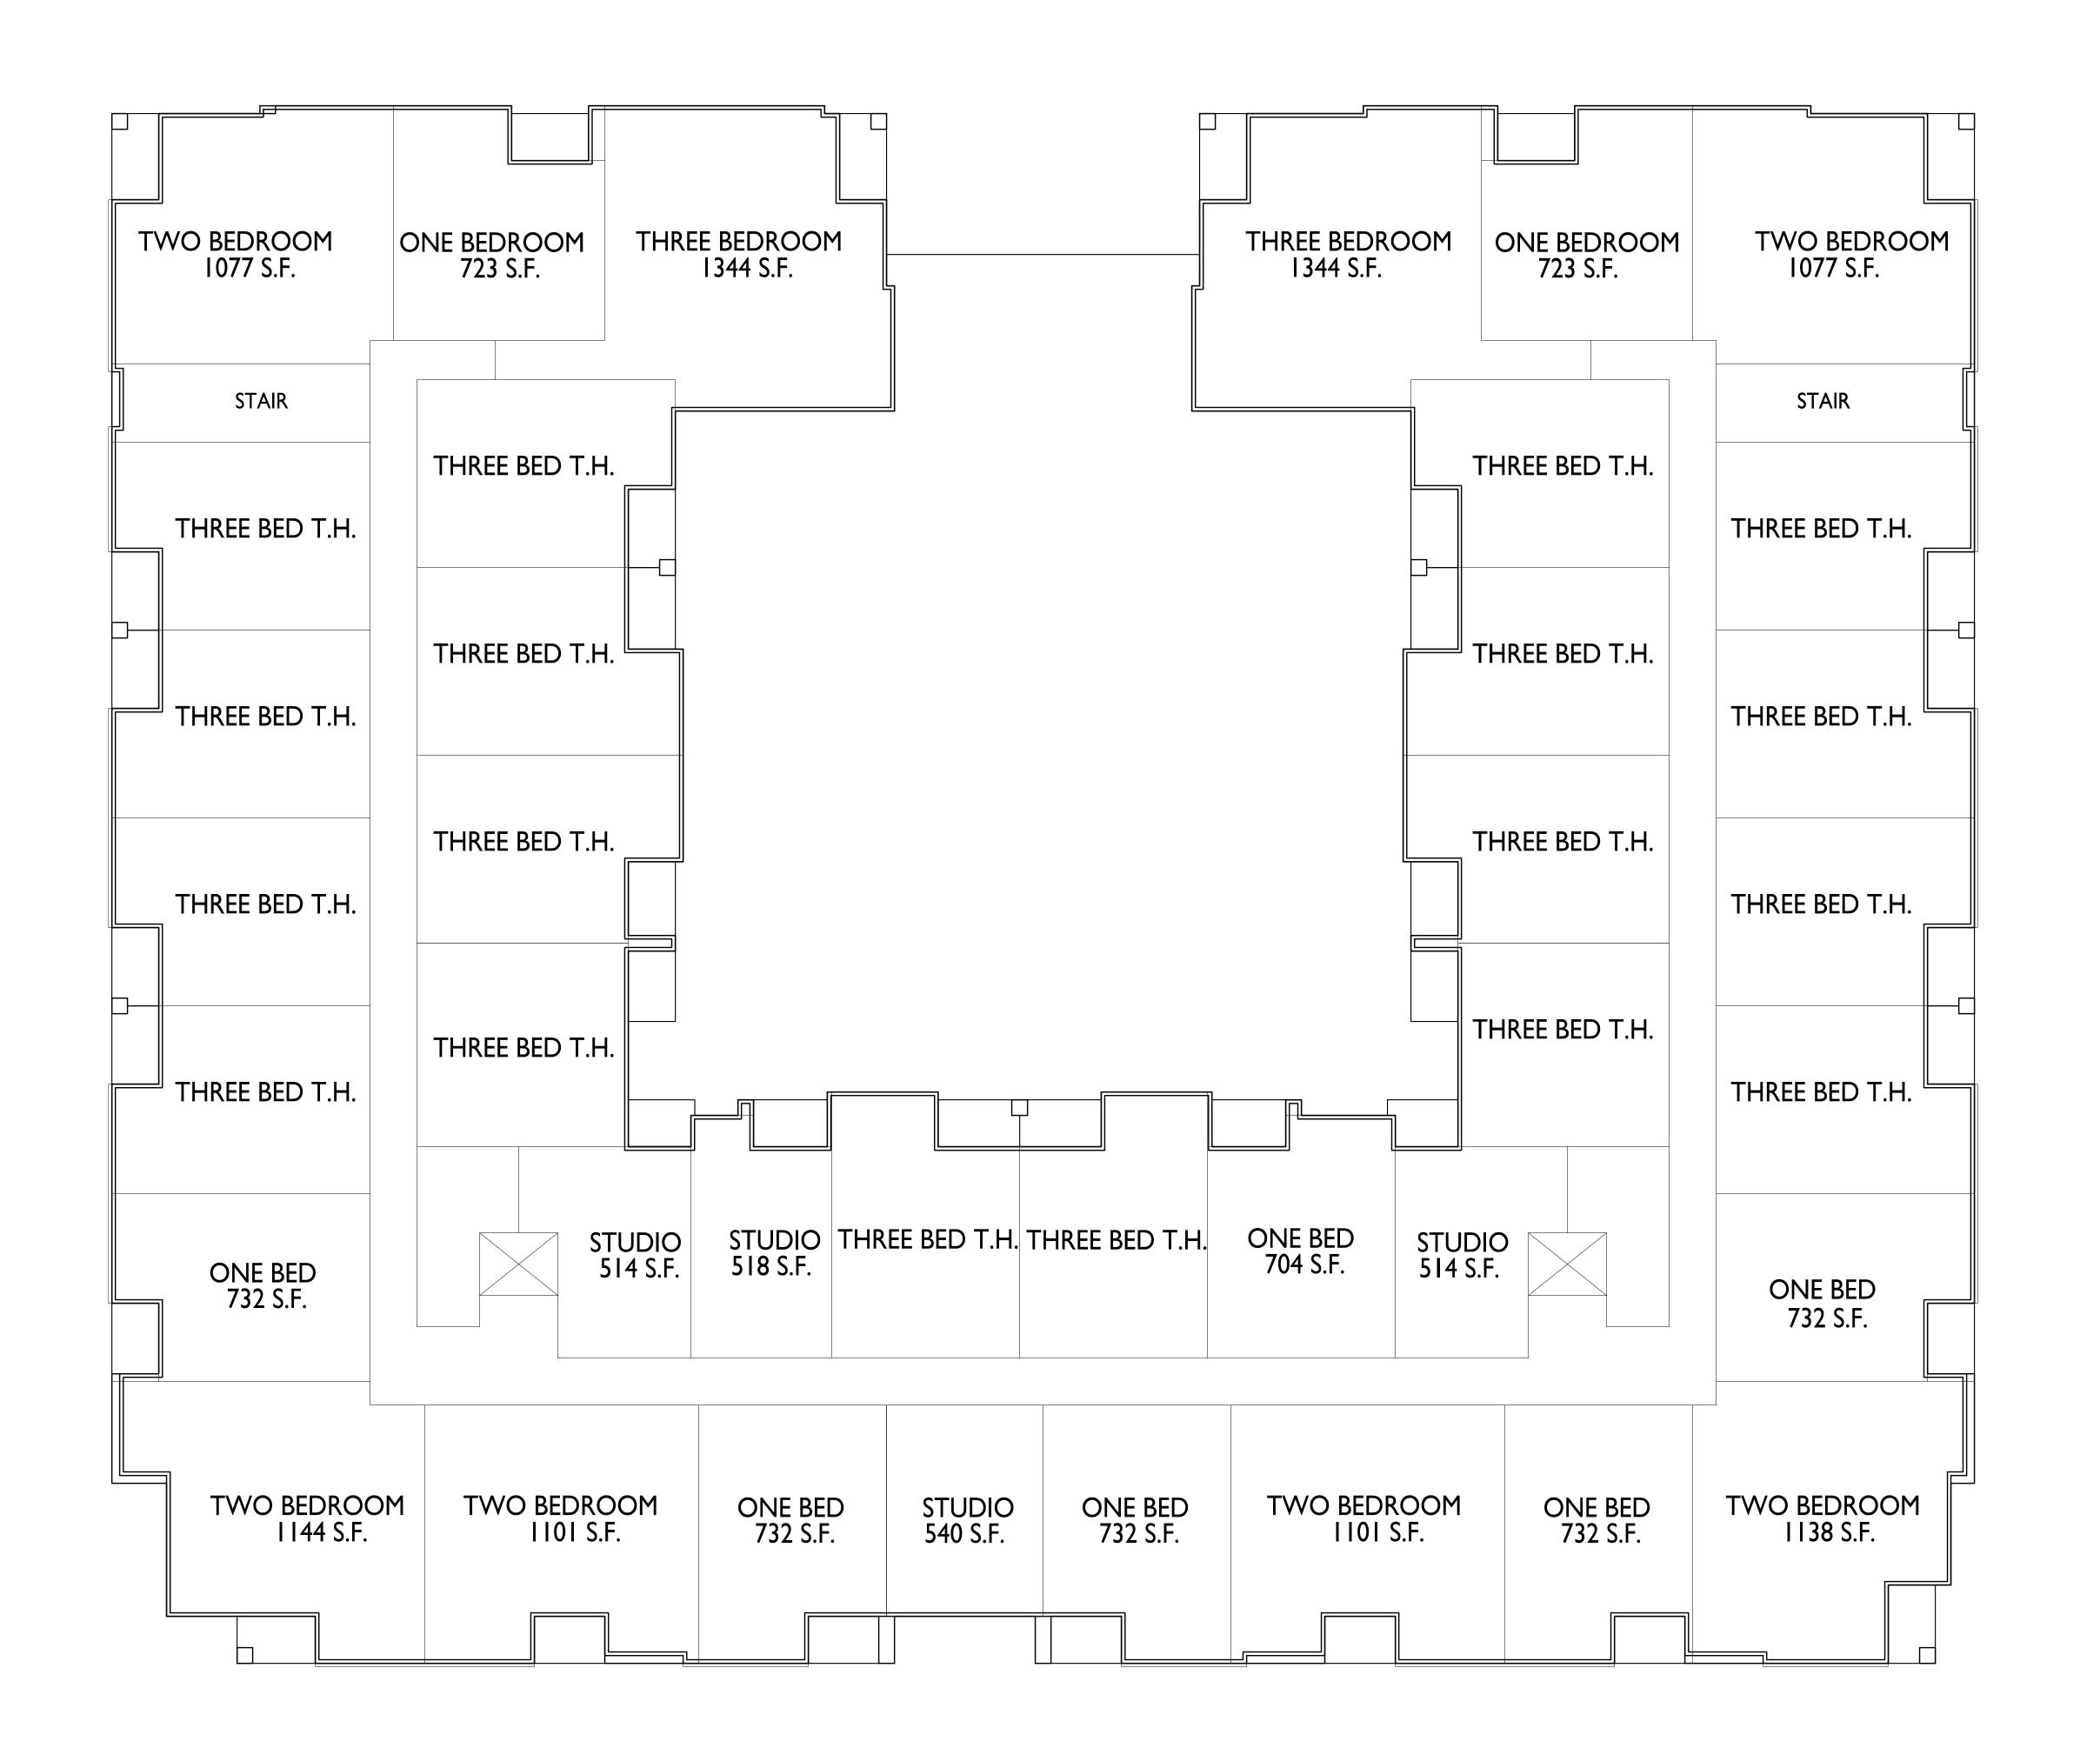

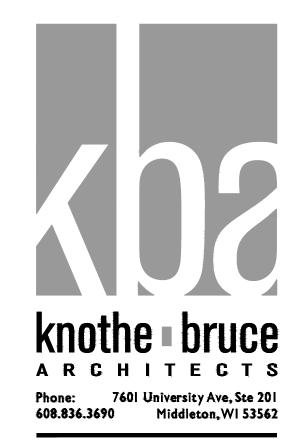

PROJECT TITLE
Odana Road
Site Concept

Northpointe Development


Odana Rd, Madison
SHEET TITLE

Second Floor Plan

SHEET NUMBER





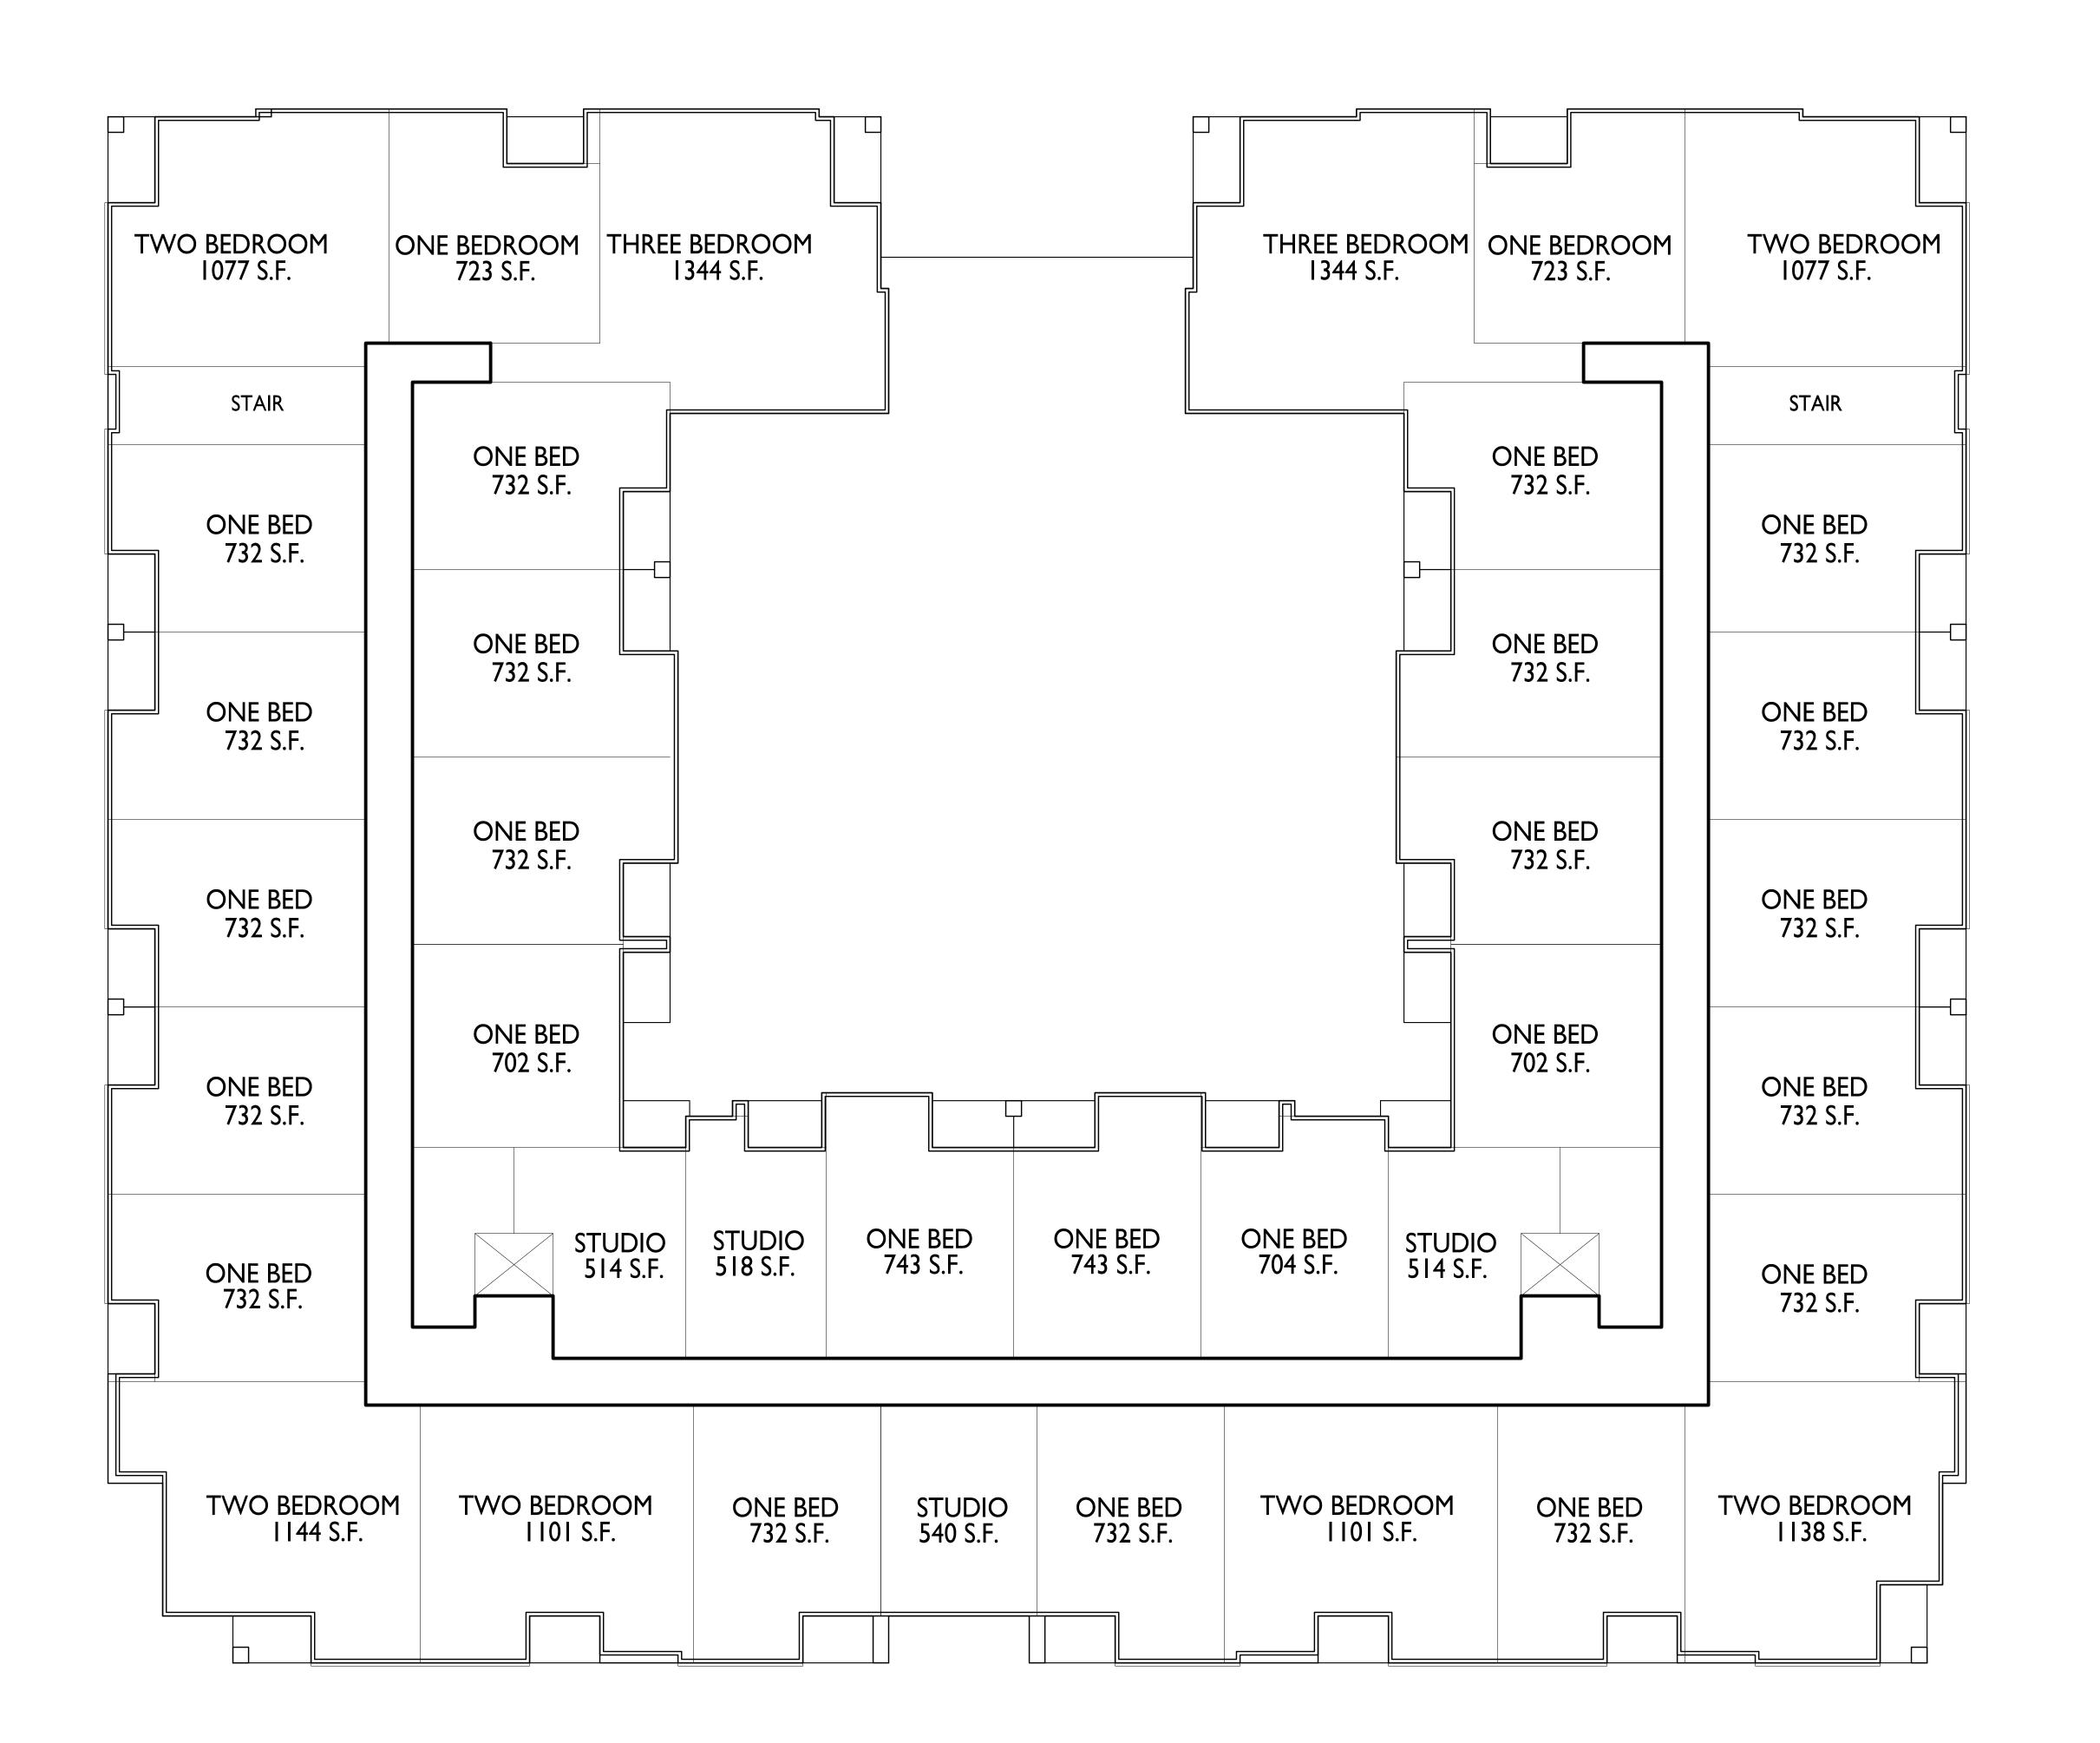



PROJECT TITLE
Odana Road
Site Concept

Northpointe Development

Odana Rd, Madison

SHEET TITLE


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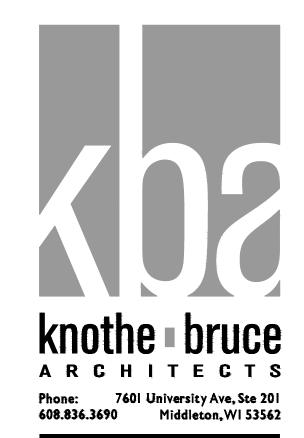
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PROJECT NO. 2233





PROJECT TITLE

Odana Road

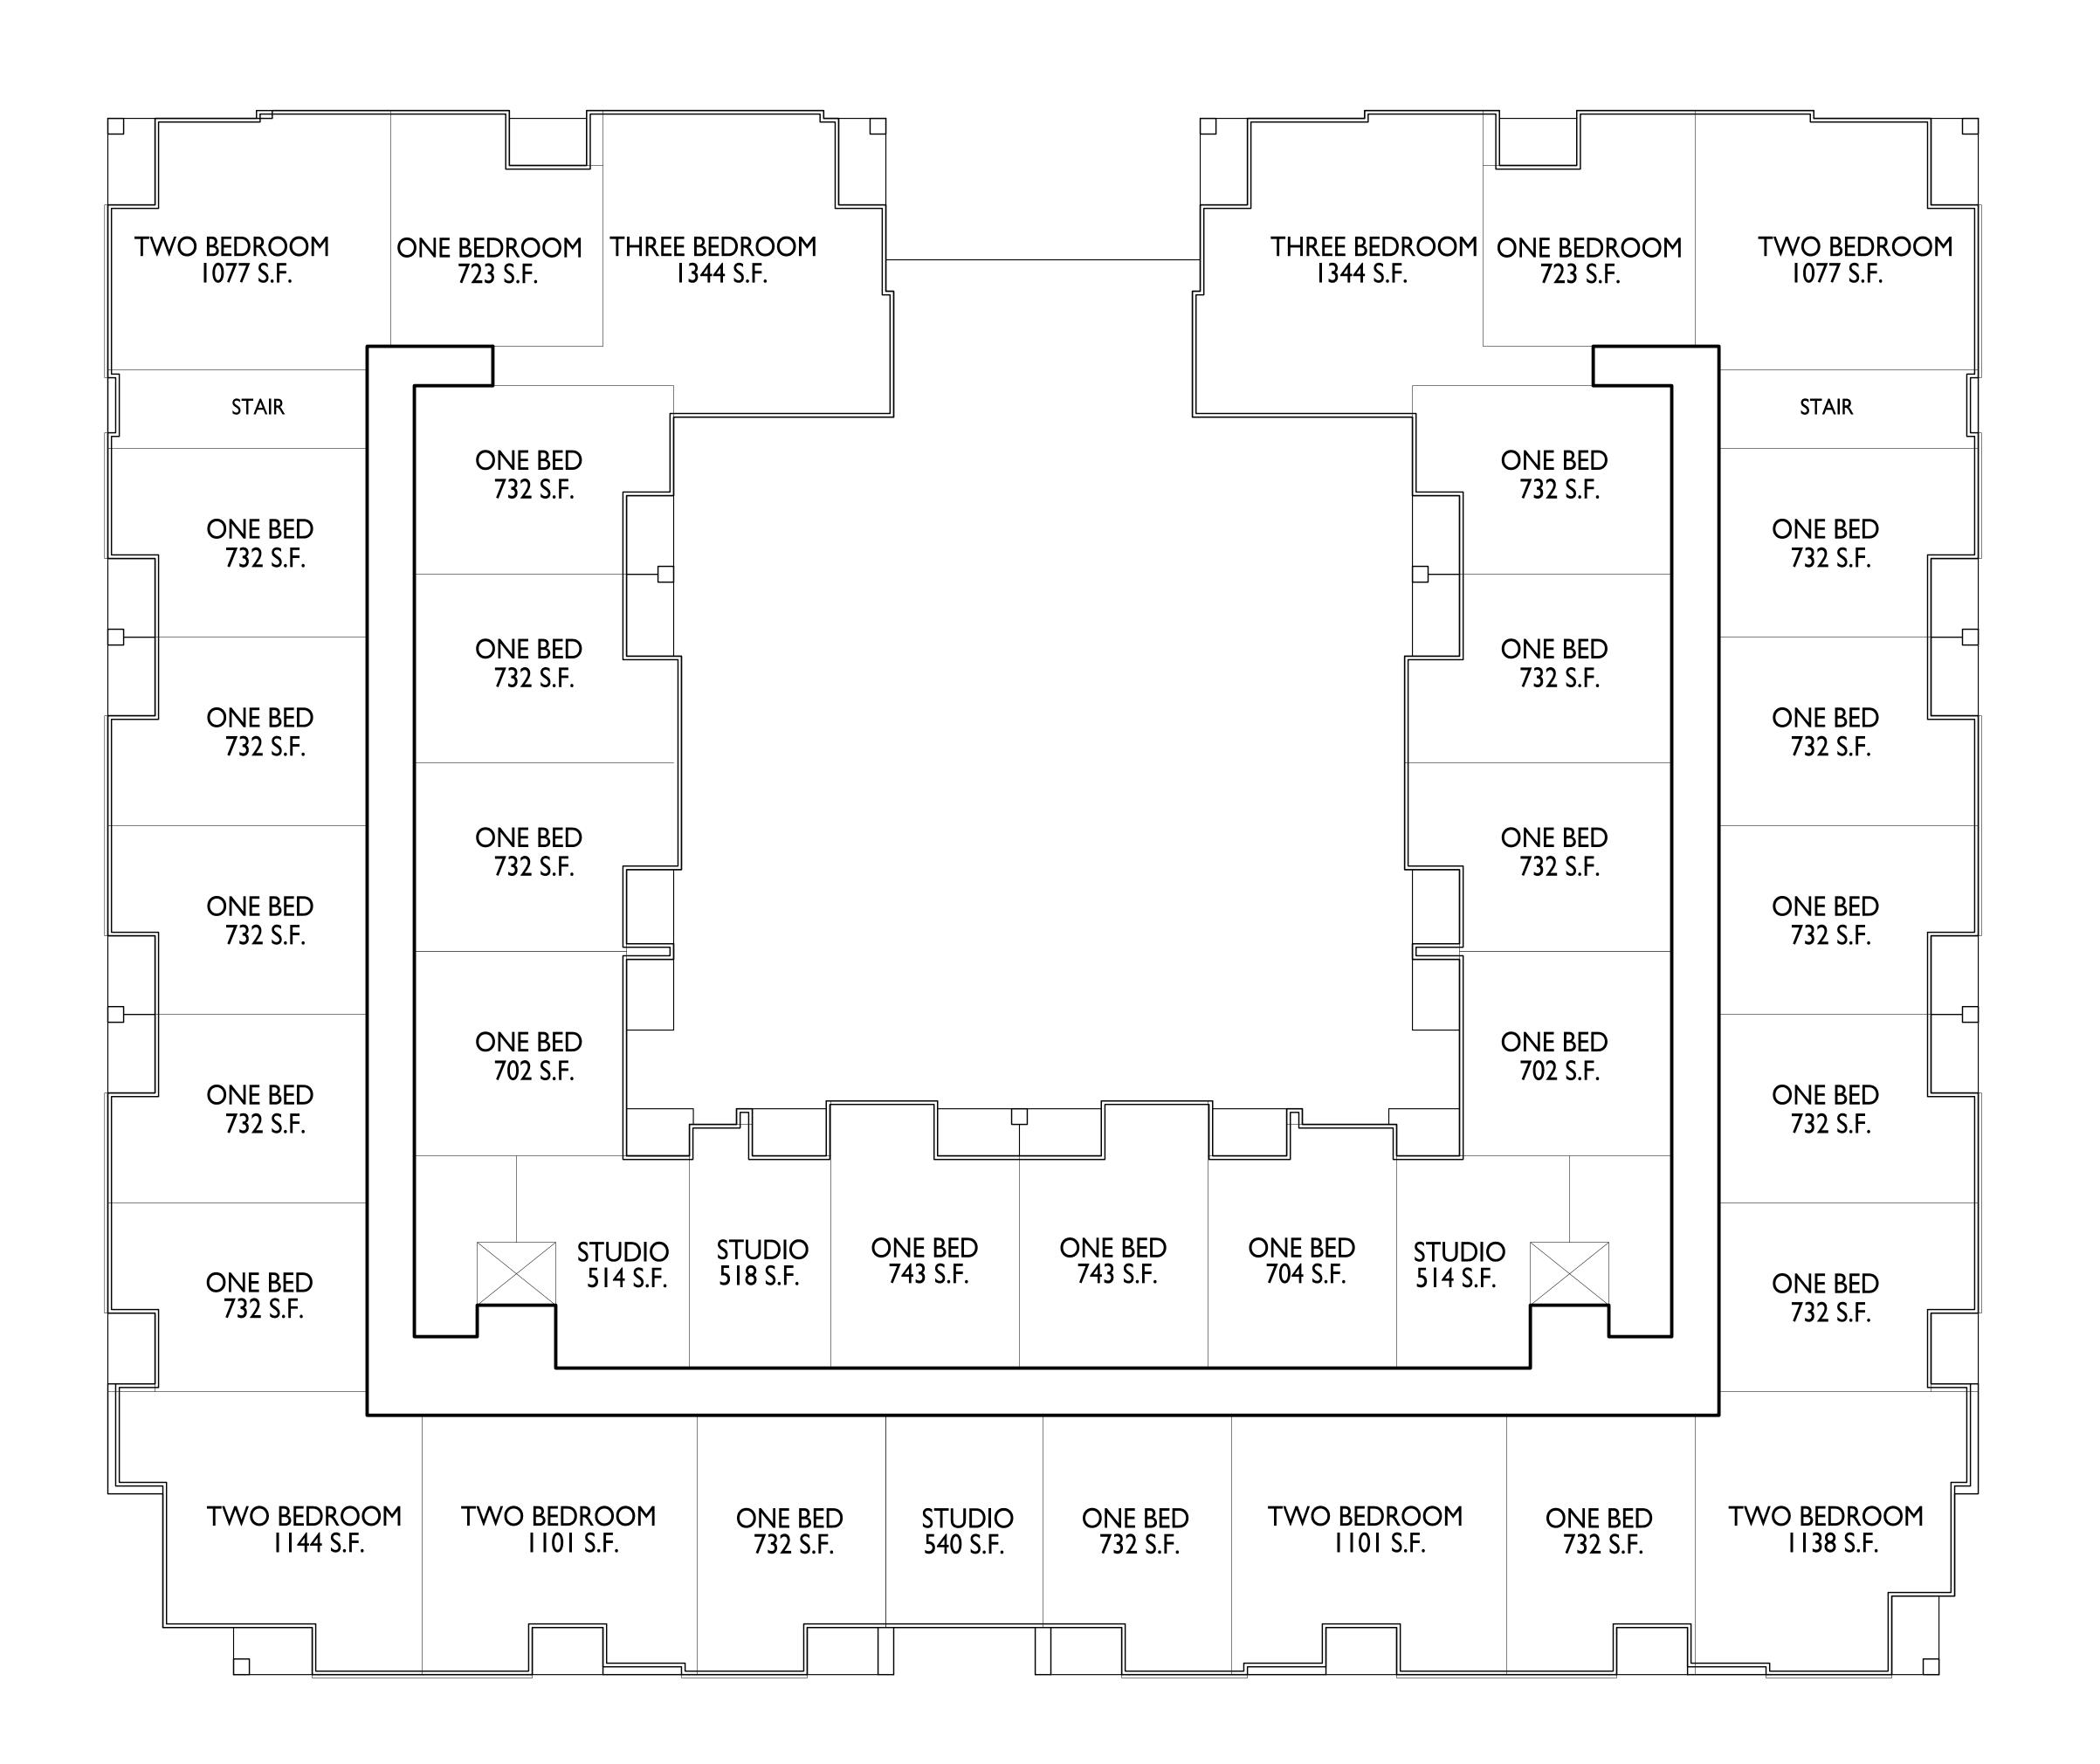Site Concept

Northpointe Development


Odana Rd, Madison


SHEET TITLE
Fourth Floor Plan

SHEET NUMBER





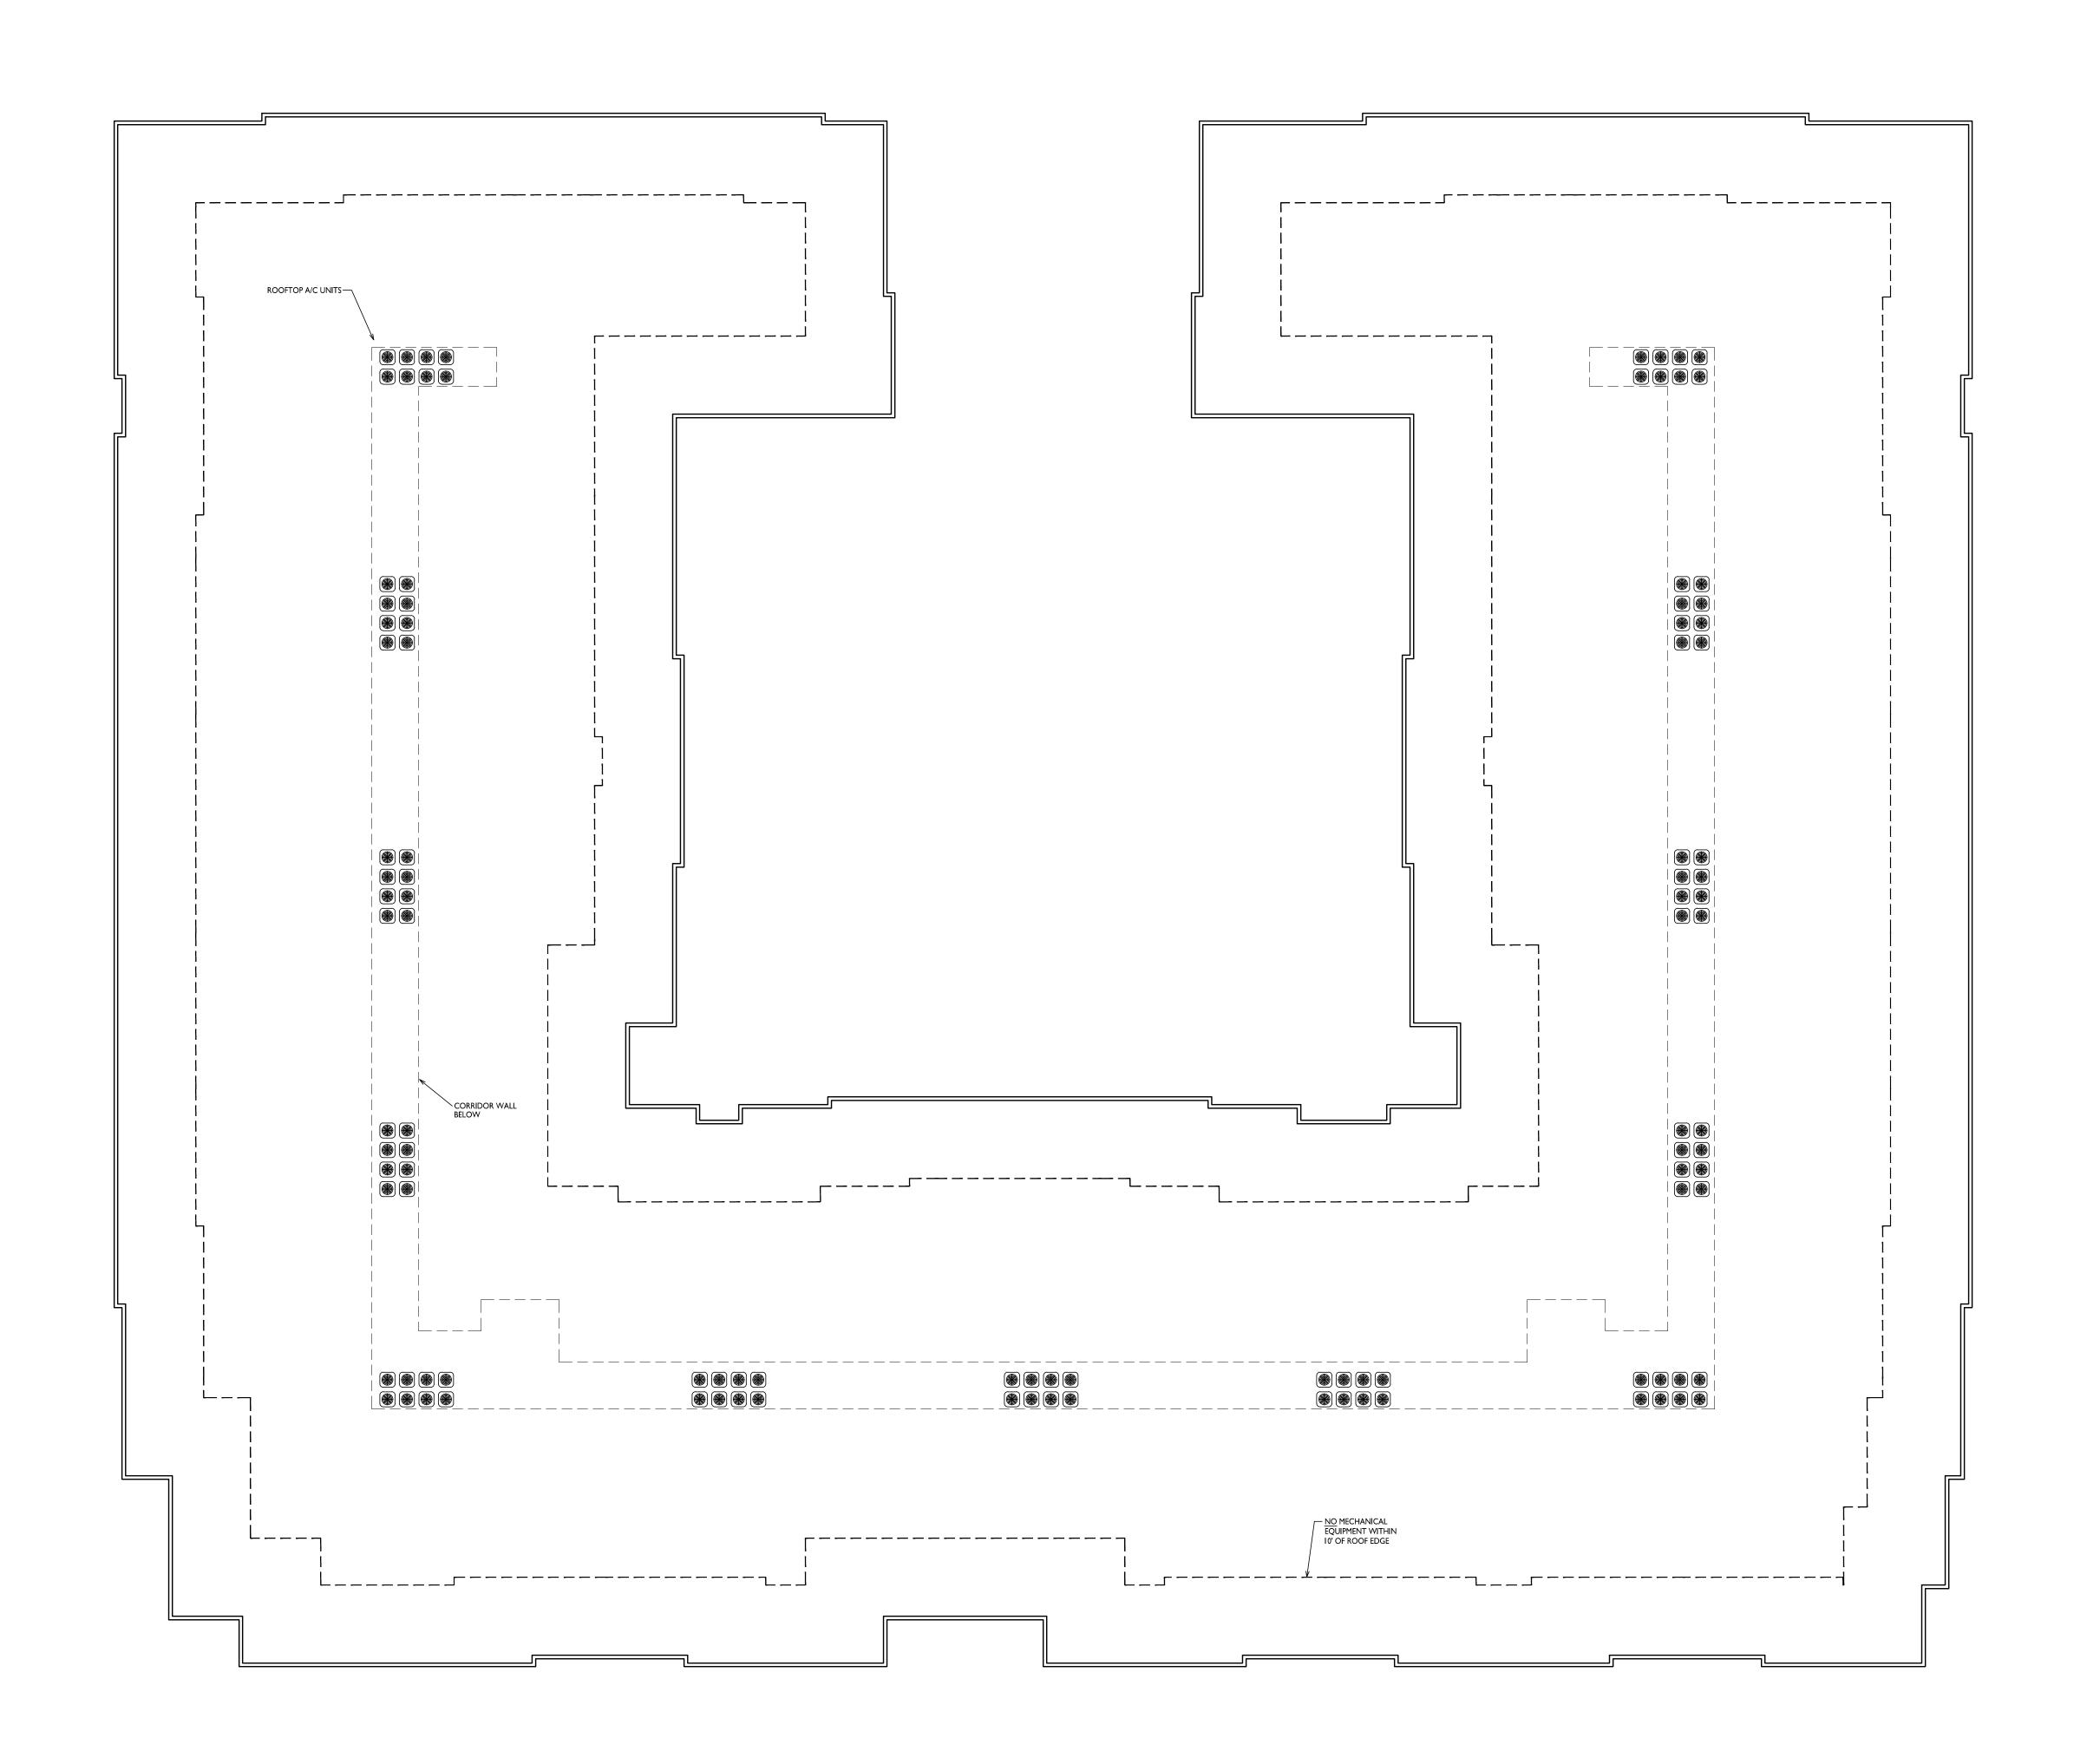

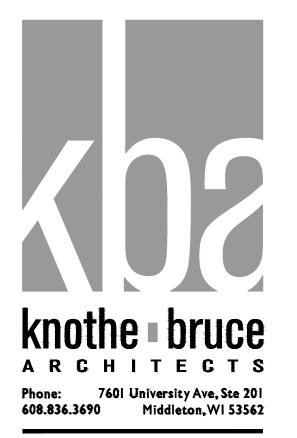

PROJECT TITLE
Odana Road
Site Concept


Northpointe Development

Odana Rd, Madison
SHEET TITLE
Roof Plan

SHEET NUMBER



PROJECT NO. 22.

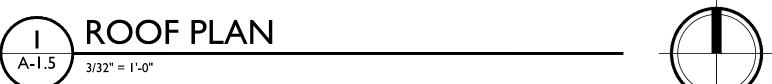




1 ELEVATION - EAST A201 3/32" = 1'-0"



2 ELEVATION - WEST 3/32" = 1'-0"

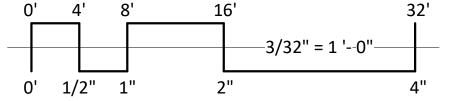

EXTERIOR MATERIAL SCHEDULE						
BUILDING ELEMENT	MANUFACTURER	COLOR	BUILDING ELEMENT	MANUFACTURER	COLOR	
(#1) - COMPOSITE LAP SIDING - 6"	LP SMARTSIDING	QUARRY GRAY	(#7) - CAST STONE BANDS & SILLS	ROCKCAST	CRYSTAL WHITE	
(#2) - METAL PANEL	PAC CLAD	CUSTOM - NAVY BLUE	(#8) - COMPOSITE WINDOWS	ANDERSEN 100	WHITE	
(#3) - COMPOSITE PANEL	LP SMARTSIDING	RUSTIC SERIES - OLD CHERRY	(#9) - ALUM. STOREFRONT	N/A	WHITE	
COMPOSITE TRIM	LP SMARTSIDING	MATCH ADJ. COLOR	CANOPY & BAY SOFFITS	LP SMARTSIDING	MATCH ADJ. TRIM	
(#4) - BRICK VENEER	INTERSTATE BRICK	ATLAS EMPEROR 4x4x16 - COAL	TREATED-EXPOSED DECK BEAMS	N/A	BROWN TREATED	
(#5) - STONE VENEER	ACME BRICK	MSTONE - WHITE QUARTZ SPLITFACE	(#10) - RAILING & HANDRAILS	SUPERIOR	BLACK	
(#6) - HEADERS - SOLDIER COURSE	INTERSTATE BRICK	ATLAS EMPEROR 4x4x16 - COAL				



ISSUED

PROJECT TITLE

Northpointe Odana Rd.

123 FAKE ST. SUPER
CITY
STATE OF MIND
SHEET TITLE
EXTERIOR

ELEVATIONS

SHEET NUMBER

A201
PROJECT NUMBER 2233



1 ELEVATION - NORTH 3/32" = 1'-0"



2 ELEVATION - SOUTH 3/32" = 1'-0"

0' 4' 8' 16' 32' 0' 1/2" 1" 2" 4"

		EVTEDIOD MAA	TEDIAL SCHEDULE		
		EXTERIOR IVIA	TERIAL SCHEDULE		
BUILDING ELEMENT	MANUFACTURER	COLOR	BUILDING ELEMENT	MANUFACTURER	COLOR
(#1) - COMPOSITE LAP SIDING - 6"	LP SMARTSIDING	QUARRY GRAY	(#7) - CAST STONE BANDS & SILLS	ROCKCAST	CRYSTAL WHITE
(#2) - METAL PANEL	PAC CLAD	CUSTOM - NAVY BLUE	(#8) - COMPOSITE WINDOWS	ANDERSEN 100	WHITE
(#3) - COMPOSITE PANEL	LP SMARTSIDING	RUSTIC SERIES - OLD CHERRY	(#9) - ALUM. STOREFRONT	N/A	WHITE
COMPOSITE TRIM	LP SMARTSIDING	MATCH ADJ. COLOR	CANOPY & BAY SOFFITS	LP SMARTSIDING	MATCH ADJ. TRIM
(#4) - BRICK VENEER	INTERSTATE BRICK	ATLAS EMPEROR 4x4x16 - COAL	TREATED-EXPOSED DECK BEAMS	N/A	BROWN TREATED
(#5) - STONE VENEER	ACME BRICK	MSTONE - WHITE QUARTZ SPLITFACE	(#10) - RAILING & HANDRAILS	SUPERIOR	BLACK
(#6) - HEADERS - SOLDIER COURSE	INTERSTATE BRICK	ATLAS EMPEROR 4x4x16 - COAL			

knoth ARCH Phone: 608.836.3690

Middleton, WI 53562

PROJECT TITLE

Northpointe

Odana Rd.

123 FAKE ST. SUPER CITY
STATE OF MIND
SHEET TITLE

ELEVATIONS

STATE OF MINSHEET TITLE


EXTERIOR

SHEET NUMBER


A202
PROJECT NUMBER 2233



1 ELEVATION - EAST INTERIOR A203 3/32" = 1'-0"

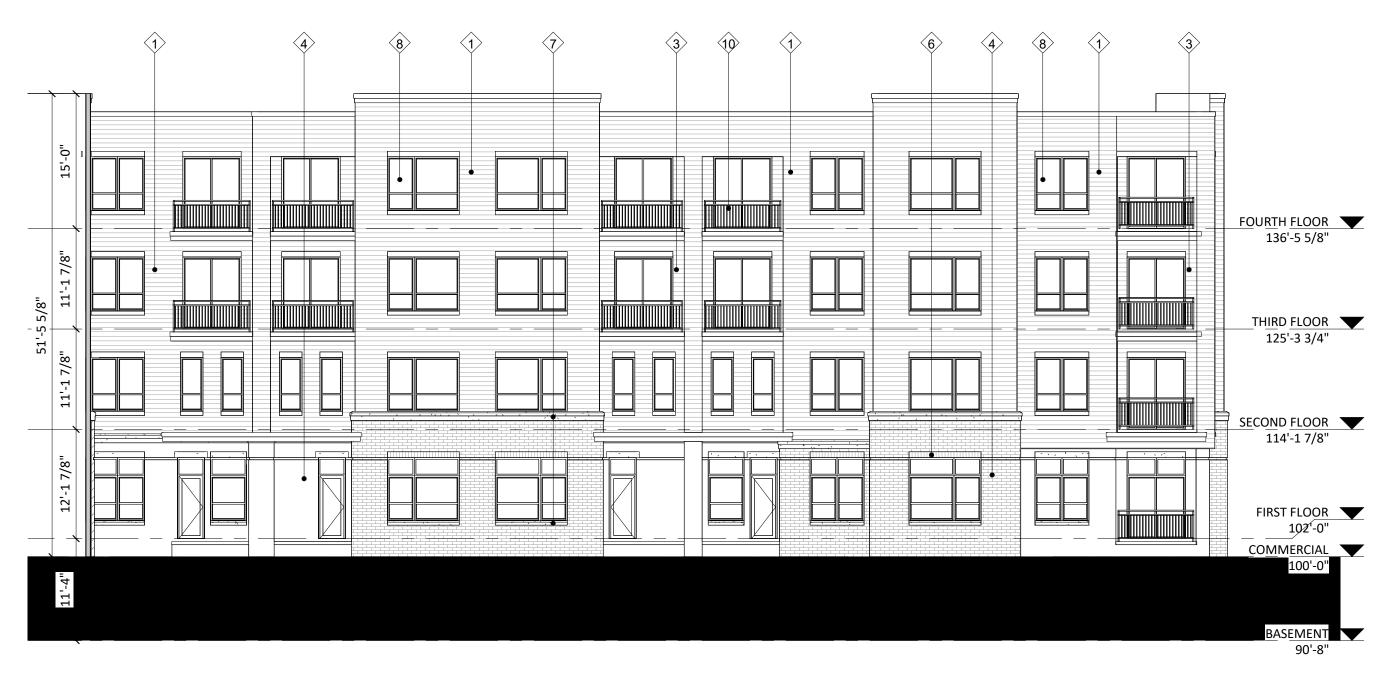

2 ELEVATION - WEST INTERIOR A203 3/32" = 1'-0"

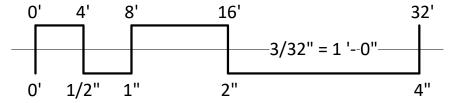

EXTERIOR MATERIAL SCHEDULE						
BUILDING ELEMENT	MANUFACTURER	COLOR	BUILDING ELEMENT	MANUFACTURER	COLOR	
(#1) - COMPOSITE LAP SIDING - 6"	LP SMARTSIDING	QUARRY GRAY	(#7) - CAST STONE BANDS & SILLS	ROCKCAST	CRYSTAL WHITE	
(#2) - METAL PANEL	PAC CLAD	CUSTOM - NAVY BLUE	(#8) - COMPOSITE WINDOWS	ANDERSEN 100	WHITE	
(#3) - COMPOSITE PANEL	LP SMARTSIDING	RUSTIC SERIES - OLD CHERRY	(#9) - ALUM. STOREFRONT	N/A	WHITE	
COMPOSITE TRIM	LP SMARTSIDING	MATCH ADJ. COLOR	CANOPY & BAY SOFFITS	LP SMARTSIDING	MATCH ADJ. TRIM	
(#4) - BRICK VENEER	INTERSTATE BRICK	ATLAS EMPEROR 4x4x16 - COAL	TREATED-EXPOSED DECK BEAMS	N/A	BROWN TREATED	
(#5) - STONE VENEER	ACME BRICK	MSTONE - WHITE QUARTZ SPLITFACE	(#10) - RAILING & HANDRAILS	SUPERIOR	BLACK	
(#6) - HEADERS - SOLDIER COURSE	INTERSTATE BRICK	ATLAS EMPEROR 4x4x16 - COAL				

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PROJECT TITLE

Northpointe Odana Rd.

123 FAKE ST. SUPER
CITY
STATE OF MIND
SHEET TITLE
EXTERIOR

ELEVATIONS

SHEET NUMBER

A203
PROJECT NUMBER 2233



1 COLORED ELEVATION - EAST 3/32" = 1'-0"

FURTH HORE TO SEE THE STATE OF THE PROPERTY OF

2 COLORED ELEVATION - WEST A204 3/32" = 1'-0"

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	• •		EXTERIOR MAT	ERIAL SCHEDULE		
BUILDING ELEMENT		MANUFACTURER	COLOR	BUILDING ELEMENT	MANUFACTURER	COLOR
(#1) - COMPOSITE LAP SIDING - 6"		LP SMARTSIDING	QUARRY GRAY	(#7) - CAST STONE BANDS & SILLS	ROCKCAST	CRYSTAL WHITE
(#2) - METAL PANEL		PAC CLAD	CUSTOM - NAVY BLUE	(#8) - COMPOSITE WINDOWS	ANDERSEN 100	WHITE
(#3) - COMPOSITE PANEL		LP SMARTSIDING	RUSTIC SERIES - OLD CHERRY	(#9) - ALUM. STOREFRONT	N/A	WHITE
COMPOSITE TRIM		LP SMARTSIDING	MATCH ADJ. COLOR	CANOPY & BAY SOFFITS	LP SMARTSIDING	MATCH ADJ. TRIM
(#4) - BRICK VENEER	• .	INTERSTATE BRICK	ATLAS EMPEROR 4x4x16 - COAL	TREATED-EXPOSED DECK BEAMS	N/A	BROWN TREATED
(#5) - STONE VENEER		ACME BRICK	MSTONE - WHITE QUARTZ SPLITFACE	(#10) - RAILING & HANDRAILS	SUPERIOR	BLACK
(#6) - HEADERS - SOLDIER COURSE		INTERSTATE BRICK	ATLAS EMPEROR 4x4x16 - COAL	· ·		

PROJECT TITLE

Northpointe

Odana Rd.

Middleton, WI 53562

608.836.3690

ISSUED

123 FAKE ST. SUPER CITY

CITY STATE OF MIND

SHEET TITLE

EXTERIOR

EXTERIOR ELEVATIONS COLORED

SHEET NUMBER

A204

PROJECT NUMBER 2233



1 COLORED ELEVATION - NORTH 3/32" = 1'-0"



2 COLORED ELEVATION - SOUTH A205 3/32" = 1'-0"

---3/32" = 1 '--0"----0' 1/2" 1"

	٠,		EXTERIOR MAT	ERIAL SCHEDULE		
BUILDING ELEMENT		MANUFACTURER	COLOR	BUILDING ELEMENT	MANUFACTURER	COLOR
(#1) - COMPOSITE LAP SIDING - 6"		LP SMARTSIDING	QUARRY GRAY	(#7) - CAST STONE BANDS & SILLS	ROCKCAST	CRYSTAL WHITE
(#2) - METAL PANEL		PAC CLAD	CUSTOM - NAVY BLUE	(#8) - COMPOSITE WINDOWS	ANDERSEN 100	WHITE
(#3) - COMPOSITE PANEL		LP SMARTSIDING	RUSTIC SERIES - OLD CHERRY	(#9) - ALUM. STOREFRONT	N/A	WHITE
COMPOSITE TRIM		LP SMARTSIDING	MATCH ADJ. COLOR	CANOPY & BAY SOFFITS	LP SMARTSIDING	MATCH ADJ. TRIM
(#4) - BRICK VENEER	· .	INTERSTATE BRICK	ATLAS EMPEROR 4x4x16 - COAL	TREATED-EXPOSED DECK BEAMS	N/A	BROWN TREATED
(#5) - STONE VENEER		ACME BRICK	MSTONE - WHITE QUARTZ SPLITFACE	(#10) - RAILING & HANDRAILS	SUPERIOR	BLACK
(#6) - HEADERS - SOLDIER COURSE		INTERSTATE BRICK	ATLAS EMPEROR 4x4x16 - COAL			

608.836.3690

ISSUED

Middleton, WI 53562

PROJECT TITLE Northpointe Odana Rd.

123 FAKE ST. SUPER CITY STATE OF MIND

SHEET TITLE

EXTERIOR ELEVATIONS COLORED


SHEET NUMBER

PROJECT NUMBER 2233





2 COLORED ELEVATION - WEST INTERIOR A206 3/32" = 1'-0"

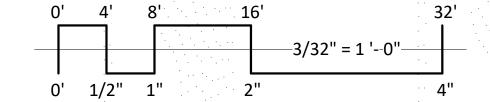

		EXTERIOR MAT			
BUILDING ELEMENT	MANUFACTURER	COLOR	BUILDING ELEMENT	MANUFACTURER	COLOR
(#1) - COMPOSITE LAP SIDING - 6"	LP SMARTSIDING	QUARRY GRAY	(#7) - CAST STONE BANDS & SILLS	ROCKCAST	CRYSTAL WHITE
(#2) - METAL PANEL	PAC CLAD	CUSTOM - NAVY BLUE	(#8) - COMPOSITE WINDOWS	ANDERSEN 100	WHITE
(#3) - COMPOSITE PANEL	LP SMARTSIDING	RUSTIC SERIES - OLD CHERRY	(#9) - ALUM. STOREFRONT	N/A	WHITE
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(#6) - HEADERS - SOLDIER COURSE	INTERSTATE BRICK	ATLAS EMPEROR 4x4x16 - COAL			

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Middleton, WI 53562

PROJECT TITLE Northpointe Odana Rd.

123 FAKE ST. SUPER CITY

STATE OF MIND

SHEET TITLE **EXTERIOR ELEVATIONS**

COLORED

SHEET NUMBER

PROJECT NUMBER 2233















LOOKING EAST

knothe bruce