

# ALL METALS RECYCLING - ALL METELS RECYLCING CENTER

5651 TRADESMAN DRIVE, MADISON WI, 53718



OIVIE, TIME ACCESS, EMIDOCAI E, DIVAVIIIO				
SHEET NUMBER	SHEET NAME			
C200	SITE PLAN OVERALL			
C201	SITE PLAN - NORTH DETAIL			
C202	SITE PLAN - SOUTH DETAIL			
C300	GRADING AND EROSION CONTROL - OVER			
C301	GRADING AND EROSION CONTROL - NORT			
C302	GRADING AND EROSION CONTROL - SOUT			
C400	UTILITY PLAN - OVERALL			
C401	UTILITY PLAN - NORTH DETAIL			
C402	UTILITY PLAN - SOUTH DETAIL			
EXH1	FIRE ACCESS PLAN			
L100	OVERALL LANDSCAPE PLAN			
L101	NORTH LANDSCAPE PLAN			
L102	SOUTH WEST LANDSCAPE PLAN			
L103	SOUTH EAST LANDSCAPE PLAN			
L104	LANDSCAPE DETAILS			

## ARCHITECTURAL DRAWINGS

SHEET NUMBER	SHEET NAME
A002	SITE GEOMETRY PLAN
A101	FLOOR PLANS
A201	EXTERIOR ELEVATIONS


1 | 2 | 3 | 4 | 5 | 6 | 7 | 8 | 9 | 10 | 11 | 12 | 13 | 14 | 15 | 16 | 17 | 18 | 19 | 20


www.opnarchitects.com All reports, plans, specifications, computer files, field data,

ALL METALS RECYCLING 1802 S. PARK STREET

ALL METALS RECYCLING CENTER 5651 TRADESMEN DRIVE

301 N Broom St., Suite 100

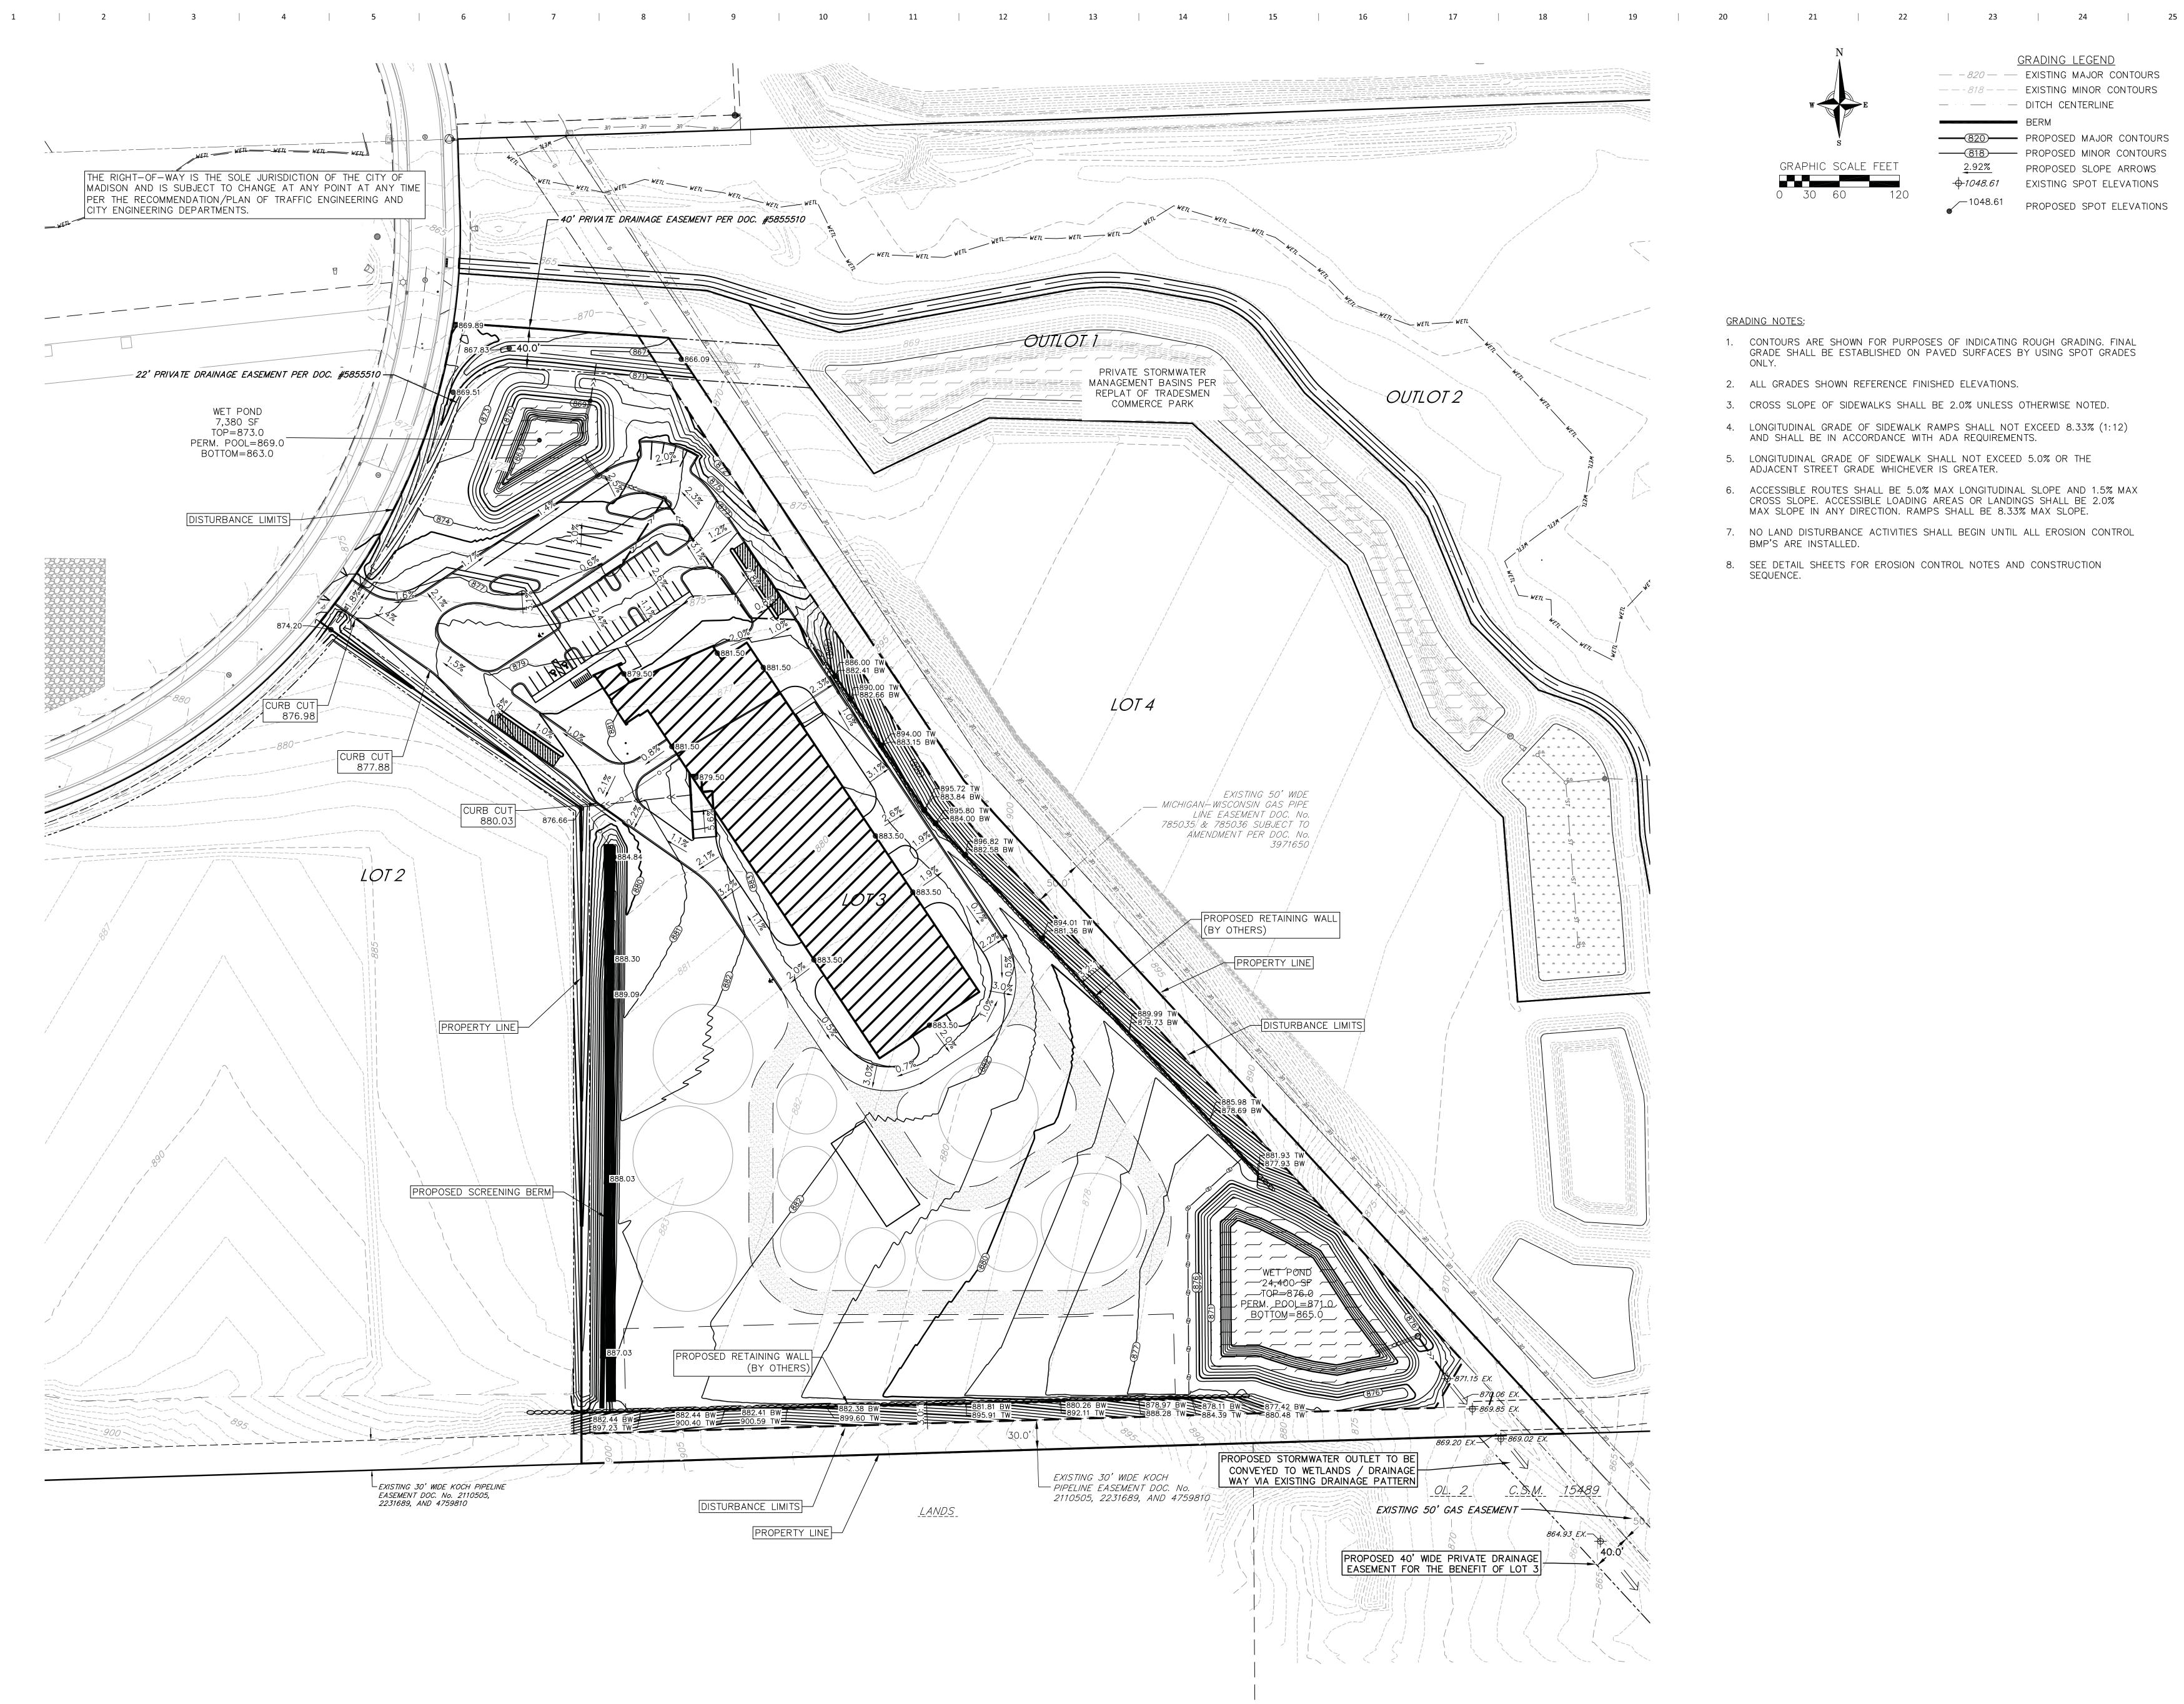

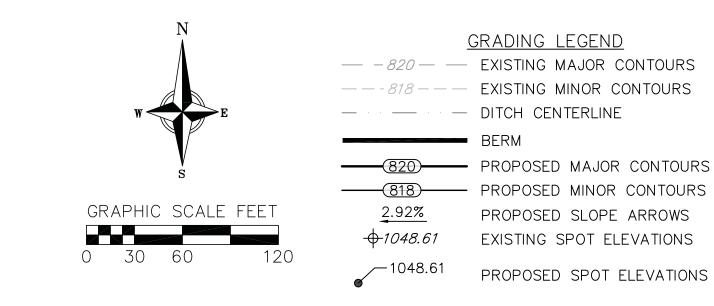

#### **GRADING NOTES:**

- 1. CONTOURS ARE SHOWN FOR PURPOSES OF INDICATING ROUGH GRADING. FINAL GRADE SHALL BE ESTABLISHED ON PAVED SURFACES BY USING SPOT GRADES
- 2. ALL GRADES SHOWN REFERENCE FINISHED ELEVATIONS.
- 3. CROSS SLOPE OF SIDEWALKS SHALL BE 2.0% UNLESS OTHERWISE NOTED.
- 4. LONGITUDINAL GRADE OF SIDEWALK RAMPS SHALL NOT EXCEED 8.33% (1:12) AND SHALL BE IN ACCORDANCE WITH ADA REQUIREMENTS.
- 5. LONGITUDINAL GRADE OF SIDEWALK SHALL NOT EXCEED 5.0% OR THE ADJACENT STREET GRADE WHICHEVER IS GREATER.
- 6. ACCESSIBLE ROUTES SHALL BE 5.0% MAX LONGITUDINAL SLOPE AND 1.5% MAX CROSS SLOPE. ACCESSIBLE LOADING AREAS OR LANDINGS SHALL BE 2.0% MAX SLOPE IN ANY DIRECTION. RAMPS SHALL BE 8.33% MAX SLOPE.
- 7. NO LAND DISTURBANCE ACTIVITIES SHALL BEGIN UNTIL ALL EROSION CONTROL BMP'S ARE INSTALLED.
- 8. SEE DETAIL SHEETS FOR EROSION CONTROL NOTES AND CONSTRUCTION SEQUENCE.

301 N Broom St., Suite 100 Madison, WI 53703 P: 608-819-0260 www.opnarchitects.com

All reports, plans, specifications, computer files, field data, OPN Architects, Inc. as instruments of service shall remain the property of OPN Architects, Inc. OPN Architects, Inc. shall retain all common law, statutory and other reserved rights, including the copyright thereto. © 2022 OPN Architects, Inc.

ALL METALS RECYCLING 1802 S PARK ST MADISON, WI 53713

**ALL METALS RECYCLING CENTER** 5651 Tradesmen Drive Madison, WI 53718

General Contractor

**Contractor Name** 

Civil Engineer VIERBICHER

MADISON, WI 53717

Structural Engineer

**Contractor Name** 

999 FOURIER DR # 201

Mechanical Engineer **Contractor Name** 

**Contractor Name** 


22637000

Sheet Name **GRADING AND EROSION CONTROL - OVERALL** 

PRELIMINARY. NOT FOR CONSTRUCTION.



1 | 2 | 3 | 4 | 5 | 6 | 7 | 8 | 9 | 10 | 11 | 12 | 13 | 14 | 15 | 16 | 21 | 22 | 23 | 24 | 25

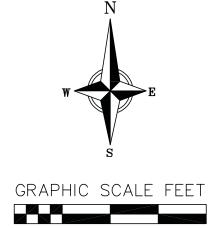

GRADING LEGEND — −820 — EXISTING MAJOR CONTOURS --818--- EXISTING MINOR CONTOURS — DITCH CENTERLINE PROPOSED SLOPE ARROWS <del>-</del>0-1048.61 EXISTING SPOT ELEVATIONS

### **GRADING NOTES:**

1. CONTOURS ARE SHOWN FOR PURPOSES OF INDICATING ROUGH GRADING. FINAL GRADE SHALL BE ESTABLISHED ON PAVED SURFACES BY USING SPOT GRADES ONLY.

PROPOSED SPOT ELEVATIONS

- 2. ALL GRADES SHOWN REFERENCE FINISHED ELEVATIONS.
- 3. CROSS SLOPE OF SIDEWALKS SHALL BE 2.0% UNLESS OTHERWISE NOTED.
- 4. LONGITUDINAL GRADE OF SIDEWALK RAMPS SHALL NOT EXCEED 8.33% (1:12) AND SHALL BE IN ACCORDANCE WITH ADA REQUIREMENTS.
- 5. LONGITUDINAL GRADE OF SIDEWALK SHALL NOT EXCEED 5.0% OR THE ADJACENT STREET GRADE WHICHEVER IS GREATER.
- 6. ACCESSIBLE ROUTES SHALL BE 5.0% MAX LONGITUDINAL SLOPE AND 1.5% MAX CROSS SLOPE. ACCESSIBLE LOADING AREAS OR LANDINGS SHALL BE 2.0% MAX SLOPE IN ANY DIRECTION. RAMPS SHALL BE 8.33% MAX SLOPE.
- 7. NO LAND DISTURBANCE ACTIVITIES SHALL BEGIN UNTIL ALL EROSION CONTROL BMP'S ARE INSTALLED.
- 8. SEE DETAIL SHEETS FOR EROSION CONTROL NOTES AND CONSTRUCTION SEQUENCE.

301 N Broom St., Suite 100 Madison, WI 53703

P: 608-819-0260 www.opnarchitects.com All reports, plans, specifications, computer files, field data,

OPN Architects, Inc. as instruments of service shall remain the property of OPN Architects, Inc. OPN Architects, Inc. shall retain all common law, statutory and other reserved rights, including the copyright thereto. © 2022 OPN Architects, Inc.

> 1802 S PARK ST MADISON, WI 53713

ALL METALS RECYCLING

ALL METALS RECYCLING CENTER 5651 Tradesmen Drive Madison, WI 53718

General Contractor **Contractor Name** 

Civil Engineer **VIERBICHER** 999 FOURIER DR # 201 MADISON, WI 53717

Structural Engineer **Contractor Name** 

Mechanical Engineer

Electrical Engineer **Contractor Name** 

**Contractor Name** 

22637000

PRELIMINARY. NOT FOR CONSTRUCTION.

301 N Broom St., Suite 100 Madison, WI 53703 P: 608-819-0260

GRADING LEGEND

— −820 — EXISTING MAJOR CONTOURS

--818--- Existing minor contours

+1048.61 EXISTING SPOT ELEVATIONS

PROPOSED SLOPE ARROWS

PROPOSED SPOT ELEVATIONS

— — — DITCH CENTERLINE

GRAPHIC SCALE FEET

www.opnarchitects.com All reports, plans, specifications, computer files, field data, notes and other documents and instruments prepared by OPN Architects, Inc. as instruments of service shall remain the property of OPN Architects, Inc. OPN Architects, Inc. shall retain all common law, statutory and other reserved

rights, including the copyright thereto. © 2022 OPN Architects, Inc. ALL METALS RECYCLING

ALL METALS RECYCLING CENTER 5651 Tradesmen Drive Madison, WI 53718

General Contractor **Contractor Name** 

1802 S PARK ST MADISON, WI 53713

Civil Engineer VIERBICHER 999 FOURIER DR # 201 MADISON, WI 53717

**Contractor Name** 

Structural Engineer

Mechanical Engineer

Electrical Engineer **Contractor Name** 


**Contractor Name** 

22637000

REVIEW Sheet Name

PRELIMINARY. NOT FOR CONSTRUCTION.

CONTROL
Sheet Number

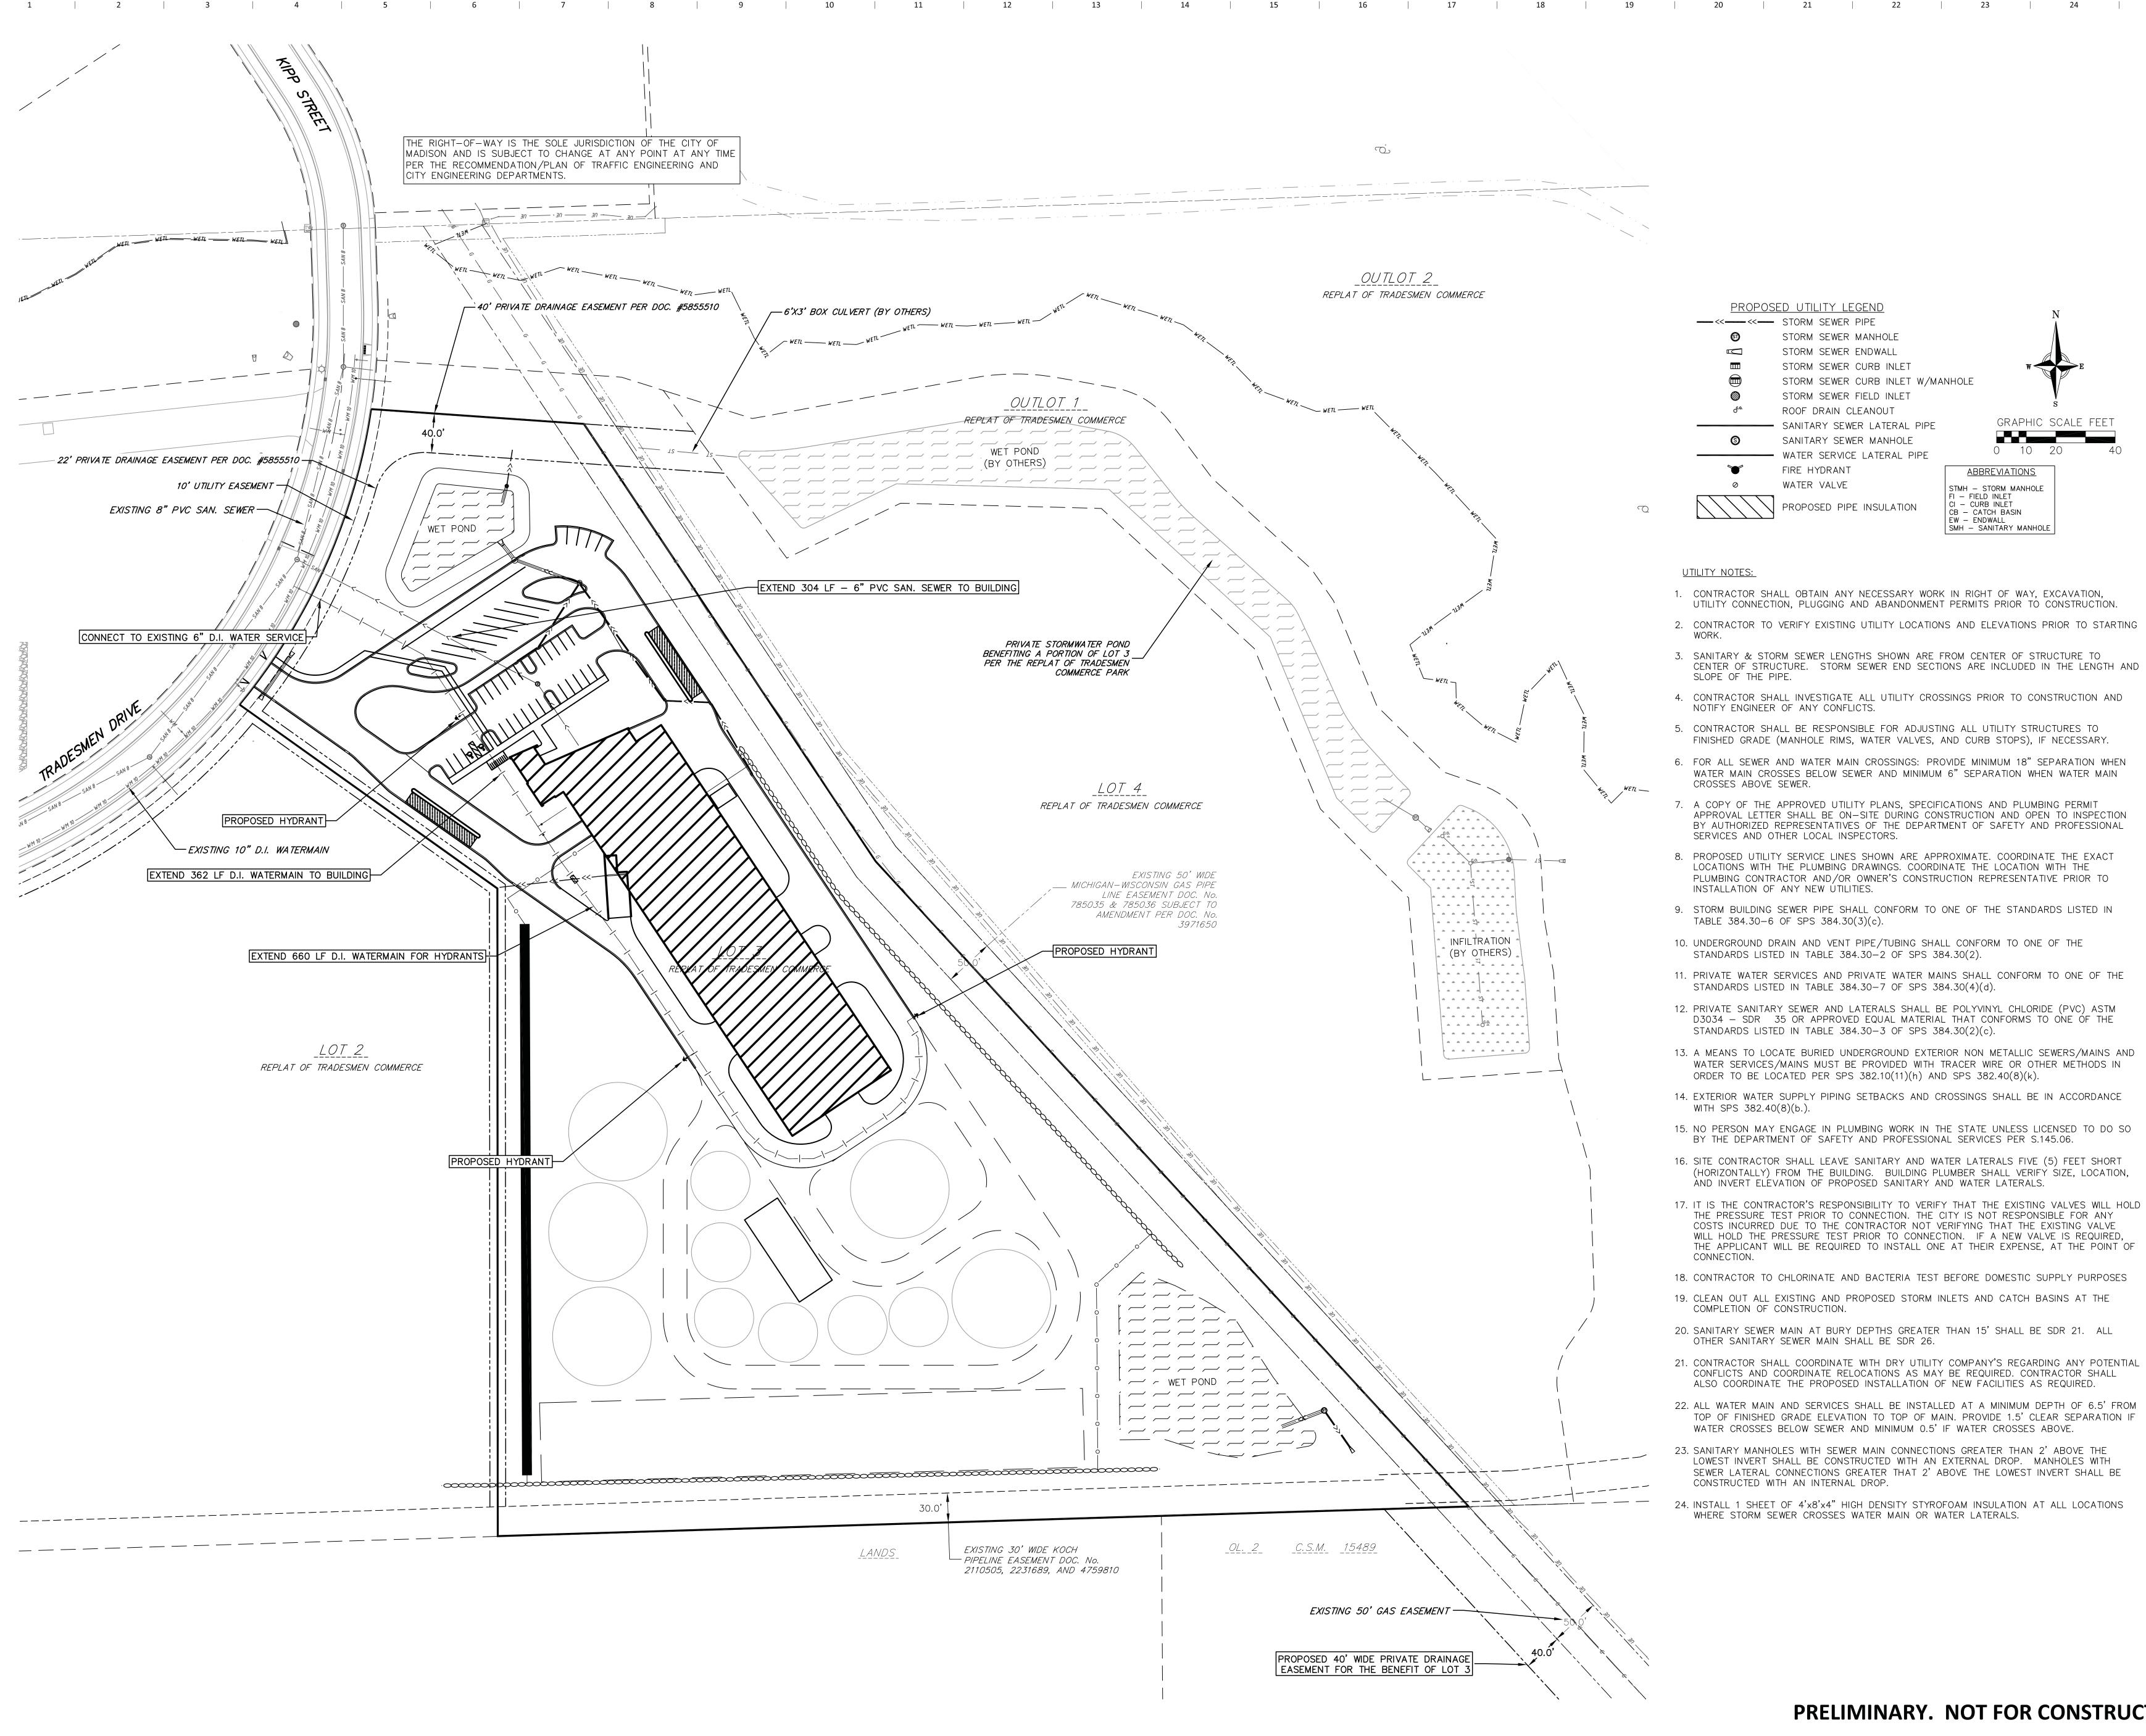

1 | 2 | 3 | 4 | 5 | 6 | 7 | 8 | 9 | 10 | 11 | 12 | 13 | 14 | 15 | 16 | 21 | 22 | 23 | 24 | 25

301 N Broom St., Suite 100 Madison, WI 53703 P: 608-819-0260 www.opnarchitects.com

notes and other documents and instruments prepared by OPN Architects, Inc. as instruments of service shall remain the property of OPN Architects, Inc. OPN Architects, Inc. shall retain all common law, statutory and other reserved rights, including the copyright thereto. © 2022 OPN Architects, Inc.

> **ALL METALS RECYCLING** 1802 S. PARK STREET MADISON, WI 53713

ALL METALS RECYCLING CENTER 5651 TRADESMEN DRIVE MADISON, WI 53718

General Contractor

Contractor Name

Civil Engineer VIERBICHER 999 FOURIER DR # 201

GRAPHIC SCALE FEET

**ABBREVIATIONS** 

SMH - SANITARY MANHOLE

STMH - STORM MANHOLE FI — FIELD INLET

CI - CURB INLET

EW — ENDWALL

CB - CATCH BASIN

Structural Engineer

MADISON, WI 53717

Mechanical Engineer Contractor Name

Contractor Name

Contractor Name


22637000

Sheet Issue Date

REVIEW Sheet Name **UTILITY PLAN -**

OVERALL

PRELIMINARY. NOT FOR CONSTRUCTION.

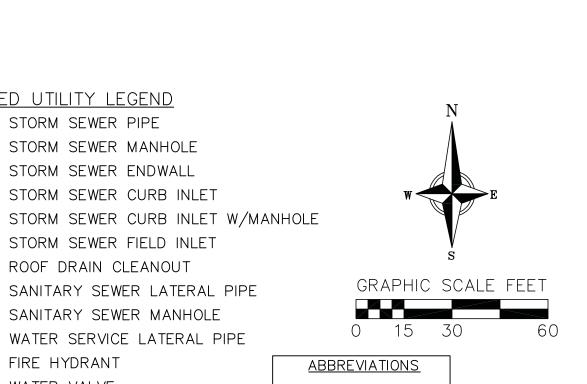

STMH - STORM MANHOLE

SMH - SANITARY MANHOLE

FI — FIELD INLET
CI — CURB INLET

CB - CATCH BASIN EW - ENDWALL

#### **UTILITY NOTES:**

1. CONTRACTOR SHALL OBTAIN ANY NECESSARY WORK IN RIGHT OF WAY, EXCAVATION, UTILITY CONNECTION, PLUGGING AND ABANDONMENT PERMITS PRIOR TO CONSTRUCTION.

PROPOSED UTILITY LEGEND

STORM SEWER MANHOLE

STORM SEWER ENDWALL

STORM SEWER CURB INLET

STORM SEWER FIELD INLET

ROOF DRAIN CLEANOUT

FIRE HYDRANT

WATER VALVE

- CONTRACTOR TO VERIFY EXISTING UTILITY LOCATIONS AND ELEVATIONS PRIOR TO STARTING
- 3. SANITARY & STORM SEWER LENGTHS SHOWN ARE FROM CENTER OF STRUCTURE TO
- CENTER OF STRUCTURE. STORM SEWER END SECTIONS ARE INCLUDED IN THE LENGTH AND SLOPE OF THE PIPE. 4. CONTRACTOR SHALL INVESTIGATE ALL UTILITY CROSSINGS PRIOR TO CONSTRUCTION AND
- NOTIFY ENGINEER OF ANY CONFLICTS.
- 5. CONTRACTOR SHALL BE RESPONSIBLE FOR ADJUSTING ALL UTILITY STRUCTURES TO FINISHED GRADE (MANHOLE RIMS, WATER VALVES, AND CURB STOPS), IF NECESSARY.
- 6. FOR ALL SEWER AND WATER MAIN CROSSINGS: PROVIDE MINIMUM 18" SEPARATION WHEN WATER MAIN CROSSES BELOW SEWER AND MINIMUM 6" SEPARATION WHEN WATER MAIN
- CROSSES ABOVE SEWER. 7. A COPY OF THE APPROVED UTILITY PLANS, SPECIFICATIONS AND PLUMBING PERMIT
- APPROVAL LETTER SHALL BE ON-SITE DURING CONSTRUCTION AND OPEN TO INSPECTION BY AUTHORIZED REPRESENTATIVES OF THE DEPARTMENT OF SAFETY AND PROFESSIONAL SERVICES AND OTHER LOCAL INSPECTORS.
- 8. PROPOSED UTILITY SERVICE LINES SHOWN ARE APPROXIMATE. COORDINATE THE EXACT LOCATIONS WITH THE PLUMBING DRAWINGS. COORDINATE THE LOCATION WITH THE PLUMBING CONTRACTOR AND/OR OWNER'S CONSTRUCTION REPRESENTATIVE PRIOR TO INSTALLATION OF ANY NEW UTILITIES.
- 9. STORM BUILDING SEWER PIPE SHALL CONFORM TO ONE OF THE STANDARDS LISTED IN
- 10. UNDERGROUND DRAIN AND VENT PIPE/TUBING SHALL CONFORM TO ONE OF THE STANDARDS LISTED IN TABLE 384.30-2 OF SPS 384.30(2).
- 11. PRIVATE WATER SERVICES AND PRIVATE WATER MAINS SHALL CONFORM TO ONE OF THE
- STANDARDS LISTED IN TABLE 384.30-7 OF SPS 384.30(4)(d).
- D3034 SDR 35 OR APPROVED EQUAL MATERIAL THAT CONFORMS TO ONE OF THE STANDARDS LISTED IN TABLE 384.30-3 OF SPS 384.30(2)(c).
- 13. A MEANS TO LOCATE BURIED UNDERGROUND EXTERIOR NON METALLIC SEWERS/MAINS AND WATER SERVICES/MAINS MUST BE PROVIDED WITH TRACER WIRE OR OTHER METHODS IN ORDER TO BE LOCATED PER SPS 382.10(11)(h) AND SPS 382.40(8)(k).
- 14. EXTERIOR WATER SUPPLY PIPING SETBACKS AND CROSSINGS SHALL BE IN ACCORDANCE WITH SPS 382.40(8)(b.).
- 15. NO PERSON MAY ENGAGE IN PLUMBING WORK IN THE STATE UNLESS LICENSED TO DO SO BY THE DEPARTMENT OF SAFETY AND PROFESSIONAL SERVICES PER S.145.06.
- 16. SITE CONTRACTOR SHALL LEAVE SANITARY AND WATER LATERALS FIVE (5) FEET SHORT (HORIZONTALLY) FROM THE BUILDING. BUILDING PLUMBER SHALL VERIFY SIZE, LOCATION, ÀND INVERT ELÉVATION OF PROPOSED SANITARY AND WATER LATERALS.
- 17. IT IS THE CONTRACTOR'S RESPONSIBILITY TO VERIFY THAT THE EXISTING VALVES WILL HOLD THE PRESSURE TEST PRIOR TO CONNECTION. THE CITY IS NOT RESPONSIBLE FOR ANY COSTS INCURRED DUE TO THE CONTRACTOR NOT VERIFYING THAT THE EXISTING VALVE WILL HOLD THE PRESSURE TEST PRIOR TO CONNECTION. IF A NEW VALVE IS REQUIRED, THE APPLICANT WILL BE REQUIRED TO INSTALL ONE AT THEIR EXPENSE, AT THE POINT OF
- 18. CONTRACTOR TO CHLORINATE AND BACTERIA TEST BEFORE DOMESTIC SUPPLY PURPOSES
- 19. CLEAN OUT ALL EXISTING AND PROPOSED STORM INLETS AND CATCH BASINS AT THE COMPLETION OF CONSTRUCTION.
- 20. SANITARY SEWER MAIN AT BURY DEPTHS GREATER THAN 15' SHALL BE SDR 21. ALL
- 21. CONTRACTOR SHALL COORDINATE WITH DRY UTILITY COMPANY'S REGARDING ANY POTENTIAL CONFLICTS AND COORDINATE RELOCATIONS AS MAY BE REQUIRED. CONTRACTOR SHALL
- 22. ALL WATER MAIN AND SERVICES SHALL BE INSTALLED AT A MINIMUM DEPTH OF 6.5' FROM TOP OF FINISHED GRADE ELEVATION TO TOP OF MAIN. PROVIDE 1.5' CLEAR SEPARATION IF WATER CROSSES BELOW SEWER AND MINIMUM 0.5' IF WATER CROSSES ABOVE.
- 23. SANITARY MANHOLES WITH SEWER MAIN CONNECTIONS GREATER THAN 2' ABOVE THE LOWEST INVERT SHALL BE CONSTRUCTED WITH AN EXTERNAL DROP. MANHOLES WITH SEWER LATERAL CONNECTIONS GREATER THAT 2' ABOVE THE LOWEST INVERT SHALL BE
- 24. INSTALL 1 SHEET OF 4'x8'x4" HIGH DENSITY STYROFOAM INSULATION AT ALL LOCATIONS WHERE STORM SEWER CROSSES WATER MAIN OR WATER LATERALS.

PRELIMINARY. NOT FOR CONSTRUCTION.

301 N Broom St., Suite 100 Madison, WI 53703 P: 608-819-0260 www.opnarchitects.com

notes and other documents and instruments prepared by OPN Architects, Inc. as instruments of service shall remain the property of OPN Architects, Inc. OPN Architects, Inc. shall retain all common law, statutory and other reserved rights, including the copyright thereto. © 2022 OPN Architects, Inc.

**ALL METALS RECYCLING** 1802 S. PARK STREET MADISON, WI 53713

ALL METALS RECYCLING CENTER 5651 TRADESMEN DRIVE MADISON, WI 53718

General Contractor

Contractor Name

Civil Engineer VIERBICHER

MADISON, WI 53717

999 FOURIER DR # 201

Contractor Name

Structural Engineer


Mechanical Engineer Contractor Name

Contractor Name

22637000

Sheet Issue Date REVIEW Sheet Name

> **UTILITY PLAN -NORTH DETAIL**

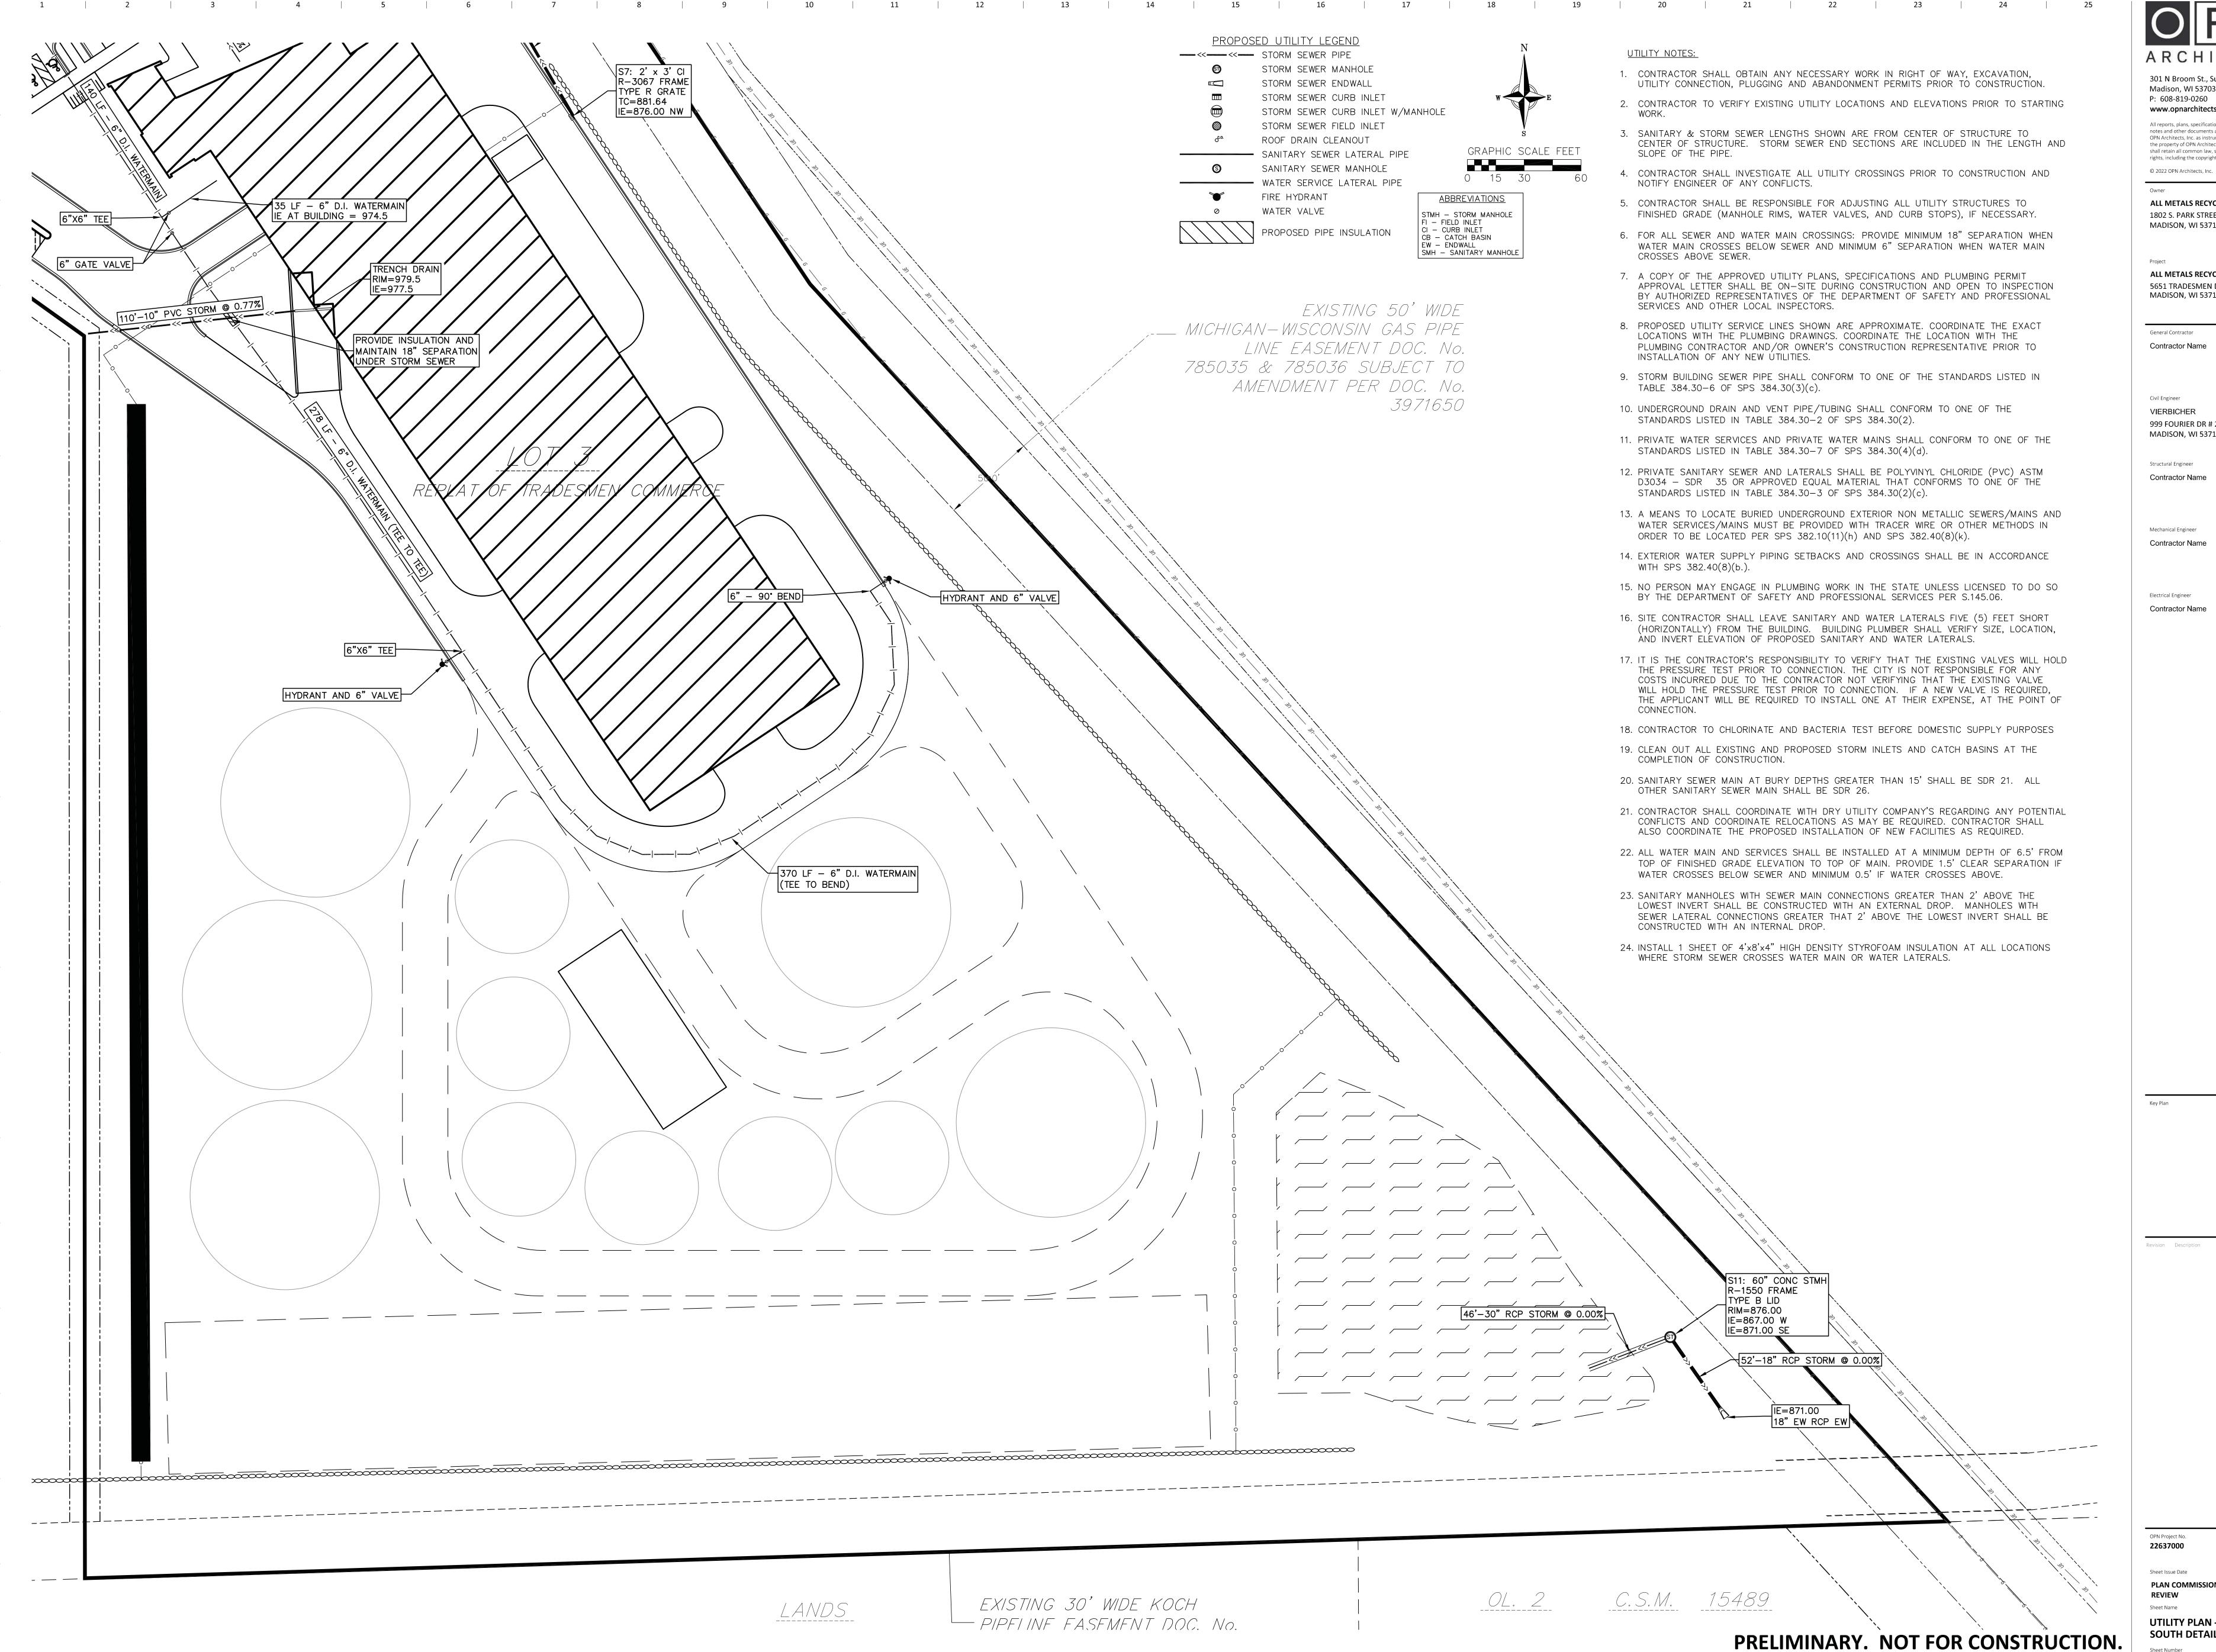

1 2 3 4 5 6 7 8 9 10 11 12 13 14 15 16 22 23 23 24

301 N Broom St., Suite 100 Madison, WI 53703 P: 608-819-0260

www.opnarchitects.com All reports, plans, specifications, computer files, field data, notes and other documents and instruments prepared by OPN Architects, Inc. as instruments of service shall remain the property of OPN Architects, Inc. OPN Architects, Inc. shall retain all common law, statutory and other reserved

**ALL METALS RECYCLING** 1802 S. PARK STREET MADISON, WI 53713

rights, including the copyright thereto.

ALL METALS RECYCLING CENTER 5651 TRADESMEN DRIVE MADISON, WI 53718

General Contractor

Contractor Name

Civil Engineer VIERBICHER 999 FOURIER DR # 201

Structural Engineer Contractor Name

MADISON, WI 53717

Mechanical Engineer Contractor Name

Electrical Engineer Contractor Name

REVIEW

Sheet Name **UTILITY PLAN -SOUTH DETAIL** 

1 | 2 | 3 | 4 | 5 | 6 | 7 | 8 | 9 | 10 | 11 | 12 | 13 | 14 | 25

301 N Broom St., Suite 100 Madison, WI 53703 P: 608-819-0260 www.opnarchitects.com

All reports, plans, specifications, computer files, field data, notes and other documents and instruments prepared by OPN Architects, Inc. as instruments of service shall remain the property of OPN Architects, Inc. OPN Architects, Inc. shall retain all common law, statutory and other reserved rights, including the copyright thereto. © 2022 OPN Architects, Inc.

ALL METALS RECYCLING 1802 S. PARK STREET MADISON, WI 53713

ALL METALS RECYCLING CENTER 5651 TRADESMEN DRIVE MADISON, WI 53718

General Contractor

Contractor Name

VIERBICHER 999 FOURIER DR # 201

Structural Engineer Contractor Name

Mechanical Engineer

Contractor Name

FIRE ACCESS

EXH1

301 N Broom St., Suite 100 Madison, WI 53703 P: 608-819-0260 www.opnarchitects.com

All reports, plans, specifications, computer files, field data, OPN Architects, Inc. as instruments of service shall remain the property of OPN Architects, Inc. OPN Architects, Inc. shall retain all common law, statutory and other reserved rights, including the copyright thereto. © 2022 OPN Architects, Inc.

ALL METALS RECYCLING 1802 S. PARK ST MADISON, WI 53713

> ALL METALS RECYCLING CENTER 5651 TRADESMEN DRIVE MADISON, WI 53718

General Contractor Contractor Name

Civil Engineer VIERBICHER

999 FOURIER DR # 201

MADISON, WI 53717

Structural Engineer Contractor Name

Mechanical Engineer Contractor Name

Electrical Engineer

Contractor Name

22637000

Overall Landscape Plan

L100

PRELIMINARY. NOT FOR CONSTRUCTION.



1 | 2 | 3 | 4 | 5 | 6 | 7 | 8 | 9 | 10 | 11 | 12 | 13 | 24 | 25

OPN

301 N Broom St., Suite 100 Madison, WI 53703

P: 608-819-0260

www.opnarchitects.com

All reports, plans, specifications, computer files, field data, notes and other documents and instruments prepared by OPN Architects, Inc. as instruments of service shall remain the property of OPN Architects, Inc. OPN Architects, Inc. shall retain all common law, statutory and other reserved rights including the services that the services that the services that the services the services that the serv

rights, including the copyright thereto.
© 2022 OPN Architects, Inc.

Owner

ALL METALS RECYCLING

1802 S. PARK ST MADISON, WI 53713

Project

ALL METALS RECYCLING CENTER
5651 TRADESMEN DRIVE

General Contractor

Contractor Name

MADISON, WI 53718

Civil Engineer
VIERBICHER
999 FOURIER DR # 201
MADISON, WI 53717

Structural Engineer

Contractor Name

Mechanical Engineer

Contractor Name

Electrical Engineer

Contractor Name

22637000

Sheet Issue Date

PLAN COMMISSION 10/1

REVIEW


Sheet Name

North Landscape Plan

L101

PRELIMINARY. NOT FOR CONSTRUCTION.

Sheet Number

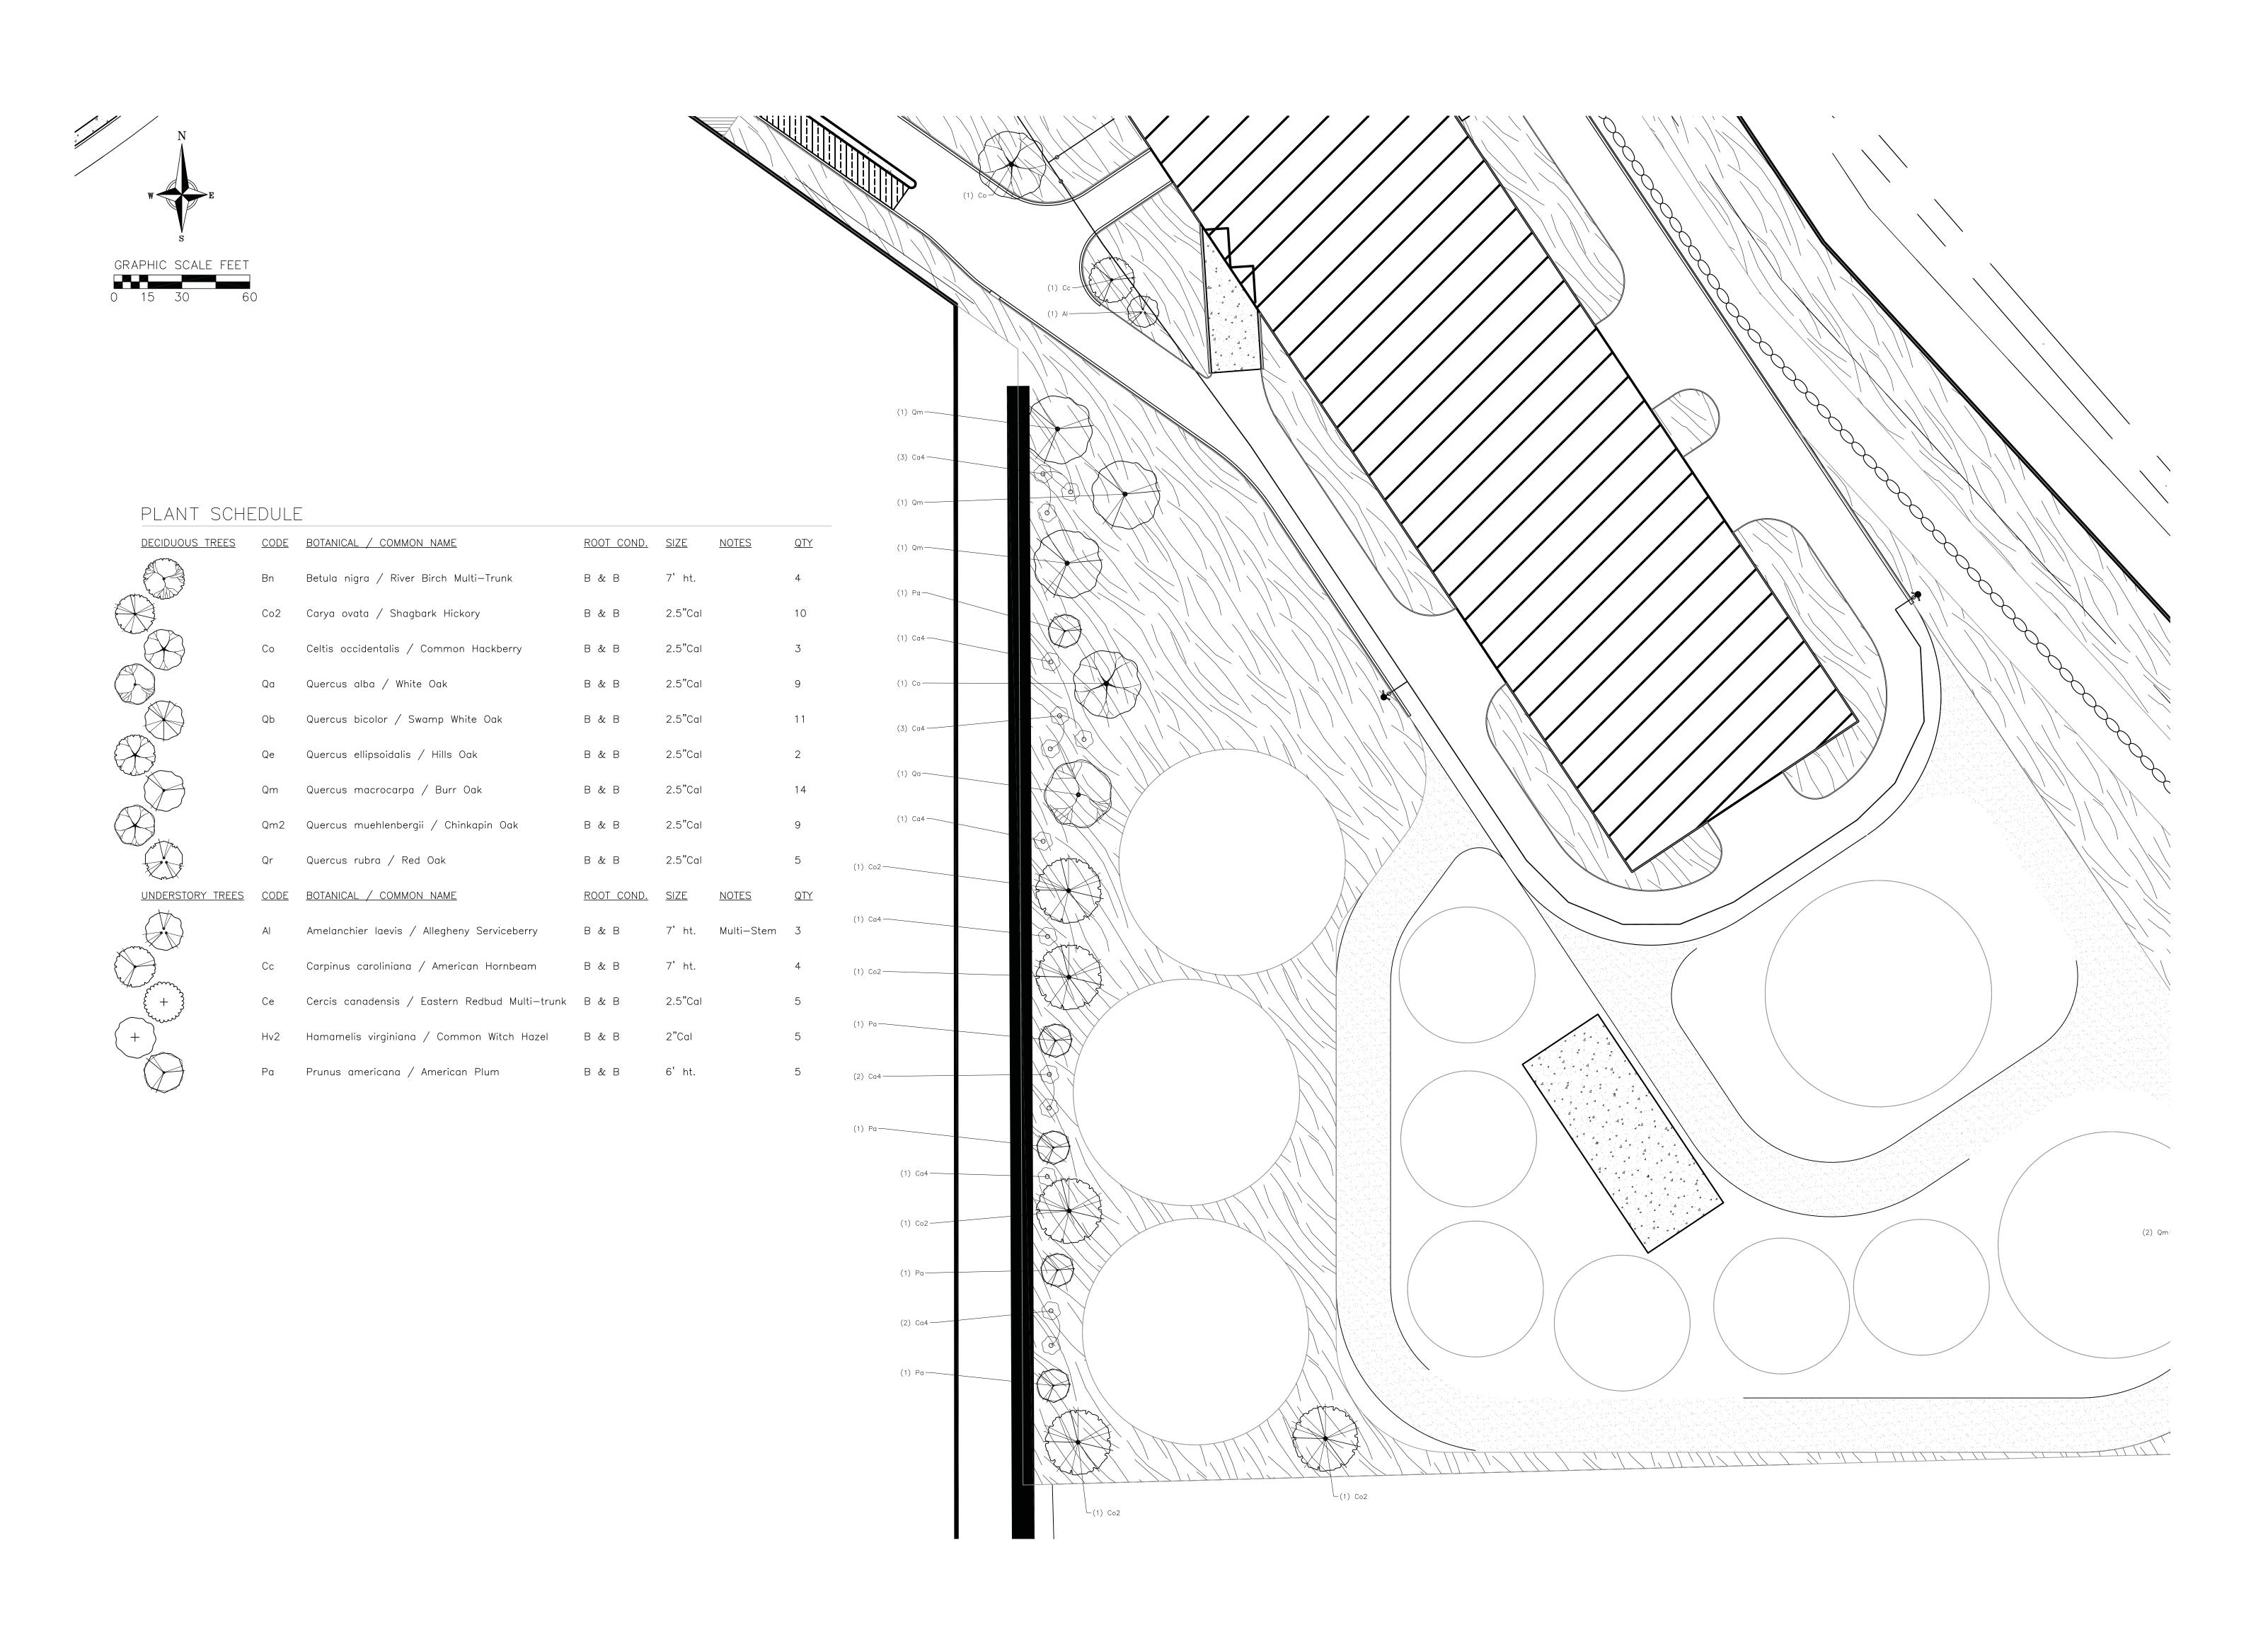

301 N Broom St., Suite 100 Madison, WI 53703 P: 608-819-0260

www.opnarchitects.com

All reports, plans, specifications, computer files, field data, OPN Architects, Inc. as instruments of service shall remain the property of OPN Architects, Inc. OPN Architects, Inc. shall retain all common law, statutory and other reserved rights, including the copyright thereto. © 2022 OPN Architects, Inc.

ALL METALS RECYCLING 1802 S. PARK ST MADISON, WI 53713

> ALL METALS RECYCLING CENTER 5651 TRADESMEN DRIVE MADISON, WI 53718

General Contractor Contractor Name

Civil Engineer

VIERBICHER 999 FOURIER DR # 201 MADISON, WI 53717

Structural Engineer Contractor Name

Mechanical Engineer Contractor Name

Electrical Engineer Contractor Name

22637000

South West Landscape Plan

L102

PRELIMINARY. NOT FOR CONSTRUCTION.

Sheet Number

1 | 2 | 3 | 4 | 5 | 6 | 7 | 8 | 9 | 10 | 11 | 12 | 13 | 14 | 15 | 21 | 22 | 23 | 24 | 25 |

OPN

301 N Broom St., Suite 100 Madison, WI 53703 P: 608-819-0260

All reports, plans, specifications, computer files, field data, notes and other documents and instruments prepared by OPN Architects, Inc. as instruments of service shall remain the property of OPN Architects, Inc. OPN Architects, Inc. shall retain all common law, statutory and other reserved rights, including the copyright thereto.

Owner

ALL METALS RECYCLING

1802 S. PARK ST

© 2022 OPN Architects, Inc.

MADISON, WI 53713

5651 TRADESMEN DRIVE MADISON, WI 53718

ALL METALS RECYCLING CENTER

General Contractor

Contractor Name

Civil Engineer

VIERBICHER 999 FOURIER DR # 201 MADISON, WI 53717

Structural Engineer

Contractor Name

Contractor Name

Mechanical Engineer

Electrical Engineer

Contractor Name

\_\_\_

Revision Description

**22637000** 

Sheet Issue Date
PLAN COMMISSION
REVIEW


South East Landscape Plan

Number

PRELIMINARY. NOT FOR CONSTRUCTION.

Sheet Number

L103

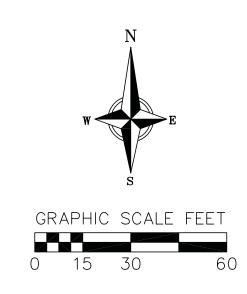

PLANT SCHEDULE

DECIDUOUS TREES	BOTANICAL / COMMON NAME	ROOT COND.	<u>SIZE</u>	<u>NOTES</u>	<u>QTY</u>
Bn	Betula nigra / River Birch Multi-Trunk	B & B	7' ht.	<u></u>	4
Co2	Carya ovata / Shagbark Hickory	B & B	2.5"Cal		10
Со	Celtis occidentalis / Common Hackberry	В & В	2.5"Cal		3
Qa	Quercus alba / White Oak	B & B	2.5"Cal		9
Qb	Quercus bicolor / Swamp White Oak	B & B	2.5"Cal		11
Qe	Quercus ellipsoidalis / Hills Oak	B & B	2.5"Cal		2
Qm	Quercus macrocarpa / Burr Oak	B & B	2.5"Cal		13
Qm2	Quercus muehlenbergii / Chinkapin Oak	B & B	2.5"Cal		9
Qr	Quercus rubra / Red Oak	B & B	2.5"Cal		4
<u>UNDERSTORY TREES</u>	BOTANICAL / COMMON NAME	ROOT COND.	SIZE	NOTES	<u>QTY</u>
Al	Amelanchier laevis / Allegheny Serviceberry	B & B	7' ht.	Multi-Stem	3
Сс	Carpinus caroliniana / American Hornbeam	B & B	7' ht.		4
Ce	Cercis canadensis / Eastern Redbud Multi-trunk	B & B	2.5"Cal		5
Hv2	Hamamelis virginiana / Common Witch Hazel	B & B	2"Cal		5
Pa	Prunus americana / American Plum	B & B	6' ht.		5
<u>SHRUBS</u>	BOTANICAL / COMMON NAME	ROOT COND.	<u>SIZE</u>	<u>NOTES</u>	QTY
Ar2	Alnus rugosa / Speckled Alder	B & B	<u>5' h</u> t.	110120	8
Ca	Ceanothus americanus / New Jersey Tea	Cont.	3 Gal.		41
Co3	Cephalanthus occidentalis / Buttonbush	Cont.	5 Gal.		28
Ca4	Corylus americana / American Hazelnut	В & В	4' ht.		14
VI	Viburnum lentago / Nannyberry	B & B	7' ht.		10
Vb	Viburnum prunifolium / Blackhaw Viburnum	Cont.	5 Gal.		6
<u>PERENNIALS</u>	BOTANICAL / COMMON NAME	ROOT COND.	<u>SIZE</u>	<u>NOTES</u>	<u>QTY</u>
At	Asclepias tuberosa / Butterfly Milkweed	Cont.	<u>0,22</u> 1 Gal.	110120	38
Av	Asclepias verticillata / Whorled Milkweed	Cont.	1 Gal.		7
Ва	Baptisia alba / White Wild Indigo	Cont.	1 Gal.		53
Bc	Bouteloua curtipendula / Side Oats Grama	Cont.	1 Gal.		19
Ср	· · · · · · · · · · · · · · · · · · ·	Cont.	1 Gal.		6
Oβ	Loreonsis naimata / Stitt Hokseea		1 001.		
Dn	Coreopsis palmata / Stiff Tickseed		1 Gal		
· · · · · · · · · · · · · · · · · · ·	Dalea purpurea / Purple Prairie Clover	Cont.	1 Gal.		25
Dp Ep	Dalea purpurea / Purple Prairie Clover Echinacea pallida / Pale Purple Coneflower	Cont. Cont.	1 Gal.		25 25
Ep Ep2	Dalea purpurea / Purple Prairie Clover Echinacea pallida / Pale Purple Coneflower Echinacea purpurea / Coneflower	Cont. Cont. Cont.	1 Gal. 1 Gal.		25 25 7
Ep Ep2 Ey	Dalea purpurea / Purple Prairie Clover Echinacea pallida / Pale Purple Coneflower Echinacea purpurea / Coneflower Eryngium yuccifolium / Rattlesnake Master	Cont. Cont. Cont. Cont.	1 Gal. 1 Gal. 1 Gal.		25 25 7 26
Ep Ep2 Ey Gt	Dalea purpurea / Purple Prairie Clover Echinacea pallida / Pale Purple Coneflower Echinacea purpurea / Coneflower Eryngium yuccifolium / Rattlesnake Master Geum triflorum / Prairie Smoke	Cont. Cont. Cont. Cont. Cont.	1 Gal. 1 Gal. 1 Gal. 1 Gal.		25 25 7 26 120
Ep Ep2 Ey Gt Iv3	Dalea purpurea / Purple Prairie Clover Echinacea pallida / Pale Purple Coneflower Echinacea purpurea / Coneflower Eryngium yuccifolium / Rattlesnake Master Geum triflorum / Prairie Smoke Iris versicolor / Blue Flag	Cont. Cont. Cont. Cont. Cont. Cont.	1 Gal. 1 Gal. 1 Gal. 1 Gal. 1 Gal.		25 25 7 26 120 65
Ep Ep2 Ey Gt Iv3 Km	Dalea purpurea / Purple Prairie Clover Echinacea pallida / Pale Purple Coneflower Echinacea purpurea / Coneflower Eryngium yuccifolium / Rattlesnake Master Geum triflorum / Prairie Smoke Iris versicolor / Blue Flag Koeleria macrantha / Prairie Junegrass	Cont. Cont. Cont. Cont. Cont. Cont. Cont. Cont.	1 Gal. 1 Gal. 1 Gal. 1 Gal. 1 Gal. 1 Gal.		25 25 7 26 120 65
Ep Ep2 Ey Gt Iv3 Km La	Dalea purpurea / Purple Prairie Clover Echinacea pallida / Pale Purple Coneflower Echinacea purpurea / Coneflower Eryngium yuccifolium / Rattlesnake Master Geum triflorum / Prairie Smoke Iris versicolor / Blue Flag Koeleria macrantha / Prairie Junegrass Liatris aspera / Rough Blazing Star	Cont. Cont. Cont. Cont. Cont. Cont. Cont. Cont. Cont.	<ol> <li>Gal.</li> <li>Gal.</li> <li>Gal.</li> <li>Gal.</li> <li>Gal.</li> <li>Gal.</li> <li>Gal.</li> </ol>		25 7 26 120 65 135 30
Ep Ep2 Ey Gt Iv3 Km La	Dalea purpurea / Purple Prairie Clover Echinacea pallida / Pale Purple Coneflower Echinacea purpurea / Coneflower Eryngium yuccifolium / Rattlesnake Master Geum triflorum / Prairie Smoke Iris versicolor / Blue Flag Koeleria macrantha / Prairie Junegrass Liatris aspera / Rough Blazing Star Liatris pycnostachya / Gayfeather	Cont.	<ol> <li>Gal.</li> </ol>		25 25 7 26 120 65 135 30 40
Ep Ep2 Ey Gt Iv3 Km La Lp	Dalea purpurea / Purple Prairie Clover Echinacea pallida / Pale Purple Coneflower Echinacea purpurea / Coneflower Eryngium yuccifolium / Rattlesnake Master Geum triflorum / Prairie Smoke Iris versicolor / Blue Flag Koeleria macrantha / Prairie Junegrass Liatris aspera / Rough Blazing Star Liatris pycnostachya / Gayfeather Monarda fistulosa / Bergamot	Cont.	<ol> <li>Gal.</li> </ol>		25 7 26 120 65 135 30 40 12
Ep Ep2 Ey Gt Iv3 Km La Lp Mf	Dalea purpurea / Purple Prairie Clover Echinacea pallida / Pale Purple Coneflower Echinacea purpurea / Coneflower Eryngium yuccifolium / Rattlesnake Master Geum triflorum / Prairie Smoke Iris versicolor / Blue Flag Koeleria macrantha / Prairie Junegrass Liatris aspera / Rough Blazing Star Liatris pycnostachya / Gayfeather Monarda fistulosa / Bergamot Monarda punctata / Spotted Horsemint	Cont.	<ol> <li>Gal.</li> </ol>		25 7 26 120 65 135 30 40 12
Ep Ep2 Ey Gt Iv3 Km La Lp Mf Mp	Dalea purpurea / Purple Prairie Clover Echinacea pallida / Pale Purple Coneflower Echinacea purpurea / Coneflower Eryngium yuccifolium / Rattlesnake Master Geum triflorum / Prairie Smoke Iris versicolor / Blue Flag Koeleria macrantha / Prairie Junegrass Liatris aspera / Rough Blazing Star Liatris pycnostachya / Gayfeather Monarda fistulosa / Bergamot Monarda punctata / Spotted Horsemint Panicum virgatum / Switch Grass	Cont.	<ol> <li>Gal.</li> </ol>		25 7 26 120 65 135 30 40 12 105
Ep Ep2 Ey Gt Iv3 Km La Lp Mf Mp Pv	Dalea purpurea / Purple Prairie Clover Echinacea pallida / Pale Purple Coneflower Echinacea purpurea / Coneflower Eryngium yuccifolium / Rattlesnake Master Geum triflorum / Prairie Smoke Iris versicolor / Blue Flag Koeleria macrantha / Prairie Junegrass Liatris aspera / Rough Blazing Star Liatris pycnostachya / Gayfeather Monarda fistulosa / Bergamot Monarda punctata / Spotted Horsemint Panicum virgatum / Switch Grass Parthenium integrifolium / Wild Quinine	Cont.	<ol> <li>Gal.</li> </ol>		25 7 26 120 65 135 30 40 12 105 209
Ep Ep2 Ey Gt Iv3 Km La Lp Mf Mp Pv Pm	Dalea purpurea / Purple Prairie Clover Echinacea pallida / Pale Purple Coneflower Echinacea purpurea / Coneflower Eryngium yuccifolium / Rattlesnake Master Geum triflorum / Prairie Smoke Iris versicolor / Blue Flag Koeleria macrantha / Prairie Junegrass Liatris aspera / Rough Blazing Star Liatris pycnostachya / Gayfeather Monarda fistulosa / Bergamot Monarda punctata / Spotted Horsemint Panicum virgatum / Switch Grass Parthenium integrifolium / Wild Quinine Phlox pilosa / Downy Phlox	Cont.	<ol> <li>Gal.</li> </ol>		25 25 7 26 120 65 135 30 40 12 105 209 26 38
Ep Ep2 Ey Gt Iv3 Km La Lp Mf Mp Pv Pm Pp Rh	Dalea purpurea / Purple Prairie Clover Echinacea pallida / Pale Purple Coneflower Echinacea purpurea / Coneflower Eryngium yuccifolium / Rattlesnake Master Geum triflorum / Prairie Smoke Iris versicolor / Blue Flag Koeleria macrantha / Prairie Junegrass Liatris aspera / Rough Blazing Star Liatris pycnostachya / Gayfeather Monarda fistulosa / Bergamot Monarda punctata / Spotted Horsemint Panicum virgatum / Switch Grass Parthenium integrifolium / Wild Quinine Phlox pilosa / Downy Phlox Rudbeckia hirta / Black—eyed Susan	Cont.	<ol> <li>Gal.</li> </ol>		25 7 26 120 65 135 30 40 12 105 26 38 34
Ep Ep2 Ey Gt Iv3 Km La Lp Mf Mp Pv Pm Pp Rh Ss	Dalea purpurea / Purple Prairie Clover Echinacea pallida / Pale Purple Coneflower Echinacea purpurea / Coneflower Eryngium yuccifolium / Rattlesnake Master Geum triflorum / Prairie Smoke Iris versicolor / Blue Flag Koeleria macrantha / Prairie Junegrass Liatris aspera / Rough Blazing Star Liatris pycnostachya / Gayfeather Monarda fistulosa / Bergamot Monarda punctata / Spotted Horsemint Panicum virgatum / Switch Grass Parthenium integrifolium / Wild Quinine Phlox pilosa / Downy Phlox Rudbeckia hirta / Black—eyed Susan Schizachyrium scoparium / Little Bluestem	Cont.	<ol> <li>Gal.</li> </ol>		25 25 7 26 120 65 135 30 40 12 105 209 26 38 34 206
Ep Ep2 Ey Gt Iv3 Km La Lp Mf Mp Pv Pm Pp Rh Ss Sh	Dalea purpurea / Purple Prairie Clover Echinacea pallida / Pale Purple Coneflower Echinacea purpurea / Coneflower Eryngium yuccifolium / Rattlesnake Master Geum triflorum / Prairie Smoke Iris versicolor / Blue Flag Koeleria macrantha / Prairie Junegrass Liatris aspera / Rough Blazing Star Liatris pycnostachya / Gayfeather Monarda fistulosa / Bergamot Monarda punctata / Spotted Horsemint Panicum virgatum / Switch Grass Parthenium integrifolium / Wild Quinine Phlox pilosa / Downy Phlox Rudbeckia hirta / Black—eyed Susan Schizachyrium scoparium / Little Bluestem Sporobolus heterolepis / Prairie Dropseed	Cont.	<ol> <li>Gal.</li> </ol>		25 7 26 120 65 135 30 40 12 105 26 38 34 206 263
Ep Ep2 Ey Gt Iv3 Km La Lp Mf Mp Pv Pm Pp Rh Ss	Dalea purpurea / Purple Prairie Clover Echinacea pallida / Pale Purple Coneflower Echinacea purpurea / Coneflower Eryngium yuccifolium / Rattlesnake Master Geum triflorum / Prairie Smoke Iris versicolor / Blue Flag Koeleria macrantha / Prairie Junegrass Liatris aspera / Rough Blazing Star Liatris pycnostachya / Gayfeather Monarda fistulosa / Bergamot Monarda punctata / Spotted Horsemint Panicum virgatum / Switch Grass Parthenium integrifolium / Wild Quinine Phlox pilosa / Downy Phlox Rudbeckia hirta / Black—eyed Susan Schizachyrium scoparium / Little Bluestem	Cont.	<ol> <li>Gal.</li> </ol>		25 25 7 26 120 65 135 30 40 12 105 209 26 38 34 206

1 | 2 | 3 | 4 | 5 | 6 | 7 | 8 | 9 | 10 | 11 | 12 | 13 | 14 | 15 | 16 | 21 | 22 | 23 | 24 | 25

CONCEPT PLANT SCHEDULE

8,090 sf

PLANT MATERIAL NOTES:

- 1. ALL PLANTINGS SHALL CONFORM TO QUALITY REQUIREMENTS AS PER ANSI Z60.1.
- 2. ALL PLANT MATERIAL SHALL BE TRUE TO SPECIES, VARIETY AND SIZE SPECIFIED, NURSERY GROWN IN ACCORDANCE WITH GOOD HORTICULTURAL PRACTICES, AND UNDER CLIMATIC CONDITIONS SIMILAR TO THOSE OF THE PROJECT SITE.
- 3. CONTACT LANDSCAPE ARCHITECT, IN WRITING, TO REQUEST ANY PLANT MATERIAL SUBSTITUTIONS DUE TO AVAILABILITY ISSUES.
- 4. ALL PLANTS SHALL BE GUARANTEED TO BE IN HEALTHY AND FLOURISHING CONDITION DURING THE GROWING SEASON FOLLOWING INSTALLATION. ALL PLANT MATERIAL SHALL BE GUARANTEED FOR ONE YEAR FROM THE TIME OF INSTALLATION.

#### LANDSCAPE MATERIAL NOTES:

- CONTRACTOR SHALL PROVIDE A SUITABLE AMENDED TOPSOIL BLEND FOR ALL PLANTING AREAS WHERE SOIL CONDITIONS ARE UNSUITABLE FOR PLANT GROWTH. TOPSOIL SHALL CONFORM TO QUALITY REQUIREMENTS AS PER SECTION 625.2(1) OF THE "STANDARD SPECIFICATIONS FOR HIGHWAY CONSTRUCTION." PROVIDE A MINIMUM OF 18" OF TOPSOIL IN ALL PLANTING AREAS AND 6" OF TOPSOIL IN AREAS TO BE SEEDED/SODDED.
- 2. LANDSCAPE BEDS TO BE MULCHED WITH UNDYED SHREDDED HARDWOOD BARK MULCH TO 3" DEPTH MIN. AND EDGED WITH COMMERCIAL GRADE ALUMINUM LANDSCAPE EDGING, PERMALOC CLEANLINE 3"X4" OR EQUAL, COLOR BLACK ANODIZED.
- 3. ALL TREES AND/OR SHRUBS PLANTED IN LAWN AREAS TO BE INSTALLED WITH A 5' DIAMETER MULCH RING AND SHOVEL CUT EDGE. A PRE-EMERGENT GRANULAR HERBICIDE WEED-PREVENTER SHOULD BE MIXED WITH MULCH AS WELL AS TOPICALLY APPLIED TO

#### SEEDING AND PLUG PLANTING NOTES:

- 1. ALL DISTURBED AREAS, UNLESS OTHERWISE NOTED, TO BE SEEDED WITH 'MADISON PARKS' MIX BY 'LACROSSE SEED COMPANY'/WI DOT SEED MIX #40 OR EQUIVALENT, PER MANUFACTURER'S SPECIFIED APPLICATION RATES. ALL SEEDED AREAS ARE TO BE WATERED DAILY TO MAINTAIN ADEQUATE SOIL MOISTURE FOR PROPER GERMINATION. AFTER VIGOROUS GROWTH IS ESTABLISHED, APPLY 1 WATER TWICE WEEKLY UNTIL FINAL ACCEPTANCE.
- AREAS SHOWN AS SOD TO BE PLANTED WITH TURFGRASS SOD GROWN IN SOIL SIMILAR IN COMPOSITION TO SITE SOIL (NOT PEAT). PLACE SOD ROLLS SO SEAMS ARE STAGGERED. ROLL TO ENSURE GOOD SOIL CONTACT AND SECURE WITH WOOD PEGS. METAL STAPLES, IF USED, MUST BE REMOVED WITHIN 8 WEEKS OF INSTALLATION. SOD AREAS TO BE WATERED
- 3. INSTALL BIORETENTION PLUG PLANTINGS AS 2" X 2" X 4" DEEP PLUGS, 12" ON CENTER IN A TRIANGULAR GRID PATTERN. PLANT SPECIES IN ODD NUMBERED GROUPS OF 5-9 PLANTS, DISTRIBUTING EACH SPECIES RANDOMLY ACROSS PLANTING AREA FOR NATURAL
- 4. ALL AREAS NOTED ON PLAN AS DRY DETENTION BASIN SEEDING, INSTALL 'DETENTION BASIN - BIOSWALE' SEED MIX BY 'PRAIRIE NURSERY'. INSTALL PER MANUFACTURER'S SPECIFIED APPLICATION RATES. ALL SEEDED AREAS ARE TO BE WATERED DAILY TO MAINTAIN ADEQUATE SOIL MOISTURE FOR PROPER GERMINATION. AFTER VIGOROUS GROWTH IS ESTABLISHED, APPLY 1 WATER TWICE WEEKLY UNTIL FINAL ACCEPTANCE.

# PRAIRIE AREAS: PLANTING AND MAINTENANCE THROUGH YEAR 2

PREPARING THE SITE

- Remove weeds from site prior to planting, using one or a combination of the following methods:
- 1. Apply a vegetation killing herbicide at least two times.
- 2. Cover the area with black plastic, cardboard, or mulch for one growing season. 3. Rototill or disk the area at least every month for at least one entire growing season.


PLANTING THE SEED

Plant seed mix before June 15 or after October 15 for best results. Soil seed contact is necessary for seeds to germinate; either till soil well or use a special drill for no-till seeding. Incorporate any necessary soil amendments prior to seeding. Do not plant seed deeper than one inch. Watering and mulching may help support germination, but watering must be done consistently until germination is complete. CARING FOR THE PLANTING

Weed control is critical while the native plants are becoming established. Weeds may be controlled via mowing, spot herbicide application, or hand pulling. During the first two growing seasons, mow when vegetation reaches a height of 6-12 inches just as weeds flower or when they exceed three feet in height. Do not mow too often or too short, as this will encourage weeds to flower closer to the ground. PRAIRIE AREAS: MAINTENANCE AFTER YEAR 2

After two growing seasons, weeds can be controlled via burning. Burning is best done in late spring (late April) for maximum destruction of weeds and to preserve winter nesting habitat. Burning should be done annually, although burns may be rotated so that only a portion (1/2-1/3 of the total area) is burned each year. In areas where burning is not feasible, remaining vegetation should be mowed to a height of 6" in late fall or early spring to help distribute seed and allow sunlight to warm the soil in the spring.

- 1. PARKING ISLAND TO BE FREE OF AGGREGATE TO A MINIMUM DEPTH OF 24"
- 2. ANY PAVEMENT BASE MATERIALS REMAINING FROM PAVEMENT INSTALLATION WITHIN PLANTING AREA SHALL BE REMOVED AND REPLACED WITH NATIVE SOIL PRIOR TO

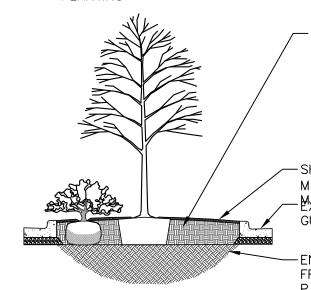

-BACKFILL WITH NATIVE SOIL. TAMP SOIL AROUND ROOT BALL BASE FIRMLY WITH FOOT PRESSURE SO THAT ROOT BALL DOES NOT SHIFT. WATER THOROUGHLY AND MAINTAIN ADEQUATE MOISTURE THROUGH THE FIRST GROWING SEASON

-SHREDDED HARDWOOD BARK MULCH TO 3" DEPTH MIN. DO NOT - MAYNACYHISTALAEBINSJRBLANBS GUTTER

-ENSURE EXISTING SUBSOIL IS FREE FROM CONSTRUCTION DEBRIS, PAVING BASE MATERIAL, ETC. SCARIFY SURFACE TO 4" DEPTH PRIOR TO PLACING ISLAND PLANTINGS

1 PARKING ISLAND PLANTING AREA

22637000

301 N Broom St., Suite 100

www.opnarchitects.com

rights, including the copyright thereto.

ALL METALS RECYCLING

ALL METALS RECYCLING CENTER

5651 TRADESMEN DRIVE MADISON, WI 53718

General Contractor Contractor Name

Civil Engineer VIERBICHER

999 FOURIER DR # 201 MADISON, WI 53717

Structural Engineer Contractor Name

Mechanical Engineer

Electrical Engineer

Contractor Name

Contractor Name

© 2022 OPN Architects, Inc.


1802 S. PARK ST MADISON, WI 53713

All reports, plans, specifications, computer files, field data, notes and other documents and instruments prepared by OPN Architects, Inc. as instruments of service shall remain the property of OPN Architects, Inc. OPN Architects, Inc. shall retain all common law, statutory and other reserved

Madison, WI 53703 P: 608-819-0260

Landscape Details

PRELIMINARY. NOT FOR CONSTRUCTION.

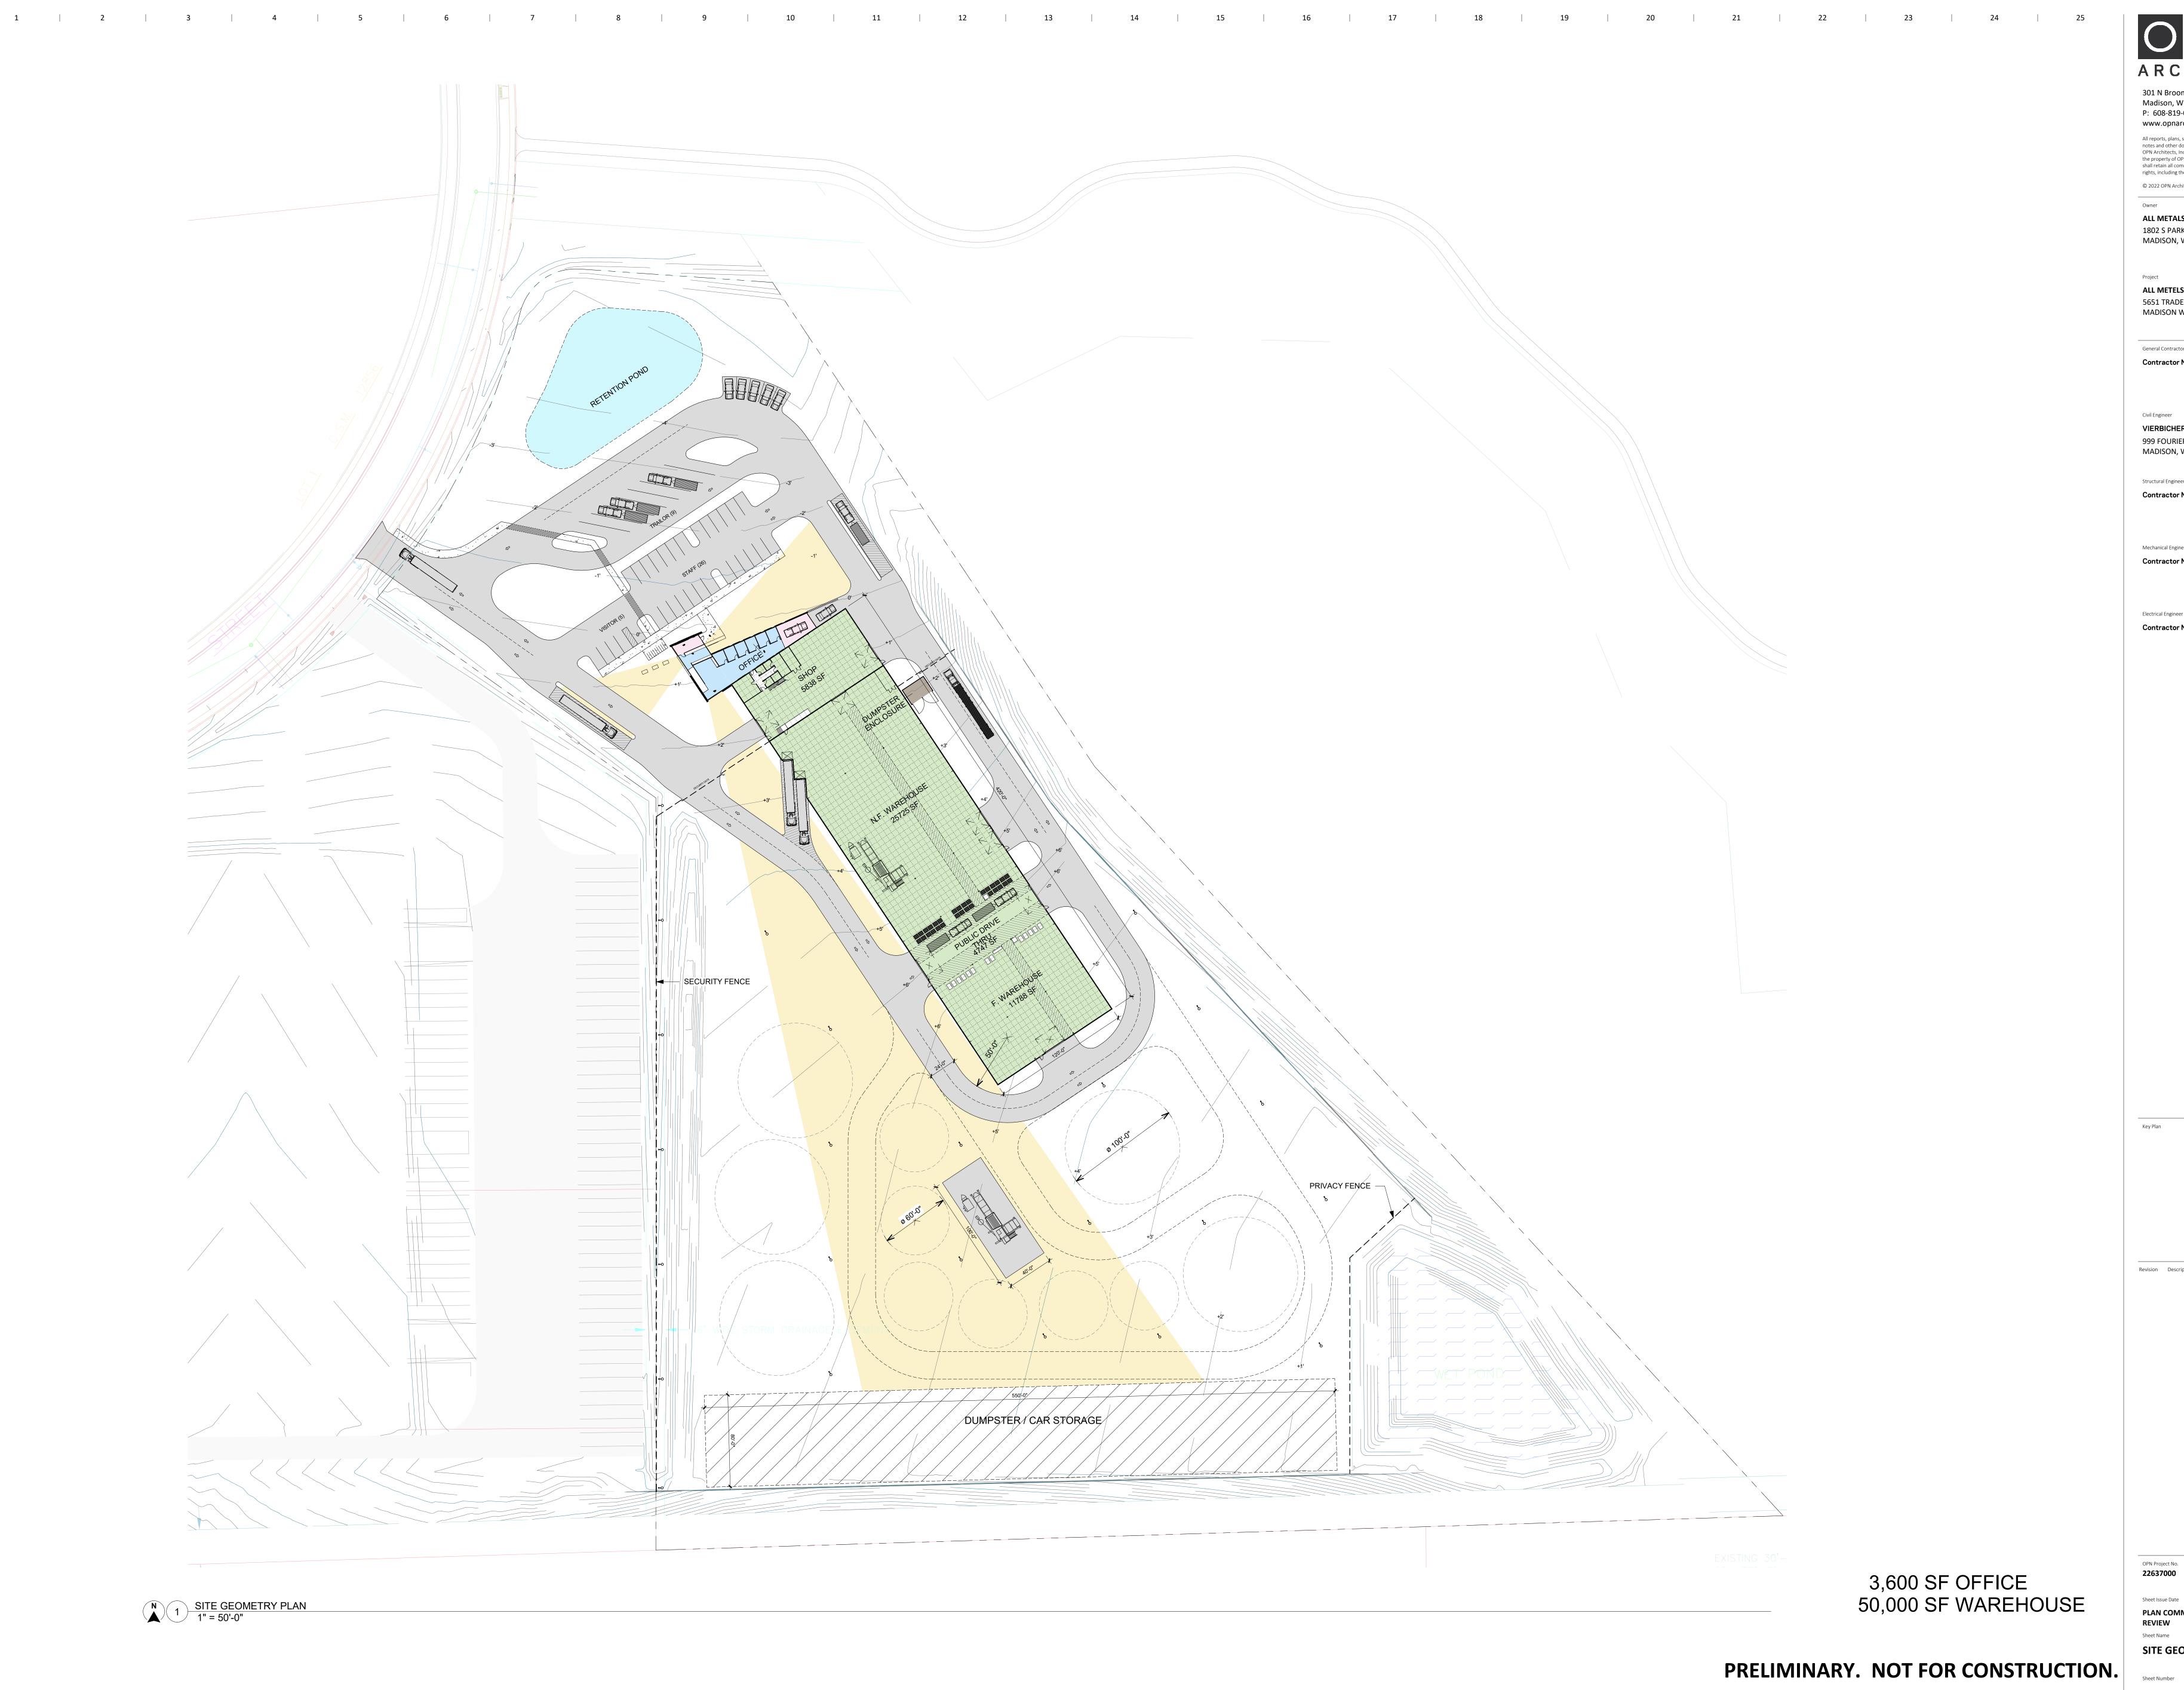

301 N Broom St., Suite 100 Madison, WI 53703

P: 608-819-0260 www.opnarchitects.com

All reports, plans, specifications, computer files, field data, notes and other documents and instruments prepared by OPN Architects, Inc. as instruments of service shall remain the property of OPN Architects, Inc. OPN Architects, Inc. shall retain all common law, statutory and other reserved states in adulting the construction. rights, including the copyright thereto. © 2022 OPN Architects, Inc.

ALL METELS RECYLCING CENTER

5651 TRADESMAN DRIVE MADISON WI, 53718

ALL METALS RECYCLING

1802 S PARK ST MADISON, WI 53713

General Contractor

**Contractor Name** 

Civil Engineer

VIERBICHER 999 FOURIER DR # 201 MADISON, WI 53717

Contractor Name

Structural Engineer

Mechanical Engineer **Contractor Name** 

Electrical Engineer


**Contractor Name** 

OPN Project No. **22637000** 


REVIEW

Sheet Name SITE GEOMETRY PLAN

A002

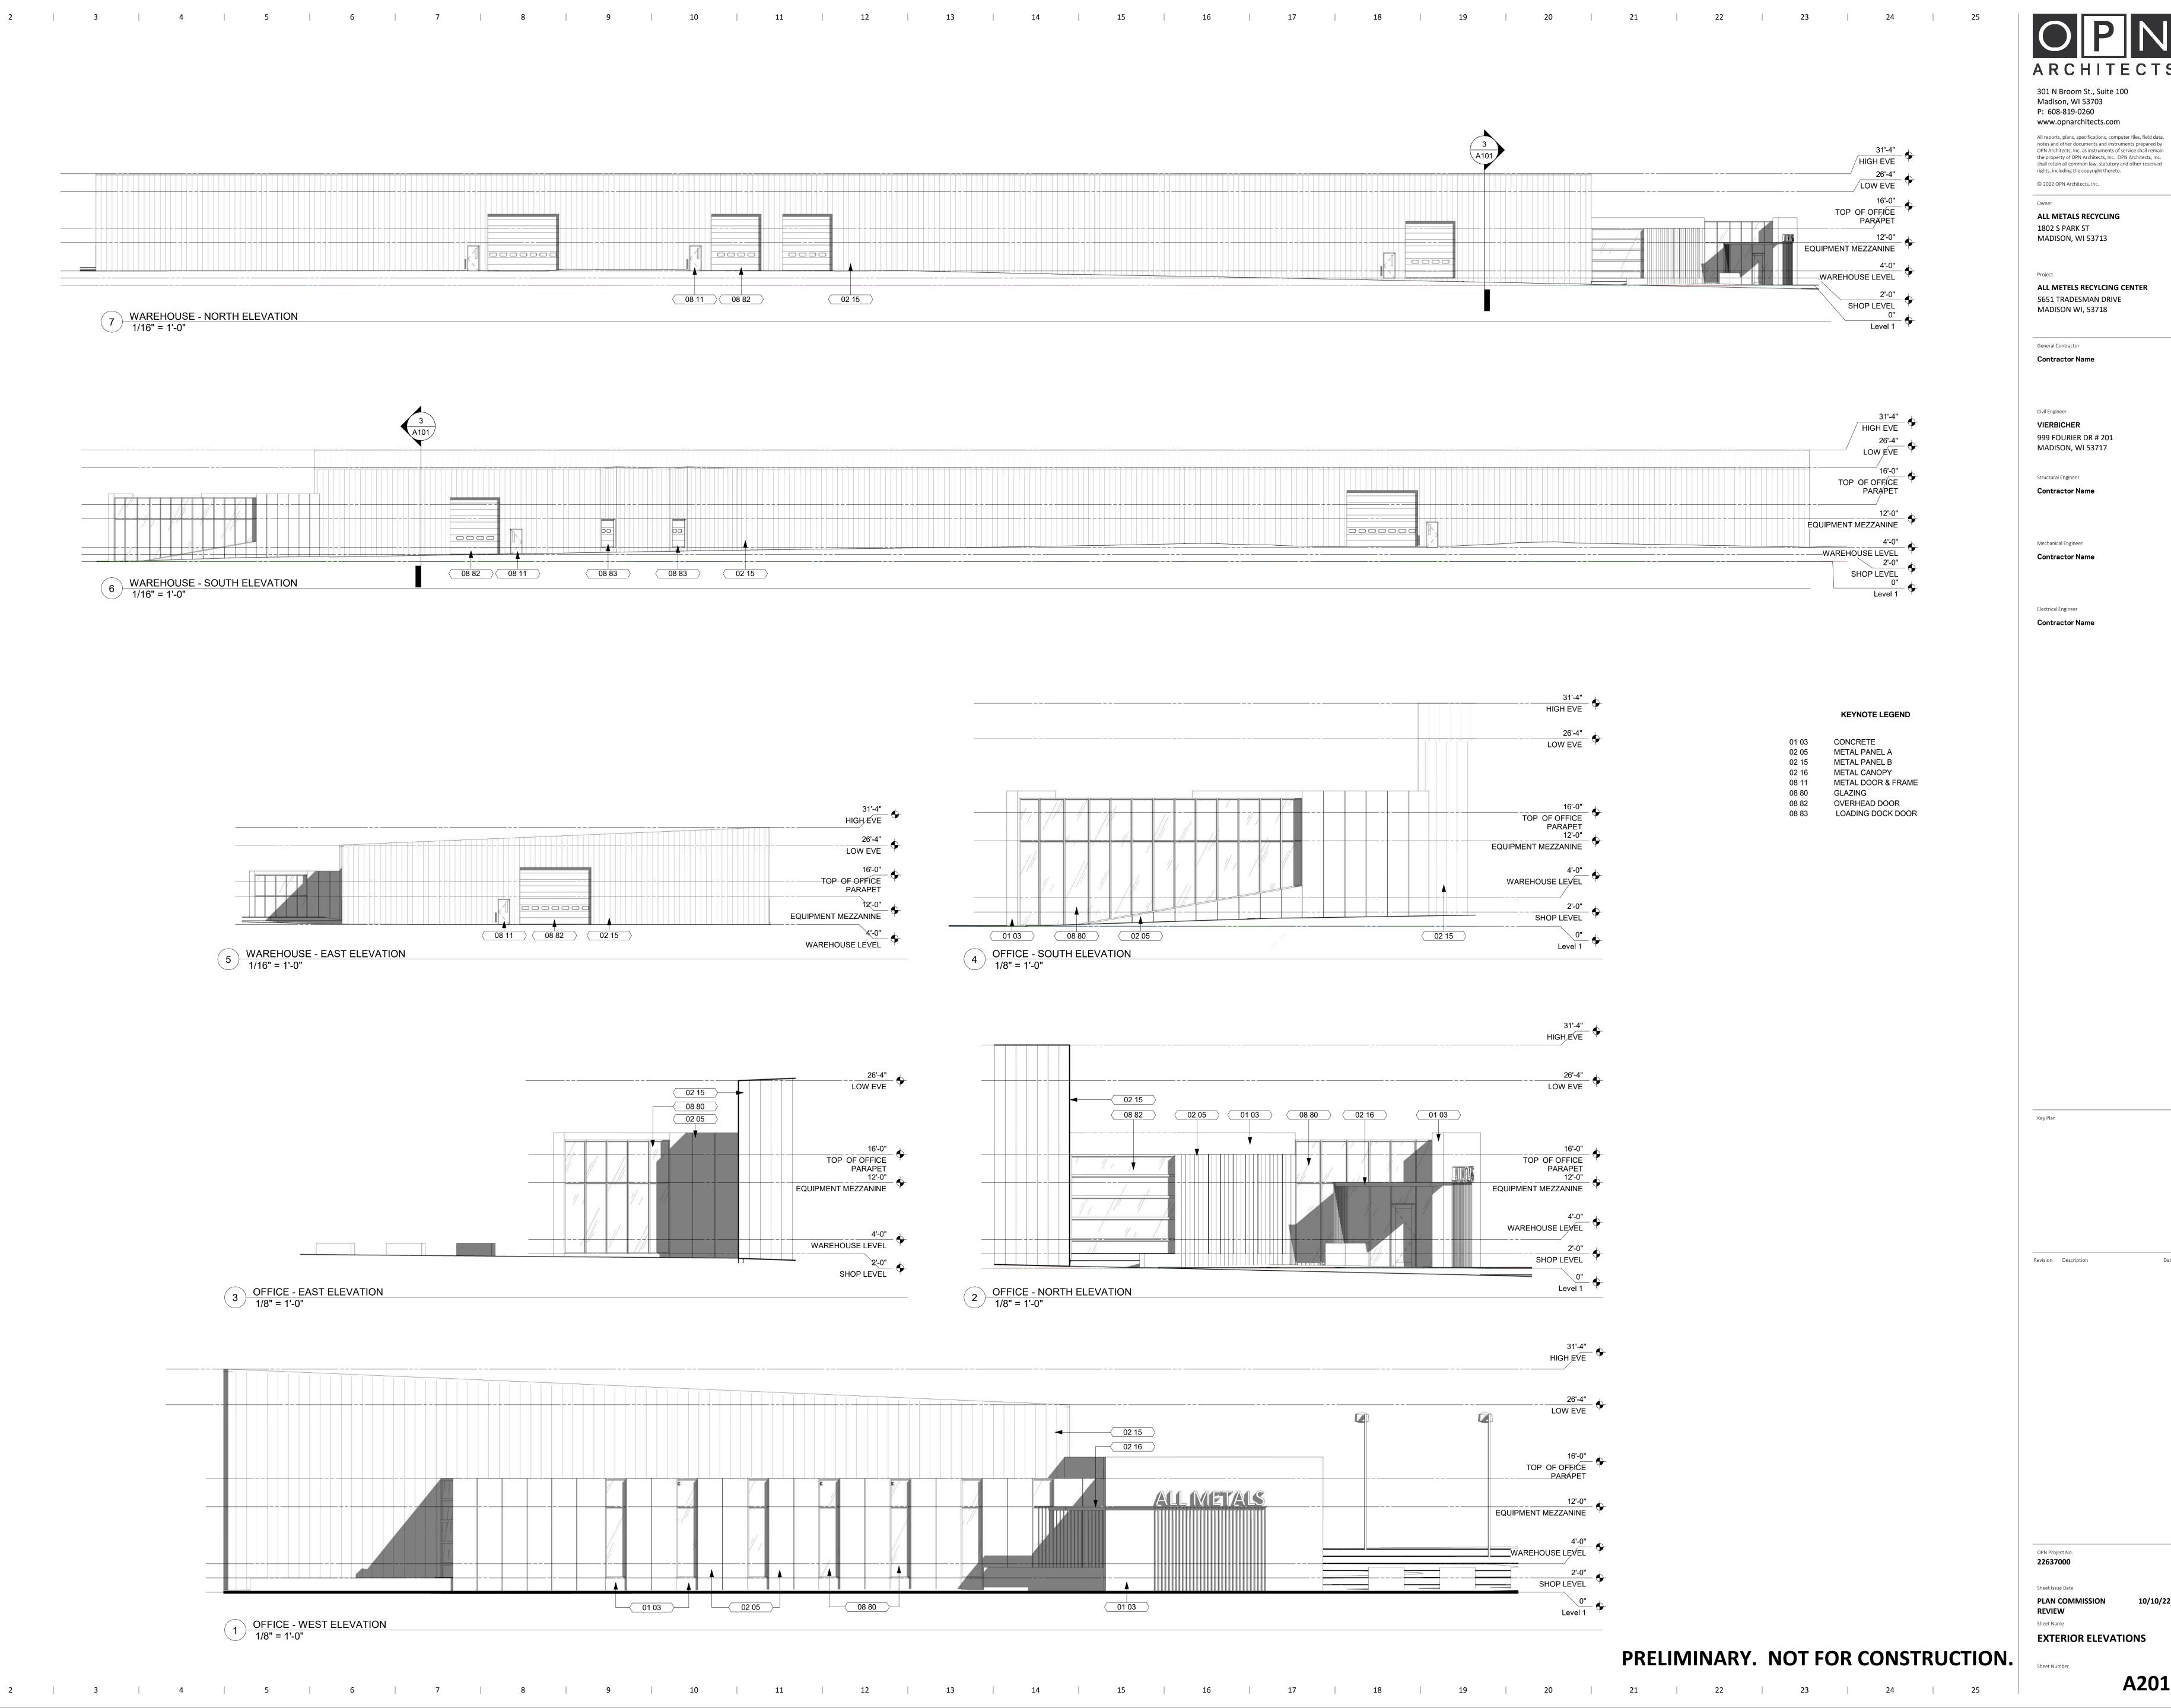

A201

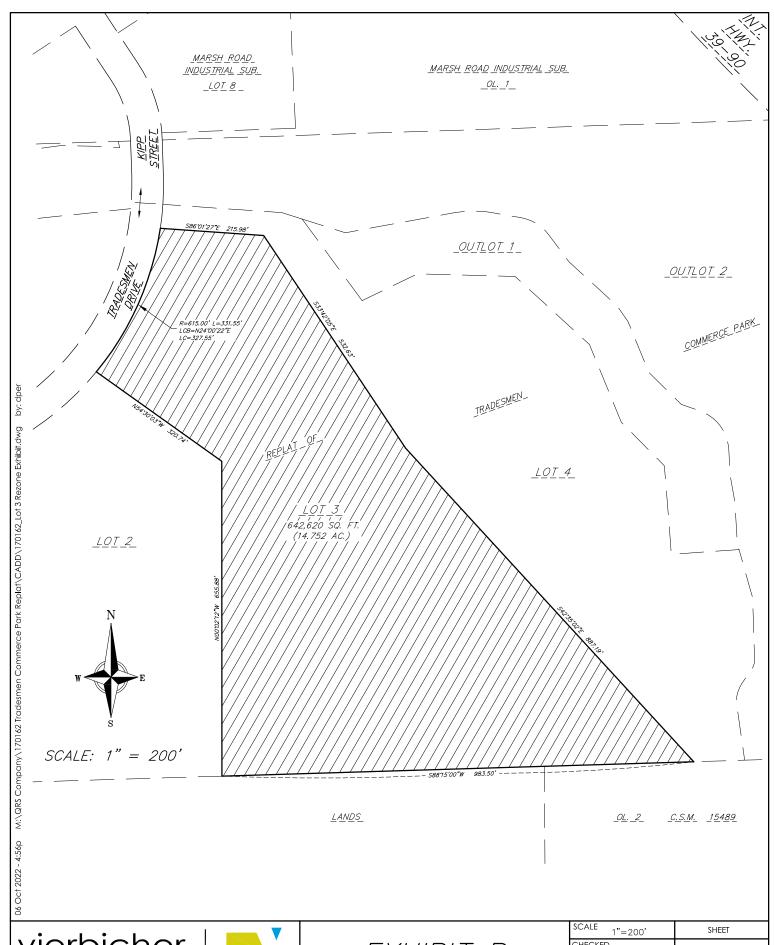

vierbicher
planners | engineers | advisors

Phone: (800) 261-3898



EXHIBIT B LOT 3 REZONE

SCALE 1"=200'	SHEET		
CHECKED MZIE			
DRAFTER DPER	1 OF 1		
DATE 10/07/2022	l OF I		
JOB NO. 170162			