


HARTMEYER REDEVELOPMENT: FAMILY HOUSING

2007 ROTH STREET: LOT 2



DRAWING INDEX FAMILY HOUSING				
DRAWING#	DRAWING TITLE			
G000	COVER SHEET			
G000 G010	SITE LOCATOR MAP			
G010 G011	CONTEXTUAL SITE INFO			
G011 G012	CONTEXTUAL SITE INFO			
G012 G013	CONTEXTUAL SITE INFO			
C0.1	EXISTING CONDITIONS MAP			
C1.0	GENERAL NOTES & LEGEND			
C2.0	DEMO PLAN			
C3.0	SITE PLAN			
C4.0				
	GRADING & EROSION CONTROL PLAN			
C4.1 C4.2	DETAILED GRADING PLAN DETAILED GRADING PLAN			
C5.0	UTILITY PLAN			
C6.0	DETAILS FIRE ACCESS DIANI			
C7.0	FIRE ACCESS PLAN			
L1.0	LANDSCAPE PLAN OVERALL			
L1.1	LANDSCAPE PLAN – NORTHWEST			
L1.2	LANDSCAPE PLAN - NORTHEAST			
L1.3	LANDSCAPE PLAN – SOUTHWEST			
L1.4	LANDSCAPE PLAN – SOUTHEAST			
L1.5	LANDSCAPE PLAN – NW COURTYARD			
L1.6	LANDSCAPE PLAN – NE COURTYARD			
L1.7	LANDSCAPE PLAN – SW COURTYARD			
L2.0	LANDSCAPE DETAILS & NOTES			
ASP-100	USABLE OPEN SPACE			
ASP-200	SITE LIGHTING PLAN			
A101	1ST FLOOR PLAN			
A102	2ND FLOOR PLAN			
A103	3RD FLOOR PLAN			
A104	4TH - 6TH FLOOR PLANS			
A105	ROOF PLAN			
A200	CONCEPTUAL ELEVATION: WEST & SOUTH			
A201	CONCEPTUAL ELEVATION: EAST & NORTH			
A202	EXTERIOR PERSPECTIVE: BIRD'S EYE VIEW FROM SOUTHWEST			
A203	EXTERIOR PERSPECTIVE: BIRD'S EYE VIEW FROM WEST			
A204	EXTERIOR PERSPECTIVE: BIRD'S EYE VIEW FROM NORTHWEST			
A205	EXTERIOR PERSPECTIVE: VIEW TO ENTRANCE			
A206	EXTERIOR PERSPECTIVE: VIEW TO ENTRANCE			
A210	MATERIALS BOARDS			

LAND USE APPLICATION SUBMITTAL

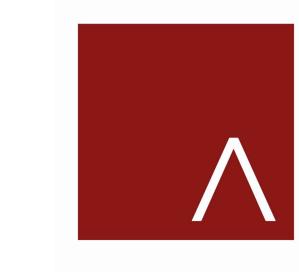







JLA PROJECT NUMBER:



HARTMEYER
REDEVELOPMENT:
FAMILY HOUSING

2007 ROTH STREET LOT 2

LAND USE APPLICATION

KEY PLAN

SEPTEMBER 26, 2022

PROGRESS DOCUMENTS

These documents reflect progress and intent and may be subject to change, including additional detail. These are not final construction documents and should not be used for final bidding or construction-related purposes.

DATE OF ISSUANCE

REVISION SCHEDULE

Mark Description

SHEET TITLE

SITE LOCATOR

SHEET NUMBER



AERIAL VIEW FROM SOUTHWEST



AERIAL VIEW FROM NORTHEAST



JLA PROJECT NUMBER: W22-0128-01



HARTMEYER
REDEVELOPMENT:
FAMILY HOUSING

2007 ROTH STREET LOT 2

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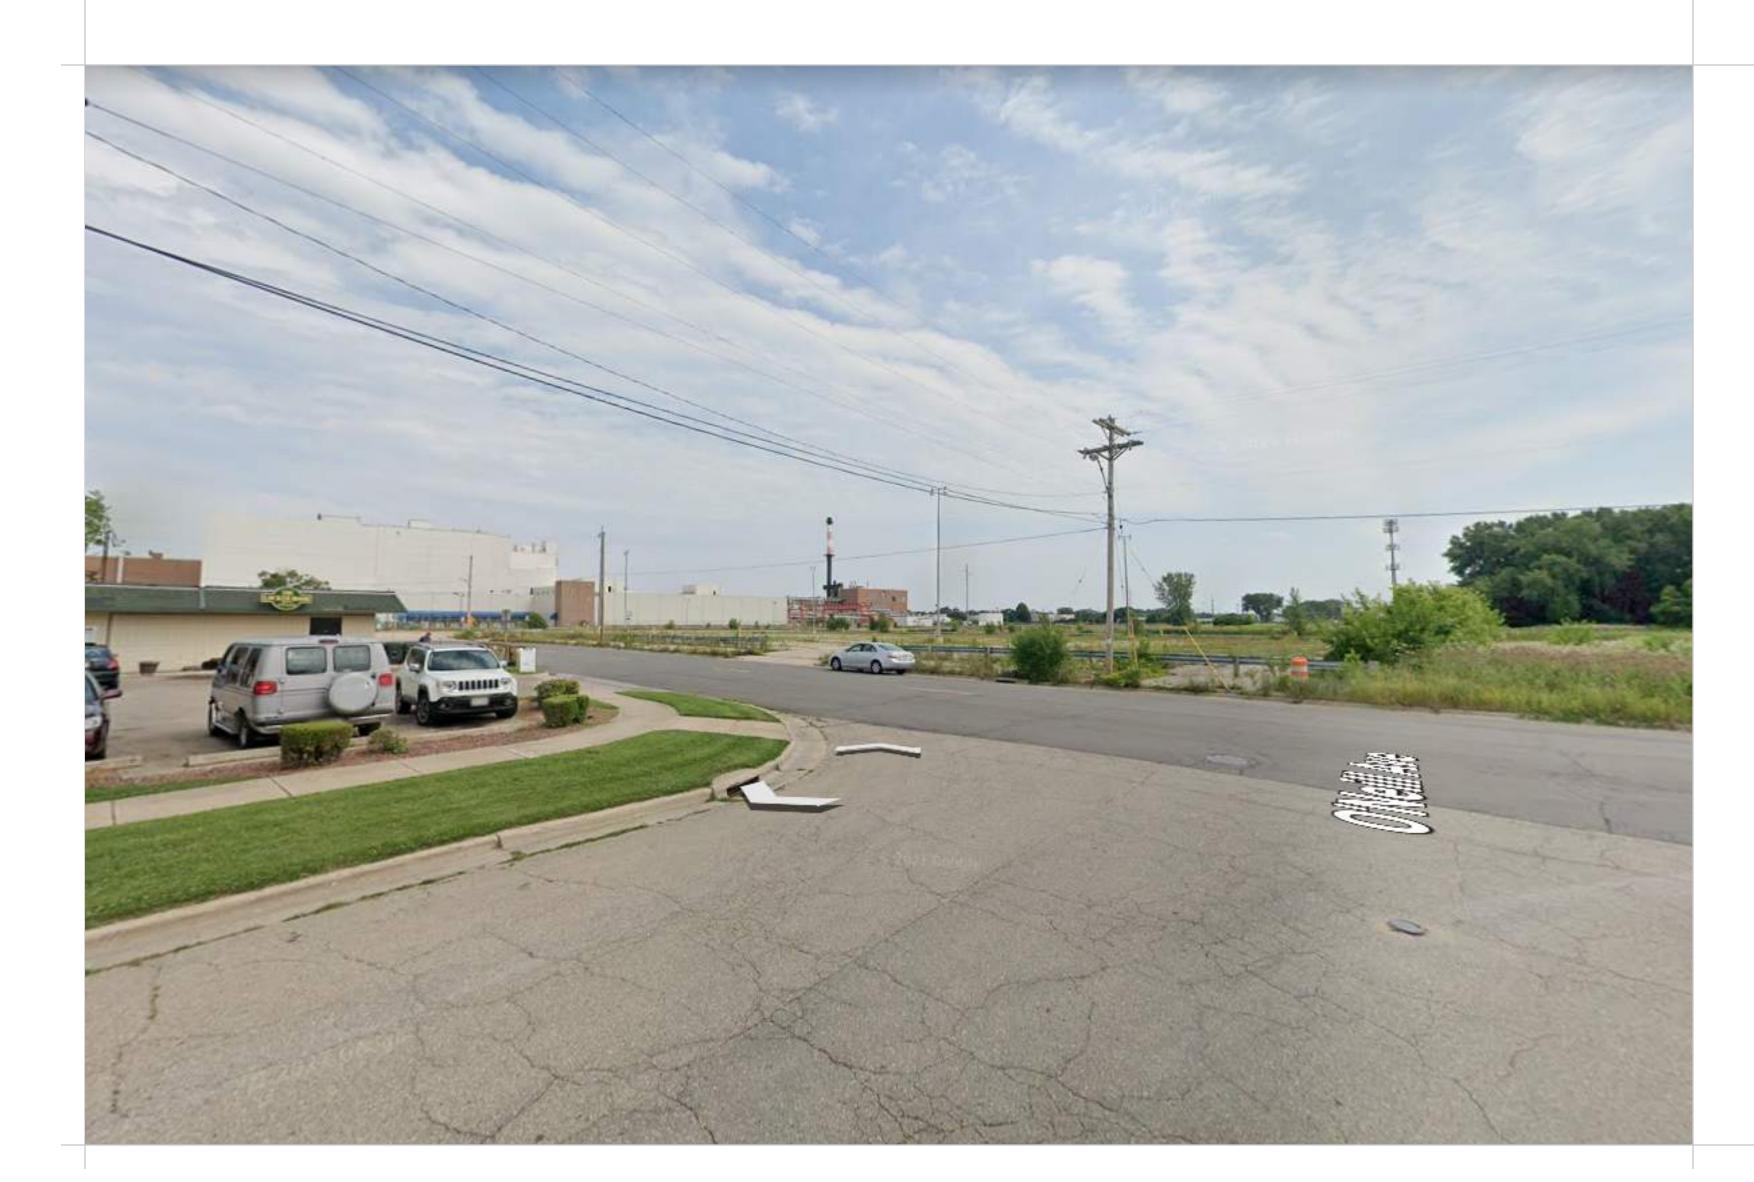
SHEET TITLE

CONTEXTUAL SITE INFORMATION


SHEET NIIIAARE



ROTH ST AT RAILROAD LOOKING SOUTH



O'NEIL AVE LOOKING SOUTHEAST

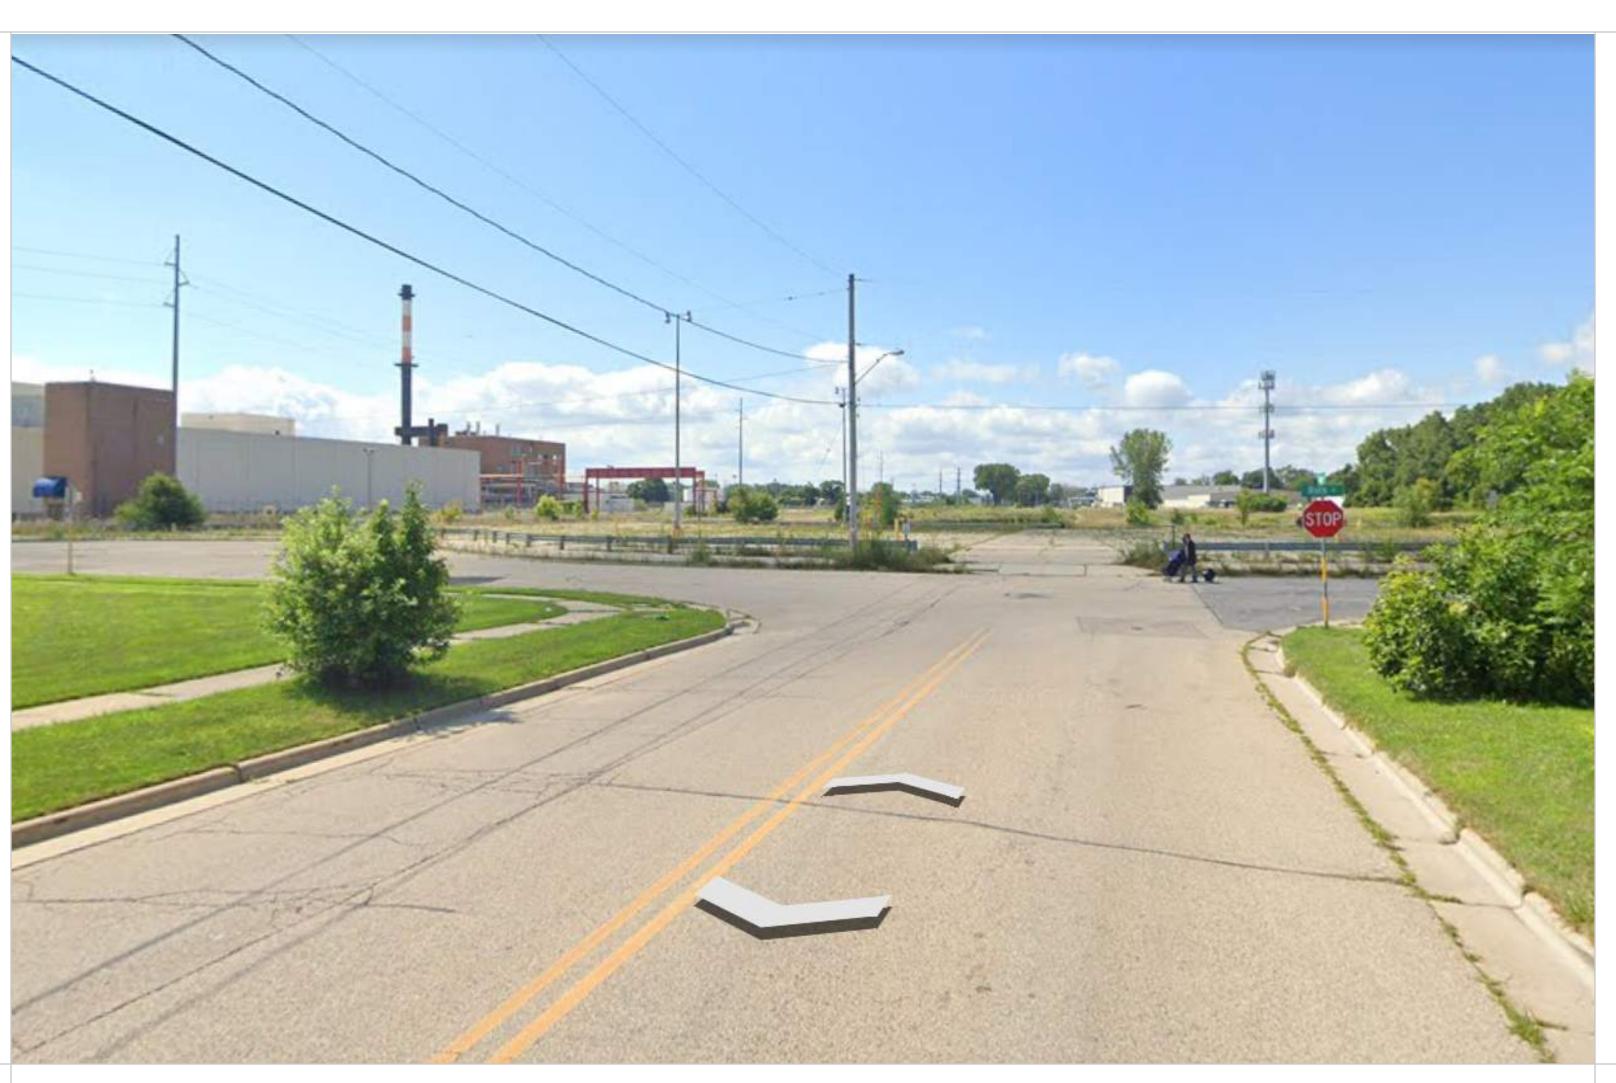

HUXLEY ST LOOKING SOUTH



ROTH STREET LOOKINGEAST



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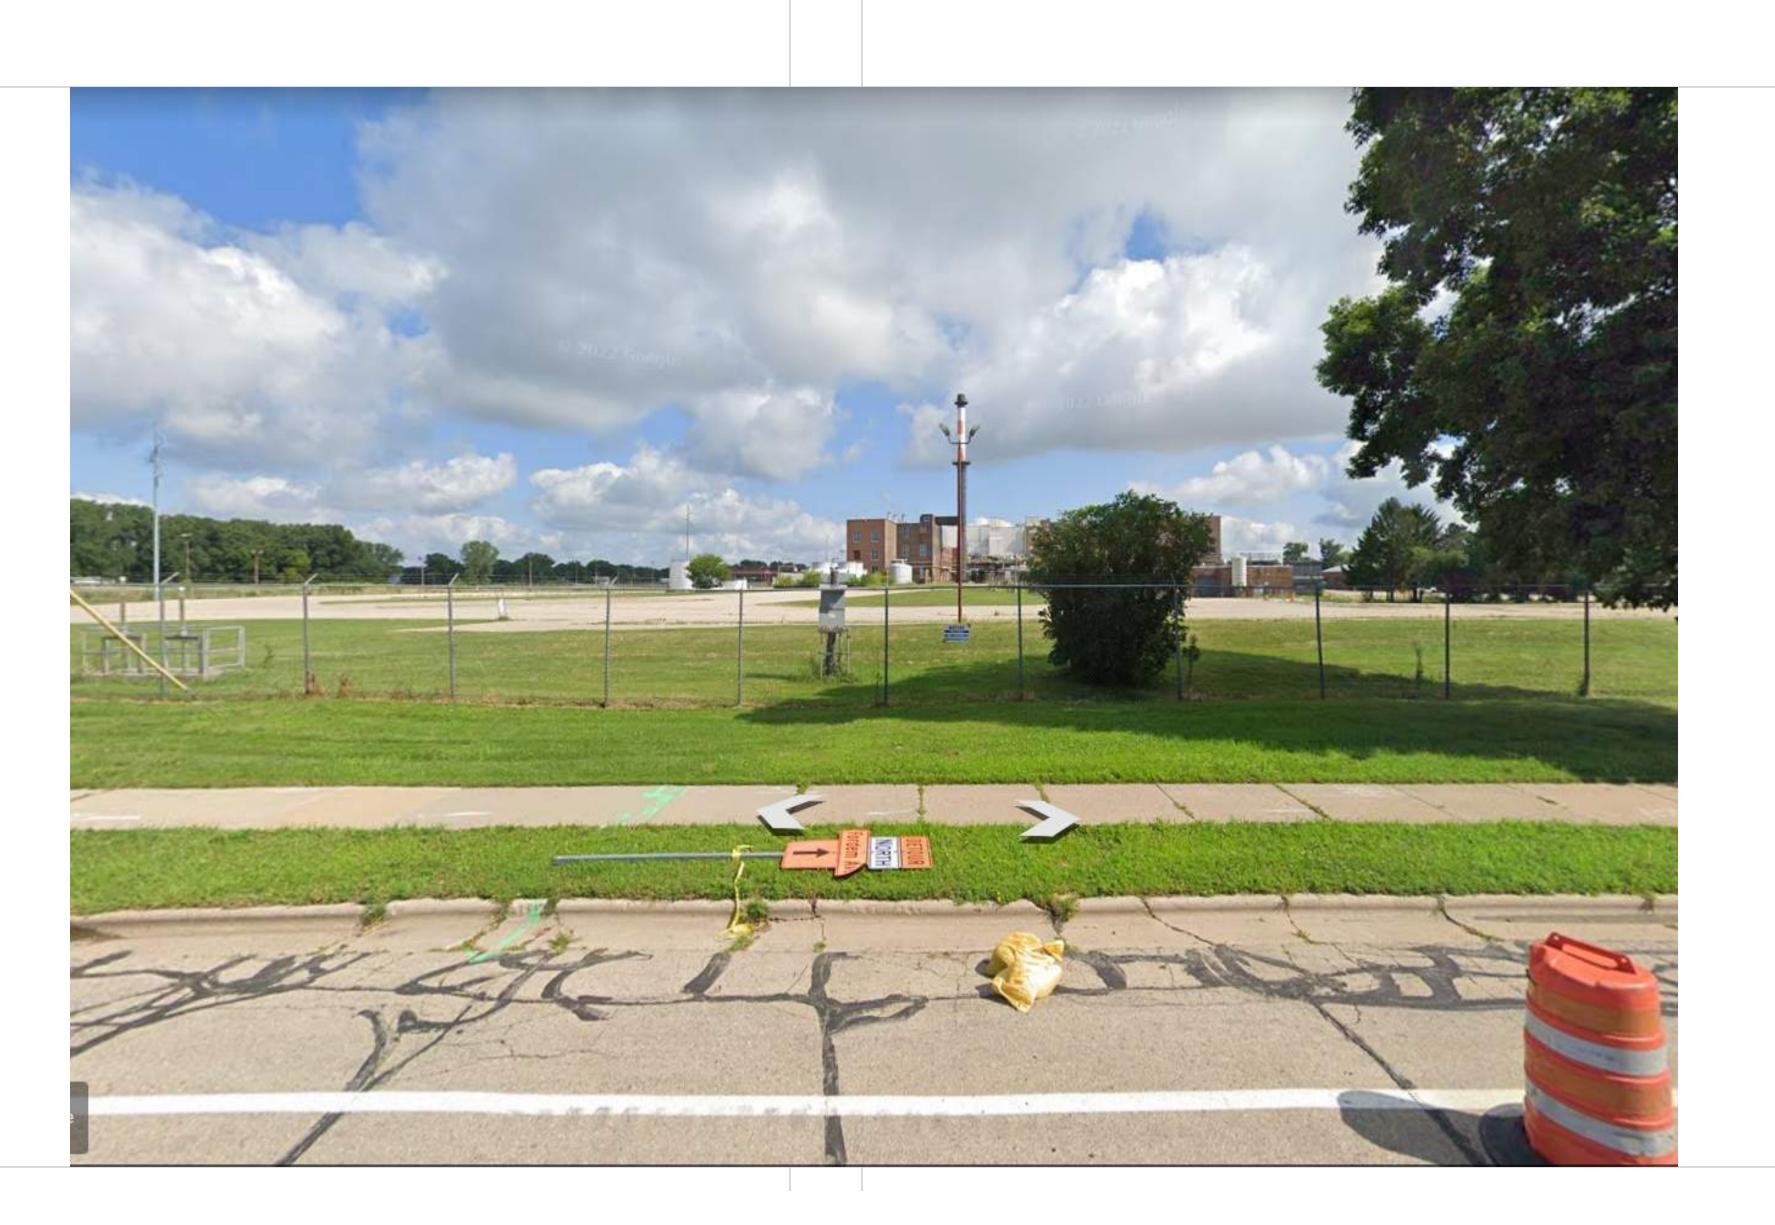
SHEET NUMBER



RUSKIN ST ATCOMMERCIAL AVE LOOKING NORTH



COMMERCIAL AVE AT RAILROAD LOOKING NORTH



COMMERCIAL AVE LOOKING NORTH



LA PROJECT NUMBER:



HARTMEYER REDEVELOPMENT: FAMILY HOUSING

2007 ROTH STREET LOT 2

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SEPTEMBER 26, 2022

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Description

CLICET TITLE

CONTEXTUAL SITE INFORMATION

SHEET NUMBE

LOT 1 OF PROPOSED CSM LOT 2 CSM 15507 PROPOSED COOLIDGE STREET GAS BUILDING LPT 3 OF PROPOSED CSM BUILDING AREA AT EXTERIOR FOOTPRINT = 265 S.F. 16' x 16' BUILDING 10 FOOT HIGH <u>LEGEND</u> PARCEL 368,794 S.F. 8.466 ACRE LOT 2 OF PROPOSED CSM **ILDING** 702 RUSKIN STREET ----- PLATTED LOT LINE ±S89°21'32"W 206.12' LOT 1 CSM 15507 <u>NOTES</u> 705 RUSKIN STREET BUILDING OWNER: JEAN EDWARDS HARTMEYER ESTATE 703 RUSKIN STREET OWNER: CASCADE INVESTMENT GROUP LLC OWNER: LEROY KLECKER LANDS NOT FIELD MARKED-NOT — KNOWN IF ABANDONED IN PLACE OR LIVE - BENCHMARK TOP OF HYDRANT =857.88 NAVD88 GRANT OF EASEMENT, DOCUMENT No. 1383555 CURVE LENGTH RADIUS DELTA CHORD CHORD BEARING C-1 34.86' 25.00' 79'53'17" 32.10' N60'45'25"E HARTMEYER ICE ARENA — APPROXIMATE WETLAND LOCATION PER WETLAND DELINEATION REPORT PREPARED BY KIMLEY—HORN AND ASSOCIATES, DATED NOVEMBER 2021 TWO-STORY MASONRY BUILDING OWNER: MADISON ICE HARTMEYER LLC 1834 COMMERCIAL AVENUE RIM=851.67 1 INV=847.87 E 15" 852 NNV OWNER: MADISON ICE HARTMEYER LLC *JSD DOES NOT GUARANTEE THAT THE BENCHMARK ELEVATIONS LISTED ON THIS MAP HAVE NOT BEEN DISTURBED SINCE THE DATE OF THE SURVEY AND SHOULD BE VERIFIED PRIOR TO CONSTRUCTION ACTIVITIES. ------- **COMMERCIAL AVENUE** ______

EXISTING CONDITIONS MAP

PART OF THE NORTHEAST QUARTER OF THE SOUTHWEST QUARTER, THE SOUTHEAST QUARTER OF THE SOUTHWEST QUARTER, THE SOUTHWEST QUARTER OF THE SOUTHWEST QUARTER OF SECTION 31, TOWNSHIP 08 NORTH, RANGE 10 EAST, CITY OF MADISON, DANE COUNTY, WISCONSIN



1" IRON PIPE FOUND BENCHMARK BOLLARD SIGN SANITARY MANHOLE WATERMAIN OR GASMAIN VALVE HYDRANT ROUND CASTED INLET SQUARE CASTED INLET CURB INLET STORM SEWER ACCESS POWER POLE W/GUY → TRAFFIC SIGNAL MONITORING WELL Fwtf WETLAND FLAG

——— PARCEL BOUNDARY ····· CHORD LINE ---- CENTERLINE

--- RIGHT-OF-WAY LINE — · · · — SETBACK LINE — - - - — SECTION LINE

— · — · — EASEMENT LINE -x-x- FENCE LINE

GUARD OR SAFETY RAIL ----- EDGE OF PAVEMENT

CONCRETE CURB & GUTTER --- EDGE OF GRAVEL

— ST — STORM SEWER ----G---- NATURAL GAS

/////// BUILDING ---875- INDEX CONTOUR -874 INTERMEDIATE CONTOUR --- DELINEATED WETLANDS

CONCRETE PAVEMENT GRAVEL ----- EDGE OF BITUMINOUS

BITUMINOUS PAVEMENT

 \sim END OF FLAGGED UTILITIES () DENOTES RECORD DATA DEPICTING THE SAME LINE ON THE GROUND AS RETRACED BY THIS SURVEY

1. FIELD WORK PERFORMED ON AUGUST 22, 2022.

2. BEARINGS FOR THIS SURVEY AND MAP ARE REFERENCED TO THE WISCONSIN COUNTY COORDINATE SYSTEM, DANE COUNTY ZONE; THE SOUTH LINE OF SECTION 31, TO8N, R10E, BEARS

3. ELEVATIONS ARE BASED ON THE NORTH AMERICAN VERTICAL DATUM OF 1988 (NAVD88). BENCHMARK IS THE TOP NUT OF A HYDRANT AS NOTED ON ALTA COMPLETED BY D'ONOFRIO KOTTKE AND ASSOCIATES, INC., FEBRUARY 25, 2022, ELEVATION = 857.88' 4. CONTOUR INTERVAL IS ONE FOOT.

5. SUBSURFACE UTILITIES AND FEATURES SHOWN ON THIS MAP HAVE BEEN APPROXIMATED BY LOCATING SURFICIAL FEATURES AND APPURTENANCES, LOCATING DIGGERS HOTLINE FIELD MARKINGS AND BY REFERENCE TO UTILITY RECORDS AND MAPS. DIGGER'S HOTLINE LOCATE TICKET NO. 20223425446, 20223425501, 20223425514, WITH A CLEAR DATE OF AUGUST 24, 2022, AND DIGGER'S HOTLINE MAPPING TICKET NO. 20223425467, 20223425471, 20223425546, WITH A CLEAR DATE OF AUGUST 29, 2022.

6. UTILITY COMPANIES CONTACTED THRU DIGGERS HOTLINE: MADISON GAS & ELECTRIC AMERICAN TRANSMISSION

ROGERS COMMUNICATIONS CANADA AT&T DISTIBUTION TDS TELECOM - MIDDLETON TDS METROCOM

CITY OF MADISON ENGINEERING

7. BEFORE EXCAVATION, APPROPRIATE UTILITY COMPANIES SHOULD BE CONTACTED. FOR EXACT LOCATION OF UNDERGROUND UTILITIES, CONTACT DIGGERS HOTLINE, AT 1.800.242.8511. 8. JSD PROFESSIONAL SERVICES, INC. DOES NOT GUARANTEE THAT THE BENCHMARKS LISTED ON THIS MAP HAVE NOT BEEN DISTURBED SINCE THE DATE OF SURVEY AND SHOULD BE VERIFIED

PRIOR TO USE.

9. THIS PARCEL IS SUBJECT TO ALL EASEMENTS AND AGREEMENTS, BOTH RECORDED AND UNRECORDED. 10. THE PARCEL BOUNDARY HEREON IS SHOWN AS PROPOSED ON THE LAND DIVISION BY CERTIFIED SURVEY MAP THAT IS UNDER LOCAL REVIEW. PARCEL MONUMENTS HAVE NOT BEEN SET IN THE

CURVE TABLE

	BENCHMARKS				
BENCH MARK	ELEVATION	DESCRIPTION			
BM-1	857.88	TOP NUT ON HYDRANT EAST SIDE OF RUSKIN STREET, NW CORNER OF HARTMEYER ICE ARENA PARCEL			
BM-2	851.64	M.A.G. NAIL FOUND, SE CORNER OF SITE, EAST SIDE OF RAILROAD, NORTH SIDE OF COMMERCIAL AVENUE.			





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MADISON REGIONAL OFFICE 161 HORIZON DRIVE, SUITE 101 VERONA, WISCONSIN 53593 P. 608.848.5060

LINCOLN AVENUE CAPITAL

CLIENT ADDRESS: 401 WILSHIRE BLVD, STE 1070 SANTA MONICA, CA 90401

RUSKIN & ROTH **APARTMENTS 2**

PROJECT LOCATION: CITY OF MADISON DANE COUNTY, WI

09/23/22 LAND USE SUBMITTAL

CJO 09/01/22 JK 09/02/22 Approved By: INIT 00/00/00

CONDITIONS

GENERAL NOTES

- ALL WORK IN THE ROW AND/OR PUBLIC EASEMENTS SHALL BE IN ACCORDANCE WITH THE STANDARD
- SPECIFICATIONS FOR SEWER & WATER CONSTRUCTION IN WISCONSIN AND MUNICIPAL REQUIREMENTS. 3. EXISTING GRADE SPOT ELEVATIONS SHOWN FOR INFORMATIONAL PURPOSES. DURING CONSTRUCTION

1. REFER TO THE EXISTING CONDITIONS SURVEY FOR EXISTING CONDITIONS NOTES AND LEGENDS.

- 4. NO SITE GRADING OUTSIDE OR DOWNSLOPE OF PROPOSED SILT FENCE LOCATION. NO LAND DISTURBANCE BEYOND PROPERTY LINES.
- 5. JSD SHALL BE HELD HARMLESS AND DOES NOT WARRANT ANY DEVIATIONS BY THE OWNER/CONTRACTOR FROM THE APPROVED CONSTRUCTION PLANS THAT MAY RESULT IN DISCIPLINARY ACTIONS BY ANY OR ALL REGULATORY AGENCIES.

DEMOLITION NOTES

MATCH EXISTING GRADES AT CONSTRUCTION LIMITS.

- 1. THIS PLAN INDICATES ITEMS ON THE PROPERTY INTENDED FOR DEMOLITION BASED ON THE CURRENT SITE DESIGN THAT HAVE BEEN IDENTIFIED BY A REASONABLE OBSERVATION OF THE EXISTING CONDITIONS THROUGH FIELD SURVEY RECONNAISSANCE, "DIGGER'S HOTLINE" LOCATION, AND GENERAL "STANDARD OF CARE". THERE MAY BE ADDITIONAL ITEMS THAT CAN NOT BE IDENTIFIED BY A REASONABLE ABOVE GROUND OBSERVATION, OF WHICH THE ENGINEER WOULD HAVE NO KNOWLEDGE OR MAY BE A PART OF ANOTHER DESIGN DISCIPLINE. IT IS THE CONTRACTOR'S /BIDDER'S RESPONSIBILITY TO REVIEW THE PLANS, INSPECT THE SITE AND PROVIDE THEIR OWN DUE DILIGENCE TO INCLUDE IN THEIR BID WHAT ADDITIONAL ITEMS, IN THEIR OPINION, MAY BE NECESSARY FOR DEMOLITION. ANY ADDITIONAL ITEMS IDENTIFIED BY THE CONTRACTOR/BIDDER SHALL BE IDENTIFIED IN THE BID AND REPORTED TO THE ENGINEER OF ECORD. JŚD TAKES NO RESPONSIBILITY FOR ITEMS ON THE PROPERTY THAT COULD NOT [LOCATED BY A REASONABLE OBSERVATION OF THE PROPERTY OR OF WHICH THEY WOULD HAVE NO
- CONTRACTOR SHALL KEEP ALL STREETS AND PRIVATE DRIVES FREE AND CLEAR OF ALL
- 3. ALL TREES WITHIN THE CONSTRUCTION LIMITS SHALL BE REMOVED UNLESS SPECIFICALLY CALLED OUT FOR PROTECTION. ALL TREES TO BE REMOVED SHALL BE REMOVED IN THEIR ENTIRETY AND STUMPS SHALL BE GROUND TO PROPOSED SUBGRADE.
- 4. ALL LIGHT POLES TO BE REMOVED SHALL BE REMOVED IN THEIR ENTIRETY. INCLUDING BASE AND ALL APPURTENANCES. SALVAGE FOR RELOCATION. COORDINATE RELOCATION AND/OR ABANDONMENT OF ALL ELECTRIC LINES WITH ELECTRICAL ENGINEER AND OWNER PRIOR TO DEMOLITION.
- ABANDONED/REMOVED ITEMS SHALL BE DISPOSED OF OFF SITE UNLESS OTHERWISE NOTED.
- CONTRACTOR TO REPLACE ALL SIDEWALK AND CURB AND GUTTER ABUTTING THE PROPERTIES, WHICH IS DAMAGED BY THE CONSTRUCTION. OR ANY SIDEWALK AND CURB AND GUTTER THAT THE CITY ENGINEER DETERMINES NEEDS TO BE REPLACED BECAUSE IT IS NOT AT A DESIRABLE GRADE REGARDLESS OF WHETHER THE CONDITION EXISTED PRIOR TO BEGINNING CONSTRUCTION.
- PRIOR TO CONSTRUCTION, THE CONTRACTOR IS RESPONSIBLE FOR: 7.1. EXAMINE ALL SITE CONDITIONS RELATIVE TO THE CONDITIONS INDICATED ON THE ENGINEERING DRAWINGS. ANY DISCREPANCIES ARE TO BE REPORTED IMMEDIATELY TO THE ENGINEER AND RESOLVED PRIOR TO THE START OF CONSTRUCTION.
- 7.2. VERIFYING UTILITY ELEVATIONS AND NOTIFYING ENGINEER OF ANY DISCREPANCIES. NO WORK SHALL BE PERFORMED UNTIL THE DISCREPANCIES ARE RESOLVED.
- 7.3. NOTIFYING ALL UTILITIES PRIOR TO THE REMOVAL OF ANY UNDERGROUND UTILITIES. 7.4. NOTIFYING THE DESIGN ENGINEER AND LOCAL CONTROLLING MUNICIPALITY 48 HOURS PRIOR TO
- THE START OF CONSTRUCTION TO ARRANGE FOR APPROPRIATE CONSTRUCTION INSPECTION. 8. ANY SANITARY SEWER, SANITARY SEWER SERVICES, WATER MAIN, WATER SERVICES, STORM SEWER OR OTHER UTILITIES, WHICH ARE DAMAGED BY THE CONTRACTORS, SHALL BE REPAIRED TO THE
- OWNER'S SATISFACTION AT THE CONTRACTOR'S EXPENSE. 9. CONTRACTOR IS RESPONSIBLE FOR SITE SAFETY DURING THE CONSTRUCTION OF THESE
- 10. CONTRACTOR TO COORDINATE PRIVATE UTILITY REMOVAL / ABANDONMENT AND NECESSARY RELOCATION WITH RESPECTIVE UTILITY COMPANY. COORDINATION REQUIRED PRIOR TO CONSTRUCTION.
- 11. ALL DEMOLITION SHALL BE IN ACCORDANCE WITH THE APPROVED MUNICIPALITY RECYCLING PLAN.
- 12. ANY CONTAMINATED SOILS SHALL BE REMOVED IN ACCORDANCE WITH FEDERAL AND STATE REGULATIONS TO AN APPROVED LANDFILL. CONTRACTOR SHALL REFER TO THE PROJECT MATERIAL HANDLING AND ENVIRONMENTAL REPOTS FOR DETAILS ON SOIL CONTAMINATION.
- 13. ALL EXISTING UTILITIES TO BE FIELD LOCATED AND FLAGGED BY CONTRACTOR.
- 14. SEWER ABANDONMENT SHALL BE IN ACCORDANCE WITH SECTION 3.2.24, OF THE STANDARD SPECIFICATIONS FOR WATER AND SEWER CONSTRUCTION IN WISCONSIN, LATEST ADDITION, AND CITY OF MADISON SPECIFICATIONS.
- 15. WATER ABANDONMENT SHALL BE IN ACCORDANCE WITH SECTION 4.14.0 OF THE STANDARD SPECIFICATIONS FOR WATER AND SEWER CONSTRUCTION IN WISCONSIN, LATEST ADDITION, AND CITY OF MADISON SPECIFICATIONS.
- 16. ALL PERIMETER EROSION CONTROL DEVICES SHALL BE INSTALLED PRIOR TO THE START OF DEMOLITION ACTIVITIES. CONTRACTOR SHALL KEEP ALL STREETS AND PAVEMENT FREE AND CLEAR OF ALL CONSTRUCTION RELATED DIRT, DUST AND DEBRIS.
- 17. BUILDING REMOVALS SHALL BE BY A QUALIFIED CONTRACTOR. CONTRACTOR TO FOLLOW ALL DEMOLITION REGULATIONS, DISCONNECT ALL UTILITIES, OBTAIN ALL APPLICABLE PERMITS AND DISPOSE OF ALL BUILDING MATERIALS IN APPROPRIATE LANDFILLS. DEMOLISHED MATERIALS SHALL NOT BE BURIED ON SITE. IF ENCOUNTERED, ANY CONTAMINATED SOILS SHALL BE REMOVED TO A
- 18. CONTRACTOR TO REMOVE EXISTING UTILITY PIPE OR PROVIDE PIPE BACK-FILLING AFTER REMOVAL OF EXISTING UTILITIES WITHIN BUILDING FOOTPRINT USING "LOW DENSITY CONCRETE/FLOWABLE FILL".

LANDFILL IN ACCORDANCE WITH APPROPRIATE STATE AND FEDERAL REGULATIONS.

19. RESTORATION OF THE EXISTING ROADWAY RIGHT-OF-WAYS ARE CONSIDERED INCIDENTAL AND SHOULD BE PART OF THE COST OF THE UNDERGROUND IMPROVEMENTS, DEMOLITION AND REMOVAL. THIS INCLUDES CURB & GUTTER, SIDEWALK, TOPSOIL, SEEDING AND MULCHING.

PAVING NOTES

1.1. ALL PAVING SHALL CONFORM TO "STATE OF WISCONSIN STANDARD SPECIFICATIONS FOR HIGHWAY & STRUCTURE CONSTRUCTION, LATEST EDITION, APPLICABLE CITY OF MADISON ORDINANCES AND THE GEOTECHNICAL REPORT PREPARED BY CGC, INC. DATED SEPTEMBER 13, 2022.

1.2. ALL PAVING DIMENSIONS ARE TO FACE OF CURB UNLESS SPECIFIED OTHERWISE.

- 1.3. SURFACE PREPARATION NOTIFY ENGINEER/OWNER OF UNSATISFACTORY CONDITIONS. DO NOT BEGIN PAVING WORK UNTIL DEFICIENT SUBBASE AREAS HAVE BEEN CORRECTED AND ARE READY
- 1.4. ANY REQUIRED REPLACEMENT OF PUBLIC CURB AND GUTTER SHALL MATCH EXISTING AND MEET MUNICIPALITY REQUIREMENTS.
- 2. ASPHALTIC CONCRETE PAVING SPECIFICATIONS
- CODES AND STANDARDS THE PLACING, CONSTRUCTION AND COMPOSITION OF THE ASPHALTIC BASE COURSE AND ASPHALTIC CONCRETE SURFACE COURSE SHALL BE IN ACCORDANCE WITH THE REQUIREMENTS OF SECTIONS 450, 455, 460 AND 465 OF THE STATE OF WISCONSIN STANDARD SPECIFICATIONS FOR HIGHWAY AND STRUCTURE CONSTRUCTION, CURRENT EDITION. HEREAFTER, THIS PUBLICATION WILL BE REFERRED TO AS STATE HIGHWAY SPECIFICATIONS.
- 2.2. WEATHER LIMITATIONS APPLY TACK COATS WHEN AMBIENT TEMPERATURE IS ABOVE 50° F (10°) AND WHEN TEMPERATURE HAS NOT BEEN BELOW 35° F (1° C) FOR 12 HOURS IMMEDIATELY PRIOR TO APPLICATION. DO NOT APPLY WHEN BASE IS WET OR CONTAINS EXCESS OF MOISTURE CONSTRUCT ASPHALTIC CONCRETE SURFACE COURSE WHEN ATMOSPHERIC TEMPERATURE IS ABOVE 40° F (4° C) AND WHEN BASE IS DRY AND WHEN WEATHER IS NOT RAINY. BASE COURSE MAY BE PLACED WHEN AIR TEMPERATURE IS ABOVE 30° F $(-1^{\circ} C)$.
- 2.3. GRADE CONTROL ESTABLISH AND MAINTAIN REQUIRED LINES AND ELEVATIONS FOR EACH COURSE DURING CONSTRUCTION.
- 2.4. CRUSHED AGGREGATE BASE COURSE THE TOP LAYER OF BASE COURSE SHALL CONFORM TO SECTIONS 301 AND 305, STATE HIGHWAY SPECIFICATIONS.
- 2.5. BINDER COURSE AGGREGATE THE AGGREGATE FOR THE BINDER COURSE SHALL CONFORM TO SECTIONS 460 AND 315, STATE HIGHWAY SPECIFICATIONS.
- 2.6. SURFACE COURSE AGGREGATE THE AGGREGATE FOR THE SURFACE COURSE SHALL CONFORM TO SECTIONS 460 AND 465, STATE HIGHWAY SPECIFICATIONS.
- 2.7. ASPHALTIC MATERIALS THE ASPHALTIC MATERIALS SHALL CONFORM TO SECTION 455 AND 460, STATE HIGHWAY SPECIFICATIONS.
- CONCRETE PAVING SHALL BE IN ACCORDANCE WITH THE REQUIREMENTS OF SECTIONS 415 AND 416 OF THE STATE HIGHWAY SPECIFICATIONS.
- 3.2. CONCRETE PAVEMENT SHALL BE REINFORCED WITH NOVOMESH 950 (OR EQUAL) FIBER REINFORCEMENT AT A RATE OF 5 LBS/CUBIC YARD.
- 3.3. CURING COMPOUNDS SHALL CONFORM TO SECTION 415 OF THE STATE HIGHWAY SPECIFICATIONS. 3.4. CONTRACTOR SHALL PROVIDE CONTROL JOINTS AND CONSTRUCTION JOINTS OF ONE-QUARTER
- CONCRETE THICKNESS AT AN EQUAL RATIO OF LENGTH TO WIDTH WHEREVER POSSIBLE WITH A MAXIMUM LENGTH BETWEEN JOINTS OF 8' ON CENTER.
- 3.5. CONTRACTOR SHALL PROVIDE EXPANSION JOINTS IN SIDEWALKS AT A MAXIMUM 24' ON CENTER. 3.6. EXTERIOR CONCRETE SURFACES SHALL BE BROOM FINISHED.
- 3.7. ALL CONCRETE SURFACES TO BE SEALED WITH TYPE TK-26UV CONCRETE SEALANT.
- 4. PAVEMENT MARKING SPECIFICATIONS

3. <u>CONCRETE PAVING SPECIFICATIONS</u>

- 4.1. USE 4" WIDE, HIGH VISIBILITY YELLOW LATEX PAINT FOR STALL LINES.
- 4.2. MARK AND STRIPE ADA PARKING SPACES APPROPRIATELY.
- 4.3. ALL PAVEMENT MARKINGS INCLUDING: STOP BARS, CROSSWALKS, DIRECTIONAL ARROWS, PARKING STALL LINES, ADA STALL MARKINGS, NO PARKING ZONES, DROP-OFF/PICK-UP ZONES SHALL BE PAINTED WITH LATEX PAINT PER SPECIFICATIONS.
- 4.4. 2' x 4' TRUNCATED DOME WARNING DETECTION FIELD SHALL BE PLACED AT ALL ADA RAMPS.

GRADING AND SEEDING NOTES

- 1. ALL PROPOSED GRADES SHOWN ARE FINISHED GRADES. CONTRACTOR SHALL VERIFY ALL GRADES, MAKE SURE ALL AREAS DRAIN PROPERLY AND SHALL REPORT ANY DISCREPANCIES TO THE ENGINEER PRIOR TO CONSTRUCTION.
- 2. CONTRACTOR SHALL ASSUME SOLE RESPONSIBILITY FOR COMPUTATIONS OF ALL GRADING QUANTITIES. WHILE JSD PROFESSIONAL SERVICES, INC. ATTEMPTS TO PROVIDE A COST EFFECTIVE APPROACH TO BALANCE EARTHWORK, GRADING DESIGN IS BASED ON MANY FACTORS, INCLUDING SAFETY AESTHETICS, AND COMMON ENGINEERING STANDARDS OF CARE. THEREFORE, NO GUARANTEE CAN BE MADE FOR A BALANCED SITE.
- 3. PARKING LOT AND DRIVEWAY ELEVATIONS ARE PAVEMENT GRADES, NOT TOP OF CURB GRADES, UNLESS OTHERWISE NOTED.
- 4. ANY WORK WITHIN RIGHT-OF-WAY SHALL BE PROPERLY PERMITTED AND COORDINATED WITH THE APPROPRIATE OFFICIALS PRIOR TO COMMENCEMENT OF ANY CONSTRUCTION ACTIVITIES. ALL GRADING WITHIN RIGHT-OF-WAY IS SUBJECT TO APPROVAL BY SAID OFFICIALS.
- CONTRACTOR SHALL PROVIDE NOTICE TO THE MUNICIPALITY IN ADVANCE OF ANY SOIL DISTURBING ACTIVITIES, IN ACCORDANCE WITH MUNICIPAL REQUIREMENTS.
- 6. ALL DISTURBED AREAS SHALL BE SODDED AND/OR SEEDED AND MULCHED IMMEDIATELY FOLLOWING GRADING ACTIVITIES. SOD/SEED MIX TO BE IN ACCORDANCE WITH LANDSCAPE PLAN.
- 7. CONTRACTOR SHALL CHISEL-PLOW OR DEEP TILL WITH DOUBLE TINES ALL STORMWATER MANAGEMENT FACILITIES JUST PRIOR TO SODDING AND/OR SEEDING AND MULCHING TO PROMOTE INFILTRATION.
- 8. CONTRACTOR SHALL WATER ALL NEWLY SODDED/SEEDED AREAS DURING THE SUMMER MONTHS WHENEVER THERE IS A 7 DAY LAPSE WITH NO SIGNIFICANT RAINFALL.
- 9. CONTRACTOR TO DEEP TILL ALL COMPACTED PERVIOUS SURFACES PRIOR TO SODDING AND/OR SEEDING AND MULCHING.
- 10. ALL SLOPES 20% OR GREATER SHALL BE TEMPORARY SEEDED, MULCHED, OR OTHER MEANS OF COVER PLACED ON THEM WITHIN 2 WEEKS OF DISTURBANCE.
- 11. ALL EXPOSED SOIL AREAS THAT WILL NOT BE BROUGHT TO FINAL GRADE OR ON WHICH LAND DISTURBING ACTIVITIES WILL NOT BE PERFORMED FOR A PERIOD GREATER THAN 30 DAYS AND REQUIRE VEGETATIVE COVER FOR LESS THAN 1 YEAR, REQUIRE TEMPORARY SEEDING FOR EROSION CONTROL. SEEDING FOR EROSION CONTROL SHALL BE IN ACCORDANCE WITH WDNR TECHNICAL STANDARD 1059 AND CITY OF MADISON ORDINANCE.

JTILITY NOTES

- . ALL EXISTING UTILITIES ARE SHOWN FOR INFORMATIONAL PURPOSES ONLY AND ARE NOT GUARANTEED O BE ACCURATE OR ALL INCLUSIVE. THE CONTRACTOR IS RESPONSIBLE FOR MAKING HIS OWN DETERMINATION AS TO THE TYPE AND LOCATIONS OF UNDERGROUND UTILITIES AS MAY BE NECESSARY TO AVOID DAMAGE THERETO. CONTRACTOR/OWNER SHALL CALL "DIGGER'S HOTLINE" PRIOR TO ANY CONSTRUCTION.
- PRIOR TO CONSTRUCTION, THE PRIME CONTRACTOR IS RESPONSIBLE FOR: EXAMINING ALL SITE CONDITIONS RELATIVE TO THE CONDITIONS INDICATED ON THE ENGINEERING DRAWINGS. ANY DISCREPANCIES ARE TO BE REPORTED TO THE ENGINEER AND RESOLVED PRIOR TO THE START OF CONSTRUCTION. OBTAINING ALL PERMITS INCLUDING PERMIT COSTS, TAP FEES, METER DEPOSITS, BONDS, AND

ALL OTHER FEES REQUIRED FOR PROPOSED WORK TO OBTAIN OCCUPANCY.

AND CHECK ALL UTILITY CROSSINGS FOR CONFLICTS. NOTIFY ENGINEER OF ANY DISCREPANCY. NO WORK SHALL BE PERFORMED UNTIL THE DISCREPANCY IS RESOLVED. NOTIFYING ALL UTILITIES PRIOR TO INSTALLATION OF ANY UNDERGROUND IMPROVEMENTS. NOTIFYING THE DESIGN ENGINEER AND MUNICIPALITY 48 HOURS PRIOR TO THE START OF CONSTRUCTION TO ARRANGE FOR APPROPRIATE CONSTRUCTION OBSERVATION. COORDINATING ALL CONSTRUCTION WITH OTHER CONTRACTORS INVOLVED WITH CONSTRUCTION

VERIFYING ALL ELEVATIONS, LOCATIONS AND SIZES OF SANITARY, WATER AND STORM LATERALS

OF THE PROPOSED DEVELOPMENT AND FOR REPORTING ANY ERRORS OR DISCREPANCIES BETWEEN THESE PLANS AND PLANS PREPARED BY OTHERS. ALL UTILITY WORK SHALL BE DONE IN ACCORDANCE WITH THE STANDARD SPECIFICATIONS FOR SEWER AND WATER CONSTRUCTION IN WISCONSIN - AND ALL STATE AND LOCAL CODES AND SPECIFICATIONS.

IT IS THE CONTRACTORS RESPONSIBILITY TO DETERMINE WHICH SPECIFICATIONS AND CODES APPLY

- AND TO COORDINATE ALL CONSTRUCTION ACTIVITIES WITH THE APPROPRIATE LOCAL AND STATE 4. SPECIFICATIONS SHALL COMPLY WITH THE CITY OF MADISON SPECIAL PROVISIONS.
- . LENGTHS OF ALL UTILITIES ARE TO CENTER OF STRUCTURES OR FITTINGS AND MAY VARY SLIGHTLY FROM PLAN. LENGTHS SHALL BE VERIFIED IN THE FIELD DURING CONSTRUCTION.
- 6. CONTRACTOR IS RESPONSIBLE FOR SITE SAFETY DURING THE CONSTRUCTION OF IMPROVEMENTS. 7. CONTRACTOR SHALL INSTALL A PEDESTRIAN FENCE AROUND ALL EXCAVATIONS TO BE LEFT OPEN OVER NIGHT AS REQUIRED IN CONSTRUCTION SITES WHERE THE POTENTIAL FOR PEDESTRIAN INJURY
- . CONTRACTOR SHALL ADJUST AND/OR RECONSTRUCT ALL UTILITY COVERS (SUCH AS MANHOLE COVERS,
- VALVE BOX COVERS, ETC.) TO MATCH THE FINISHED GRADES OF THE AREAS EFFECTED BY THE . THE PRIME CONTRACTOR IS RESPONSIBLE FOR COORDINATING ALL CONSTRUCTION WITH OTHER
- ANY ERRORS OR DISCREPANCIES BETWEEN THESE PLANS AND PLANS PREPARED BY OTHERS. 10. ANY SANITARY SEWER, SANITARY SEWER SERVICES, WATER MAIN, WATER SERVICES, STORM SEWER OR OTHER UTILITIES, WHICH ARE DAMAGED BY THE CONTRACTORS, SHALL BE REPAIRED TO THE

CONTRACTORS INVOLVED WITH CONSTRUCTION OF THE PROPOSED DEVELOPMENT AND FOR REPORTING

- 11. THE CONTRACTOR IS RESPONSIBLE FOR PROVIDING THE ENGINEER WITH AS—BUILT CONDITIONS OF THE DESIGNATED IMPROVEMENTS IN ORDER THAT THE APPROPRIATE DRAWINGS CAN BE PREPARED, REQUIRED. ANY CHANGES TO THE DRAWINGS OR ADDITIONAL ITEMS MUST BE REPORTED TO THE ENGINEER AS WORK PROGRESSES.
- 12. STORM SEWER SPECIFICATIONS

OWNER'S SATISFACTION AT THE CONTRACTOR'S EXPENSE.

- PIPE REINFORCED CONCRETE PIPE (RCP) SHALL MEET THE REQUIREMENTS OF ASTM CLASS III (MINIMUM) C-76 WITH RUBBER GASKET JOINTS CONFORMING TO ASTM C-443. HIGH DENSITY DUAL-WALL POLYETHYLENE CORRUGATED PIPE SHALL BE AS MANUFACTURED BY ADS OR EQUAL WITH WATER TIGHT JOINTS, AND SHALL MEET THE REQUIREMENTS OF AASHTO DESIGNATION M-294 TYPE
- INLETS INLETS SHALL BE CONSTRUCTED IN ACCORDANCE WITH FILE. NO. 28 OF THE "STANDARD SPECIFICATIONS", OR APPROVED EQUAL WITH A 1'-8" X 2'-6" MAXIMUM OPENING. CURB FRAME & GRATE SHALL BE NEENAH R-3067 WITH TYPE R GRATE, OR EQUAL. BACKFILL AND BEDDING — STORM SEWER SHALL BE CONSTRUCTED WITH GRAVEL BACKFILL AND CLASS B" BEDDING IN ALL PAVED AREAS AND TO A POINT 5 FEET BEYOND THE EDGE OF PAVEMENT.
- TRENCHES RUNNING PARALLEL TO AND LESS THAN 5 FEET FROM THE EDGE OF PAVEMENT SHALL ALSO REQUIRE GRAVEL BACKFILL. LANDSCAPED AREAS MAY BE BACKFILLED WITH EXCAVATED MATERIAL IN CONFORMANCE WITH SECTION 8.43.5 OF THE "STANDARD SPECIFICATIONS". MANHOLE FRAMES AND COVERS - MANHOLE FRAMES AND COVERS SHALL REFER TO SHEET C5.0.
- FIELD TILE CONNECTION ALL FIELD TILE ENCOUNTERED DURING CONSTRUCTION SHALL BE INCLUDED IN THE UNIT PRICE(S) FOR STORM SEWER. TILE LINES CROSSED BY THE TRENCH SHALL BE REPLACED WITH THE SAME MATERIAL AS THE STORM SEWER.
- PIPE DUCTILE IRON PIPE SHALL BE CLASS 52 CONFORMING TO AWWA C151 AND CHAPTER 8.18.0 OF THE "STANDARD SPECIFICATIONS". POLYVINYL CHLORIDE (PVC) PIPE SHALL MEET THE REQUIREMENTS OF AWWA STANDARD C-900, CLASS 150, DR-18, WITH CAST IRON O.D. AND INTEGRAL ELASTOMERIC BELL AND SPIGOT JOINTS. NON-METALLIC WATER MAINS SHALL BE INSTALLED WITH BLUE INSULATION TRACER WIRE AND CONFORM WITH SPS 382.30(11)(h).
- VALVES AND VALVE BOXES GATE VALVES SHALL BE AWWA GATE VALVES MEETING THE REQUIREMENTS OF AWWA C-500 AND CHAPTER 8.27.0 OF THE "STANDARD SPECIFICATIONS". GATE VALVES AND VALVE BOXES SHALL CONFORM TO LOCAL PLUMBING ORDINANCES. HYDRANTS — HYDRANTS SHALL CONFORM TO THE SPECIFICATIONS OF THE CITY OF MADISON. THI DISTANCE FROM THE GROUND LINE TO THE CENTERLINE OF THE LOWEST NOZZLE AND THE LOWEST CONNECTION OF THE FIRE DEPARTMENT SHALL BE NO LESS THAN 18-INCHES AND NO GREATER THAN
- BEDDING AND COVER MATERIAL PIPE BEDDING AND COVER MATERIAL SHALL BE SAND, CRUSHED STONE CHIPS OR CRUSHED STONE SCREENINGS CONFORMING TO CHAPTER 8.43.2 OF THE "STANDARD SPECIFICATIONS". BACKFILL - BACKFILL MATERIAL AND INSTALLATION SHALL BE IN ACCORDANCE WITH CHAPTER 2.6.0

OF THE "STANDARD SPECIFICATIONS". GRAVEL BACKFILL IS REQUIRED IN ALL PAVED AREAS AND TO A

POINT 5 FEET BEYOND THE EDGE OF PAVEMENT. TRENCHES RUNNING PARALLEL TO AND LESS THAN 5

FEET FROM THE EDGE OF PAVEMENT SHALL ALSO REQUIRE GRAVEL BACKFILL. LANDSCAPED AREAS

MAY BE BACKFILLED WITH EXCAVATED MATERIAL IN CONFORMANCE WITH SECTION 8.43.5 OF THE

"STANDARD SPECIFICATIONS". 14. SANITARY SEWER SPECIFICATIONS -

13. WATER MAIN SPECIFICATIONS -

- PIPE SANITARY SEWER PIPE MATERIAL SHALL BE POLYVINYL CHLORIDE (PVC) MEETING REQUIREMENTS OF ASTM D 3034, SDR—35, WITH INTEGRAL BELL TYPE FLEXIBLE ELASTOMERIC JOINTS, MEETING THE REQUIREMENTS OF ASTM D-3212.
- BEDDING AND COVER MATERIAL BEDDING AND COVER MATERIAL SHALL CONFORM TO THE APPROPRIATE SECTIONS OF THE "STANDARD SPECIFICATION" WITH THE FOLLOWING MODIFICATION: "COVER MATERIAL SHALL BE THE SAME AS USED FOR BEDDING AND SHALL CONFORM TO SECTION 8.43.2 (A). BEDDING AND COVER MATERIAL SHALL BE PLACED IN A MINIMUM OF THREE SEPARATE LIFTS, OR AS REQUIRED TO INSURE ADEQUATE COMPACTING OF THESE MATERIALS, WITH ONE LIFT OF BEDDING MATERIAL ENDING AT OR NEAR THE SPRINGLINE OF THE PIPE. THE CONTRACTOR SHALL TAKI CARE TO COMPLETELY WORK BEDDING MATERIAL UNDER THE HAUNCH OF THE PIPE TO PROVIDE ADEQUATE SIDE SUPPORT.
- BACKFILL BACKFILL MATERIAL AND INSTALLATION SHALL BE IN ACCORDANCE CHAPTER 2.6.0 OF THE "STANDARD SPECIFICATIONS." GRAVEL BACKFILL IS REQUIRED IN ALL PAVED AREAS AND TO A POINT 5 FEET BEYOND THE EDGE OF PAVEMENT. TRENCHES RUNNING PARALLEL TO AND LESS THAN 5 FEET FROM THE EDGE OF PAVEMENT SHALL ALSO REQUIRE GRAVEL BACKFILL. LANDSCAPED AREAS MAY BE BACKFILLED WITH EXCAVATED MATERIAL IN CONFORMANCE WITH SECTION 8.43.5 OF THE "STANDARD
- MANHOLES MANHOLES SHALL BE CONSTRUCTED IN ACCORDANCE WITH FILE NOS. 12, 13 AND 15 OF THE "STANDARD SPECIFICATIONS" AND ALL SPECIAL PROVISIONS OF THE CITY OF MADISON. MANHOLE FRAMES AND COVERS - MANHOLE FRAMES AND COVERS SHALL REFER TO SHEET C5.0.
- 15. WATERMAIN AND SANITARY SEWER SHALL BE INSULATED WHEREVER THE DEPTH OF COVER IS LESS THAN 6 FEET. INSULATION AND INSTALLATION OF INSULATION SHALL BE CONFORMING WITH CHAPTER 4.17.0 "INSULATION" OF THE STANDARD SPECIFICATIONS FOR SEWER AND WATER CONSTRUCTION IN WISCONSIN 6TH EDITION UPDATED WITH ITS LATEST ADDENDUM (TYP.).

EROSION CONTROL NOTES

REPLACED IMMEDIATELY UPON INSPECTION.

AND AS REQUESTED BY THE CITY OF MADISON.

THE APPROVED PLANS.

- CONTRACTOR IS RESPONSIBLE TO NOTIFY ENGINEER OF RECORD AND OFFICIALS OF ANY CHANGES TO THE EROSION CONTROL AND STORMWATER MANAGEMENT PLANS. ENGINEER OF RECORD AND APPROPRIATE CITY OF MADISON OFFICIALS MUST APPROVE ANY CHANGES PRIOR TO DEVIATION FROM
- 2. ALL EROSION CONTROL MEASURES SHALL BE CONSTRUCTED AND MAINTAINED BY THE CONTRACTOR IN ACCORDANCE WITH THE WISCONSIN DEPARTMENT OF NATURAL RESOURCES (WDNR) TECHNICAL STANDARDS (REFERRED TO AS BMP'S) AND CITY OF MADISON ORDINANCE. IT IS THE CONTRACTOR'S RESPONSIBILITY TO OBTAIN A COPY´OF THESE STANDARDS. CONTRACTOR SHALL BE RESPONSIBLE FOR ANY ADDITIONAL EROSION CONTROL MEASURES WHICH MAY BE NECESSARY TO MEET UNFORESEEN FIELD CONDITIONS.
- INSTALL PERIMETER EROSION CONTROL MEASURES (SUCH AS CONSTRUCTION ENTRANCES, SILT FENCE AND EXISTING INLET PROTECTION) PRIOR TO ANY SITE WORK, INCLUDING GRADING OR DISTURBANCE OF EXISTING SURFACE COVER, AS SHOWN ON PLAN. MODIFICATIONS TO THE APPROVED EROSION CONTROL DESIGN IN ORDER TO MEET UNFORESEEN FIELD CONDITIONS IS ALLOWED IF MODIFICATIONS CONFORM TO BMP'S. ALL DESIGN MODIFICATIONS MUST BE APPROVED BY THE CITY OF MADISON
- PRIOR TO DEVIATION OF THE APPROVED PLAN. 4. ADDITIONAL EROSION CONTROL MEASURES, AS REQUESTED BY STATE INSPECTORS, LOCAL INSPECTORS,
- COUNTY INSPECTORS AND/OR ENGINEER OF RECORD SHALL BE INSTALLED WITHIN 24 HOURS OF 5. INSPECTIONS AND MAINTENANCE OF ALL EROSION CONTROL MEASURES SHALL BE ROUTINE (ONCE PER
- CONTROL MEASURES ARE TO BE IN WORKING ORDER AT THE END OF EACH WORK DAY. 6. ALL EROSION AND SEDIMENT CONTROL ITEMS SHALL BE INSPECTED WITHIN 24 HOURS OF ALL RAIN EVENTS EXCEEDING 0.5 INCHES. ANY DAMAGED EROSION CONTROL MEASURES SHALL BE REPAIRED OR

WEEK MINIMUM) TO ENSURE PROPER FUNCTION OF EROSION CONTROLS AT ALL TIMES. EROSION

7. CONSTRUCTION ENTRANCES SHALL BE INSTALLED AT ALL LOCATIONS OF VEHICLE INGRESS/EGRESS POINTS. ADDITIONAL LOCATIONS OTHER THAN AS SHOWN ON THE PLANS MUST BE PRIOR APPROVED BY THE MUNICIPALITY. CONSTRUCTION ENTRANCES SHALL BE 50' LONG AND NO LESS THAN 12" THICK BY USE OF 3" CLEAR STONE. CONSTRUCTION ENTRANCES SHALL BE MAINTAINED BY THE CONTRACTOR IN A CONDITION WHICH WILL PREVENT THE TRACKING OF MUD OR DRY SEDIMENT ONTO

ADJACENT PUBLIC STREETS AFTER EACH WORKING DAY OR MORE FREQUENTLY AS REQUIRED.

- PAVED SURFACES ADJACENT TO CONSTRUCTION SITE VEHICLE ACCESS SHALL BE SWEPT AND/OR SCRAPED TO REMOVE ACCUMULATED SOIL, DIRT AND/OR DUST AFTER THE END OF EACH WORK DAY
- 9. INLET PROTECTION SHALL BE IMMEDIATELY FITTED AT THE INLET OF ALL INSTALLED STORM SEWER AND SILT FENCE SHALL BE IMMEDIATELY FITTED AT ALL INSTALLED CULVERT INLETS TO PREVENT SEDIMENT DEPOSITION WITHIN STORM SEWER SYSTEMS.
- 10. INSTALL EROSION CONTROLS ON THE DOWNSTREAM SIDE OF STOCKPILES. IF STOCKPILE REMAINS UNDISTURBED FOR MORE THAN SEVEN (7) DAYS, TEMPORARY SEEDING AND STABILIZATION IN ACCORDANCE WITH BEST MANAGEMENT PRACTICES IS REQUIRED. IF DISTURBANCE OCCURS BETWEEN NOVEMBER 15TH AND MAY 15TH, THE MULCHING SHALL BE PERFORMED BY HYDRO-MULCHING WITH A
- 11. DITCH CHECKS AND APPLICABLE EROSION NETTING/MATTING SHALL BE INSTALLED IMMEDIATELY AFTER COMPLETION OF GRADING EFFORTS WITHIN DITCHES/SWALES TO PREVENT SOIL TRANSPORTATION. 12. EROSION CONTROL FOR UTILITY CONSTRUCTION (STORM SEWER, SANITARY SEWER, WATER MAIN, ETC.):
- A. PLACE EXCAVATED TRENCH MATERIAL ON THE HIGH SIDE OF THE TRENCH. B. BACKFILL, COMPACT, AND STABILIZE THE TRENCH IMMEDIATELY AFTER PIPE CONSTRUCTION. DISCHARGE TRENCH WATER INTO A SEDIMENTATION BASIN OR FILTERING TANK IN ACCORDANCE WITH THE DEWATERING TECHNICAL STANDARD NO. 1061 PRIOR TO RELEASE INTO THE STORM SEWER, RECEIVING STREAM, OR DRAINAGE DITCH.
- 13. ALL SLOPES 4:1 OR GREATER SHALL BE STABILIZED WITH CLASS I, TYPE B EROSION MATTING OR APPLICATION OF A WISCONSIN DEPARTMENT OF TRANSPORTATION (WisDOT) APPROVED POLYMER SOIL STABILIZATION TREATMENT OR A COMBINATION THEREOF, AS REQUIRED WITHIN 7 DAYS OF REACHING FINAL GRADE AND/OR AS SOON AS CONDITIONS ALLOW. DRAINAGE SWALES SHALL BE STABILIZED WITH CLASS II, TYPE B EROSION MATTING. EROSION MATTING AND/OR NETTING USED ONSITE SHALL BE INSTALLED IN ACCORDANCE WITH MANUFACTURER'S GUIDELINES AND WDNR TECHNICAL STANDARDS
- 14. CONTRACTOR SHALL TAKE ALL NECESSARY STEPS TO CONTROL DUST ARISING FROM CONSTRUCTION OPERATIONS. REFER TO WDNR TECHNICAL STANDARD 1068.
- 15. EROSION CONTROL MEASURES SHALL NOT BE REMOVED UNTIL ALL LAND DISTURBING CONSTRUCTION ACTIVITY AT THE SITE HAS BEEN COMPLETED AND THAT A UNIFORM PERENNIAL VEGETATIVE COVER HAS BEEN ESTABLISHED WITH A DENSITY OF AT LEAST 70% FOR UNPAVED AREAS AND AREAS NOT COVERED BY PERMANENT STRUCTURES OR THAT EMPLOY EQUIVALENT PERMANENT STABILIZATION
- 16. CONTRACTOR/OWNER SHALL FILE A NOTICE OF TERMINATION UPON COMPLETION OF THE PROJECT IN ACCORDANCE WITH WDNR REQUIREMENTS AND/OR PROPERTY SALE IN ACCORDANCE WITH WDNR 17. STABILIZATION PRACTICES:
- STABILIZATION MEASURES SHALL BE INITIATED AS SOON AS PRACTICABLE IN PORTIONS OF THE SITE WHERE CONSTRUCTION ACTIVITIES HAVE TEMPORARILY OR PERMANENTLY CEASED. NO MORE THAN SEVEN (7) DAYS SHALL PASS AFTER THE CONSTRUCTION ACTIVITY IN THAT PORTION OF THE SITE HAS CEASED UNLESS:
- THE INITIATION STABILIZATION MEASURES BY THE SEVENTH (7) DAY AFTER CONSTRUCTION ACTIVITY HAS CEASED IS PRECLUDED BY SNOW COVER. IN THAT EVENT, STABILIZATION SHALL BE INITIATED AS SOON AS PRACTICABLE. CONSTRUCTION ACTIVITY WILL RESUME ON A PORTION OF THE SITE WITHIN FOURTEEN (14) DAYS FROM WHEN ACTIVITY CEASED, (I.E. THE TOTAL TIME PERIOD THAT THE CONSTRUCTION
- ACTIVITY IS TEMPORARILY CEASED IS LESS THAN FOURTEEN (14) DAYS. IN THAT EVENT STABILIZATION MEASURES DO NOT HAVE TO BE INITIATED ON THAT PORTION OF THE SITE BY THE SEVENTH (7) DAY AFTER CONSTRUCTION ACTIVITY HAS TEMPORARILY CEASED. STABILIZATION MEÀSÚRES SHALL BE DETERMINED BASED ON SITE CONDITIONS AT THE TIME CONSTRUCTION ACTIVITY HAS CEASED, INCLUDING BUT NOT LIMITED TO WEATHER CONDITIONS AND LENGTH OF TIME MEASURE MUST BE EFFECTIVE. THE FOLLOWING ARE
 - ACCEPTABLE STABILIZATION MEASURES: PERMANENT SEEDING; IN ACCORDANCE WITH APPROVED CONSTRUCTION SPECIFICATION • TEMPORARY SEEDING, MAY CONSIST OF SPRING OATS(100LBS/ACRE) AND/OR WHEAT OR CEREAL RYE (150LB/ACRE)
 - HYDRO-MULCHING WITH A TACKIFIER GEOTEXTILE EROSION MATTING SODDING

STORMWATER FACILITIES CONSTRUCTION NOTES

WHERE PROPOSED STORMWATER MANAGEMENT FACILITIES ARE LOCATED.

RATES SHALL BE EQUAL TO OR GREATER THAN DESIGN INFILTRATION RATES.

MATERIALS CONFORMING TO SPECIFICATIONS PER WDNR TECH STANDARD 1004.

- 1. ENGINEER SHALL BE NOTIFIED PRIOR TO INSTALLATION OF STORMWATER MANAGEMENT FACILITIES. CONSTRUCTION OF STORMWATER MANAGEMENT FACILITIES SHALL BE OBSERVED AND DOCUMENTED BY
- THE ENGINEER, OR AN OWNER'S REPRESENTATIVE. STORMWATER MANAGEMENT FACILITIES SHALL BE INSTALLED AFTER SUBSTANTIAL COMPLETION OF FINAL SITE GRADING AND SOILS HAVE BEEN STABILIZED.
- 3. AREAS USED FOR TEMPORARY SEDIMENT BASINS SHALL BE REMOVED IN THEIR ENTIRETY AFTER CONSTRUCTION OF STORMWATER MANAGEMENT FACILITIES. 4. CONSTRUCTION TRAFFIC, HEAVY EQUIPMENT AND SOIL STOCKPILES SHALL NOT BE PLACED IN AREAS
- 5. NATIVE SOIL INFILTRATION RATES BELOW STORMWATER FACILITIES SHALL BE VERIFIED BY THE OWNER'S GEOTECHNICAL ENGINEER PRIOR INSTALLATION OF FACILITIES. NATIVE SOIL INFILTRATION
- 6. NATIVE SOILS SHALL BE BLENDED A MINIMUM OF TWO FEET PRIOR TO INSTALLATION OF STORMWATER INFILTRATION FACILITIES TO BREAKUP ANY LOWER PERMEABILITY SEAMS THAT MAY BE PRESENT. 7. THICKER SILT OR CLAY LAYERS SHALL BE OVER-EXCAVATED AND BACKFILLED WITH GRANULAR

LEGEND

PROPERTY LINE ----- EASEMENT LINE BUILDING OUTLINE ---- BUILDING OVERHANG --- BUILDING SETBACK LINE

STANDARD CURB AND GUTTER REJECT CURB AND GUTTER MOUNTABLE CURB AND GUTTER 8" CONCRETE RIBBON CURB ASPHALT PAVEMENT HEAVY DUTY ASPHALT PAVEMENT

EDGE OF PAVEMENT

—— —— PAVEMENT SETBACK LINE

CONCRETE PAVEMENT 4 4 4 HEAVY DUTY CONCRETE PAVEMENT 959—PROPOSED 1 FOOT CONTOUR -----960 PROPOSED 5 FOOT CONTOUR — — ·959· — — EXISTING 1 FOOT CONTOUR ----960--- EXISTING 5 FOOT CONTOUR

DRAINAGE DIRECTION - - GRADE BREAK ----- STORMWATER MANAGEMENT AREA RETAINING WALL

——X FENCE LIGHT POLE (REFER TO PHOTOMETRIC PLAN) ADA PARKING SIGN

BOLLARD WITH ADA PARKING SIGN BIKE RACK

TREE REMOVAL

WATERMAIN

FLAG POLE

SHRUB REMOVAL SAWCUT EXISTING PAVEMENT S SANITARY SEWER

· BOULDER WALL

D STORM SEWER 8'x4'x4" INSULATION (PLAN VIEW) 8'x4'x4" INSULATION (PROFILE VIEW) —sf—sf—sf— SILT FENCE

RIP-RAP

CONSTRUCTION ENTRANCE EROSION MATTING TURF REINFORCEMENT MATTING

> SPOT ELEVATION EP - EDGE OF PAVEMENT FG - FINISH GRADE EC - EDGE OF CONCRETE FG: XXX.XX BOC - BACK OF CURB MATCH - MATCH EXISTING GRADE HP - HIGH POINT

> > DITCH CHECK

INLET PROTECTION

SW - SIDEWALK



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JLA PROJECT NUMBER:



W22-0128-0



HARTMEYER REDEVELOPMENT: FAMILY HOUSING

2007 ROTH STREET

LAND USE APPLICATION

KEY PLAN

PROGRESS DOCUMENTS These documents reflect progress and intent and may be subject to change, including additional detail. These are not final construction documents and should not be used for final bidding or


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construction-related purposes.

HEET NUMBER

GENERAL **NOTES AND LEGEND**

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HARTMEYER
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FAMILY HOUSING

2007 ROTH STREET LOT 2

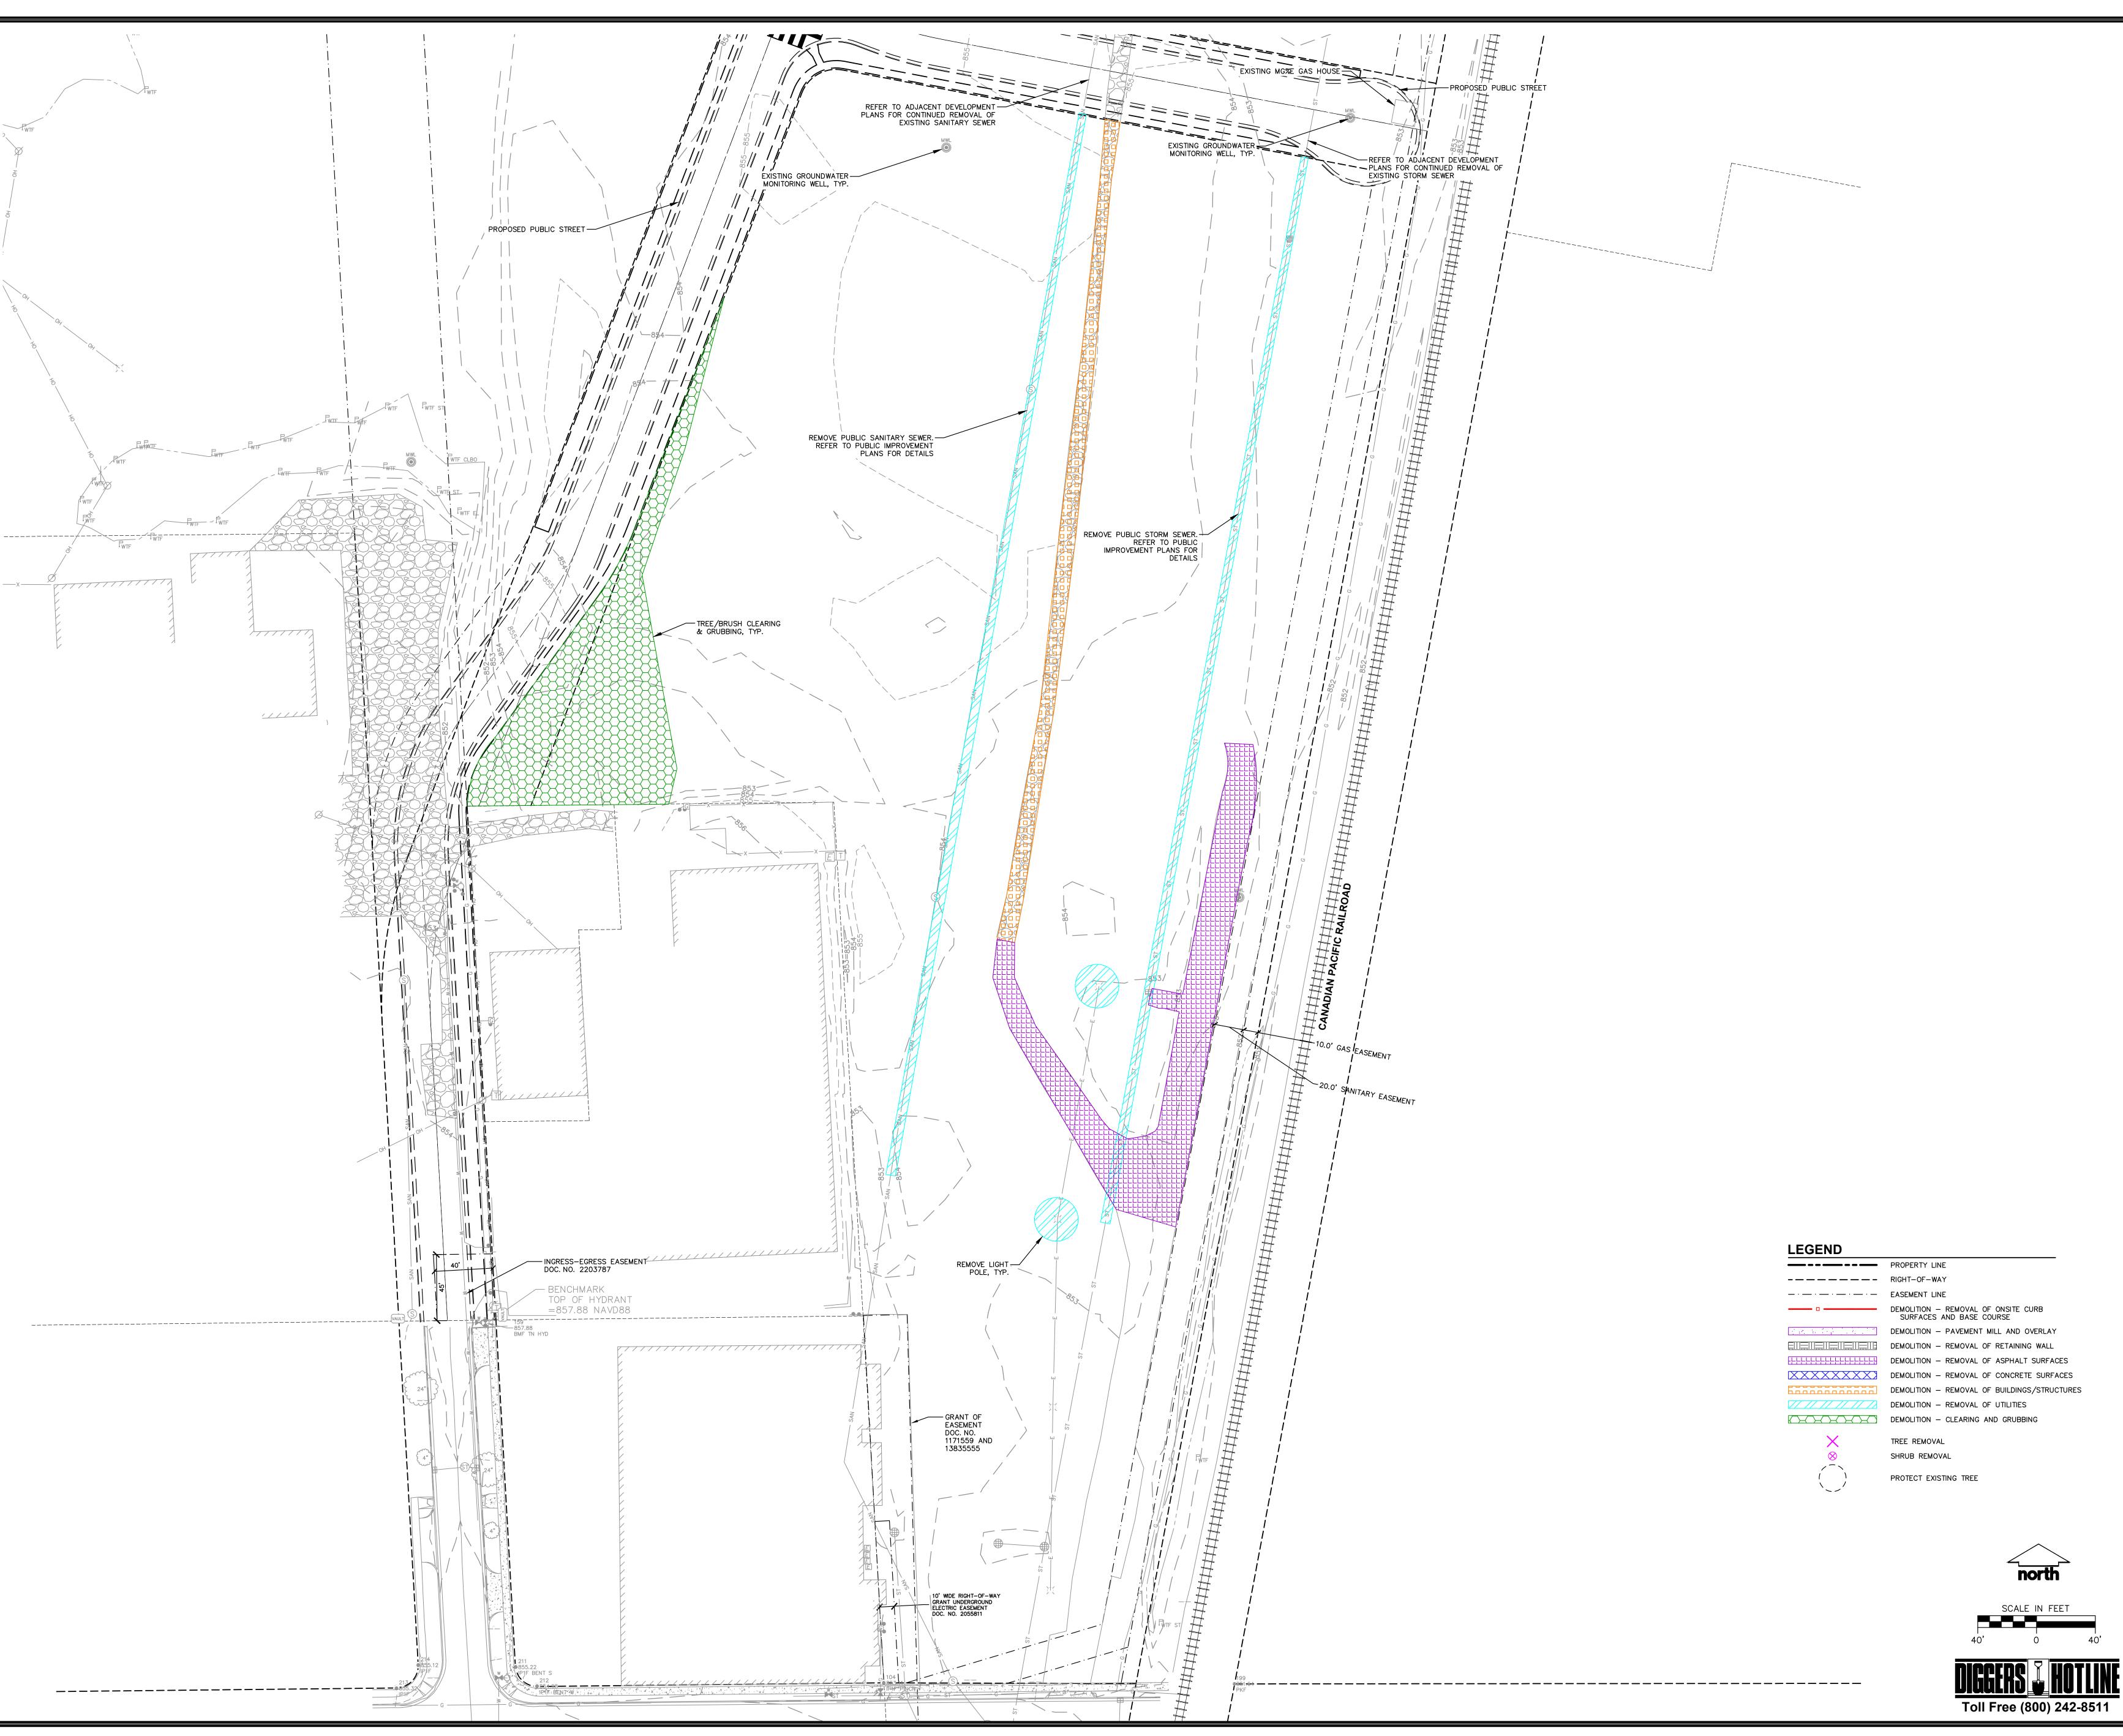LAND USE APPLICATION

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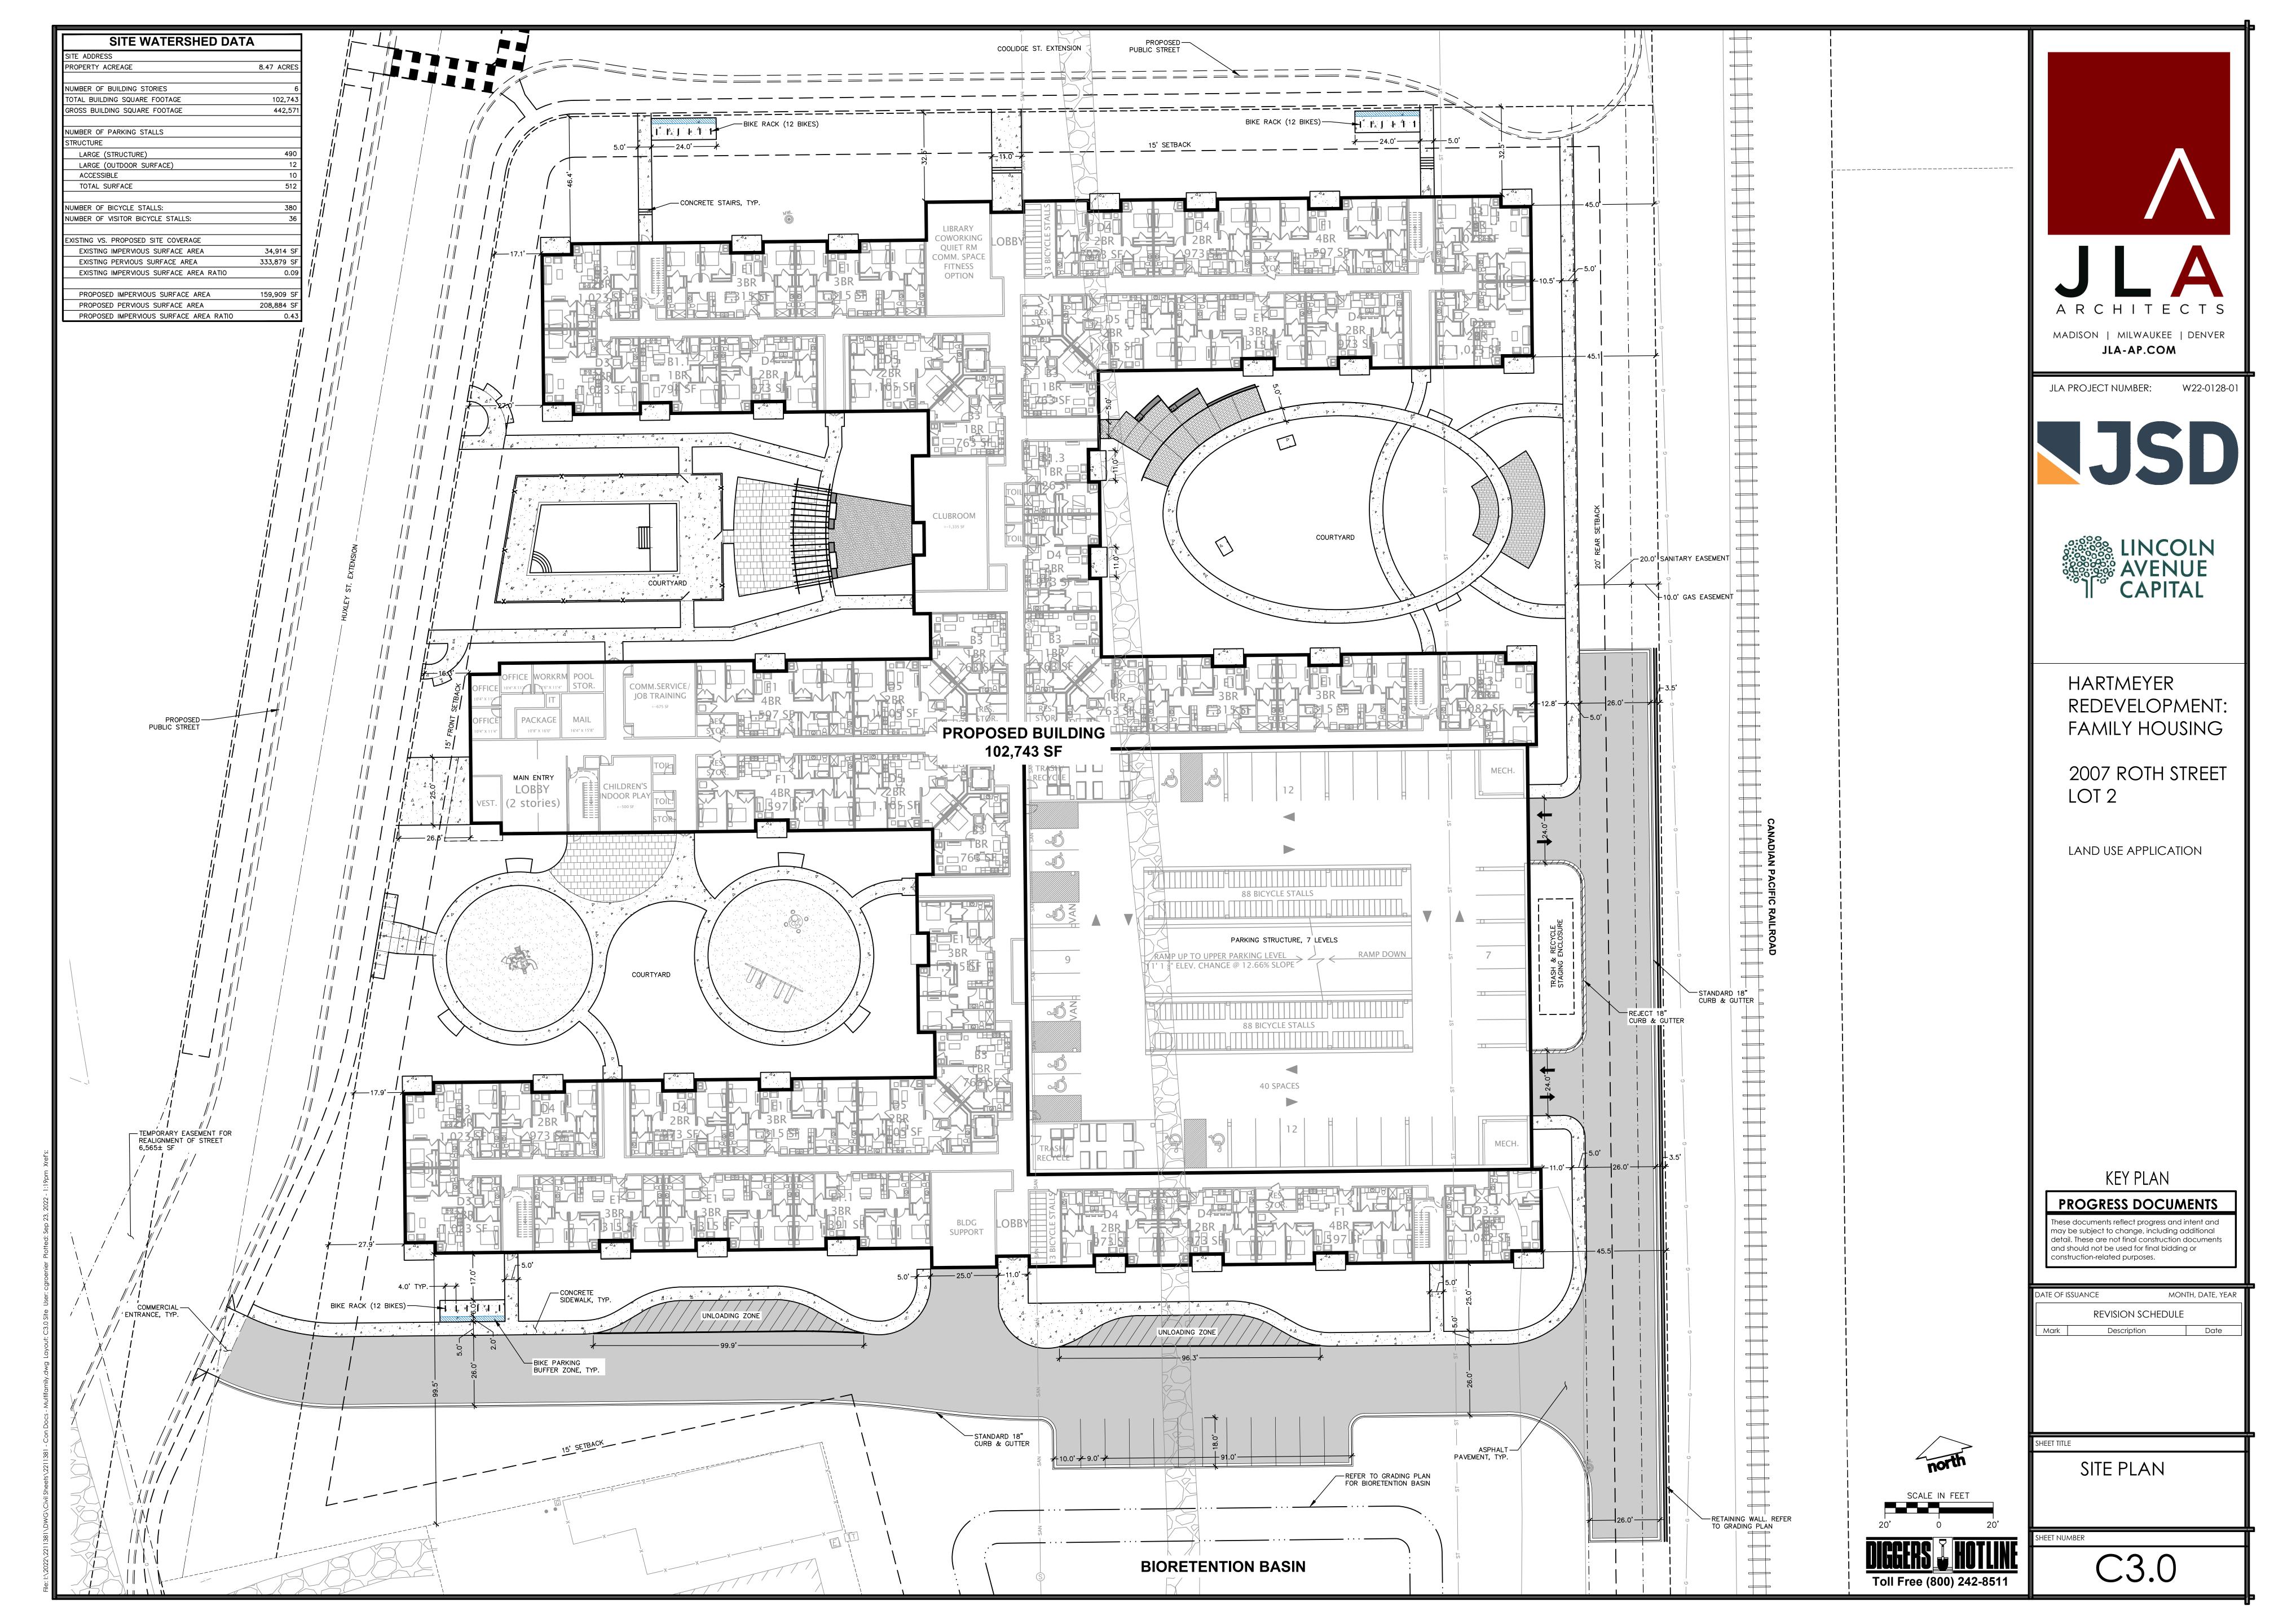
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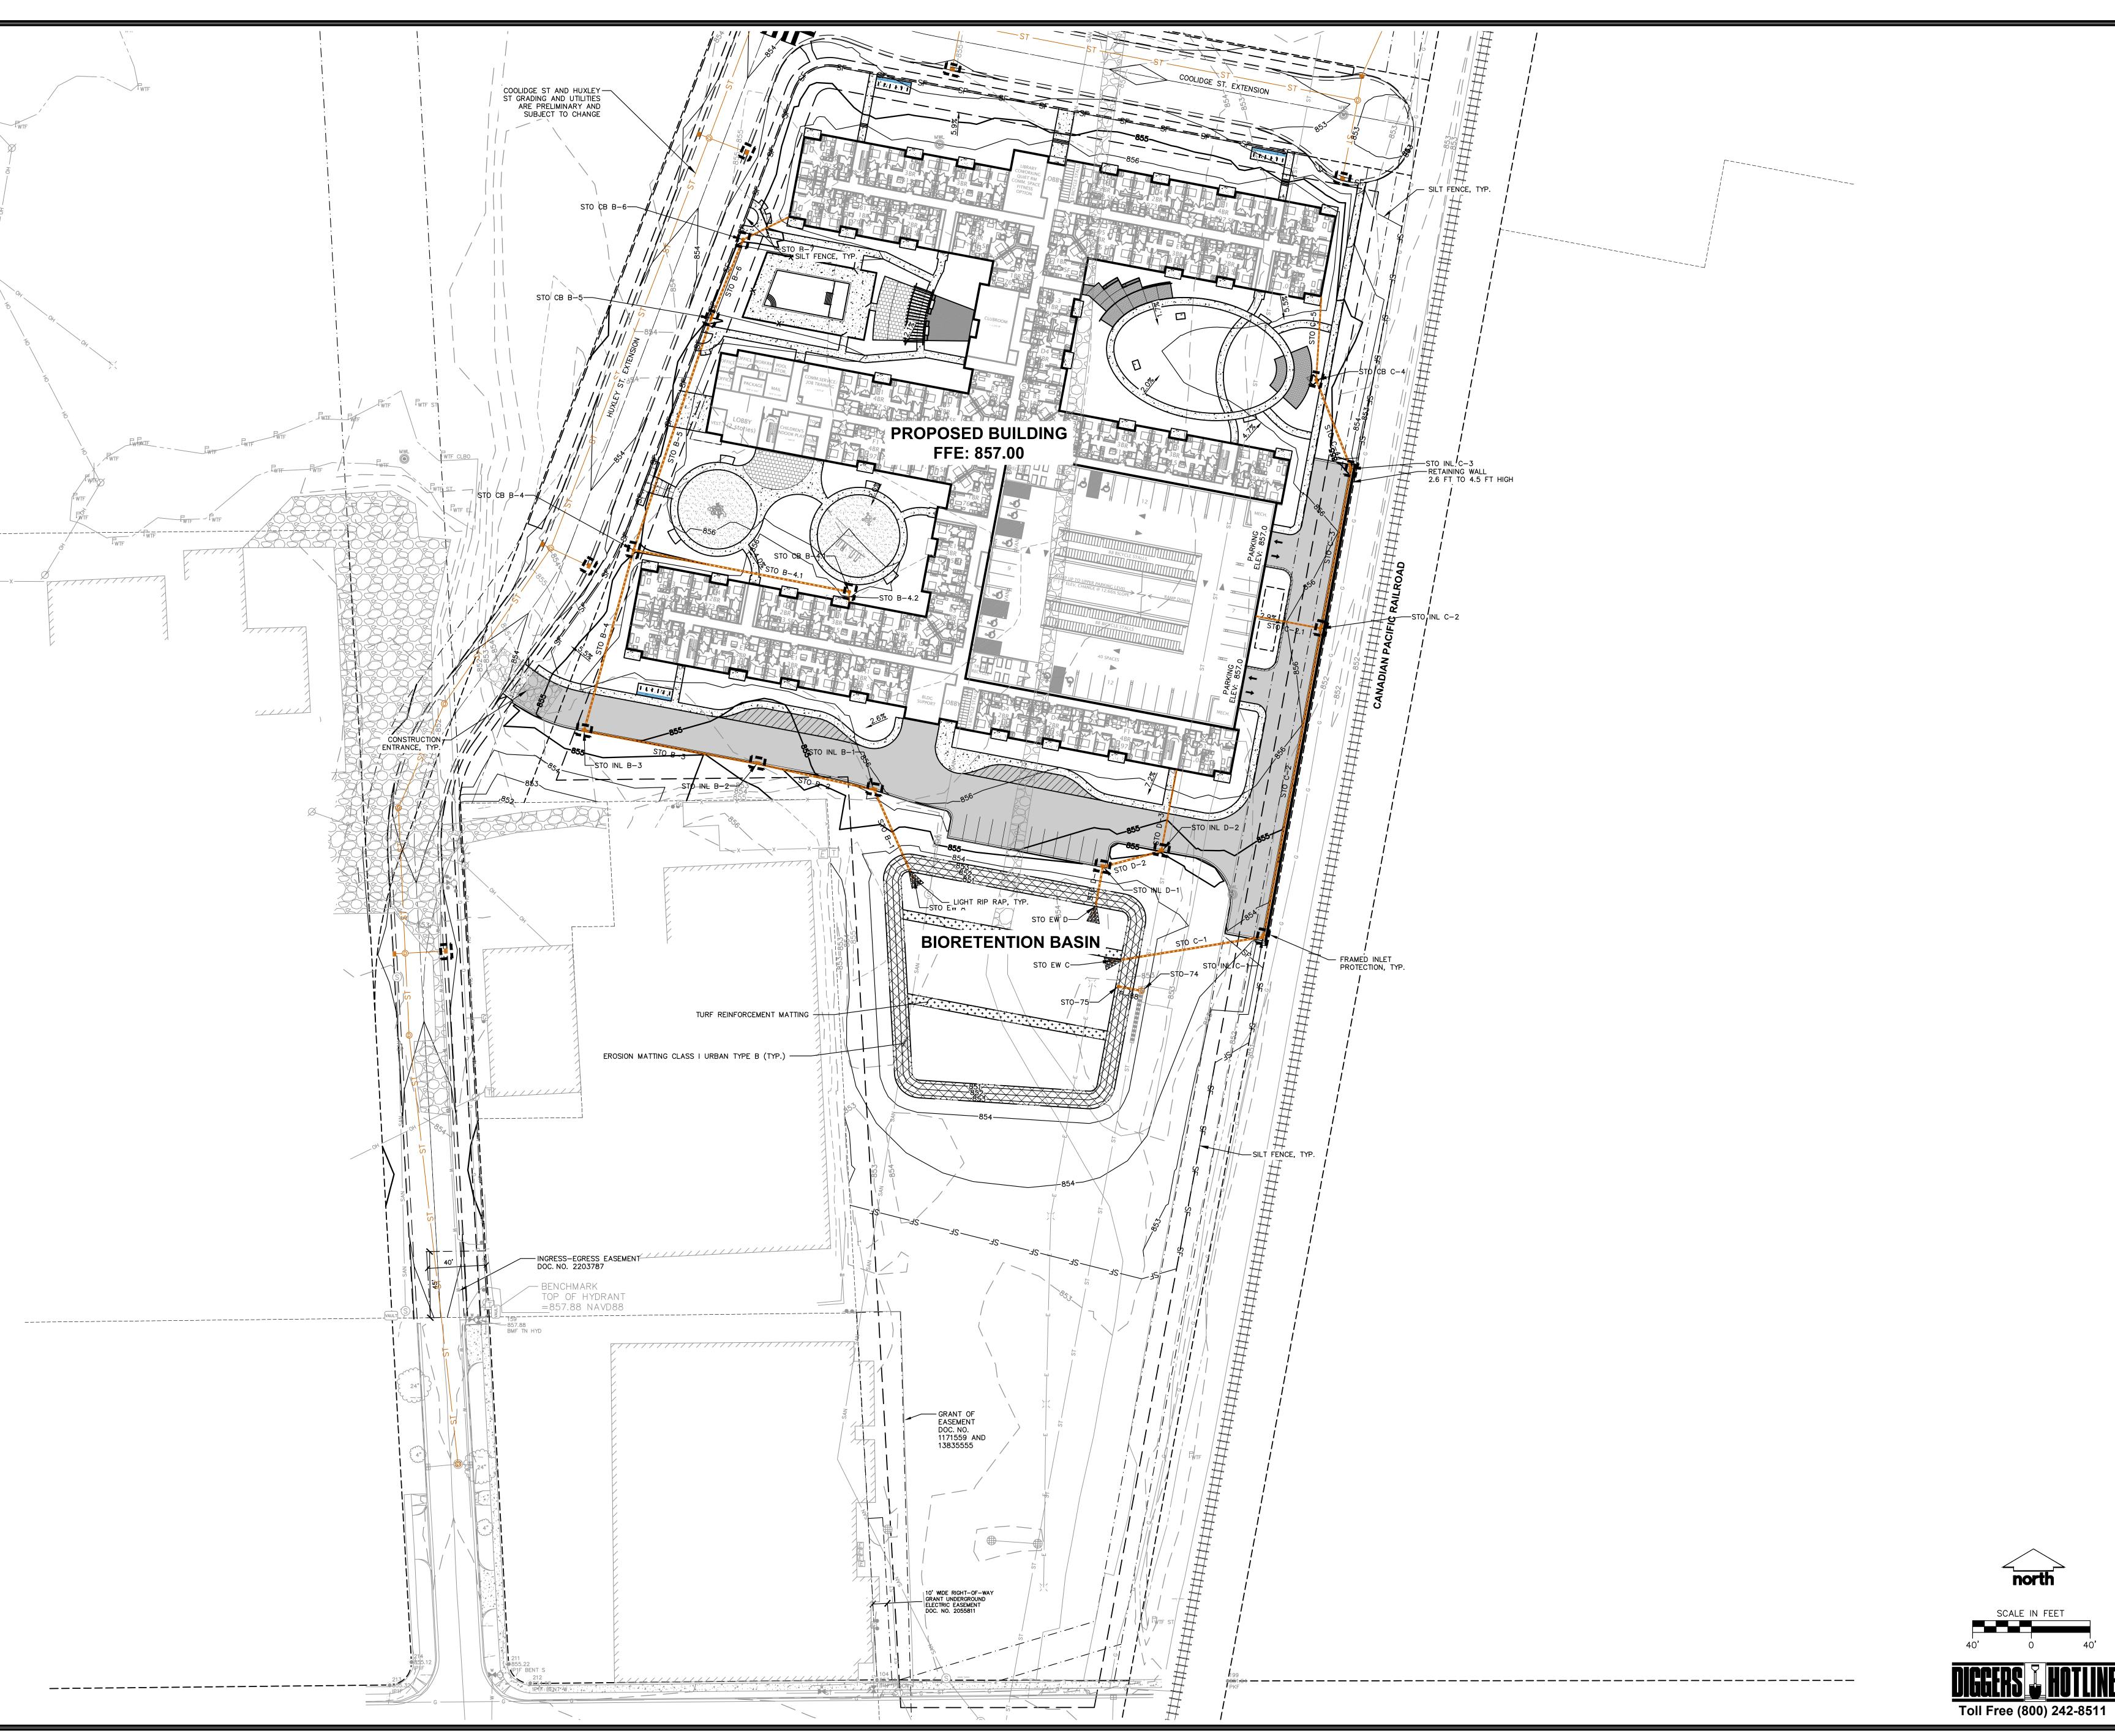
REVISION SCHEDULE

DEMOLITION PLAN

SHEET NUMBER

C2.0







JLA PROJECT NUMBER:





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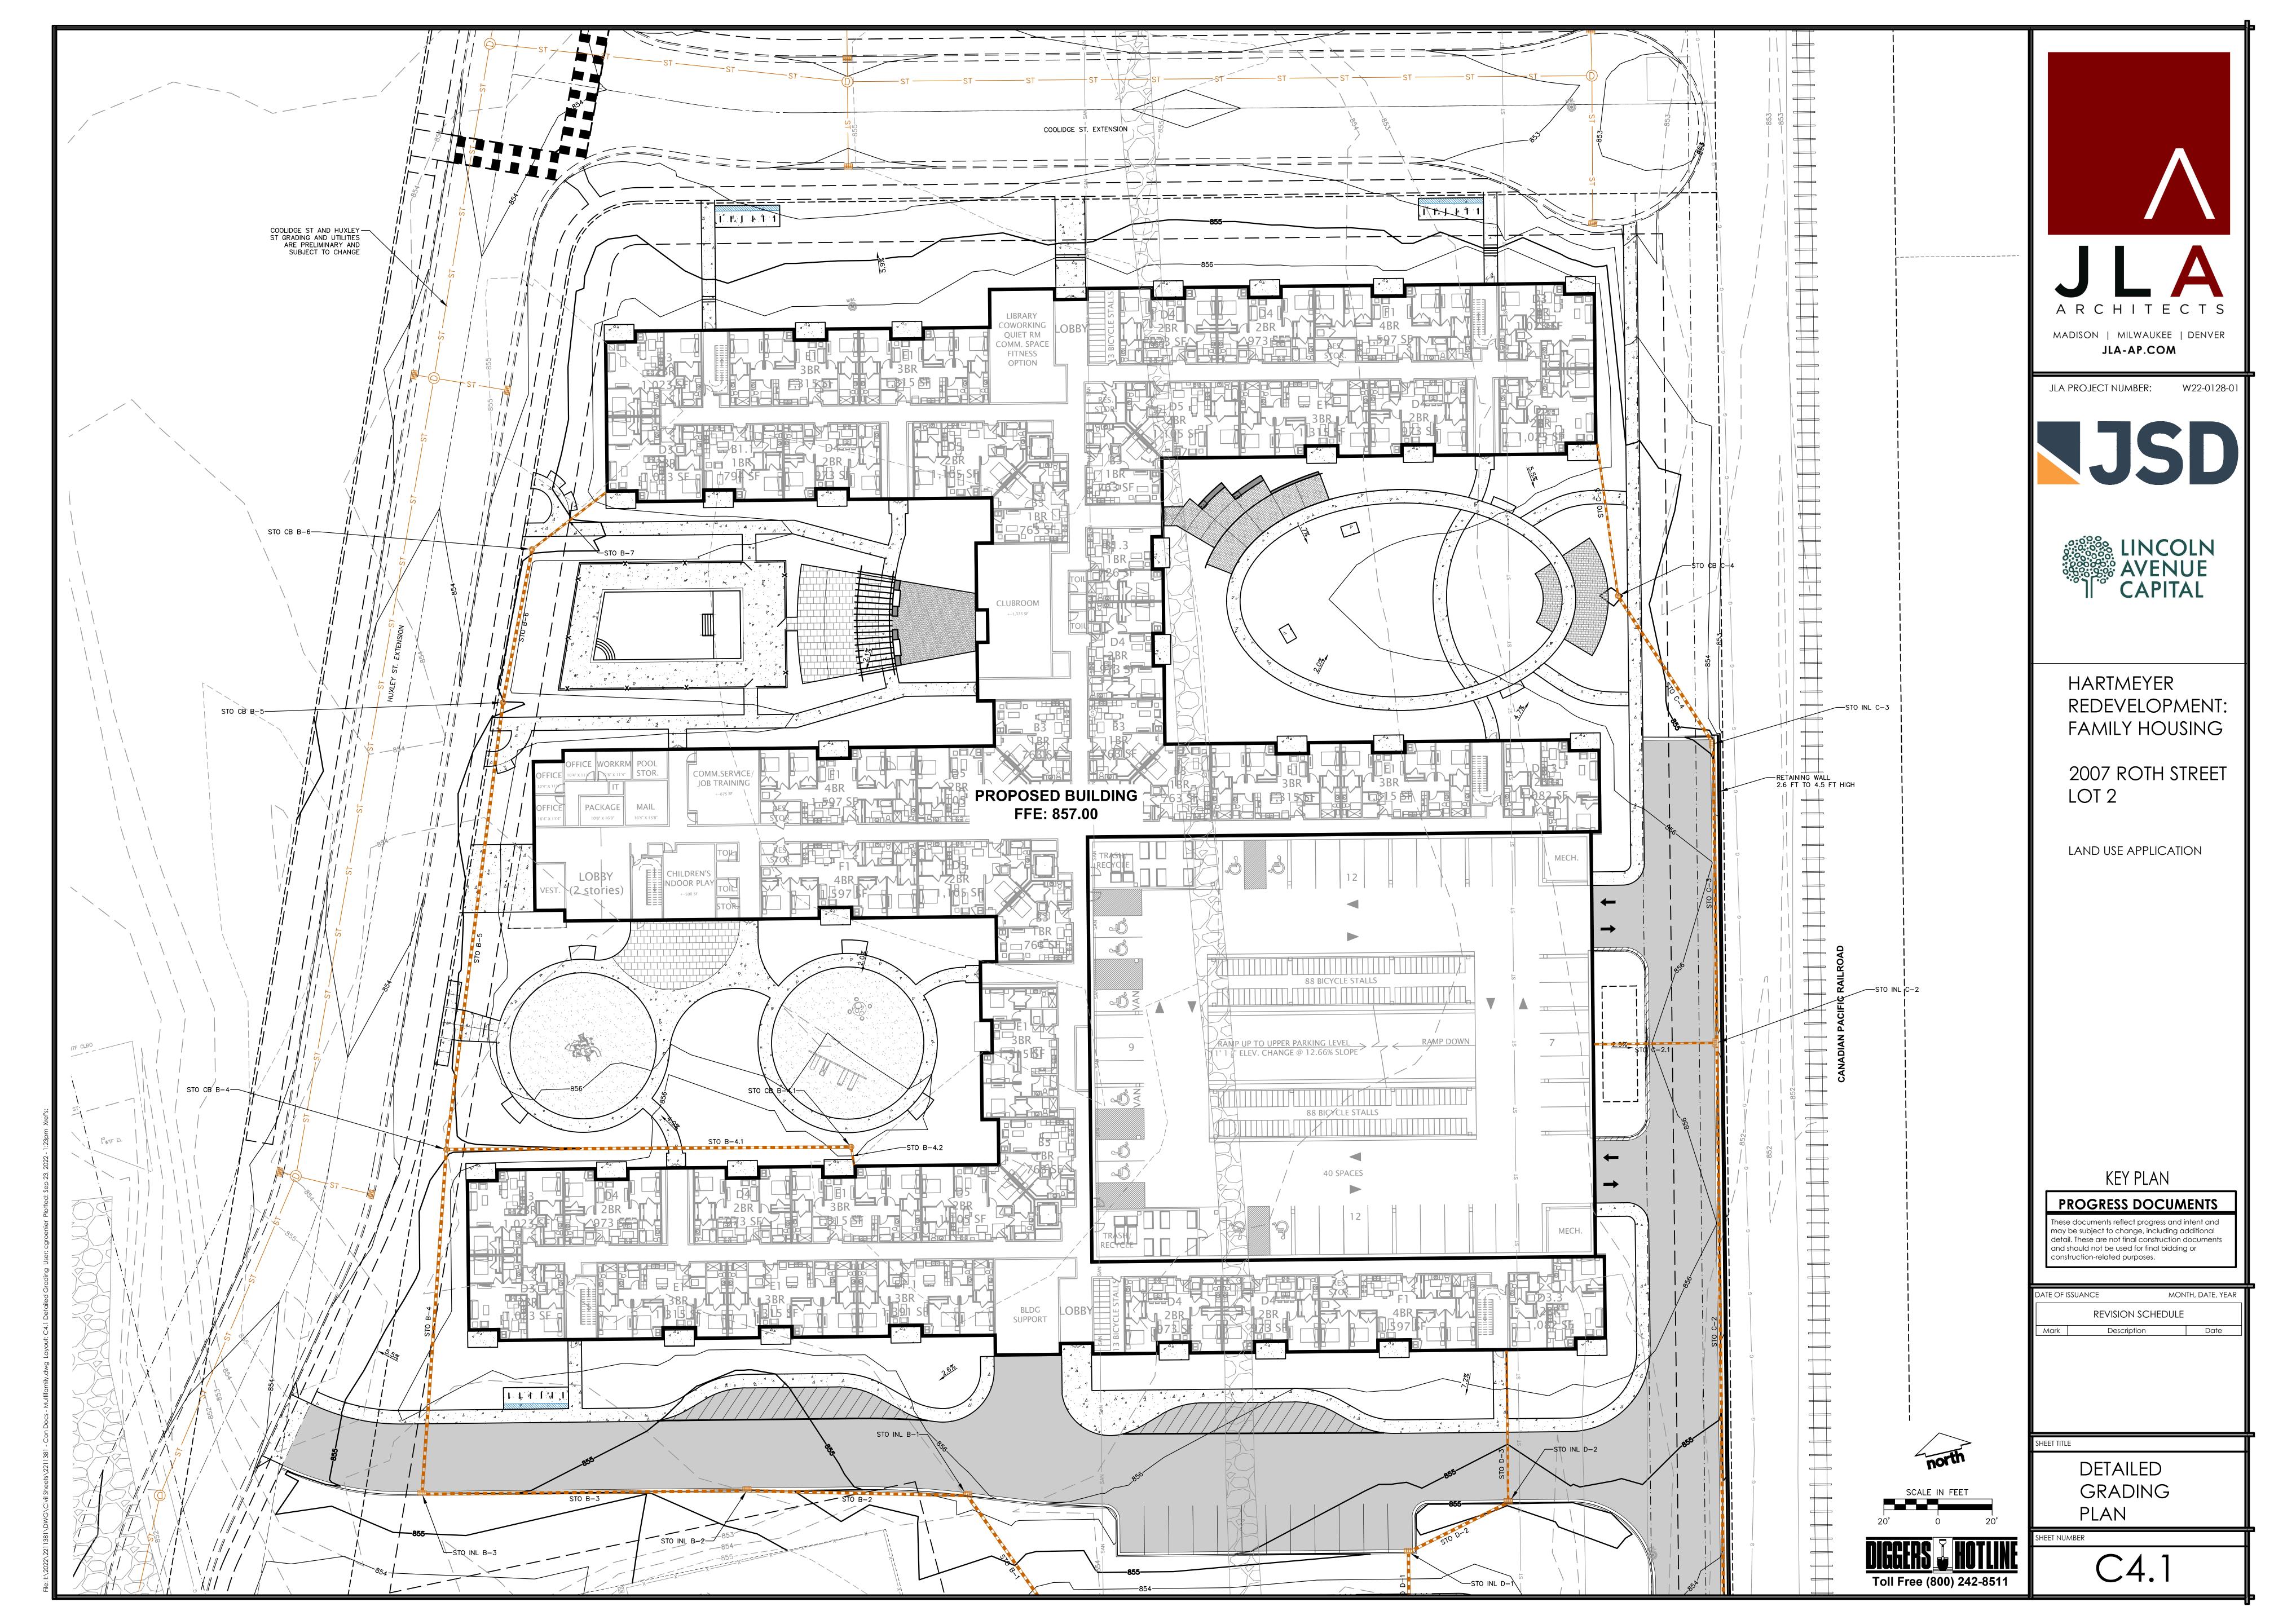
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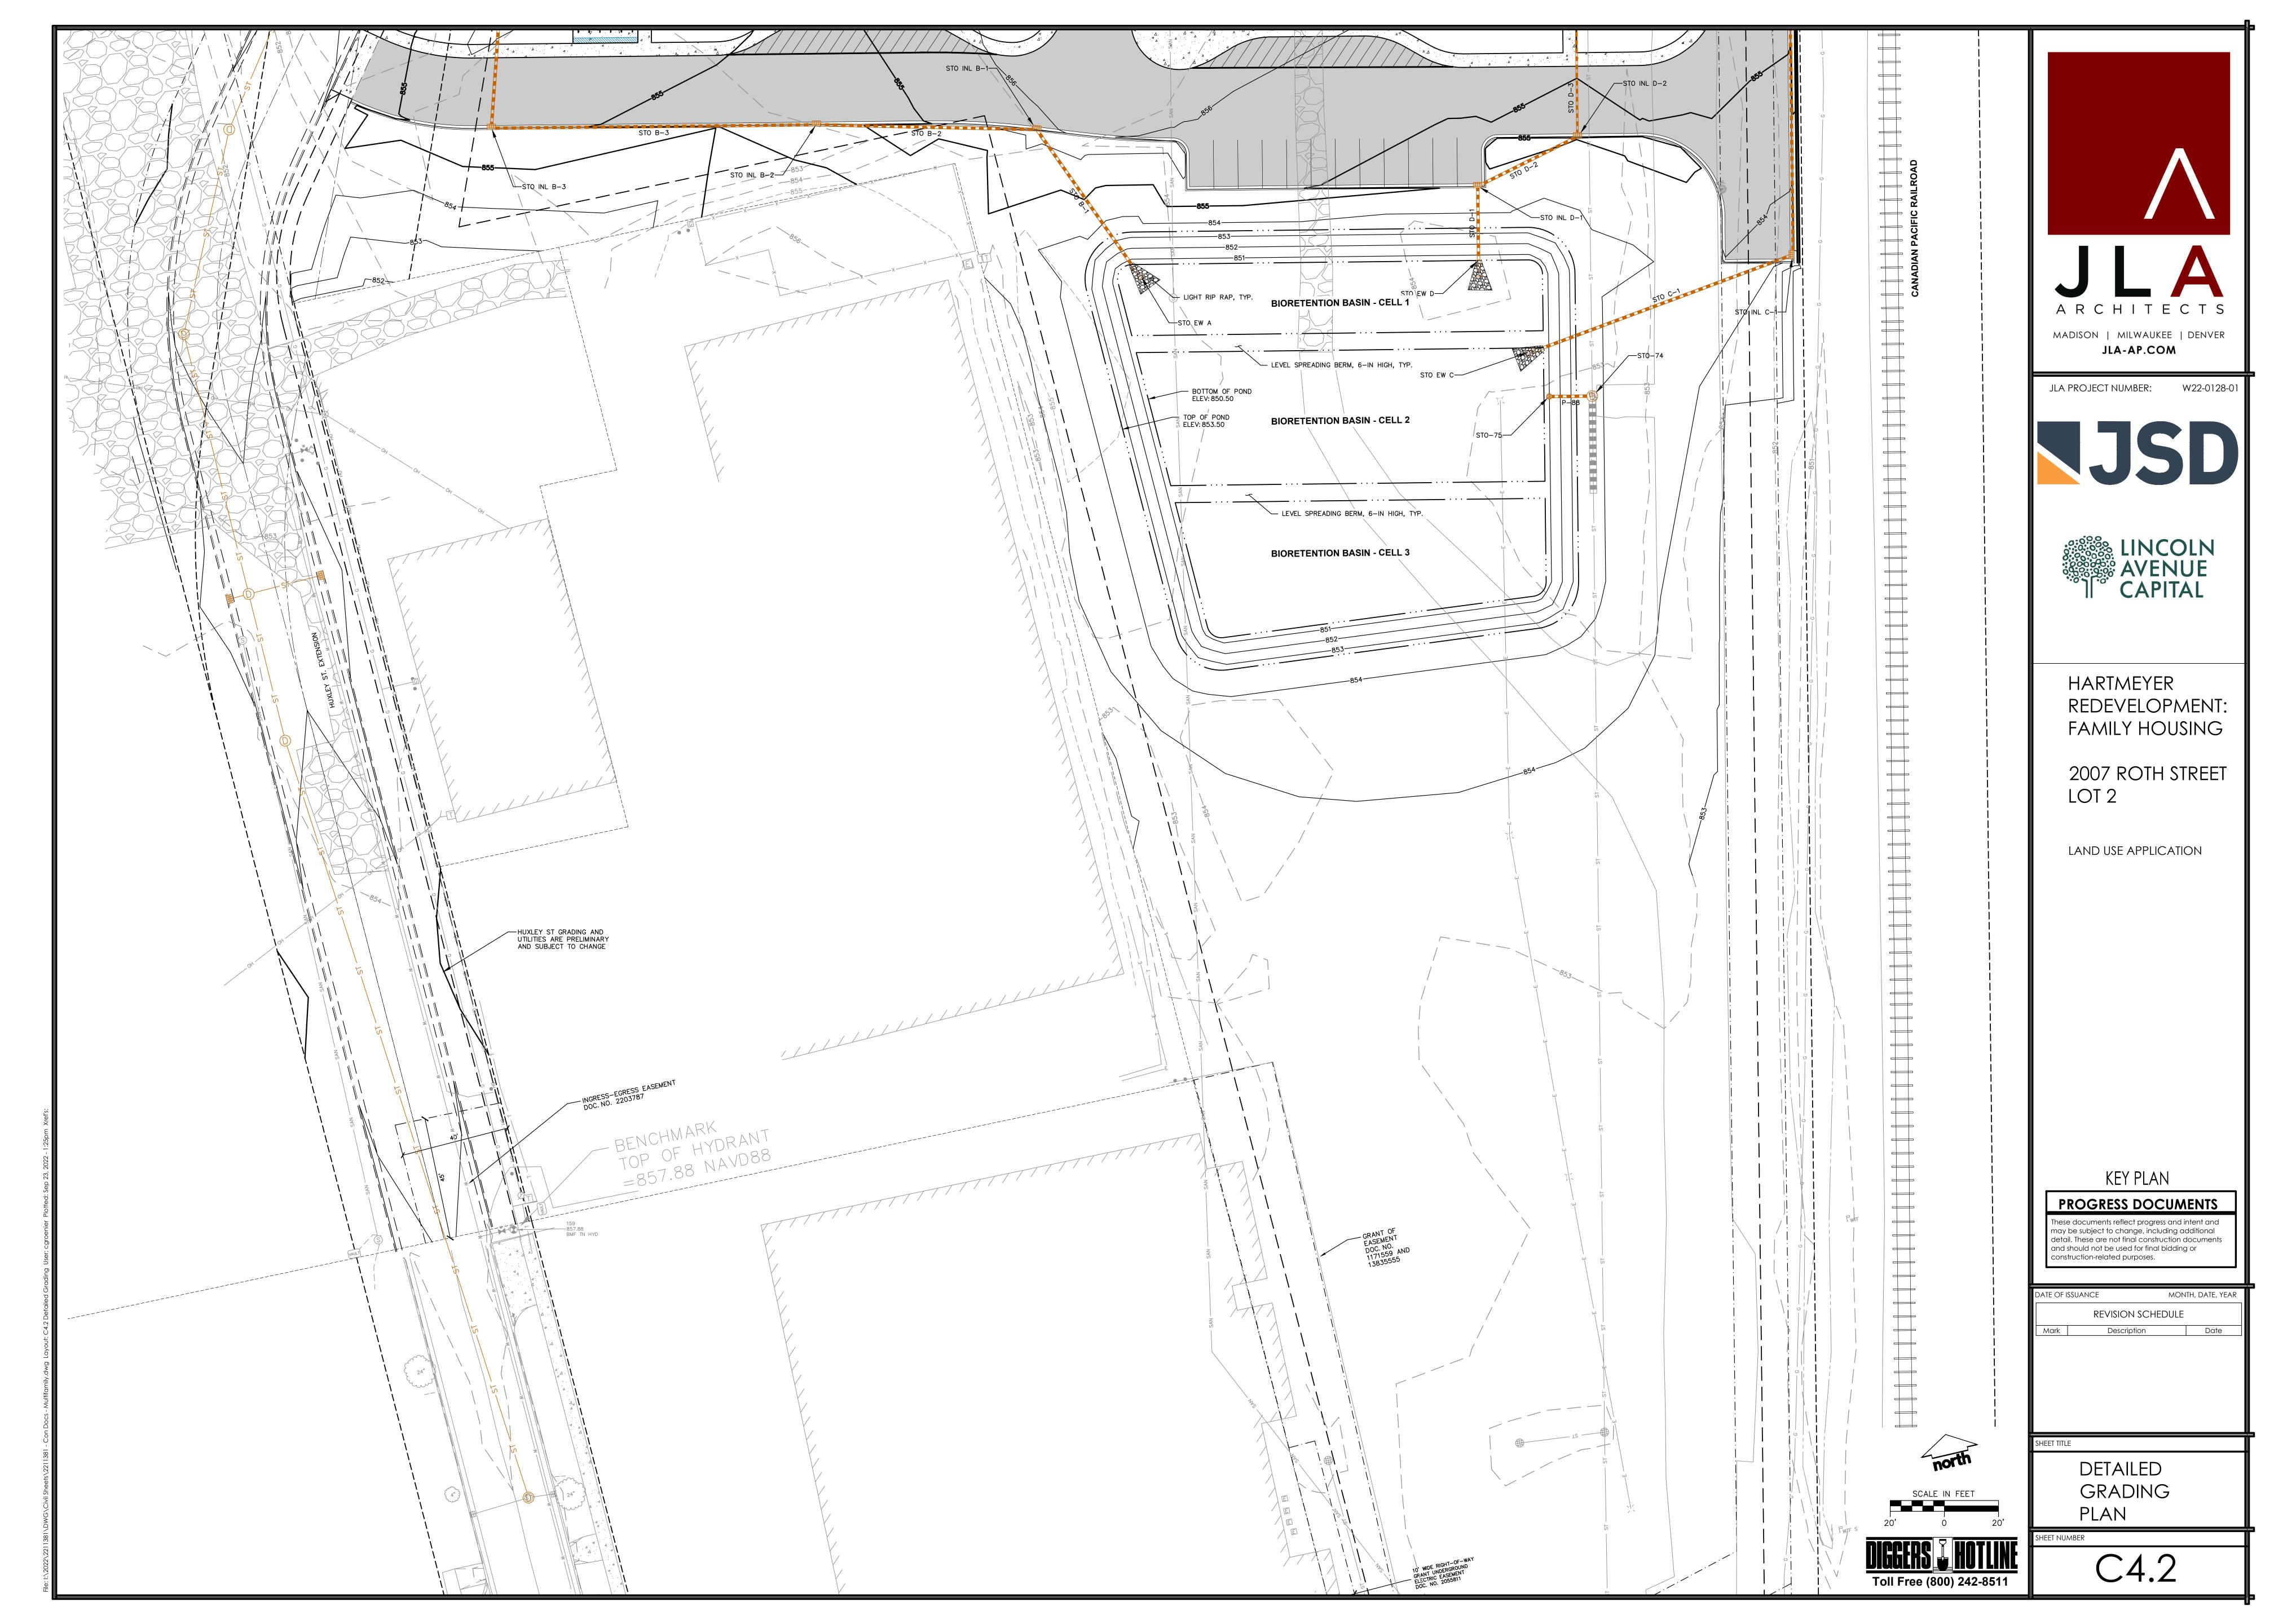
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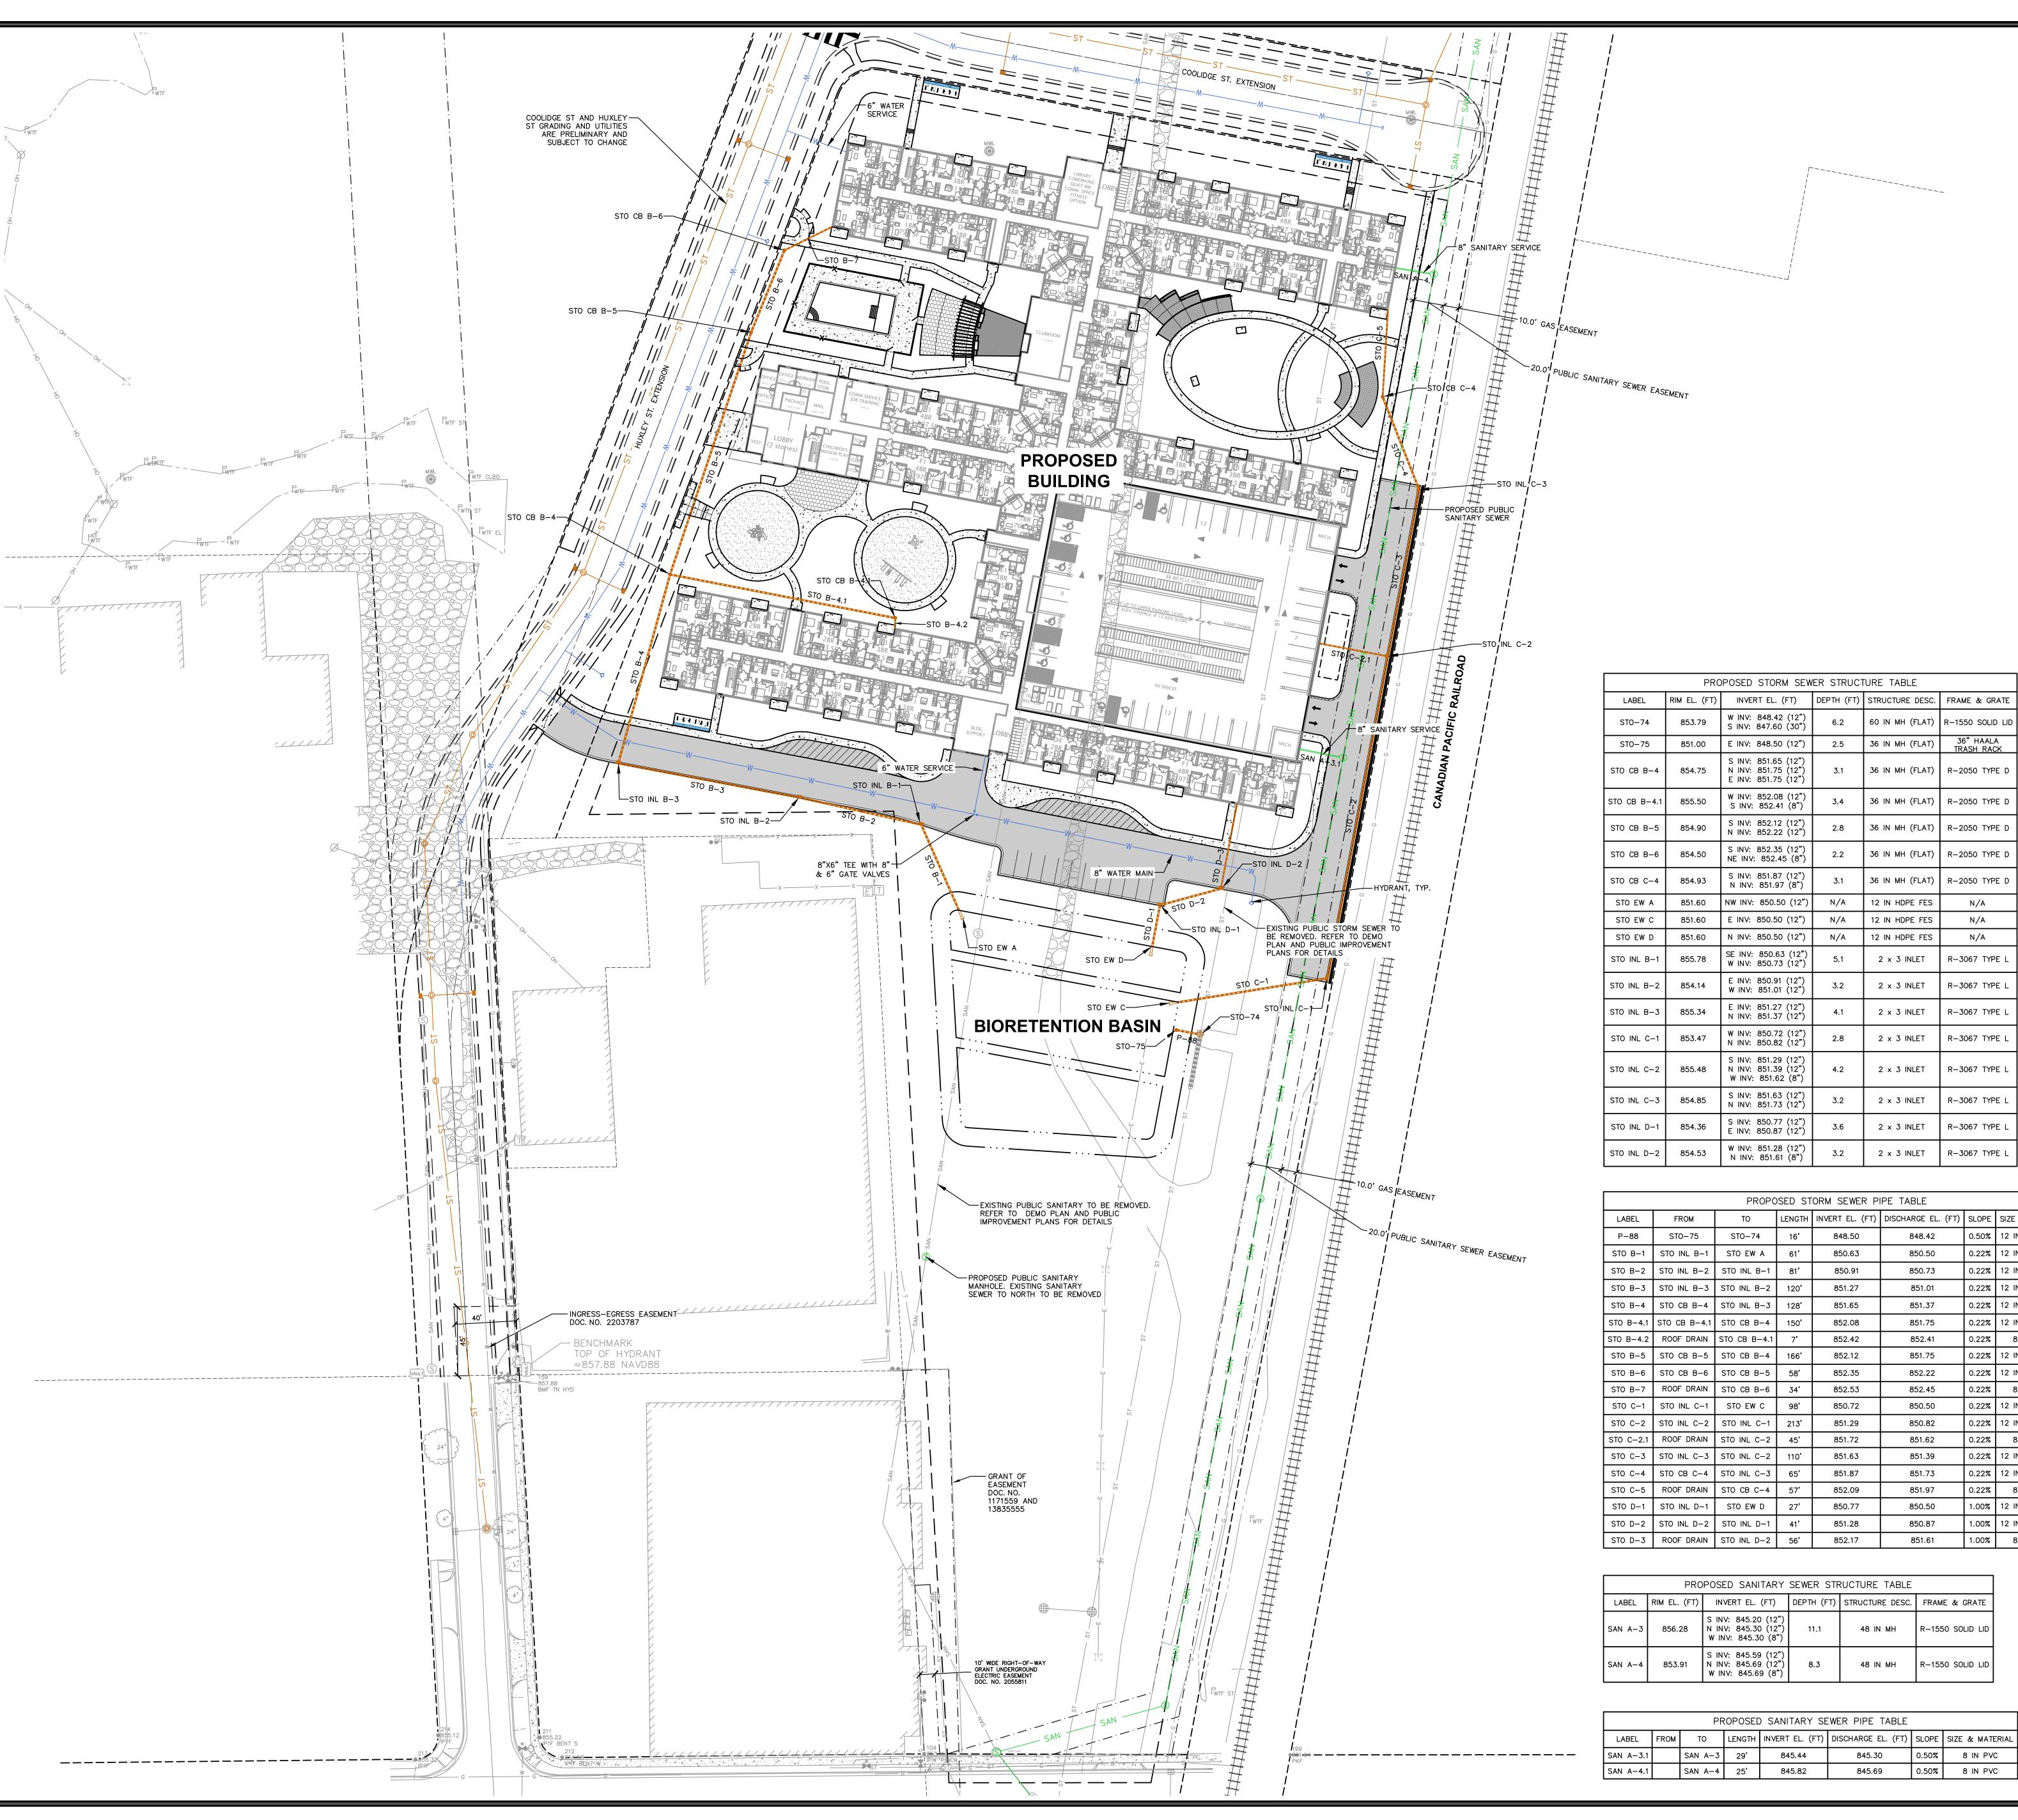
GRADING AND
EROSION
CONTROL PLAN


HOTLINE SHEET NUMBER

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	PROPOSED STORM SEWER PIPE TABLE						
LABEL	FROM	то	LENGTH	INVERT EL. (FT)	DISCHARGE EL. (FT)	SLOPE	SIZE & MATERIAL
P-88	ST0-75	ST0-74	16'	848.50	848.42	0.50%	12 IN HDPE (HP)
STO B-1	STO INL B-1	STO EW A	61'	850.63	850.50	0.22%	12 IN HDPE (HP)
STO B-2	STO INL B-2	STO INL B-1	81'	850.91	850.73	0.22%	12 IN HDPE (HP)
STO B-3	STO INL B-3	STO INL B-2	120'	851.27	851.01	0.22%	12 IN HDPE (HP)
STO B-4	STO CB B-4	STO INL B-3	128'	851.65	851.37	0.22%	12 IN HDPE (HP)
STO B-4.1	STO CB B-4.1	STO CB B-4	150'	852.08	851.75	0.22%	12 IN HDPE (HP)
STO B-4.2	ROOF DRAIN	STO CB B-4.1	7'	852.42	852.41	0.22%	8 IN HDPE
STO B-5	STO CB B-5	STO CB B-4	166'	852.12	851.75	0.22%	12 IN HDPE (HP)
STO B-6	STO CB B-6	STO CB B-5	58'	852.35	852.22	0.22%	12 IN HDPE (HP)
STO B-7	ROOF DRAIN	STO CB B-6	34'	852.53	852.45	0.22%	8 IN HDPE
STO C-1	STO INL C-1	STO EW C	98'	850.72	850.50	0.22%	12 IN HDPE (HP)
STO C-2	STO INL C-2	STO INL C-1	213'	851.29	850.82	0.22%	12 IN HDPE (HP)
STO C-2.1	ROOF DRAIN	STO INL C-2	45'	851.72	851.62	0.22%	8 IN HDPE
STO C-3	STO INL C-3	STO INL C-2	110'	851.63	851.39	0.22%	12 IN HDPE (HP)
STO C-4	STO CB C-4	STO INL C-3	65'	851.87	851.73	0.22%	12 IN HDPE (HP)
STO C-5	ROOF DRAIN	STO CB C-4	57'	852.09	851.97	0.22%	8 IN HDPE
STO D-1	STO INL D-1	STO EW D	27'	850.77	850.50	1.00%	12 IN HDPE (HP)
STO D-2	STO INL D-2	STO INL D-1	41'	851.28	850.87	1.00%	12 IN HDPE (HP)
STO D-3	ROOF DRAIN	STO INL D-2	56'	852.17	851.61	1.00%	8 IN HDPE

	PROPOSED SANITARY SEWER STRUCTURE TABLE						
LABEL	RIM EL. (FT)	INVERT EL. (FT)	DEPTH (FT)	STRUCTURE DESC.	FRAME & GRATE		
SAN A-3	856.28	S INV: 845.20 (12") N INV: 845.30 (12") W INV: 845.30 (8")	11.1	48 IN MH	R-1550 SOLID LID		
SAN A-4	853.91	S INV: 845.59 (12") N INV: 845.69 (12") W INV: 845.69 (8")	8.3	48 IN MH	R-1550 SOLID LID		


SAN A-4 25'

845.69 (12") 845.69 (8")	8.3	48 IN MH	R-1550	SOLID	LID				
			•					SCALE IN I	FEET
						-			
OSED SAN	ITARY SEWE	R PIPE TABLE					40'	0	
	i					7			

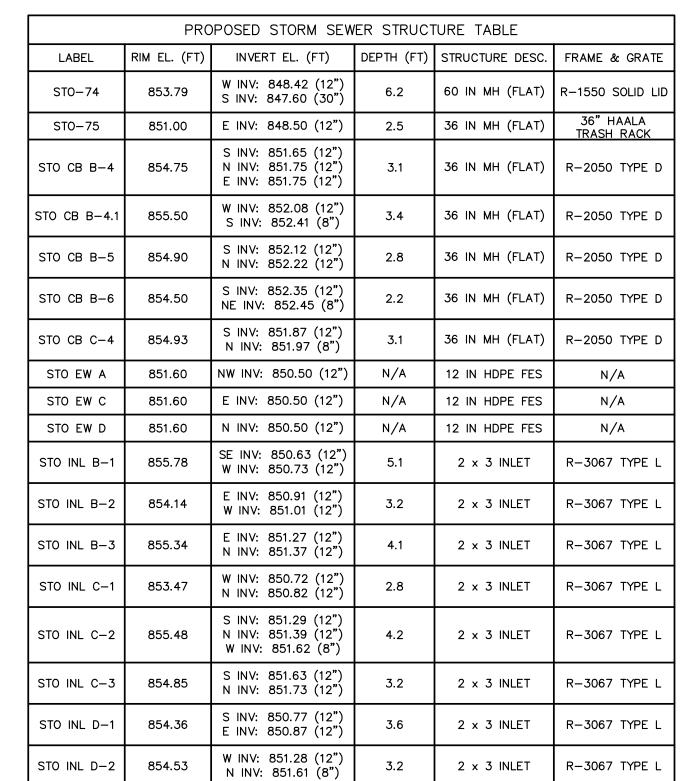0.50% 8 IN PVC

0.50% 8 IN PVC

845.69

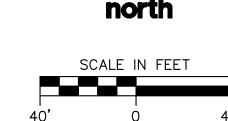

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HARTMEYER REDEVELOPMENT: FAMILY HOUSING

2007 ROTH STREET LOT 2

LAND USE APPLICATION

KEY PLAN

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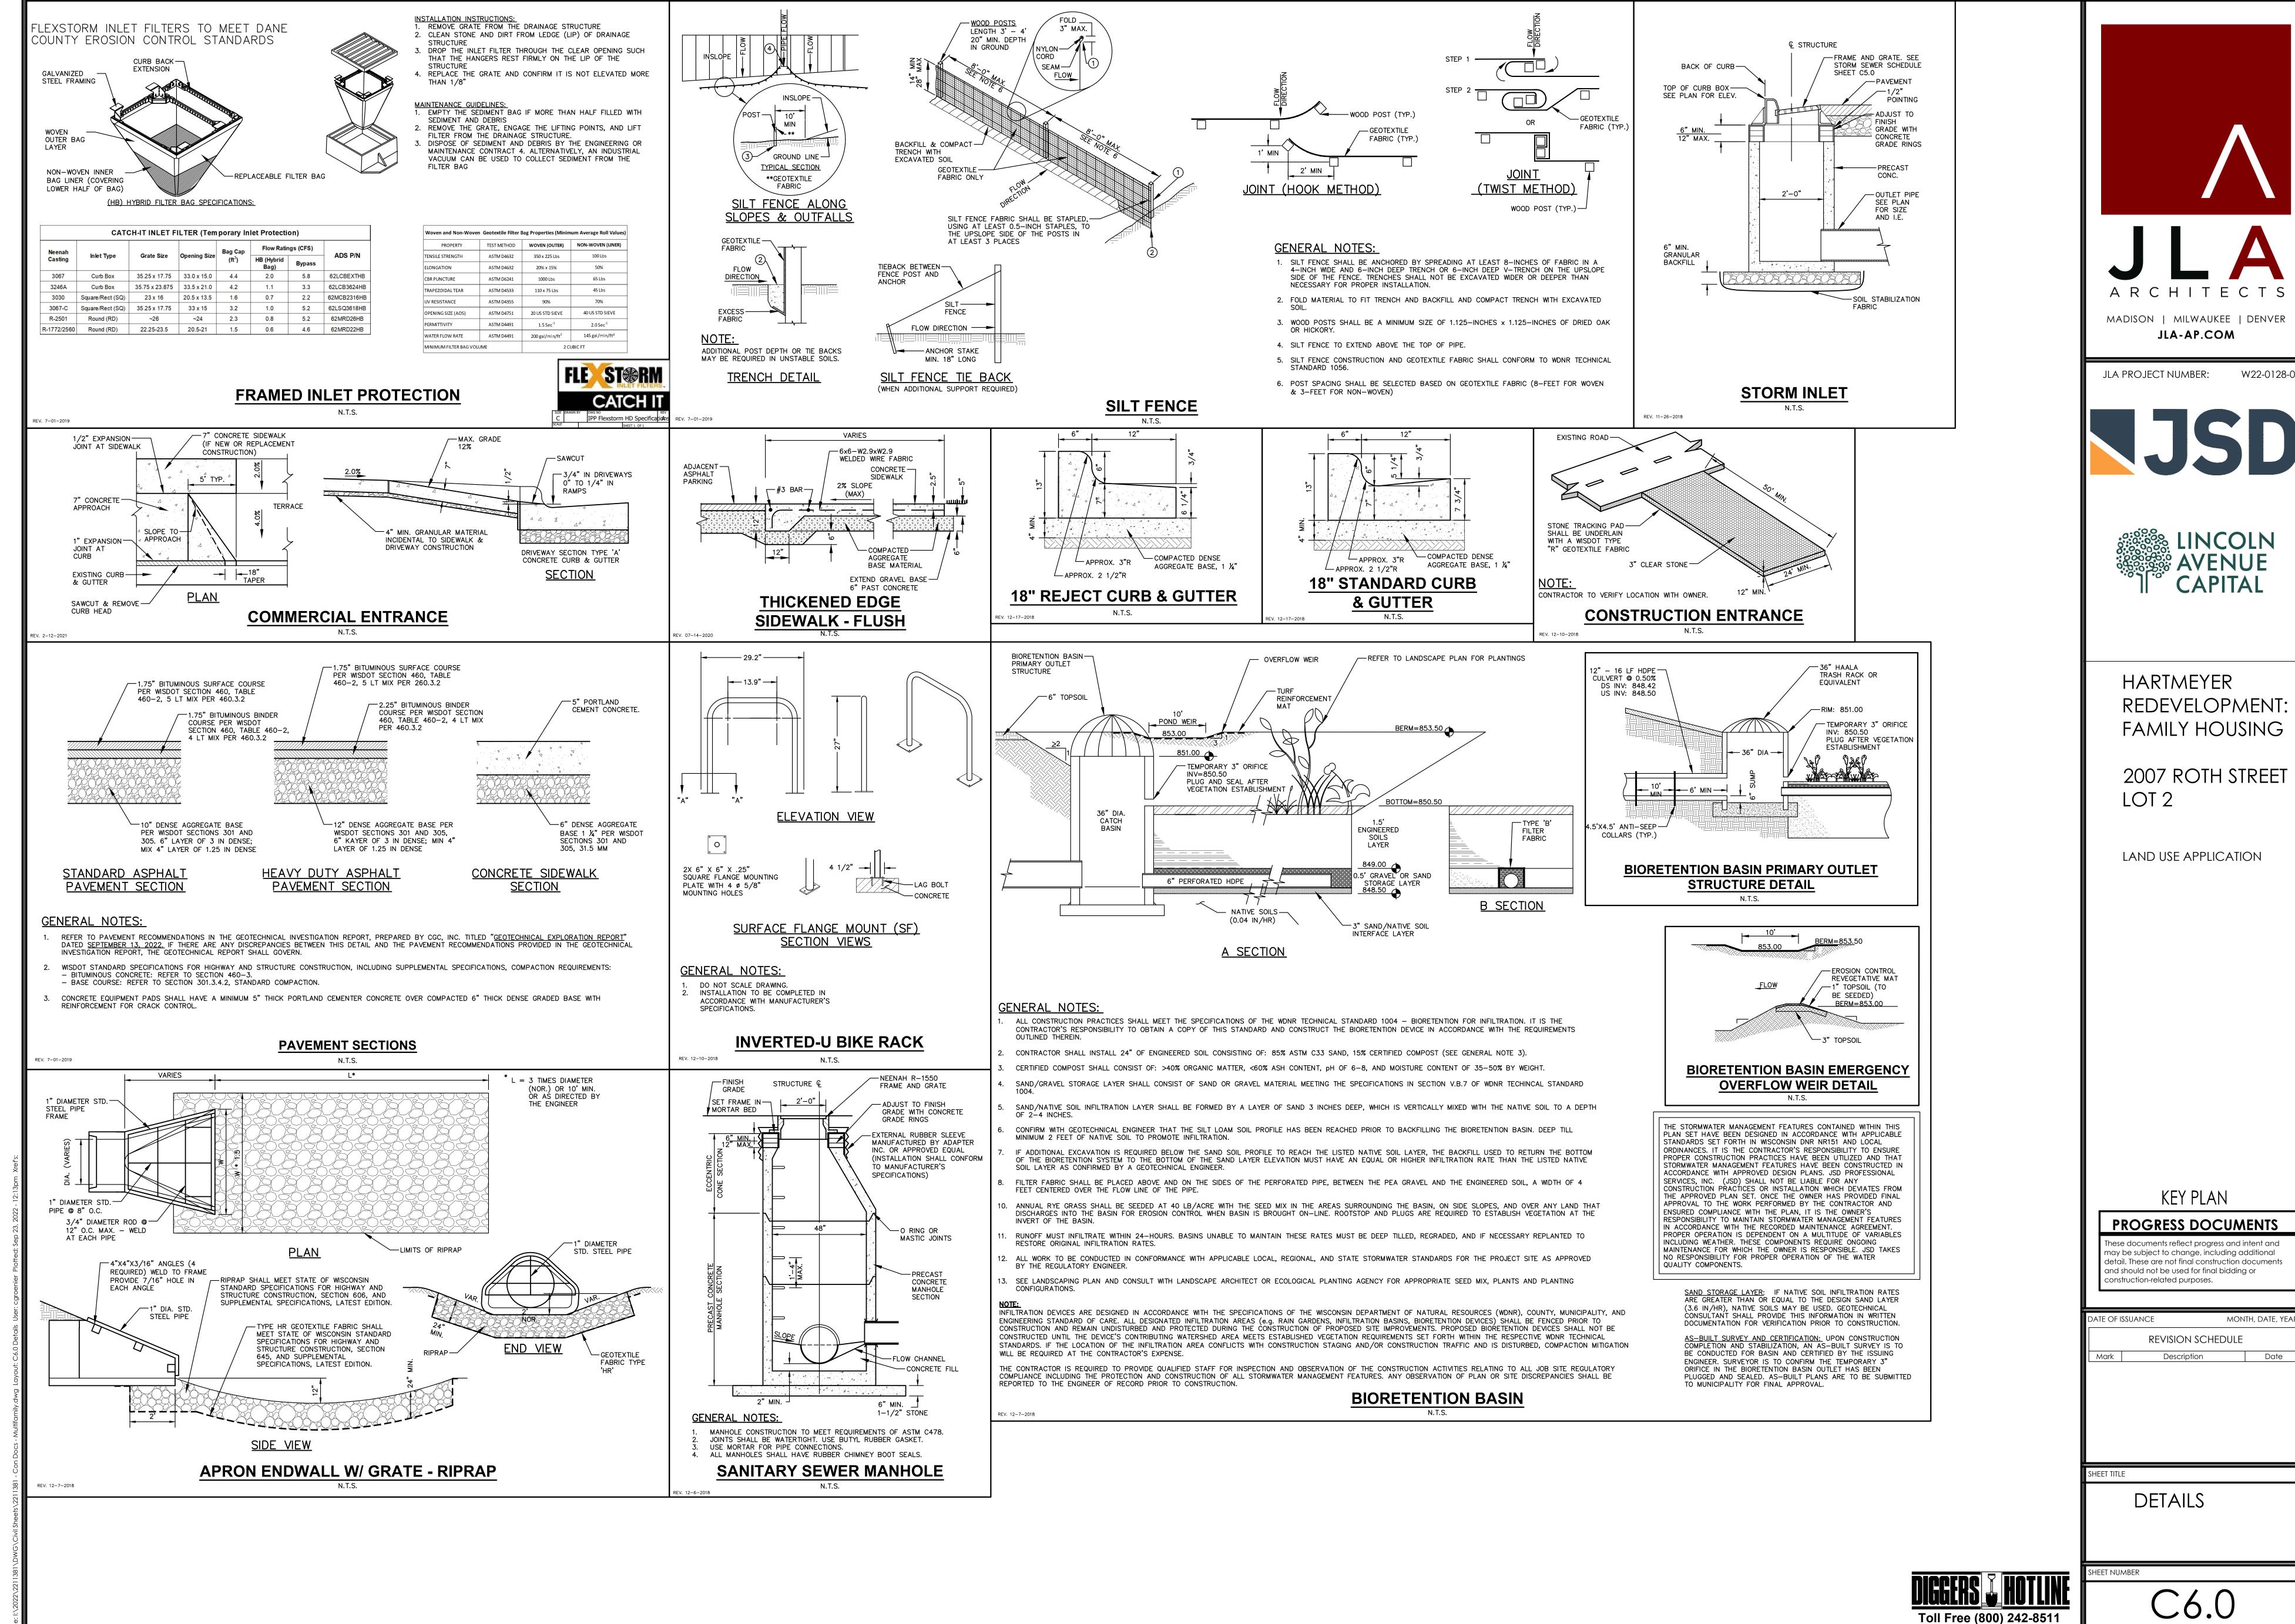
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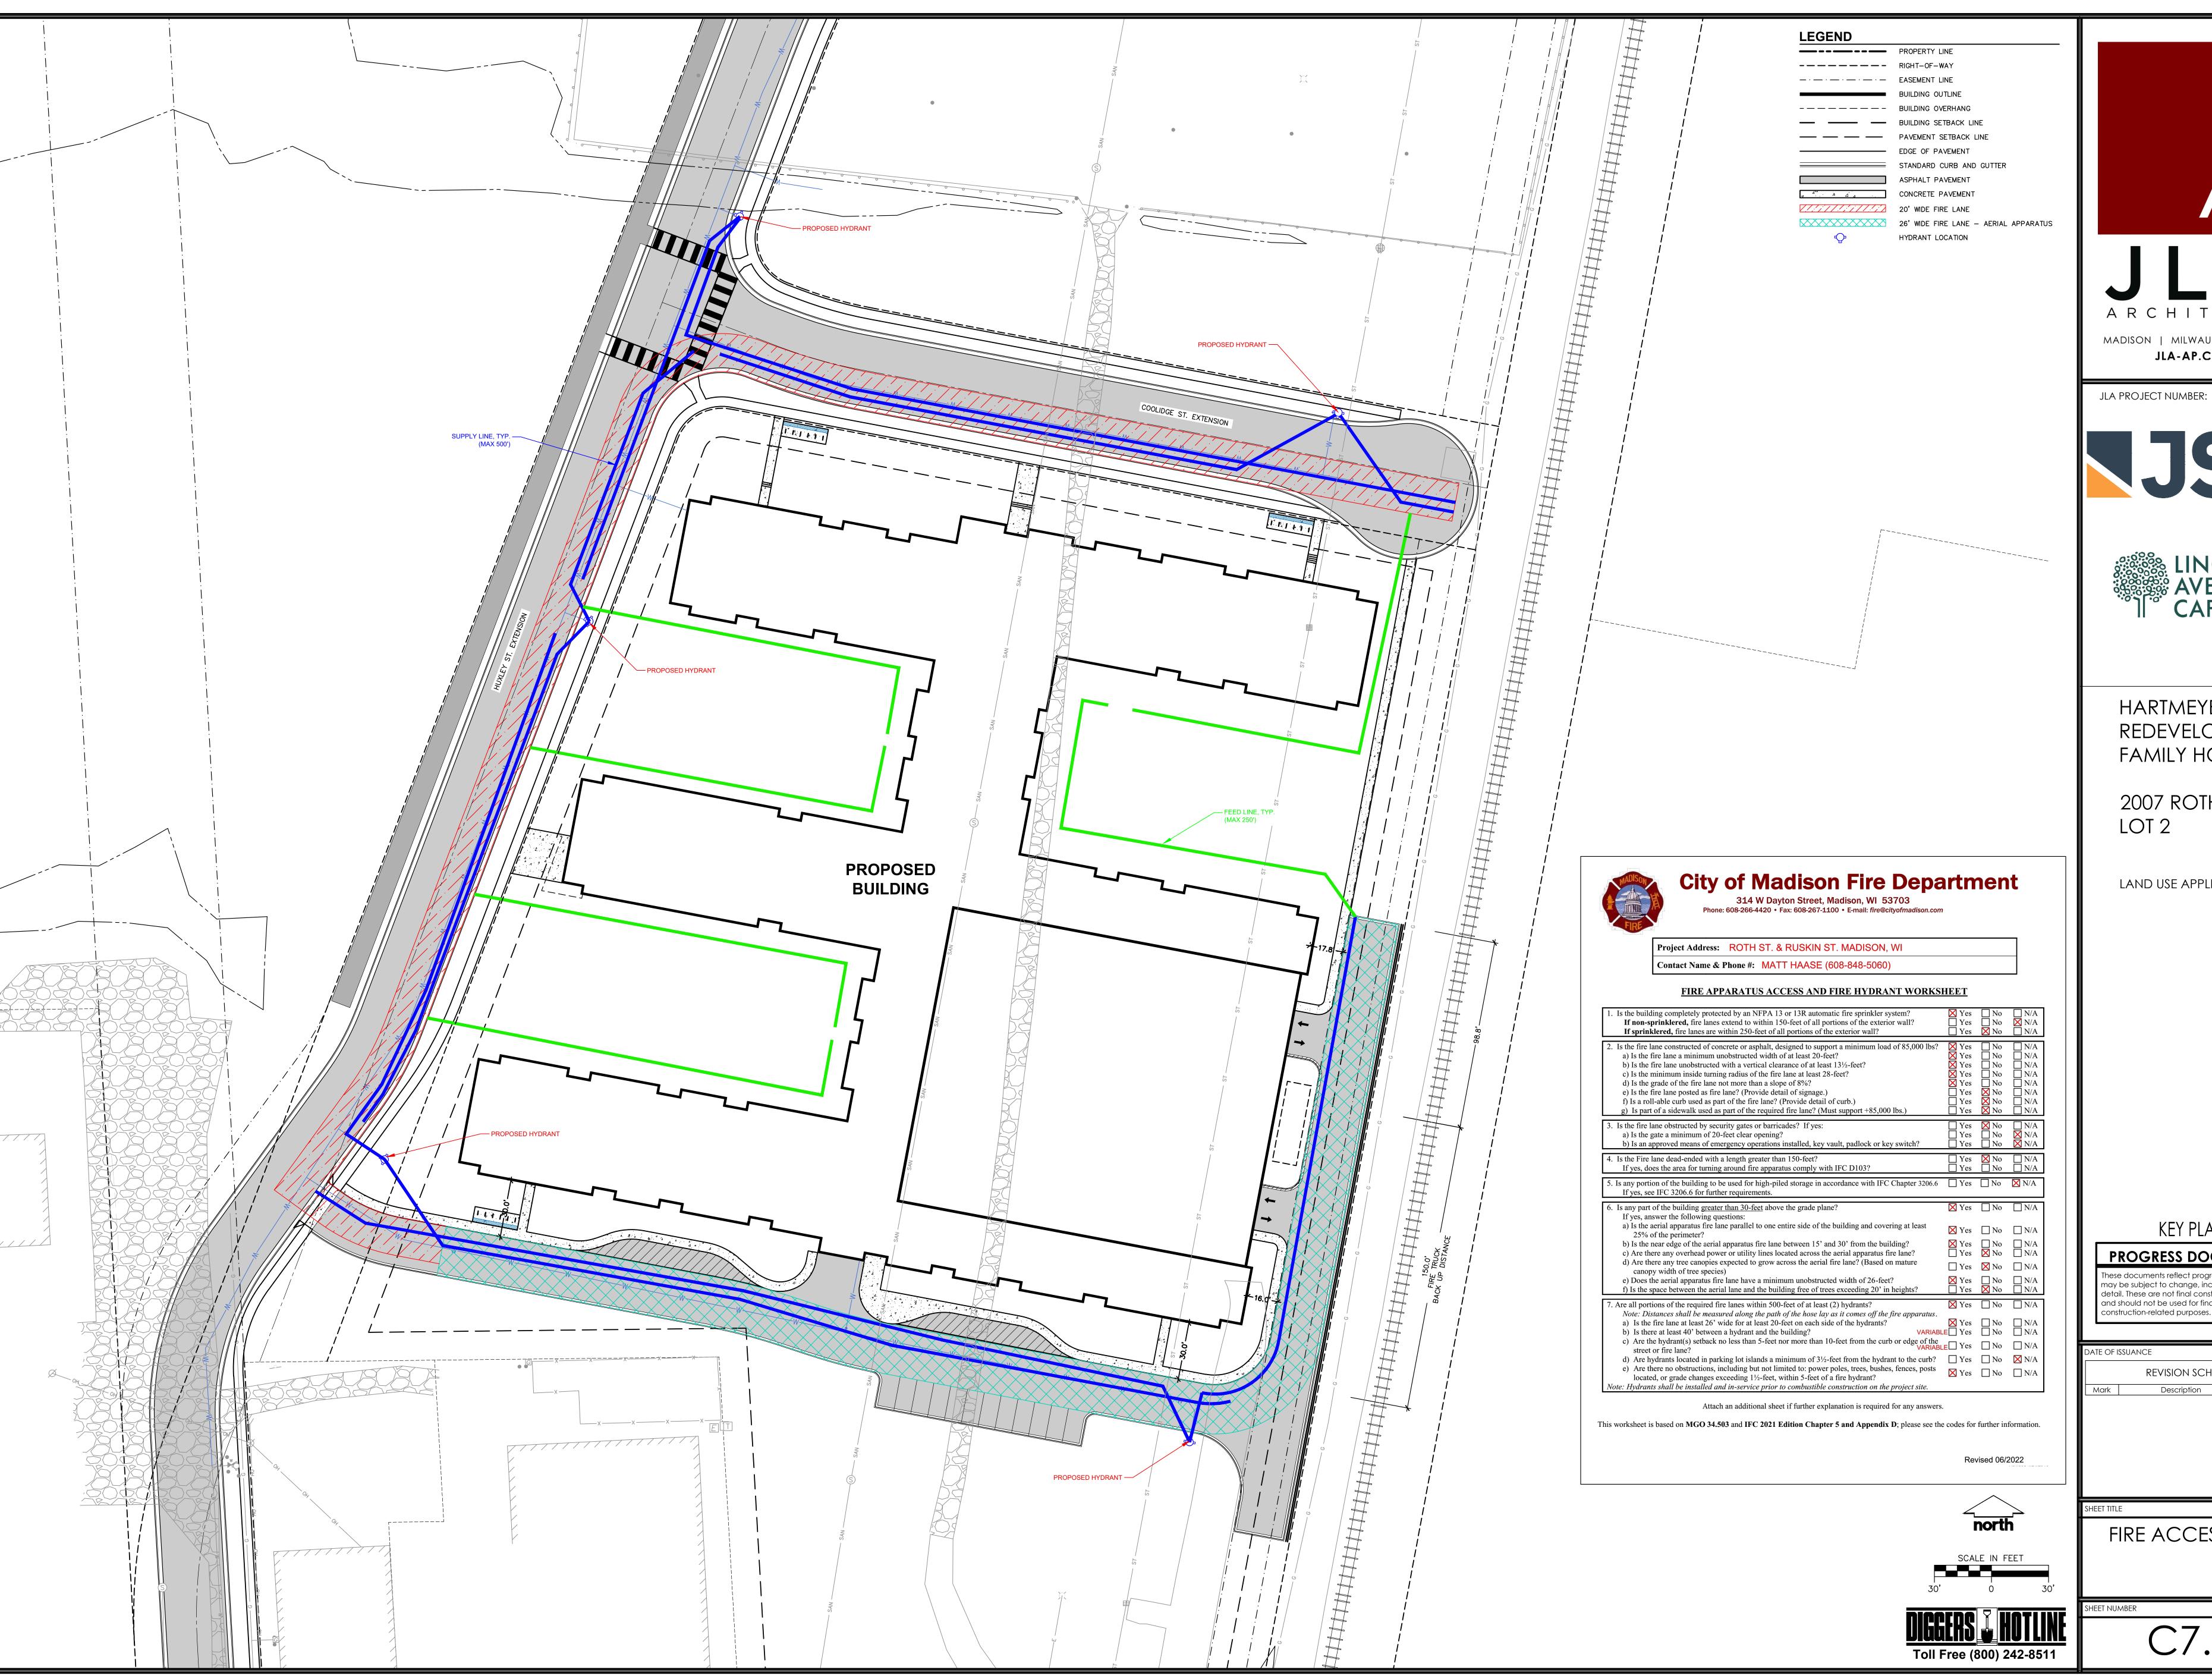
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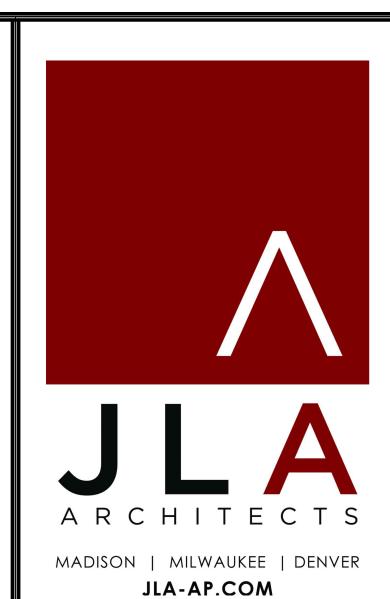
REVISION SCHEDULE Mark Description

UTILITY PLAN



C6.0





JLA PROJECT NUMBER: W22-0128-01





HARTMEYER REDEVELOPMENT: FAMILY HOUSING

2007 ROTH STREET LOT 2

LAND USE APPLICATION


KEY PLAN


PROGRESS DOCUMENTS These documents reflect progress and intent and may be subject to change, including additional detail. These are not final construction documents and should not be used for final bidding or


DATE OF ISSUANCE MONTH, DATE, YEAR


REVISION SCHEDULE


FIRE ACCESS PLAN

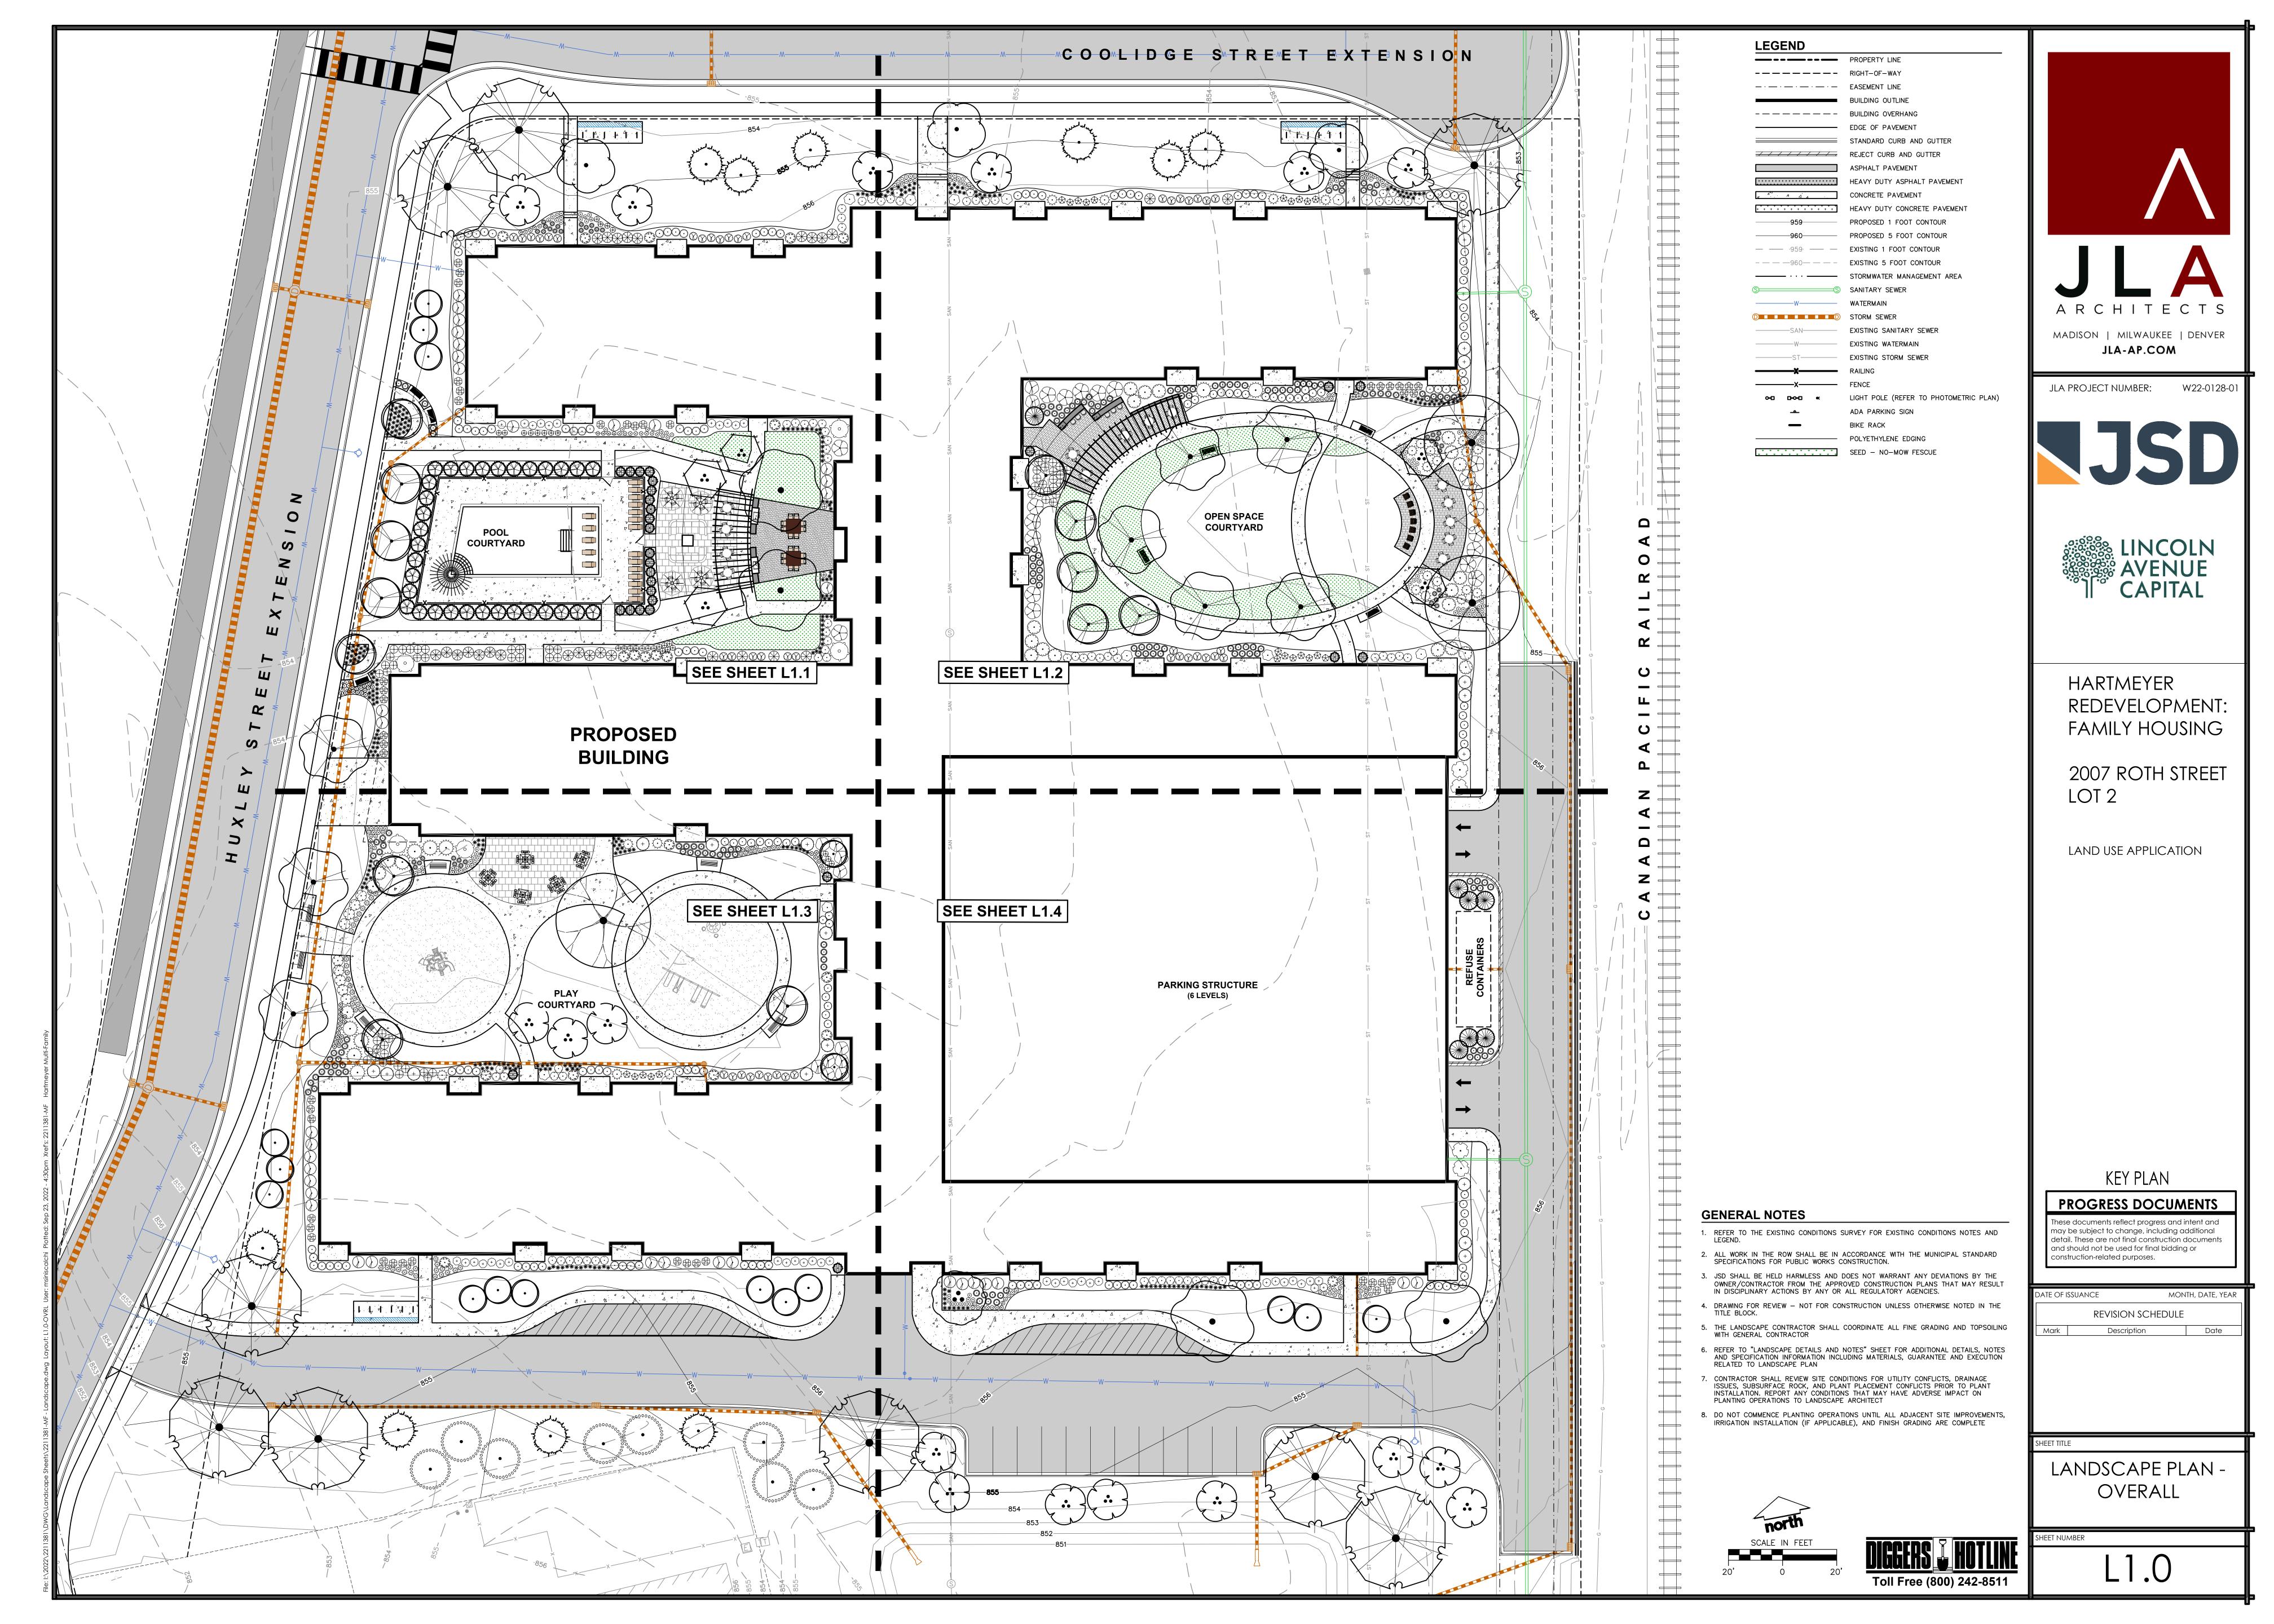


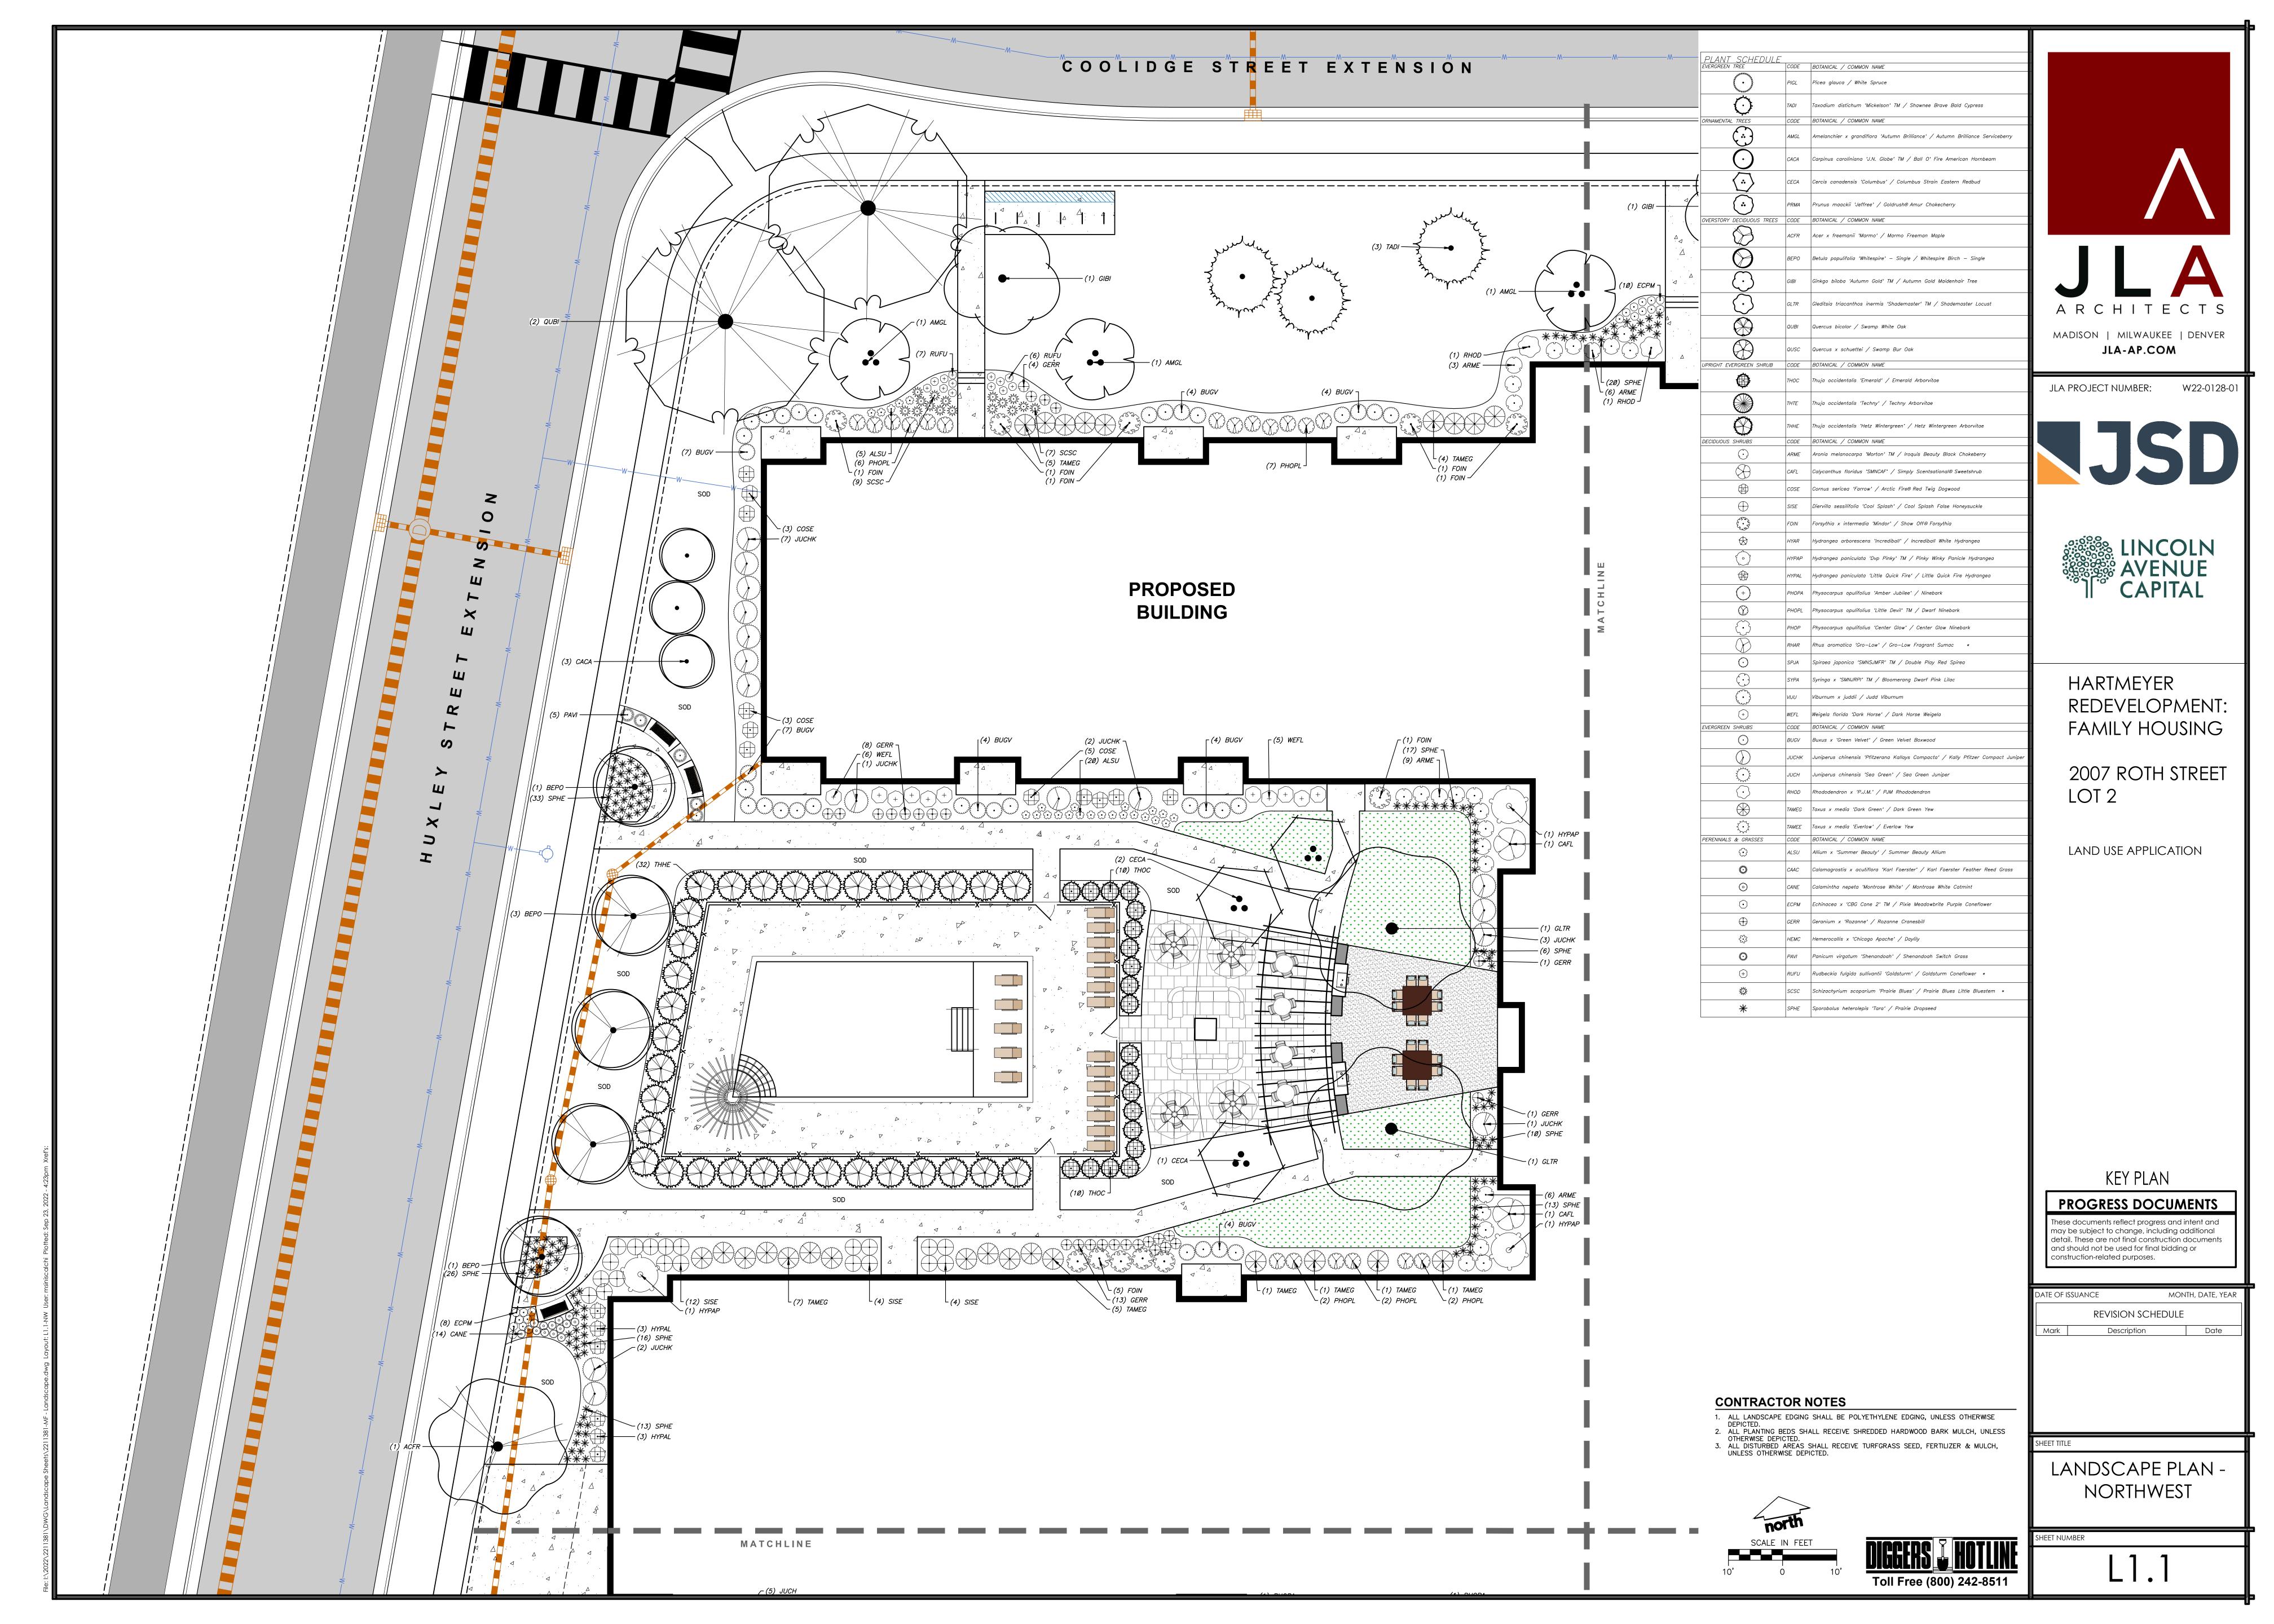

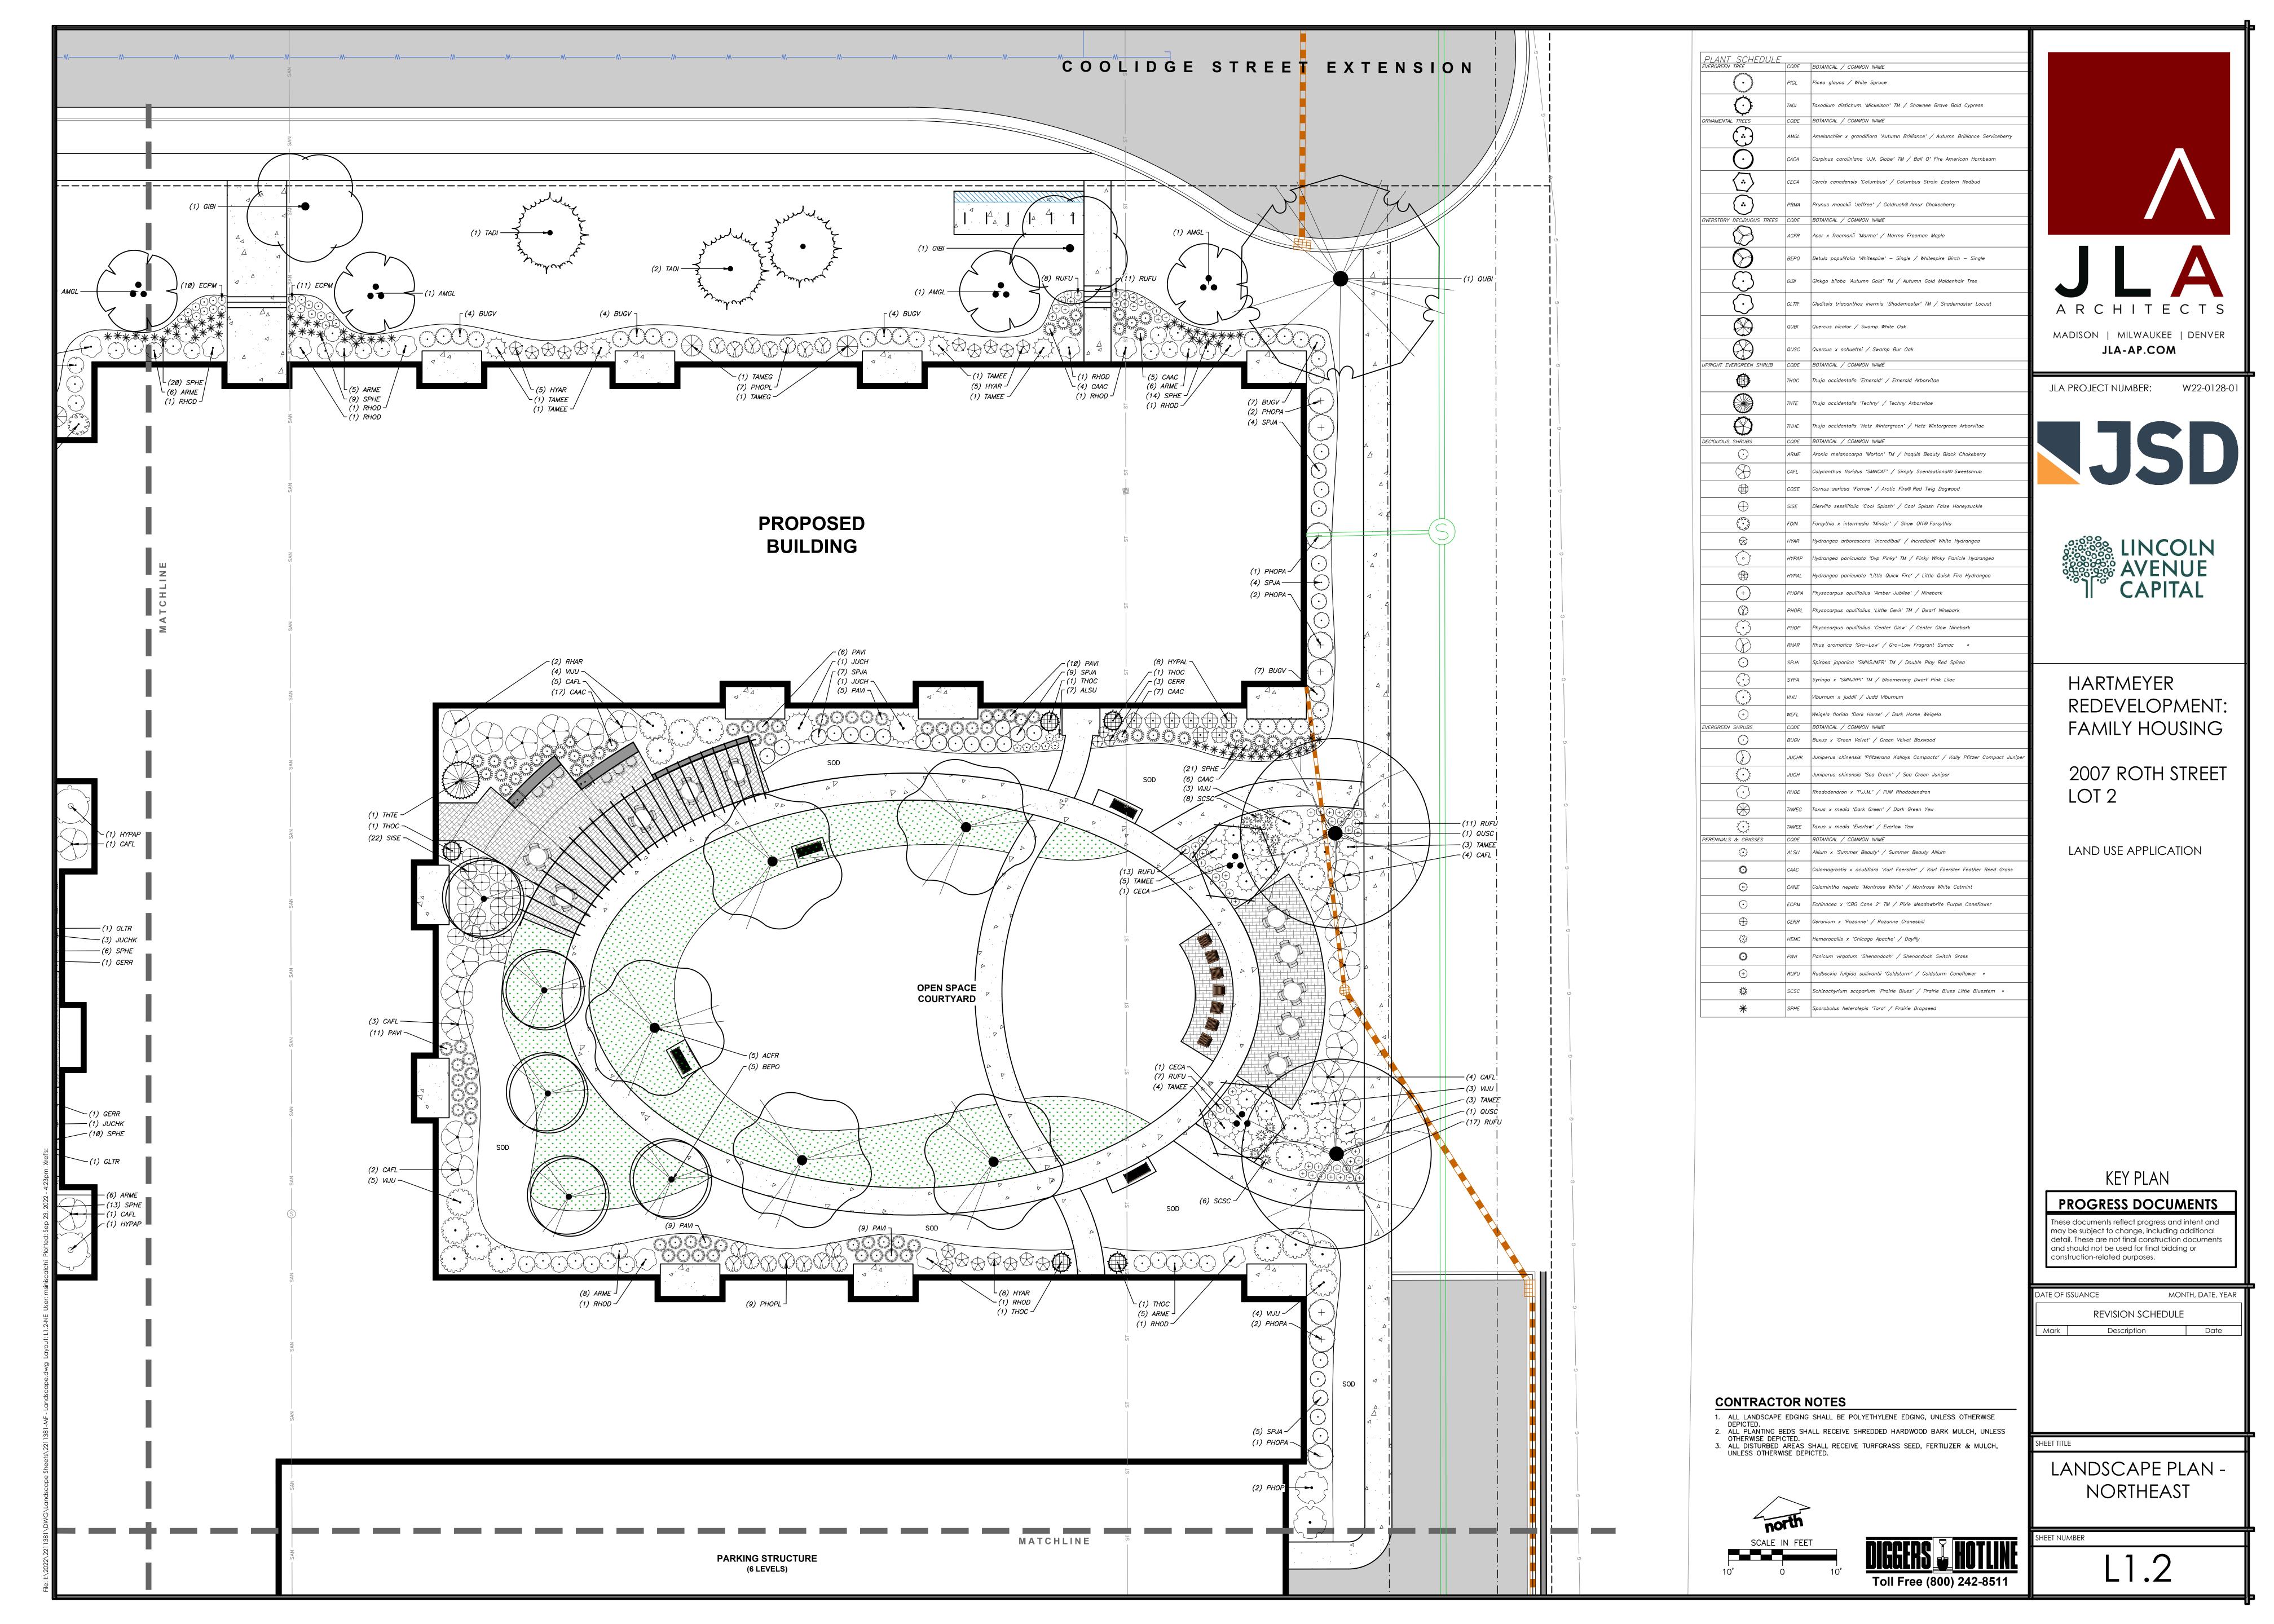

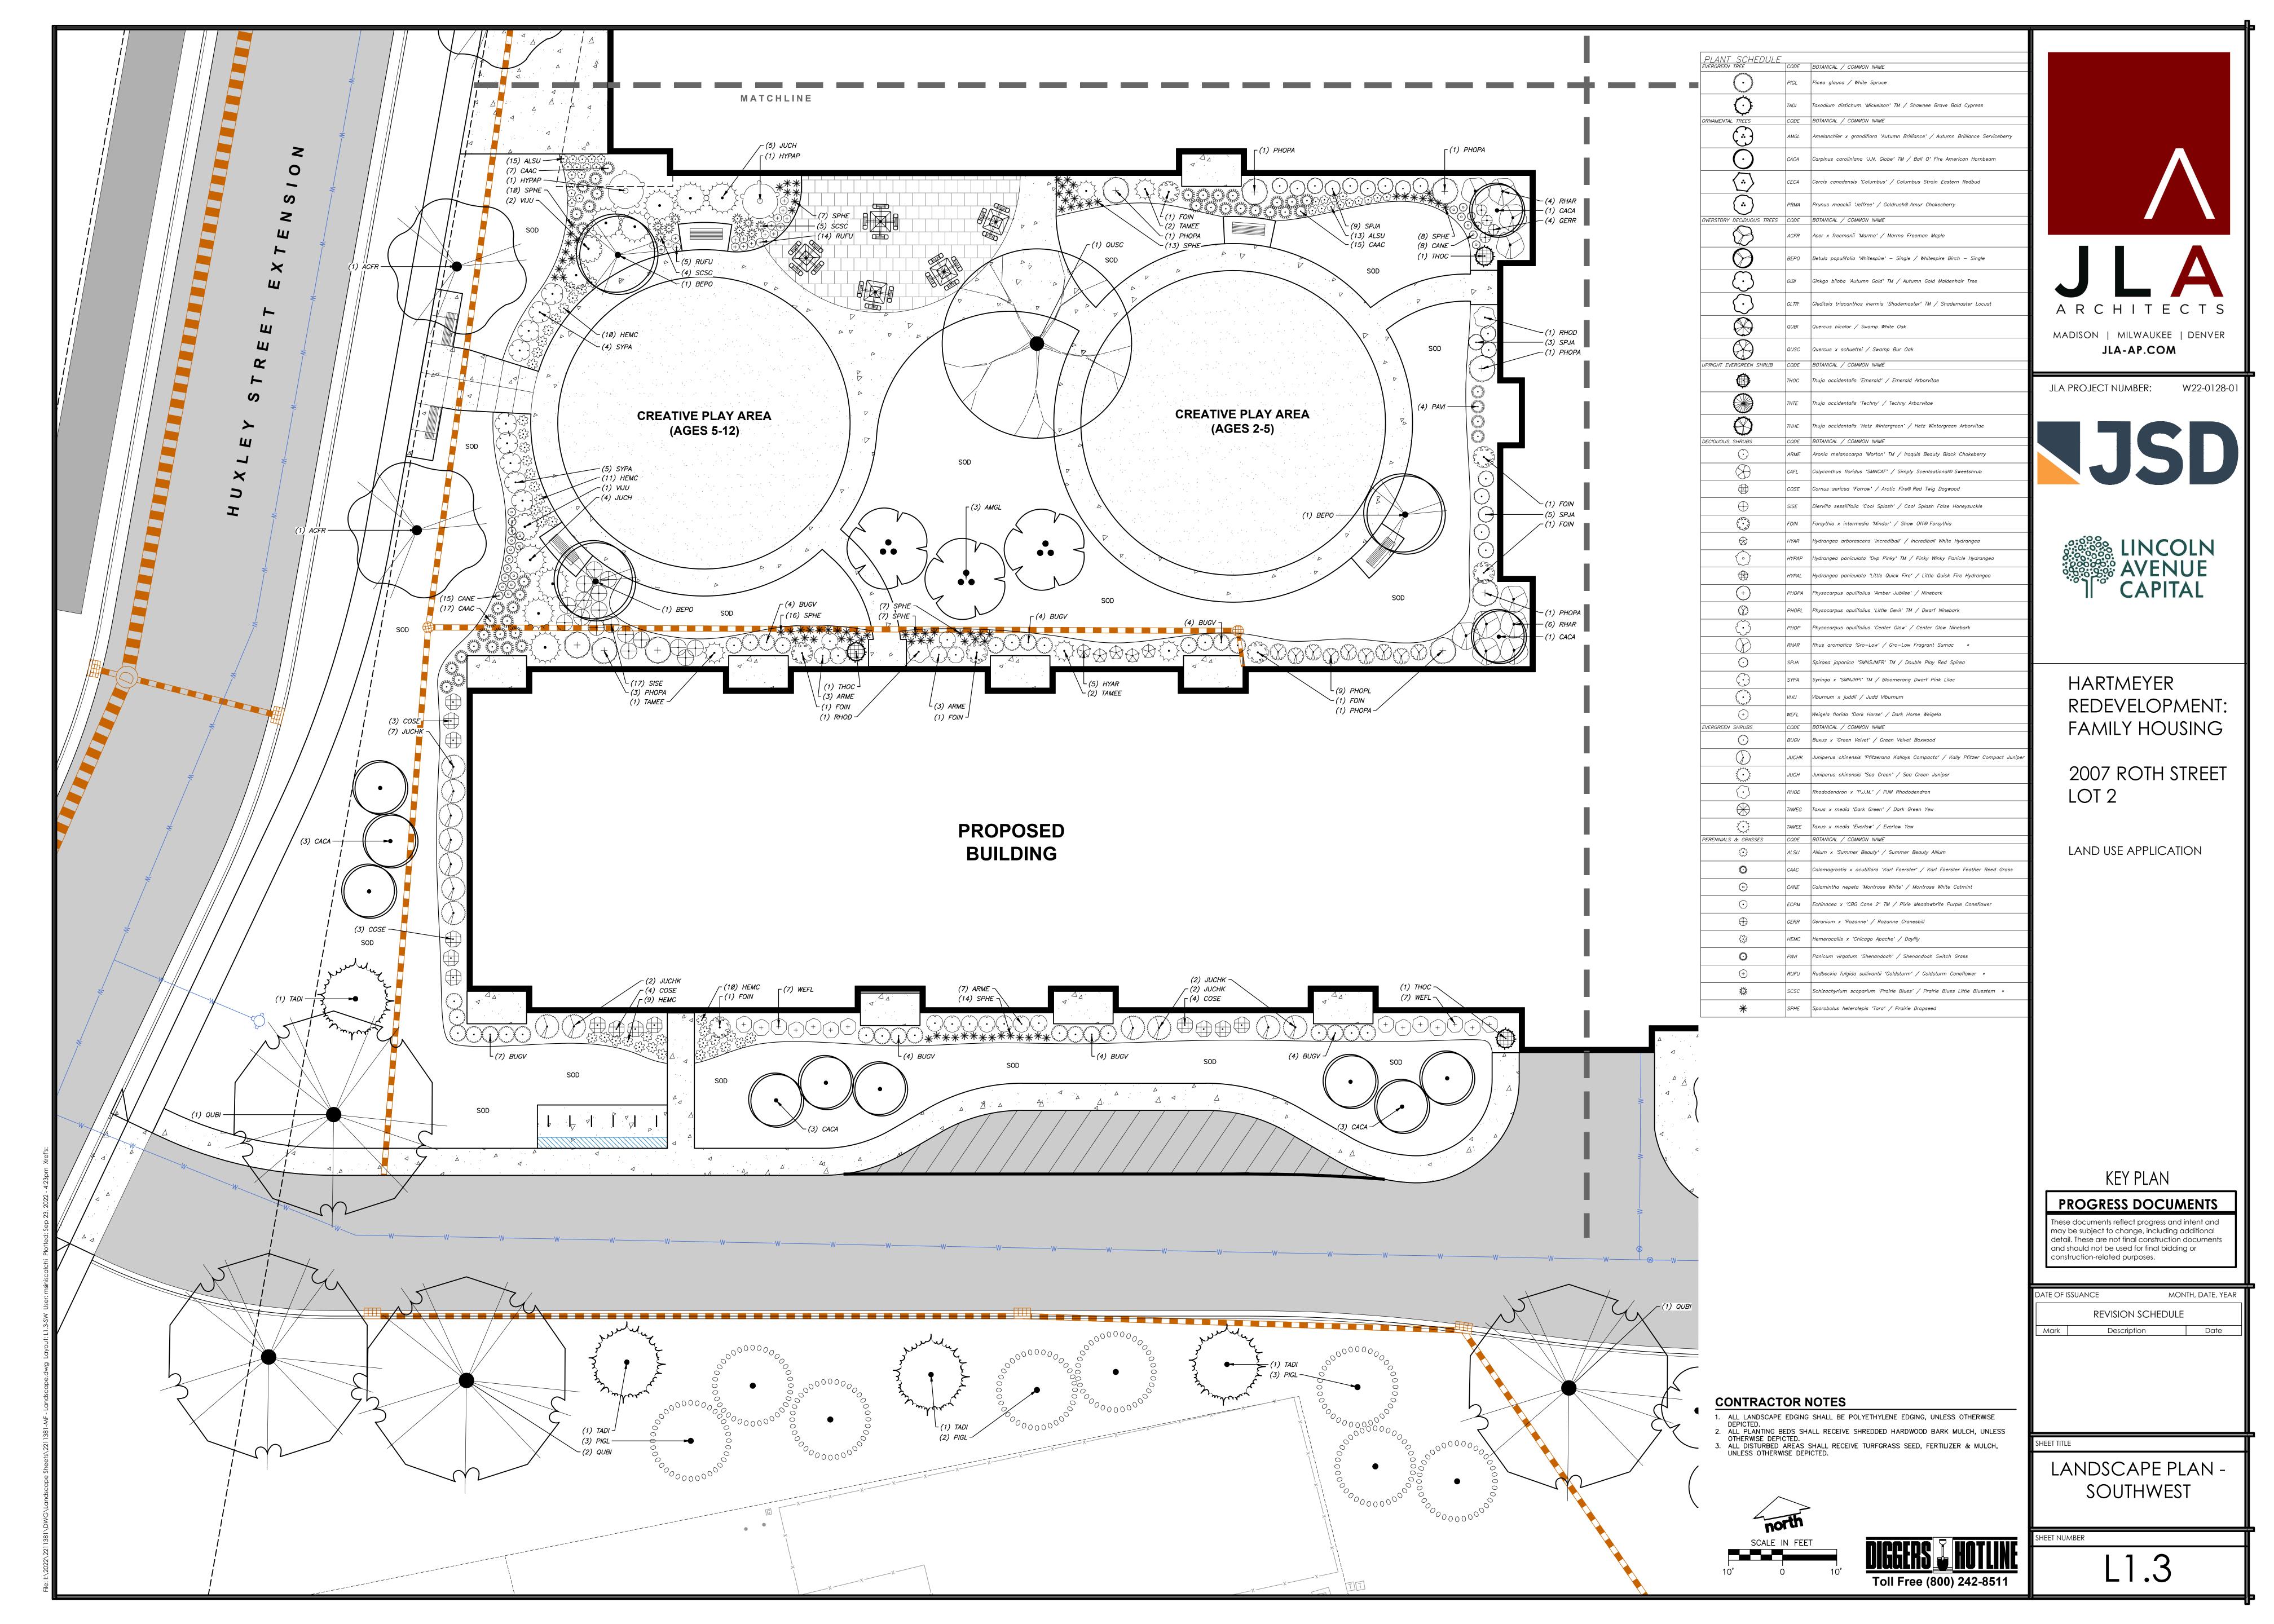

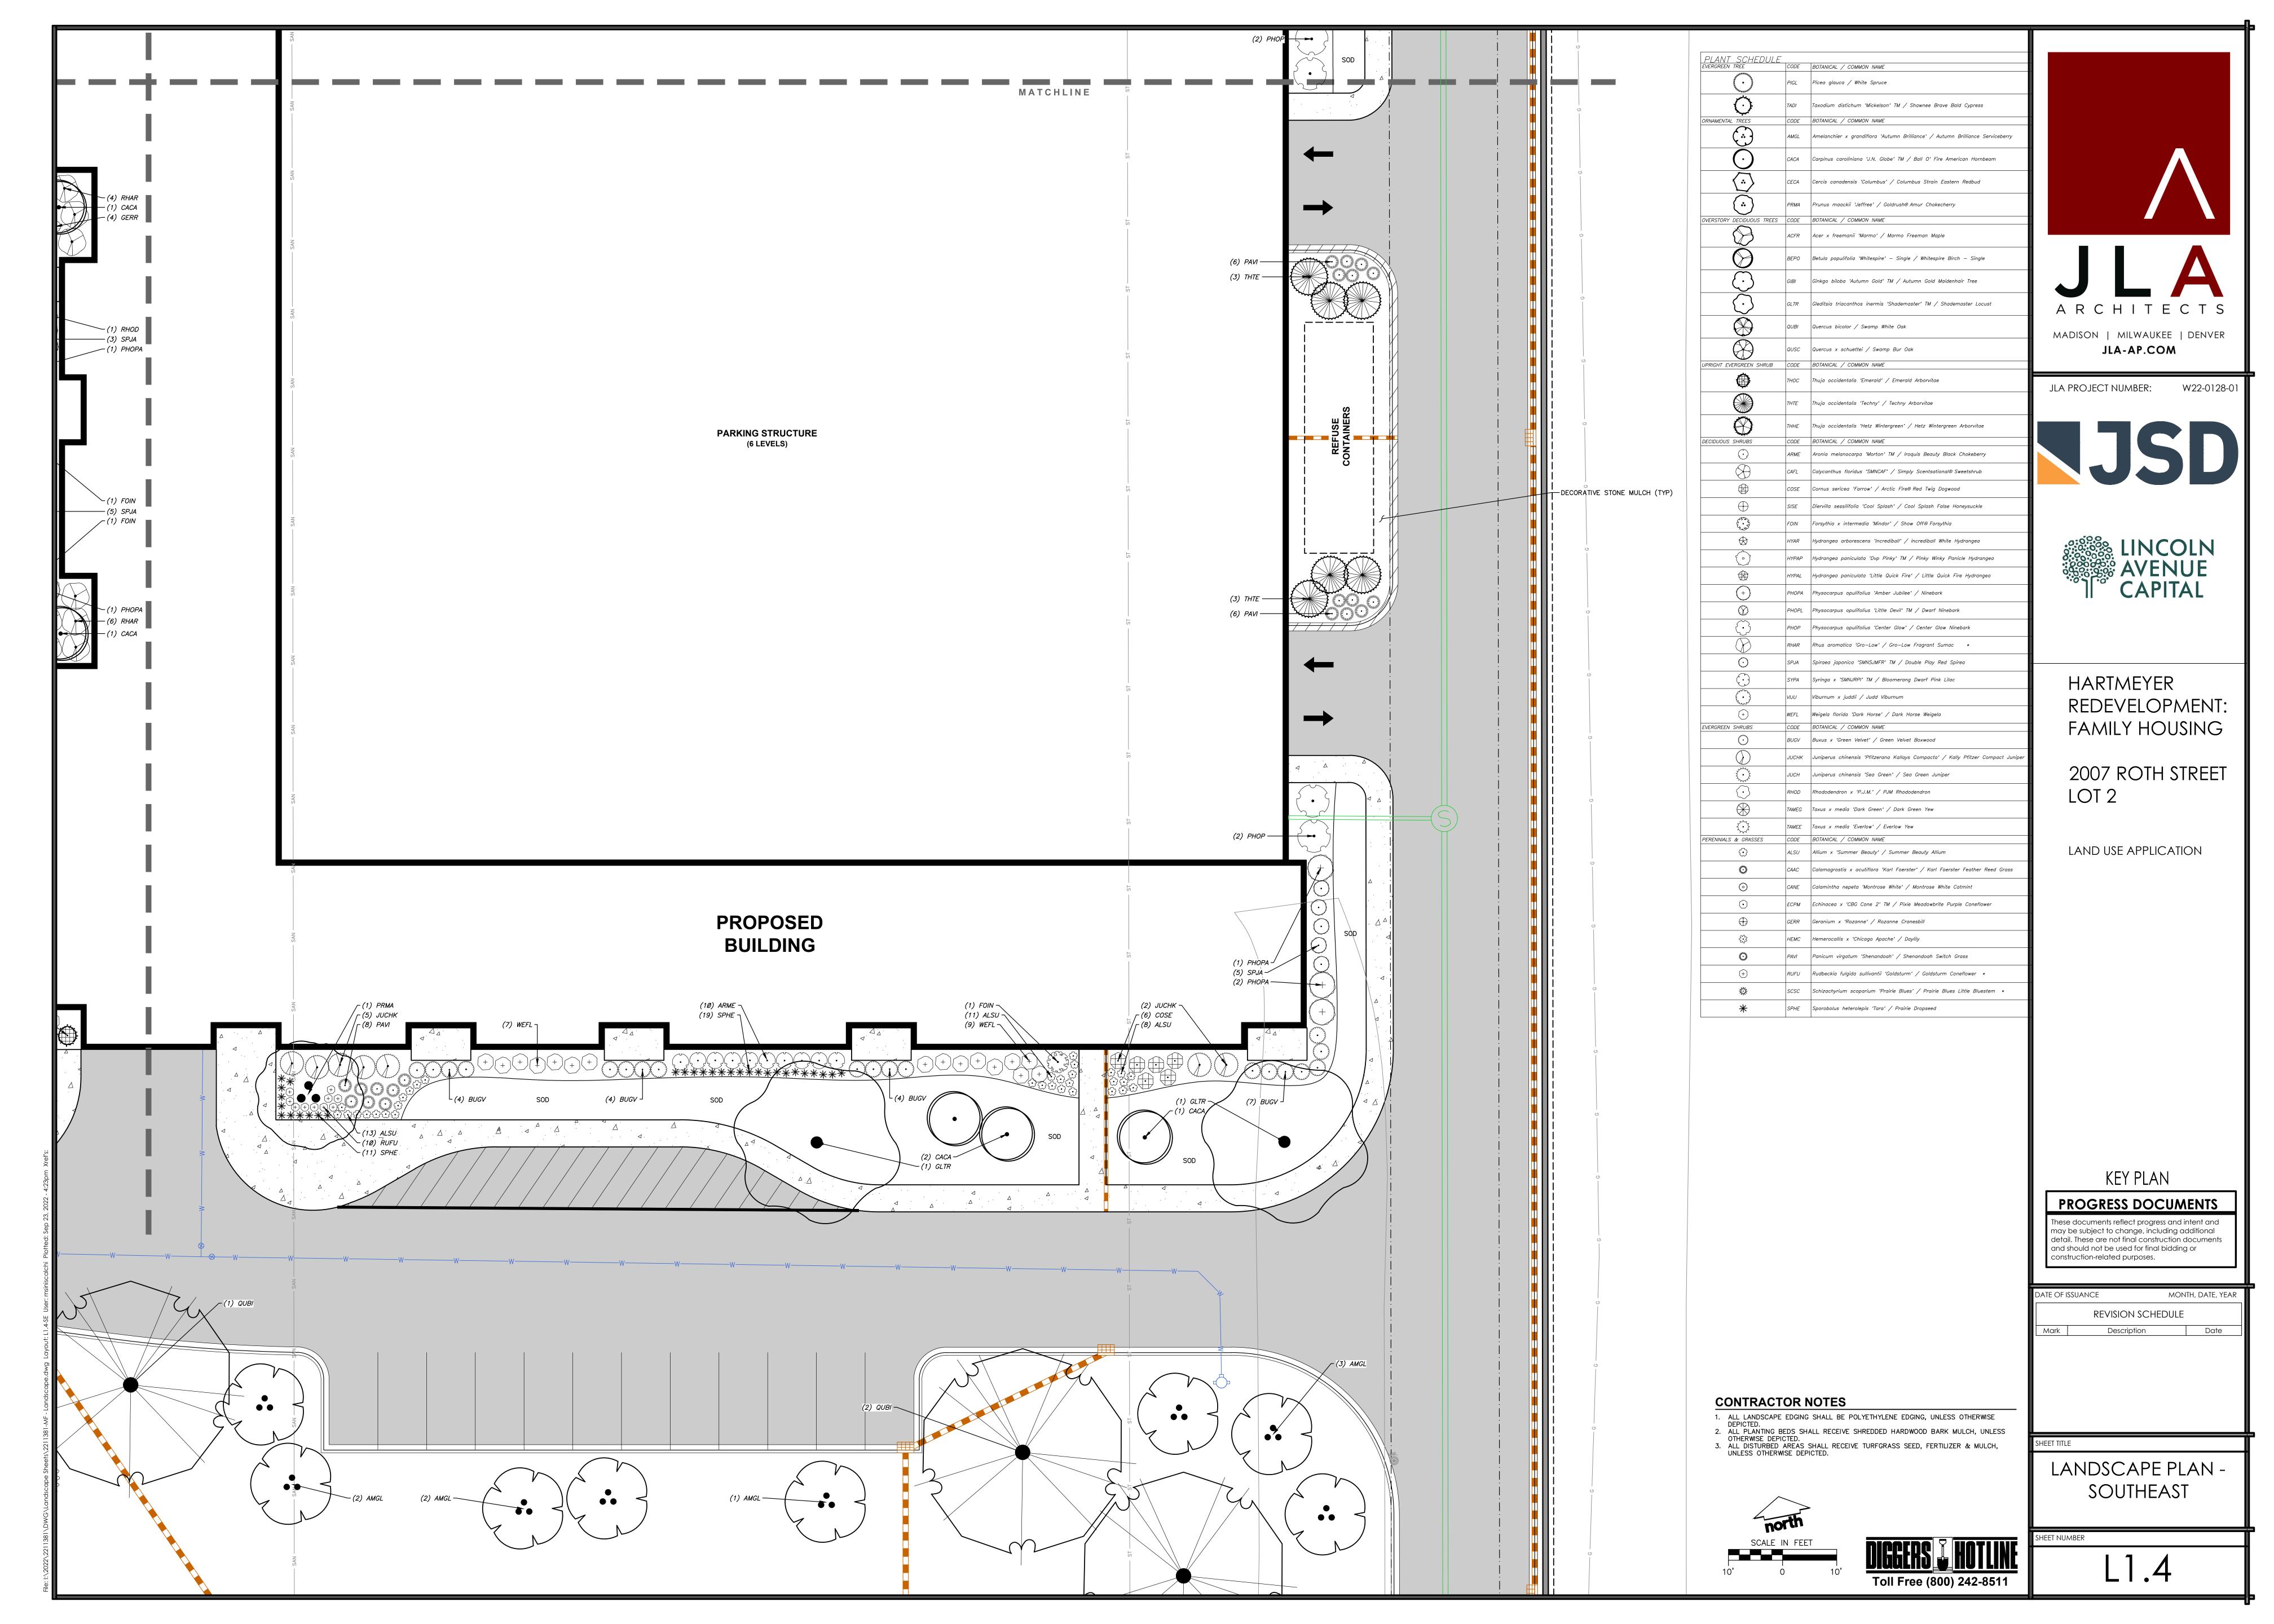

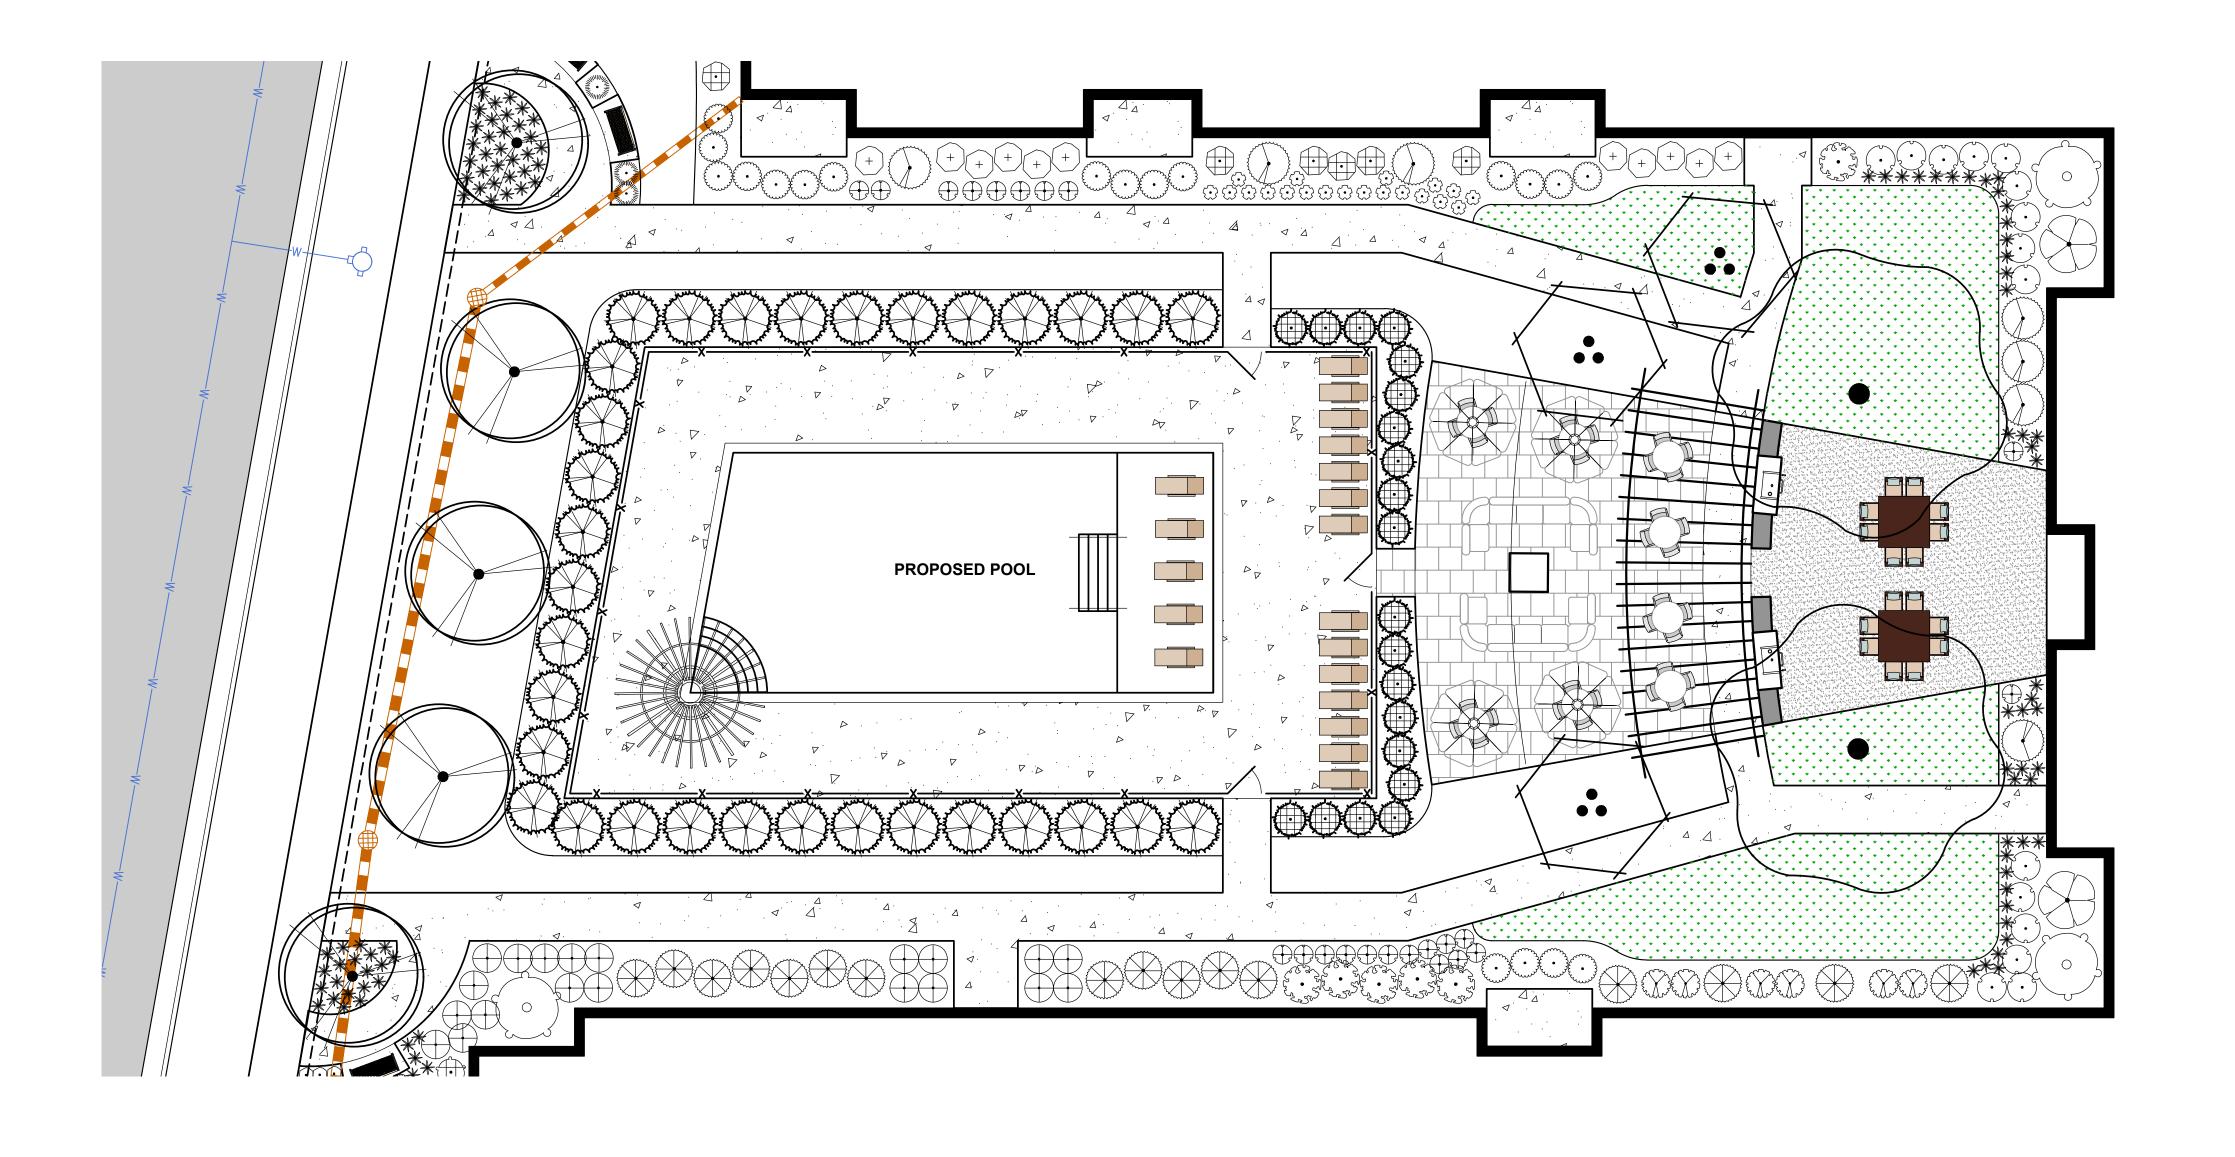







HARTMEYER REDEVELOPMENT: FAMILY HOUSING

2007 ROTH STREET LOT 2


LAND USE APPLICATION

KEY PLAN

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MONTH, DATE, YEAR DATE OF ISSUANCE REVISION SCHEDULE

LANDSCAPE PLAN -NW COURTYARD

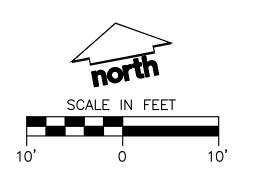


CONTRACTOR NOTES

ALL LANDSCAPE EDGING SHALL BE POLYETHYLENE EDGING, UNLESS OTHERWISE DEPICTED.
 ALL PLANTING BEDS SHALL RECEIVE SHREDDED HARDWOOD BARK MULCH, UNLESS OTHERWISE DEPICTED.
 ALL DISTURBED AREAS SHALL RECEIVE TURFGRASS SEED, FERTILIZER & MULCH, UNLESS OTHERWISE DEPICTED.



SHEET NUMBER

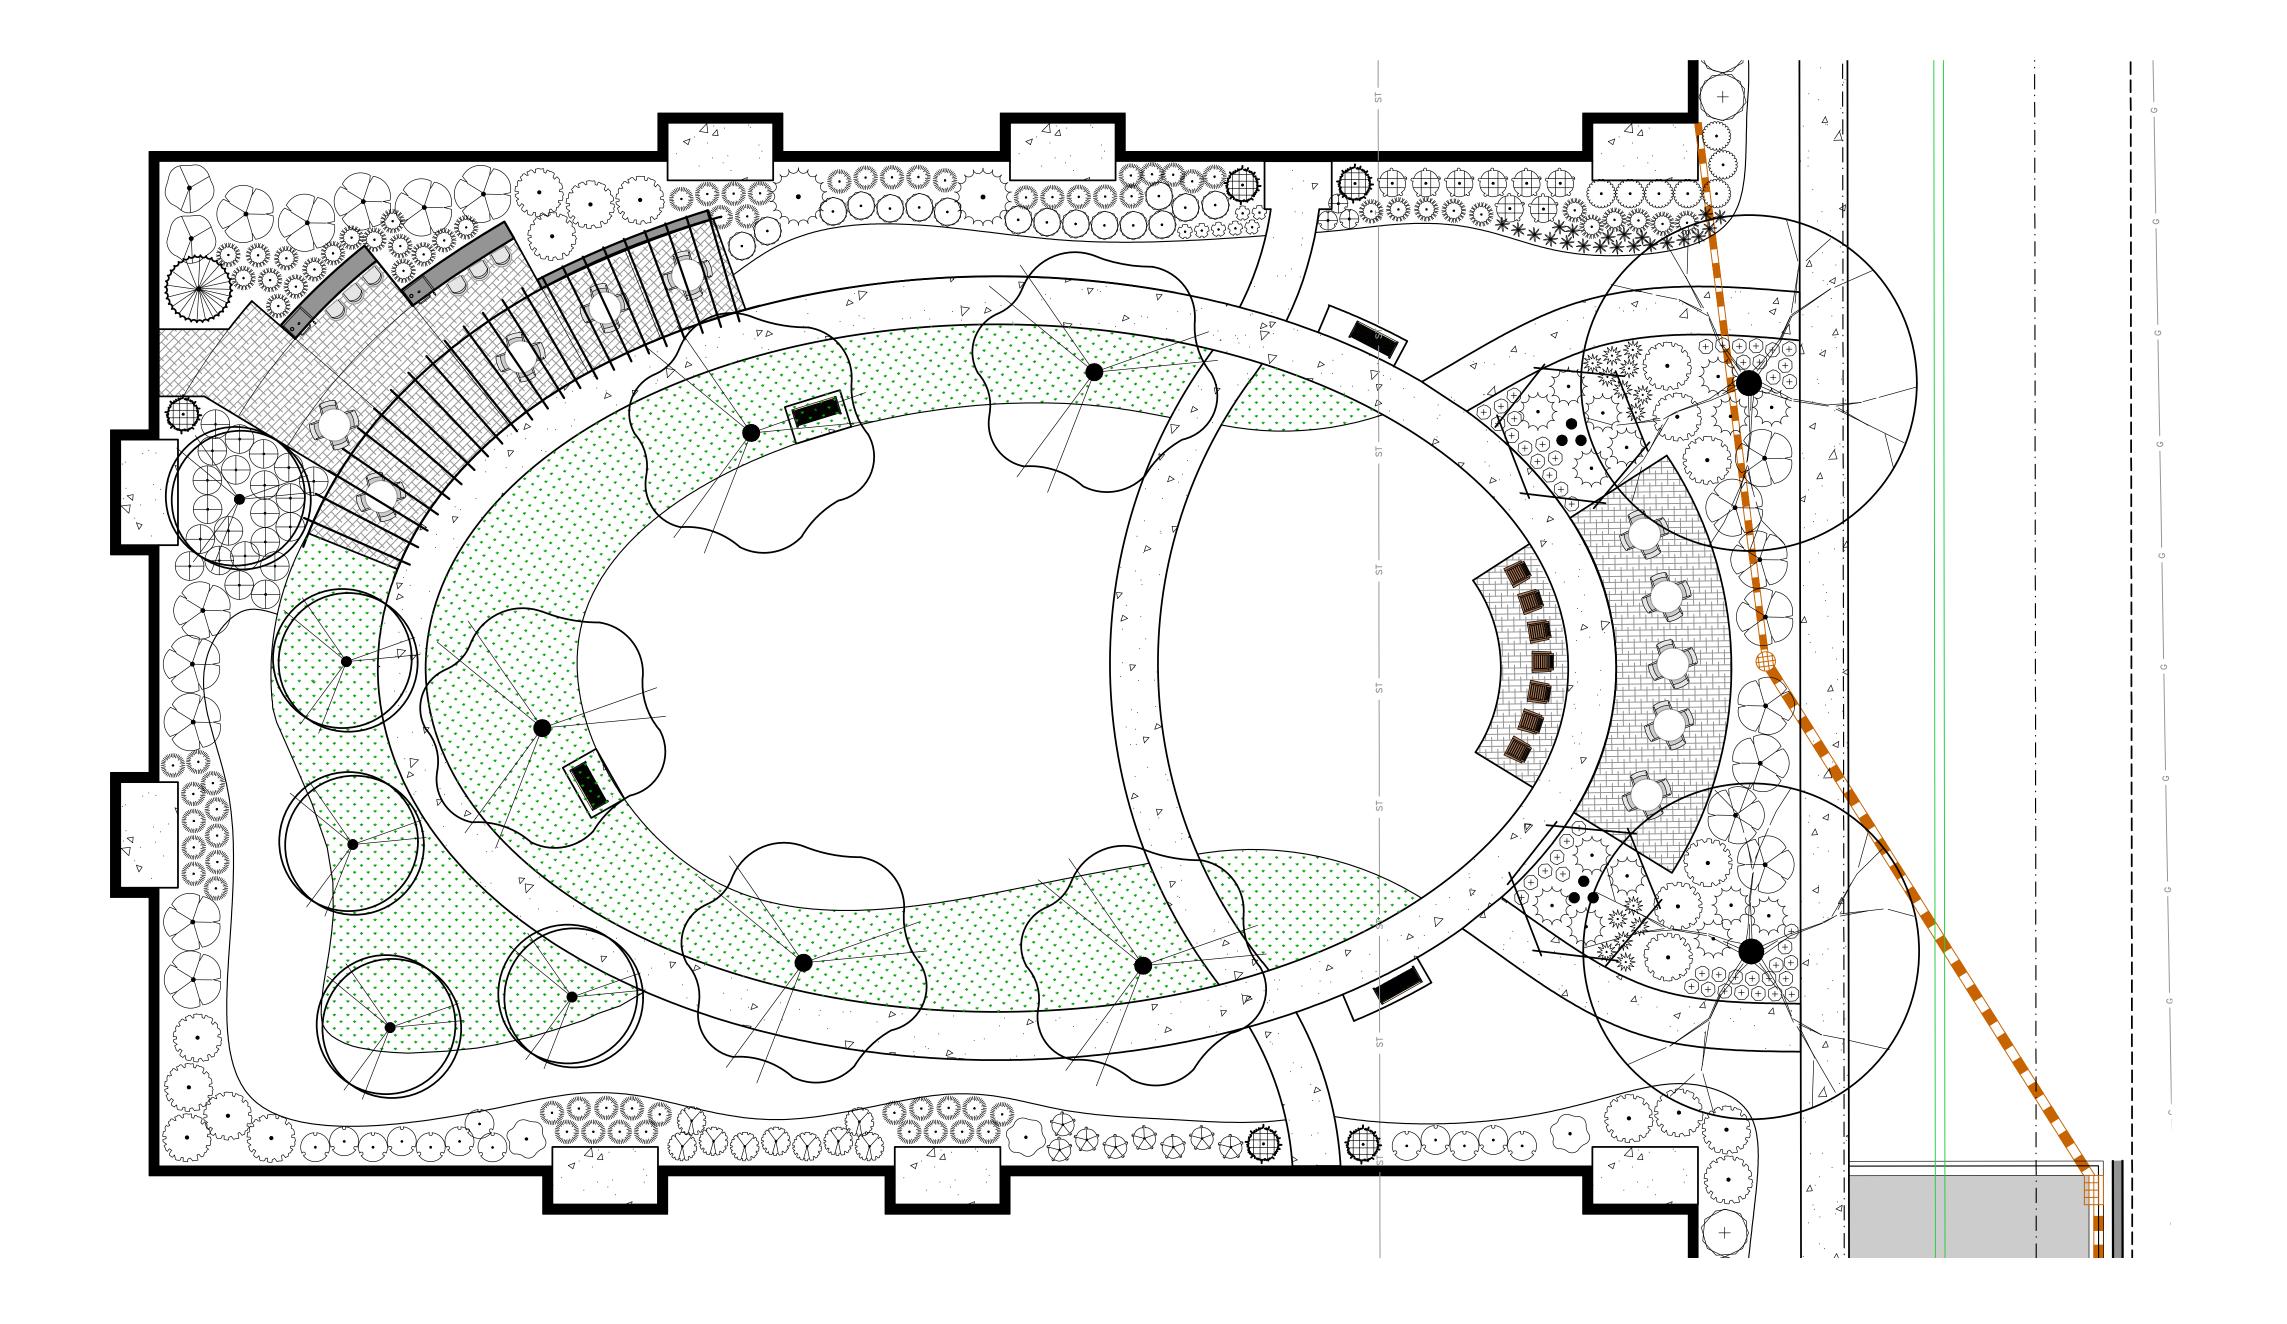



JLA PROJECT NUMBER:





HARTMEYER
REDEVELOPMENT:
FAMILY HOUSING

2007 ROTH STREET LOT 2

LAND USE APPLICATION

KEY PLAN

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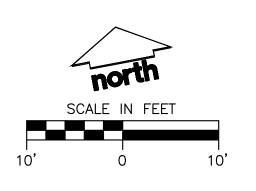
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REVISION SCHEDULE

k Description Date

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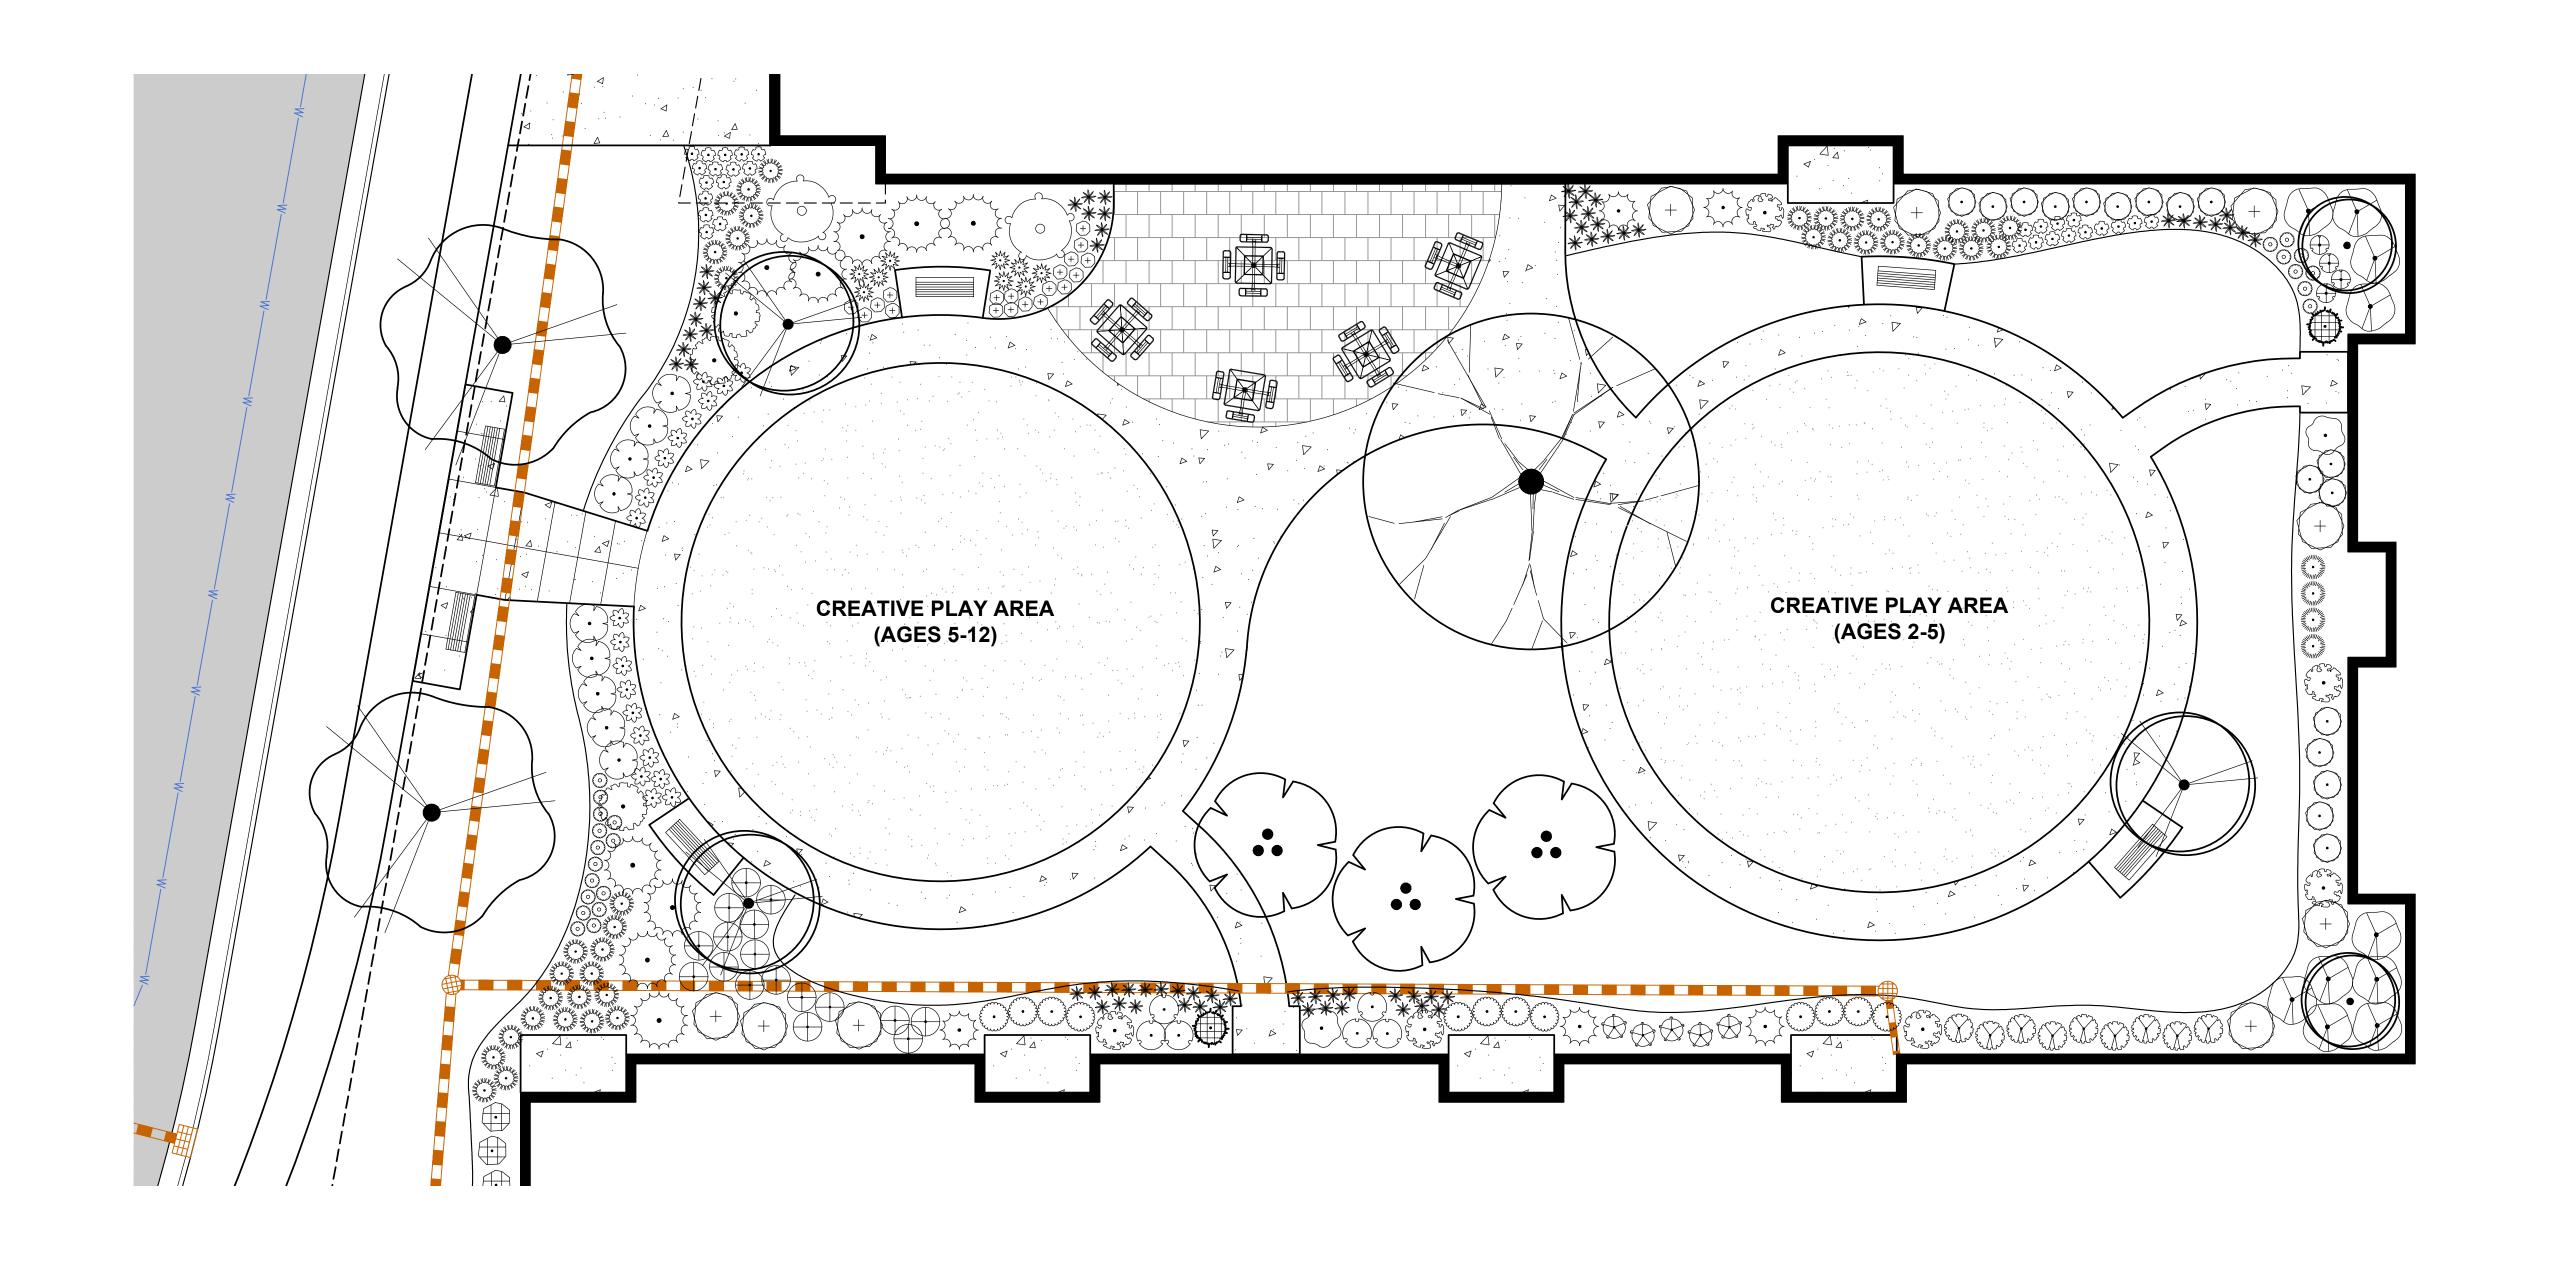


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LANDSCAPE PLAN -NE COURTYARD


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JLA PROJECT NUMBER: W22-0128-01





HARTMEYER
REDEVELOPMENT:
FAMILY HOUSING

2007 ROTH STREET LOT 2

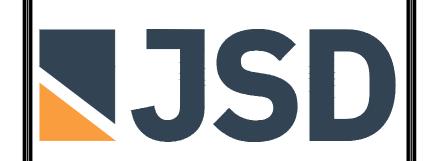LAND USE APPLICATION

KEY PLAN

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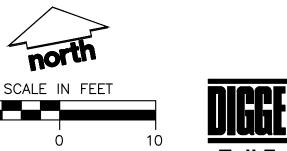
DATE OF ISSUANCE MONTH, DATE, YEAR

REVISION SCHEDULE

Description Date

SHEET TITLE

LANDSCAPE PLAN -SW COURTYARD



ALL LANDSCAPE EDGING SHALL BE POLYETHYLENE EDGING, UNLESS OTHERWISE DEPICTED.
 ALL PLANTING BEDS SHALL RECEIVE SHREDDED HARDWOOD BARK MULCH, UNLESS OTHERWISE DEPICTED.
 ALL DISTURBED AREAS SHALL RECEIVE TURFGRASS SEED, FERTILIZER & MULCH, UNLESS OTHERWISE DEPICTED.

CONTRACTOR NOTES





SHEET NUMBER

2. REMOVE NYLON STRAPPING WITHIN 9–18 MONTHS FOLLOWING INSTALLATION


DECIDUOUS TREE PLANTING DETAIL

N.T.S.

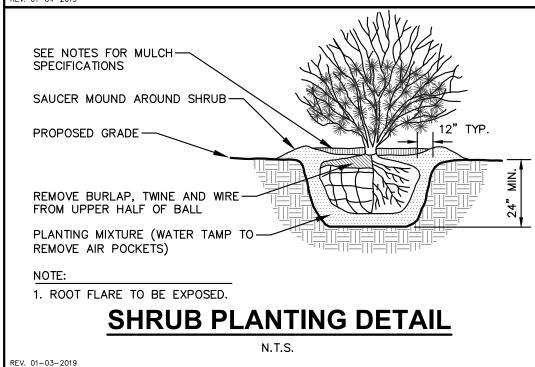

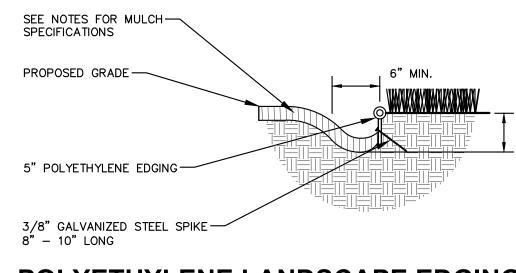


POLYETHYLENE LANDSCAPE EDGING DETAIL

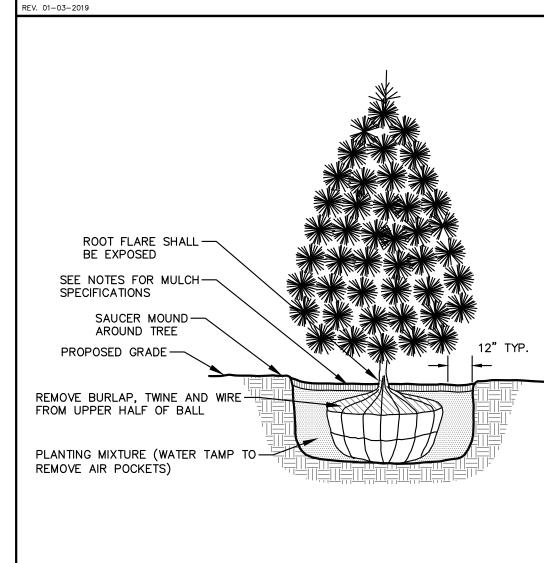

NOTE:

1. DIG HOLE NO DEEPER THAN BASE OF ROOT BALL TO FLARE. ROOT BALL TO BE SET ON UNDISTURBED SOIL UNLESS COMPACTED AGGREGATE STONE REMAINS FROM SITE EXCAVATOR. REMOVE REMAINING AGGREGATE STONE UNTIL SOIL LAYER IS REACHED

EVERGREEN TREE PLANTING DETAIL

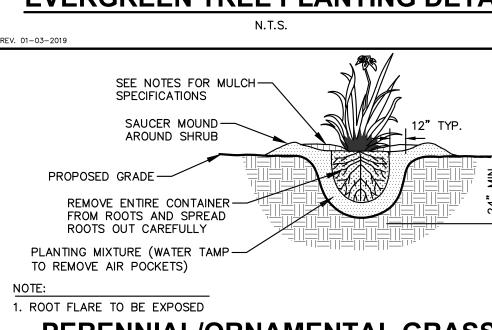

PERENNIAL/ORNAMENTAL GRASS
PLANTING DETAIL

REV. 01-03-2019

N.T.S.

COMPREHENSSIVE PLANT SCHEDULE FVFRGRFFN TRFF BOTANICAL / COMMON NAME | B & B | Min. 6' Ht. Picea glauca / White Spruce Taxodium distichum 'Mickelson' TM / Shawnee Brave Bald Cypress B & B | Min. 6' Ht. BOTANICAL / COMMON NAME ORNAMENTAL TREES Amelanchier x grandiflora 'Autumn Brilliance' / Autumn Brilliance Serviceberry B & B | 1.5" Cal (Multi-Stem) Carpinus caroliniana 'J.N. Globe' TM / Ball O' Fire American Hornbeam B & B | Min. 4' Ht. < ∴ CECA | Cercis canadensis 'Columbus' / Columbus Strain Eastern Redbud |B & B | 2" Cal (Multi-Stem) Prunus maackii 'Jeffree' / Goldrush® Amur Chokecherry | B & B | Min. 6' Ht. OVFRSTORY DECIDUOUS TREES CODE BOTANICAL / COMMON NAME ACFR | Acer x freemanii 'Marmo' / Marmo Freeman Maple B & B | 2.5"Cal Betula populifolia 'Whitespire' - Single / Whitespire Birch - Single B & B | 2.5"Cal | B & B | 2.5"Cal Ginkgo biloba 'Autumn Gold' TM / Autumn Gold Maidenhair Tree Gleditsia triacanthos inermis 'Shademaster' TM / Shademaster Locust B & B | 2.5"Cal B & B | 2"Cal Quercus bicolor / Swamp White Oak Quercus x schuettei / Swamp Bur Oak B & B | 2"Cal UPRIGHT EVERGREEN SHRUB | CODE | BOTANICAL / COMMON NAME Thuja occidentalis 'Emerald' / Emerald Arborvitae | B & B | Min. 3' tall B & B | Min. 5' Ht. Thuja occidentalis 'Techny' / Techny Arborvitae Thuja occidentalis 'Hetz Wintergreen' / Hetz Wintergreen Arborvitae | B & B | Min. 6' Ht. DECIDUOUS SHRUBS BOTANICAL / COMMON NAME Aronia melanocarpa 'Morton' TM / Iroquis Beauty Black Chokeberry Min. 12"-24" |Calycanthus floridus 'SMNCAF' / Simply Scentsational® Sweetshrub B & B | Min. 12"-24" Cornus sericea 'Farrow' / Arctic Fire® Red Twig Dogwood B & B | Min. 12"-24" Diervilla sessilifolia 'Cool Splash' / Cool Splash False Honeysuckle | B & B | Min. 18-24" Ht. Forsythia x intermedia 'Mindor' / Show Off® Forsythia B & B | Min. 18-24" Ht. \bigcirc Min. 12"-24" Hydrangea arborescens 'Incrediball' / Incrediball White Hydrangea Hydrangea paniculata 'Dvp Pinky' TM / Pinky Winky Panicle Hydrangea B & B | Min. 24" Ht. Hydrangea paniculata 'Little Quick Fire' / Little Quick Fire Hydrangea Min. 12"-24" PHOPA | Physocarpus opulifolius 'Amber Jubilee' / Ninebark | B & B | Min. 24" Ht. Physocarpus opulifolius 'Little Devil' TM / Dwarf Ninebark Min. 12"-24" Physocarpus opulifolius 'Center Glow' / Center Glow Ninebark B & B | Min. 24" Ht. | Rhus aromatica 'Gro-Low' / Gro-Low Fragrant Sumac * Min. 12"-24" Spiraea japonica 'SMNSJMFR' TM / Double Play Red Spirea B & B | Min. 24" Ht. | Syringa x 'SMNJRPI' TM / Bloomerang Dwarf Pink Lilac B & B | Min. 24" Ht. Viburnum x juddii / Judd Viburnum Min. 12"-24" Weigela florida 'Dark Horse' / Dark Horse Weigela B & B | Min. 12"-24" **EVERGREEN SHRUBS** BOTANICAL / COMMON NAME Buxus x 'Green Velvet' / Green Velvet Boxwood 3 gal | Min. 12"-24" Juniperus chinensis 'Pfitzerana Kallays Compacta' / Kally Pfitzer Compact Juniper | B & B | Min. 12" Wide Juniperus chinensis 'Sea Green' / Sea Green Juniper B & B | Min. 24" wide Rhododendron x 'P.J.M.' / PJM Rhododendron B & B | Min. 12"-24" TAMEG Taxus x media 'Dark Green' / Dark Green Yew Min. 12"-24" Taxus x media 'Everlow' / Everlow Yew 1in. 12" Wide BOTANICAL / COMMON NAME PERENNIALS & GRASSES Min. 8"-18" Allium x 'Summer Beauty' / Summer Beauty Allium AND THE REAL PROPERTY OF THE PERTY OF THE PE Calamagrostis x acutiflora 'Karl Foerster' / Karl Foerster Feather Reed Grass Min. 8"−18" (\circ) Calamintha nepeta 'Montrose White' / Montrose White Catmint Min. 8"-18" Echinacea x 'CBG Cone 2' TM / Pixie Meadowbrite Purple Coneflower Min. 8"-18" | Geranium x 'Rozanne' / Rozanne Cranesbill 1in. 8"-18" | Hemerocallis x 'Chicago Apache' / Daylily Min. 8"-18" Panicum virgatum 'Shenandoah' / Shenandoah Switch Grass Min. 8"-18" Rudbeckia fulgida sullivantii 'Goldsturm' / Goldsturm Coneflower * Min. 8"-18" SCSC | Schizachyrium scoparium 'Prairie Blues' / Prairie Blues Little Bluestem * Min. 8"-18"

SPHE | Sporobolus heterolepis 'Tara' / Prairie Dropseed

CONTRACTOR AND OWNER RESPONSIBILITY NOTES

REPRESENTATIVE. PLANTS SHALL BE ALIVE AND IN HEALTHY AND FLOURISHING CONDITION AT THE END OF THE GUARANTEE PERIOD. THE CONTRACTOR SHALL REPLACE (AT NO COST TO OWNER) ANY PLANTS THAT ARE DEAD OR NOT IN A VIGOROUS THRIVING CONDITION. REPLACEMENT PLANTS SHALL BE OF THE SAME KIND AND SIZE AS ORIGINALLY SPECIFIED UNLESS OTHERWISE DIRECTED BY OWNER'S REPRESENTATIVE. RESTORE BEDS AS NECESSARY FOLLOWING PLANT REPLACEMENT, INCLUDING BUT NOT LIMITED TO BEDDING, EDGING, MULCH, ETC. REPLACE PLANTS DAMAGED AT TIME OF PLANTING. REPAIR AREAS DISTURBED IN ANY WAY DURING PLANT REPLACEMENT AT NO COST TO OWNER. CONTRACTOR SHALL PROVIDE A ONE (1)—YEAR STRAIGHTENING GUARANTEE FOR ALL TREES.

GUARANTEE: THE CONTRACTOR SHALL GUARANTEE ALL PLANTS THROUGH ONE (1) YEAR AFTER ACCEPTANCE BY THE OWNER'S

2. CONTRACTOR IS RESPONSIBLE FOR STAKING THE PLANT MATERIALS FOR REVIEW BY OWNER'S REPRESENTATIVE PRIOR TO DIGGING AND PLACEMENT AND SHALL COORDINATE ALL FINE GRADING AND RESTORATION WITH THE GRADING CONTRACTOR.

- 3. MAINTENANCE: (CONTRACTOR) FOR ALL PLANTINGS, SEEDED AND/OR SODDED LAWN AREAS: THE CONTRACTOR SHALL MAINTAIN ALL PLANTINGS AND LAWN AREAS FOR A MINIMUM TIME PERIOD OF 60 DAYS, UNTIL FINAL ACCEPTANCE BY OWNER'S REPRESENTATIVE. THE CONTRACTOR IS RESPONSIBLE FOR ADEQUATELY WATERING PLANTS AND LAWN/TURFGRASS DURING THIS 60 DAY ESTABLISHMENT PERIOD. CONTRACTOR IS RESPONSIBLE FOR THE ESTABLISHMENT OF HEALTHY VIGOROUS PLANT MATERIALS AND LAWN/TURFGRASS GROWTH. CONTRACTOR IS ALSO RESPONSIBLE FOR ANY PRUNING OF PLANT MATERIALS, AND SHAPING AND/OR REPLACEMENT OR SUPPLEMENT OF DEFICIENT SHREDDED HARDWOOD BARK MULCH DURING THIS PERIOD. LONG TERM PLANT MATERIALS AND LAWN/TURFGRASS MAINTENANCE AND ANY PROGRAM FOR SUCH IS THE RESPONSIBILITY OF THE OWNER. ALL PLANTINGS AND LAWN/TURFGRASS AREAS SHALL BE MAINTAINED IN A MANICURED CONDITION UNTIL THE TIME WHEN THE OWNER'S ACCEPTANCE IS GIVEN.
- 4. MAINTENANCE: (OWNER) THE OWNER IS RESPONSIBLE FOR THE CONTINUED MAINTENANCE, REPAIR AND REPLACEMENT OF ALL LANDSCAPING MATERIALS AND WEED BARRIER FABRIC AS NECESSARY FOLLOWING THE ONE (1) YEAR CONTRACTOR GUARANTEE PERIOD.

LANDSCAPE CALCULATIONS AND DISTRIBUTIONS

- Required landscaped areas shall be calculated based upon the total developed area of the property. Developed area is defined as that area within a single contiguous boundary which is made up of structures, parking, driveways and docking/loading facilities, but excluding the area of any building footprint at grade, land designated for open space uses such as athletic fields, and undeveloped land area on the same zoning lot. There are three methods for calculating landscape points depending on the size of the lot and Zoning District.
- (A) For all lots except those described in (B) and (C) below, five (5) landscape points shall be provided for each three hundred (300) square feet of developed area

Total square footage of developed area: 57,166 SQUARE FEET

Total landscape points required: 953 POINTS

(B) — For lots larger than five (5) acres, points shall be provided at five (5) points per three hundred (300) square feet for the first Five (5) developed acres, and one (1) point per one hundred (100) square feet for all additional acres.

Five (5) acres =

First five (5) developed acres =

Total landscape points required:

LANDSCAPE FURNITURE

DEVELOPED AREA. CANNOT

TOTAL REQUIRED POINTS)

COMPRISE MORE THAN 5% OF

TOTAL NUMBER OF POINTS PROVIDED

(C) For the Industrial – Limited (IL) and Industrial – General (IG) districts, one (1) point shall be provided ——per one hundred (100) square feet of developed area.

TABU	ILATION OF LA	ANDSCA	PE CRED	ITS AND	POINTS	•
				'EXISTING CAPING	NEW / PROPOSED LANDSCAPING	
PLANT TYPE/ELEMENT	MINIMUM INSTALLATION SIZE	POINTS	QUANTITY	POINTS ACHIEVED	QUANTITY	POINTS ACHIEVED
OVERSTORY DECIDUOUS TREE	2.5" CAL MIN.	35	40	1400	0	0
TALL EVERGREEN TREE	5-6' TALL MIN.	35	18	630	0	0
ORNAMENTAL TREE	1.5" CAL MIN.	15	40	600	0	0
UPRIGHT EVERGREEN SHRUB	3-4' TALL, MIN.	10	67	670	0	0
SHRUB, DECIDUOUS	#3 CONT., MIN. 12"-24"	3	445	1335	0	0
SHRUB, EVERGREEN	#3 CONT., MIN. 12"-24"	4	220	880	0	0
ORNAMENTAL GRASS & PERENNIAL	#1 CONT., MIN. 8"-18"	2	845	1690	0	0
ORNAMENTAL / DECORATIVE FENCING OR WALL	4 POINTS / 10 LF	.4	0	0	0	0
EXISTING SIGNIFICANT SPECIMAN TREE	14 POINTS / CAL. (MAXIMUM 200 POINTS PER TREE)	14	0	0	0	0
	5 POINTS PER SEAT					

7,205

GENERAL NOTES

- 1. GENERAL: ALL WORK IN THE R-O-W AND PUBLIC EASEMENTS SHALL BE IN ACCORDANCE WITH LOCAL MUNICIPAL REQUIREMENTS. JSD SHALL BE HELD HARMLESS AND DOES NOT WARRANT ANY DEVIATIONS BY THE OWNER/CONTRACTOR FROM THE APPROVED CONSTRUCTION PLANS THAT MAY RESULT IN DISCIPLINARY ACTIONS BY ANY OR ALL REGULATORY AGENCIES. LOCATE ALL UTILITIES PRIOR TO CONSTRUCTION. THE CONTRACTOR IS RESPONSIBLE FOR REPAIRING ANY DAMAGE DONE TO UTILITIES. CONTRACTOR MUST CALL 1-800-242-8511 FOR UTILITY LOCATIONS AT LEAST THREE DAYS PRIOR TO DIGGING. HAND DIG AND INSTALL ALL PLANTS THAT ARE NEAR EXISTING UTILITIES. PROTECT PREVIOUSLY INSTALLED WORK OF OTHER TRADES. CONTRACTOR IS RESPONSIBLE FOR STAKING THE PLANT MATERIALS FOR REVIEW BY OWNER PRIOR TO DIGGING AND PLACEMENT AND SHALL COORDINATE ALL FINE GRADING AND RESTORATION WITH THE GRADING CONTRACTOR.
- 2. DELIVERY AND HANDLING: DO NOT DELIVER MORE PLANT MATERIALS THAN CAN BE PLANTED IN ONE DAY, UNLESS ADEQUATE, APPROPRIATE AND SECURE STORAGE IS PROVIDED AND APPROVED BY OWNER'S REPRESENTATIVE. AT ALL TIMES, PROTECT ALL PLANT MATERIALS FROM WIND AND DIRECT SUN. DELIVER PLANTS WITH LEGIBLE IDENTIFICATION LABELS. PROTECT PLANTS DURING DELIVERY AND DO NOT PRUNE PRIOR TO DELIVERY. ALL TREES AND SHRUBS SHALL BE PLANTED ON THE DAY OF DELIVERY; IF THIS IS NOT POSSIBLE, PROTECT THE PLANT MATERIALS NOT PLANTED BY STORING THEM IN A SHADED, SECURE AREA, PROTECTING THE ROOT MASS WITH WET SOIL, MULCH, HAY OR OTHER SUITABLE MEDIUM. CONTRACTOR TO KEEP ALL PLANT MATERIALS ADEQUATELY WATERED TO PREVENT ROOT DESICCATION. DO NOT REMOVE CONTAINER GROWN STOCK FROM CONTAINERS BEFORE TIME OF PLANTING. DO NOT PICK UP CONTAINER OR BALLED PLANTS BY STEM OR ROOTS. ALL PLANTS SHALL BE LIFTED AND HANDLED FROM THE BOTTOM OF THE CONTAINER OR BALL. PERFORM ACTUAL PLANTING ONLY WHEN WEATHER AND SOIL CONDITIONS ARE SUITABLE IN ACCORDANCE WITH LOCALLY ACCEPTED BEST HORTICULTURAL PRACTICES.
- 3. MATERIALS PLANTS: ALL PLANTS SHALL CONFORM TO THE LATEST VERSION OF THE AMERICAN STANDARD FOR NURSERY STOCK ANSI Z60.1. PLANTS SHALL BE TRUE TO SPECIES AND VARIETY SPECIFIED AND NURSERY GROWN IN ACCORDANCE WITH GOOD HORTICULTURAL PRACTICES UNDER CLIMATIC CONDITIONS SIMILAR TO THOSE IN THE LOCALITY OF THE PROJECT FOR AT LEAST 2 YEARS. PLANTS SHALL BE FRESHLY DUG (DURING THE MOST RECENT FAVORABLE HARVEST SEASON). PLANTS SHALL BE SO TRAINED IN DEVELOPMENT AND APPEARANCE AS TO BE UNQUESTIONABLY SUPERIOR IN FORM, COMPACTNESS, AND SYMMETRY. PLANTS SHALL BE SOUND, HEALTHY, VIGOROUS, WELL BRANCHED AND DENSELY FOLIATED WHEN IN LEAF, AND FREE OF DISEASE AND INSECTS (ADULT EGGS, PUPAE OR LARVAE). THEY SHALL HAVE HEALTHY, WELL—DEVELOPED ROOT SYSTEMS AND SHALL BE FREE FROM PHYSICAL DAMAGE OR OTHER CONDITIONS THAT WOULD PREVENT THRIVING GROWTH OR PREMATURE MORTALITY. PLANTS SHALL BE OF THE HIGHEST QUALITY, POSSESS TYPICAL GROWTH HABITS AND FORM FOR THEIR SPECIES AND BE FREE OF INJURY. PARKWAY TREES AND PARKING LOT TREES SHALL HAVE A MINIMUM BRANCHING HEIGHT OF SIX (6) FEET ABOVE THE GROUND TO ALLOW ADEQUATE VISUAL AND PHYSICAL CLEARANCE.
- 4. PRUNING: THE CONTRACTOR SHALL PRUNE ALL TREES AND REPAIR ANY INJURIES THAT OCCURRED DURING THE PLANTING PROCESS. DOUBLE LEADERS, DEAD BRANCHES, AND LIMBS DAMAGED OR BROKEN DURING THE PLANTING PROCESS, SHALL BE PRUNED. THIS SHALL BE THE ONLY PRUNING ALLOWED AT PLANTING. PRUNING SHALL CONFORM TO THE LATEST VERSION OF THE AMERICAN STANDARD FOR TREE CARE OPERATIONS, ANSI A300. PRUNE TREES IN ACCORDANCE WITH NAA GUIDELINES. DO NOT TOP TREES. PRUNE SHRUBS ACCORDING TO STANDARD HORTICULTURAL PRACTICES. ON CUTS OVER 3/4" IN DIAMETER AND BRUISES OR SCARS ON BARK, TRACE THE INJURED CAMBIUM LAYER BACK TO LIVING TISSUE AND REMOVE. SMOOTH AND SHAPE WOUNDS SO AS NOT TO RETAIN WATER. TREAT THE AREA WITH AN APPROVED INCONSPICUOUS LATEX BASED ANTISEPTIC TREE PAINT, IF PRUNING OCCURS "IN SEASON". DO NOT PRUNE ANY OAK TREES DURING THE MONTHS FROM APRIL TO OCTOBER.
- 5. CLEANUP: THE WORK AREA SHALL BE KEPT SAFE AND NEAT AT ALL TIMES. DISPOSED OF EXCESS SOIL. REMOVE ALL CUTTINGS AND WASTE MATERIALS. SOIL AND BRANCHES. BIND AND WRAP THESE MATERIALS, ANY REJECTED PLANTS, AND ANY OTHER DEBRIS RESULTING FROM ALL PLANTING TASKS AND PROMPTLY CLEAN UP AND REMOVE FROM THE PROJECT SITE. UNDER NO CIRCUMSTANCES SHALL THE ACCUMULATION OF SOIL, BRANCHES OR OTHER DEBRIS BE ALLOWED UPON A PUBLIC PROPERTY IN SUCH A MANNER AS TO RESULT IN A PUBLIC SAFETY HAZARD OR DAMAGE. LIKEWISE, UNDER NO CIRCUMSTANCES SHALL ANY DEBRIS OR INCIDENTAL MATERIALS BE ALLOWED UPON ADJACENT PRIVATE PROPERTY.
- 6. ANY SUBSTITUTIONS IN PLANT TYPE, LOCATION, OR SIZE SHALL BE APPROVED BY LANDSCAPE ARCHITECT PRIOR TO INSTALLATION.
- 7. CONTRACTOR TO VERIFY PLANT MATERIAL QUANTITIES AND SQUARE FOOTAGES. QUANTITIES SHOWN ON PLAN TAKE PRECEDENCE OVER THOSE ON SCHEDULE.

LANDSCAPE MATERIAL NOTES

- MATERIALS PLANTING MIXTURE: ALL HOLES EXCAVATED FOR TREES, SHRUBS, PERENNIALS AND ORNAMENTAL GRASSES SHALL BE BACKFILLED WITH TWO (2) PARTS TOPSOIL, ONE (1) PART SAND AND ONE (1) PART COMPOST. SOIL MIXTURE SHALL BE WELL BLENDED PRIOR TO INSTALLATION.
- 2. MATERIALS TOPSOIL: TOPSOIL TO BE CLEAN, FRIABLE LOAM FROM A LOCAL SOURCE, FREE FROM STONES OR DEBRIS OVER 3/4" IN DIAMETER, AND FREE FROM TOXINS OR OTHER DELETERIOUS MATERIALS. TOPSOIL SHALL HAVE A pH VALUE BETWEEN 6 AND 7. TOPSOIL AND PLANTING SOIL SHALL BE TESTED TO ENSURE CONFORMANCE WITH THESE SPECIFICATIONS AND SHALL BE AMENDED TO MEET THESE SPECIFICATIONS. PROVIDE TEST RESULTS TO OWNER'S REPRESENTATIVE PRIOR TO PLACEMENT. DO NOT PLACE FROZEN OR MUDDY TOPSOIL. APPLY SOIL AMENDMENTS TO ALL LANDSCAPE AREAS PER SOIL TEST.
- 3. MATERIALS SHREDDED HARDWOOD BARK MULCH: ALL PLANTING AREAS LABELED ON PLAN SHALL RECEIVE CERTIFIED WEED FREE SHREDDED HARDWOOD BARK MULCH INSTALLED TO A MINIMUM AND CONSISTENT DEPTH OF 3—INCHES. SHREDDED HARDWOOD BARK MULCH SIZE & COLOR TO BE APPROVED BY OWNER'S REPRESENTATIVE PRIOR TO INSTALLATION. FERTILIZER SHALL BE IN ACCORDANCE WITH APPLICABLE LOCAL, COUNTY AND STATE REQUIREMENTS. SHREDDED HARDWOOD BARK MULCH AREAS SHALL NOT RECEIVE WOVEN WEED BARRIER FABRIC.
- 4. MATERIALS DECORATIVE STONE MULCH: ALL PLANTING AREAS LABELED ON PLAN SHALL RECEIVE 3/4" HERITAGE STONE MULCH SPREAD TO A MINIMUM AND CONSISTENT DEPTH OF 3—INCHES. DECORATIVE STONE MULCH TYPE, SIZE & COLOR TO BE APPROVED BY OWNER'S REPRESENTATIVE PRIOR TO INSTALLATION. FERTILIZER SHALL BE IN ACCORDANCE WITH APPLICABLE LOCAL, COUNTY AND STATE REQUIREMENTS. STONE MULCH AREAS SHALL RECEIVE WOVEN WEED BARRIER FABRIC. NO PLASTIC/IMPERVIOUS BARRIERS WILL BE PERMITTED. EXAMPLE: BLACK VISQUEEN.
- 5. MATERIALS TREE & SHRUB RINGS: ALL TREES AND/OR SHRUBS PLANTED IN SEEDED LAWN AREAS TO BE INSTALLED WITH A MINIMUM 4' DIAMETER SHREDDED HARDWOOD BARK MULCH TREE RING SPREAD TO A CONSISTENT DEPTH OF 3—INCHES. ALL TREE RINGS SHOULD BE INSTALLED WITH A 5" DEPTH SHOVEL CUT EDGE, ANGLED 45 DEGREES INTO SOIL AT A 5' DIAMETER ABOUT THE CENTER OF THE TREE PLANTING. A PRE-EMERGENT GRANULAR HERBICIDE WEED-PREVENTER SHOULD BE MIXED WITH MULCH USED TO INSTALL TREE RING AS WELL AS TOPICALLY APPLIED TO COMPLETED INSTALLATION OF TREE RING.
- MATERIALS POLYETHYLENE EDGING: EDGING SHALL BE 5" DEEP, POLYETHYLENE EDGING. OWNER'S REPRESENTATIVE SHALL APPROVE PRODUCT SPECIFICATION PROVIDED BY LANDSCAPE CONTRACTOR.
 MATERIALS ALUMINUM EDGING: EDGING SHALL BE 1/8" X 4", ALUMINUM EDGING, MILL FINISH. OWNER'S REPRESENTATIVE SHALL APPROVE PRODUCT SPECIFICATION PROVIDED BY LANDSCAPE
- 8. MATERIALS TREE PROTECTION: ALL TREES TO BE INSTALLED WITH LDPE TREE GUARDS AS MANUFACTURED BY A.M. LEONARD HORTICULTURAL TOOL & SUPPLY CO., OR APPROVED EQUAL.
 9. MATERIALS (ALTERNATE 1): TREE WATERING BAGS: ALL TREES TO BE INSTALLED WITH ONE (1)
- 98183-R OR APPROVED EQUAL. INSTALL IN ACCORDANCE WITH MANUFACTURER'S RECOMMENDATIONS.

 10. MATERIALS (ALTERNATE 2): ROOT WATERING SYSTEM: ALL TREES TO BE INSTALLED WITH TWO (2) DEEP TREE ROOT WATER AERATION/WATERING TUBES. PRODUCT TO BE "ROOTWELL PRO—318, OR APPROVED EQUAL. INSTALL IN ACCORDANCE WITH MANUFACTURER'S RECOMMENDATIONS. CARE

WATER BAG. PRODUCT TO BE "TREE GATOR ORIGINAL SLOW RELEASE WATERING BAG," PRODUCT NO.

SEEDING, SODDING, & POND VEGETATION NOTES

SHALL BE TAKEN TO AVOID DAMAGE TO TREE ROOT BALL.

- 1. MATERIALS "NO-MOW" SEED: DISTURBED LAWN AREAS LABELED ON PLAN AS SUCH, SHALL RECEIVE 6" OF TOPSOIL AND "NO MOW" FESCUE SEED OR EQUIVALENT AS APPROVED BY THE OWNER'S REPRESENTATIVE, INSTALLED PER MANUFACTURER'S RECOMMENDATIONS. IN ADDITION TO FESCUE SEED, ANNUAL RYE SHALL BE APPLIED TO ALL DISTURBED AREAS AT A RATE OF 1-1/2 LBS PER 1000 SQUARE FEET. FERTILIZE AND MULCH PER MANUFACTURER'S RECOMMENDATIONS.
- 2. MATERIALS TURFGRASS SEED: DISTURBED LAWN AREAS LABELED ON PLAN AS SUCH, SHALL RECEIVE 6" OF TOPSOIL AND EARTH CARPET'S "MADISON PARKS" GRASS SEED, OR EQUIVALENT AS APPROVED BY THE OWNER'S REPRESENTATIVE, INSTALLED PER MANUFACTURER'S RECOMMENDATIONS. IN ADDITION TO TURFGRASS SEED, ANNUAL RYE SHALL BE APPLIED TO ALL DISTURBED AREAS AT A RATE OF 1 1/2 LBS PER 1000 SQUARE FEET. FERTILIZE AND MULCH PER MANUFACTURER'S RECOMMENDATIONS. MULCH SHALL BE CERTIFIED NOXIOUS WEED SEED—FREE
- 3. MATERIALS SOD: DISTURBED LAWN AREAS LABELED ON PLAN AS SUCH, SHALL RECEIVE 6" OF TOPSOIL AND A PREMIUM GRADE TURFGRASS SOD. ONLY IMPROVED TYPES OF SOD (ELITE) ARE ACCEPTABLE. TURFGRASS SHALL BE MACHINE CUT AT A UNIFORM THICKNESS OF .60 INCH, PLUS OR MINUS .25 INCH, AT TIME OF CUTTING. MEASUREMENT FOR THICKNESS SHALL EXCLUDE TOP GROWTH AND THATCH. LARGE ROLL TURFGRASS SOD SHALL BE CUT TO THE SUPPLIER'S STANDARD WIDTH (36-48 INCHES) AND LENGTH. BROKEN PADS AND TORN OR UNEVEN ENDS WILL NOT BE ACCEPTABLE. STANDARD SIZE SECTIONS OF TURGRASS SOD SHALL BE STRONG ENOUGH SO THAT THEY CAN BE PICKED UP AND HANDLED WITHOUT DAMAGE. TURFGRASS SOD SHALL NOT BE HARVESTED OR TRANSPLANTED WHEN MOISTURE CONTENT IS EXCESSIVELY DRY OR WET, AS THIS MAY ADVERSELY AFFECT ITS SURVIVAL. POST-PLANT IRRIGATION WILL BE NECESSARY TO ENSURE SOD STAYS ALIVE AND ROOTS INTO SOIL. THE CONTRACTOR IS RESPONSIBLE FOR WATERING SOD UNTIL TIME OF ACCEPTANCE BY THE OWNER. TURFGRASS SOD SHALL BE HARVESTED, DELIVERED, AND INSTALLED/TRANSPLANTED WITHIN A PERIOD OF 24 HOURS. TURFGRASS SOD SHALL BE RELATIVELY FREE OF THATCH, UP TO 0.5 INCH ALLOWABLE (UNCOMPRESSED). TURFGRASS SOD SHALL BE REASONABLY FREE (10 WEEDS/100 SQ. FT.) OF DISEASES, NEMATODES AND SOIL-BORNE INSECTS. ALL TURFGRASS SOD SHALL BE FREE OF GRASSY AND BROAD LEAF WEEDS AND WEED SEED. THE SOD SUPPLIER SHALL MAKE RECOMMENDATIONS TO THE CONTRACTOR REGARDING WATERING SCHEDULE. THE WATERING SCHEDULE SHOULD BEGIN IMMEDIATELY AFTER SOD IS INSTALLED.
- 4. MATERIALS PRAIRIE SEED MIX: DISTURBED LAWN AREAS LABELED ON PLAN AS SUCH, SHALL BE BROADCAST SEEDED WITH "DIVERSE PRAIRIE FOR MEDIUM SOILS" SEED MIX, AS PROVIDED BY PRAIRIE NURSERY, P.O. BOX 306, WESTFIELD, WISCONSIN, 53964, TEL. 608—296—3679 (OR APPROVED EQUIVALENT). INSTALL SEED WITH SUPPLEMENTAL MATERIALS AND AMENDMENTS AS RECOMMENDED BY SEED SUPPLIER AND AT RATES AND OPTIMUM TIMES OF THE YEAR AS RECOMMENDED BY THE SEED SUPPLIER TO ENSURE SUCCESSFUL GERMINATION AND SEED/ROOT ZONE GROWTH DEVELOPMENT.
- REFER TO PRODUCT SPECIFICATIONS AND MANUFACTURERS RECOMMENDATIONS FOR INSTALLATION.

 5. MATERIALS BIORETENTION BASIN PLUG PLANTINGS: PLUG PLANTINGS TO BE INSTALLED 1'—0" ON CENTER, MIXING SPECIES INTEGRALLY IN FLATS OF 20 AT A TIME. REFER TO WDNR PLUG PLANTING TECHNICAL STANDARDS FOR ROOTSTOCK AND INSTALLATION SPECIFICATIONS.

MATERIALS — BIORETENTION BASIN NATIVE VEGETATIVE MAT (NVM): AREAS SPECIFIED ON PLANS SHALL RECEIVE AGRECOL "RAINWATER RENEWAL" NATIVE VEGETATIVE MAT — DEGRADABLE CORE. CONTRACTOR SHALL CONTACT AGRECOL NATIVE NURSERY 16 WEEKS IN ADVANCE OF INSTALLATION FOR PROPER GROWING LEAD TIME. CONTRACTOR SHALL ASSUME AVAILABLE DELIVERY DATE TO BE BETWEEN

MID-JUNE THROUGH THE END OF OCTOBER DUE TO THE NMV GROWING SEASON. REFER TO

PRODUCT SPECIFICATIONS AND MANUFACTURERS RECOMMENDATIONS FOR INSTALLATION PROCEDURES.

ARCHITECTS

MADISON | MILWAUKEE | DENVER

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JLA PROJECT NUMBER:



W22-0128-0



HARTMEYER
REDEVELOPMENT:
FAMILY HOUSING

2007 ROTH STREET LOT 2

LAND USE APPLICATION

KEY PLAN

PROGRESS DOCUMENTS

These documents reflect progress and intent and may be subject to change, including additional detail. These are not final construction documents and should not be used for final bidding or

DATE OF ISSUANCE MONTH, DATE, YEAR

REVISION SCHEDULE

SHEET NUMBER

construction-related purposes.

LANDSCAPE DETAILS & NOTES



12.0



Street

Huxley

USABLE OPEN AREA CHART FAMILY HOUSING

DENOTES USABLE OPEN AREA ON PLAN = 79,522 SF DENOTES USABLE OPEN AREA PRIVATE BALCONIES 231 X 66 SF = 15,246 SF

TOTAL USABLE OPEN AREA = 94,768SM

MINIMUN USABLE SPACE REQUIRMENT - SQ. FT. PER D.U. (40/D.U.) 302 TOTAL D.U. X 40 = 12,080 SF



JLA PROJECT NUMBER: W22-0128-01



HARTMEYER REDEVELOPMENT: FAMILY HOUSING

2007 ROTH STREET LOT 2

LAND USE APPLICATION

KEY PLAN

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DATE OF ISSUANCE SEPTEMBER 26, 2022 REVISION SCHEDULE

USABLE OPEN SPACE

ASP-100







	FAMILY HOUSING DATA					
LEVEL	AUTOM	AUTOMOBILE PARKING				
LE	STANDARD	COMPACT	ADA	TOTAL	PARKING	
RL	58	18	_	76		
6	58	18	_	76	-	
5	58	18	_	76	_	
4	58	18	_	76	_	
3	51	18	_	69	60	
2	38	18	_	56	176	
1	21	9	10	40	176	
Т.	342	117	10	469	412	

ELECTRICAL VEHICLE CHARGING STATION REQUIREMENTS FAMILY HOUSING						
TOTAL STALL IN LOT	469					
EV READY 10% =	47					
EV INSTALLED 2% =	10					

ACCESSIBLE STATIONS					
NUMBER OF EV	MINIMUM				
INSTALLED SPACES	ACCESSIBLE EV				
REQUIRED	INSTALLED SPACE				
3-50	1				



JLA PROJECT NUMBER:



HARTMEYER
REDEVELOPMENT:
FAMILY HOUSING

2007 ROTH STREET LOT 2

LAND USE APPLICATION

PROGRESS DOCUMENTS

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REVISION SCHEDULE

Mark Description Date

IEET TITLE

SECOND FLOOR PLAN

SHEET NUMBER



	F	FAMILY HOUSING DATA			
Æ	AUTOMOBILE PARKIN				BIKE
LEVEL	STANDARD	COMPACT	ADA	TOTAL	PARKING
RL	58	18	_	76	
6	58	18	_	76	_
5	58	18	_	76	_
4	58	18	_	76	_
3	51	18	_	69	60
2	38	18	1	56	176
1	21	9	10	40	176
T.	342	117	10	469	412
L				l	

ELECTRICAL VEHICLE CHARGING STATION REQUIREMENTS FAMILY HOUSING

TOTAL STALL IN LOT	469
EV READY 10% =	47
EV INSTALLED 2% =	10

ACCESSIBLE STATIONS				
	NUMBER OF EV	MINIMUM		
	INSTALLED SPACES	ACCESSIBLE EV		

REQUIRED

3-50

LE STATIONS		
LE STATIONS	JLA PROJECT NUMBER:	W22-012
MINIMUM	SEAT NOSECTINOMBER.	VV22 012
ACCESSIBLE EV		
INSTALLED SPACE		



ARCHITECTS

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HARTMEYER
REDEVELOPMENT:
FAMILY HOUSING

2007 ROTH STREET LOT 2

LAND USE APPLICATION

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DATE OF ISSUANCE SEPTEMBER 26, 2022

REVISION SCHEDULE

Description

HEET TITLE

third floor Plans

SHEET NUMBER

A103

THIRD FLOOR PLAN
3/64"=1' - 0"



	FAMILY HOUSING DATA											
LEVEL	AUTOM	BIKE										
LE	STANDARD COMPACT ADA		TOTAL	PARKING								
RL	58	18	_	76								
6	58	18	_	76	-							
5	58	18	_	76	_							
4	58	18	_	76								
3	51	18	_	69	60							
2	38	18	_	56	176							
1	21	9	10	40	176							
T.	342	117	10	469	412							

	VEHICLE CHARGING EMENTS FAMILY HOUSING
TOTAL STALL IN LOT	469
EV READY 10% =	47
EV INSTALLED 2% =	10
ACCESS	SIBLE STATIONS
NUMBER OF EV	MINIMUM
INSTALLED SPACES	ACCESSIBLE EV
REQUIRED	INSTALLED SPACE



JLA PROJECT NUMBER: W22-0128-0



HARTMEYER
REDEVELOPMENT:
FAMILY HOUSING

2007 ROTH STREET LOT 2

LAND USE APPLICATION

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Mark


Description


Date

IEET TITLE

FOURTH - SIXTH FLOOR PLAN

SHEET NUMBER

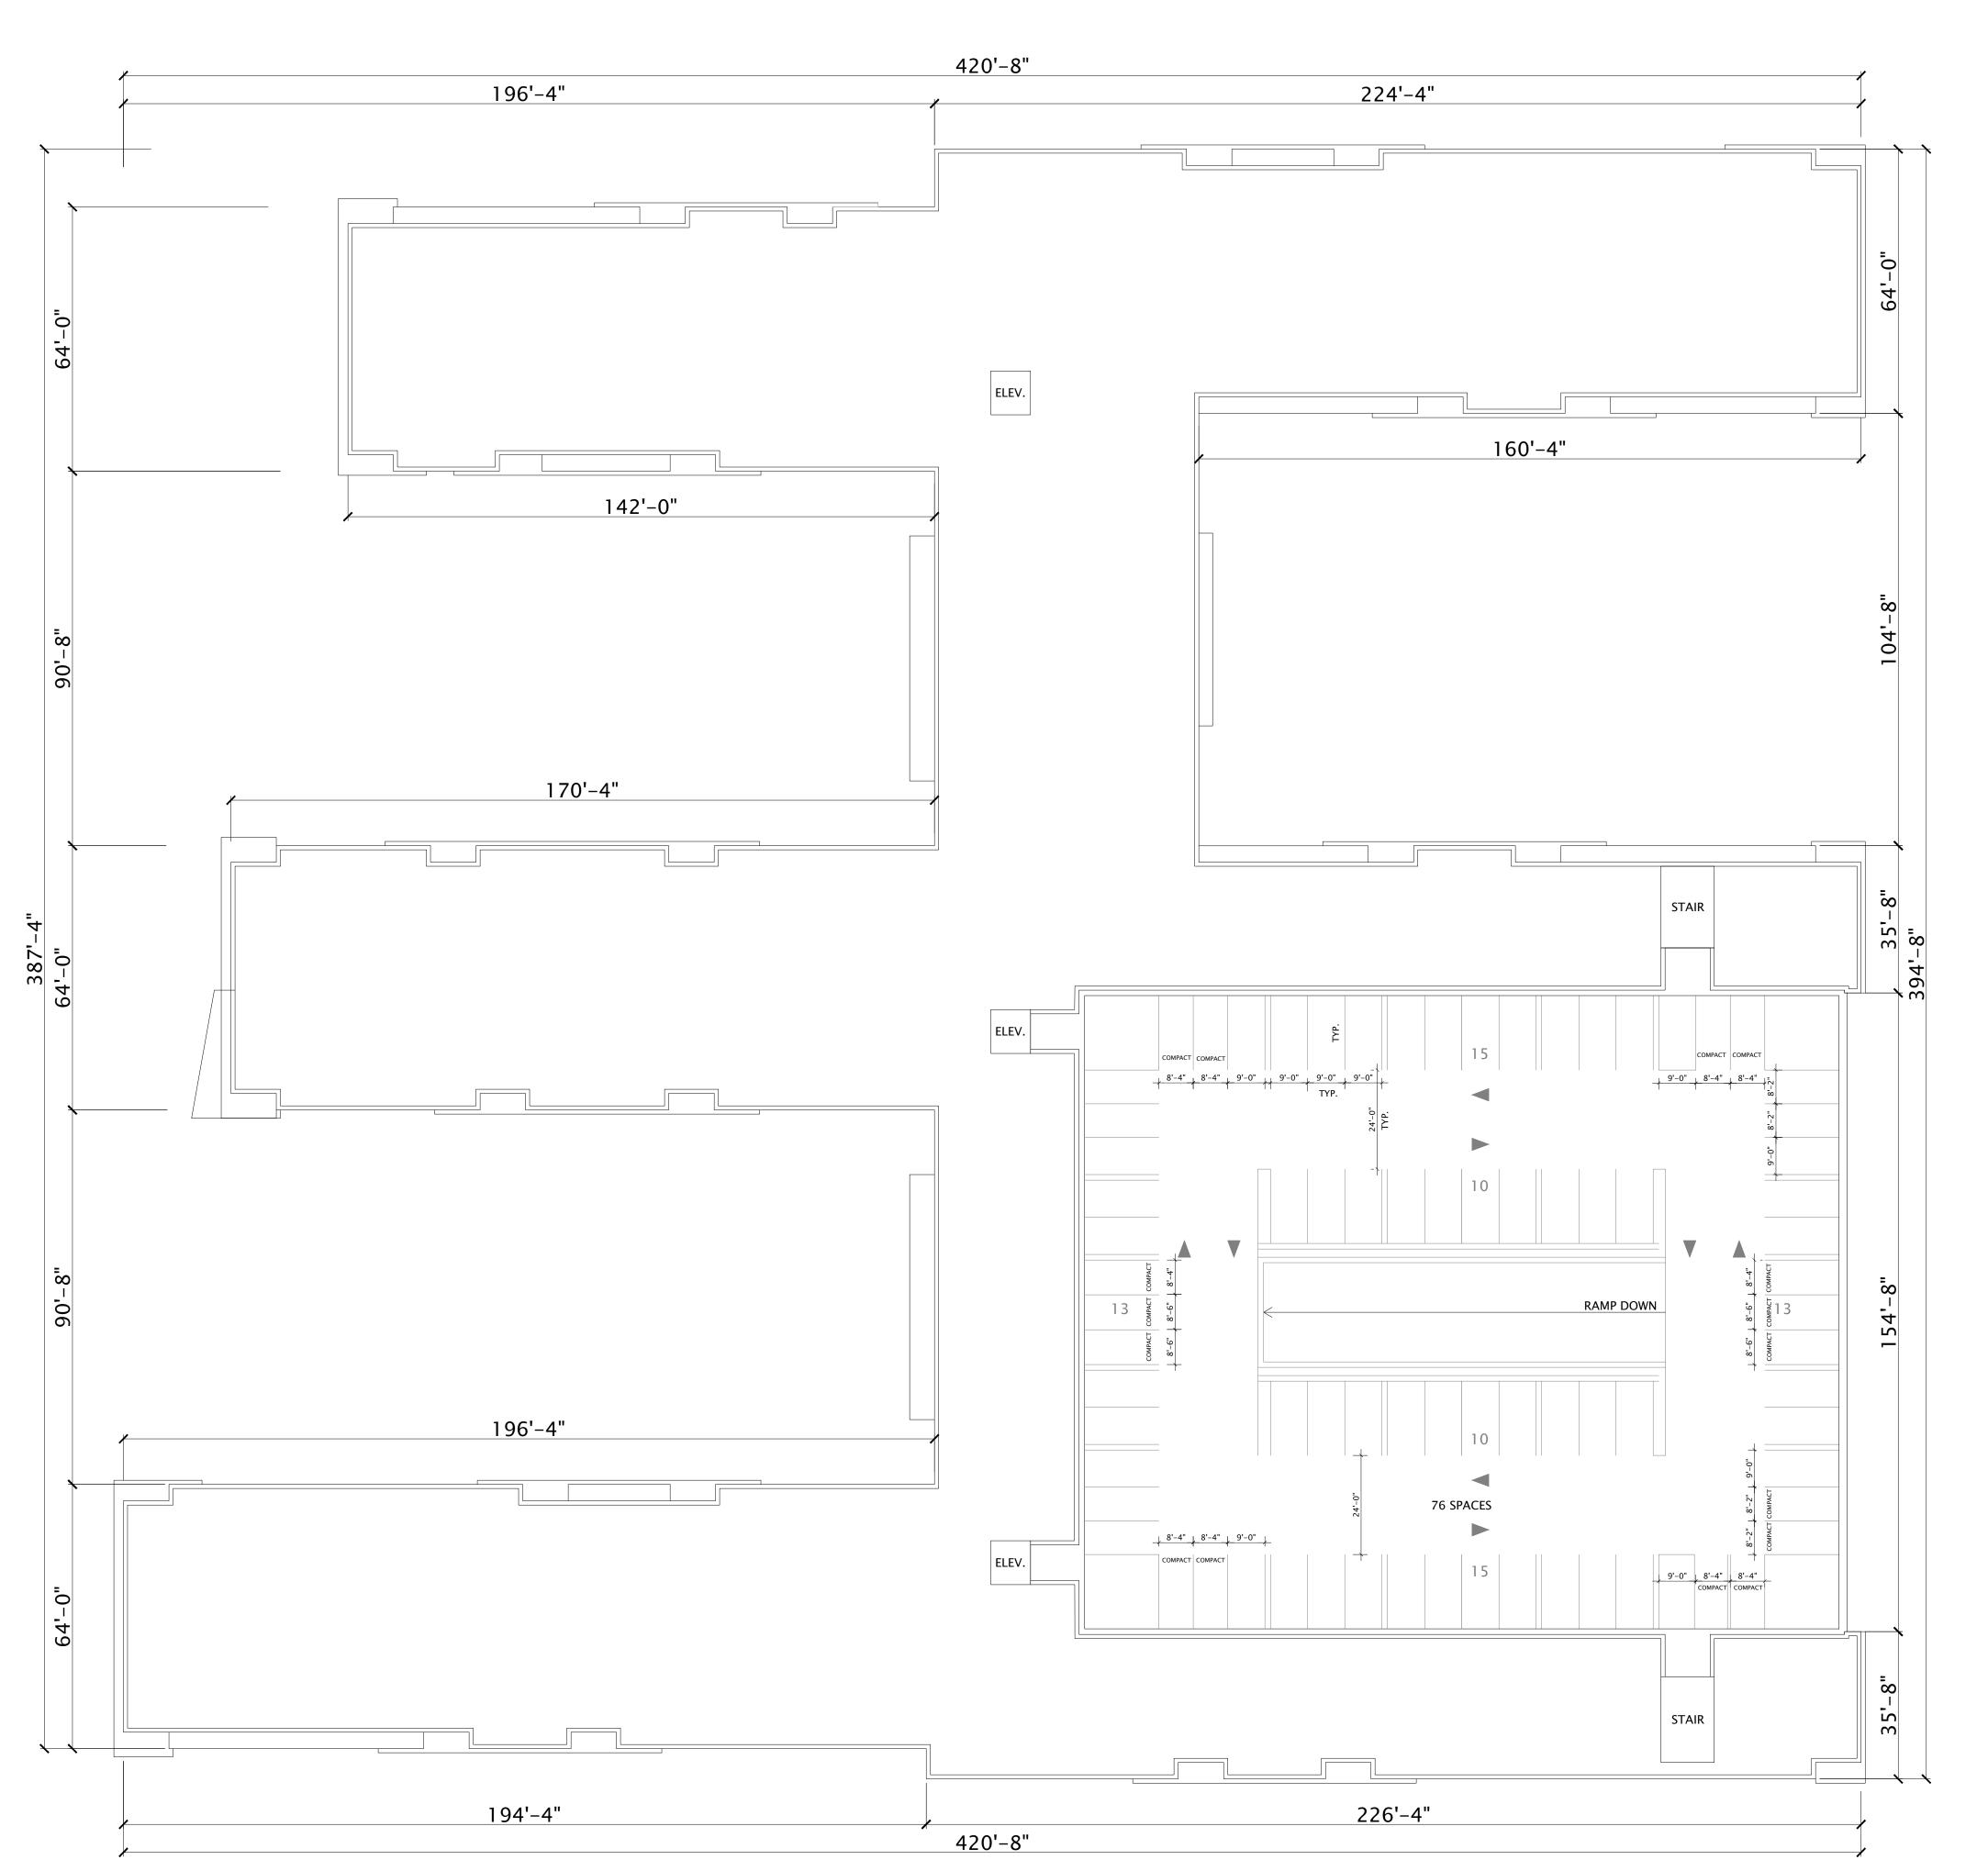

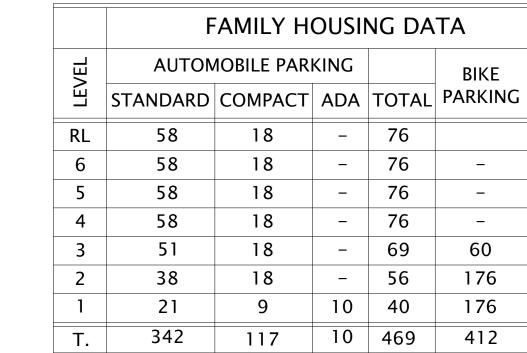



JLA PROJECT NUMBER: W22-0128-01



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FAMILY HOUSING

2007 ROTH STREET LOT 2

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Mark

Description

Date

ובבד דודו ב

ROOF PLAN

SHEET NUMBER

A105

ROOF PLAN 3/64"=1' - 0"

EXTERIOR MATERIALS SCHEDULE												
MARK	DESCRIPTION	MANUFACTURER	TYPE / STYLE	DIMENSIONS	COLOR	NOTES						
1	ARTIST MURAL - TBD											
4	FIBER CEMENT SIDING 1			-								
5	FIBER CEMENT SIDING 2 - HORIZONTAL	-										
6	FIBER CEMENT SIDING 4 - VERTICAL											
7	FIBER CEMENT SIDING 3 - WOODTONE ACCENT											
11	MASONRY VENEER 1					-						



7 NORTH ELEVATION
1/16" = 1'-0"

11



1) WEST ELEVATION
1/16" = 1'-0"



JLA PROJECT NUMBER: W22-0128-01



HARTMEYER
REDEVELOPMENT:
FAMILY HOUSING

2007 ROTH STREET LOT 2

LAND USE APPLICATION

DATE OF ISSUANCE SEPTEMBER 26, 2022

REVISION SCHEDULE

Mark Description Date

CLIEFT TITLE

EXTERIOR ELEVATIONS

SHEET NUMBER

	EXTERIOR MATERIALS SCHEDULE												
MARK	DESCRIPTION	MANUFACTURER	TYPE / STYLE	DIMENSIONS	COLOR	NOTES							
1	ARTIST MURAL - TBD	-	-	-	-								
4	FIBER CEMENT SIDING 1	-	-		-								
5	FIBER CEMENT SIDING 2 - HORIZONTAL	-		-	-								
6	FIBER CEMENT SIDING 4 - VERTICAL	-	-	-	-								
7	FIBER CEMENT SIDING 3 - WOODTONE ACCENT	-	-	-	-								
11	MASONRY VENEER 1	_	_	_	-	_							



1) SOUTH ELEVATION 1/16" = 1'-0"



2 EAST ELEVATION
1/16" = 1'-0"

ARCHITECTS

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REDEVELOPMENT:
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2007 ROTH STREET LOT 2

LAND USE APPLICATION

DATE OF ISSUANCE

REVISION SCHEDULE

Mark Description Date

SHEET TITLE

EXTERIOR ELEVATIONS

SHEET NUMBER



BIRD'S EYE VIEW FROM SOUTHWEST



JLA PROJECT NUMBER: W22-0128-01



HARTMEYER
REDEVELOPMENT:
FAMILY HOUSING

2007 ROTH STREET LOT 2

LAND USE APPLICATION

DATE OF ISSUANCE

REVISION SCHEDULE

Mark

Description

Date

CLIEFT TO

BIRD'S EYE VIEW FROM SOUTHWEST

SHEET NUMBER



BIRD'S EYE VIEW FROM WEST



JLA PROJECT NUMBER: W22-0128-01



HARTMEYER
REDEVELOPMENT:
FAMILY HOUSING

2007 ROTH STREET LOT 2

LAND USE APPLICATION

DATE OF ISSUANCE

REVISION SCHEDULE

Mark

Description

Date

CLIEFT TI

BIRD'SEYE VIEW FROM WEST

SHEET NUMBER



BIRD'S EYE VIEW FROM NORTHWEST



JLA PROJECT NUMBER: W22-0128-01



HARTMEYER
REDEVELOPMENT:
FAMILY HOUSING

2007 ROTH STREET LOT 2

LAND USE APPLICATION

DATE OF ISSUANCE SEPTEMBER 26, 202

REVISION SCHEDULE

Mark Description Date

CLIEFT TITLE

BIRD'S EYE VIEW FROM NORTHWEST

SHEET NUMBER



VIEW TO ENTRANCE



JLA PROJECT NUMBER: W22-0128-01



HARTMEYER
REDEVELOPMENT:
FAMILY HOUSING

2007 ROTH STREET LOT 2

LAND USE APPLICATION

DATE OF ISSUANCE

REVISION SCHEDULE

Mark

Description

Date

SHEET TITL

VIEW TO ENTRANCE

SHEET NUMBE



VIEW TO ENTRANCE



JLA PROJECT NUMBER: W22-0128-01



HARTMEYER
REDEVELOPMENT:
FAMILY HOUSING

2007 ROTH STREET LOT 2

LAND USE APPLICATION

DATE OF ISSUANCE

REVISION SCHEDULE

Mark


Description

Date

SHEET TITL

VIEW TO ENTRANCE

SHEET NUMBE

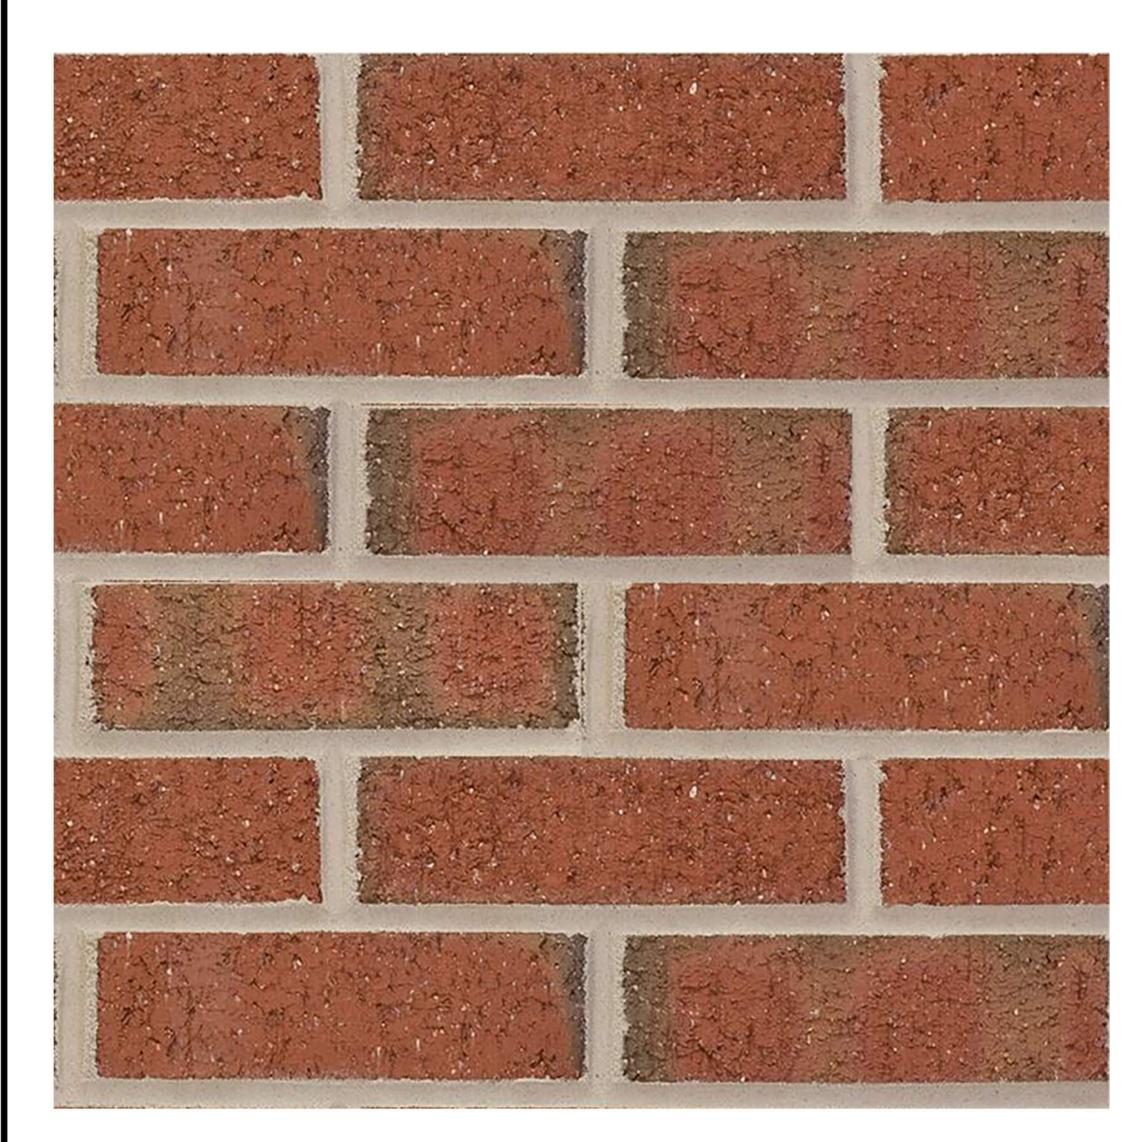


MASONRY VENEER 1



FIBER CEMENT SIDING 3 WOODTONE ACCENT



FIBER CEMENT SIDING 1

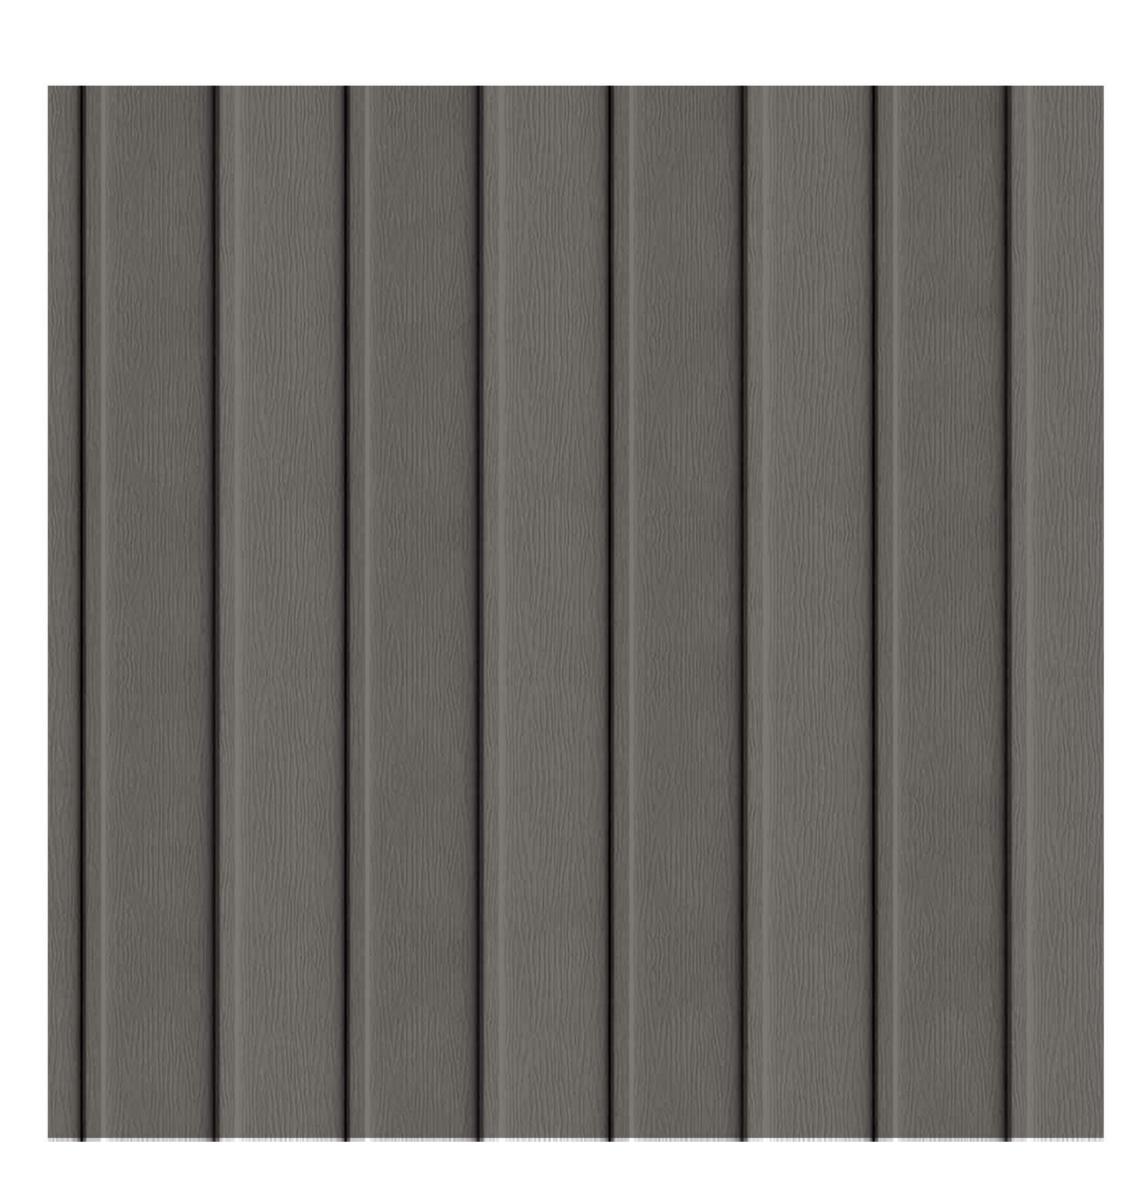

FIBER CEMENT SIDING 4 VERTICAL



FIBER CEMENT SIDING 2 HORIZONTAL



JLA PROJECT NUMBER: W22-0128-01



HARTMEYER REDEVELOPMENT: FAMILY HOUSING

2007 ROTH STREET LOT 2

LAND USE APPLICATION

KEY PLAN

PROGRESS DOCUMENTS

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DATE OF ISSUANCE SEPTEMBER 26, 2022

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Mark Description Date

IEET TITLE

MATERIALS BOARD

SHEET NIIMAR

28.129 BIRD-SAFE REQUIREMENTS:

(1) Statement of Purpose: The Bird-Safe Glass Requirements in this section are intended to reduce the heightened risk for bird collisions with glass on specified building designs and configurations.

(2) Applicability: Subsection (4) applies to all exterior construction and development activity, including the expansion of existing buildings and structures, as specified therein.

(3) Measuring Glass Area: Under this Ordinance, glass area shalle be measured as one (1) continuous panel of glass or other transparent material, or a set of two (2) or more such panels divided by mullions of six (6) inches in width or narrower. Panels surrounded on all sides by solid walls or mullions wider than six (6) inches shall be considered individual windows. Spandrel or opaque reflectivity of 14% or less shall not be included in the calculation of glass area. See Revised Figure 1.

(4) Bird-Safe Glass Treatment Requirements: Glass areas on the following buildings or structures shall be treated to reduce the risk of bird collision by incorporating a pattern of visual markers that are either; a) dots or other isolated shapes that are 1/4" in diameter or larger and spaced at not more than a two-inch (2") by two-inch (2") pattern; or b) lines that are 1/8" in width or greater and spaced no more than 2" apart; low reflective opaque materials; building-integrated structures like non-glass double-skin facades, metal screens, fixed solar shading, exterior insect screens, and other features that cover the glass surface; or other similar mitigation treatments approved by the Zoning Administrator.

(a) Buildings or structures over 10,000 square feet: For any building or structure over 10,000 square feet in size (floor area of above-grade stories), bird-safe glass treatment is required as follows:

1. For building facades where the first sixty (60) feet (See REVISED Figure 2) from grade are comprised of greater than or equal to fifty percent (50%) glass:

a. At least eighty-five percent (85%) of the glass must be treated; and b. All glass within fifteen (15) feet of a building corner must be treated when see through or fly through conditions exist. See Figure 3.

2. For building facades where the first sixty (60) feet from grade are comprised of less than fifty percent (50%) glass;

a. At least eighty-five percent (85%) of the glass on glass areas fifty (50) square feet or over must be treated; and b. Of all glass areas over fifty (50) square feet, any glass within fifteen (15) feet of a building corner must be treated.

3. All glass railings must be treated.


4. All glass on enclosed building connections shall be treated up to sixty (60) feet above grade.

(b) Sky-bridges: For buildings and structures of any size, all glass on above-ground bridges must be treated.

(c) At grade glass: For buildings and structures of any size, all at grade glass features such as sound walls or glass screens must be treated.

(5) This Ordinance shall become effective October 1, 2020.

BIRD GLASS CALCULATIONS: FAMILY 9/22/2022					50+ SQ FT AND	REQUIR	RE A BIRD GLA	AZING SAFETY S	SYSTEM ON A MIN	I. OF 85% O	F THE GLAZING												
MARCEL UTTECH																							
					COLITILIANALI	. 1	FAC:	T \A/A)A/ECT \A	/	NORTHY	A/A			ESIGNATION NE COURTYARD - S NW COURTYARD - N NW COURTYARD - S SW COURTYARD - N SW COURTYARD - S								
WINDOW DESIGNATION	LIFICUT		OF DANIES	, D.E.A	SOUTH WALI			T WALL	WEST W		NORTH V		NE COURTY		 					1			SW COURTYARD - S
WINDOW DESIGNATION WINDOW A 6/0 X 6/0	HEIGHT WID	5.7	4.0		GLZ AREA # WINI 4142.8	129.0	2569.2	# WINDOW		WINDOW 136.0	ļ		GLZ AREA #	# WINDOW 54.0	GLZ AREA 1541.5	# WINDOW 48.0	GLZ AREA # \ 1348.8	WINDOW 42.0	GLZ AREA 1798.4	# WINDOW 56.0			5280.0 # WINDOW 5280.0 66.0
WINDOW A 6/0 X 6/0 WINDOW B 3/0 X 6/0	2.7	5.7	2.0	32.1 15.1	181.4	129.0	181.4	80 12		24.0			1734.2	12.0	181.4	12.0	272.1	18.0	166.3			51.0 11.0	5280.0 66.0 144.0 12.0
WINDOW C 6/0 X 4/0	3.7	5.7	2.0	20.8	101.4	12.0	1413.1	68		24.0	181.4	12.0	181.4	12.0	181.4	12.0	2/2.1	16.0	100.3	11.0	132.0	11.0	144.0 12.0
GLAZED DOUBLE SERVICE DOOR		8.7	2.0	65.0	65.0	1.0	1415.1		.0		65.0	1.0											
GLAZED SINGLE SERVICE DOOR	7.5	0.7	2.0	03.0	33.0	2.0					03.0	1.0											
					4389.2 TOTAL	GLZ	4.163.7	TOTAL GLZ	4,730.4 T	OTAL GLZ	3.811.1	TOTAL GLZ	1,915,6 7	ΓΟΤΑL GLZ	1.722.9	TOTAL GLZ	1,620.9 TC	TAL GLZ	1.964.7	TOTAL GLZ	1.769.9	TOTAL GLZ	5,424.0 TOTAL GLZ
					29271 WALL		-	WALL AREA	27,462.0 V		<u> </u>	WALL AREA	11,156.0		1	WALL AREA	9,880.0 W		-	WALL AREA	 	WALL AREA	13,661.5 WALL AREA
					15.00% % GLA		•	% GLAZING	-	6 GLAZING	<u> </u>	% GLAZING		% GLAZING	· ·	% GLAZING	16.41% %			% GLAZING	 	% GLAZING	39.70% % GLAZING
L					13.0070 70 GLA	21110	13.1070	70 GLAZIIVG	17.23/0 /	0 GLAZIII G	14.5470	70 GLAZIIIG	17.1770 7	70 GLAZING	13.4470	70 GLAZING	10.4170 70	OLAZIIVO	10.50/0	70 GLAZIIIG	14.5570	70 GLAZIIIG	33.7070 70 GEAZIIVG
													\	WALL DESIG	NATION								
					SOUTH WALI	L	EAS	T WALL	WEST W	/ALL	NORTH V	VALL	NE COURTY		NE COURT	YARD - S	NW COURTYA	RD - N	NW COUP	TYARD - S	SW COURTY	YARD - N	SW COURTYARD - S
PATIO DESIGNATION	HEIGHT WID	TH #	OF PANES	AREA	GLZ AREA # PATI		LZ AREA	# PATIO		PATIO	GLZ AREA			# PATIO	 					# PATIO			GLZ AREA # PATIO
P1 w/TRANSOM 9/0 X 8/0		8.3	1.0	63.9	3386.1	53.0	766.7			12.0				18.0		18.0	1150.0	18.0				15.0	288.0 24.0
					3386.1 TOTAL	. GLZ	766.7	TOTAL GLZ	766.7 T	OTAL GLZ	3002.8	TOTAL GLZ	1150.0 T	ΓΟΤΑL GLZ	1150.0	TOTAL GLZ	1150.0 TC	TAL GLZ	958.3	TOTAL GLZ	180.0	TOTAL GLZ	288.0 TOTAL GLZ
					29271.0 WALL	AREA	27462.0	WALL AREA	27462.0 V	VALL AREA	25508.0	WALL AREA	11156.0 V	WALL AREA	11156.0	WALL AREA	9880.0 W	ALL AREA	11852.0	WALL AREA	11852.0	WALL AREA	13661.5 WALL AREA
					11.57% % GLA	ZING	2.79%	% GLAZING	2.79% %	6 GLAZING	11.77%	% GLAZING	10.31% %	% GLAZING	10.31%	% GLAZING	11.64% %	GLAZING	8.09%	% GLAZING	1.52%	% GLAZING	2.11% % GLAZING
		'		•		•	'				•	•					•			•	-		
														550.0									
						.							1	WALL DESIG	İ								
					SOUTH WALI			T WALL	WEST W		NORTH V		NE COURTY		NE COURT		NW COURTYA		NW COUF		SW COURTY		SW COURTYARD - S
SF DESIGNATION	HEIGHT WID	TH #	OF PANES		GLZ AREA # SF	GI		# SF		‡ SF			GLZ AREA #	# SF	GLZ AREA	# SF	GLZ AREA # 5	SF		# SF			SLZ AREA # SF
STOREFRONT A		5.7	2.0	49.1			196.5	4	.0 0.0	0.0		2.0							294.7	6.0		5.0	
STOREFRONT B		2.7	1.0	53.5					160.4	3.0											0.0	0.0	
STOREFRONT C: CURTAINWALL		22.7		438.2					438.2	1.0	438.2	1.0									171.0	1.0	
STOREFRONT D: CURTAINWALL	19.8	8.7		171.9	0.0 70711	0.7	100 =		500 5		500.4		0.0		0.0		0.0 7.0		224-		171.9	1.0	0.0 70744 047
					0.0 TOTAL			TOTAL GLZ		OTAL GLZ		TOTAL GLZ		TOTAL GLZ	1	TOTAL GLZ		TAL GLZ		TOTAL GLZ	+	TOTAL GLZ	0.0 TOTAL GLZ
					29271.0 WALL			WALL AREA	27462.0 V		<u> </u>	WALL AREA		WALL AREA	 	WALL AREA	9880.0 W			WALL AREA	<u> </u>	WALL AREA	13661.5 WALL AREA
					0.00% % GLA	ZING	0.72%	% GLAZING	2.18% 9	6 GLAZING	2.10%	% GLAZING	0.00% 9	% GLAZING	0.00%	% GLAZING	0.00% %	GLAZING	2.49%	% GLAZING	3.52%	% GLAZING	0.00% % GLAZING
				ſ																			
					SOUTH WALI		E A C	 Γ WALL	WEST W	/	NORTH V	Λ/ΛΙΙ	NE COURTY	/ADD N	NE COURT	VADD C	NW COURTYA	DD N	NW COUF	TVADD C	SW COURTY	VADD N	SW COURTYARD - S
					7,775.3 TOTAL			TOTAL GLZ		OTAL GLZ		TOTAL GLZ		TOTAL GLZ	1	TOTAL GLZ	2,770.9 TC			TOTAL GLZ		TOTAL GLZ	5,712.0 TOTAL GLZ
					29,271.0 WALL			WALL AREA	27,462.0 V			WALL AREA	11,156.0 V			WALL AREA	9,880.0 W			WALL AREA		WALL AREA	13,661.5 WALL AREA
					26.56% % GLA		·	% GLAZING	<u> </u>	6 GLAZING	<u> </u>	% GLAZING		% GLAZING	 	% GLAZING	28.05% %			% GLAZING	,	% GLAZING	41.81% % GLAZING
				l	20.3070 70 GLA	21110	10.0770	70 GLAZIIVG	22.2070 /	0 GLAZIII G	20.0270	70 GLAZIIVG	27.4070 /	70 GLAZING	23.7370	70 GLAZING	20.0370 70	GLAZIIVG	27.13/0	70 GLAZIIIG	15.5770	70 GLAZIIIG	41.0170 70 GEAZIIVG

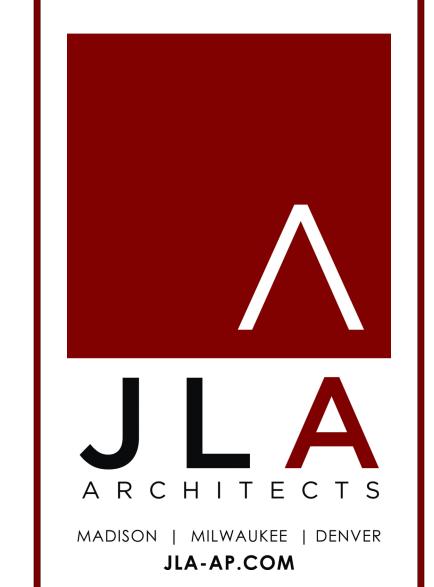

JLA PROJECT NUMBER: W22-0128-01



HARTMEYER
REDEVELOPMENT:
FAMILY HOUSING

2007 ROTH STREET LOT 2

LAND USE APPLICATION

DATE OF ISSUANCE SEPTEMBER 26, 2022

REVISION SCHEDULE

IEET TITLE

BIRD GLASS MATRIX

SHEET NIIIMBED



GLAZING KEYNOTES

- (1) WINDOW A: 6/0 X 6/0
- (2) WINDOW B: 3/0 X 6/0
- (3) WINDOW C: 6/0 X 4/0
- 4 GLAZED DOUBLE SERVICE DOOR

 $\langle 5 \rangle$ P1: 9/0 X 6'-8" PATIO DOOR WITH 1'-4" TRANSOM

- 6 STOREFRONT A
- $\langle 7 \rangle$ storefront B
- (8) STOREFRONT C: CURTAINWALL
- $\langle 9 \rangle$ Storefront D: Curtainwall

ARCHITECTS MADISON | MILWAUKEE | DENVER JLA-AP.COM

JLA PROJECT NUMBER: W22-0128-01



HARTMEYER REDEVELOPMENT: FAMILY HOUSING

2007 ROTH STREET LOT 2

LAND USE APPLICATION

DATE OF ISSUANCE SEPTEMBER 26, 2022 REVISION SCHEDULE

EXTERIOR ELEVATIONS -BIRDGLASS

SHEET NUMBER

A221

NORTH ELEVATION BIRDGLASS
1/16" = 1'-0"



WEST ELEVATION BIRDGLASS
1/16" = 1'-0"



4 SOUTH ELEVATION BIRDGLASS
1/16" = 1'-0"

FIRST FLOOR 100'-0"

3 EAST ELEVATION BIRDGLASS
1/16" = 1'-0"