

# McGRATH Property Group

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001



DAYTON-MIFFLIN HOTEL
LAND USE SUBMITTAL

COVER	
JLA PROJECT No:	21-1006
DATE OF ISSUANCE:	AUGUST 15, 2022
REVISION DATE:	

#### SHEET **DISCIPLINE AND** NUMBER

001	COVER
002	INDEX

#### CIVII

CIVIL	
C100	EXISTING CONDITIONS PLAN
C101	DEMOLITION PLAN
C101E	DEMOLITION PHOTOS - DAYTON STREET
C102E	DEMOLITION PHOTOS - MIFFLIN STREET
C101I	DEMOLITION PHOTOS - INTERIOR
C 2 0 1	SITE PLAN
C301	EROSION CONTROL PLAN
C401	GRADING PLAN
C 5 0 1	UTILITY PLAN
C701	CONSTRUCTION DETAILS
C702	CONSTRUCTION DETAILS
C703	CONSTRUCTION DETAILS
C704	CONSTRUCTION DETAILS

#### LANDSCAPE

L100	STREET TREE PLAN
L101	LANDSCAPE PLAN OVERVIEW
L102	LANDSCAPE PLAN

#### FIRE ACCESS

	1
EXH	FIRE ACCESS PLAN

#### SHEET **DISCIPLINE AND** NUMBER

#### ARCHITECTURAL

TRETTTECTORALE	,
A100	LOWER LEVEL PLAN
A 1 0 1	FIRST FLOOR PLAN
A102	SECOND FLOOR PLAN
A103	THIRD FLOOR PLAN
A110	ROOF PLAN
A 2 0 0	EXTERIOR ELEVATIONS - B/W
A 2 0 1	EXTERIOR ELEVATIONS - B/W
A 2 0 2	EXTERIOR ELEVATIONS
A 2 0 3	EXTERIOR ELEVATIONS
A 2 0 4	DAYTON ST RENDERING
A 2 0 5	MIFFLIN RENDERING
A 3 0 0	BUILDING SECTIONS
A 3 0 1	BUILDING SECTIONS
A 3 0 2	BUILDING SECTIONS

ELL	EXTERIOR LIGHTING LAYOUT

# PROJECT TEAM:

OWNER:

McGrath Property Group LLC 730 Williamson St #150

Contact: Michael Metzger Phone: 608.616.0705

Madison, WI 53703

ARCHITECT OF RECORD

JLA Architects & Planners 800 W Broadway St # 200 Monona, WI 53713 Contact: Patrick Terry Phone: 608:442:3823

**CIVIL ENGINEER:** 

Vierbicher

600 West Virginia St. # 601 Milwaukee, WI 53204 Contact: Carter Lanser

Phone: 608.821.3946

Property Group

MADISON : MILWAUKEE

DAYTON-MIFFLIN HOTEL


LAND USE SUBMITTAL


INDEX

JLA PROJECT No: 21-1006 DATE OF ISSUANCE: AUGUST 05, 2022 **REVISION DATE:** 

002

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- PROPERTY BOUNDARY

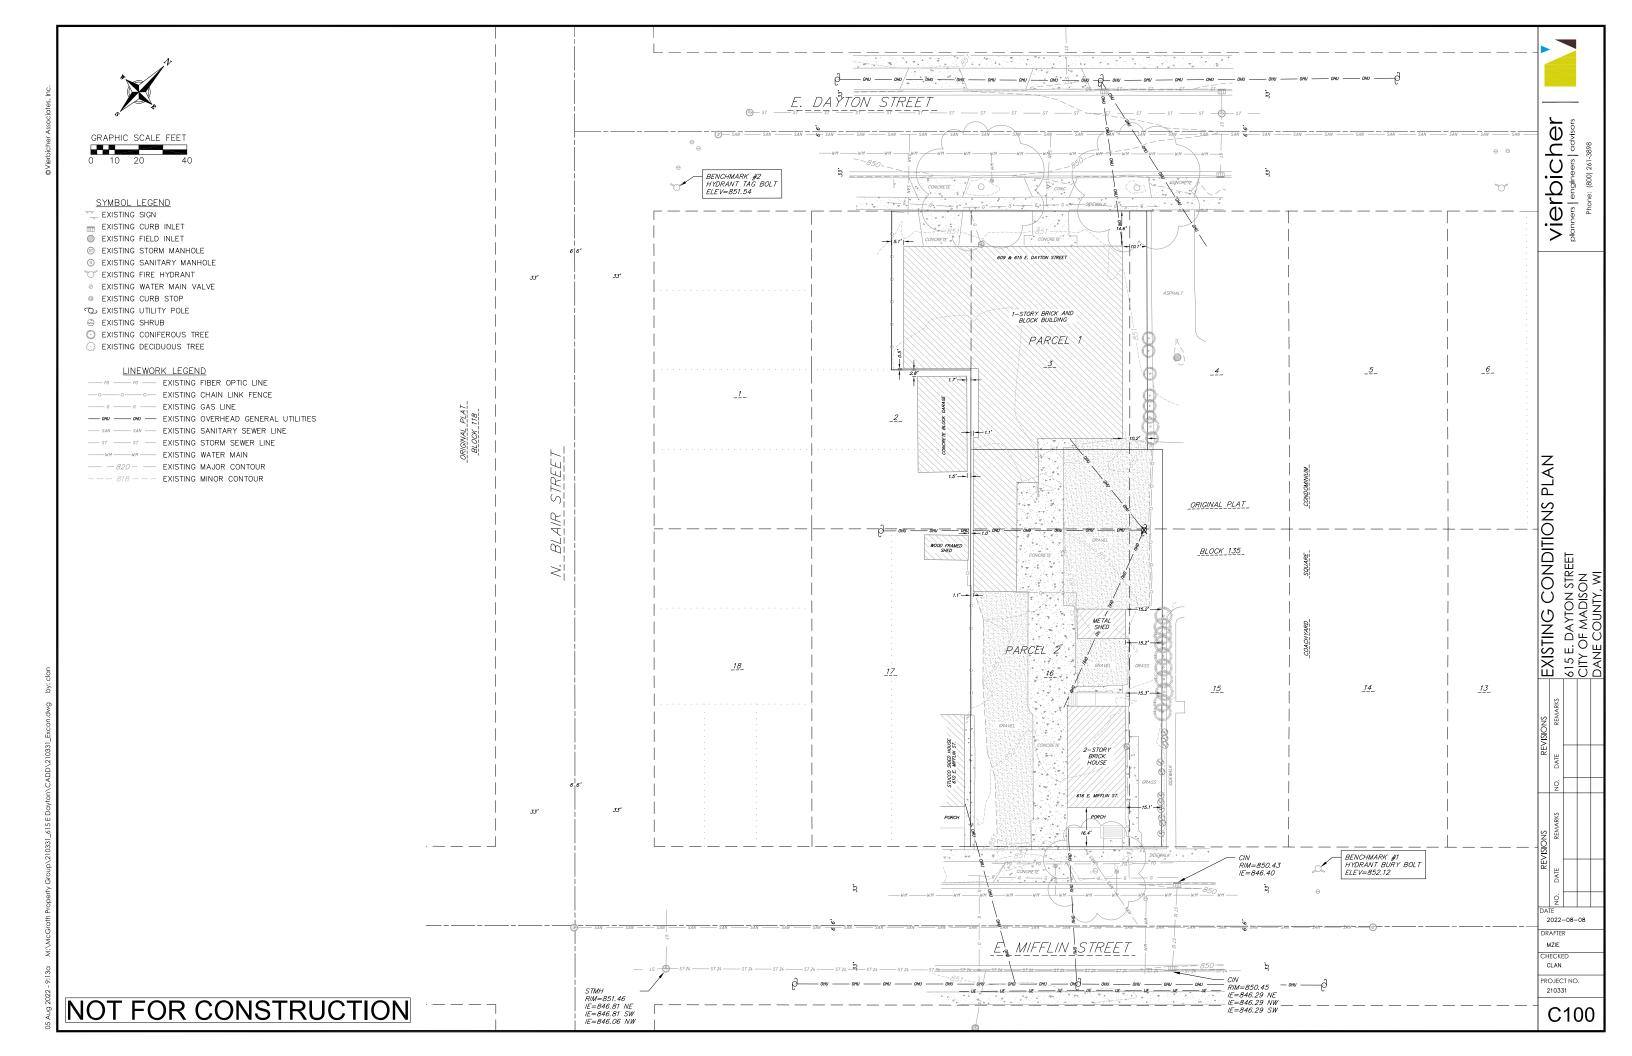CURB AND GUTTER (REVERSE CURB HATCHED)

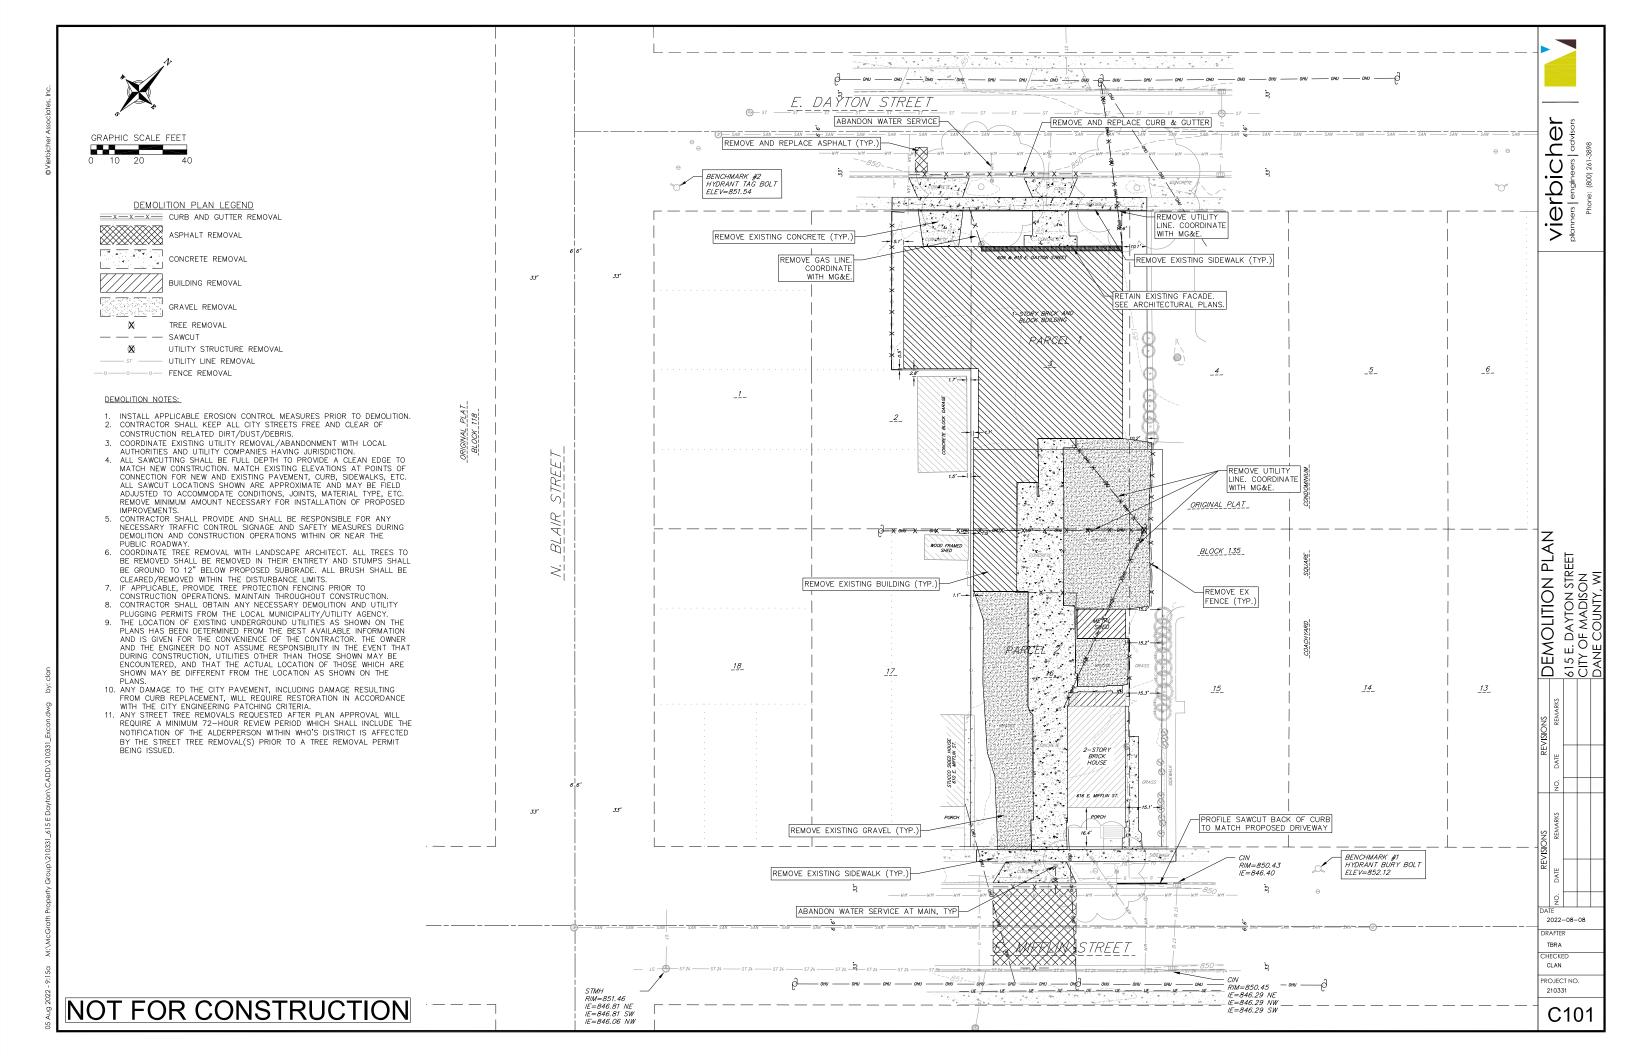- PROPOSED RETAINING WALL

PROPOSED CONCRETE

0

PROPOSED ASPHALT

00 PROPOSED SIGN

PROPOSED LIGHT POLE (SEE LIGHTING PLAN)

PROPOSED BOLLARD

PROPOSED ADA DETECTABLE WARNING FIELD

PROPOSED HANDICAP PARKING

#### SITE NOTES:

- CONTRACTOR TO OBTAIN ANY NECESSARY UTILITY CONNECTION, DEMOLITION, DRIVEWAY CONNECTION, RIGHT-OF-WAY AND EXCAVATION PERMITS PRIOR TO CONSTRUCTION. THE CONTRACTOR IS RESPONSIBLE FOR ANY DAMAGE CAUSED DURING CONSTRUCTION TO PUBLIC PROPERTY, PRIVATE PROPERTY OR UTILITIES.
- OR UTILITIES.

  THE CONTRACTOR SHALL SUBMIT SHOP DRAWINGS OF SITE RELATED ITEMS FOR REVIEW BY THE ENGINEER, PRIOR TO PLACING AN ORDER OF ANY SUCH ITEM.
  CONTRACTOR SHALL BE RESPONSIBLE FOR PROTECTING EXISTING PROPERTY CORNER MONUMENTATION. ANY MONUMENTS DISTURBED BY CONTRACTOR SHALL BE REPLACED AT THE CONTRACTORS FXPENSF. EXPENSE.
  5. DIMENSIONS RELATING TO CURB ARE TO FACE OF CURB.

Parking Lot Plan Site Information Block

Site Address: 615 E Dayton Street

Site acreage (total) = 0.52 ACRES

Number of building stories (above grade): 3 Building height: Average Existing Grade to Top of Building = 34' - 1" DILHR type of construction (new structures): 5A NF 13 SM

 $\langle \rangle$ 

B

Use of property: Mixed Use — HOTEL Gross square feet of building: 51,634 SF Gross square feet of retail area: N/A SF Number of employees: 8 Number of employees in production area: N/A Capacity of restaurant/place of assembly: N/A


Number of bicycle stalls shown: 5 floor mounted internal stalls 6 external stalls

Number of parking stalls:


Proposed (Site)	0 Large + 0 Compact = 0
Proposed (Covered)	22 Large + 4 Compact = 26
Accessible	0 (Site) + 1 (Covered) = 1
Van Accessible	0 (Site) + 1 (Covered) = 1
EV Stalls	0 (Site) + 2 (Covered) = 2
EV Ready Stalls	0 (Site) + 1 (Covered) = 1
Total Stalls	26


Number of trees shown: See Landscape Plan

LOT COVERAGE: COVERED LOT = 0.38 AC TOTAL LOT = 0.52 AC PERCENT LOT COVERAGE = 72.3% MAXIMUM ALLOWABLE LOT COVERAGE = 85.0%

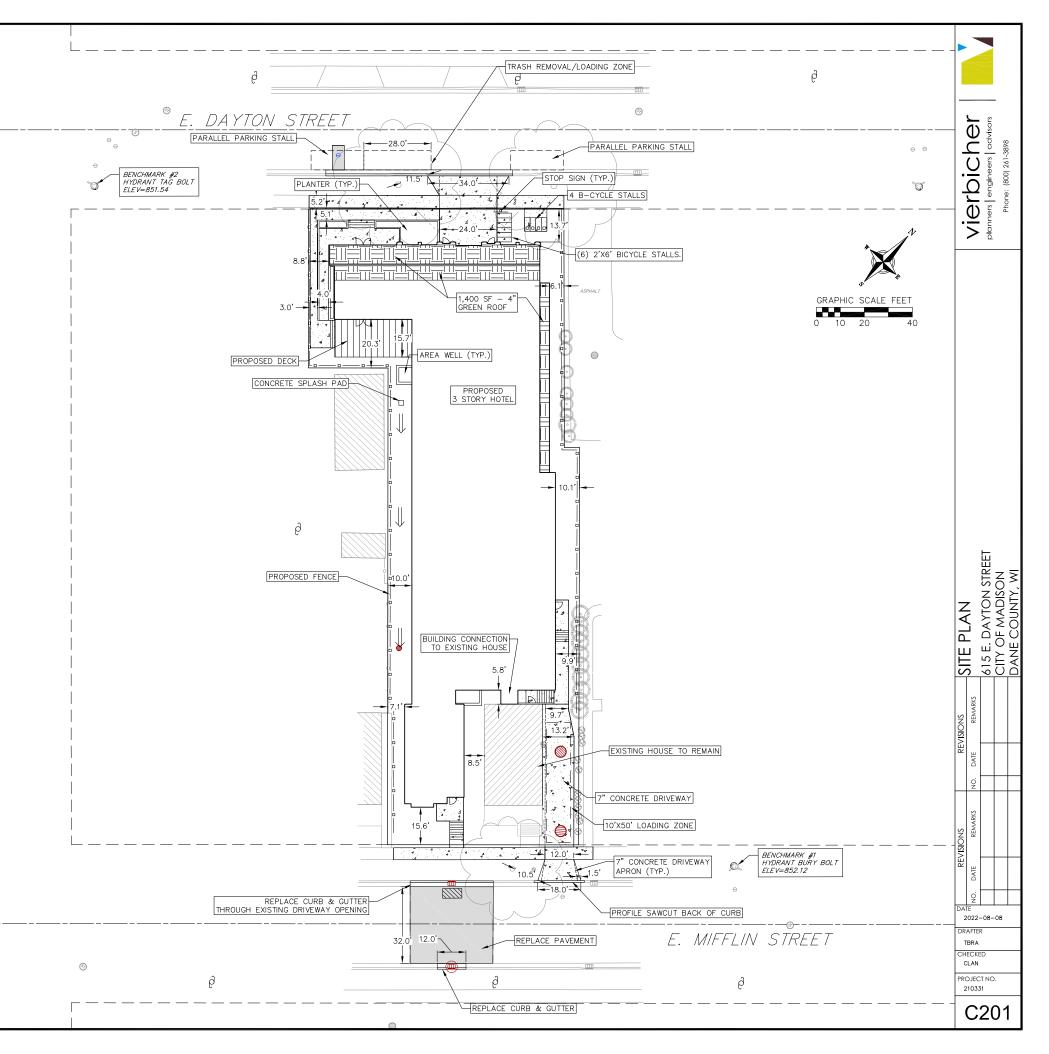

NOT FOR CONSTRUCTION

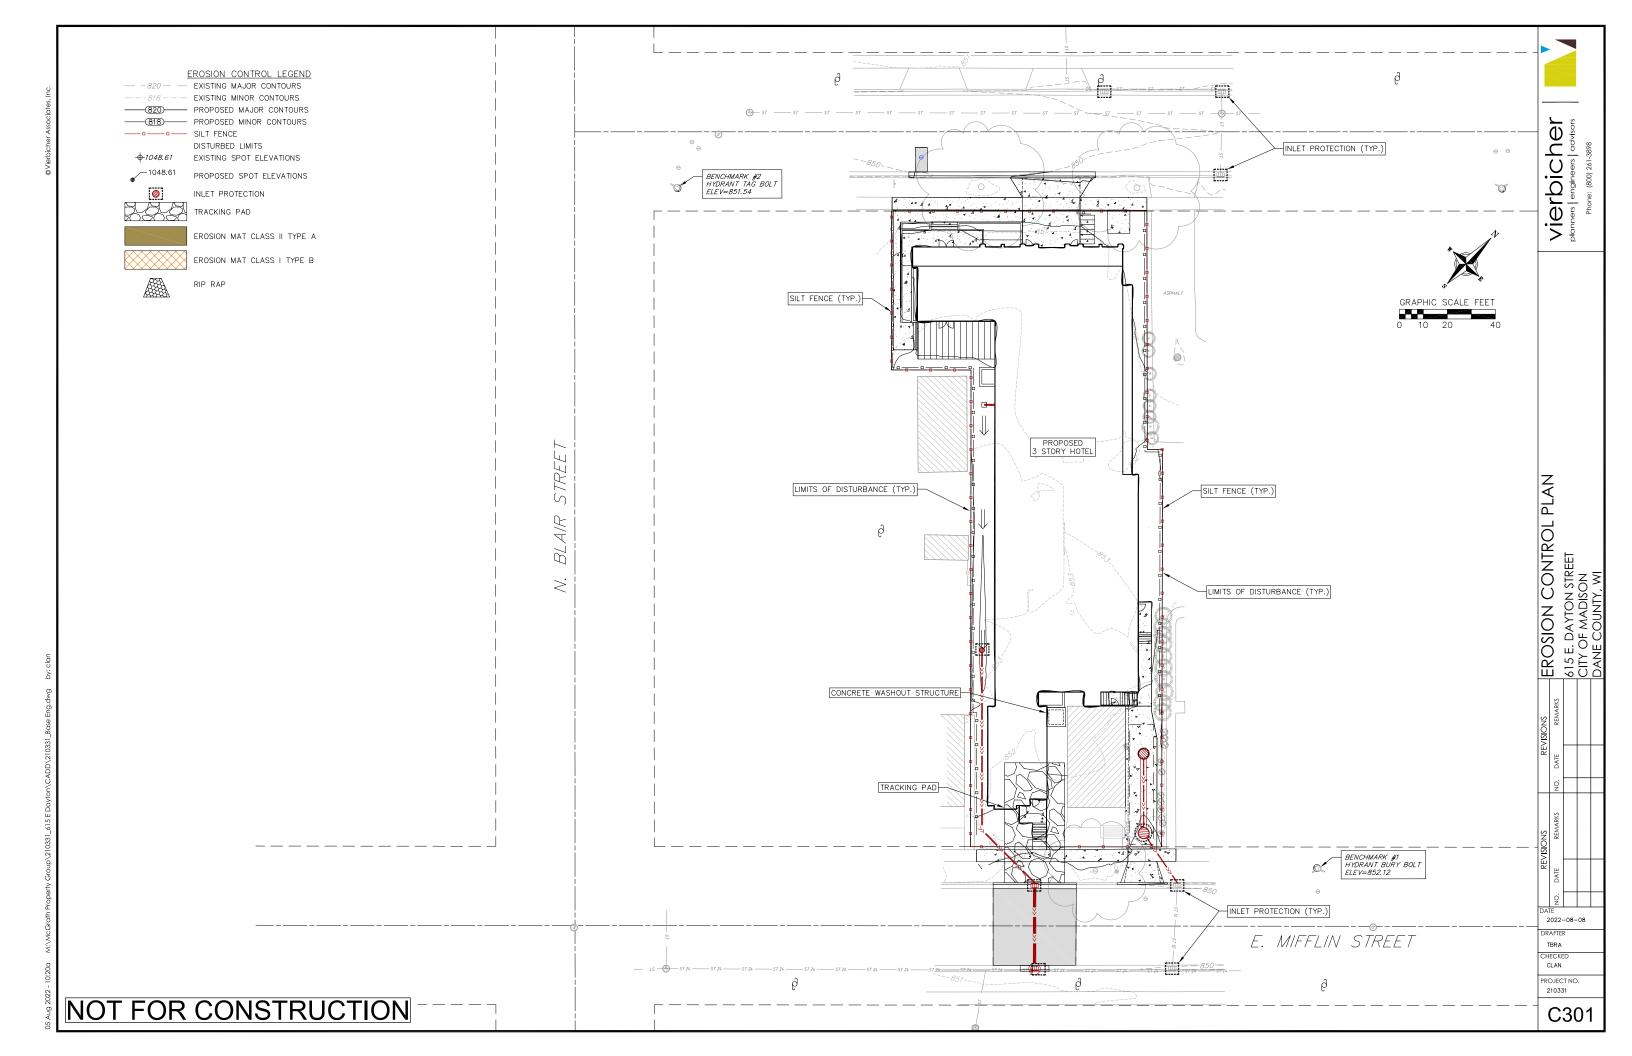

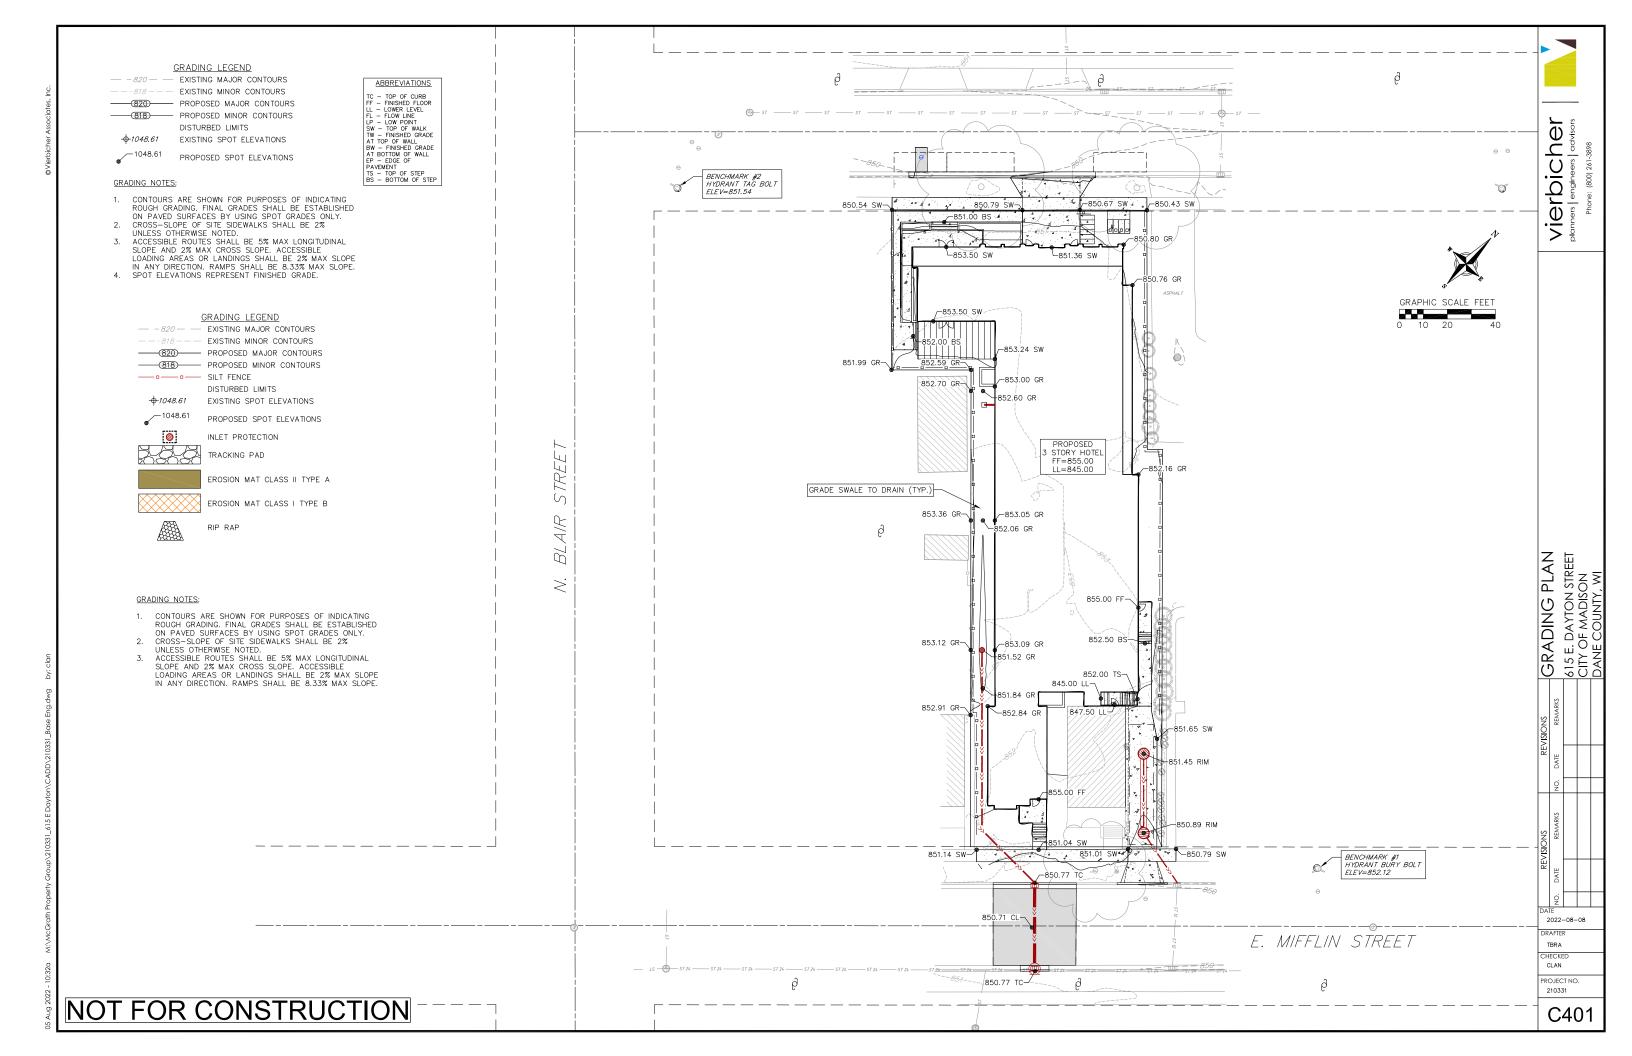

37'-12" RCP STORM @ 1.00%

S1.0: 48" CONC CB R-3067 FRAME

TYPE C GRATE

IE=846.03 NW

IE=843.69 SW IE=843.69 NE

 $\bigcirc$ 

615 E. DAYTON STREI CITY OF MADISON DANE COUNTY, WI

2022-08-08 ORAFTER

TBRA

CHECKED

CLAN

PRO IECT NO

C501

210331

E. MIFFLIN STREET

R-3067 FRAME

TYPE C GRATE

0

GRAPHIC SCALE FEET

ULO — CAUTION UNDERGROUND UTILITIES. FOR ALL LOCATIONS MARKED "ULO" CONTRACTOR TO ULO PRIOR TO CONSTRUCTION TO CONFIRM NO CONFLICTS EXIST. ALL CONFLICTS TO BE REPORTED TO ENGINEER IMMEDIATELY PRIOR TO START OF UTILITY CONSTRUCTION.

NOT FOR CONSTRUCTION

#### EROSION CONTROL MEASURES

- EROSION CONTROL SHALL BE IN ACCORDANCE WITH THE CITY OF MADISON EROSION CONTROL ORDINANCE AND CHAPTER NR 216 OF THE WISCONSIN ADMINISTRATIVE CODE.
- CONSTRUCT AND MAINTAIN ALL EROSION AND SEDIMENT CONTROL MEASURES IN ACCORDANCE WITH WISCONSIN DNR TECHNICAL STANDARDS (http://dnr.wi.gov/runoff/stormwater/techstds.htm) AND WISCONSIN CONSTRUCTION SITE BEST MANAGEMENT PRACTICE
- INSTALL SEDIMENT CONTROL PRACTICES (TRACKING PAD, PERIMETER SILT FENCE, SEDIMENT BASINS, ETC.) PRIOR TO INITIATING OTHER LAND DISTURBING CONSTRUCTION ACTIVITIES.
- THE CONTRACTOR IS REQUIRED TO MAKE EROSION CONTROL INSPECTIONS AT THE END OF EACH WEEK AND WHEN 0.5 INCHES OF RAIN FALLS WITHIN 24 HOURS. INSPECTION REPORTS SHALL BE PREPARED AND FILED AS REQUIRED BY THE DNR AND/OR CITY. ALL MAINTENANCE WILL FOLLOW AN INSPECTION WITHIN 24 HOURS
- FROSION CONTROL IS THE RESPONSIBILITY OF THE CONTRACTOR UNTIL ACCEPTANCE OF THIS PROJECT. FROSION CONTROL MEASURES AS SHOWN SHALL BE THE MINIMUM PRECAUTIONS THAT WILL BE ALLOWED. ADDITIONAL EROSION CONTROL MEASURES, AS REQUESTED IN WRITING BY THE STATE OR LOCAL INSPECTORS, OR THE DEVELOPER'S ENGINEER, SHALL BE INSTALLED WITHIN 24 HOURS.
- A 3" CLEAR STONE TRACKING PAD SHALL BE INSTALLED AT THE END OF ROAD CONSTRUCTION LIMITS TO PREVENT SEDIMENT FROM BEING TRACKED ONTO THE ADJACENT PAVED PUBLIC ROADWAY. SEDIMENT TRACKING PAD SHALL CONFORM TO WISDNR TECHNICAL STANDARD 1057. SEDIMENT REACHING THE PUBLIC ROAD SHALL BE REMOVED BY STREET CLEANING (NOT HYDRAULIC FLUSHING) BEFORE THE END OF
- 7. CHANNELIZED RUNOFF: FROM ADJACENT AREAS PASSING THROUGH THE SITE SHALL BE DIVERTED AROUND DISTURBED AREAS.
- STABILIZED DISTURBED GROUND: ANY SOIL OR DIRT PILES WHICH WILL REMAIN IN EXISTENCE FOR MORE THAN 7-CONSECUTIVE DAYS, THER TO BE WORKED DURING THAT PERIOD OR NOT, SHALL NOT BE LOCATED WITHIN 25-FEET OF ANY ROADWAY, PARKING LOT, PAVED AREA, OR DRAINAGE STRUCTURE OR CHANNEL (UNLESS INTENDED TO BE USED AS PART OF THE EROSION CONTROL MEASURES). TEMPORARY STABILIZATION AND CONTROL MEASURES (SEEDING, MULCHING, TARPING, EROSION MATTING, BARRIER FENCING, ETC.) ARE REQUIRED FOR THE PROTECTION OF DISTURBED AREAS AND SOIL PILES, WHICH WILL REMAIN UN-WORKED FOR A PERIOD OF MORE THAN 14-CONSECUTIVE CALENDAR DAYS. THESE MEASURES SHALL REMAIN IN PLACE UNTIL SITE HAS STABILIZED.
- 9. <u>SITE DE-WATERING:</u> WATER PUMPED FROM THE SITE SHALL BE TREATED BY TEMPORARY SEDIMENTATION BASINS OR OTHER APPROPRIATE CONTROL MEASURES. SEDIMENTATION BASINS SHALL HAVE A DEPTH OF AT LEAST 3 FEET, BE SURROUNDED BY SNOWFENCE OR EQUIVALENT BARRIER AND HAVE SUFFICIENT SURFACE AREA TO PROVIDE A SURFACE SETTLING RATE OF NO MORE THAN 750 GALLONS PER SQUARE FOOT PER DAY AT THE HIGHEST DEWATERING PUMPING RATE. WATER MAY NOT BE DISCHARGED IN A MANNER THAT CAUSES EROSION OF THE SITE, A NEIGHBORING SITE, OR THE BED OR BANKS OF THE RECEIVING WATER. POLYMERS MAY BE USED AS DIRECTED BY DNR TECHNICAL
- WASHED STONE WEEPERS OR TEMPORARY EARTH BERMS SHALL BE BUILT PER PLAN BY CONTRACTOR TO TRAP SEDIMENT OR SLOW THE VELOCITY OF STORM WATER.
- 11. SEE GRADING AND EROSION CONTROL PLAN FOR RIP-RAP SIZING. IN NO CASE WILL RIP-RAP BE SMALLER THAN 3" TO 6".
- 12. INLET FILTERS ARE TO BE PLACED IN STORMWATER INLET STRUCTURES AS SOON AS THEY ARE INSTALLED. THE FILTERS SHALL BE MAINTAINED UNTIL THE DISTURBED AREAS ARE BOTH 70% RESTORED AND PAVED.
- RESTORATION (SEED, FERTILIZE AND MULCH) SHALL BE PER SPECIFICATIONS ON THIS SHEET UNLESS SPECIAL RESTORATION IS CALLED FOR ON THE LANDSCAPE PLAN.
- 14. SEED. FERTILIZER AND MULCH SHALL BE APPLIED WITHIN 7 DAYS AFTER FINAL GRADE HAS BEEN ESTABLISHED. IF DISTURBED AREAS
- FOR THE FIRST SIX WEEKS AFTER RESTORATION (E.G. SEED & MULCH, EROSION MAT, SOD) OF A DISTURBED AREA, INCLUDE SUMMER WATERING PROVISIONS OF ALL NEWLY SEEDED AND MULCHED AREAS WHENEVER 7 DAYS ELAPSE WITHOUT A RAIN EVENT.
- 16. EROSION MAT (CLASS I, TYPE B PER WISCONSIN D.O.T. P.A.L.) SHALL BE INSTALLED ON ALL SLOPES 3:1 OR GREATER BUT LESS THAN
- 17. SOIL STABILIZERS SHALL BE APPLIED TO DISTURBED AREAS WITH SLOPES BETWEEN 10% AND 3:1 (DO NOT USE IN CHANNELS). SOIL STABILIZERS SHALL BE TYPE B, PER WISCONSIN D.O.T. P.A.L. (PRODUCT ACCEPTABILITY LIST), OR EQUAL. APPLY AT RATES AND METHODS SPECIFIED PER MANUFACTURER. SOIL STABILIZERS SHALL BE RE-APPLIED WHENEVER VEHICLES OR OTHER EQUIPMENT TRACK ON THE AREA
- SILT FENCE OR EROSION MAT SHALL BE INSTALLED ALONG THE CONTOLES AT 100 FOOT INTERVALS DOWN THE SLOPE ON THE DISTURBED SLOPES STEEPER THAN 5% AND MORE THAN 100 FEET LONG THAT SHEET FLOW TO THE ROADWAY UNLESS SOIL STABILIZERS ARE USED.
- 19. SILT FENCE TO BE USED ACROSS AREAS OF THE LOT THAT SLOPE TOWARDS A PUBLIC STREET OR WATERWAY. SEE DETAILS.
- 20. SEDIMENT SHALL BE CLEANED FROM CURB AND GUTTER AFTER EACH RAINFALL AND PRIOR TO PROJECT ACCEPTANCE.
- ACCUMULATED CONSTRUCTION SEDIMENT SHALL BE REMOVED FROM ALL PERMANENT BASINS TO THE ELEVATION SHOWN ON THE GRADING PLAN FOLLOWING THE STABILIZATION OF DRAINAGE AREAS.
- 22. ALL CONSTRUCTION ENTRANCES S USE AND AT THE END OF EACH DAY. ALL CONSTRUCTION ENTRANCES SHALL HAVE TEMPORARY ROAD CLOSED SIGNS THAT WILL BE IN PLACE WHEN THE ENTRANCE IS NOT IN
- 23. ANY PROPOSED CHANGES TO THE EROSION CONTROL PLAN MUST BE SUBMITTED AND APPROVED BY THE CITY AND STATE.
- 24. THE CITY, OWNER AND/OR ENGINEER MAY REQUIRE ADDITIONAL EROSION CONTROL MEASURES AT ANY TIME DURING CONSTRUCTION.
- THE CONTRACTOR SHALL REMOVE ANY SEDIMENT TRACKED ONTO ADJACENT ROADS BY MEANS OF STREET SWEEPING (NOT FLUSHING) AT A MINIMUM OF THE END OF EACH WORK DAY OR MORE AS NEEDED.

#### SEEDING RATES

#### TEMPORARY:

. USE ANNUAL OATS AT 3.0 LB./1,000 S.F. FOR SPRING AND SUMMER PLANTINGS 2. USE WINTER WHEAT OR RYE AT 3.0 LB./1,000 SF FOR FALL

PLANTINGS STARTED

#### PERMANENT: SEE LANDSCAPE PLAN.

FERTILIZING RATES:

TEMPORARY AND PERMANENT: USE WISCONSIN D.O.T. TYPE A OR B AT 7 LB./1,000 S.F.

MULCHING RATES:

#### TEMPORARY AND PERMANENT:


USE ½" TO 1-½" STRAW OR HAY MULCH, CRIMPED PER SECTION 607.3.2.3, OR OTHER RATE AND METHOD PER SECTION 627, WISCONSIN D.O.T. STANDARD SPECIFICATIONS FOR HIGHWAY AND STRUCTURE CONSTRUCTION

#### **CONSTRUCTION SEQUENCE:**


- 1. INSTALL FROSION CONTROL MEASURES
- 2. CONDUCT DEMOLITION
- 3. STRIP TOPSOIL (UNWORKED AREAS MAY REMAIN NON-STABILIZED FOR A MAXIMUM OF 14 DAYS)
- 4. ROUGH GRADE SITE
- 5. CONSTRUCT UNDERGROUND UTILITIES
- 6. INSTALL INLET PROTECTION IN NEW INLETS
- 7. CONSTRUCT BUILDING
- 8. CONSTRUCT PAVEMENT
- 9 FINAL GRADE AND PERMANENTLY RESTORE DISTURBED AREAS
- 10. REMOVE EROSION CONTROL MEASURES AFTER DISTURBED AREAS ARE 70% RESTORED OR PAVED.

#### NOTES:

- 1. INSTALL SILT FENCE TO FOLLOW THE GROUND CONTOURS AS CLOSELY AS POSSIBLE.
- 2. CURVE THE SILT FENCE UP THE SLOPE TO PREVENT WATER FROM RUNNING AROUND THE ENDS.
- POST SPACING WITH FENCE SUPPORT MESH = 10 FT. (MAX.)
  - POST SPACING WITHOUT FENCE SUPPORT MESH = 6 FT. (MAX.)
- SILT FENCE SUPPORT MESH CONSISTS OF 14-GAUGE STEEL WIRE WITH A MESH SPACING OF 6 IN. X 6 IN. OR PREFABRICATED POLYMERIC MESH OF EQUIVALENT STRENGTH

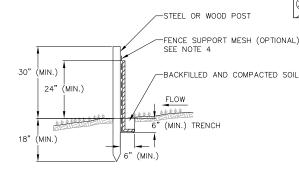




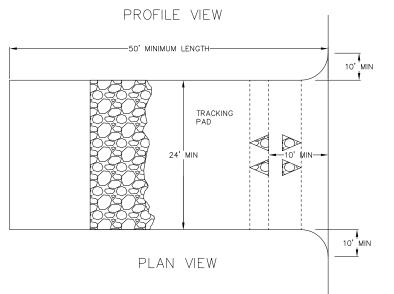

- 1. FOLLOW WISCONSIN DNR TECHNICAL STANDARD 1057 FOR FURTHER DETAILS AND INSTALLATION
- 2. LENGTH MINIMUM OF 50'.
- 3. WIDTH 24' MINIMUM, SHOULD BE FLARED AT THE EXISTING ROAD TO PROVIDE A TURNING RADIUS.
- 4. ON SITES WITH A HIGH GROUNDWATER TABLE OR WHERE SATURATED CONDITIONS EXIST, GEOTEXTILE FABRIC SHALL BE PLACED OVER EXISTING GROUND PRIOR TO PLACING STONE. FABRIC SHALL BE WISDOT TYPE-HR GEOTEXTILE FABRIC
- 5. STONE CRUSHED 3" CLEAR STONE SHALL BE PLACED AT LEAST 12" DEEP OVER THE ENTIRE LENGTH AND
- 6. SURFACE WATER ALL SURFACE WATER FLOWING TO OR DIVERTED TOWARDS CONSTRUCTION ENTRANCES SHALL BE PIPED THROUGH THE ENTRANCE. MAINTAINING POSITIVE DRAINAGE. PIPE INSTALLED THROUGH THE STABILIZED CONSTRUCTION ENTRANCE SHALL BE PROTECTED WITH A MOUNTABLE BERM WITH 5:1 SLOPES AND MINIMUM OF 6" STONE OVER THE PIPE. PIPE SHALL BE SIZED ACCORDING TO THE DRAINAGE REQUIREMENTS. WHEN THE ENTRANCE IS LOCATED AT A HIGH SPOT AND HAS NO DRAINAGE TO CONVEY A PIPE SHALL NOT BE NECESSARY. THE MINIMUM PIPE DIAMETER SHALL BE 6". CONTRACTOR SHALL BE RESPONSIBLE FOR THE MAINTENANCE OF SAID PIPE
- 7. LOCATION A STABILIZED CONSTRUCTION ENTRANCE SHALL BE LOCATED WHERE CONSTRUCTION TRAFFIC ENTERS AND/OR LEAVES THE CONSTRUCTION SITE. VEHICLES LEAVING THE SITE MUST TRAVEL OVER THE ENTIRE LENGTH OF THE TRACKING PAD.



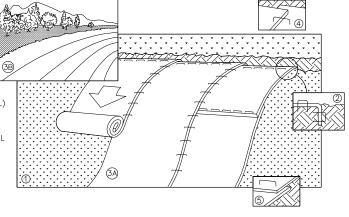



NOTE: REFER TO GENERAL STAPLE PATTERN GUIDE FOR CORRECT STAPLE PATTERN RECOMMENDATIONS FOR SLOPE INSTALLATIONS.


- PREPARE SOIL BEFORE INSTALLING BLANKETS, INCLUDING APPLICATION OF FERTILIZER AND SEED.

  NOTE: WHEN USING CELL-O-SEED, DO NOT SEED PREPARED AREA.

  CELL-O-SEED MUST BE INSTALLED WITH PAPER SIDE DOWN.
- BEGIN AT THE TOP OF THE SLOPE BY ANCHORING THE BLANKET IN 6" DEEP BY 6" WIDE TRENCH. BACKFILL AND COMPACT THE TRENCH AFTER STAPLING.
- ROLL THE BLANKETS <A.> DOWN, OR <B.> HORIZONTALLY ACROSS THE SLOPE THE EDGES OF PARALLEL BLANKETS MUST BE STAPLED WITH APPROXIMATELY 2" OVERLAP
- WHEN BLANKETS MUST BE SPLICED DOWN THE SLOPE, PLACE BLANKETS END OVER END (SHINGLE STYLE) WITH APPROXIMATELY 4" OVERLAP. STAPLE THROUGH OVERLAPPED AREA, APPROXIMATELY 12" APART.
- ALL BLANKETS MUST BE SECURELY FASTENED TO THE SLOPE BY PLACING STAPLES/STAKES IN APPROPRIATE LOCATIONS AS RECOMMENDED BY THE

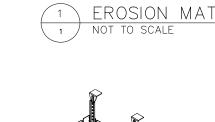

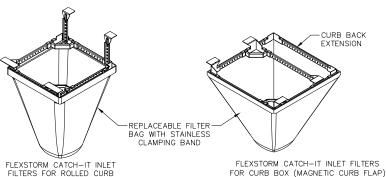

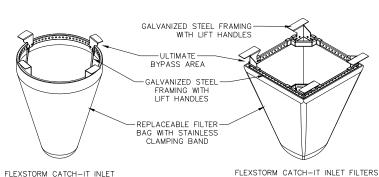

FOR SQUARE/RECTANGULAR OPENINGS

FILTERS FOR ROUND OPENINGS

- INLET PROTECTION DEVICES SHALL BE MAINTAINED OR REPLACED AT THE DIRECTION OF THE ENGINEER
- WHEN REMOVING OR MAINTAINING INLET PROTECTION, ANY TRAPPED MATERIAL THAT FALLS INTO THE INLET SHALL BE IMMEDIATELY REMOVED BY THE CONTRACTOR.





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> S. E. DAYTON STREET Y OF MADISON NE COUNTY, WI 615 E CITY DAN

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ONSTRUCTION

2022-08-08 DRAFTER TRRA

CHECKED CLAN PRO JECT NO

210331 C701

CONSTRUCTION DETAILS
615 E. DAYTON STREET
CITY OF MADISON
DANE COUNTY, WI


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PROJECT NO. 210331


C702



DRY TRENCH CONDITION

WET OR UNSTABLE CONDITION
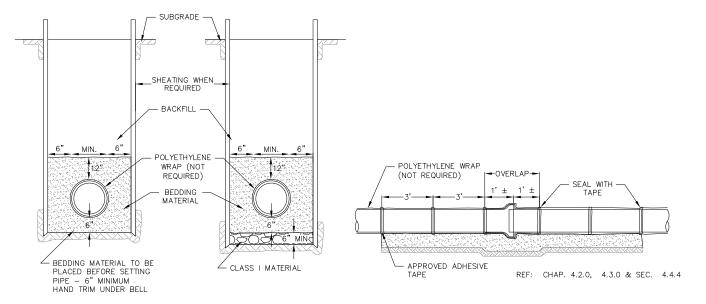
#### STANDARD WATER MAIN TRENCH SECTION NOT TO SCALE

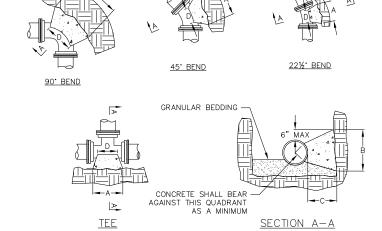

DIMENSION "D" SHALL BE AS LARGE AS POSSIBLE, BUT THE CONCRETE SHALL NOT INTERFERE WITH THE MECHANICAL JOINTS.

DIMENSION "C" SHALL BE AT LEAST 6 INCHES, AND LARGE ENOUGH TO MAKE THE "Q" ANGLE EQUAL TO OR GREATER THAN 45 DEGREES WITH THE DIMENSION "A" AS SHOWN ON THE TABLE, OR GREATER, AND WITH DIMENSION "D" AS LARGE AS POSSIBLE.


#### CONCRETE SHALL BE CLASS "C", SEE SECTION 03301

001101	CONCRETE STALE BE GLASS 0, SEE SECTION GOSGI							
	BUTTRESS DIMENSIONS							
PIPE*	TE	ES	22.5°	BEND	45°	BEND	90° E	BEND
SIZE*	Α	В	Α	В	Α	В	Α	В
4	0'-10"	1'-6"	1'-0"	1'-0"	1'-0"	1'-0"	1'-4"	1'-2"
6	1'-6"	1'-8"	1'-0"	1'-0"	1'-4"	1'-2"	1'-10"	1'-6"
8	1'-9"	2'-4"	1'-4"	1'-4"	ľ-10"	1'-10"	2'-8"	2'-3"
10	1'-9"	2'-4"	1'-10"	1'-8"	2'-6"	2'-4"	3'-10"	2'-10"
12	2'-3"	1'-7"	2'-4"	2'-0"		2'-10"	5'-0"	3'-4"
16	3'-8"	2'-10"	2'-10"		4'-0"	3'-3"	6'-4"	3'-10"
20	5'-0"	3'-10"	3'-6"	3'-0"	5'-4"	3'-10"	8'-0"	4'-8"
24	5'-4"	4'-8"						

DIMENSIONS IN THE TABLE ARE BASED ON A WATER PRESSURE OF 150 PSI AND SOIL RESISTANCE OF 2000 LBS/SQ FT

\* = FOR TEE THIS WILL BE THE BRANCH PIPE

BUTTRESS FOR BENDS NOT TO SCALE

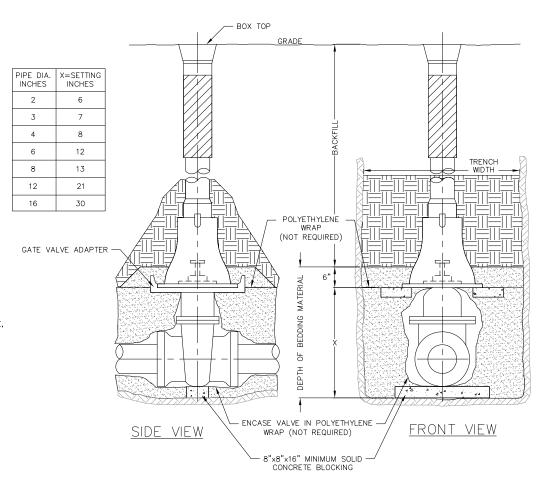


STANDARD GATE VALVE BOX SETTING NOT TO SCALE

SHEATHING -WHEN REQUIRED BACKFILL -ENSURE COMPLETE BACKFILLING -BEDDING MATERIAL TO BE - GEOTEXTILE WRAP IF CLASS I MATERIAL IN WET OR UNSTABLE CONDITION PLACED BEFORE SETTING PIPE - 6" MINIMUM UNDER BEDDING MATERIAL CLASS I, II, OR III FOR BURY DEPTH </= 15'
CLASS I OR II FOR BURY DEPTH >/= 15'
CLASS I OR II IN WET OR UNSTABLE CONDITIONS

SUBGRADE -

STANDARD SANITARY TRENCH SECTION NOT TO SCALE

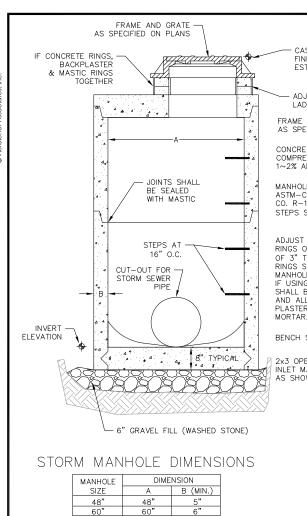

CASTING SHALL BE 1/2" BELOW FINISHED PAVEMENT OR AS ESTABLISHED BY THE ENGINEER

ADJUSTING RINGS — CONCRETE, LADTECH HDPE, OR APPROVED EQUAL

FRAME AND GRATE AS SPECIFIED ON PLANS

CONCRETE SHALL BE 4000 PSI, 28 DAY COMPRESSIVE STRENGTH, 6.5 BAG MIX WITH  $1{\sim}2\%$  AIR ENTRAINMENT.

MANHOLE STEPS SHALL CONFORM TO ASTM-C478 & SHALL BE NEENAH FOUNDRY CO. R-1981-N OR APPROVED EQUAL. STEPS SHALL BE SPACED 16" ON CENTER

ADJUST FRAME WITH A MINIMUM OF 2 RINGS OF VARIABLE THICKNESS. A MINIMUM OF 3" TO A MAXIMUM OF 9" OF ADJUSTING RINGS SHALL BE USED TO ADJUST THE MANHOLE CASTING TO THE FINISHED GRADE. IF USING CONCRETE RINGS, ALL RINGS
SHALL BE SEALED TOGETHER USING MASTIC AND ALL JOINTS SHALL BE BACK PLASTERED INSIDE AND OUT WITH CEMENT

BENCH SLOPE 1" PER FOOT.

2x3 OPENING IS REQUIRED FOR STORM INLET MANHOLES WITH CASTING AND RINGS AS SHOWN ON PLANS.

# 7" MAX -1-1/4" 26.5" DIA.→

IN BELL GRATE IN CUSTOM MANUFACTURED BY THE WESTWICK FOUNDRY COMPANY TO MADISON CONCRETE PIPE SPECIFICATIONS

GRATE IS CAST GRAY IRON MANUFACTURED TO MEET ASTM A-48 CLASS 35 B AND AASHTO M105 SPECIFICATIONS

GRATES ARE AASHTO H20 LOAD RATED

GRATE SETS FLUSH WITH TOP OF CATCH BASIN BELL

PRECAST REINFORCED CONCRETE CATCH BASIN IN MANUFACTURED TO MEET ASTM C-478 AND AASHTO M199 SPECIFICATIONS


STANDARD CATCH BASIN BARREL HEIGHTS: 2'-0", 3'-0" OR 4'-0"

CATCH BASIN STOCK 24" DIA, CATCH BASIN HAS NO BASE, BUT MAY BE ORDERED WITH A 3' THICK INTEGRAL BASE OR AS SPECIFIED

> CATCH BASIN JOINT MATERIAL: CONSEAL CS-102 AND/OR CS-202 OR EQUIVALENT WHICH MEETS OR EXCEEDS FEDERAL SPECIFICATION SS-S-210 (210A), AASHTO M-198B AND ASTM C-990

24" DIA. CATCH BASIN & GRATE

PIPE TO CATCH BASIN CONNECTORS: KOR-N-SEAL OR EQUIVALENT WHICH MEETS OR EXCEEDS REQUIREMENTS OF ASTM C-923

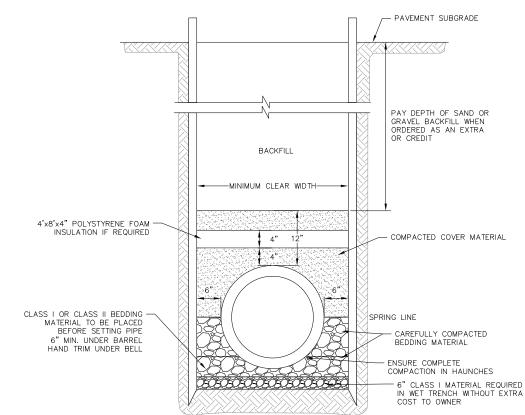


CLASS B RIGID PIPE TRENCH SECTION NOT TO SCALE

MANHOLE	DIMENSION		
SIZE	Α	B (MIN.)	
48"	48"	5"	
60"	60"	6"	
72"	72"	7"	
84"	84"	7"	
00"	00"	0"	


STORM SEWER MANHOLE

NOT TO SCALE

NOT TO SCALE

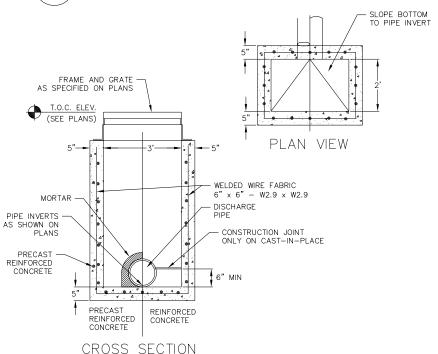

CURB INLET - TYPE 3, 2' x 3' BASIN

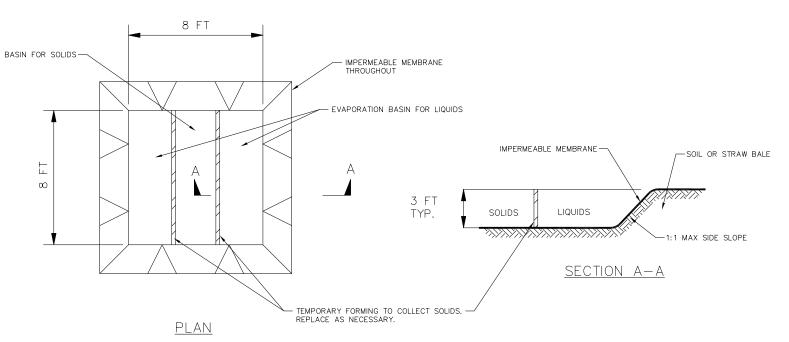

TEMPORARY CONCRETE WASHOUT NOT TO SCALE

#### CONSTRUCTION SPECIFICATIONS

- 1. LOCATE WASHOUT STRUCTURE A MINIMUM OF 50 FEET AWAY FROM OPEN
  CHANNELS, STORM DRAIN INLETS,
  SENSITIVE AREAS, WETLANDS, BUFFERS AND WATER COURSES AND AWAY FROM CONSTRUCTION TRAFFIC.
- 2.PREPARE SOIL BASE FREE OF ROCKS OR OTHER DEBRIS THAT MAY CAUSE TEARS OR HOLES IN THE LINER. FOR LINER, USE 10 MIL OR THICKER UV RESISTANT, IMPERMEABLE SHEETING, FREE OF HOLES AND TEARS OR OTHER DEFECTS THAT COMPROMISE IMPERMEABILITY OF THE MATERIAL.
- 3.KEEP CONCRETE WASHOUT STRUCTURE WATER TIGHT. REPLACE IMPERMEABLE LINER IF DAMAGED (E.G., RIPPED OR PUNCTURED). EMPTY OR REPLACE WASHOUT STRUCTURE THAT IS 75 PERCENT FULL, AND DISPOSE OF ACCUMULATED MATERIAL PROPERLY. DO NOT REUSE PLASTIC LINER. WET-VACUUM STORED LIQUIDS THAT HAVE NOT EVAPORATED AND DISPOSE OF IN AN APPROVED MANNER. REMOVE HARDENED SOLIDS, WHOLE OR BROKEN UP, FOR DISPOSAL OR RECYCLING. MAINTAIN RUNOFF DIVERSION AROUND EXCAVATED WASHOUT STRUCTURE UNTIL STRUCTURE IS REMOVED.


Vierbich planners | appropries |


DETAIL

615 E. DAYTON STREET CITY OF MADISON DANE COUNTY, WI ONSTRUCTION 2022-08-08 DRAFTER TBRA CHECKED CLAN


C703

PROJECT NO. 210331

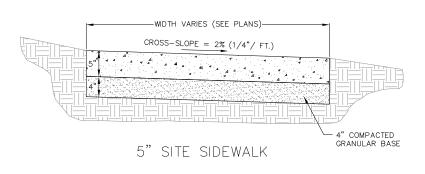


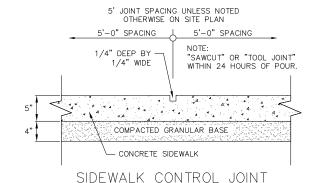




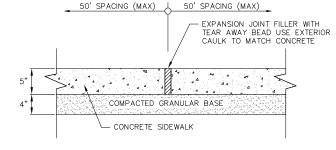


SIDEWALK EXPANSION JOINT

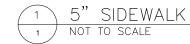

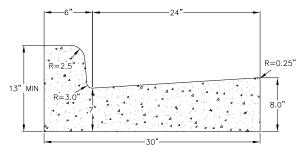


CURB AND GUTTER CROSS SECTION

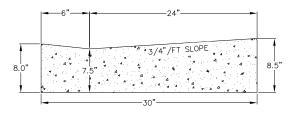


DRIVEWAY AND GUTTER CROSS SECTION

' CONCRETE CURB AND GUTTER NOT TO SCALE

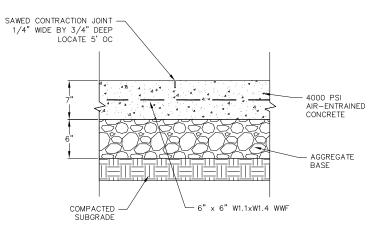



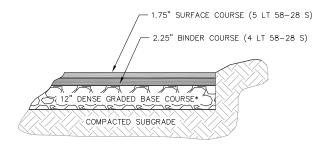

\*THE UPPER 4" SHOULD CONSIST OF 1 1/4" DENSE GRADED BASE; THE BOTTOM PART OF THE LAYER CAN CONSIST OF 3" DENSE GRADED BASE

ROAD REPLACEMENT BITUMINOUS PAVEMENT





Vierbicher planners | engineers | advisors

CONSTRUCTION DETAILS
615 E. DAYTON STREET
CITY OF MADISON
DANE COUNTY, WI 2022-08-08 DRAFTER TBRA

CLAN PROJECT NO. 210331

C704

CHECKED


#### PLANT SCHEDULE

EXISTING STREET TREES	BOTANICAL / COMMON NAME	ROOT COND.	QTY	REMARK
FA_E	Fraxinus americana / White Ash	Existing	1	24" dia
FP_E	Fraxinus pennsylvanica / Green Ash	Existing	1	32" dia
GT_E	Gleditsia triacanthos / Honey Locust	Existing	1	22" dic

#### CITY OF MADISON FORESTRY NOTES:

1. All proposed street tree removals within the right of way shall be reviewed by City Forestry before the Plan Commission meeting. Street tree removals require approval and a tree removal permit issued by City Forestry. Any street tree removals requested after the development plan is approved by the Plan Commission or the Board of Public Works and City Forestry will require a minimum of a 72-hour review period which shall include the notification of the Alderperson who's distric is affected by the tree removal(s) prior to a tree removal permit being issued.

- 2. As defined by Section 107.13 of City of Madison Standard Specifications for Public Works Construction: No excavation is permitted within 5 feet of the trunk of the street tree or when cutting roots over 3 inches in diameter. If excavation is necessary, the Contractor shall contact Madison City Forestry (266–4816) prior to excavation. City of Madison Forestry personnel shall assess the impact to the tree and to its root system prior to work commencing. Tree protection specifications can be found on the following website:
  https://www.cityofmadison.com/business/pw/specs.cfm
- 3. Contractor shall take precautions during construction to not disfigure, scar, or impair the health of any street tree. Contractor shall operate equipment in a manner as to not damage the branches of the street tree(s). This may require using smaller equipment and loading and unloading materials in a designated space away from trees on the construction site. Any damage or injury to existing street trees (either above or below ground) shall be reported immediately to City Forestry at 266-4816. Penalties and remediation shall be required.
- 4. Section 107.13(g) of City of Madison Standard Specifications for Public Works Construction addresses soil compaction near street trees and shall be followed by Contractor. The storage of parked vehicles, construction equipment, building materials, refuse, excavated spoils or dumping of poisonous materials on or around trees and roots within five (5) feet of the tree or within the protection zone is prohibited.
- 5. On this project, street tree protection zone fencing is required. The fencing shall be erected before the demolition, grading or construction begins. The fence shall include the entire width of terrace and, extend at least 5 feet on both sides of the outside edge of the tree trunk. Do not remove the fencing to allow for deliveries or equipment access through the tree protection zone.
- 6. Street tree pruning shall be coordinated with City Forestry a minimum of two weeks prior to the start of construction. Contact City Forestry at 608.266.4816. All pruning shall follow the American National Standards Institute (ANSI) A300—Part 1 Standards for pruning.

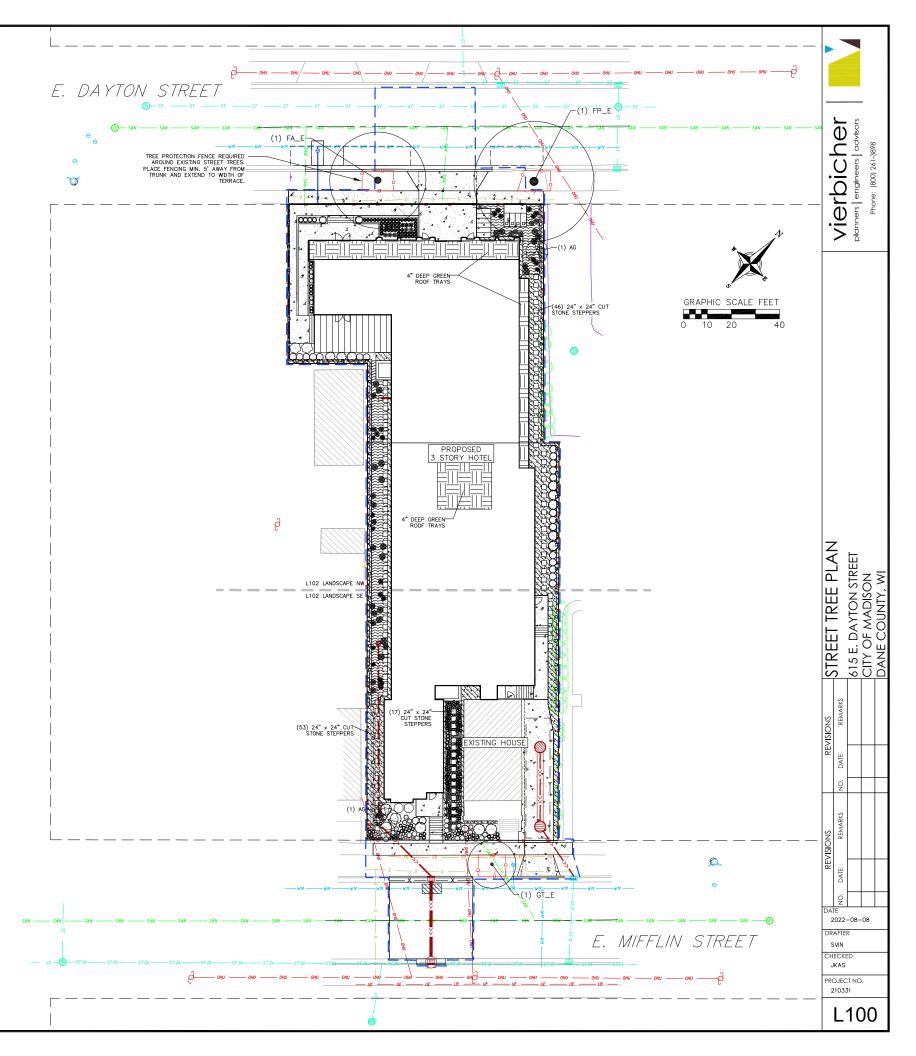

NOT FOR CONSTRUCTION

PLANT	SCHEDULE

EXISTING STREET TREES FA_E FP_E GT_E	BOTANICAL / COMMON NAME Fraxinus americana / White Ash Fraxinus pennsylvanica / Green Ash Gleditsia triacanthos / Honey Locust	ROOT COND. Existing Existing Existing	<u>SIZE</u>	NOTES	<u>QTY</u> 1 1 1	
UNDERSTORY TREES AG	$\begin{array}{lll} \underline{\text{BOTANICAL} \ / \ \text{COMMON NAME}} \\ \text{Amelanchier x grandiflora 'Robin Hill'} \ / \ \text{Robin Hill Apple Serviceberry} \end{array}$	ROOT COND. B & B	<u>SIZE</u> 6'ht.	<u>NOTES</u> Multi-Stem	QTY 2	
<u>DECIDUOUS SHRUBS</u> Ao Ha Hpq	BOTANICAL / COMMON NAME Amelanchier alnifolia 'Obelisk' TM / Standing Ovation Serviceberry Hydrangea arborescens 'Incrediball' / Incrediball White Hydrangea Hydrangea paniculata 'Little Quick Fire' / Little Quick Fire Hydrangea	ROOT COND. Cont. Cont. Cont.	<u>SIZE</u> 6' ht. 5 Gal. 5 Gal.	NOTES	<u>QTY</u> 8 2 2	
EVERGREEN SHRUBS Bg Jp Tod	BOTANICAL / COMMON NAME Buxus x 'Green Mountain' / Green Mountain Boxwood Juniperus procumbens 'Nano' / Dwarf Japanese Garden Juniper Thuja occidentalis 'Degroot's Spire' / Degroot's Spire Cedar	ROOT COND. Cont. Cont. B & B	<u>SIZE</u> 5 Gal. 5 Gal. 6' ht.	NOTES	<u>QTY</u> 5 6 20	
GROUNDCOVERS  cp cr ek ps ss2 ta tr ts vw	BOTANICAL / COMMON NAME Carex pensylvanica / Pennsylvania Sedge Carex rosea / Rosy Sedge Euonymus fortunei 'Kewensis' / Kew Wintercreeper Phlox subulata 'Ermerald Blue' / Emerald Blue Creeping Phlox Sagina subulata / Irish Moss Thymus vulgaris 'Argenteus' / Silver Common Thyme Thymus x 'Red Creeping' / Red Creeping Thyme Tiarella x 'Spring Symphony' / Spring Symphony Foamflower Veronica x 'Waterperry Blue' / Waterperry Blue Creeping Speedwell	ROOT COND. Cont.	SIZE 4 In 4 In 4 In 7 In 8 In 9	<u>NOTES</u>	QTY 23 93 20 66 20 17 33 35	
PERENNIALS am ca cb3 haa hg pvs pa sh	BOTANICAL / COMMON NAME Amsonia x 'Blue loe' / Blue loe Bluestar Calamagrostis x acutiflora 'Overdam' / Overdam Feather Reed Grass Cimicifuga racemosa 'Brunette' / Snakeroot Hosta x 'Awakening Angel' / Awakening Angel Hosta Hosta x 'Guacamole' / Guacamole Hosta Panicum virgatum 'Shenandoah' / Shenandoah Red Switch Grass Perovskia atriplicifolia 'Little Spire' / Little Spire Russian Sage Sporobolus heterolepis / Prairie Dropseed	ROOT COND. Cont.	SIZE 1 Gal. 1 Gal. 4 In 4 In 1 Gal. 1 Gal. 1 Gal. 1 Gal. 1 Gal.	NOTES	QTY 14 4 10 30 28 3 14 46	
GROUND COVERS	CODE	BOTANICAL / COMMON NAME	ROOT COND.	SIZE NOTES	SPACING	QTY
	ac	Asarum canadense / Wild Ginger	Cont	4 In	12" o.c.	919 sf

#### AGGREGATE SCHEDULE



1" QUARTZ STONE MULCH 2,209 sf

City of Madison Lands	cape Worksheet							
Address: 615 E Dayton			Date:	08.08.2022				
Total Square Footag	(Site Area)	-	(Building Fo		=	8659	sf	
Area		22684	Grac	ie)	14025			
Total Landscape Points	8,659	/ 300 =	29	x 5 =	144		144	
Lansdcape Poir	nts Requried >5 ac:		/ 100 =	0	x 1 =	-		
				s/ Existing scaping		Proposed scaping		
Plant Type/ Element Min. Size at Installation		Points	Quantity	Points Achieved	Quantity	Points Achieved		
Overstory deciduous tree	2.5" cal	35		0		0		
Tall Evergreen Tree	5-6 feet tall	35		0		0		
Ornamental tree	1.5" cal	15		0	2	30		
Upright evergreen shrub	3-4 feet tall	10		0	21	210		
Shrub, deciduous	#3 gallon	3		0	12	36		
Shrub, evergreen	#3 gallon	4		0	11	44		
Ornamental grasses/perennials	#1 gallon	2		0	109	218		
Ornamental/decorative fencing or wall	n/a	4 per 10 LF		0		0		
Existing significant specimen tree	Min. Size 2.5" cal.	14 per caliper inch.		0		0		
Landscape Furniture for public seating and/or transit connections		5 points per "seat"		0		0		
Sub Totals				0		538		
			Total Poi	nts Provided:	538			

#### PLANT MATERIAL NOTES:


- 1. ALL PLANTINGS SHALL CONFORM TO QUALITY REQUIREMENTS AS PER ANSI Z60.1.
- ALL PLANT MATERIAL SHALL BE TRUE TO SPECIES, VARIETY AND SIZE SPECIFIED, NURSERY GROWN IN ACCORDANCE WITH GOOD HORTICULTURAL PRACTICES, AND UNDER CLIMATIC CONDITIONS SIMILAR TO THOSE OF THE PROJECT SITE.
- 3. CONTACT LANDSCAPE ARCHITECT, IN WRITING, TO REQUEST ANY PLANT MATERIAL SUBSTITUTIONS DUE TO AVAILABILITY ISSUES.
- 4. ALL PLANTS SHALL BE GUARANTEED TO BE IN HEALTHY AND FLOURISHING CONDITION DURING THE GROWING SEASON FOLLOWING INSTALLATION. ALL PLANT MATERIAL SHALL BE GUARANTEED FOR ONE YEAR FROM THE TIME OF INSTALLATION.

#### LANDSCAPE MATERIAL NOTES:


- 1. CONTRACTOR SHALL PROVIDE A SUITABLE AMENDED TOPSOIL BLEND FOR ALL PLANTING AREAS WHERE SOIL CONDITIONS ARE UNSUITABLE FOR PLANT GROWTH. TOPSOIL SHALL CONFORM TO QUALITY REQUIREMENTS AS PER SECTION 625-2(1) OF THE "STANDARD SPECIFICATIONS FOR HIGHWAY CONSTRUCTION." PROVIDE A MINIMUM OF 18" OF TOPSOIL IN ALL PLANTING AREAS AND 6" OF TOPSOIL IN AREAS TO BE SEEDED/SODDED.
- 2. LANDSCAPE BEDS TO BE MULCHED WITH 1" PURPLE QUARTZ STONE (REGAL AMETHYST) TO 3" DEPTH MIN. OVER WEED BARRIER FABRIC. EDGE BEDS WITH COMMERCIAL GRADE ALUMINUM LANDSCAPE EDGING, PERMALOC CLEANLINE &"X4" OR EQUAL, COLOR BLACK ANODIZED.


#### SEEDING AND PLUG PLANTING NOTES:

- 1. STREET TERRACES AND ALL OTHER DISTURBED AREAS, UNLESS OTHERWISE NOTED, TO BE SEEDED WITH 'MADISON PARKS' MIX BY 'LACROSSE SEED COMPANY' OR EQUIVALENT, PER MANUFACTURER'S SPECIFIED APPLICATION RATES. ALL SEEDED AREAS ARE TO BE WATERED DAILY TO MAINTAIN ADEQUATE SOIL MOISTURE FOR PROPER GERMINATION. AFTER VIGOROUS GROWTH IS ESTABLISHED, APPLY \( \frac{1}{2}\)" WATER TWICE WEEKLY UNTIL FINAL ACCEPTANCE.
- 2. INSTALL BIORETENTION PLUG PLANTINGS AS 2" X 2" X 4"
  DEEP PLUGS, 12" ON CENTER IN A TRIANGULAR GRID
  PATTERN. PLANT SPECIES IN ODD NUMBERED GROUPS OF 5-9
  PLANTS, DISTRIBUTING EACH SPECIES RANDOMLY ACROSS
  PLANTING AREA FOR NATURAL APPEARANCE.

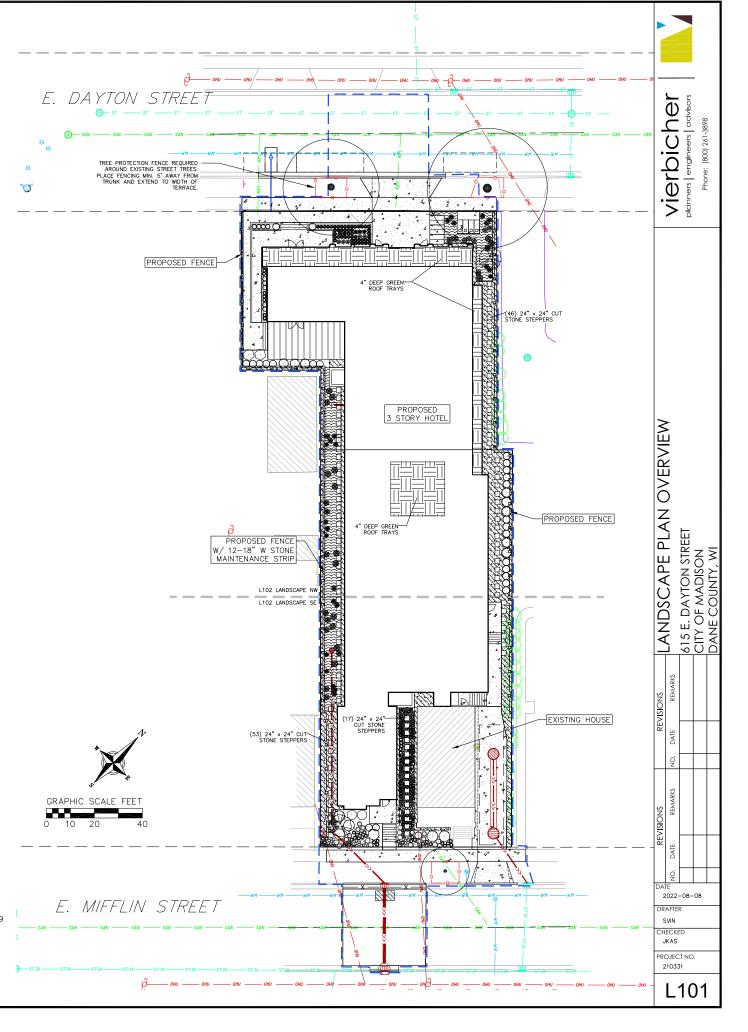

### NOT FOR CONSTRUCTION

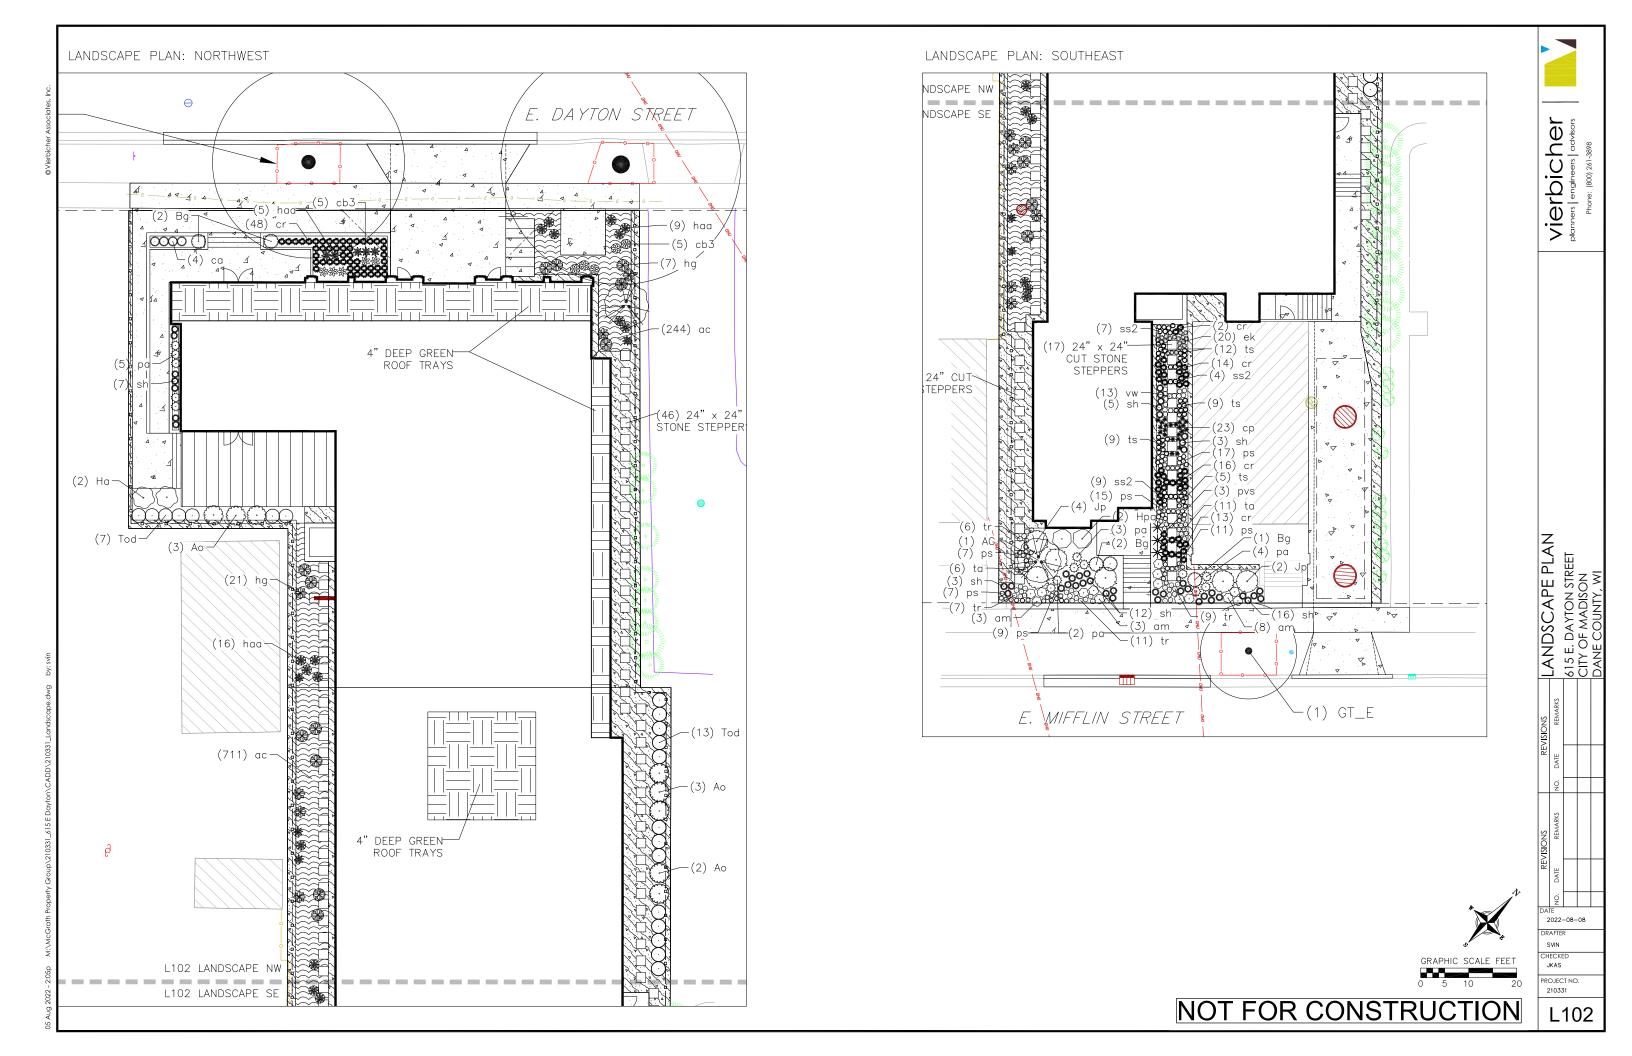

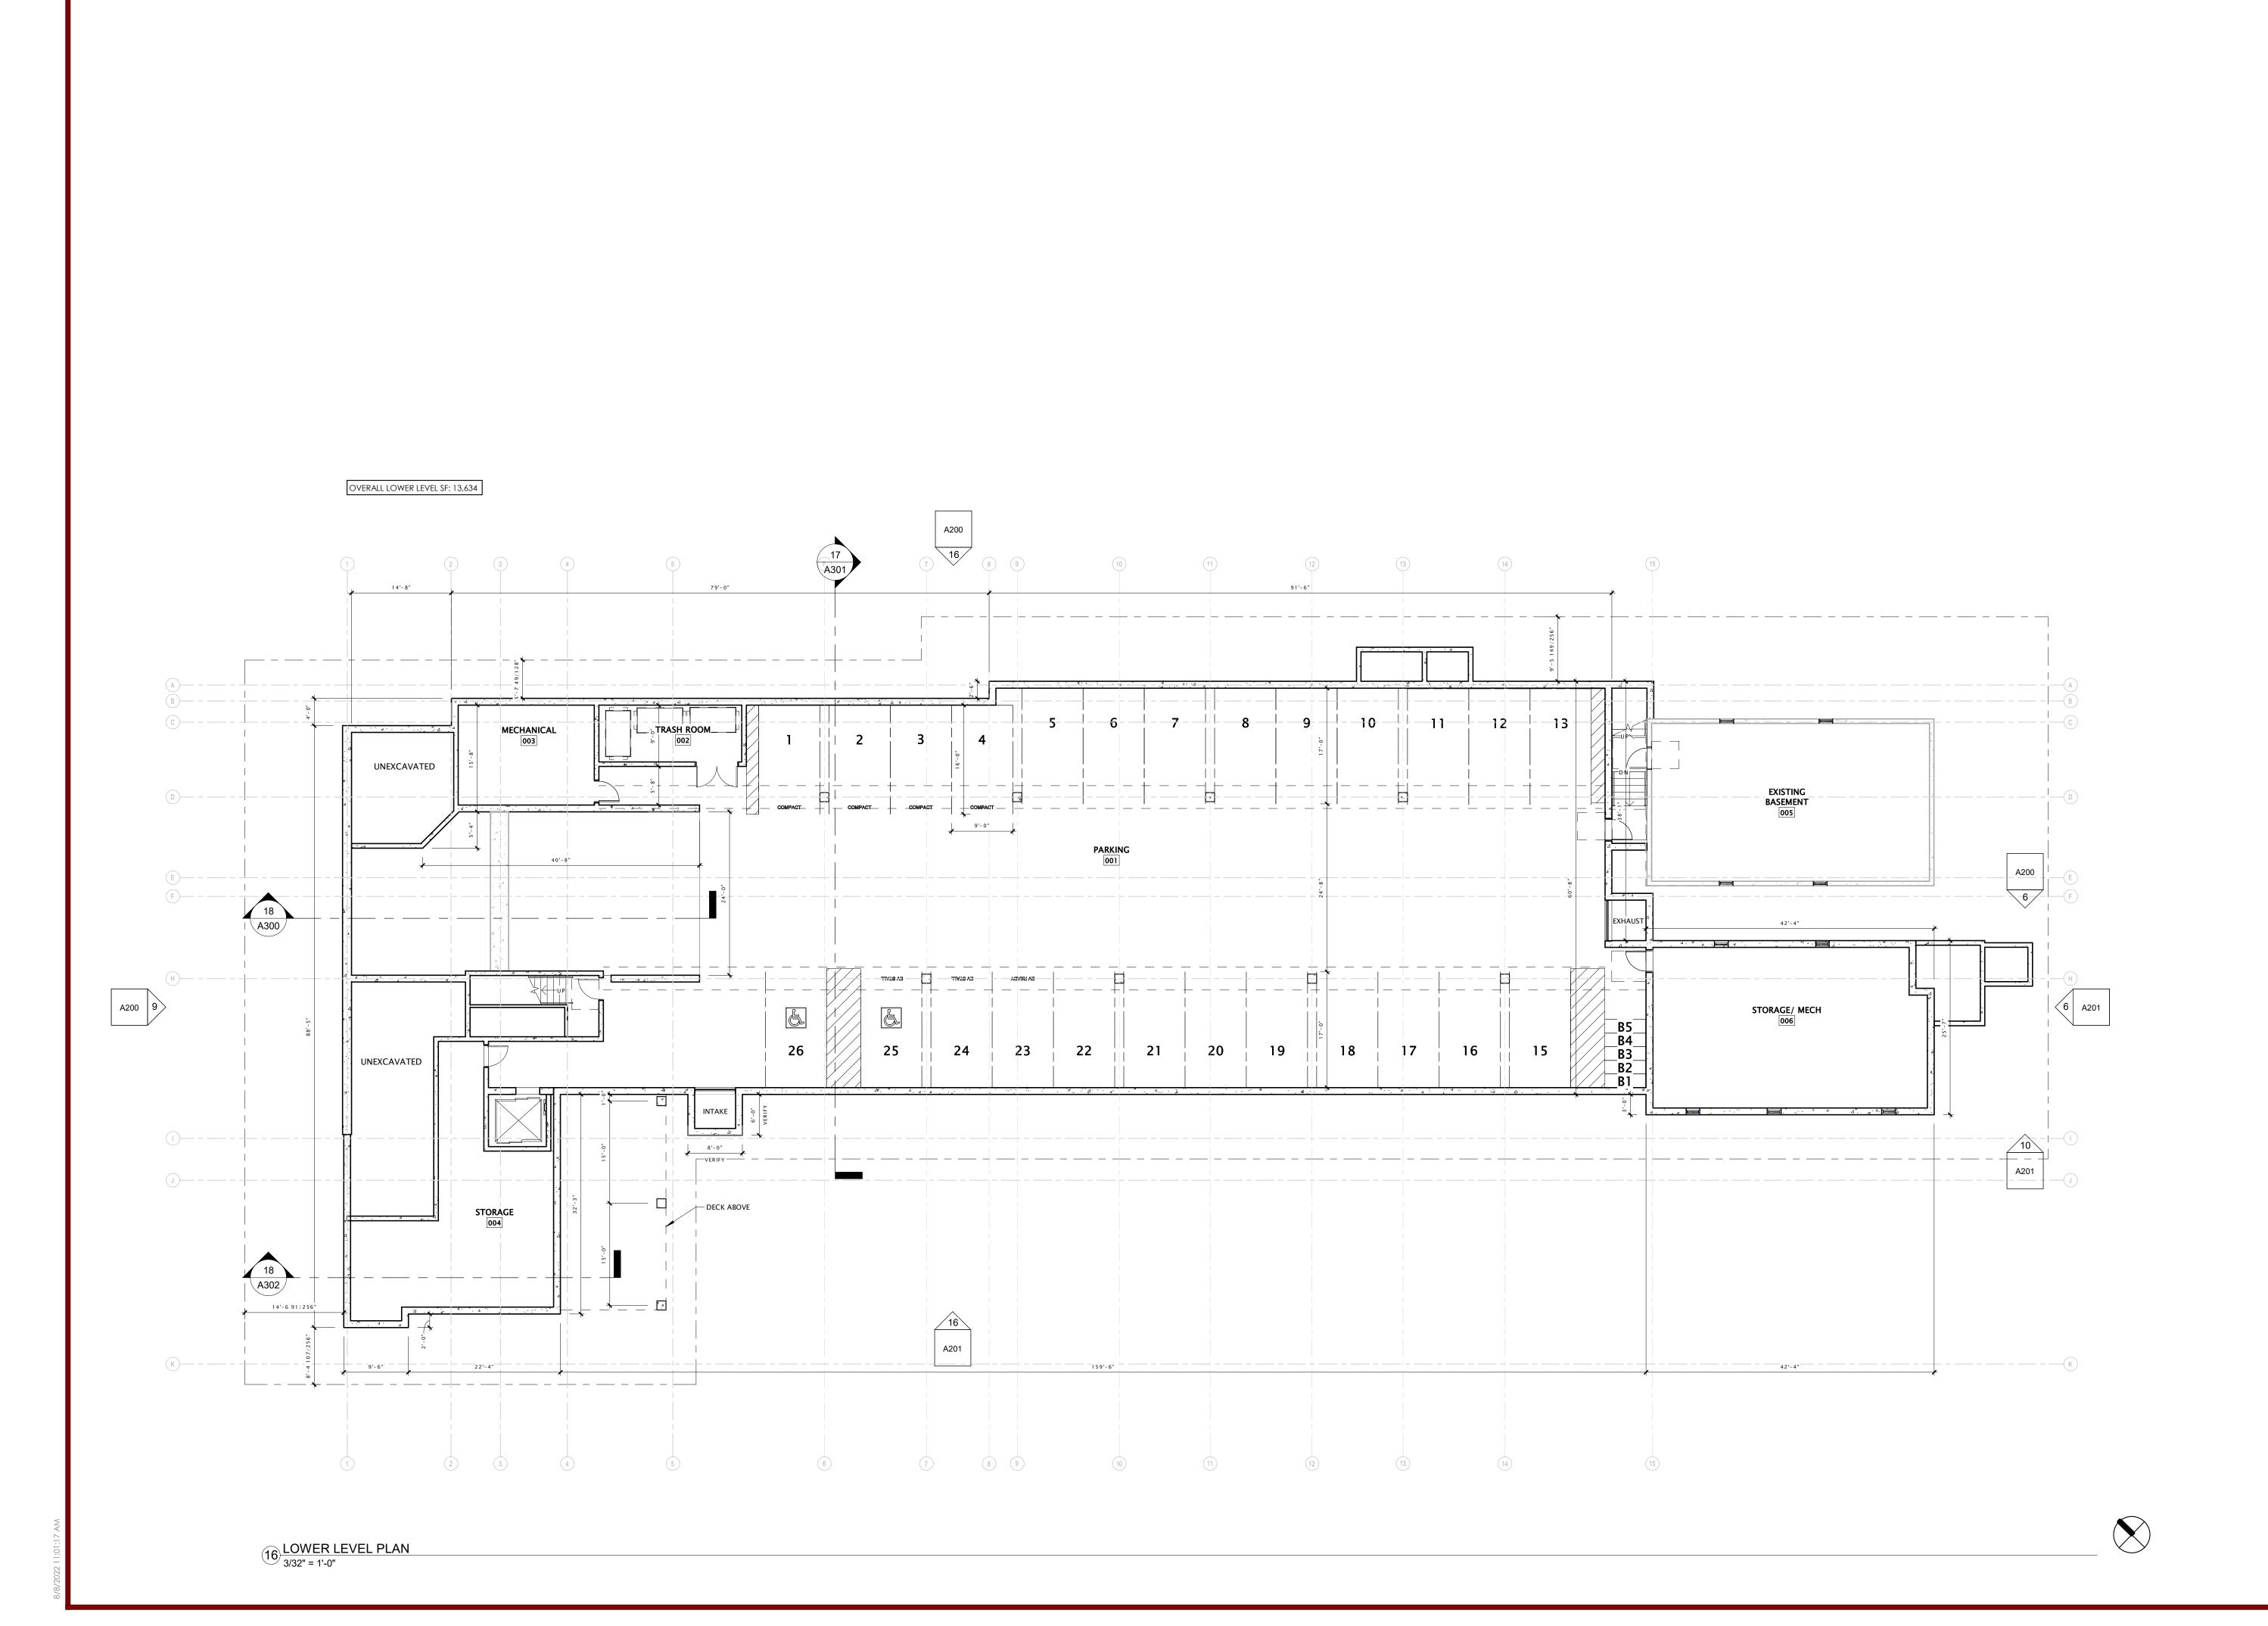



JLA PROJECT NUMBER:

jla-ap.com

# McGRATH Property Group

DAYTON-MIFFLIN HOTEL

LAND USE SUBMITTAL

# PROGRESS DOCUMENTS

These documents reflect progress and intent and may be subject to change, including additional detail. These are not final construction documents and should not be used for final bidding or construction-related purposes.

REVISION SCHEDULE

Mark Description Date

SHEET

LOWER LEVEL PLAN

Sheet number

UNIT COUNT:
FIRST FLOOR:
SECOND FLOOR:
THIRD FLOOR:
TOTAL UNITS: 17 21 17 **55** 



jla-ap.com

JLA PROJECT NUMBER:

# Property Group

21-1006

DAYTON-MIFFLIN HOTEL

LAND USE SUBMITTAL


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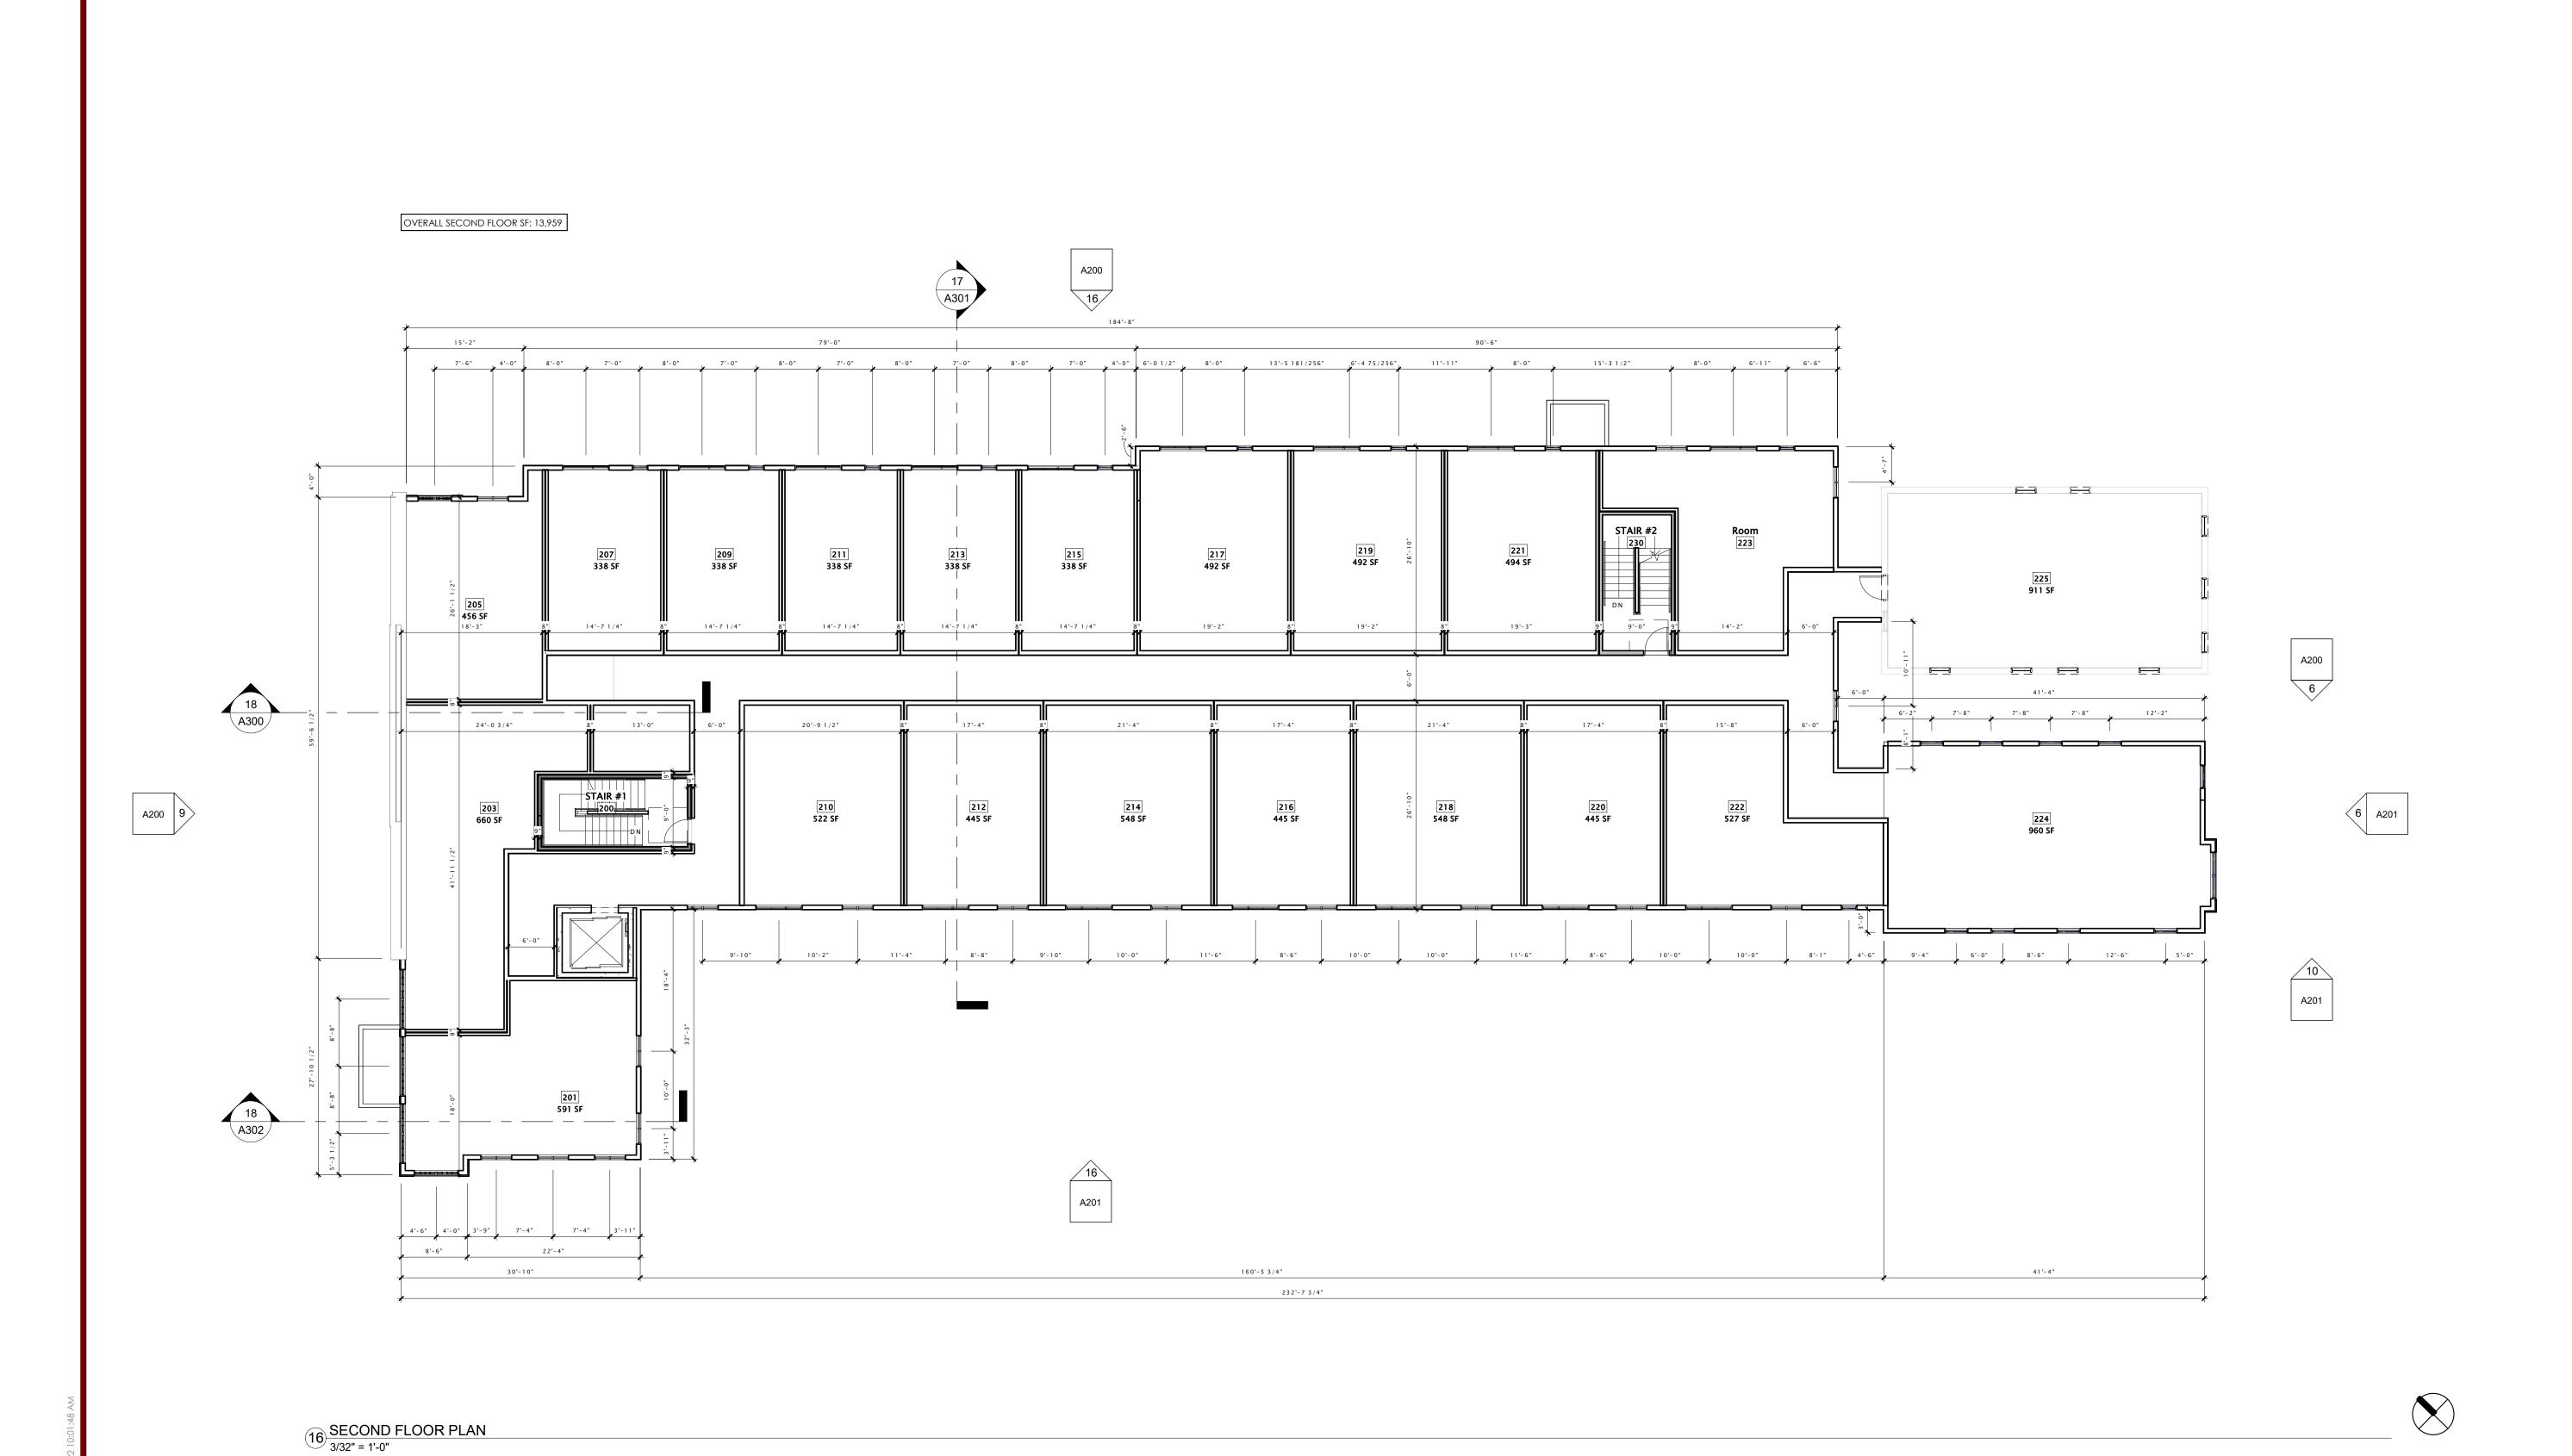
SUANCE A	UGUST 05, 2022		
revision schedule			
Description	Date		
	REVISION SCHEDULE		

FIRST FLOOR PLAN

SHEET NUMBER



16 FIRST FLOOR PLAN
3/32" = 1'-0"

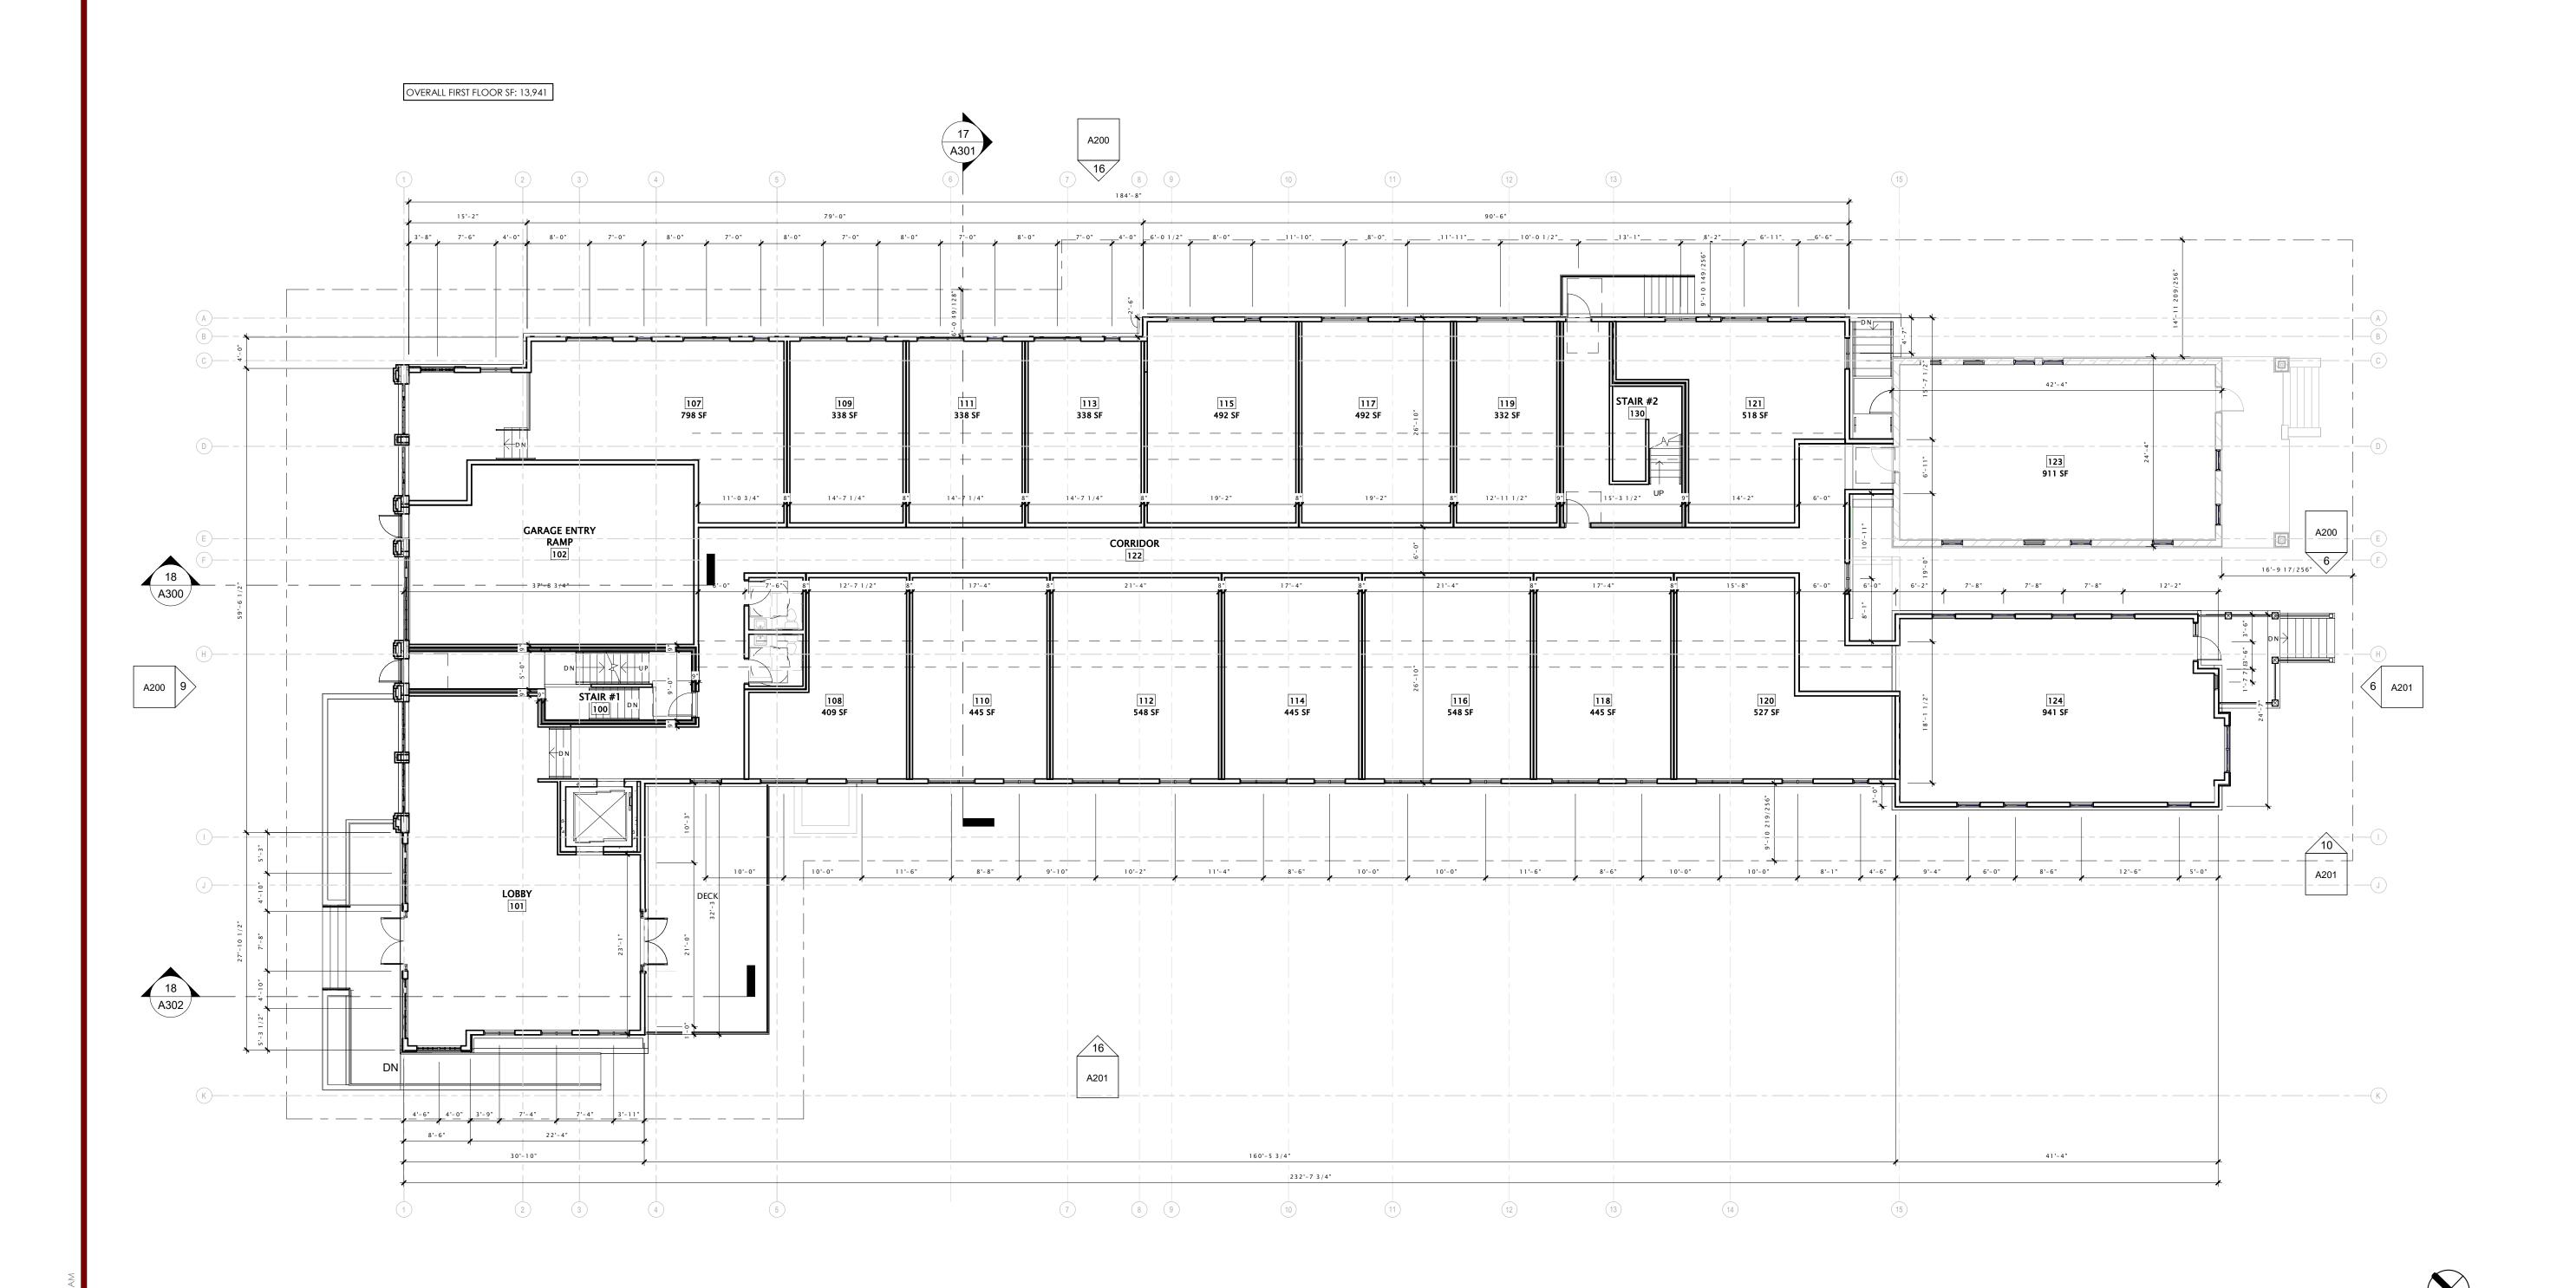



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JLA PROJECT NUMBER:

McGRATH
Property Group

21-1006

DAYTON-MIFFLIN HOTEL

LAND USE SUBMITTAL

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DATE OF ISSUANCE AUGUST 05, 2022


REVISION SCHEDULE

Mark Description Date

SHEET

SECOND FLOOR PLAN

Sheet number

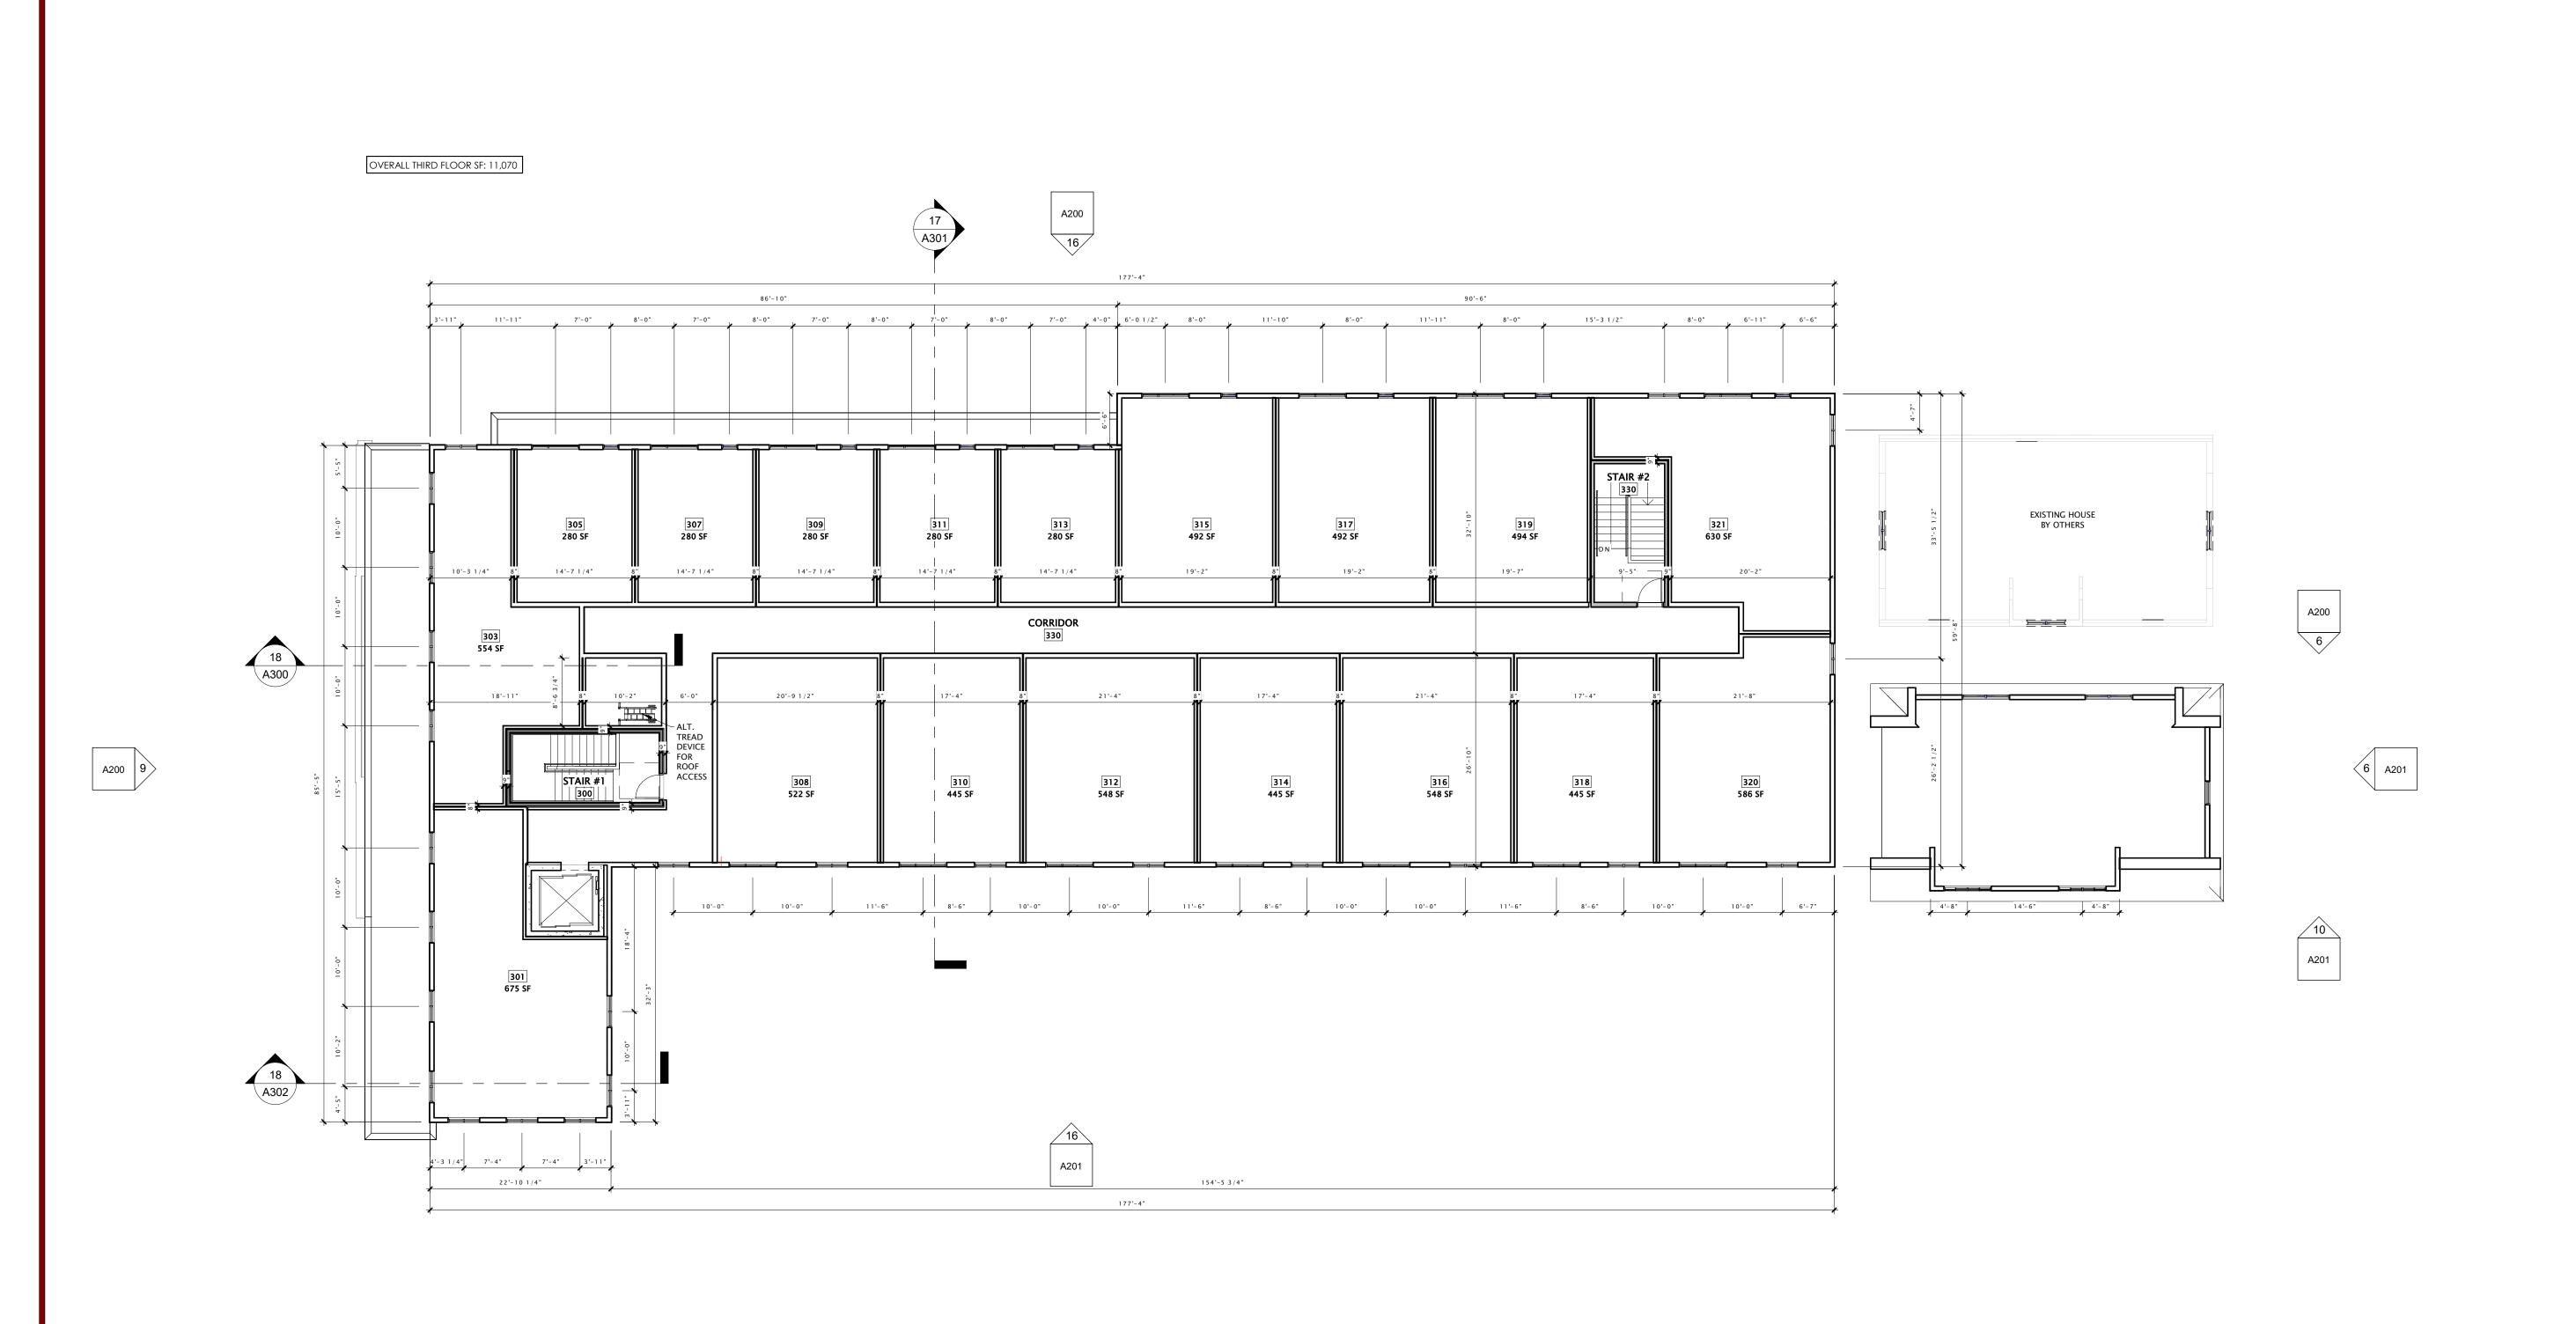

16 THIRD FLOOR PLAN
3/32" = 1'-0"



JLA PROJECT NUMBER:

T NUMBER: 21-1006

McGRATH
Property Group

DAYTON-MIFFLIN HOTEL

LAND USE SUBMITTAL

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DATE OF ISSUANCE AUGUST 05, 2022

REVISION SCHEDULE

Date


Description

SHEET TITLE

Mark

THIRD FLOOR PLAN

SHEET NUMBER

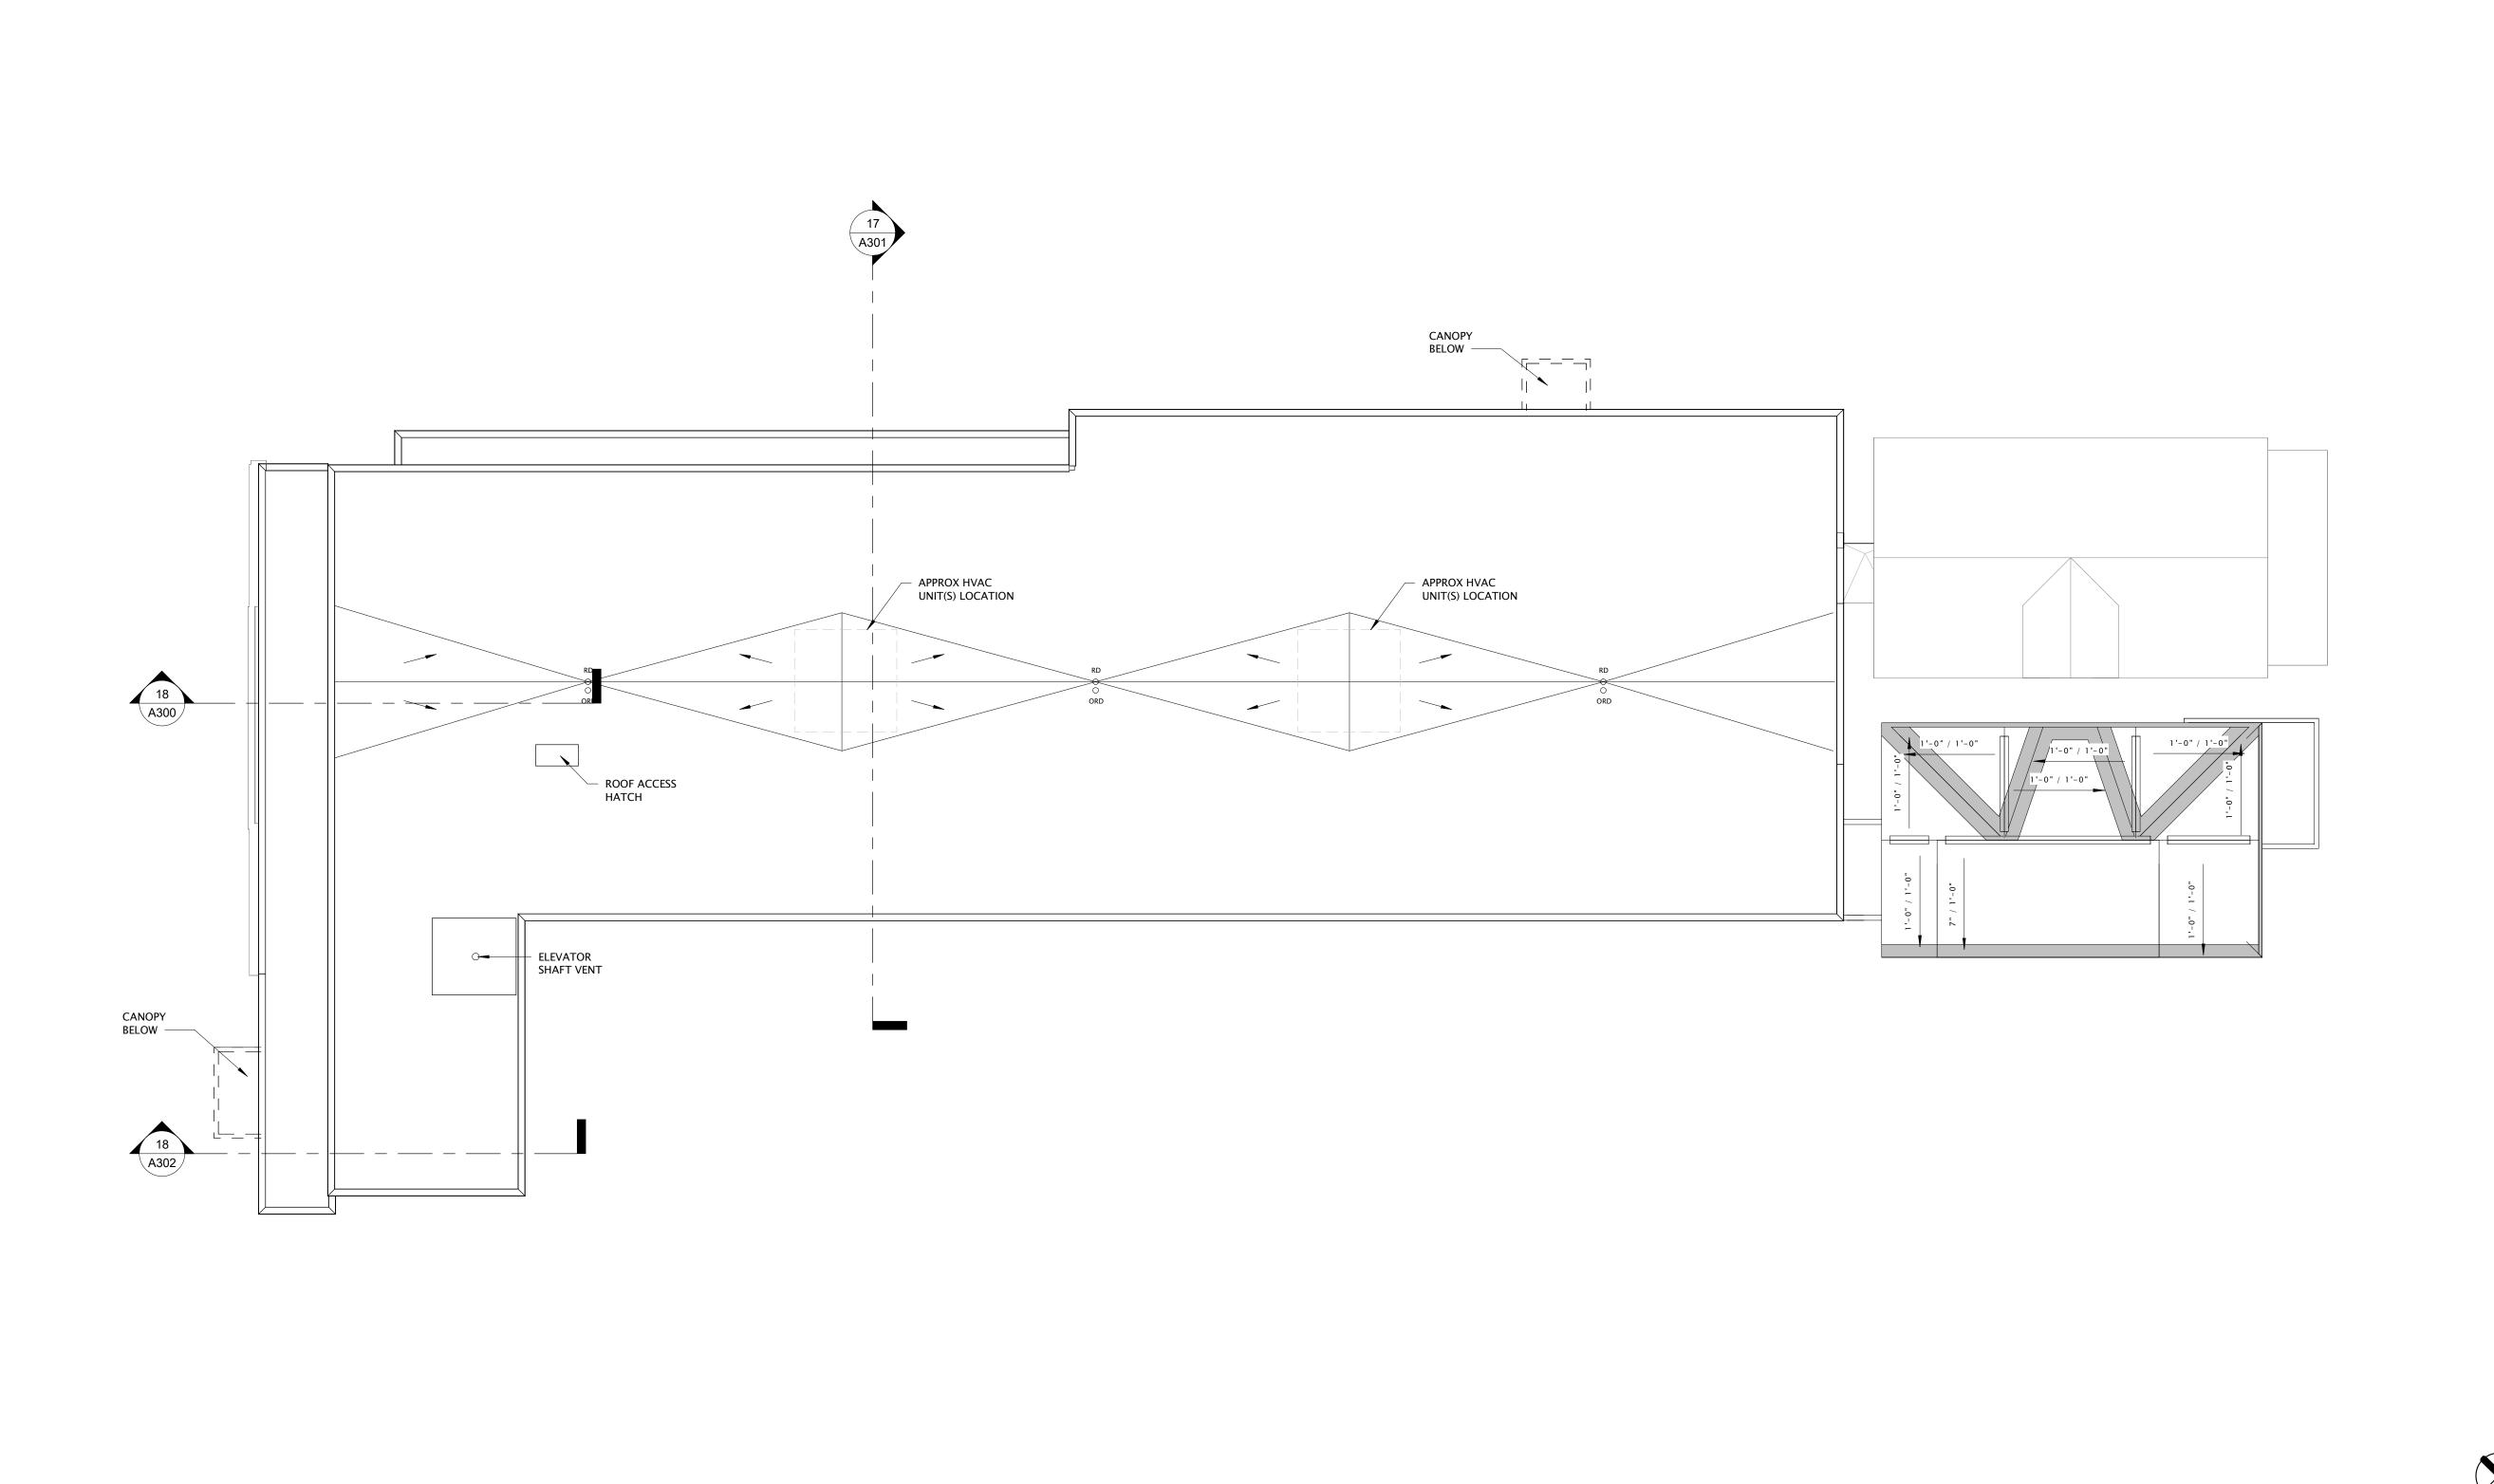

16 ROOF PLAN
3/32" = 1'-0"



JLA PROJECT NUMBER:

McGRATH
Property Group

21-1006

DAYTON-MIFFLIN HOTEL

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REVISION SCHEDULE


Mark Description Date


SHEET TITLE

**ROOF PLAN** 

SHEET NUMBER

	EXTERIOR MATERIALS SCHEDULE									
MARK	DESCRIPTION	MANUFACTURER	TYPE / STYLE	DIMENSIONS	COLOR	NOTES				
1	NOT USED									
2	METAL CANOPY	TBD	TBD	SEE PLANS	BLACK					
3	METAL PANEL	TBD	TBD	SEE PLANS	BLACK					
4	6" PAINTED SIDING	TBD	TBD	SEE PLANS	WARM GRAY					
5	6" PAINTED SIDING	TBD	TBD	SEE PLANS	DARK GRAY					
6	BOARD FORMED CONCRETE	TBD	TBD	SEE PLANS	EXPOSED CONCRETE W/ BOARD FORMED TEXTURE					
7	ACID ETCHED PRECAST CONCRETE	TBD	TBD	SEE PLANS	COLOR TO MATCH BRICK					
8	FIBERGLASS WINDOWS	TBD	TBD	SEE PLANS	BLACK					
9	SPLIT FACE CMU	TBD	TBD	SEE PLANS	GRAY					

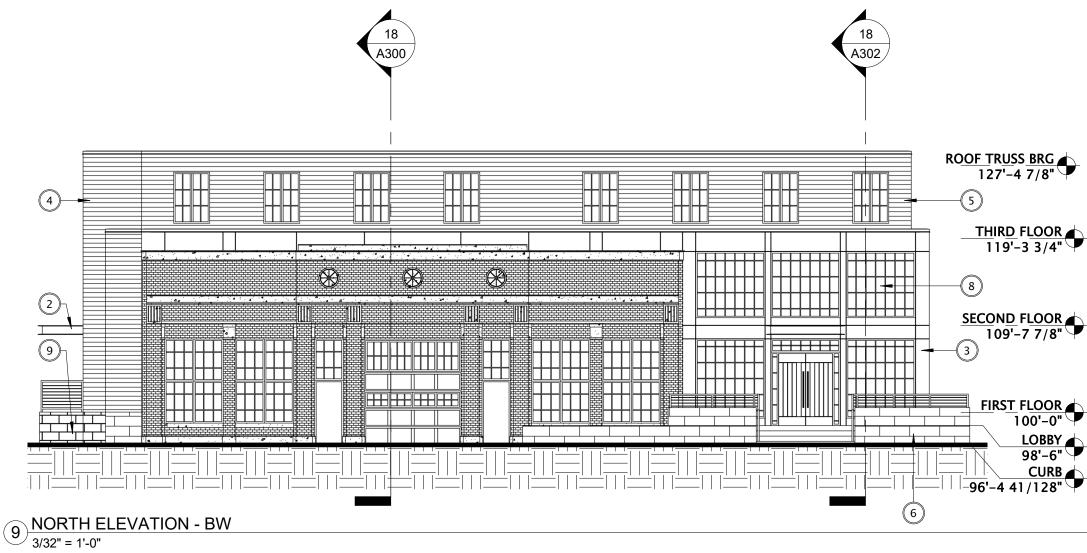

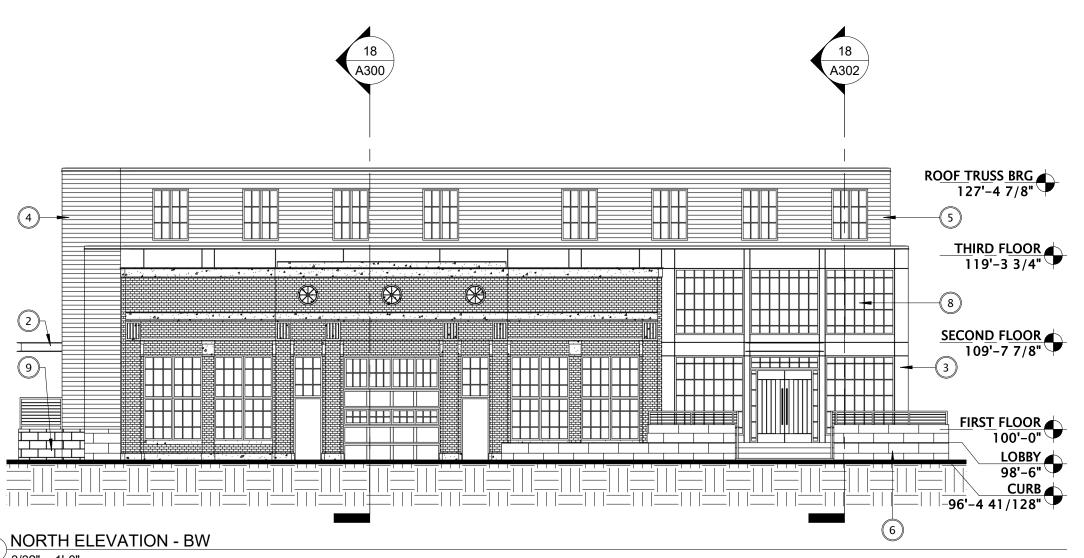



JLA PROJECT NUMBER:

21-1006

Property Group

DAYTON-MIFFLIN HOTEL

LAND USE SUBMITTAL

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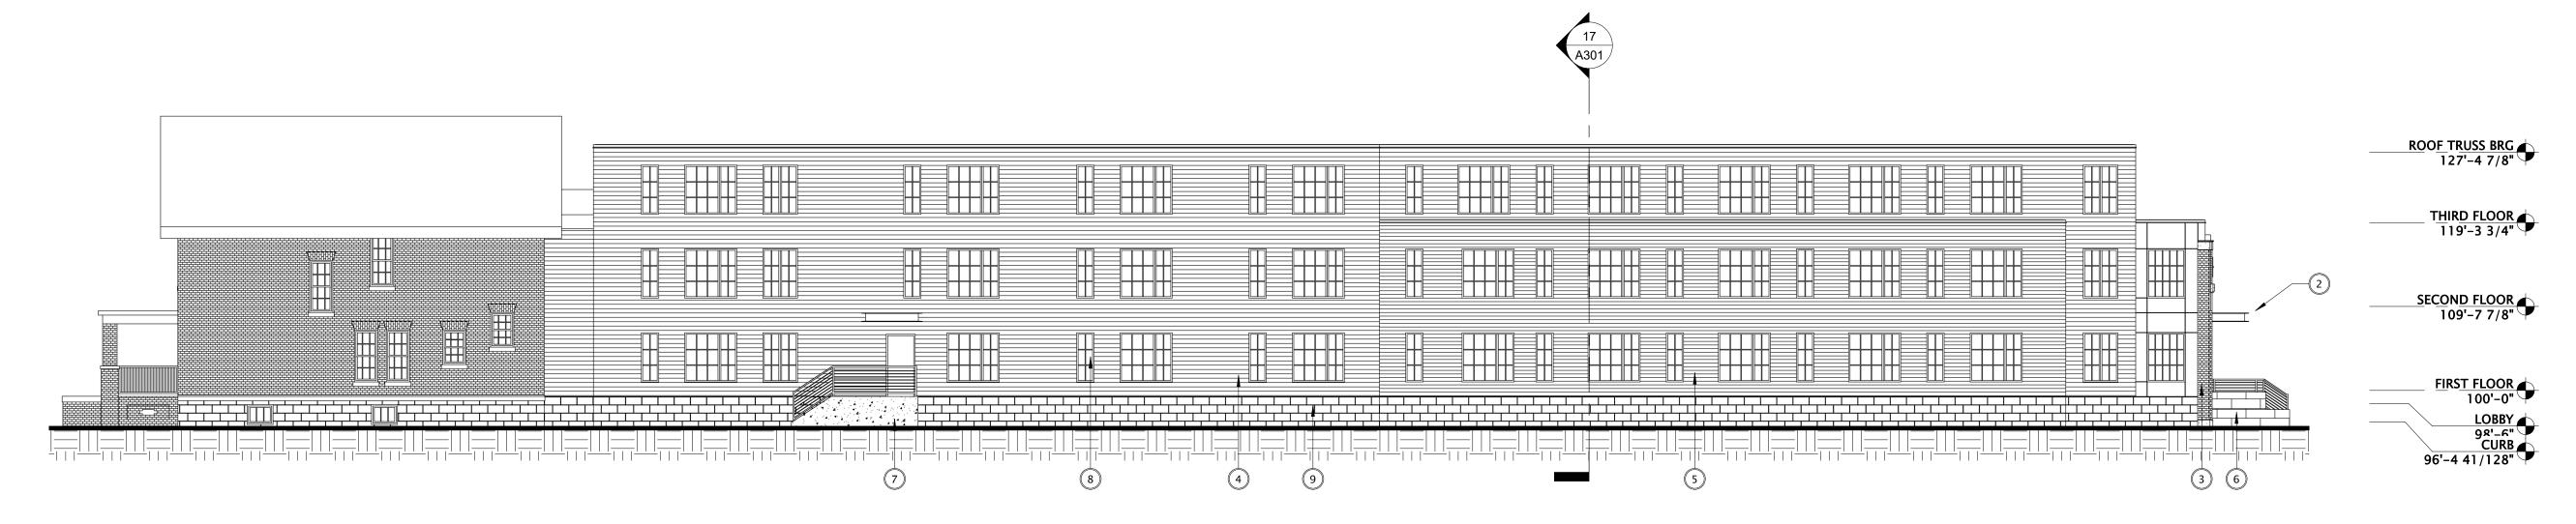
DATE OF ISSUANCE AUGUST 15, 2022 REVISION SCHEDULE Date Mark Description

SHEET TITLE

EXTERIOR ELEVATIONS - B/W

Sheet Number

A200



ROOF TRUSS BRG 127'-4 7/8"

THIRD FLOOR 119'-3 3/4"

SECOND FLOOR 109'-7 7/8"


FIRST FLOOR


96'-4 41/128"


98'-6"

6 EAST ELEVATION NEW HOUSE - BW 3/32" = 1'-0"

	EXTERIOR MATERIALS SCHEDULE									
MARK	DESCRIPTION	MANUFACTURER	TYPE / STYLE	DIMENSIONS	COLOR	NOTES				
1	NOT USED									
2	METAL CANOPY	TBD	TBD	SEE PLANS	BLACK					
3	METAL PANEL	TBD	TBD	SEE PLANS	BLACK					
4	6" PAINTED SIDING	TBD	TBD	SEE PLANS	WARM GRAY					
5	6" PAINTED SIDING	TBD	TBD	SEE PLANS	DARK GRAY					
6	BOARD FORMED CONCRETE	TBD	TBD	SEE PLANS	EXPOSED CONCRETE W/ BOARD FORMED TEXTURE					
7	ACID ETCHED PRECAST CONCRETE	TBD	TBD	SEE PLANS	COLOR TO MATCH BRICK					
8	FIBERGLASS WINDOWS	TBD	TBD	SEE PLANS	BLACK					
9	SPLIT FACE CMU	TBD	TBD	SEE PLANS	GRAY					

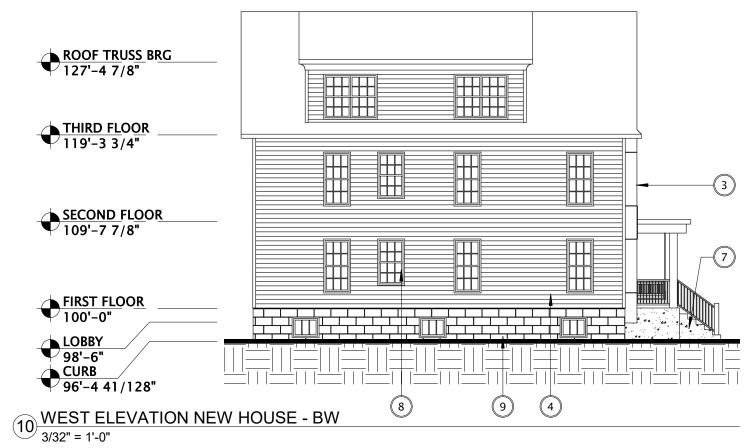

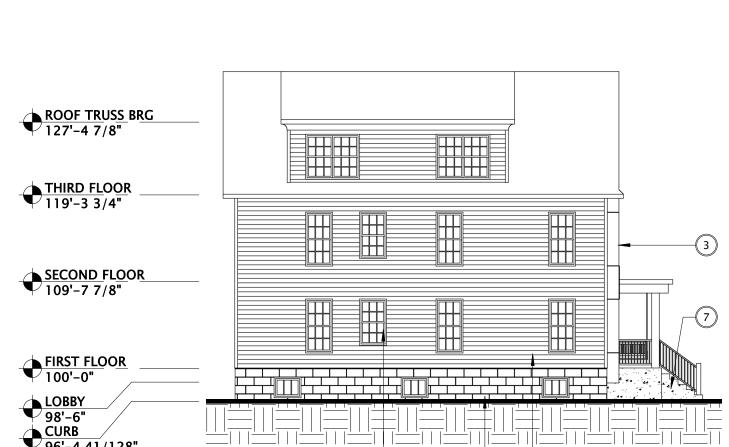

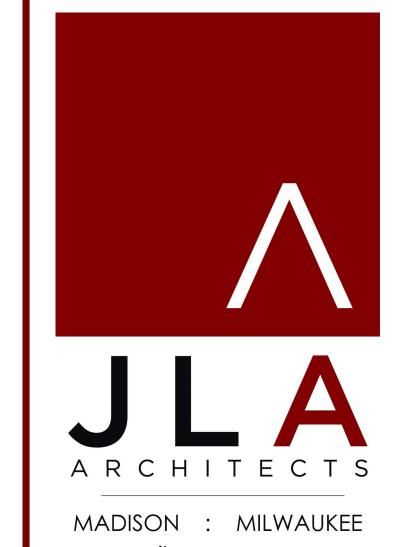

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Property Group

21-1006

DAYTON-MIFFLIN HOTEL

LAND USE SUBMITTAL

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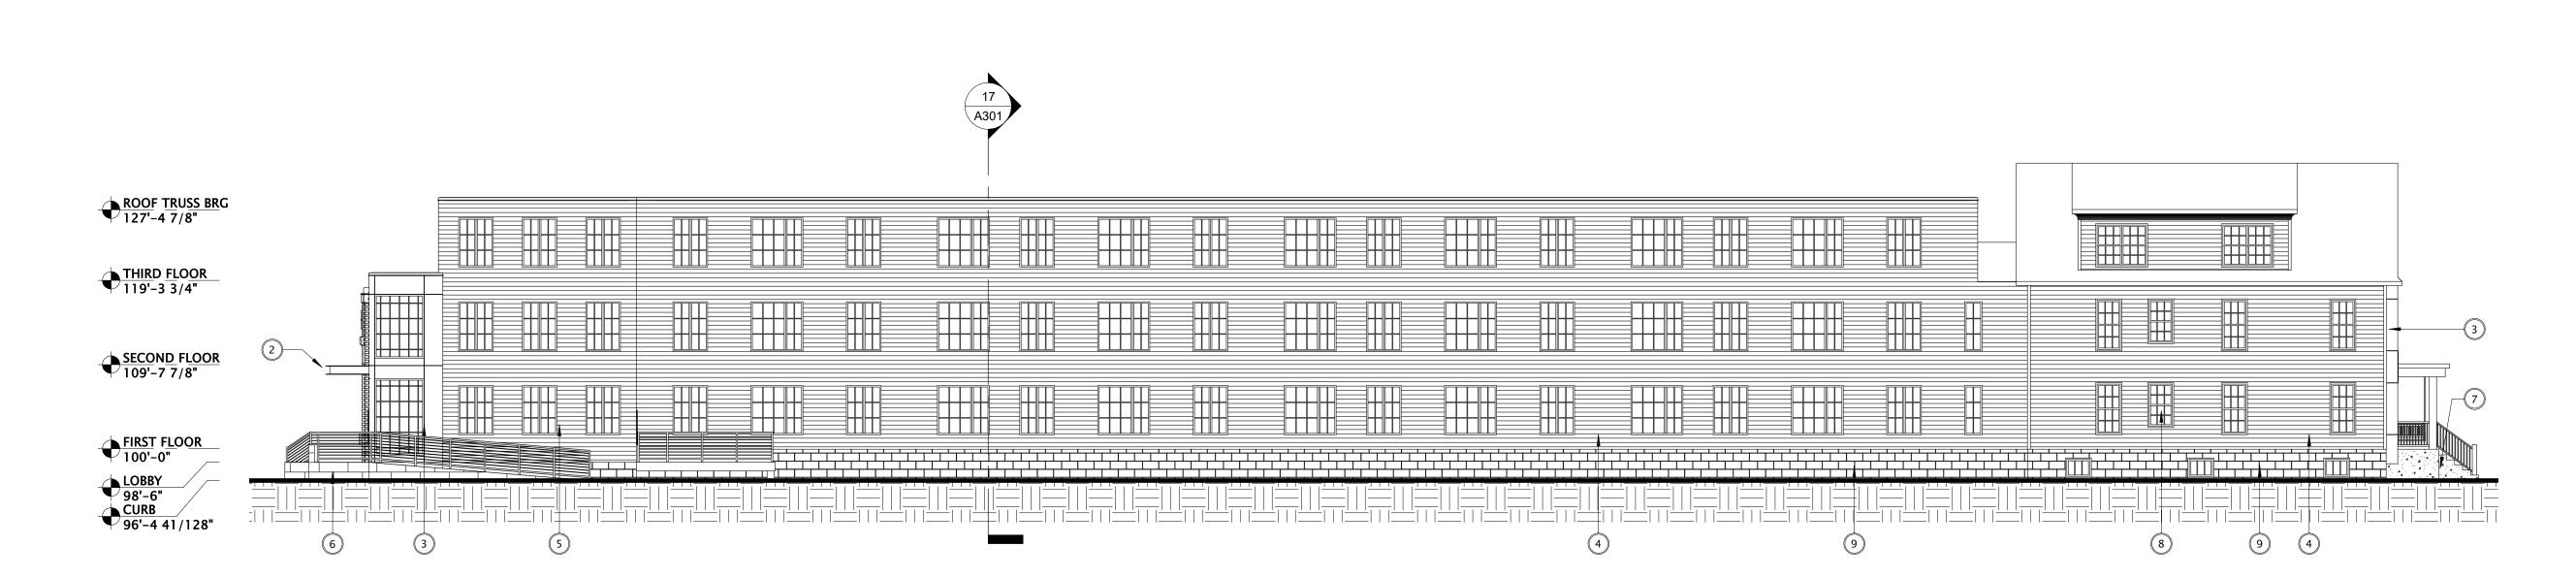
DATE OF ISSU	JANCE REVISION SCHEI	AUGUST 15, 2022
Mark	Description	Date

SHEET TITLE

EXTERIOR ELEVATIONS - B/W

Sheet Number

A201



ROOF TRUSS BRG 127'-4 7/8"

THIRD FLOOR 119'-3 3/4"

SECOND FLOOR 109'-7 7/8" 5

FIRST FLOOR 100'-0"

6 SOUTH ELEVATION - BW 3/32" = 1'-0"

16 WEST ELEVATION - BW

CURB 96'-4 41/128"

7 4 8 7

3

	EXTERIOR MATERIALS SCHEDULE									
MARK	DESCRIPTION	MANUFACTURER	TYPE / STYLE	DIMENSIONS	COLOR	NOTES				
1	NOT USED									
2	METAL CANOPY	TBD	TBD	SEE PLANS	BLACK					
3	METAL PANEL	TBD	TBD	SEE PLANS	BLACK					
4	6" PAINTED SIDING	TBD	TBD	SEE PLANS	WARM GRAY					
5	6" PAINTED SIDING	TBD	TBD	SEE PLANS	DARK GRAY					
6	BOARD FORMED CONCRETE	TBD	TBD	SEE PLANS	EXPOSED CONCRETE W/ BOARD FORMED TEXTURE					
7	ACID ETCHED PRECAST CONCRETE	TBD	TBD	SEE PLANS	COLOR TO MATCH BRICK					
8	FIBERGLASS WINDOWS	TBD	TBD	SEE PLANS	BLACK					
9	SPLIT FACE CMU	TBD	TBD	SEE PLANS	GRAY					







JLA PROJECT NUMBER:

21-1006

Property Group

DAYTON-MIFFLIN HOTEL

LAND USE SUBMITTAL

### PROGRESS DOCUMENTS

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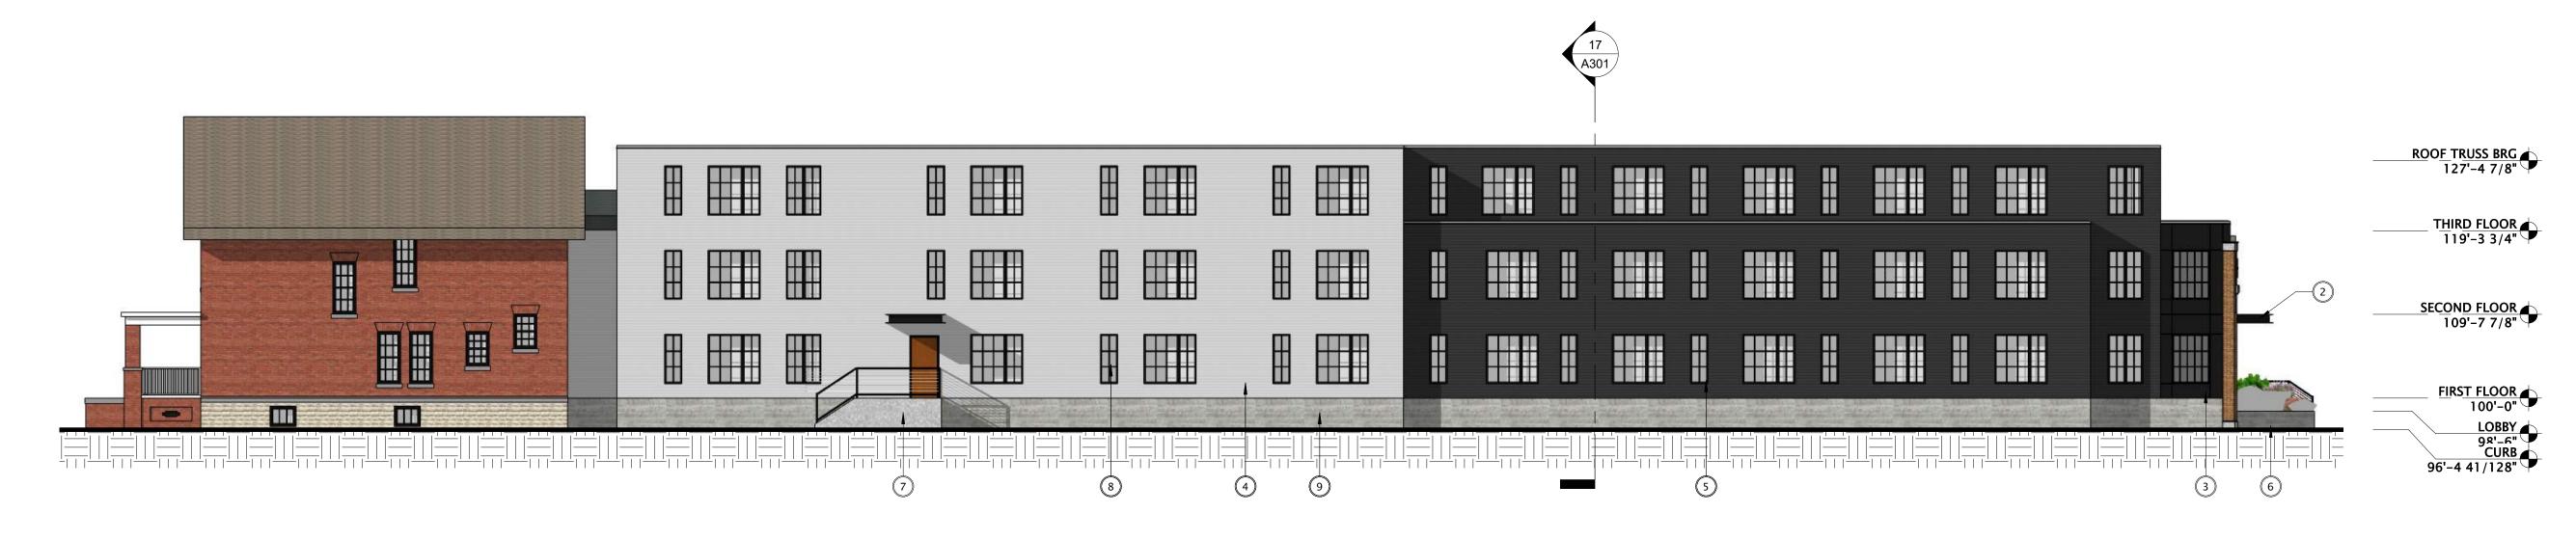
DATE OF	ISSUANCE	AUGUST 15, 2022
	revision scheduli	Ξ
Mark	Description	Date

SHEET TITLE

EXTERIOR ELEVATIONS

SHEET NUMBER

A202



6 EAST ELEVATION NEW HOUSE - SKP 3/32" = 1'-0"

ROOF TRUSS BRG 127'-4 7/8"

THIRD FLOOR 119'-3 3/4"

SECOND FLOOR 109'-7 7/8"

FIRST FLOOR

96'-4 41/128"

10BBY 98'-6"

	EXTERIOR MATERIALS SCHEDULE										
MARK	DESCRIPTION	MANUFACTURER	TYPE / STYLE	DIMENSIONS	COLOR	NOTES					
1	NOT USED										
2	METAL CANOPY	TBD	TBD	SEE PLANS	BLACK						
3	METAL PANEL	TBD	TBD	SEE PLANS	BLACK						
4	6" PAINTED SIDING	TBD	TBD	SEE PLANS	WARM GRAY						
5	6" PAINTED SIDING	TBD	TBD	SEE PLANS	DARK GRAY						
6	BOARD FORMED CONCRETE	TBD	TBD	SEE PLANS	EXPOSED CONCRETE W/ BOARD FORMED TEXTURE						
7	ACID ETCHED PRECAST CONCRETE	TBD	TBD	SEE PLANS	COLOR TO MATCH BRICK						
8	FIBERGLASS WINDOWS	TBD	TBD	SEE PLANS	BLACK						
9	SPLIT FACE CMU	TBD	TBD	SEE PLANS	GRAY						





LOBBY 98'-6" CURB 96'-4 41/128" 9 4

 $10 \frac{\text{WEST ELEVATION NEW HOUSE - SKP}}{3/32" = 1'-0"}$ 

DAYTON-MIFFLIN

LAND USE SUBMITTAL

MADISON : MILWAUKEE

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HOTEL

21-1006

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### PROGRESS DOCUMENTS

may be subject to change, including additional detail. These are not final construction documents and should not be used for final bidding or construction-related purposes.


DATE OF I	SSUANCE	AUGUST 15, 2022				
	REVISION SCHEDULE					
Mark	Description	Date				
		-				

SHEET TITLE

EXTERIOR ELEVATIONS

Sheet number



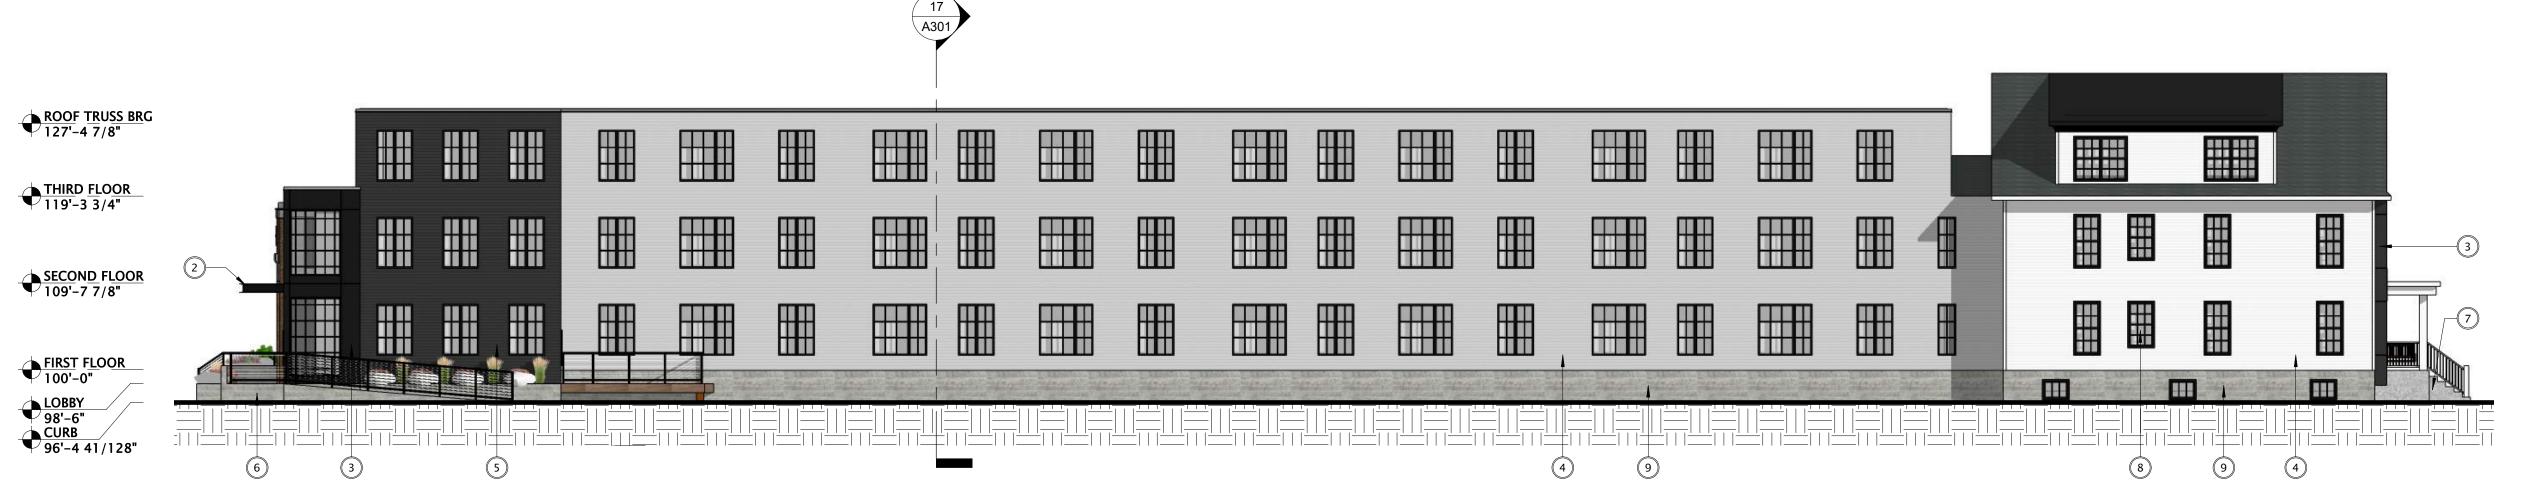





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DATE OF ISSUANCE AUGUST 05, 2022

REVISION SCHEDULE Mark

Description

Date

DAYTON ST RENDERING

Sheet Number





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DATE OF ISSUANCE AUGUST 05, 2022

Date


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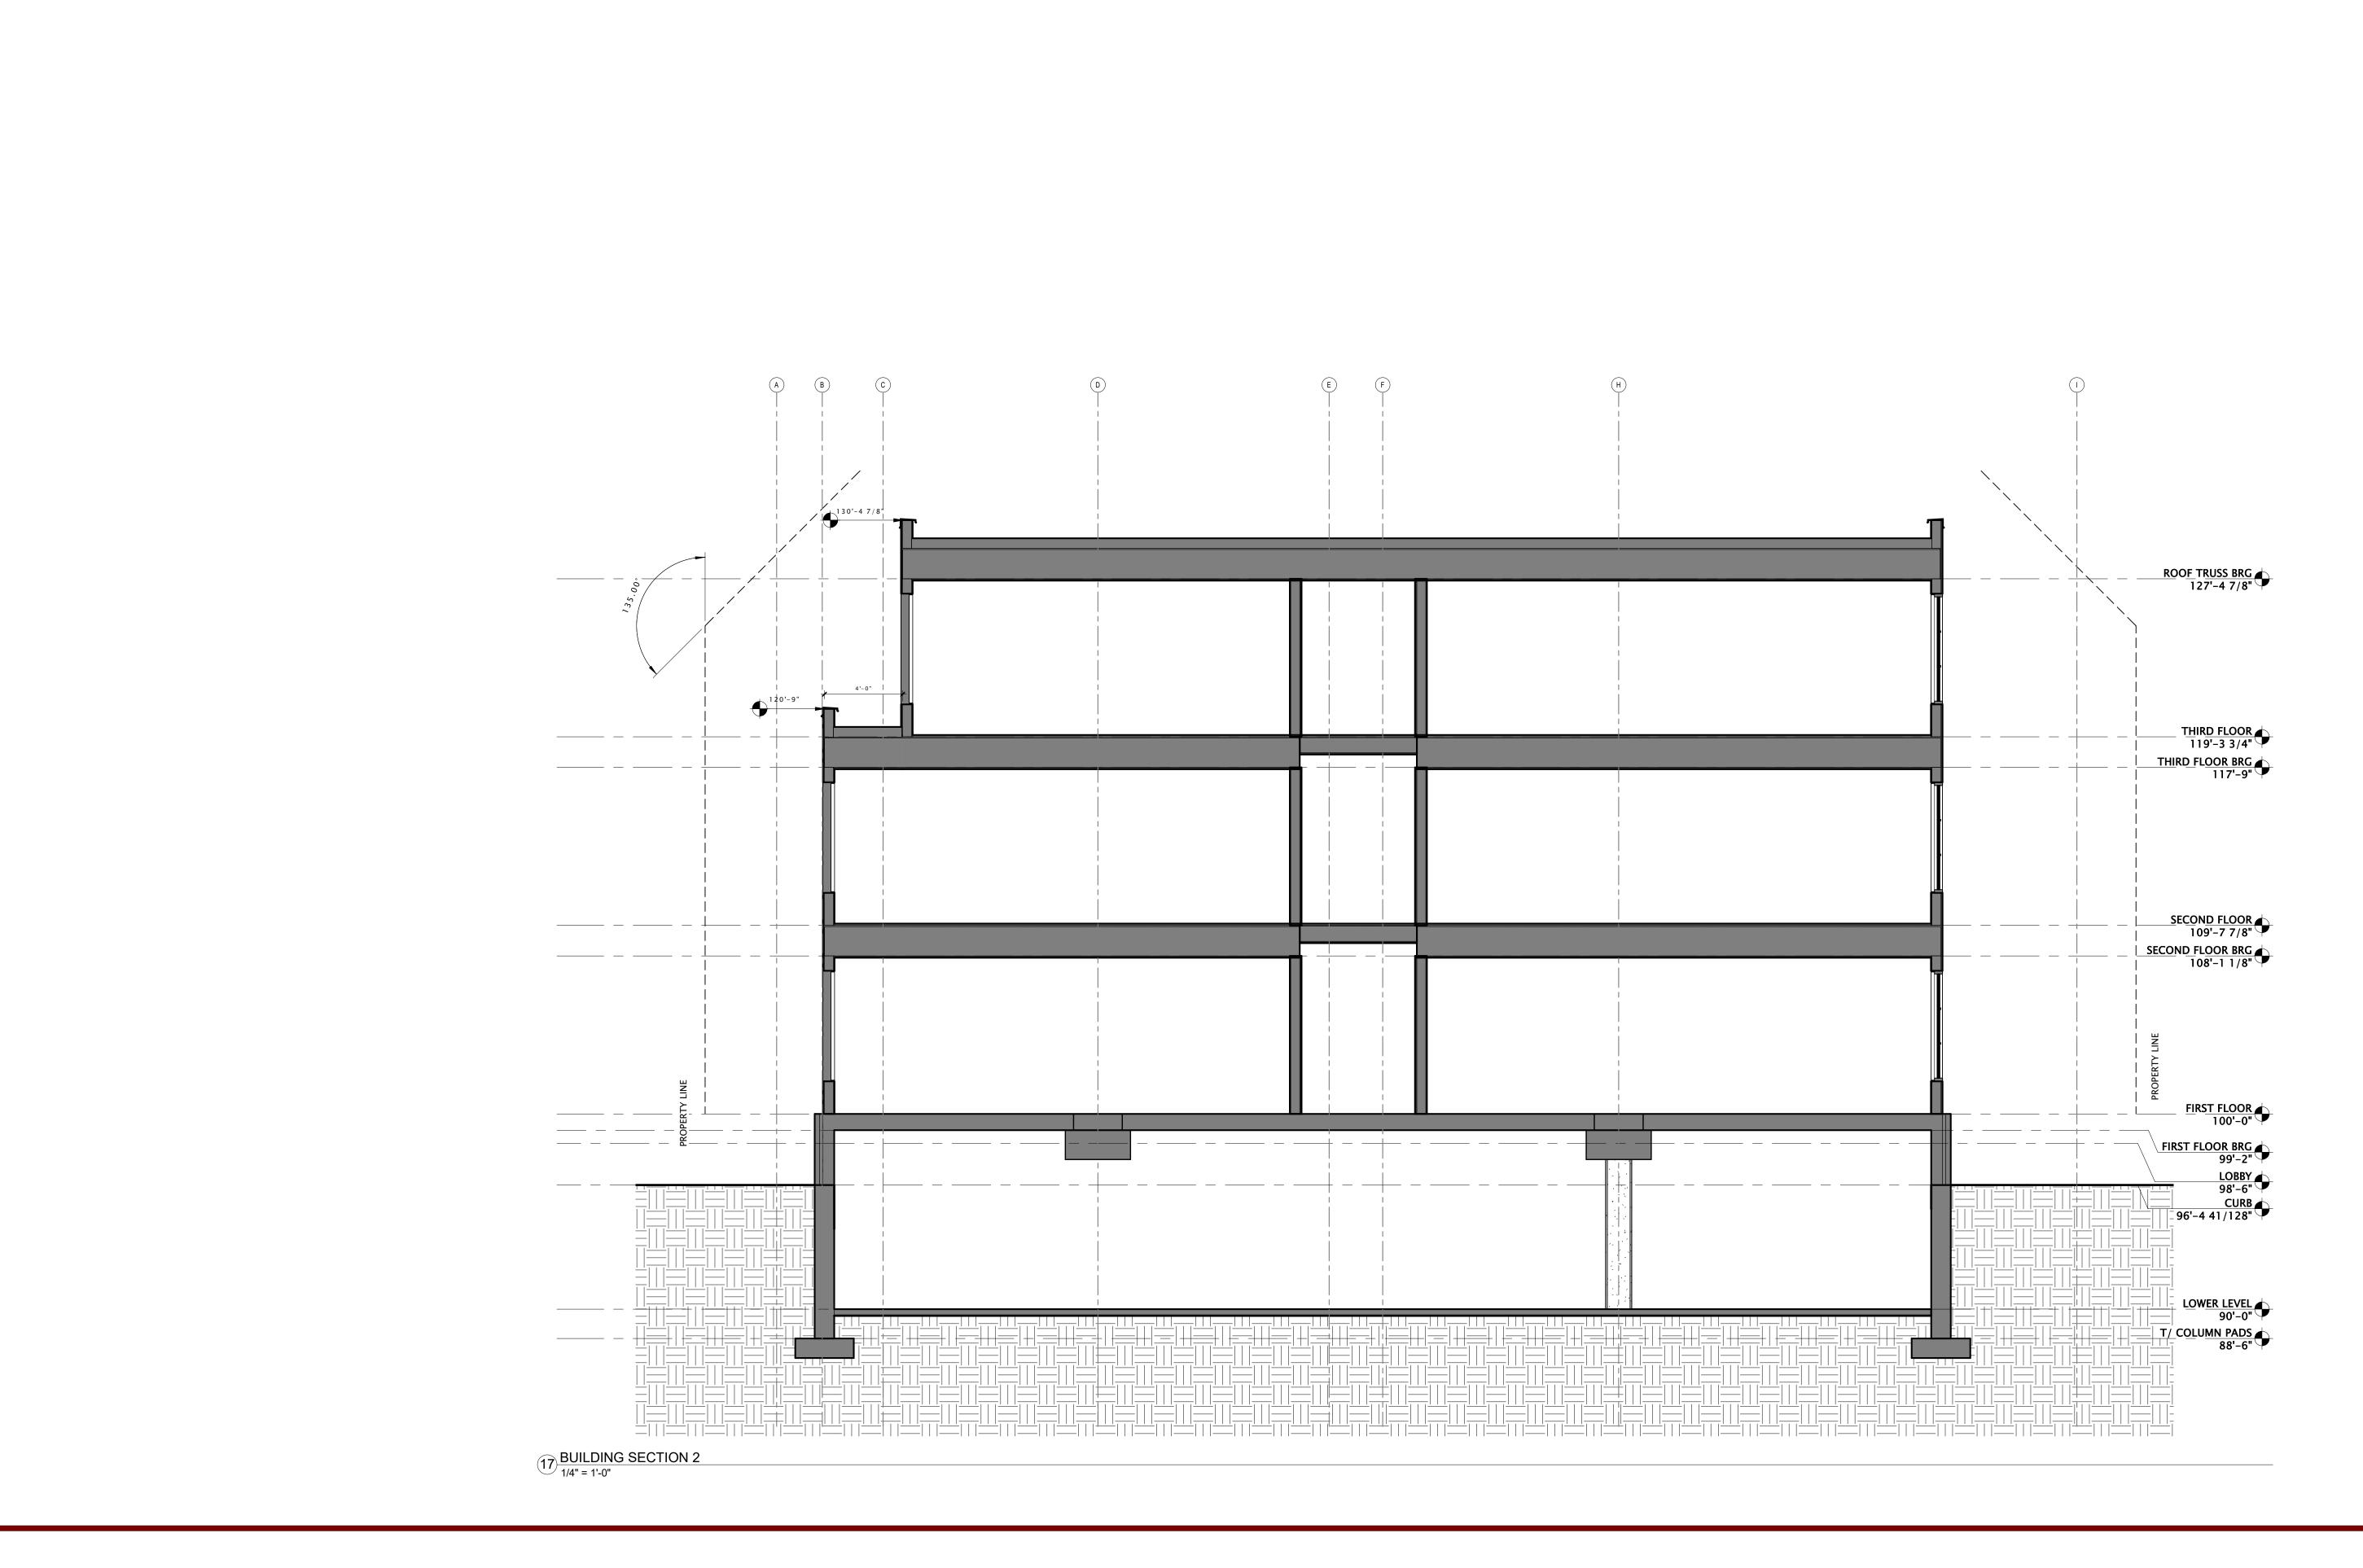
Description

Mark

MIFFLIN RENDERING

SHEET NUMBER



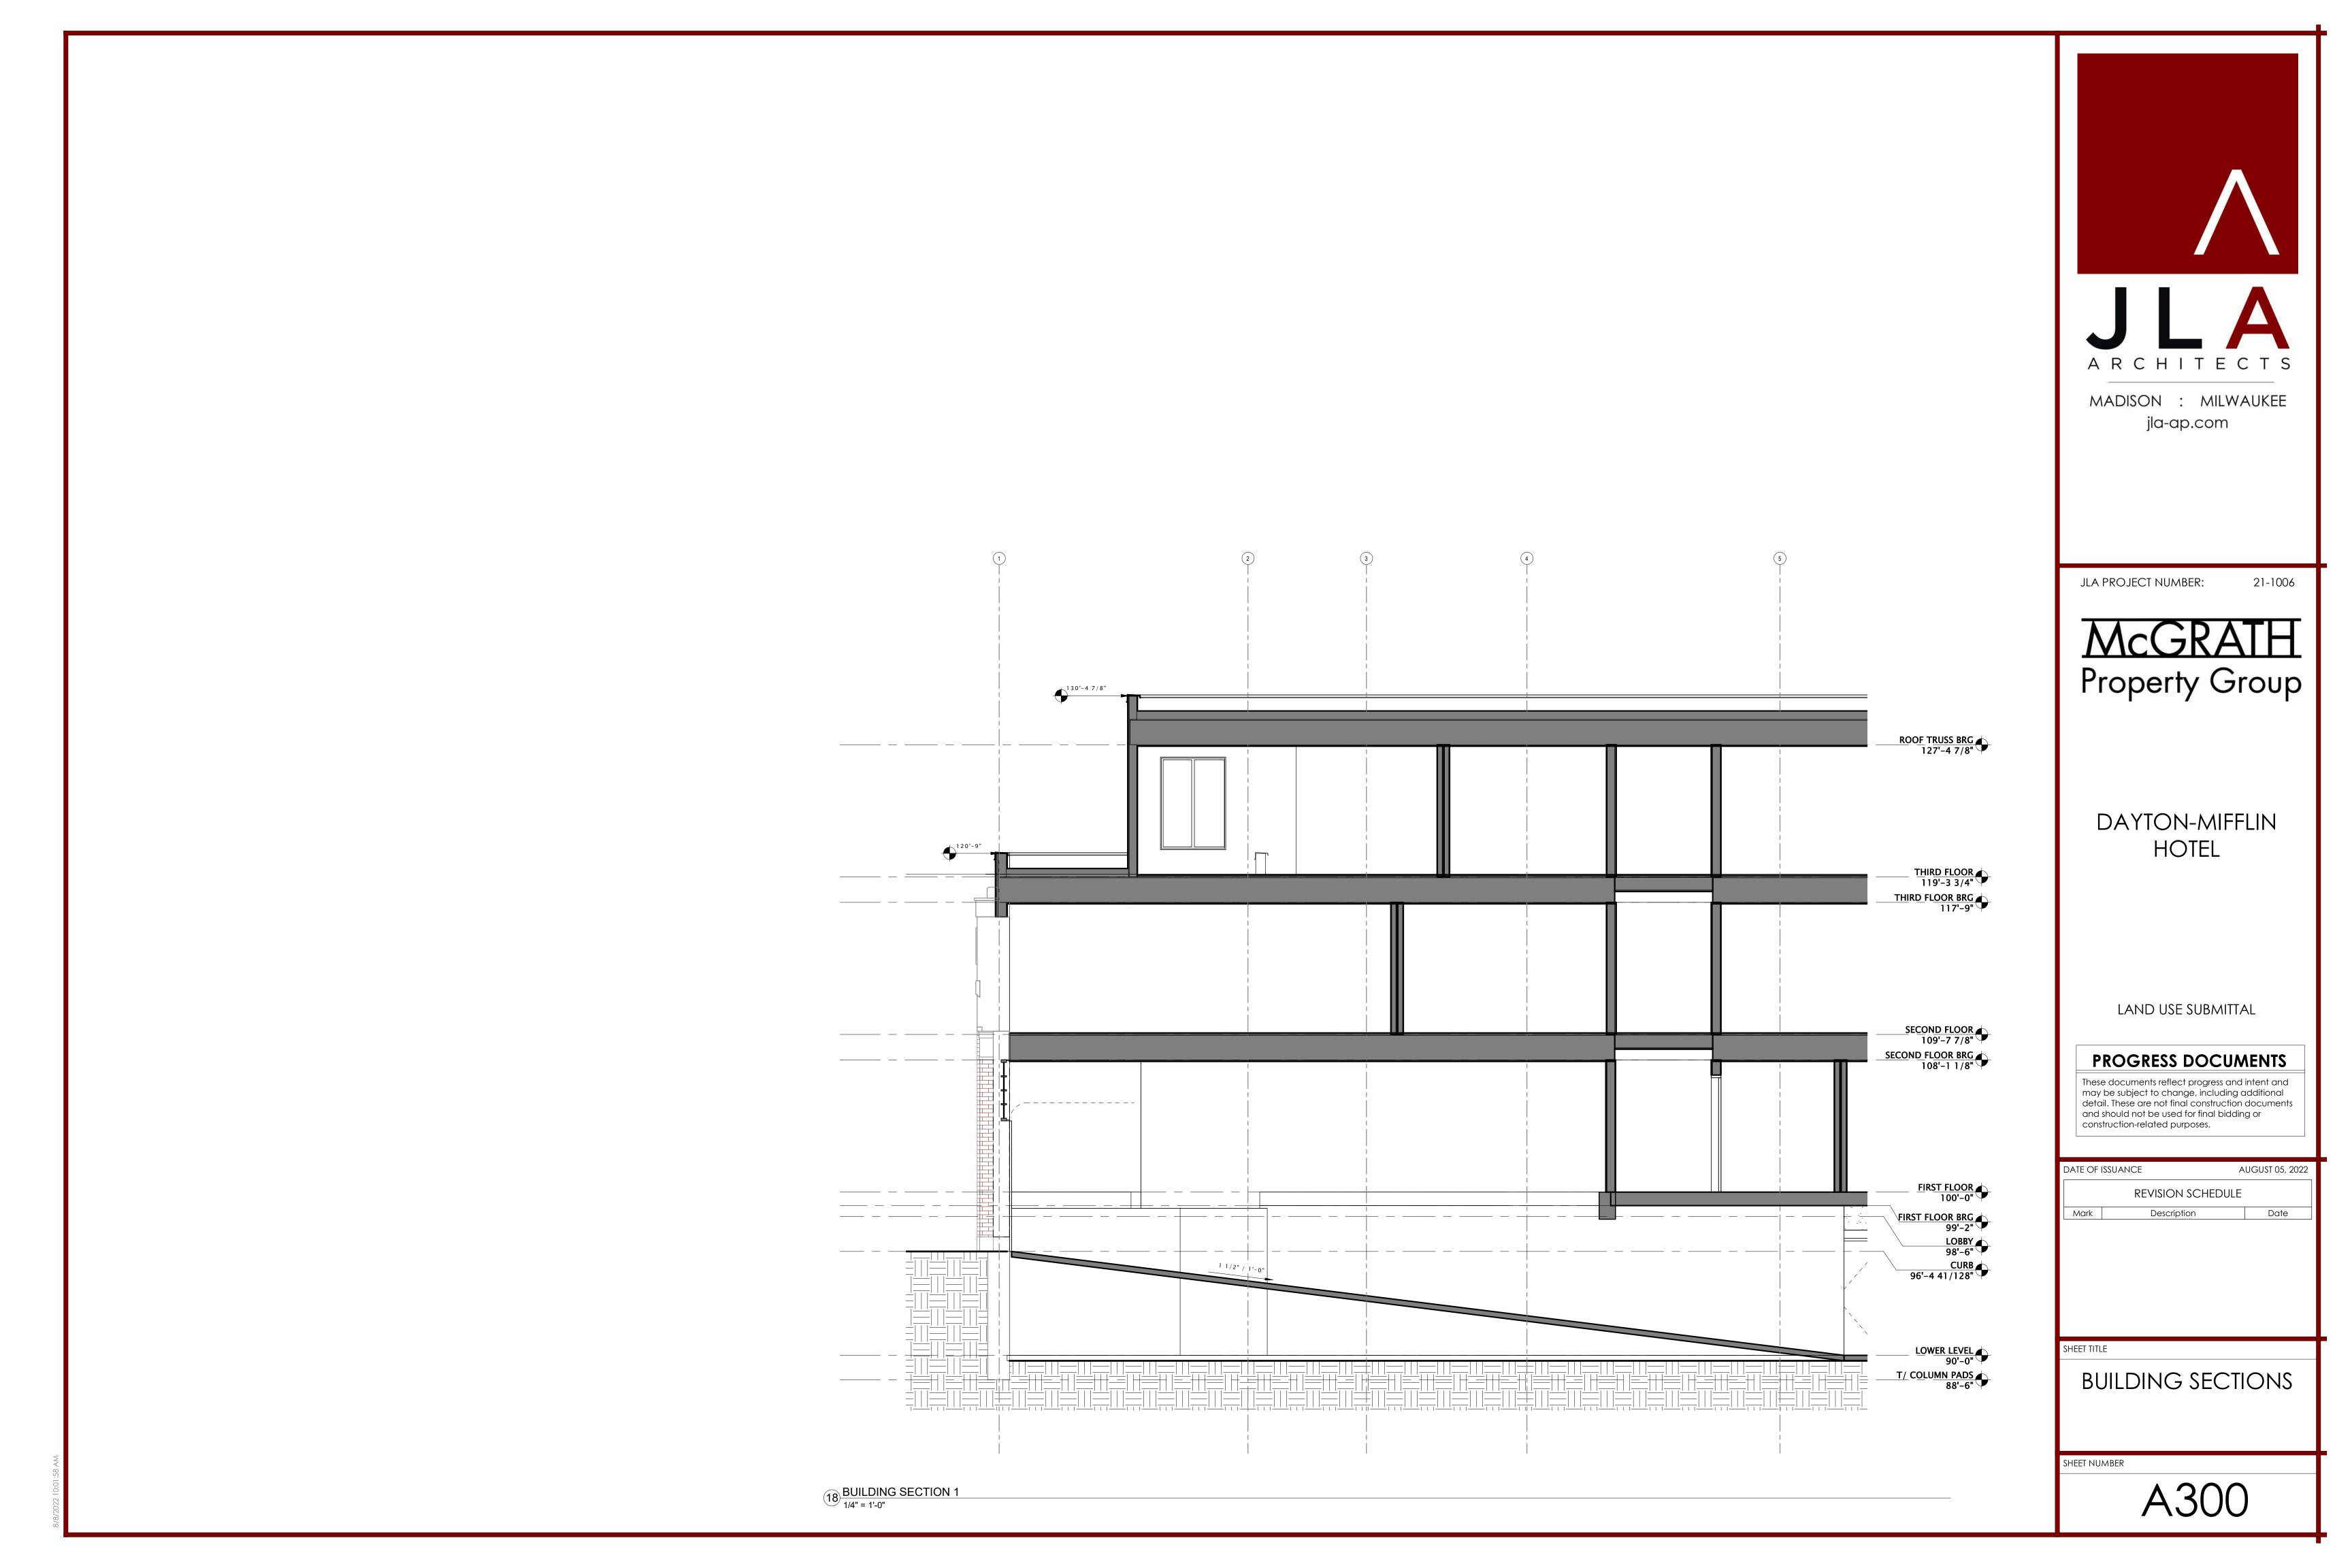



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DATE OF ISSUANCE AUGUST 05, 2022

REVISION SCHEDULE Mark

Description Date

SHEET TITLE

BUILDING SECTIONS

SHEET NUMBER



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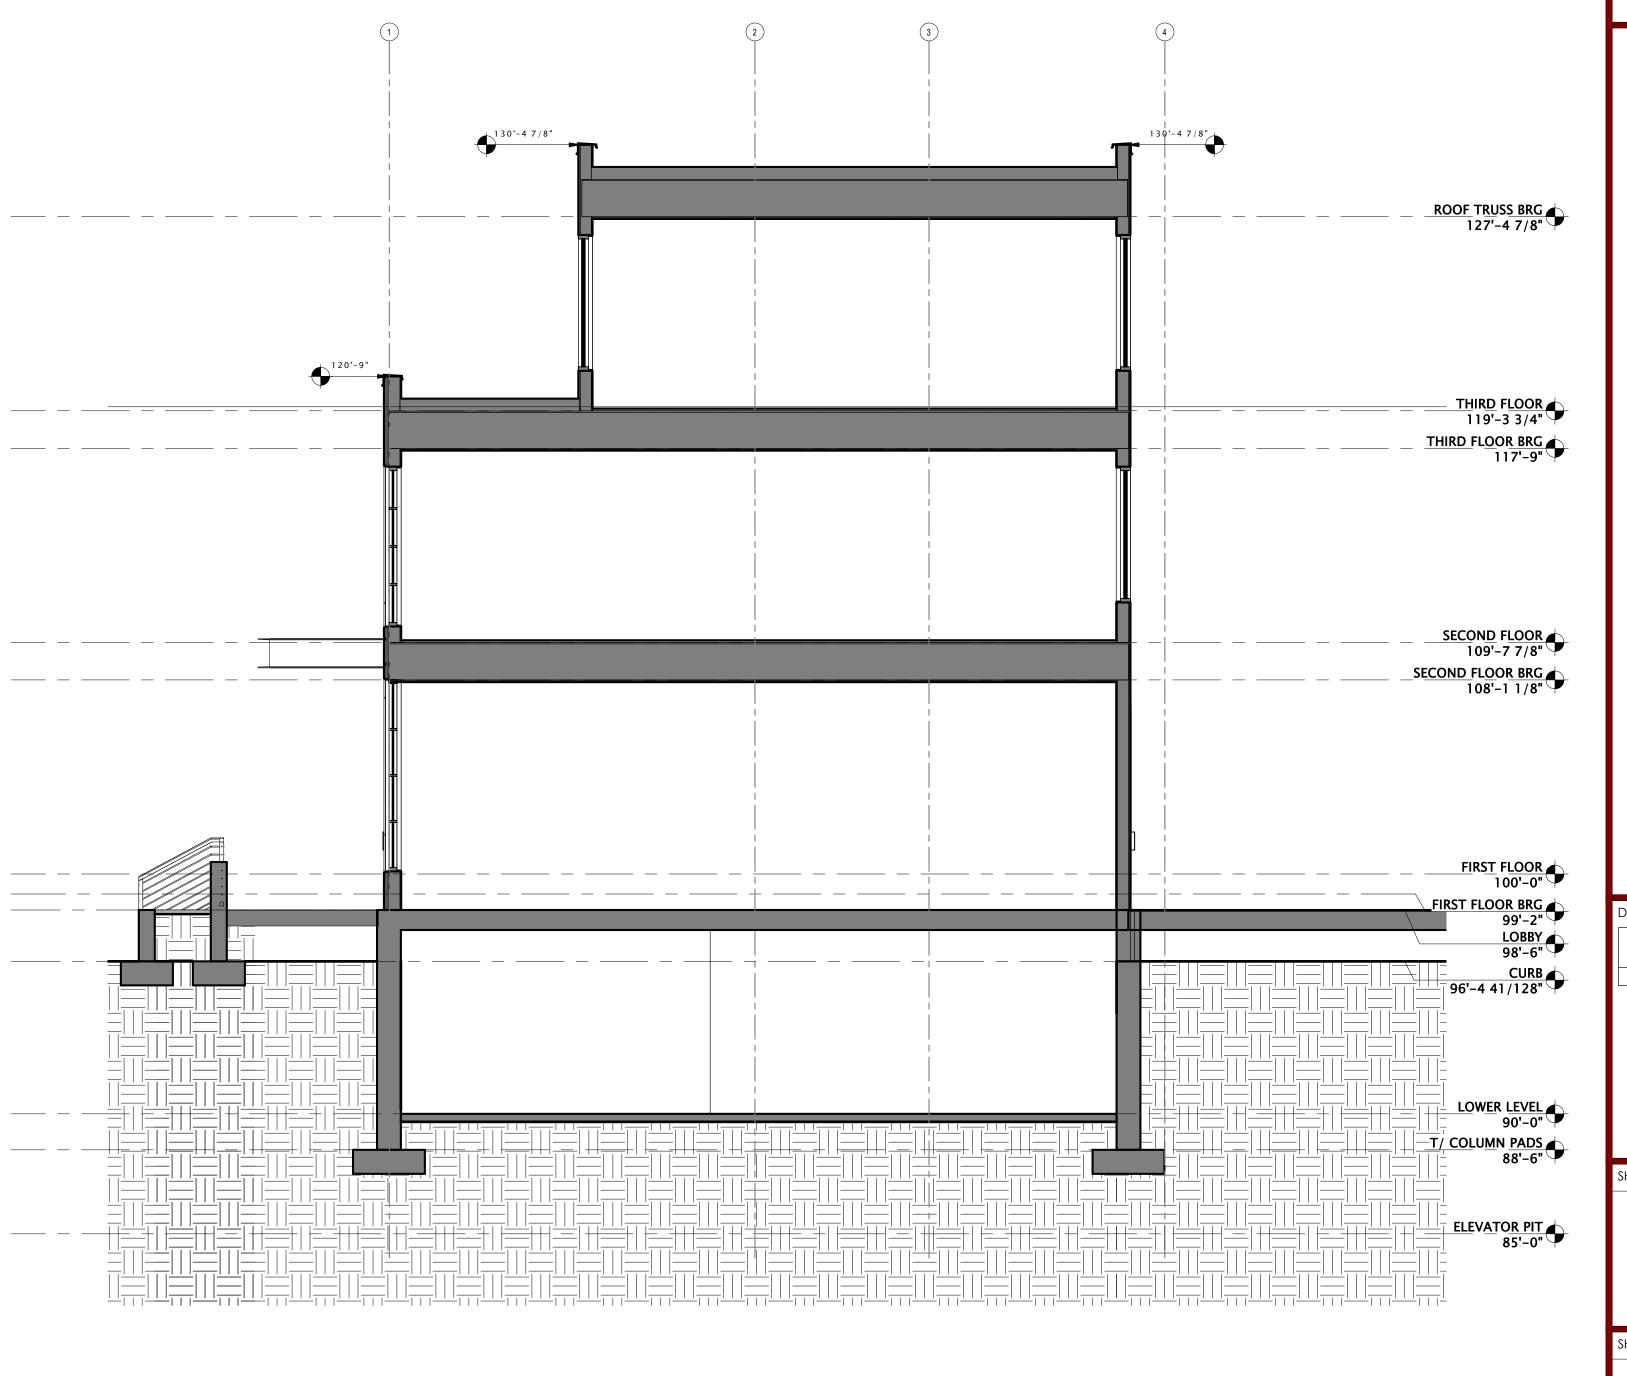
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SHEET TITLE

BUILDING SECTIONS


SHEET NUMBER

A302



18 BUILDING SECTION 3

# E. DAYTON STREET

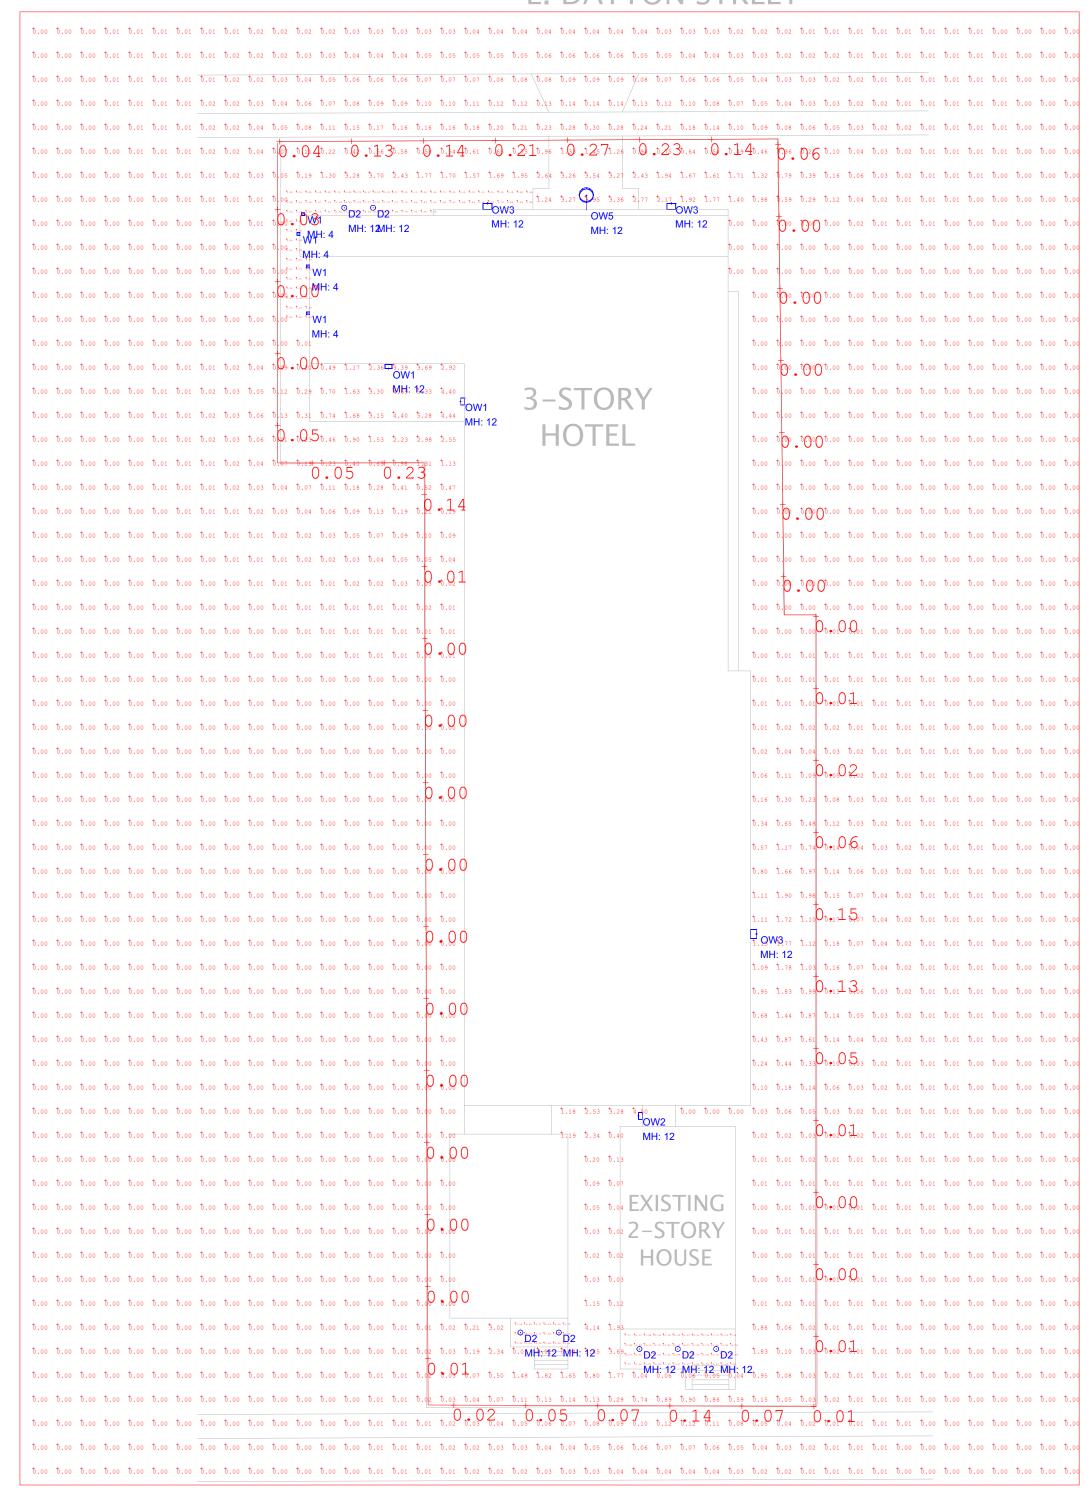

# E. MIFFLIN STREET

Luminaire	Schedule					
Qty Label MFG		MFG	Description	LLF	Lum. Watts	Total Watts
7	D2	LITHONIA	LDN4 xx/10 LO4AR LSS MVOLT (driver)	0.950	11	77
2	OW1	LITHONIA	WDGE1 LED P1 xxK 80CRI VW MVOLT (finish)	0.950	10	20
1	OW2	LITHONIA	WDGE1 LED P1 xxK 80CRI VF MVOLT (finish)	0.950	10	10
3	OW3	LITHONIA	WDGE2 LED P1 xxK 80CRI T1S MVOLT SRM (finish)	0.950	11.1658	33.4974
1	OW5	BASELITE	A812 (finish) B1 LED 12W xxK	0.950	12	12
4	W1	WAC	WL-LED300-C-BZ	0.950	3.8	15.2

Calculation Summary						
Label	Units	Avg	Max	Min	Max/Min	Avg/Min
Exisitng Porch_1_Top_1	Fc	12.55	15.88	7.33	2.17	1.71
Front Ramp & Steps_Top	Fc	4.32	18.28	0.00	N.A.	N.A.
New Porch_Top_1	Fc	14.14	15.84	12.99	1.22	1.09
Presumed Property Line @ 4'	Fc	0.05	0.27	0.00	N.A.	N.A.
Deck	Fc	2.99	5.3	0.5	10.60	5.98

