

RECENT ADMINISTRATION— **COURTYARD IMPROVEMENTS** PROPOSED PROJECT **AREA IMPROVEMENT** FOR ADMINISTRATION BUILDING **ADDITION & RENOVATION**

MADISON AREA | TECHNICAL COLLEGE



22-11690

DATE: 07/18/2022









ADMINISTRATION BUILDING & COURTYARD



POOL AND FITNESS BUILDING AREA COURTYARD



ADMINISTRATION BUILDING AREA



ADMINISTRATION BUILDING AREA





DATE: 07/18/2022

22-11690

MADISON COLLEGE ADMINISTRATION BUILDING ADDITION & RENOVATION

CITY OF MADISON, WISCONSIN

DRAWING INDEX

C100 DEMO PLAN
C200 SITE PLAN
C300 GRADING, EROSION CONTROL &
UTILITY PLAN
C400 DETAILS
L100 LANDSCAPE PLAN
L200 LANDSCAPE DETAILS
A101 FIRST FLOOR PLAN
A102 SECOND FLOOR PLAN
A103 ROOF PLAN
BUILDING ELEVATION (COLOR)
A201 BUILDING ELEVATION



PROJECT AREA

NOT TO SCALE



PROJECT INFORMATION

OWNER
CONTACT: FRED BRECHLIN
MADISON AREA TECH. COLLEGE
1701 WRIGHT ST. MADISON, WI, 53704
P: 608-246-6837
C: 608-576-1352
FBRECHLIN@MADISONCOLLEGE.EDU

CIVIL CONSULTANTJSD PROFESSIONAL SERVICES, INC.
CONTACT: JUSTIN FRAHM
7402 STONE RIDGE DR. SUITE 4
WESTON, WI 54476
P:715-298-6330
justin.frahm@jsd.com

ARCHITECT
ASSEMBLAGE ARCHITECTS
CONTACT: HAMID NOUGHANI
7433 ELMWOOD AVE,
MIDDLETON, WI, 53562
P:608-827-5047
C:608-332-3148
noughani@assemblagearchitects.com

MEP CONSULTANT
HENNEMAN ENGINEERING. INC
CONTACT: MITCHELL SETTERMAN
20855 WATERTOWN ROAD, SUIT 170
P:262-901-0626
MSETTERMAN@HENNEMAN.COM

MUNICIPAL CONTACTS


CITY OF MADISON DEPARTMENT OF PUBLIC WORKS/ENGINEER
CONTACT: BRENDA STANLEY
210 MLK BLVD., ROOM 115
MADISON, WI, 53703
P:608-261-9127
BSTANLEY@CITYOFMADISON.COM



MADISON COLLEGE
ADMINISTRATION BUILDING
ADDITION AND RENOVATION
Madison, Wisconsin



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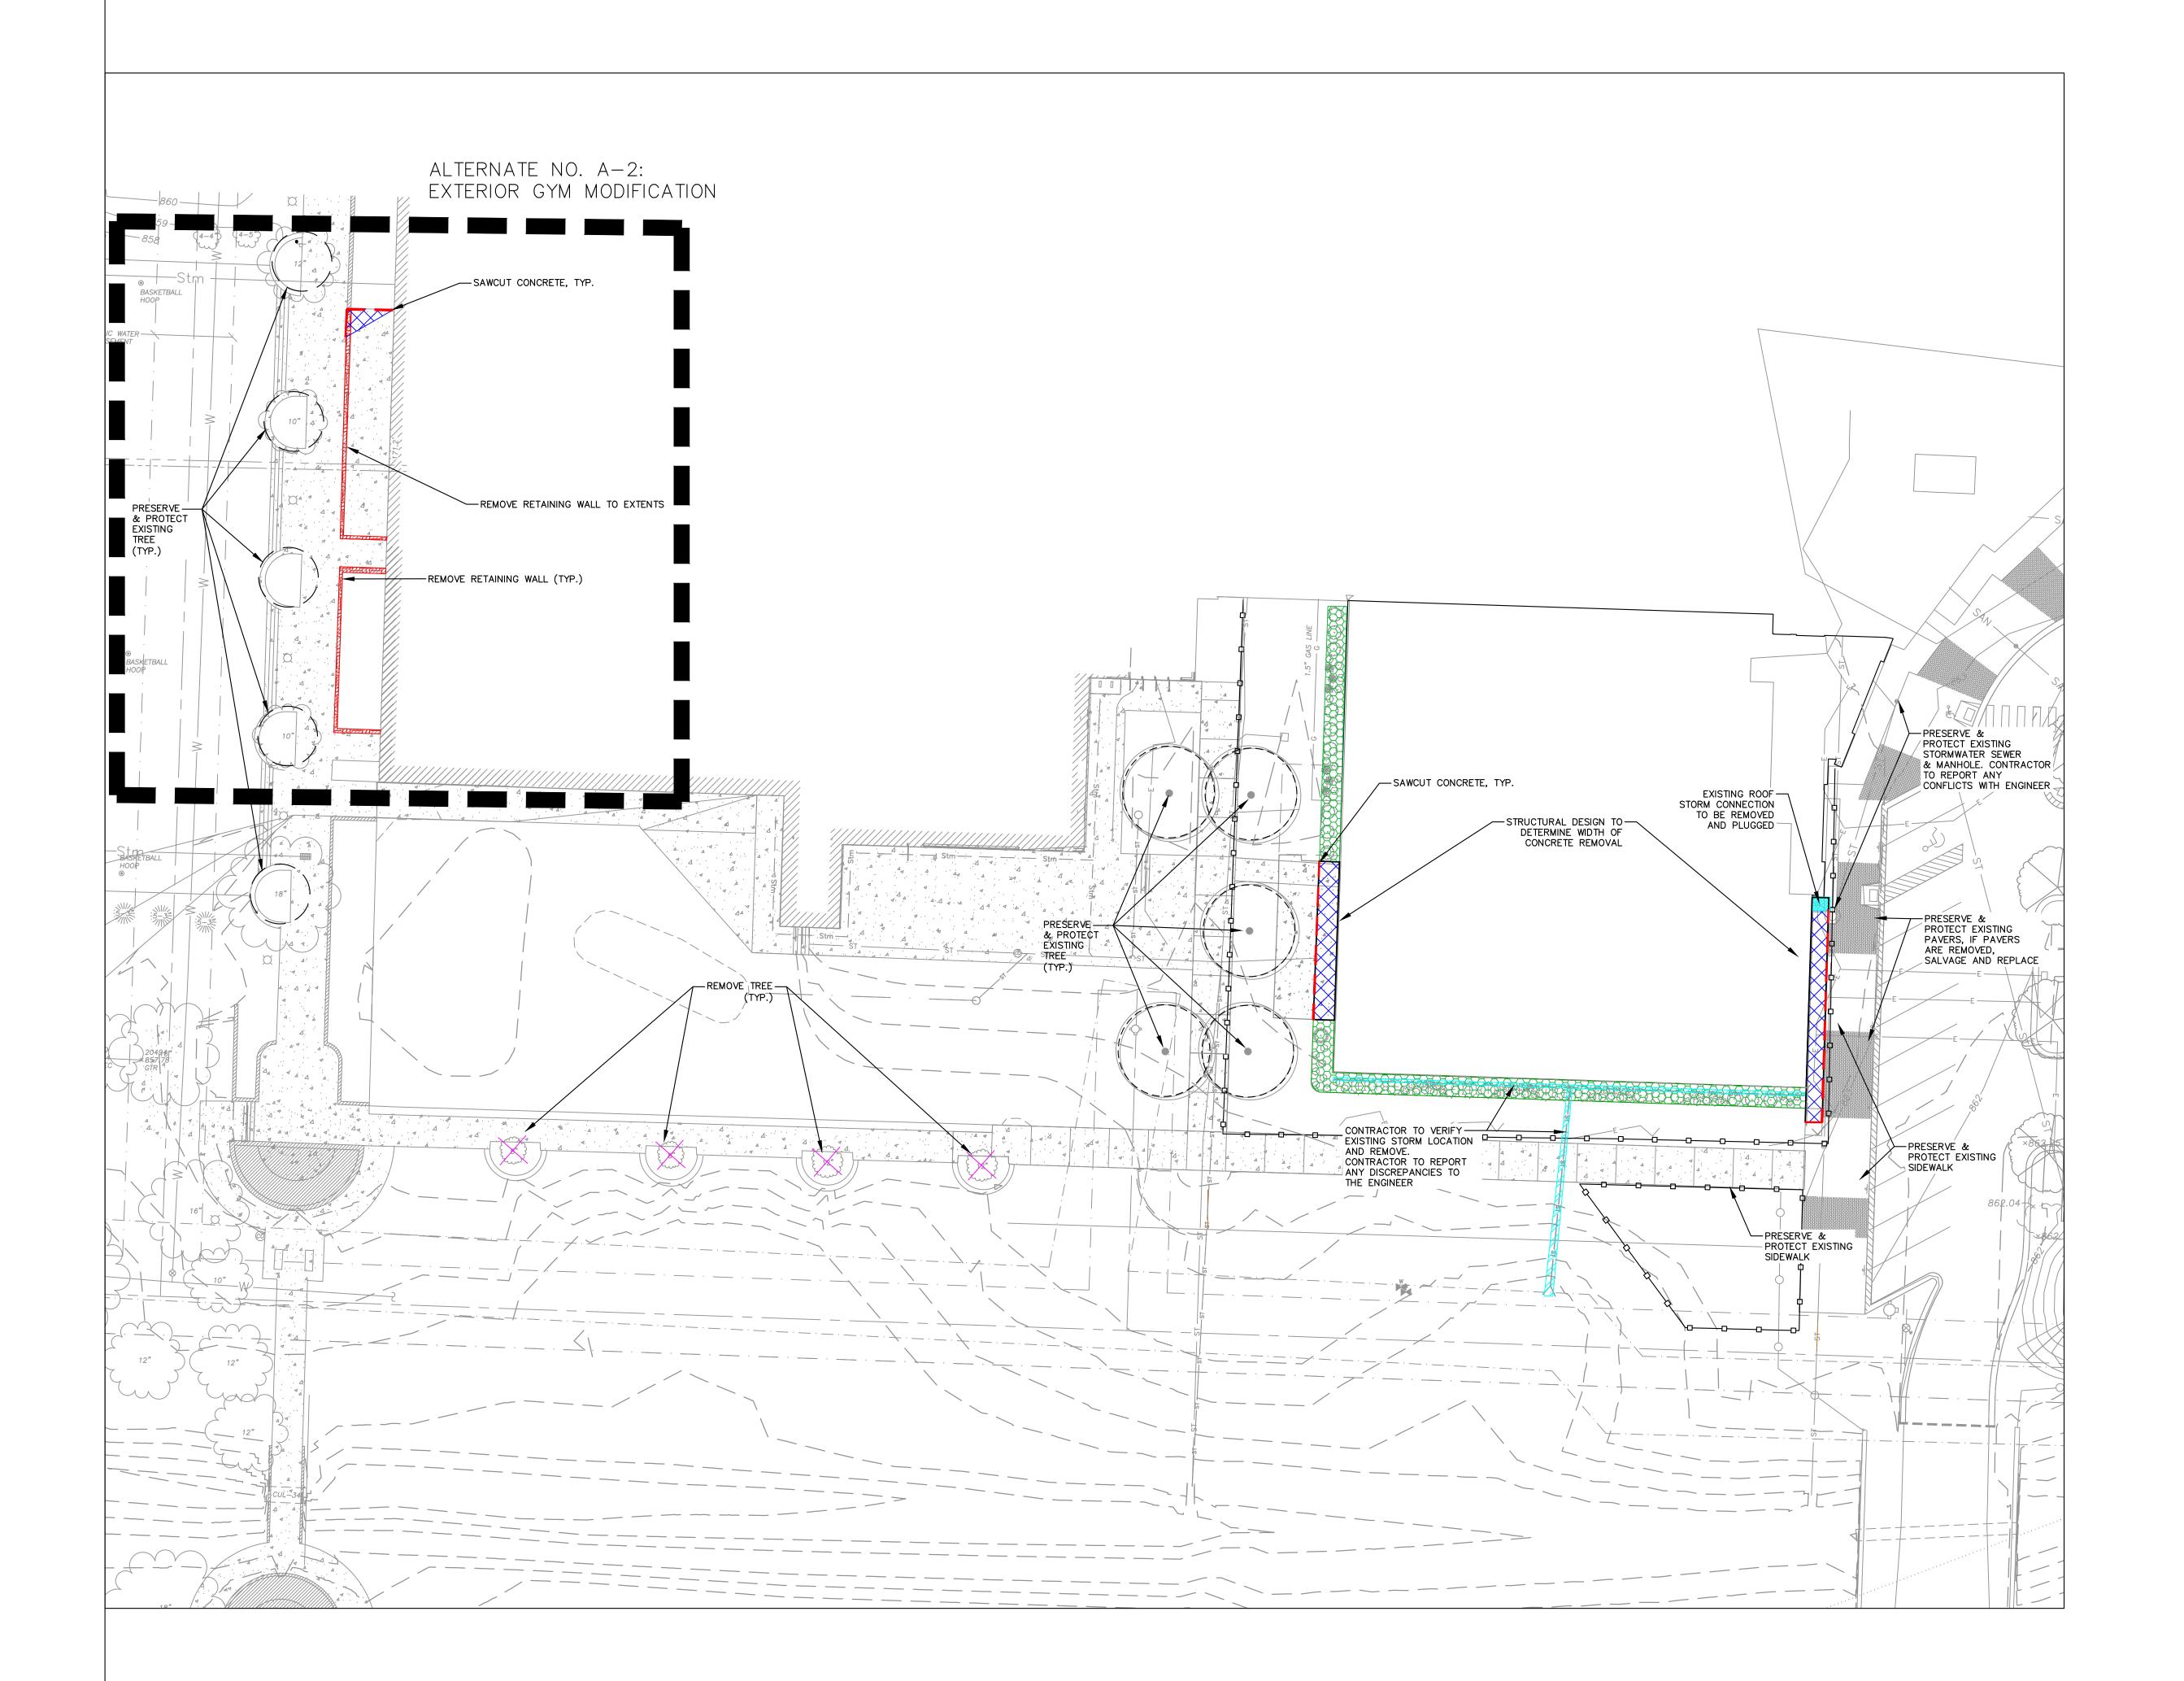
assemblage ARCHITECTS 7433 Elmwood Avenue Middleton, WI 53562 T 608.827.5047

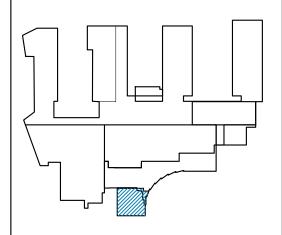SCALE

SHEET TITLE
TITLE SHEET

SHEET NUMBER

C000



DEMOLITION NOTES

- 1. THIS PLAN INDICATES ITEMS ON THE PROPERTY INTENDED FOR DEMOLITION BASED ON THE CURRENT SITE DESIGN THAT HAVE BEEN IDENTIFIED BY A REASONABLE OBSERVATION OF THE EXISTING CONDITIONS THROUGH FIELD SURVEY RECONNAISSANCE, "DIGGER'S HOTLINE" LOCATION, AND GENERAL "STANDARD OF CARE". THERE MAY BE ADDITIONAL ITEMS THAT CAN NOT BE IDENTIFIED BY A REASONABLE ABOVE GROUND OBSERVATION, OF WHICH THE ENGINEER WOULD HAVE NO KNOWLEDGE OR MAY BE A PART OF ANOTHER DESIGN DISCIPLINE. IT IS THE CONTRACTOR'S/BIDDER'S RESPONSIBILITY TO REVIEW THE PLANS, INSPECT THE SITE AND PROVIDE THEIR OWN DUE DILIGENCE TO INCLUDE IN THEIR BID WHAT ADDITIONAL ITEMS, IN THEIR OPINION, MAY BE NECESSARY FOR DEMOLITION. ANY ADDITIONAL ITEMS IDENTIFIED BY THE CONTRACTOR/BIDDER SHALL BE IDENTIFIED IN THE BID AND REPORTED TO THE ENGINEER OF RECORD. JSD TAKES NO RESPONSIBILITY FOR ITEMS ON THE PROPERTY THAT COULD NOT BE LOCATED BY A REASONABLE OBSERVATION OF THE PROPERTY OR OF WHICH THEY WOULD HAVE NO KNOWLEDGE.
- 2. CONTRACTOR SHALL KEEP ALL STREETS AND PRIVATE DRIVES FREE AND CLEAR OF ALL CONSTRUCTION RELATED DIRT, DUST AND DEBRIS.
- 3. ALL TREES TO BE REMOVED SHALL BE REMOVED IN THEIR ENTIRETY AND STUMPS SHALL BE GROUND TO PROPOSED SUBGRADE.
- 4. ABANDONED/REMOVED ITEMS SHALL BE DISPOSED OF OFF SITE UNLESS OTHERWISE NOTED.
- 5. CONTRACTOR TO REPLACE ALL SIDEWALK AND CURB AND GUTTER ABUTTING THE PROPERTIES, WHICH IS DAMAGED BY THE CONSTRUCTION, OR ANY SIDEWALK AND CURB AND GUTTER THAT THE CITY ENGINEER DETERMINES NEEDS TO BE REPLACED BECAUSE IT IS NOT AT A DESIRABLE GRADE REGARDLESS OF WHETHER THE CONDITION EXISTED PRIOR TO BEGINNING CONSTRUCTION.

6. PRIOR TO CONSTRUCTION, THE CONTRACTOR IS RESPONSIBLE FOR:

- 6.1. EXAMINE ALL SITE CONDITIONS RELATIVE TO THE CONDITIONS INDICATED ON THE ENGINEERING DRAWINGS. ANY DISCREPANCIES ARE TO BE REPORTED IMMEDIATELY TO THE ENGINEER AND RESOLVED PRIOR TO THE START OF CONSTRUCTION.
- 6.2. VERIFYING UTILITY ELEVATIONS AND NOTIFYING ENGINEER OF ANY DISCREPANCIES. NO WORK SHALL BE PERFORMED UNTIL THE DISCREPANCIES ARE RESOLVED.
- 6.3. NOTIFYING ALL UTILITIES PRIOR TO THE REMOVAL OF ANY UNDERGROUND UTILITIES.6.4. NOTIFYING THE DESIGN ENGINEER AND LOCAL CONTROLLING MUNICIPALITY 48 HOURS PRIOR TO

OR OTHER UTILITIES, WHICH ARE DAMAGED BY THE CONTRACTORS, SHALL BE REPAIRED TO THE

- THE START OF CONSTRUCTION TO ARRANGE FOR APPROPRIATE CONSTRUCTION INSPECTION.

 7. ANY SANITARY SEWER, SANITARY SEWER SERVICES, WATER MAIN, WATER SERVICES, STORM SEWER,
- OWNER'S SATISFACTION AT THE CONTRACTOR'S EXPENSE.

 8. CONTRACTOR IS RESPONSIBLE FOR SITE SAFETY DURING THE CONSTRUCTION OF THESE
- 9. CONTRACTOR TO COORDINATE PRIVATE UTILITY REMOVAL / ABANDONMENT AND NECESSARY RELOCATION WITH RESPECTIVE UTILITY COMPANY. COORDINATION REQUIRED PRIOR TO CONSTRUCTION.
- 10. ALL DEMOLITION SHALL BE IN ACCORDANCE WITH THE APPROVED MUNICIPALITY RECYCLING PLAN.

 11. ANY CONTAMINATED SOILS SHALL BE REMOVED IN ACCORDANCE WITH FEDERAL AND STATE
- REGULATIONS TO AN APPROVED LANDFILL.

 12. ALL EXISTING UTILITIES TO BE FIELD LOCATED AND FLAGGED BY CONTRACTOR.

LEGEND

PROPERTY LINE
RIGHT-OF-WAY
EASEMENT LINE

DEMOLITION - REMOVAL OF RETAINING WALL

TREE REMOVAL

DEMOLITION - REMOVAL OF CONCRETE SURFACES

PROTECT EXISTING TREE

DEMOLITION - REMOVAL OF UTILITIES

DEMOLITION - PRESERVE AND PROTECT LANDSCAPE BEDDING

- 13. EXISTING FIBER OPTIC LINE TO BE CLEARLY MARKED PRIOR TO ANY EXCAVATION. CONTRACTOR TO NOTIFY ENGINEER IMMEDIATELY IF ANY DISCREPANCIES OCCUR IN THE LOCATION SHOWN OR PROPOSED IMPROVEMENTS IMPACTING EXISTING FIBER OPTIC LINE LOCATION.
- 14. ALL PERIMETER EROSION CONTROL DEVICES SHALL BE INSTALLED PRIOR TO THE START OF DEMOLITION ACTIVITIES. CONTRACTOR SHALL KEEP ALL STREETS AND PAVEMENT FREE AND CLEAR OF ALL CONSTRUCTION RELATED DIRT, DUST AND DEBRIS.




MADISON COLLEGE
ADMINISTRATION BUILDING
ADDITION AND RENOVATION
Madison, Wisconsin



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MC Project No.:	RFB22-006
Bid Pkg No.:	-

EVISION	DATE

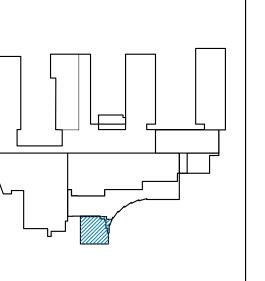

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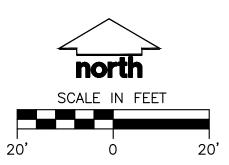
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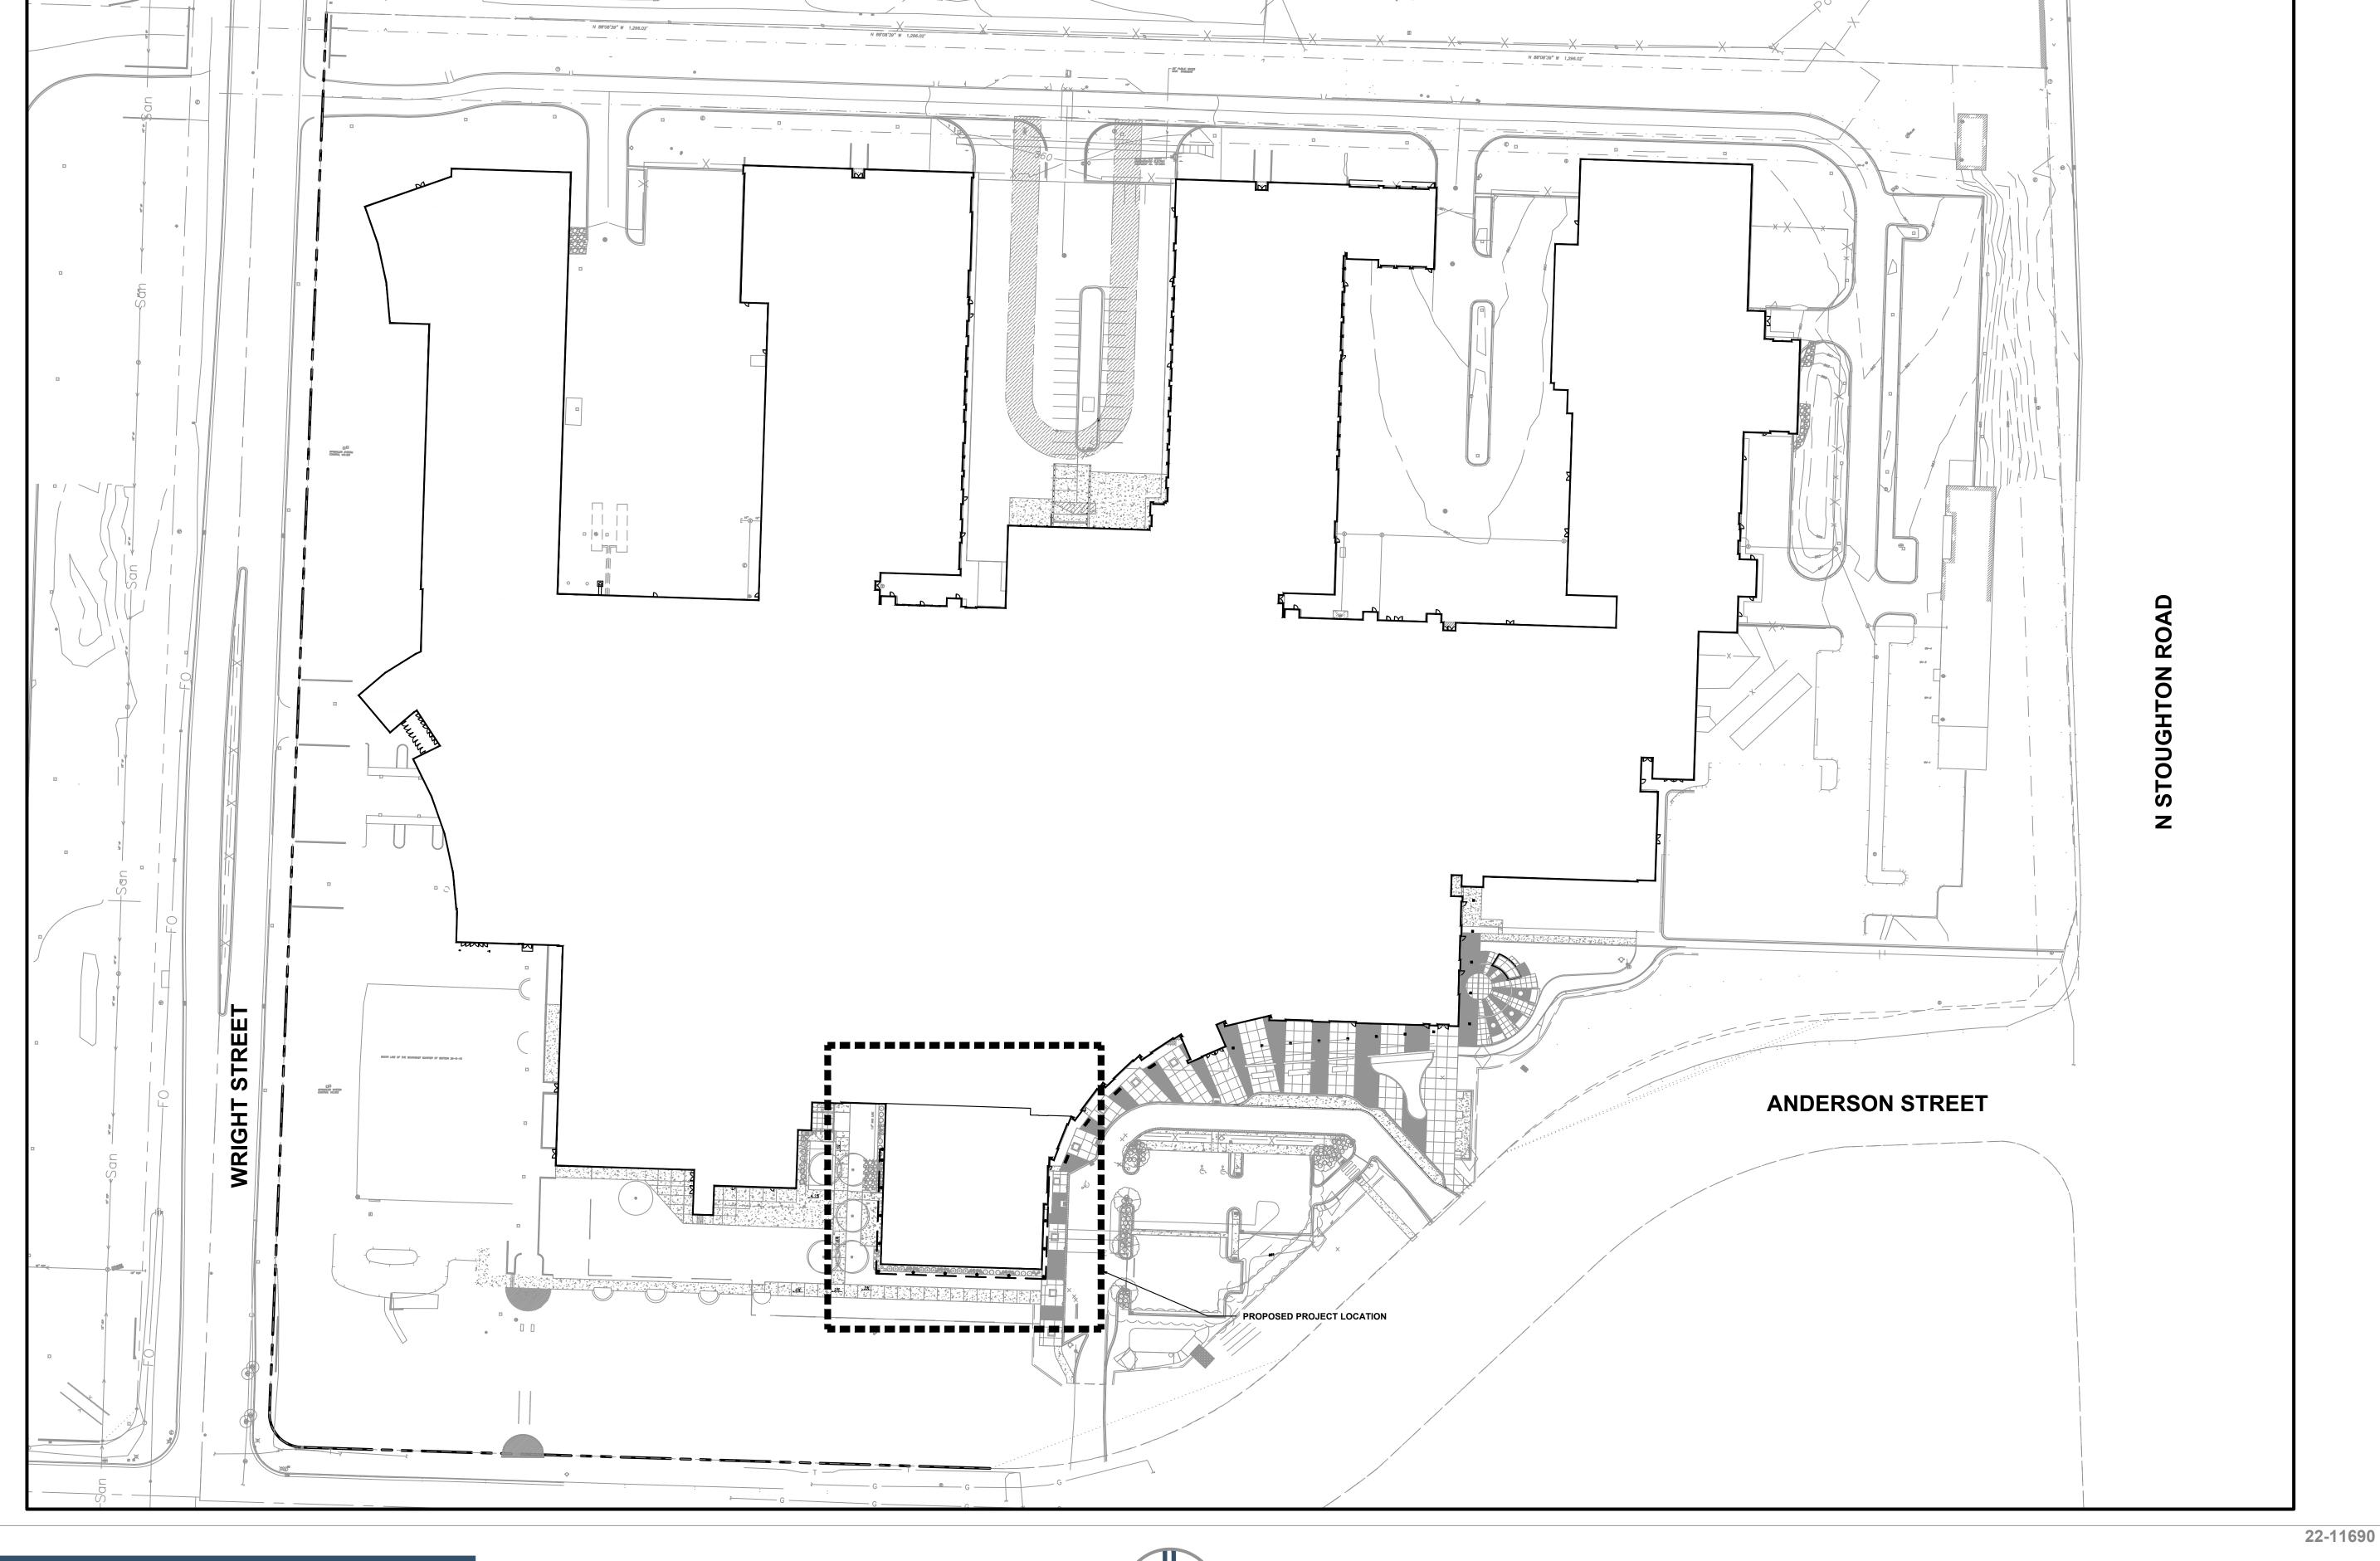
AS NOTED

SHEET TITLE


DEMO PLAN

DIGGERS HOTLINE
Toll Free (800) 242-8511






MC-Adimn. Building Addition & Renovation Overall Site Plan Madison, WI **DATE: 07.20.2022**

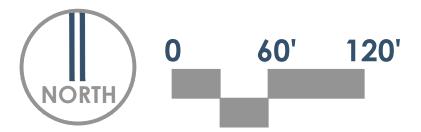



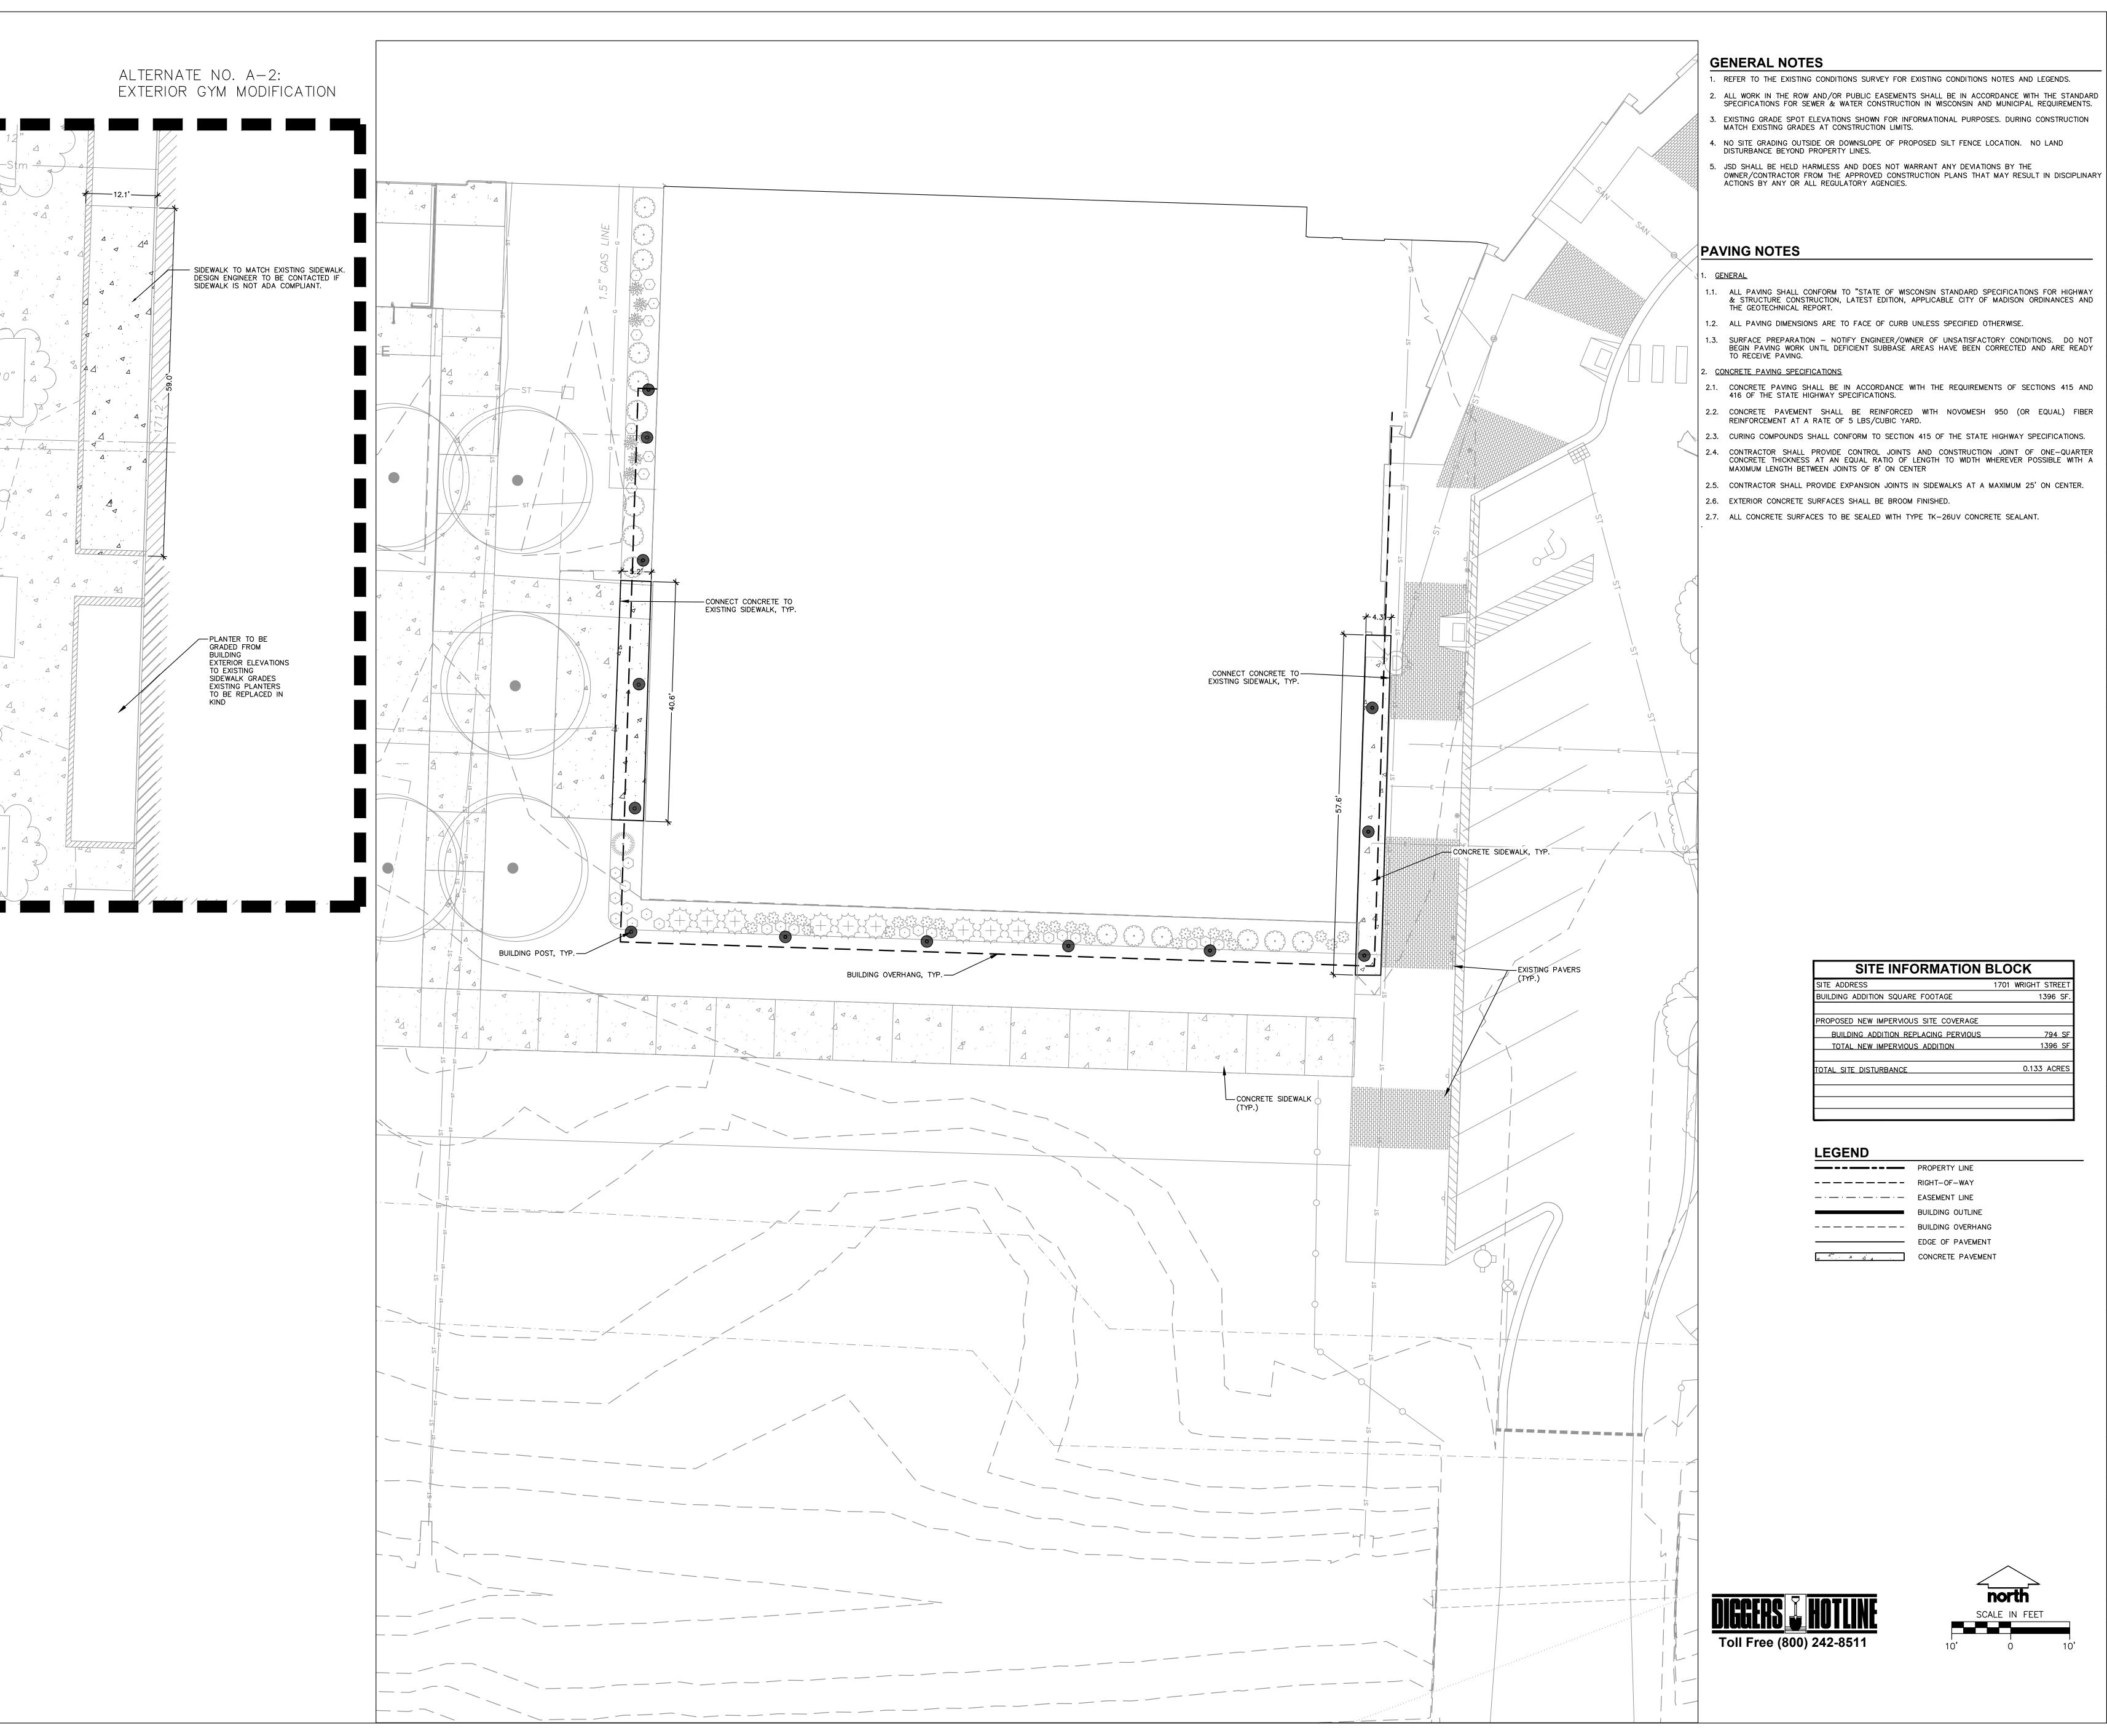

- . REFER TO THE EXISTING CONDITIONS SURVEY FOR EXISTING CONDITIONS NOTES AND LEGENDS.
- 2. ALL WORK IN THE ROW AND/OR PUBLIC EASEMENTS SHALL BE IN ACCORDANCE WITH THE STANDARD SPECIFICATIONS FOR SEWER & WATER CONSTRUCTION IN WISCONSIN AND MUNICIPAL REQUIREMENTS.
- 3. EXISTING GRADE SPOT ELEVATIONS SHOWN FOR INFORMATIONAL PURPOSES. DURING CONSTRUCTION MATCH EXISTING GRADES AT CONSTRUCTION LIMITS.
- 4. NO SITE GRADING OUTSIDE OR DOWNSLOPE OF PROPOSED SILT FENCE LOCATION. NO LAND DISTURBANCE BEYOND PROPERTY LINES.
- 5. JSD SHALL BE HELD HARMLESS AND DOES NOT WARRANT ANY DEVIATIONS BY THE

MADISON COLLEGE ADMINISTRATION BUILDING ADDITION AND RENOVATION

Madison, Wisconsin

JSD

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REVISION

0.133 ACRES

EDGE OF PAVEMENT


CONCRETE PAVEMENT

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T 608.827.5047

AS NOTED

SHEET TITLE SITE PLAN

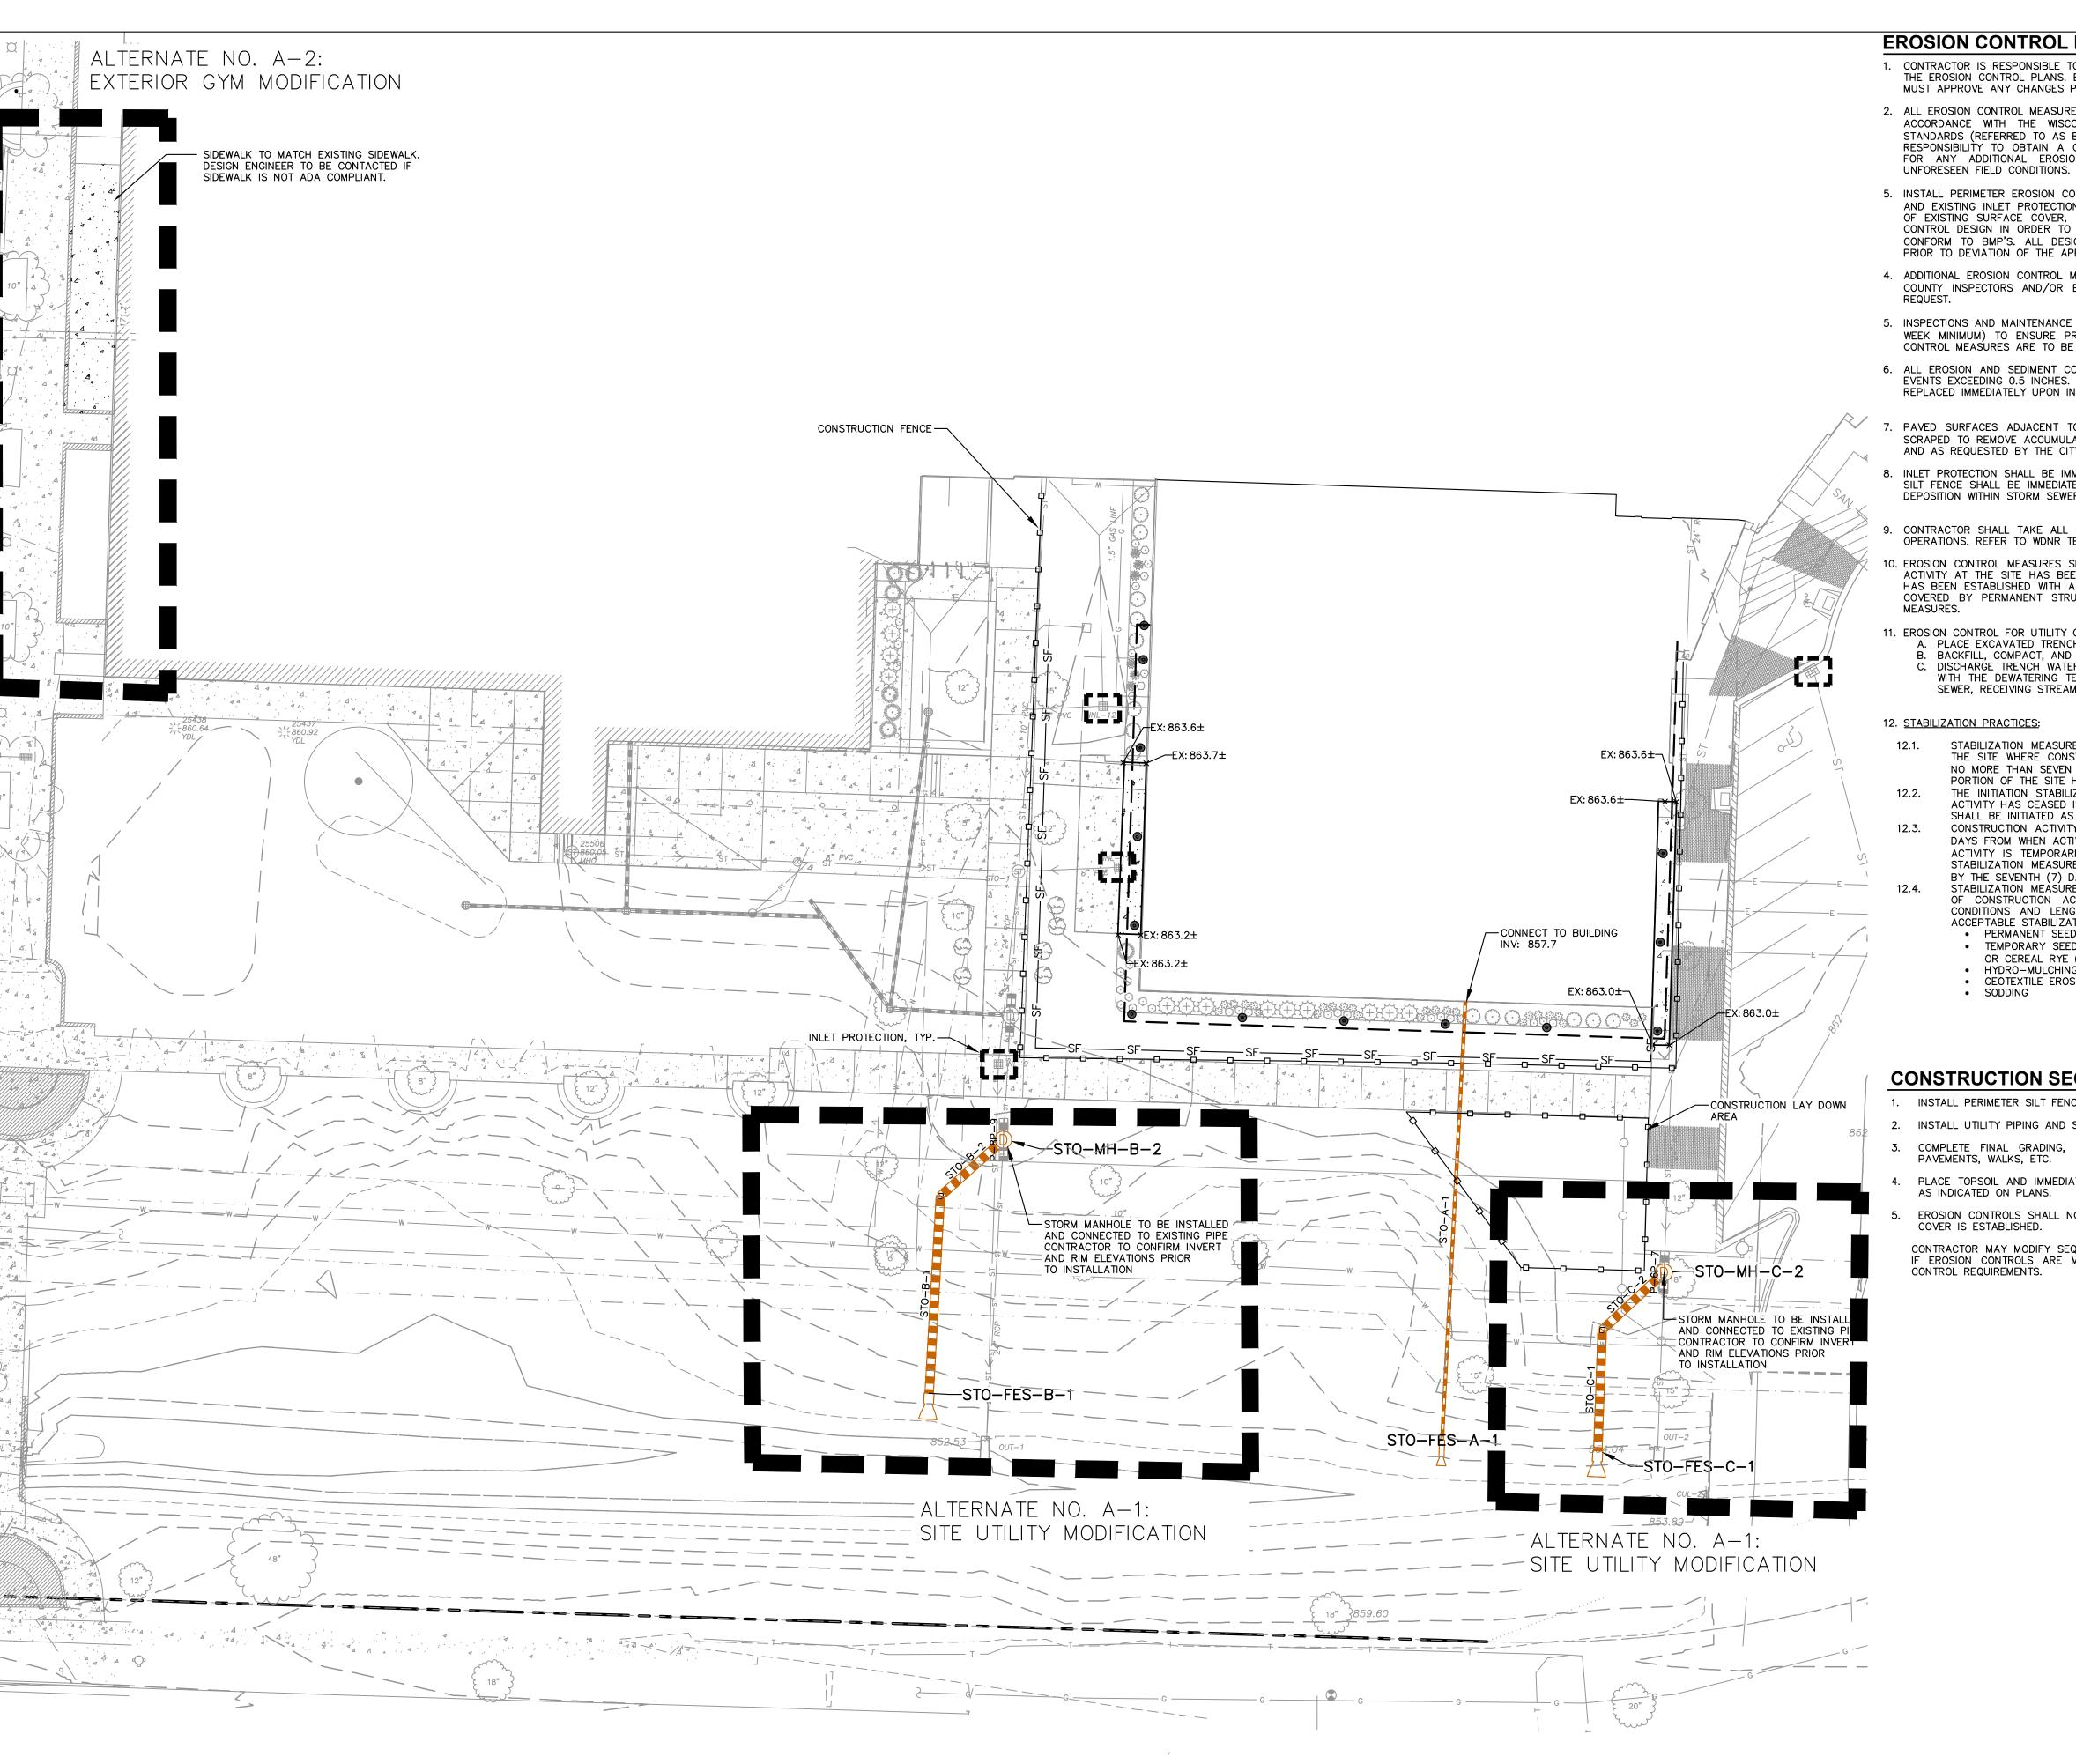

EROSION CONTROL NOTES

1. CONTRACTOR IS RESPONSIBLE TO NOTIFY ENGINEER OF RECORD AND OFFICIALS OF ANY CHANGES TO THE EROSION CONTROL PLANS. ENGINEER OF RECORD AND APPROPRIATE CITY OF MADISON OFFICIALS MUST APPROVE ANY CHANGES PRIOR TO DEVIATION FROM THE APPROVED PLANS.

2. ALL EROSION CONTROL MEASURES SHALL BE CONSTRUCTED AND MAINTAINED BY THE CONTRACTOR IN ACCORDANCE WITH THE WISCONSIN DEPARTMENT OF NATURAL RESOURCES (WDNR) TECHNICAL STANDARDS (REFERRED TO AS BMP'S) AND CITY OF MADISON ORDINANCE. IT IS THE CONTRACTOR'S RESPONSIBILITY TO OBTAIN A COPY OF THESE STANDARDS. CONTRACTOR SHALL BE RESPONSIBLE FOR ANY ADDITIONAL EROSION CONTROL MEASURES WHICH MAY BE NECESSARY TO MEET

5. INSTALL PERIMETER EROSION CONTROL MEASURES (SUCH AS CONSTRUCTION ENTRANCES, SILT FENCE AND EXISTING INLET PROTECTION) PRIOR TO ANY SITE WORK, INCLUDING GRADING OR DISTURBANCE OF EXISTING SURFACE COVER, AS SHOWN ON PLAN. MODIFICATIONS TO THE APPROVED EROSION CONTROL DESIGN IN ORDER TO MEET UNFORESEEN FIELD CONDITIONS IS ALLOWED IF MODIFICATIONS CONFORM TO BMP'S. ALL DESIGN MODIFICATIONS MUST BE APPROVED BY THE CITY OF MADISON PRIOR TO DEVIATION OF THE APPROVED PLAN.

4. ADDITIONAL EROSION CONTROL MEASURES, AS REQUESTED BY STATE INSPECTORS, LOCAL INSPECTORS, COUNTY INSPECTORS AND/OR ENGINEER OF RECORD SHALL BE INSTALLED WITHIN 24 HOURS OF

5. INSPECTIONS AND MAINTENANCE OF ALL EROSION CONTROL MEASURES SHALL BE ROUTINE (ONCE PER WEEK MINIMUM) TO ENSURE PROPER FUNCTION OF EROSION CONTROLS AT ALL TIMES. EROSION CONTROL MEASURES ARE TO BE IN WORKING ORDER AT THE END OF EACH WORK DAY.

6. ALL EROSION AND SEDIMENT CONTROL ITEMS SHALL BE INSPECTED WITHIN 24 HOURS OF ALL RAIN EVENTS EXCEEDING 0.5 INCHES. ANY DAMAGED EROSION CONTROL MEASURES SHALL BE REPAIRED OR REPLACED IMMEDIATELY UPON INSPECTION.

7. PAVED SURFACES ADJACENT TO CONSTRUCTION SITE VEHICLE ACCESS SHALL BE SWEPT AND/OR SCRAPED TO REMOVE ACCUMULATED SOIL, DIRT AND/OR DUST AFTER THE END OF EACH WORK DAY AND AS REQUESTED BY THE CITY OF MADISON. INLET PROTECTION SHALL BE IMMEDIATELY FITTED AT THE INLET OF ALL INSTALLED STORM SEWER AND

SILT FENCE SHALL BE IMMEDIATELY FITTED AT ALL INSTALLED CULVERT INLETS TO PREVENT SEDIMENT DEPOSITION WITHIN STORM SEWER SYSTEMS. CONTRACTOR SHALL TAKE ALL NECESSARY STEPS TO CONTROL DUST ARISING FROM CONSTRUCTION

OPERATIONS. REFER TO WDNR TECHNICAL STANDARD 1068. 10. EROSION CONTROL MEASURES SHALL NOT BE REMOVED UNTIL ALL LAND DISTURBING CONSTRUCTION ACTIVITY AT THE SITE HAS BEEN COMPLETED AND THAT A UNIFORM PERENNIAL VEGETATIVE COVER HAS BEEN ESTABLISHED WITH A DENSITY OF AT LEAST 70% FOR UNPAVED AREAS AND AREAS NOT COVERED BY PERMANENT STRUCTURES OR THAT EMPLOY EQUIVALENT PERMANENT STABILIZATION

11. EROSION CONTROL FOR UTILITY CONSTRUCTION (STORM SEWER, SANITARY SEWER, WATER MAIN, ETC.): A. PLACE EXCAVATED TRENCH MATERIAL ON THE HIGH SIDE OF THE TRENCH. B. BACKFILL, COMPACT, AND STABILIZE THE TRENCH IMMEDIATELY AFTER PIPE CONSTRUCTION. C. DISCHARGE TRENCH WATER INTO A SEDIMENTATION BASIN OR FILTERING TANK IN ACCORDANCE WITH THE DEWATERING TECHNICAL STANDARD NO. 1061 PRIOR TO RELEASE INTO THE STORM SEWER, RECEIVING STREAM, OR DRAINAGE DITCH.

12. STABILIZATION PRACTICES:

STABILIZATION MEASURES SHALL BE INITIATED AS SOON AS PRACTICABLE IN PORTIONS OF THE SITE WHERE CONSTRUCTION ACTIVITIES HAVE TEMPORARILY OR PERMANENTLY CEASED. NO MORE THAN SEVEN (7) DAYS SHALL PASS AFTER THE CONSTRUCTION ACTIVITY IN THAT PORTION OF THE SITE HAS CEASED UNLESS: THE INITIATION STABILIZATION MEASURES BY THE SEVENTH (7) DAY AFTER CONSTRUCTION

ACTIVITY HAS CEASED IS PRECLUDED BY SNOW COVER. IN THAT EVENT, STABILIZATION SHALL BE INITIATED AS SOON AS PRACTICABLE. CONSTRUCTION ACTIVITY WILL RESUME ON A PORTION OF THE SITE WITHIN FOURTEEN (14) DAYS FROM WHEN ACTIVITY CEASED, (I.E. THE TOTAL TIME PERIOD THAT THE CONSTRUCTION ACTIVITY IS TEMPORARILY CEASED IS LESS THAN FOURTEEN (14) DAYS. IN THAT EVENT, STABILIZATION MEASURES DO NOT HAVE TO BE INITIATED ON THAT PORTION OF THE SITE BY THE SEVENTH (7) DAY AFTER CONSTRUCTION ACTIVITY HAS TEMPORARILY CEASED. STABILIZATION MEASURES SHALL BE DETERMINED BASED ON SITE CONDITIONS AT THE TIME

CONDITIONS AND LENGTH OF TIME MEASURE MUST BE EFFECTIVE. THE FOLLOWING ARE ACCEPTABLE STABILIZATION MEASURES: PERMANENT SEEDING; IN ACCORDANCE WITH APPROVED CONSTRUCTION SPECIFICATION TEMPORARY SEEDING; MAY CONSIST OF SPRING OATS(100LBS/ACRE) AND/OR WHEAT OR CEREAL RYE (150LB/ACRE) HYDRO-MULCHING WITH A TACKIFIER GEOTEXTILE EROSION MATTING

OF CONSTRUCTION ACTIVITY HAS CEASED. INCLUDING BUT NOT LIMITED TO WEATHER

CONSTRUCTION SEQUENCING

SODDING

- 1. INSTALL PERIMETER SILT FENCE AND INLET PROTECTION.
- 2. INSTALL UTILITY PIPING AND STRUCTURES.
- . COMPLETE FINAL GRADING, INSTALLATION OF GRAVEL BASE COURSES, PLACEMENT OF CURBS, PAVEMENTS, WALKS, ETC.
- 4. PLACE TOPSOIL AND IMMEDIATELY STABILIZE DISTURBED AREAS WITH EROSION CONTROL MEASURES AS INDICATED ON PLANS.
- EROSION CONTROLS SHALL NOT BE REMOVED UNTIL SITE IS FULLY STABILIZED OR 70% VEGETATIVE COVER IS ESTABLISHED. CONTRACTOR MAY MODIFY SEQUENCING AFTER ITEM NO. 1 AS NEEDED TO COMPLETE CONSTRUCTION F EROSION CONTROLS ARE MAINTAINED IN ACCORDANCE WITH THE CONSTRUCTION SITE EROSION CONTROL REQUIREMENTS.

GRADING AND SEEDING NOTES

UTILITY NOTES

AUTHORITIES.

1. ALL PROPOSED GRADES SHOWN ARE FINISHED GRADES. CONTRACTOR SHALL VERIFY ALL GRADES, MAKE SURE ALL AREAS DRAIN PROPERLY AND SHALL REPORT ANY DISCREPANCIES TO THE ENGINEER PRIOR TO CONSTRUCTION.

- CONTRACTOR SHALL ASSUME SOLE RESPONSIBILITY FOR COMPUTATIONS OF ALL GRADING QUANTITIES. WHILE JSD PROFESSIONAL SERVICES, INC. ATTEMPTS TO PROVIDE A COST EFFECTIVE APPROACH TO BALANCE EARTHWORK, GRADING DESIGN IS BASED ON MANY FACTORS, INCLUDING SAFETY,
- AESTHETICS, AND COMMON ENGINEERING STANDARDS OF CARE. THEREFORE, NO GUARANTEE CAN BE MADE FOR A BALANCED SITE. 3. ANY WORK WITHIN RIGHT-OF-WAY SHALL BE PROPERLY PERMITTED AND COORDINATED WITH THE
- APPROPRIATE OFFICIALS PRIOR TO COMMENCEMENT OF ANY CONSTRUCTION ACTIVITIES. ALL GRADING WITHIN RIGHT-OF-WAY IS SUBJECT TO APPROVAL BY SAID OFFICIALS.
- 4. CONTRACTOR SHALL PROVIDE NOTICE TO THE MUNICIPALITY IN ADVANCE OF ANY SOIL DISTURBING ACTIVITIES, IN ACCORDANCE WITH MUNICIPAL REQUIREMENTS.

6. CONTRACTOR SHALL WATER ALL NEWLY SODDED/SEEDED AREAS DURING THE SUMMER MONTHS

- 5. ALL DISTURBED AREAS SHALL BE SODDED AND/OR SEEDED AND MULCHED IMMEDIATELY FOLLOWING GRADING ACTIVITIES. SOD/SEED MIX TO BE IN ACCORDANCE WITH LANDSCAPE PLAN.
- WHENEVER THERE IS A 7 DAY LAPSE WITH NO SIGNIFICANT RAINFALL. CONTRACTOR TO DEEP TILL ALL COMPACTED PERVIOUS SURFACES PRIOR TO SODDING AND/OR SEEDING AND MULCHING.
- 8. ALL SLOPES 20% OR GREATER SHALL BE TEMPORARY SEEDED, MULCHED, OR OTHER MEANS OF Madison, Wisconsin COVER PLACED ON THEM WITHIN 2 WEEKS OF DISTURBANCE.
- 9. ALL EXPOSED SOIL AREAS THAT WILL NOT BE BROUGHT TO FINAL GRADE OR ON WHICH LAND DISTURBING ACTIVITIES WILL NOT BE PERFORMED FOR A PERIOD GREATER THAN 30 DAYS AND REQUIRE VEGETATIVE COVER FOR LESS THAN 1 YEAR, REQUIRE TEMPORARY SEEDING FOR EROSION CONTROL. SEEDING FOR EROSION CONTROL SHALL BE IN ACCORDANCE WITH WDNR TECHNICAL STANDARD 1059 AND CITY OF MADISON ORDINANCE.



MADISON COLLEGE

ADMINISTRATION BUILDING

ADDITION AND RENOVATION

07-14-2022

2021-08

DATE

RFB22-006

Issued for:

1. ALL EXISTING UTILITIES ARE SHOWN FOR INFORMATIONAL PURPOSES ONLY AND ARE NOT GUARANTEED TO BE ACCURATE OR ALL INCLUSIVE. THE CONTRACTOR IS RESPONSIBLE FOR MAKING HIS OWN Issue date: DETERMINATION AS TO THE TYPE AND LOCATIONS OF UNDERGROUND UTILITIES AS MAY BE NECESSARY TO AVOID DAMAGE THERETO. CONTRACTOR/OWNER SHALL CALL "DIGGER'S HOTLINE" AA Project No.: PRIOR TO ANY CONSTRUCTION.

MC Project No.: PRIOR TO CONSTRUCTION, THE PRIME CONTRACTOR IS RESPONSIBLE FOR: EXAMINING ALL SITE CONDITIONS RELATIVE TO THE CONDITIONS INDICATED ON THE ENGINEERING DRAWINGS. ANY DISCREPANCIES ARE TO BE REPORTED TO THE ENGINEER AND RESOLVED PRIOR TO BID Pkg No.: THE START OF CONSTRUCTION. OBTAINING ALL PERMITS INCLUDING PERMIT COSTS, TAP FEES, METER DEPOSITS, BONDS, AND

- ALL OTHER FEES REQUIRED FOR PROPOSED WORK TO OBTAIN OCCUPANCY. VERIFYING ALL ELEVATIONS, LOCATIONS AND SIZES OF SANITARY, WATER AND STORM LATERALS AND CHECK ALL UTILITY CROSSINGS FOR CONFLICTS. NOTIFY ENGINEER OF ANY DISCREPANCY. NO WORK SHALL BE PERFORMED UNTIL THE DISCREPANCY IS RESOLVED. NOTIFYING ALL UTILITIES PRIOR TO INSTALLATION OF ANY UNDERGROUND IMPROVEMENTS.
- NOTIFYING THE DESIGN ENGINEER AND MUNICIPALITY 48 HOURS PRIOR TO THE START C CONSTRUCTION TO ARRANGE FOR APPROPRIATE CONSTRUCTION OBSERVATION. COORDINATING ALL CONSTRUCTION WITH OTHER CONTRACTORS INVOLVED WITH CONSTRUCTION REVISION THE PROPOSED DEVELOPMENT AND FOR REPORTING ANY ERRORS OR DISCREPANCIES

AND TO COORDINATE ALL CONSTRUCTION ACTIVITIES WITH THE APPROPRIATE LOCAL AND STATE

- BETWEEN THESE PLANS AND PLANS PREPARED BY OTHERS. 3. ALL UTILITY WORK SHALL BE DONE IN ACCORDANCE WITH THE STANDARD SPECIFICATIONS FOR SEWER AND WATER CONSTRUCTION IN WISCONSIN - AND ALL STATE AND LOCAL CODES AND SPECIFICATIONS. IT IS THE CONTRACTORS RESPONSIBILITY TO DETERMINE WHICH SPECIFICATIONS AND CODES APPLY.
- 4. SPECIFICATIONS SHALL COMPLY WITH THE CITY OF MADISON SPECIAL PROVISIONS.
- LENGTHS OF ALL UTILITIES ARE TO CENTER OF STRUCTURES OR FITTINGS AND MAY VARY SLIGHTLY FROM PLAN. LENGTHS SHALL BE VERIFIED IN THE FIELD DURING CONSTRUCTION. 6. CONTRACTOR IS RESPONSIBLE FOR SITE SAFETY DURING THE CONSTRUCTION OF IMPROVEMENTS.
- 7. CONTRACTOR SHALL INSTALL A PEDESTRIAN FENCE AROUND ALL EXCAVATIONS TO BE LEFT OPEN OVER NIGHT AS REQUIRED IN CONSTRUCTION SITES WHERE THE POTENTIAL FOR PEDESTRIAN INJURY
- 8. CONTRACTOR SHALL ADJUST AND/OR RECONSTRUCT ALL UTILITY COVERS (SUCH AS MANHOLE COVERS, VALVE BOX COVERS, ETC.) TO MATCH THE FINISHED GRADES OF THE AREAS EFFECTED BY THE
- 9. THE PRIME CONTRACTOR IS RESPONSIBLE FOR COORDINATING ALL CONSTRUCTION WITH OTHER CONTRACTORS INVOLVED WITH CONSTRUCTION OF THE PROPOSED DEVELOPMENT AND FOR REPORTING ANY ERRORS OR DISCREPANCIES BETWEEN THESE PLANS AND PLANS PREPARED BY OTHERS. 10. ANY SANITARY SEWER, SANITARY SEWER SERVICES, WATER MAIN, WATER SERVICES, STORM SEWER, OR OTHER UTILITIES, WHICH ARE DAMAGED BY THE CONTRACTORS, SHALL BE REPAIRED TO THE
- 11. THE CONTRACTOR IS RESPONSIBLE FOR PROVIDING THE ENGINEER WITH AS-BUILT CONDITIONS OF THE DESIGNATED IMPROVEMENTS IN ORDER THAT THE APPROPRIATE DRAWINGS CAN BE PREPARED, IF REQUIRED. ANY CHANGES TO THE DRAWINGS OR ADDITIONAL ITEMS MUST BE REPORTED TO THE ENGINEER AS WORK PROGRESSES.

12. STORM SEWER SPECIFICATIONS -

OWNER'S SATISFACTION AT THE CONTRACTOR'S EXPENSE.

PIPE - HIGH DENSITY DUAL-WALL POLYETHYLENE CORRUGATED PIPE SHALL BE AS MANUFACTURED BY ADS OR EQUAL WITH WATER TIGHT JOINTS, AND SHALL MEET THE REQUIREMENTS OF AASHTO DESIGNATION M-294 TYPE "S".

BACKFILL AND BEDDING - STORM SEWER SHALL BE CONSTRUCTED WITH GRAVEL BACKFILL AND CLASS "B" BEDDING IN ALL PAVED AREAS AND TO A POINT 5 FEET BEYOND THE EDGE OF PAVEMENT. TRENCHES RUNNING PARALLEL TO AND LESS THAN 5 FEET FROM THE EDGE OF PAVEMENT SHALL ALSO REQUIRE GRAVEL BACKFILL. LANDSCAPED AREAS MAY BE BACKFILLED WITH EXCAVATED MATERIAL IN CONFORMANCE WITH SECTION 8.43.5 OF THE "STANDARD SPECIFICATIONS".

MANHOLE FRAMES AND COVERS - MANHOLE FRAMES AND COVERS SHALL BE NEENAH R-1556 SEALING LIDS, NON-ROCKING OR EQUAL. FIELD TILE CONNECTION - ALL FIELD TILE ENCOUNTERED DURING CONSTRUCTION SHALL BE INCLUDED

IN THE UNIT PRICE(S) FOR STORM SEWER. TILE LINES CROSSED BY THE TRENCH SHALL BE REPLACED

PROPOSED STORM SEWER STRUCTURE TABLE						
LABEL	RIM EL. (FT)	INVERT EL. (FT)	DEPTH (FT)	STRUCTURE DESC.	FRAME & GRATE	
STO-FES-A-1	856.08	N INV: 855.54 (8")		12 IN HDPE FES		
STO-FES-B-1	857.17	N INV: 855.00 (24")		24 IN HDPE FES		
STO-FES-C-1	857.44	N INV: 855.27 (24")		24 IN HDPE FES		
STO-MH-B-2	862.66	SW INV: 856.00 (24") S INV: 853.34 (24") N INV: 853.38 (24")	9.3	60 IN MH (FLAT)	R-1556 SOLID LID	
STO-MH-C-2	862.18	SW INV: 856.00 (24") S INV: 854.47 (24")	7.7	60 IN MH (FLAT)	R-1556 SOLID LID	

N INV: 854.51 (24")


WITH THE SAME MATERIAL AS THE STORM SEWER.

PROPOSED STORM SEWER PIPE TABLE							
LABEL	FROM	ТО	LENGTH	INVERT EL. (FT)	DISCHARGE EL. (FT)	SLOPE	SIZE & MATERIAL
STO-A-1	BUILDING	STO-FES-A-1	104'	857.70	855.54	2.08%	8 IN HDPE
STO-B-1	BEND	STO-FES-B-1	47'	855.70	855.00	1.50%	24 IN HDPE
STO-B-2	STO-MH-B-2	BEND	20'	856.00	855.70	1.50%	24 IN HDPE
STO-C-1	BEND	STO-FES-C-1	29'	855.70	855.27	1.50%	24 IN HDPE
STO-C-2	STO-MH-C-2	BEND	20'	856.00	855.70	1.50%	24 IN HDPE

LEGEND

PROPERTY LINE ----- EASEMENT LINE ---- BUILDING OVERHANG

CONCRETE PAVEMENT D STORM SEWER ——SF——SF—— SILT FENCE

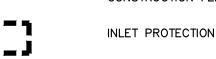

SCALE **AS NOTED**

PLAN

SHEET TITLE **GRADING, EROSION**

CONTROL & UTILITY


assemblage


ARCHITECTS

7433 Elmwood Avenue

Middleton, WI 53562

T 608.827.5047

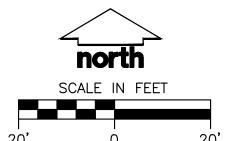

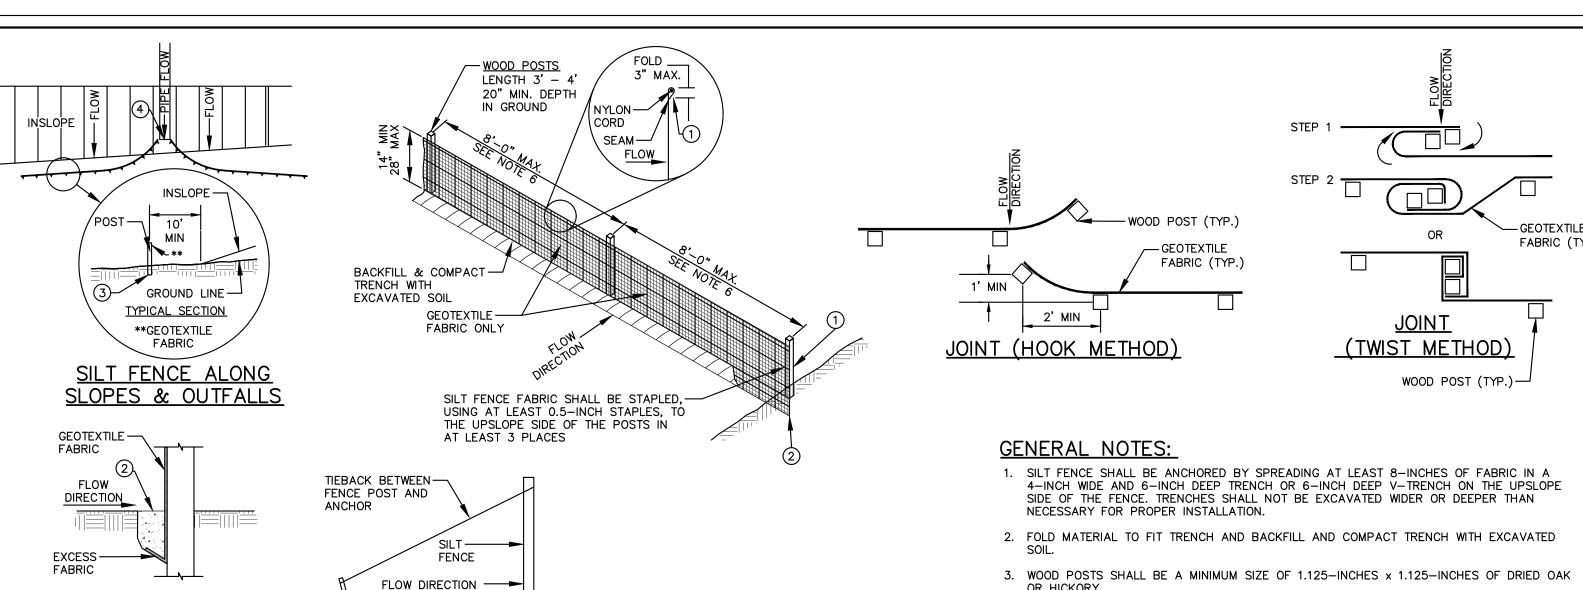

SILT FENCE

FLEXSTORM INLET FILTERS TO MEET DANE — GEOTEXTILE

- OR HICKORY. 4. SILT FENCE TO EXTEND ABOVE THE TOP OF PIPE.
- 5. SILT FENCE CONSTRUCTION AND GEOTEXTILE FABRIC SHALL CONFORM TO WDNR TECHNICAL STANDARD 1056.
- POST SPACING SHALL BE SELECTED BASED ON GEOTEXTILE FABRIC (8—FEET FOR WOVEN & 3—FEET FOR NON—WOVEN)

COUNTY EROSION CONTROL STANDARDS	
GALVANIZED STEEL FRAMING CURB BACK EXTENSION	
WOVEN OUTER BAG LAYER	
NON-WOVEN INNER BAG LINER (COVERING LOWER HALF OF BAG) REPLACEABLE FILTER BAG	
(HB) HYBRID FILTER BAG SPECIFICATIONS:	

CATCH-IT INLET FILTER (Temporary Inlet Protection)

23 x 16 20.5 x 13.5 1.6 0.7

3067-C Square/Rect (SQ) 35.25 x 17.75 33 x 15 3.2 1.0 5.2 62LSQ3618HB

R-2501 Round (RD) ~26 ~24 2.3 0.8 5.2 62MRD26HB


R-1772/2560 Round (RD) 22.25-23.5 20.5-21 1.5 0.6 4.6 62MRD22HB

35.75 x 23.875 33.5 x 21.0 4.2

REV. 7-01-2019

REV. 12-07-2018

(ft²) HB (Hybrid

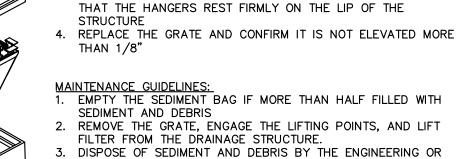


INSTALLATION INSTRUCTIONS:

1. REMOVE GRATE FROM THE DRAINAGE STRUCTURE

2. CLEAN STONE AND DIRT FROM LEDGE (LIP) OF DRAINAGE

3. DROP THE INLET FILTER THROUGH THE CLEAR OPENING SUCH

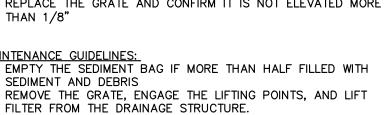

MAINTENANCE CONTRACT 4. ALTERNATIVELY, AN INDUSTRIAL VACUUM CAN BE USED TO COLLECT SEDIMENT FROM THE

Woven and Non-Woven Geotextife Filter Bag Properties (Minimum Average Roll Values)

A57M Ð6241

ASTM 04533

ASTM 04355

ASTM 04491

CBR PUNCTURE

UV RESISTANCE

PERMITTIVITY

TRAPEZOFDALTEAR

OPENING SIZE (AOS)

WATER FLOW RATE

MINIMUM FILTER BAG VOLUME

TEST METHOD WOVEN (OUTER) NON-WOVEN (UNER)

1000 Lbs

90%

1.5 Sec⁻¹

ASTM 04751 20 US STD SIEVE

ASTM 04491 200 gal/min/ft²

110 x 75 Lbs

MADISON COLLEGE

AREA | TECHNICAL

ADMINISTRATION BUILDING ADDITION AND RENOVATION Madison, Wisconsin

\JSD

|Issued for: 07-14-2022 Issue date: 2021-08 AA Project No.: RFB22-006 MC Project No.:

REVISION

FRAMED INLET PROTECTION N.T.S.




65 Lbs

45 Los

40 US STD SIEVE

2.0 Sec⁻¹

145 gal/min/ft²

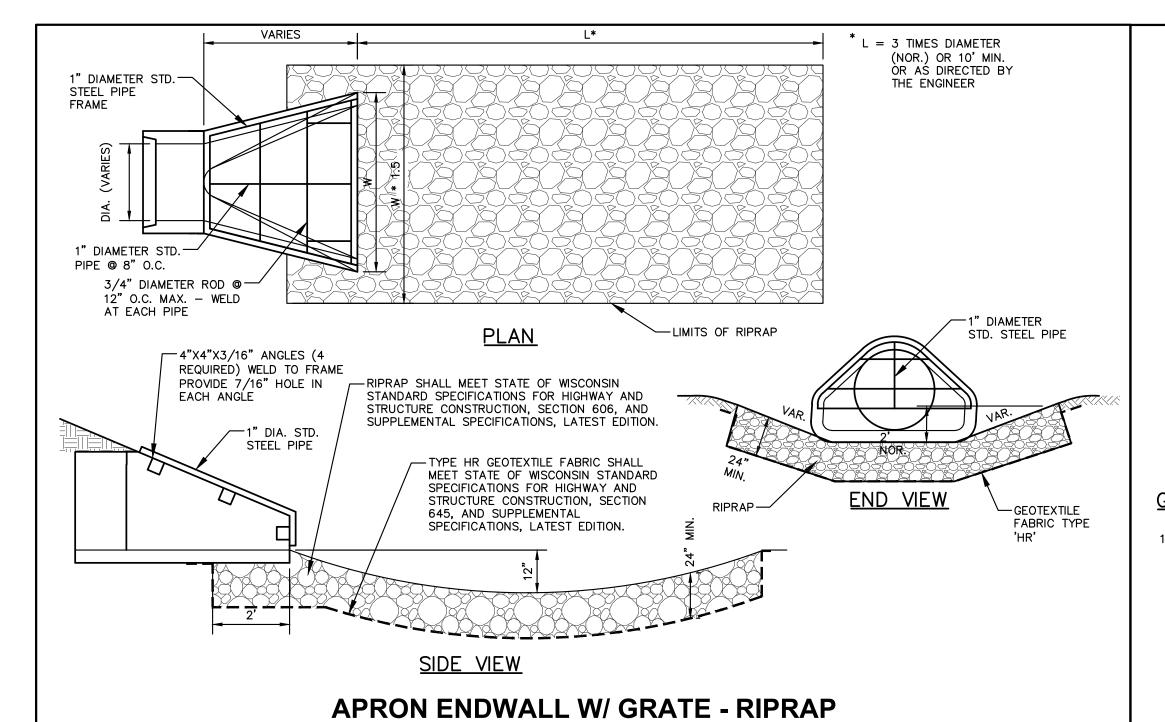

REV. 12-7-2018

REV. 7-01-2019

ADDITIONAL POST DEPTH OR TIE BACKS MAY BE REQUIRED IN UNSTABLE SOILS.


TRENCH DETAIL

ANCHOR STAKE

MIN. 18" LONG

SILT FENCE TIE BACK

(WHEN ADDITIONAL SUPPORT REQUIRED)

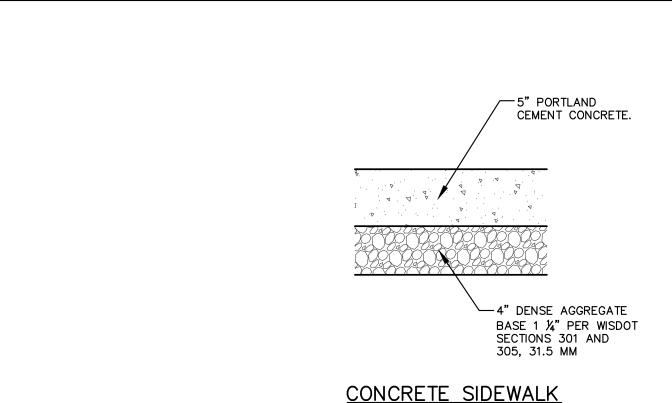

<u>SECTION</u>


GENERAL NOTES:


REV. 7-01-2019

. WISDOT STANDARD SPECIFICATIONS FOR HIGHWAY AND STRUCTURE CONSTRUCTION, INCLUDING SUPPLEMENTAL SPECIFICATIONS, COMPACTION REQUIREMENTS:

— BASE COURSE: REFER TO SECTION 301.3.4.2, STANDARD COMPACTION.


PAVEMENT SECTIONS N.T.S.

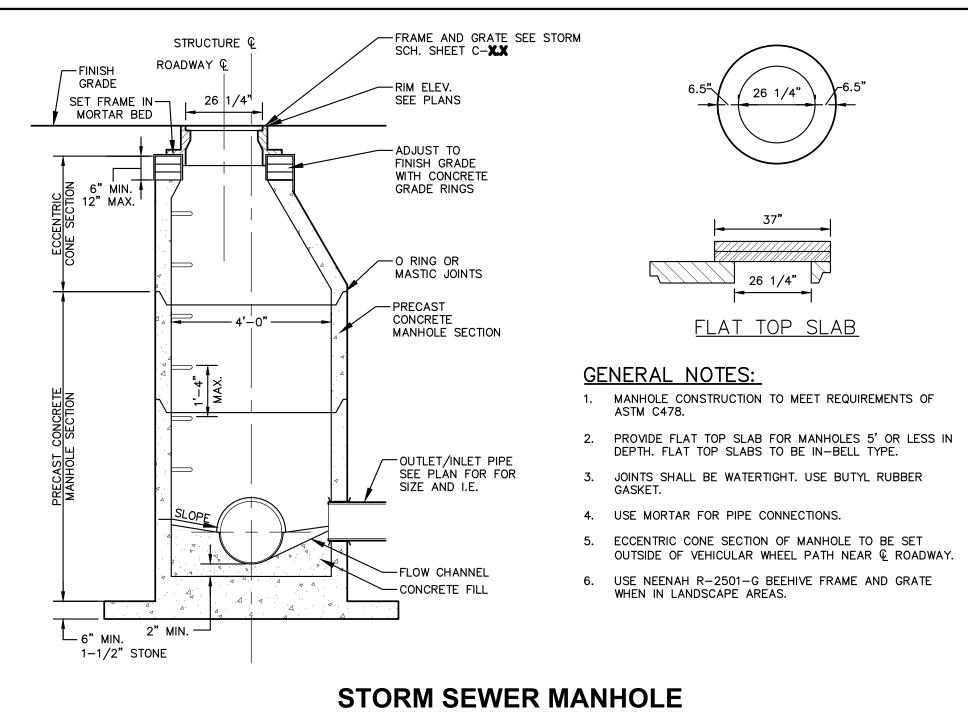

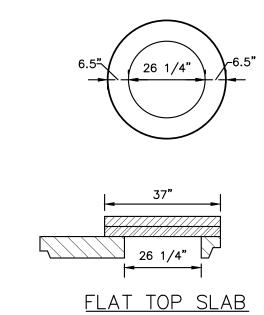

1. MANHOLE CONSTRUCTION TO MEET REQUIREMENTS OF


- JOINTS SHALL BE WATERTIGHT. USE BUTYL RUBBER GASKET.
- 4. USE MORTAR FOR PIPE CONNECTIONS.
- OUTSIDE OF VEHICULAR WHEEL PATH NEAR & ROADWAY.
- 6. USE NEENAH R-2501-G BEEHIVE FRAME AND GRATE WHEN IN LANDSCAPE AREAS.

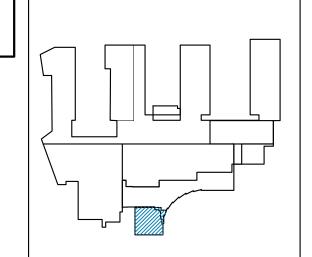

assemblage ARCHITECTS 7433 Elmwood Avenue Middleton, WI 53562 T 608.827.5047

SCALE

SHEET TITLE **DETAILS**

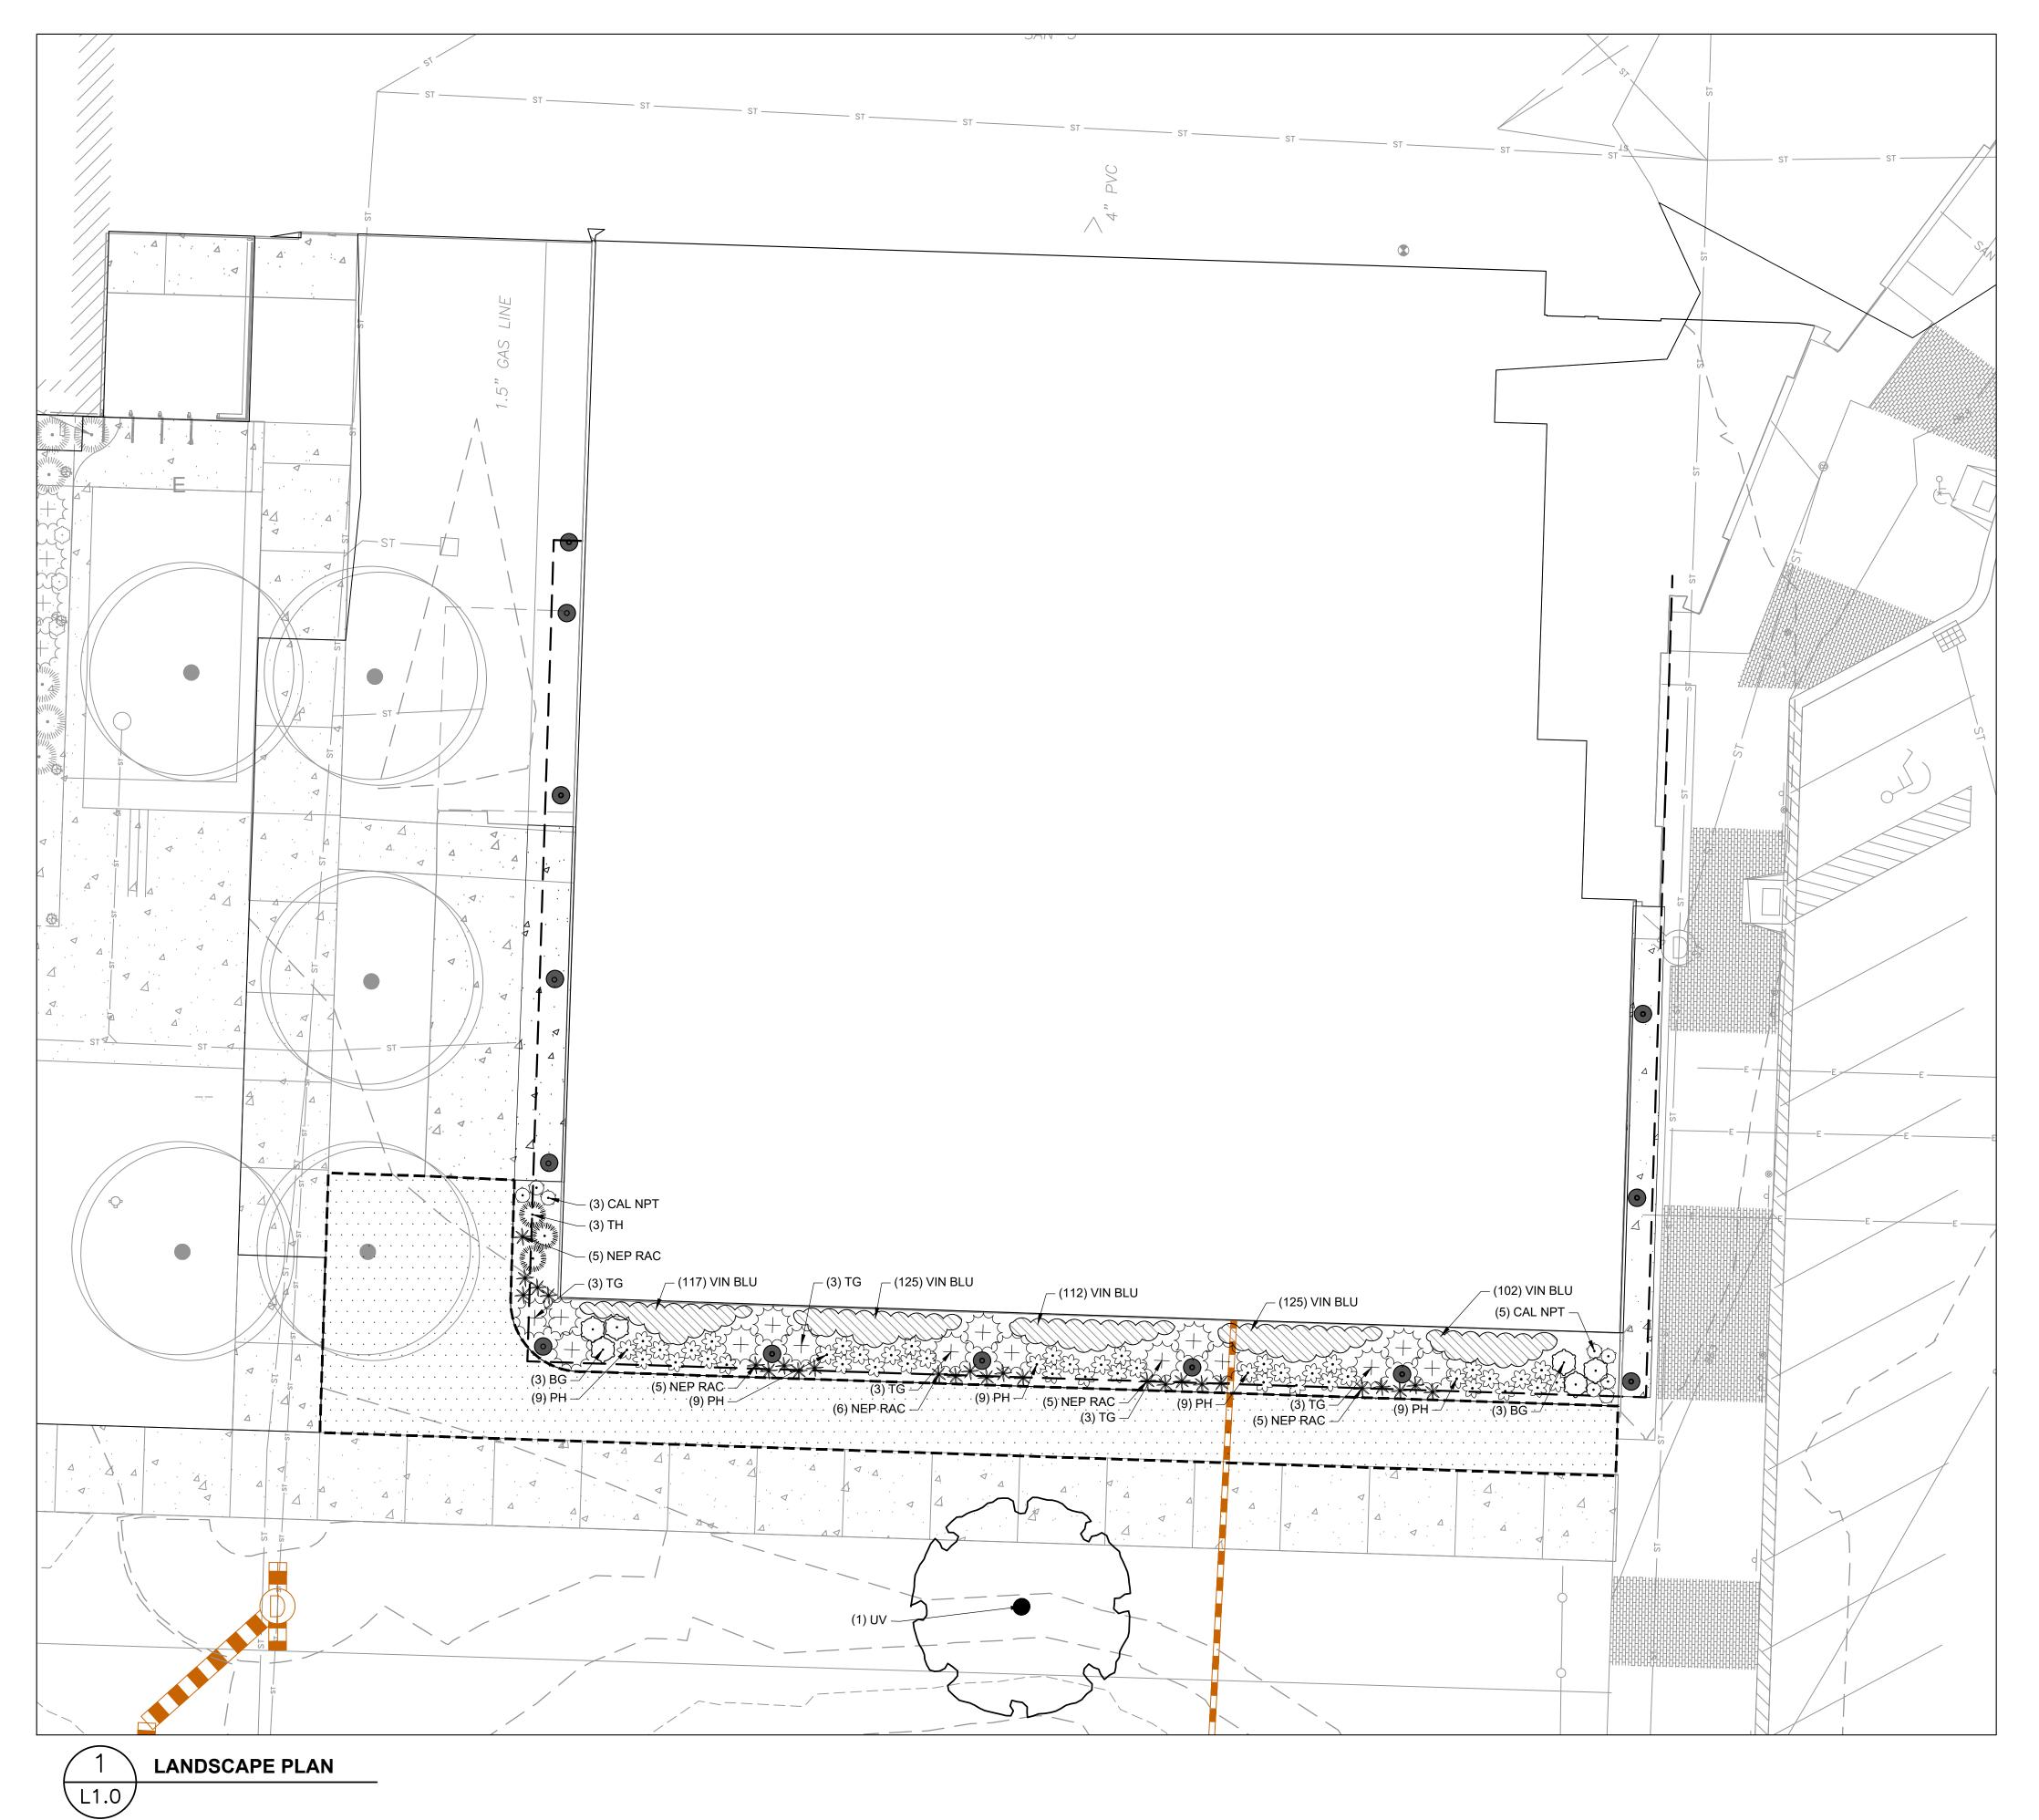


GENERAL NOTES

- 1. REFER TO THE EXISTING CONDITIONS SURVEY FOR EXISTING CONDITIONS NOTES AND LEGEND.
- 2. ALL WORK IN THE ROW SHALL BE IN ACCORDANCE WITH THE MUNICIPAL STANDARD SPECIFICATIONS FOR PUBLIC WORKS CONSTRUCTION.
- 3. JSD SHALL BE HELD HARMLESS AND DOES NOT WARRANT ANY DEVIATIONS BY THE OWNER/CONTRACTOR FROM THE APPROVED CONSTRUCTION PLANS THAT MAY RESULT IN DISCIPLINARY ACTIONS BY ANY OR ALL REGULATORY AGENCIES.
- 4. DRAWING FOR REVIEW NOT FOR CONSTRUCTION UNLESS OTHERWISE NOTED IN THE TITLE BLOCK.
- 5. THE LANDSCAPE CONTRACTOR SHALL COORDINATE ALL FINE GRADING AND TOPSOILING WITH GENERAL CONTRACTOR
- 6. REFER TO "LANDSCAPE DETAILS AND NOTES" SHEET FOR ADDITIONAL DETAILS, NOTES AND SPECIFICATION INFORMATION INCLUDING MATERIALS, GUARANTEE AND EXECUTION RELATED TO LANDSCAPE PLAN
- INSTALLATION. REPORT ANY CONDITIONS THAT MAY HAVE ADVERSE IMPACT ON PLANTING OPERATIONS TO LANDSCAPE ARCHITECT

7. CONTRACTOR SHALL REVIEW SITE CONDITIONS FOR UTILITY CONFLICTS, DRAINAGE ISSUES, SUBSURFACE ROCK, AND PLANT PLACEMENT CONFLICTS PRIOR TO PLANT


8. DO NOT COMMENCE PLANTING OPERATIONS UNTIL ALL ADJACENT SITE IMPROVEMENTS, IRRIGATION INSTALLATION (IF APPLICABLE), AND FINISH GRADING ARE COMPLETE
9. THE CONTRACTOR SHALL WATER ALL NEWLY SEEDED AREAS UNTIL SUBSTANTIAL COMPLETION AND THE SITE IS TURNED OVER TO THE OWNER.

LEGEND

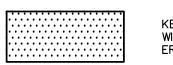


KENTUCKY BLUEGRASS BLEND (SEED) WITH NORTH AMERICAN GREEN DS75 EROSION CONTROL BLANKET

PLANT SCHEDULE					
EVERGREEN TREE	CODE	BOTANICAL / COMMON NAME	ROOT CONDITION	SIZE AT PLANTING	QTY
	JUN VIR	Juniperus virginiana 'Canaertii' / Canaerti Eastern Redcedar	B & B	Min. 5` tall	3
OVERSTORY DECIDUOUS TREES	CODE	BOTANICAL / COMMON NAME	ROOT CONDITION	SIZE AT PLANTING	QTY
	UV	Ulmus americana 'Valley Forge' / Valley Forge American Elm	B & B	2.5"Cal	1
EVERGREEN SHRUBS	CODE	BOTANICAL / COMMON NAME	CONT	SIZE AT PLANTING	QTY
\odot	BG	Buxus microphylla koreana `Green Gem` / Green Gem Boxwood	B & B	Min. 12"-18"	6
\\\\\\\\\\\\\\\\\\\\\\\\\\\\\\\\\\\\\	TG	Taxus x media `Dark Green` / Dark Green Spreader Yew	B & B	Min. 18"-24"	15
	TH	Thuja occidentalis `Hetz Midget` / Hetz Midget Arborvitae	#05/5 gal.	Min. 12"-18"	3
ORNAMENTAL GRASSES	CODE	BOTANICAL / COMMON NAME	CONT	SIZE AT PLANTING	QTY
*	PAN HEA	Panicum virgatum 'Heavy Metal' / Heavy Metal Switch Grass	#03/3 gal.	Min. 24"	12
€;3	PH	Pennisetum alopecuroides `Hameln` / Hameln Dwarf Fountain Grass	#01/1 gal.	Min. 12"-18"	59
PERENNIALS	CODE	BOTANICAL / COMMON NAME	CONT	SIZE AT PLANTING	QTY
\odot	CAL NPT	Calamintha nepeta nepeta / Lesser Calamint	#01/1 gal.		50
*	NEP RAC	Nepeta racemosa 'Walker's Low' / Walker's Low Catmint	#01/1 gal.		26
GROUND COVERS	CODE	BOTANICAL / COMMON NAME	CONT	SPACING	QTY
	VIN BLU	Vinca minor 'Blue and Gold' / Blue and Gold Periwinkle	24 Flat	8" o.c.	581

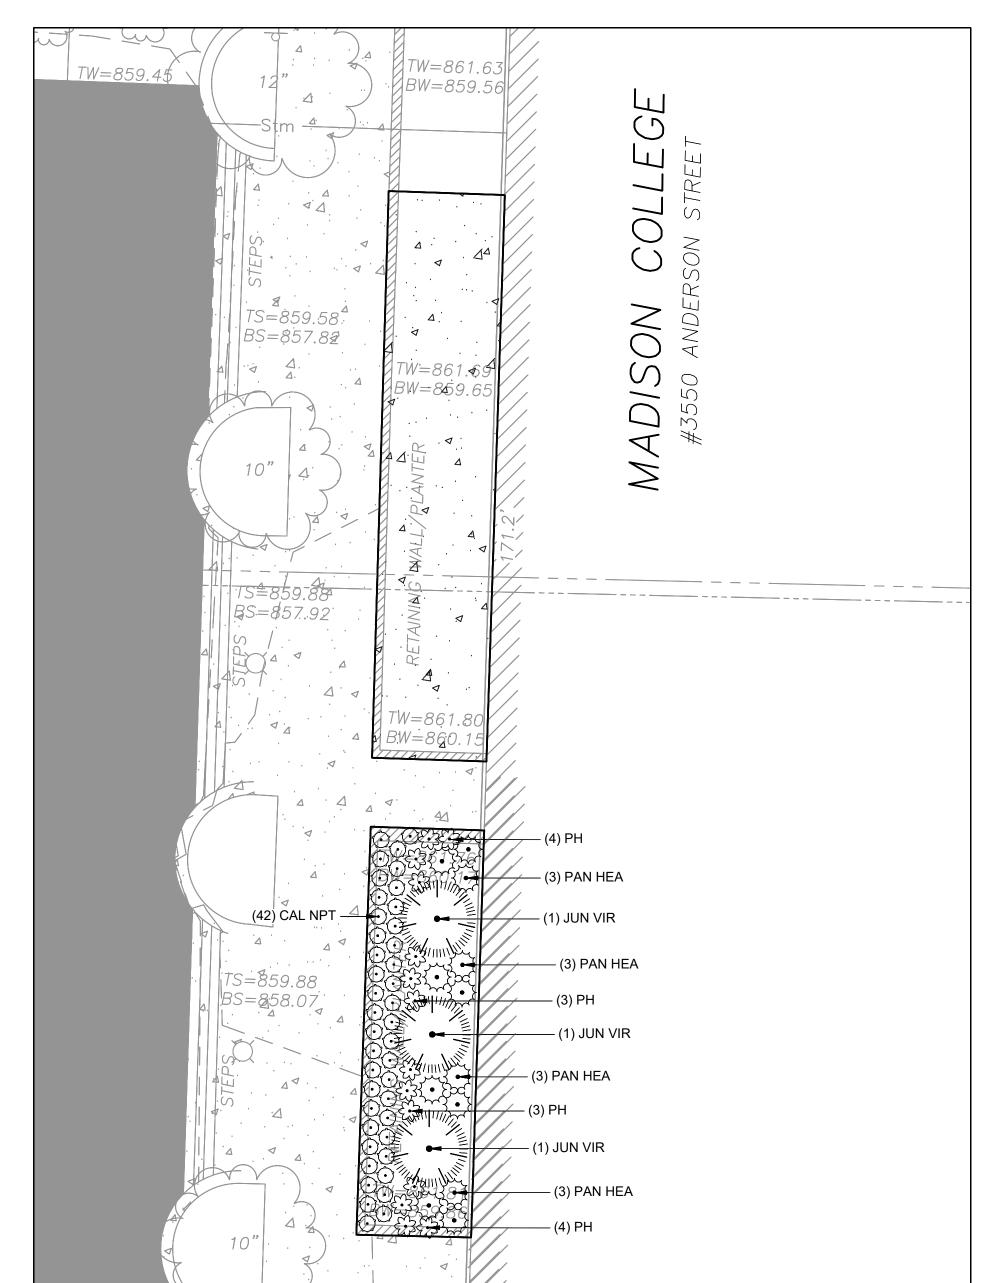





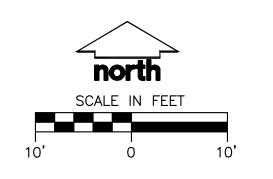




MADISON COLLEGE ADMINISTRATION BUILDING ADDITION AND RENOVATION Madison, Wisconsin

U JCD

Issued for:	BID
Issue date:	07-14-2022
AA Project No.:	2021-08
MC Project No.:	RFB22-006
Bid Pkg No.:	-

REVISION	DATE
	-

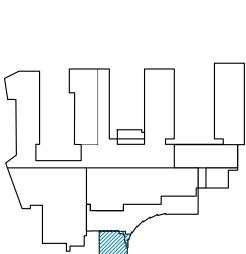

assemblage ARCHITECTS 7433 Elmwood Avenue Middleton, WI 53562 T 608.827.5047

SCALE

SHEET TITLE

LANDSCAPE PLAN

SHEET NUMBER

L100

GENERAL NOTES

- 1. GENERAL: ALL WORK IN THE R-O-W AND PUBLIC EASEMENTS SHALL BE IN ACCORDANCE WITH LOCAL MUNICIPAL REQUIREMENTS. JSD SHALL BE HELD HARMLESS AND DOES NOT WARRANT ANY DEVIATIONS BY THE OWNER/CONTRACTOR FROM THE APPROVED CONSTRUCTION PLANS THAT MAY RESULT IN DISCIPLINARY ACTIONS BY ANY OR ALL REGULATORY AGENCIES. LOCATE ALL UTILITIES PRIOR TO CONSTRUCTION. THE CONTRACTOR IS RESPONSIBLE FOR REPAIRING ANY DAMAGE DONE TO UTILITIES. CONTRACTOR MUST CALL 1-800-242-8511 FOR UTILITY LOCATIONS AT LEAST THREE DAYS PRIOR TO DIGGING. HAND DIG AND INSTALL ALL PLANTS THAT ARE NEAR EXISTING UTILITIES. PROTECT PREVIOUSLY INSTALLED WORK OF OTHER TRADES. CONTRACTOR IS RESPONSIBLE FOR STAKING THE PLANT MATERIALS FOR REVIEW BY OWNER PRIOR TO DIGGING AND PLACEMENT AND SHALL COORDINATE ALL FINE GRADING AND RESTORATION WITH THE GRADING CONTRACTOR.
- 2. DELIVERY AND HANDLING: DO NOT DELIVER MORE PLANT MATERIALS THAN CAN BE PLANTED IN ONE DAY, UNLESS ADEQUATE, APPROPRIATE AND SECURE STORAGE IS PROVIDED AND APPROVED BY OWNER'S REPRESENTATIVE. AT ALL TIMES, PROTECT ALL PLANT MATERIALS FROM WIND AND DIRECT SUN. DELIVER PLANTS WITH LEGIBLE IDENTIFICATION LABELS. PROTECT PLANTS DURING DELIVERY AND DO NOT PRUNE PRIOR TO DELIVERY. ALL TREES AND SHRUBS SHALL BE PLANTED ON THE DAY OF DELIVERY; IF THIS IS NOT POSSIBLE, PROTECT THE PLANT MATERIALS NOT PLANTED BY STORING THEM IN A SHADED, SECURE AREA, PROTECTING THE ROOT MASS WITH WET SOIL, MULCH, HAY OR OTHER SUITABLE MEDIUM. CONTRACTOR TO KEEP ALL PLANT MATERIALS ADEQUATELY WATERED TO PREVENT ROOT DESICCATION. DO NOT REMOVE CONTAINER GROWN STOCK FROM CONTAINERS BEFORE TIME OF PLANTING. DO NOT PICK UP CONTAINER OR BALLED PLANTS BY STEM OR ROOTS. ALL PLANTS SHALL BE LIFTED AND HANDLED FROM THE BOTTOM OF THE CONTAINER OR BALL. PERFORM ACTUAL PLANTING ONLY WHEN WEATHER AND SOIL CONDITIONS ARE SUITABLE IN ACCORDANCE WITH
- 3. MATERIALS PLANTS: ALL PLANTS SHALL CONFORM TO THE LATEST VERSION OF THE AMERICAN STANDARD FOR NURSERY STOCK ANSI Z60.1. PLANTS SHALL BE TRUE TO SPECIES AND VARIETY SPECIFIED AND NURSERY GROWN IN ACCORDANCE WITH GOOD HORTICULTURAL PRACTICES UNDER CLIMATIC CONDITIONS SIMILAR TO THOSE IN THE LOCALITY OF THE PROJECT FOR AT LEAST 2 YEARS. PLANTS SHALL BE FRESHLY DUG (DURING THE MOST RECENT FAVORABLE HARVEST SEASON). PLANTS SHALL BE SO TRAINED IN DEVELOPMENT AND APPEARANCE AS TO BE UNQUESTIONABLY SUPERIOR IN FORM, COMPACTNESS, AND SYMMETRY. PLANTS SHALL BE SOUND, HEALTHY, VIGOROUS, WELL BRANCHED AND DENSELY FOLIATED WHEN IN LEAF, AND FREE OF DISEASE AND INSECTS (ADULT EGGS, PUPAE OR LARVAE). THEY SHALL HAVE HEALTHY, WELL—DEVELOPED ROOT SYSTEMS AND SHALL BE FREE FROM PHYSICAL DAMAGE OR OTHER CONDITIONS THAT WOULD PREVENT THRIVING GROWTH OR PREMATURE MORTALITY. PLANTS SHALL BE OF THE HIGHEST QUALITY, POSSESS TYPICAL GROWTH HABITS AND FORM FOR THEIR SPECIES AND BE FREE OF INJURY. PARKWAY TREES AND PARKING LOT TREES SHALL HAVE A MINIMUM BRANCHING HEIGHT OF SIX (6) FEET ABOVE THE GROUND TO ALLOW ADEQUATE VISUAL AND PHYSICAL CLEARANCE.
- 4. PRUNING: THE CONTRACTOR SHALL PRUNE ALL TREES AND REPAIR ANY INJURIES THAT OCCURRED DURING THE PLANTING PROCESS. DOUBLE LEADERS, DEAD BRANCHES, AND LIMBS DAMAGED OR BROKEN DURING THE PLANTING PROCESS, SHALL BE PRUNED. THIS SHALL BE THE ONLY PRUNING ALLOWED AT PLANTING. PRUNING SHALL CONFORM TO THE LATEST VERSION OF THE AMERICAN STANDARD FOR TREE CARE OPERATIONS, ANSI A300. PRUNE TREES IN ACCORDANCE WITH NAA GUIDELINES. DO NOT TOP TREES. PRUNE SHRUBS ACCORDING TO STANDARD HORTICULTURAL PRACTICES. ON CUTS OVER 3/4" IN DIAMETER AND BRUISES OR SCARS ON BARK, TRACE THE INJURED CAMBIUM LAYER BACK TO LIVING TISSUE AND REMOVE. SMOOTH AND SHAPE WOUNDS SO AS NOT TO RETAIN WATER. TREAT THE AREA WITH AN APPROVED INCONSPICUOUS LATEX BASED ANTISEPTIC TREE PAINT, IF PRUNING OCCURS "IN SEASON". DO NOT PRUNE ANY OAK TREES DURING THE MONTHS FROM APRIL TO OCTOBER.
- 5. CLEANUP: THE WORK AREA SHALL BE KEPT SAFE AND NEAT AT ALL TIMES. DISPOSED OF EXCESS SOIL. REMOVE ALL CUTTINGS AND WASTE MATERIALS. SOIL AND BRANCHES. BIND AND WRAP THESE MATERIALS, ANY REJECTED PLANTS, AND ANY OTHER DEBRIS RESULTING FROM ALL PLANTING TASKS AND PROMPTLY CLEAN UP AND REMOVE FROM THE PROJECT SITE. UNDER NO CIRCUMSTANCES SHALL THE ACCUMULATION OF SOIL, BRANCHES OR OTHER DEBRIS BE ALLOWED UPON A PUBLIC PROPERTY IN SUCH A MANNER AS TO RESULT IN A PUBLIC SAFETY HAZARD OR DAMAGE. LIKEWISE, UNDER NO CIRCUMSTANCES SHALL ANY DEBRIS OR INCIDENTAL MATERIALS BE ALLOWED UPON
- 6. ANY SUBSTITUTIONS IN PLANT TYPE, LOCATION, OR SIZE SHALL BE APPROVED BY LANDSCAPE ARCHITECT PRIOR TO INSTALLATION.
- 7. CONTRACTOR TO VERIFY PLANT MATERIAL QUANTITIES AND SQUARE FOOTAGES. QUANTITIES SHOWN ON PLAN TAKE PRECEDENCE OVER THOSE ON SCHEDULE.

LANDSCAPE MATERIAL NOTES

LOCALLY ACCEPTED BEST HORTICULTURAL PRACTICES.


- MATERIALS PLANTING MIXTURE: ALL HOLES EXCAVATED FOR TREES, SHRUBS, PERENNIALS AND ORNAMENTAL GRASSES SHALL BE BACKFILLED WITH TWO (2) PARTS TOPSOIL, ONE (1) PART SAND AND ONE (1) PART COMPOST. SOIL MIXTURE SHALL BE WELL BLENDED PRIOR TO INSTALLATION.
- 2. MATERIALS TOPSOIL: TOPSOIL TO BE CLEAN, FRIABLE LOAM FROM A LOCAL SOURCE, FREE FROM STONES OR DEBRIS OVER 3/4" IN DIAMETER, AND FREE FROM TOXINS OR OTHER DELETERIOUS MATERIALS. TOPSOIL SHALL HAVE A pH VALUE BETWEEN 6 AND 7. TOPSOIL AND PLANTING SOIL SHALL BE TESTED TO ENSURE CONFORMANCE WITH THESE SPECIFICATIONS AND SHALL BE AMENDED TO MEET THESE SPECIFICATIONS. PROVIDE TEST RESULTS TO OWNER'S REPRESENTATIVE PRIOR TO PLACEMENT. DO NOT PLACE FROZEN OR MUDDY TOPSOIL. APPLY SOIL AMENDMENTS TO ALL LANDSCAPE AREAS PER SOIL TEST.
- 3. MATERIALS SHREDDED HARDWOOD BARK MULCH: ALL PLANTING AREAS LABELED ON PLAN SHALL RECEIVE CERTIFIED WEED FREE SHREDDED HARDWOOD BARK MULCH INSTALLED TO A MINIMUM AND CONSISTENT DEPTH OF 3—INCHES. SHREDDED HARDWOOD BARK MULCH SIZE & COLOR TO BE APPROVED BY OWNER'S REPRESENTATIVE PRIOR TO INSTALLATION. FERTILIZER SHALL BE IN ACCORDANCE WITH APPLICABLE LOCAL, COUNTY AND STATE REQUIREMENTS. SHREDDED HARDWOOD BARK MULCH AREAS SHALL NOT RECEIVE WOVEN WEED BARRIER FABRIC.
- 4. MATERIALS TREE PROTECTION: ALL TREES TO BE INSTALLED WITH LDPE TREE GUARDS AS MANUFACTURED BY A.M. LEONARD HORTICULTURAL TOOL & SUPPLY CO., OR APPROVED EQUAL.

SEEDING

. MATERIALS — TURFGRASS SEED: DISTURBED LAWN AREAS LABELED ON PLAN AS SUCH, SHALL RECEIVE 6" OF TOPSOIL AND EARTH CARPET'S "MADISON PARKS" GRASS SEED, OR EQUIVALENT AS APPROVED BY THE OWNER'S REPRESENTATIVE, INSTALLED PER MANUFACTURER'S RECOMMENDATIONS. IN ADDITION TO TURFGRASS SEED, ANNUAL RYE SHALL BE APPLIED TO ALL DISTURBED AREAS AT A RATE OF 1 1/2 LBS PER 1000 SQUARE FEET. FERTILIZE AND MULCH PER MANUFACTURER'S RECOMMENDATIONS. MULCH SHALL BE CERTIFIED NOXIOUS WEED SEED—FREE


CONTRACTOR AND OWNER RESPONSIBILITY NOTES

- GUARANTEE: THE CONTRACTOR SHALL GUARANTEE ALL PLANTS THROUGH ONE (1) YEAR AFTER ACCEPTANCE BY THE OWNER'S REPRESENTATIVE. PLANTS SHALL BE ALIVE AND IN HEALTHY AND FLOURISHING CONDITION AT THE END OF THE GUARANTEE PERIOD. THE CONTRACTOR SHALL REPLACE (AT NO COST TO OWNER) ANY PLANTS THAT ARE DEAD OR NOT IN A VIGOROUS THRIVING CONDITION. REPLACEMENT PLANTS SHALL BE OF THE SAME KIND AND SIZE AS ORIGINALLY SPECIFIED UNLESS OTHERWISE DIRECTED BY OWNER'S REPRESENTATIVE. RESTORE BEDS AS NECESSARY FOLLOWING PLANT REPLACEMENT, INCLUDING BUT NOT LIMITED TO BEDDING, EDGING, MULCH, ETC. REPLACE PLANTS DAMAGED AT TIME OF PLANTING. REPAIR AREAS DISTURBED IN ANY WAY DURING PLANT REPLACEMENT AT NO COST TO OWNER. CONTRACTOR SHALL PROVIDE A ONE (1)—YEAR STRAIGHTENING GUARANTEE FOR ALL TREES.
- 2. CONTRACTOR IS RESPONSIBLE FOR STAKING THE PLANT MATERIALS FOR REVIEW BY OWNER'S REPRESENTATIVE PRIOR TO DIGGING AND PLACEMENT AND SHALL COORDINATE ALL FINE GRADING AND RESTORATION WITH THE GRADING CONTRACTOR.
- MAINTENANCE: (CONTRACTOR) FOR ALL PLANTINGS, SEEDED AND/OR SODDED LAWN AREAS: THE CONTRACTOR SHALL MAINTAIN ALL PLANTINGS AND LAWN AREAS FOR A MINIMUM TIME PERIOD OF 60 DAYS, UNTIL FINAL ACCEPTANCE BY OWNER'S REPRESENTATIVE. THE CONTRACTOR IS RESPONSIBLE FOR ADEQUATELY WATERING PLANTS AND LAWN/TURFGRASS DURING THIS 60 DAY ESTABLISHMENT PERIOD. CONTRACTOR IS RESPONSIBLE FOR THE ESTABLISHMENT OF HEALTHY VIGOROUS PLANT MATERIALS AND LAWN/TURFGRASS GROWTH. CONTRACTOR IS ALSO RESPONSIBLE FOR ANY PRUNING OF PLANT MATERIALS, AND SHAPING AND/OR REPLACEMENT OR SUPPLEMENT OF DEFICIENT SHREDDED HARDWOOD BARK MULCH DURING THIS PERIOD. LONG TERM PLANT MATERIALS AND LAWN/TURFGRASS MAINTENANCE AND ANY PROGRAM FOR SUCH IS THE RESPONSIBILITY OF THE OWNER. ALL PLANTINGS AND LAWN/TURFGRASS AREAS SHALL BE MAINTAINED IN A MANICURED CONDITION UNTIL THE TIME WHEN THE OWNER'S ACCEPTANCE IS GIVEN.
- 4. MAINTENANCE: (OWNER) THE OWNER IS RESPONSIBLE FOR THE CONTINUED MAINTENANCE, REPAIR AND REPLACEMENT OF ALL LANDSCAPING MATERIALS AND WEED BARRIER FABRIC AS NECESSARY FOLLOWING THE ONE (1) YEAR CONTRACTOR GUARANTEE PERIOD.

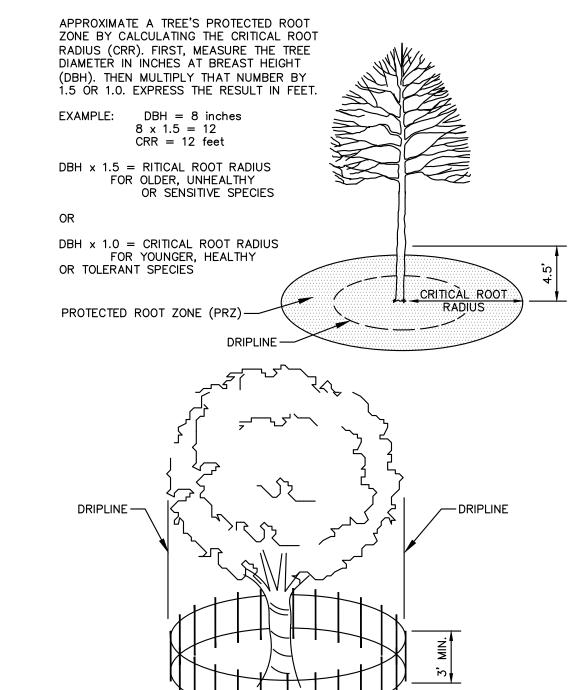

CONTRACTOR SHALL INSTALL TREE PROTECTION FENCING IN THE AREA SURROUNDING THE TREE WITHIN THE CRITICAL ROOT RADIUS
 NO EXCAVATION IS PERMITTED WITHIN THE CRITICAL ROOT RADIUS
 IF EXCAVATION WITHIN THE CRITICAL ROOT RADIUS OF ANY TREE IS NECESSARY, CONTRACTOR SHALL CONTACT CITY FORESTER PRIOR TO EXCAVATION TO ASSESS THE IMPACT TO THE TREE AND ROOT SYSTEM.



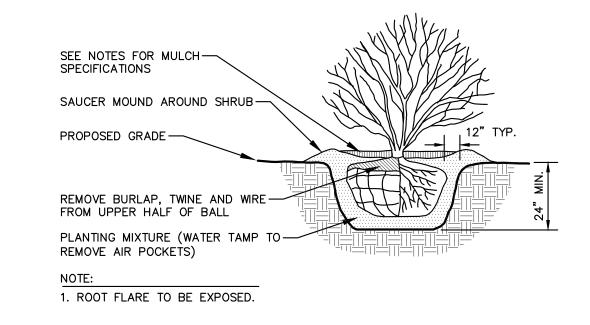


----4" SPADE EDGE


AREAS ABUT

WHERE SODDED



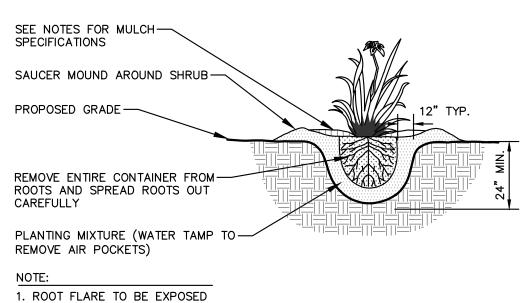

PERENNIAL/ORNAMENTAL GRASS

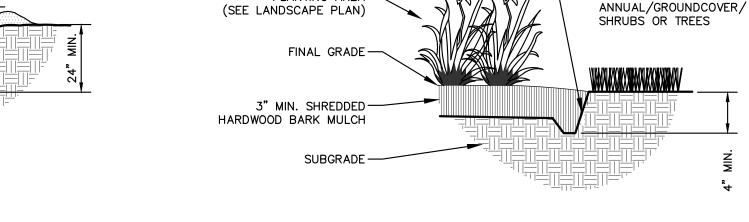



NATURAL SPADE EDGE




MADISON COLLEGE
ADMINISTRATION BUILDING
ADDITION AND RENOVATION
Madison, Wisconsin



Issue date:	07-14-2022
AA Project No.:	2021-08
MC Project No.:	RFB22-006
Bid Pkg No.:	-

REVISION	DATE

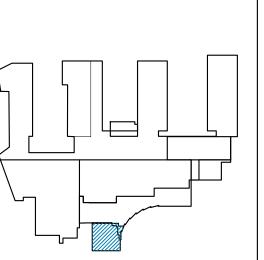

assemblage ARCHITECTS 7433 Elmwood Avenue Middleton, WI 53562 T 608.827.5047

SCALE


SHEET TITLE

LANDSCAPE NOTES

& DETAILS

SHEET NUMBER

L200

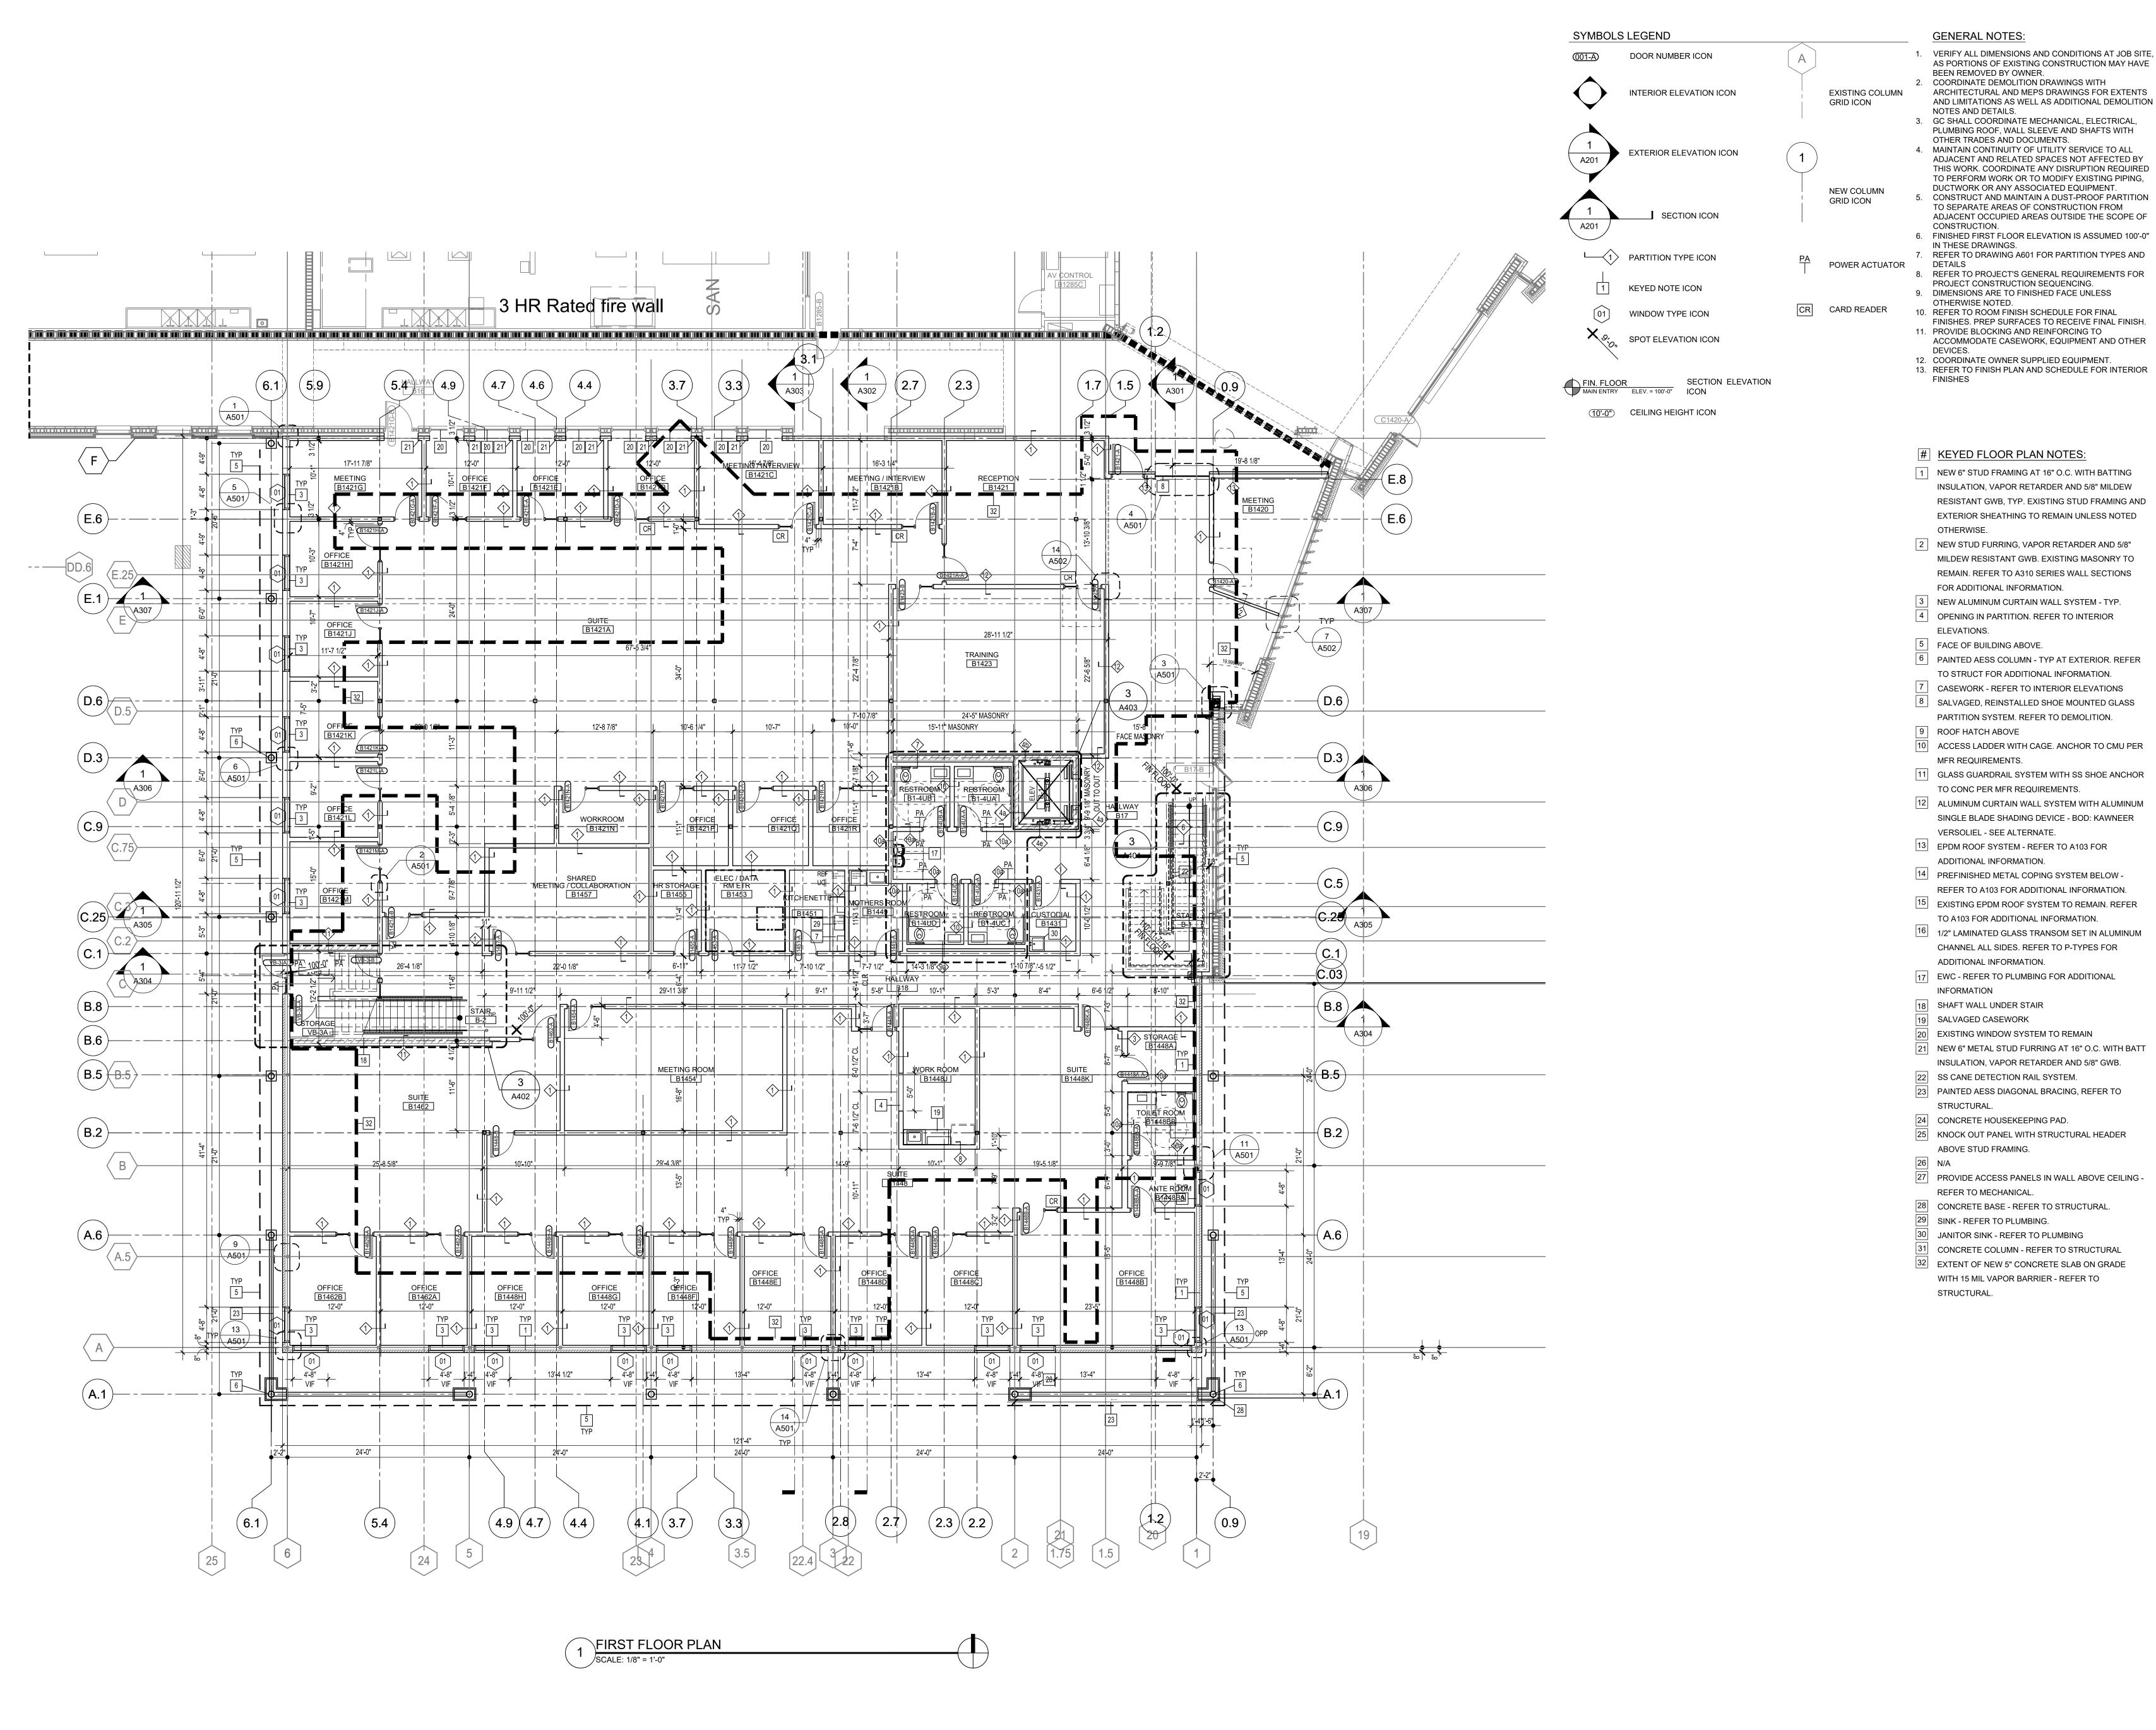



MADISON COLLEGE
ADMINISTRATION BUILDING
ADDITION AND RENOVATION
Madison, Wisconsin

Issued for:

BID

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REVISION

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SCALE


1/8"=1'-0"

SHEET TITLE

FIRST FLOOR PLAN

SHEET NUMBER


A101

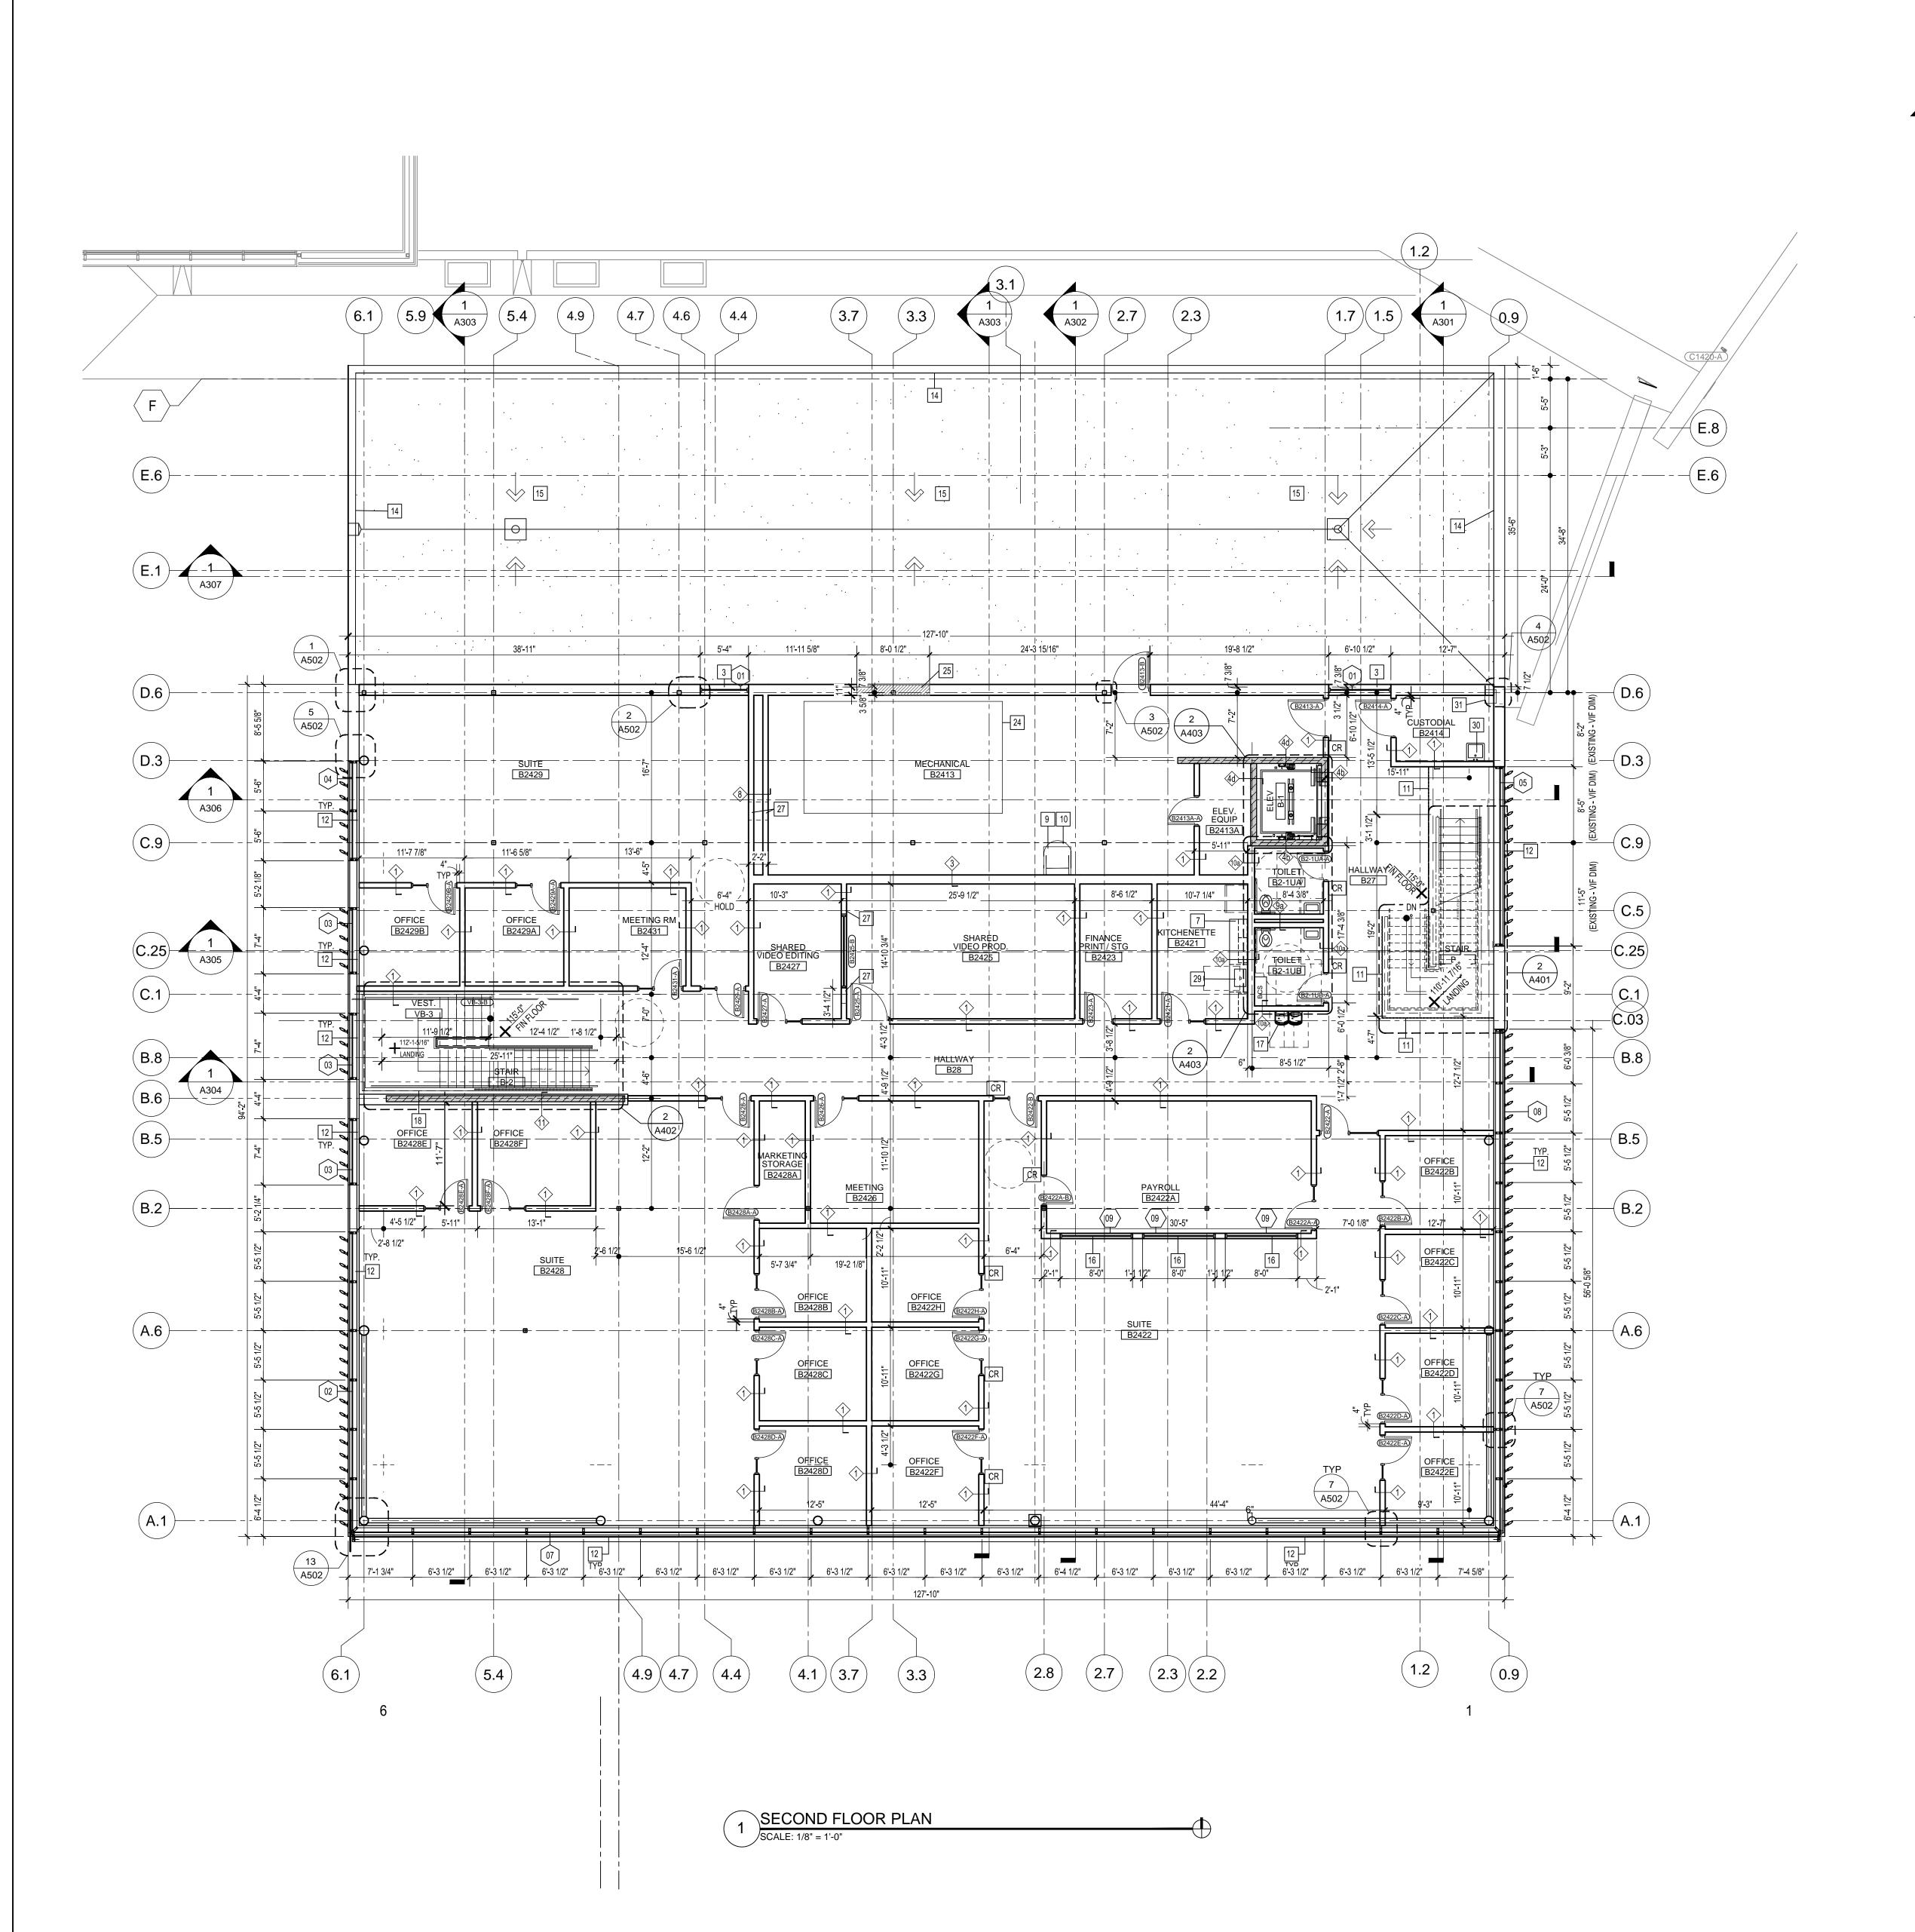

SYMBOLS LEGEND

DOOR NUMBER ICON INTERIOR ELEVATION ICON

EXISTING COLUMN **GRID ICON**

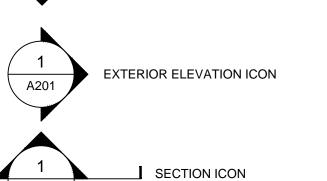

NEW COLUMN GRID ICON

POWER ACTUATOR

CR CARD READER

PARTITION TYPE ICON KEYED NOTE ICON

WINDOW TYPE ICON SPOT ELEVATION ICON

FIN. FLOOR

MAIN ENTRY ELEV. = 100'-0"

SECTION

ICON

(10'-0") CEILING HEIGHT ICON

GENERAL NOTES: VERIFY ALL DIMENSIONS AND CONDITIONS AT JOB SITE AS PORTIONS OF EXISTING CONSTRUCTION MAY HAVE BEEN REMOVED BY OWNER. COORDINATE DEMOLITION DRAWINGS WITH

AREA | TECHNICAL

MADISON COLLEGE

Madison, Wisconsin

ADMINISTRATION BUILDING

ADDITION AND RENOVATION

2021-08

- ARCHITECTURAL AND MEPS DRAWINGS FOR EXTENTS AND LIMITATIONS AS WELL AS ADDITIONAL DEMOLITION NOTES AND DETAILS. 3. GC SHALL COORDINATE MECHANICAL, ELECTRICAL,
 - PLUMBING ROOF, WALL SLEEVE AND SHAFTS WITH OTHER TRADES AND DOCUMENTS. MAINTAIN CONTINUITY OF UTILITY SERVICE TO ALL ADJACENT AND RELATED SPACES NOT AFFECTED BY
 - TO PERFORM WORK OR TO MODIFY EXISTING PIPING, DUCTWORK OR ANY ASSOCIATED EQUIPMENT. CONSTRUCT AND MAINTAIN A DUST-PROOF PARTITION TO SEPARATE AREAS OF CONSTRUCTION FROM ADJACENT OCCUPIED AREAS OUTSIDE THE SCOPE OF CONSTRUCTION.

THIS WORK. COORDINATE ANY DISRUPTION REQUIRED

- 6. FINISHED FIRST FLOOR ELEVATION IS ASSUMED 100'-0" IN THESE DRAWINGS. 7. REFER TO DRAWING A601 FOR PARTITION TYPES AND
- DETAILS 8. REFER TO PROJECT'S GENERAL REQUIREMENTS FOR PROJECT CONSTRUCTION SEQUENCING. 9. DIMENSIONS ARE TO FINISHED FACE UNLESS
- FINISHES. PREP SURFACES TO RECEIVE FINAL FINISH. 11. PROVIDE BLOCKING AND REINFORCING TO ACCOMMODATE CASEWORK, EQUIPMENT AND OTHER DEVICES.
- 13. REFER TO FINISH PLAN AND SCHEDULE FOR INTERIOR FINISHES

KEYED FLOOR PLAN NOTES:

- 1 NEW 6" STUD FRAMING AT 16" O.C. WITH BATTING INSULATION, VAPOR RETARDER AND 5/8" MILDEW RESISTANT GWB, TYP. EXISTING STUD FRAMING AND EXTERIOR SHEATHING TO REMAIN UNLESS NOTED OTHERWISE.
- 2 NEW STUD FURRING, VAPOR RETARDER AND 5/8" MILDEW RESISTANT GWB. EXISTING MASONRY TO REMAIN. REFER TO A310 SERIES WALL SECTIONS FOR ADDITIONAL INFORMATION.
- 3 NEW ALUMINUM CURTAIN WALL SYSTEM TYP. 4 OPENING IN PARTITION. REFER TO INTERIOR ELEVATIONS.
- FACE OF BUILDING ABOVE.
- PAINTED AESS COLUMN TYP AT EXTERIOR. REFER TO STRUCT FOR ADDITIONAL INFORMATION.
- CASEWORK REFER TO INTERIOR ELEVATIONS
- PARTITION SYSTEM. REFER TO DEMOLITION.
- 9 ROOF HATCH ABOVE
- MFR REQUIREMENTS.
- TO CONC PER MFR REQUIREMENTS.
- SINGLE BLADE SHADING DEVICE BOD: KAWNEER
- 13 EPDM ROOF SYSTEM REFER TO A103 FOR ADDITIONAL INFORMATION.
- PREFINISHED METAL COPING SYSTEM BELOW -
- REFER TO A103 FOR ADDITIONAL INFORMATION.
- 1/2" LAMINATED GLASS TRANSOM SET IN ALUMINUM CHANNEL ALL SIDES. REFER TO P-TYPES FOR
- 17 EWC REFER TO PLUMBING FOR ADDITIONAL
- INFORMATION
- 18 SHAFT WALL UNDER STAIR
- SALVAGED CASEWORK
- NEW 6" METAL STUD FURRING AT 16" O.C. WITH BATT
- INSULATION, VAPOR RETARDER AND 5/8" GWB.
- PAINTED AESS DIAGONAL BRACING, REFER TO
- STRUCTURAL.
- 25 KNOCK OUT PANEL WITH STRUCTURAL HEADER
- ABOVE STUD FRAMING.
- REFER TO MECHANICAL.
- 8 CONCRETE BASE REFER TO STRUCTURAL.
- SINK REFER TO PLUMBING.
- EXTENT OF NEW 5" CONCRETE SLAB ON GRADE

WITH 15 MIL VAPOR BARRIER - REFER TO STRUCTURAL.


SCALE


1/8"=1'-0" SHEET TITLE

SECOND FLOOR PLAN

SHEET NUMBER

A102

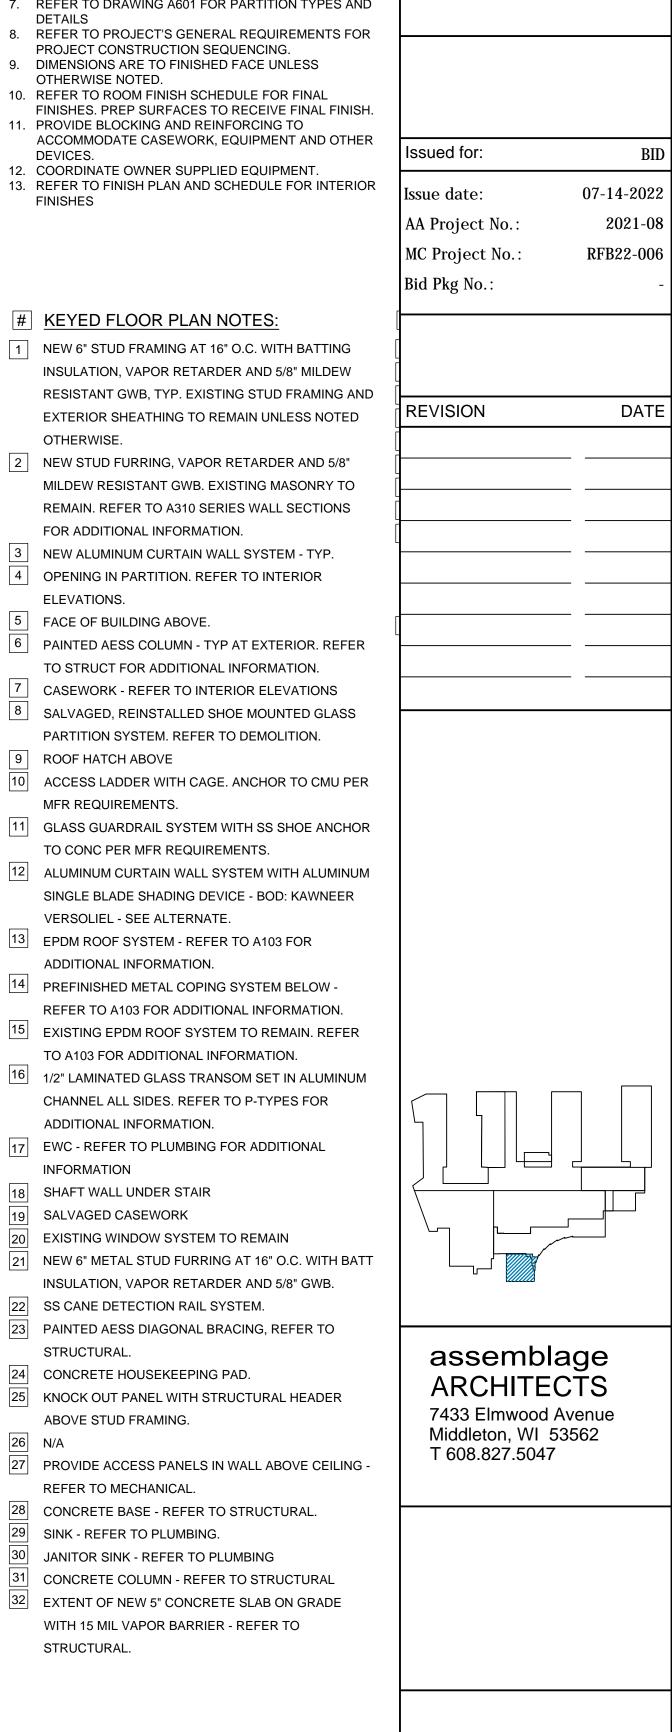


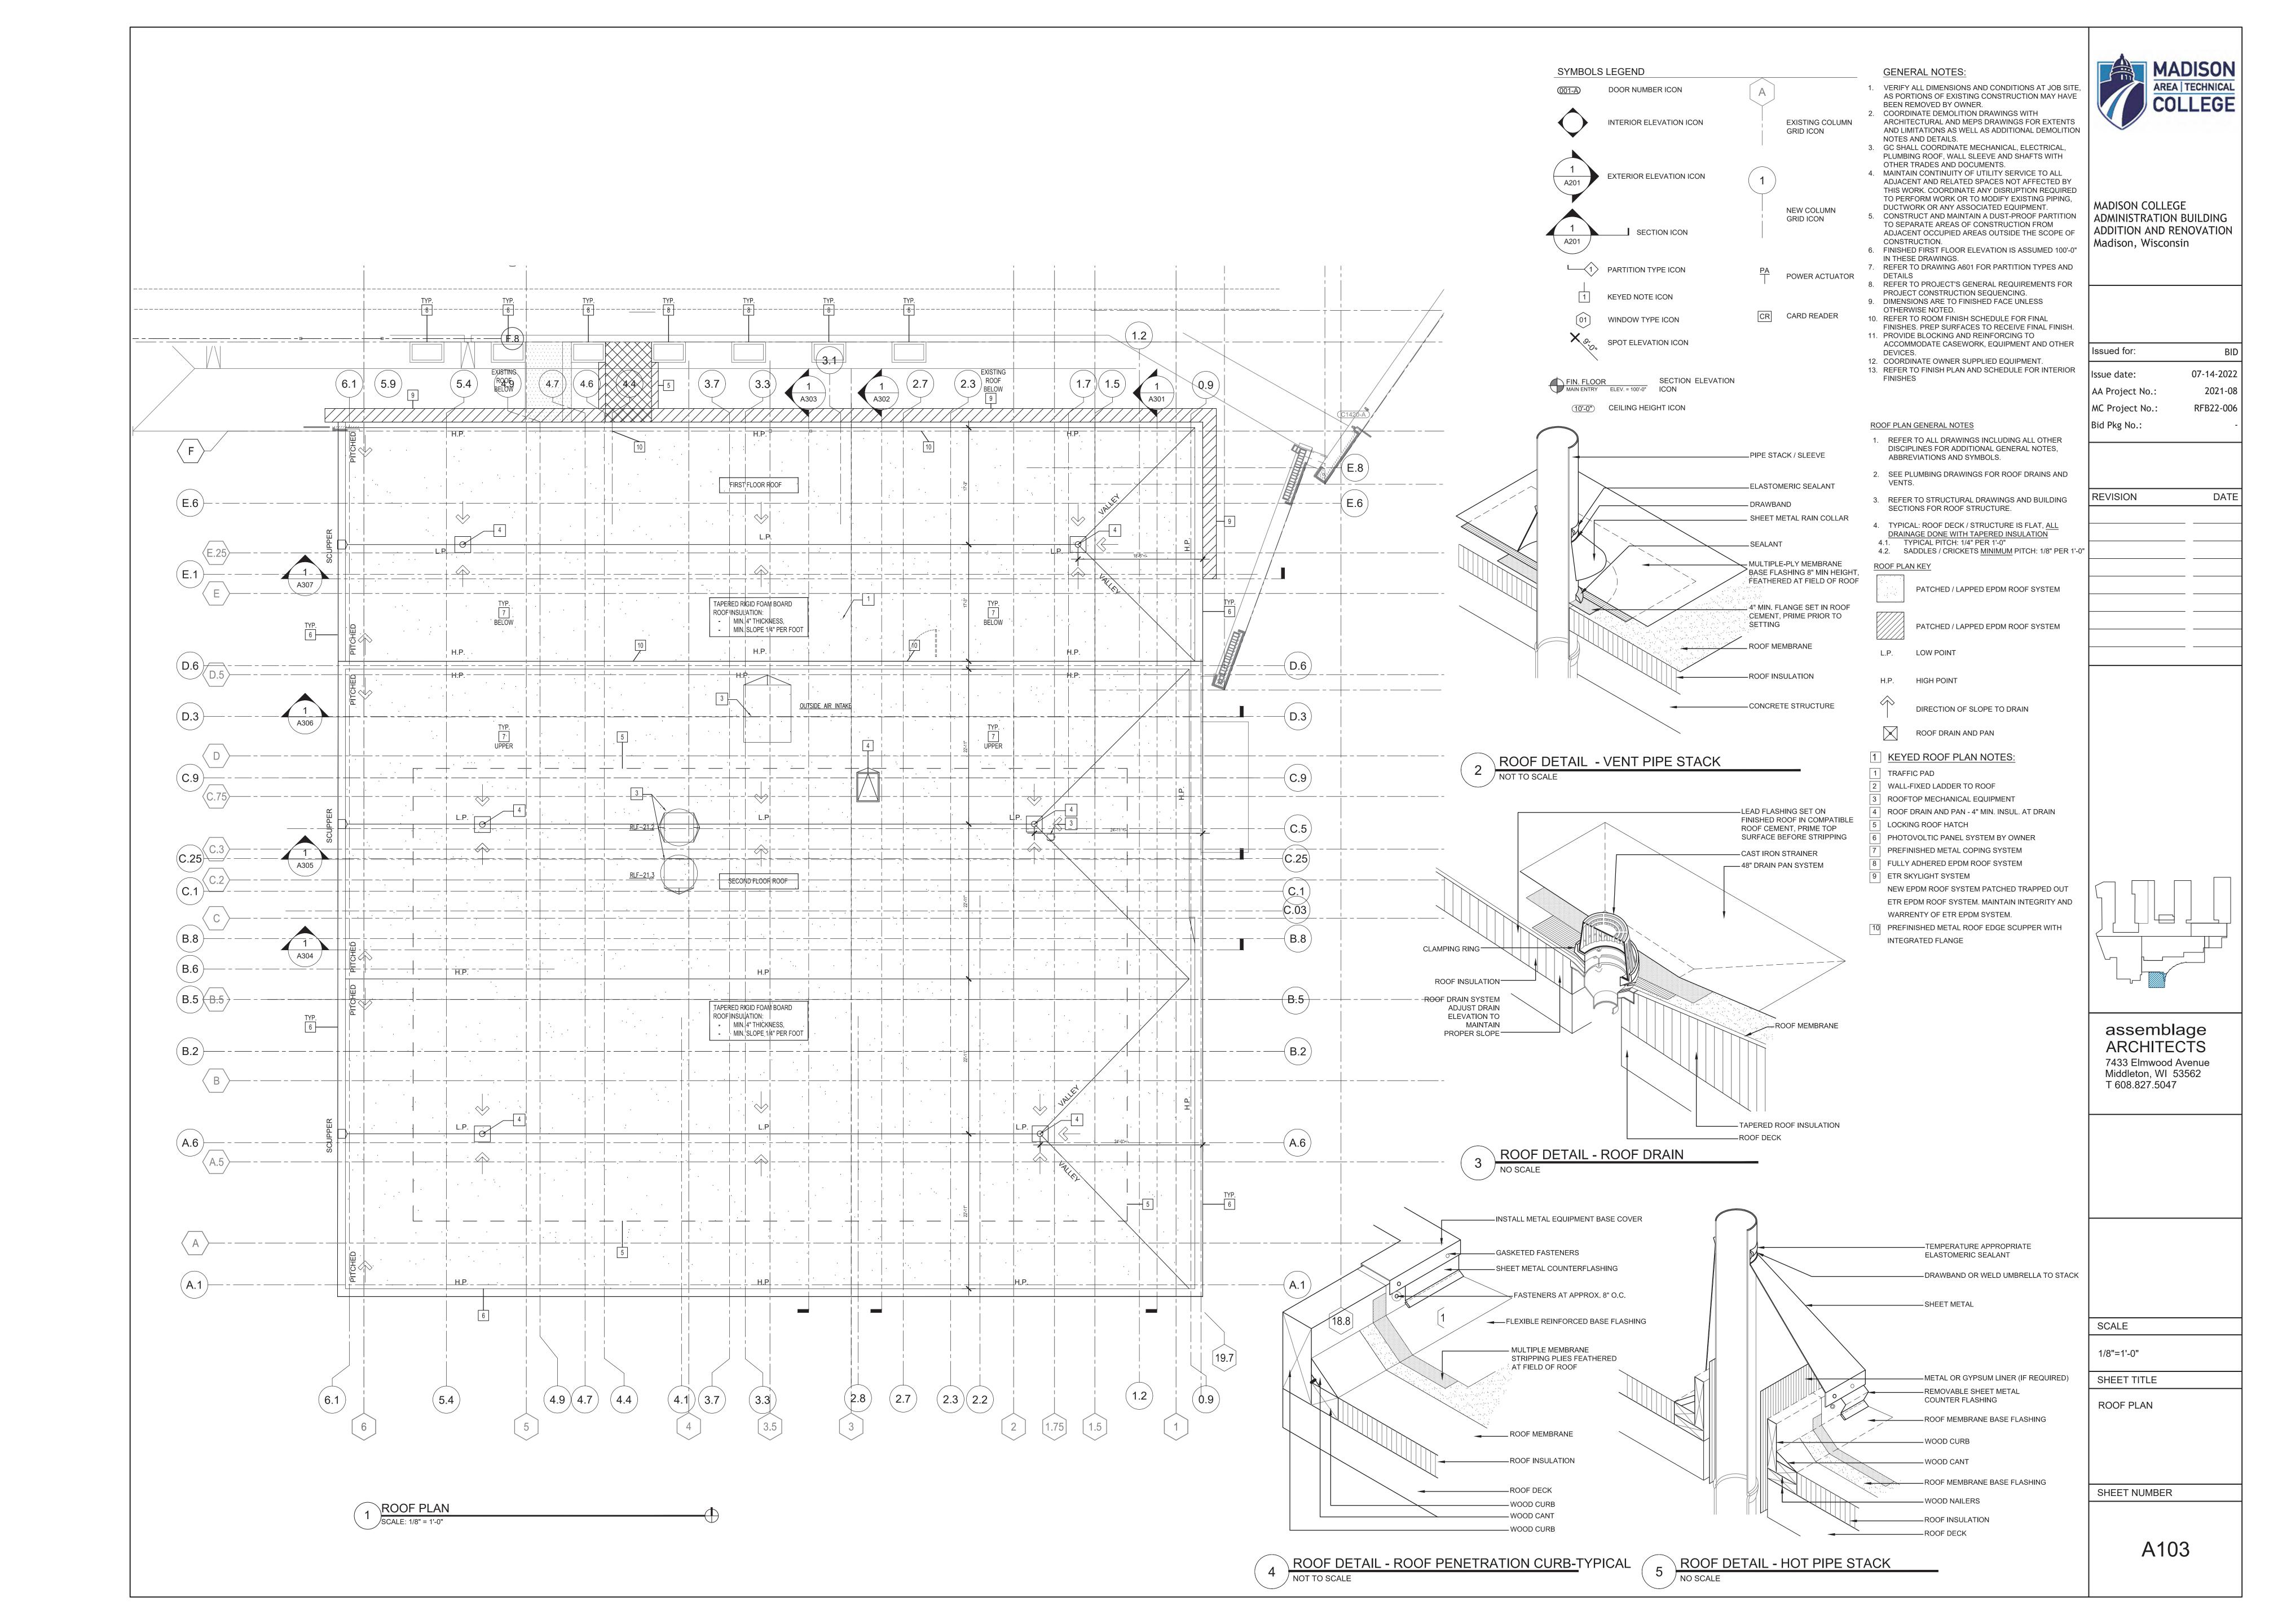



MADISON AREA | TECHNICAL COLLEGE

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MADISON COLLEGE - ADMIN BUILDING JUNE 22, 2022

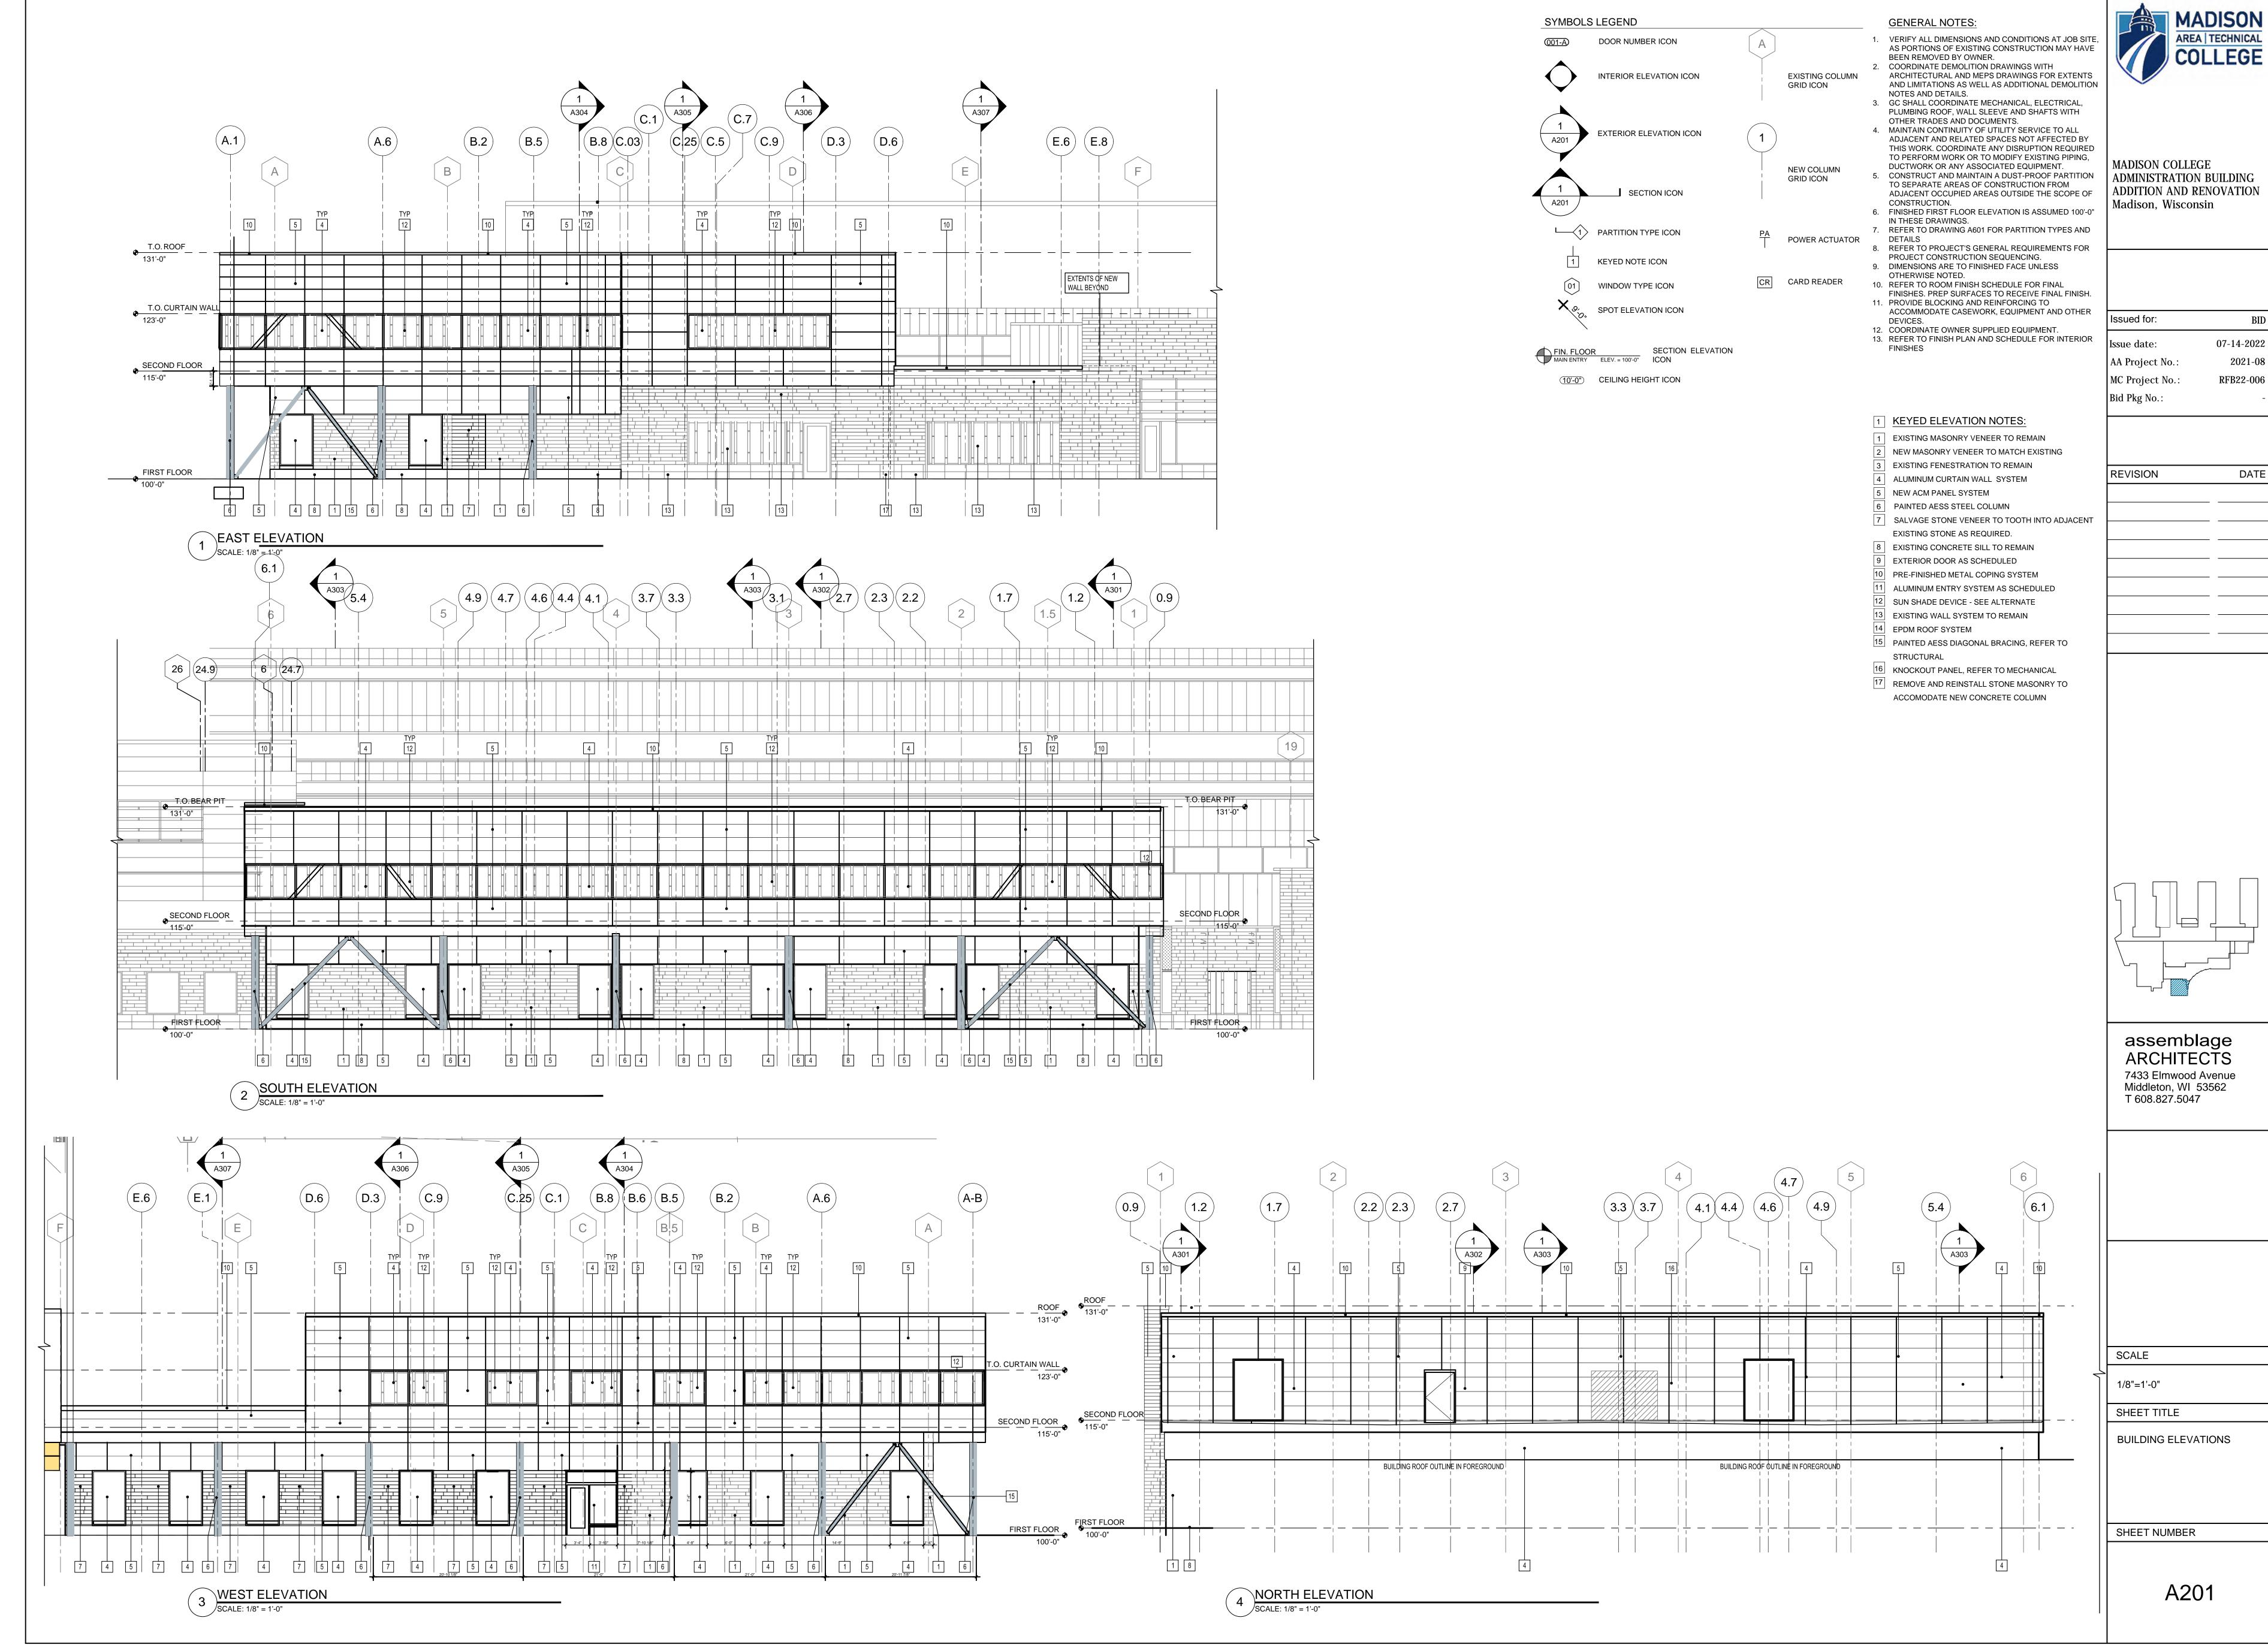MADISON COLLEGE ADMINISTRATION BUILDING MATERIALS SAMPLE SHEET




METAL PANEL SYSTEM



STONE VENEER SYSTEM





EXISTING CONCRETE BASE

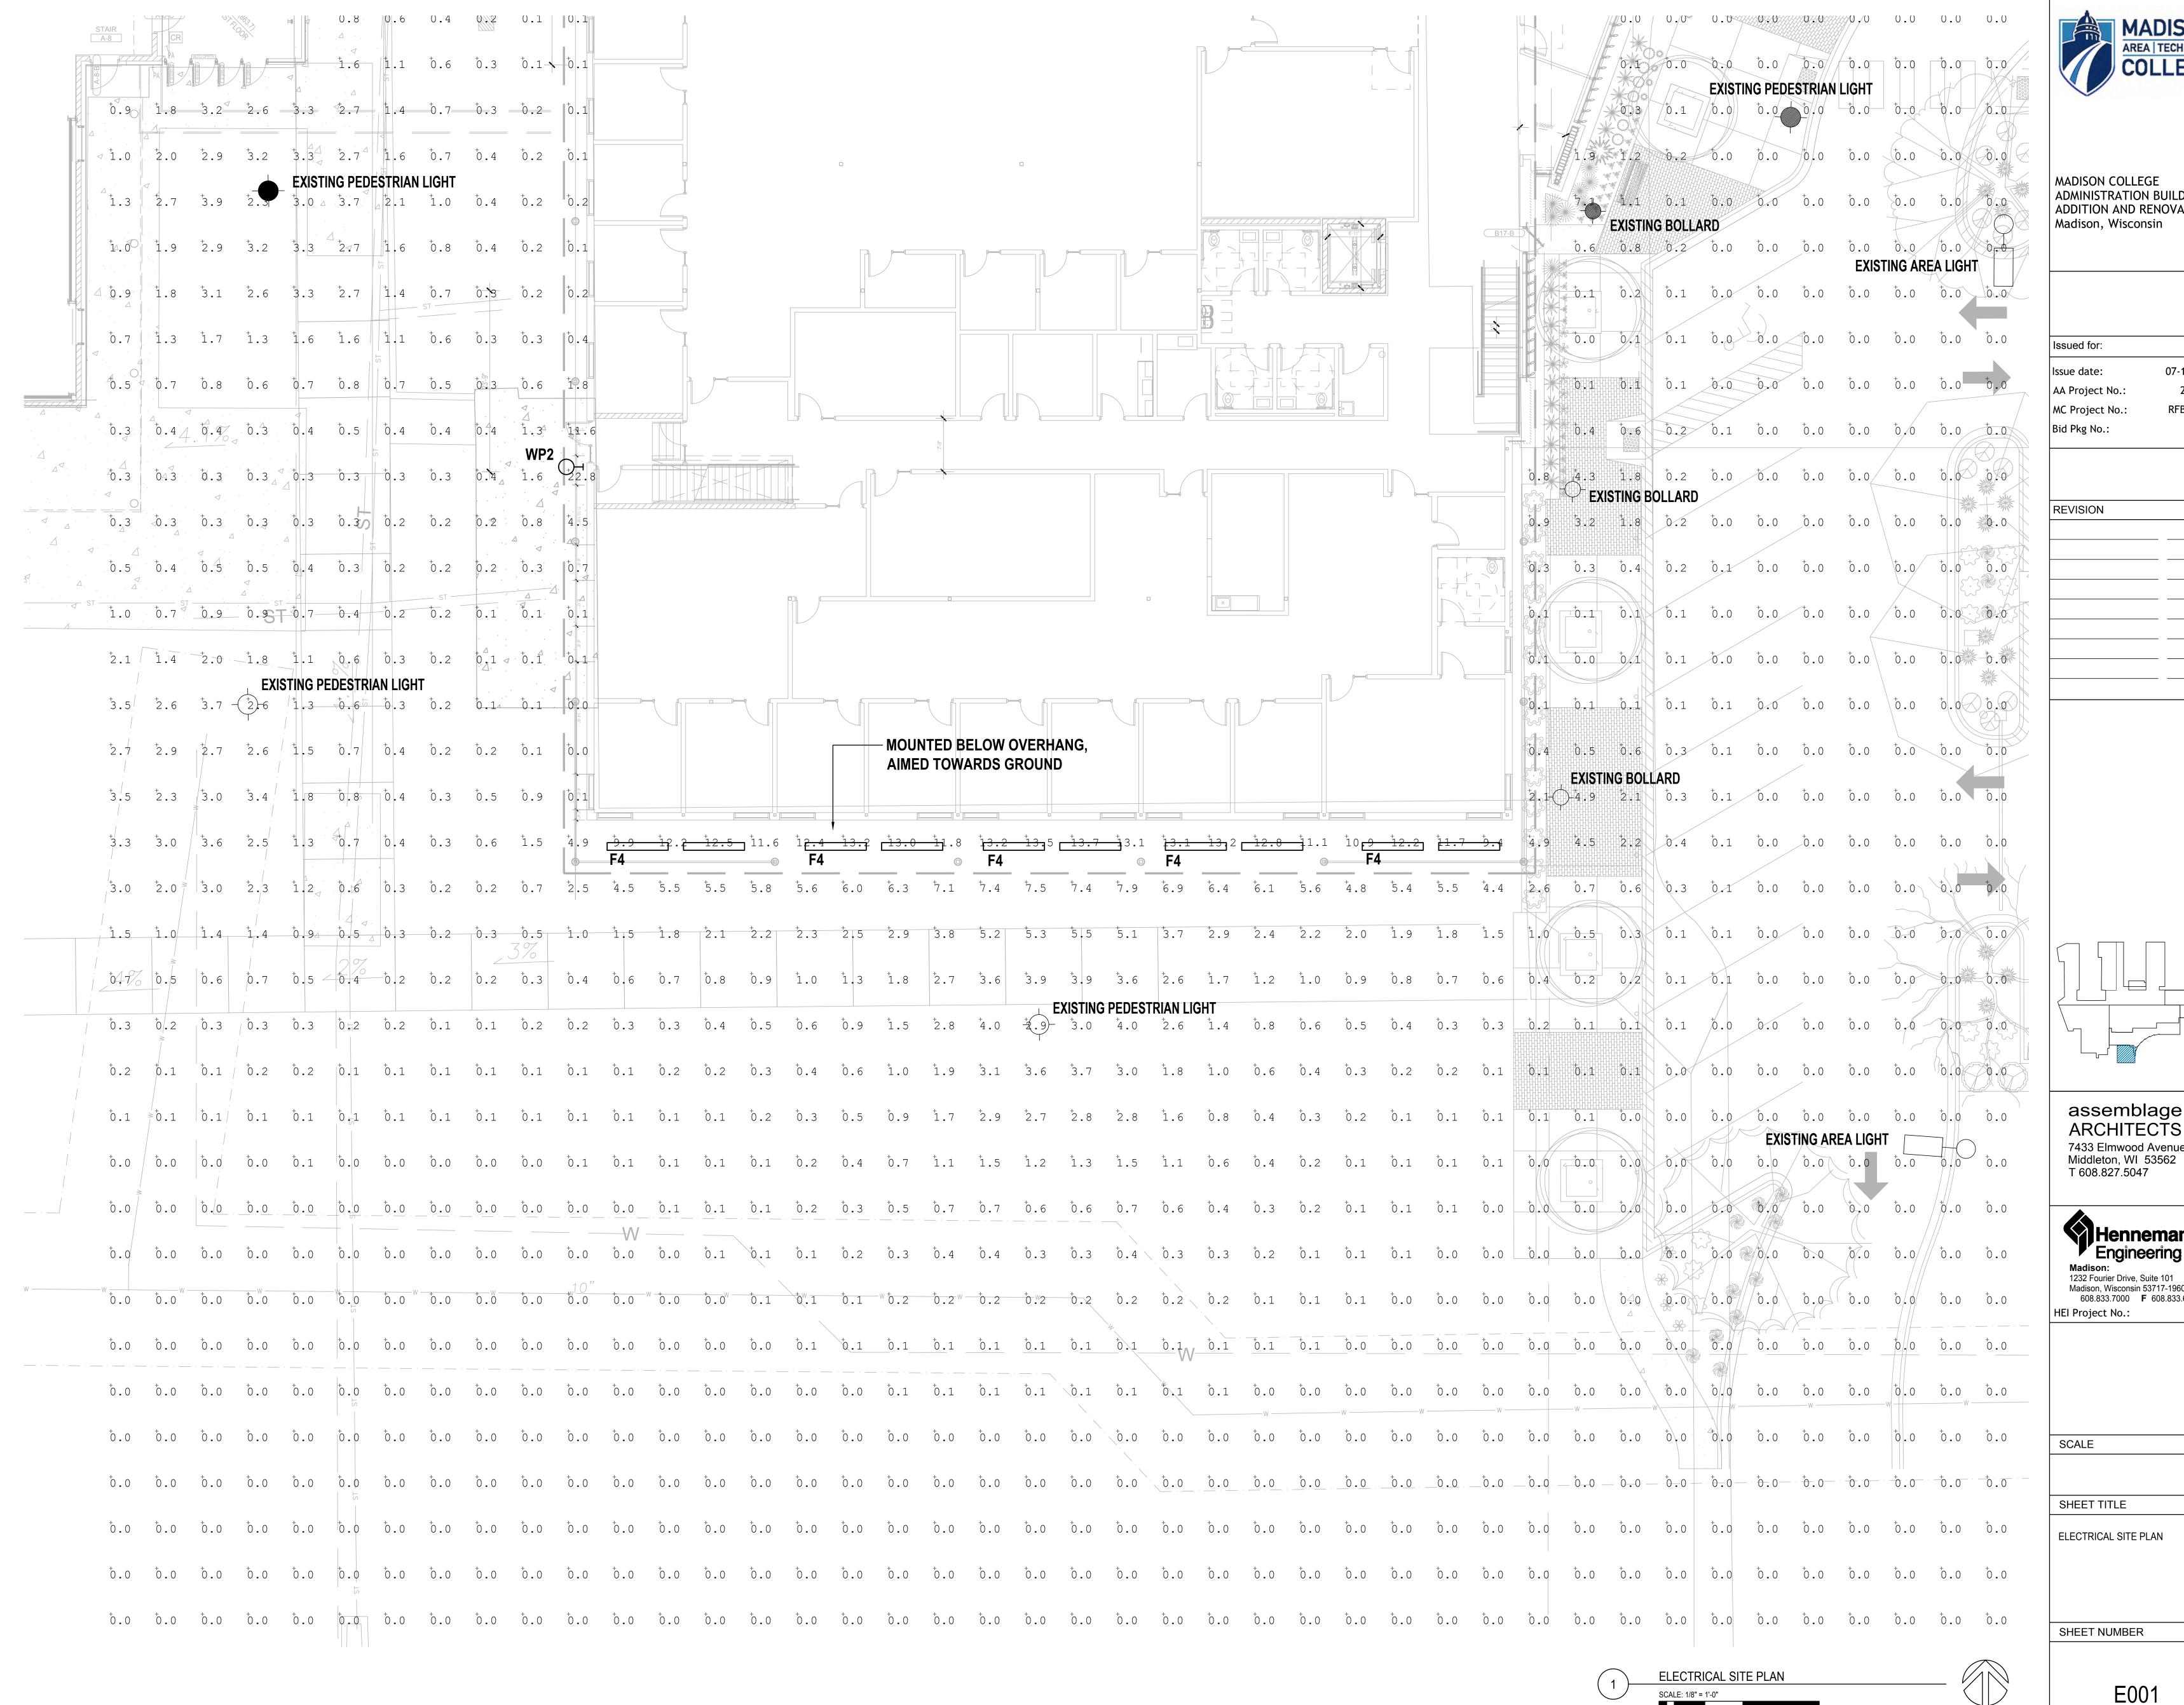



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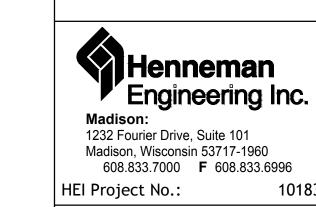


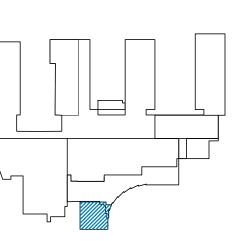MADISON COLLEGE
ADMINISTRATION BUILDING
ADDITION AND RENOVATION
Madison, Wisconsin
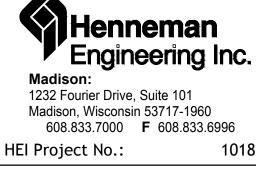
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Issue date:	07-14-2022
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MC Project No.:	RFB22-006
Bid Pkg No.:	-

REVISION	DAT

assemblage ARCHITECTS 7433 Elmwood Avenue Middleton, WI 53562 T 608.827.5047



SCALE


SHEET TITLE

SITE LIGHTING LUMINAIRES

SHEET NUMBER

TYPE F4



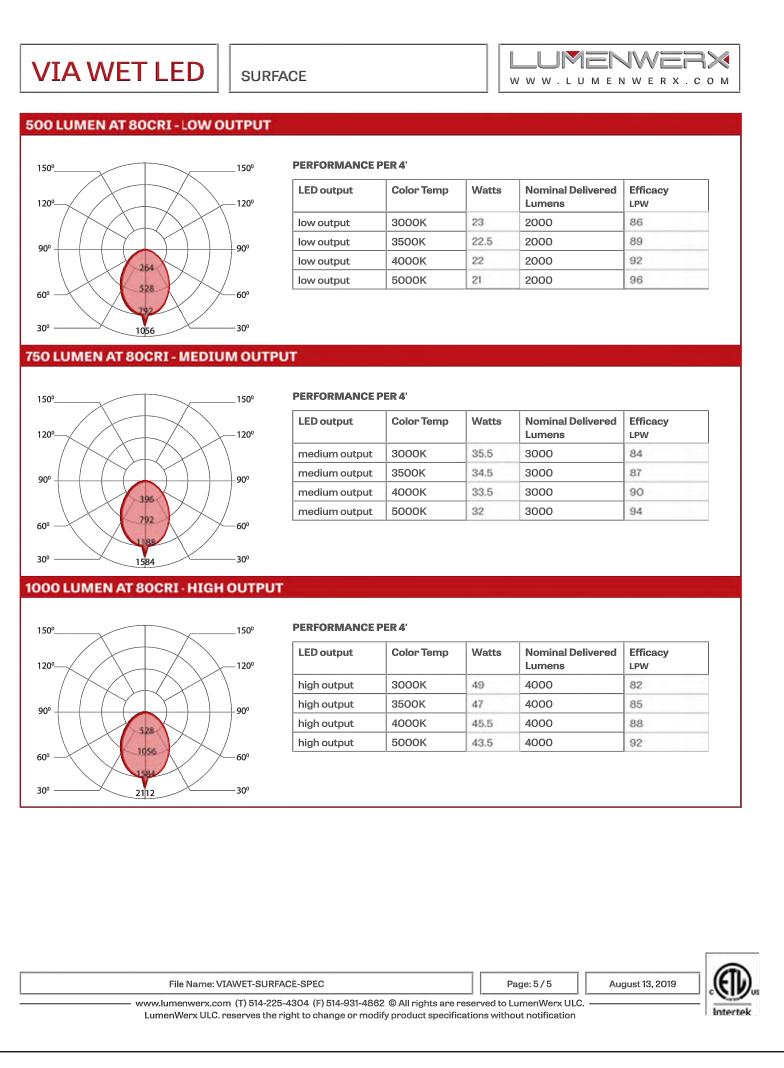

TYPE WP2

